



# ALBUQUEQUE METROPOLITAN ARROYO FLOOD CONTROL AUTHORITY



## CONSTRUCTION PLANS FOR


# BARR SPUR IMPROVEMENTS

ALBUQUERQUE, NM 87105

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SITE  
LOCATION



VICINITY MAP  
NTS

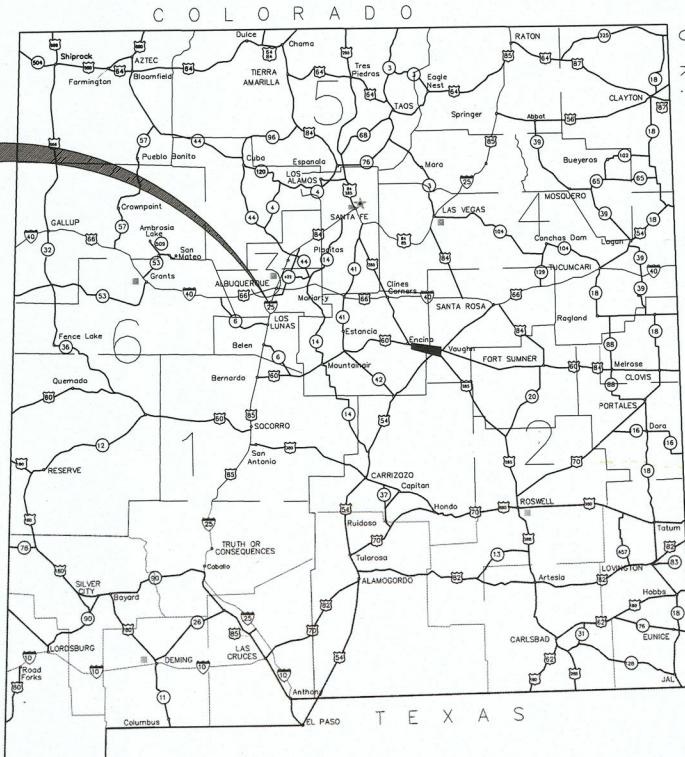1

PROJECT  
LOCATION



LOCATION MAP:  
ZONE MAP R-12, R-13, S-12 & S-13  
NTS

JERRY LOVATO, PE, EXECUTIVE ENGINEER  
APPROVAL FOR BIDDING & CONSTRUCTION  
ALBUQUERQUE METROPOLITAN ARROYO  
FLOOD CONTROL AUTHORITY

DATE  
TJA  
DRAWN BY: JEM  
CHECKED BY: TJA  
DATE: JAN 2022  
SHEET TITLE  
COVER SHEET

SHEET NO:  
G-001

**WILSON**  
& COMPANY

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ALBUQUERQUE, NM 87109  
PHONE: 505-348-4000  
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BARR SPUR  
IMPROVEMENTS

SEAL  
CONSULTANTS  
60% SUBMITTAL  
NOT FOR  
CONSTRUCTION

## GENERAL NOTES:

1. ALL WORK DETAILED ON THESE PLANS TO BE PERFORMED UNDER CONTRACT SHALL, EXCEPT AS OTHERWISE STATED OR PROVIDED FOR HEREON, BE CONSTRUCTED IN ACCORDANCE WITH THE NEW MEXICO STATE HIGHWAY AND TRANSPORTATION DEPARTMENT STANDARD SPECIFICATIONS FOR HIGHWAY AND BRIDGE CONSTRUCTION, 2019 EDITION
2. ALL STATIONING FOR THE ROADWAYS, EMBANKMENTS AND CHANNELS REFER TO THE MEASURED HORIZONTAL DISTANCE. LEFT AND RIGHT OF CENTERLINE ARE LOOKING IN THE DIRECTION OF INCREASING STATION.
3. WHEN COORDINATES ARE SHOWN, HEREIN (N,E) THEY REFER TO GROUND COORDINATES. PROJECT GROUND COORDINATES ARE CALCULATED FROM ADJUSTED GRID COORDINATES USING A PROJECT COMBINED GRID-TO-GROUND FACTOR (CGGF) TO OBTAIN ADJUSTED GRID COORDINATES DIVIDE THE PROJECT GROUND COORDINATES BY THE CGGF. TO OBTAIN PROJECT GROUND COORDINATES MULTIPLY THE ADJUSTED GRID COORDINATES BY THE CGGF.
4. LIMITS OF WORK ARE SHOWN ON THE PLANS. THE CONTRACTOR SHALL CONFINE HIS OPERATIONS WITHIN THE PROJECT LIMITS UNLESS OTHERWISE NOTED OR PERMITTED. THE CONTRACTOR WILL BE HELD RESPONSIBLE FOR ANY AGREEMENTS NECESSARY OR DAMAGE BY HIS OPERATION TO PUBLIC OR PRIVATE PROPERTY INCLUDING UTILITIES.
5. FILL MATERIALS FROM EXCAVATION OR BORROW WHICH REQUIRE MORE THAN ONE HANDLING PRIOR TO FINAL PLACEMENT, INCLUDING STOCKPILING AND BLENDING TO MEET GRADATION REQUIREMENTS OR STOCKPILING FOR LATER DISPOSAL, WILL BE CONSIDERED INCIDENTAL TO THE CONTRACT UNIT PRICE FOR UNCLASSIFIED EXCAVATION. NO SEPARATE PAYMENT SHALL BE MADE FOR BLENDING OR MULTIPLE HANDLING AND FINAL PAYMENT SHALL BE MADE ON THE BASIS OF QUANTITIES REMOVED FROM ORIGINAL LOCATION.
6. ANY AREAS DISTURBED BY THE CONTRACTOR THAT ARE AREAS NOT INCLUDED ON THE PLANS SHALL BE TREATED AND STABILIZED WITH USFWS INTERIOR MIX, USFWS EXTERIOR MIX OR MRGCD MIX, AND NO MEASUREMENT OR PAYMENT WILL BE MADE THEREFORE.
7. WATERING, AS REQUIRED FOR CONSTRUCTION AND DUST CONTROL, SHALL BE CONSIDERED INCIDENTAL TO CONSTRUCTION AND NO MEASUREMENT OR PAYMENT SHALL BE MADE. CONSTRUCTION AREAS SHALL BE WATERED FOR DUST POLLUTION ABATEMENT. THE CONTRACTOR SHALL BE RESPONSIBLE FOR LOCATING AND SUPPLYING WATER AS REQUIRED. THE COST FOR REQUIRED CONSTRUCTION OF AIR QUALITY MITIGATION SHALL BE INCIDENTAL TO THE PROJECT COST.
8. THE CONTRACTOR IS RESPONSIBLE FOR EXECUTING A "SPECIAL USE PERMIT" WITH THE U.S.FISH & WILDLIFE SERVICE. THE CONTRACTOR SHALL COMPLY WITH ALL PROVISIONS OF THE "SPECIAL USE PERMIT".
9. MINOR CHANGES IN ELEVATIONS AND SLOPES FOR EXCAVATION AND FILL MAY BE MADE TO SUIT FIELD CONDITIONS, AS APPROVED BY THE ENGINEER.
10. PRIOR TO CONSTRUCTION, THE CONTRACTOR SHALL EXCAVATE AND VERIFY THE HORIZONTAL AND VERTICAL LOCATIONS OF ALL OBSTRUCTIONS. SHOULD A CONFLICT EXIST, THE CONTRACTOR SHALL NOTIFY THE ENGINEER SO THAT THE CONFLICT CAN BE RESOLVED WITH A MINIMUM AMOUNT OF DELAY. ALL UTILITY LOCATIONS SHOWN ARE APPROXIMATE.
11. TWO (2) WORKING DAYS PRIOR TO ANY EXCAVATION, CONTRACTOR MUST CONTACT N.M. ONE-CALL SYSTEM, (505) 260-1990, FOR LOCATION OF EXISTING UTILITIES.
12. IT SHALL BE THE CONTRACTOR'S RESPONSIBILITY TO ENSURE THAT BUILDING STRUCTURES ADJACENT TO THE PROJECT NOT BE DAMAGED DUE TO ANY CONSTRUCTION ACTIVITIES. DAMAGE CAUSED TO ANY BUILDING STRUCTURE WILL BE THE SOLE RESPONSIBILITY OF THE CONTRACTOR, INCLUDING ALL COSTS INCURRED IN RESTORING/REPAIRING SAID DAMAGE PER NMDOT SPEC. SECTION 617.
13. THE CONTRACTOR SHALL MAINTAIN AN UP TO DATE SET OF AS-BUILT PLANS FOR THE PROJECT. THESE PLANS SHALL BE KEPT CURRENT, WITHIN TWO WEEKS, AT ALL TIMES AND SHALL BE SUBJECT TO REVIEW BY THE PROJECT MANAGER. THE FINAL AS-BUILT PLANS SHALL BE SUBMITTED TO THE PROJECT MANAGER.

## MRGCD GENERAL NOTES:

1. THE CONTRACTOR IS RESPONSIBLE FOR EXECUTING A "SPECIAL USE LICENSE AGREEMENT" WITH THE M.R.G.C.D. PRIOR TO CONSTRUCTION. THE CONTRACTOR SHALL COMPLY WITH ALL PROVISIONS OF THE "SPECIAL USE LICENSE" INCLUDING BUT NOT LIMITED TO: CONSTRUCTION DEADLINES, COORDINATION WITH M.R.G.C.D OPERATIONS AND DEWATERING REQUIREMENTS.
2. THE CONTRACTOR SHALL NOT STORE EQUIPMENT, NEW MATERIALS OR DEBRIS WITHIN DISTRICT RIGHT-OF-WAY, OUTSIDE OF THE ESTABLISHED CONSTRUCTION LIMITS, WHICH MAY INTERFERE WITH OPERATIONS AND MAINTENANCE OF M.R.G.C.D. FACILITIES.
3. THE CONTRACTOR SHALL NOT SERVICE VEHICLES OR EQUIPMENT WITHIN M.R.G.C.D. RIGHT-OF-WAY, OUTSIDE OF THE ESTABLISHED CONSTRUCTION LIMITS.
4. SEEDING OF DISTURBED AREAS WITHIN M.R.G.C.D. RIGHT-OF-WAYS IS REQUIRED PER THE M.R.G.C.D SEEDING SPECIFICATIONS WITHIN THE ESTABLISHED CONSTRUCTION LIMITS.
5. THE CONTRACTOR SHALL BE RESPONSIBLE FOR OBTAINING PERMISSION FROM INDIVIDUAL LANDOWNERS TO ACCESS THE PROJECT SITE BY WAY OF PRIVATE CROSSINGS AND PROPERTY.
6. THE CONTRACTOR IS RESPONSIBLE FOR REPAIRING AND OR REPLACEMENT OF ANY STRUCTURES REMOVED AND OR DAMAGED DUE TO THE CONTRACTOR'S ACTIVITIES WITHIN THE DISTRICT'S RIGHT-OF-WAY. ANY STRUCTURES SUCH AS TURNOUTS, CULVERT PIPES, EMBANKMENTS, DRIVEWAYS, FENCING, AND OTHERS WHICH ARE DAMAGED DURING CONSTRUCTION ACTIVITIES, SHALL BE REPLACED AT THE CONTRACTOR'S EXPENSE. REPAIRS AND OR REPLACEMENTS WITHIN M.R.G.C.D RIGHT-OF-WAY MUST COMPLY WITH THE PROJECT AND DISTRICT SPECIFICATIONS.
7. ALL SALVAGEABLE CULVERTS, IRRIGATION GATES, ETC. MUST BE RETURNED TO THE M.R.G.C.D.
8. TEMPORARY INSTALLATIONS SHALL BE REMOVED BEFORE PROJECT COMPLETION SUCH THAT THE FINISHED WORK WILL NOT INTERFERE WITH OPERATIONS OF THE M.R.G.C.D FACILITIES.

THE FOLLOWING NOTES ALSO APPLY WHEN CHECKED:

- ALL UTILITIES AND UTILITY SERVICE LINES SHALL BE INSTALLED PRIOR TO PAVING.
- BACKFILL COMPACTION SHALL BE ACCORDING TO SPECIFIED STREET USE.
- TACK COAT REQUIREMENTS SHALL BE DETERMINED BY THE ENGINEER.
- SIDEWALKS AND WHEELCHAIR RAMPS WITHIN THE CURB RETURNS SHALL BE CONSTRUCTED WHEREVER A NEW CURB RETURN IS CONSTRUCTED.
- IF CURB IS DEPRESSED FOR A DRIVEPAD, THE DRIVEPAD SHALL BE CONSTRUCTED PRIOR TO ACCEPTANCE OF CURB AND GUTTER.
- ALL STORM DRAINAGE FACILITIES SHALL BE COMPLETED PRIOR TO FINAL ACCEPTANCE.

UTILITY CONTACTS	PHONE	UTILITY COMPANY CONTACTS
LUNA, DAMIAN	OFFICE PHONE: (505) 289-3031 OFFICE FAX: (505) 289-3060 CELL PHONE: (505) 414-5695 DLUNA@ABCWUA.ORG	ALBUQUERQUE BERNALILLO COUNTY WATER UTILITY AUTHORITY P.O. BOX 568 ALBUQUERQUE, NM 87103
MOYER, MIKE	OFFICE PHONE: (505) 241-3697 OFFICE FAX: (505) 241-3415 CELL PHONE: (505) 249-5712 MIKEMOYER@PNM.COM	PNM ELECTRIC 4625 EDITH BLVD. NE ALBUQUERQUE, NM 87107
HERRERA, JOE	OFFICE PHONE: (505) 697-6802 OFFICE FAX: (505) 344-0091 CELL PHONE: (505) 401-7642 JJHERRERA@TECOENERGY.COM	NM GAS COMPANY 4625 EDITH BLVD. NE ALBUQUERQUE, NM 87107
KELLY, SEAN	OFFICE PHONE: (505) 842-2838 OFFICE FAX: (505) 842-2890 CELL PHONE: (505) 200-1994 SK1561@ATT.COM	AT&T 111 3RD STREET NW ALBUQUERQUE, NM 87102
BENNETT, NOLAN	OFFICE PHONE: (505) 884-2215 OFFICE FAX: (505) 884-0214 CELL PHONE: (505) 301-6941 NBENNETT@AMAFCA.ORG	AMAFCA 2600 PROSPECT ALBUQUERQUE, NM 87107
HERNANDEZ, SAL	OFFICE PHONE: (505) 884-2215 OFFICE FAX: (505) 884-0214 CELL PHONE: (505) 366-8209 SHERNANDEZ@AMAFCA.ORG	AMAFCA 2600 PROSPECT ALBUQUERQUE, NM 87107
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MARTINEZ, ROBERT	OFFICE PHONE: (505) 217-0038 OFFICE FAX: (505) 217-0048 CELL PHONE: (505) 228-3329 ROBERT.MARTINEZ@WINDSTREAM.COM	WINDSTREAM 505 MARQUETTE NW SUITE 1600 ALBUQUERQUE, NM 87102
PAPPAS, DENNIS	OFFICE PHONE: (505) 245-6165 OFFICE FAX: (505) 889-6542 CELL PHONE: (970) 980-3730 DENNIS.PAPPAS@CENTURYLINK.COM	CENTURY LINK DIRECTOR-NETWORK OPS 4301 BOGAN NE ALBUQUERQUE, NM 87109
MELENDREZ, JOHN	OFFICE PHONE: (505) 245-6124 JOHN.MELENDREZ@CENTURYLINK.COM	CENTURY LINK 400 TIJERAS AVE NW ALBUQUERQUE, NM 87102
LOPEZ, ALICIA	OFFICE PHONE: (505) 247-0234 ext. 1356 ALICIA@MRGCD.US	M.R.G.C.D 1931 SECOND ST. SW ALBUQUERQUE, NM 87102

## LEGEND:

W	UTILITY, WATER VALVE	—○—○	FENCE, CHAINLINK
W	UTILITY, WATER MANHOLE	—x—x	FENCE, PIG WIRE
F	UTILITY, WATER FAUCET	—che—	UTILITY, OVERHEAD ELECTRIC LINE
P	UTILITY, POWER POLE	—uge—	UTILITY, UNDERGROUND ELECTRIC LINE
ST	DRAINAGE, MANHOLE	—ugt—	UTILITY, TELEPHONE LINE
CB	DRAINAGE, AREA INLET	—fo—	UTILITY, FIBER OPTIC LINE
SS	SANITARY, MANHOLE	—sas—	UTILITY, SANITARY SEWER LINE
M	SITE, MONITORING WELL	—w—w	UTILITY, WATER LINE
◎	SITE, BOLLARD	—wavy—	SITE, TREE LINE
IR	SITE, IRRIGATION VALVE	—dash—	SITE, MAJOR CONTOUR
●	BORE HOLE LOCATION	—dash—	SITE, MINOR CONTOUR

PROJECT NO:	1660060700
DESIGNED BY:	TJA
DRAWN BY:	JEM
CHECKED BY:	TJA
DATE:	JAN 2022
SHEET TITLE	
GENERAL NOTES	
SHEET NO:	G-002

BARR SPUR  
IMPROVEMENTS

60% SUBMITTAL  
NOT FOR CONSTRUCTION

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**& COMPANY**

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## BARR SPUR CL

NUMBER	LENGTH	DIRECTION	RADIUS	DELTA	START	END
C1	42.67'	N67° 15' 03.00"E	50.00'	48°53'29"	N: 1450891.77, E: 1513660.28	N: 1450907.77, E: 1513698.44
C2	114.86'	S88° 57' 41.80"E	5000.00'	1°18'58"	N: 1450895.15, E: 1514124.35	N: 1450893.07, E: 1514239.19
C3	58.09'	N89° 32' 53.82"E	2000.00'	1°39'50"	N: 1450883.43, E: 1515692.07	N: 1450883.89, E: 1515750.15
C4	83.51'	N48° 50' 32.47"E	60.00'	79°44'52"	N: 1450893.07, E: 1516160.02	N: 1450943.70, E: 1516217.94
L1	245.69'	N42° 48' 18.67"E			N: 1450711.51, E: 1513493.33	N: 1450891.77, E: 1513660.28
L2	426.10'	S88° 18' 12.66"E			N: 1450907.77, E: 1513698.44	N: 1450895.15, E: 1514124.35
L3	1452.91'	S89° 37' 10.94"E			N: 1450893.07, E: 1514239.19	N: 1450883.43, E: 1515692.07
L4	409.97'	N88° 42' 58.58"E			N: 1450883.89, E: 1515750.15	N: 1450893.07, E: 1516160.02
L5	58.82'	N8° 58' 06.36"E			N: 1450943.70, E: 1516217.94	N: 1451001.81, E: 1516227.11


BARR INTERIOR DRAIN CL


NUMBER	LENGTH	DIRECTION	RADIUS	DELTA	START	END
L6	137.78'	N13° 02' 53.76"W			N: 1450836.47, E: 1513617.27	N: 1450970.69, E: 1513586.16
L5	162.22'	N18° 57' 36.60"W			N: 1450683.05, E: 1513669.97	N: 1450836.47, E: 1513617.27


PROJECT NO:	1660060700
DESIGNED BY:	TJA
DRAWN BY:	JEM
CHECKED BY:	TJA
DATE:	JAN 2022
SHEET TITLE	

## HORIZONTAL & VERTICAL DATUM CONTROL

SHEET NO: **C-101**

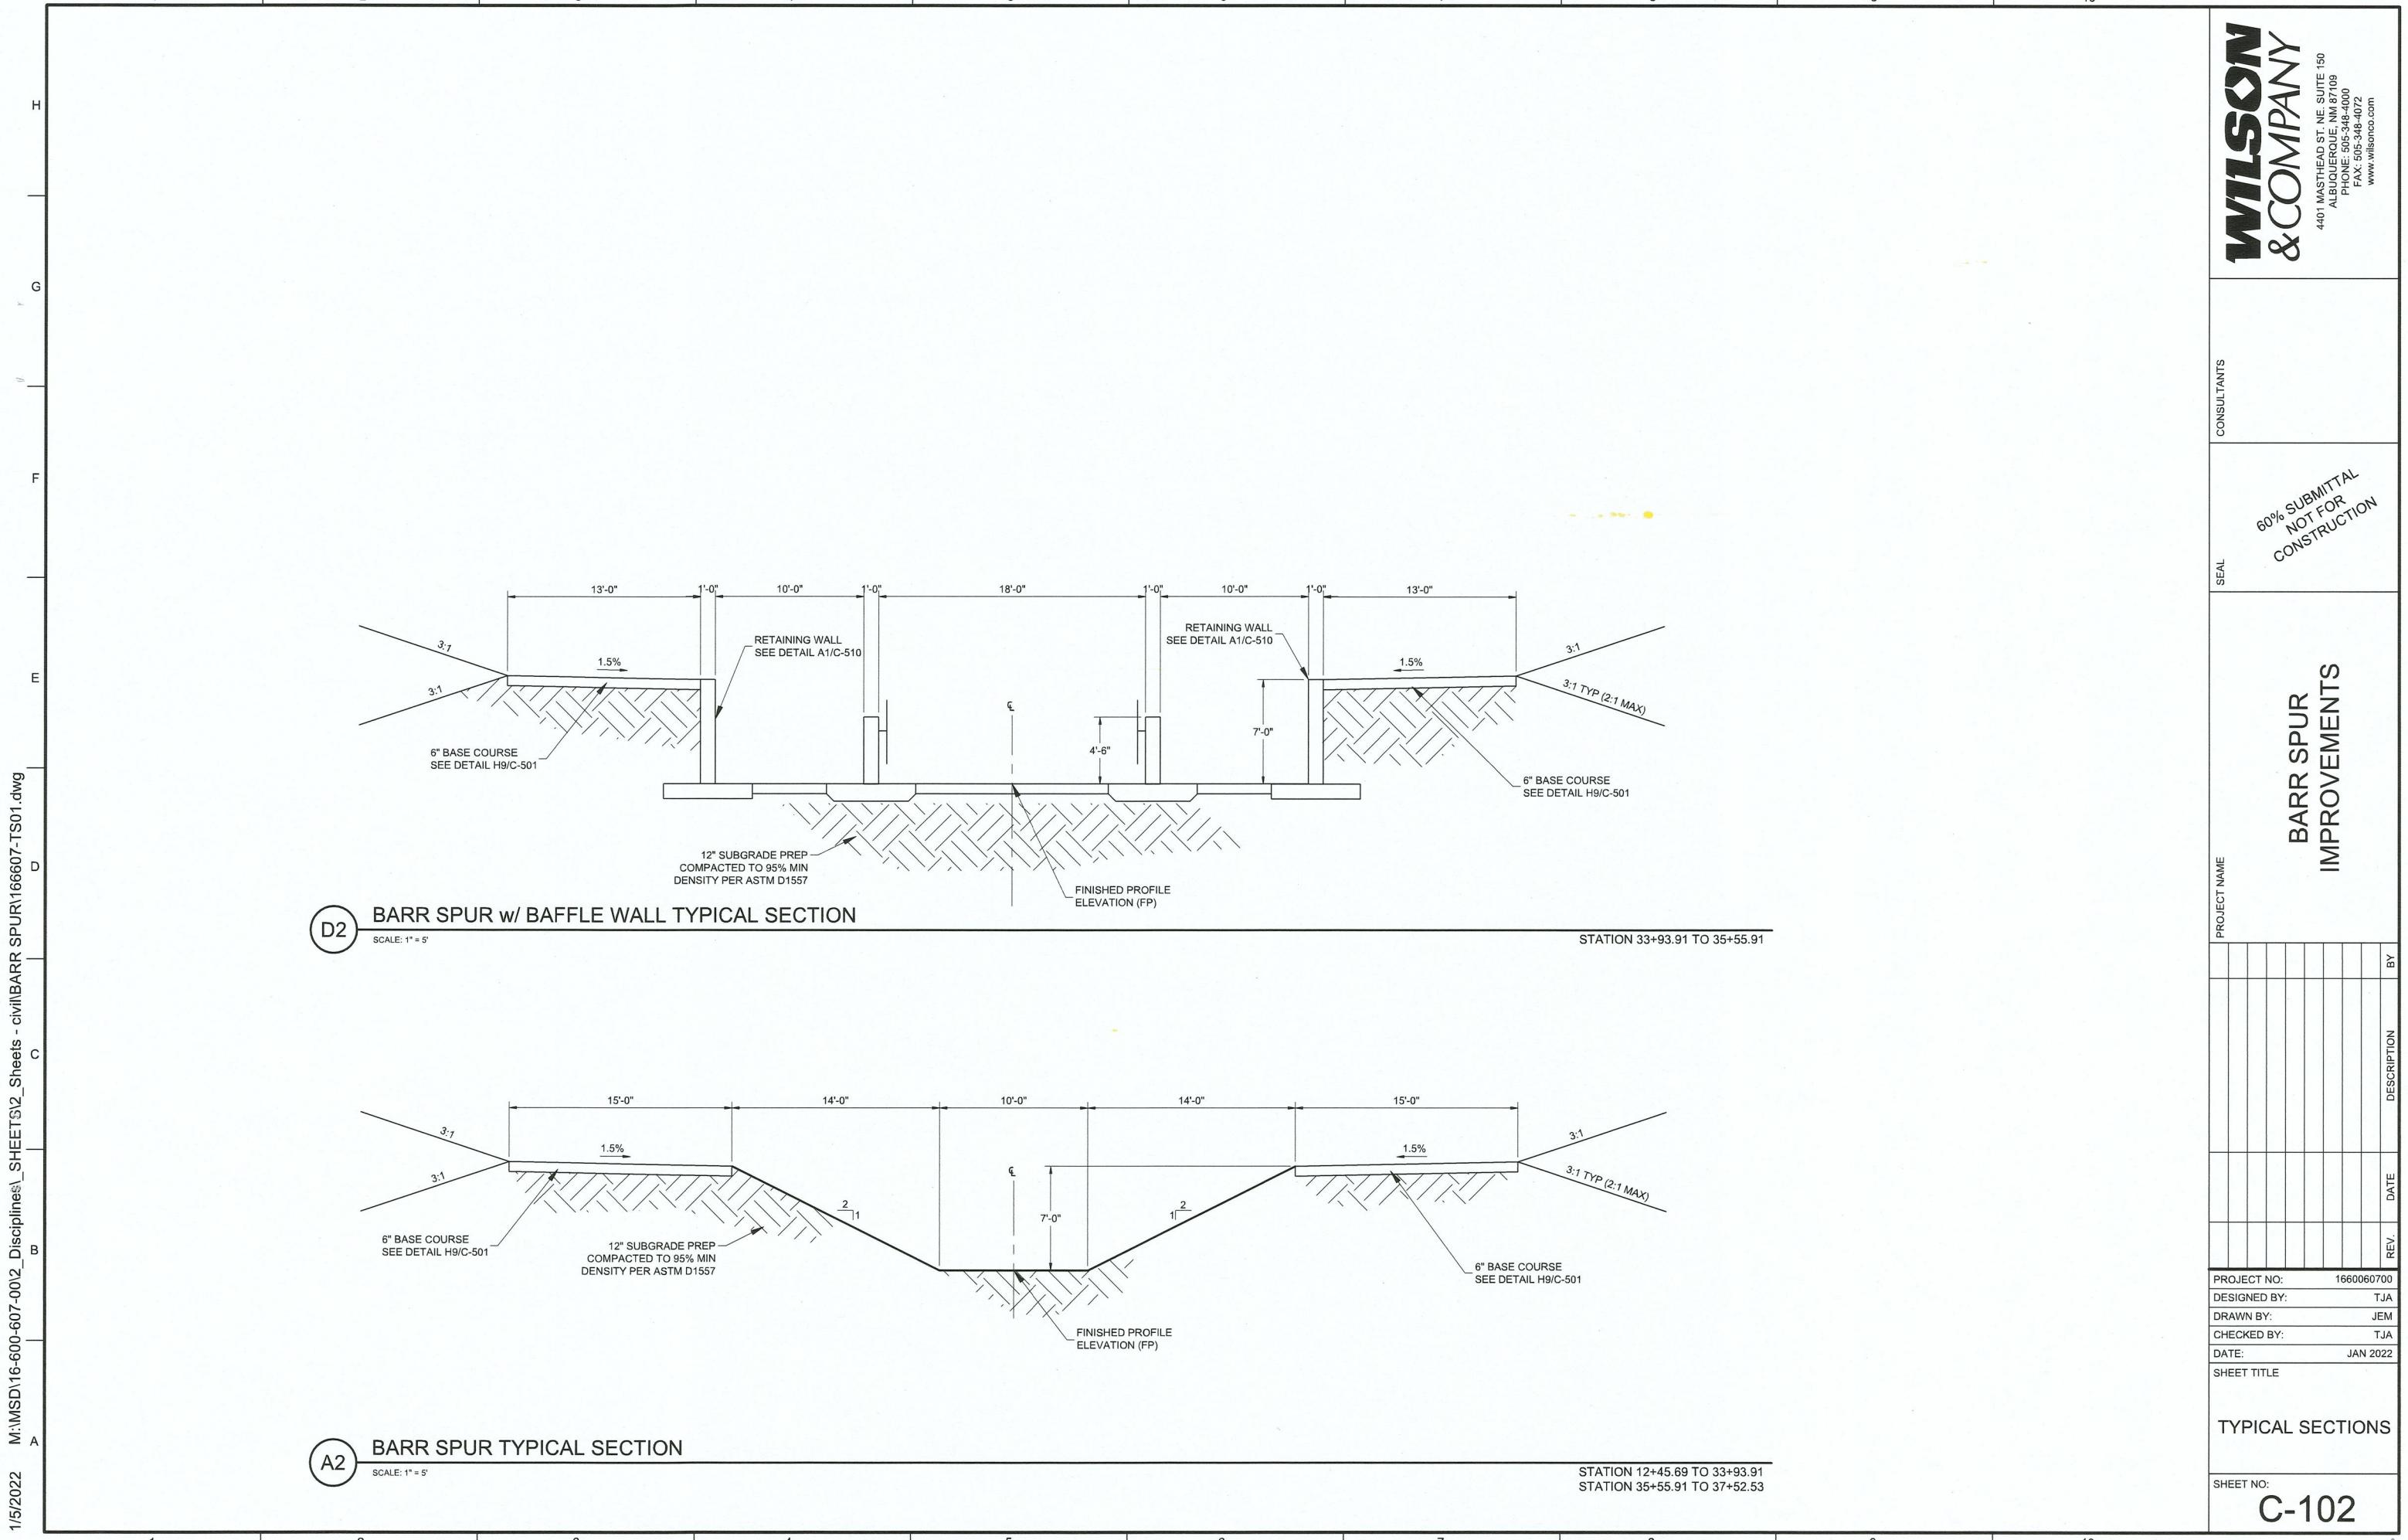

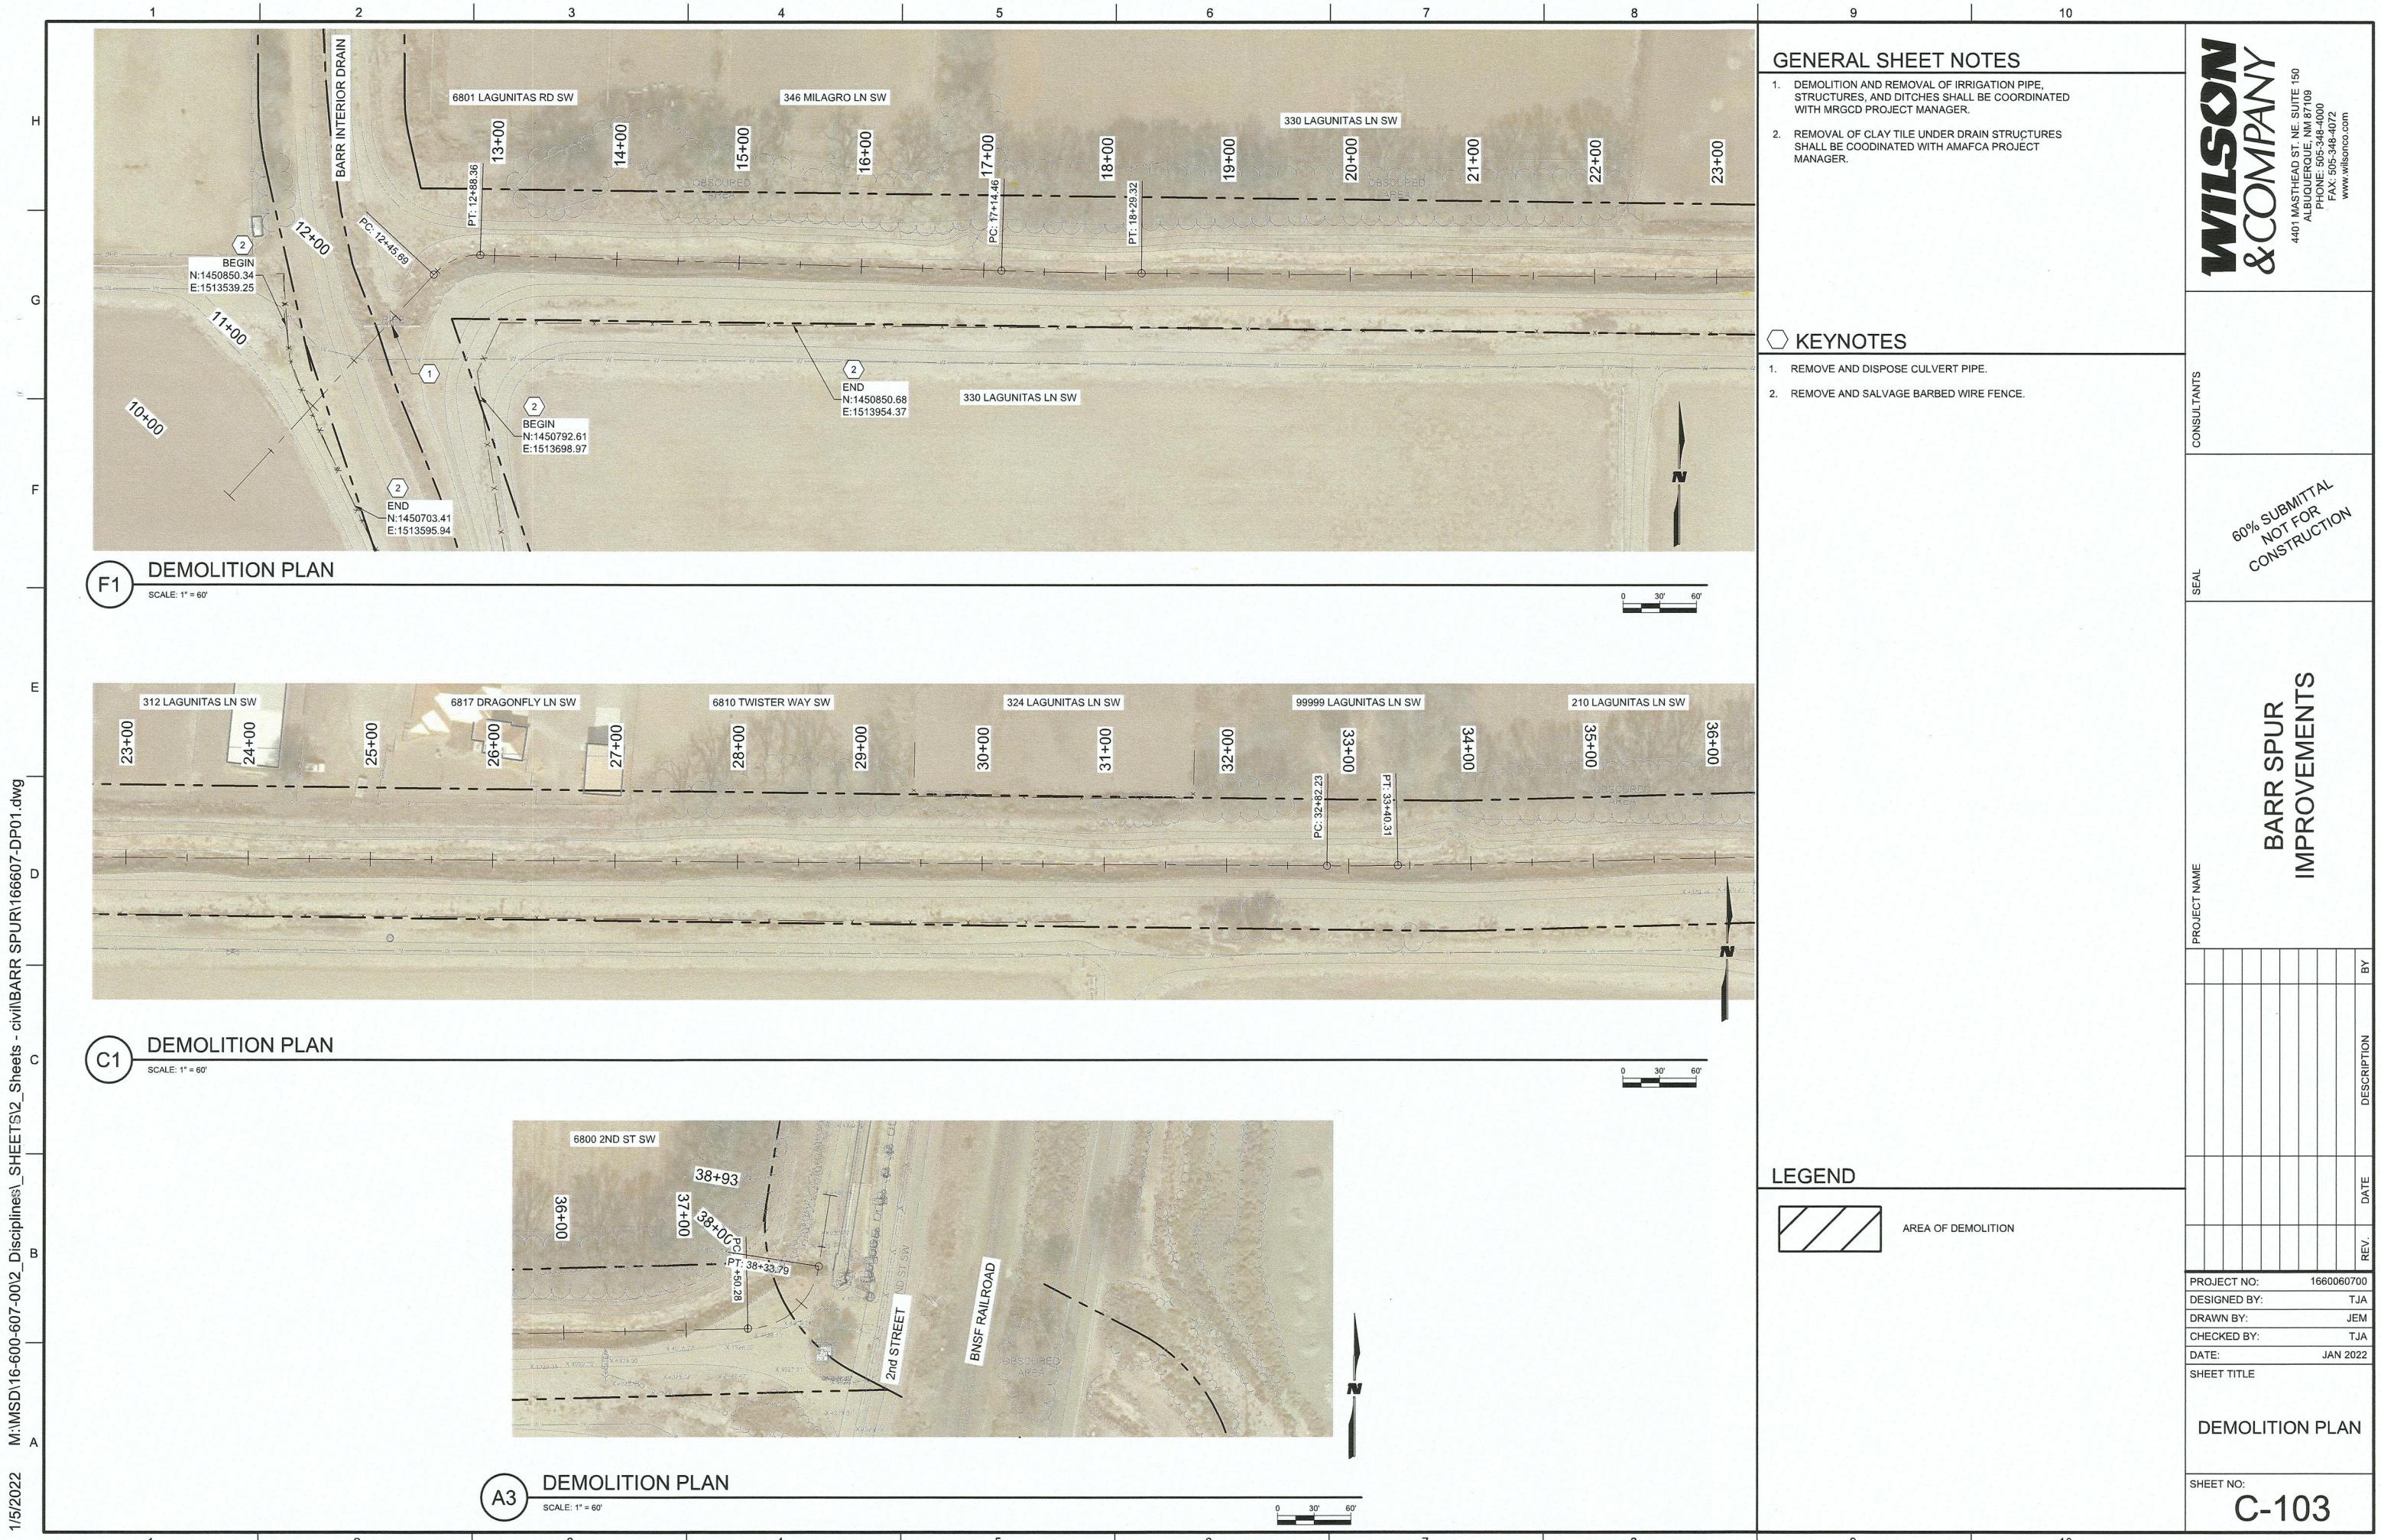

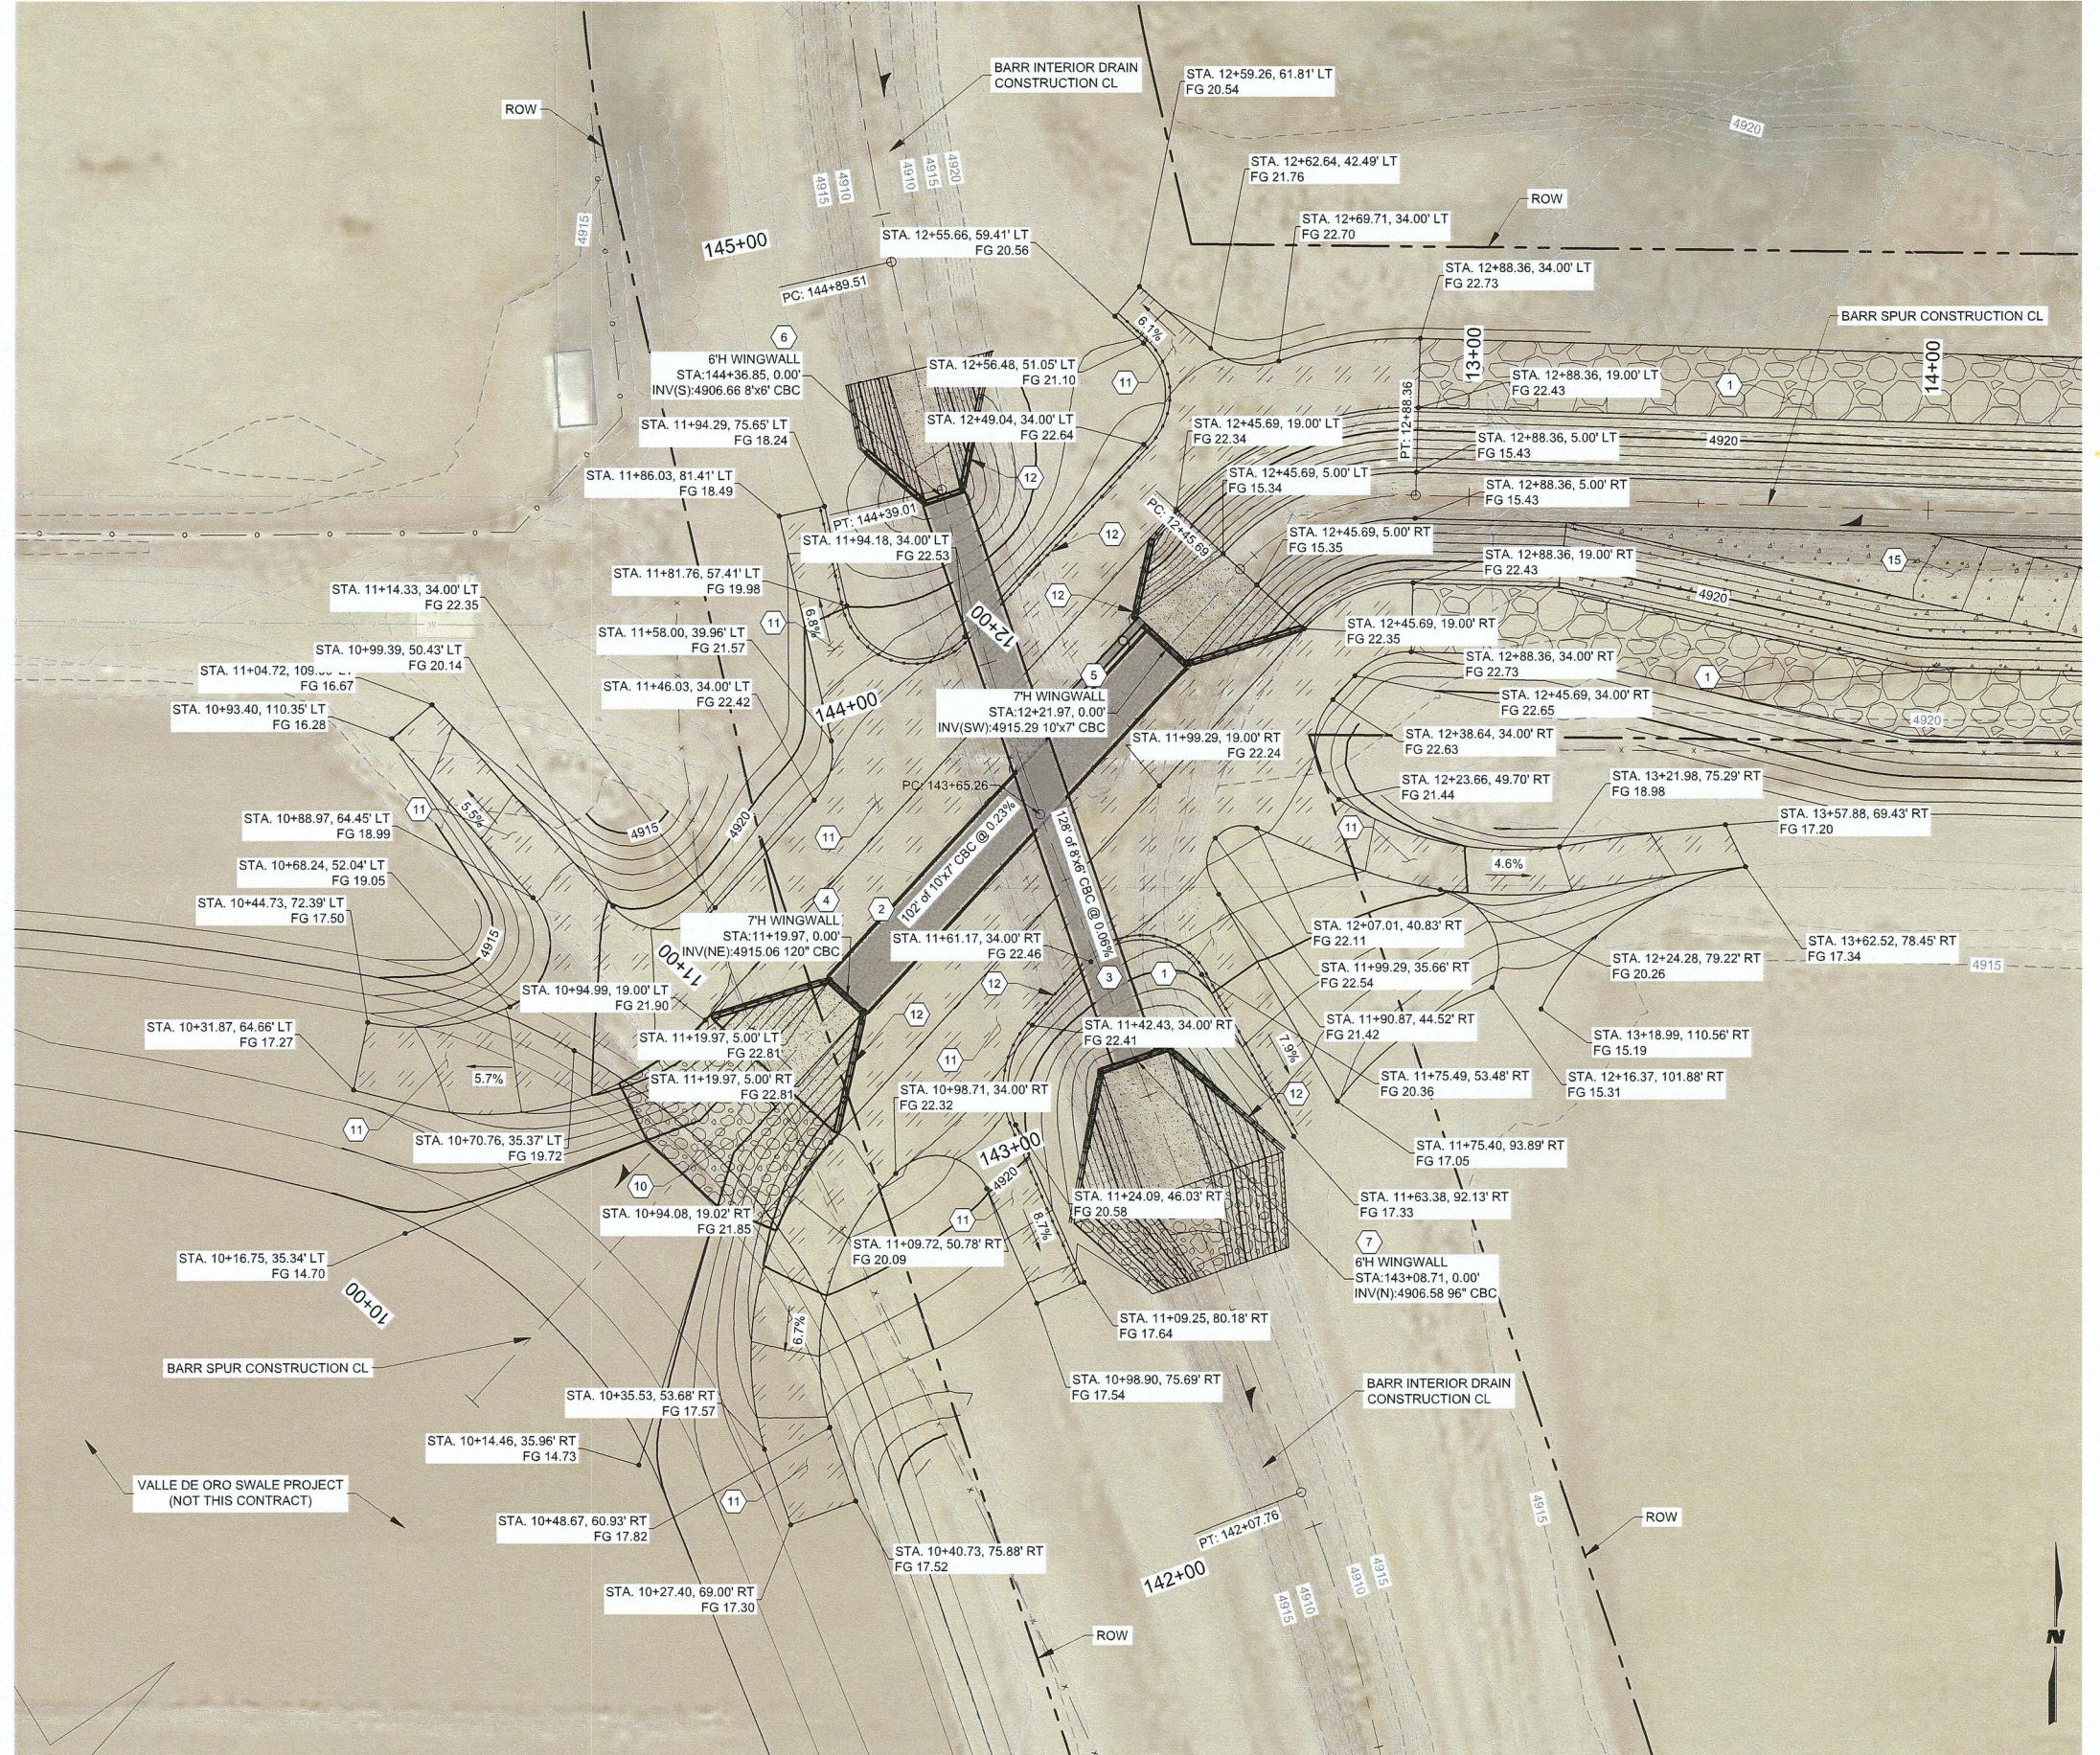

A1 GRADING &amp; DRAINAGE PLAN @ BOP

SCALE: 1" = 20'

0 10' 20'

## GENERAL SHEET NOTES

- SEE SHEET C-106 FOR ADDITIONAL GRADING AT BARR SPUR CBC CROSSING.
- SEE SHEET C-107 FOR ADDITIONAL GRADING AT BARR INTERIOR DRAIN CBC CROSSING.

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## BARR SPUR IMPROVEMENTS

60% SUBMITTAL  
NOT FOR  
CONSTRUCTION

CONSULTANTS

SEAL

PROJECT NAME

BY

DESCRIPTION

DATE

REV.

DATE

REV.


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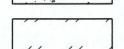
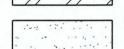
BASE COURSE MAINTENANCE ROAD



18" THICK RIPRAP



REINFORCED CONCRETE

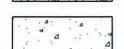
6" NATIVE MATERIAL  
w/ RECYCLED BASE COURSE

SHOTCRETE



FLOW ARROW

 PROJECT NO: 1660060700  
 DESIGNED BY: TJA  
 DRAWN BY: JEM  
 CHECKED BY: TJA  
 DATE: JAN 2022  
 SHEET TITLE: GRADING & DRAINAGE PLAN @ BOP  
 SHEET NO: C-104

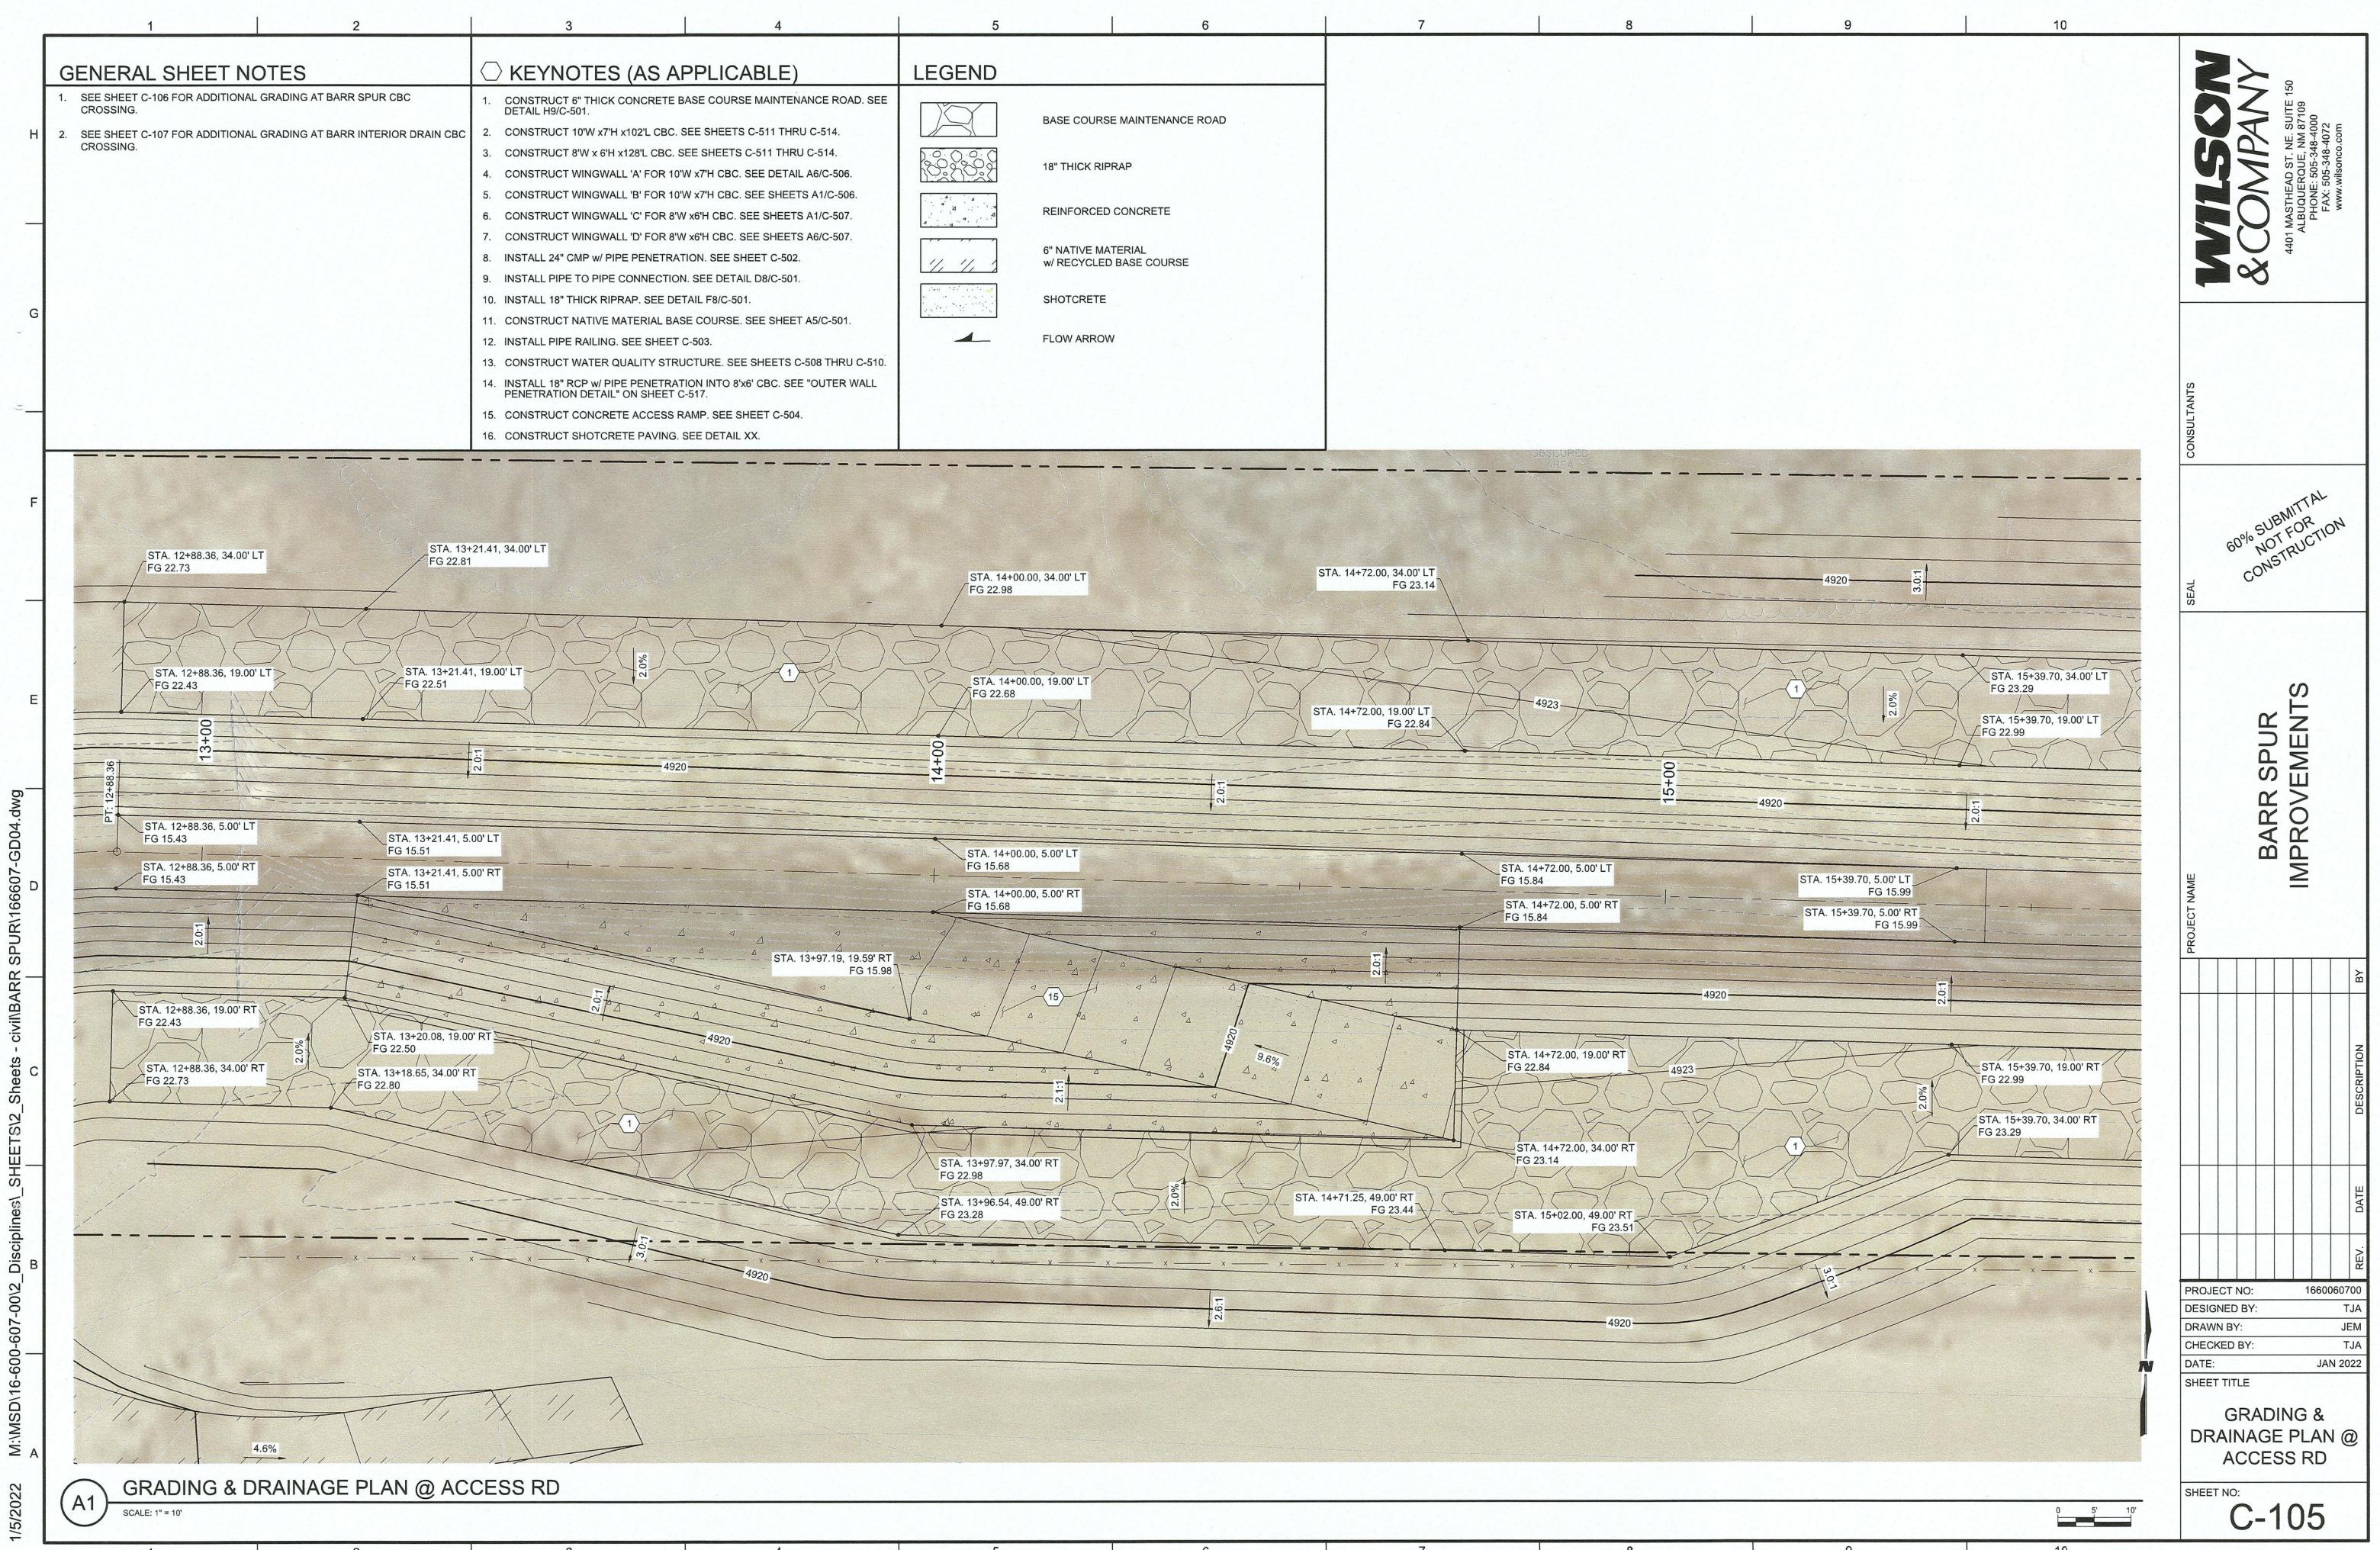



F1 GRADING & DRAINAGE PLAN @ BARR SPUR CROSSING  
SCALE: 1" = 10'

0 10' 20'

## GENERAL SHEET NOTES

- GENERAL SHEET NOTES.

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BARR SPUR  
IMPROVEMENTS

PROJECT NAME  
BY

DESCRIPTION  
DATE


REV.


PROJECT NO: 166060700  
DESIGNED BY: TJA  
DRAWN BY: JEM  
CHECKED BY: TJA  
DATE: JAN 2022


SHEET TITLE  
GRADING &  
DRAINAGE PLAN @  
BARR SPUR  
CROSSING

SHEET NO:  
C-106

## LEGEND

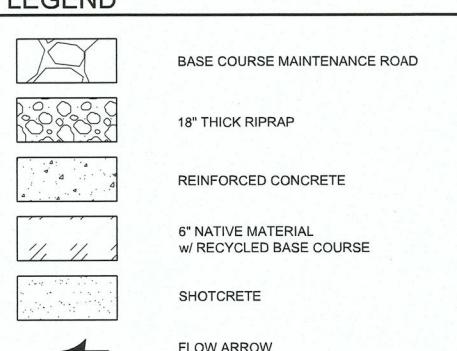

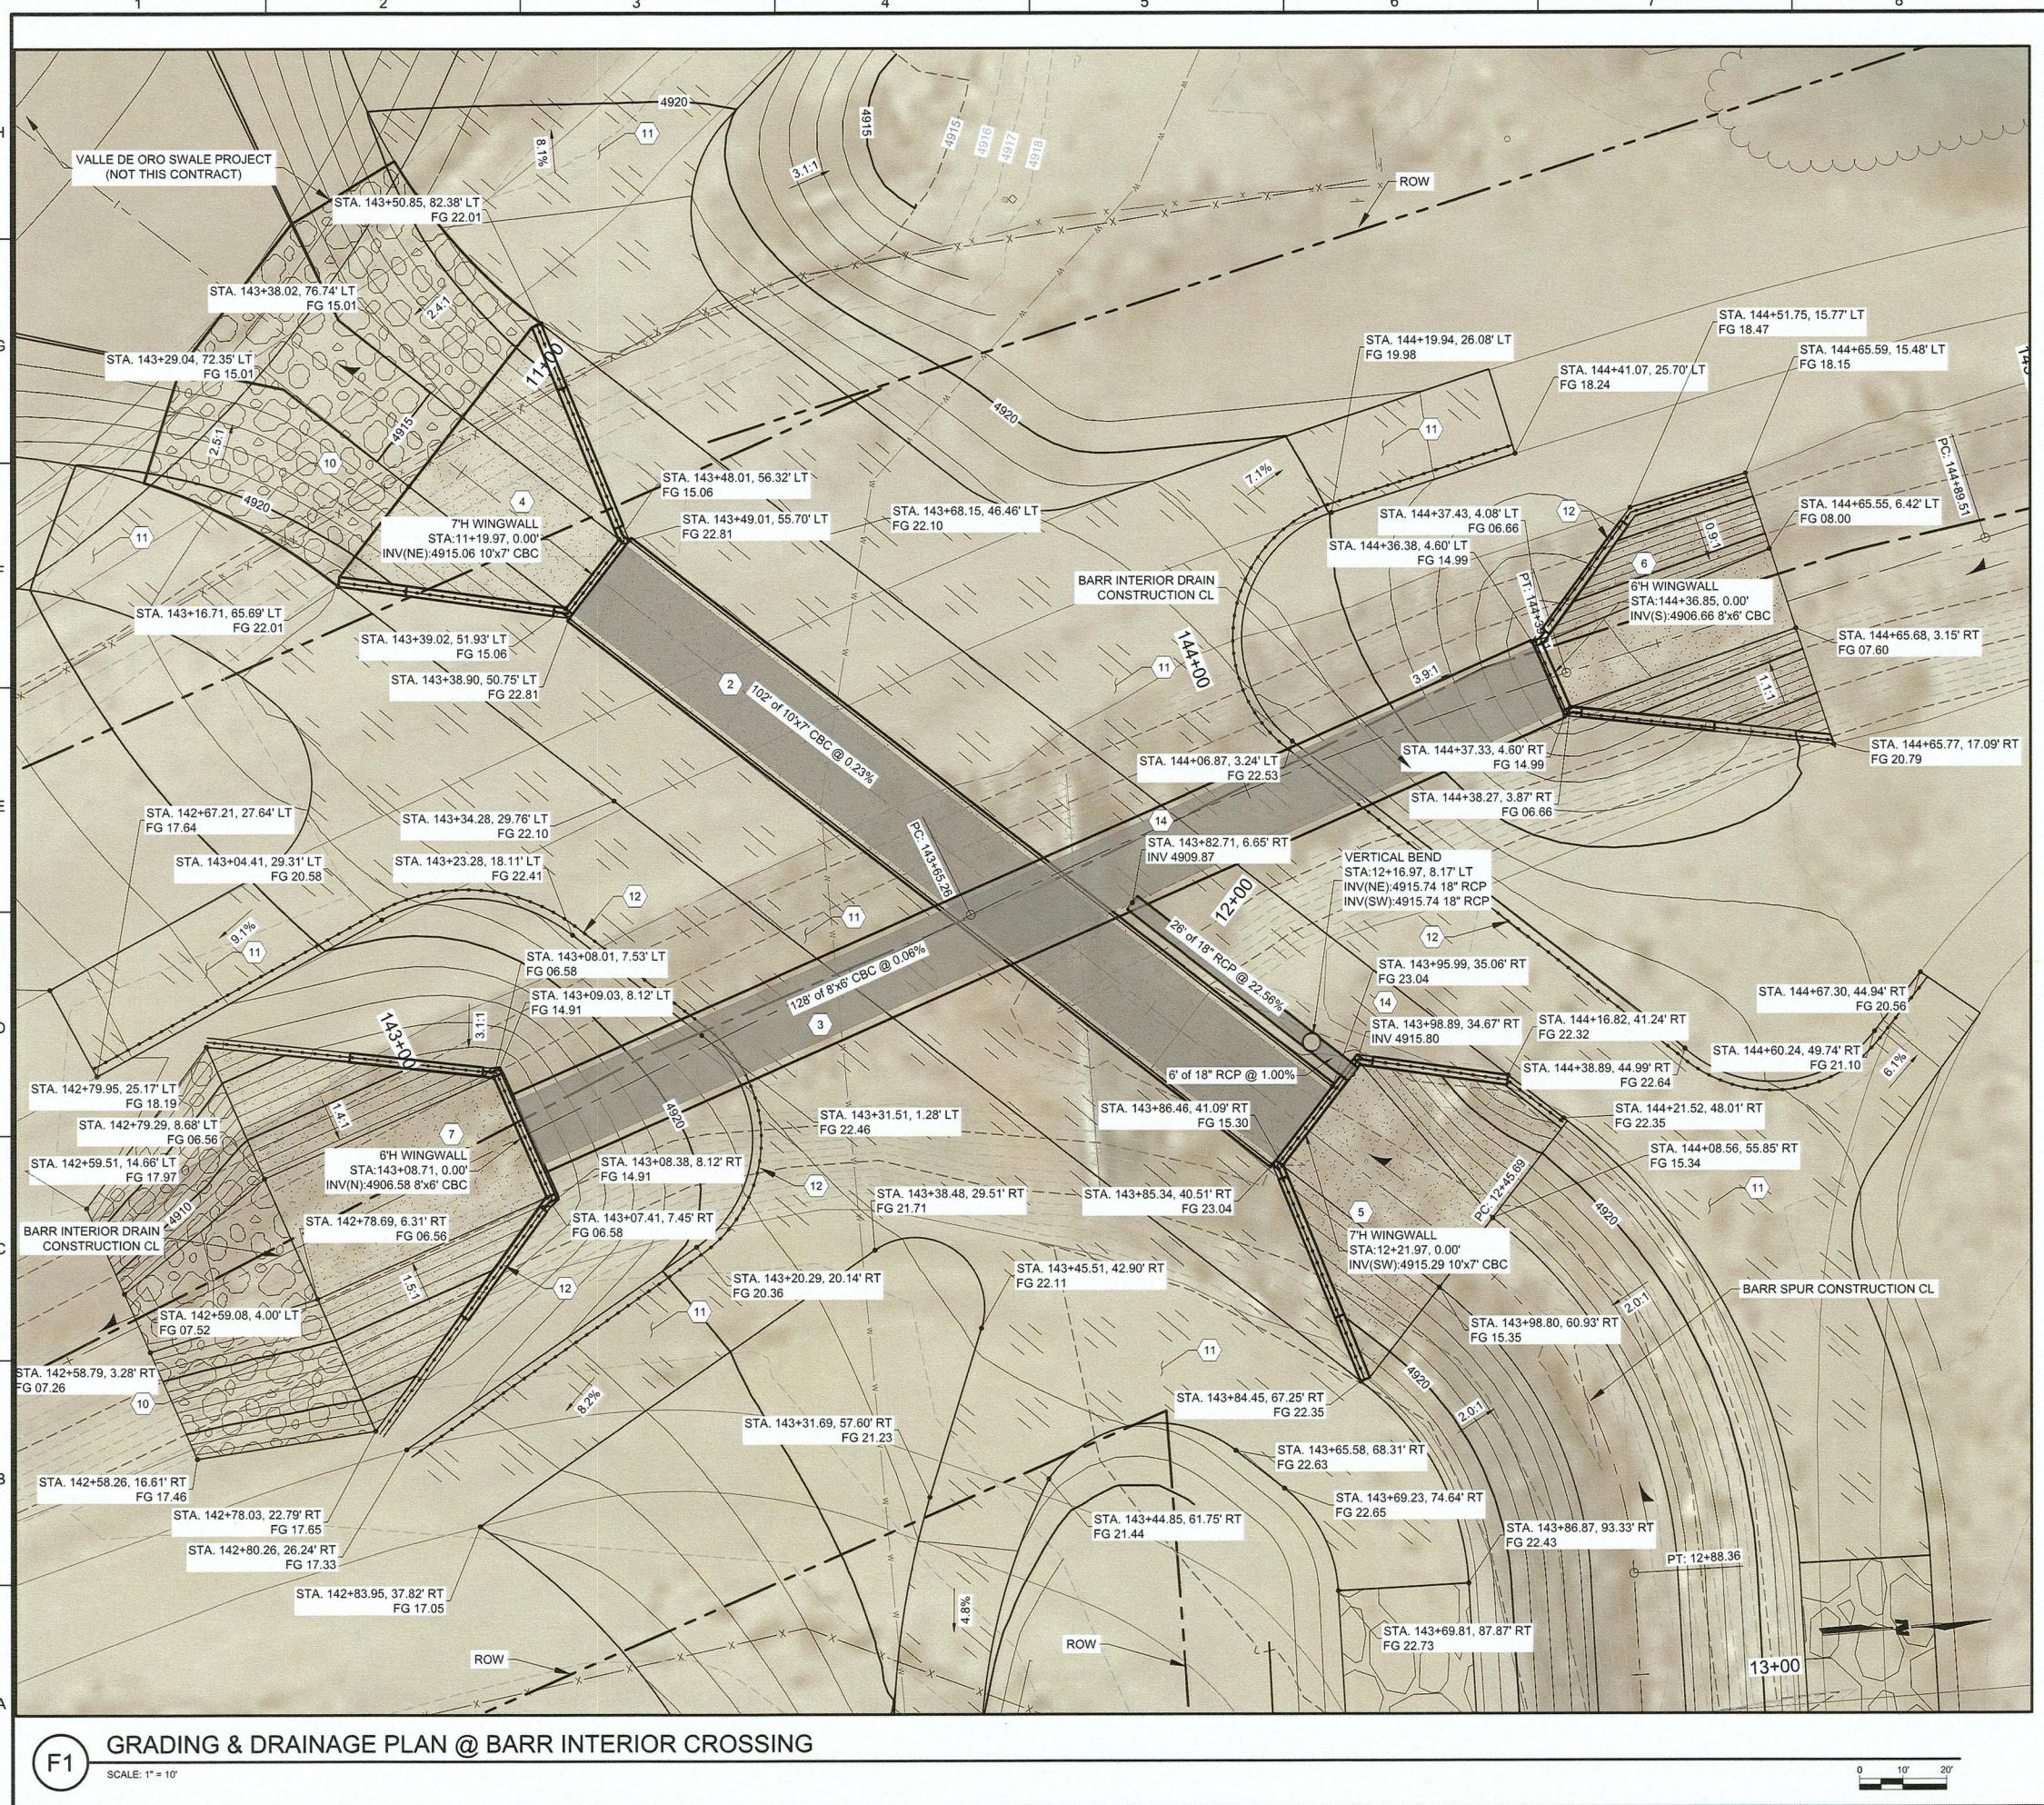

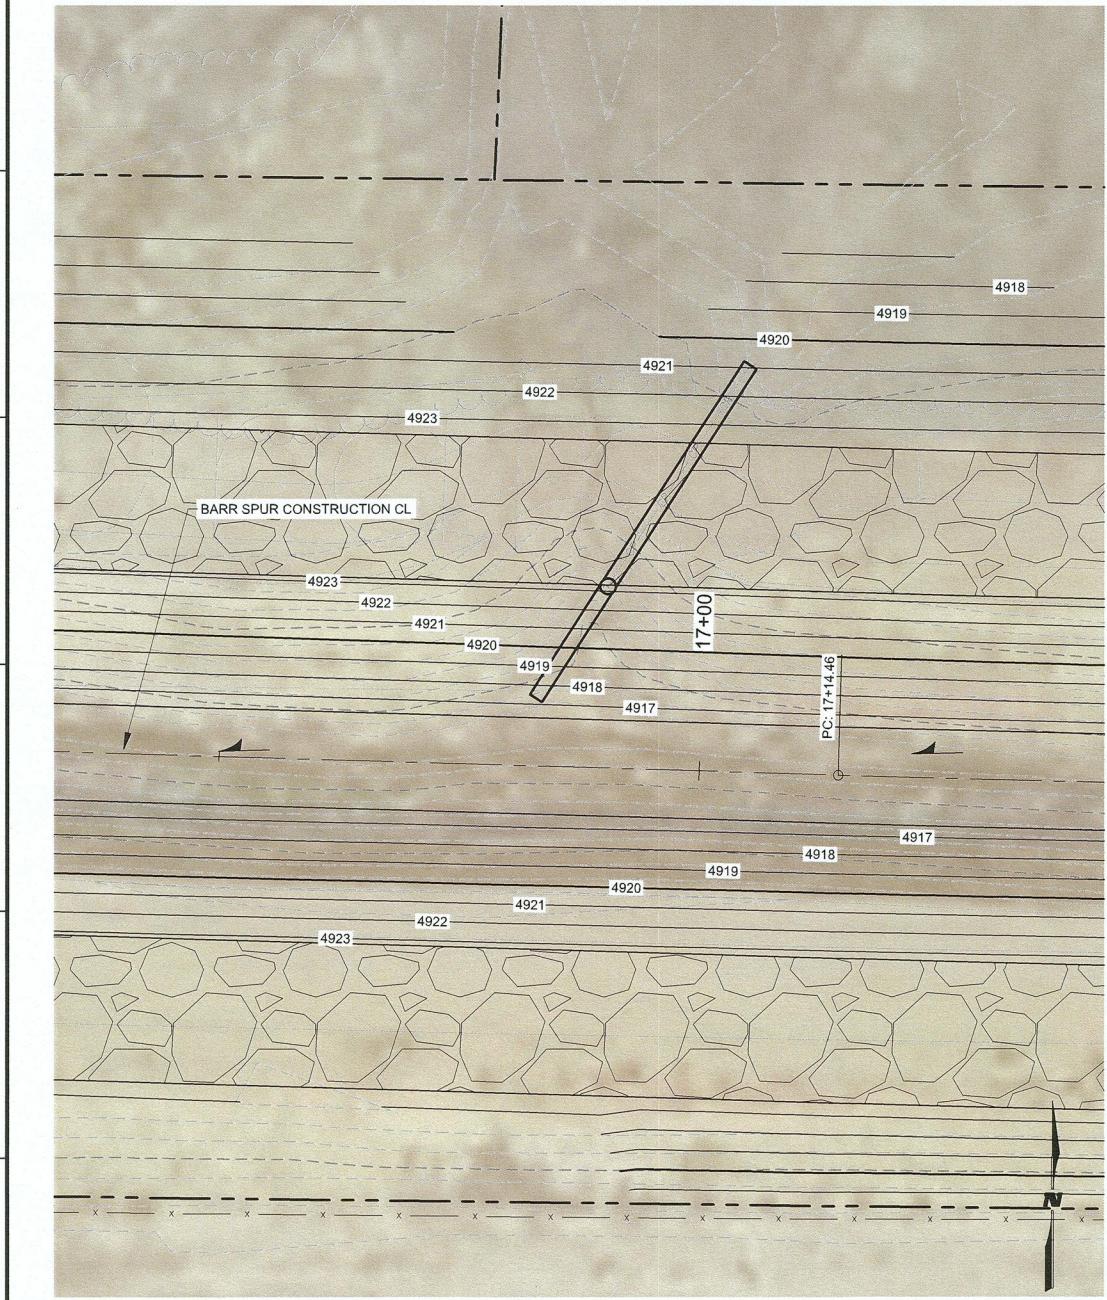

GRADING &amp; DRAINAGE PLAN @ CULVERT

A1

SCALE: 1" = 10'

0 5' 10'

## GENERAL SHEET NOTES

- SEE SHEET C-106 FOR ADDITIONAL GRADING AT BARR SPUR CBC CROSSING.
- SEE SHEET C-107 FOR ADDITIONAL GRADING AT BARR INTERIOR DRAIN CBC CROSSING.

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## KEYNOTES (AS APPLICABLE)

- CONSTRUCT 6" THICK CONCRETE BASE COURSE MAINTENANCE ROAD. SEE DETAIL H9/C-501.
- CONSTRUCT 10'W x 7'H x 102'L CBC. SEE SHEETS C-511 THRU C-514.
- CONSTRUCT 8'W x 6H x 128'L CBC. SEE SHEETS C-511 THRU C-514.
- CONSTRUCT WINGWALL 'A' FOR 10'W x 7'H CBC. SEE DETAIL A6/C-506.
- CONSTRUCT WINGWALL 'B' FOR 10'W x 7'H CBC. SEE SHEETS A1/C-506.
- CONSTRUCT WINGWALL 'C' FOR 8'W x 6'H CBC. SEE SHEETS A1/C-507.
- CONSTRUCT WINGWALL 'D' FOR 8'W x 6'H CBC. SEE SHEETS A6/C-507.
- INSTALL 24" CMP w/ PIPE PENETRATION. SEE SHEET C-502.
- INSTALL PIPE TO PIPE CONNECTION. SEE DETAIL D8/C-501.
- INSTALL 18" THICK RIPRAP. SEE DETAIL F8/C-501.
- CONSTRUCT NATIVE MATERIAL BASE COURSE. SEE SHEET A5/C-501.
- INSTALL PIPE RAILING. SEE SHEET C-503.
- CONSTRUCT WATER QUALITY STRUCTURE. SEE SHEETS C-508 THRU C-510.
- INSTALL 18" RCP w/ PIPE PENETRATION INTO 8'x6' CBC. SEE "OUTER WALL PENETRATION DETAIL" ON SHEET C-517.
- CONSTRUCT CONCRETE ACCESS RAMP. SEE SHEET C-504.
- CONSTRUCT SHOTCRETE PAVING. SEE DETAIL XX.

60% SUBMITTAL  
NOT FOR  
CONSTRUCTIONBARR SPUR  
IMPROVEMENTS

PROJECT NAME

BY

## LEGEND

	BASE COURSE MAINTENANCE ROAD
	18" THICK RIPRAP
	REINFORCED CONCRETE
	6" NATIVE MATERIAL w/ RECYCLED BASE COURSE
	SHOTCRETE
	FLOW ARROW

GRADING &  
DRAINAGE PLAN @  
CULVERTS

SHEET NO:


C-108

## GENERAL SHEET NOTES

## KEYNOTES (AS APPLICABLE)

## LEGEND

1. SEE SHEET C-106 FOR ADDITIONAL GRADING AT BARR SPUR CBC CROSSING.  
 2. SEE SHEET C-107 FOR ADDITIONAL GRADING AT BARR INTERIOR DRAIN CBC CROSSING.
1. CONSTRUCT 6" THICK CONCRETE BASE COURSE MAINTENANCE ROAD. SEE DETAIL H9/C-501.  
 2. CONSTRUCT 10W x7H x102L CBC. SEE SHEETS C-511 THRU C-514.  
 3. CONSTRUCT 8'W x 6'H x128L CBC. SEE SHEETS C-511 THRU C-514.  
 4. CONSTRUCT WINGWALL 'A' FOR 10W x7H CBC. SEE DETAIL A6/C-506.  
 5. CONSTRUCT WINGWALL 'B' FOR 10W x7H CBC. SEE SHEETS A1/C-506.  
 6. CONSTRUCT WINGWALL 'C' FOR 8'W x6'H CBC. SEE SHEETS A1/C-507.  
 7. CONSTRUCT WINGWALL 'D' FOR 8'W x6'H CBC. SEE SHEETS A6/C-507.  
 8. INSTALL 24" CMP w/ PIPE PENETRATION. SEE SHEET C-502.  
 9. INSTALL PIPE TO PIPE CONNECTION. SEE DETAIL D8/C-501.  
 10. INSTALL 18" THICK RIPRAP. SEE DETAIL F8/C-501.  
 11. CONSTRUCT NATIVE MATERIAL BASE COURSE. SEE SHEET A5/C-501.  
 12. INSTALL PIPE RAILING. SEE SHEET C-503.  
 13. CONSTRUCT WATER QUALITY STRUCTURE. SEE SHEETS C-508 THRU C-510.  
 14. INSTALL 18" RCP w/ PIPE PENETRATION INTO 8'x6' CBC. SEE "OUTER WALL PENETRATION DETAIL" ON SHEET C-517.  
 15. CONSTRUCT CONCRETE ACCESS RAMP. SEE SHEET C-504.  
 16. CONSTRUCT SHOTCRETE PAVING. SEE DETAIL XX.

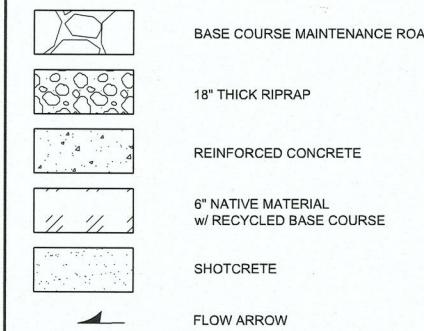

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CONSULTANTS

60% SUBMITTAL  
NOT FOR  
CONSTRUCTIONBARR SPUR  
IMPROVEMENTS

PROJECT NAME

REV. DATE DESCRIPTION BY

PROJECT NO: 1660060700

DESIGNED BY: TJA

DRAWN BY: JEM

CHECKED BY: TJA


DATE: JAN 2022

SHEET TITLE

GRADING &  
DRAINAGE PLAN @  
WATER QUALITY  
STRUCTURE

SHEET NO:

C-109

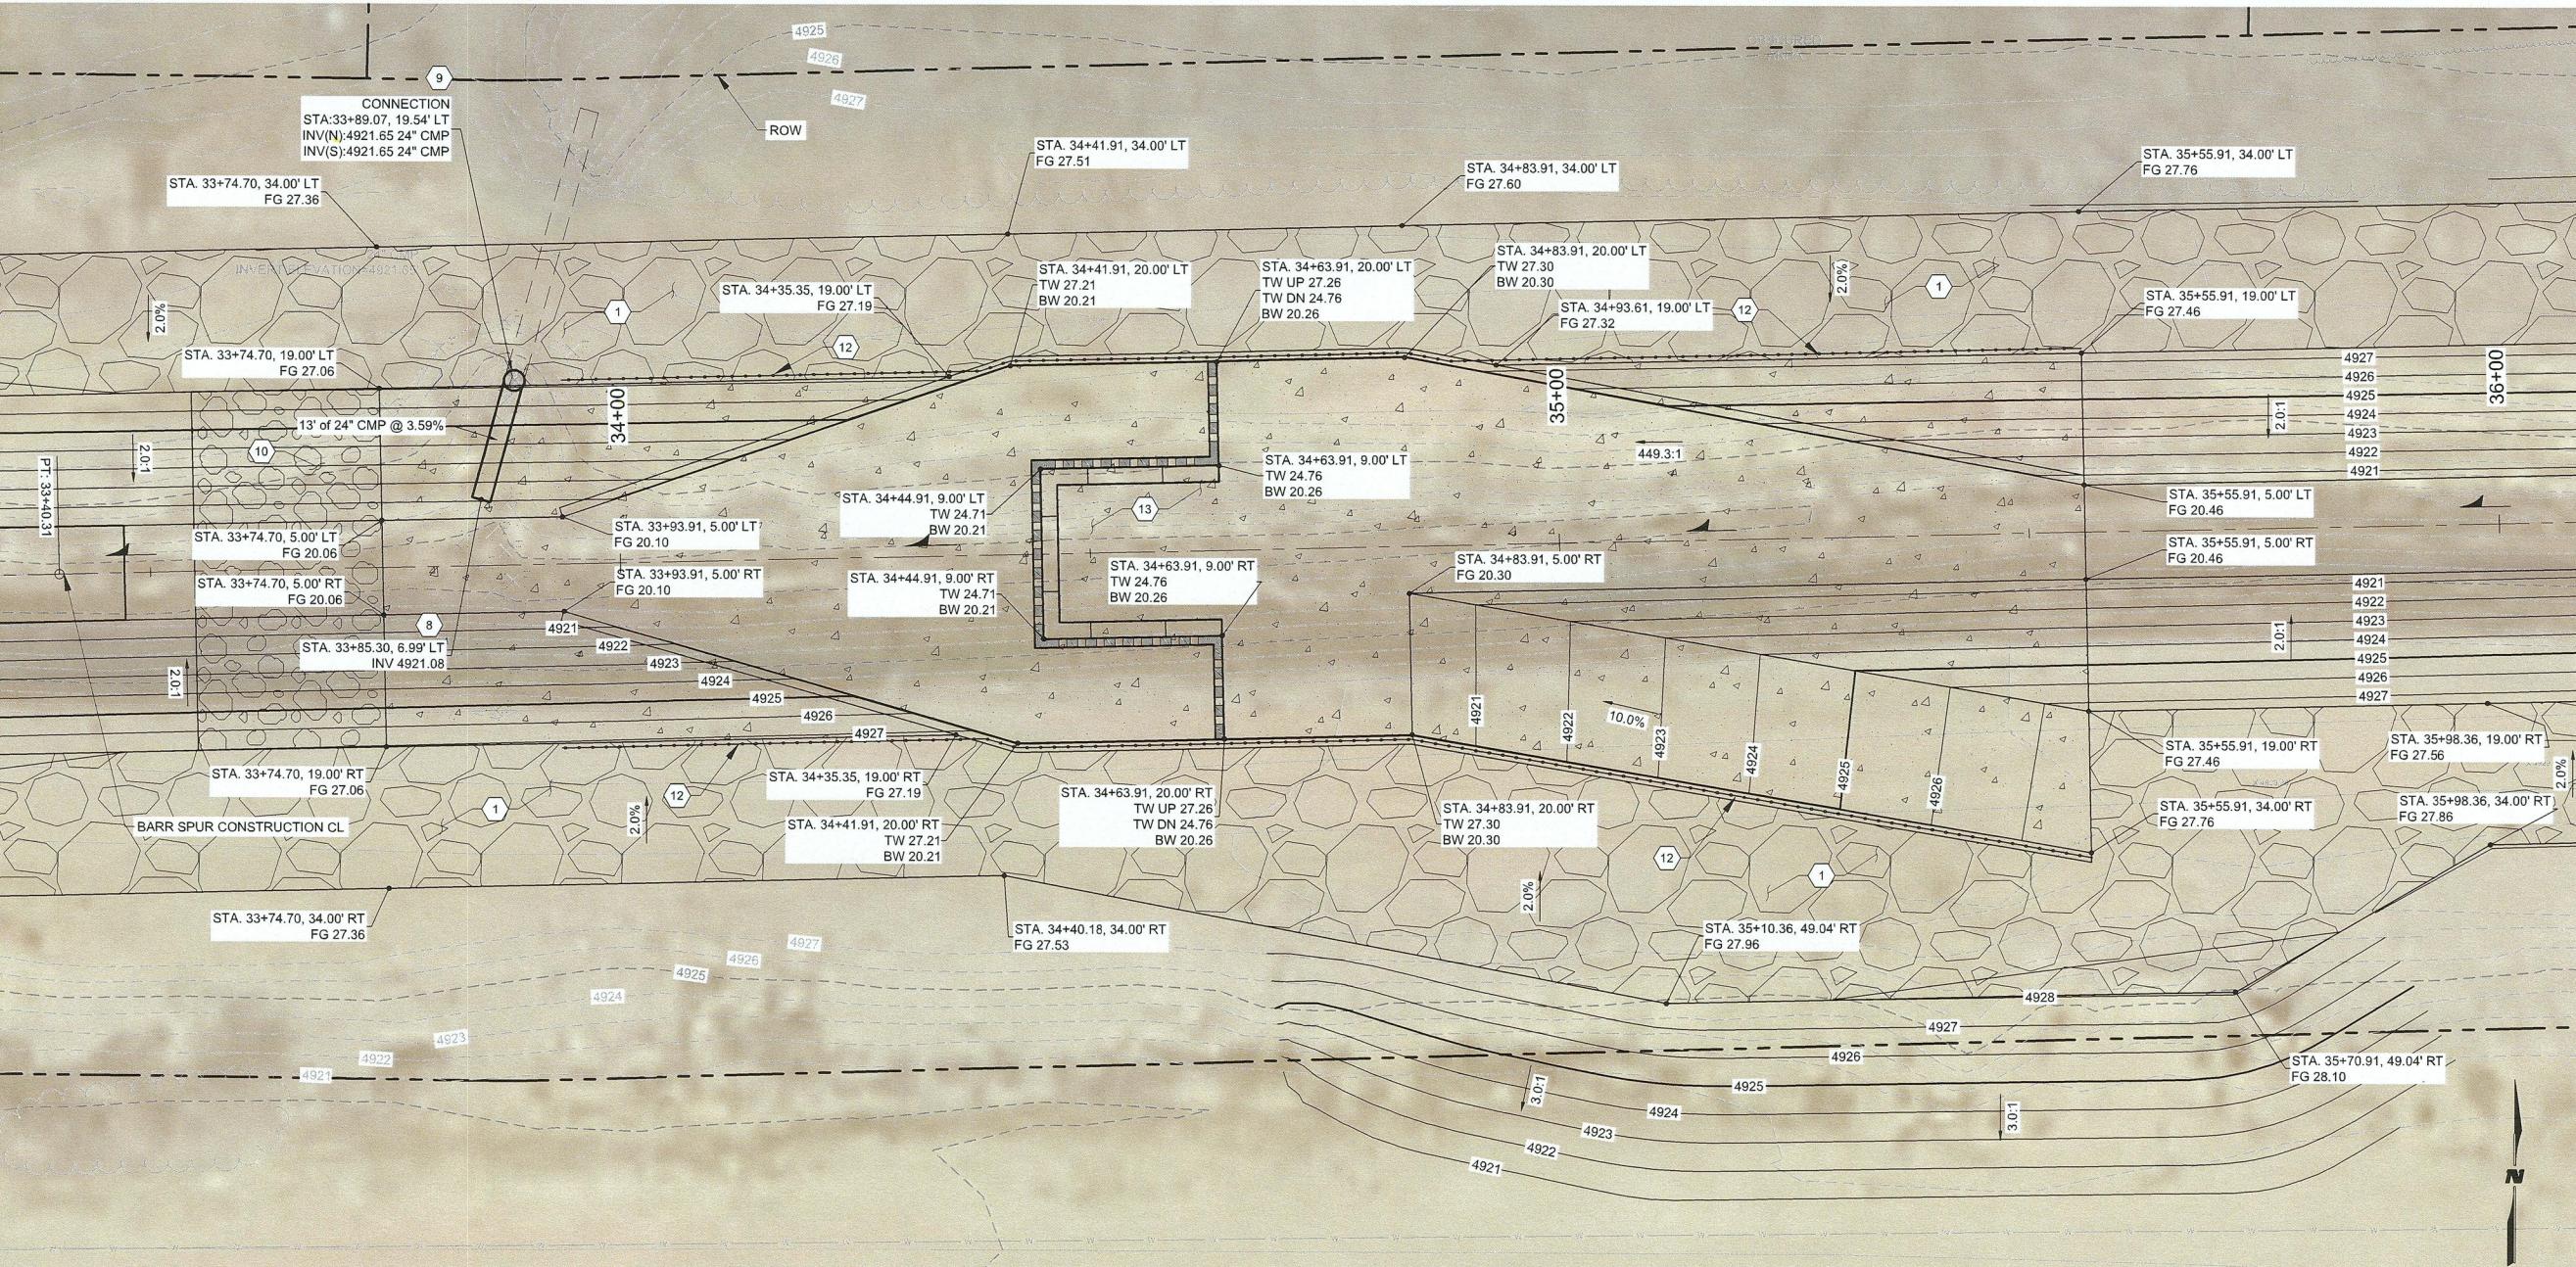

0  
5'  
10'

1

2

3

4

5


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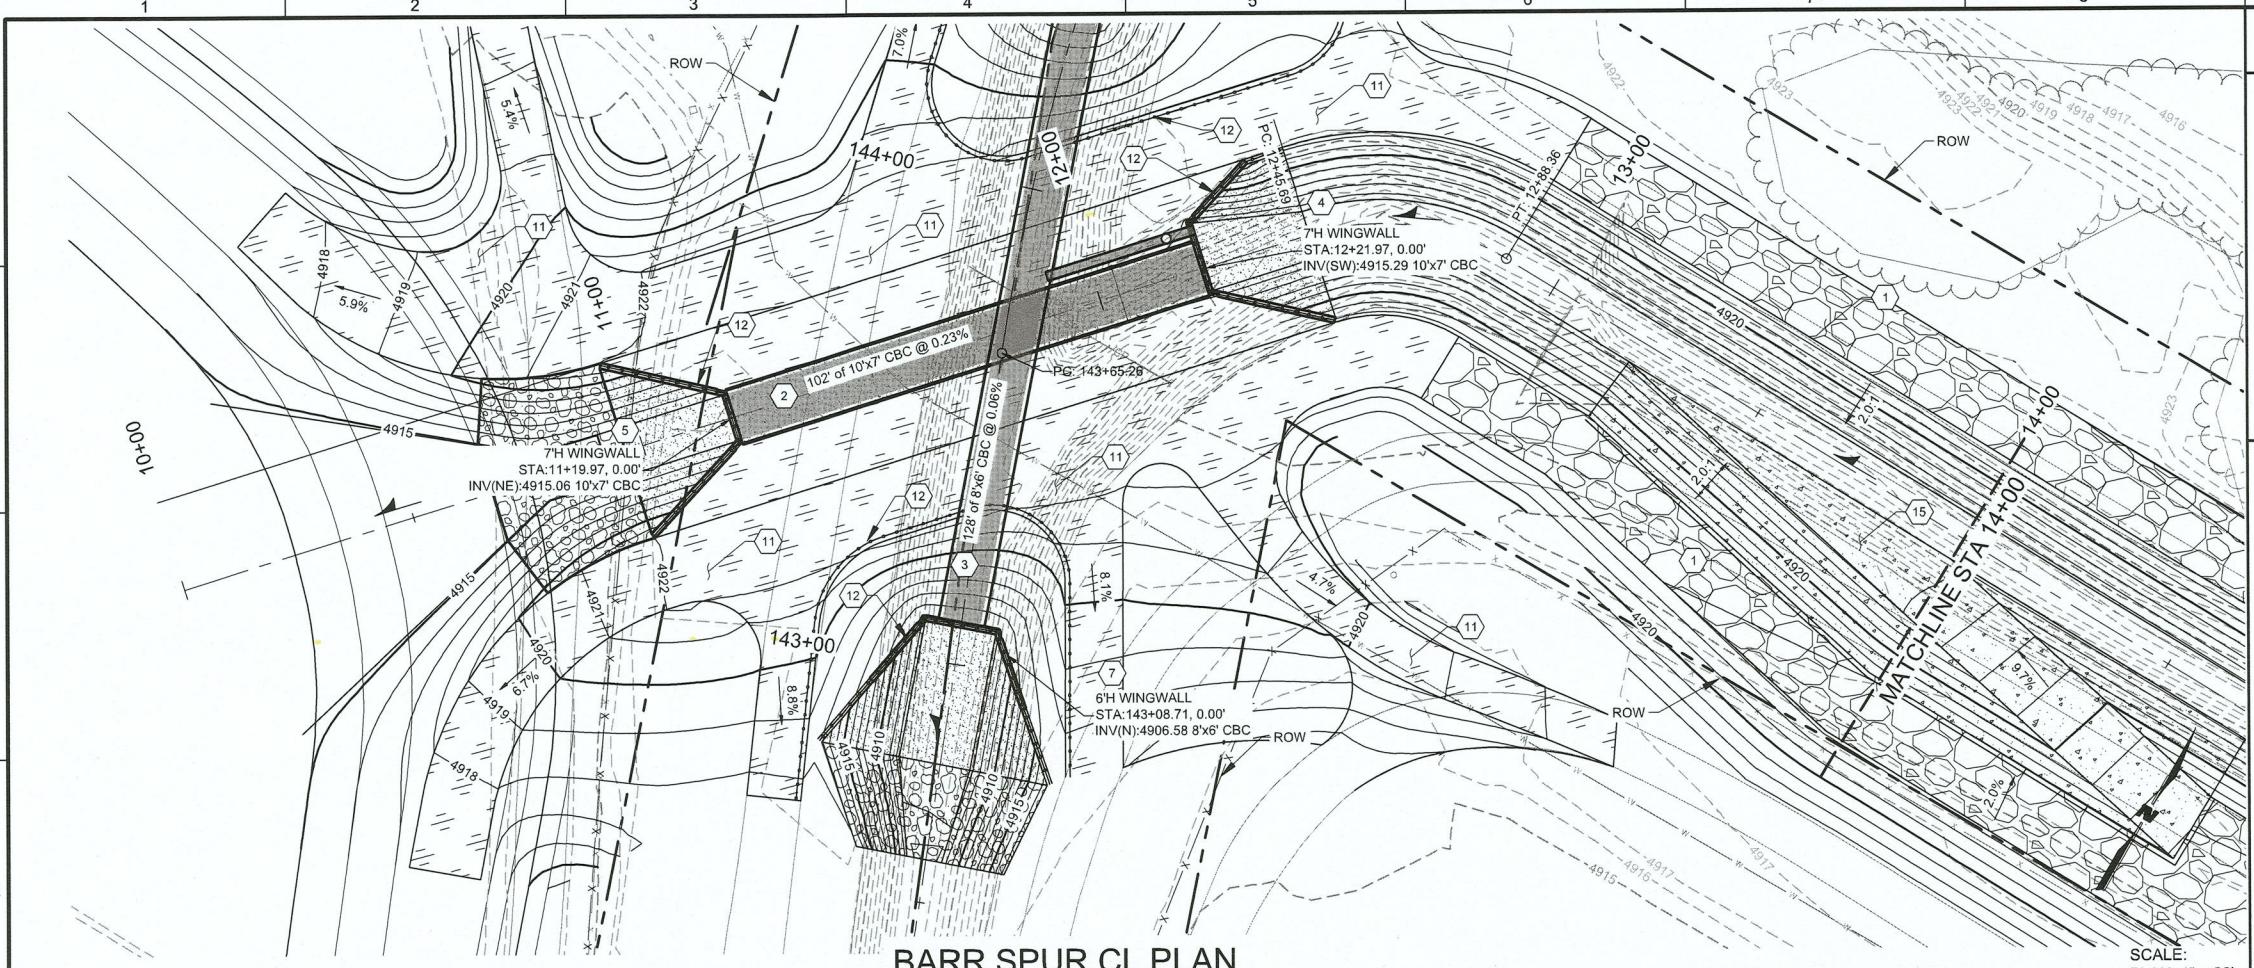
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A1 GRADING &amp; DRAINAGE PLAN @ EOP

SCALE: 1" = 10'

2ND ST PROJECT  
(CURRENTLY CONSTRUCTED)STA. 38+91.01, 10.77' LT  
FG 23.01STA. 38+84.63, 41.69' LT  
FG 28.57STA. 38+87.41, 28.23' LT  
FG 28.44STA. 38+61.65, 21.43' LT  
FG 28.32STA. 38+54.12, 34.94' LT  
FG 28.60STA. 38+53.46, 5.46' LT,  
FG 22.39STA. 38+43.77, 9.82' RT  
FG 22.26STA. 38+84.47, 9.25' RT  
FG 23.02STA. 38+84.62, 13.68' RT  
FG 27.37STA. 38+46.53, 11.88' RT  
FG 27.31STA. 38+22.82, 13.17' RT  
FG 29.58STA. 37+38.59, 34.00' LT  
FG 28.19STA. 37+38.59, 19.00' LT  
FG 27.89STA. 36+72.48, 34.00' LT  
FG 28.02STA. 36+72.48, 19.00' LT  
FG 27.72STA. 36+72.48, 5.00' LT  
FG 20.72STA. 36+72.48, 5.00' RT  
FG 20.72STA. 37+38.59, 5.00' LT  
FG 20.89STA. 37+43.63, 5.00' RT  
FG 20.92STA. 37+78.58, 34.86' RT  
FG 27.99STA. 37+51.99, 19.03' RT  
FG 27.90STA. 37+54.41, 52.95' RT  
FG 27.63STA. 36+72.48, 19.00' RT  
FG 27.72STA. 36+72.48, 5.00' RT  
FG 20.72STA. 37+38.59, 19.03' RT  
FG 27.90STA. 37+43.63, 5.00' RT  
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FG 27.63STA. 36+72.48, 19.00' RT  
FG 27.72STA. 36+72.48, 5.00' RT  
FG 20.72STA. 37+38.59, 19.03' RT  
FG 27.90



### GENERAL SHEET NOTES

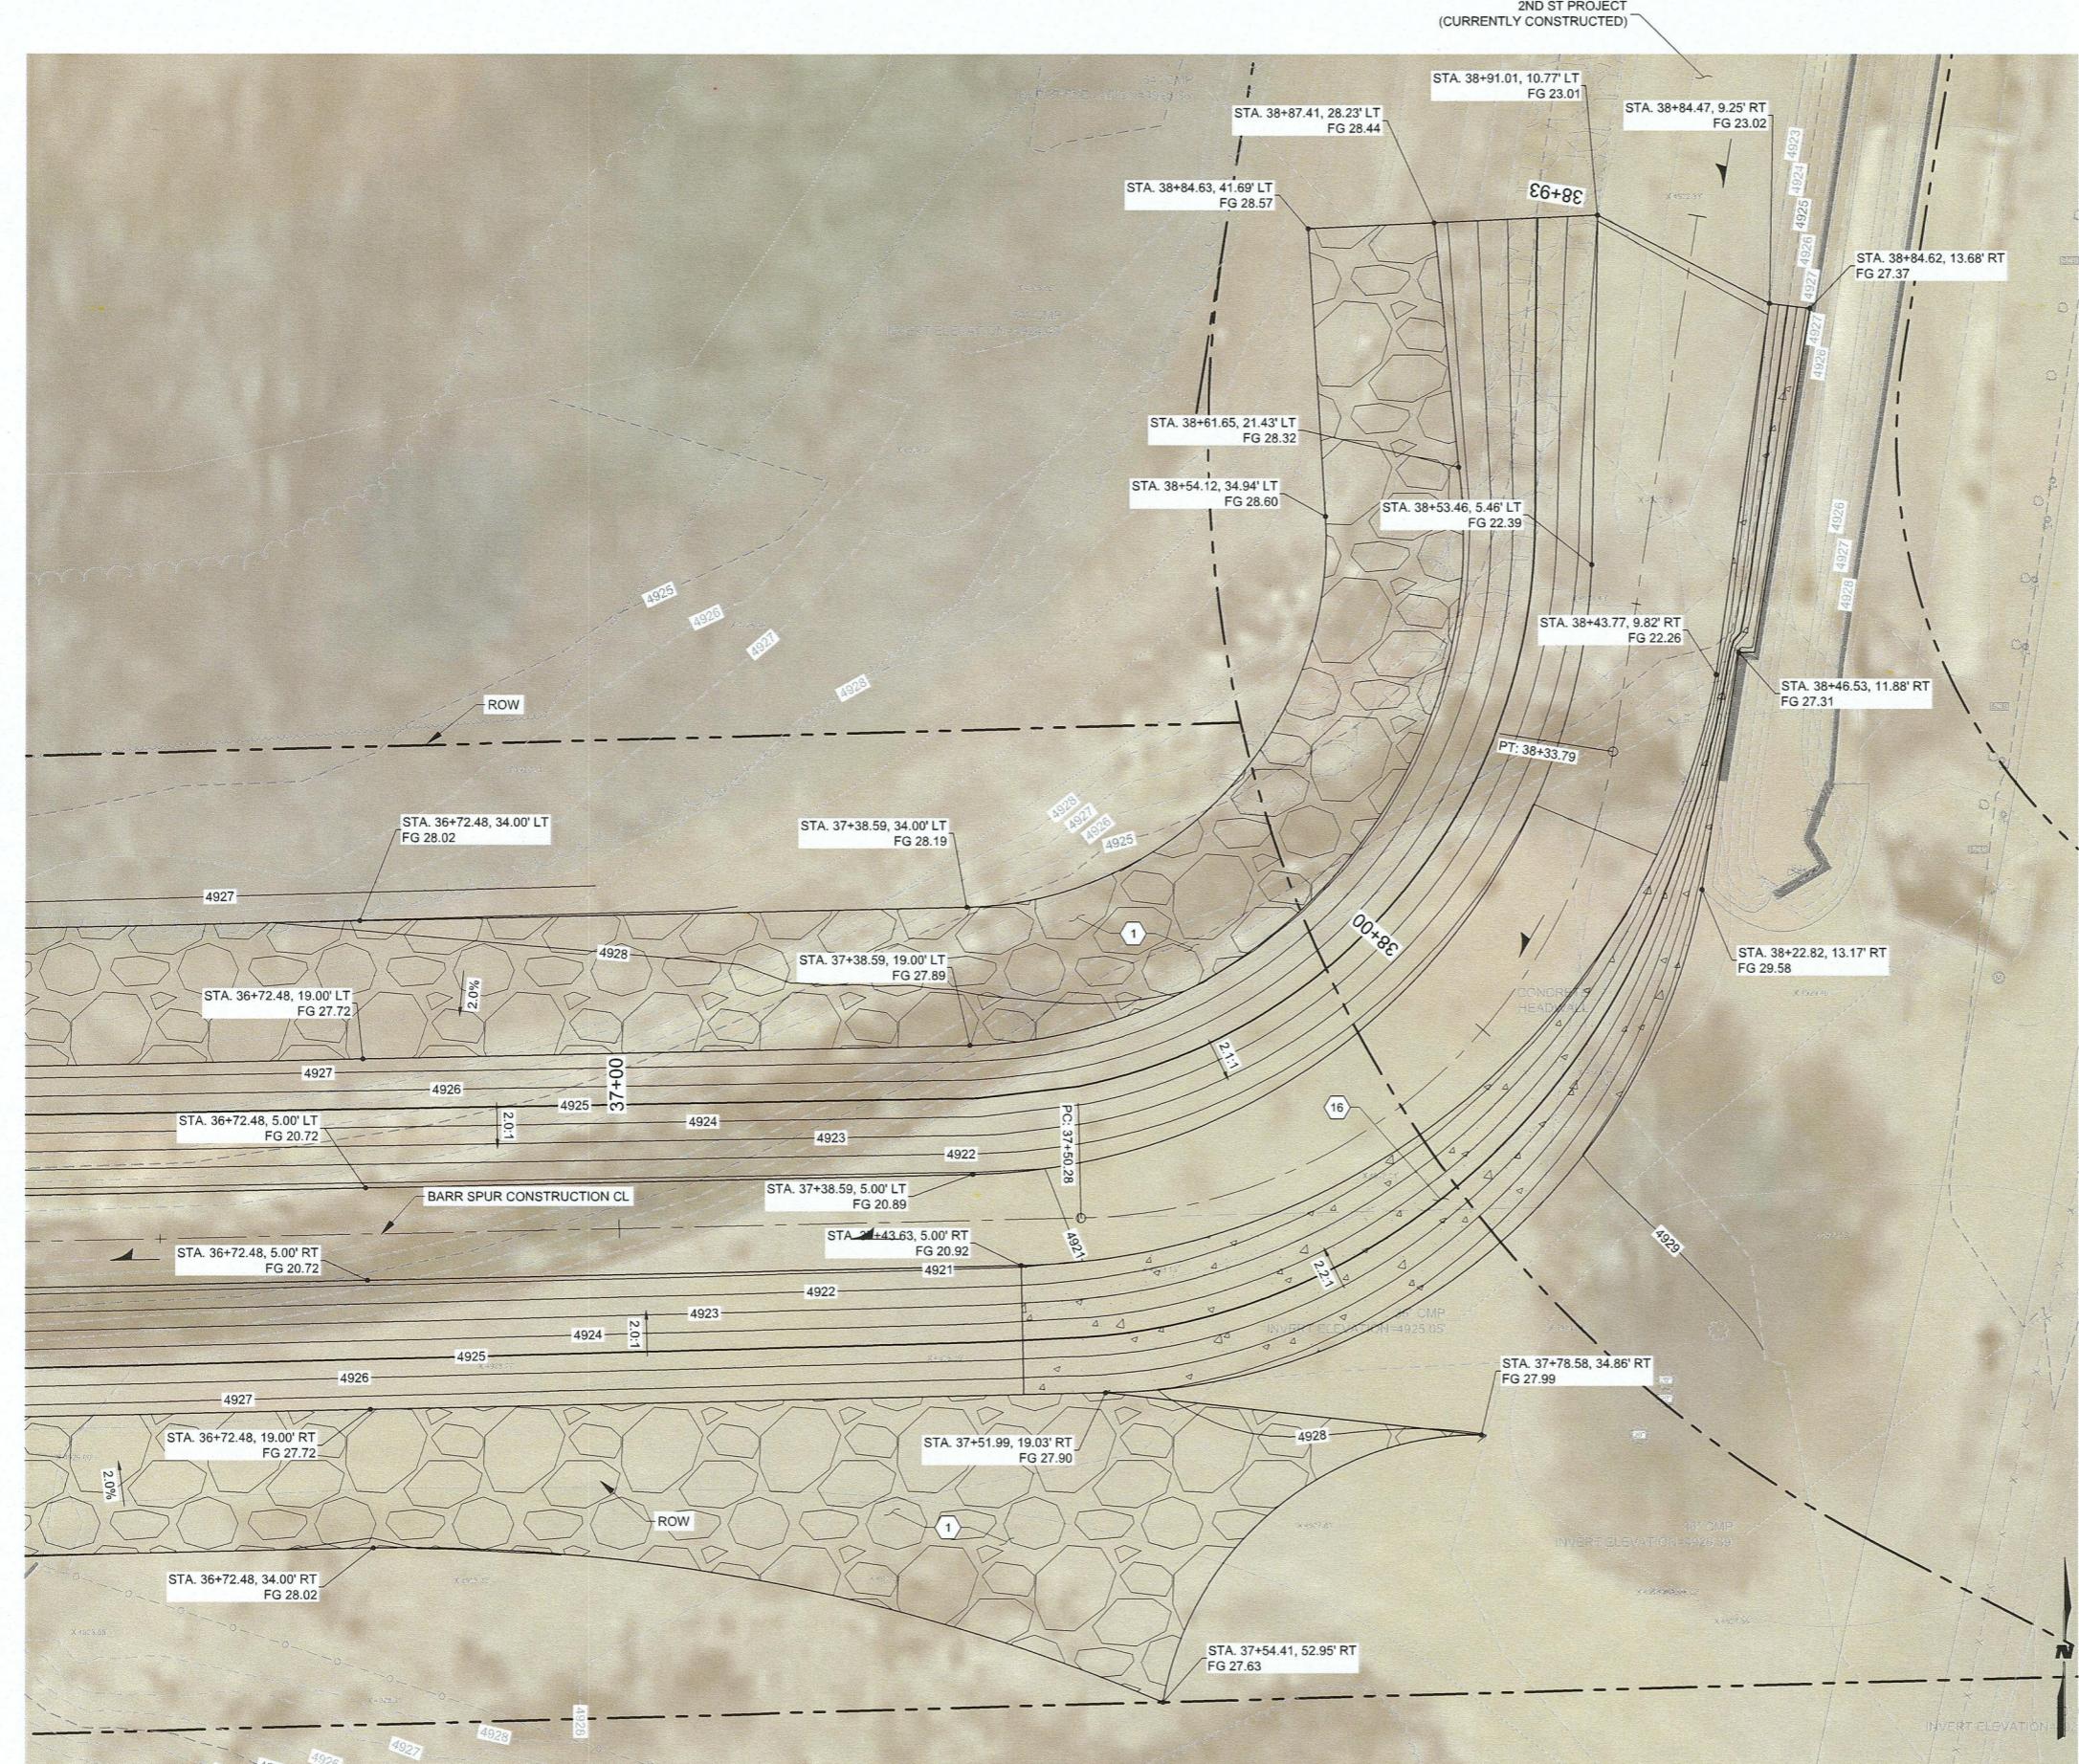- GENERAL SHEET NOTES.

**WILSON**  
& COMPANY

4401 MASTHEAD ST. NE, SUITE 150  
ALBUQUERQUE, NM 87109  
PHONE: 505-348-4000  
FAX: 505-348-4072  
www.wilsonco.com

CONSULTANTS

SEAL

PROJECT NAME

DESCRIPTION

PROJECT NO: 1660060700  
DESIGNED BY: TJA  
DRAWN BY: JEM  
CHECKED BY: TJA  
DATE: JAN 2022  
SHEET TITLE

BARR SPUR  
PLAN & PROFILE

SHEET NO:  
**C-401**


REV. DATE BY


60% SUBMITTAL  
NOT FOR  
CONSTRUCTION

### KEYNOTES (AS APPLICABLE)

- CONSTRUCT 6" THICK CONCRETE BASE COURSE MAINTENANCE ROAD. SEE DETAIL H9/C-501.
- CONSTRUCT 10'W x 7'H x 102'L CBC. SEE SHEETS C-511 THRU C-514.
- CONSTRUCT 8'W x 6'H x 128'L CBC. SEE SHEETS C-511 THRU C-514.
- CONSTRUCT WINGWALL 'A' FOR 10'W x 7'H CBC. SEE DETAIL A6/C-506.
- CONSTRUCT WINGWALL 'B' FOR 10'W x 7'H CBC. SEE SHEETS A1/C-506.
- CONSTRUCT WINGWALL 'C' FOR 8'W x 6'H CBC. SEE SHEETS A1/C-507.
- CONSTRUCT WINGWALL 'D' FOR 8'W x 6'H CBC. SEE SHEETS A6/C-507.
- INSTALL 24" CMP w/ PIPE PENETRATION. SEE SHEET C-502.
- INSTALL PIPE TO PIPE CONNECTION. SEE DETAIL D8/C-501.
- INSTALL 18" THICK RIPRAP. SEE DETAIL F8/C-501.
- CONSTRUCT NATIVE MATERIAL BASE COURSE. SEE SHEET A5/C-501.
- INSTALL PIPE RAILING. SEE SHEET C-503.
- CONSTRUCT WATER QUALITY STRUCTURE. SEE SHEETS C-508 THRU C-510.
- INSTALL 18" RCP w/ PIPE PENETRATION INTO 8'x6' CBC. SEE "OUTER WALL PENETRATION DETAIL" ON SHEET C-517.
- CONSTRUCT CONCRETE ACCESS RAMP. SEE SHEET C-504.
- CONSTRUCT SHOTCRETE PAVING. SEE DETAIL XX.

### LEGEND

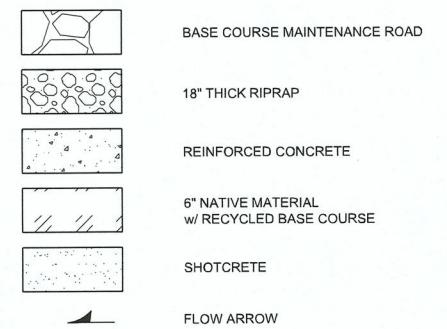

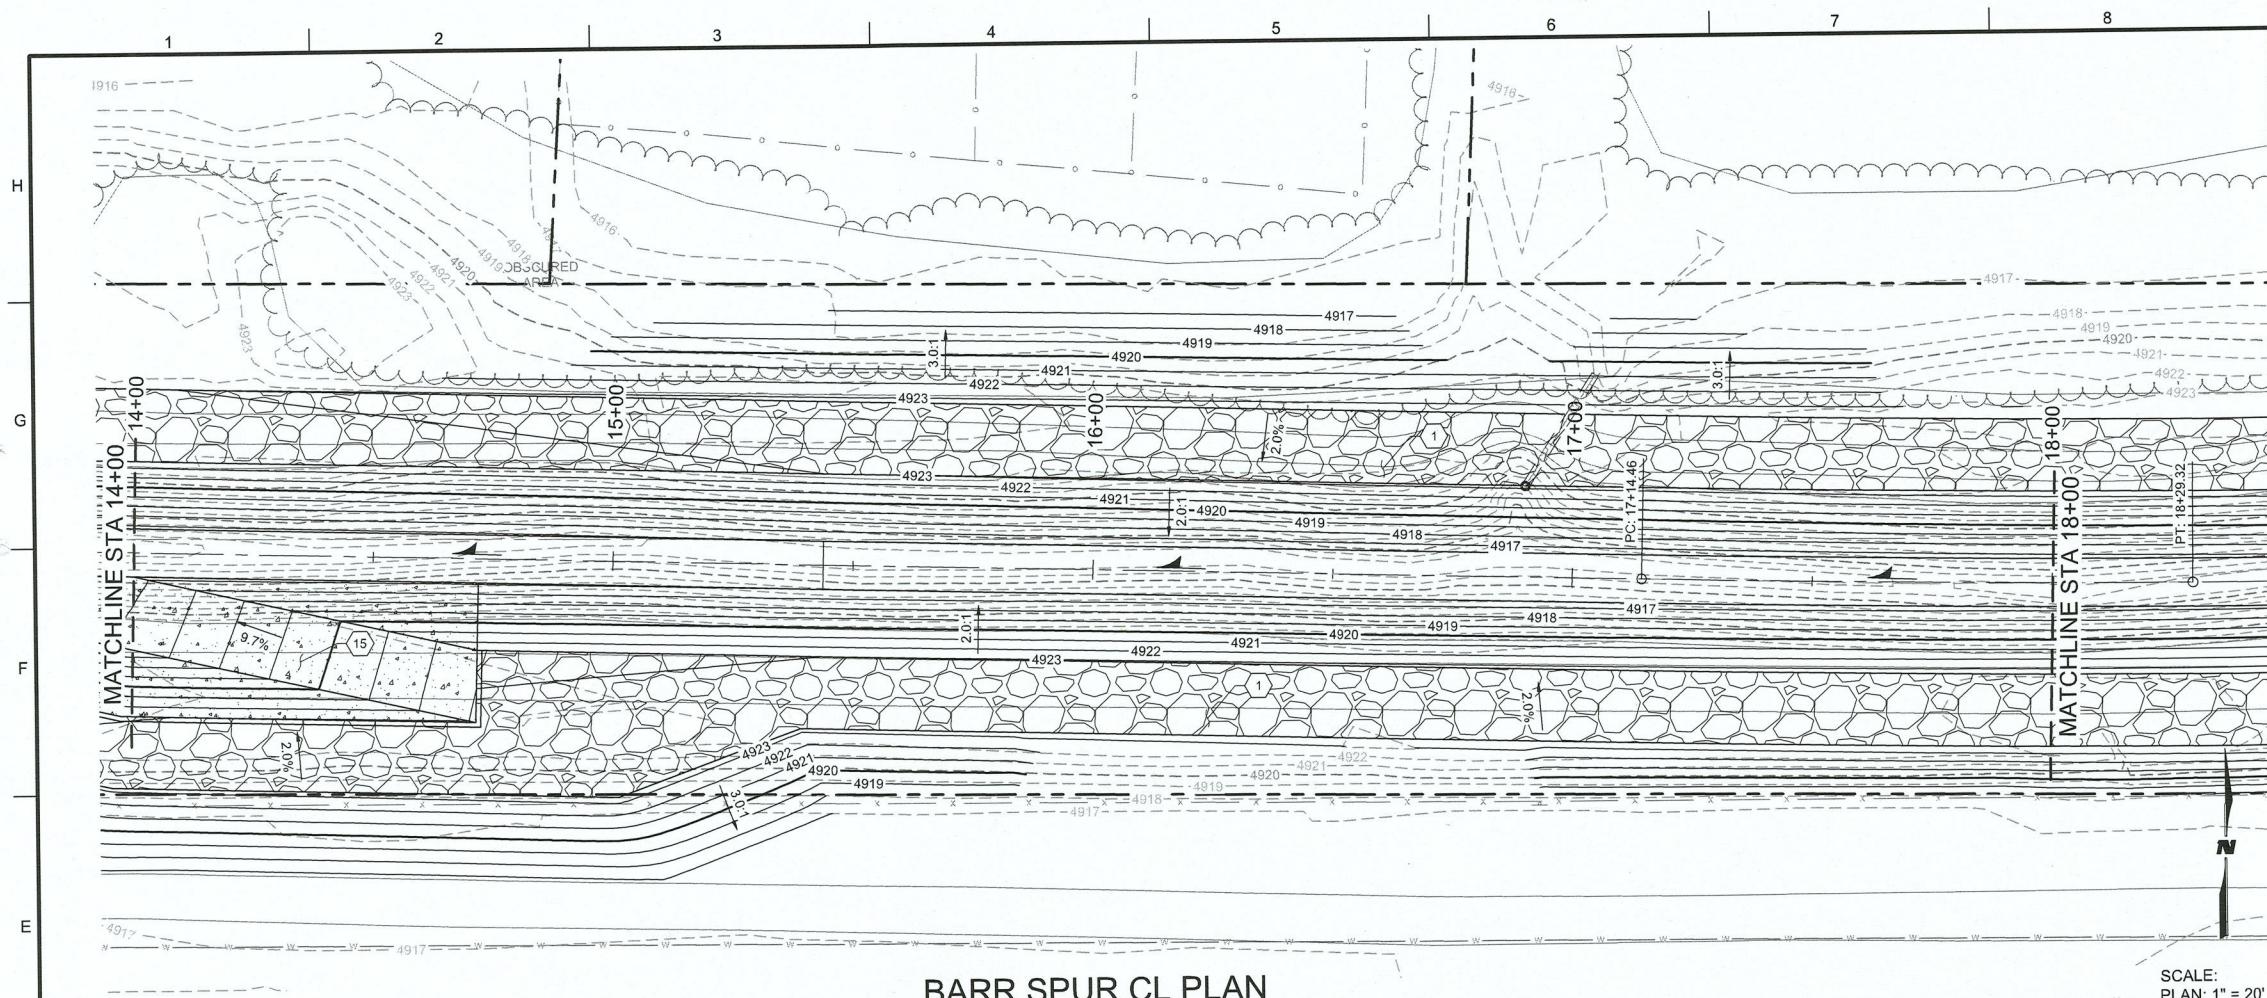

BARR SPUR CL PLAN

## GENERAL SHEET NOTES

- GENERAL SHEET NOTES.

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**& COMPANY**

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FAX: 505-348-4072  
www.wilsonco.com

60% SUBMITTAL  
NOT FOR  
CONSTRUCTION

BARR SPUR  
IMPROVEMENTS

CONSULTANTS

SEAL

PROJECT NAME

REV.

DATE

DESCRIPTION

BY

PROJECT NO: 1660060700  
DESIGNED BY: TJA  
DRAWN BY: JEM  
CHECKED BY: TJA  
DATE: JAN 2022  
SHEET TITLE



BARR SPUR  
PLAN & PROFILE


SHEET NO: C-402

## KEYNOTES (AS APPLICABLE)



- CONSTRUCT 6" THICK CONCRETE BASE COURSE MAINTENANCE ROAD. SEE DETAIL H9/C-501.
- CONSTRUCT 10'W x7'H x102'L CBC. SEE SHEETS C-511 THRU C-514.
- CONSTRUCT 8'W x 6'H x128'L CBC. SEE SHEETS C-511 THRU C-514.
- CONSTRUCT WINGWALL 'A' FOR 10'W x7'H CBC. SEE DETAIL A6/C-506.
- CONSTRUCT WINGWALL 'B' FOR 10'W x7'H CBC. SEE SHEETS A1/C-506.
- CONSTRUCT WINGWALL 'C' FOR 8'W x6'H CBC. SEE SHEETS A1/C-507.
- CONSTRUCT WINGWALL 'D' FOR 8'W x6'H CBC. SEE SHEETS A6/C-507.
- INSTALL 24" CMP w/ PIPE PENETRATION. SEE SHEET C-502.
- INSTALL PIPE TO PIPE CONNECTION. SEE DETAIL D8/C-501.
- INSTALL 18" THICK RIPRAP. SEE DETAIL F8/C-501.
- CONSTRUCT NATIVE MATERIAL BASE COURSE. SEE SHEET A5/C-501.
- INSTALL PIPE RAILING. SEE SHEET C-503.
- CONSTRUCT WATER QUALITY STRUCTURE. SEE SHEETS C-508 THRU C-510.
- INSTALL 18" RCP w/ PIPE PENETRATION INTO 8'x6' CBC. SEE "OUTER WALL PENETRATION DETAIL" ON SHEET C-517.
- CONSTRUCT CONCRETE ACCESS RAMP. SEE SHEET C-504.
- CONSTRUCT SHOTCRETE PAVING. SEE DETAIL XX.


## LEGEND

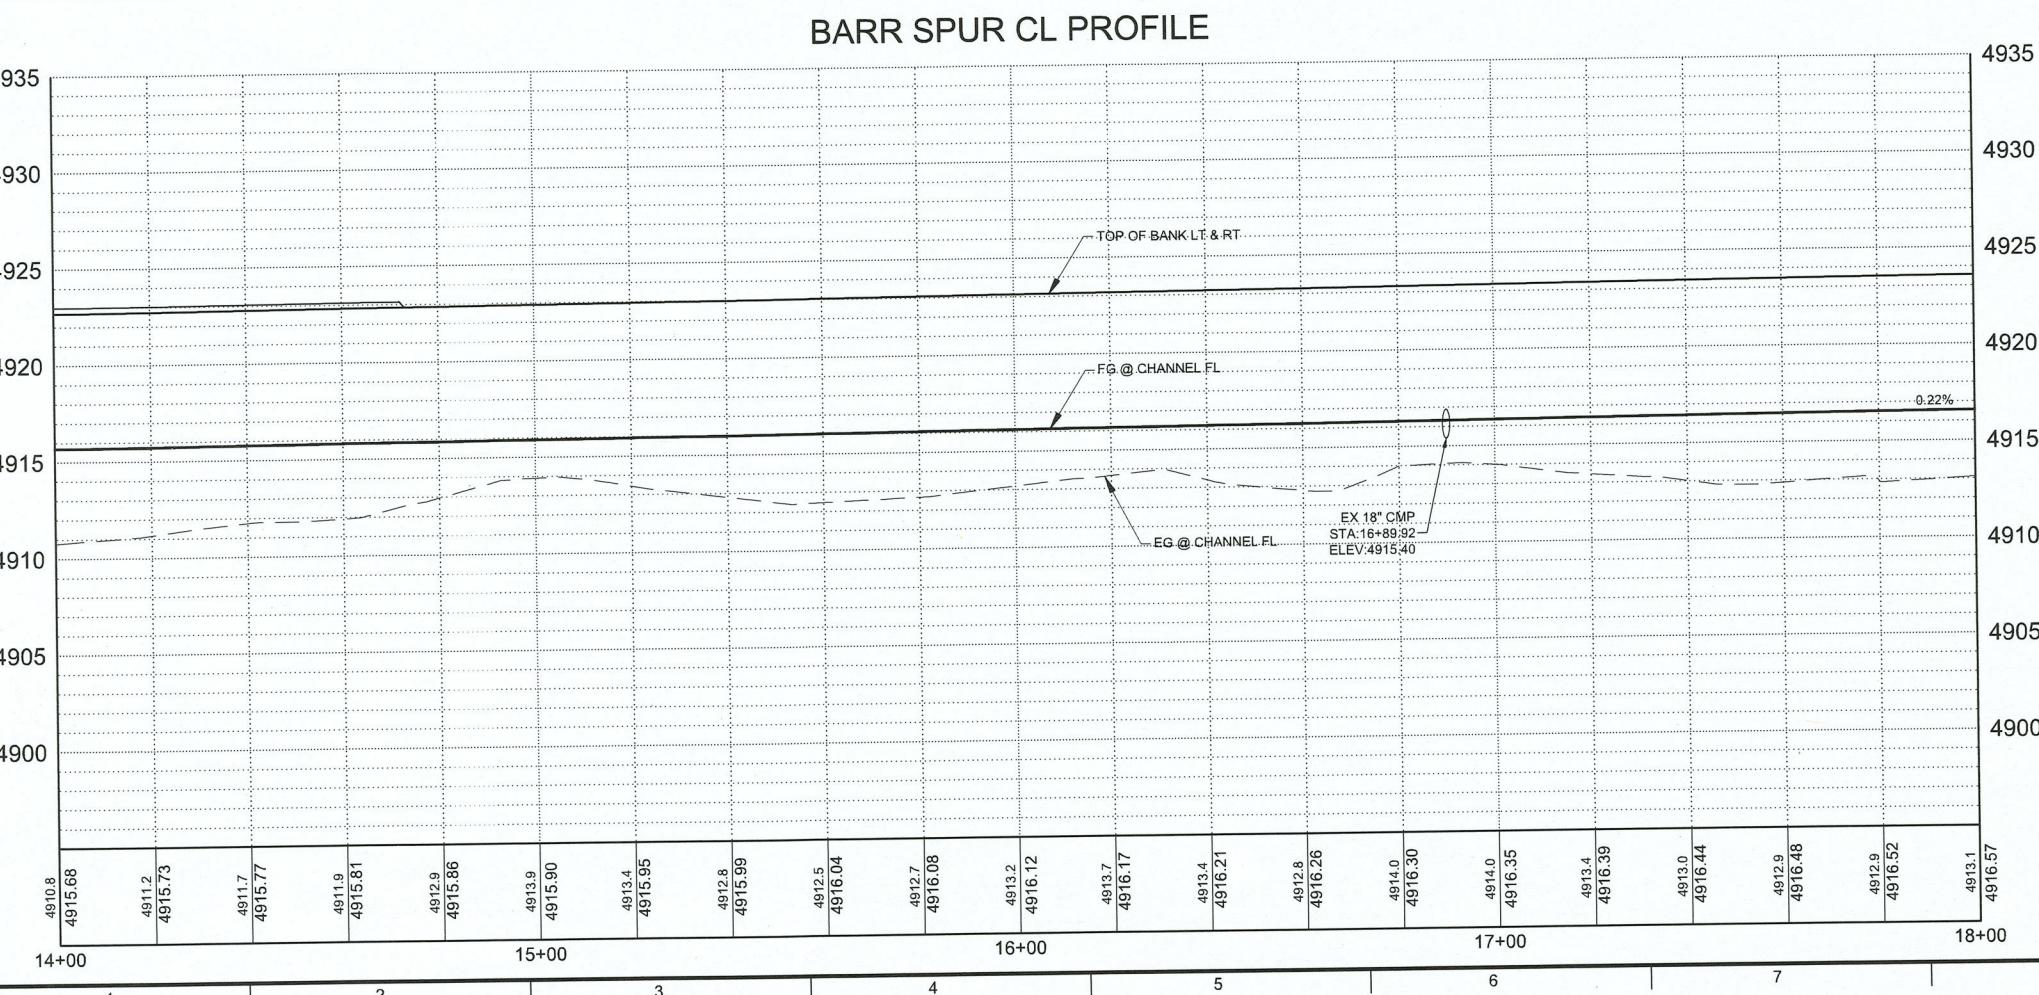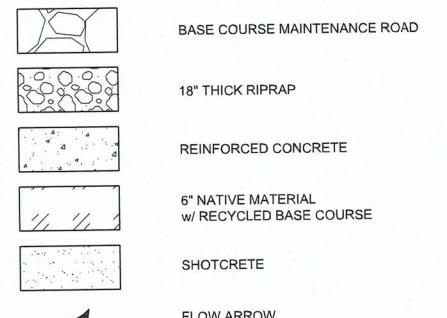

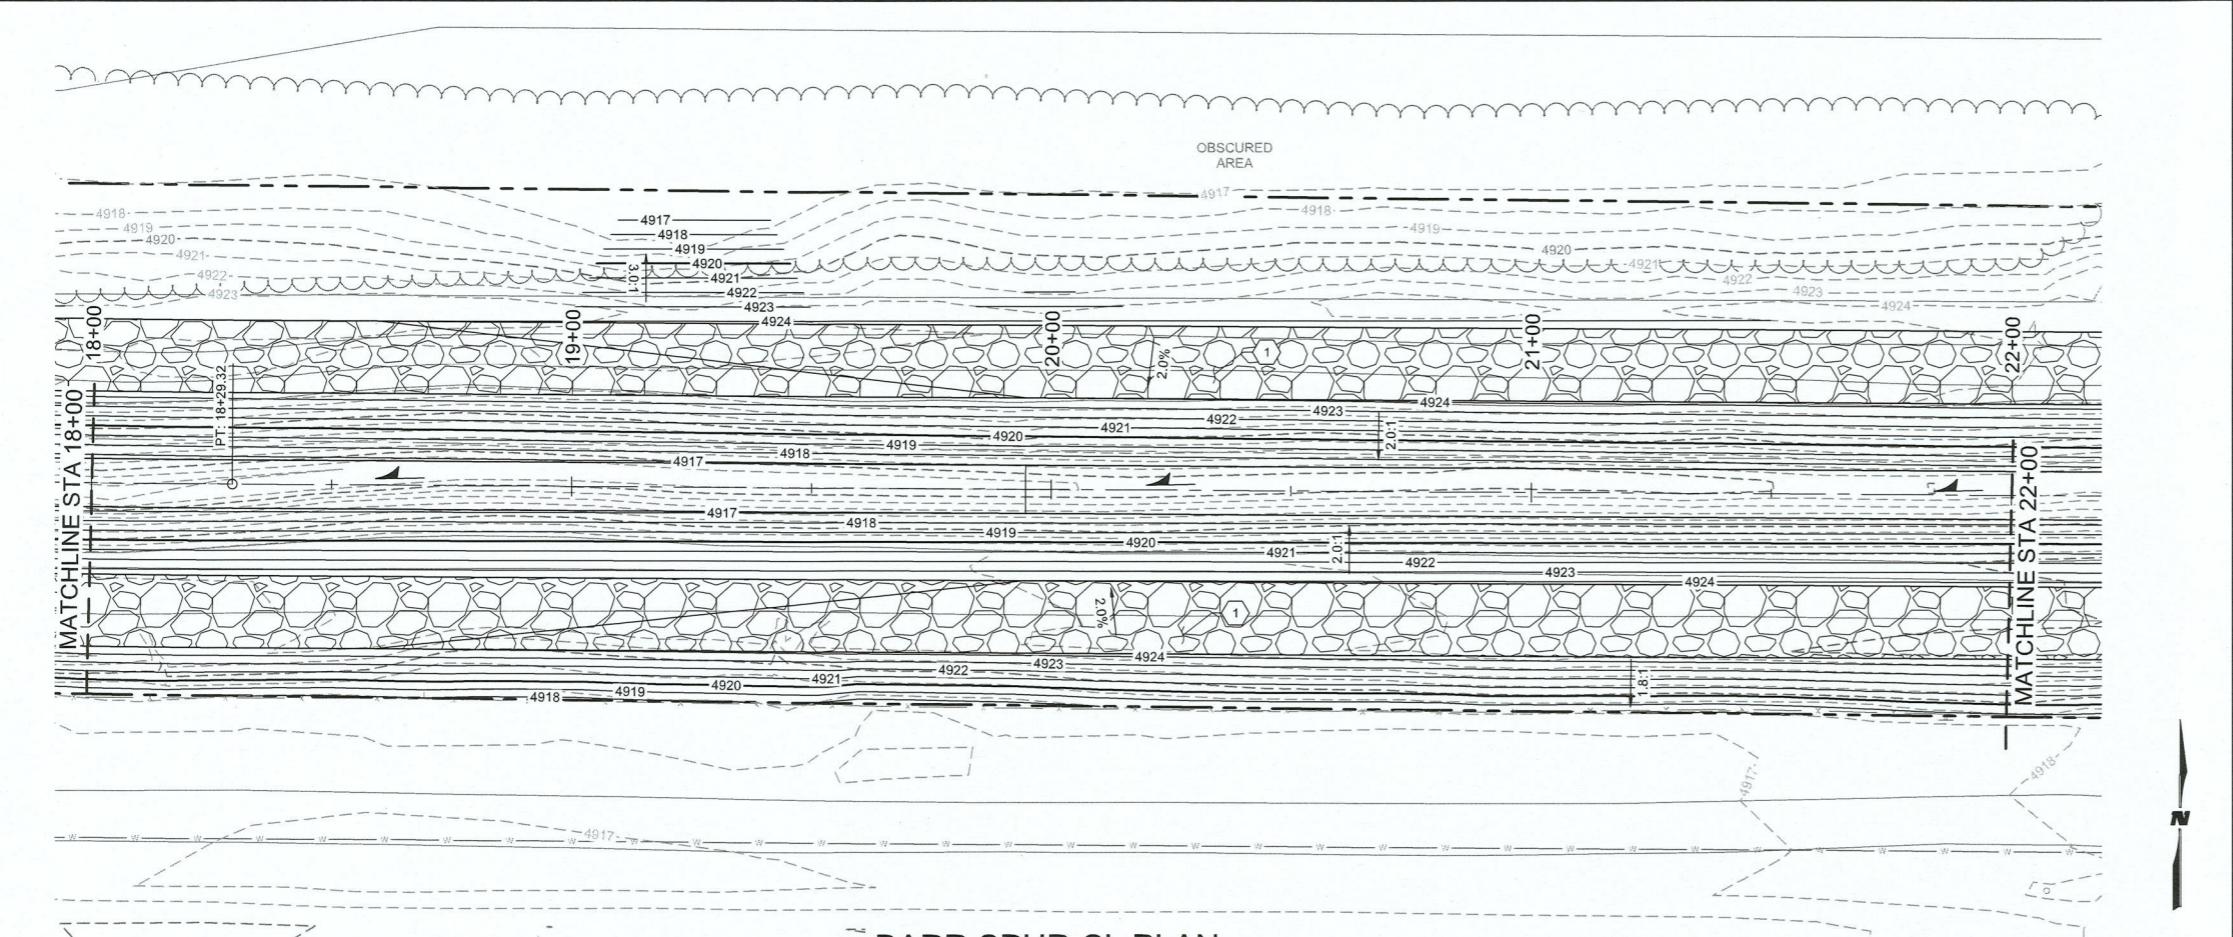

BARR SPUR CL PLAN

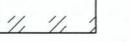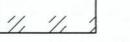
GENERAL SHEET NOTES			
1. GENERAL SHEET NOTES.			
KEYNOTES (AS APPLICABLE)			
1. CONSTRUCT 6" THICK CONCRETE BASE COURSE MAINTENANCE ROAD. SEE DETAIL H9/C-501.			
2. CONSTRUCT 10'W x 7'H x 102'L CBC. SEE SHEETS C-511 THRU C-514.			
3. CONSTRUCT 8'W x 6'H x 128'L CBC. SEE SHEETS C-511 THRU C-514.			
4. CONSTRUCT WINGWALL 'A' FOR 10'W x 7'H CBC. SEE DETAIL A6/C-506.			
5. CONSTRUCT WINGWALL 'B' FOR 10'W x 7'H CBC. SEE SHEETS A1/C-506.			
6. CONSTRUCT WINGWALL 'C' FOR 8'W x 6'H CBC. SEE SHEETS A1/C-507.			
7. CONSTRUCT WINGWALL 'D' FOR 8'W x 6'H CBC. SEE SHEETS A6/C-507.			
8. INSTALL 24" CMP w/ PIPE PENETRATION. SEE SHEET C-502.			
9. INSTALL PIPE TO PIPE CONNECTION. SEE DETAIL D8/C-501.			
10. INSTALL 18" THICK RIPRAP. SEE DETAIL F8/C-501.			
11. CONSTRUCT NATIVE MATERIAL BASE COURSE. SEE SHEET A5/C-501.			
12. INSTALL PIPE RAILING. SEE SHEET C-503.			
13. CONSTRUCT WATER QUALITY STRUCTURE. SEE SHEETS C-508 THRU C-510.			
14. INSTALL 18" RCP w/ PIPE PENETRATION INTO 8'x6' CBC. SEE "OUTER WALL PENETRATION DETAIL" ON SHEET C-517.			
15. CONSTRUCT CONCRETE ACCESS RAMP. SEE SHEET C-504.			
16. CONSTRUCT SHOTCRETE PAVING. SEE DETAIL XX.			
		60% SUBMITTAL NOT FOR CONSTRUCTION	
		BARR SPUR IMPROVEMENTS	
		PROJECT NAME BY	
		REV. DATE DESCRIPTION	
		PROJECT NO: 1660060700 DESIGNED BY: TJA DRAWN BY: JEM CHECKED BY: TJA DATE: JAN 2022 SHEET TITLE BARR SPUR PLAN & PROFILE SHEET NO: C-403	
		LEGEND	
		 BASE COURSE MAINTENANCE ROAD  18" THICK RIPRAP  REINFORCED CONCRETE  6" NATIVE MATERIAL w/ RECYCLED BASE COURSE  SHOTCRETE  FLOW ARROW	
GENERAL SHEET NOTES			
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KEYNOTES (AS APPLICABLE)			
1. CONSTRUCT 6" THICK CONCRETE BASE COURSE MAINTENANCE ROAD. SEE DETAIL H9/C-501.			
2. CONSTRUCT 10'W x 7'H x 102'L CBC. SEE SHEETS C-511 THRU C-514.			
3. CONSTRUCT 8'W x 6'H x 128'L CBC. SEE SHEETS C-511 THRU C-514.			
4. CONSTRUCT WINGWALL 'A' FOR 10'W x 7'H CBC. SEE DETAIL A6/C-506.			
5. CONSTRUCT WINGWALL 'B' FOR 10'W x 7'H CBC. SEE SHEETS A1/C-506.			
6. CONSTRUCT WINGWALL 'C' FOR 8'W x 6'H CBC. SEE SHEETS A1/C-507.			
7. CONSTRUCT WINGWALL 'D' FOR 8'W x 6'H CBC. SEE SHEETS A6/C-507.			
8. INSTALL 24" CMP w/ PIPE PENETRATION. SEE SHEET C-502.			
9. INSTALL PIPE TO PIPE CONNECTION. SEE DETAIL D8/C-501.			
10. INSTALL 18" THICK RIPRAP. SEE DETAIL F8/C-501.			
11. CONSTRUCT NATIVE MATERIAL BASE COURSE. SEE SHEET A5/C-501.			
12. INSTALL PIPE RAILING. SEE SHEET C-503.			
13. CONSTRUCT WATER QUALITY STRUCTURE. SEE SHEETS C-508 THRU C-510.			
14. INSTALL 18" RCP w/ PIPE PENETRATION INTO 8'x6' CBC. SEE "OUTER WALL PENETRATION DETAIL" ON SHEET C-517.			
15. CONSTRUCT CONCRETE ACCESS RAMP. SEE SHEET C-504.			
16. CONSTRUCT SHOTCRETE PAVING. SEE DETAIL XX.			
60% SUBMITTAL NOT FOR CONSTRUCTION		BARR SPUR IMPROVEMENTS	
		PROJECT NAME BY	
		REV. DATE DESCRIPTION	
		PROJECT NO: 1660060700 DESIGNED BY: TJA DRAWN BY: JEM CHECKED BY: TJA DATE: JAN 2022 SHEET TITLE BARR SPUR PLAN & PROFILE SHEET NO: C-403	
		LEGEND	
		 BASE COURSE MAINTENANCE ROAD  18" THICK RIPRAP  REINFORCED CONCRETE  6" NATIVE MATERIAL w/ RECYCLED BASE COURSE  SHOTCRETE  FLOW ARROW	


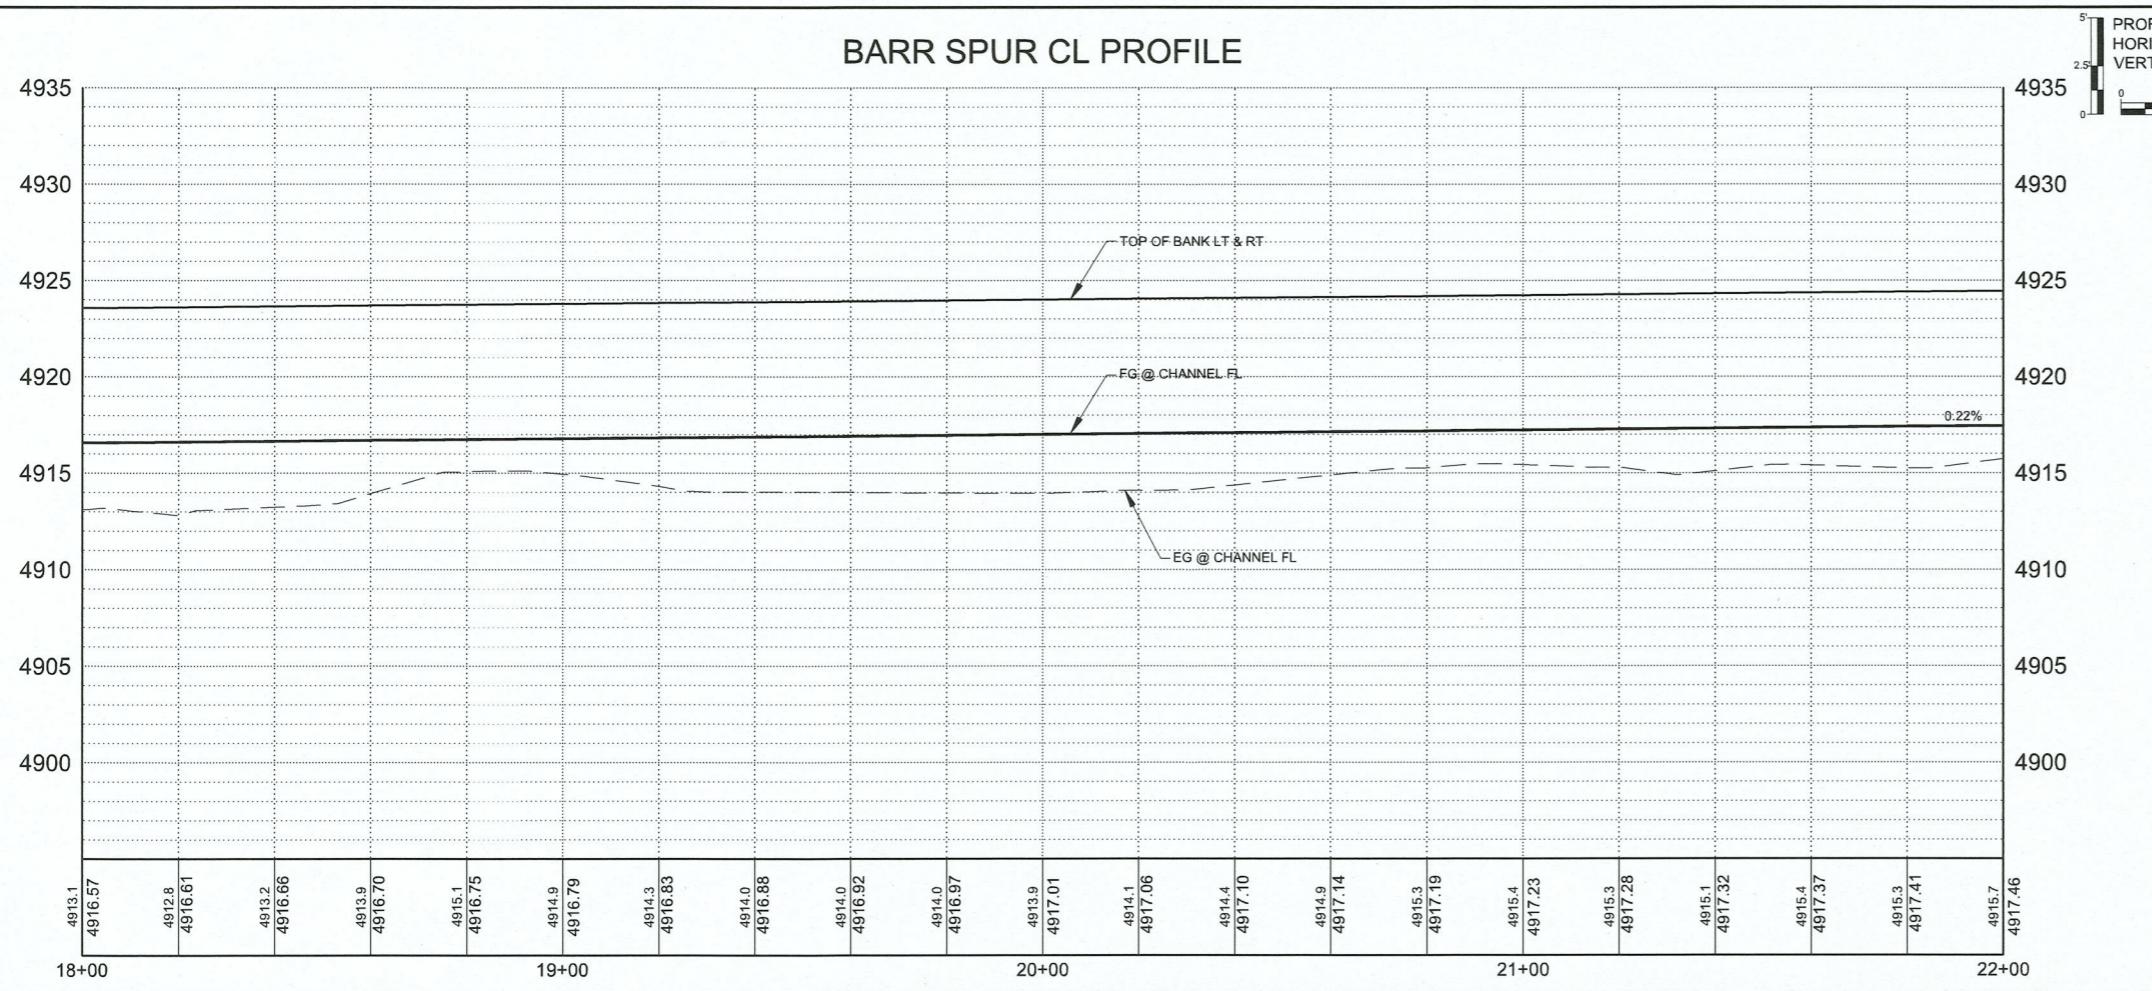



BARR SPUR CL PROFILE

**WILSON**  
**& COMPANY**

4401 MASTHEAD ST. NE SUITE 150  
ALBUQUERQUE, NM 87109  
PHONE: 505-348-4000  
FAX: 505-348-4072  
www.wilsonco.com

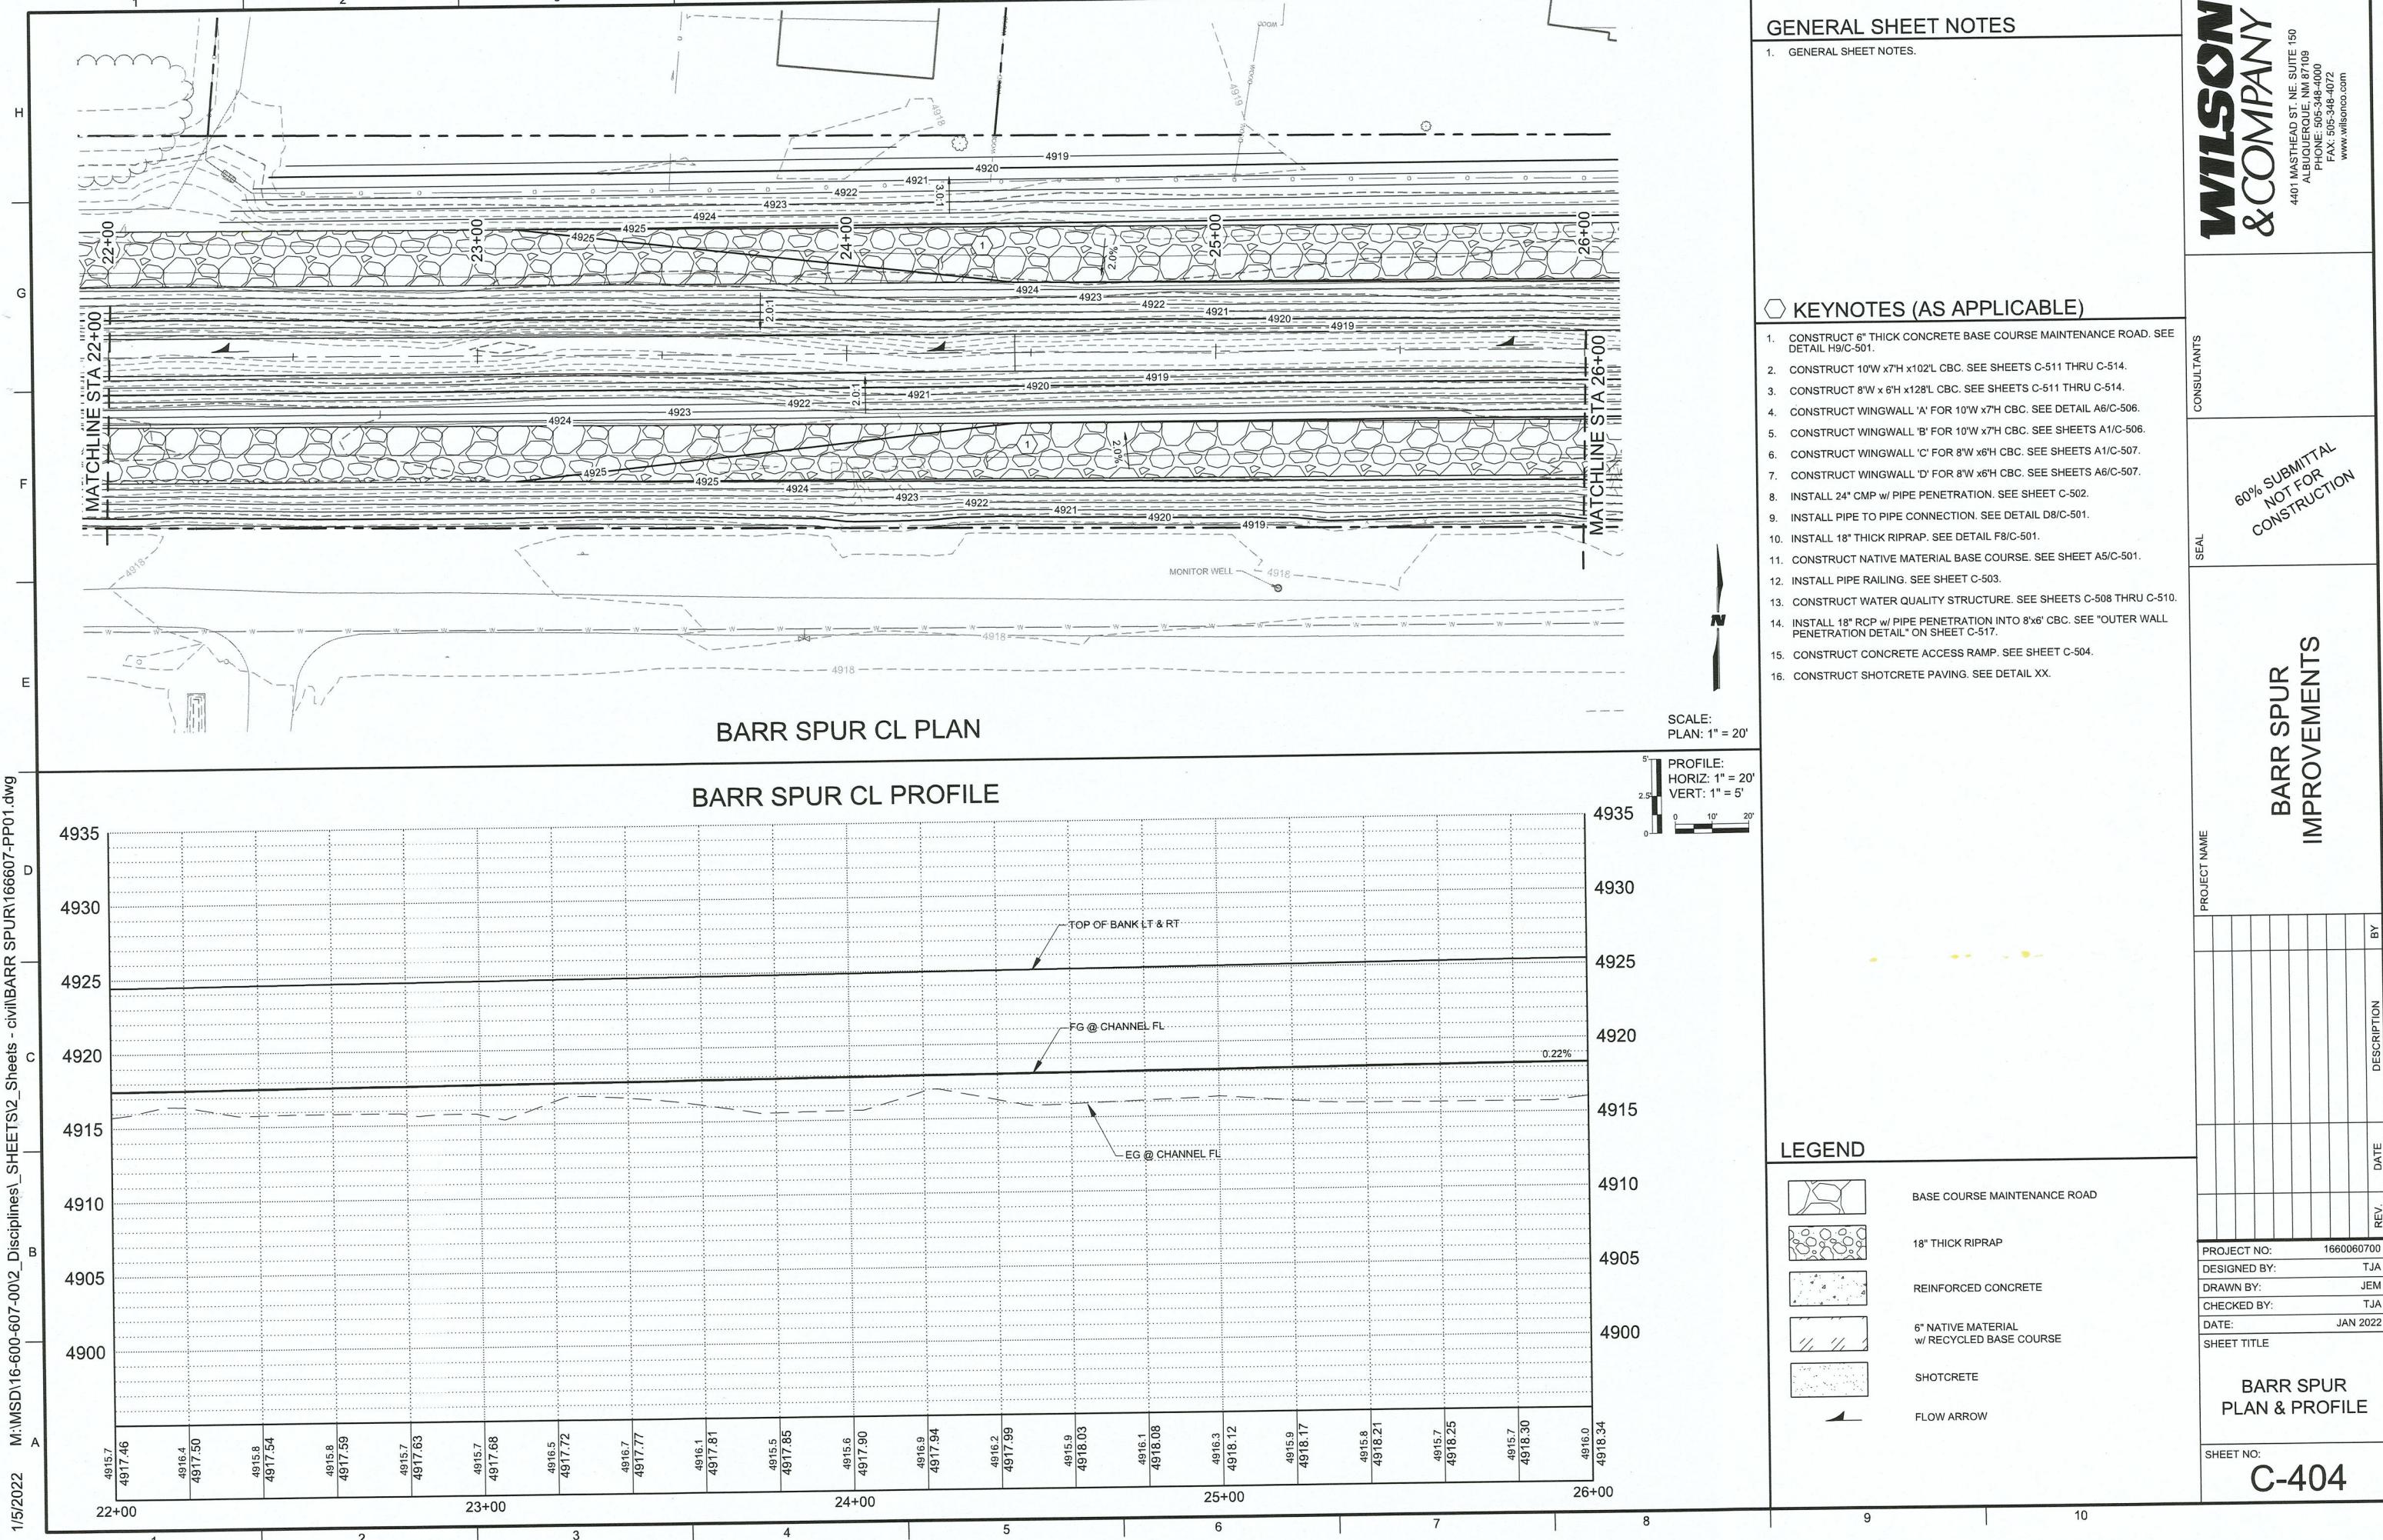

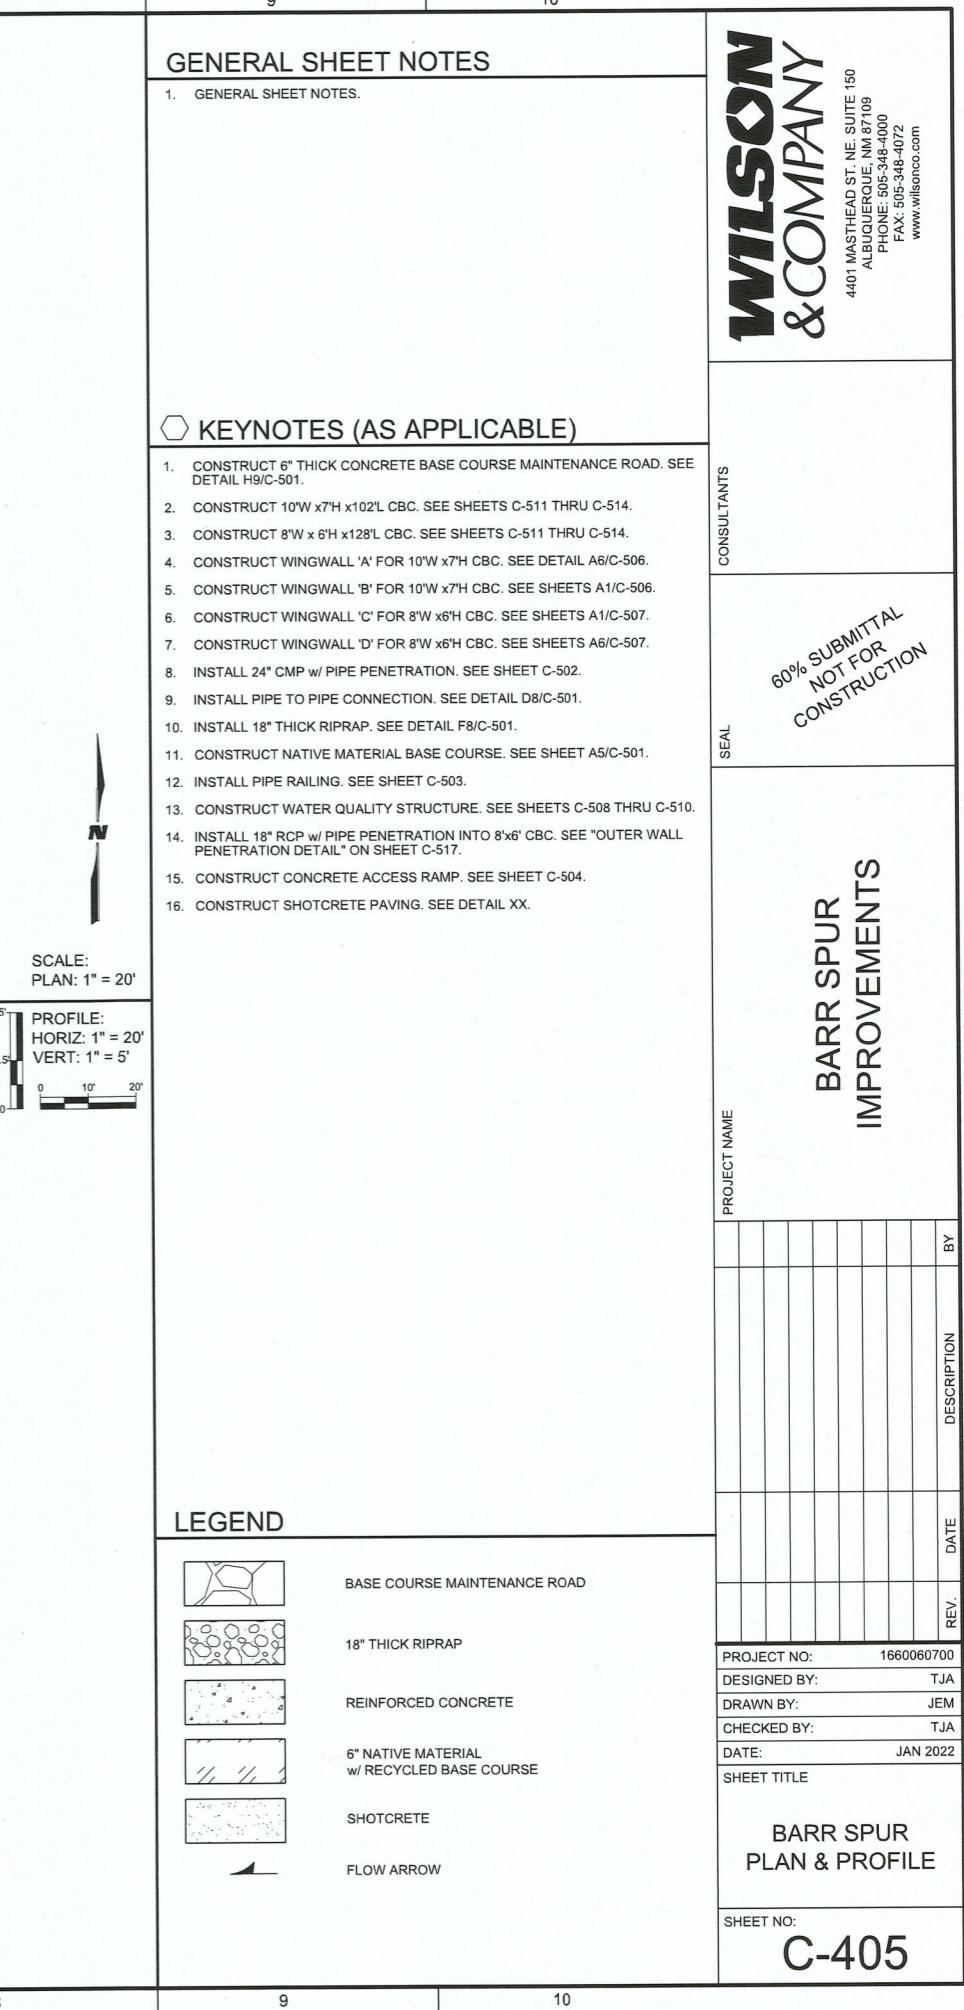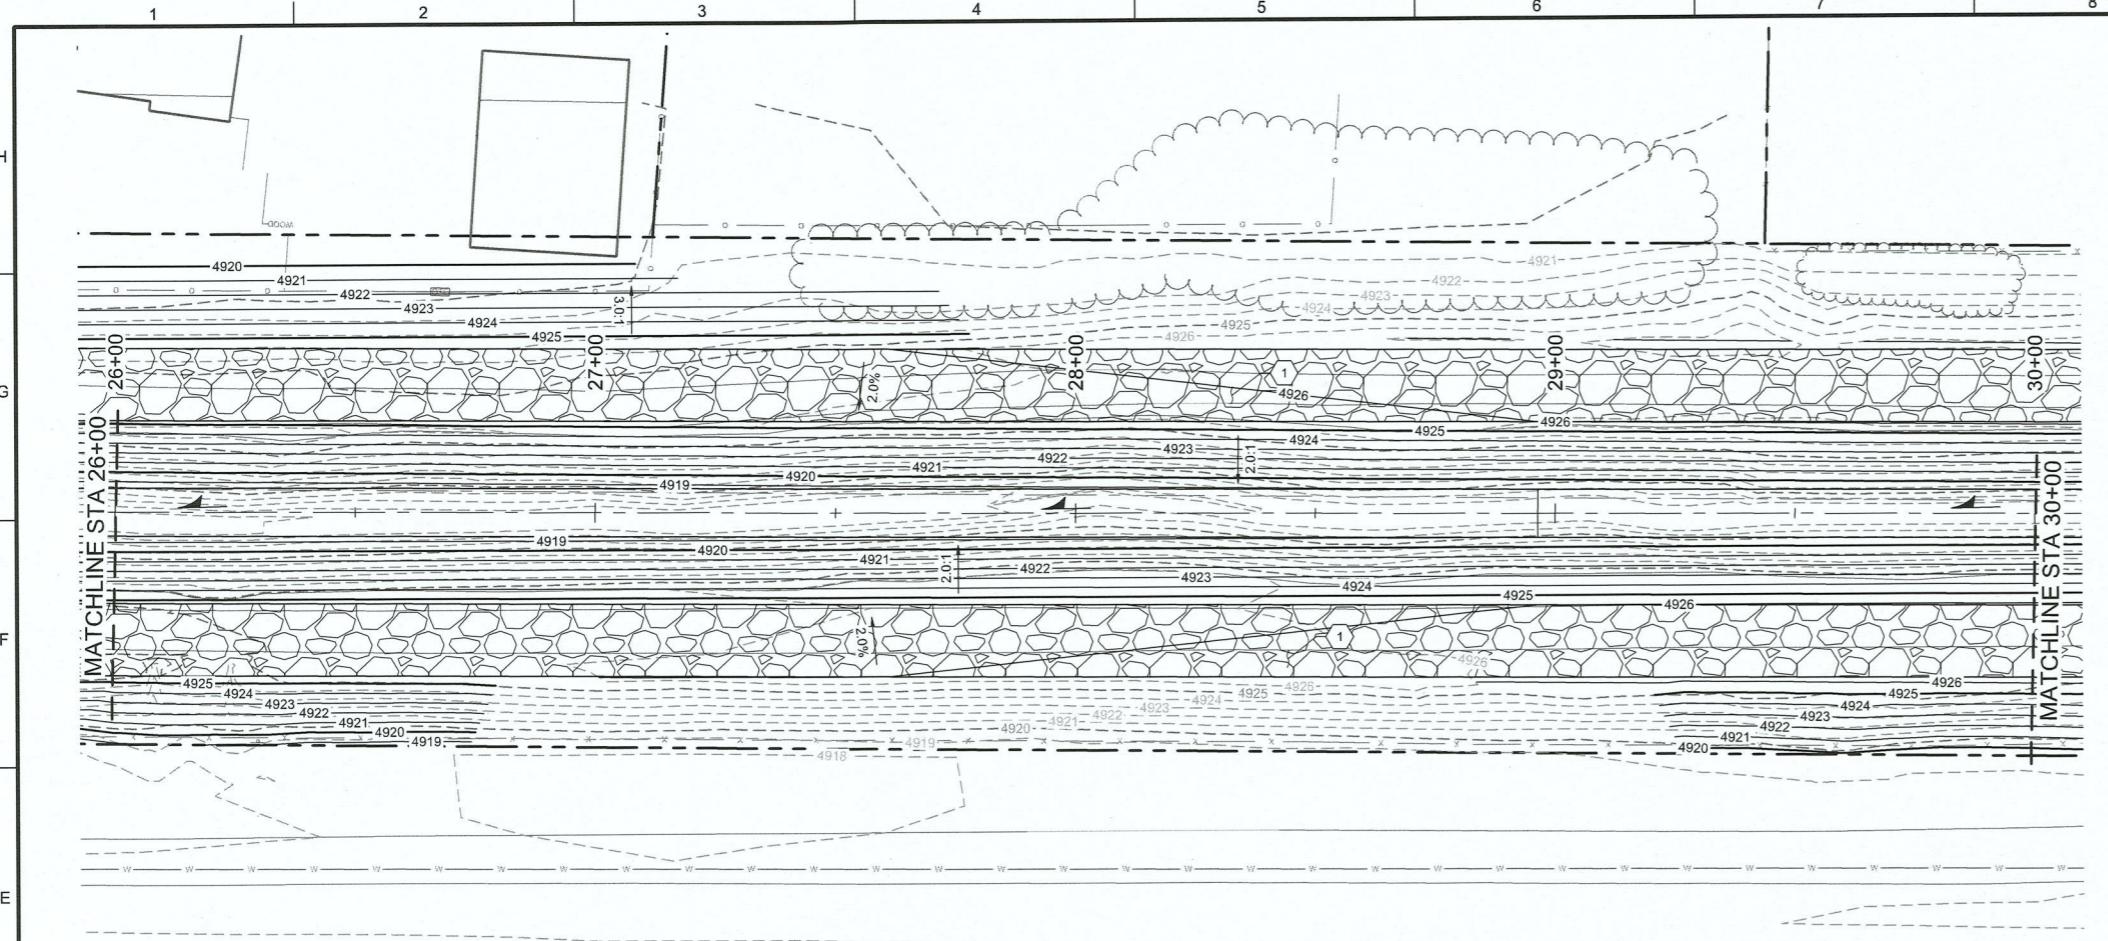

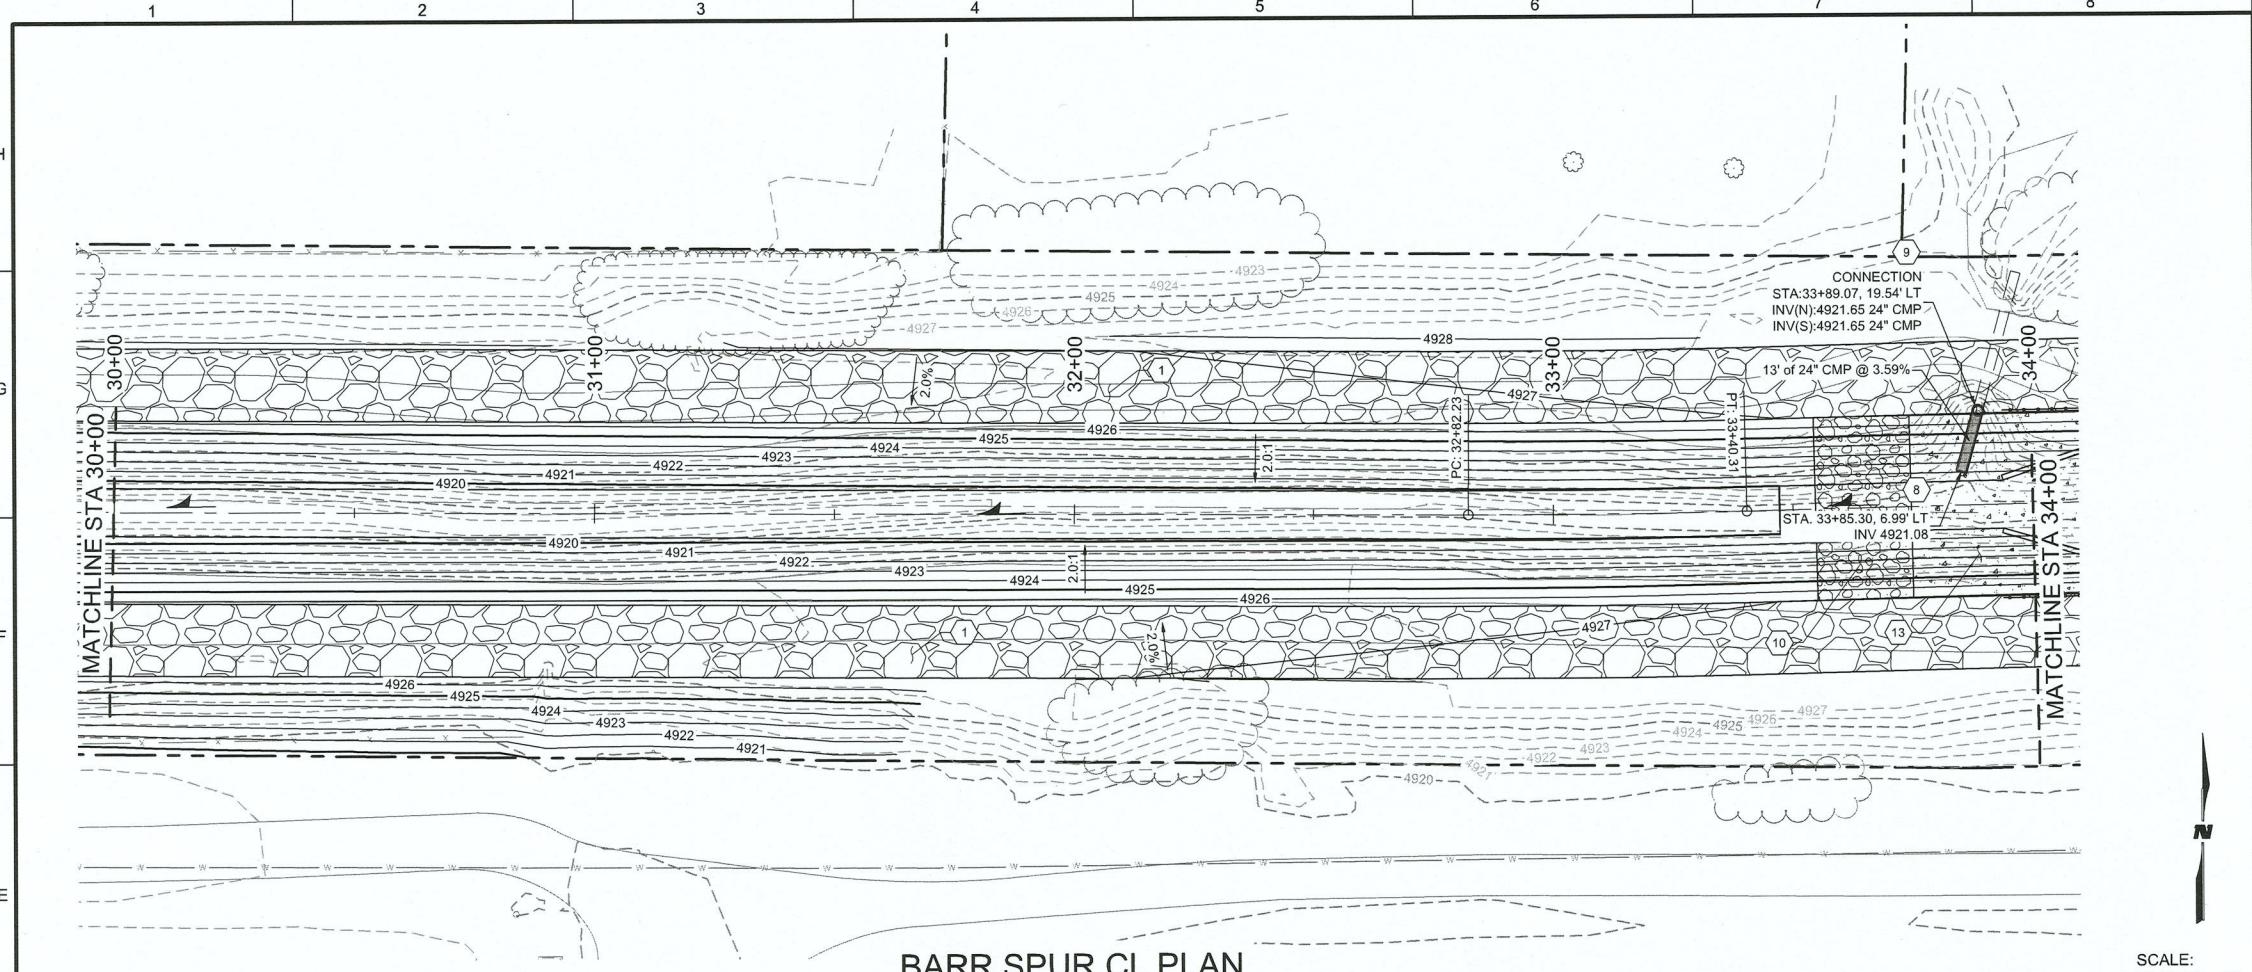

### GENERAL SHEET NOTES

- GENERAL SHEET NOTES.


**WILSON & COMPANY**

4401 ALBUQUERQUE ST. NE, SUITE 150  
ALBUQUERQUE, NM 87109  
PHONE: 505-348-4000  
FAX: 505-348-4072  
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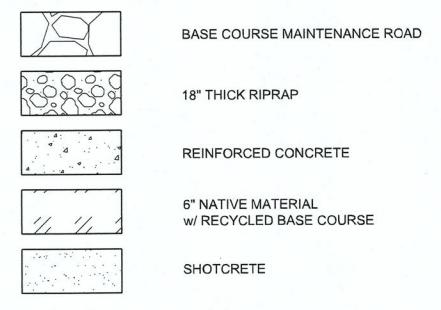
### BARR SPUR IMPROVEMENTS

60% SUBMITAL  
NOT FOR  
CONSTRUCTION

PROJECT NAME	REV.	DATE	DESCRIPTION	BY

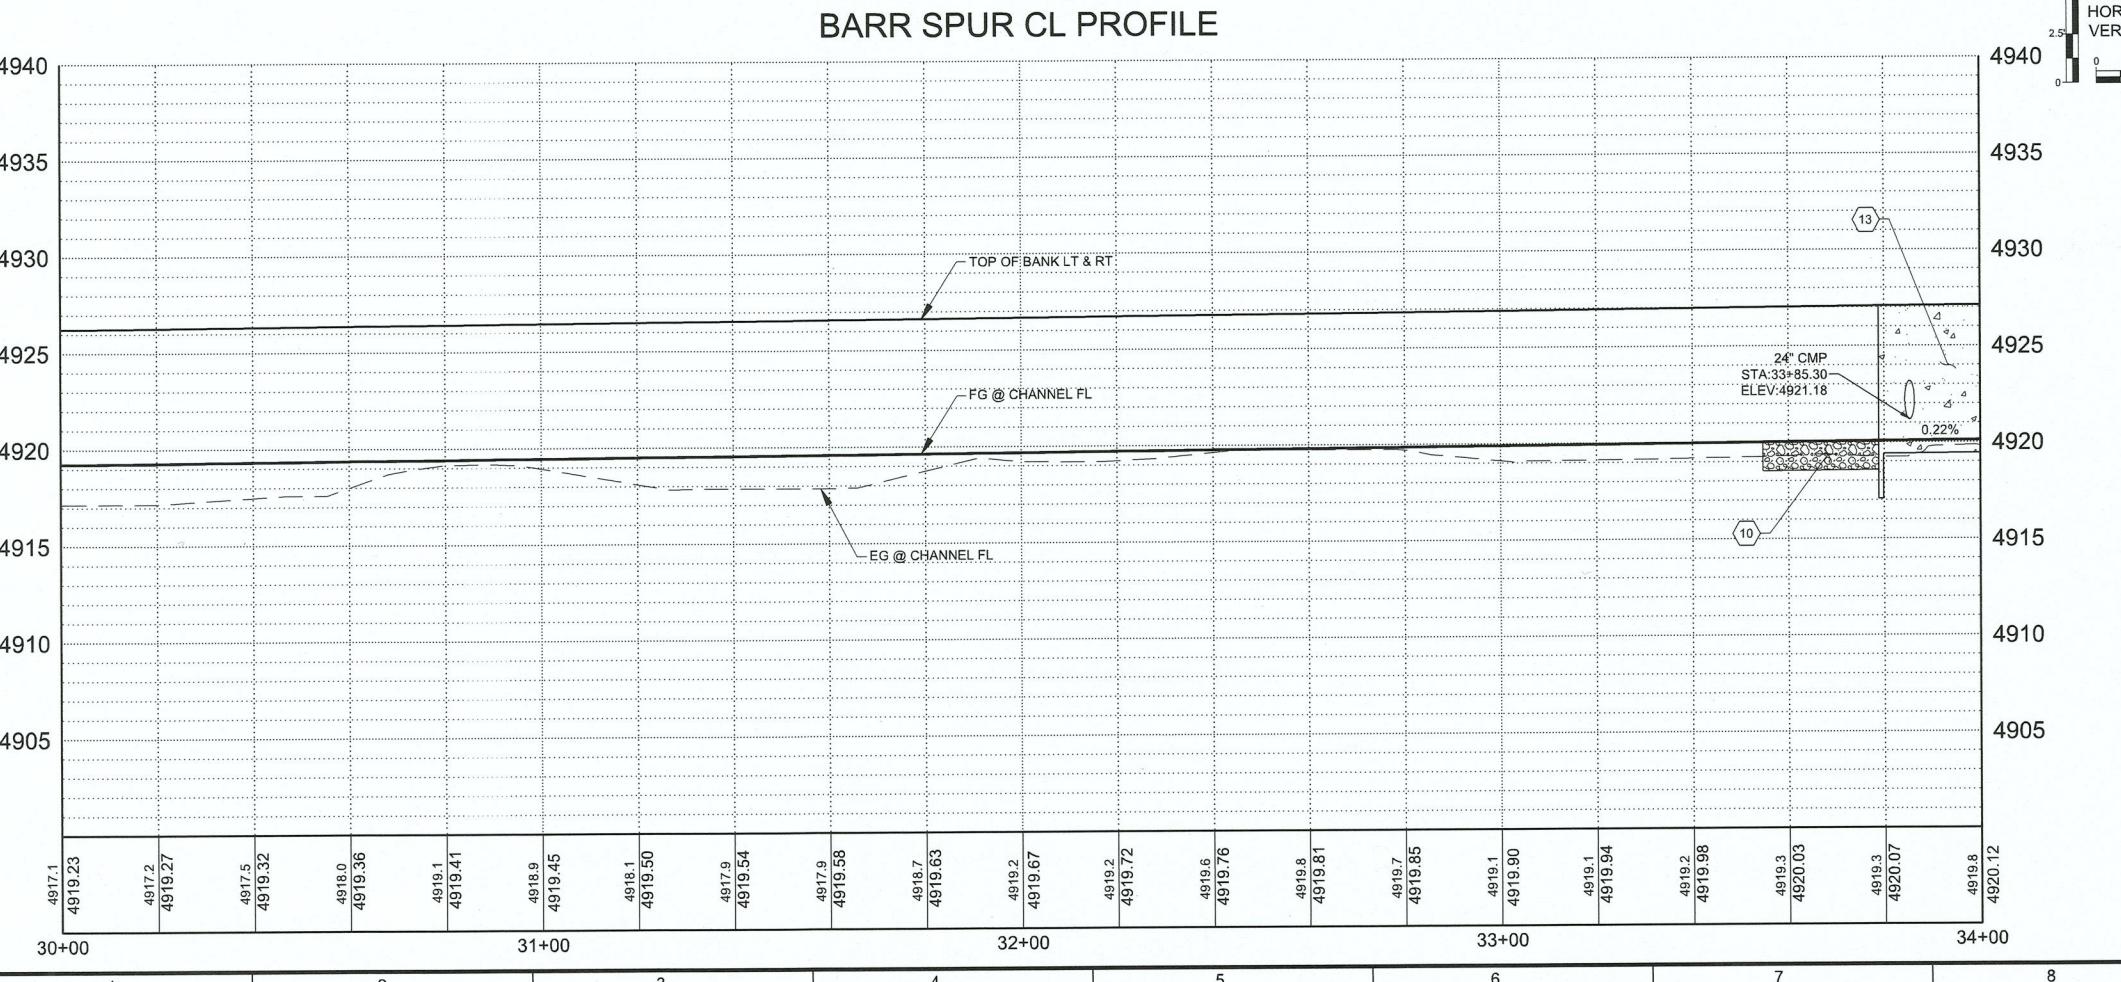


### LEGEND



PROJECT NO: 1660060700  
DESIGNED BY: TJA  
DRAWN BY: JEM  
CHECKED BY: TJA  
DATE: JAN 2022  
SHEET TITLE

BARR SPUR  
PLAN & PROFILE

SHEET NO: C-406

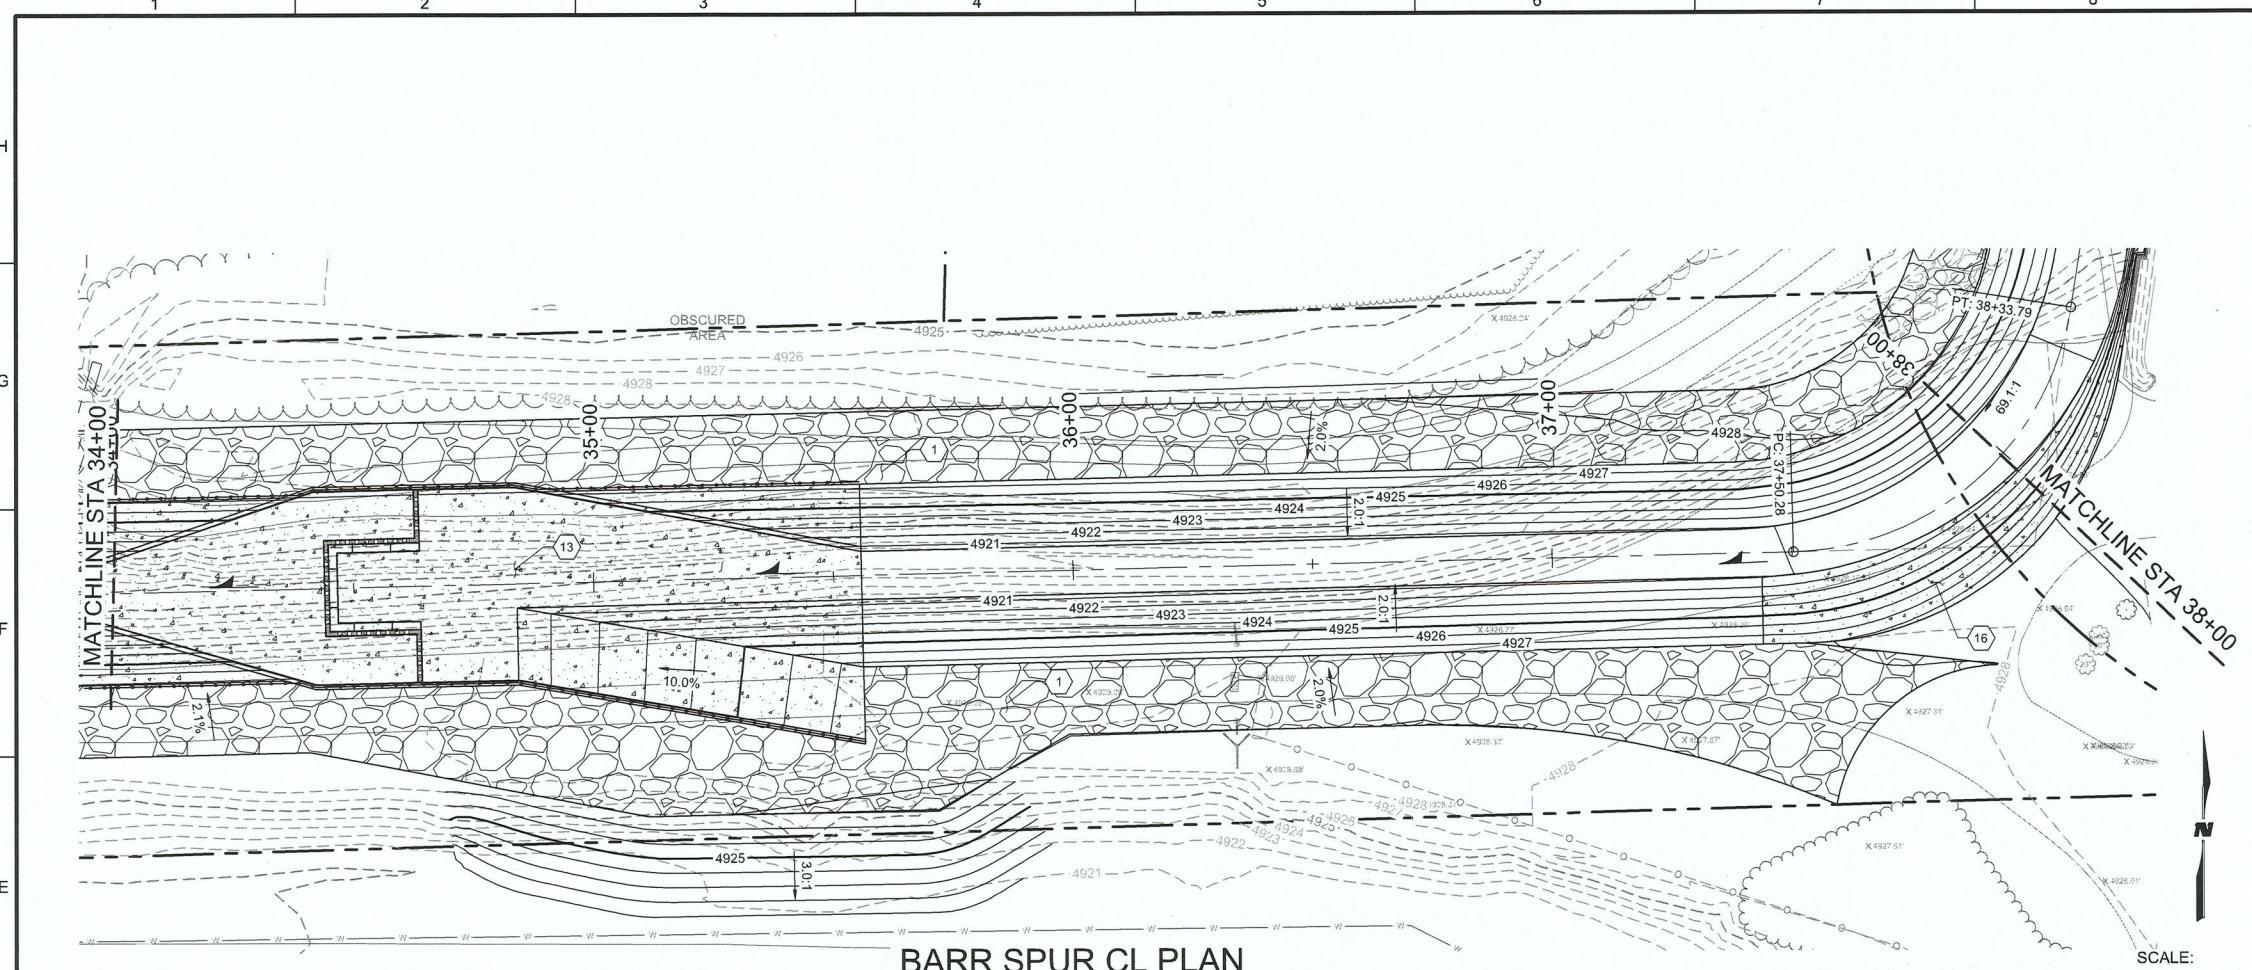


SCALE:

PLAN: 1" = 20'


PROFILE:

HORIZ: 1" = 20'

VERT: 1" = 5'

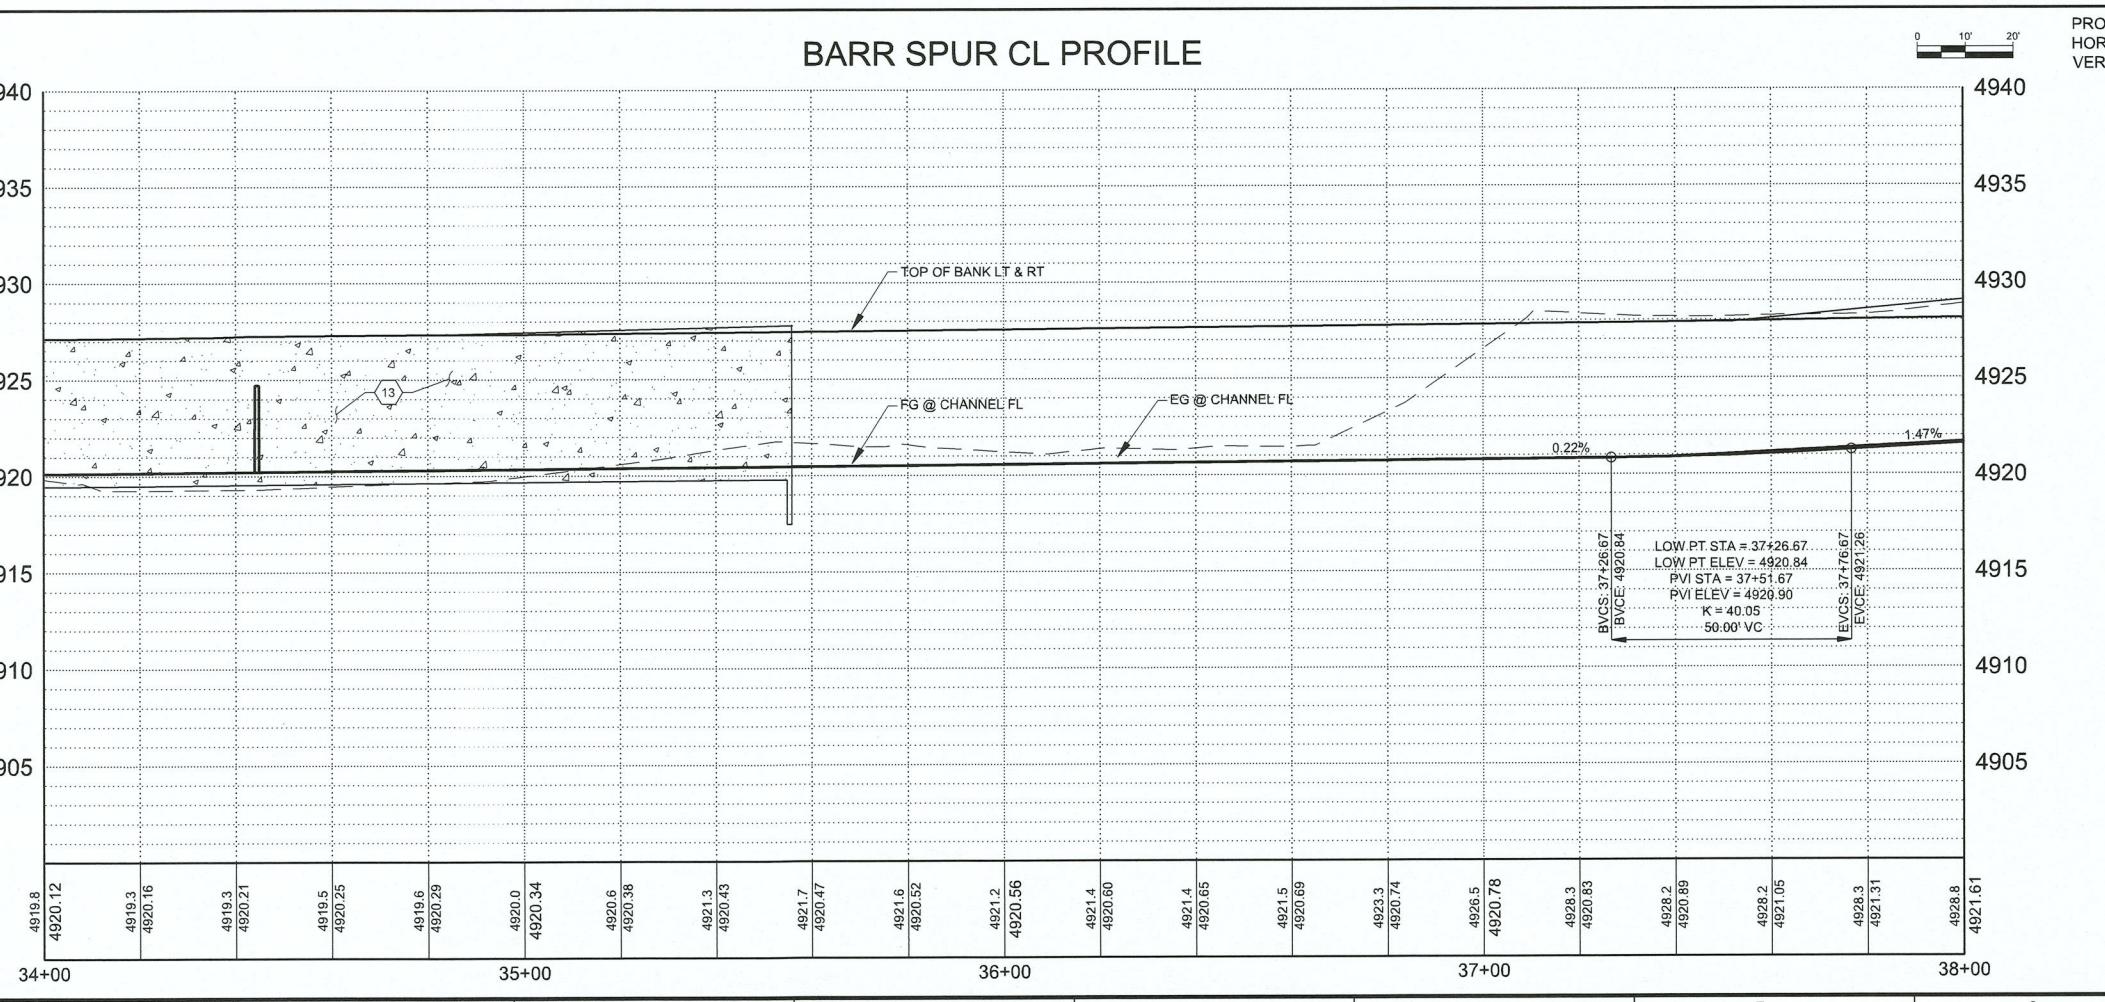
**BARR SPUR CL PROFILE**



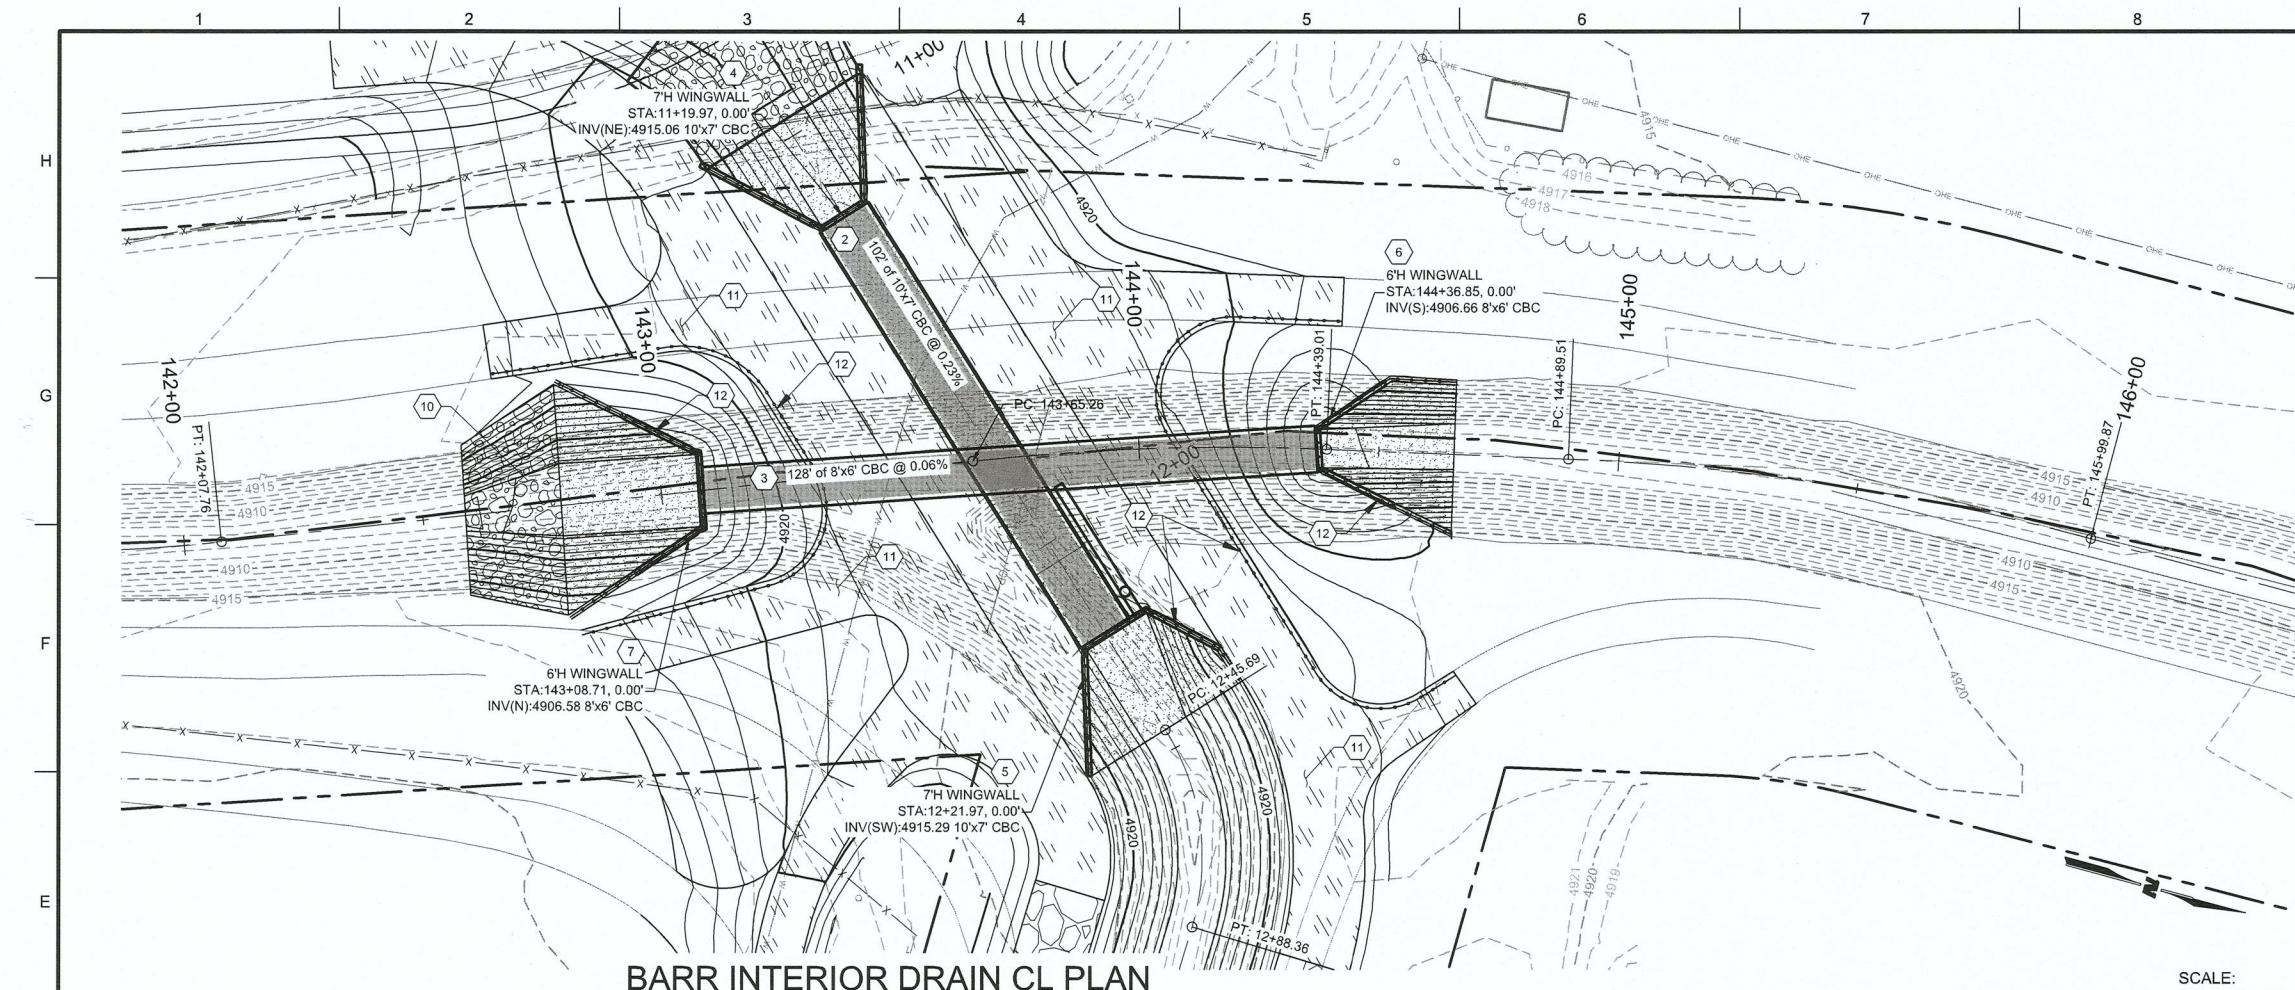

## BARR INTERIOR DRAIN CL PLAN

SCALE:  
PLAN: 1" = 20'

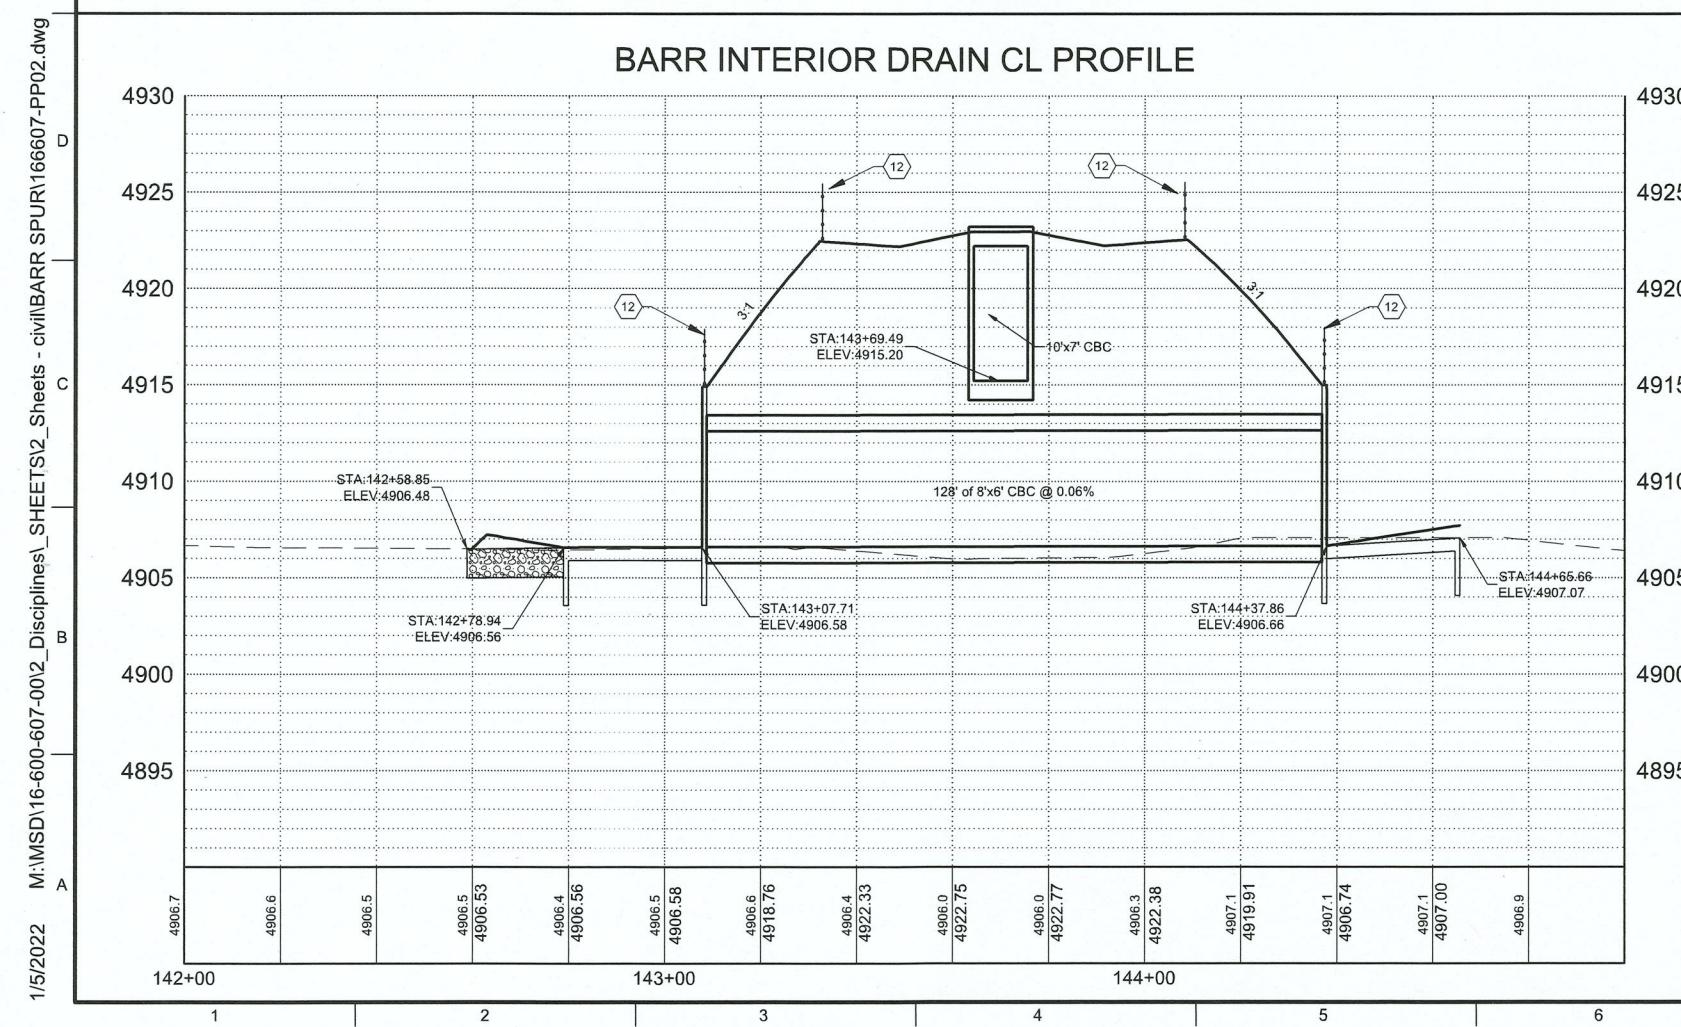

## BARR INTERIOR DRAIN CL PROFILE

5'  
2.5'  
0 10' 20'

PROFILE:  
HORIZ: 1" = 20'  
VERT: 1" = 5'



**LEGEND**



## BASE COURSE MAINTENANCE ROAD



### 18" THICK RIPRAP

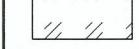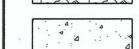

#### SHOTCRETE



### FLOW ARROW

## BARR SPUR IMPROVEMENTS

4401 MASTHEAD ST. NE SUITE 150  
ALBUQUERQUE, NM 87109  
PHONE: 505-348-4000  
FAX: 505-348-4017

PHONE: 505-348-4000  
FAX: 505-348-4072  
[www.wilsonco.com](http://www.wilsonco.com)

## GENERAL SHEET NOTES

1. SEE SHEETS C-106 & C-107 FOR ADDITIONAL GRADING AT CBC CROSSINGS.

 KEYNOTES

1. CONSTRUCT 6" THICK CONCRETE BASE COURSE MAINTENANCE ROAD. SEE DETAIL H9/C-501.

2. CONSTRUCT 10'W x7'H x102'L CBC. SEE SHEETS C-511 THRU C-514.

3. CONSTRUCT 8'W x 6'H x128'L CBC. SEE SHEETS C-511 THRU C-514.

4. CONSTRUCT WINGWALL 'A' FOR 10'W x7'H CBC. SEE DETAIL A6/C-506.

5. CONSTRUCT WINGWALL 'B' FOR 10'W x7'H CBC. SEE SHEETS A1/C-506.

6. CONSTRUCT WINGWALL 'C' FOR 8'W x6'H CBC. SEE SHEETS A1/C-507.

7. CONSTRUCT WINGWALL 'D' FOR 8'W x6'H CBC. SEE SHEETS A6/C-507.

8. INSTALL 24" CMP w/ PIPE PENETRATION. SEE SHEET C-502.

9. INSTALL PIPE TO PIPE CONNECTION. SEE DETAIL D8/C-501.

10. INSTALL 18" THICK RIPRAP. SEE DETAIL F8/C-501.

11. CONSTRUCT NATIVE MATERIAL BASE COURSE. SEE SHEET A5/C-501.


12. INSTALL PIPE RAILING. SEE SHEET C-503.

13. CONSTRUCT WATER QUALITY STRUCTURE. SEE SHEETS C-508 THRU C-510.

14. INSTALL 18" RCP w/ PIPE PENETRATION INTO 8'x6' CBC. SEE "OUTER WALL PENETRATION DETAIL" ON SHEET C-517.


15. CONSTRUCT CONCRETE ACCESS RAMP. SEE SHEET C-504.

16. CONSTRUCT SHOTCRETE PAVING. SEE DETAIL XX.

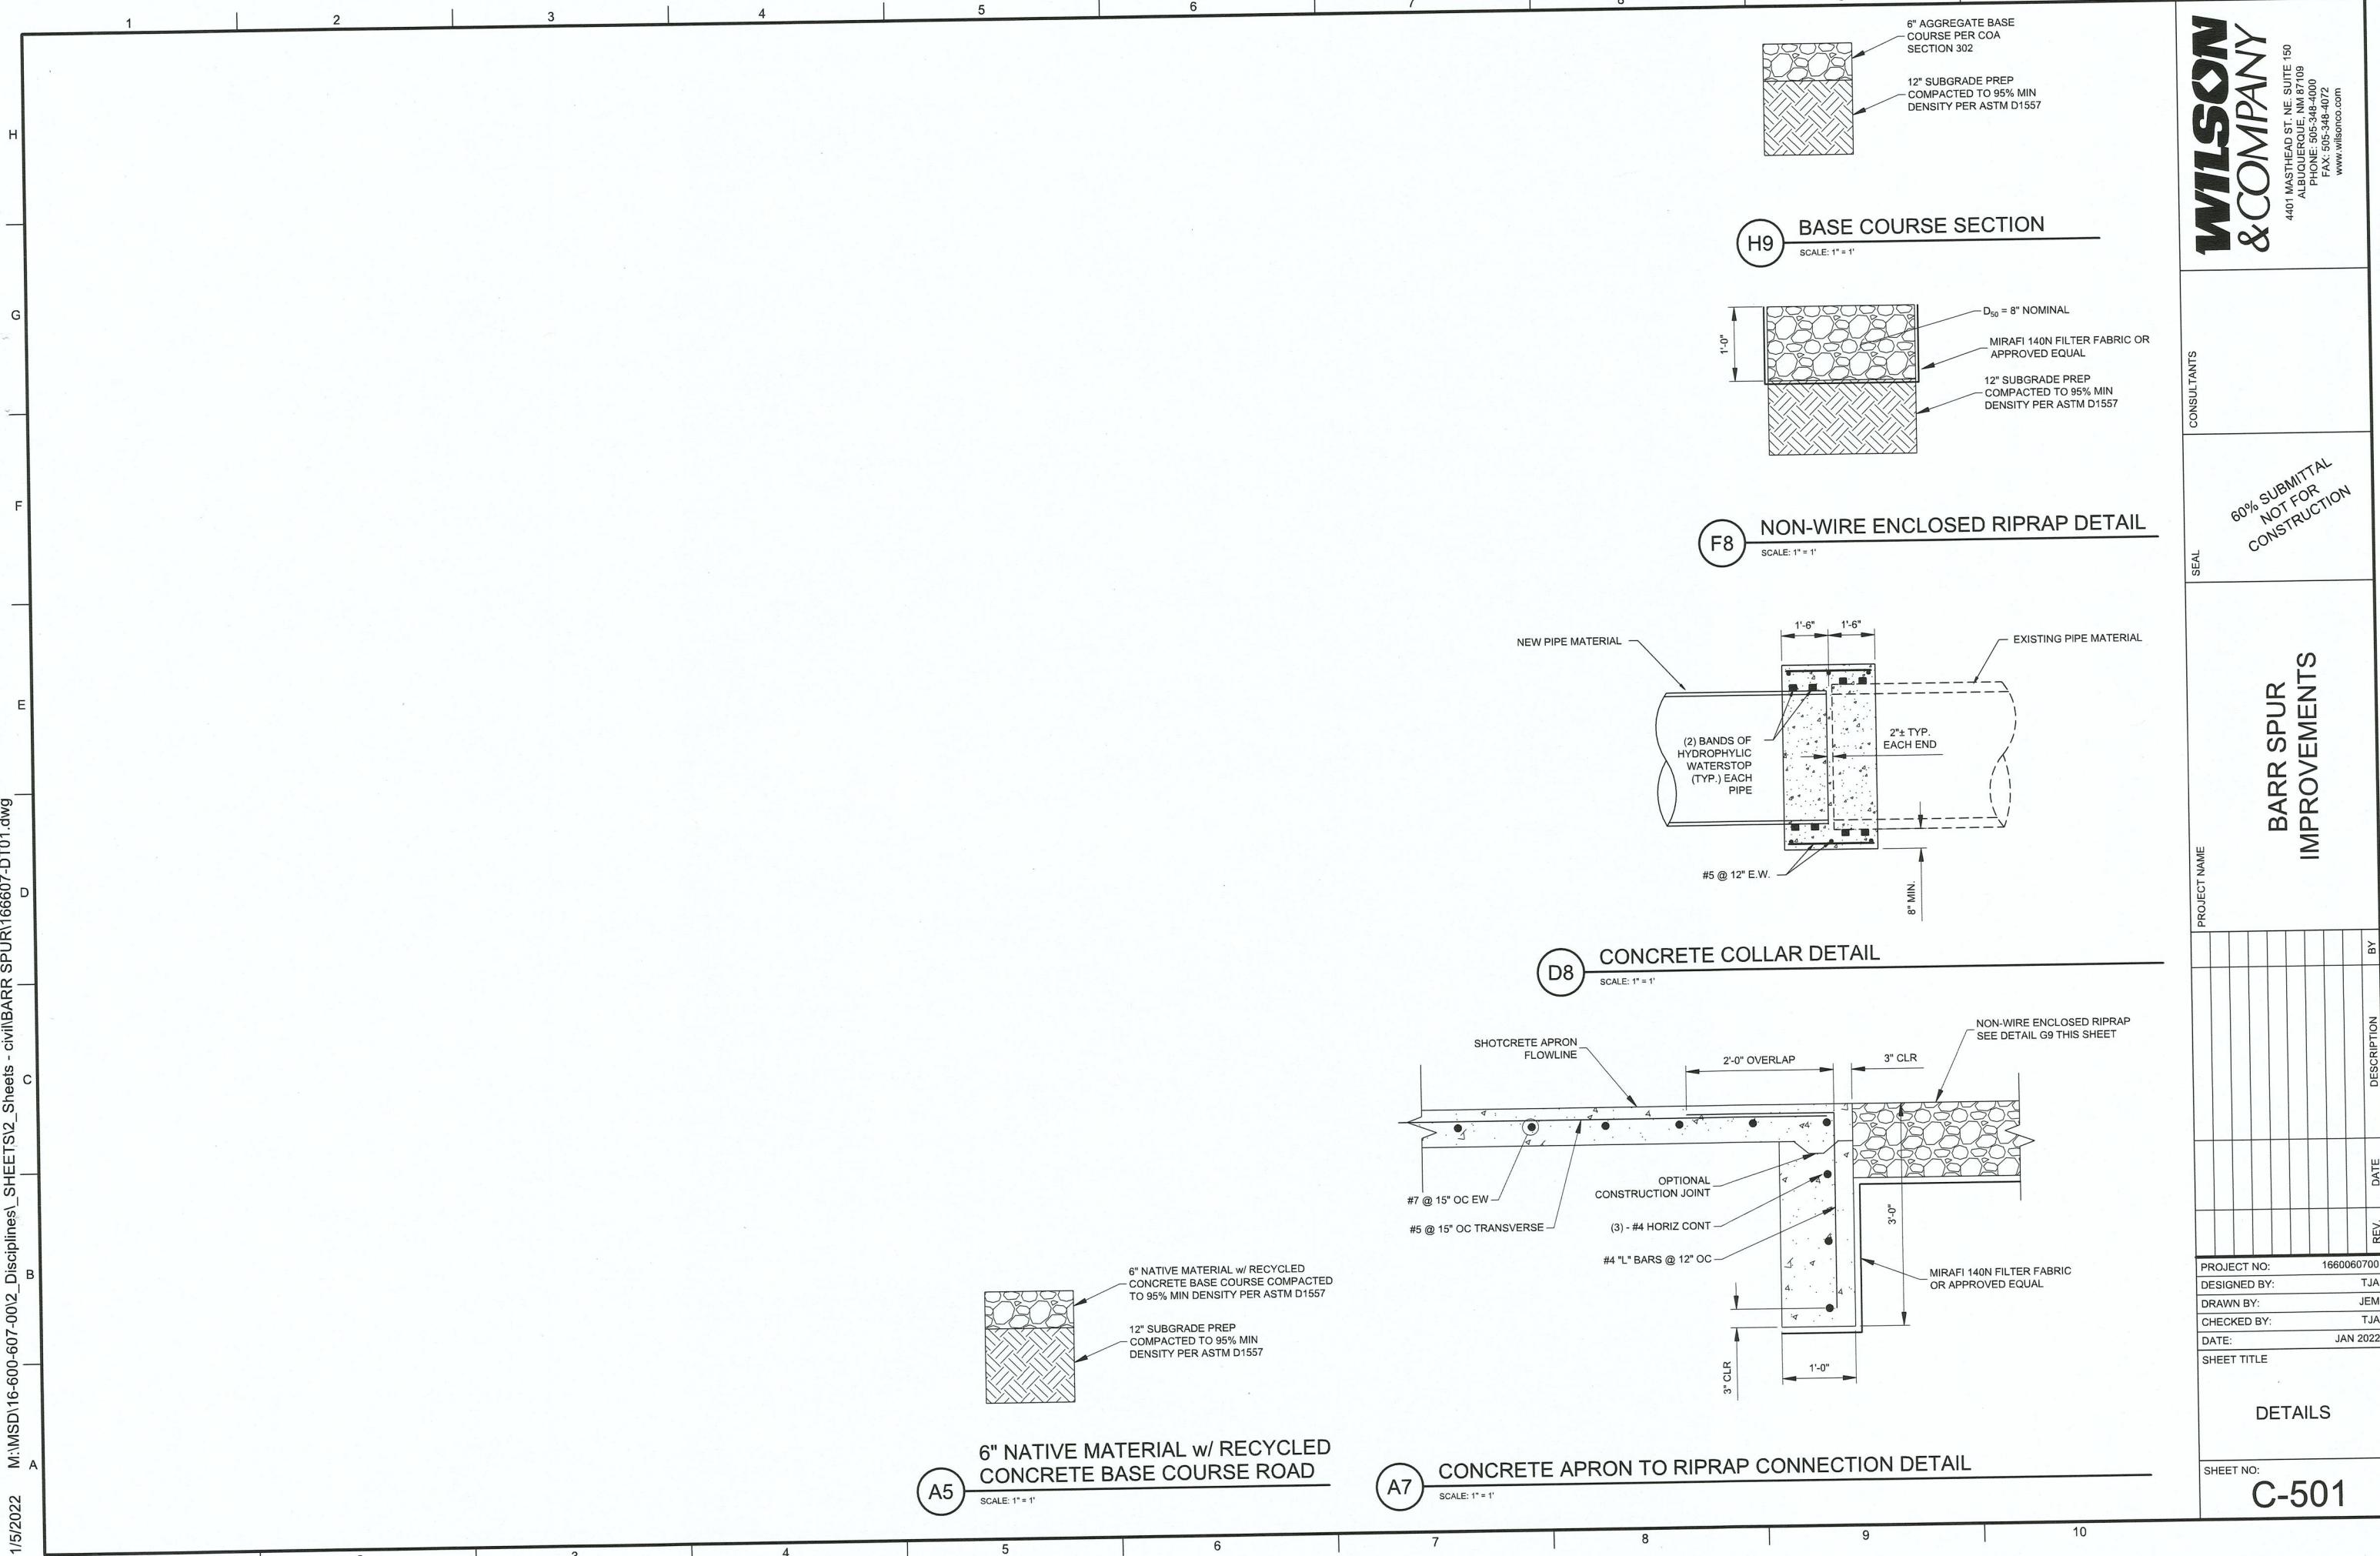






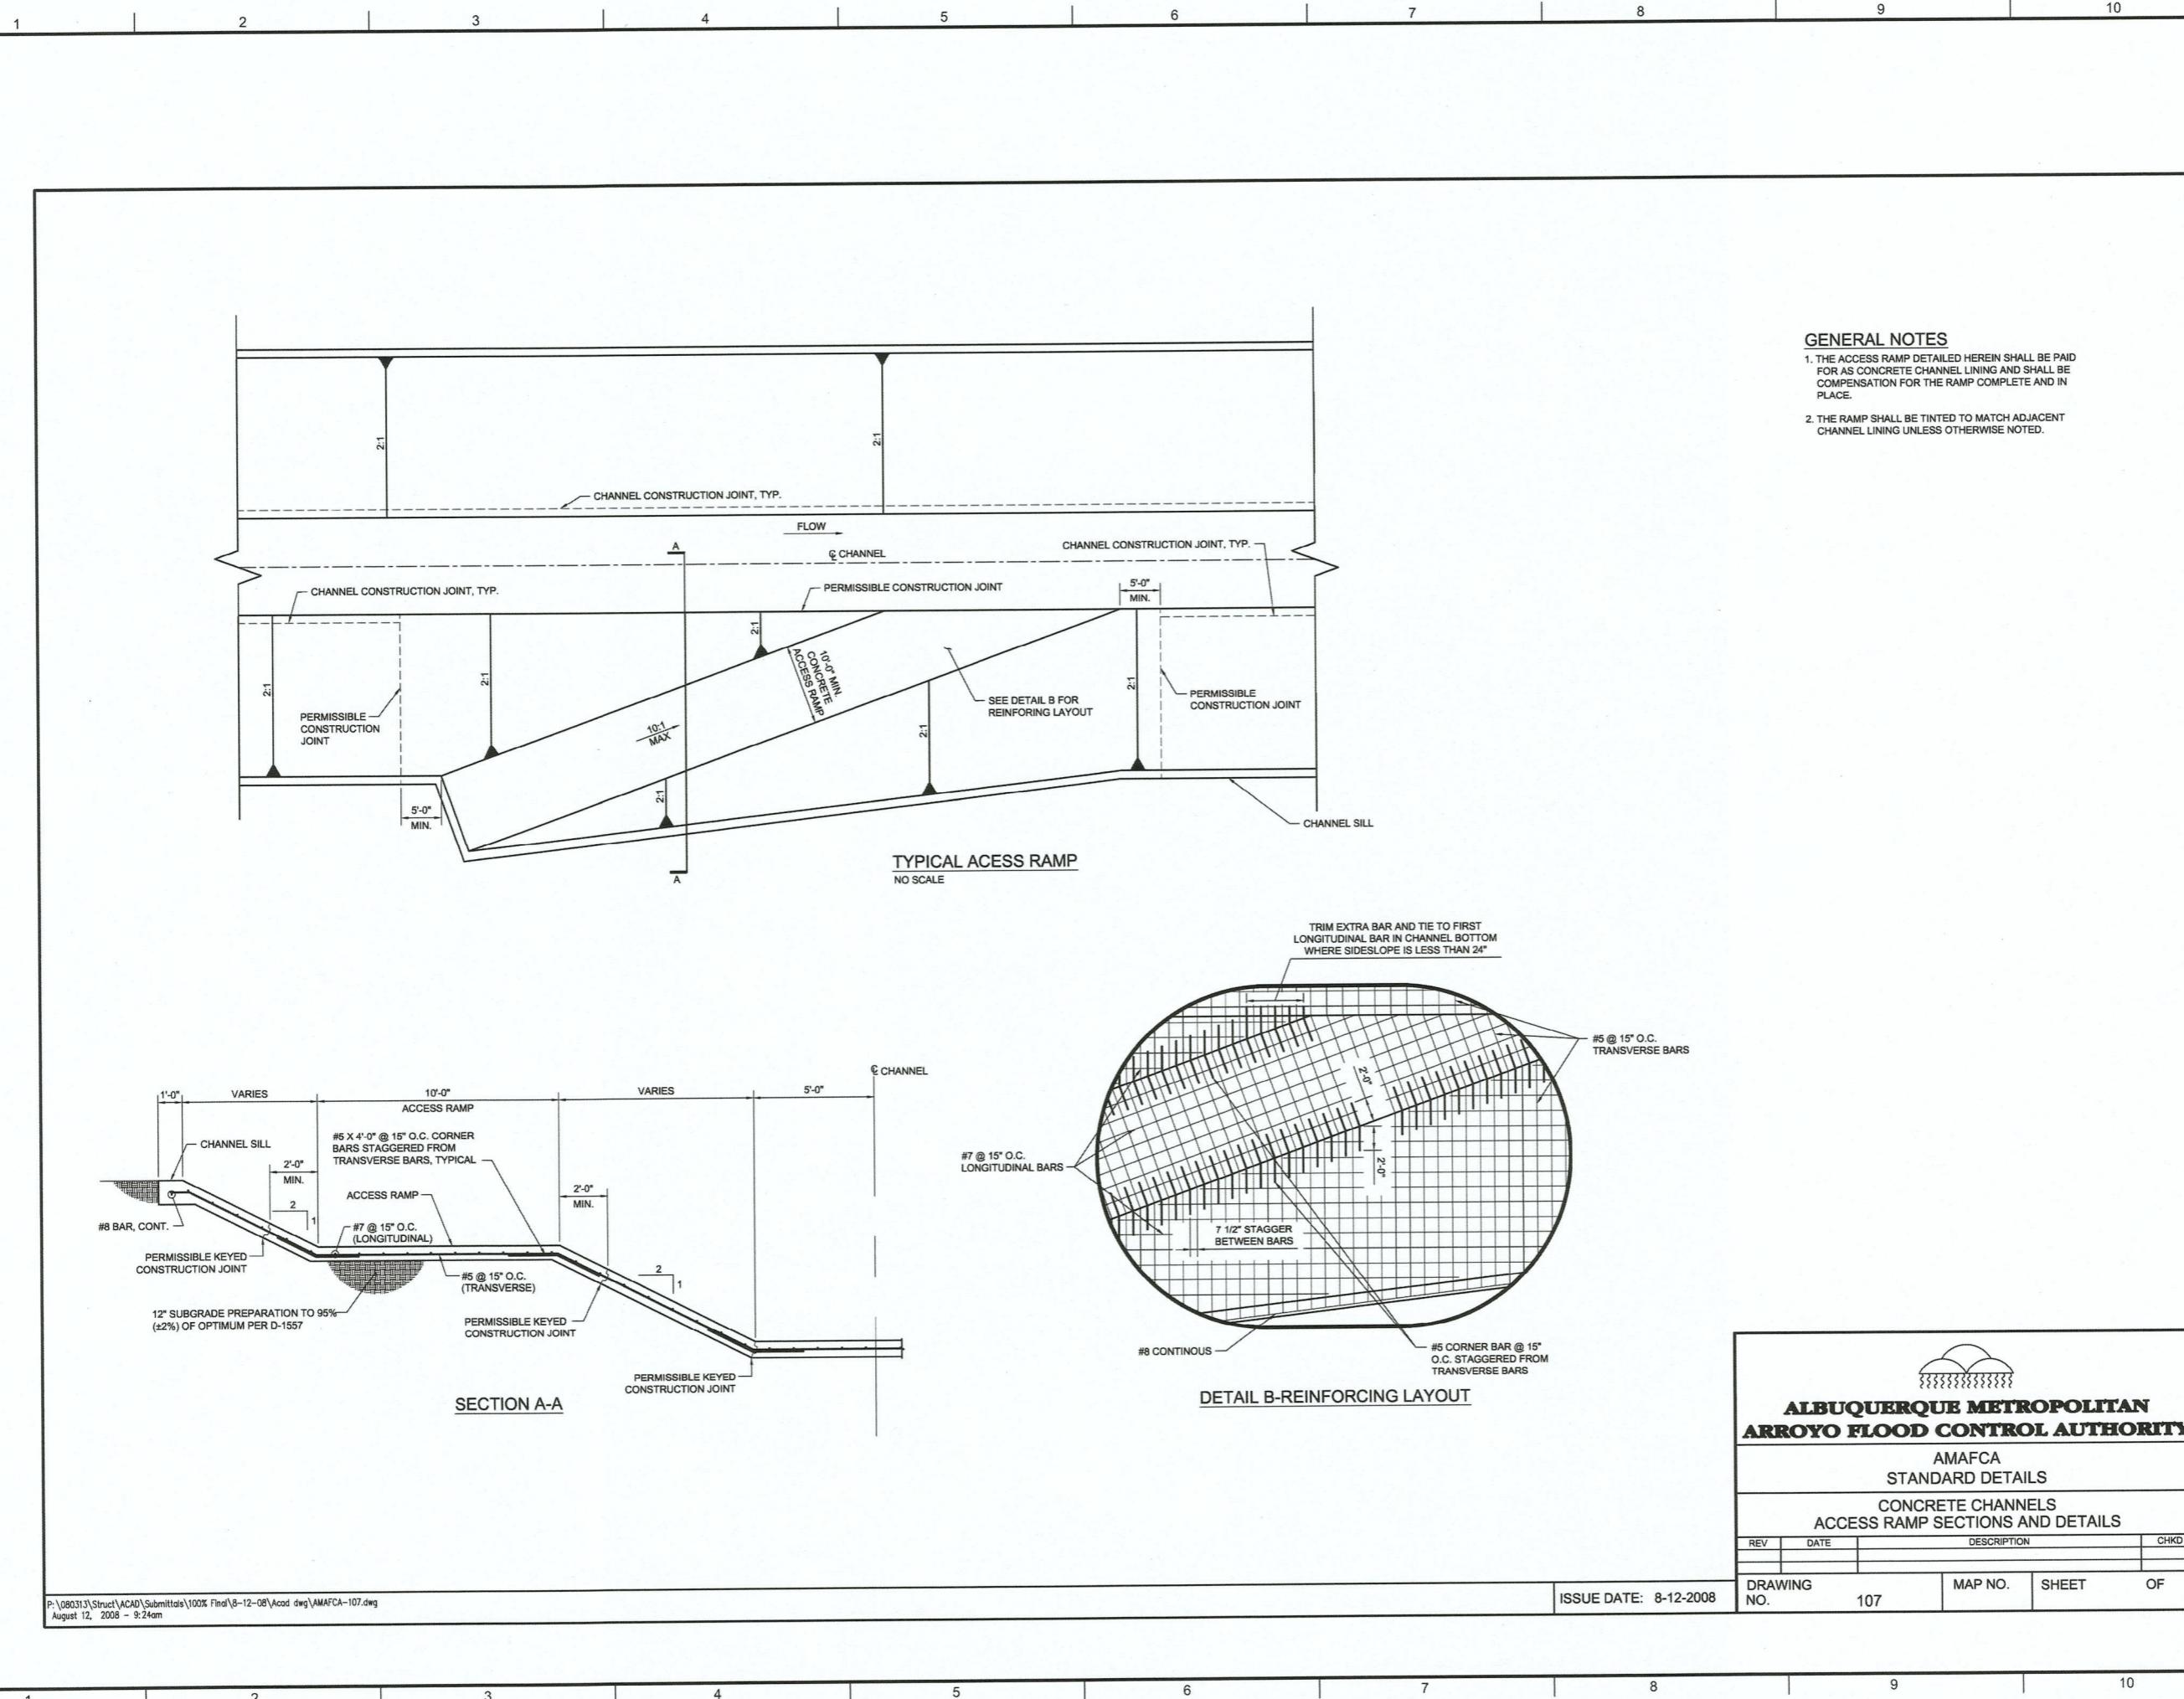

1	2	3	4	5	6	7	8	9	10
<b>WILSON &amp; COMPANY</b> 4401 MASTHEAD ST. NE, SUITE 150 ALBUQUERQUE, NM 87109 PHONE: 505-348-4000 FAX: 505-348-4072 www.wilsonco.com									
<b>60% SUBMITTAL NOT FOR CONSTRUCTION</b>									
SEAL	CONSULTANTS								
<b>BARR SPUR IMPROVEMENTS</b>									
PROJECT NAME BY									
REV. DATE DESCRIPTION BY									
PROJECT NO: 1660060700 DESIGNED BY: TJA DRAWN BY: JEM CHECKED BY: TJA DATE: JAN 2022 SHEET TITLE <b>DETAILS</b> SHEET NO: C-504									

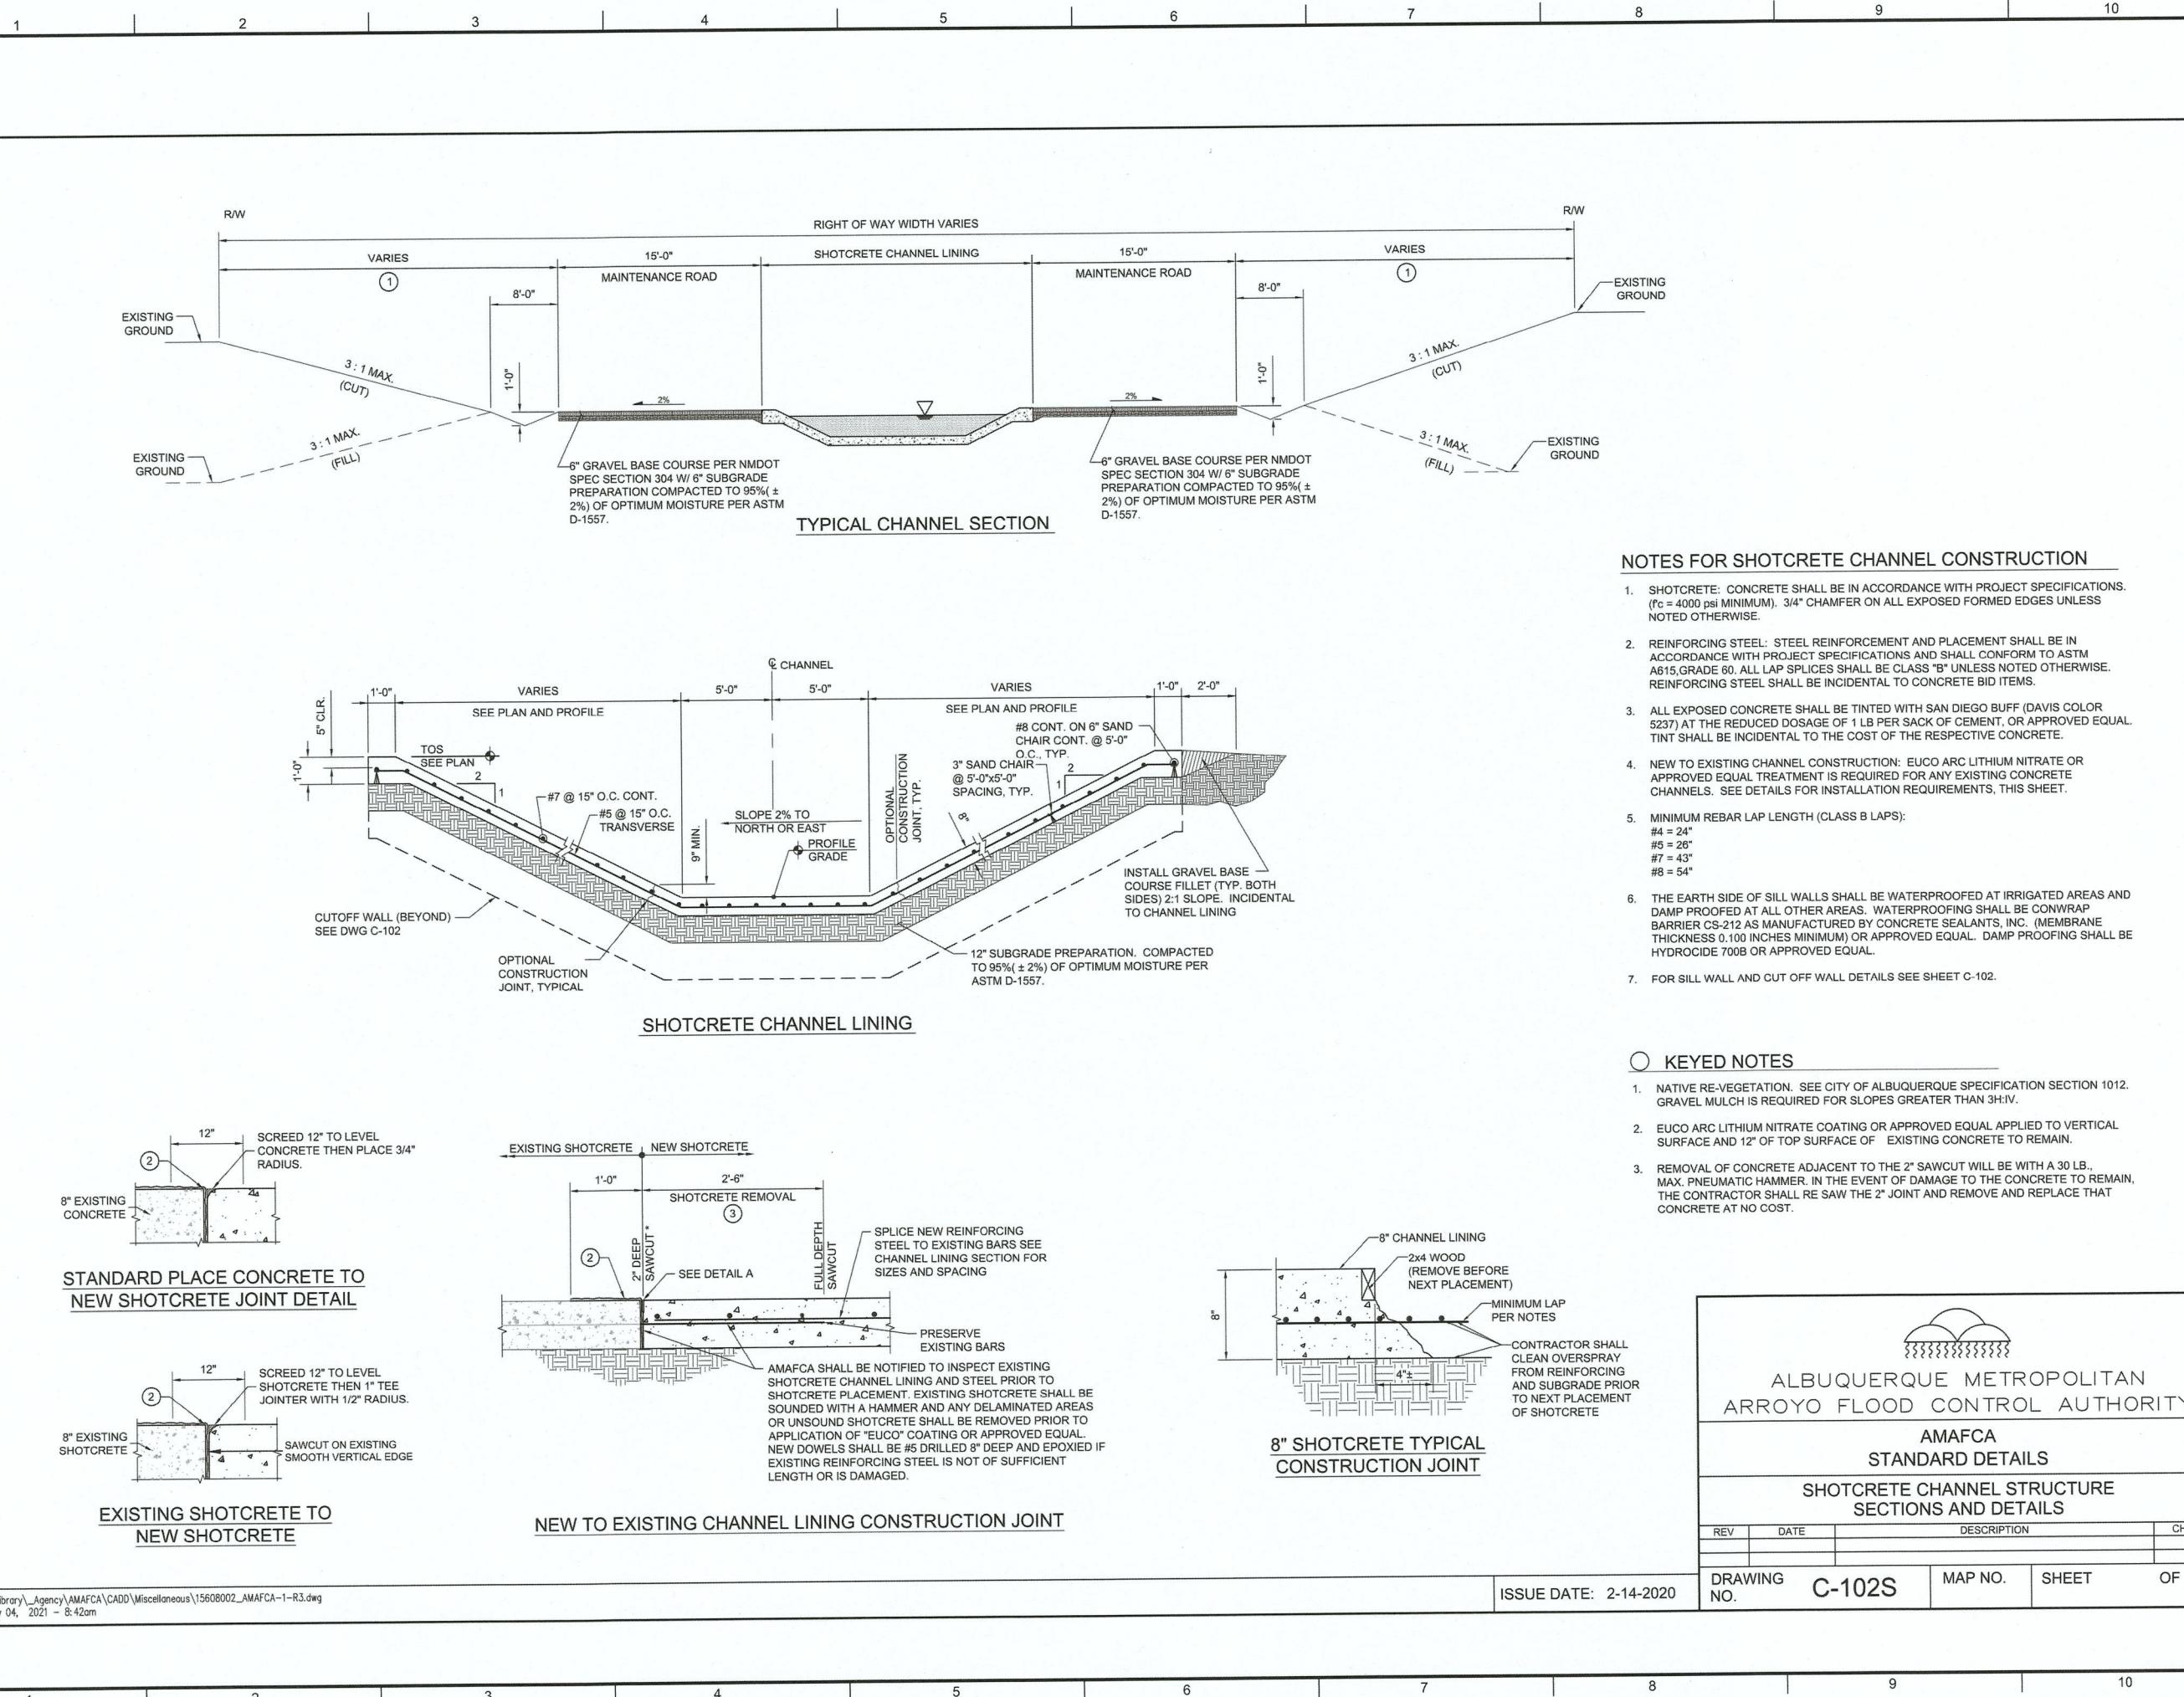

PROJECT NO.	166606700	REV.	
DESIGNED BY:	TJA		
DRAWN BY:	JEM		
CHECKED BY:	TJA		
DATE:	JAN 2022		
SHEET TITLE			

## BARR SPUR IMPROVEMENTS

60% SUBMITTAL  
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**WILSON & COMPANY**

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PHONE: 505-348-4000  
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www.wilsonco.com

C-505

## **GENERAL SHEET NOTES**

1. FOR CONCRETE BOX CULVERTS, REFER TO SHEETS ##### THRU C-514.
  2. FOR HEADWALL/CUT-OFF WALLS, REFER TO SHEET C-515 THRU C-516.
  3. FOR WINGWALL DIMENSIONS, REFER TO THIS SHEET. FOR WINGWALL NOTES AND REBAR REINFORCEMENT, REFER TO SHEETS C-518 THRU C-519.
  4. FOR 18" RCP PENETRATION ON HEADWALL, SEE "OUTER WALL PENETRATION DETAIL" ON SHEET C-517.
  5. 18" RCP SHALL HAVE TURNOUT INSTALLED @ HEADWALL. TURNOUT WILL BE 18" TYPE III WITH 18" FRESNO GATE MODEL 101C

WEISER  
& COMPANY  
4401 MASTHEAD ST. NE, SUITE 150  
ALBUQUERQUE, NM 87109  
PHONE: 505-348-4000  
FAX: 505-348-4072

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[www.wilsonco.com](http://www.wilsonco.com)

## BARR SPUR IMPROVEMENTS

60% SUBMITTAL  
NOT FOR  
CONSTRUCTION

11

BY

DESCRIPTION

ATE

CT NO: 1660060700  
NED BY: TJA  
N BY: JEM  
ED BY: TJA

JAN 2022

**DETAILS**

1 2 3 4 5 6 7 8 9 10

## GENERAL SHEET NOTES

1. FOR CONCRETE BOX CULVERTS, REFER TO SHEETS ##### THRU C-514.
2. FOR HEADWALL/CUT-OFF WALLS, REFER TO SHEET C-515 THRU C-516.
3. FOR WINGWALL DIMENSIONS, REFER TO THIS SHEET. FOR WINGWALL NOTES AND REBAR REINFORCEMENT, REFER TO SHEETS C-518 THRU C-519.

**WILSON**  
& COMPANY


4401 MASTHEAD ST. NE, SUITE 150  
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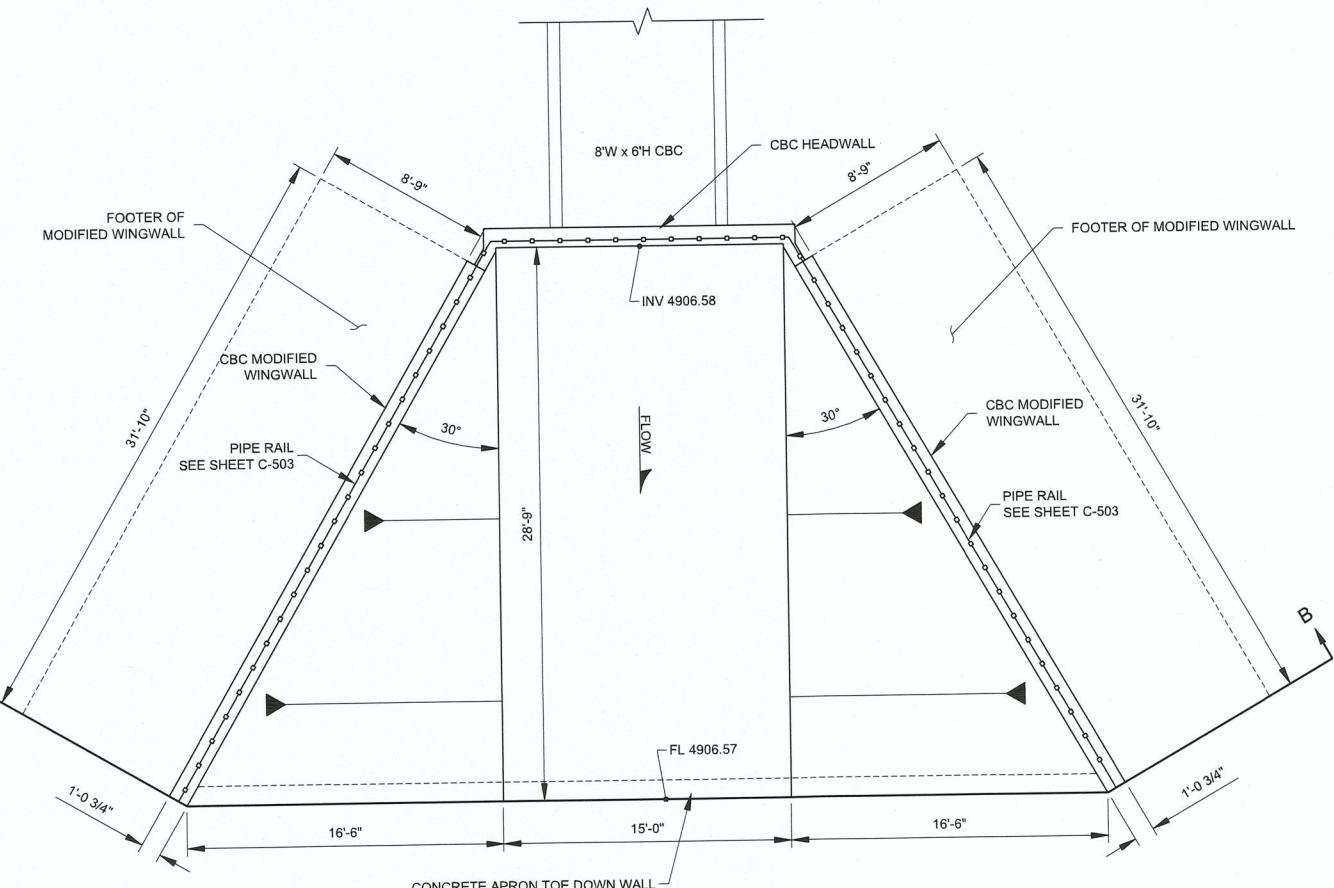
PROJECT NAME	REV.	DATE	DESCRIPTION

PROJECT NO: 1660060700  
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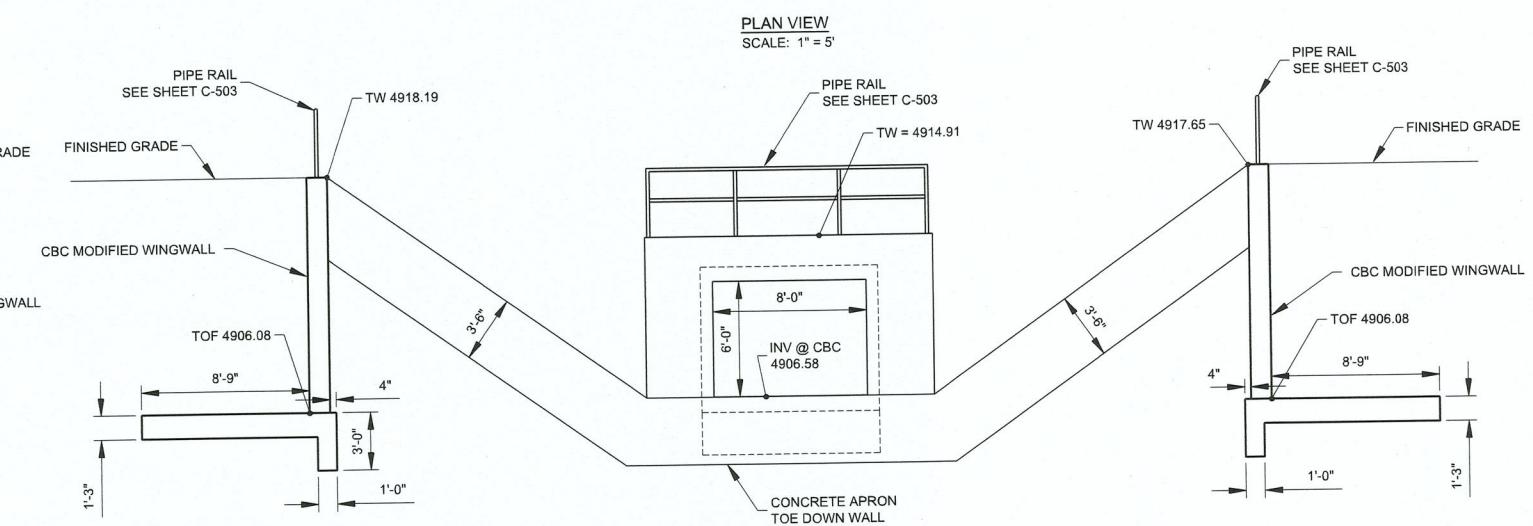
## DETAILS

SHEET NO:  
**C-507**SECTION A-A  
SCALE: 1" = 5'

**A1**  
BARR INTERIOR DRAIN UPSTREAM  
CONCRETE WINGWALL 'C' DETAIL  
SCALE: 1" = 5'

SECTION B-B  
SCALE: 1" = 5'

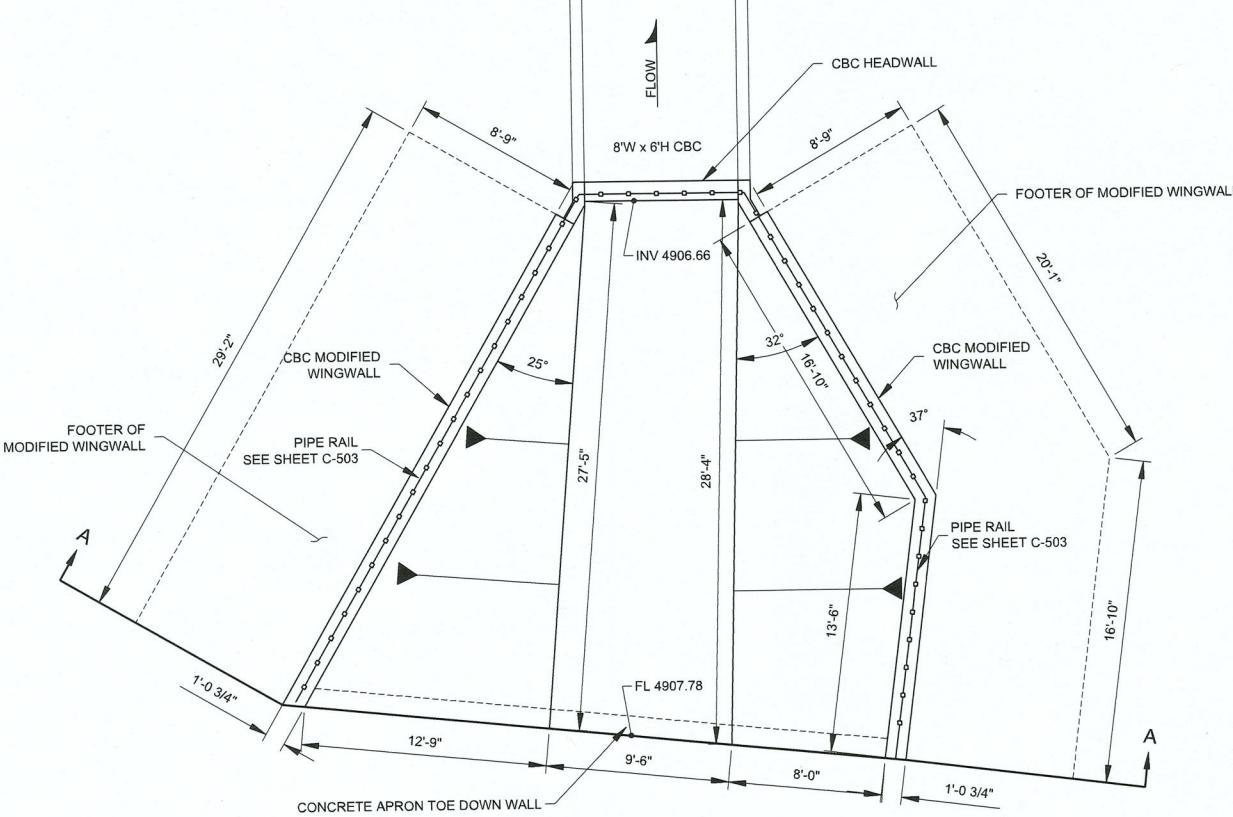**A6**  
BARR INTERIOR DRAIN DOWNSTREAM  
CONCRETE WINGWALL 'D' DETAIL  
SCALE: 1" = 5'

PLAN VIEW  
SCALE: 1" = 5'

PIPE RAIL  
SEE SHEET C-503  
TW 4918.19

FINISHED GRADE  
CBC MODIFIED WINGWALL  
TOF 4906.08  
8'-9"  
4"  
1'-0"  
1'-3"  
CONCRETE APRON  
TOE DOWN WALL

PIPE RAIL  
SEE SHEET C-503  
TW 4917.65  
FINISHED GRADE  
CBC MODIFIED WINGWALL  
TOF 4906.08  
8'-9"  
4"  
1'-0"  
1'-3"

PIPE RAIL  
SEE SHEET C-503  
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FINISHED GRADE  
CBC MODIFIED WINGWALL  
TOF 4906.08  
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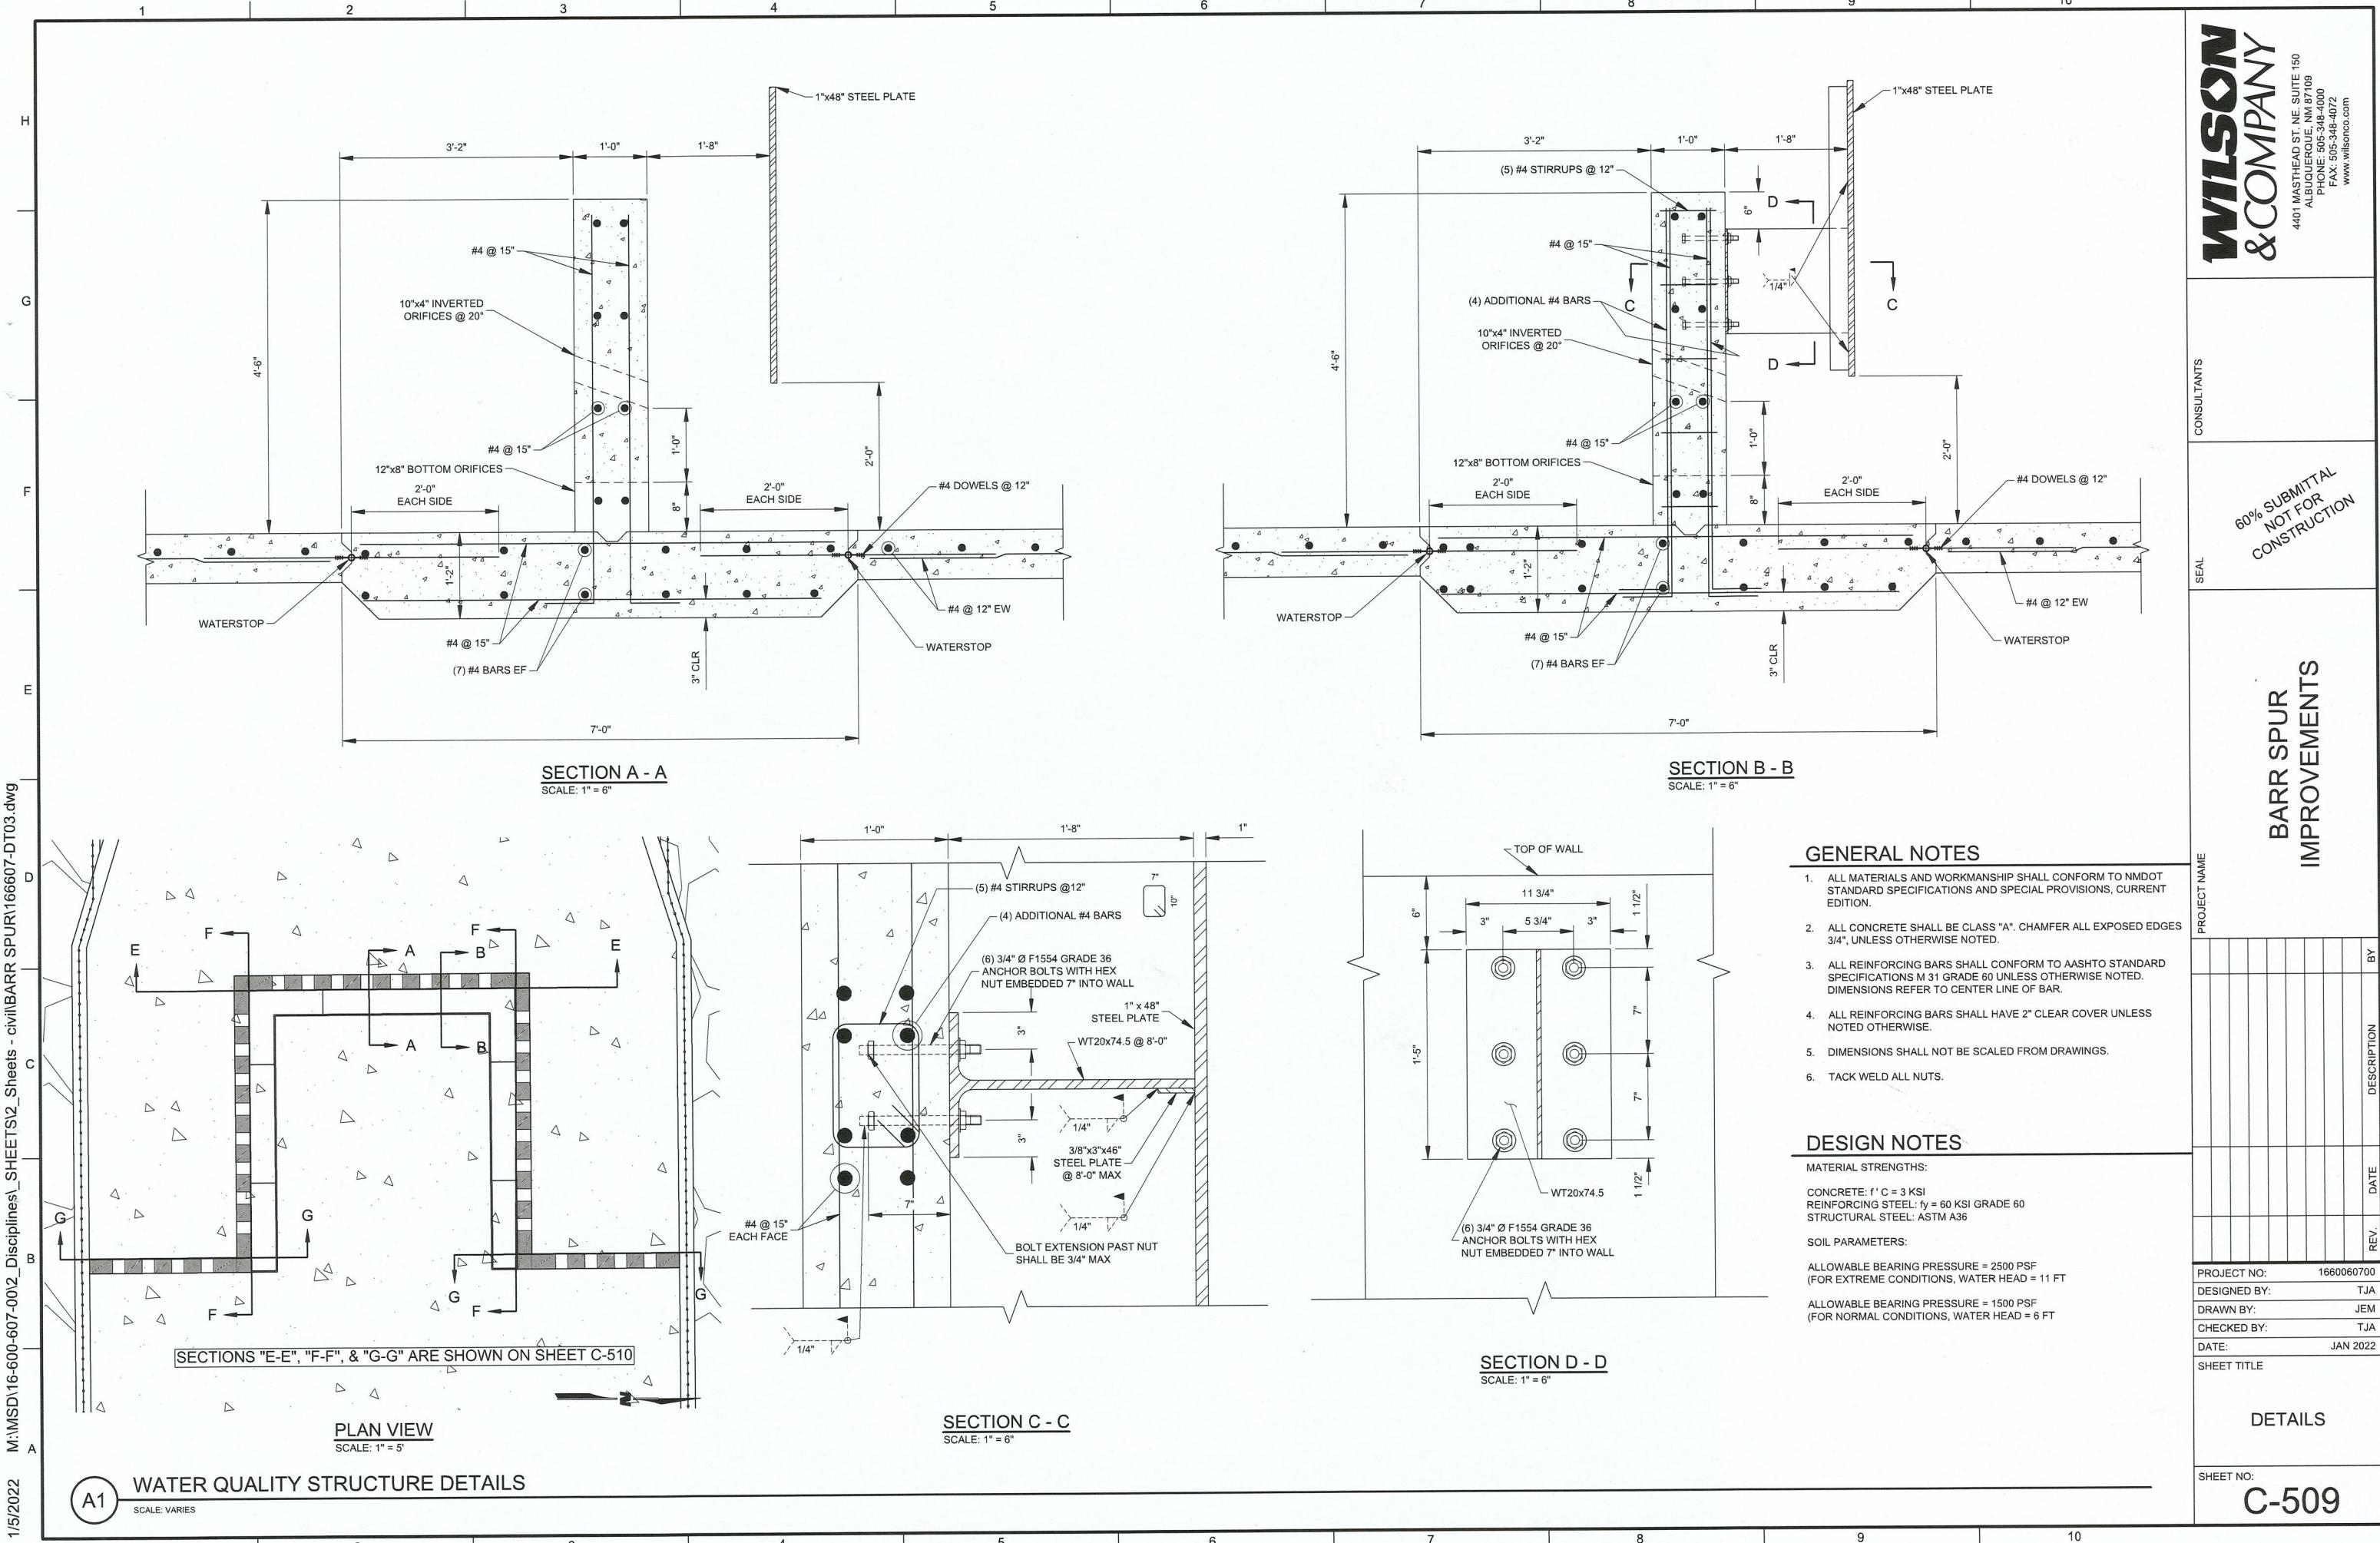
PIPE RAIL  
SEE SHEET C-503  
TW 4917.65  
FINISHED GRADE  
CBC MODIFIED WINGWALL  
TOF 4906.08  
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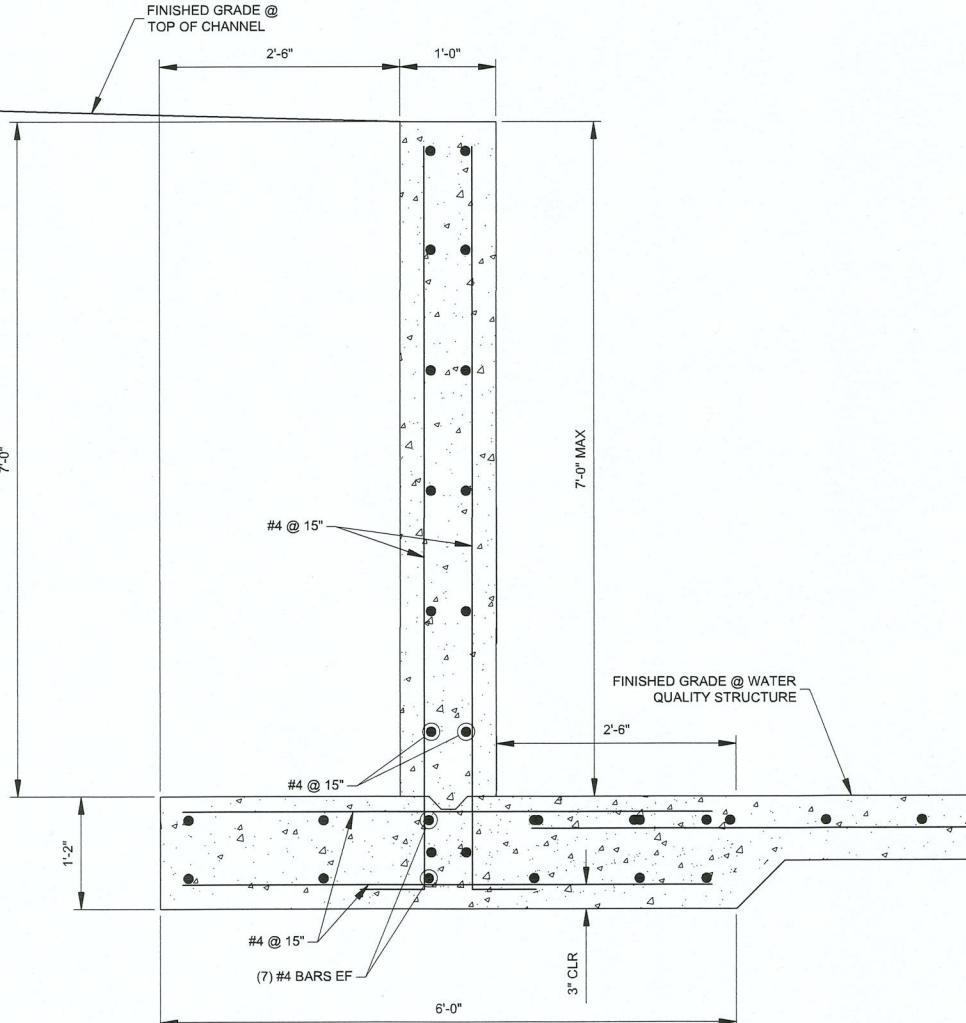
PIPE RAIL  
SEE SHEET C-503  
TW 4917.65  
FINISHED GRADE  
CBC MODIFIED WINGWALL  
TOF 4906.08  
8'-9"  
4"  
1'-0"  
1'-3"






## A1 RETAINING WALL DETAIL

SCALE: 1" = 1"




## A5 WATER QUALITY STRUCTURE SECTIONS

SCALE: 1" = 2"

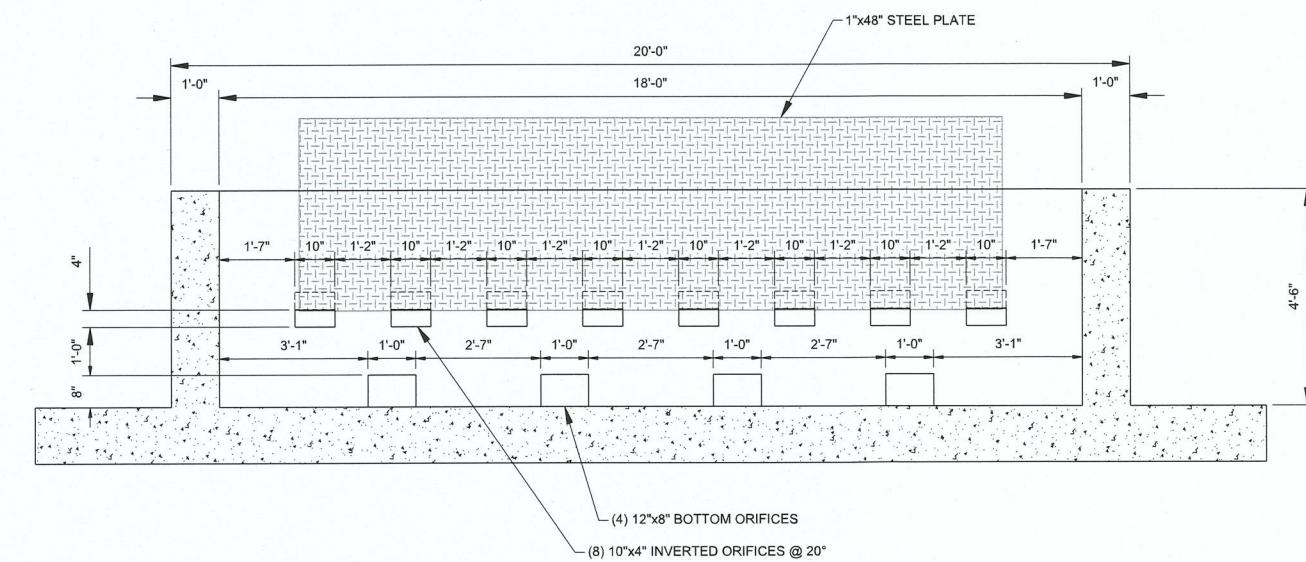


## SECTION G - G

SCALE: 1" = 2"

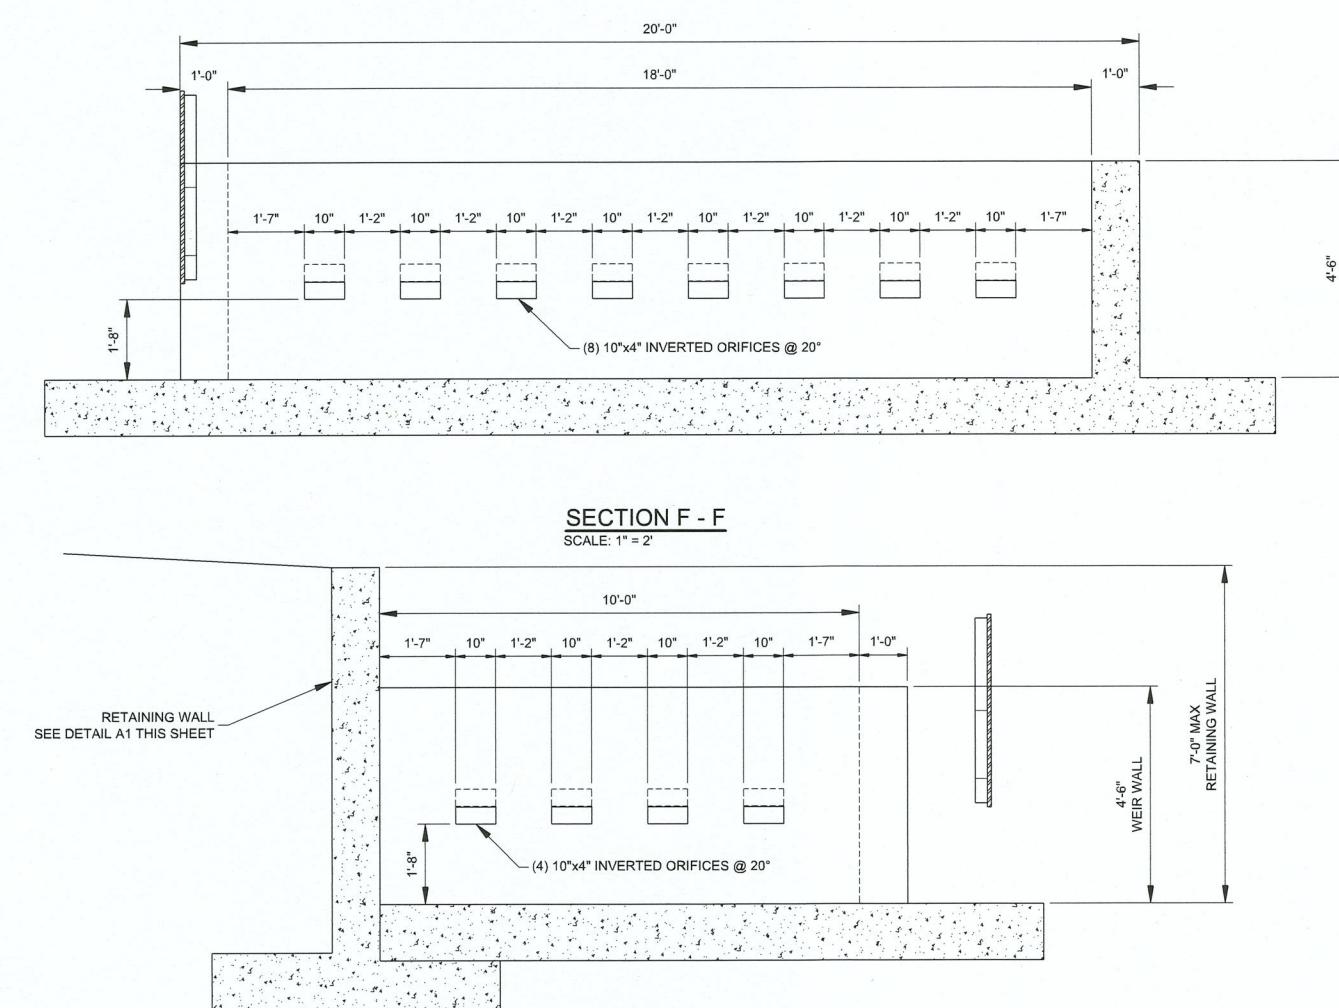


## SECTION E - E

SCALE: 1" = 2"

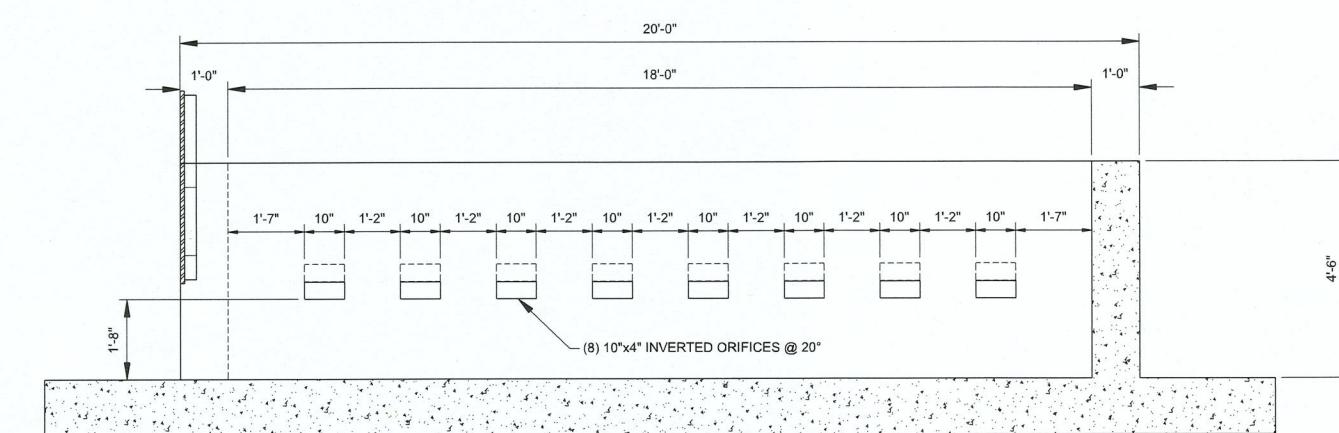

## SECTION F - F

SCALE: 1" = 2"

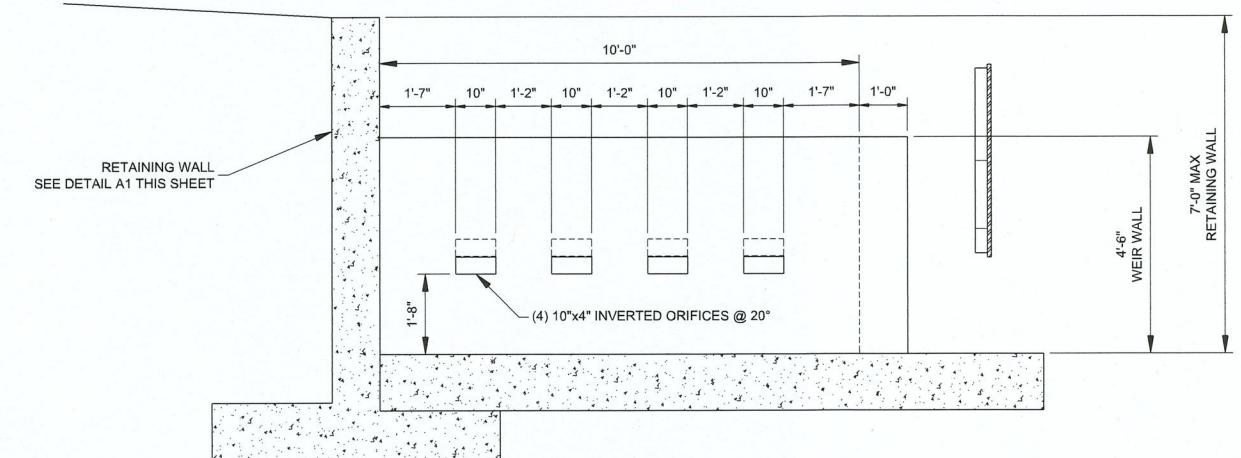

C-510

DETAILS

SHEET NO:

PROJECT NO:	1660060700
DESIGNED BY:	TJA
DRAWN BY:	JEM
CHECKED BY:	TJA
DATE:	JAN 2022
SHEET TITLE	

BARR SPUR  
IMPROVEMENTS

PROJECT NAME

BY

REV.	DATE	DESCRIPTION







SEAL


CONSULTANTS

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BOX TYPE	CONFIGURATION	DESIGN FILL	DRAWINGS
SINGLE BARREL CBC		"A"	511-60-1/2 511-60-2/2
SINGLE BARREL CBC		"B" "C" "D" "E"	511-61-1/2 511-61-2/2
DOUBLE BARREL CBC		"A"	511-62-1/2 511-62-2/2
DOUBLE BARREL CBC		"B" "C" "D" "E"	511-63-1/2 511-63-2/2
TRIPLE AND QUADRUPLE BARREL CBC		"A"	511-64-1/3 511-64-2/3 511-64-3/3
TRIPLE AND QUADRUPLE BARREL CBC		"B" "C" "D" "E"	511-65-1/3 511-65-2/3 511-65-3/3
CBC HEADWALL/CUTOFF WALL & MISC. DETAILS		"A" "B" "C" "D" "E"	511-66-1/6 511-66-2/6 511-66-3/6 511-66-4/6 511-66-5/6 511-66-6/6
WINGWALL & APRON		"A" "B" "C" "D" "E"	511-67-1/2 511-67-2/2



## PAYMENT

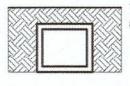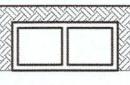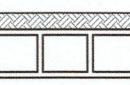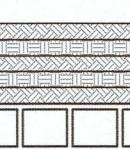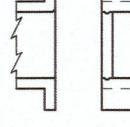
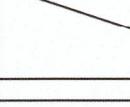
PAYMENT FOR CBC'S IS BASED ON "LIN. FT." UNIT OF MEASUREMENT FOR THE TOTAL LENGTH OF ALL NEW BARRELS CONSTRUCTED AT THE CENTERLINE OF BARREL. LENGTH OF BARREL SHALL NOT INCLUDE "HW" WHICH SHALL BE PAID FOR SEPARATELY.

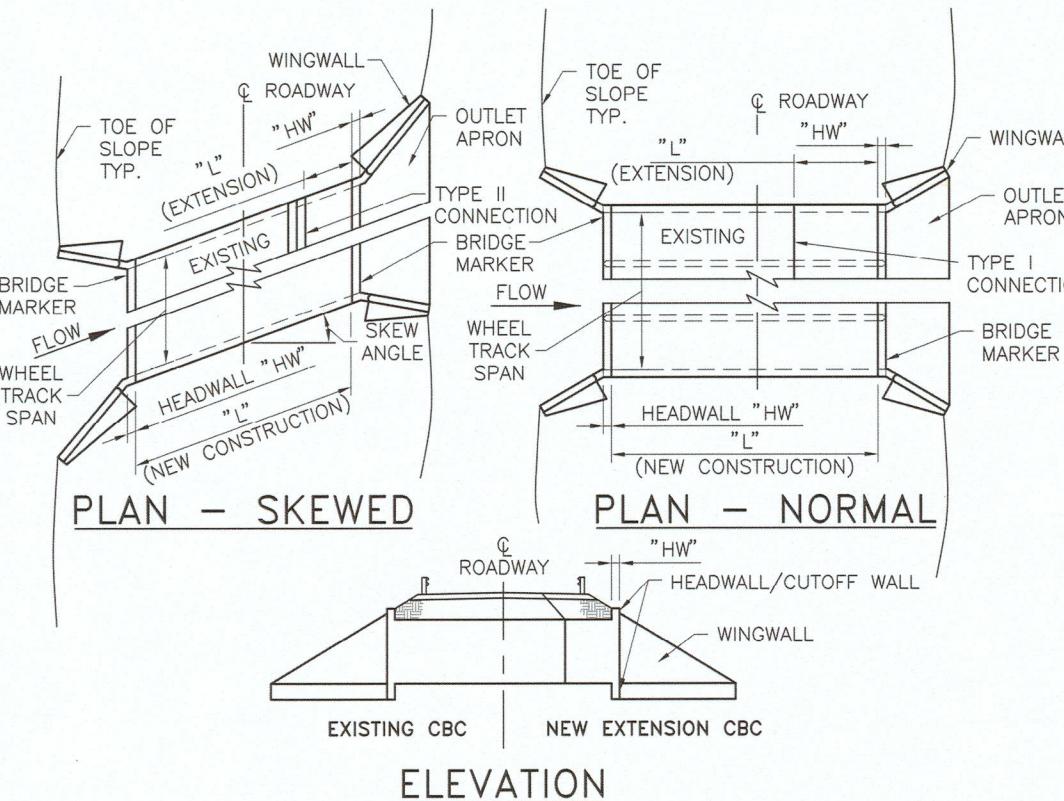PAYMENT FOR HEADWALL/CUTOFF WALL IS BASED ON "EACH" UNIT OF MEASUREMENT FOR EACH NEW BARREL CONSTRUCTED. IN CASE OF TYPE II CONNECTION EACH HEAD/CUTOFF WALL UNIT SHALL BE PAID FOR, I.E. TWO PER BARREL PER CULVERT EXTENSION.

PAYMENT FOR WINGWALL IS BASED ON "SQ. FT." UNIT OF MEASUREMENT BASED ON SOIL SIDE VERTICAL FACE AREA FOR EACH INDIVIDUAL HEIGHT OF INTERIOR BARREL DIMENSION. PAYMENT FOR OUTLET APRON IS BASED ON "SQ. FT." UNIT OF MEASUREMENT BASED ON PLAN AREA OF APRON.

ALTERNATIVELY, A COMPLETE CONCRETE BOX CULVERT MAY BE PAID FOR UNDER CLASS "AA" CONCRETE BY "CU. YD." ITEM 511030 AND GRADE 60 REBAR BY "LBS." ITEM 540060.

REBAR, CONCRETE, FORMING, DEMOLITION, AND ALL OTHER WORK AND MATERIAL REQUIRED FOR A COMPLETE CBC, HEADWALL/CUTOFF WALL, WINGWALL, AND APRON CONSTRUCTION SHALL BE INCLUDED IN THE UNIT COST FOR EACH AND NO FURTHER PAYMENT SHALL BE MADE FOR THESE INCIDENTAL ITEMS.

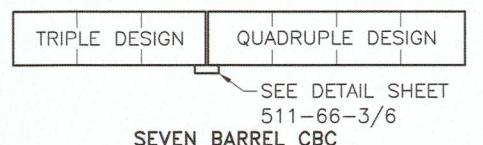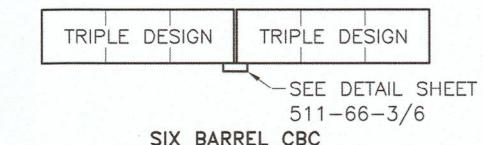

## EXAMPLE CONFIGURATIONS OF CBC W/MORE THAN 4 BARRELS


NOTE: USE SAME BARREL CONFIGURATION IF POSSIBLE

NO.	DATE	REV. BY	DESCRIPTION
REVISIONS (OR CHANGE NOTICES)			
NEW MEXICO DEPARTMENT OF TRANSPORTATION STANDARD DRAWING			
CONCRETE BOX CULVERT INDEX OF SHEETS EXPLANATION OF USE OF DRAWINGS			
APPROVED	DESIGN ENGINEER	APR 9, 07	
DESIGNED BY	DRAWN BY	DATE	REV.
NMDOT STD DWG			

511-59-1/2      1 OF 2

## METHOD OF EXTENDING UNEQUAL BOX DIMENSIONS

FOR DETAILS SEE SHEET 511-66-4/6

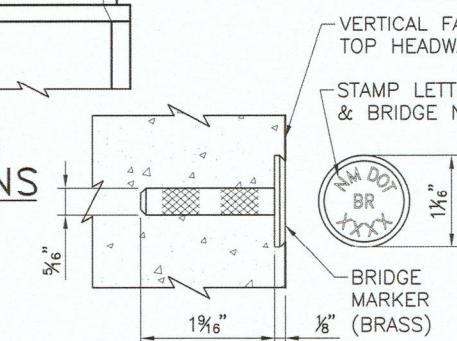

## BRIDGE MARK DETAIL

**WILSON & COMPANY**  
4401 MASTHEAD ST. NE, SUITE 150  
ALBUQUERQUE, NM 87109  
PHONE: 505-348-4000  
FAX: 505-345-4072  
www.wilsonco.com


60% SUBMITTAL  
NOT FOR CONSTRUCTION

**BARR SPUR IMPROVEMENTS**


PROJECT NO.	166060700
DESIGNED BY:	TJA
DRAWN BY:	JEM
CHECKED BY:	TJA
DATE:	JAN 2022
SHEET TITLE	
REV.	
DATE	

SHEET NO: C-511




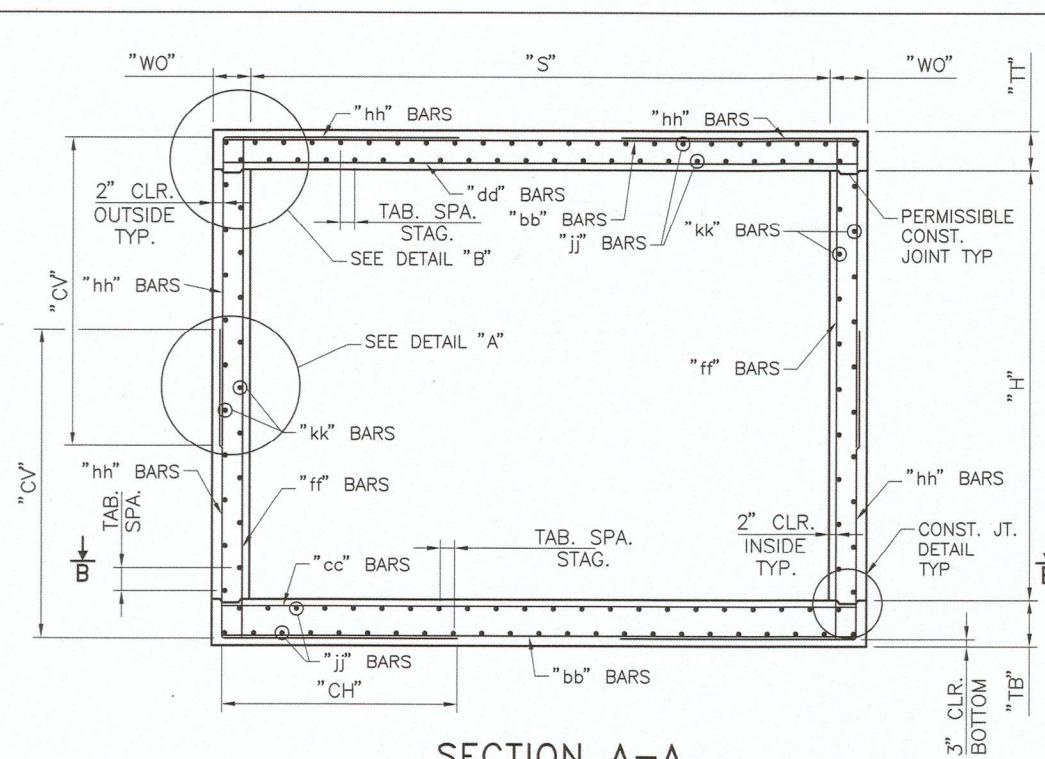


SECTION A-A

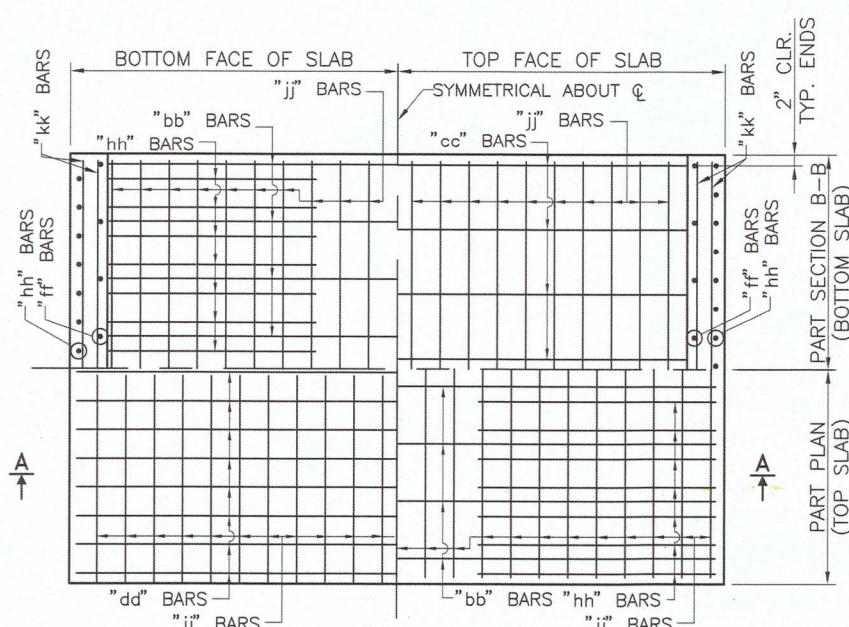

## REBAR LAYOUT - PLAN VIEW

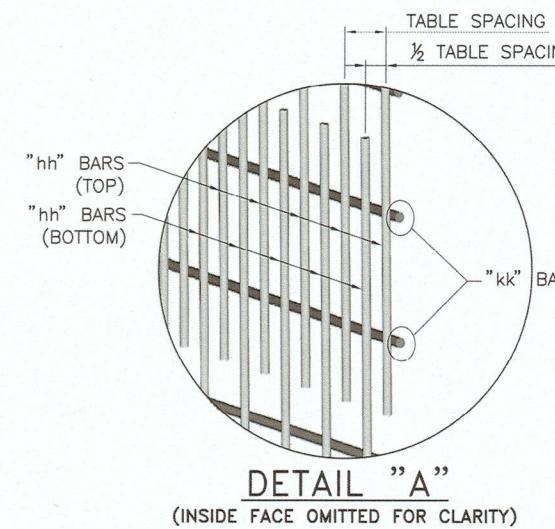

DETAIL "A"

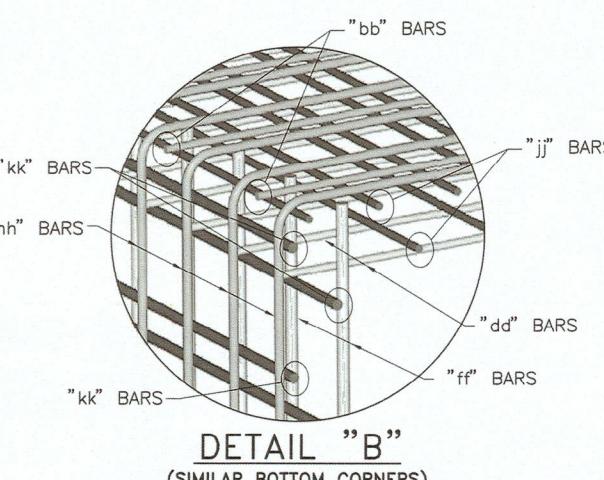

DETAIL "B"  
(SIMILAR BOTTOM CORNERS)

## GENERAL NOTES

1. ALL MATERIALS AND WORKMANSHIP SHALL CONFORM TO THE NEW MEXICO DEPARTMENT OF TRANSPORTATION SPECIFICATIONS FOR HIGHWAY AND BRIDGE CONSTRUCTION (CURRENT EDITION) WITH APPLICABLE SPECIAL PROVISIONS.
  2. ALL CONCRETE SHALL BE CLASS "AA" (4000 psi). CHAMFER ALL EXPOSED EDGES  $\frac{3}{4}$ ".
  3. ALL REINFORCING STEEL TO BE DEFORMED BARS, CONFORMING TO AASHTO M-31, GRADE 60. ALL DIMENSIONS REFER TO THE CENTERLINE OF BAR.
  4. "COVER" IS HEIGHT OF FILL FROM TOP OF BOX TO THE TOP OF PAVEMENT. ORIGINAL HEIGHT OF COVER MAY NOT BE EXCEEDED IN THE FUTURE OR WILL REQUIRE REMOVAL AND REPLACEMENT WITH PROPER DESIGN FILL CBC. IN CASE OF COVER EQUAL TO 10', 15', 20', OR 25' USE HIGHER DESIGN FILL IN CASE OF FUTURE AC OVERLAY.
  5. "jj" AND "kk" BARS MAY BE SPLICED WHEN NECESSARY BY LAPING AT LEAST 40 BAR DIAMETERS. NO OTHER SPLICING OF BARS WILL BE PERMITTED. LENGTH OF THESE BARS SHALL EQUAL THE LENGTH OF BARREL "L" PLUS (2 X "HW") MINUS 4" FOR TOTAL NEW CONSTRUCTION, NOT INCLUDING LAP LENGTH. FOR CULVERT EXTENSION, LENGTH OF THESE BARS SHALL BE "L" PLUS "HW" MINUS 2".
  6. REINFORCING SHOWN IS FOR PLACEMENT LOCATION ONLY. USE APPROPRIATE SHEETS AND CORRESPONDING TABLES TO DETERMINE THE REINFORCING REQUIREMENTS AND SPACINGS.
  7. ALL CONSTRUCTION JOINTS SHALL BE AS PER DETAIL THIS SHEET. CONSTRUCTION JOINTS ARE PERMISSIBLE AND SHALL BE LOCATED AT WALL/SLAB HORIZONTAL INTERFACE.
  8. DO NOT BACKFILL WALLS UNTIL TOP SLAB HAS REACHED 4000 psi DESIGN STRENGTH.
  9. CBC'S SHALL BE CONSTRUCTED TO THE SPAN, HEIGHT, NUMBER OF BARRELS, SKEW, ALIGNMENT, AND FLOWLINE GRADE AS SPECIFIED ON THE PLAN AND PROFILE AND STRUCTURE PLACEMENT SECTIONS.
  10. EXCAVATION AND BACKFILL OF CBC'S SHALL BE IN ACCORDANCE WITH STANDARD DRAWING 210-01-1/1.


## DESIGN

DESIGNED IN ACCORDANCE WITH AASHTO LRFD BRIDGE DESIGN SPECIFICATIONS, THIRD EDITION

## PAYMENT

PAYMENT FOR CBC'S IS BASED ON "LIN. FT." UNIT OF MEASUREMENT FOR THE TOTAL LENGTH OF ALL NEW BARRELS CONSTRUCTED AT THE CENTERLINE OF BARREL. I.E. SINGLE BARREL SHALL BE 1 X "L" AND TRIPLE BARREL SHALL BE 3 X "L" FOR PAYMENT. LENGTH OF BARREL SHALL NOT INCLUDE "HW" WHICH SHALL BE PAID FOR SEPARATELY. CONCRETE, REBAR, FORMING, AND OTHER WORK AND MATERIAL SHALL BE INCLUDED IN THE LIN. FT. COST FOR THE CBC AND NO FURTHER PAYMENT SHALL BE MADE FOR THESE INCIDENTAL ITEMS.

ALTERNATIVELY, A COMPLETE CONCRETE BOX CULVERT MAY BE PAID FOR UNDER CLASS "AA" CONCRETE BY "CU. YD." ITEM 511030 AND GRADE 60 REBAR BY "LBS." ITEM 540060.

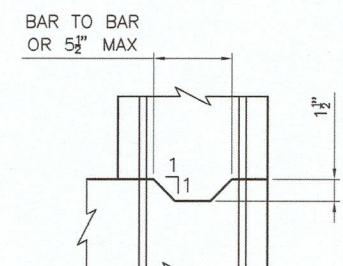

## CONSTRUCTION JOINT DETAIL

NO.	DATE	REV. BY	DESCRIPTION
REVISIONS (OR CHANGE NOTICES)			
<p><b>NEW MEXICO</b>  <b>DEPARTMENT OF TRANSPORTATION</b>  <b>STANDARD DRAWING</b></p>			
<p><b>CONCRETE BOX CULVERT SINGLE  OPENING - DESIGN FILL "A" 0-10 FT  STRUCTURAL SECTIONS AND REBAR</b></p>			
APPROVED		DESIGN ENGINEER	Apr. 9, 07
DESIGNED BY	TLB	DRAWN BY	SGL
CHECKED BY		HDR	
<p><b>511-60-1/2</b></p>			
<p>1 OF 2</p>			

511-60-1/

111

101

1

## NMDOT STD DWG

HEET NO:

H  
G  
F  
E  
D  
C  
B  
A

SINGLE OPENING BOX CULVERT STRUCTURE DIMENSIONS			GRADE 60 REINFORCING BAR SCHEDULE (BAR SIZE, SPACING AND LENGTH DIMENSIONS)											
DIM	0-10 FT BURIAL DESIGN FILL "A"		"bb"	"cc"	"dd"	"bb", "cc" & "dd"	"ff"	"hh"		"jj"	"kk"			
	SPAN "S" INSIDE	HEIGHT "H" INSIDE						SIZE	SIZE					
4' 2"	7.5"	8.5"	7.5"	#4 12"	#4 6"	#4 6"	4'-11"	#4 12"	2'-11"	#4 6"	25"	25"	#4 6"	#4 6"
4' 3"	7.5"	8.5"	7.5"	#4 12"	#4 6"	#4 6"	4'-11"	#4 12"	3'-11"	#4 6"	25"	31"	#4 6"	#4 6"
4' 4"	7.5"	8.5"	7.5"	#4 12"	#4 6"	#4 6"	4'-11"	#4 12"	4'-11"	#4 6"	25"	37"	#4 6"	#4 6"
6' 2"	7.5"	8.5"	7.5"	#5 12"	#5 6"	#6 6"	6'-11"	#4 12"	2'-11"	#5 6"	30"	26"	#4 6"	#4 6"
6' 3"	7.5"	8.5"	7.5"	#5 12"	#5 6"	#6 6"	6'-11"	#4 12"	3'-11"	#5 6"	30"	32"	#4 6"	#4 6"
6' 4"	7.5"	8.5"	7.5"	#5 12"	#5 6"	#6 6"	6'-11"	#4 12"	4'-11"	#5 6"	30"	38"	#4 6"	#4 6"
6' 5"	7.5"	8.5"	7.5"	#5 12"	#5 6"	#6 6"	6'-11"	#4 12"	5'-11"	#5 6"	30"	44"	#4 6"	#4 6"
6' 6"	7.5"	8.5"	7.5"	#5 12"	#5 6"	#6 6"	6'-11"	#4 12"	6'-11"	#5 6"	30"	50"	#4 6"	#4 6"
6' 7"	7.5"	8.5"	7.5"	#5 12"	#5 6"	#6 6"	6'-11"	#4 12"	7'-11"	#5 6"	30"	56"	#4 6"	#4 6"
8' 4"	9.0"	9.5"	7.5"	#6 12"	#6 6"	#7 6"	8'-11"	#4 12"	5'-1"	#6 6"	36"	41"	#4 6"	#4 6"
8' 5"	9.0"	9.5"	7.5"	#6 12"	#6 6"	#7 6"	8'-11"	#4 12"	6'-1"	#6 6"	36"	47"	#4 6"	#4 6"
8' 6"	9.0"	9.5"	7.5"	#6 12"	#6 6"	#7 6"	8'-11"	#4 12"	7'-1"	#6 6"	36"	53"	#4 6"	#4 6"
8' 7"	9.0"	9.5"	7.5"	#6 12"	#6 6"	#7 6"	8'-11"	#4 12"	8'-1"	#6 6"	36"	59"	#4 6"	#4 6"
8' 8"	9.0"	9.5"	7.5"	#6 12"	#6 6"	#7 6"	8'-11"	#4 12"	9'-1"	#6 6"	36"	65"	#4 6"	#4 6"
10' 3"	9.0"	9.5"	7.5"	#7 12"	#8 6"	#8 6"	10'-11"	#4 12"	4'-1"	#7 6"	43"	38"	#4 6"	#4 6"
10' 4"	9.0"	9.5"	7.5"	#7 12"	#8 6"	#8 6"	10'-11"	#4 12"	5'-1"	#7 6"	43"	44"	#4 6"	#4 6"
10' 5"	9.0"	9.5"	7.5"	#7 12"	#8 6"	#8 6"	10'-11"	#4 12"	6'-1"	#7 6"	43"	50"	#4 6"	#4 6"
10' 6"	9.0"	9.5"	7.5"	#7 12"	#8 6"	#8 6"	10'-11"	#4 12"	7'-1"	#7 6"	43"	56"	#4 6"	#4 6"
10' 7"	9.0"	9.5"	7.5"	#7 12"	#8 6"	#8 6"	10'-11"	#4 12"	8'-1"	#7 6"	43"	62"	#4 6"	#4 6"
10' 8"	9.5"	10.0"	9.0"	#8 12"	#8 6"	#8 6"	11'-2"	#5 6"	9'-2"	#8 6"	53"	72"	#4 6"	#4 6"
10' 9"	9.5"	10.0"	9.0"	#8 12"	#8 6"	#8 6"	11'-2"	#5 6"	10'-2"	#8 6"	53"	78"	#4 6"	#4 6"
10' 10"	9.5"	10.0"	9.0"	#8 12"	#8 6"	#8 6"	11'-2"	#5 6"	11'-2"	#8 6"	53"	84"	#4 6"	#4 6"
10' 11"	9.5"	10.0"	9.0"	#8 12"	#8 6"	#8 6"	11'-2"	#5 6"	12'-2"	#8 6"	53"	90"	#4 6"	#4 6"
10' 12"	9.5"	10.0"	9.0"	#8 12"	#8 6"	#8 6"	11'-2"	#5 6"	13'-2"	#8 6"	53"	96"	#4 6"	#4 6"
12' 6"	10.0"	11.0"	9.5"	#8 12"	#9 6"	#9 6"	13'-3"	#4 6"	7'-4"	#8 6"	56"	61"	#4 6"	#4 6"
12' 7"	10.0"	11.0"	9.5"	#8 12"	#9 6"	#9 6"	13'-3"	#4 6"	8'-4"	#8 6"	56"	67"	#4 6"	#4 6"
12' 8"	10.0"	11.0"	9.5"	#8 12"	#9 6"	#9 6"	13'-3"	#4 6"	9'-4"	#8 6"	56"	73"	#4 6"	#4 6"
12' 9"	10.0"	11.0"	9.5"	#8 12"	#9 6"	#9 6"	13'-3"	#4 6"	10'-4"	#8 6"	56"	79"	#4 6"	#4 6"
12' 10"	10.0"	11.0"	9.5"	#8 12"	#9 6"	#9 6"	13'-3"	#4 6"	11'-4"	#8 6"	56"	85"	#4 6"	#4 6"
12' 12"	10.0"	11.0"	9.5"	#8 12"	#9 6"	#9 6"	13'-3"	#4 6"	13'-4"	#8 6"	56"	97"	#4 6"	#4 6"
14' 8"	11.0"	12.0"	10.5"	#9 12"	#9 6"	#9 6"	15'-5"	#5 6"	9'-6"	#9 6"	101"	79"	#4 6"	#4 6"
14' 9"	11.0"	12.0"	10.5"	#9 12"	#9 6"	#9 6"	15'-5"	#5 6"	10'-6"	#9 6"	101"	85"	#4 6"	#4 6"
14' 10"	11.0"	12.0"	10.5"	#9 12"	#9 6"	#9 6"	15'-5"	#5 6"	11'-6"	#9 6"	101"	91"	#4 6"	#4 6"
14' 11"	11.0"	12.0"	10.5"	#9 12"	#9 6"	#9 6"	15'-5"	#5 6"	12'-6"	#9 6"	101"	97"	#4 6"	#4 6"
14' 12"	11.0"	12.0"	10.5"	#9 12"	#9 6"	#9 6"	15'-5"	#5 6"	13'-6"	#9 6"	101"	103"	#4 6"	#4 6"
14' 13"	11.0"	12.0"	10.5"	#9 12"	#9 6"	#9 6"	15'-5"	#5 6"	14'-6"	#9 6"	101"	109"	#4 6"	#4 6"
14' 14"	11.0"	12.0"	10.5"	#9 12"	#9 6"	#9 6"	15'-5"	#5 6"	15'-6"	#9 6"	101"	115"	#4 6"	#4 6"

\* EXAMPLE OF USE OF THIS TABLE:  
PROPOSED STRUCTURE - SINGLE BARREL, 10 FT. SPAN/7 FT. HEIGHT, CBC WITH 2 FT. DEPTH OF COVER.  
USE THE FOLLOWING BUILD INFORMATION FROM THE TABLE ABOVE:

DIM	0-10 FT BURIAL DESIGN FILL "A"		"bb"	"cc"	"dd"	"bb", "cc" & "dd"	"ff"	"hh"		"jj"	"kk"
	SPAN "S" INSIDE	HEIGHT "H" INSIDE						SIZE	SIZE		
10' 7"	9.0"	9.5"	7.5"	#7 12"	#8 6"	#8 6"	10'-11"	#4 12"	8'-1"	#7 6"	43"

FOR EXTENSIONS OF EXISTING CBC'S OF S=5', S=7', AND S=9' SIZE SPANS NOT INCLUDED IN THIS TABLE, USE DIMENSIONS FOR NEXT GREATER SPAN TO BUILD. FOR EXAMPLE: FOR S=5' USE DESIGN DIMENSIONS FROM THE TABLE FOR S=6'. ALSO REDUCE THE S=6' TABLE LENGTH OF BARS "bb", "cc" AND "dd" BY ONE FOOT TO ACCOMMODATE THE SHORTER SPAN. SEE DETAILS ON SHEET 511-66-4/6. ANY OTHER SIZES OF BOX EXTENSIONS NOT COVERED BY THIS MODIFICATION SHALL BE DONE THROUGH SPECIAL DESIGNS INCLUDED IN THE PROJECT PLANS.

**WILSON**  
& COMPANY  
4401 MASTHEAD ST. NE SUITE 150  
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PHONE: 505-348-4000  
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60% SUBMITAL  
NOT FOR  
CONSTRUCTION






PROJECT NAME  
BARR SPUR  
IMPROVEMENTS

DATE  
DESCRIPTION  
REV.


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DESIGNED BY: TJA  
DRAWN BY: JEM  
CHECKED BY: TJA  
DATE: JAN 2022  
SHEET TITLE: NMDOT STD DWG

SHEET NO: C-514  
Sheet 511-83

NO.	DATE	REV. BY	DESCRIPTION
REVISIONS (OR CHANGE NOTICES)			
			NEW MEXICO DE

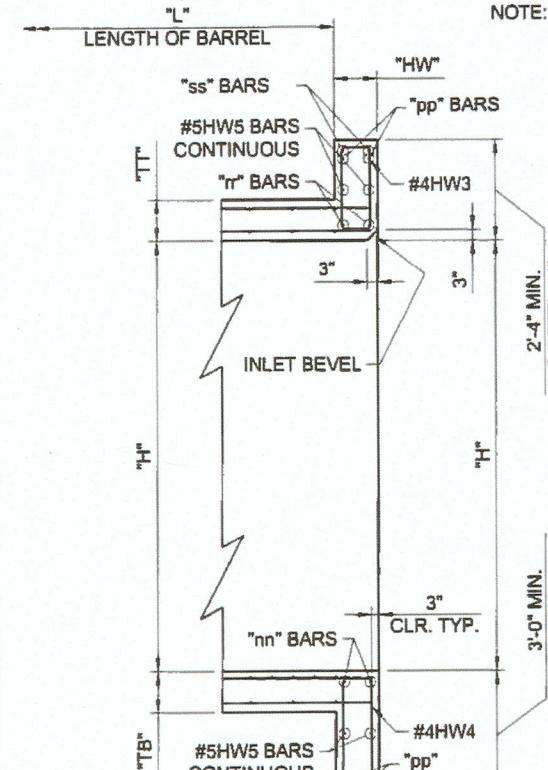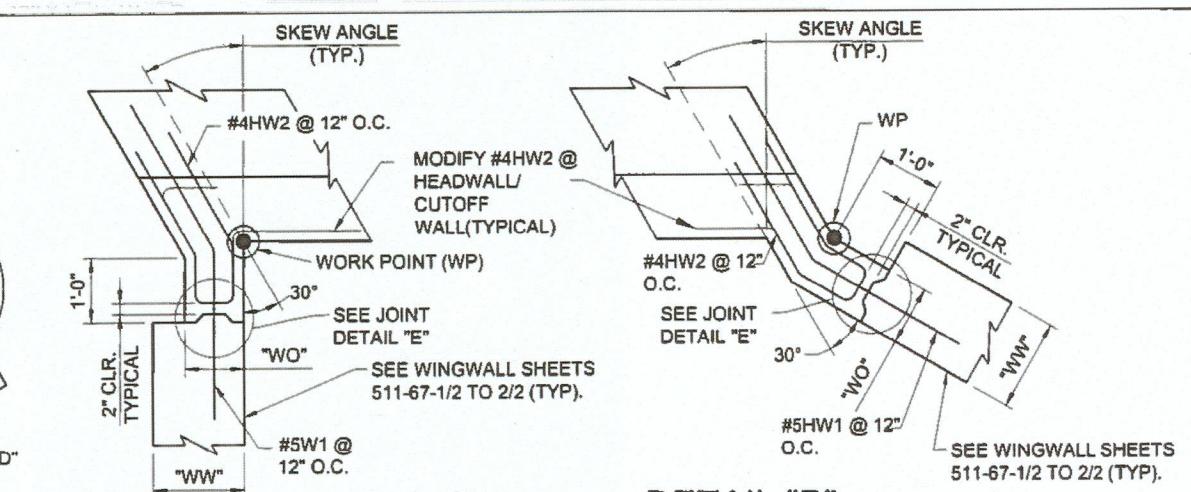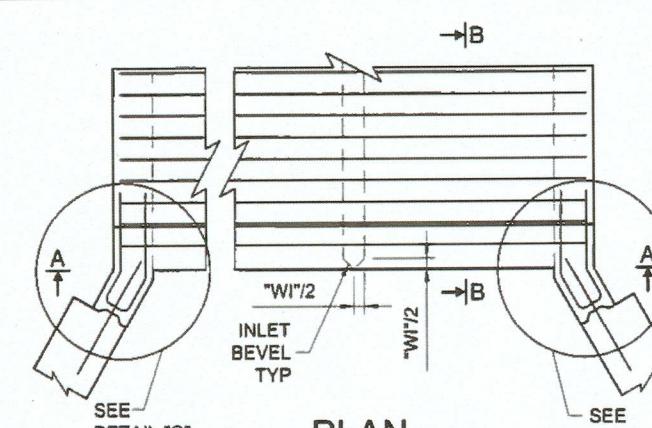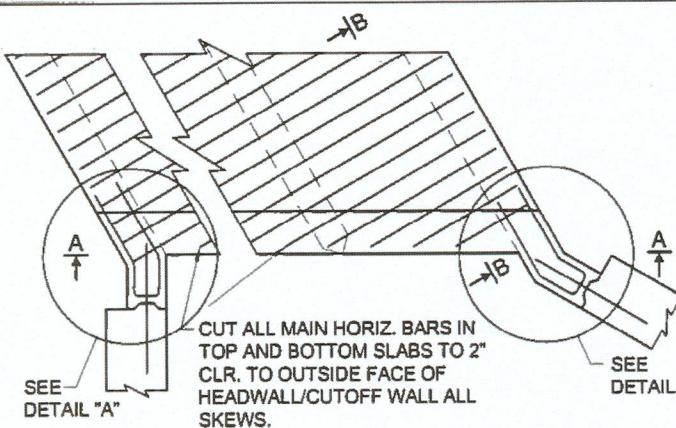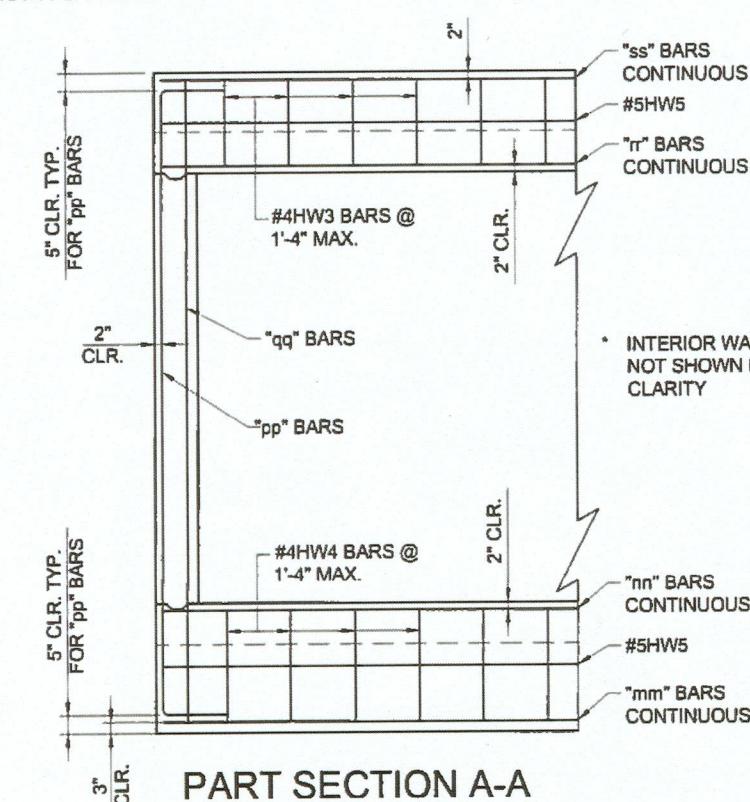**PLAN**(SKEWED)  
SIMILAR FOR SINGLE BARREL  
(NOT TO BE USED FOR SKEWS OVER 45°)NOTE: SEE SHEET 511-66-2/6 FOR BAR  
SIZES, NUMBER OF BARS, AND  
BAR LENGTH FORMULAS.**PART SECTION B-B****PART SECTION A-A****DETAIL "A"**


(SKEWED)

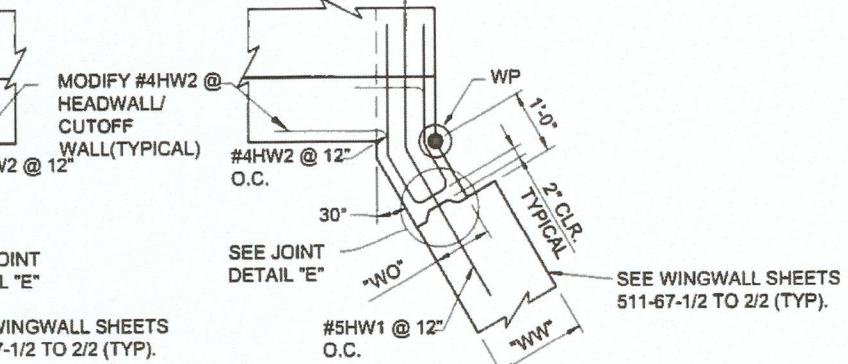**DETAIL "B"**


(SKEWED)

**DETAIL "C"**

(NORMAL)

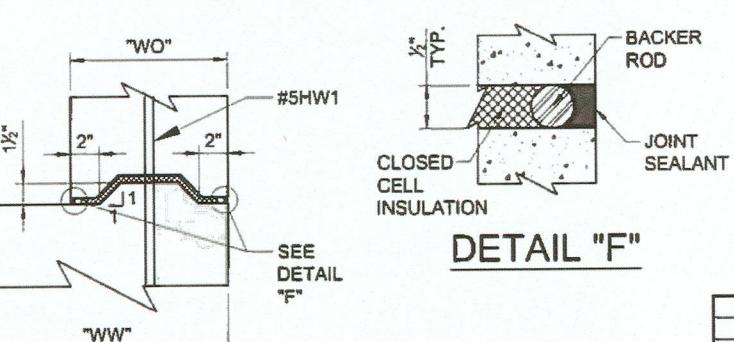**DETAIL "D"**

(NORMAL)

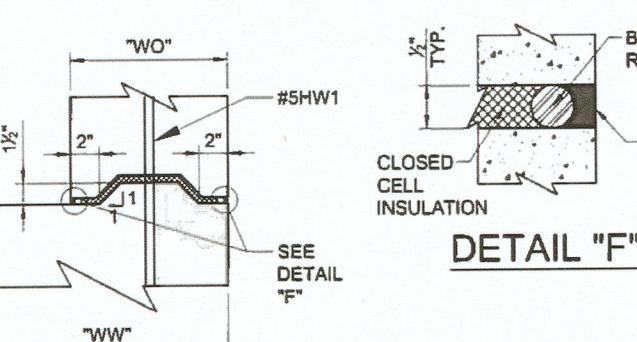**JOINT DETAIL "E"****PAYMENT**

PAYMENT FOR HEADWALL/CUTOFF WALL IS BASED ON "EACH" UNIT OF MEASUREMENT FOR EACH NEW BARREL CONSTRUCTED. IN CASE OF TYPE II CONNECTION EACH HEADWALL/CUTOFF WALL UNIT SHALL BE PAID FOR, I.E. TWO PER CULVERT EXTENSION.

ALTERNATIVELY, A COMPLETE CONCRETE BOX CULVERT MAY BE PAID FOR UNDER CLASS "AA" CONCRETE BY "CU.YD." ITEM 511030 AND GRADE 60 REBAR BY "LBS." ITEM 540060.

NO	DATE	REV. BY	DESCRIPTION
REVISIONS (OR CHANGE NOTICES)			
NEW MEXICO DEPARTMENT OF TRANSPORTATION STANDARD DRAWING			
CBC HEAD/CUTOFF WALLS - ALL DESIGN FILLS-0° 15° 30° 45° SKEWS STRUCTURAL SECTIONS AND REBAR			
APPROVED	DESIGN ENGINEER	DATE: 1/19/16	
DESIGNED BY	DRAWN BY	checked by	HDR
511-66-1/6 1 OF 6			

C-515


**BARR SPUR  
IMPROVEMENTS**

PROJECT NAME	BY
60% SUBMITTAL NOT FOR CONSTRUCTION	
REV.	DATE
DESCRIPTION	REV.
REVISIONS	DATE

PROJECT NO: 1660060700  
DESIGNED BY: TJA  
DRAWN BY: JEM  
CHECKED BY: TJA  
DATE: JAN 2022  
SHEET TITLE: NMDOT STD DWG

**WILSON  
& COMPANY**  
4401 MASHEAD ST. NE SUITE 150  
ALBUQUERQUE, NM 87109  
PHONE: 505-348-4000  
FAX: 505-348-4072  
www.wilsonco.com






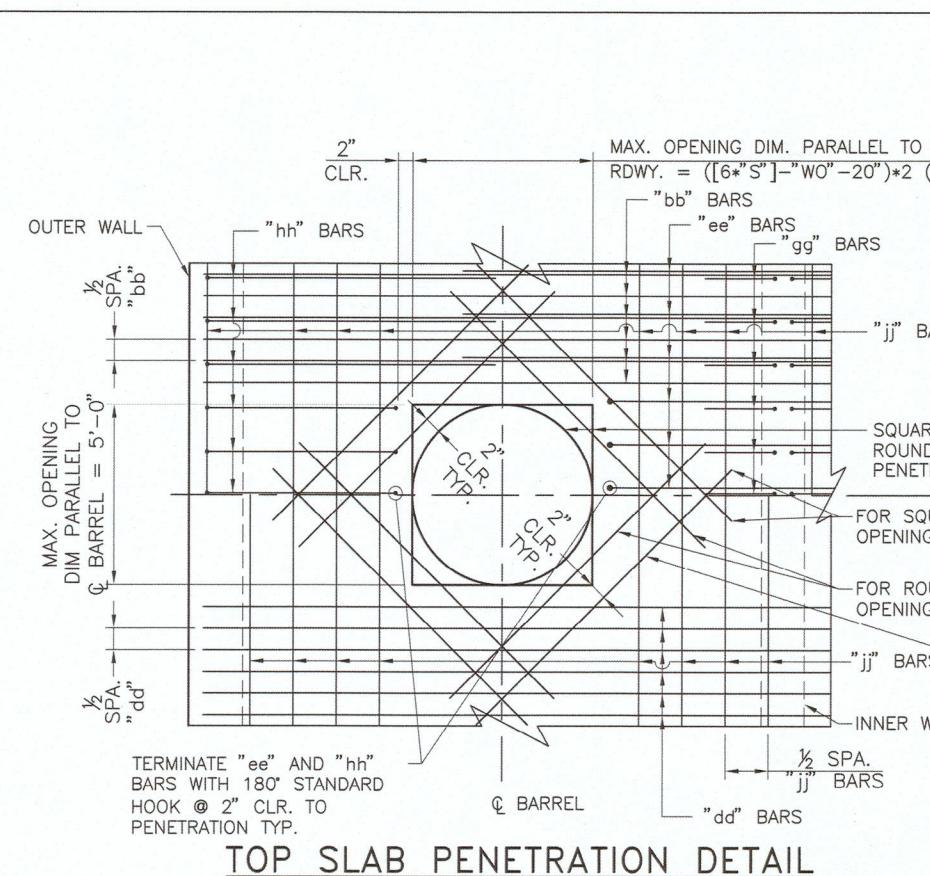


## EXAMPLES:

TOP SLAB - "S"=10' "H"=7', DESIGN FILL "B", DOUBLE BARREL CBC: MAX. OPENING DIM. PARALLEL TO  $\frac{1}{2}$  RDWY. =  $[(6*5')-9-20']*2$  = 62 (in)

SIDE WALL - "S"=10' "H"=7', DESIGN FILL "B", DOUBLE BARREL CBC: MIN DIM. TO INSIDE TOP & BOTTOM OF CBC =  $[1.2*7]+18$  = 26.4 (in)

TWO MATS OF #5 BARS INSIDE OF ALL OTHER TYPICAL REINFORCING FOR "TT" GREATER THAN 9". OTHERWISE ONE MAT OF #5 BARS. LENGTH OF BARS EQUAL TO TWICE DIM. OF OPENING.

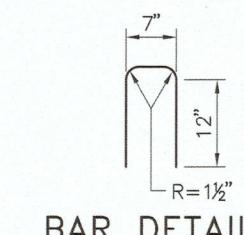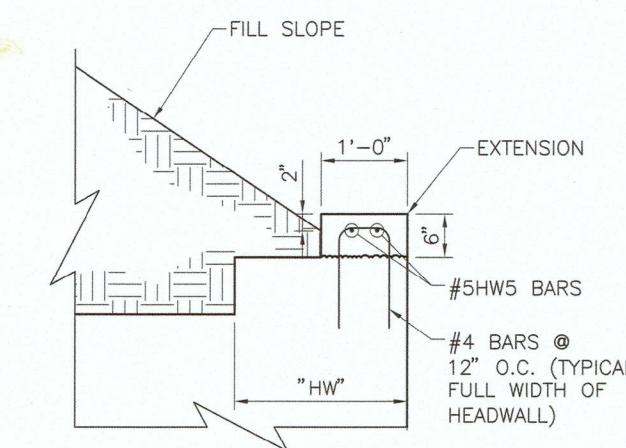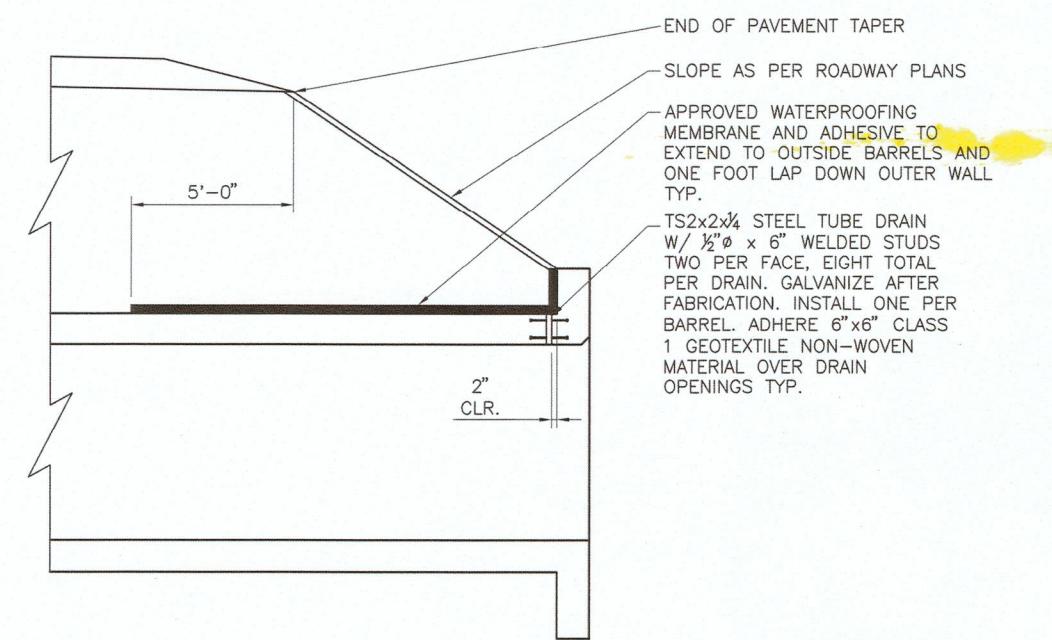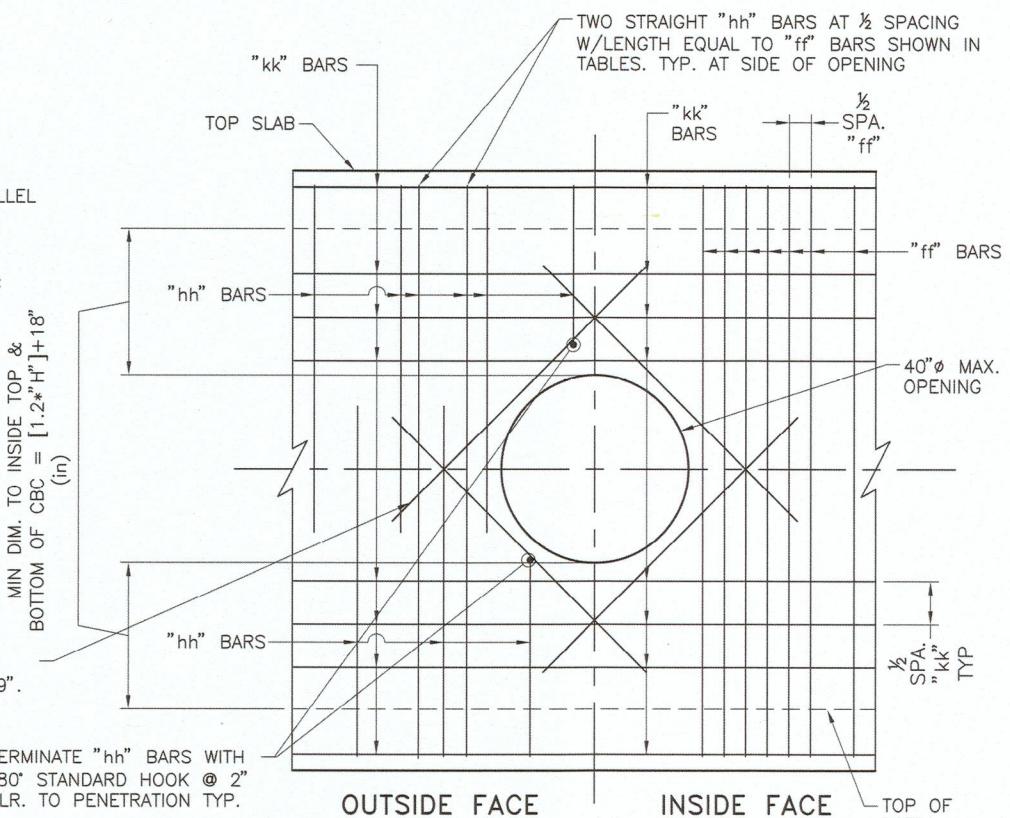


PAYMENT NOTE: ALL WORK AND MATERIALS ASSOCIATED WITH HEADWALL EXTENSION, MEMBRANE, DRAINS, AND PENETRATIONS SHALL BE CONSIDERED INCIDENTAL TO CONSTRUCTION OF A FINISHED CBC AND NO FURTHER PAYMENT WILL BE MADE FOR THESE INCLUDED ITEMS.

NO.	DATE	REV. BY	DESCRIPTION
REVISIONS (OR CHANGE NOTICES)			
			NEW MEXICO
			DEPARTMENT OF TRANSPORTATION
			STANDARD DRAWING
			CONCRETE BOX CULVERT EXTENSION
			ALL DESIGN FILLS - ALL SKEWS
			MISCELLANEOUS DETAILS & BACKFILL
APPROVED	DESIGN ENGINEER	APR 9, 2022	DATE
DESIGNED BY	TLB	DRAWN BY	SGL
CHECKED BY		CHECKED BY	HDR
DATE:			JAN 2022
SHEET TITLE			
NMDOT STD DWG			
511-66-5/6			
5 OF 6			


PROJECT NAME	CONSULTANTS	SEAL	60% SUBMITTAL NOT FOR CONSTRUCTION



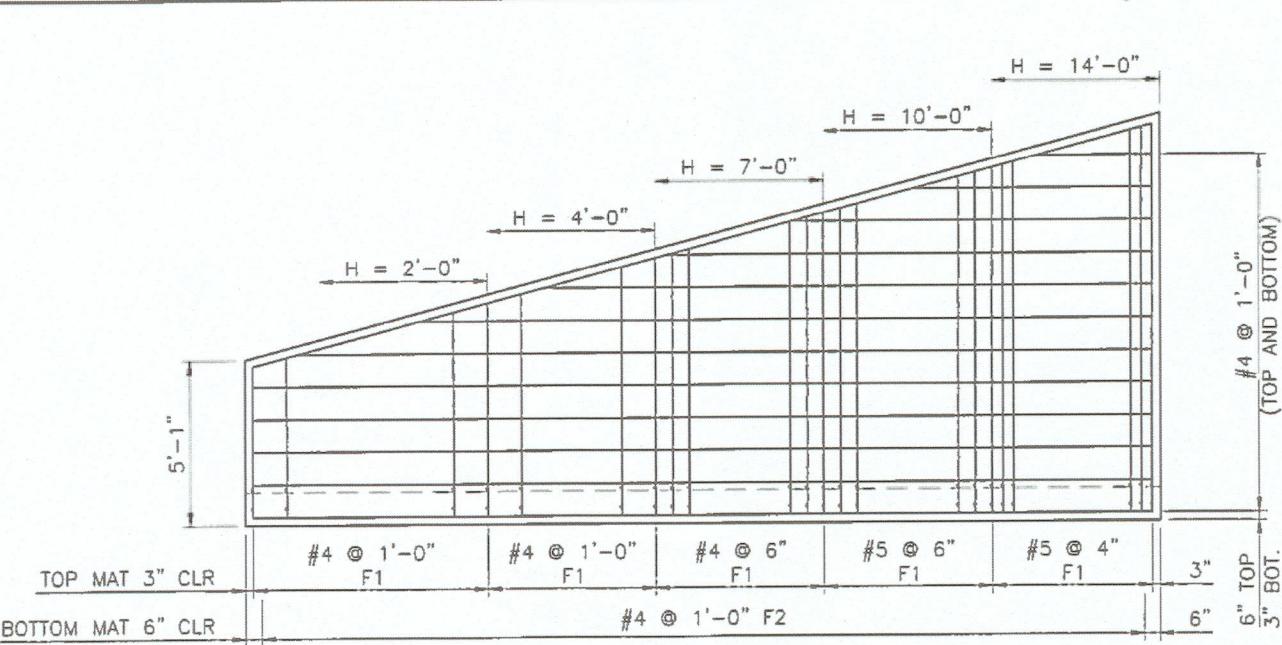


FOOTING PLAN


CONTRACTOR IS RESPONSIBLE FOR DETERMINING ALL BAR LENGTH DIMENSIONS FOR THE WINGWALL REINFORCEMENT.

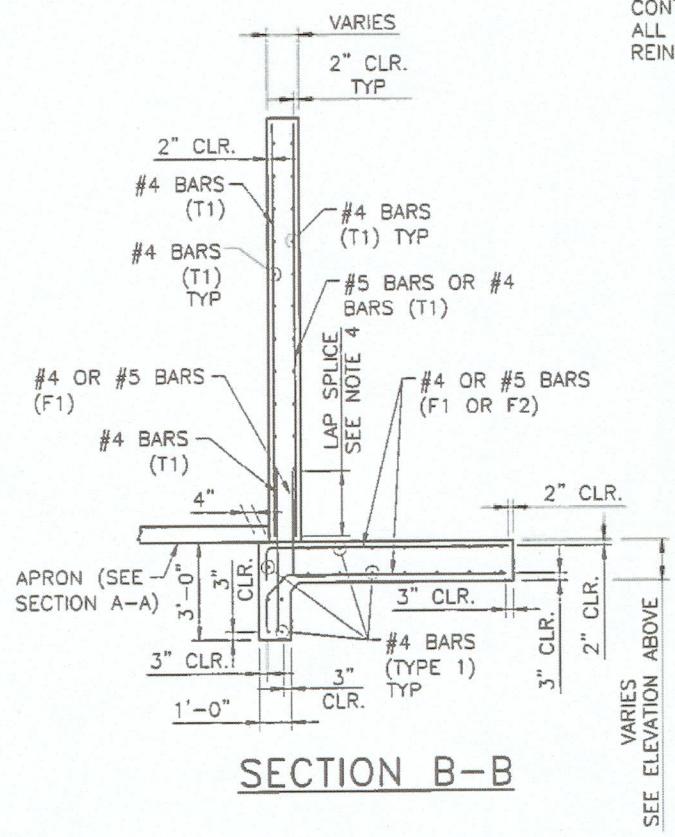

#4 @ 1'-0" (TOP AND BOTTOM)

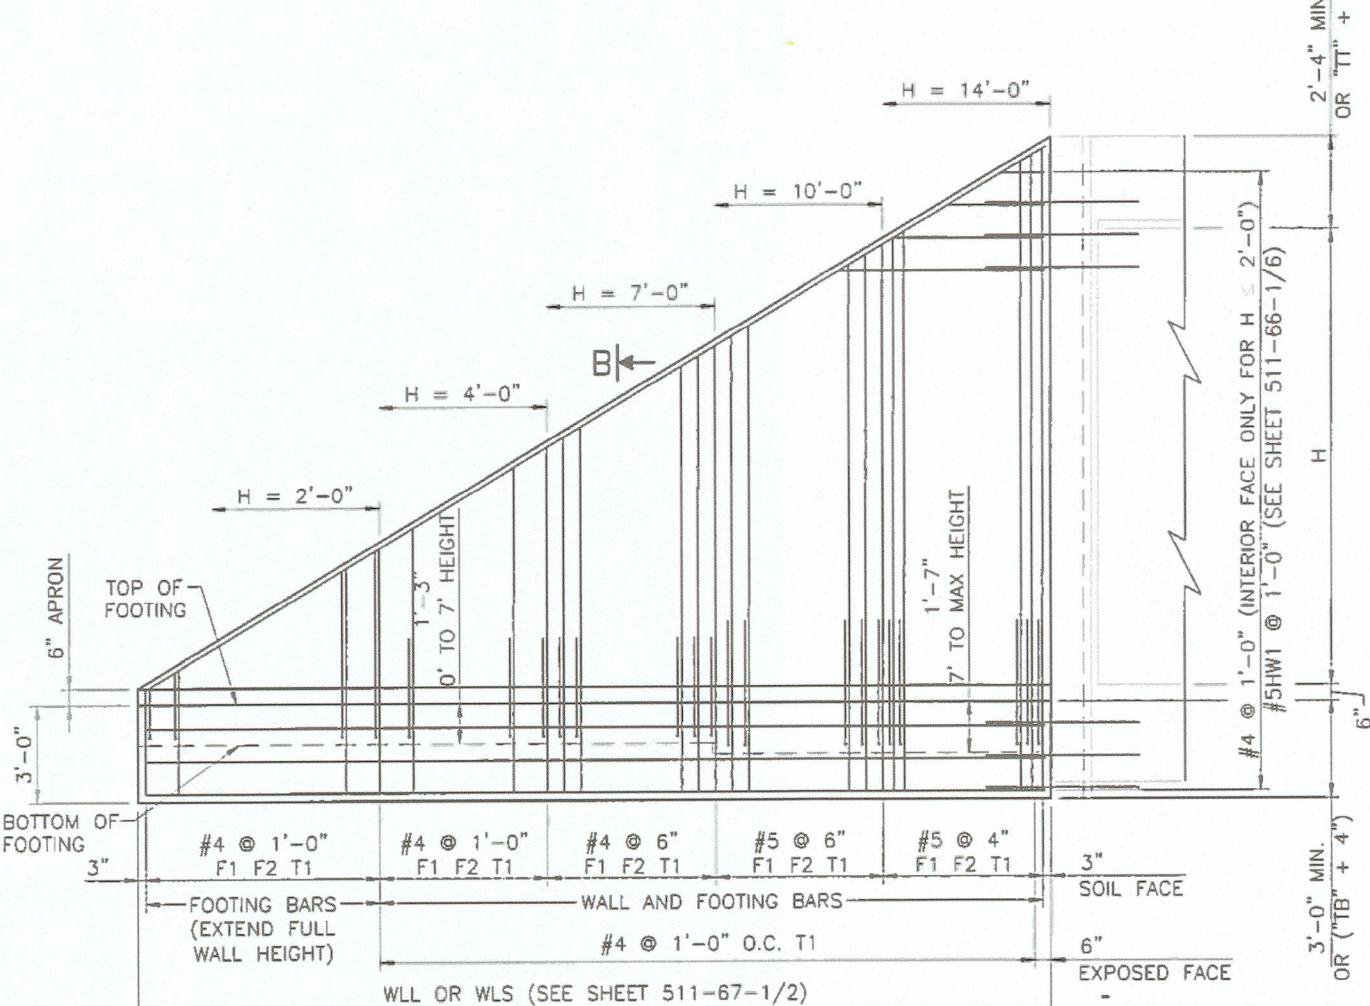

WINGWALL ELEVATION

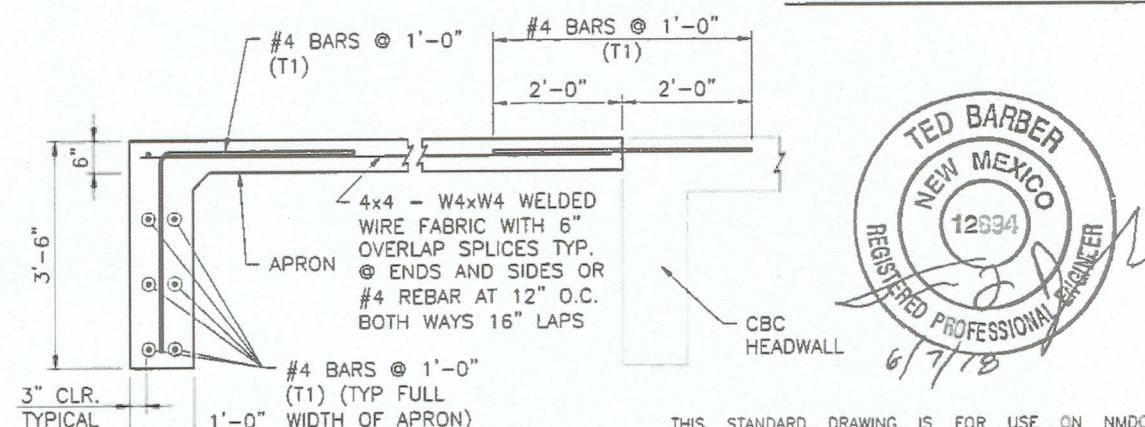

SECTION A-A



THIS STANDARD DRAWING IS FOR USE ON NMDOT PROJECTS. OTHERS WHO USE THE NMDOT STANDARD DRAWINGS DO SO AT THEIR OWN RISK. STANDARD DRAWINGS THAT ARE APPLICABLE TO A SPECIFIC PROJECT WILL BE IDENTIFIED ON THE PROJECT PLANS BUT WILL NOT BE PHYSICALLY INCLUDED IN THOSE PLANS. THE DESIGNER WHO SPECIFIES A STANDARD DRAWING ACCEPTS THE RESPONSIBILITY OF DETERMINING THEIR APPLICABILITY.

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PROJECT NAME	BY