



ALBUQUEQUE METROPOLITAN ARROYO FLOOD CONTROL AUTHORITY



CONSTRUCTION PLANS
FOR


BARR SPUR IMPROVEMENTS

ALBUQUERQUE, NM 87105

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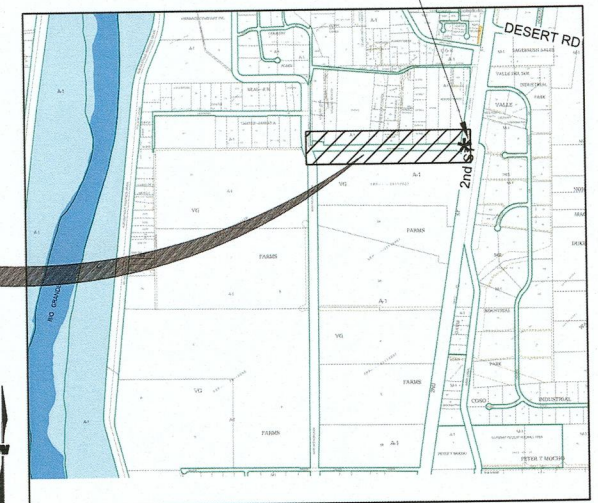
SITE
LOCATION



VICINITY MAP
NTS

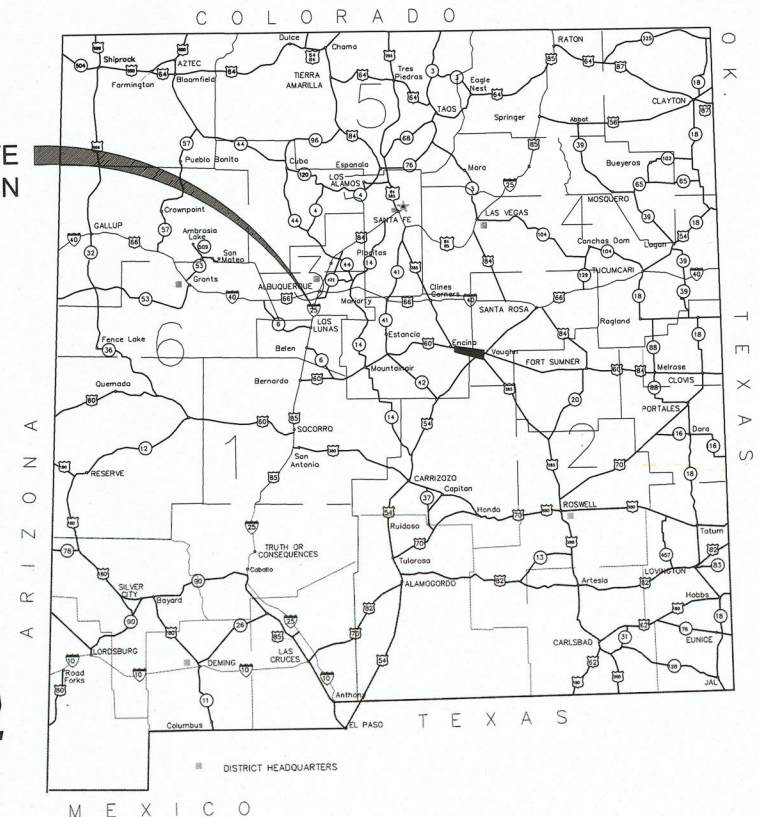PREBID SITE LOCATION

PROJECT
LOCATION



LOCATION MAP:
ZONE MAP R-12, R-13, S-12 & S-13
NTS

JERRY LOVATO, PE, EXECUTIVE ENGINEER
APPROVAL FOR BIDDING & CONSTRUCTION
ALBUQUERQUE METROPOLITAN ARROYO
FLOOD CONTROL AUTHORITY

DATE

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& COMPANY**
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CONSULTANTS

60% SUBMITTAL
NOT FOR
CONSTRUCTION

SEAL

BARR SPUR
IMPROVEMENTS

PROJECT NAME

BY	DESCRIPTION	DATE	REV.

PROJECT NO: 1660060700
DESIGNED BY: TJA
DRAWN BY: JEM
CHECKED BY: TJA
DATE: JAN 2022
SHEET TITLE

COVER SHEET

SHEET NO:

G-001

GENERAL NOTES:

1. ALL WORK DETAILED ON THESE PLANS TO BE PERFORMED OR CONTRACTED SHALL, EXCEPT AS OTHERWISE STATED OR PROVIDED FOR HEREON, BE CONSTRUCTED IN ACCORDANCE WITH THE NEW MEXICO STATE HIGHWAY AND TRANSPORTATION DEPARTMENT STANDARD SPECIFICATIONS FOR HIGHWAY AND BRIDGE CONSTRUCTION, 2019 EDITION
2. ALL STATIONING FOR THE ROADWAYS, EMBANKMENTS AND CHANNELS REFER TO THE MEASURED HORIZONTAL DISTANCE. LEFT AND RIGHT OF CENTERLINE ARE LOOKING IN THE DIRECTION OF INCREASING STATION.
3. WHEN COORDINATES ARE SHOWN, HEREIN (N,E) THEY REFER TO GROUND COORDINATES. PROJECT GROUND COORDINATES ARE CALCULATED FROM ADJUSTED GRID COORDINATES USING A PROJECT COMBINED GRID-TO-GROUND FACTOR (CGGF) TO OBTAIN ADJUSTED GRID COORDINATES DIVIDE THE PROJECT GROUND COORDINATES BY THE CGGF. TO OBTAIN PROJECT GROUND COORDINATES MULTIPLY THE ADJUSTED GRID COORDINATES BY THE CGGF.
4. LIMITS OF WORK ARE SHOWN ON THE PLANS. THE CONTRACTOR SHALL CONFINE HIS OPERATIONS WITHIN THE PROJECT LIMITS UNLESS OTHERWISE NOTED OR PERMITTED. THE CONTRACTOR WILL BE HELD RESPONSIBLE FOR ANY AGREEMENTS NECESSARY OR DAMAGE BY HIS OPERATION TO PUBLIC OR PRIVATE PROPERTY INCLUDING UTILITIES.
5. FILL MATERIALS FROM EXCAVATION OR BORROW WHICH REQUIRE MORE THAN ONE HANDLING PRIOR TO FINAL PLACEMENT, INCLUDING STOCKPILING AND BLENDING TO MEET GRADATION REQUIREMENTS OR STOCKPILING FOR LATER DISPOSAL, WILL BE CONSIDERED INCIDENTAL TO THE CONTRACT UNIT PRICE FOR UNCLASSIFIED EXCAVATION. NO SEPARATE PAYMENT SHALL BE MADE FOR BLENDING OR MULTIPLE HANDLING AND FINAL PAYMENT SHALL BE MADE ON THE BASIS OF QUANTITIES REMOVED FROM ORIGINAL LOCATION.
6. ANY AREAS DISTURBED BY THE CONTRACTOR THAT ARE AREAS NOT INCLUDED ON THE PLANS SHALL BE TREATED AND STABILIZED WITH USFWS INTERIOR MIX, USFWS EXTERIOR MIX OR MRGCD MIX, AND NO MEASUREMENT OR PAYMENT WILL BE MADE THEREFORE.
7. WATERING, AS REQUIRED FOR CONSTRUCTION AND DUST CONTROL, SHALL BE CONSIDERED INCIDENTAL TO CONSTRUCTION AND NO MEASUREMENT OR PAYMENT SHALL BE MADE. CONSTRUCTION AREAS SHALL BE WATERED FOR DUST POLLUTION ABATEMENT. THE CONTRACTOR SHALL BE RESPONSIBLE FOR LOCATING AND SUPPLYING WATER AS REQUIRED. THE COST FOR REQUIRED CONSTRUCTION OF AIR QUALITY MITIGATION SHALL BE INCIDENTAL TO THE PROJECT COST.
8. THE CONTRACTOR IS RESPONSIBLE FOR EXECUTING A "SPECIAL USE PERMIT" WITH THE U.S.FISH & WILDLIFE SERVICE. THE CONTRACTOR SHALL COMPLY WITH ALL PROVISIONS OF THE "SPECIAL USE PERMIT".
9. MINOR CHANGES IN ELEVATIONS AND SLOPES FOR EXCAVATION AND FILL MAY BE MADE TO SUIT FIELD CONDITIONS, AS APPROVED BY THE ENGINEER.
10. PRIOR TO CONSTRUCTION, THE CONTRACTOR SHALL EXCAVATE AND VERIFY THE HORIZONTAL AND VERTICAL LOCATIONS OF ALL OBSTRUCTIONS. SHOULD A CONFLICT EXIST, THE CONTRACTOR SHALL NOTIFY THE ENGINEER SO THAT THE CONFLICT CAN BE RESOLVED WITH A MINIMUM AMOUNT OF DELAY. ALL UTILITY LOCATIONS SHOWN ARE APPROXIMATE.
11. TWO (2) WORKING DAYS PRIOR TO ANY EXCAVATION, CONTRACTOR MUST CONTACT N.M. ONE-CALL SYSTEM, (505) 260-1990, FOR LOCATION OF EXISTING UTILITIES.
12. IT SHALL BE THE CONTRACTOR'S RESPONSIBILITY TO ENSURE THAT BUILDING STRUCTURES ADJACENT TO THE PROJECT NOT BE DAMAGED DUE TO ANY CONSTRUCTION ACTIVITIES. DAMAGE CAUSED TO ANY BUILDING STRUCTURE WILL BE THE SOLE RESPONSIBILITY OF THE CONTRACTOR, INCLUDING ALL COSTS INCURRED IN RESTORING/REPAIRING SAID DAMAGE PER NMDOT SPEC. SECTION 617.
13. THE CONTRACTOR SHALL MAINTAIN AN UP TO DATE SET OF AS-BUILT PLANS FOR THE PROJECT. THESE PLANS SHALL BE KEPT CURRENT, WITHIN TWO WEEKS, AT ALL TIMES AND SHALL BE SUBJECT TO REVIEW BY THE PROJECT MANAGER. THE FINAL AS-BUILT PLANS SHALL BE SUBMITTED TO THE PROJECT MANAGER.

14. THE CONTRACTOR SHALL ASSUME RESPONSIBILITY FOR ANY DAMAGE TO EXISTING PAVEMENTS, PAVEMENT MARKINGS, CURB AND GUTTER, DRIVEPADS, HANDICAP RAMPS, AND SIDEWALK DURING CONSTRUCTION APART FROM THOSE SECTIONS INDICATED FOR REMOVAL ON THE PLANS, AND SHALL REMOVE AND REPLACE AS PER BERNALILLO COUNTY STANDARDS, AS APPLICABLE, AT THEIR OWN EXPENSE.
15. WHEN REMOVAL OF EXISTING CURB AND GUTTER OR SIDEWALK IS REQUIRED, REMOVE TO NEAREST JOINT.
16. STRUCTURES SHALL BE CLEAN AT THE TIME OF FINAL PROJECT ACCEPTANCE. THIS WORK WILL BE CONSIDERED AS INCIDENTAL TO THE COMPLETION OF THE PROJECT AND NO SEPARATE MEASUREMENT OR PAYMENT WILL BE MADE THEREFORE.
17. THE CONTRACTOR SHALL INCLUDE IN HIS CONSTRUCTION SEQUENCE PROVISIONS WHICH WILL ALLOW FOR THE SAFE PASSAGE OF WATER FROM ARROYOS AND DITCHES THROUGH THE PROJECT SITE WITHOUT DAMAGE TO FACILITIES BEING CONSTRUCTED, COMPLETED FACILITIES, OR ADJACENT PRIVATE PROPERTY.
18. ALL STORM WATER DISCHARGES FROM THE PROJECT SITE SHALL MEET THE REQUIREMENTS OF THE REGULATIONS OF THE NATIONAL POLLUTANT DISCHARGE ELIMINATION SYSTEM (NPDES) AS WELL AS APPLICABLE STATE AND LOCAL REGULATIONS.
19. SEVEN (7) WORKING DAYS PRIOR TO BEGINNING CONSTRUCTION, THE CONTRACTOR SHALL SUBMIT TO PROJECT MANAGER A DETAILED CONSTRUCTION SCHEDULE. SEVEN (7) WORKING DAYS PRIOR TO CONSTRUCTION, THE CONTRACTOR SHALL OBTAIN A BARRICADING PERMIT FROM BERNALILLO COUNTY, IF NEEDED.
20. CONTRACTOR SHALL MAINTAIN A GRAFFITI-FREE WORK SITE. CONTRACTOR SHALL PROMPTLY REMOVE ANY GRAFFITI FROM ALL EQUIPMENT, WHETHER PERMANENT OR TEMPORARY. THIS WORK IS INCIDENTAL TO TRAFFIC CONTROL BID ITEM.
21. ALL EXCAVATION, TRENCHING AND SHORING ACTIVITIES MUST BE CARRIED OUT IN ACCORDANCE WITH OSHA 29CFR 1926.650 SUBPART P.
22. THE CONTRACTOR WILL BE RESPONSIBLE FOR DISPOSING OF ALL DEBRIS, INCLUDING, NOT LIMITED TO HAZARDOUS WASTE AT DISPOSAL SITES APPROVED BY GOVERNMENTAL AGENCIES REGULATING THE DISPOSAL OF SUCH MATERIALS.
23. THE CONTRACTOR SHALL PROVIDE AND MAINTAIN ALL CONSTRUCTION SIGNING UNTIL PROJECT HAS BEEN ACCEPTED BY AMAFCA.
24. SOME OF THE CONSTRUCTION WILL TAKE PLACE ON PROPERTY OWNED BY THE U.S. FISH & WILDLIFE SERVICE THAT ALLOWS PUBLIC ACCESS. CONTRACTOR SHALL PROVIDE APPROPRIATE BARRICADES & WARNING SIGNS AROUND THE WORK ZONE.

MRGCD GENERAL NOTES:

1. THE CONTRACTOR IS RESPONSIBLE FOR EXECUTING A "SPECIAL USE LICENSE AGREEMENT" WITH THE M.R.G.C.D. PRIOR TO CONSTRUCTION. THE CONTRACTOR SHALL COMPLY WITH ALL PROVISIONS OF THE "SPECIAL USE LICENSE" INCLUDING BUT NOT LIMITED TO: CONSTRUCTION DEADLINES, COORDINATION WITH M.R.G.C.D OPERATIONS AND DEWATERING REQUIREMENTS.
2. THE CONTRACTOR SHALL NOT STORE EQUIPMENT, NEW MATERIALS OR DEBRIS WITHIN DISTRICT RIGHT-OF-WAY, OUTSIDE OF THE ESTABLISHED CONSTRUCTION LIMITS, WHICH MAY INTERFERE WITH OPERATIONS AND MAINTENANCE OF M.R.G.C.D. FACILITIES.
3. THE CONTRACTOR SHALL NOT SERVICE VEHICLES OR EQUIPMENT WITHIN M.R.G.C.D. RIGHT-OF-WAY, OUTSIDE OF THE ESTABLISHED CONSTRUCTION LIMITS.
4. SEEDING OF DISTURBED AREAS WITHIN M.R.G.C.D. RIGHT-OF-WAYS IS REQUIRED PER THE M.R.G.C.D SEEDING SPECIFICATIONS WITHIN THE ESTABLISHED CONSTRUCTION LIMITS.
5. THE CONTRACTOR SHALL BE RESPONSIBLE FOR OBTAINING PERMISSION FROM INDIVIDUAL LANDOWNERS TO ACCESS THE PROJECT SITE BY WAY OF PRIVATE CROSSINGS AND PROPERTY.
6. THE CONTRACTOR IS RESPONSIBLE FOR REPAIRING AND OR REPLACEMENT OF ANY STRUCTURES REMOVED AND OR DAMAGED DUE TO THE CONTRACTOR'S ACTIVITIES WITHIN THE DISTRICT'S RIGHT-OF-WAY. ANY STRUCTURES SUCH AS TURNOUTS, CULVERT PIPES, EMBANKMENTS, DRIVEWAYS, FENCING, AND OTHERS WHICH ARE DAMAGED DURING CONSTRUCTION ACTIVITIES, SHALL BE REPLACED AT THE CONTRACTOR'S EXPENSE. REPAIRS AND OR REPLACEMENTS WITHIN M.R.G.C.D RIGHT-OF-WAY MUST COMPLY WITH THE PROJECT AND DISTRICT SPECIFICATIONS.
7. ALL SALVAGEABLE CULVERTS, IRRIGATION GATES, ETC. MUST BE RETURNED TO THE M.R.G.C.D.
8. TEMPORARY INSTALLATIONS SHALL BE REMOVED BEFORE PROJECT COMPLETION SUCH THAT THE FINISHED WORK WILL NOT INTERFERE WITH OPERATIONS OF THE M.R.G.C.D FACILITIES.


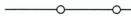



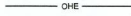





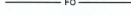



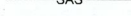

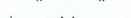
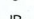







THE FOLLOWING NOTES ALSO APPLY WHEN CHECKED:

- ☒ ALL UTILITIES AND UTILITY SERVICE LINES SHALL BE INSTALLED PRIOR TO PAVING.
- ☐ BACKFILL COMPACTION SHALL BE ACCORDING TO SPECIFIED STREET USE.
- ☐ TACK COAT REQUIREMENTS SHALL BE DETERMINED BY THE ENGINEER.
- ☐ SIDEWALKS AND WHEELCHAIR RAMPS WITHIN THE CURB RETURNS SHALL BE CONSTRUCTED WHEREVER A NEW CURB RETURN IS CONSTRUCTED.
- ☐ IF CURB IS DEPRESSIONED FOR A DRIVEPAD, THE DRIVEPAD SHALL BE CONSTRUCTED PRIOR TO ACCEPTANCE OF CURB AND GUTTER.
- ☒ ALL STORM DRAINAGE FACILITIES SHALL BE COMPLETED PRIOR TO FINAL ACCEPTANCE.

[illegible]

LUNA, DAMIAN	OFFICE PHONE: (505) 289-3031 OFFICE FAX: (505) 289-3060 CELL PHONE: (505) 414-5695 DLUNA@ABCWUA.ORG	ALBUQUERQUE BERNALILLO COUNTY WATER UTILITY AUTHORITY P.O. BOX 568 ALBUQUERQUE, NM 87103
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LOPEZ, ALICIA	OFFICE PHONE: (505) 247-0234 ext. 1356 ALICIA@MRGCD.US	M.R.G.C.D 1931 SECOND ST. SW ALBUQUERQUE, NM 87102

LEGEND:

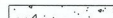	UTILITY, WATER VALVE		FENCE, CHAIN LINK
	UTILITY, WATER MANHOLE		FENCE, PIG WIRE
	UTILITY, WATER FAUCET		UTILITY, OVERHEAD ELECTRIC LINE
	UTILITY, POWER POLE		UTILITY, UNDERGROUND ELECTRIC LINE
	DRAINAGE, MANHOLE		UTILITY, TELEPHONE LINE
	DRAINAGE, AREA INLET		UTILITY, FIBER OPTIC LINE
	SANITARY, MANHOLE		UTILITY, GAS LINE
	SANITARY, MANHOLE		UTILITY, SANITARY SEWER LINE
	SITE, MONITORING WELL		UTILITY, WATER LINE
	SITE, BOLLARD		SITE, TREE LINE
	SITE, IRRIGATION VALVE		SITE, MAJOR CONTOUR
	BORE HOLE LOCATION		SITE, MINOR CONTOUR
			SITE, BASE COURSE ROAD
			SITE, CONCRETE/SHOTCRETE

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& COMPANY

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CONSULTANTS

SEAL

60% SUBMITTAL
NOT FOR
CONSTRUCTION

PROJECT NAME

BARR SPUR IMPROVEMENTS

[illegible]

PROJECT NO:	1660060700
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DESIGNED BY: TJA

DRAWN BY: JEM

CHECKED BY:	TJA
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DATE: JAN 2022


SHEET TITLE	
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GENERAL NOTES

SHEET NO:

G-002

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1/5/2022

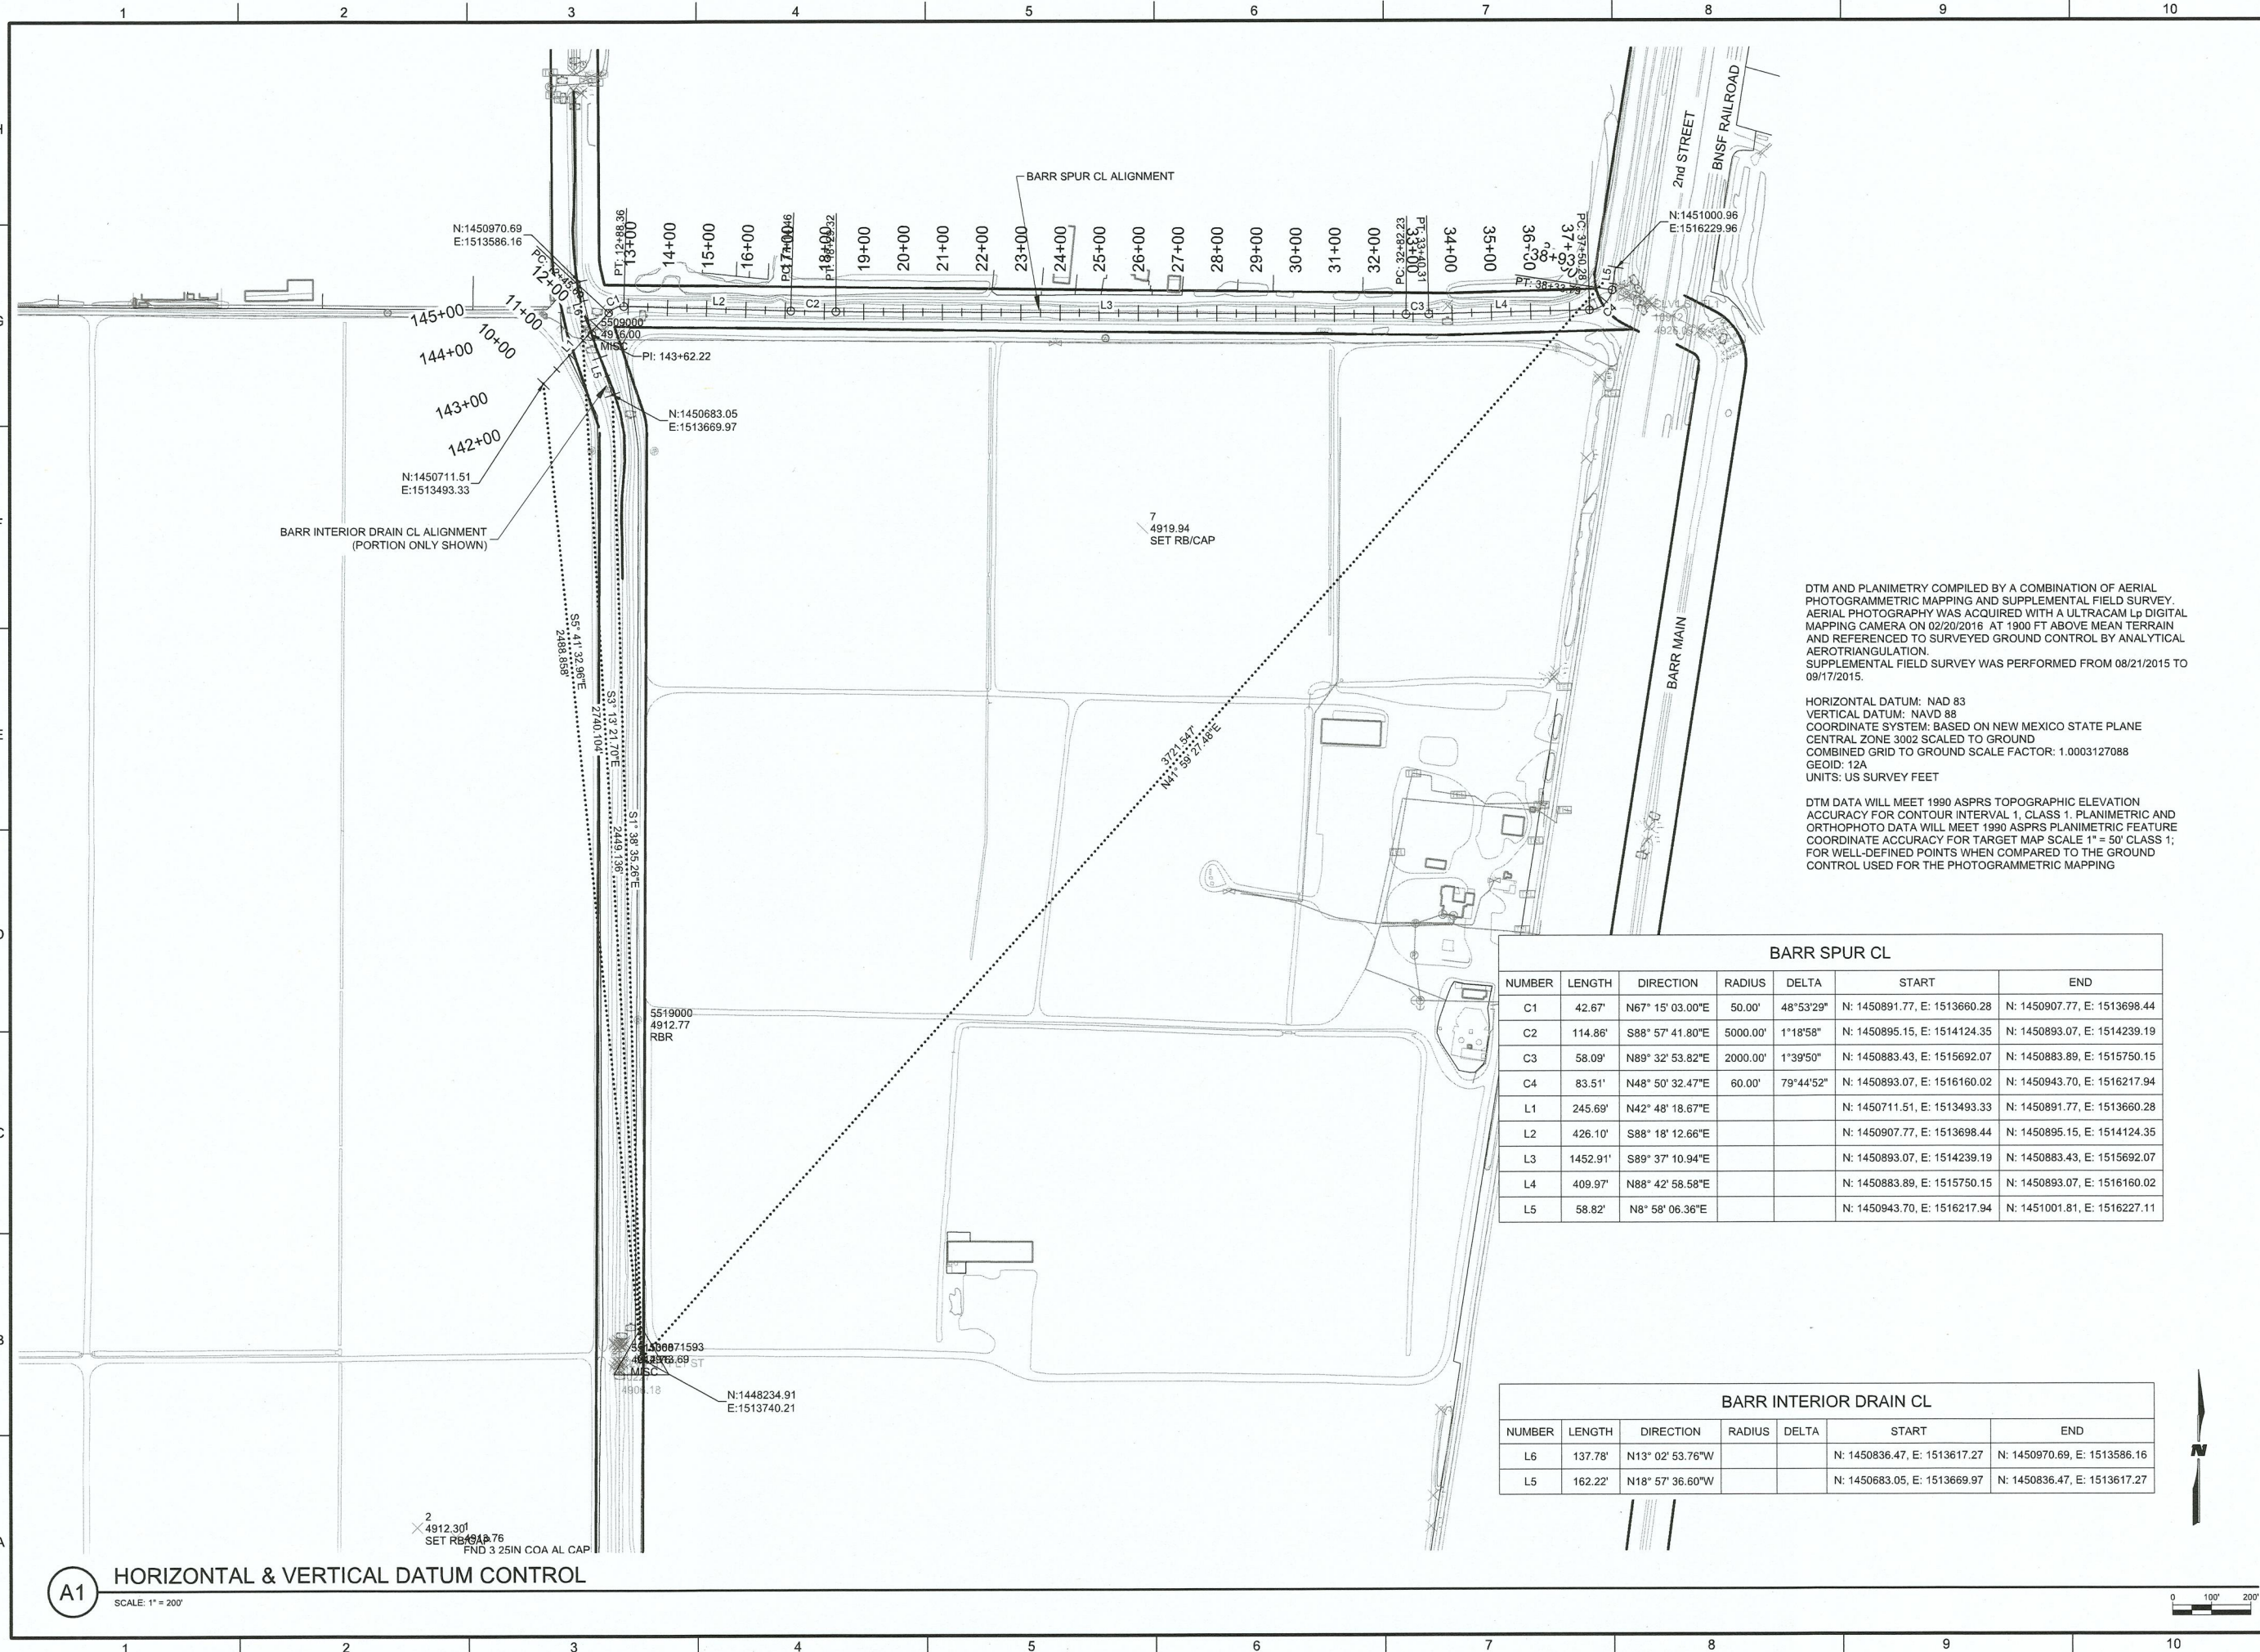

WILSON & COMPANY
4401 MASTHEAD ST. NE, SUITE 150
ALBUQUERQUE, NM 87109
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FAX: 505-348-4072
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CONSULTANTS

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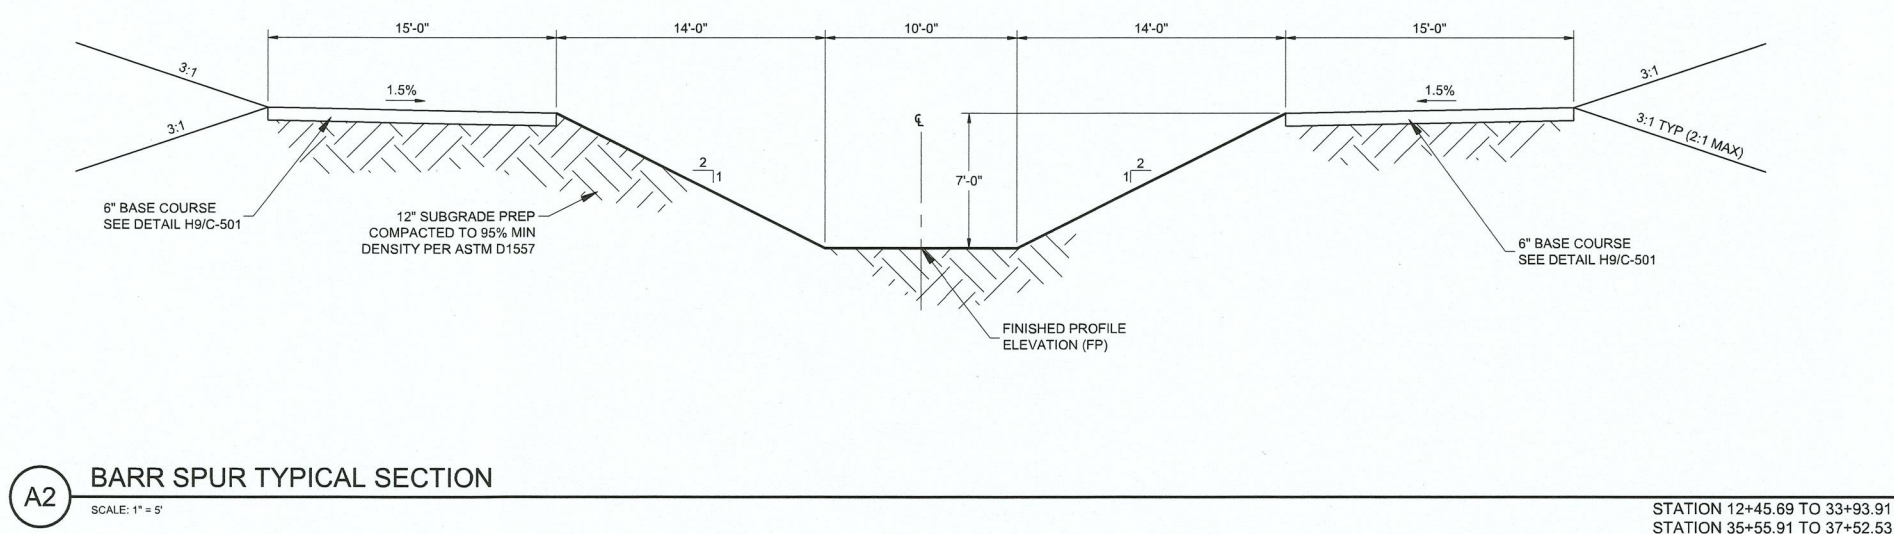
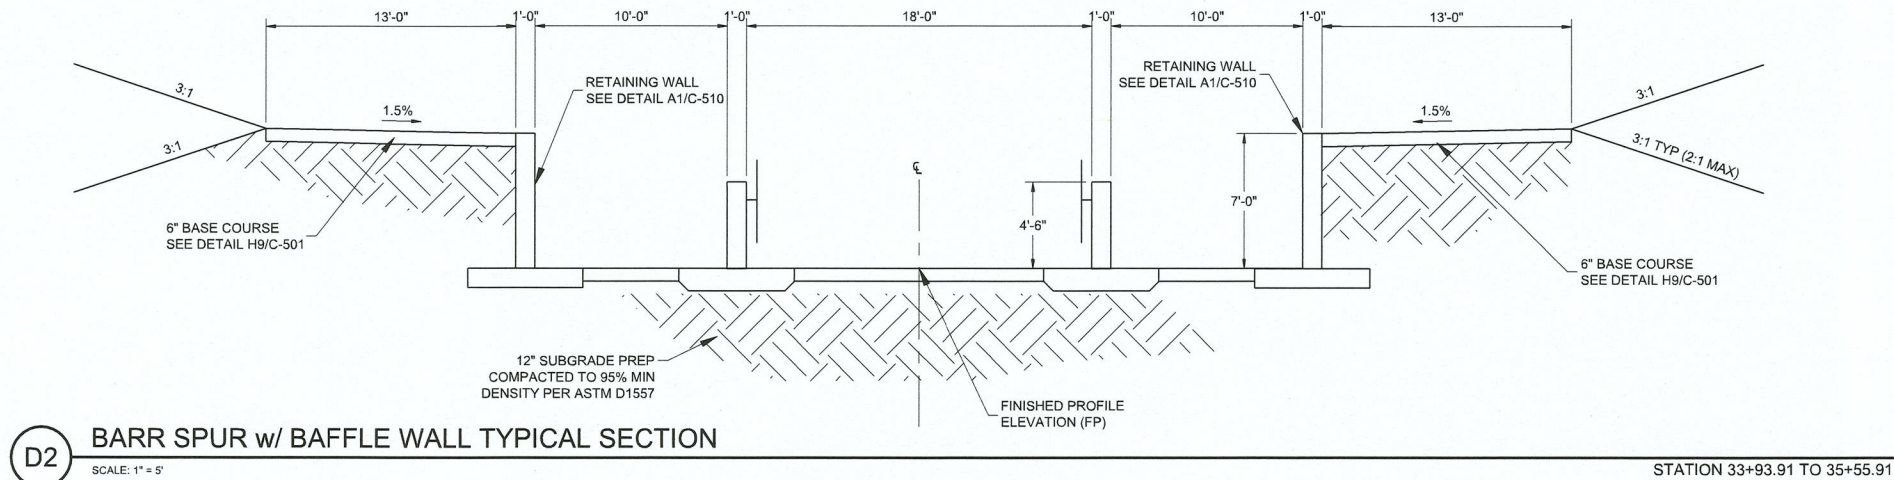
**BARR SPUR
IMPROVEMENTS**

PROJECT NAME

REV.	DATE	DESCRIPTION	BY

PROJECT NO: 166060700
DESIGNED BY: TJA
DRAWN BY: JEM
CHECKED BY: TJA
DATE: JAN 2022
SHEET TITLE
HORIZONTAL & VERTICAL DATUM CONTROL
SHEET NO:
C-101

1/5/2022 M:\MSD\16-600-607-002_Disciplines\16-600-607-002_SHEETS\16-600-607-002_TS01.dwg



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**BARR SPUR
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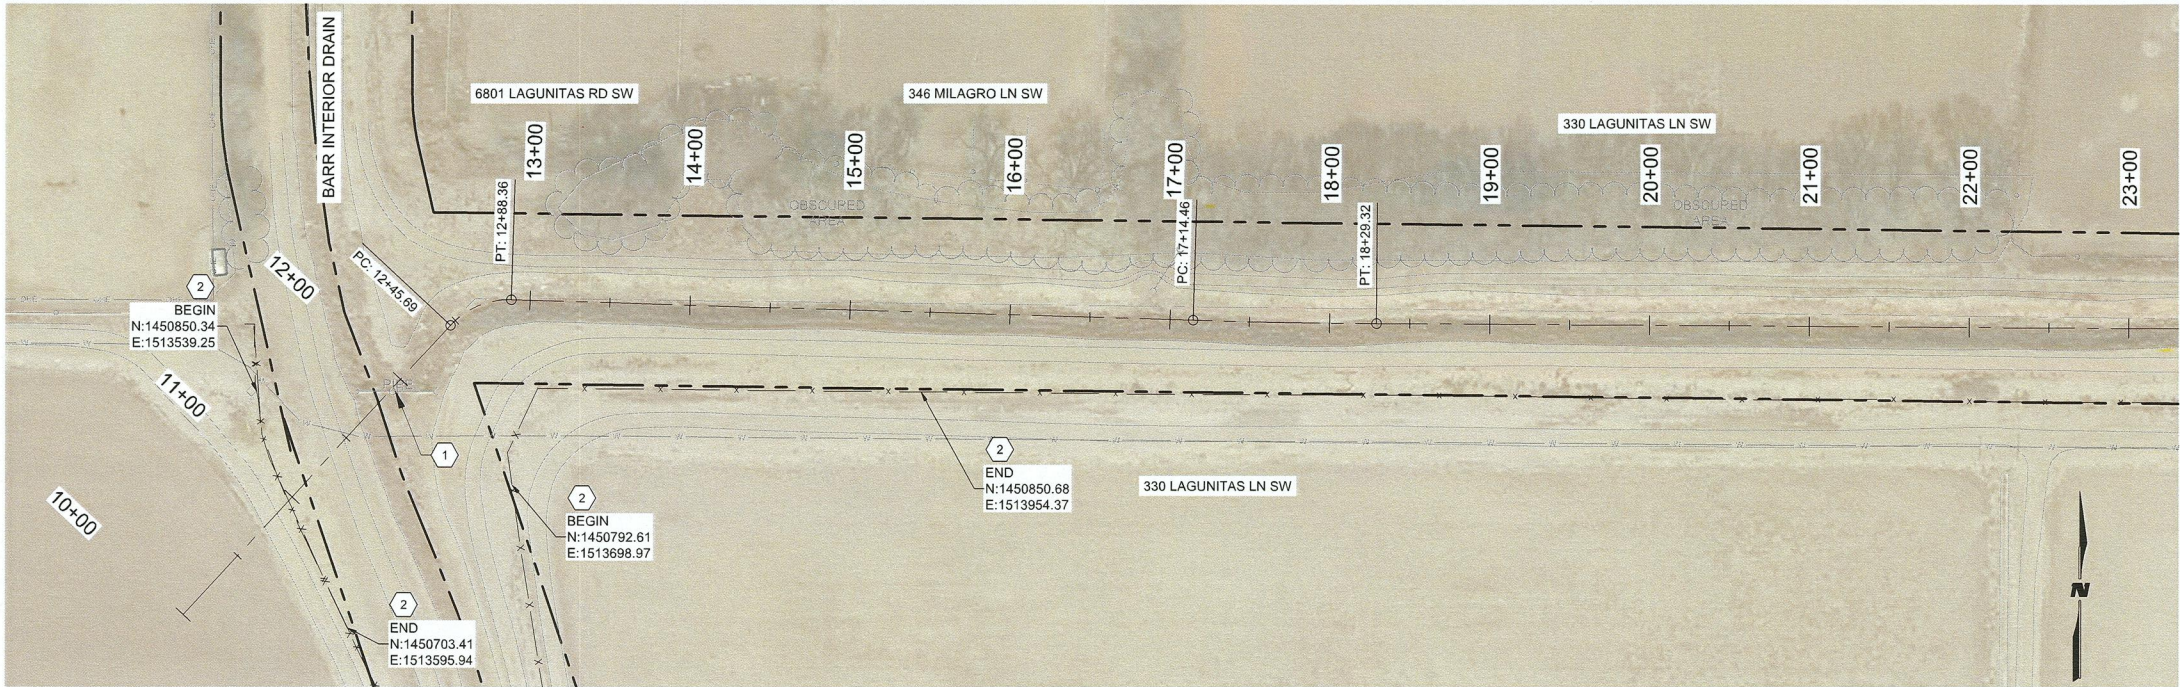
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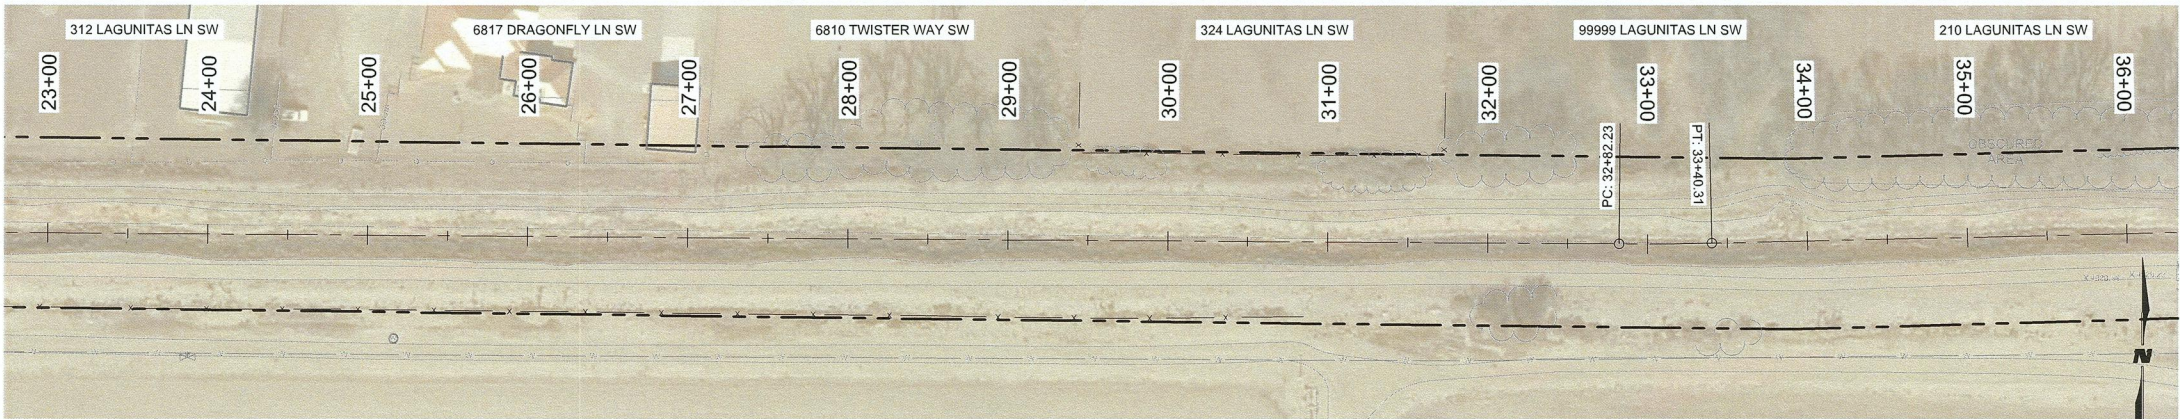
TYPICAL SECTIONS

SHEET NO:
C-102


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F1 DEMOLITION PLAN
SCALE: 1" = 60'



C1 DEMOLITION PLAN
SCALE: 1" = 60'



A3 DEMOLITION PLAN
SCALE: 1" = 60'

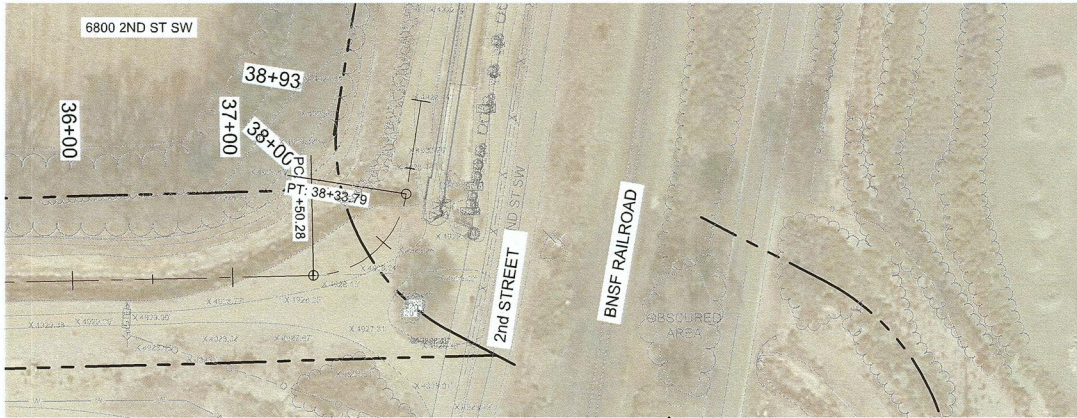GENERAL SHEET NOTES

- DEMOLITION AND REMOVAL OF IRRIGATION PIPE, STRUCTURES, AND DITCHES SHALL BE COORDINATED WITH MRGCD PROJECT MANAGER.
- REMOVAL OF CLAY TILE UNDER DRAIN STRUCTURES SHALL BE COORDINATED WITH AMAFCA PROJECT MANAGER.

KEYNOTES

- REMOVE AND DISPOSE CULVERT PIPE.
- REMOVE AND SALVAGE BARBED WIRE FENCE.

LEGEND



WILSON & COMPANY

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ALBUQUERQUE, NM 87109
PHONE: 505-348-4000
FAX: 505-348-4072
www.wilsonco.com

CONSULTANTS

SEAL

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CONSTRUCTION

PROJECT NAME

BARR SPUR
IMPROVEMENTS

REV.	DATE	DESCRIPTION	BY


PROJECT NO: 1660060700
DESIGNED BY: TJA
DRAWN BY: JEM
CHECKED BY: TJA
DATE: JAN 2022
SHEET TITLE

DEMOLITION PLAN

SHEET NO:

C-103

M:\MSD\16-600-607-002_Disciplines\Sheets - civil\BARR SPUR166607-GD04.dwg 1/5/2022

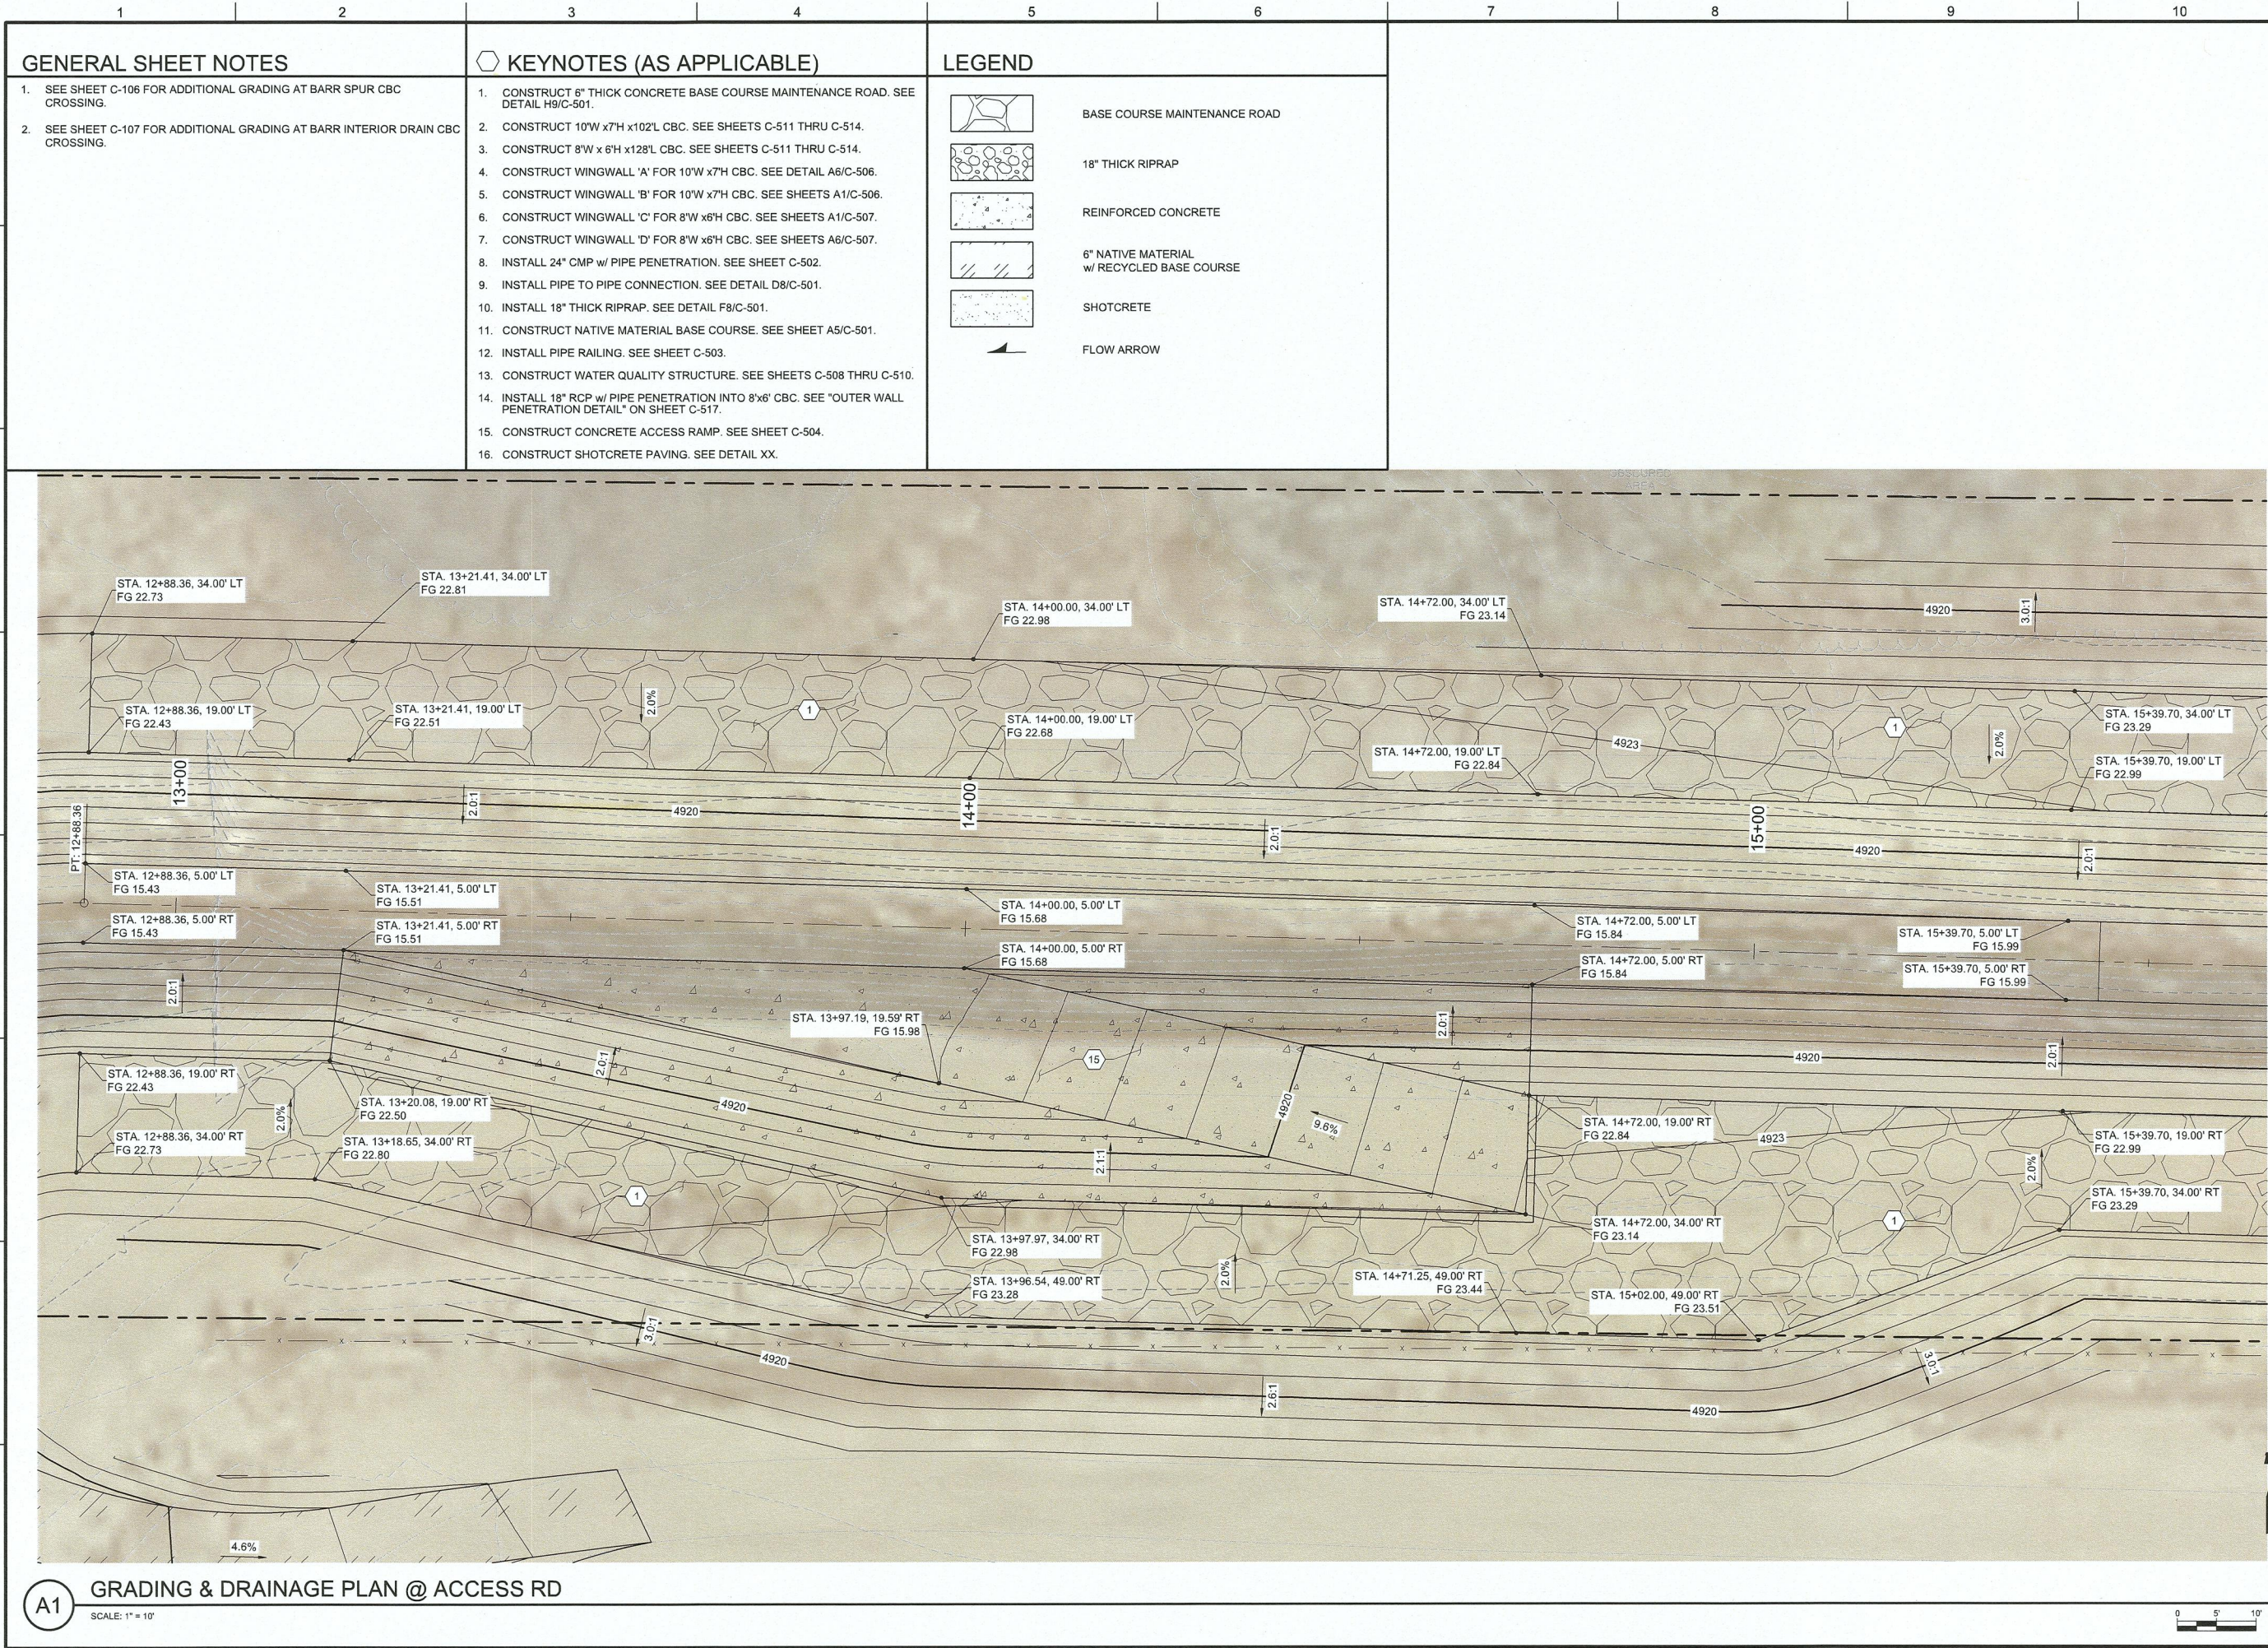

GENERAL SHEET NOTES

- SEE SHEET C-106 FOR ADDITIONAL GRADING AT BARR SPUR CBC CROSSING.
- SEE SHEET C-107 FOR ADDITIONAL GRADING AT BARR INTERIOR DRAIN CBC CROSSING.

KEYNOTES (AS APPLICABLE)

- CONSTRUCT 6" THICK CONCRETE BASE COURSE MAINTENANCE ROAD. SEE DETAIL H9/C-501.
- CONSTRUCT 10'W x7'H x102'L CBC. SEE SHEETS C-511 THRU C-514.
- CONSTRUCT 8'W x 6'H x128'L CBC. SEE SHEETS C-511 THRU C-514.
- CONSTRUCT WINGWALL 'A' FOR 10'W x7'H CBC. SEE DETAIL A6/C-506.
- CONSTRUCT WINGWALL 'B' FOR 10'W x7'H CBC. SEE SHEETS A1/C-506.
- CONSTRUCT WINGWALL 'C' FOR 8'W x6'H CBC. SEE SHEETS A1/C-507.
- CONSTRUCT WINGWALL 'D' FOR 8'W x6'H CBC. SEE SHEETS A6/C-507.
- INSTALL 24" CMP w/ PIPE PENETRATION. SEE SHEET C-502.
- INSTALL PIPE TO PIPE CONNECTION. SEE DETAIL D8/C-501.
- INSTALL 18" THICK RIPRAP. SEE DETAIL F8/C-501.
- CONSTRUCT NATIVE MATERIAL BASE COURSE. SEE SHEET A5/C-501.
- INSTALL PIPE RAILING. SEE SHEET C-503.
- CONSTRUCT WATER QUALITY STRUCTURE. SEE SHEETS C-508 THRU C-510.
- INSTALL 18" RCP w/ PIPE PENETRATION INTO 8'x6' CBC. SEE "OUTER WALL PENETRATION DETAIL" ON SHEET C-517.
- CONSTRUCT CONCRETE ACCESS RAMP. SEE SHEET C-504.
- CONSTRUCT SHOTCRETE PAVING. SEE DETAIL XX.

LEGEND

- BASE COURSE MAINTENANCE ROAD
- 18" THICK RIPRAP
- REINFORCED CONCRETE
- 6" NATIVE MATERIAL w/ RECYCLED BASE COURSE
- SHOTCRETE
- FLOW ARROW

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PROJECT NAME

BARR SPUR
IMPROVEMENTS

REV.	DATE	DESCRIPTION	BY


PROJECT NO: 1660060700
DESIGNED BY: TJA
DRAWN BY: JEM
CHECKED BY: TJA
DATE: JAN 2022

SHEET TITLE

GRADING &
DRAINAGE PLAN @
ACCESS RD

SHEET NO:


C-105

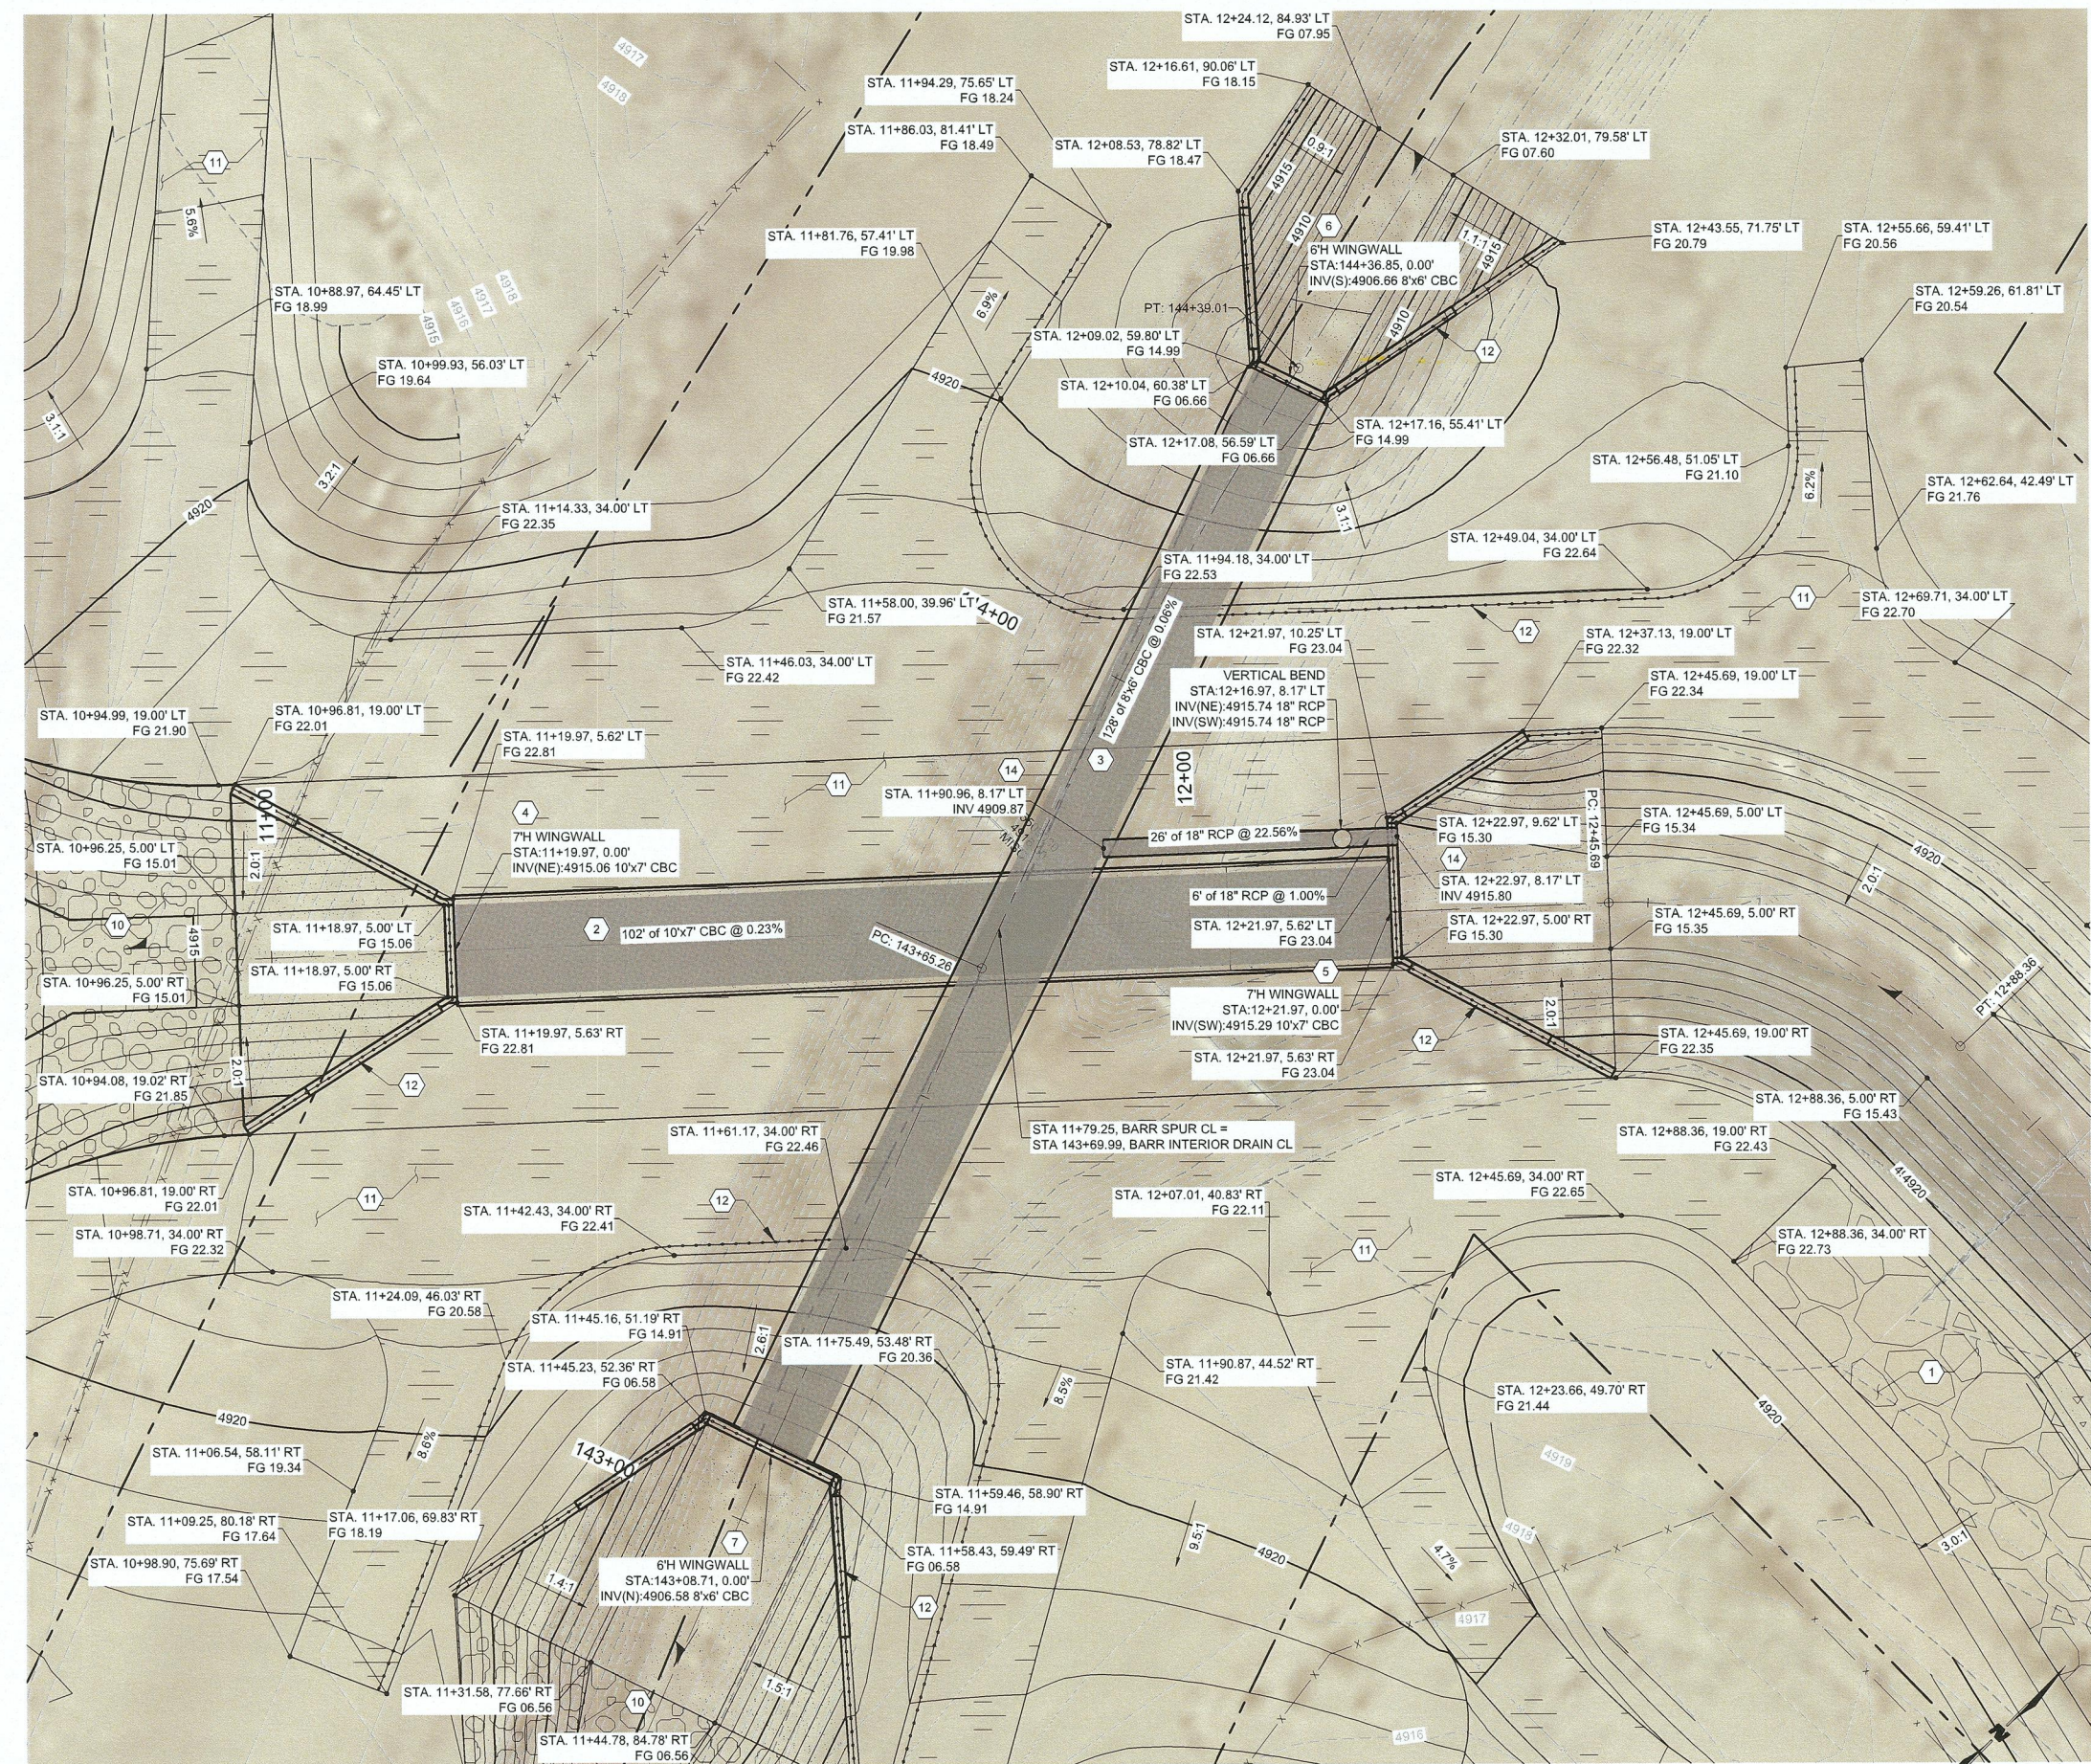

SCALE: 1" = 10'

C-106

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



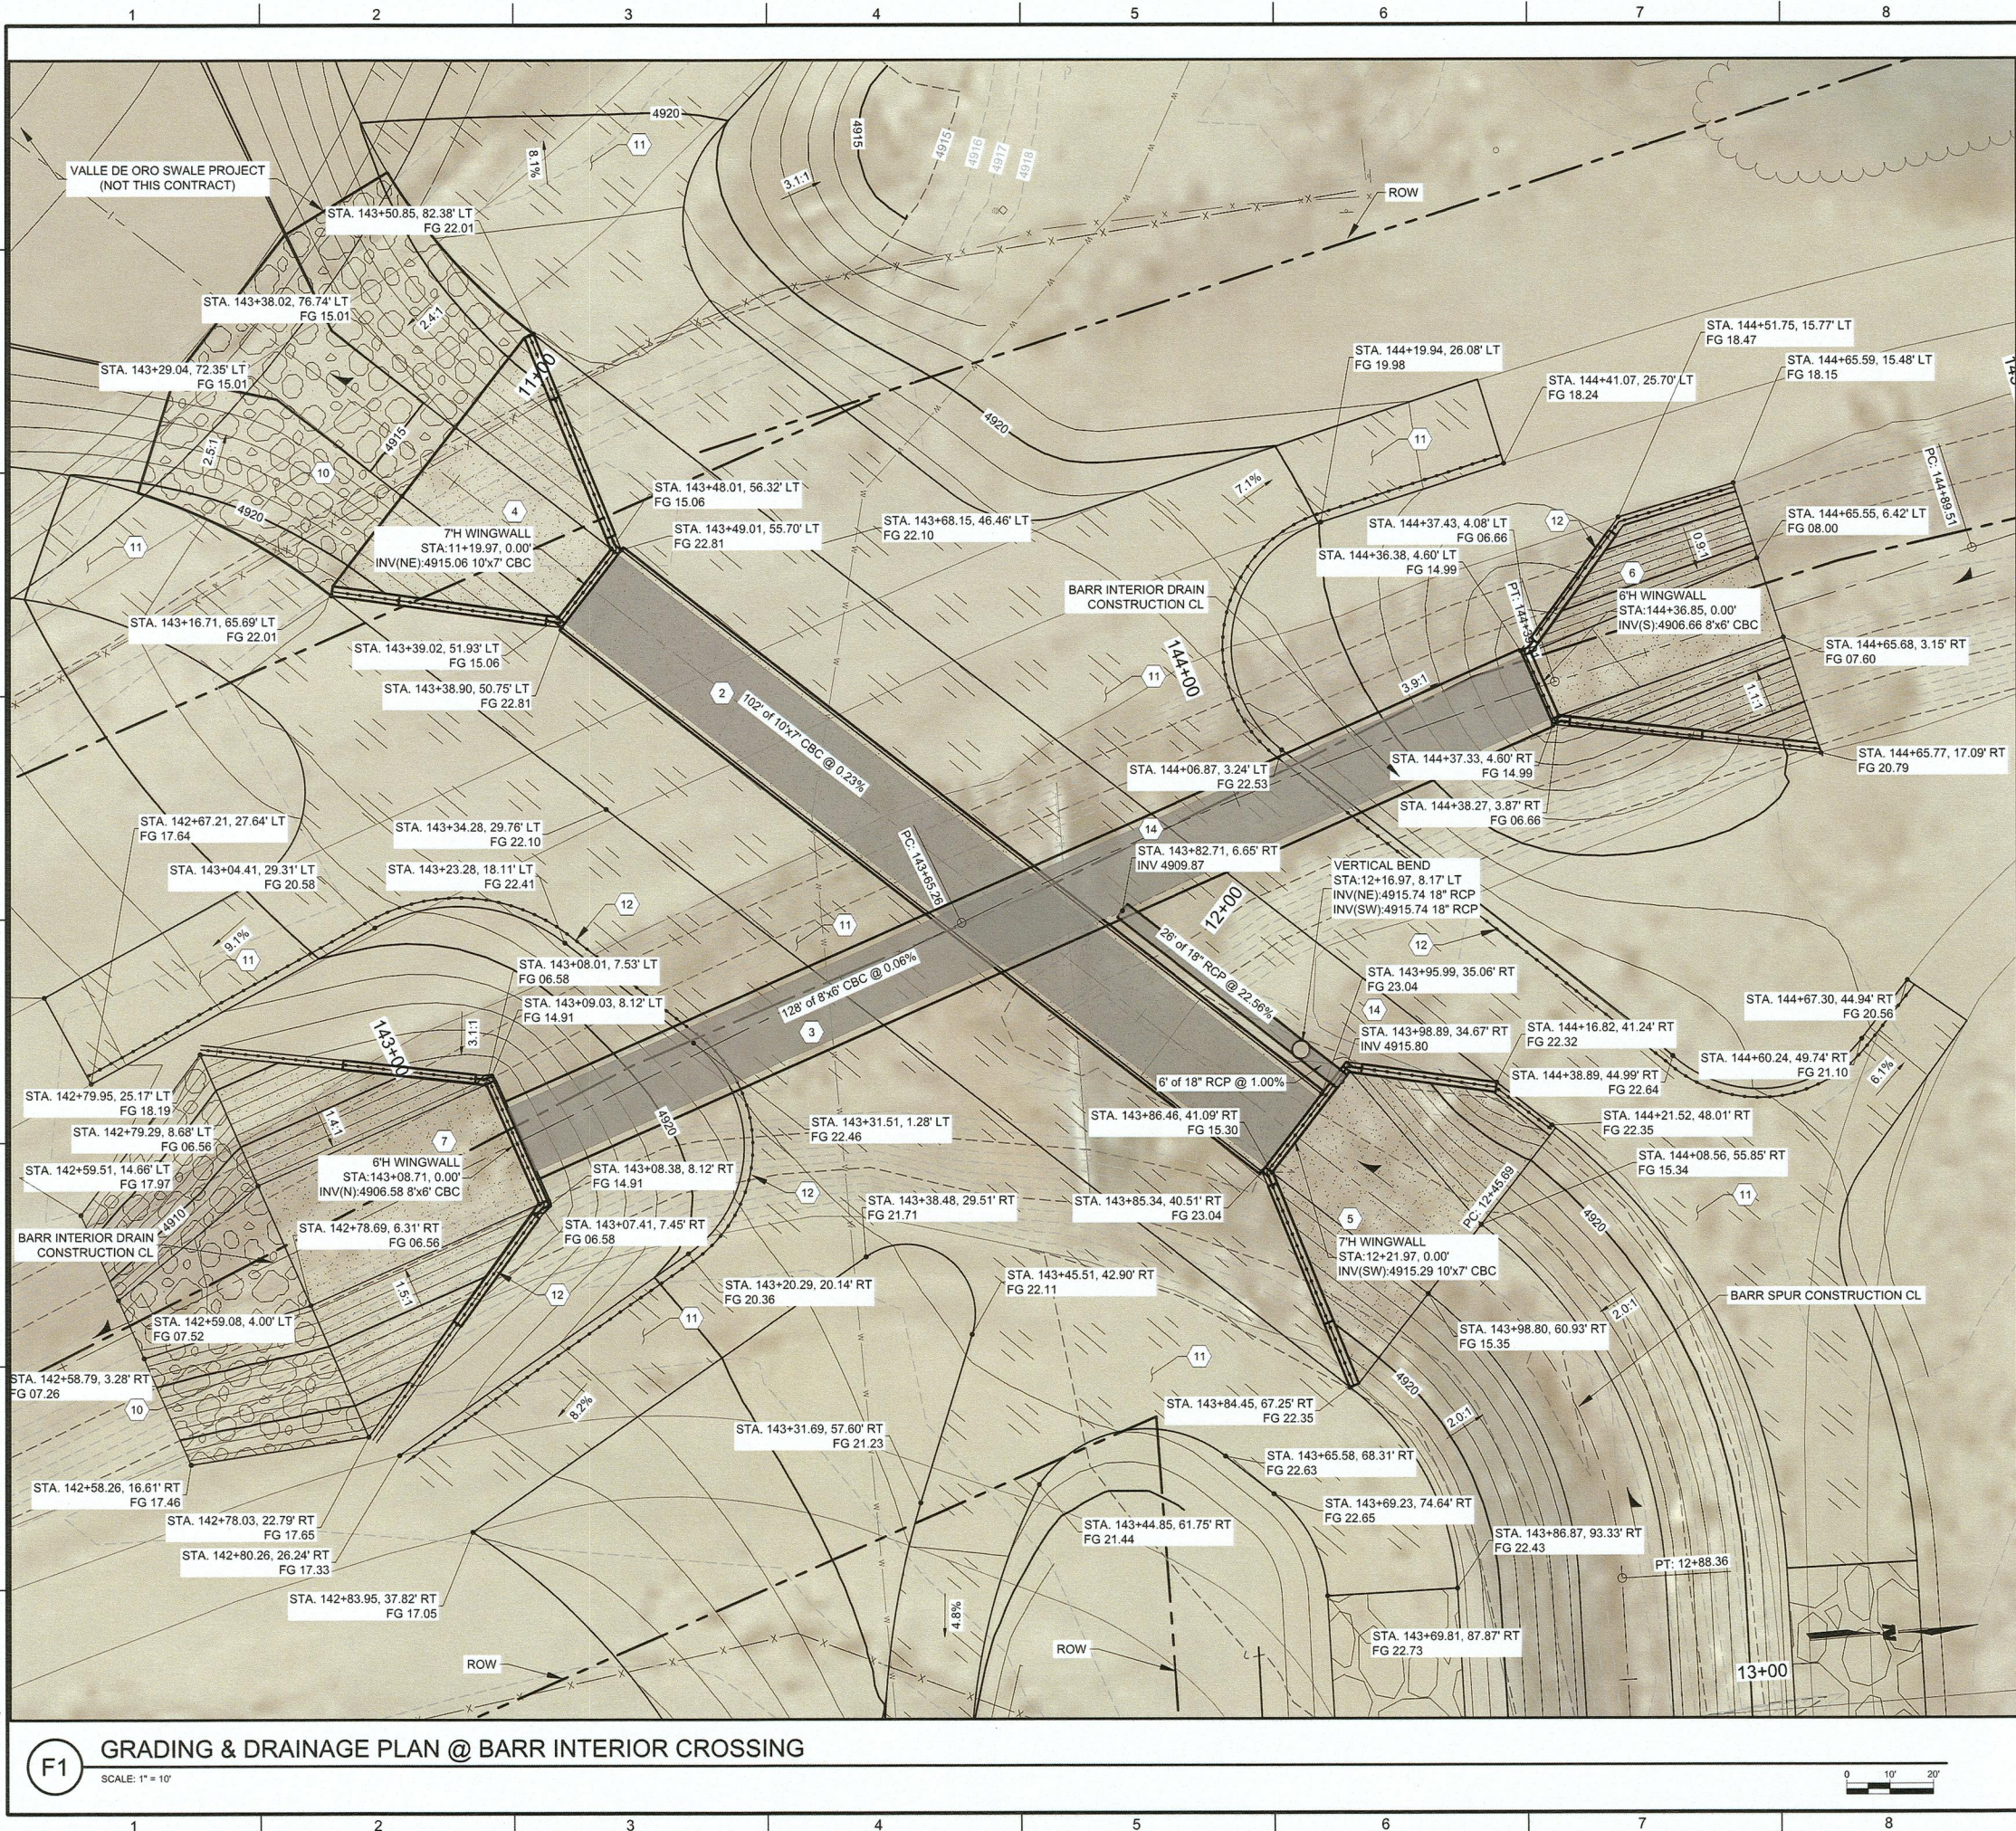

GENERAL SHEET NOTES

- GENERAL SHEET NOTES.

KEYNOTES (AS APPLICABLE)

- CONSTRUCT 6" THICK CONCRETE BASE COURSE MAINTENANCE ROAD. SEE DETAIL H9/C-501.
- CONSTRUCT 10'W x 7'H x 102'L CBC. SEE SHEETS C-511 THRU C-514.
- CONSTRUCT 8'W x 6'H x 128'L CBC. SEE SHEETS C-511 THRU C-514.
- CONSTRUCT WINGWALL 'A' FOR 10'W x 7'H CBC. SEE DETAIL A6/C-506.
- CONSTRUCT WINGWALL 'B' FOR 10'W x 7'H CBC. SEE SHEETS A1/C-506.
- CONSTRUCT WINGWALL 'C' FOR 8'W x 6'H CBC. SEE SHEETS A1/C-507.
- CONSTRUCT WINGWALL 'D' FOR 8'W x 6'H CBC. SEE SHEETS A6/C-507.
- INSTALL 24" CMP w/ PIPE PENETRATION. SEE SHEET C-502.
- INSTALL PIPE TO PIPE CONNECTION. SEE DETAIL D8/C-501.
- INSTALL 18" THICK RIPRAP. SEE DETAIL F8/C-501.
- CONSTRUCT NATIVE MATERIAL BASE COURSE. SEE SHEET A5/C-501.
- INSTALL PIPE RAILING. SEE SHEET C-503.
- CONSTRUCT WATER QUALITY STRUCTURE. SEE SHEETS C-508 THRU C-510.
- INSTALL 18" RCP w/ PIPE PENETRATION INTO 8'x6' CBC. SEE "OUTER WALL PENETRATION DETAIL" ON SHEET C-517.
- CONSTRUCT CONCRETE ACCESS RAMP. SEE SHEET C-504.
- CONSTRUCT SHOTCRETE PAVING. SEE DETAIL XX.

LEGEND

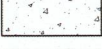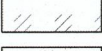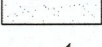	BASE COURSE MAINTENANCE ROAD
	18" THICK RIPRAP
	REINFORCED CONCRETE
	6" NATIVE MATERIAL w/ RECYCLED BASE COURSE
	SHOTCRETE
	FLOW ARROW

WILSON & COMPANY
4401 MASTHEAD ST. NE, SUITE 150
ALBUQUERQUE, NM 87109
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FAX: 505-348-4072
www.wilsonco.com

CONSULTANTS

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CONSTRUCTION

PROJECT NAME

BARR SPUR
IMPROVEMENTS

REV	DATE	DESCRIPTION	BY


PROJECT NO: 1660060700
DESIGNED BY: TJA
DRAWN BY: JEM
CHECKED BY: TJA
DATE: JAN 2022

SHEET TITLE
GRADING &
DRAINAGE PLAN @
BARR INTERIOR
CROSSING

SHEET NO:


C-107

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A1 GRADING & DRAINAGE PLAN @ CULVERT

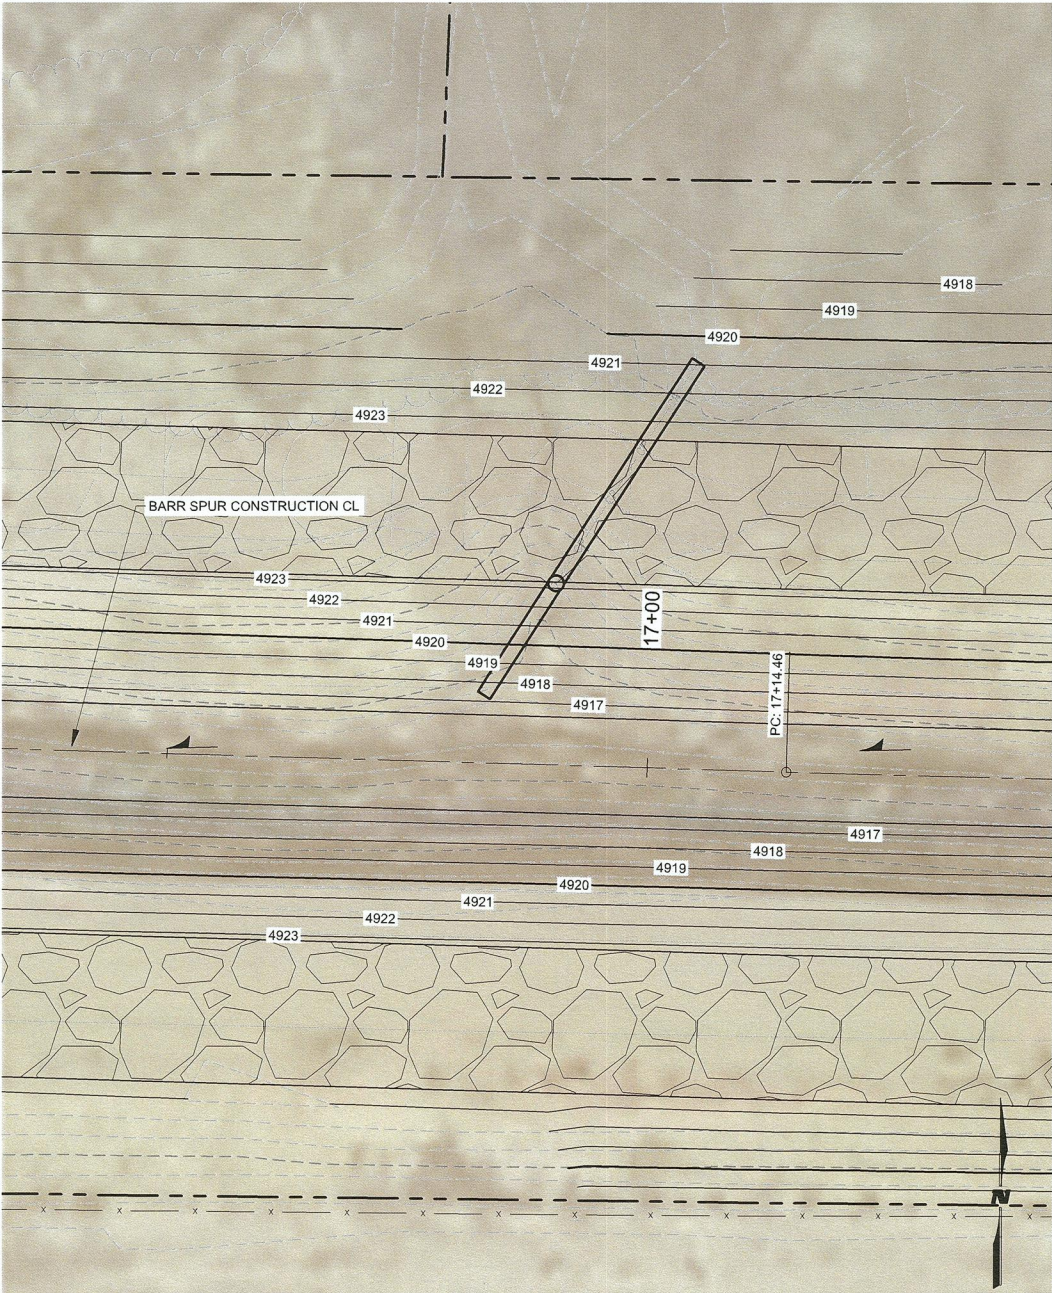SCALE: 1" = 10'



GENERAL SHEET NOTES

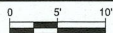- SEE SHEET C-106 FOR ADDITIONAL GRADING AT BARR SPUR CBC CROSSING.
- SEE SHEET C-107 FOR ADDITIONAL GRADING AT BARR INTERIOR DRAIN CBC CROSSING.

KEYNOTES (AS APPLICABLE)

- CONSTRUCT 6" THICK CONCRETE BASE COURSE MAINTENANCE ROAD. SEE DETAIL H9/C-501.
- CONSTRUCT 10'W x7'H x102'L CBC. SEE SHEETS C-511 THRU C-514.
- CONSTRUCT 8'W x 6'H x128'L CBC. SEE SHEETS C-511 THRU C-514.
- CONSTRUCT WINGWALL 'A' FOR 10'W x7'H CBC. SEE DETAIL A6/C-506.
- CONSTRUCT WINGWALL 'B' FOR 10'W x7'H CBC. SEE SHEETS A1/C-506.
- CONSTRUCT WINGWALL 'C' FOR 8'W x6'H CBC. SEE SHEETS A1/C-507.
- CONSTRUCT WINGWALL 'D' FOR 8'W x6'H CBC. SEE SHEETS A6/C-507.
- INSTALL 24" CMP w/ PIPE PENETRATION. SEE SHEET C-502.
- INSTALL PIPE TO PIPE CONNECTION. SEE DETAIL D8/C-501.
- INSTALL 18" THICK RIPRAP. SEE DETAIL F8/C-501.
- CONSTRUCT NATIVE MATERIAL BASE COURSE. SEE SHEET A5/C-501.
- INSTALL PIPE RAILING. SEE SHEET C-503.
- CONSTRUCT WATER QUALITY STRUCTURE. SEE SHEETS C-508 THRU C-510.
- INSTALL 18" RCP w/ PIPE PENETRATION INTO 8'x6' CBC. SEE "OUTER WALL PENETRATION DETAIL" ON SHEET C-517.
- CONSTRUCT CONCRETE ACCESS RAMP. SEE SHEET C-504.
- CONSTRUCT SHOTCRETE PAVING. SEE DETAIL XX.

LEGEND

- | | |
|--|---|
| | BASE COURSE MAINTENANCE ROAD |
| | 18" THICK RIPRAP |
| | REINFORCED CONCRETE |
| | 6" NATIVE MATERIAL
w/ RECYCLED BASE COURSE |
| | SHOTCRETE |
| | FLOW ARROW |

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CONSTRUCTION

PROJECT NAME

BARR SPUR
IMPROVEMENTS

REV.	DATE	DESCRIPTION	BY

PROJECT NO:	1660060700
DESIGNED BY:	TJA
DRAWN BY:	JEM
CHECKED BY:	TJA
DATE:	JAN 2022

SHEET TITLE

GRADING &
DRAINAGE PLAN @
CULVERTS

SHEET NO:

C-108

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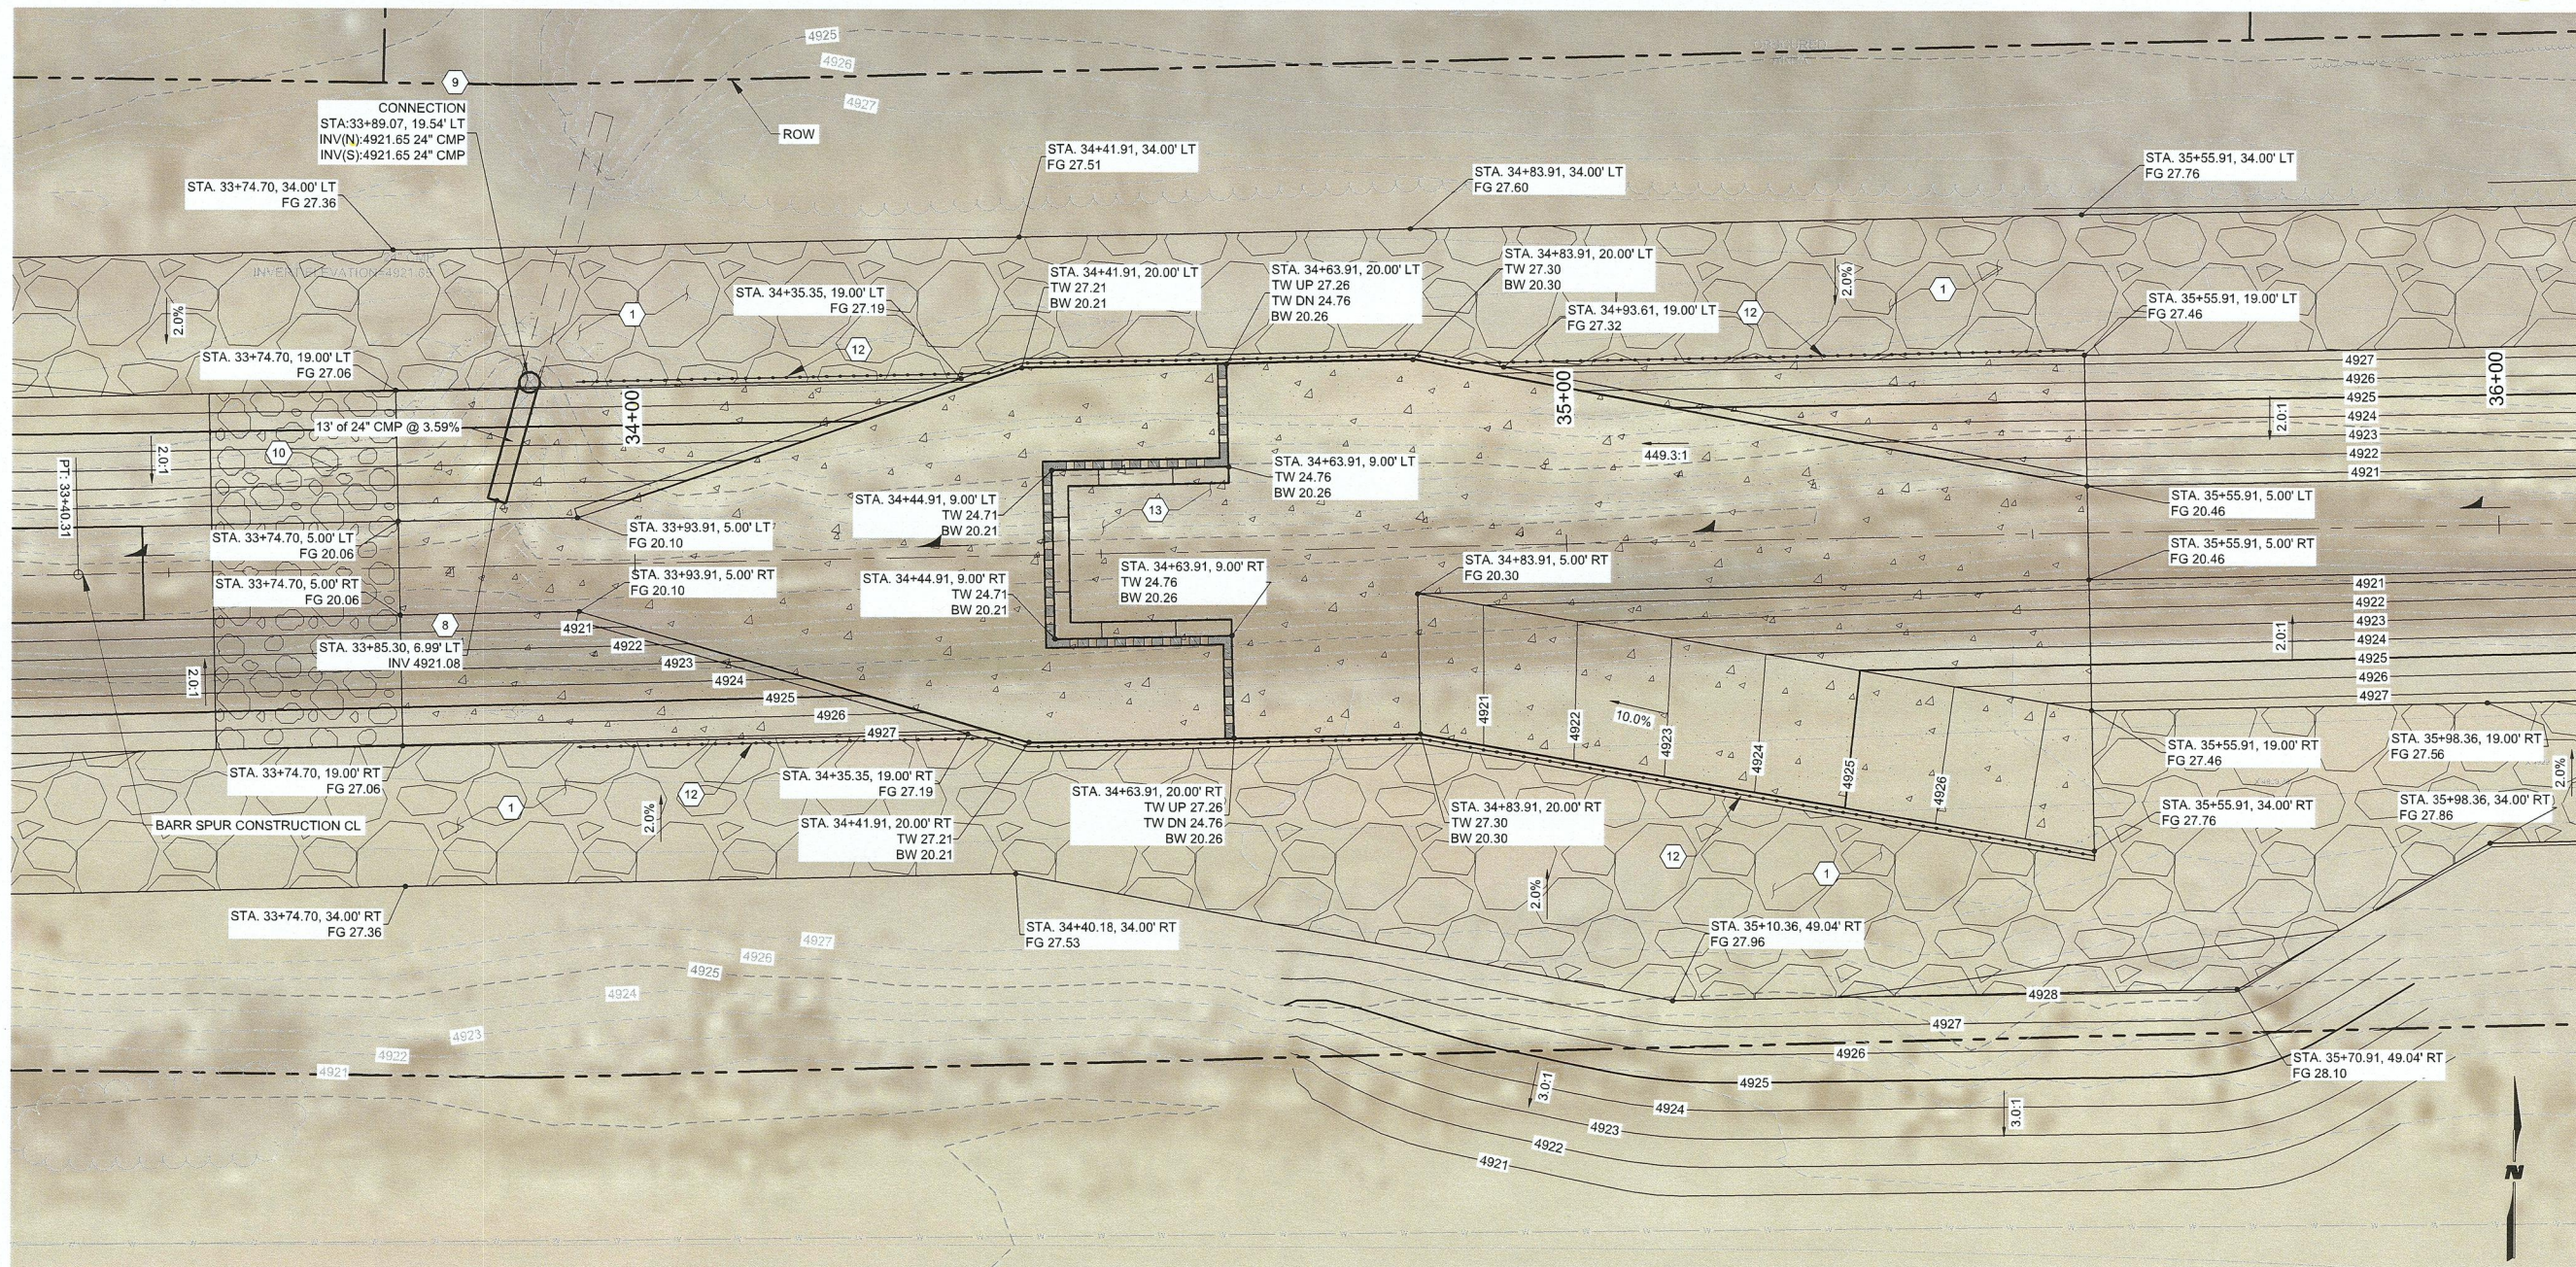
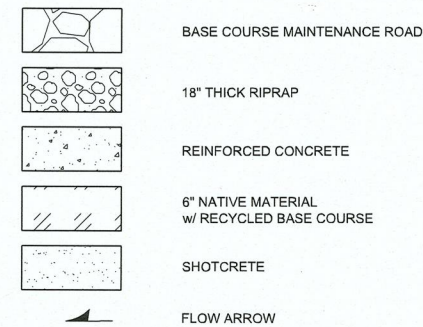
GENERAL SHEET NOTES

- SEE SHEET C-106 FOR ADDITIONAL GRADING AT BARR SPUR CBC CROSSING.
- SEE SHEET C-107 FOR ADDITIONAL GRADING AT BARR INTERIOR DRAIN CBC CROSSING.

KEYNOTES (AS APPLICABLE)


- CONSTRUCT 6" THICK CONCRETE BASE COURSE MAINTENANCE ROAD. SEE DETAIL H9/C-501.
- CONSTRUCT 10'W x7'H x102'L CBC. SEE SHEETS C-511 THRU C-514.
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- CONSTRUCT WINGWALL 'C' FOR 8'W x6'H CBC. SEE SHEETS A1/C-507.
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- CONSTRUCT NATIVE MATERIAL BASE COURSE. SEE SHEET A5/C-501.
- INSTALL PIPE RAILING. SEE SHEET C-503.
- CONSTRUCT WATER QUALITY STRUCTURE. SEE SHEETS C-508 THRU C-510.
- INSTALL 18" RCP w/ PIPE PENETRATION INTO 8'x6' CBC. SEE "OUTER WALL PENETRATION DETAIL" ON SHEET C-517.
- CONSTRUCT CONCRETE ACCESS RAMP. SEE SHEET C-504.
- CONSTRUCT SHOTCRETE PAVING. SEE DETAIL XX.

LEGEND



A1 GRADING & DRAINAGE PLAN @ WATER QUALITY STRUCTURE

SCALE: 1" = 10'

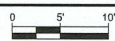

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PROJECT NAME

BARR SPUR
IMPROVEMENTS

REV.	DATE	DESCRIPTION	BY


PROJECT NO: 1660060700
DESIGNED BY: TJA
DRAWN BY: JEM
CHECKED BY: TJA
DATE: JAN 2022

SHEET TITLE
GRADING &
DRAINAGE PLAN @
WATER QUALITY
STRUCTURE


SHEET NO:

C-109

1/5/2022 M:\MSD\16-600-607-002_Disciplines_Sheets - civil\BARR SPUR\166607-PP01.dwg

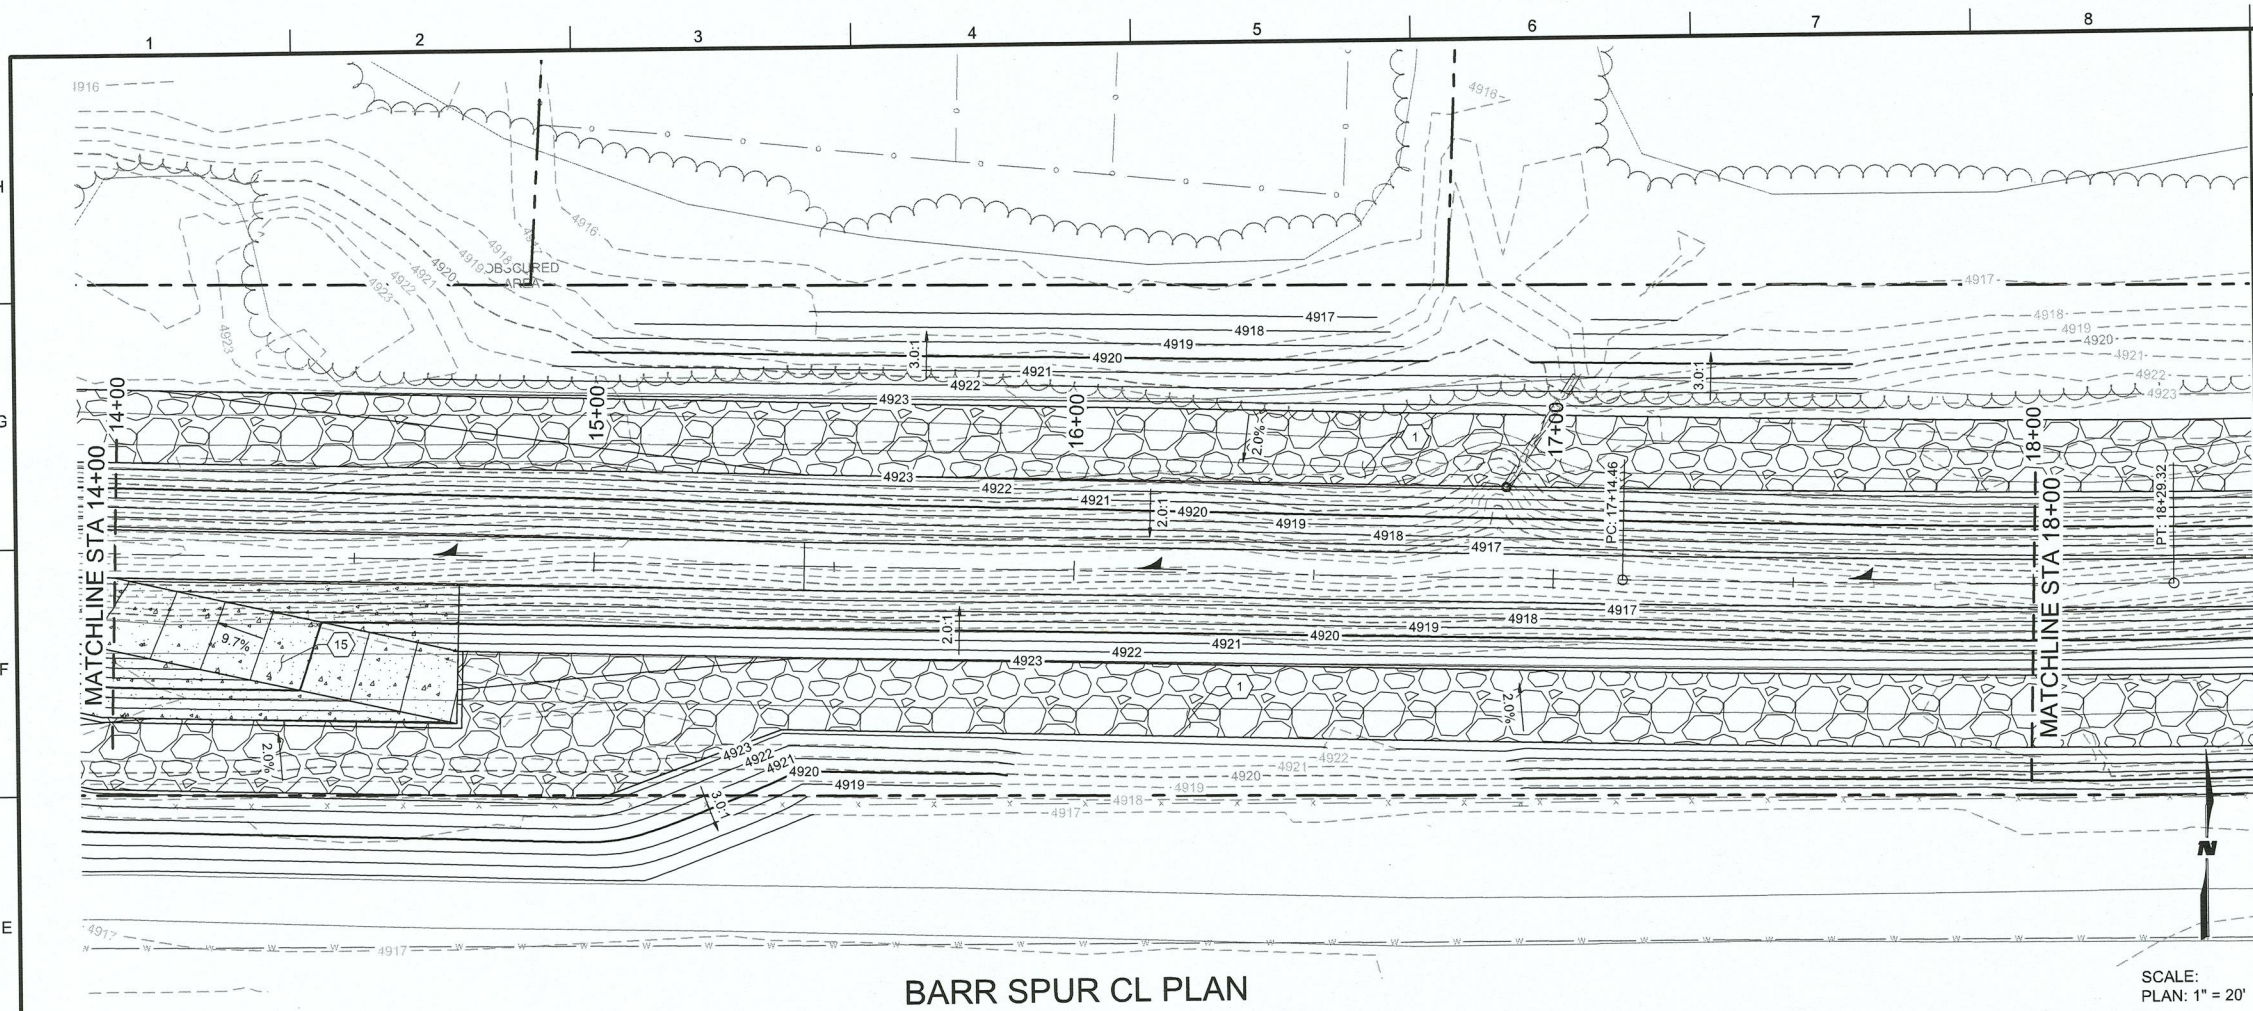

BARR SPUR CL PLAN

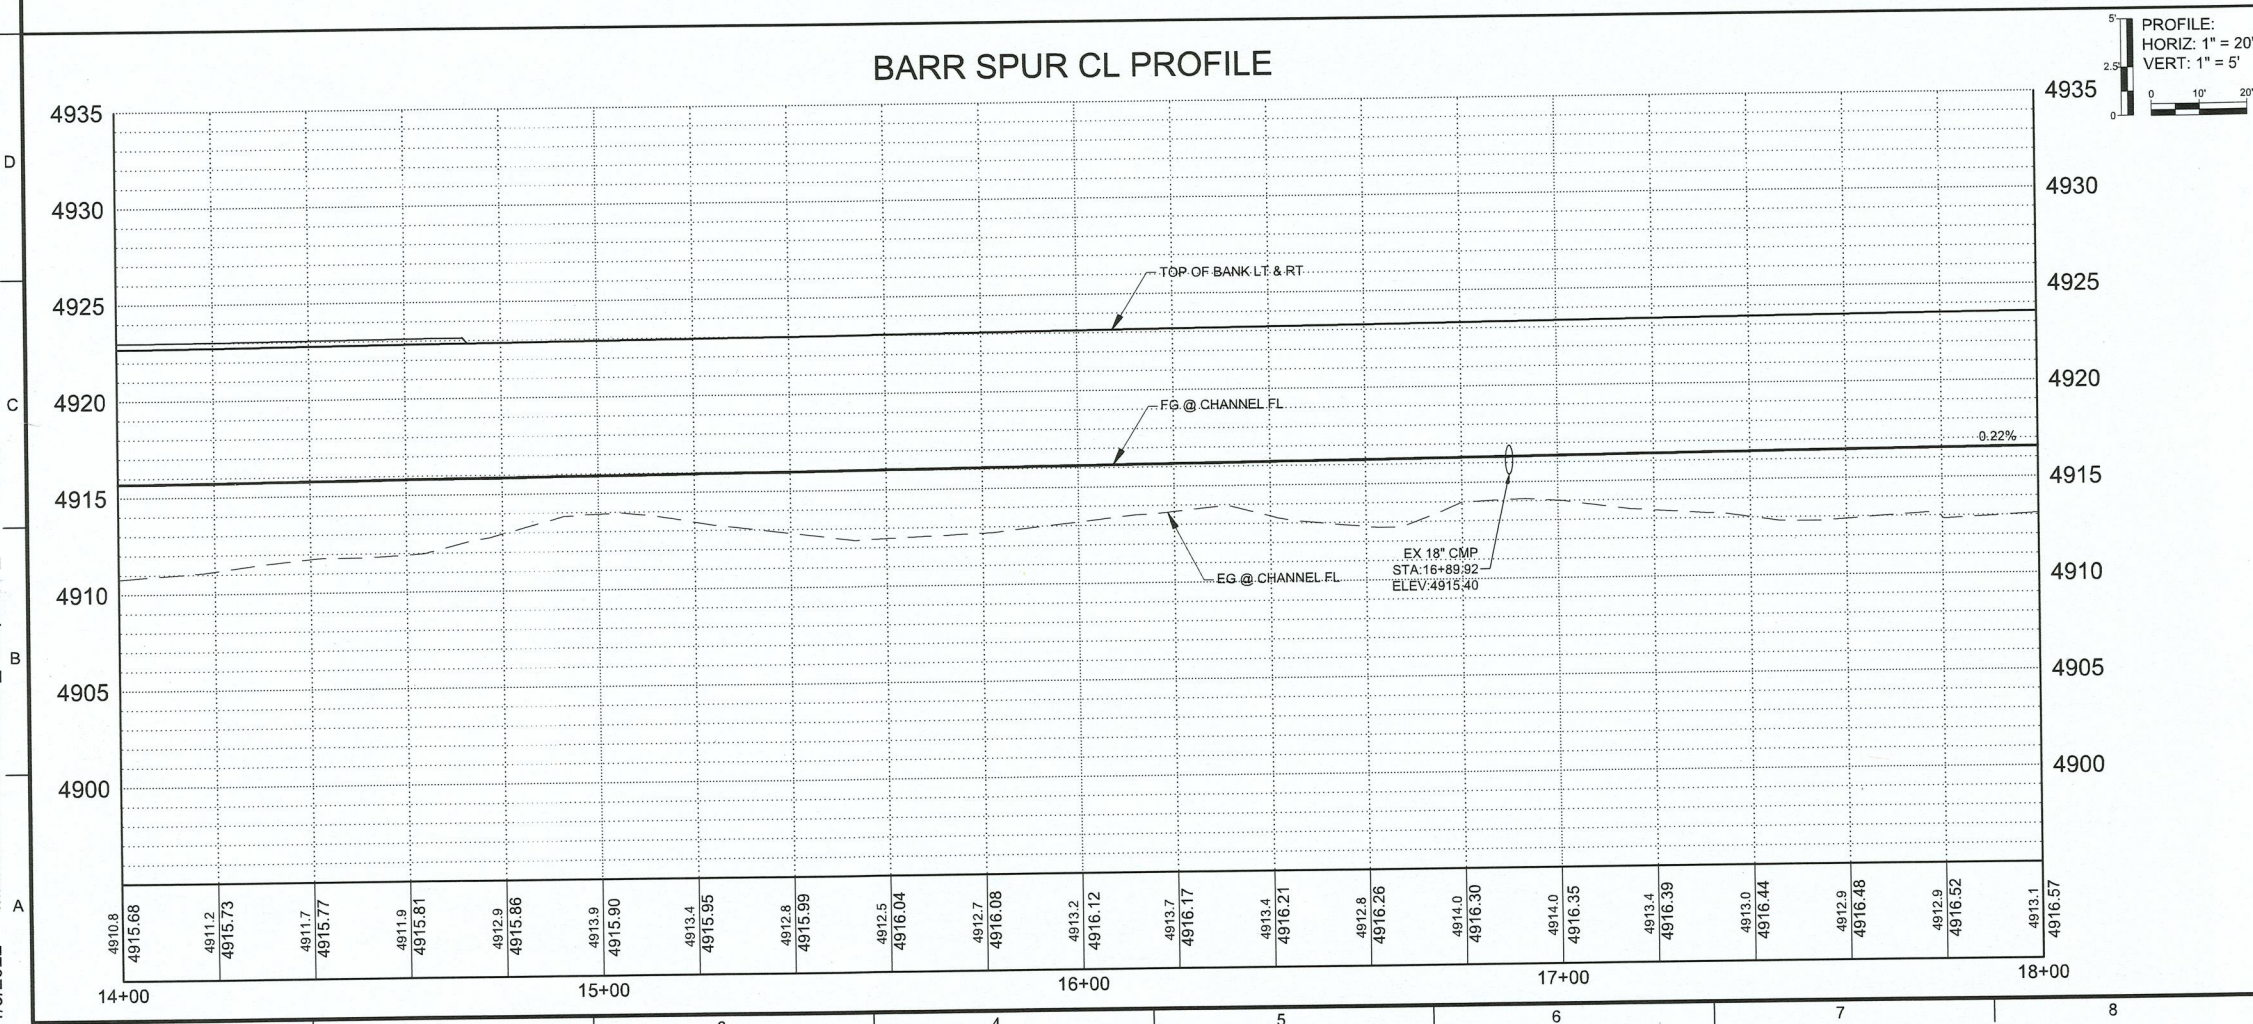

BARR SPUR CL PROFILE

GENERAL SHEET NOTES

1. GENERAL SHEET NOTES.

KEYNOTES (AS APPLICABLE)

1. CONSTRUCT 6" THICK CONCRETE BASE COURSE MAINTENANCE ROAD. SEE DETAIL H9/C-501.
2. CONSTRUCT 10'W x7'H x102'L CBC. SEE SHEETS C-511 THRU C-514.
3. CONSTRUCT 8'W x 6'H x128'L CBC. SEE SHEETS C-511 THRU C-514.
4. CONSTRUCT WINGWALL 'A' FOR 10'W x7'H CBC. SEE DETAIL A6/C-506.
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7. CONSTRUCT WINGWALL 'D' FOR 8'W x6'H CBC. SEE SHEETS A6/C-507.
8. INSTALL 24" CMP w/ PIPE PENETRATION. SEE SHEET C-502.
9. INSTALL PIPE TO PIPE CONNECTION. SEE DETAIL D8/C-501.
10. INSTALL 18" THICK RIPRAP. SEE DETAIL F8/C-501.
11. CONSTRUCT NATIVE MATERIAL BASE COURSE. SEE SHEET A5/C-501.
12. INSTALL PIPE RAILING. SEE SHEET C-503.
13. CONSTRUCT WATER QUALITY STRUCTURE. SEE SHEETS C-508 THRU C-510.
14. INSTALL 18" RCP w/ PIPE PENETRATION INTO 8'x6' CBC. SEE "OUTER WALL PENETRATION DETAIL" ON SHEET C-517.
15. CONSTRUCT CONCRETE ACCESS RAMP. SEE SHEET C-504.
16. CONSTRUCT SHOTCRETE PAVING. SEE DETAIL XX.

LEGEND

- | | |
|--|------------------------------|
| | BASE COURSE MAINTENANCE ROAD |
| | |

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www.wilsonco.com

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BARR SPUR
IMPROVEMENTS

PROJECT NAME



REV	DATE	DESCRIPTION	BY

PROJECT NO: 1660060700
DESIGNED BY: TJA
DRAWN BY: JEM
CHECKED BY: TJA
DATE: JAN 2022
SHEET TITLE

BARR SPUR
PLAN & PROFILE

SHEET NO:
C-402

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GENERAL SHEET NOTES

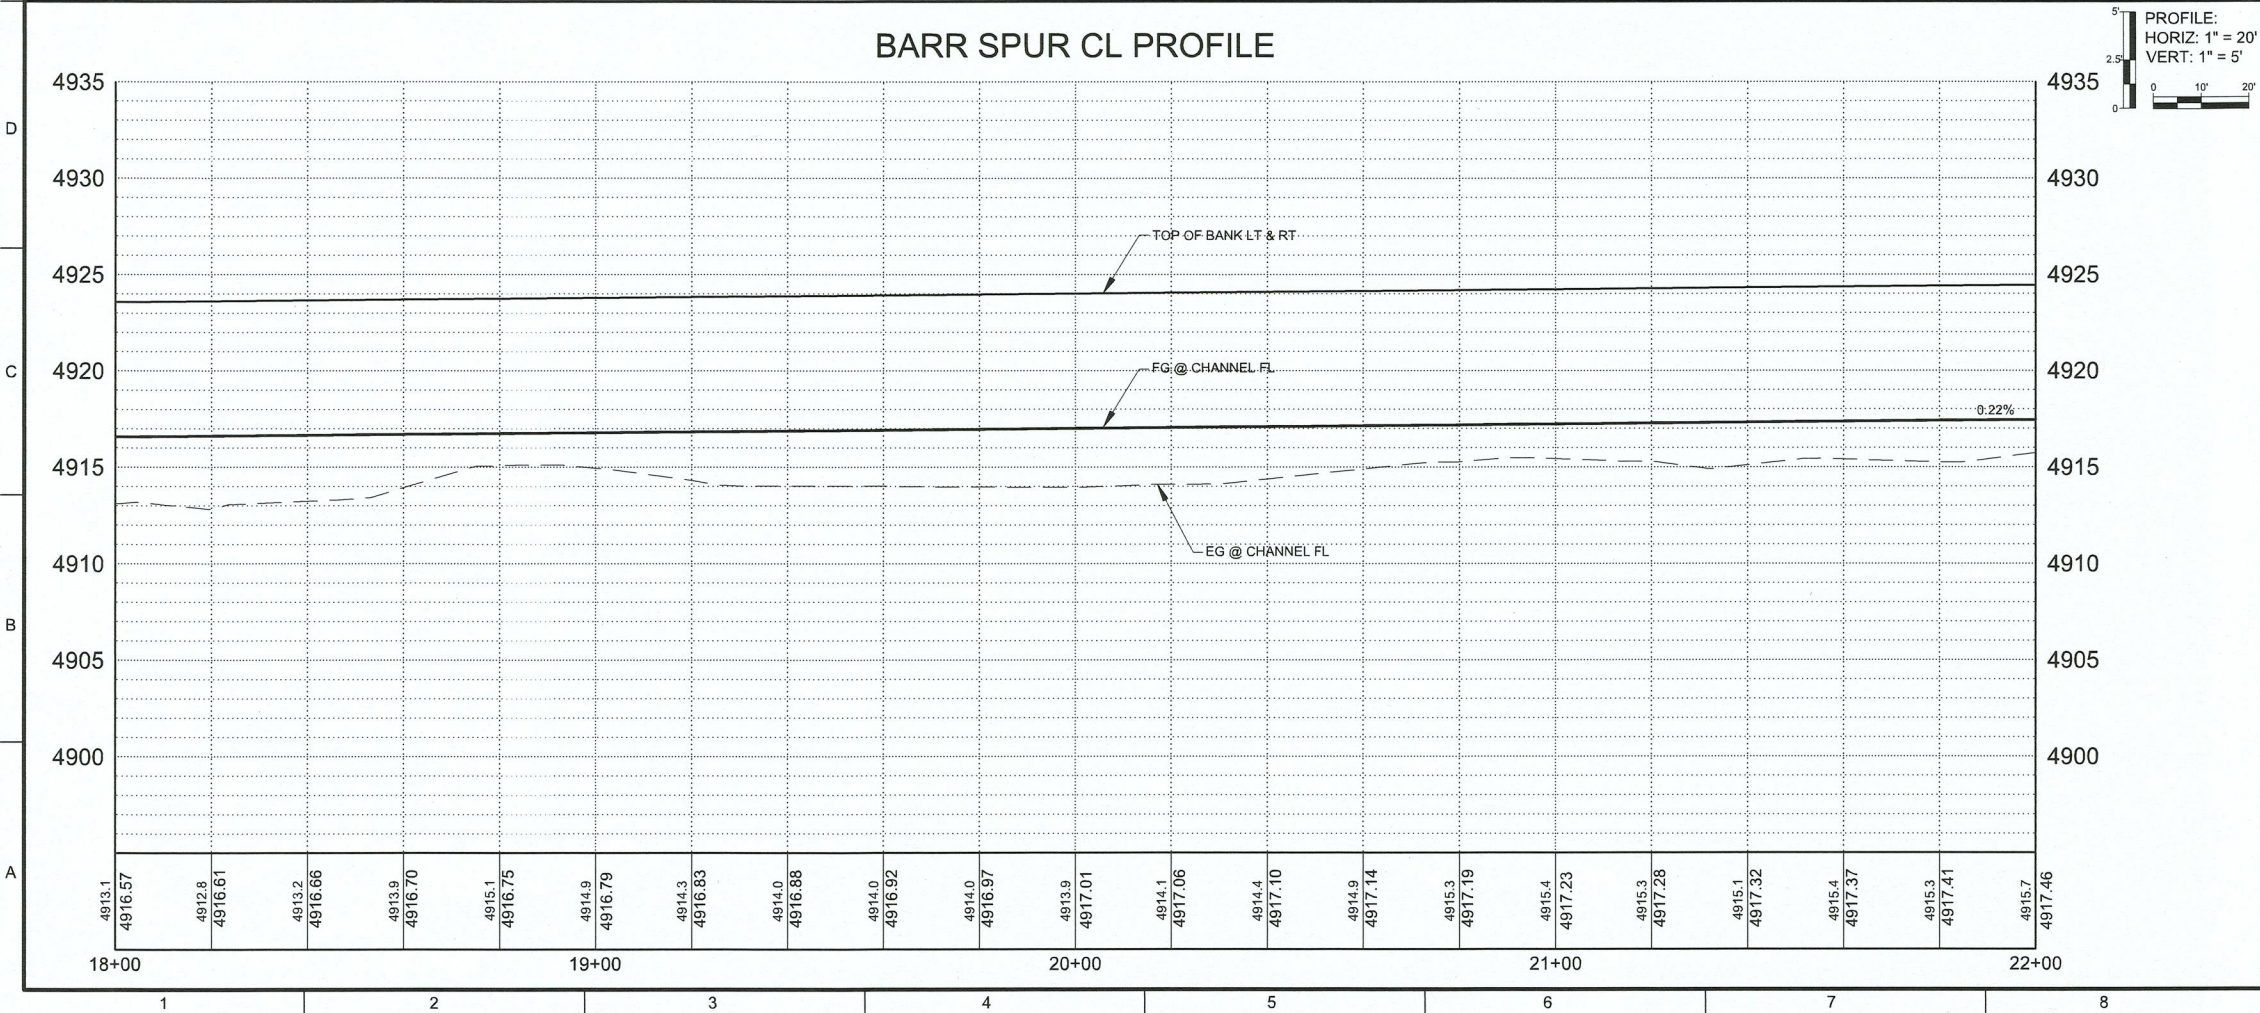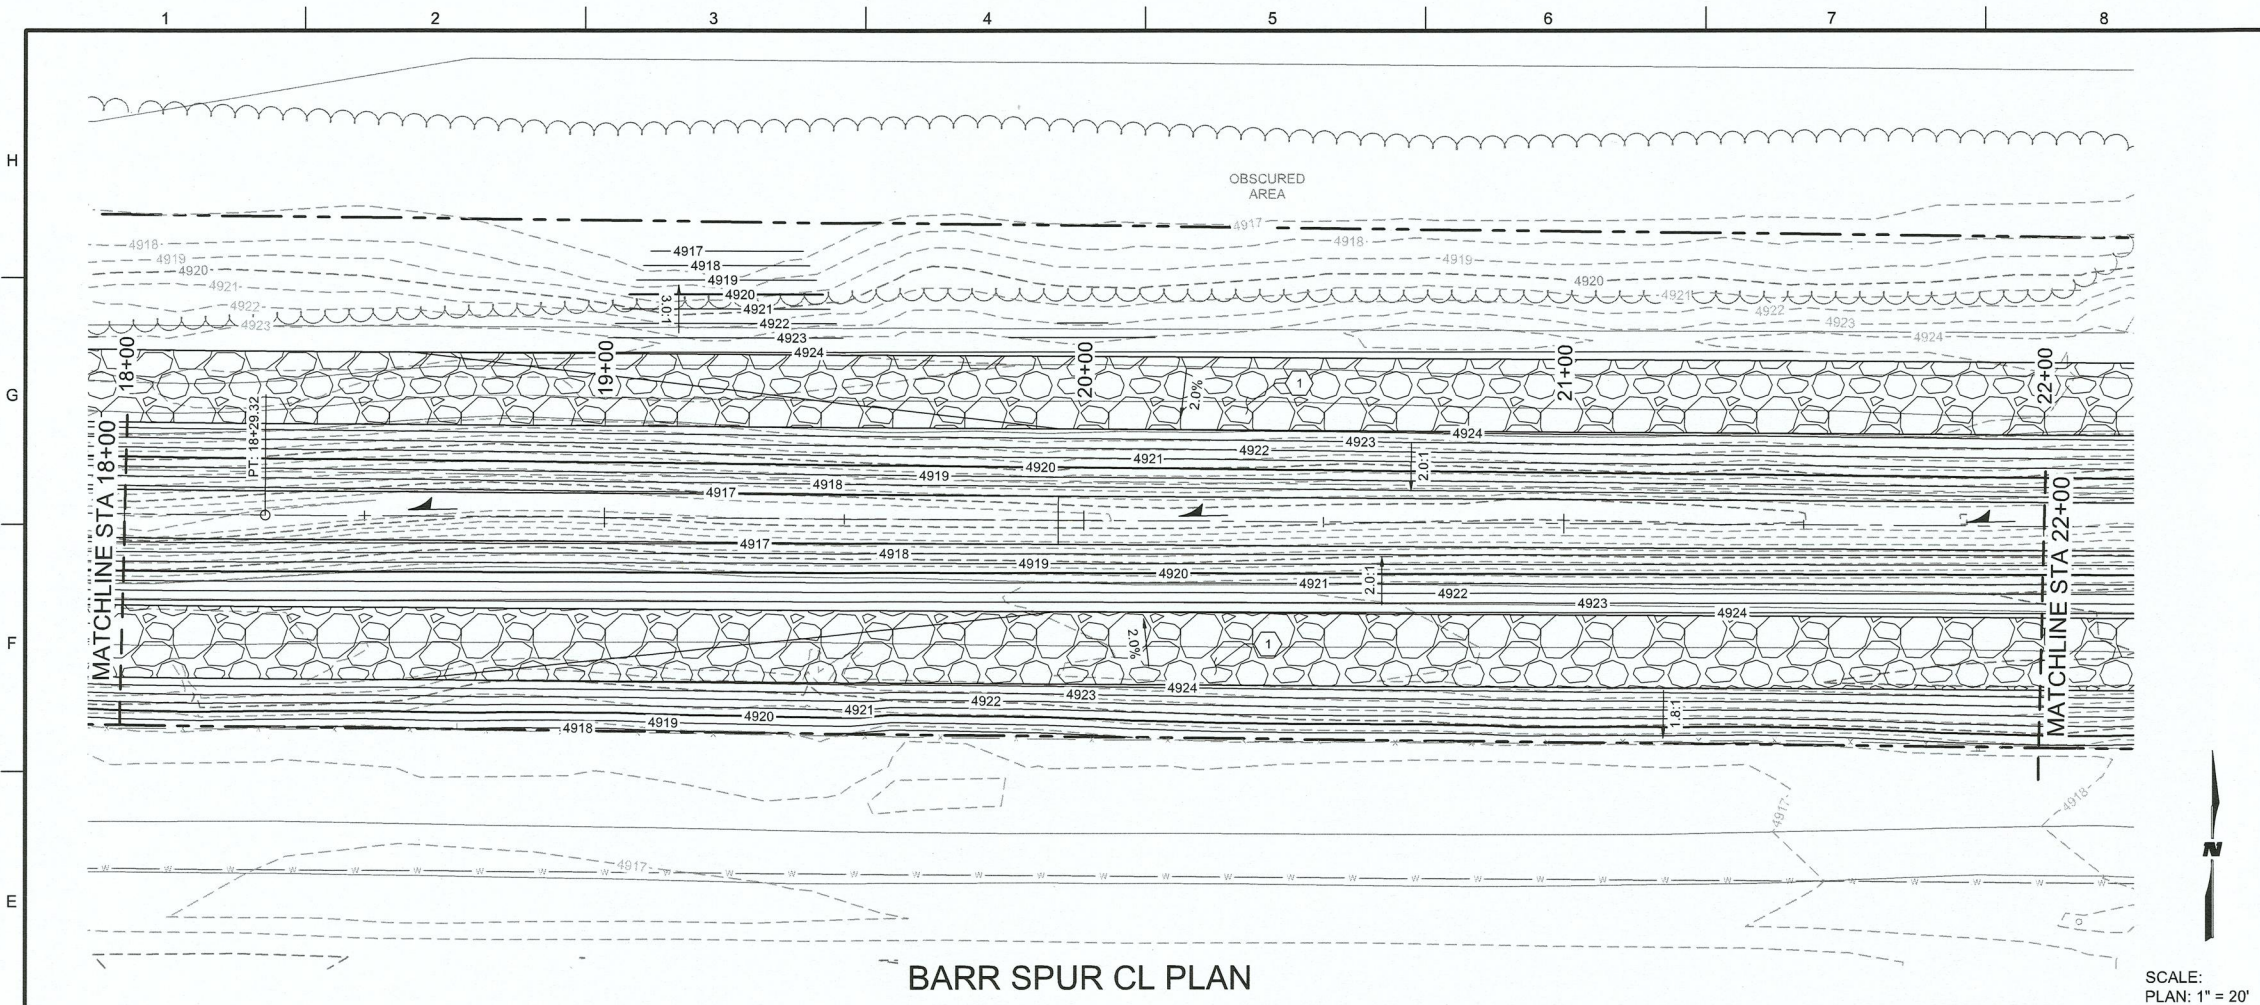- GENERAL SHEET NOTES.

KEYNOTES (AS APPLICABLE)

- CONSTRUCT 6" THICK CONCRETE BASE COURSE MAINTENANCE ROAD. SEE DETAIL H9/C-501.
- CONSTRUCT 10'W x7'H x102'L CBC. SEE SHEETS C-511 THRU C-514.
- CONSTRUCT 8'W x 6'H x128'L CBC. SEE SHEETS C-511 THRU C-514.
- CONSTRUCT WINGWALL 'A' FOR 10'W x7'H CBC. SEE DETAIL A6/C-506.
- CONSTRUCT WINGWALL 'B' FOR 10'W x7'H CBC. SEE SHEETS A1/C-506.
- CONSTRUCT WINGWALL 'C' FOR 8'W x6'H CBC. SEE SHEETS A1/C-507.
- CONSTRUCT WINGWALL 'D' FOR 8'W x6'H CBC. SEE SHEETS A6/C-507.
- INSTALL 24" CMP w/ PIPE PENETRATION. SEE SHEET C-502.
- INSTALL PIPE TO PIPE CONNECTION. SEE DETAIL D8/C-501.
- INSTALL 18" THICK RIPRAP. SEE DETAIL F8/C-501.
- CONSTRUCT NATIVE MATERIAL BASE COURSE. SEE SHEET A5/C-501.
- INSTALL PIPE RAILING. SEE SHEET C-503.
- CONSTRUCT WATER QUALITY STRUCTURE. SEE SHEETS C-508 THRU C-510.
- INSTALL 18" RCP w/ PIPE PENETRATION INTO 8'x6' CBC. SEE "OUTER WALL PENETRATION DETAIL" ON SHEET C-517.
- CONSTRUCT CONCRETE ACCESS RAMP. SEE SHEET C-504.
- CONSTRUCT SHOTCRETE PAVING. SEE DETAIL XX.

LEGEND

- | | |
|--|------------------------------|
| | BASE COURSE MAINTENANCE ROAD |
| | |

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www.wilsonco.com

CONSULTANTS

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CONSTRUCTION

BARR SPUR
IMPROVEMENTS

PROJECT NAME


REV.	DATE	DESCRIPTION	BY

PROJECT NO: 1660060700
DESIGNED BY: TJA
DRAWN BY: JEM
CHECKED BY: TJA
DATE: JAN 2022

SHEET TITLE
**BARR SPUR
PLAN & PROFILE**

SHEET NO:
C-403

1/5/2022 M:\MSD\16-600-607-00\2_Disciplines\Sheets - civil\BARR SPUR\166607-PP01.dwg

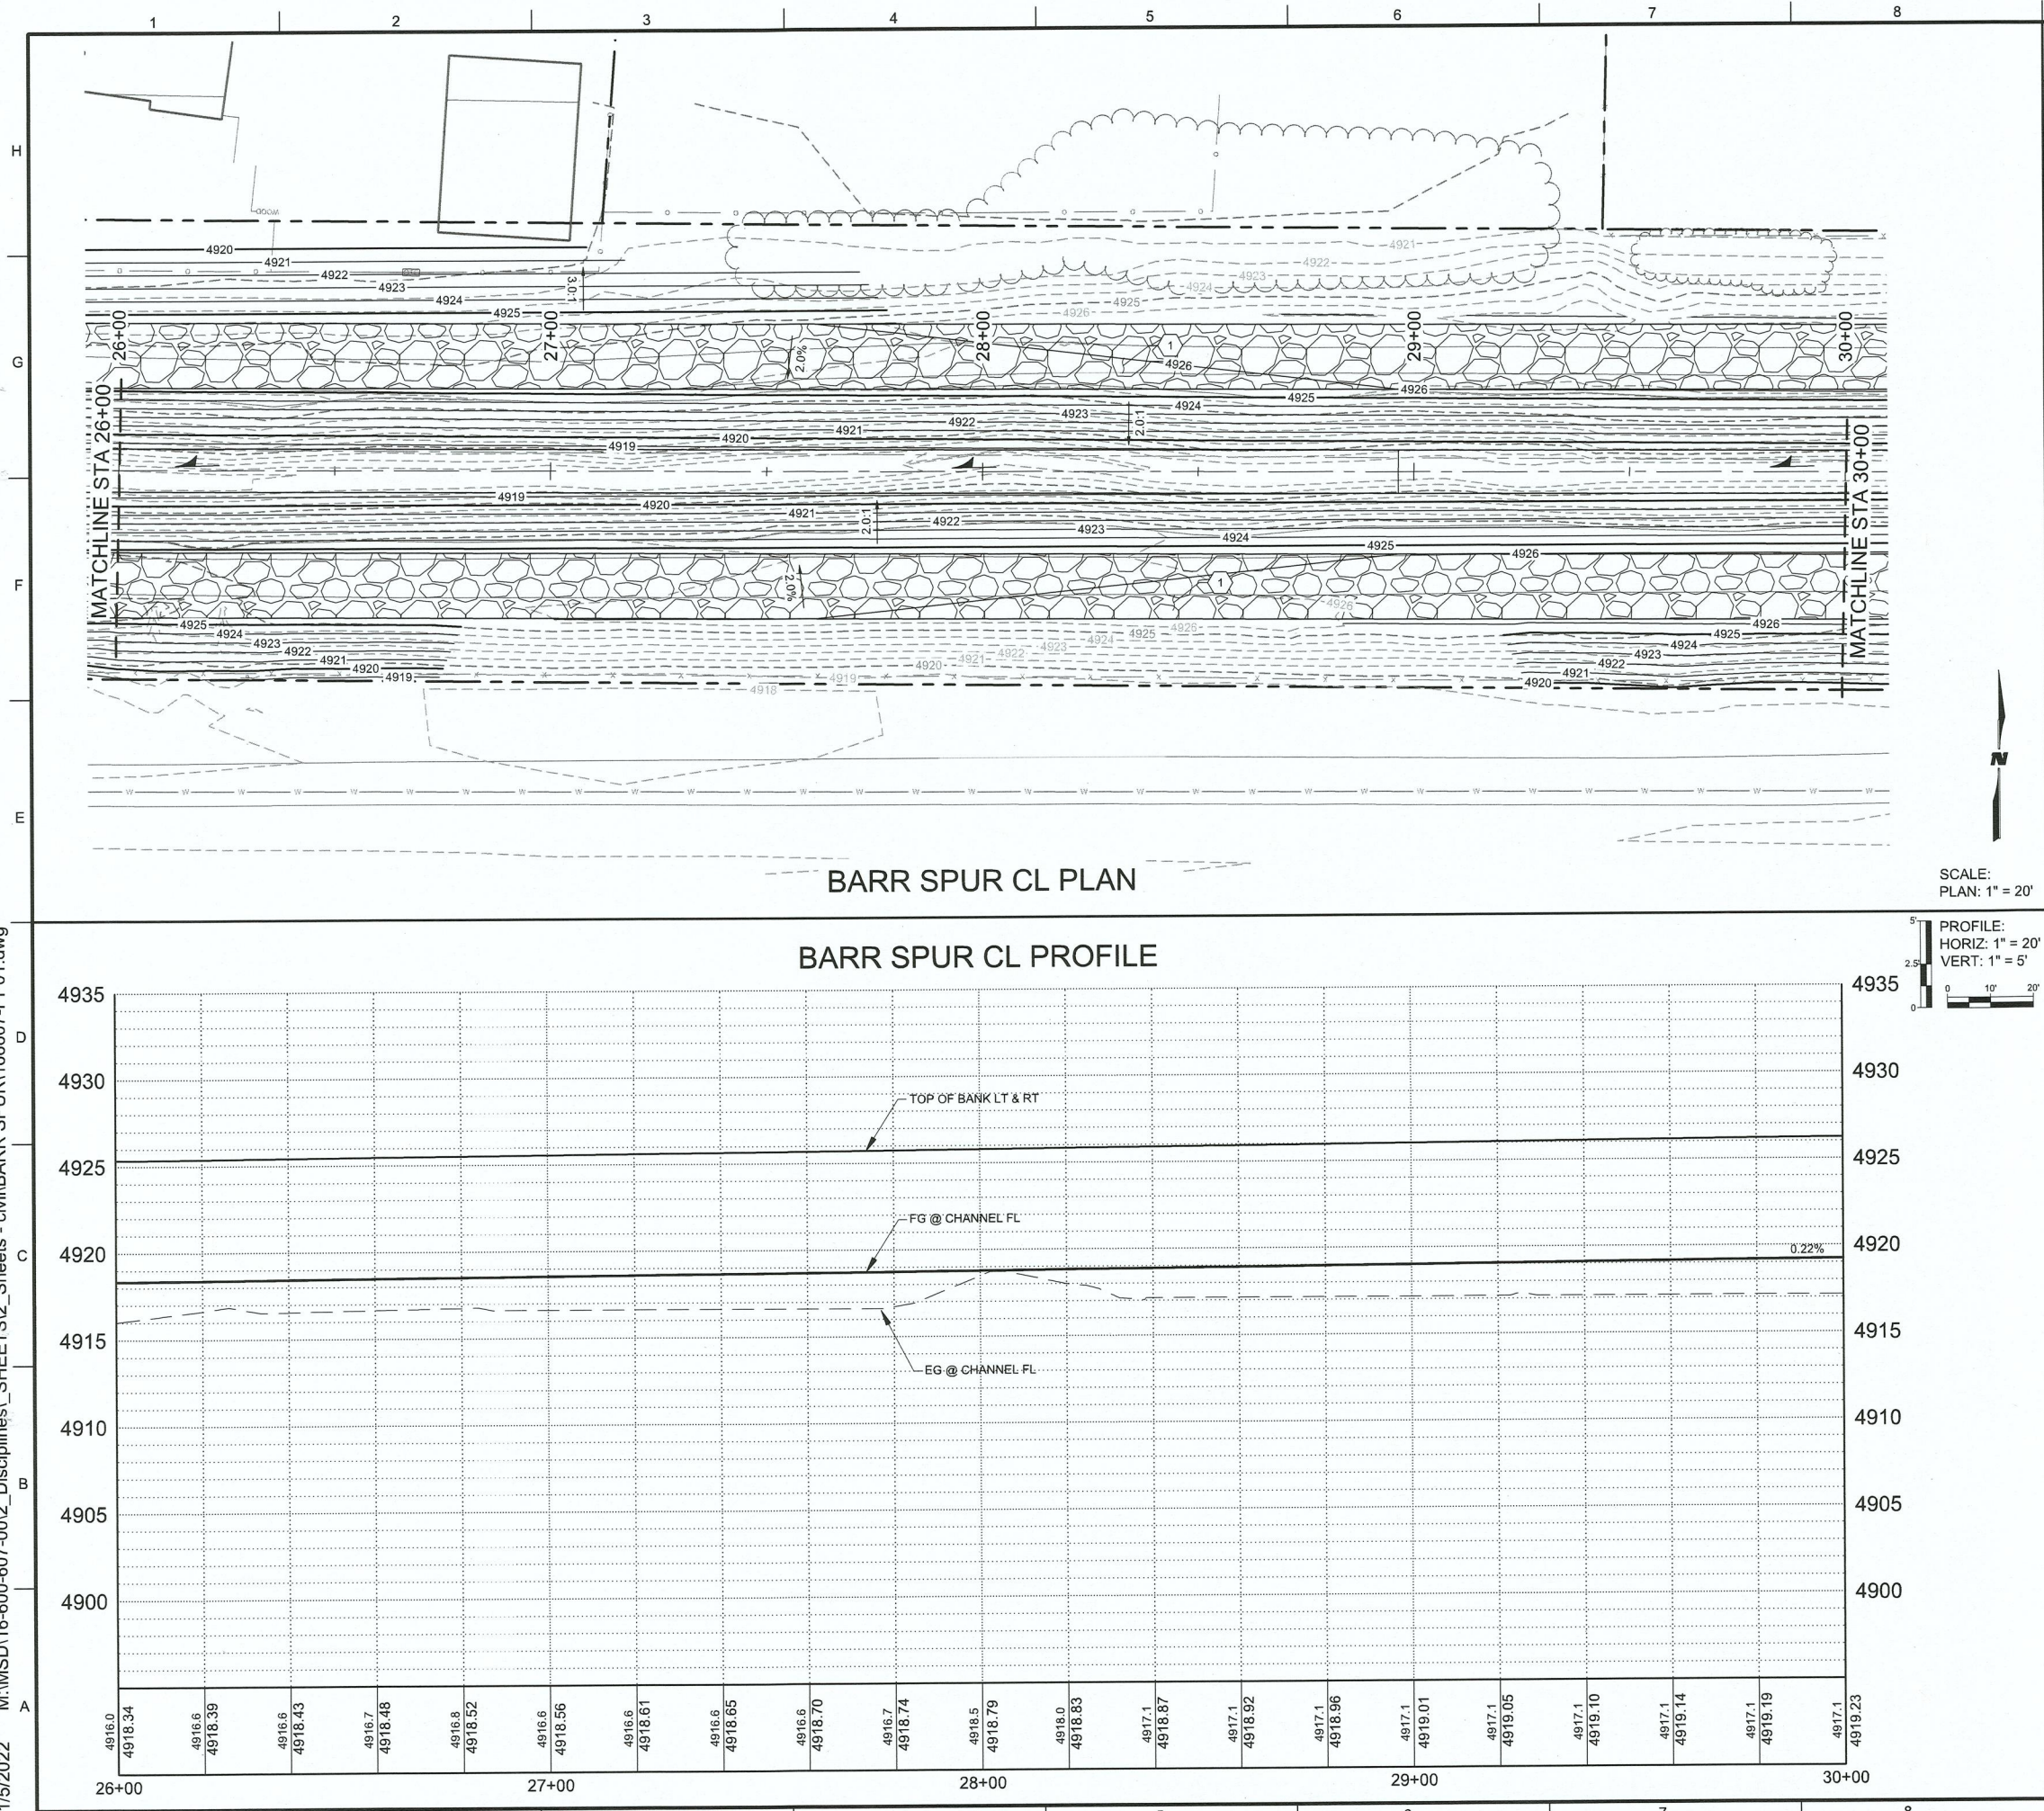

GENERAL SHEET NOTES

1. GENERAL SHEET NOTES.

KEYNOTES (AS APPLICABLE)

1. CONSTRUCT 6" THICK CONCRETE BASE COURSE MAINTENANCE ROAD. SEE DETAIL H9/C-501.
2. CONSTRUCT 10'W x 7'H x 102'L CBC. SEE SHEETS C-511 THRU C-514.
3. CONSTRUCT 8'W x 6'H x 128'L CBC. SEE SHEETS C-511 THRU C-514.
4. CONSTRUCT WINGWALL 'A' FOR 10'W x 7'H CBC. SEE DETAIL A6/C-506.
5. CONSTRUCT WINGWALL 'B' FOR 10'W x 7'H CBC. SEE SHEETS A1/C-506.
6. CONSTRUCT WINGWALL 'C' FOR 8'W x 6'H CBC. SEE SHEETS A1/C-507.
7. CONSTRUCT WINGWALL 'D' FOR 8'W x 6'H CBC. SEE SHEETS A6/C-507.
8. INSTALL 24" CMP w/ PIPE PENETRATION. SEE SHEET C-502.
9. INSTALL PIPE TO PIPE CONNECTION. SEE DETAIL D8/C-501.
10. INSTALL 18" THICK RIPRAP. SEE DETAIL F8/C-501.
11. CONSTRUCT NATIVE MATERIAL BASE COURSE. SEE SHEET A5/C-501.
12. INSTALL PIPE RAILING. SEE SHEET C-503.
13. CONSTRUCT WATER QUALITY STRUCTURE. SEE SHEETS C-508 THRU C-510.
14. INSTALL 18" RCP w/ PIPE PENETRATION INTO 8'x6' CBC. SEE "OUTER WALL PENETRATION DETAIL" ON SHEET C-517.
15. CONSTRUCT CONCRETE ACCESS RAMP. SEE SHEET C-504.
16. CONSTRUCT SHOTCRETE PAVING. SEE DETAIL XX.

LEGEND




BASE COURSE MAINTENANCE ROAD




18" THICK RIPRAP



REINFORCED CONCRETE

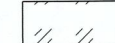

6" NATIVE MATERIAL
w/ RECYCLED BASE COURSE

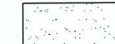

SHOTCRETE



FLOW ARROW

**WILSON
& COMPANY**

4401 MASSEHEAD ST. NE. SUITE 150
ALBUQUERQUE, NM 87109
PHONE: 505-348-4000
FAX: 505-348-4072
www.wilsonco.com

CONSULTANTS

SEAL

60% SUBMITTAL
NOT FOR
CONSTRUCTION

PROJECT NAME

REV.	DATE	DESCRIPTION	BY

PROJECT NO: 1660060700
DESIGNED BY: TJA
DRAWN BY: JEM
CHECKED BY: TJA
DATE: JAN 2022
SHEET TITLE

BARR SPUR
PLAN & PROFILE

SHEET NO:

C-405

1. GENERAL SHEET NOTES.

- KEYNOTES (AS APPLICABLE)

**WILSON
& COMPANY**

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FAX: 505-348-4072
www.wilsonco.com

CONSULTANTS

SEAL

PROJECT NAME

60% SUBMITTAL
NOT FOR
CONSTRUCTION

BARR SPUR IMPROVEMENTS

[illegible]

PROJECT NO:	1660060700
DESIGNED BY:	TJA
DRAWN BY:	JEM
CHECKED BY:	TJA
DATE:	JAN 2022
SHEET TITLE	

BARR SPUR
PLAN & PROFILE

SHEET NO:
C-406


LEGEND




BASE COURSE MAINTENANCE ROAD




18" THICK RIPRAP

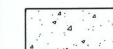

REINFORCED CONCRETE

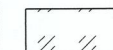

6" NATIVE MATERIAL
w/ RECYCLED BASE COURSE

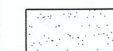


SHOTCRETE




FLOW ARROW

SHEET NO:
C-407

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BARR SPUR CL PLAN

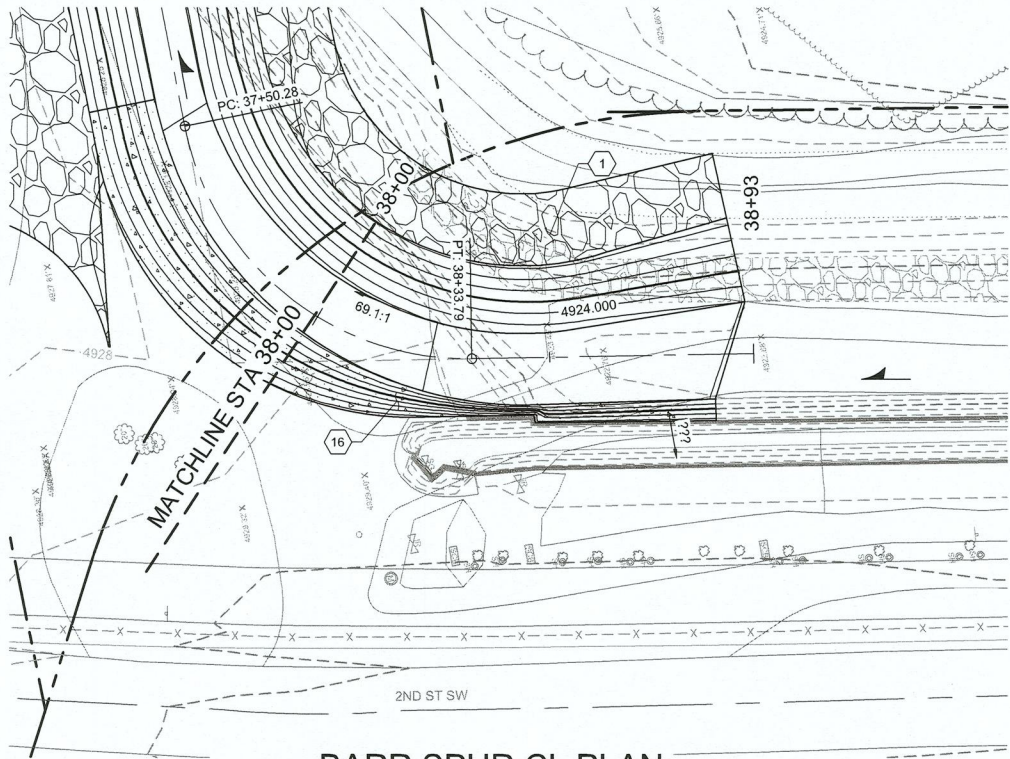

SCALE:
PLAN: 1" = 20'

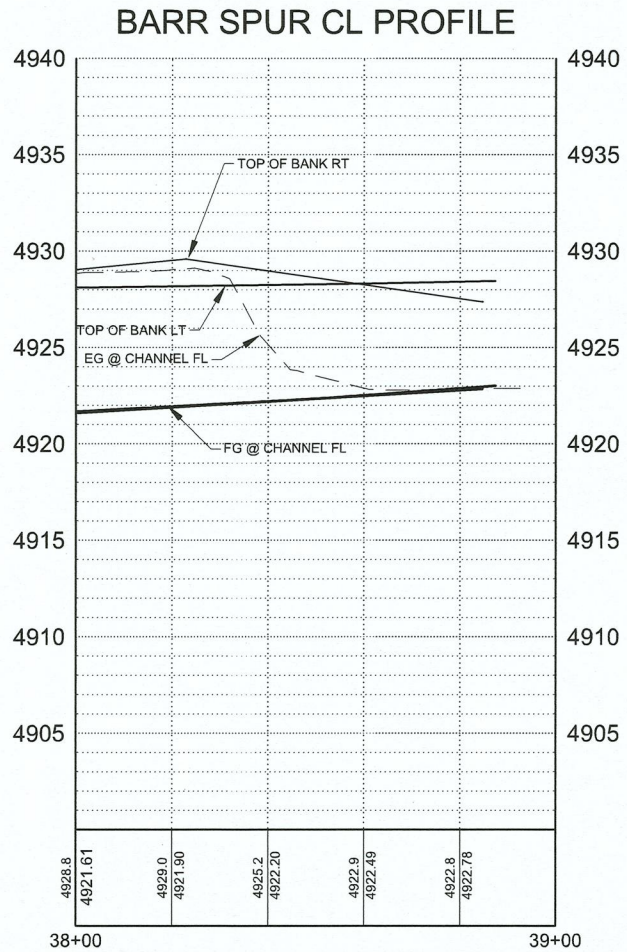PROFILE:
HORIZ: 1" = 20'
VERT: 1" = 5'

GENERAL SHEET NOTES

1. GENERAL SHEET NOTES.

KEYNOTES (AS APPLICABLE)

1. CONSTRUCT 6" THICK CONCRETE BASE COURSE MAINTENANCE ROAD. SEE DETAIL H9/C-501.
2. CONSTRUCT 10'W x 7'H x 102'L CBC. SEE SHEETS C-511 THRU C-514.
3. CONSTRUCT 8'W x 6'H x 128'L CBC. SEE SHEETS C-511 THRU C-514.
4. CONSTRUCT WINGWALL 'A' FOR 10'W x 7'H CBC. SEE DETAIL A6/C-506.
5. CONSTRUCT WINGWALL 'B' FOR 10'W x 7'H CBC. SEE SHEETS A1/C-506.
6. CONSTRUCT WINGWALL 'C' FOR 8'W x 6'H CBC. SEE SHEETS A1/C-507.
7. CONSTRUCT WINGWALL 'D' FOR 8'W x 6'H CBC. SEE SHEETS A6/C-507.
8. INSTALL 24" CMP w/ PIPE PENETRATION. SEE SHEET C-502.
9. INSTALL PIPE TO PIPE CONNECTION. SEE DETAIL D8/C-501.
10. INSTALL 18" THICK RIPRAP. SEE DETAIL F8/C-501.
11. CONSTRUCT NATIVE MATERIAL BASE COURSE. SEE SHEET A5/C-501.
12. INSTALL PIPE RAILING. SEE SHEET C-503.
13. CONSTRUCT WATER QUALITY STRUCTURE. SEE SHEETS C-508 THRU C-510.
14. INSTALL 18" RCP w/ PIPE PENETRATION INTO 8'x6' CBC. SEE "OUTER WALL PENETRATION DETAIL" ON SHEET C-517.
15. CONSTRUCT CONCRETE ACCESS RAMP. SEE SHEET C-504.
16. CONSTRUCT SHOTCRETE PAVING. SEE DETAIL XX.

LEGEND

- | | |
|--|---|
| | BASE COURSE MAINTENANCE ROAD |
| | 18" THICK RIPRAP |
| | REINFORCED CONCRETE |
| | 6" NATIVE MATERIAL
w/ RECYCLED BASE COURSE |
| | SHOTCRETE |
| | FLOW ARROW |

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BARR SPUR
IMPROVEMENTS

PROJECT NAME

REV.	DATE	DESCRIPTION	BY

PROJECT NO:	1660060700
DESIGNED BY:	TJA
DRAWN BY:	JEM
CHECKED BY:	TJA
DATE:	JAN 2022


SHEET TITLE

BARR SPUR
PLAN & PROFILE


SHEET NO:

C-408

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BARR INTERIOR DRAIN CL PROFILE

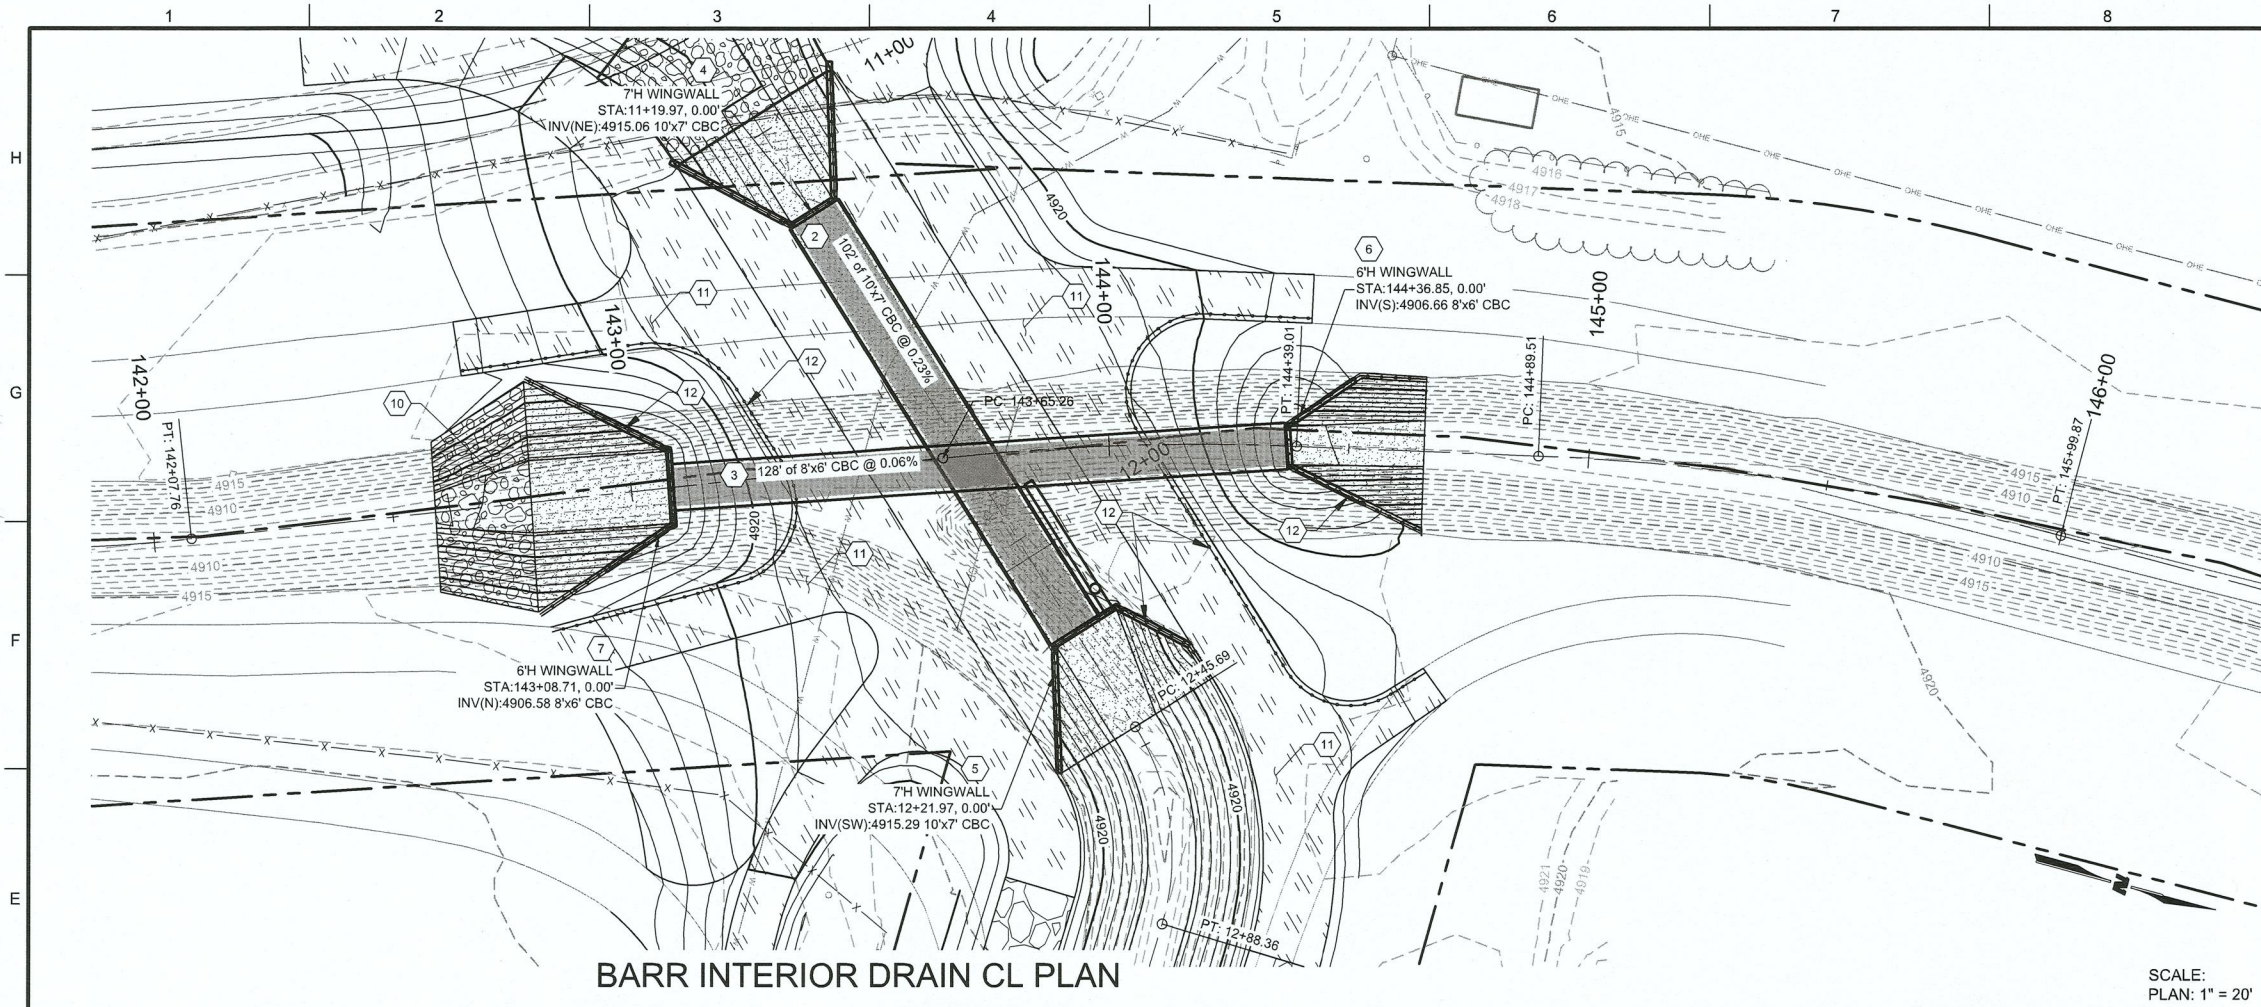

GENERAL SHEET NOTES

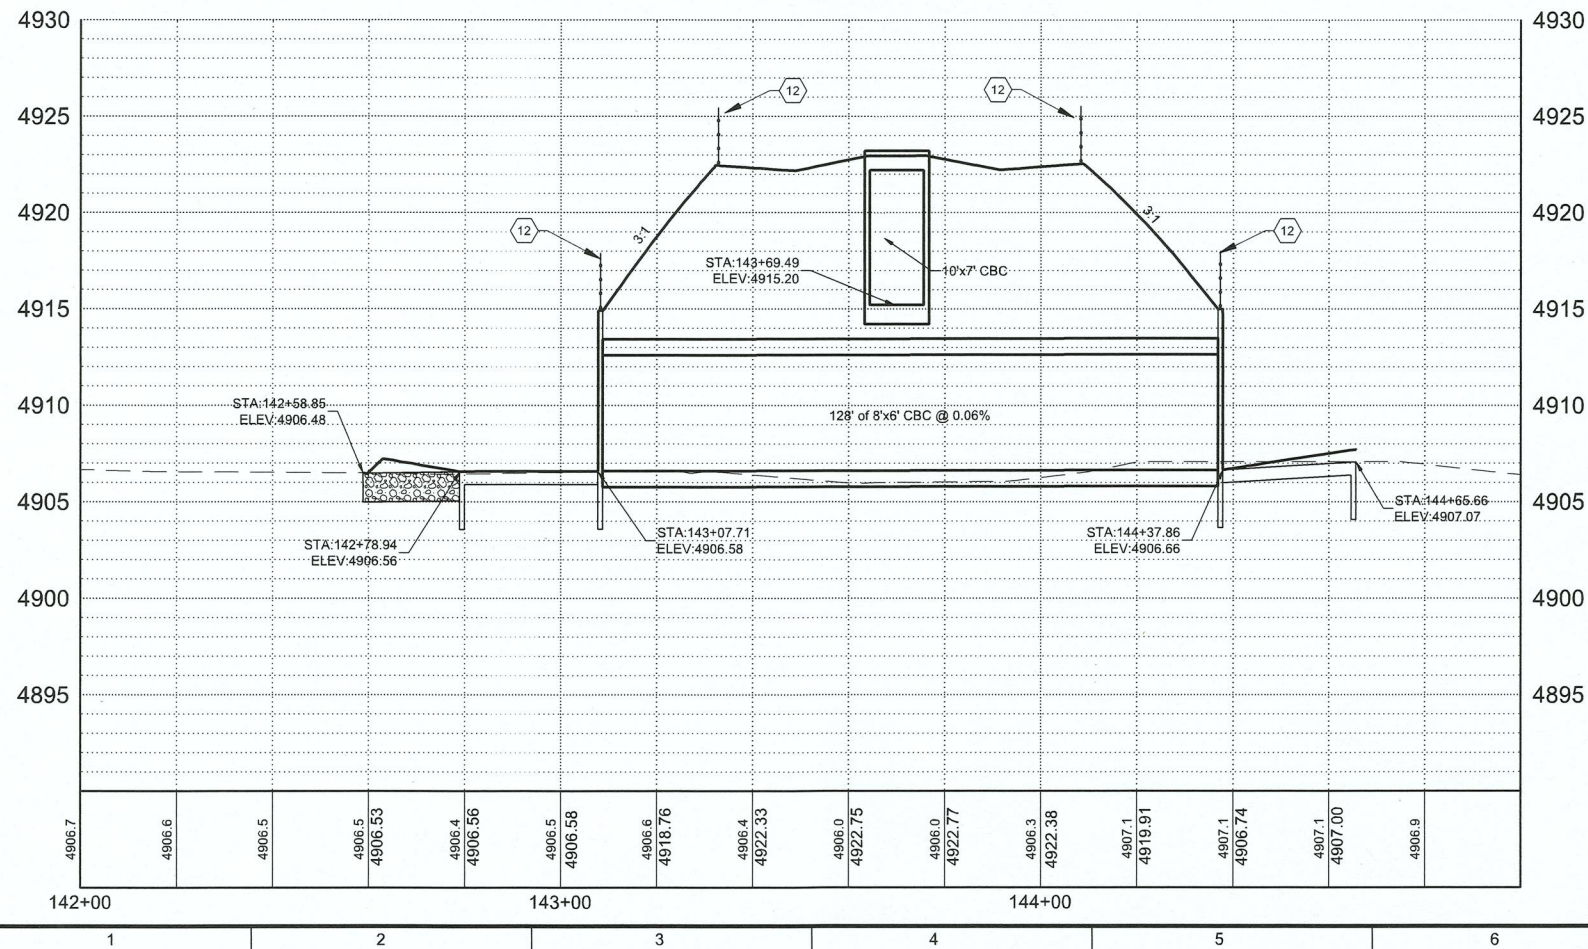- SEE SHEETS C-106 & C-107 FOR ADDITIONAL GRADING AT CBC CROSSINGS.

KEYNOTES

- CONSTRUCT 6" THICK CONCRETE BASE COURSE MAINTENANCE ROAD. SEE DETAIL H9/C-501.
- CONSTRUCT 10'W x 7'H x 102'L CBC. SEE SHEETS C-511 THRU C-514.
- CONSTRUCT 8'W x 6'H x 128'L CBC. SEE SHEETS C-511 THRU C-514.
- CONSTRUCT WINGWALL 'A' FOR 10'W x 7'H CBC. SEE DETAIL A6/C-506.
- CONSTRUCT WINGWALL 'B' FOR 10'W x 7'H CBC. SEE SHEETS A1/C-506.
- CONSTRUCT WINGWALL 'C' FOR 8'W x 6'H CBC. SEE SHEETS A1/C-507.
- CONSTRUCT WINGWALL 'D' FOR 8'W x 6'H CBC. SEE SHEETS A6/C-507.
- INSTALL 24" CMP w/ PIPE PENETRATION. SEE SHEET C-502.
- INSTALL PIPE TO PIPE CONNECTION. SEE DETAIL D8/C-501.
- INSTALL 18" THICK RIPRAP. SEE DETAIL F8/C-501.
- CONSTRUCT NATIVE MATERIAL BASE COURSE. SEE SHEET A5/C-501.
- INSTALL PIPE RAILING. SEE SHEET C-503.
- CONSTRUCT WATER QUALITY STRUCTURE. SEE SHEETS C-508 THRU C-510.
- INSTALL 18" RCP w/ PIPE PENETRATION INTO 8'x6' CBC. SEE "OUTER WALL PENETRATION DETAIL" ON SHEET C-517.
- CONSTRUCT CONCRETE ACCESS RAMP. SEE SHEET C-504.
- CONSTRUCT SHOTCRETE PAVING. SEE DETAIL XX.

LEGEND

- BASE COURSE MAINTENANCE ROAD
- 18" THICK RIPRAP
- REINFORCED CONCRETE
- 6" NATIVE MATERIAL w/ RECYCLED BASE COURSE
- SHOTCRETE
- FLOW ARROW

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IMPROVEMENTS

PROJECT NAME

REV.	DATE	DESCRIPTION	BY




PROJECT NO: 1660060700
DESIGNED BY: TJA
DRAWN BY: JEM
CHECKED BY: TJA
DATE: JAN 2022

SHEET TITLE
BARR INTERIOR
DRAIN CBC PLAN &
PROFILE

SHEET NO:

C-409

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PROJECT NAME
**BARR SPUR
IMPROVEMENTS**

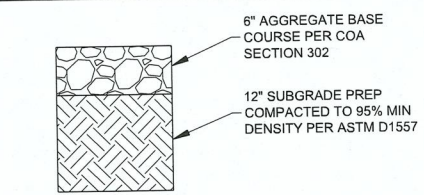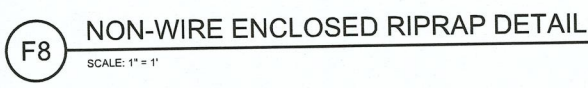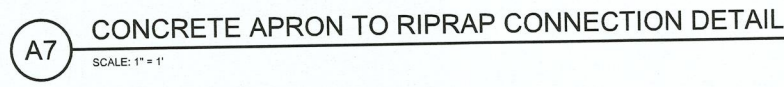REV.	DATE	DESCRIPTION	BY

PROJECT NO: 1660060700
DESIGNED BY: TJA
DRAWN BY: JEM
CHECKED BY: TJA
DATE: JAN 2022
SHEET TITLE
DETAILS
SHEET NO:
C-501

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PROJECT NAME


BARR SPUR
IMPROVEMENTS

BY DESCRIPTION REV. DATE

PROJECT NO: 1660060700
DESIGNED BY: TJA
DRAWN BY: JEM
CHECKED BY: TJA
DATE: JAN 2022
SHEET TITLE

DETAILS

SHEET NO:
C-502






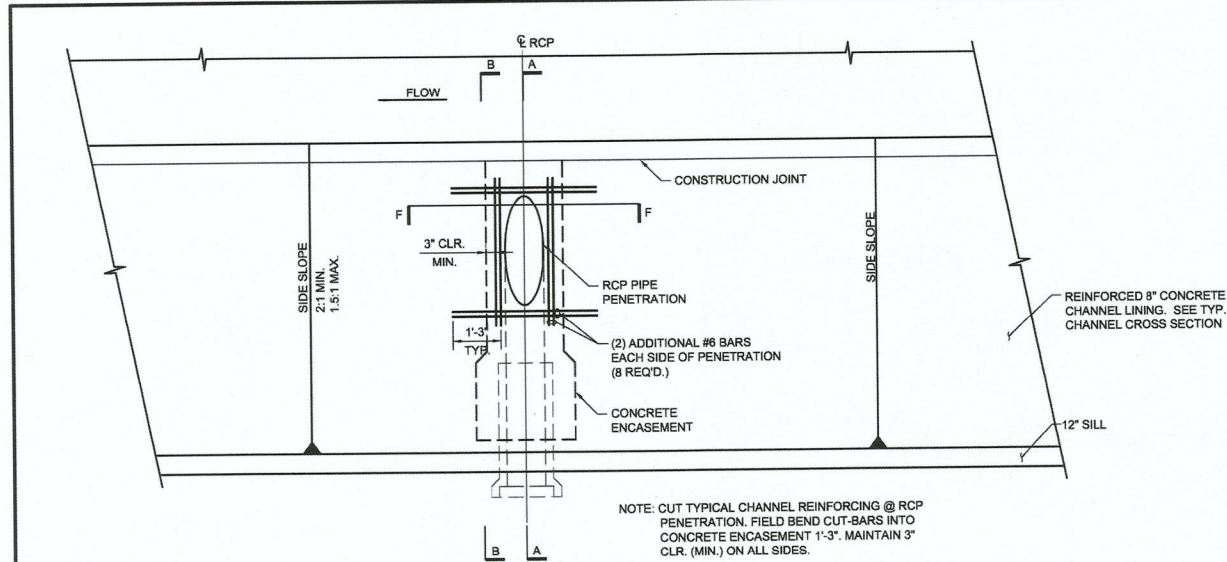


SIDE SLOPE	DIMENSION "A"							
	PIPE DIAMETER (INCHES)							
1.5:1	4'-8"	5'-5"	6'-2"	6'-11"	7'-8"	8'-5"	9'-2"	10'-8"
2:1	5'-8"	6'-8"	7'-8"	8'-8"	9'-8"	10'-8"	11'-8"	13'-8"

	DIMENSION "B"							
	PIPE DIAMETER (INCHES)							
	24	30	36	42	48	54	60	72
	10"	11"	1'-1"	1'-2"	1'-3"	1'-4"	1'-6"	1'-8"

GENERAL NOTES:


1. THE PIPE PENETRATION DETAILED HEREIN SHALL BE PAID FOR LUMP SUM AND SHALL BE COMPENSATION FOR THE PENETRATION COMPLETE AND IN PLACE. INCLUDED IN THIS WORK (BUT NOT LIMITED TO) IS GRADING, SUBGRADE PREPARATION, REINFORCED CONCRETE, CONSTRUCTION JOINTS, CONCRETE PLACEMENT AND FINISHING. NOTE THE MEASUREMENT FOR 8" CHANNEL LINING IS CONTINUOUS AND UNINTERRUPTED AT THE PENETRATION LOCATION.
2. ALL CULVERT PIPE PLACED UNDER THE CHANNEL LINING OR WITHIN AMAFCA RIGHT-OF-WAY SHALL BE RCP CLASS III MIN.
3. FOR PIPE PENETRATIONS INTO EXISTING CHANNELS, USE CHANNEL REMOVAL DETAILS FROM AMAFCA STANDARD DRAWING 102.

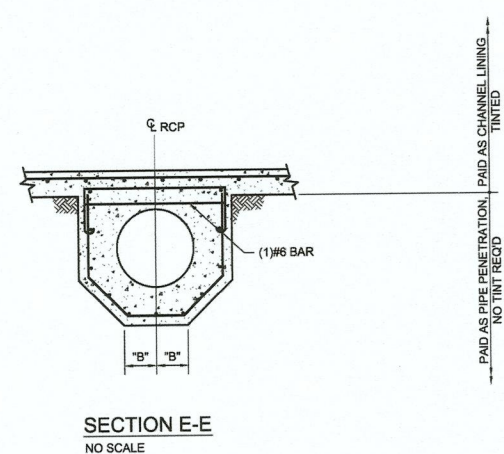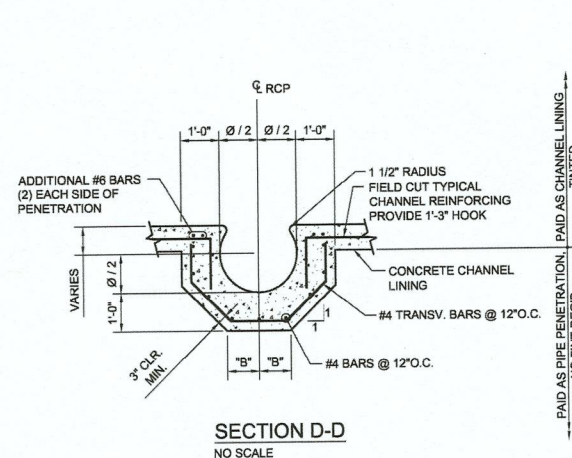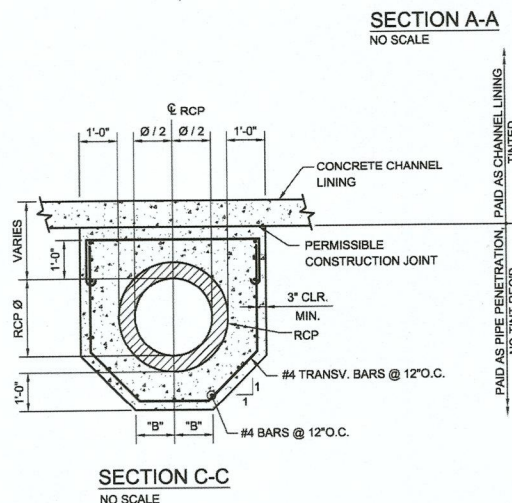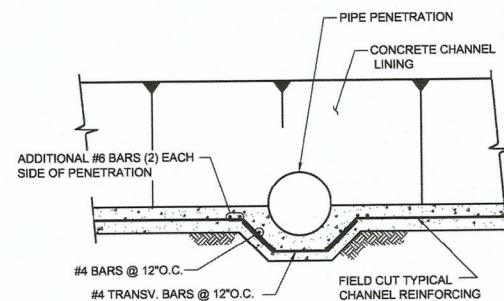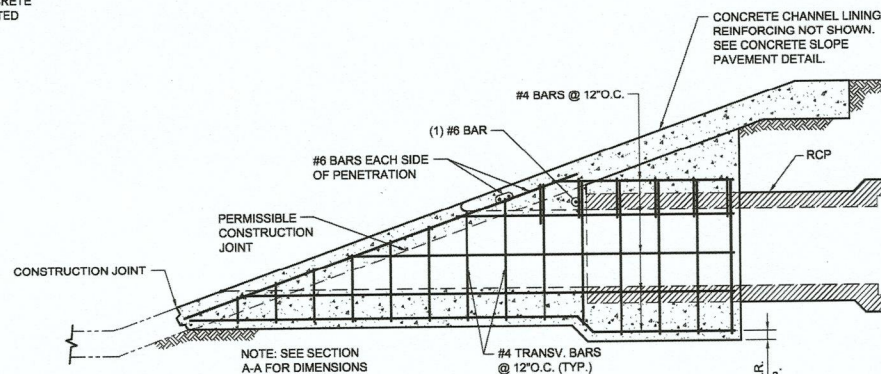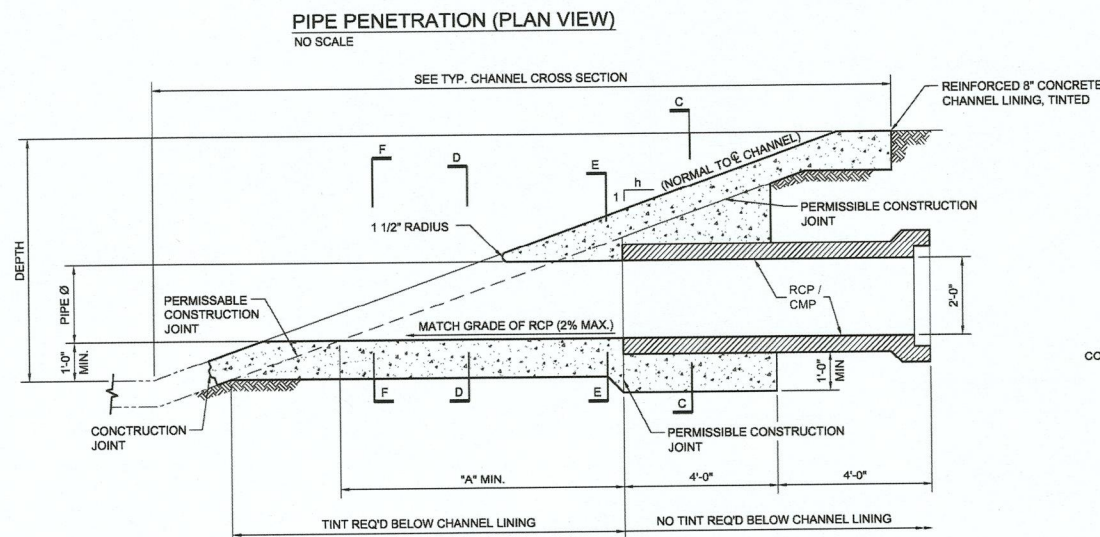

ALBUQUERQUE METROPOLITAN ARROYO FLOOD CONTROL AUTHORITY			
AMAFCA STANDARD DETAILS			
RCP CHANNEL PENETRATION PIPE DIAMETER > 12", 0° SKEW			
REV	DATE	DESCRIPTION	CHKD
DRAWING NO.	103	MAP NO.	SHEET OF

ISSUE DATE: 8-12-2008

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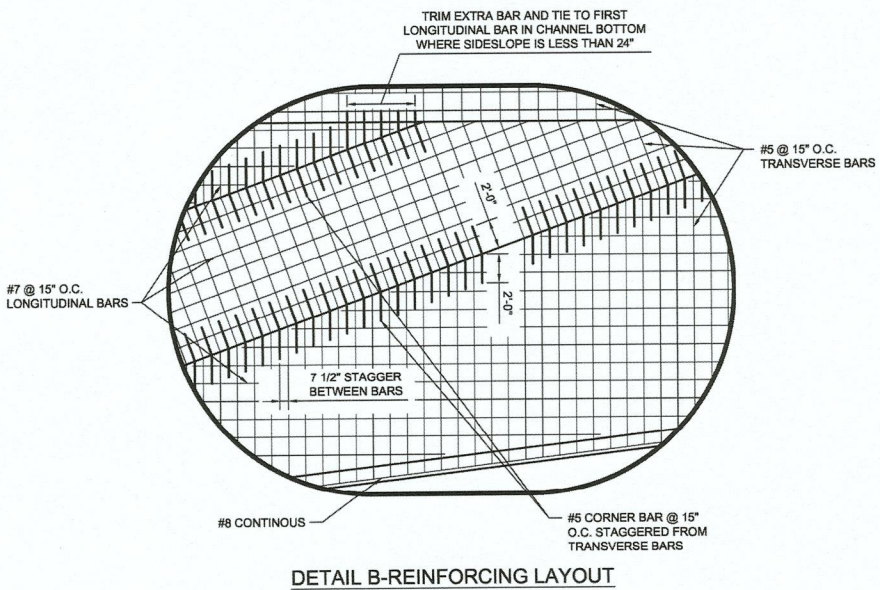
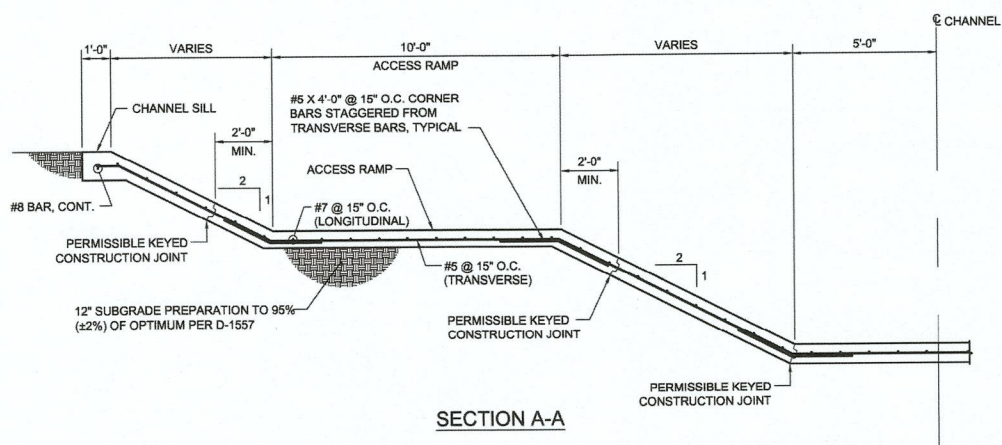
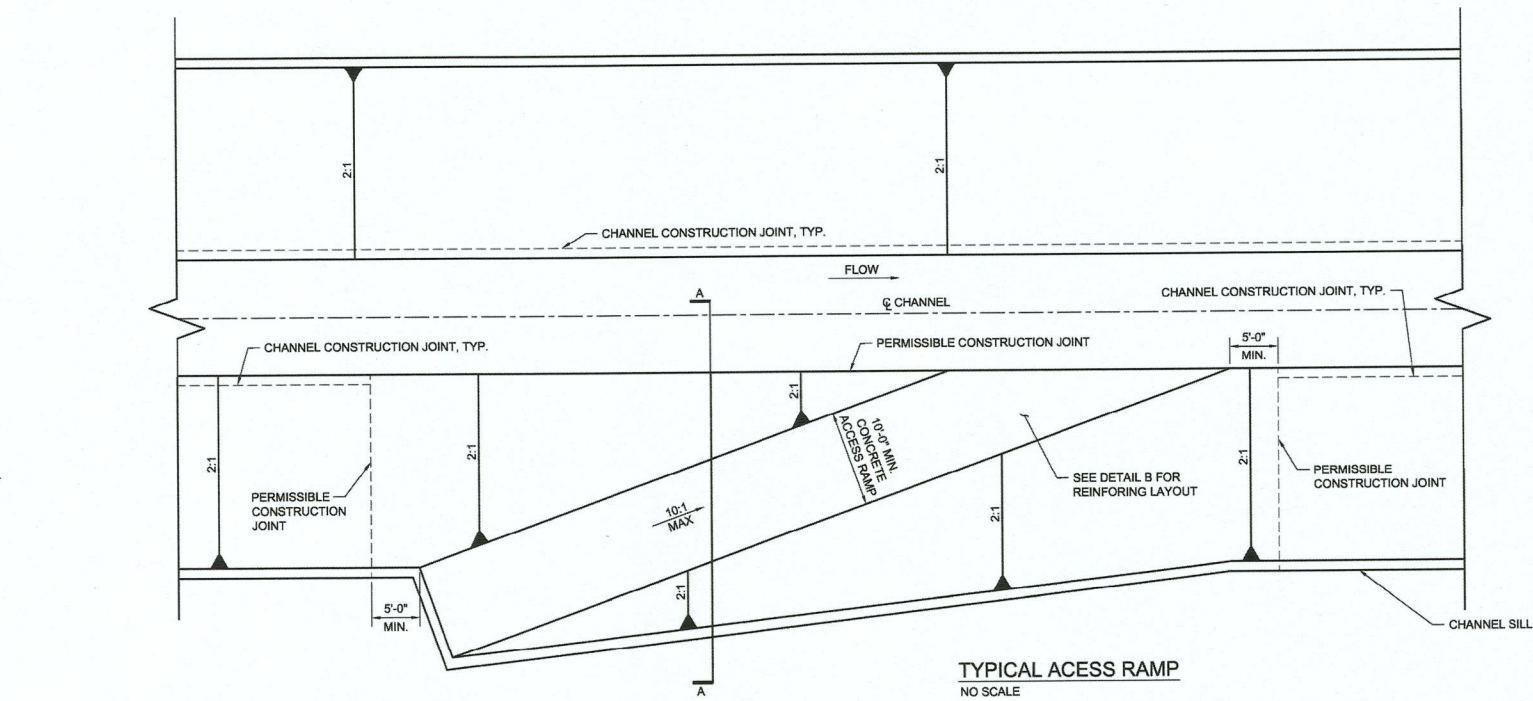
BY	DESCRIPTION	DATE	REV.

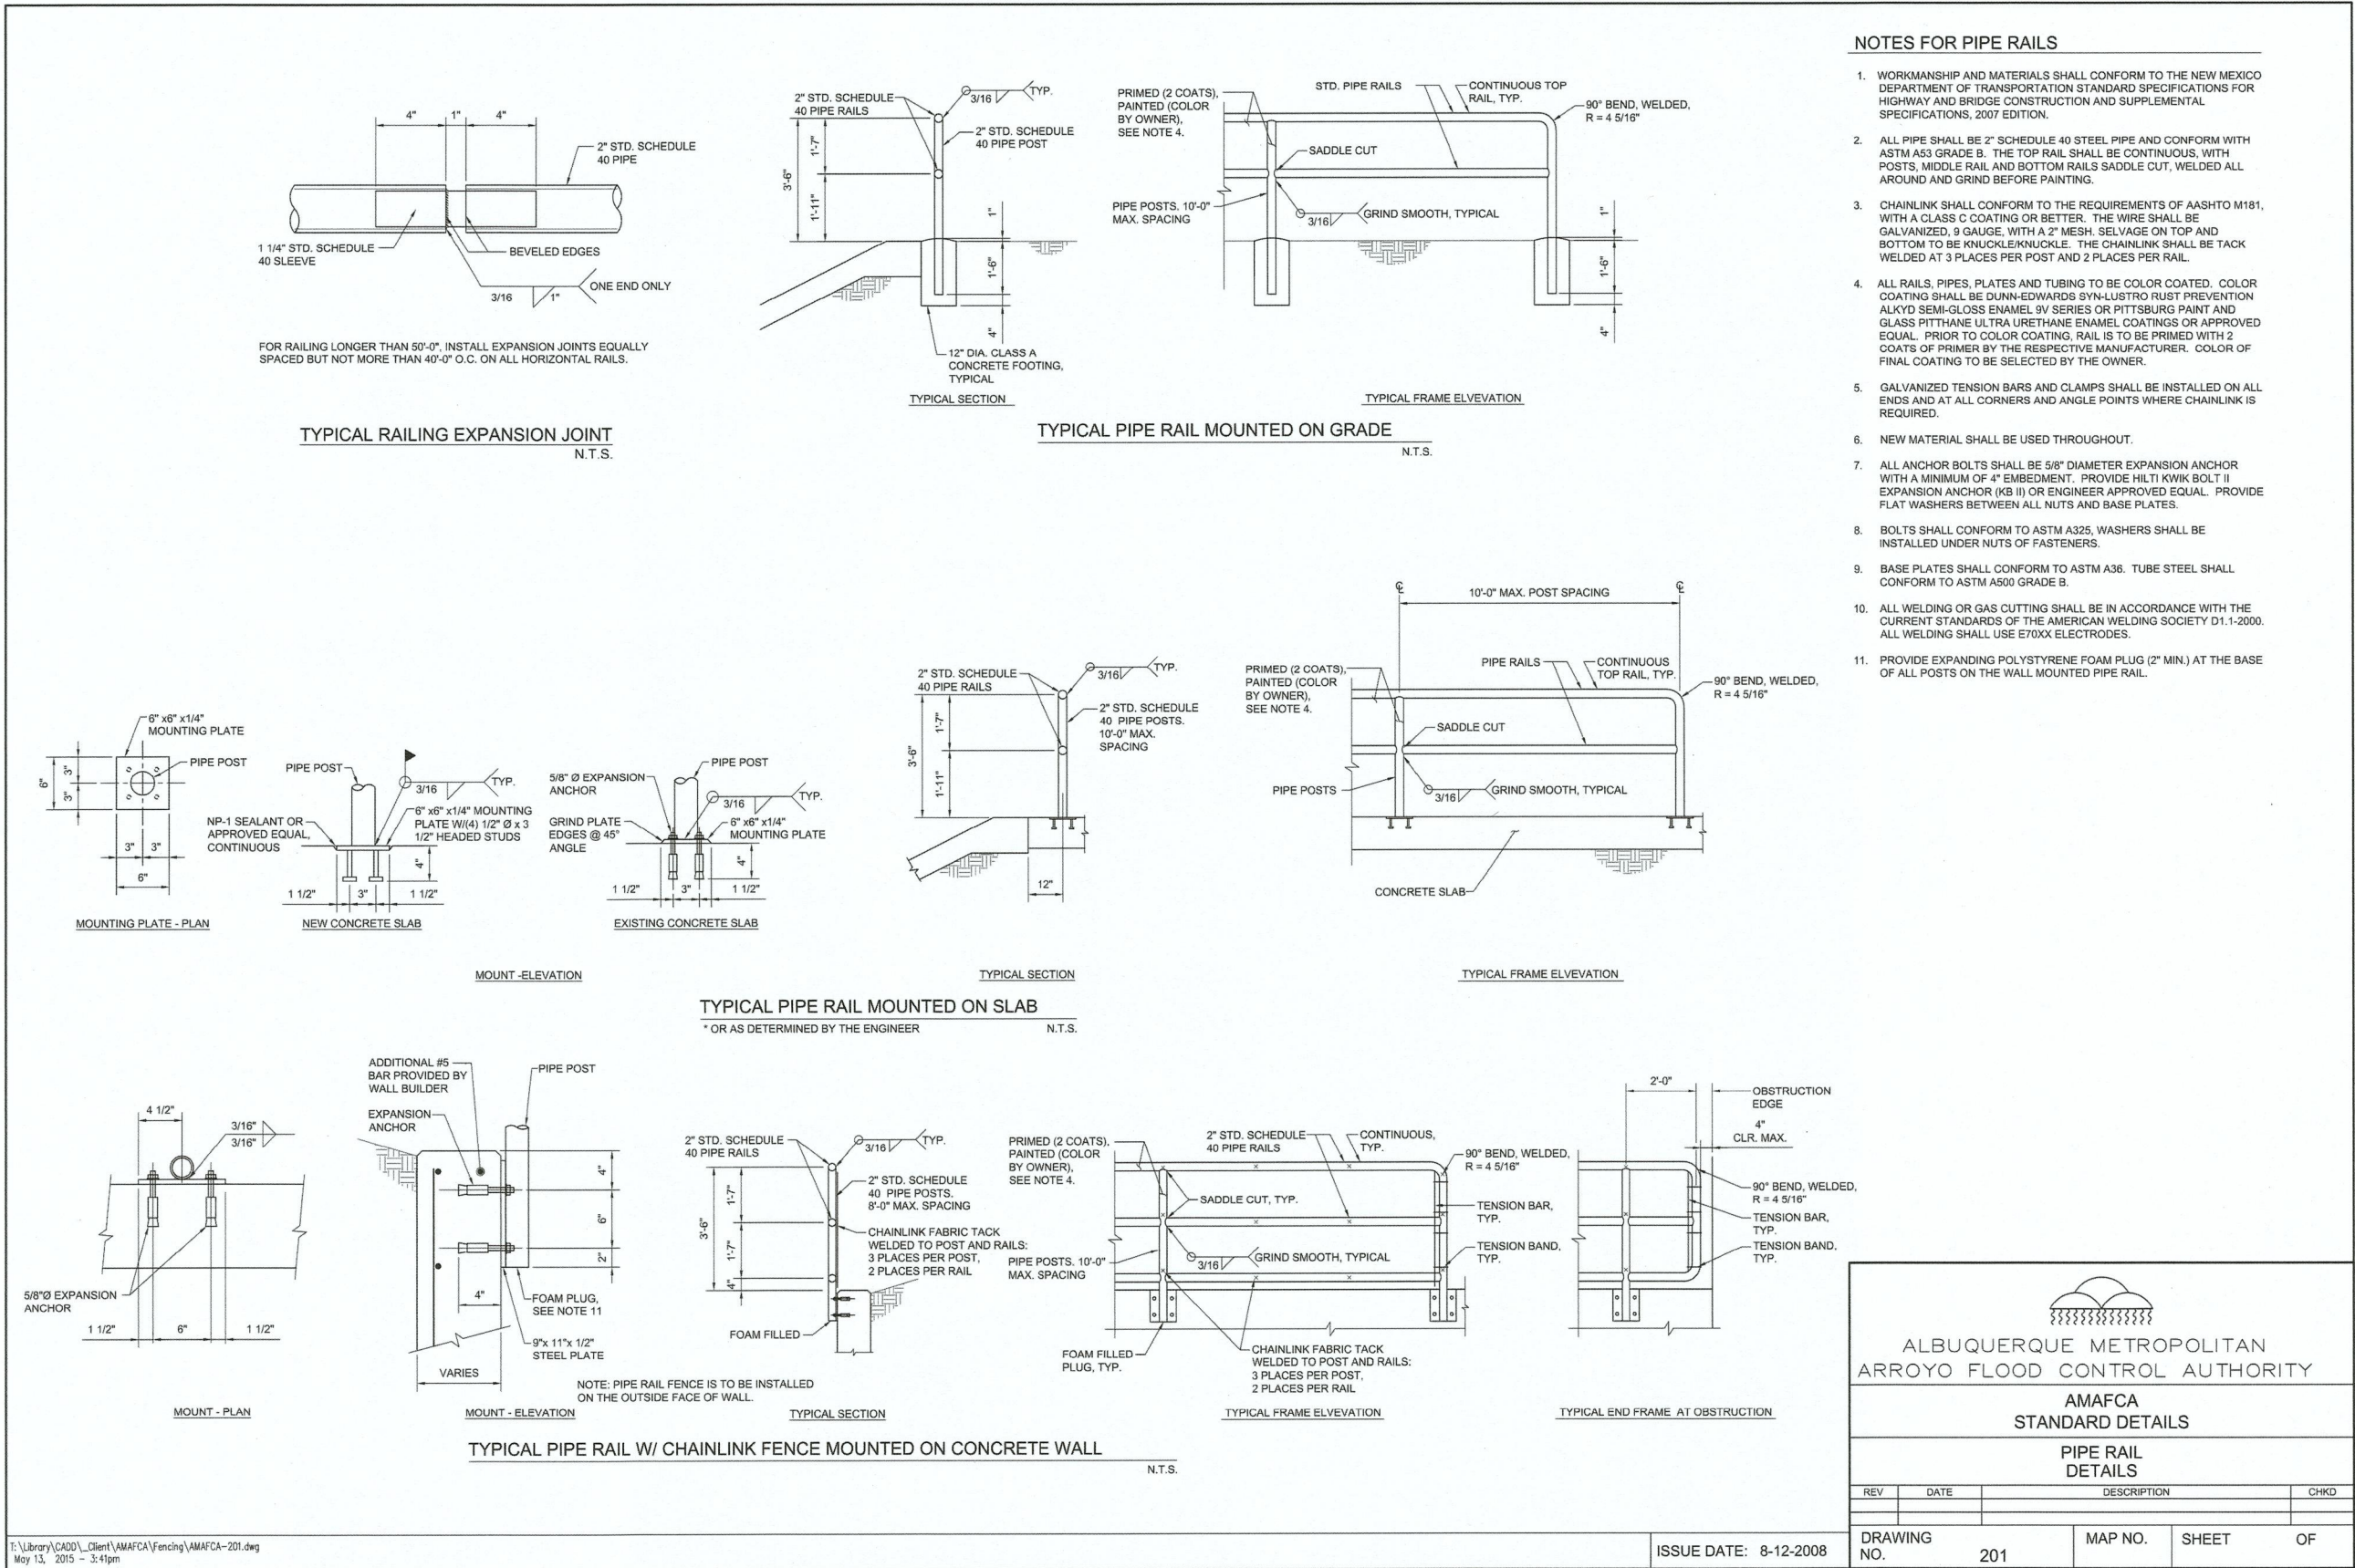PROJECT NO: 1660060700
DESIGNED BY: TJA
DRAWN BY: JEM
CHECKED BY: TJA
DATE: JAN 2022
SHEET TITLE

DETAILS

SHEET NO:
C-503

1/5/2022 M:\MSD\16-600-607-00\2_Disciplines\Sheets - civil\BARR SPUR\166607-DT01.dwg



- GENERAL NOTES**
1. THE ACCESS RAMP DETAILED HEREIN SHALL BE PAID FOR AS CONCRETE CHANNEL LINING AND SHALL BE COMPENSATION FOR THE RAMP COMPLETE AND IN PLACE.
 2. THE RAMP SHALL BE TINTED TO MATCH ADJACENT CHANNEL LINING UNLESS OTHERWISE NOTED.

**ALBUQUERQUE METROPOLITAN
ARROYO FLOOD CONTROL AUTHORITY**

AMAFCA
STANDARD DETAILS

CONCRETE CHANNELS
ACCESS RAMP SECTIONS AND DETAILS

REV	DATE	DESCRIPTION	CHKD

DRAWING NO.	107	MAP NO.	SHEET	OF
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ISSUE DATE: 8-12-2008

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IMPROVEMENTS**

REV.	DATE	DESCRIPTION	BY

PROJECT NO: 1660060700

DESIGNED BY: TJA

DRAWN BY: JEM

CHECKED BY: TJA

DATE: JAN 2022


SHEET TITLE

DETAILS


SHEET NO:

C-504


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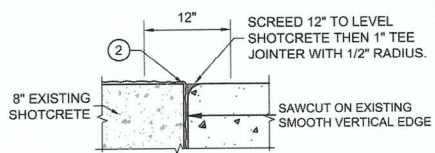
TYPICAL CHANNEL SECTION

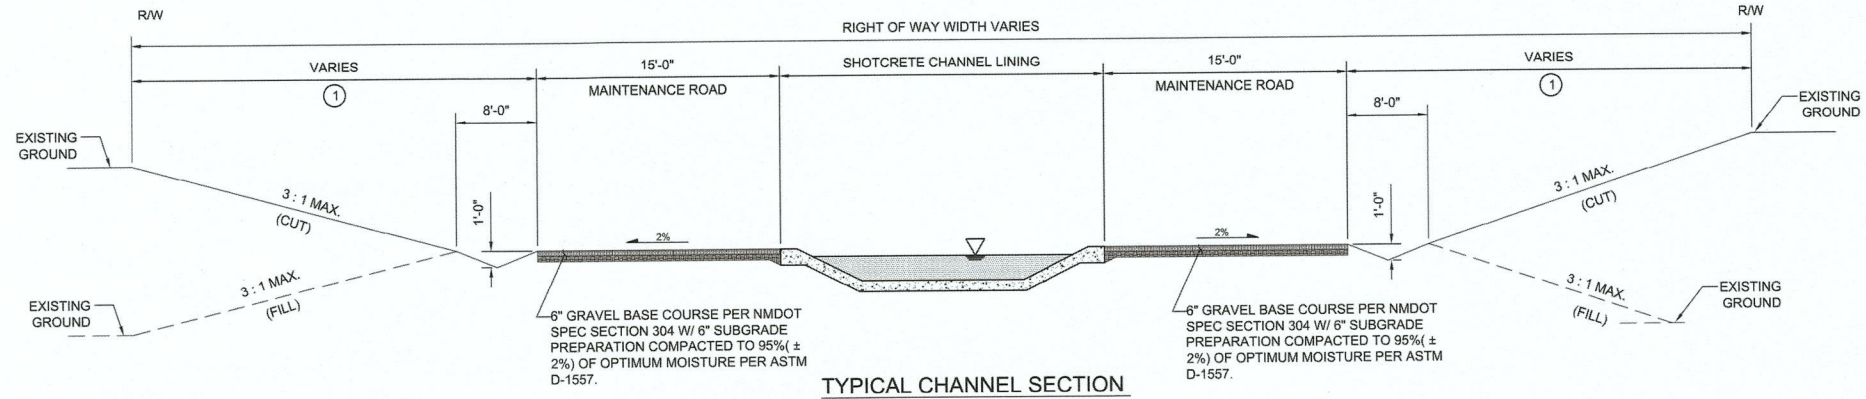


SHOTCRETE CHANNEL LINING

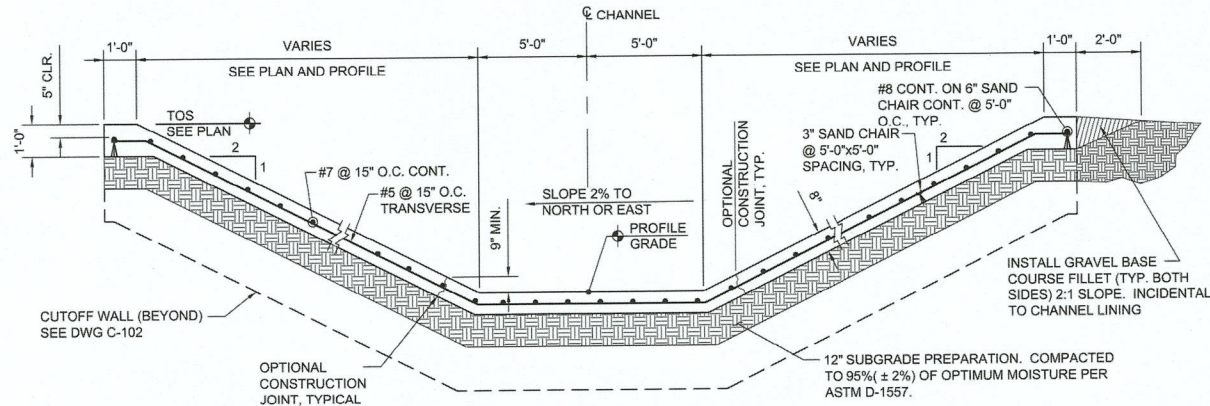


STANDARD PLACE CONCRETE TO NEW SHOTCRETE JOINT DETAIL

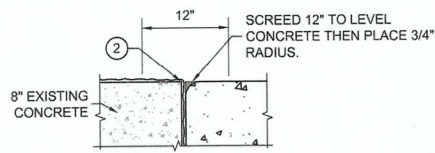

EXISTING SHOTCRETE TO NEW SHOTCRETE

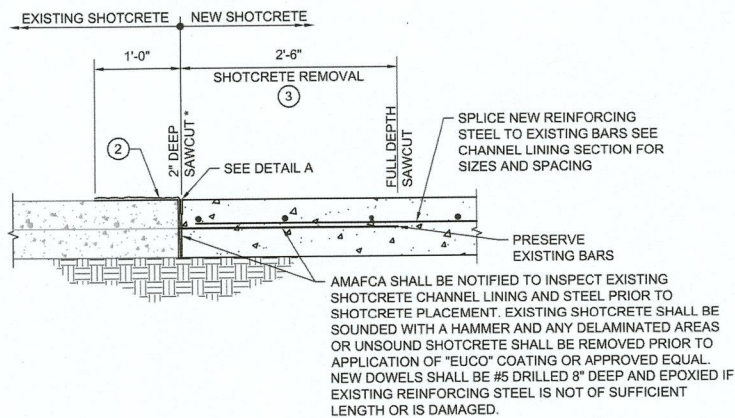

NEW TO EXISTING CHANNEL LINING CONSTRUCTION JOINT

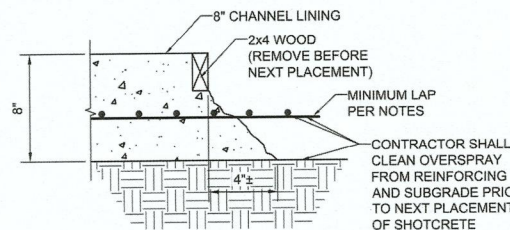

8" SHOTCRETE TYPICAL CONSTRUCTION JOINT

NOTES FOR SHOTCRETE CHANNEL CONSTRUCTION

- SHOTCRETE: CONCRETE SHALL BE IN ACCORDANCE WITH PROJECT SPECIFICATIONS. ($f_c = 4000$ psi MINIMUM). $3/4$ " CHAMFER ON ALL EXPOSED FORMED EDGES UNLESS NOTED OTHERWISE.
- REINFORCING STEEL: STEEL REINFORCEMENT AND PLACEMENT SHALL BE IN ACCORDANCE WITH PROJECT SPECIFICATIONS AND SHALL CONFORM TO ASTM A615, GRADE 60. ALL LAP SPLICES SHALL BE CLASS "B" UNLESS NOTED OTHERWISE. REINFORCING STEEL SHALL BE INCIDENTAL TO CONCRETE BID ITEMS.
- ALL EXPOSED CONCRETE SHALL BE TINTED WITH SAN DIEGO BUFF (DAVIS COLOR 5237) AT THE REDUCED DOSAGE OF 1 LB PER SACK OF CEMENT, OR APPROVED EQUAL. TINT SHALL BE INCIDENTAL TO THE COST OF THE RESPECTIVE CONCRETE.
- NEW TO EXISTING CHANNEL CONSTRUCTION: EUCO ARC LITHIUM NITRATE OR APPROVED EQUAL TREATMENT IS REQUIRED FOR ANY EXISTING CONCRETE CHANNELS. SEE DETAILS FOR INSTALLATION REQUIREMENTS, THIS SHEET.
- MINIMUM REBAR LAP LENGTH (CLASS B LAPS):
#4 = 24"
#5 = 26"
#7 = 43"
#8 = 54"
- THE EARTH SIDE OF SILL WALLS SHALL BE WATERPROOFED AT IRRIGATED AREAS AND DAMP PROOFED AT ALL OTHER AREAS. WATERPROOFING SHALL BE CONWRAP BARRIER CS-212 AS MANUFACTURED BY CONCRETE SEALANTS, INC. (MEMBRANE THICKNESS 0.100 INCHES MINIMUM) OR APPROVED EQUAL. DAMP PROOFING SHALL BE HYDROCID 700B OR APPROVED EQUAL.
- FOR SILL WALL AND CUT OFF WALL DETAILS SEE SHEET C-102.

KEYED NOTES

- NATIVE RE-VEGETATION. SEE CITY OF ALBUQUERQUE SPECIFICATION SECTION 1012. GRAVEL MULCH IS REQUIRED FOR SLOPES GREATER THAN 3H:1V.
- EUCO ARC LITHIUM NITRATE COATING OR APPROVED EQUAL APPLIED TO VERTICAL SURFACE AND 12" OF TOP SURFACE OF EXISTING CONCRETE TO REMAIN.
- REMOVAL OF CONCRETE ADJACENT TO THE 2" SAWCUT WILL BE WITH A 30 LB., MAX. PNEUMATIC HAMMER. IN THE EVENT OF DAMAGE TO THE CONCRETE TO REMAIN, THE CONTRACTOR SHALL RE SAW THE 2" JOINT AND REMOVE AND REPLACE THAT CONCRETE AT NO COST.

ALBUQUERQUE METROPOLITAN ARROYO FLOOD CONTROL AUTHORITY			
AMAFCA STANDARD DETAILS			
SHOTCRETE CHANNEL STRUCTURE SECTIONS AND DETAILS			
REV	DATE	DESCRIPTION	CHKD
DRAWING NO.	C-102S	MAP NO.	SHEET OF

ISSUE DATE: 2-14-2020

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BARR SPUR
IMPROVEMENTS

PROJECT NAME

BY	DESCRIPTION	DATE	REV.

PROJECT NO: 166060700
DESIGNED BY: TJA
DRAWN BY: JEM
CHECKED BY: TJA
DATE: JAN 2022
SHEET TITLE

DETAILS

SHEET NO:
C-505

1/5/2022 M:\MSD\16-600-607-0012_Disciplines\16-600-607-0012_Sheets - civil\BARR SPUR\166607-DT03.dwg

GENERAL SHEET NOTES

1. FOR CONCRETE BOX CULVERTS, REFER TO SHEETS ##### THRU C-514.
2. FOR HEADWALL/CUT-OFF WALLS, REFER TO SHEET C-515 THRU C-516.
3. FOR WINGWALL DIMENSIONS, REFER TO THIS SHEET. FOR WINGWALL NOTES AND REBAR REINFORCEMENT, REFER TO SHEETS C-518 THRU C-519.
4. FOR 18" RCP PENETRATION ON HEADWALL, SEE "OUTER WALL PENETRATION DETAIL" ON SHEET C-517.
5. 18" RCP SHALL HAVE TURNOUT INSTALLED @ HEADWALL. TURNOUT WILL BE 18" TYPE III WITH 18" FRESNO GATE MODEL 101C

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PROJECT NAME

BARR SPUR
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REV.	DATE	DESCRIPTION	BY


PROJECT NO: 1660060700
DESIGNED BY: TJA
DRAWN BY: JEM
CHECKED BY: TJA
DATE: JAN 2022

SHEET TITLE


DETAILS

SHEET NO:

C-506

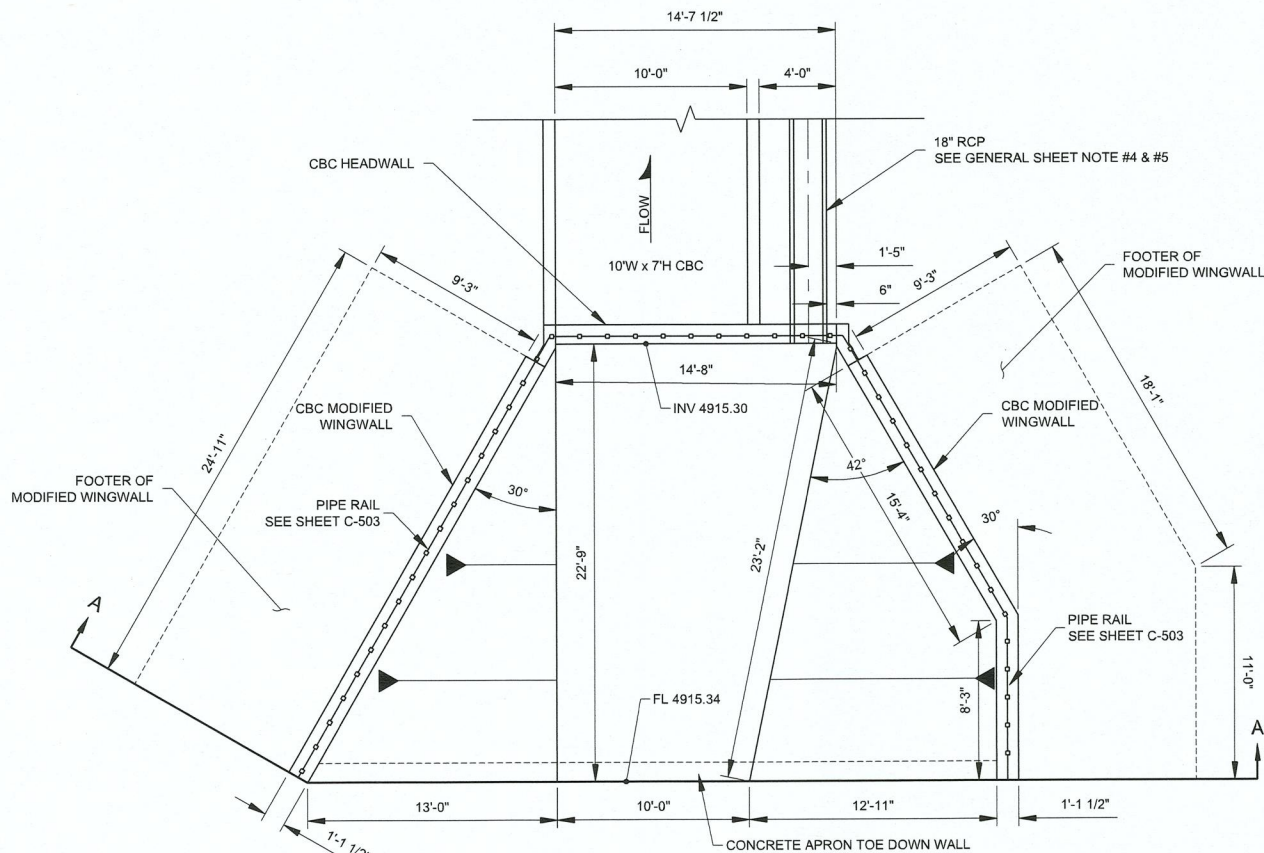

PLAN VIEW
SCALE: 1" = 5'

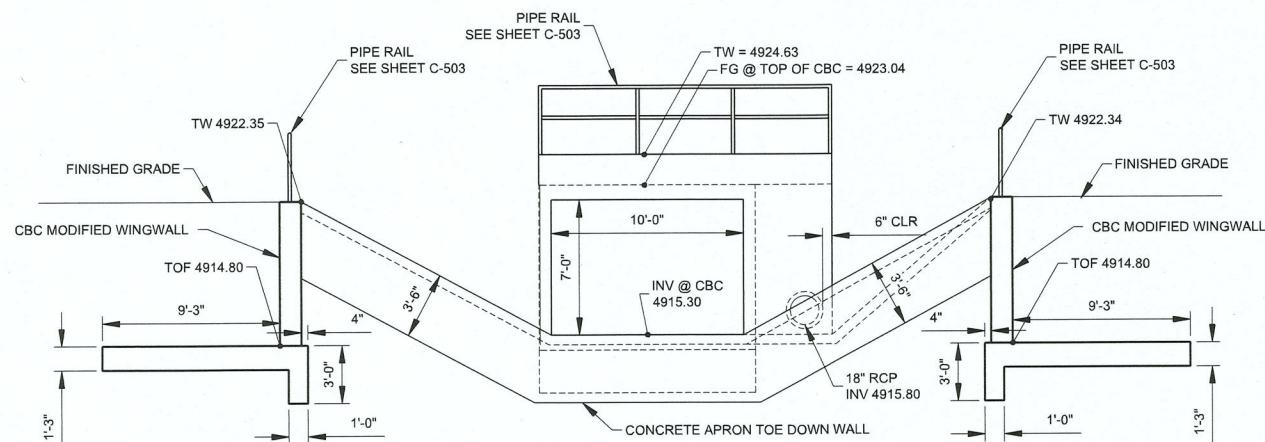


SECTION A - A
SCALE: 1" = 5'


BARR SPUR UPSTREAM
CONCRETE WINGWALL 'B' DETAIL

A1

SCALE: 1" = 5'

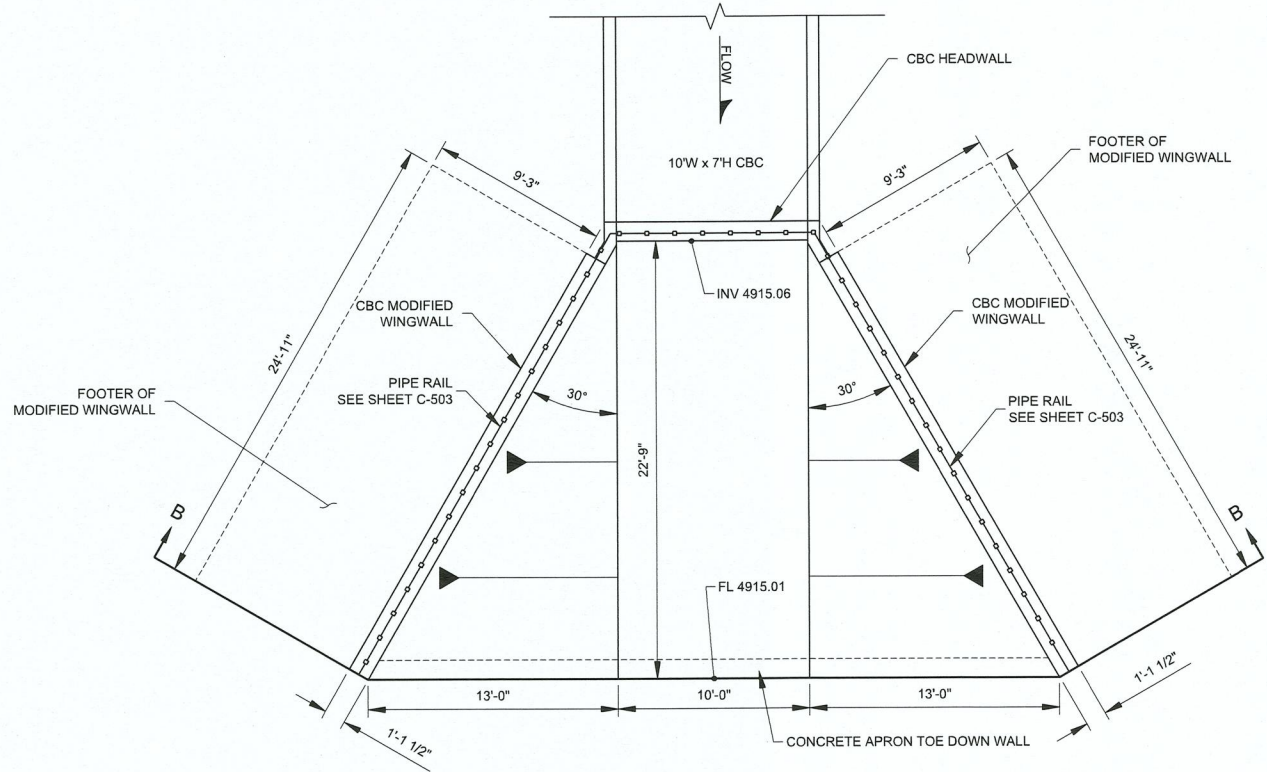

PLAN VIEW
SCALE: 1" = 5'

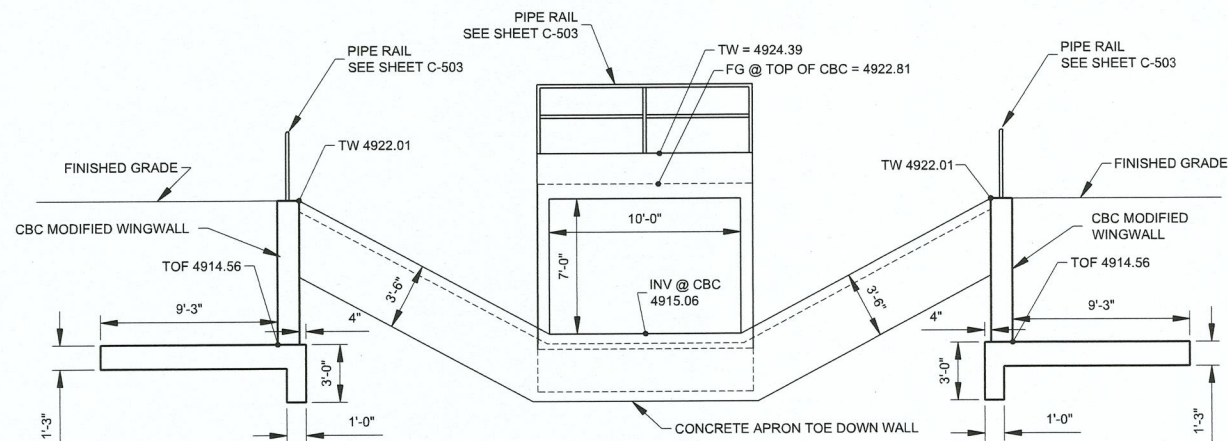

SECTION B - B
SCALE: 1" = 5'

BARR SPUR DOWNSTREAM
CONCRETE WINGWALL 'A' DETAIL

A6

SCALE: 1" = 5'

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GENERAL SHEET NOTES

1. FOR CONCRETE BOX CULVERTS, REFER TO SHEETS ##### THRU C-514.
2. FOR HEADWALL/CUT-OFF WALLS, REFER TO SHEET C-515 THRU C-516.
3. FOR WINGWALL DIMENSIONS, REFER TO THIS SHEET. FOR WINGWALL NOTES AND REBAR REINFORCEMENT, REFER TO SHEETS C-518 THRU C-519.

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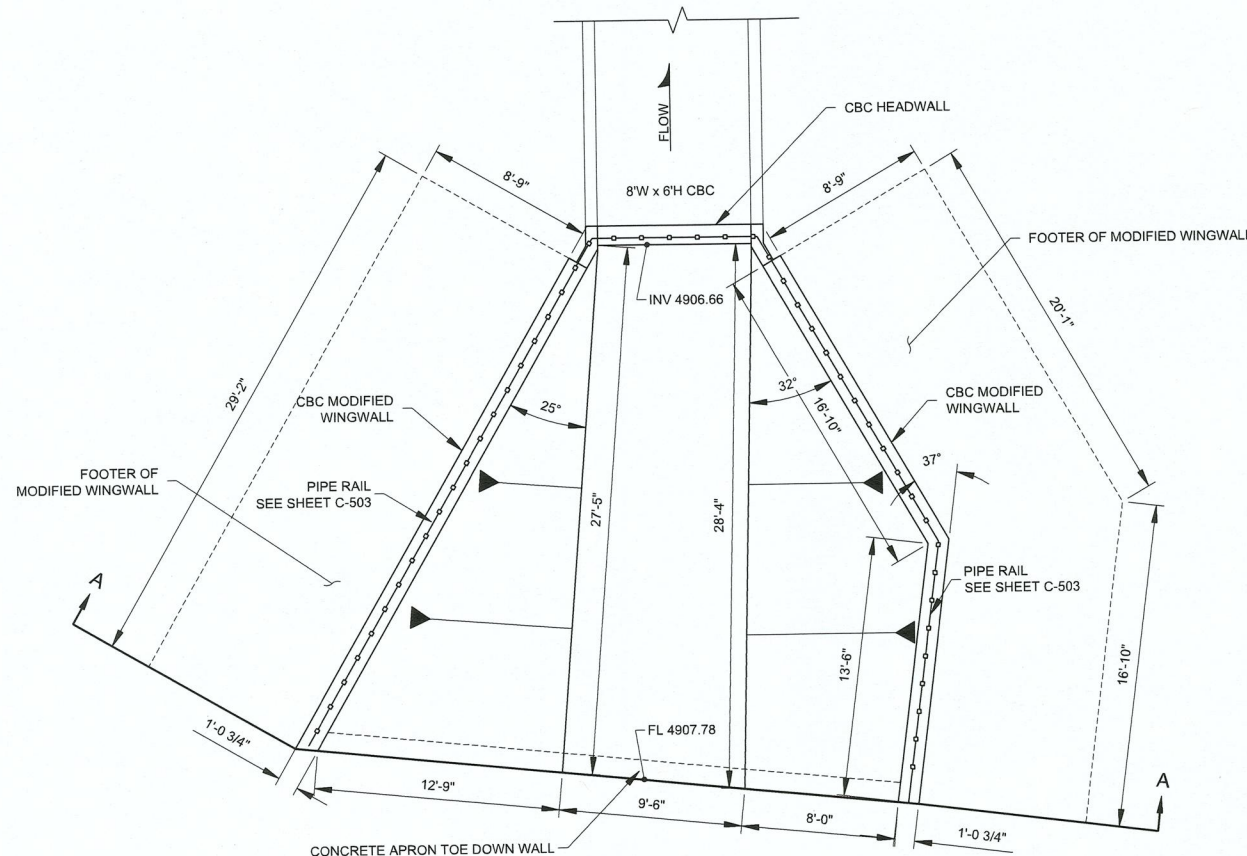
PROJECT NAME

REV.	DATE	DESCRIPTION	BY


PROJECT NO: 1660060700
DESIGNED BY: TJA
DRAWN BY: JEM
CHECKED BY: TJA
DATE: JAN 2022
SHEET TITLE

DETAILS


SHEET NO:
C-507




PLAN VIEW
SCALE: 1" = 5'

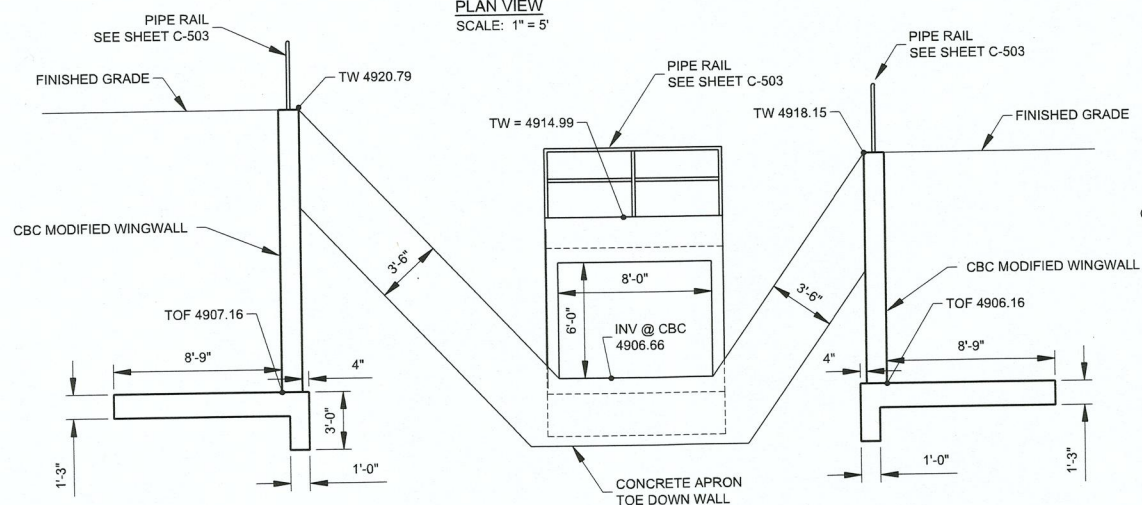

SECTION A - A
SCALE: 1" = 5'

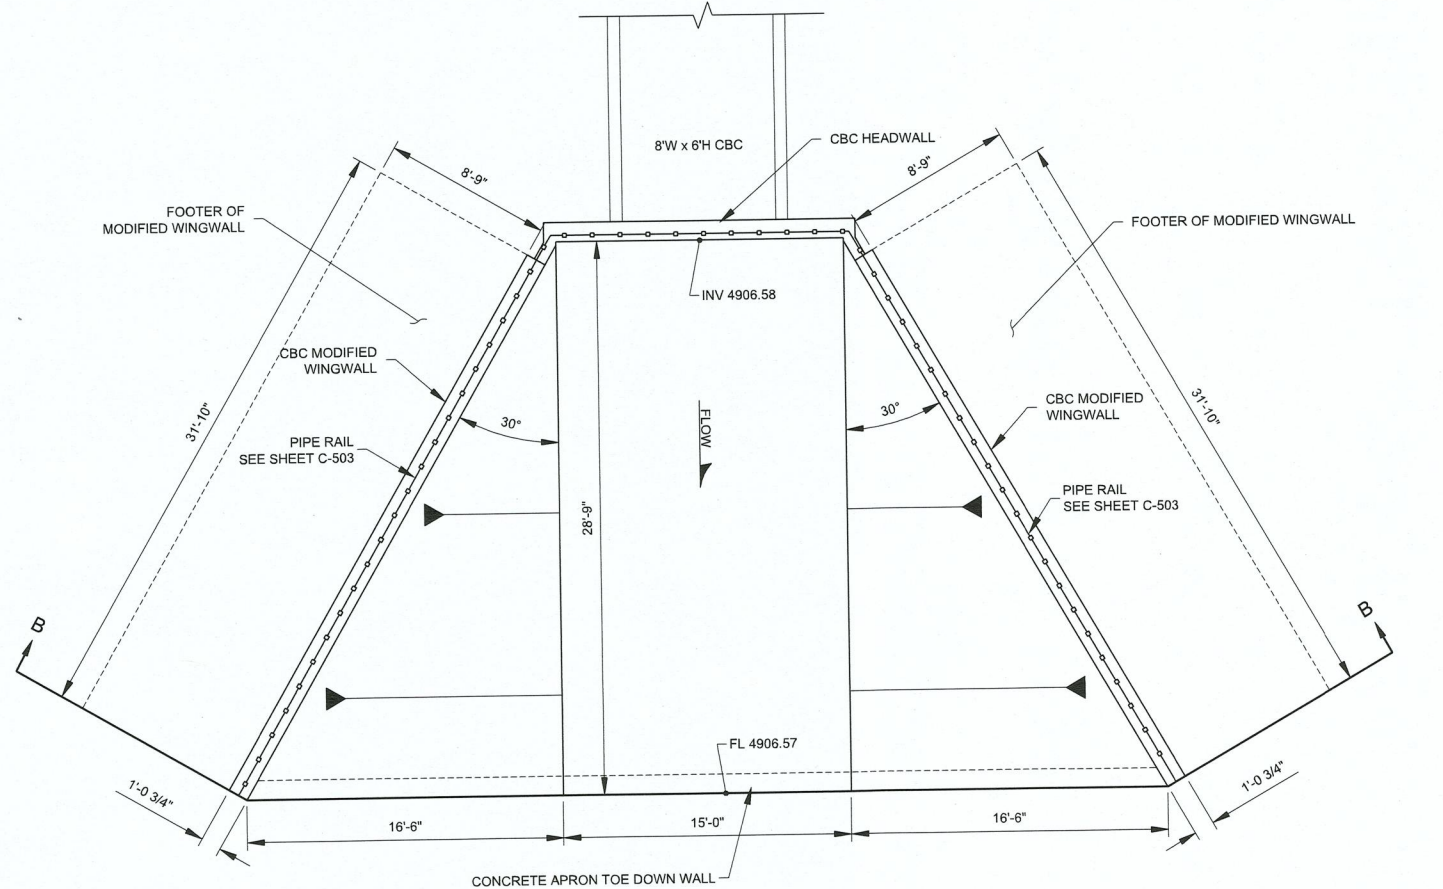

PLAN VIEW
SCALE: 1" = 5'

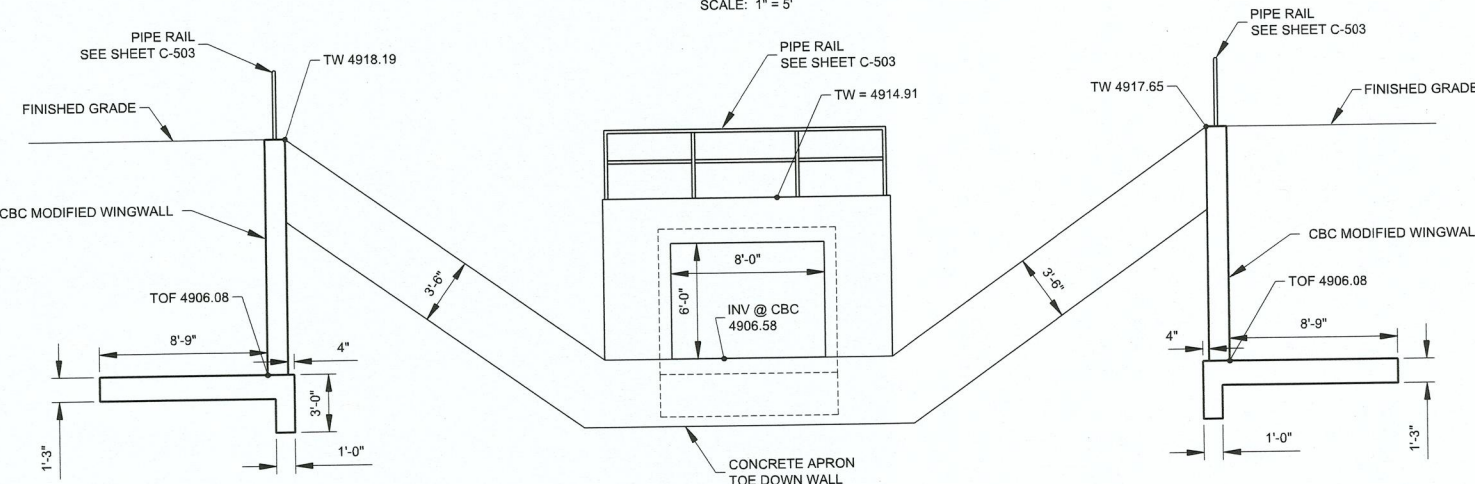

SECTION B - B
SCALE: 1" = 5'


**BARR INTERIOR DRAIN UPSTREAM
CONCRETE WINGWALL 'C' DETAIL**

**BARR INTERIOR DRAIN DOWNSTREAM
CONCRETE WINGWALL 'D' DETAIL**

A1
SCALE: 1" = 5'

A6
SCALE: 1" = 5'

1/5/2022 M:\MSD\16-600-607-002_Disciplines\ Sheets - civil\BARR SPUR\166607-DT03.dwg

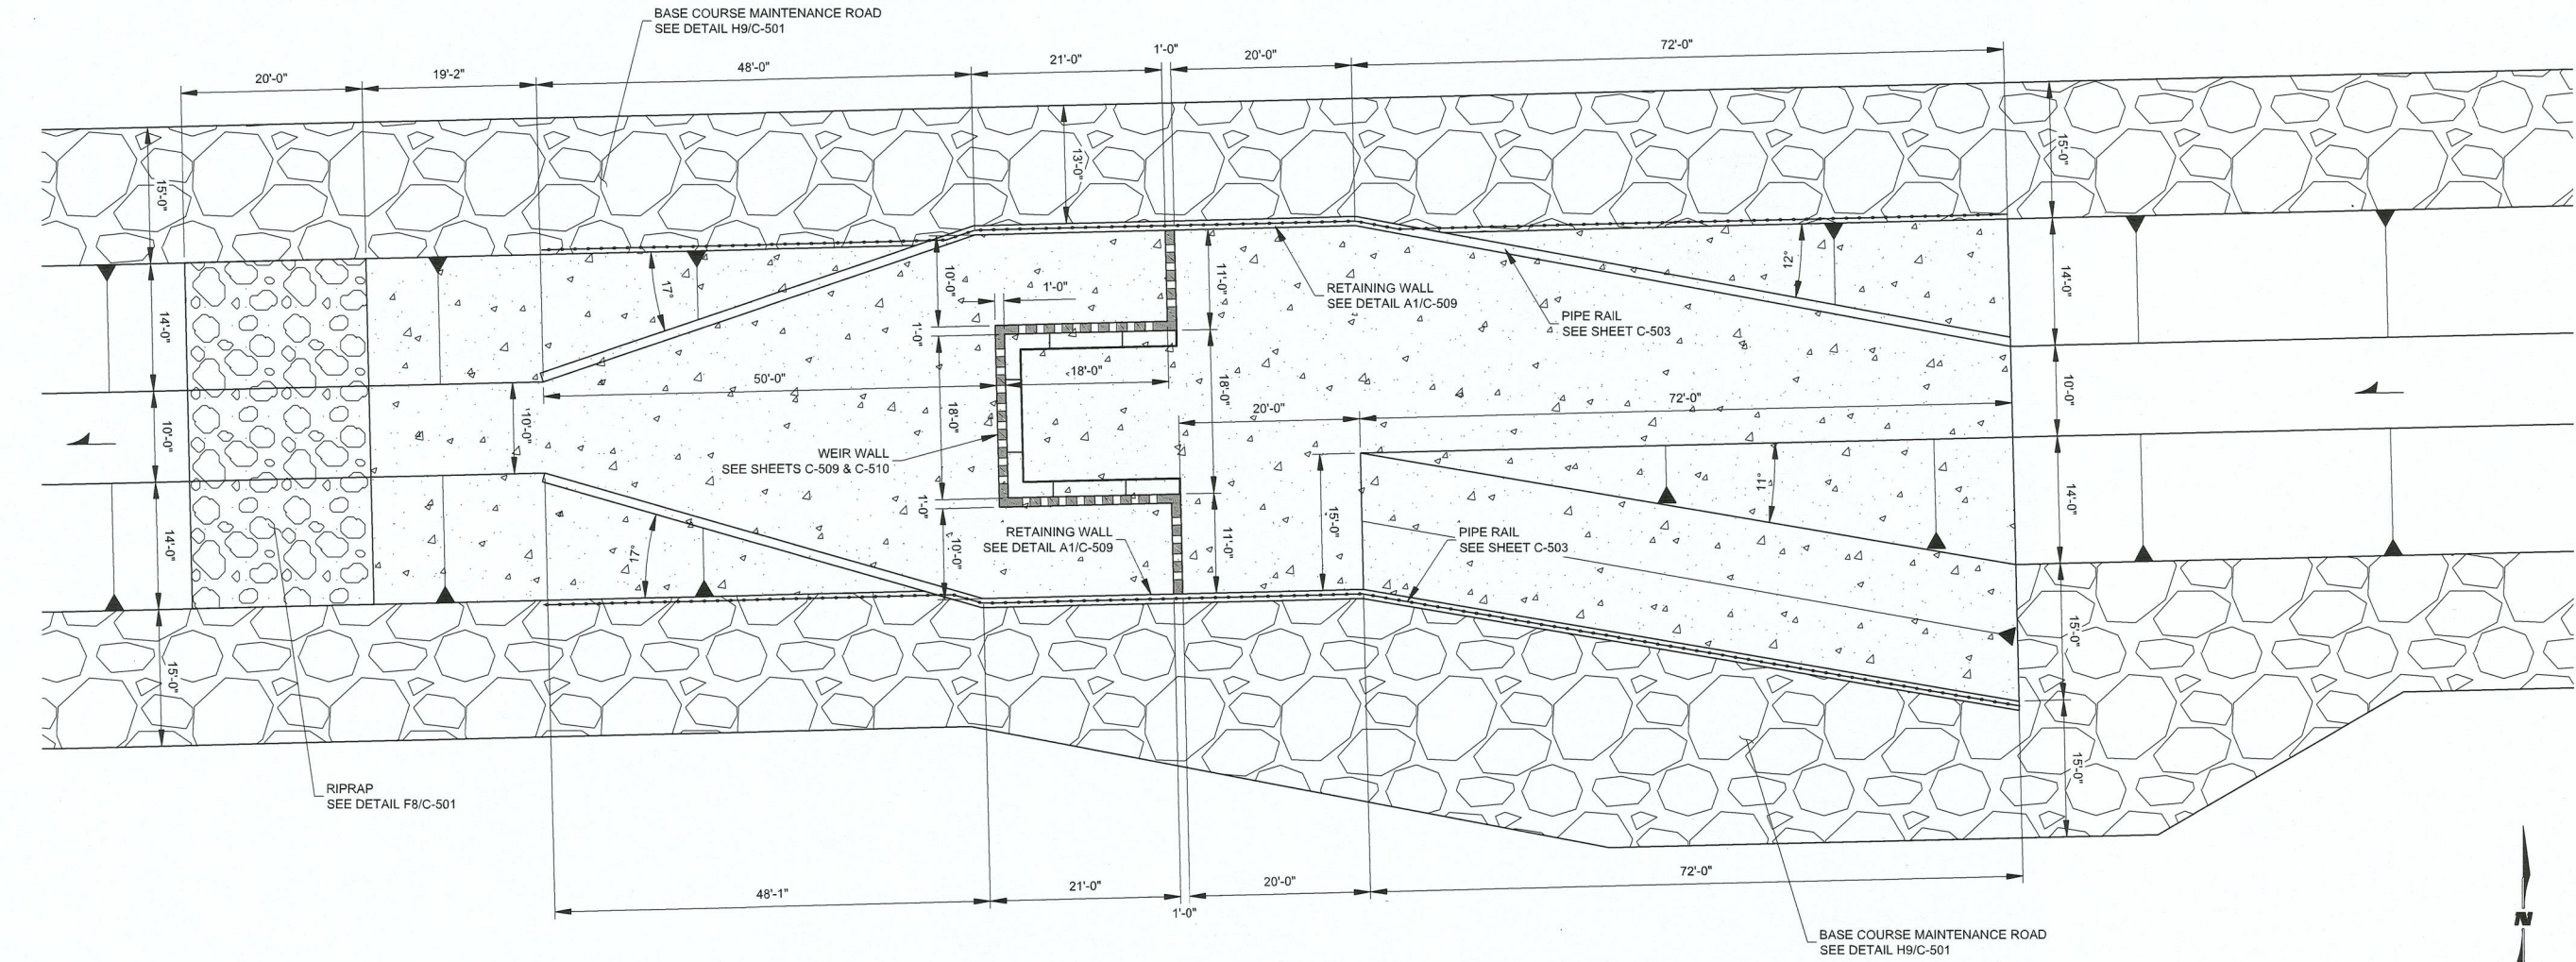

A1 WATER QUALITY STRUCTURE DETAILS
SCALE: 1" = 10'

WILSON & COMPANY
4401 MASTHEAD ST. NE SUITE 150
ALBUQUERQUE, NM 87105
PHONE: 505-348-4000
FAX: 505-348-4072
www.wilsonco.com

CONSULTANTS

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NOT FOR
CONSTRUCTION

PROJECT NAME

BARR SPUR
IMPROVEMENTS

REV.	DATE	DESCRIPTION	BY

PROJECT NO: 1660060700
DESIGNED BY: TJA
DRAWN BY: JEM
CHECKED BY: TJA
DATE: JAN 2022
SHEET TITLE

DETAILS

SHEET NO:
C-508



SCALE: 1" = 6"

SECTION B - B



PLAN VIEW

SECTION C - C

SECTION D-D

GENERAL NOTES

1. ALL MATERIALS AND WORKMANSHIP SHALL CONFORM TO NMDOT STANDARD SPECIFICATIONS AND SPECIAL PROVISIONS, CURRENT EDITION.
2. ALL CONCRETE SHALL BE CLASS "A". CHAMFER ALL EXPOSED EDGES 3/4", UNLESS OTHERWISE NOTED.
3. ALL REINFORCING BARS SHALL CONFORM TO AASHTO STANDARD SPECIFICATIONS M 31 GRADE 60 UNLESS OTHERWISE NOTED. DIMENSIONS REFER TO CENTER LINE OF BAR.
4. ALL REINFORCING BARS SHALL HAVE 2" CLEAR COVER UNLESS NOTED OTHERWISE.
5. DIMENSIONS SHALL NOT BE SCALED FROM DRAWINGS.
6. TACK WELD ALL NUTS.

DESIGN NOTES

MATERIAL STRENGTHS:

CONCRETE: $f'c = 3$ KSI
REINFORCING STEEL: $f_y = 60$ KSI GRADE 60
STRUCTURAL STEEL: ASTM A36

SOIL PARAMETERS:

ALLOWABLE BEARING PRESSURE = 2500 PSF
(FOR EXTREME CONDITIONS, WATER HEAD = 11 FT)

ALLOWABLE BEARING PRESSURE = 1500 PSF
(FOR NORMAL CONDITIONS, WATER HEAD = 6 FT)

[illegible]

PROJECT NO:	1660060700
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DESIGNED BY: TJA

DRAWN BY: JEM

CHECKED BY:	TJA
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DATE: JAN 2022

SHEET TITLE

DETAILS

SHEET NO:

C-509

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CONSTRUCTION

SEAL

BARR SPUR IMPROVEMENTS

PROJECT NAME

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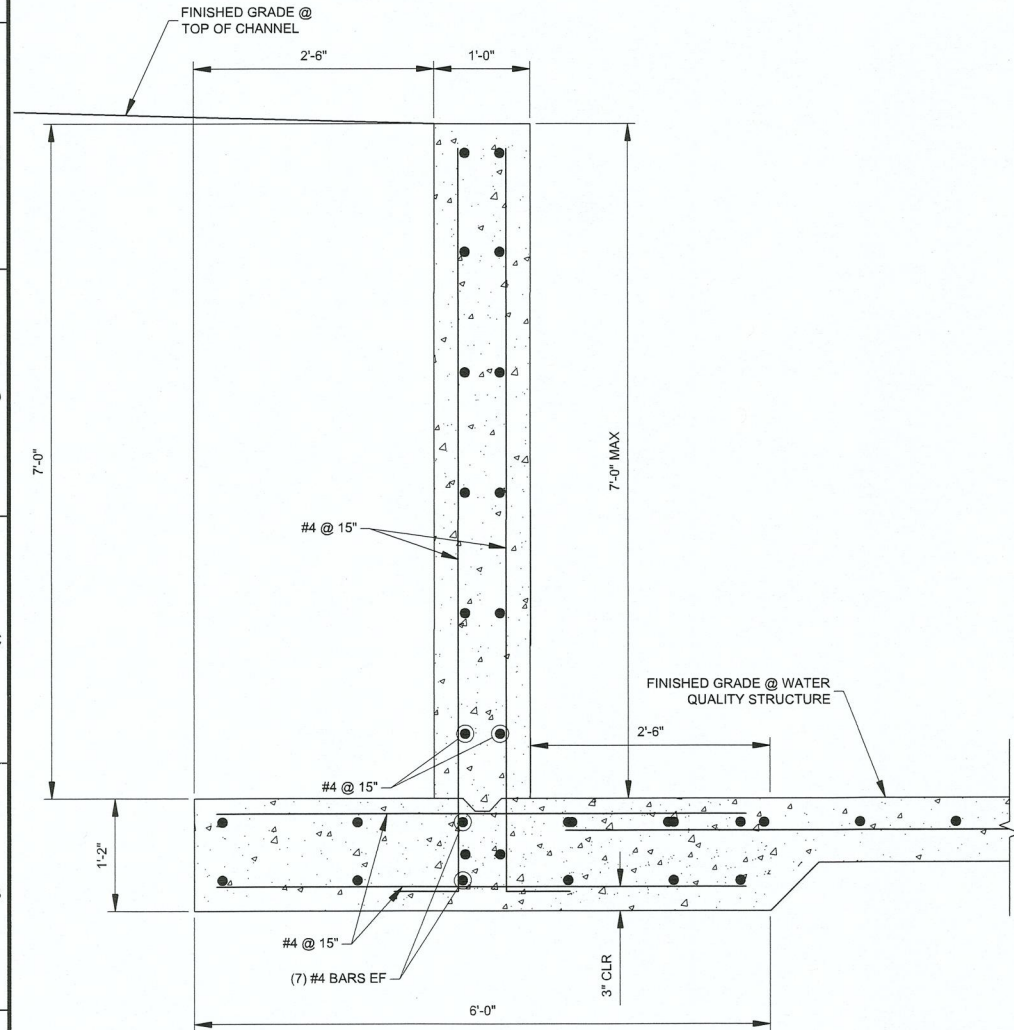
DESCRIPTION

33


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M:\MSD\16-600-607-002_Disciplines_SHEETS\2_Sheets - civil\BARR SPUR\166607-DT03.dwg


1/5/2022




A1 RETAINING WALL DETAIL
SCALE: 1" = 1'

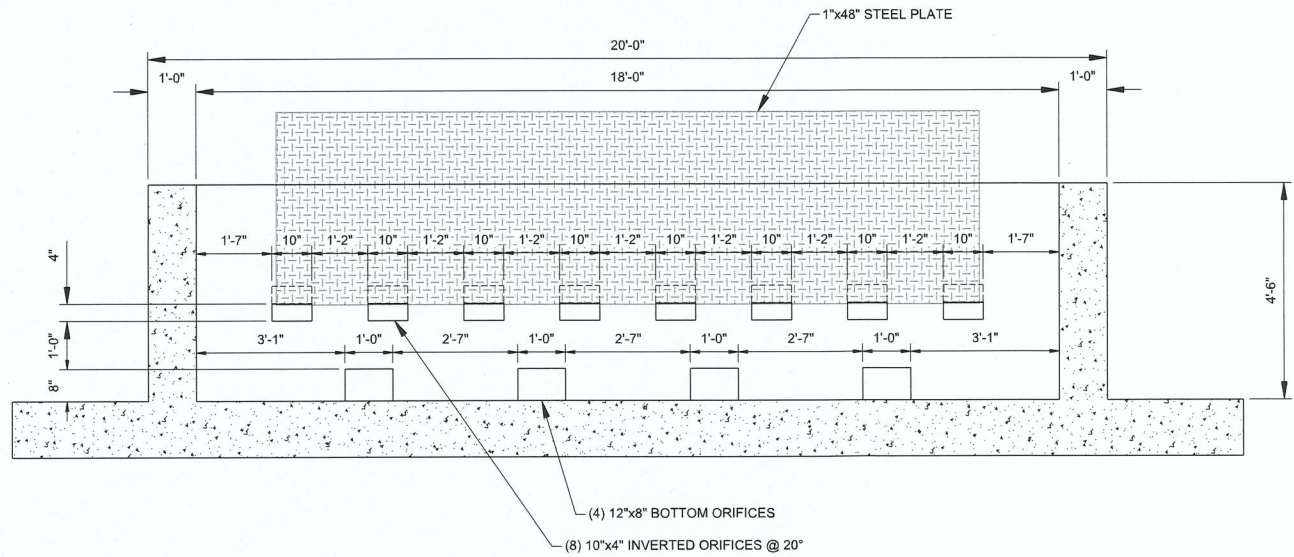

SECTION E - E
SCALE: 1" = 2'

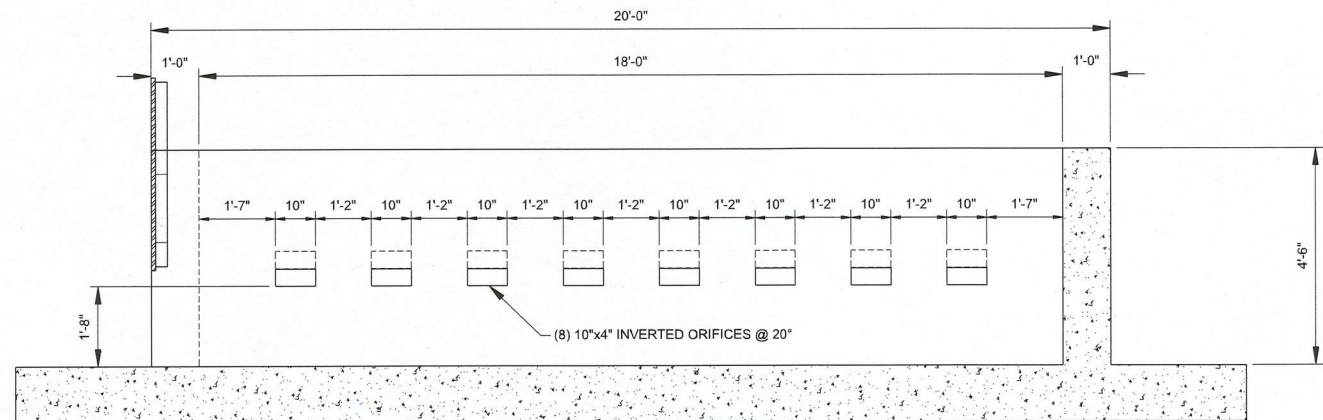

SECTION F - F
SCALE: 1" = 2'

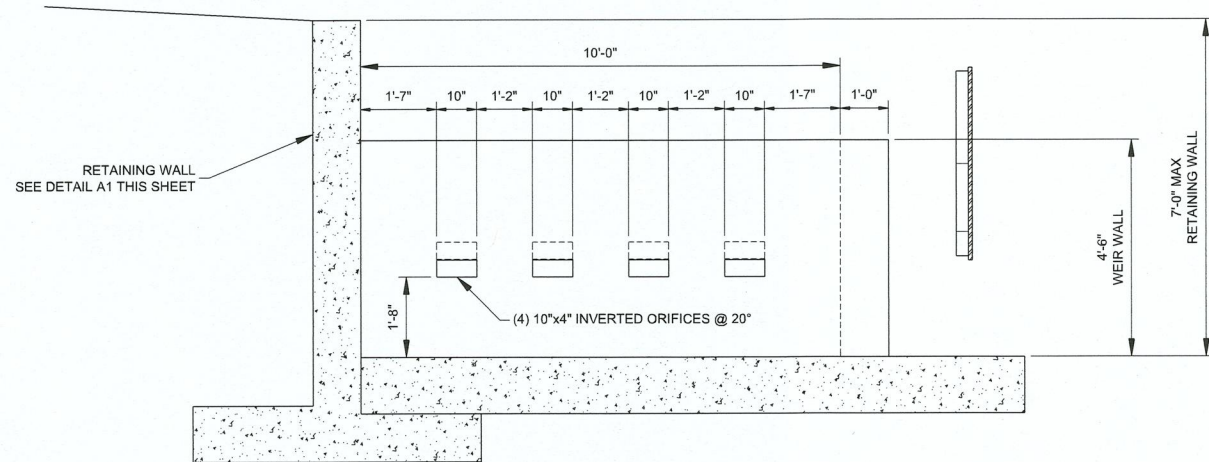

SECTION G - G
SCALE: 1" = 2'

A5 WATER QUALITY STRUCTURE SECTIONS
SCALE: 1" = 2'

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PROJECT NAME

BARR SPUR
IMPROVEMENTS

REV.	DATE	DESCRIPTION	BY

PROJECT NO: 1660060700
DESIGNED BY: TJA
DRAWN BY: JEM
CHECKED BY: TJA
DATE: JAN 2022




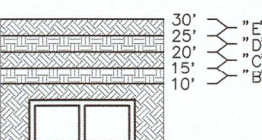

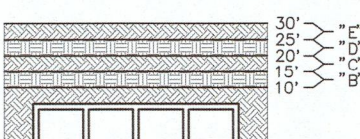
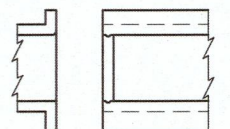
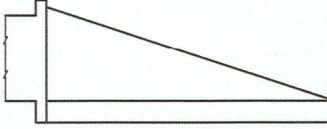
SHEET TITLE


DETAILS

SHEET NO:


C-510

M:\MSD16-600-607-002_Disciplines\SHEETS2_Sheets - civil\BARR SPUR166607-DT02.dwg 1/5/2022

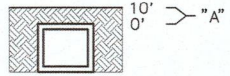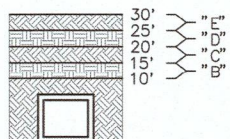
BOX TYPE	CONFIGURATION	DESIGN FILL	DRAWINGS
SINGLE BARREL CBC		"A"	511-60-1/2 511-60-2/2
SINGLE BARREL CBC		"B" "C" "D" "E"	511-61-1/2 511-61-2/2
DOUBLE BARREL CBC		"A"	511-62-1/2 511-62-2/2
DOUBLE BARREL CBC		"B" "C" "D" "E"	511-63-1/2 511-63-2/2
TRIPLE AND QUADRUPLE BARREL CBC		"A"	511-64-1/3 511-64-2/3 511-64-3/3
TRIPLE AND QUADRUPLE BARREL CBC		"B" "C" "D" "E"	511-65-1/3 511-65-2/3 511-65-3/3
CBC HEADWALL/CUTOFF WALL & MISC. DETAILS		"A" "B" "C" "D" "E"	511-66-1/6 511-66-2/6 511-66-3/6 511-66-4/6 511-66-5/6 511-66-6/6
WINGWALL & APRON		"A" "B" "C" "D" "E"	511-67-1/2 511-67-2/2

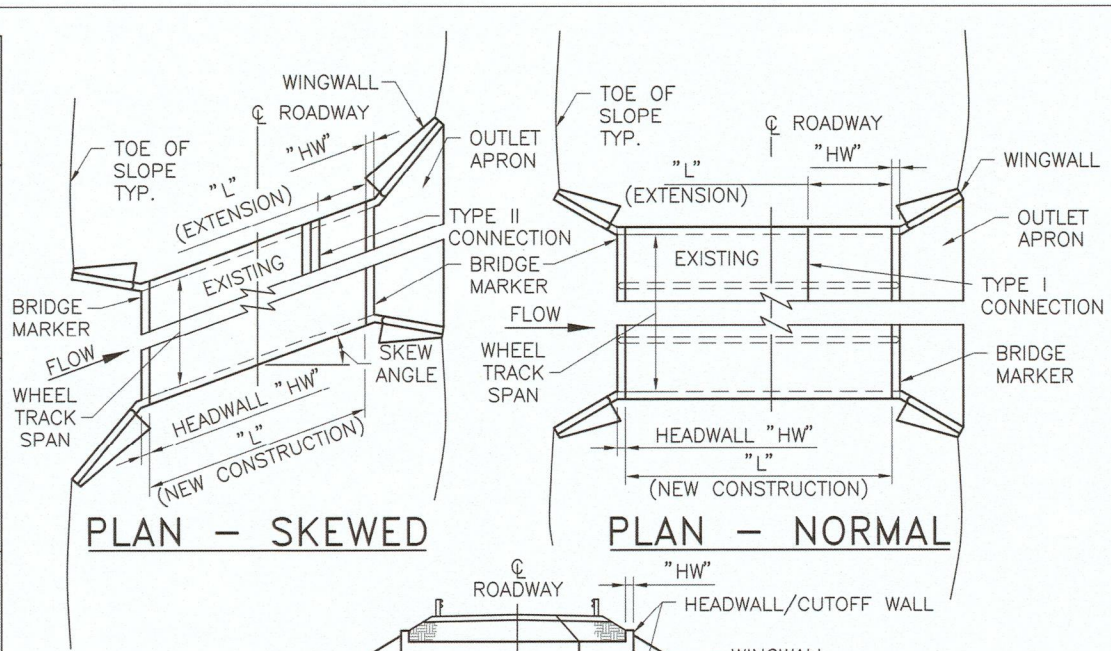

NOTE: IF THE WHEEL TRACK SPAN DIMENSION (PARALLEL TO ϕ OF ROADWAY AS SHOWN ABOVE) IS GREATER THAN 20' THE CBC IS CONSIDERED A BRIDGE AND A MAJOR STRUCTURE. FOR CBC EXTENSIONS RE-MARK BRIDGE NUMBER. NEW CBC SHALL BE MARKED AS PER DETAIL ON THIS SHEET. BRIDGE NUMBER SHALL BE OBTAINED BY REQUEST AT THE NMDOT BRIDGE MANAGEMENT SECTION. MARK SHALL BE PLACED AT UPPER LEFT SIDE OF VERTICAL FACE OF HEADWALL, BOTH INLET AND OULET.

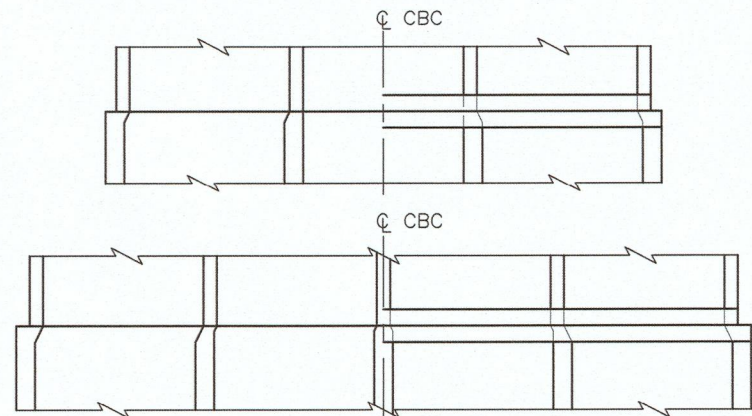

METHOD OF EXTENDING UNEQUAL BOX DIMENSIONS
FOR DETAILS SEE SHEET 511-66-4/6

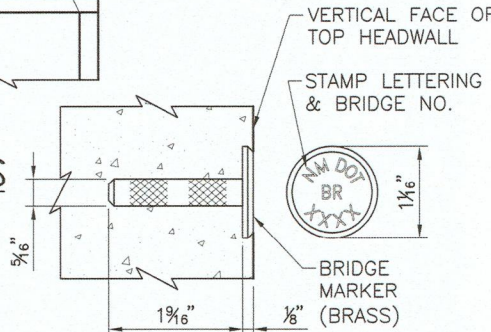

BRIDGE MARK DETAIL

PAYMENT


PAYMENT FOR CBC'S IS BASED ON "LIN. FT." UNIT OF MEASUREMENT FOR THE TOTAL LENGTH OF ALL NEW BARRELS CONSTRUCTED AT THE CENTERLINE OF BARREL. LENGTH OF BARREL SHALL NOT INCLUDE "HW" WHICH SHALL BE PAID FOR SEPARATELY.

PAYMENT FOR HEADWALL/CUTOFF WALL IS BASED ON "EACH" UNIT OF MEASUREMENT FOR EACH NEW BARREL CONSTRUCTED. IN CASE OF TYPE II CONNECTION EACH HEAD/CUTOFF WALL UNIT SHALL BE PAID FOR, I.E. TWO PER BARREL PER CULVERT EXTENSION.

PAYMENT FOR WINGWALL IS BASED ON "SQ. FT." UNIT OF MEASUREMENT BASED ON SOIL SIDE VERTICAL FACE AREA FOR EACH INDIVIDUAL HEIGHT OF INTERIOR BARREL DIMENSION. PAYMENT FOR OUTLET APRON IS BASED ON "SQ. FT." UNIT OF MEASUREMENT BASED ON PLAN AREA OF APRON.


ALTERNATIVELY, A COMPLETE CONCRETE BOX CULVERT MAY BE PAID FOR UNDER CLASS "AA" CONCRETE BY "CU. YD." ITEM 511030 AND GRADE 60 REBAR BY "LBS." ITEM 540060.

REBAR, CONCRETE, FORMING, DEMOLITION, AND ALL OTHER WORK AND MATERIAL REQUIRED FOR A COMPLETE CBC, HEADWALL/CUTOFF WALL, WINGWALL, AND APRON CONSTRUCTION SHALL BE INCLUDED IN THE UNIT COST FOR EACH AND NO FURTHER PAYMENT SHALL BE MADE FOR THESE INCIDENTAL ITEMS.

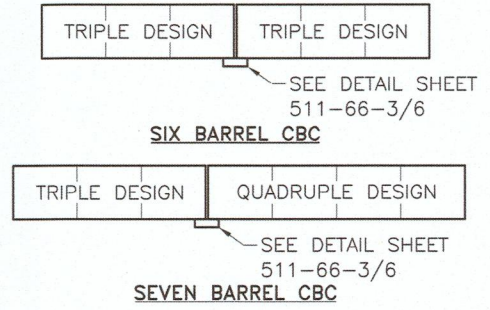

EXAMPLE CONFIGURATIONS OF CBC W/MORE THAN 4 BARRELS

NOTE: USE SAME BARREL CONFIGURATION IF POSSIBLE

NO.				DATE	REV. BY	DESCRIPTION
REVISIONS (OR CHANGE NOTICES)						
NEW MEXICO DEPARTMENT OF TRANSPORTATION STANDARD DRAWING						
CONCRETE BOX CULVERT INDEX OF SHEETS EXPLANATION OF USE OF DRAWINGS						
APPROVED  DATE APR 9, 07						
DESIGNED BY TLB DRAWN BY SGL CHECKED BY HDR						
511-59-1/2 1 OF 2						

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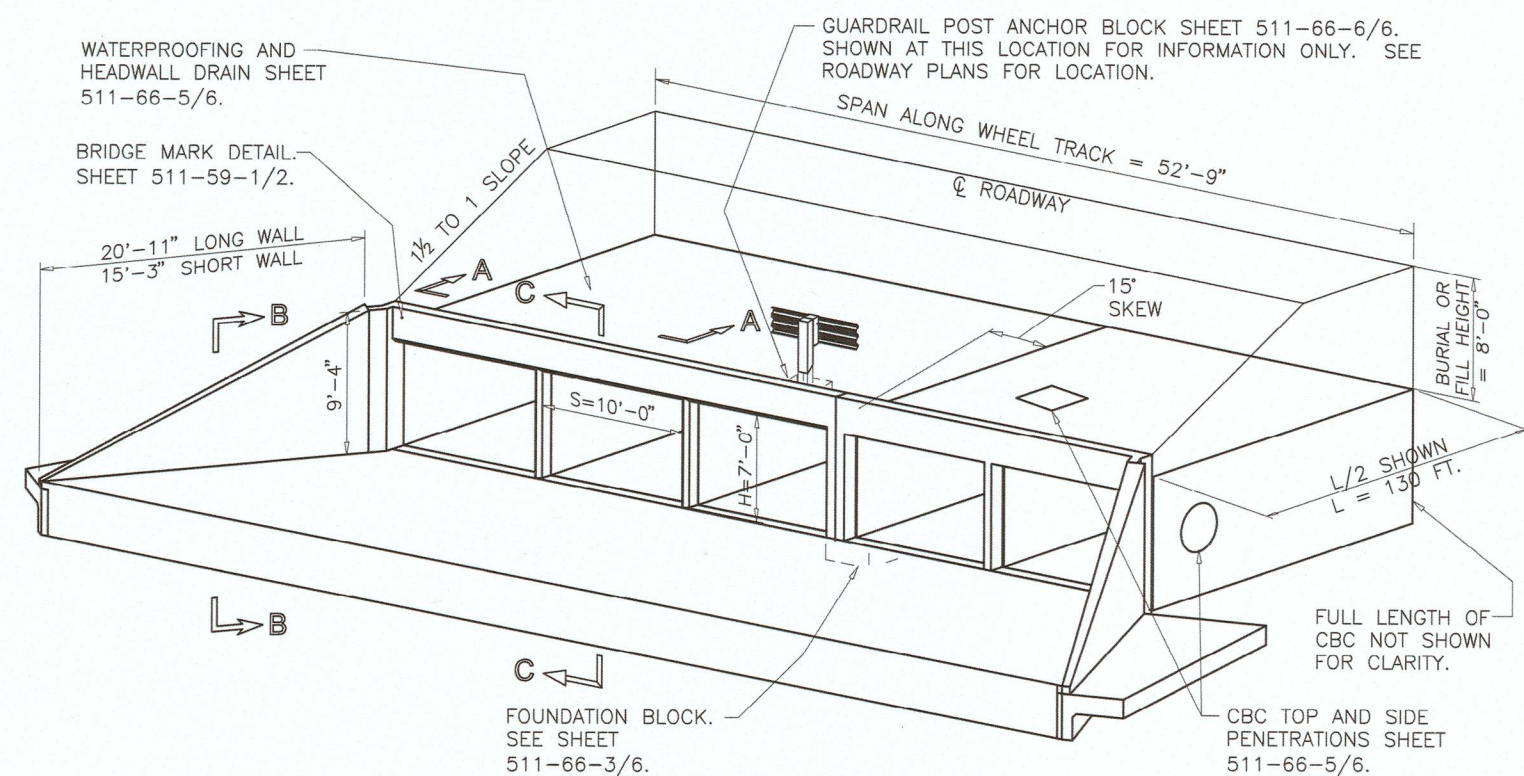
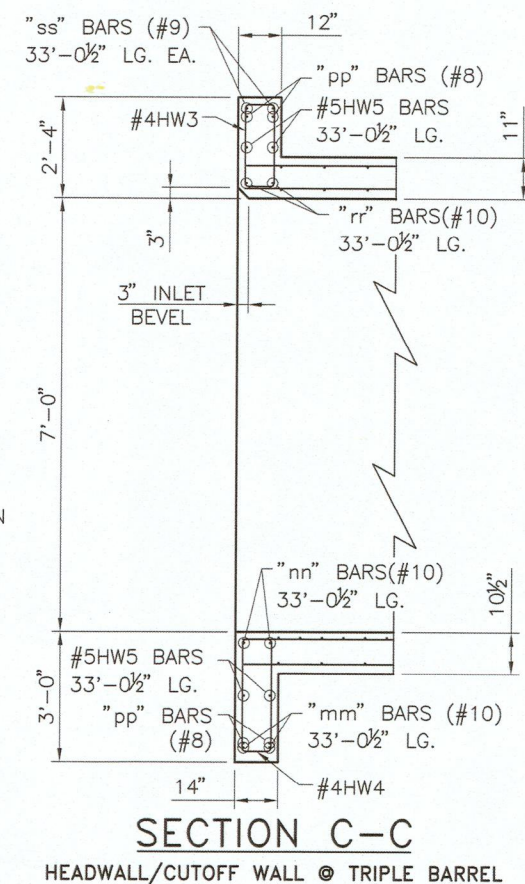
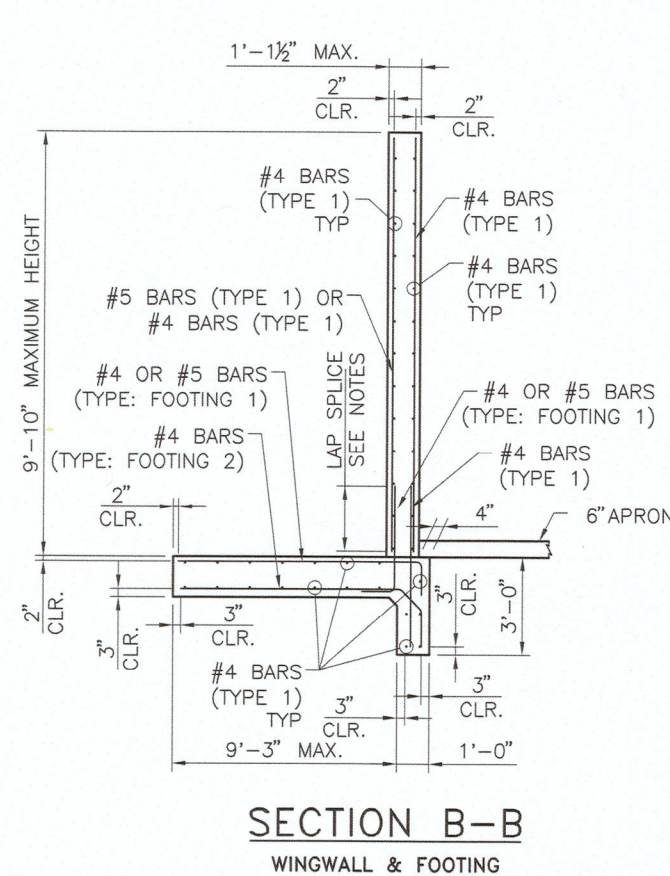
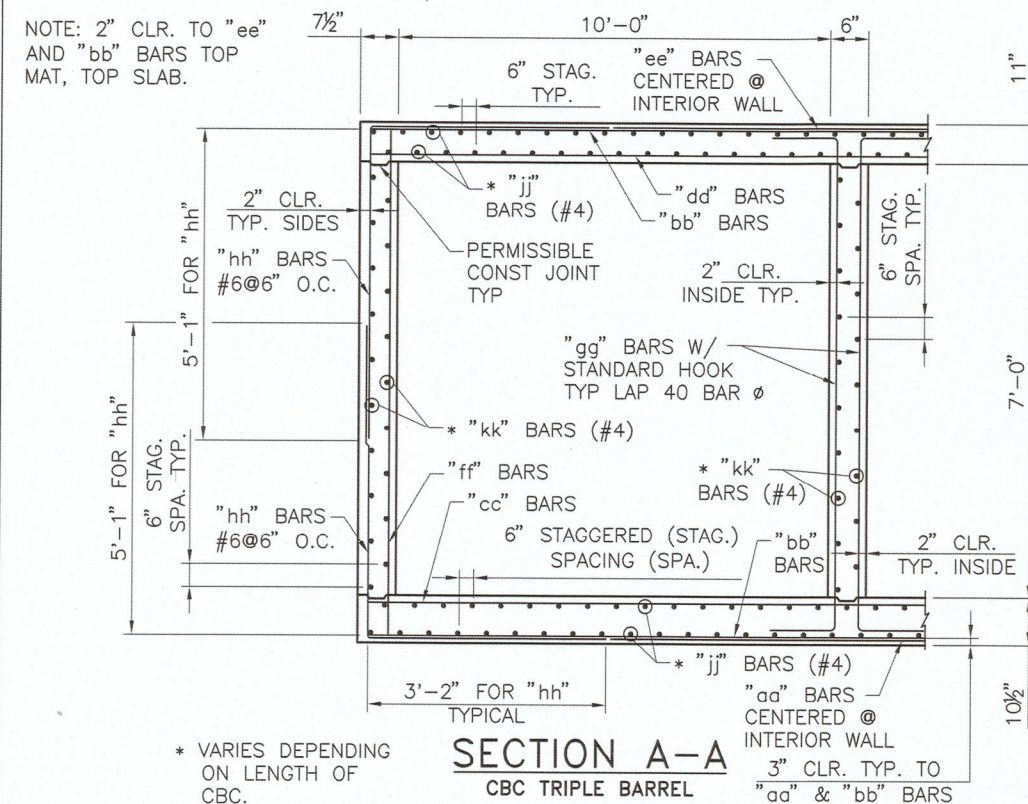
60% SUBMITTAL NOT FOR CONSTRUCTION

SEAL

PROJECT NAME
BARR SPUR IMPROVEMENTS

BY	DESCRIPTION	DATE	REV.

PROJECT NO: 1660060700
DESIGNED BY: TJA
DRAWN BY: JEM
CHECKED BY: TJA
DATE: JAN 2022
SHEET TITLE
NMDOT STD DWG
SHEET NO:
C-511




- ## NOTES

1. THE PURPOSE OF THIS DRAWING IS TO PROVIDE AN EXAMPLE OF USE OF THESE SERIAL CBC DRAWINGS. THIS EXAMPLE IS BASED ON A 5 BARREL, 10'S X 7'H, 15° SKEW, W/ 8' BURIAL DEPTH TO FINISHED @ ROADWAY. THIS 8' BURIAL REQUIRES THE DESIGN FILL "A" 0'-10' CATEGORY. INFORMATION PRESENTED ON THIS SHEET IS FROM DRAWINGS 511-62-1/2 & 2/2, 511-64-1/3 & 2/3, 511-66-1/6 THRU 6/6, AND 511-67-1/2 THRU 2/2. PLEASE REFER TO THESE SHEETS TO FOLLOW THE EXAMPLE.
2. PAYMENT FOR THE CBC BARREL CONSTRUCTION IS BY THE LINEAL FOOT OF BARREL. PAYMENT FOR THE FIVE BARREL IS 5*L, UNDER PAY ITEM 511668, CBC DESIGN "A" 10X7, "L" BEING 130FT, FOR A TOTAL LINEAL FOOT PAYMENT UNDER THIS ITEM OF 650 FT. PAYMENT FOR THE WINGWALLS CONSTRUCTION IS BY THE SQUARE FOOT OF SOIL SIDE VERTICAL FACE. UNDER PAY ITEM 511868, CBC WINGWALL BARREL HEIGHT 7FT, QUANTITY EQUALS $[(20'-11'') \times (9'-10'') + (15'-3'') \times (9'-10'')]/2$, TOTALING 178 SQ. FT. FOR THE OUTLET WINGS. PAYMENT FOR THE HEADWALL/CUTOFF WALL CONSTRUCTION IS UNDER ITEM 511845, CBC HEADWALL/CUTOFF WALL 15 DEG SKEW 10X3 THRU 10X7, UNIT OF EACH PER BARREL, TOTALING 5 EACH FOR THE OUTLET SIDE. OUTLET APRON IS MEASURED BY THE PLAN SQ. FT. UNDER ITEM 511876, CBC OUTLET APRON.
3. NO REBAR DIMENSIONS ARE SHOWN ON SECTION B-B. IT IS THE CONTRACTOR'S RESPONSIBILITY TO DETAIL THE LENGTH OF BARS DUE TO THE CONSTANT CHANGE IN LENGTH DUE TO SLOPE AND FOOTING DIMENSION CHANGE.

REBAR DETAILS						
BAR	2 BARREL			3 BARREL		
	LENGTH	SIZE	SPA.	LENGTH	SIZE	SPA.
"aa" BARS	10'-9"	#8	12"	10'-9"	#8	12"
"bb" BARS	21'-5"	#8	12"	31'-11"	#8	12"
"cc" BARS	21'-5"	#6	6"	31'-11"	#6	6"
"dd" BARS	21'-5"	#6	6"	31'-11"	#6	6"
"ee" BARS	10'-9"	#7	12"	10'-9"	#7	12"
"ff" BARS	8'-4"	#6	6"	8'-4"	#6	6"
"gg" BARS	**	#4	12"	**	#4	12"

** SEE NOTES ON SHEETS 511-62-2/2 & 511-64-2/3

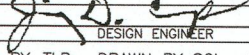NO.	DATE	REV. BY	DESCRIPTION
REVISIONS (OR CHANGE NOTICES)			
<p style="text-align: center;">NEW MEXICO DEPARTMENT OF TRANSPORTATION STANDARD DRAWING</p> <p style="text-align: center;">CONCRETE BOX CULVERT EXAMPLE OF USE OF DRAWINGS</p>			
APPROVED	 DESIGN ENGINEER		APR 9, 07 DATE
DESIGNED BY TLB DRAWN BY SGL CHECKED BY HDR			
511-59-2/2			
2 OF 2			

Sheet 511-81

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BARR SPUR IMPROVEMENTS

PROJECT NAME

7

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PROJECT NO:	1660060700
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DESIGNED BY: TIA

DRAWN BY: IEM

CHECKED BY:	TJA
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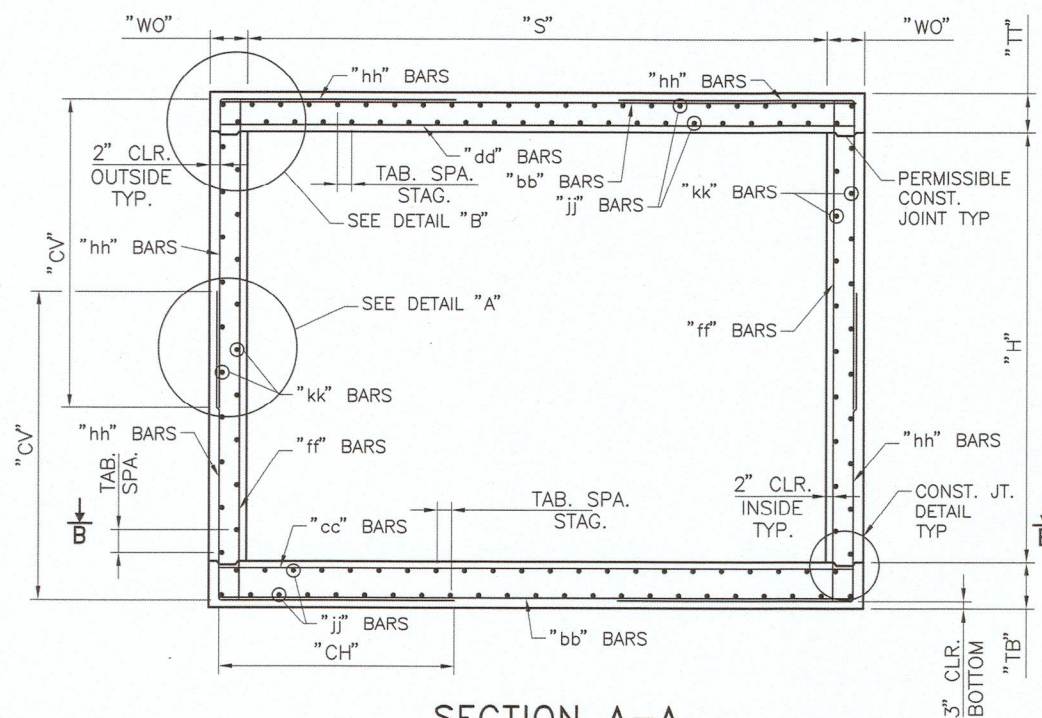
DATE: JAN 2023

SHEET	OF TOTAL
SHEET TITLE	


NMDOT STD DWG

SHEET NO:


C-512




SECTION A-A

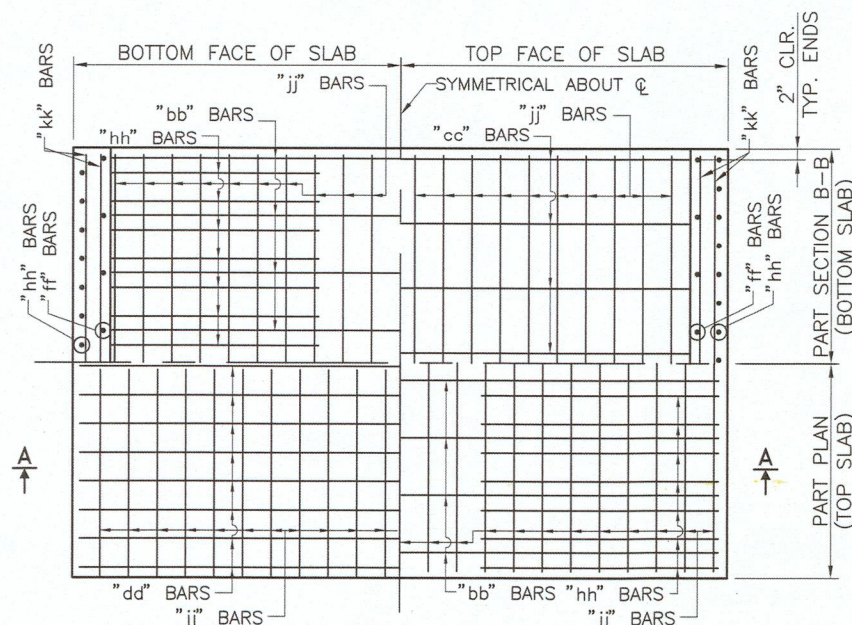


REBAR LAYOUT – PLAN VIEW

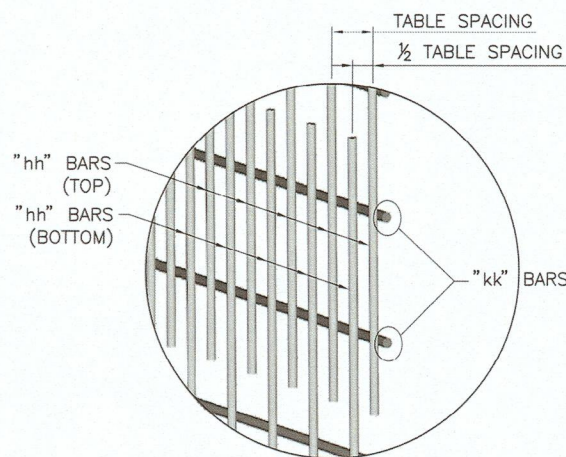

DETAIL "A"
(INSIDE FACE OMITTED FOR CLARITY)

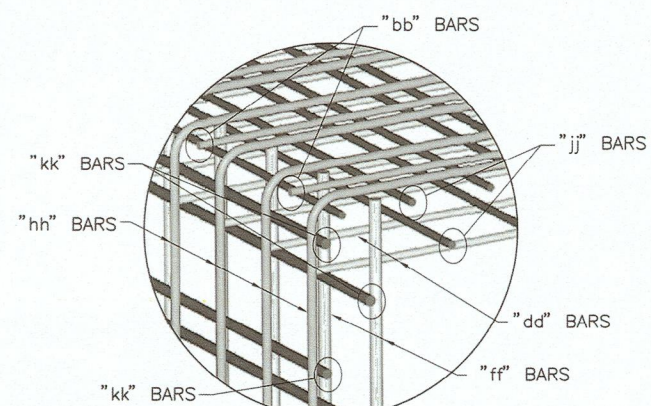

DETAIL "B"
(SIMILAR BOTTOM CORNERS)

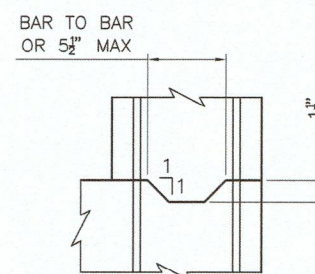

CONSTRUCTION JOINT DETAIL

GENERAL NOTES

1. ALL MATERIALS AND WORKMANSHIP SHALL CONFORM TO THE NEW MEXICO DEPARTMENT OF TRANSPORTATION SPECIFICATIONS FOR HIGHWAY AND BRIDGE CONSTRUCTION (CURRENT EDITION) WITH APPLICABLE SPECIAL PROVISIONS.
2. ALL CONCRETE SHALL BE CLASS "AA" (4000 psi). CHAMFER ALL EXPOSED EDGES $\frac{3}{4}$ ".
3. ALL REINFORCING STEEL TO BE DEFORMED BARS, CONFORMING TO AASHTO M-31, GRADE 60. ALL DIMENSIONS REFER TO THE CENTERLINE OF BAR.
4. "COVER" IS HEIGHT OF FILL FROM TOP OF BOX TO THE TOP OF PAVEMENT. ORIGINAL HEIGHT OF COVER MAY NOT BE EXCEEDED IN THE FUTURE OR WILL REQUIRE REMOVAL AND REPLACEMENT WITH PROPER DESIGN FILL CBC. IN CASE OF COVER EQUAL TO 10', 15', 20', OR 25' USE HIGHER DESIGN FILL IN CASE OF FUTURE AC OVERLAY.
5. "jj" AND "kk" BARS MAY BE SPLICED WHEN NECESSARY BY LAPPING AT LEAST 40 BAR DIAMETERS. NO OTHER SPLICING OF BARS WILL BE PERMITTED. LENGTH OF THESE BARS SHALL EQUAL THE LENGTH OF BARREL "L" PLUS (2 x "HW") MINUS 4" FOR TOTAL NEW CONSTRUCTION, NOT INCLUDING LAP LENGTH. FOR CULVERT EXTENSION, LENGTH OF THESE BARS SHALL BE "L" PLUS "HW" MINUS 2".
6. REINFORCING SHOWN IS FOR PLACEMENT LOCATION ONLY. USE APPROPRIATE SHEETS AND CORRESPONDING TABLES TO DETERMINE THE REINFORCING REQUIREMENTS AND SPACINGS.
7. ALL CONSTRUCTION JOINTS SHALL BE AS PER DETAIL THIS SHEET. CONSTRUCTION JOINTS ARE PERMISSIBLE AND SHALL BE LOCATED AT WALL/SLAB HORIZONTAL INTERFACE.
8. DO NOT BACKFILL WALLS UNTIL TOP SLAB HAS REACHED 4000 psi DESIGN STRENGTH.
9. CBC'S SHALL BE CONSTRUCTED TO THE SPAN, HEIGHT, NUMBER OF BARRELS, SKEW, ALIGNMENT, AND FLOWLINE GRADE AS SPECIFIED ON THE PLAN AND PROFILE AND STRUCTURE PLACEMENT SECTIONS.
10. EXCAVATION AND BACKFILL OF CBC'S SHALL BE IN ACCORDANCE WITH STANDARD DRAWING 210-01-1/1.

DESIGN

DESIGNED IN ACCORDANCE WITH AASHTO LRFD BRIDGE DESIGN SPECIFICATIONS, THIRD EDITION.

PAYMENT

PAYMENT FOR CBC'S IS BASED ON "LIN. FT." UNIT OF MEASUREMENT FOR THE TOTAL LENGTH OF ALL NEW BARRELS CONSTRUCTED AT THE CENTERLINE OF BARREL. I.E. SINGLE BARREL SHALL BE 1 X "L" AND TRIPLE BARREL SHALL BE 3 X "L" FOR PAYMENT. LENGTH OF BARREL SHALL NOT INCLUDE "HW" WHICH SHALL BE PAID FOR SEPARATELY. CONCRETE, REBAR, FORMING, AND OTHER WORK AND MATERIAL SHALL BE INCLUDED IN THE LIN. FT. COST FOR THE CBC AND NO FURTHER PAYMENT SHALL BE MADE FOR THESE INCIDENTAL ITEMS.

ALTERNATIVELY, A COMPLETE CONCRETE BOX CULVERT MAY BE PAID FOR UNDER CLASS "AA" CONCRETE BY "CU. YD." ITEM 511030 AND GRADE 60 REBAR BY "LBS." ITEM 540060.

NO.	DATE	REV. BY	DESCRIPTION
REVISIONS (OR CHANGE NOTICES)			

NEW MEXICO
DEPARTMENT OF TRANSPORTATION
STANDARD DRAWING

CONCRETE BOX CULVERT SINGLE
OPENING - DESIGN FILL "A" 0-10 FT.
STRUCTURAL SECTIONS AND REBAR

APPROVED		APR 9 1987
	DESIGN ENGINEER	DATE

DESIGNED BY <u>TLB</u>	DRAWN BY <u>SGL</u>	CHECKED BY <u>HDR</u>
------------------------	---------------------	-----------------------

511-60-1/2
1 OF 1

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& COMPANY**

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FAX: 505-348-4072
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BARR SPUR IMPROVEMENTS

PROJECT NAME

[illegible]

PROJECT NO:	1660060700
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DESIGNED BY:	T.JA
--------------	------

DESIGNED BY:	1971
DRAWN BY:	JEM

DRAWN BY:	SEM
CHECKED BY:	TJA

CHECKED BY:	ISA
DATE:	JAN 2022

DATE:	JAN 2022
SHEET TITLE	

NMDOT STD DWG

SHEET NO:

C-513

THIS PROJECT →

THIS PROJECT →

SINGLE OPENING BOX CULVERT STRUCTURE DIMENSIONS					GRADE 60 REINFORCING BAR SCHEDULE (BAR SIZE, SPACING AND LENGTH DIMENSIONS)																	
DIM		0-10 FT BURIAL DESIGN FILL "A"			"bb"		"cc"		"dd"		"bb" & "dd"		"ff"		"hh"				"jj"		"kk"	
SPAN "S" INSIDE	HEIGHT "H" INSIDE	TOP SLAB "TT"	BOTTOM SLAB "TB"	WALLS OUTER "WO"	SIZE	SPACING	SIZE	SPACING	SIZE	SPACING	LENGTH	SIZE	SPACING	LENGTH	SIZE	SPACING	"CH" LENGTH	"CV" LENGTH	SIZE	STAGGERED SPACING	SIZE	STAGGERED SPACING
4'	2'	7.5"	8.5"	7.5"	#4	12"	#4	6"	#4	6"	4'-11"	#4	12"	2'-11"	#4	6"	25"	25"	#4	6"	#4	6"
4'	3'	7.5"	8.5"	7.5"	#4	12"	#4	6"	#4	6"	4'-11"	#4	12"	3'-11"	#4	6"	25"	31"	#4	6"	#4	6"
4'	4'	7.5"	8.5"	7.5"	#4	12"	#4	6"	#4	6"	4'-11"	#4	12"	4'-11"	#4	6"	25"	37"	#4	6"	#4	6"
6'	2'	7.5"	8.5"	7.5"	#5	12"	#5	6"	#6	6"	6'-11"	#4	12"	2'-11"	#5	6"	30"	26"	#4	6"	#4	6"
6'	3'	7.5"	8.5"	7.5"	#5	12"	#5	6"	#6	6"	6'-11"	#4	12"	3'-11"	#5	6"	30"	32"	#4	6"	#4	6"
6'	4'	7.5"	8.5"	7.5"	#5	12"	#5	6"	#6	6"	6'-11"	#4	12"	4'-11"	#5	6"	30"	38"	#4	6"	#4	6"
6'	5'	7.5"	8.5"	7.5"	#5	12"	#5	6"	#6	6"	6'-11"	#4	12"	5'-11"	#5	6"	30"	44"	#4	6"	#4	6"
6'	6'	7.5"	8.5"	7.5"	#5	12"	#5	6"	#6	6"	6'-11"	#4	12"	6'-11"	#5	6"	30"	50"	#4	6"	#4	6"
6'	7'	7.5"	8.5"	7.5"	#5	12"	#5	6"	#6	6"	6'-11"	#4	12"	7'-11"	#5	6"	30"	56"	#4	6"	#4	6"
8'	4'	9.0"	9.5"	7.5"	#6	12"	#6	6"	#7	6"	8'-11"	#4	12"	5'-1"	#6	6"	36"	41"	#4	6"	#4	6"
8'	5'	9.0"	9.5"	7.5"	#6	12"	#6	6"	#7	6"	8'-11"	#4	12"	6'-1"	#6	6"	36"	47"	#4	6"	#4	6"
8'	6'	9.0"	9.5"	7.5"	#6	12"	#6	6"	#7	6"	8'-11"	#4	12"	7'-1"	#6	6"	36"	53"	#4	6"	#4	6"
8'	7'	9.0"	9.5"	7.5"	#6	12"	#6	6"	#7	6"	8'-11"	#4	12"	8'-1"	#6	6"	36"	59"	#4	6"	#4	6"
8'	8'	9.0"	9.5"	7.5"	#6	12"	#6	6"	#7	6"	8'-11"	#4	12"	9'-1"	#6	6"	36"	65"	#4	6"	#4	6"
10'	3'	9.0"	9.5"	7.5"	#7	12"	#8	6"	#8	6"	10'-11"	#4	12"	4'-1"	#7	6"	43"	38"	#4	6"	#4	6"
10'	4'	9.0"	9.5"	7.5"	#7	12"	#8	6"	#8	6"	10'-11"	#4	12"	5'-1"	#7	6"	43"	44"	#4	6"	#4	6"
10'	5'	9.0"	9.5"	7.5"	#7	12"	#8	6"	#8	6"	10'-11"	#4	12"	6'-1"	#7	6"	43"	50"	#4	6"	#4	6"
10'	6'	9.0"	9.5"	7.5"	#7	12"	#8	6"	#8	6"	10'-11"	#4	12"	7'-1"	#7	6"	43"	56"	#4	6"	#4	6"
10'	7'	9.0"	9.5"	7.5"	#7	12"	#8	6"	#8	6"	10'-11"	#4	12"	8'-1"	#7	6"	43"	62"	#4	6"	#4	6"
10'	8'	9.5"	10.0"	9.0"	#8	12"	#8	6"	#8	6"	11'-2"	#5	6"	9'-2"	#8	6"	53"	72"	#4	6"	#4	6"
10'	9'	9.5"	10.0"	9.0"	#8	12"	#8	6"	#8	6"	11'-2"	#5	6"	10'-2"	#8	6"	53"	78"	#4	6"	#4	6"
10'	10'	9.5"	10.0"	9.0"	#8	12"	#8	6"	#8	6"	11'-2"	#5	6"	11'-2"	#8	6"	53"	84"	#4	6"	#4	6"
10'	11'	9.5"	10.0"	9.0"	#8	12"	#8	6"	#8	6"	11'-2"	#5	6"	12'-2"	#8	6"	53"	90"	#4	6"	#4	6"
10'	12'	9.5"	10.0"	9.0"	#8	12"	#8	6"	#8	6"	11'-2"	#5	6"	13'-2"	#8	6"	53"	96"	#4	6"	#4	6"
12'	6'	10.0"	11.0"	9.5"	#8	12"	#9	6"	#9	6"	13'-3'	#4	6"	7'-4"	#8	6"	56"	61"	#4	6"	#4	6"
12'	7'	10.0"	11.0"	9.5"	#8	12"	#9	6"	#9	6"	13'-3'	#4	6"	8'-4"	#8	6"	56"	67"	#4	6"	#4	6"
12'	8'	10.0"	11.0"	9.5"	#8	12"	#9	6"	#9	6"	13'-3'	#4	6"	9'-4"	#8	6"	56"	73"	#4	6"	#4	6"
12'	9'	10.0"	11.0"	9.5"	#8	12"	#9	6"	#9	6"	13'-3'	#4	6"	10'-4"	#8	6"	56"	79"	#4	6"	#4	6"
12'	10'	10.0"	11.0"	9.5"	#8	12"	#9	6"	#9	6"	13'-3'	#4	6"	11'-4"	#8	6"	56"	85"	#4	6"	#4	6"
12'	12'	10.0"	11.0"	9.5"	#8	12"	#9	6"	#9	6"	13'-3'	#4	6"	13'-4"	#8	6"	56"	97"	#4	6"	#4	6"
14'	8'	11.0"	12.0"	10.5"	#9	12"	#9	6"	#9	6"	15'-5"	#5	6"	9'-6"	#9	6"	101"	79"	#4	6"	#4	6"
14'	9'	11.0"	12.0"	10.5"	#9	12"	#9	6"	#9	6"	15'-5"	#5	6"	10'-6"	#9	6"	101"	85"	#4	6"	#4	6"
14'	10'	11.0"	12.0"	10.5"	#9	12"	#9	6"	#9	6"	15'-5"	#5	6"	11'-6"	#9	6"	101"	91"	#4	6"	#4	6"
14'	11'	11.0"	12.0"	10.5"	#9	12"	#9	6"	#9	6"	15'-5"	#5	6"	12'-6"	#9	6"	101"	97"	#4	6"	#4	6"
14'	12'	11.0"	12.0"	10.5"	#9	12"	#9	6"	#9	6"	15'-5"	#5	6"	13'-6"	#9	6"	101"	103"	#4	6"	#4	6"
14'	13'	11.0"	12.0"	10.5"	#9	12"	#9	6"	#9	6"	15'-5"	#5	6"	14'-6"	#9	6"	101"	109"	#4	6"	#4	6"
14'	14'	11.0"	12.0"	10.5"	#9	12"	#9	6"	#9	6"	15'-5"	#5	6"	15'-6"	#9	6"	101"	115"	#4	6"	#4	6"

* EXAMPLE OF USE OF THIS TABLE:
PROPOSED STRUCTURE - SINGLE BARREL, 10 FT. SPAN/7 FT. HEIGHT, CBC WITH 2 FT. DEPTH OF COVER.
USE THE FOLLOWING BUILD INFORMATION FROM THE TABLE ABOVE:

DIM		0-10 FT BURIAL DESIGN FILL "A"			"bb"		"cc"		"dd"		"bb" & "dd"		"ff"		"hh"			"jj"		"kk"		
SPAN "S" INSIDE	HEIGHT "H" INSIDE	TOP SLAB "TT"	BOTTOM SLAB "TB"	WALLS OUTER "WO"	SIZE	SPACING	SIZE	SPACING	SIZE	SPACING	LENGTH	SIZE	SPACING	LENGTH	SIZE	SPACING	"CH" LENGTH	"CV" LENGTH	SIZE	STAGGERED SPACING	SIZE	STAGGERED SPACING
10'	7'	9.0"	9.5"	7.5"	#7	12"	#8	6"	#8	6"	10'-11"	#4	12"	8'-1"	#7	6"	43"	62"	#4	6"	#4	6"








FOR EXTENSIONS OF EXISTING CBC'S OF S=5', S=7', AND S=9' SIZE SPANS NOT INCLUDED IN THIS TABLE, USE DIMENSIONS FOR NEXT GREATER SPAN TO BUILD. FOR EXAMPLE: FOR S=5' USE DESIGN DIMENSIONS FROM THE TABLE FOR S=6'. ALSO REDUCE THE S=6' TABLE LENGTH OF BARS "bb", "cc" AND "dd" BY ONE FOOT TO ACCOMMODATE THE SHORTER SPAN. SEE DETAILS ON SHEET 511-66-4/6. ANY OTHER SIZES OF BOX EXTENSIONS NOT COVERED BY THIS MODIFICATION SHALL BE DONE THROUGH SPECIAL DESIGNS INCLUDED IN THE PROJECT PLANS.

NO.	DATE	REV. BY	DESCRIPTION
REVISIONS (OR CHANGE NOTICES)			
NEW MEXICO DEPARTMENT OF TRANSPORTATION STANDARD DRAWING			
CONCRETE BOX CULVERT SINGLE OPENING - DESIGN FILL "A" 0-10 FT DIMENSIONS AND REBAR SCHEDULE			
APPROVED	DESIGN ENGINEER		DATE
DESIGNED BY		TLB	DRAWN BY
SGL		CHECKED BY	HDR
511-60-2/2			
2 OF 2			

BY	DESCRIPTION	DATE	REV.

PROJECT NO:	1660060700
DESIGNED BY:	TJA
DRAWN BY:	JEM
CHECKED BY:	TJA
DATE:	JAN 2022
SHEET TITLE	

1/5/2022 M:\MSD\16-600-607-00\2_Disciplines\Sheets - civil\BARR SPUR\166607-DT02.dwg

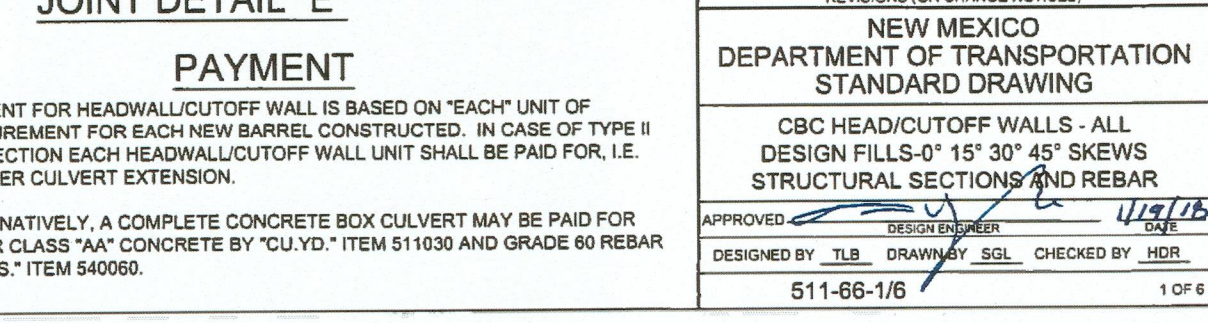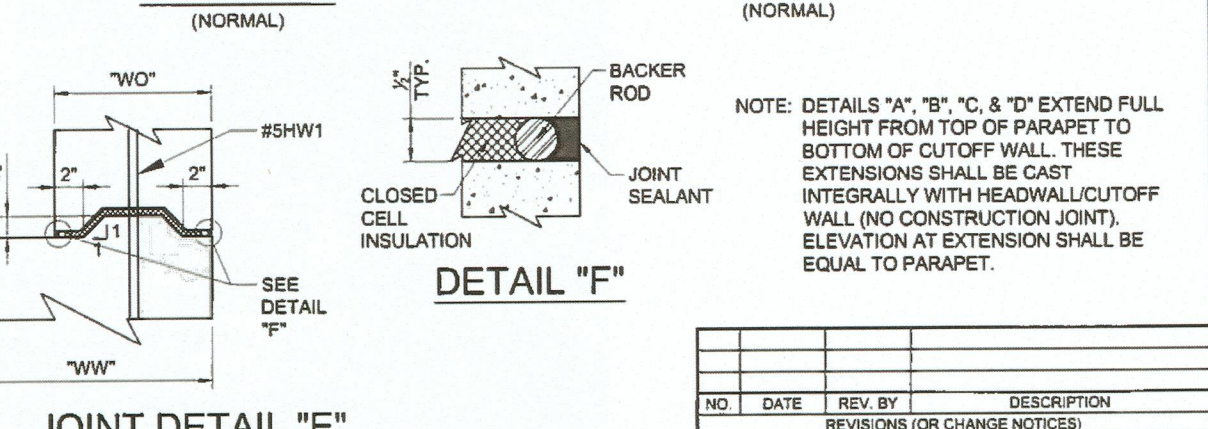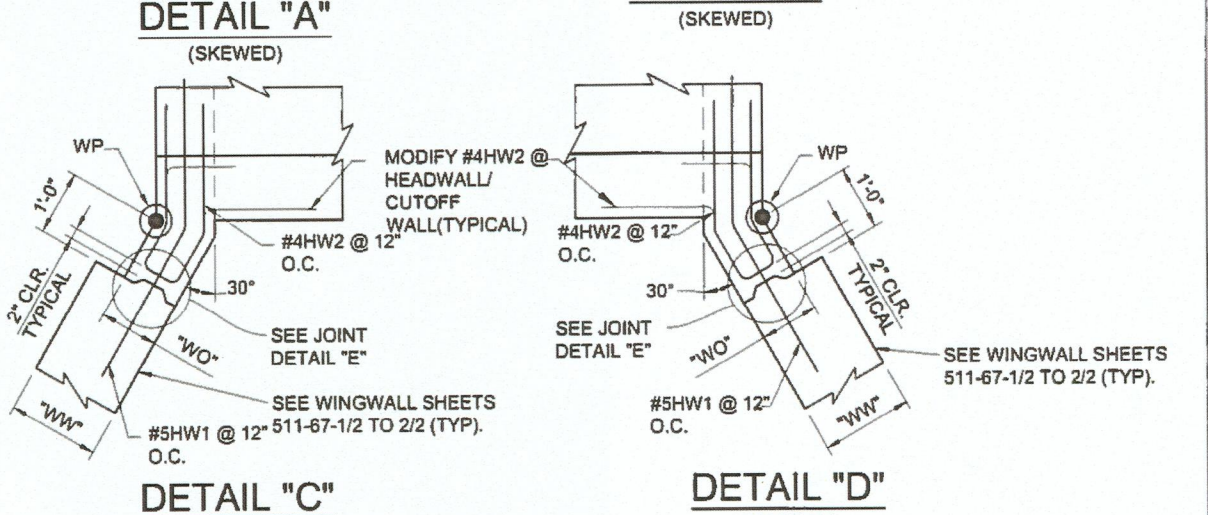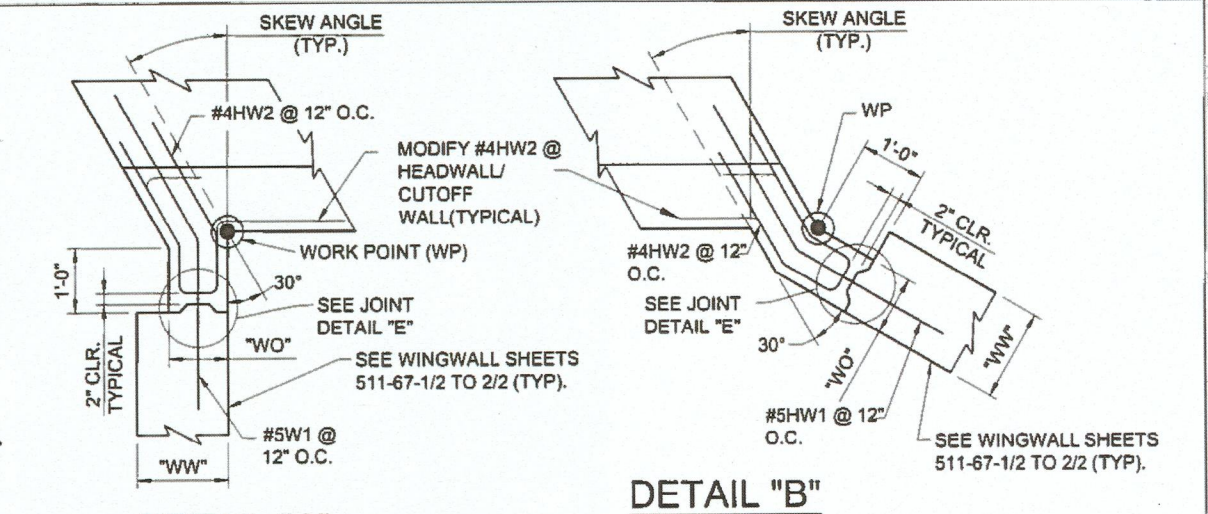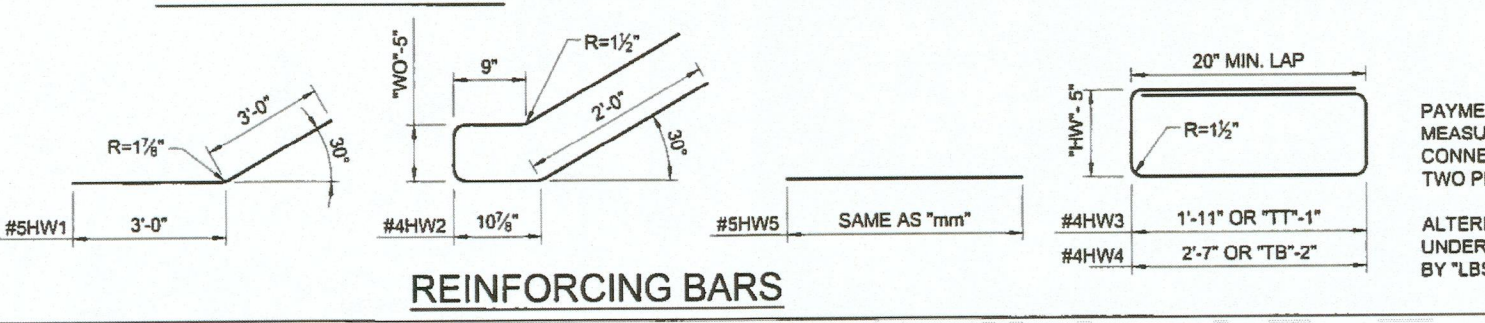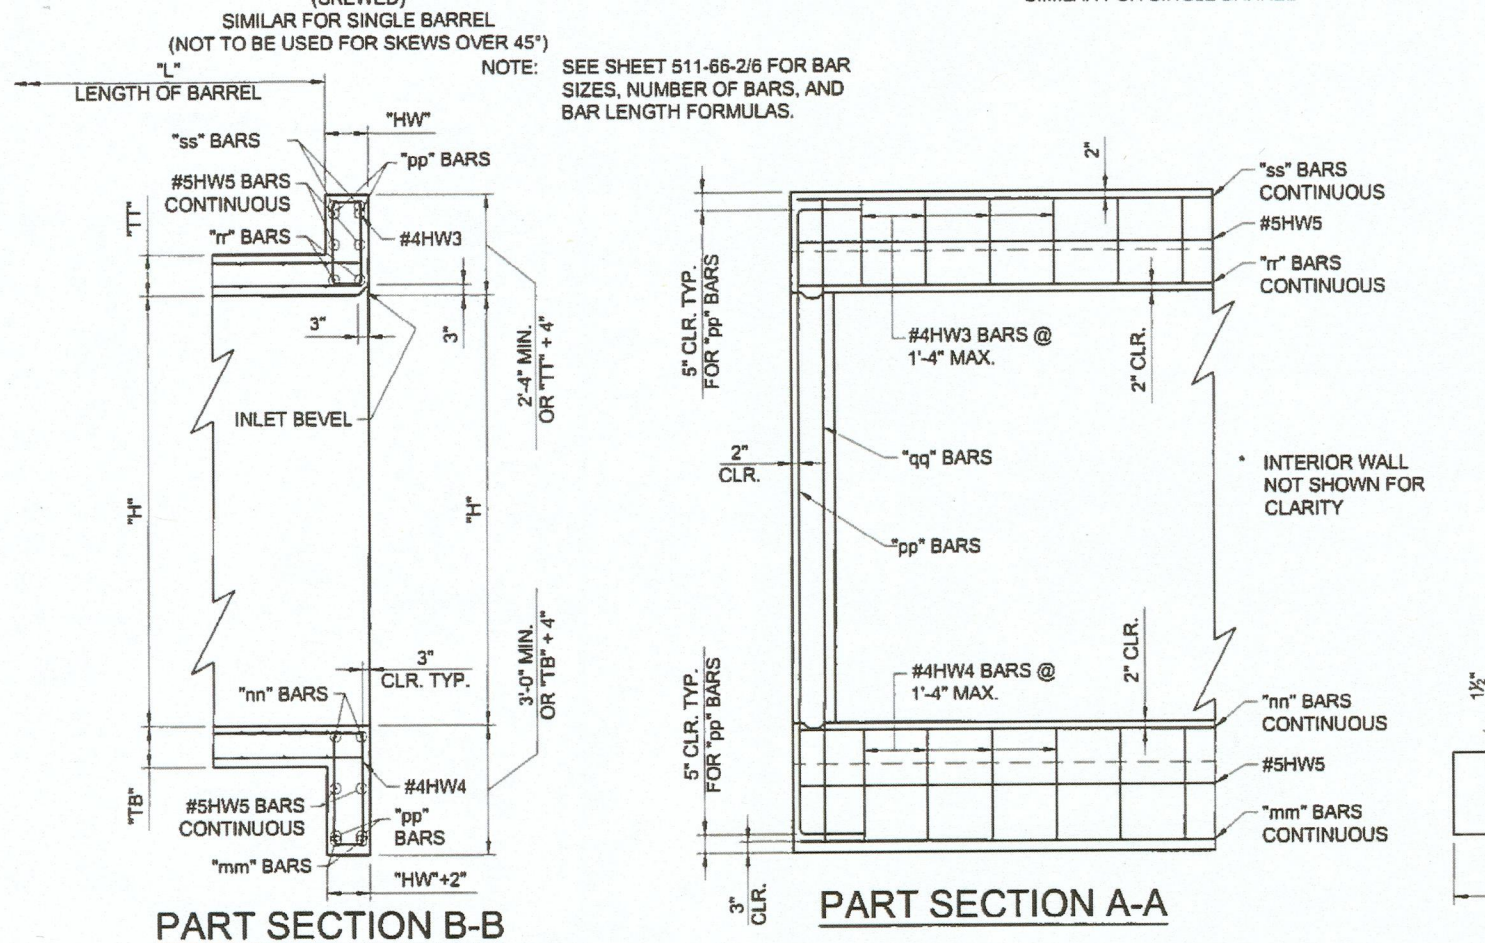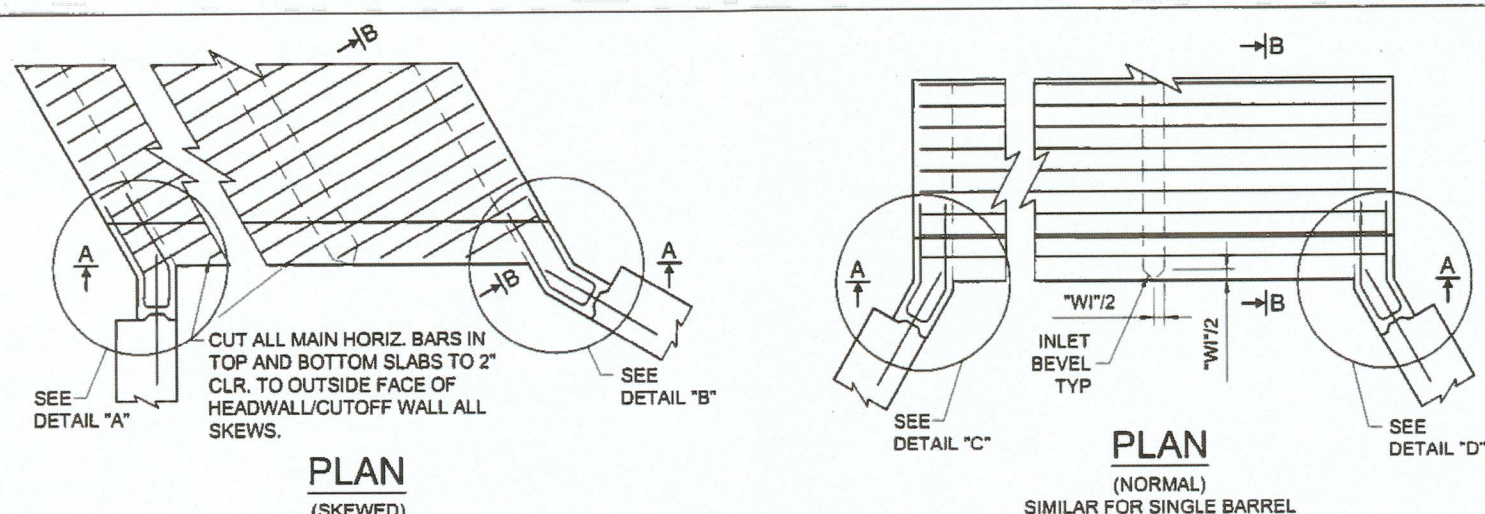

WILSON & COMPANY
4401 WASTHEAD ST. NE, SUITE 150
ALBUQUERQUE, NM 87109
PHONE: 505-348-4000
FAX: 505-348-4072
www.wilsonco.com

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SEAL

PROJECT NAME
**BARR SPUR
IMPROVEMENTS**

NO.	DATE	REV. BY	DESCRIPTION

NO.	DATE	REV. BY	DESCRIPTION

NO.	DATE	REV. BY	DESCRIPTION

NO.	DATE	REV. BY	DESCRIPTION

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NO.	DATE	REV. BY	DESCRIPTION

NO.	DATE	REV. BY	DESCRIPTION

NO.	DATE	REV. BY	DESCRIPTION
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* EXAMPLE OF USE OF THIS TABLE:
PROPOSED STRUCTURE - DOUBLE BARREL, 12 FT. SPAN/10 FT. HEIGHT,
CBC WITH 30° SKEW.
USE THE FOLLOWING BUILD INFORMATION FROM THE TABLE ABOVE:

LENGTH OF BARS: THE LENGTH OF "mm", "nn", "rr", "ss", & #5HW5 SHALL BE DETERMINED BY:

THESE BARS SHALL BE FURNISHED IN FULL LENGTHS CALCULATED OR
BE MECHANICALLY COUPLED BY DEVICES LISTED ON THE NMDOT
APPROVED PRODUCTS LIST.

N = NUMBER OF BARRELS (1, 2, 3, OR 4)

"qq" BAR LENGTH = "H" + 59'

"pp" BAR = ["H" + (5'-4" MIN. OR ("TT" + "TB" + 8") IF LARGER)] - 10" + 2*STANDARD HOOK LENGTH

FOR EXTENSIONS OF EXISTING CBC'S OF S=5', S=7', AND S=9' SIZE SPANS NOT INCLUDED IN THIS TABLE, USE DIMENSIONS, BAR SIZES, AND NUMBER OF BARS FOR NEXT GREATER SPAN TO BUILD. FOR EXAMPLE, FOR S=5' USE DIMENSIONS AND BAR DETAILS FROM THE TABLE FOR S=6'. USE S=5' IN FORMULAS TO DETERMINE LENGTH OF BARS "mm", "nn", "ss", "rr", AND #5HW5. ANY OTHER SIZE OF BOX EXTENSIONS NOT COVERED BY THIS MODIFICATION SHALL BE DONE THROUGH SPECIAL DESIGNS INCLUDED IN THE PROJECT PLANS.

NOTE:
THIS TABLE IS FOR USE WITH ONE TO FOUR BARRELS. FOR FIVE
OR MORE BARRELS USE COMBINATIONS OF ONE TO FOUR
BARRELS REPEATING THIS DESIGN.

511-66-2/6 2 OF 6

Sheet 511-97

BARR SPUR IMPROVEMENTS

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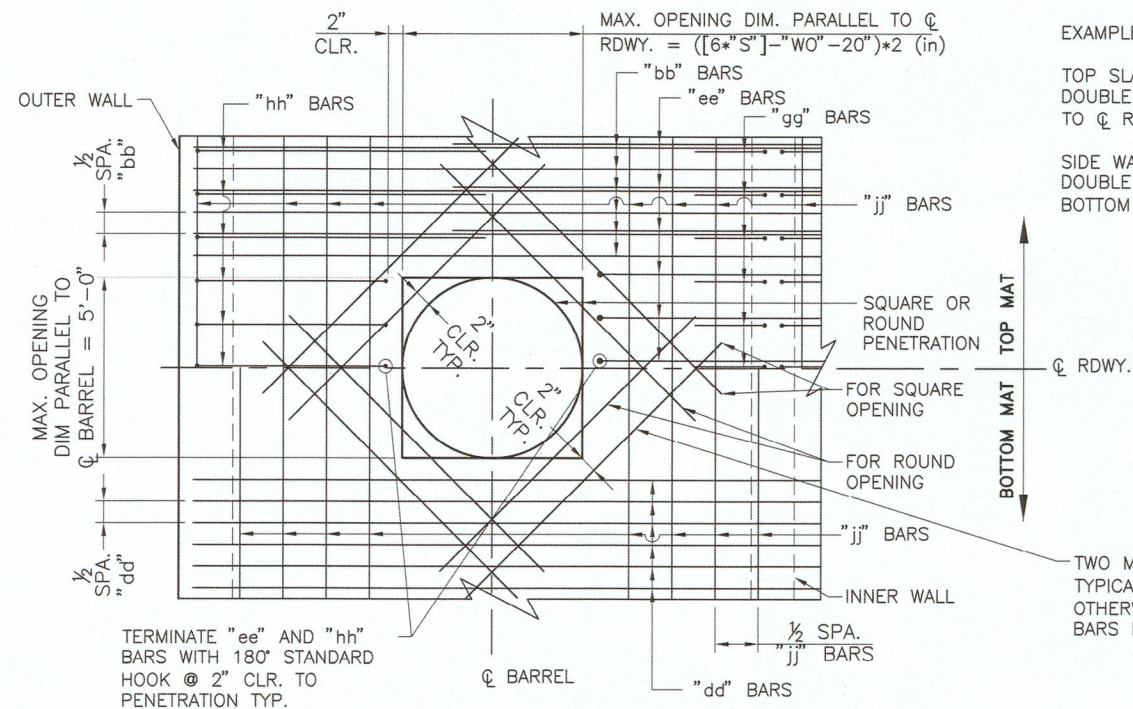
4401 MASTHEAD ST. NE. SUITE 150
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PHONE: 505-348-4000
FAX: 505-348-4072
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SHEET NO:

NMDOT STD DWG

C-516

1/5/2022 M:\MSD\16-600-607-002_Disciplines\Sheets - civil\BARR SPUR\166607-DT02.dwg



TOP SLAB PENETRATION DETAIL

NOTE: MOVE "bb", "dd" AND "jj" BARS FROM LOCATION AT PENETRATION AND PLACE EQUALLY AT 1/2 SPACING ON EACH SIDE OF OPENING.


EXAMPLES:

TOP SLAB - "S"=10' "H"=7', DESIGN FILL "B", DOUBLE BARREL CBC: MAX. OPENING DIM. PARALLEL TO C RDWY. = ([6*10]-9-20)*2 = 62 (in)

SIDE WALL - "S"=10' "H"=7', DESIGN FILL "B", DOUBLE BARREL CBC: MIN DIM. TO INSIDE TOP & BOTTOM OF CBC = [1.2*7]+18 = 26.4 (in)


TWO MATS OF #5 BARS INSIDE OF ALL OTHER TYPICAL REINFORCING FOR "TT" GREATER THAN 9". OTHERWISE ONE MAT OF #5 BARS. LENGTH OF BARS EQUAL TO TWICE DIM. OF OPENING.

TERMINATE "hh" BARS WITH 180° STANDARD HOOK @ 2" CLR. TO PENETRATION TYP.

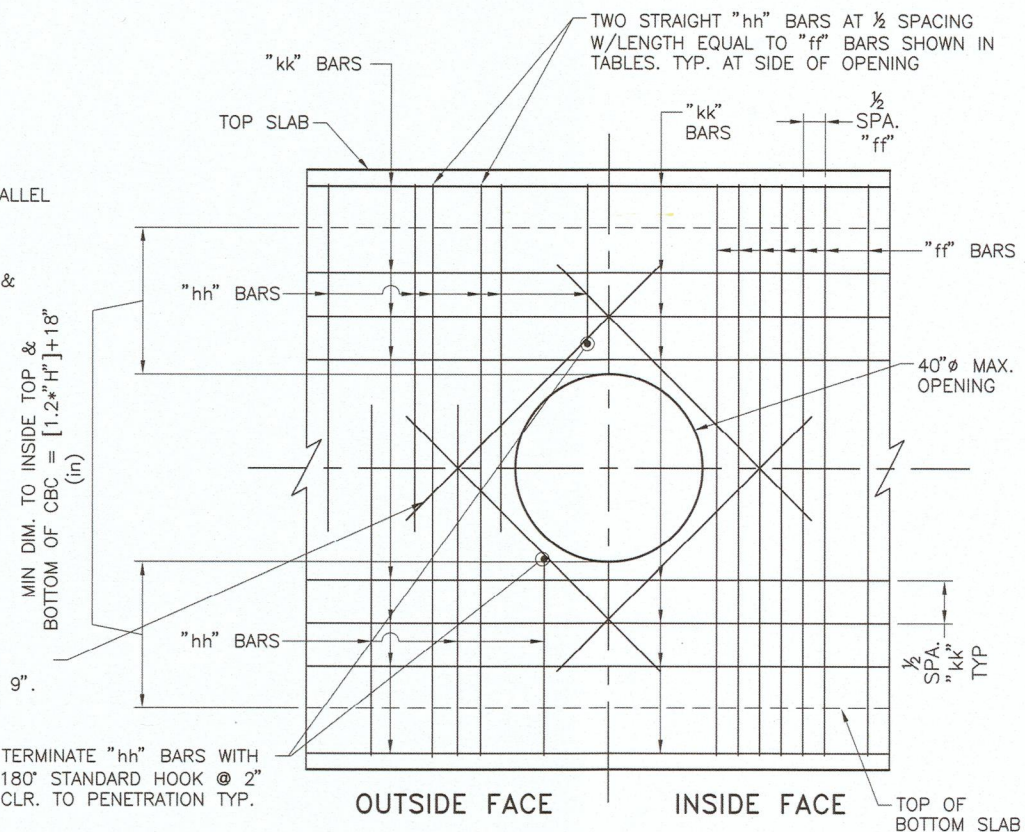


OUTER WALL PENETRATION DETAIL

NOTE: MOVE "ff" AND "kk" BARS FROM LOCATION AT PENETRATION AND PLACE EQUALLY AT 1/2 SPACING ON EACH SIDE OF OPENING.

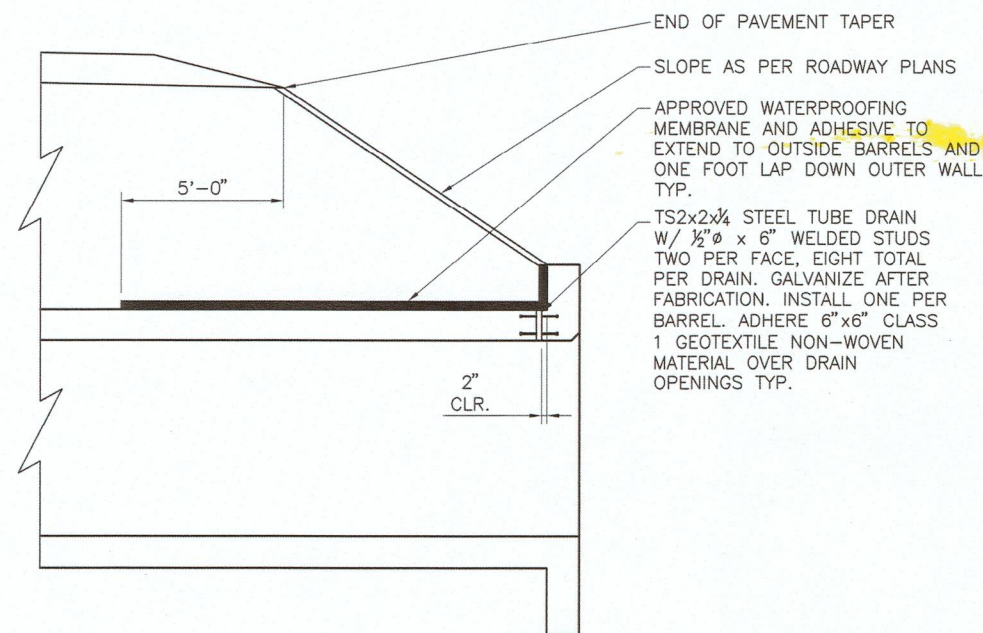


TOP SLAB MEMBRANE AND HEADWALL DRAIN DETAIL

NOTE: THIS DETAIL SHALL BE CONSTRUCTED FOR ANY NEW CBC OR CBC EXTENSION.

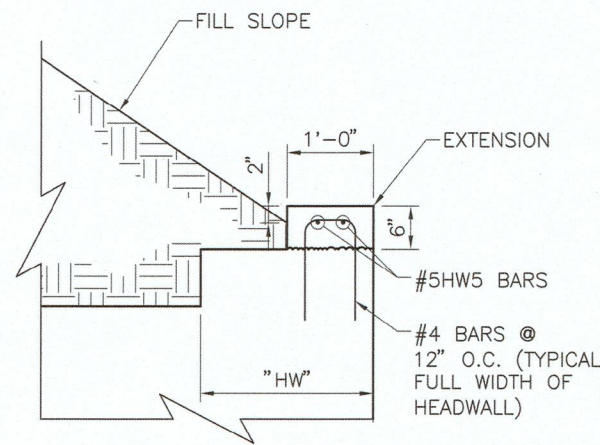

HEADWALL EXTENSION DETAIL

NOTE: IF "HW" IS GREATER THAN 12" ADD EXTENSION AND FILL AS SHOWN. 2" DIM. TYP. OF ALL HEADWALL.

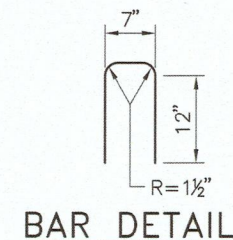

BAR DETAIL

PAYMENT NOTE: ALL WORK AND MATERIALS ASSOCIATED WITH HEADWALL EXTENSION, MEMBRANE, DRAINS, AND PENETRATIONS SHALL BE CONSIDERED INCIDENTAL TO CONSTRUCTION OF A FINISHED CBC AND NO FURTHER PAYMENT WILL BE MADE FOR THESE INCLUDED ITEMS.

NO.	DATE	REV. BY	DESCRIPTION
REVISIONS (OR CHANGE NOTICES)			
NEW MEXICO DEPARTMENT OF TRANSPORTATION STANDARD DRAWING			
CONCRETE BOX CULVERT EXTENSION ALL DESIGN FILLS - ALL SKEWS MISCELLANEOUS DETAILS & BACKFILL			
APPROVED: [Signature] DESIGN ENGINEER DATE: Apr 9, 07			
DESIGNED BY: TJB DRAWN BY: SGL CHECKED BY: HDR			
511-66-5/6 5 OF 6			

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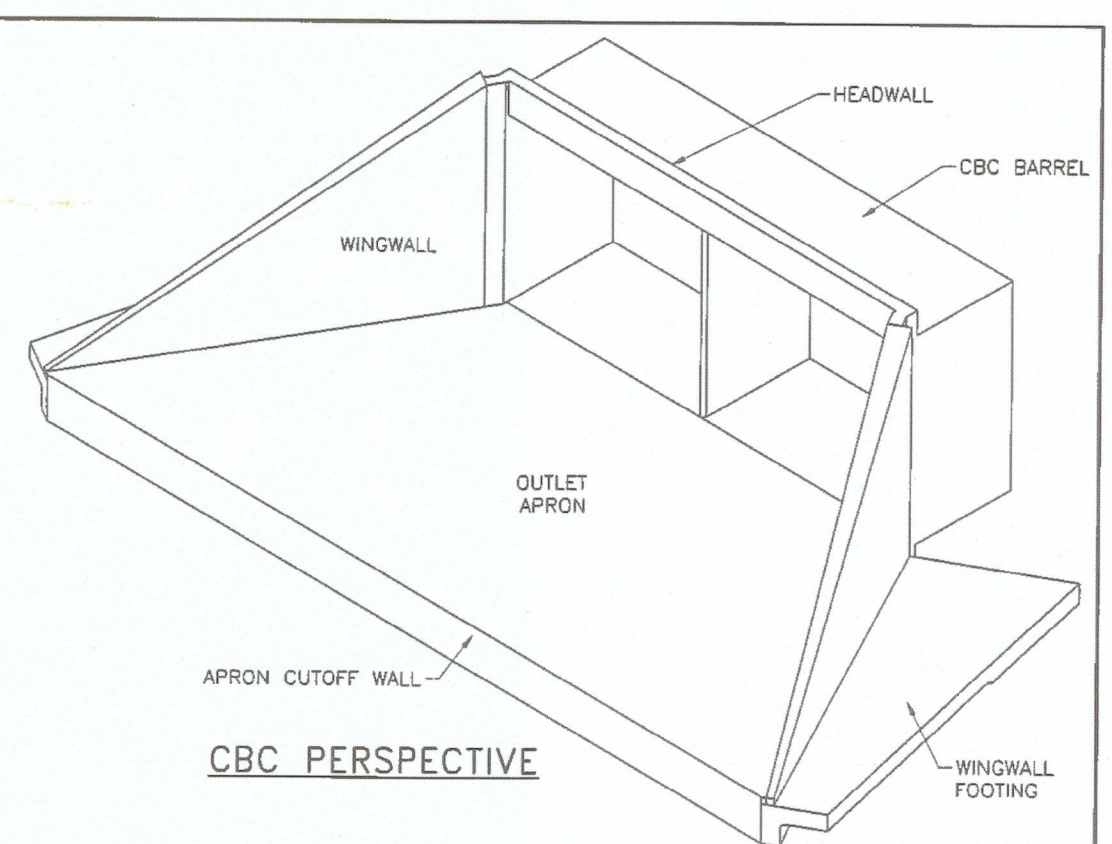
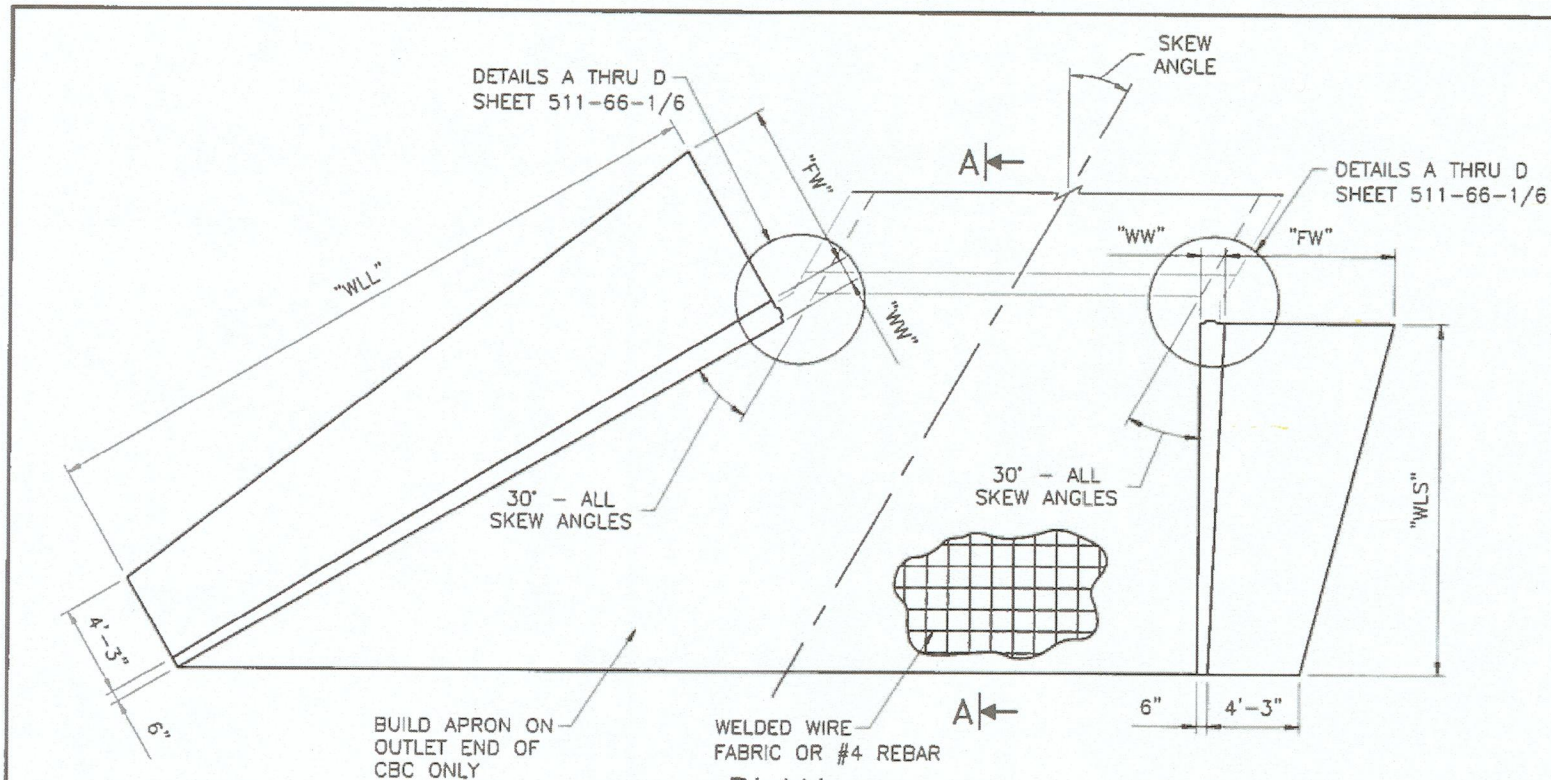
PROJECT NAME

NO.	DATE	REV. BY	DESCRIPTION


PROJECT NO: 166060700
DESIGNED BY: TJA
DRAWN BY: JEM
CHECKED BY: TJA
DATE: JAN 2022
SHEET TITLE

NMDOT STD DWG

SHEET NO:
C-517



REINFORCING BARS

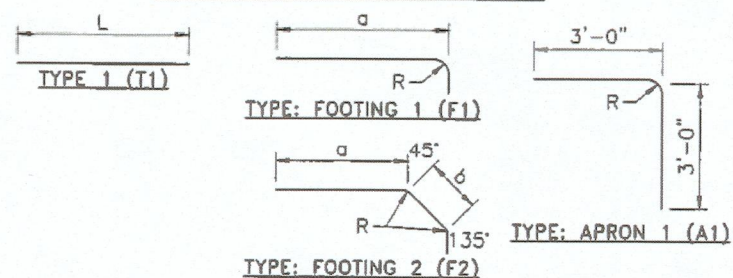

NOTE:
CONTRACTOR IS RESPONSIBLE FOR DETERMINING
ALL BAR LENGTHS DIMENSIONS FOR THE
WINGWALL REINFORCEMENT.

R SHALL BE 1¾" FOR #4 BARS AND 2¼" FOR #5 BARS.

WINGWALL DIMENSIONS

WINGS A AND B			0° SKEW		15° SKEW		30° SKEW		45° SKEW	
"H"	"WW"	"FW"	"WLL"	"WLS"	"WLL"	"WLS"	"WLL"	"WLS"	"WLL"	"WLS"
2'-0"	0'-9½"	6'-8½"	8'-5"	8'-5"	10'-3"	7'-6"	14'-6"	7'-3"	28'-0"	7'-6"
3'-0"	0'-10¾"	7'-2½"	10'-1"	10'-1"	12'-5"	9'-1"	17'-6"	8'-9"	33'-10"	9'-1"
4'-0"	0'-11½"	7'-8½"	11'-10"	11'-10"	14'-6"	10'-8"	20'-6"	10'-3"	39'-8"	10'-8"
5'-0"	1'-0"	8'-2½"	13'-7"	13'-7"	16'-8"	12'-2"	23'-6"	11'-9"	45'-5"	12'-2"
6'-0"	1'-0¾"	8'-9"	15'-4"	15'-4"	18'-9"	13'-9"	26'-6"	13'-3"	51'-3"	13'-9"
7'-0"	1'-1½"	9'-3"	17'-1"	17'-1"	20'-11"	15'-3"	29'-6"	14'-9"	57'-0"	15'-3"
8'-0"	1'-2¼"	9'-9"	18'-9"	18'-9"	23'-0"	16'-10"	32'-6"	16'-3"	62'-10"	16'-10"
9'-0"	1'-3¼"	10'-3"	20'-6"	20'-6"	25'-1"	18'-5"	35'-6"	17'-9"	68'-7"	18'-5"
10'-0"	1'-4"	10'-9"	22'-3"	22'-3"	27'-3"	19'-11"	38'-6"	19'-3"	74'-5"	19'-11"
11'-0"	1'-4¾"	11'-3"	24'-0"	24'-0"	29'-4"	21'-6"	41'-6"	20'-9"	80'-2"	21'-6"
12'-0"	1'-5½"	11'-9"	25'-9"	25'-9"	31'-6"	23'-1"	44'-6"	22'-3"	86'-0"	23'-1"
13'-0"	1'-6¼"	12'-3"	27'-5"	27'-5"	33'-7"	24'-7"	47'-6"	23'-9"	91'-9"	24'-7"
14'-0"	1'-7"	12'-9"	29'-2"	29'-2"	35'-9"	26'-2"	50'-6"	25'-3"	97'-7"	26'-2"


NOTE: TABLE DIMENSIONS SHOWN ARE FOR SLOPES OF 1.5 TO 1. FOR OTHER SLOPES MULTIPLY TABLE VALUES OF "WLS" AND "WLS" BY (SLOPE/1.5).

DESIGNED BY: TLB DRAWN BY: SLG/BEE CHECKED BY: HDR

NOTES:

1. WORKMANSHIP AND MATERIALS SHALL CONFORM TO NEW MEXICO DEPARTMENT OF TRANSPORTATION'S STANDARD SPECIFICATIONS FOR HIGHWAY AND BRIDGE CONSTRUCTION, CURRENT EDITION, AND APPLICABLE SUPPLEMENTAL SPECIFICATIONS AND SPECIAL PROVISIONS.
2. CONCRETE SHALL BE CLASS AA. CHAMFER ALL EDGES OF CONCRETE $\frac{3}{4}$ ".
3. REINFORCING BARS SHALL CONFORM TO REQUIREMENTS OF AASHTO M 31. REINFORCING BARS SHALL BE GRADE 60. DIMENSIONS SHOWN REFER TO CENTER LINES OF BARS UNLESS NOTED OTHERWISE.
4. MINIMUM SPLICE LENGTH SHALL BE 2'-0" ON ALL #4 BARS, AND 2'-6" ON ALL #5 BARS. LONGITUDINAL SPLICES SHOULD BE STAGGERED BY A MINIMUM OF TWO TIMES THE SPLICES LENGTH IN ADJACENT BARS. NO SPLICES SHALL BE ALLOWED IN VERTICAL BARS EXCEPT AS SHOWN ON THE DRAWINGS. SPLICES SHALL NOT BE ALLOWED IN TRANSVERSE DIRECTION.

THIS STANDARD DRAWING IS FOR USE ON NMDOT PROJECTS. OTHERS WHO USE THE NMDOT STANDARD DRAWINGS DO SO AT THEIR OWN RISK. STANDARD DRAWINGS THAT ARE APPLICABLE TO A SPECIFIC PROJECT WILL BE IDENTIFIED ON THE PROJECT PLANS BUT WILL NOT BE PHYSICALLY INCLUDED IN THOSE PLANS. THE DESIGNER WHO SPECIFIES A STANDARD DRAWING ACCEPTS THE RESPONSIBILITY OF DETERMINING THEIR APPLICABILITY.

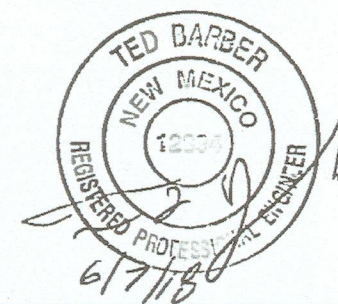[illegible]

REVISIONS (OR CHANGE NOTICES)

NEW MEXICO DEPARTMENT OF TRANSPORTATION STANDARD DRAWING

CONCRETE BOX CULVERT
WINGWALL & OUTLET APRON
ALL SKEWS
PLAN, PERSPECTIVE, & DIMENSIONS

511-67-1/2

1 of 2

Sheet 511-101

**WILSON
& COMPANY**

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ALBUQUERQUE, NM 87109
PHONE: 505-348-4000
FAX: 505-348-4072
www.wilsonco.com

CONSULTANTS

SEAL

60% SUBMITTAL
NOT FOR
CONSTRUCTION

PROJECT NAME

BARR SPUR IMPROVEMENTS

[illegible]

PROJECT NO:	1660060700
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DESIGNED BY: TJA

DRAWN BY:	JEM
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CHECKED BY:	TJA
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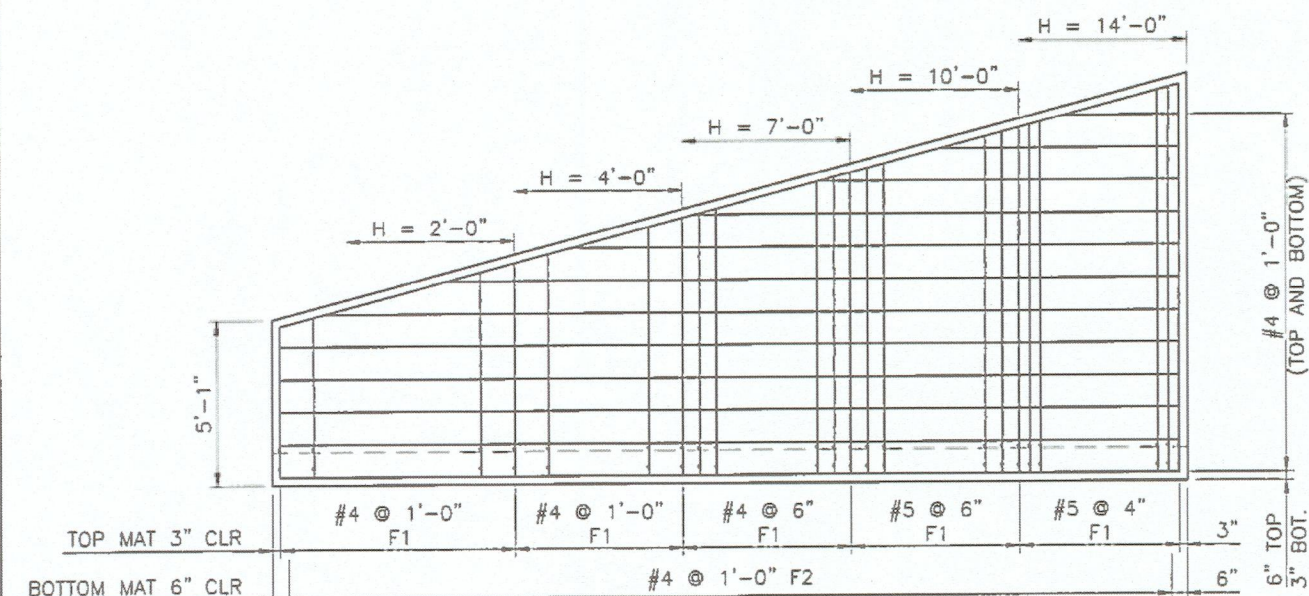
DATE: JAN 2022

SHEET TITLE

NMDOT STD DWG


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C-518




FOOTING PLAN


CONTRACTOR IS RESPONSIBLE FOR DETERMINING ALL BAR LENGTH DIMENSIONS FOR THE WINGWALL REINFORCEMENT.

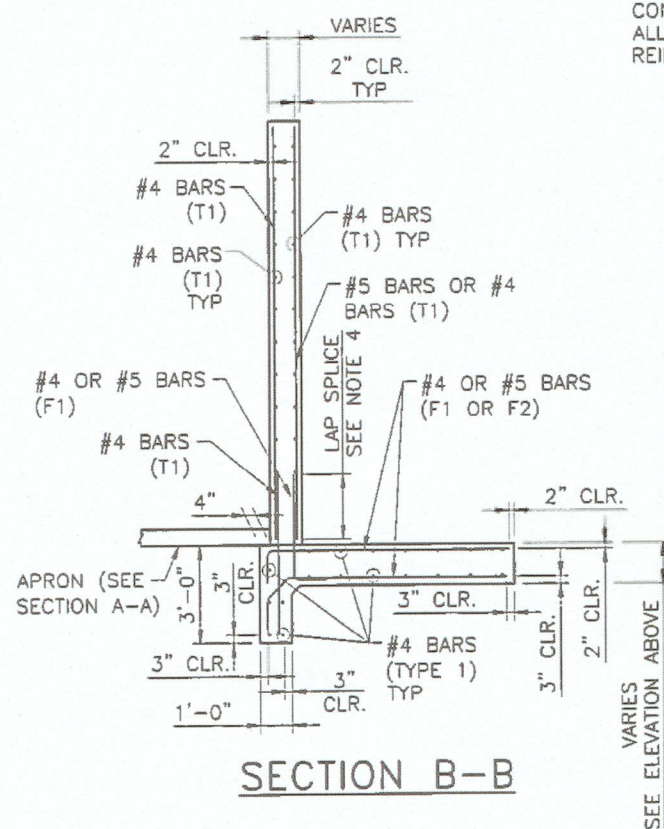

SECTION B-B

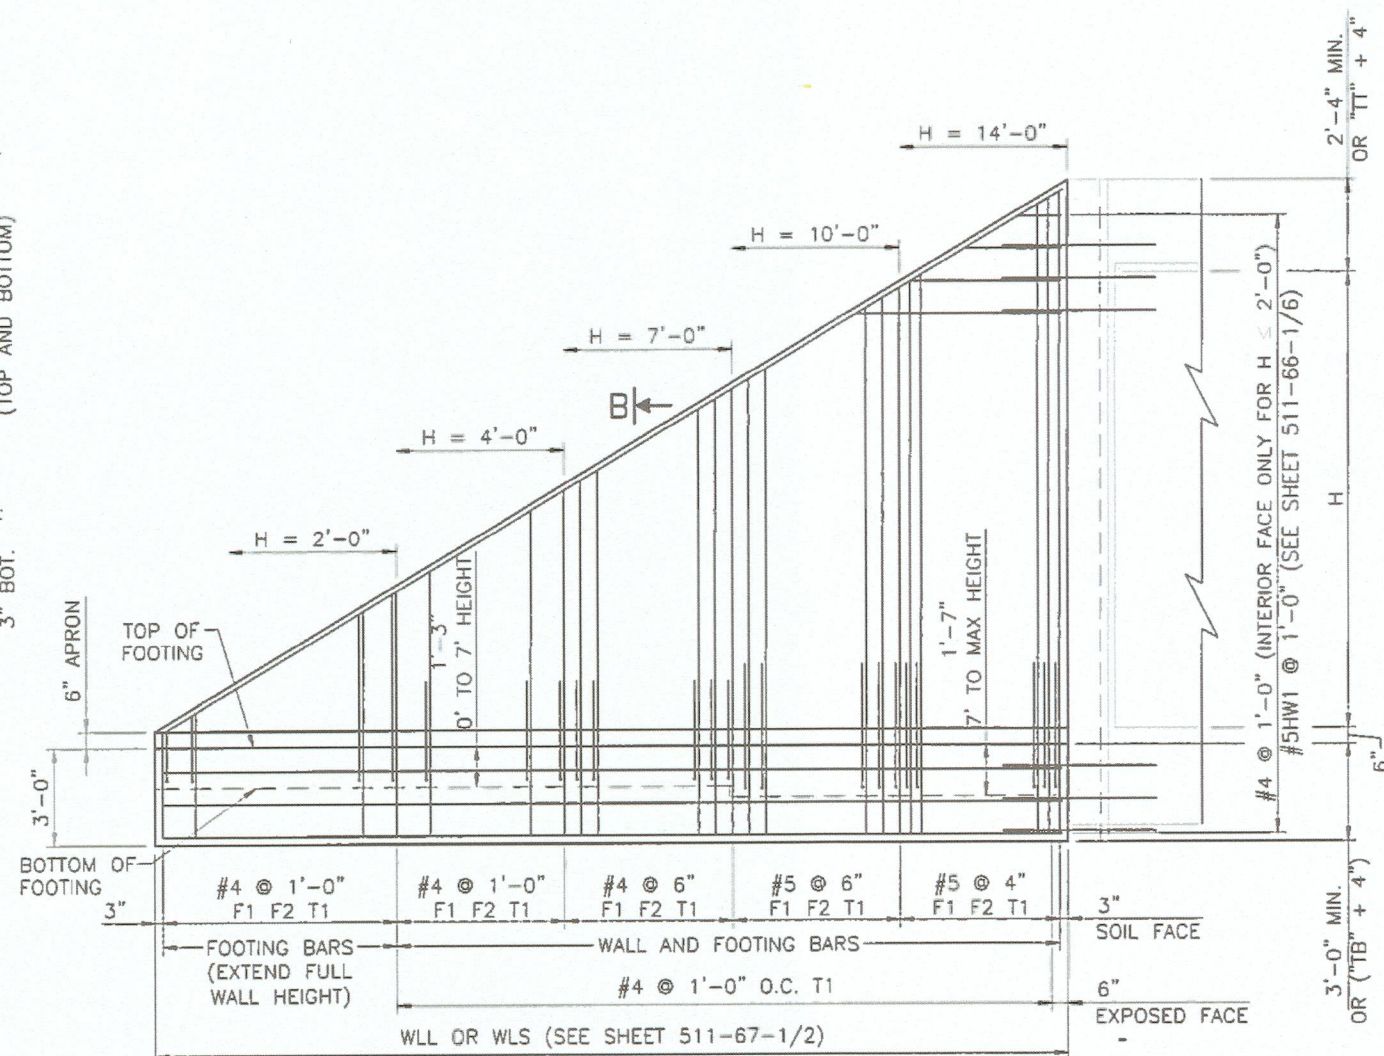

B ←
WINGWALL ELEVATION

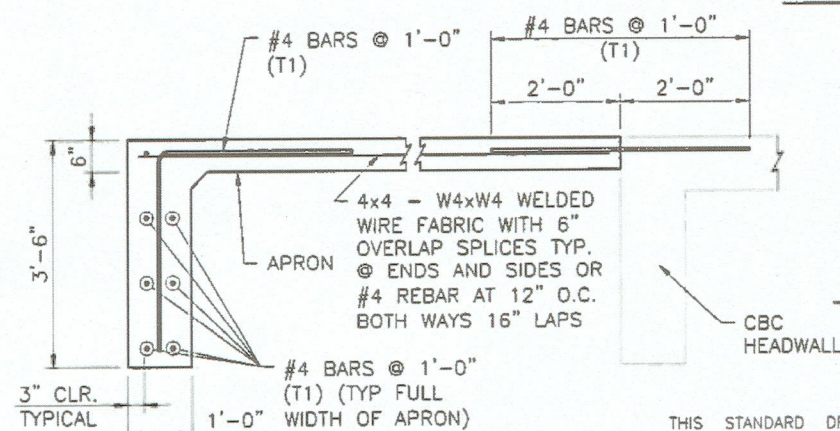

SECTION A-A

THIS STANDARD DRAWING IS FOR USE ON NMDOT PROJECTS. OTHERS WHO USE THE NMDOT STANDARD DRAWINGS DO SO AT THEIR OWN RISK. STANDARD DRAWINGS THAT ARE APPLICABLE TO A SPECIFIC PROJECT WILL BE IDENTIFIED ON THE PROJECT PLANS BUT WILL NOT BE PHYSICALLY INCLUDED IN THOSE PLANS. THE DESIGNER WHO SPECIFIES A STANDARD DRAWING ACCEPTS THE RESPONSIBILITY OF DETERMINING THEIR APPLICABILITY.

[illegible]

NEW MEXICO
DEPARTMENT OF TRANSPORTATION
STANDARD DRAWING

CONCRETE BOX CULVERT
WINGWALL & OUTLET APRON
ALL SKEWS
STRUCTURAL SECTIONS AND REBAR

511-67-2/2

2 of 2

[illegible]

PROJECT NO:	1660060700
DESIGNED BY:	TJA
DRAWN BY:	JEM
CHECKED BY:	TJA
DATE:	JAN 2022
SHEET TITLE	

NMDOT STD DWG

SHEET NO:

C-519

CONSULTANTS

SEAL

PROJECT NAME

DESCRIPTION

DATE _____

EV.

BARR SPUR IMPROVEMENTS

60% SUBMITTAL
NOT FOR
CONSTRUCTION

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& COMPANY**

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