ADDITIC ALTERAT FIRE STAT

LEGEND:

 $\begin{pmatrix} 1 \\ A5 \end{pmatrix}$ (A4)A-6 23

(11)

(222)

MASONRY WALL CONSTRUCTION STUD PARTITION WITH GYP. BD. EA. SIDE DEMISING WALL (PARTITION EXTENDED TO ROOF DECK) HIDDEN LINE (EXISTING TO BE REMOVED OR ABOVE OR BELOW VIEW)

DETAIL CUT SYMBOL

SECTION CUT SYMBOL

ELEVATION SYMBOL

KEYED NOTE SYMBOL


WINDOW NUMBER SYMBOL


DOOR NUMBER SYMBOL


ALBUQ NEW


12-


BDA ARCHITECTURE GOOD UP TOWN BLYD. NE SUITE #314 (505)266-0593 ALBUQUERQUE, NM 87110 PROJECT: RENOVATIONS - FIRE STATION #7 ALBUQUERQUE, NM 87100 OWNER II 6 47TH STREET NW ALBUQUERQUE, NM 87100 OWNER CITY OF ALBUQUEROUE INDEX TO DRAWINGS S - TITLE SHEET C1 - SITE PLAN A1 - DEMOLITION PLAN A2 - FLOOR PLAN/FNDN PLAN A3 - ELEVATIONS A4 - ROOF/CLG PLANS - SCHEDULES A5 - INTERIOR ELEVNS, WALL SECTIONS P1 - PLUMBING PLAN H1 - HVAC PLAN MP - MECHANICAL NOTES
PROJECT: RENOVATIONS - FIRE STATION #7 LOCATION: 116 47TH STREET NW ALBUQUERQUE, NM 87100 OWNER CITY OF ALBUOUEROUE INDEX TO DRAWINGS TS - TITLE SHEET C1 - SITE PLAN A1 - DEMOLITION PLAN A2 - FLOOR PLAN/FNDN PLAN A3 - ELEVATIONS A4 - ROOF/CLG PLANS - SCHEDULES A5 - INTERIOR ELEVNS, WALL SECTIONS P1 - PLUMBING PLAN H1 - HVAC PLAN
TS – TITLE SHEET C1 – SITE PLAN A1 – DEMOLITION PLAN A2 – FLOOR PLAN/FNDN PLAN A3 – ELEVATIONS A4 – ROOF/CLG PLANS – SCHEDULES A5 – INTERIOR ELEVNS, WALL SECTIONS P1 – PLUMBING PLAN H1 – HVAC PLAN
C1 – SITE PLAN A1 – DEMOLITION PLAN A2 – FLOOR PLAN/FNDN PLAN A3 – ELEVATIONS A4 – ROOF/CLG PLANS – SCHEDULES A5 – INTERIOR ELEVNS, WALL SECTIONS P1 – PLUMBING PLAN H1 – HVAC PLAN
A1 – DEMOLITION PLAN A2 – FLOOR PLAN/FNDN PLAN A3 – ELEVATIONS A4 – ROOF/CLG PLANS – SCHEDULES A5 – INTERIOR ELEVNS, WALL SECTIONS P1 – PLUMBING PLAN H1 – HVAC PLAN
P1 — PLUMBING PLAN H1 — HVAC PLAN
E1 – ELECTRICAL POWER PLAN E2 – ELECTRICAL LIGHTING PLAN E3 – ELECTRICAL NOTES
PROJECT DATA: LEGAL DESCRIPTION: LOTS 5 & 6 OF THE ZIMMERMAN ADDITION ALBUQUERQUE, NEW MEXICO
COUNTY: BERNALILLO BLOCK: 6 SECTION: UNIT:
DESIGN DATA:

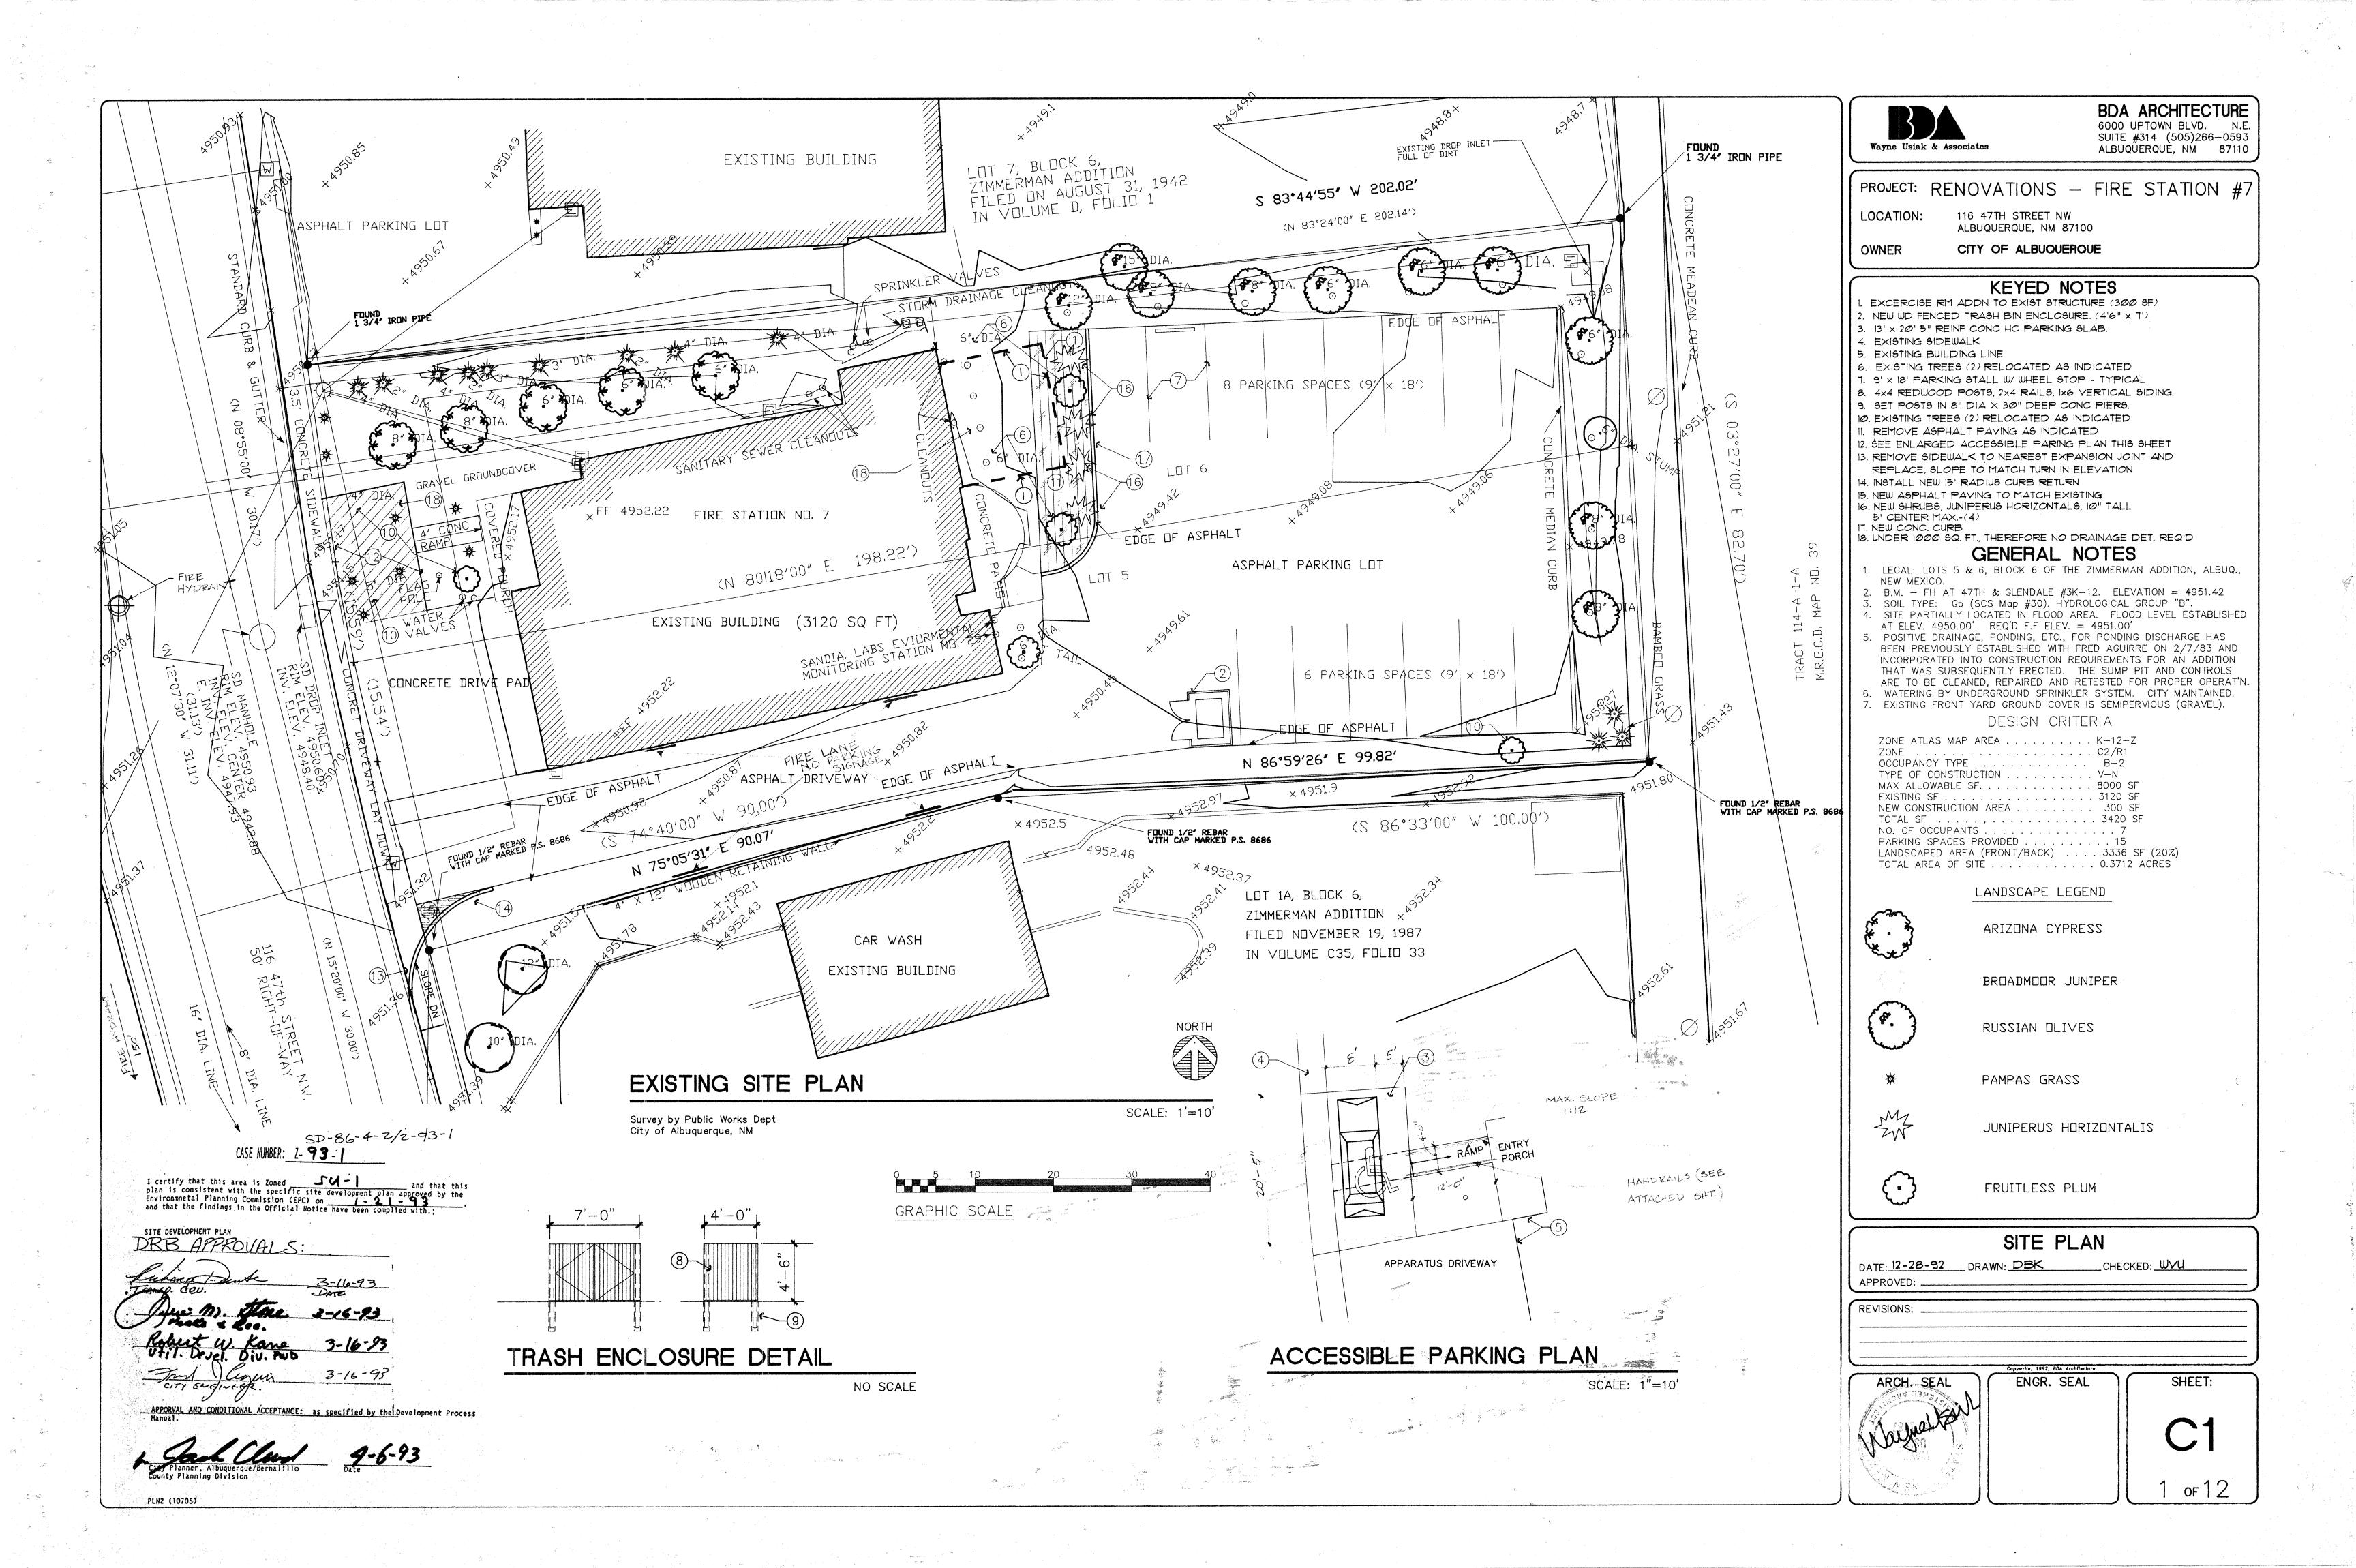

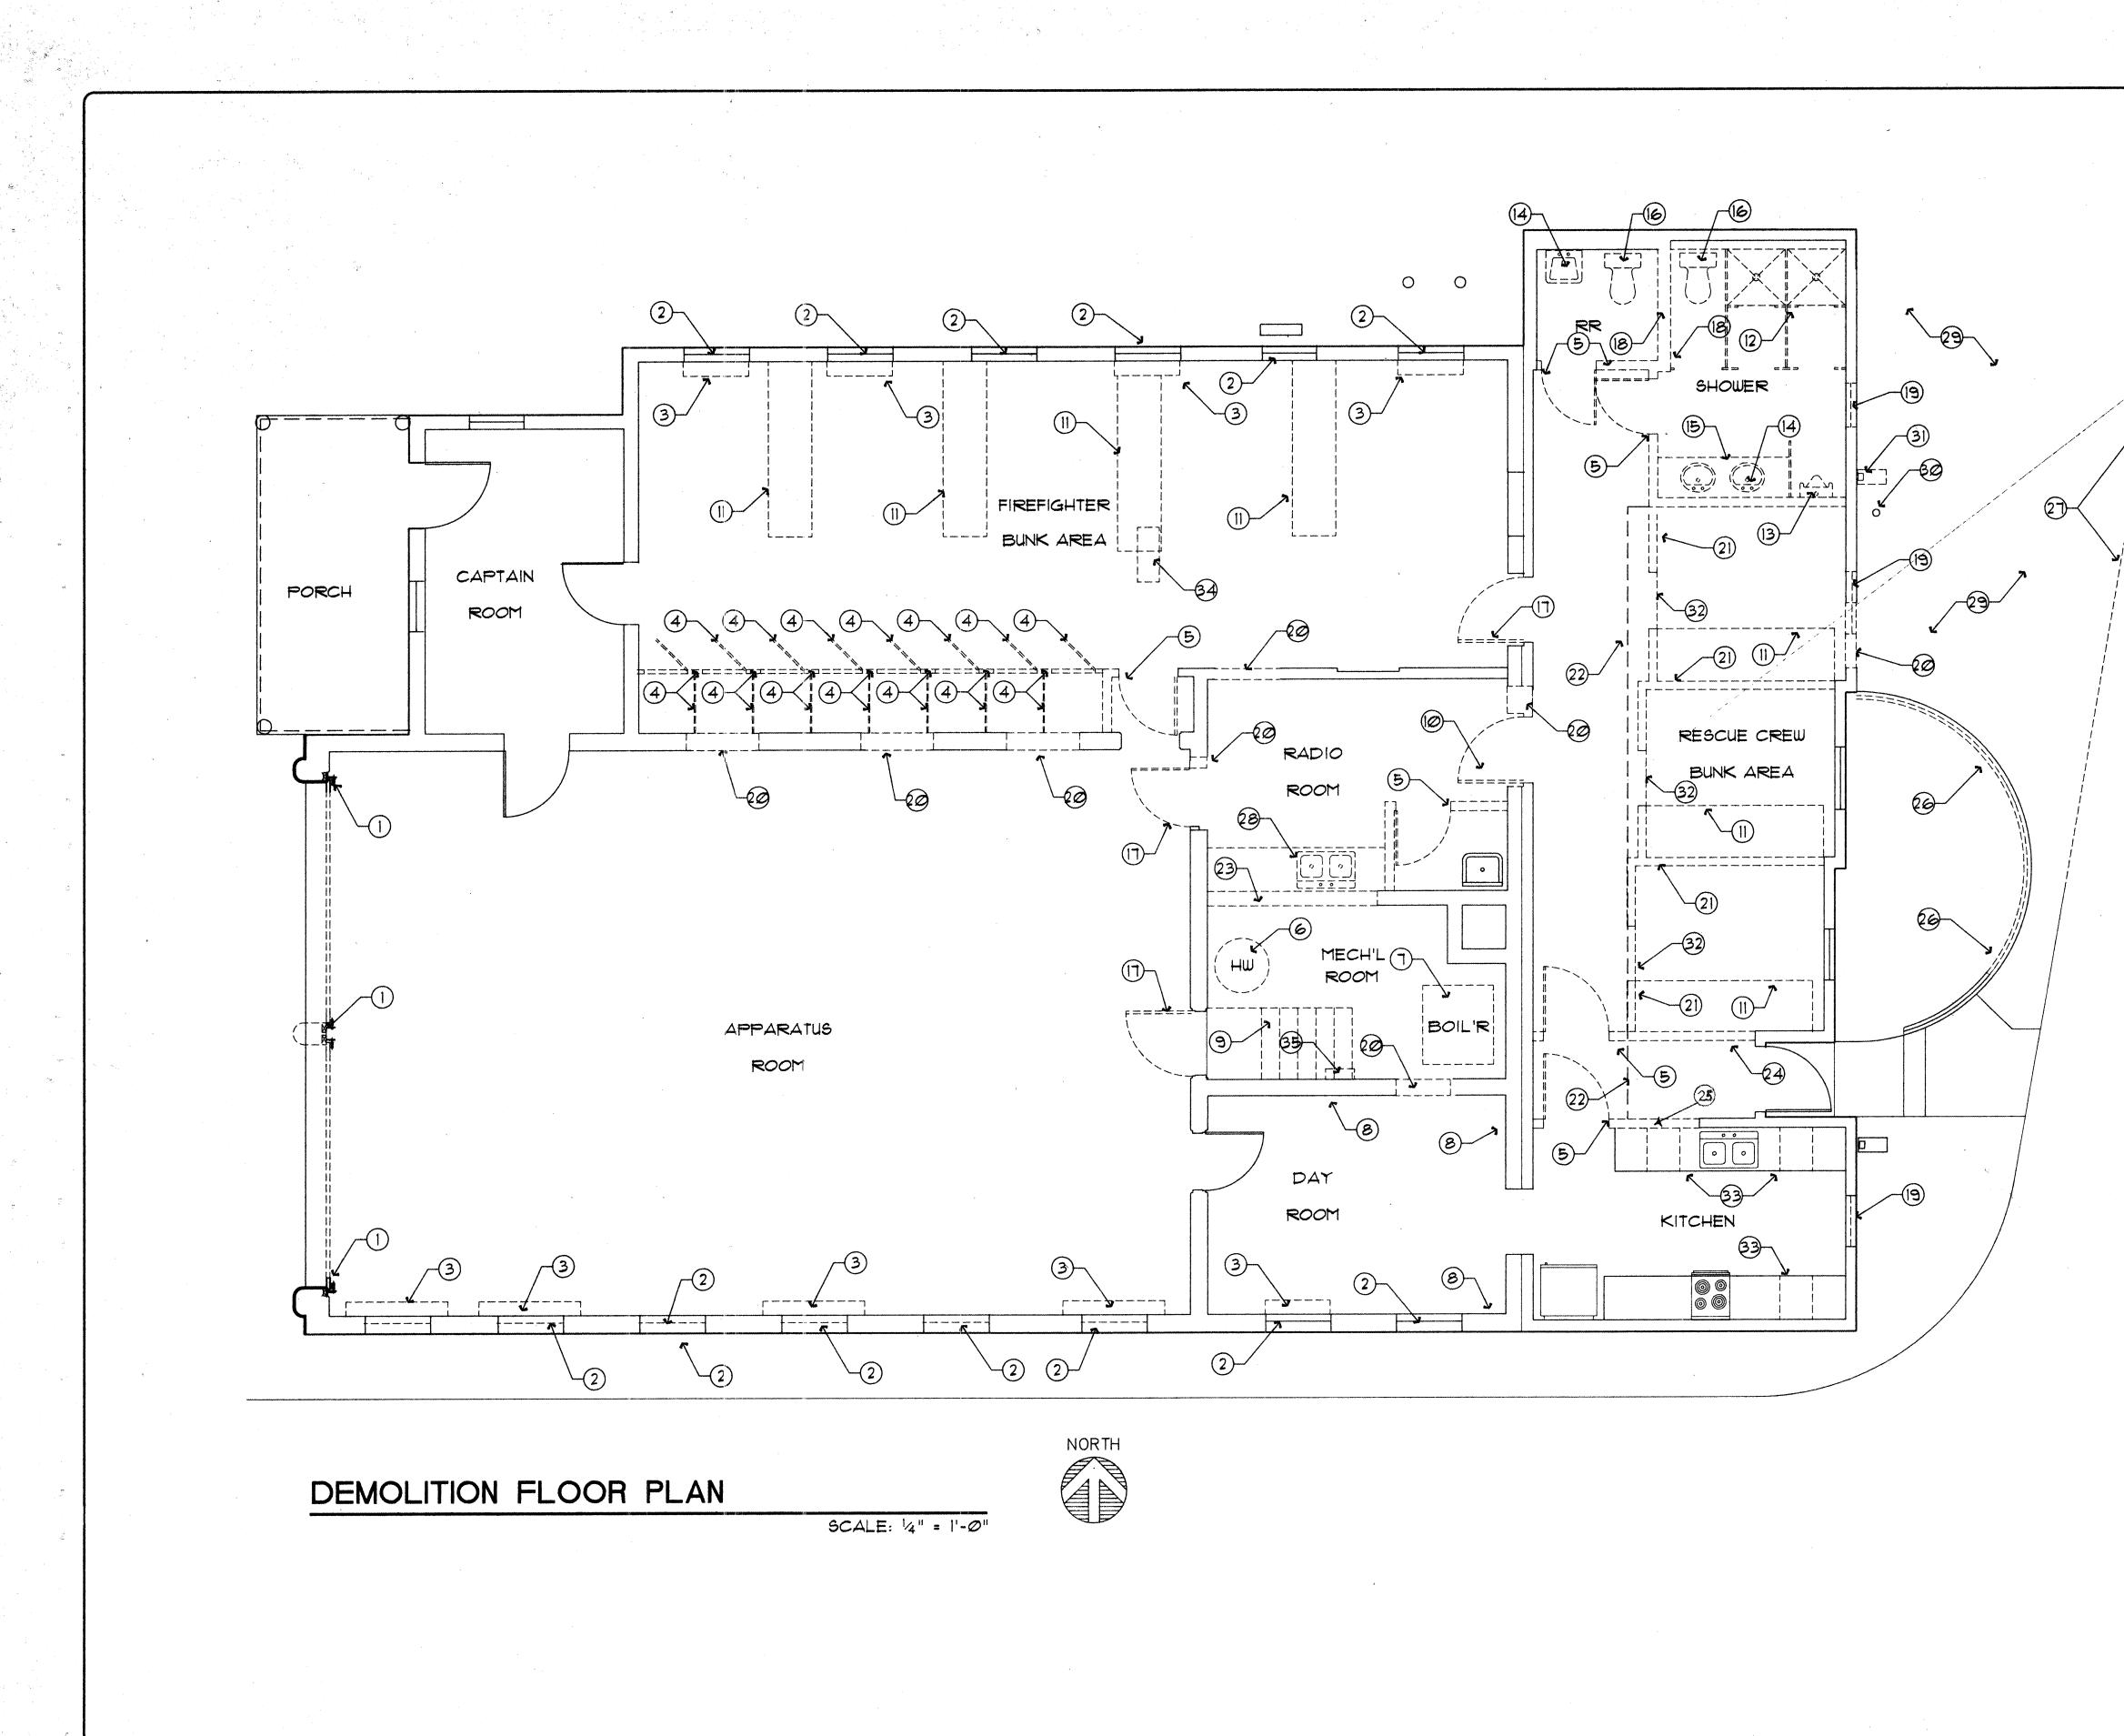

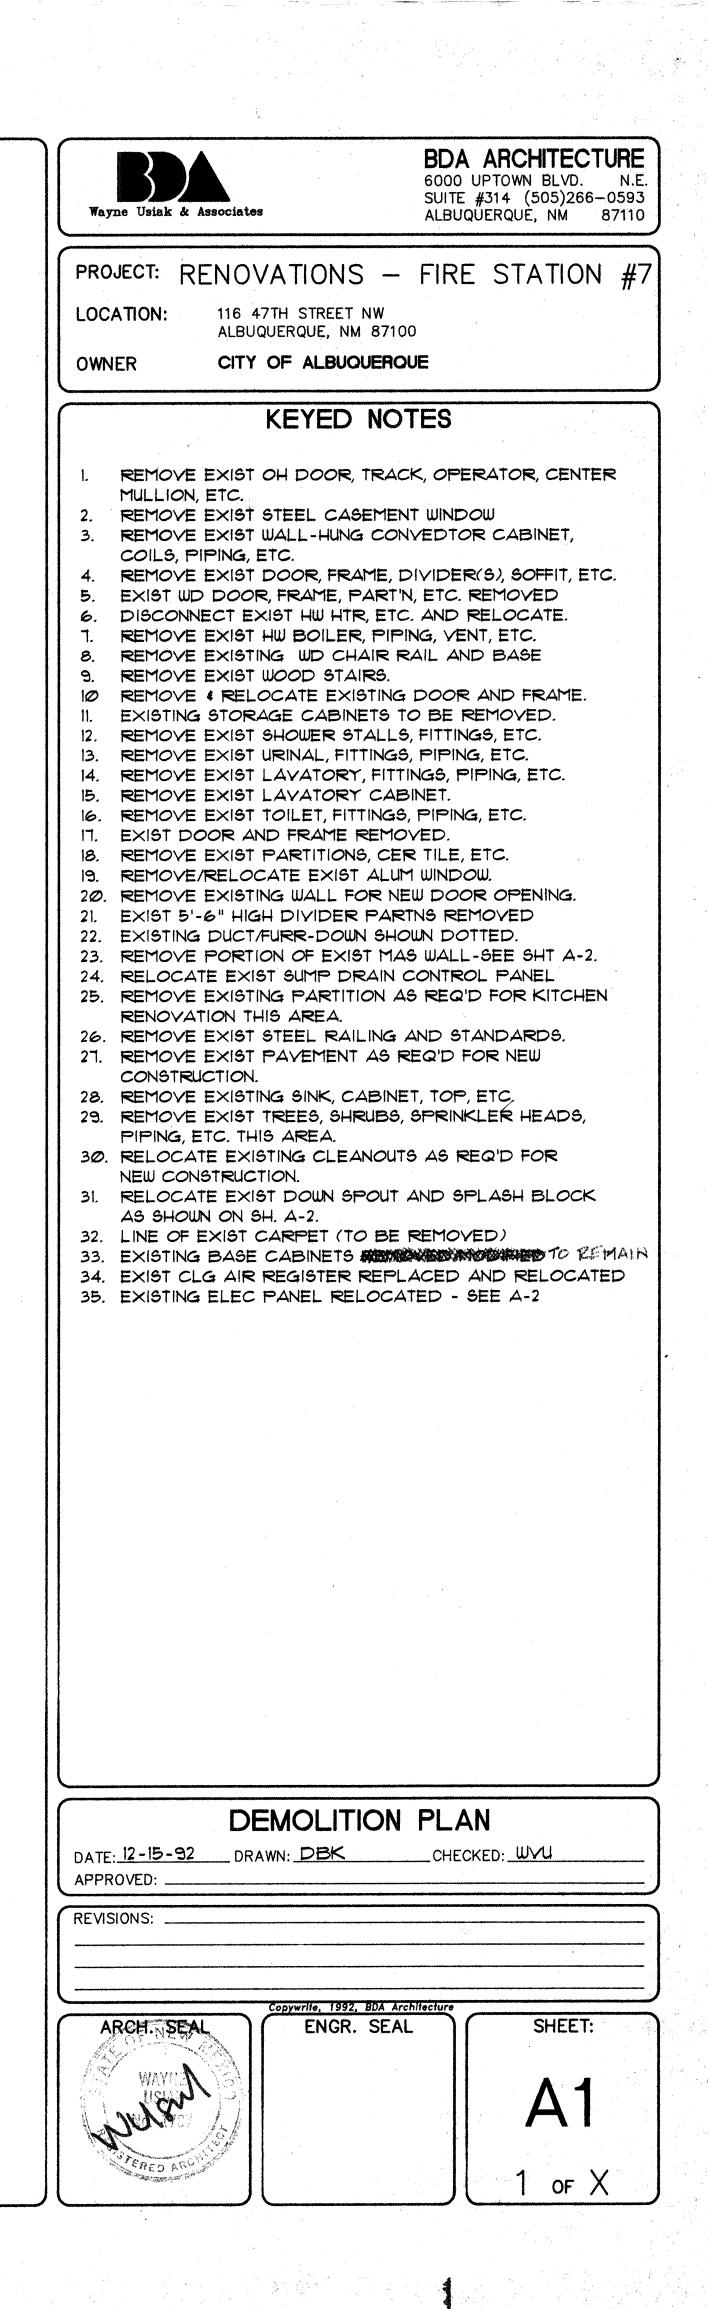

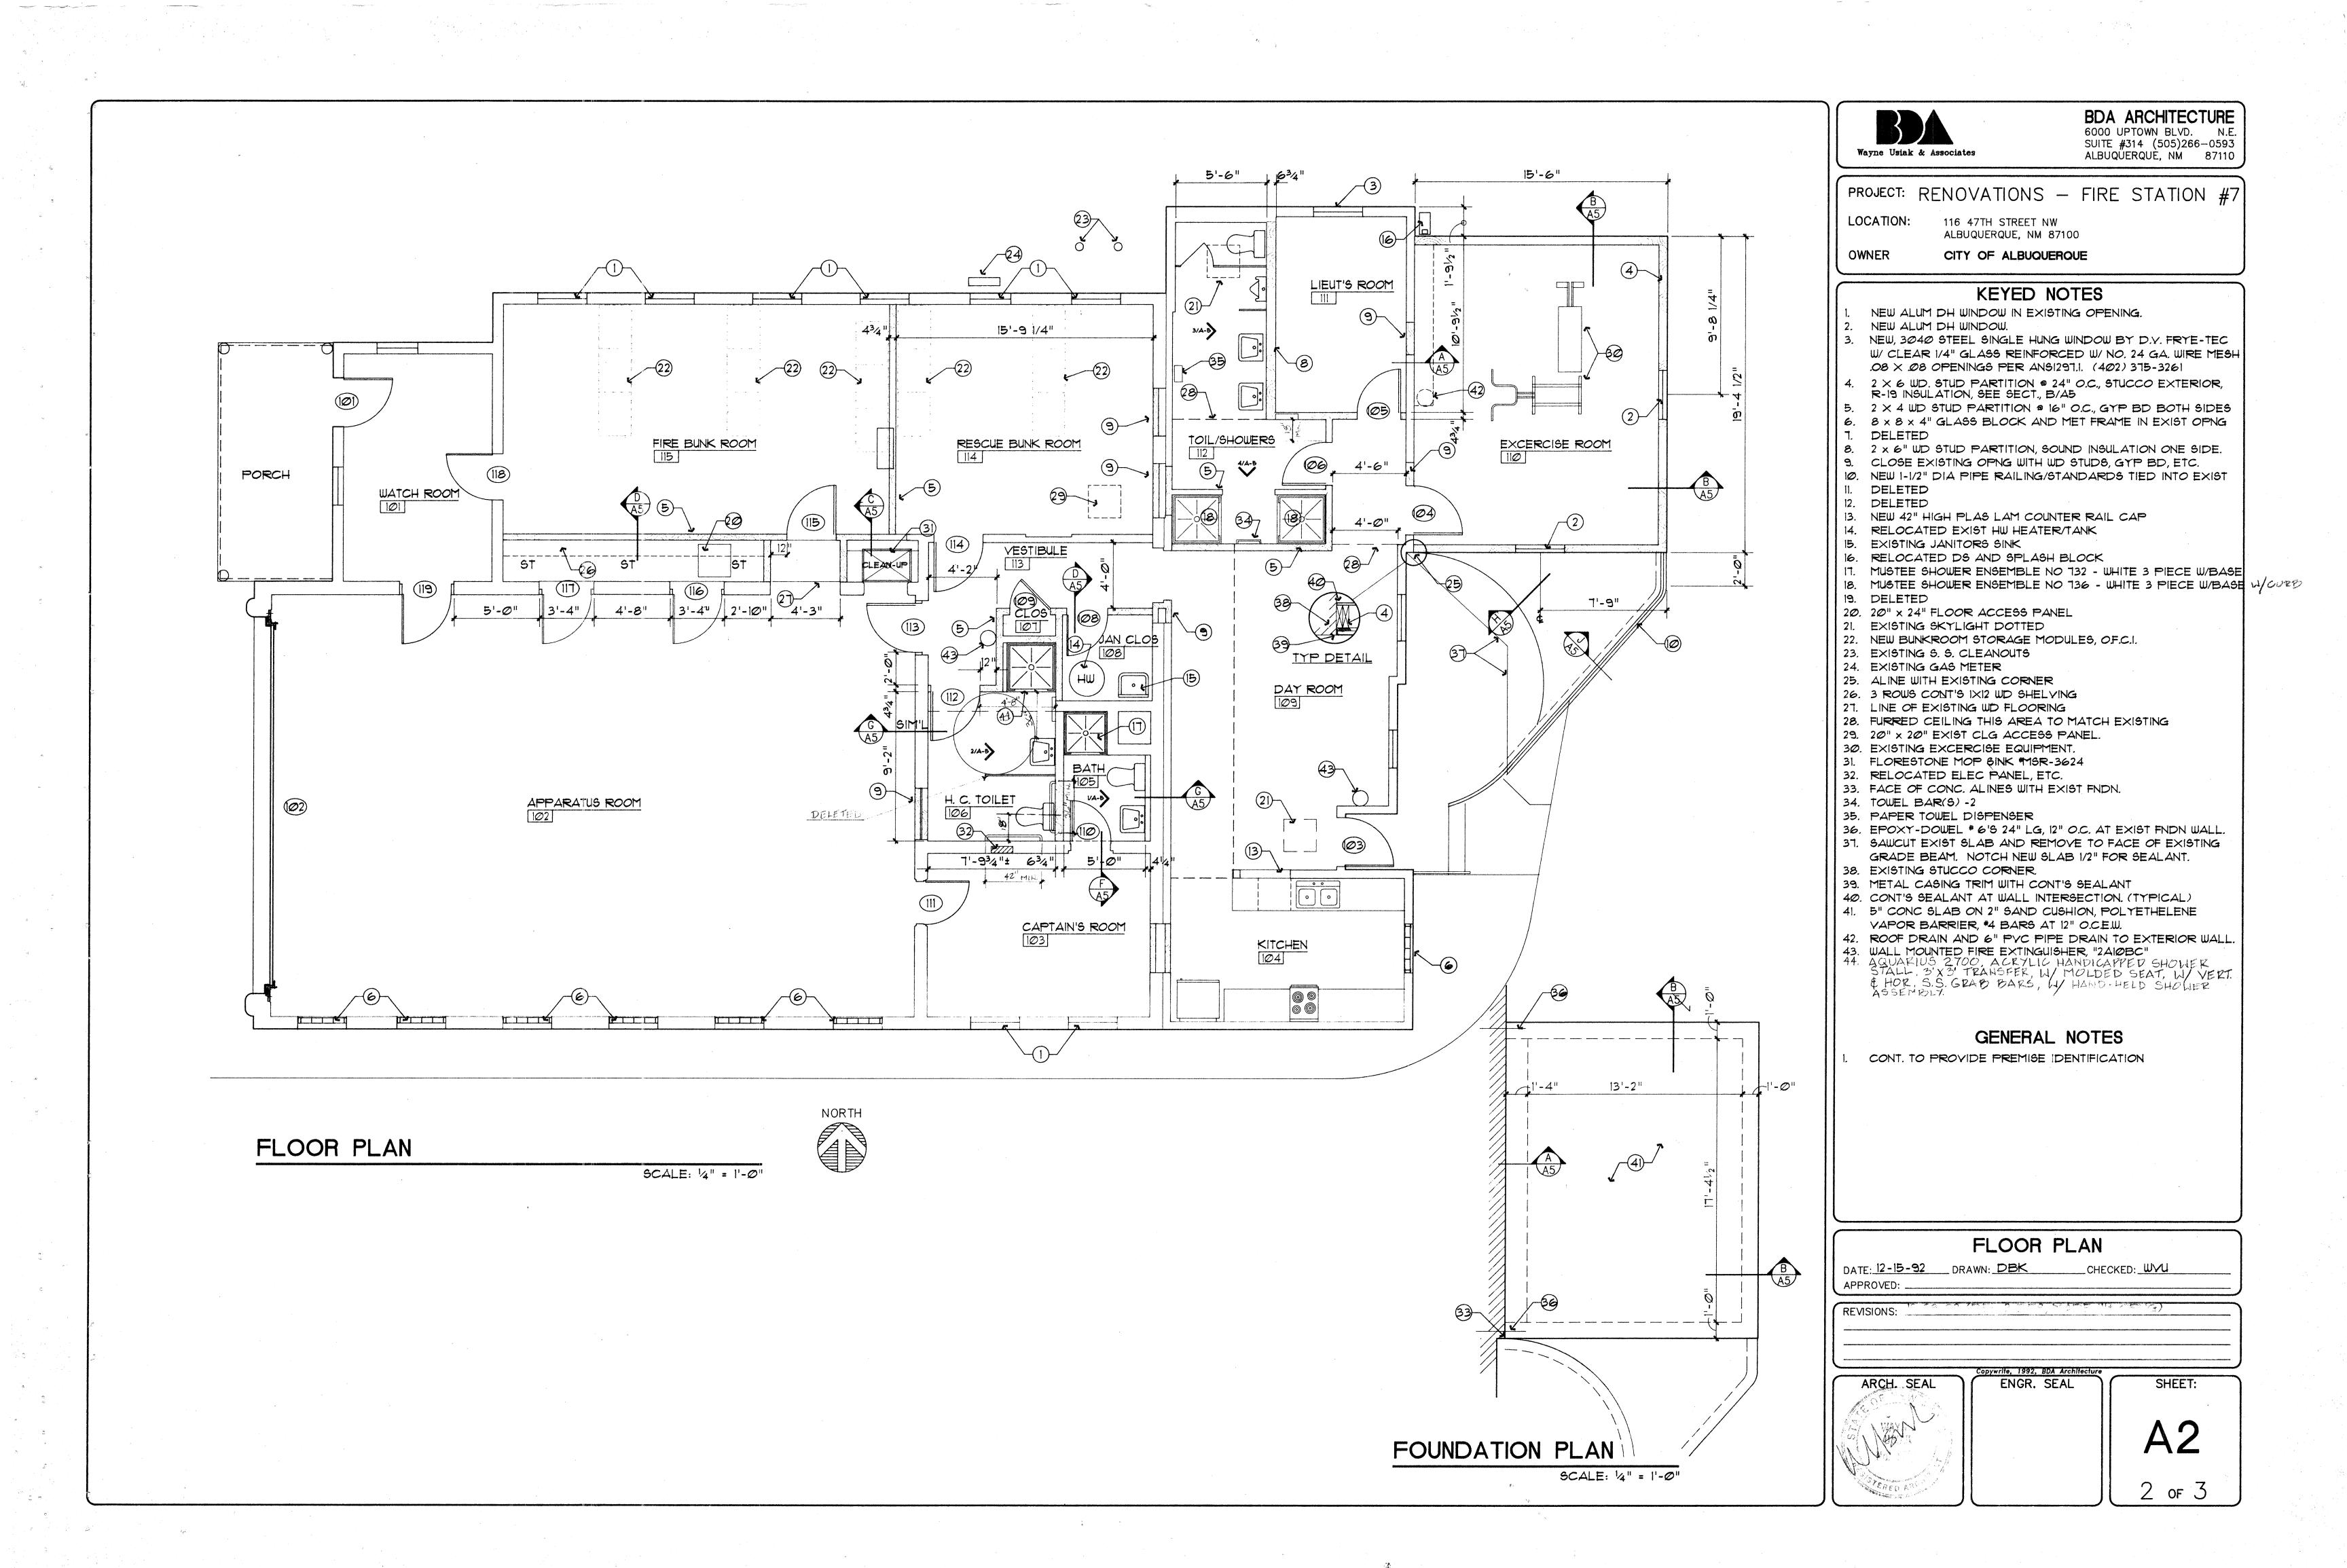

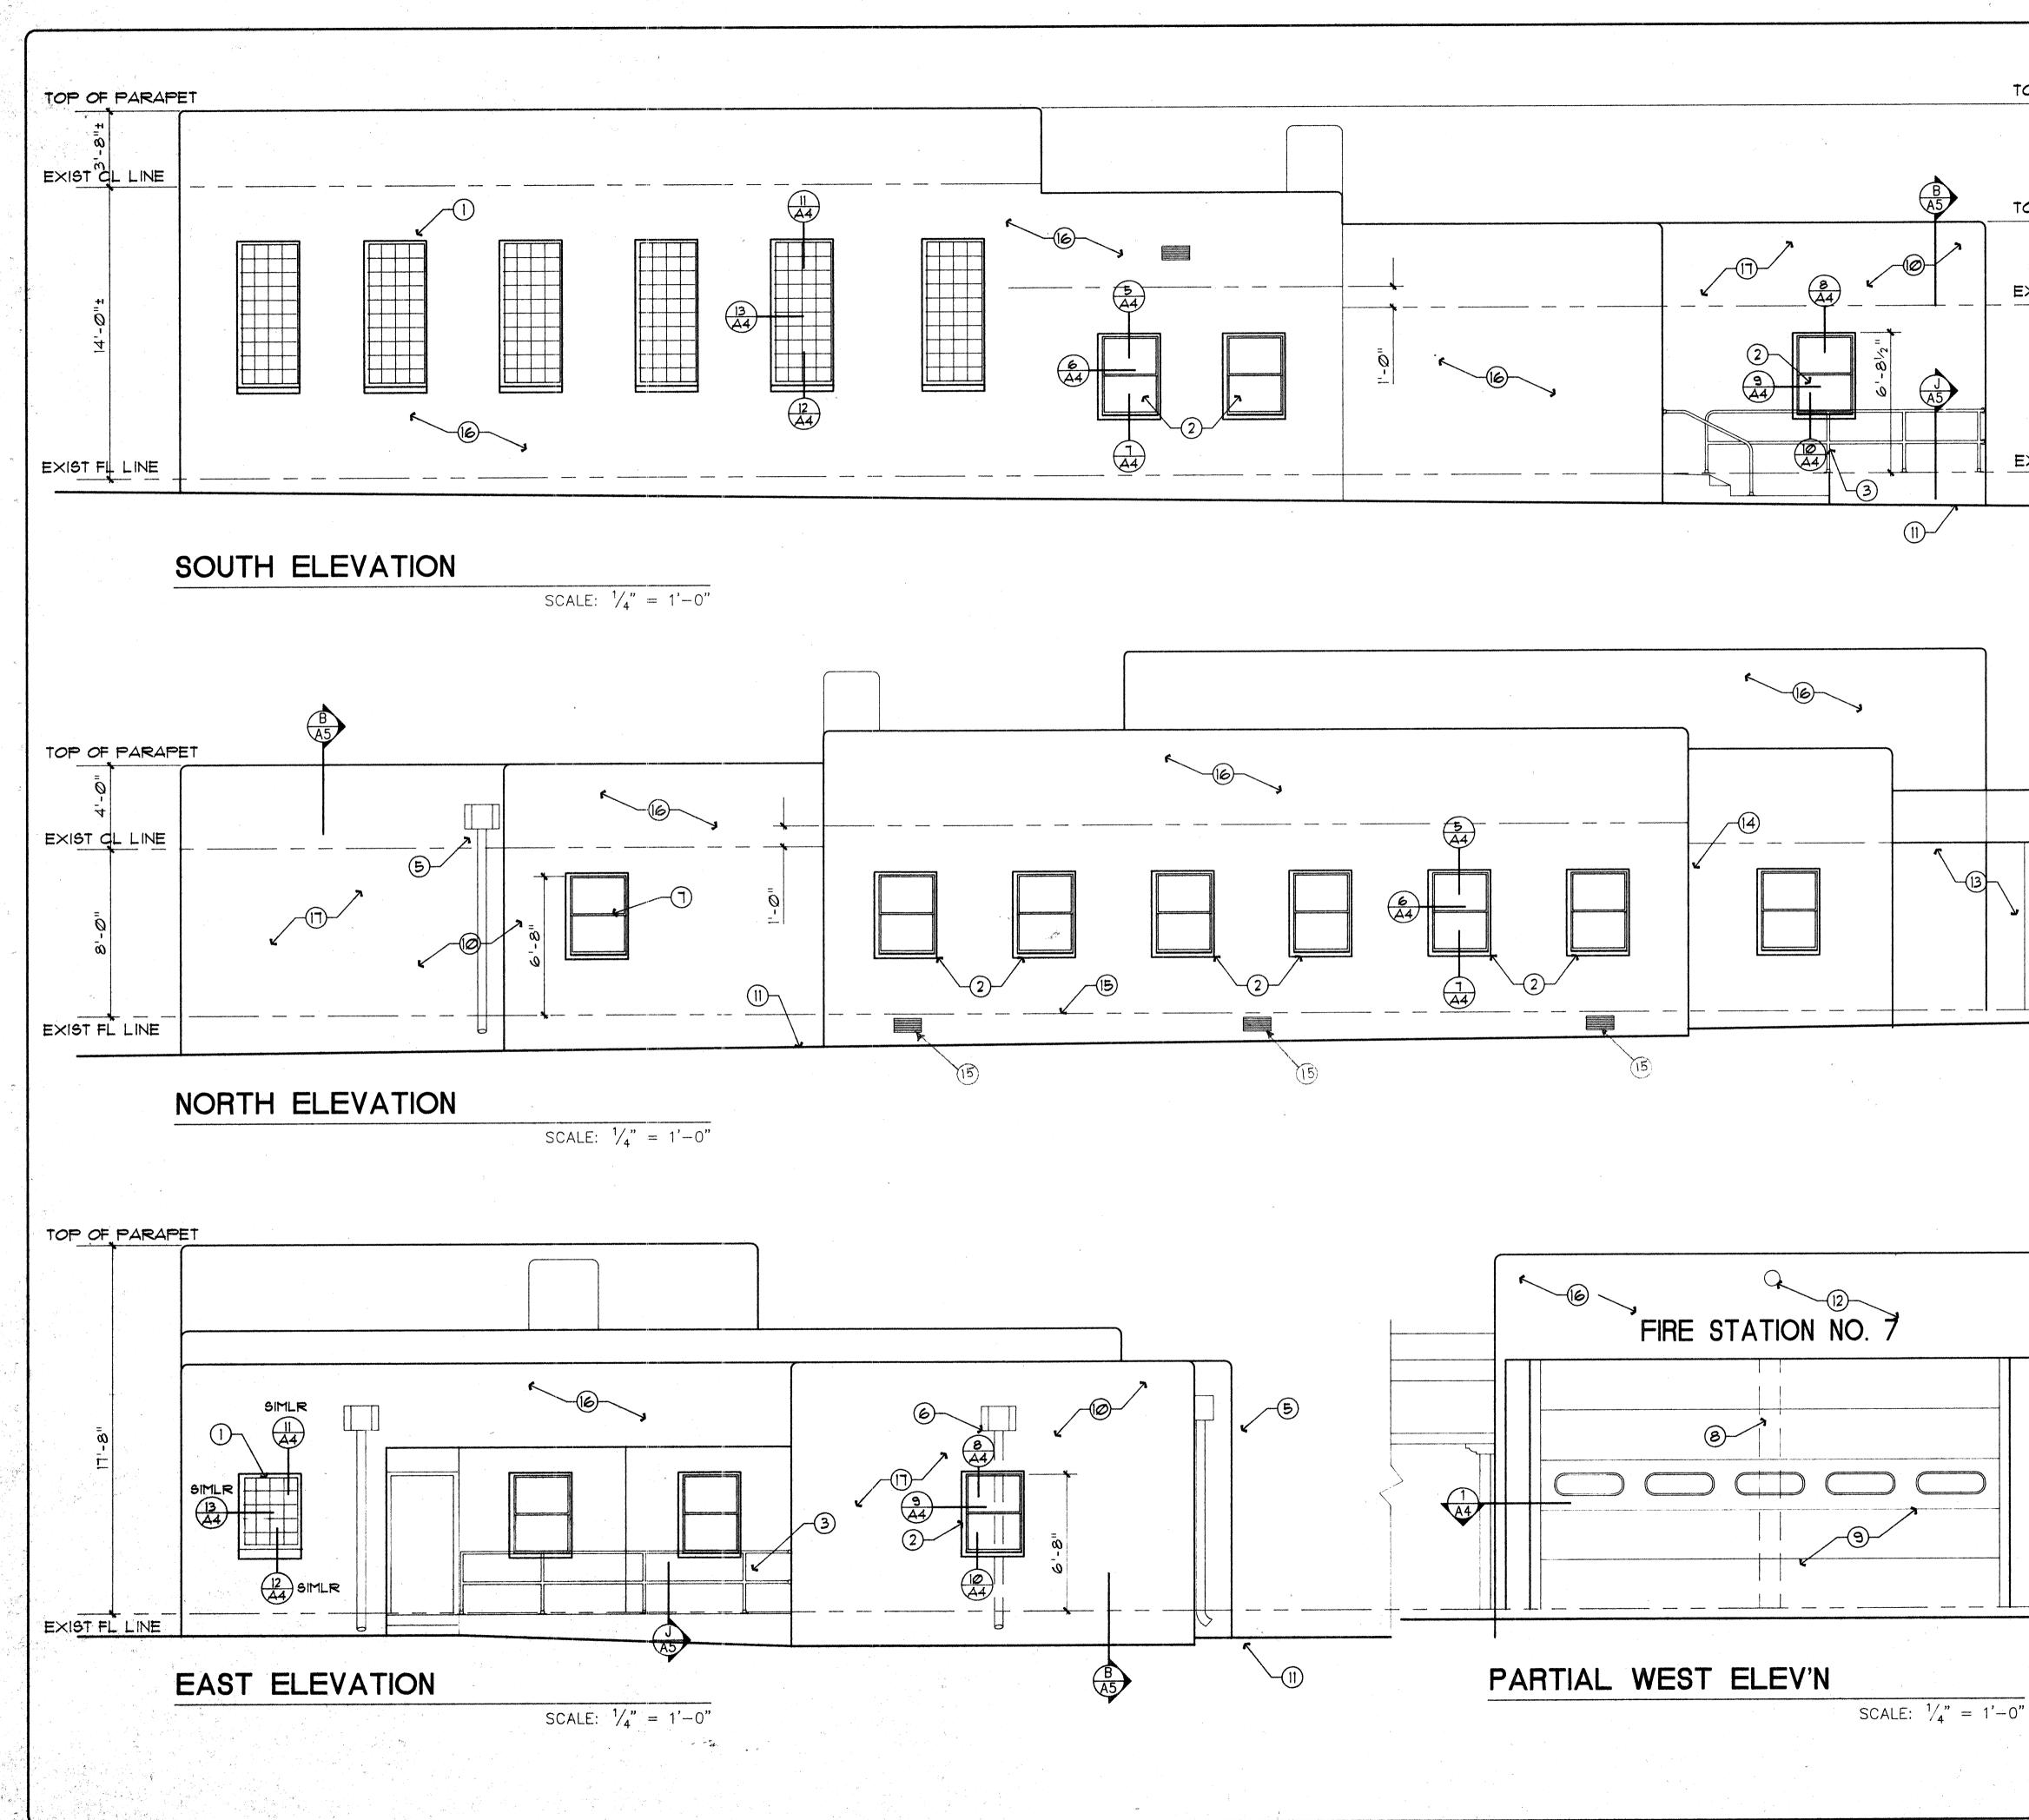


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学习, 李庆,

BDA ARCHITECTURE 6000 UPTOWN BLVD. N.E. SUITE #314 (505)266-0593 ALBUQUERQUE, NM 87110 BD Wayne Usiak & Associates TOP OF PARAPET PROJECT: RENOVATIONS - FIRE STATION #7 116 47TH STREET NW ALBUQUERQUE, NM 87100 LOCATION: TOP OF PARAPE CITY OF ALBUQUERQUE OWNER KEYED NOTES EXIST CLG LINE 8"x8"x4" GL BLK IN ALUM BRK-MTL FRAME 36 "X48" ALUM S.H. WINDOW NEW PIPE RAILING AND CENTER RAIL EXIST D.S. HEAD AND LEADER EXIST D.S. HD AND LDR RELOCATED 5. EXIST D.S. HD AND LDR REMOVED 6. EMOTOALUMUMEDEUR EREDGATED SEE BELOW EXIST REINF CONC CENTER-POST REMOVED 8. 9. NEW 22' x 12' O.H. DOOR ASSEMBLY EXIST FL LINE 10. NEW STUCCO FINISH TO MATCH ADJACENT SURFACE EXIST GRADE 11. 12. EXIST LETTERS, LIGHTS, ETC. 13. EXIST PORCH, ETC ... 14. EXIST POINT OF ENTRY FOR ELEC/TEL SERVICE 15. EXIST CRAWL SPACE VENTS 16. EXISTING TAN STUCCO FINISH 17. NEW CONST'N, R-19 WALLS, R-30 ROOF 7 NEW 3040 STEEL SINGLE HUNG WINDOW BY D.V. FRYE-TEC. W/ CLEAR 1/4" GLASS REINF. W/ NO. 24 GA. WIRE MESH .08 X.08 OPENINGS PER ANSI 297.1 -- (402) 375-3261 UL RIBIST (N) INSTALL PER U.L. LISTING ELEVATIONS DATE: 12-15-92 DRAWN: DBK CHECKED: WVU APPROVED; **REVISIONS:** pywrite, 1992, BDA Architectu ENGR. SEAL SHEET: ARCH. SEAL A3 WAY A CE 3 OF X


				ROC	M	FINIS	H SC	CHEC	ULE			•
	ROOM	FLC	OR	WAINS	cot		u sa	ALLS	n a far a standige and a standige	CEILING	;	
NO.	NAME	MATL	BASE	MATL	HGT	NORTH	EAST	SOUTH	West	MATERIAL	HGHT	REMARKS
101	WATCH ROOM	EXIST	EXIST			EXIST	EXIST	EXIST	EXIST	EXIST	8'-Ø"	REPAINT
102	APPARATUS ROOM	CONC	EXIST			EXIST	EXIST	EXIST	OHDOOR	EXIST	14'-0"	REPAINT
103	CAPTAIN'S ROOM	VCT	VINTL			EXIST	EXIST	EXIST	EXIST	ACOUS-TI	9'-Ø"	REPAINT AS SPEC'D
104	KITCHEN	EXIST	EXIST			EXIST	EXIST	EXIST	EXIST	EXIST	8'-Ø"	SEE ELEVINS A-4
105	BATH	C TILE	C TILE	CTILE	4'-6"	GYP BD	GYP BD	EXIST	GYP BD	EXIST	8'-11"	UNSC-FIXTURE WALL
106	H. C. TOILET	C TILE	CTILE	C TILE	4'-6"	GYP BD	GYP BD	EXIST	EXIST	ACOUS-T2	7'-8"	UNSC-FIXTURE WALL
107	CLOS	VCT	VINTL			GYP BD	GYP BD	GYP BD	GYP BD	GYP BD	7'-8"	N/A
108	JAN CLOS	YCT	VINTL			GYP BD	GYP BD	GYP BD	GYP BD	EXIST	8'-11"	N/A
109	DAY ROOM	VCT	VINTL			GYP BD	EXIST	GYP BD	EXIST	ACTI-GPBD	7'-11"	SEE CLG PLAN SH-A4
110	EXCERCISE ROOM	VCT	VINTL	PAINTED	3'-6"	GYP BD	GYP BD	GYP BD	EXIST	ACOUS-TI	8'-Ø"	N/A
111	LIEUT'S ROOM	VCT	VINTL	• •		GTP BD	EXIST	GYP BD	GYP BD	ACOUS-TI	"l'-11"	N/A
112	TOIL/SHOWERS	CITILE	C TILE	C TILE	4'-6"	EXIST	GTP BD	GYP BD	EXIST	ACTI-GPBD	8'/7'	UNSC-FIXTURE WALL
113	VESTIBULE	VCT	VINTL			EXIST	EXIST	GYP BD	EXIST	ACOUS-T2	7'-8"	N/A
114	RESCUE BUNK ROOM	EXIST	EXIST			EXIST	EXIST	EXIST	GTP BD	ACOUS-TI	9'-0"	N/A
115	FIRE BUNK ROOM	EXIST	EXIST			EXIST	GYP BD	GYP BD	EXIST	ACOUS-TI	9'-0"	N/A
				1					a produce displacemente i produce, e produce displacemente.			


			o di terreta de la constante d				i namenda da serie de formen			1
	an a	• • • • • •	D	OOR	SCHE	EDULE	a galadida 19 galadida 19 galadida			
NO.	OPNG SIZE/THICK	TYP	FRM	HD-DTL	JMB-DTL	SILL-DTL	LBL	ΗW	REMARKS	
101	3'-0" x 7'-0" x 1-3/4"	-	-				-		NEW HC LEVER HANDLE	
102	22'-Ø" × 12'-Ø" × 2"	В		1/A-4	1/4-4	40- 10-		*	* SEE OH DR SPECNS	
103	3'-0" x 6'-8" x 1-3/4"	-	-		any mar		-			NEW HC HANDLE
104	3'-Ø" x 6'-8" x 1-3/4"	A	1	4/4-4	4/A-4	4 4	-	2	12" x 12" LOUVER	MANULI
105	2'-8" x 6'-8" x 6'-8"	А	1	4/44	4/44		-	1	NONE	
106	2'-8" × 6'-8" × 1-3/4"	A	1	4/204	4/A-4			2	NONE	
107		The Spin of the Sp		anga baran dan gertakan persona pensaharan sebuah dan terbah dan terbah pensaharan pensaharan pensaharan pensah Baran dan pensaharan pensaharan pensaharan pensaharan pensaharan pensaharan pensaharan pensaharan pensaharan pe Baran dan pensaharan pensaharan pensaharan pensaharan pensaharan pensaharan pensaharan pensaharan pensaharan pe	(a) Constanting of the constant of the cons	¹ Strate by respect to specify the set of the Strategy Strategy state is being a specify the Strategy state is being strategy and strategy str	an a	2	Bustindo or relocated	DELETE
108	3'-0" x 6'-8" x 1-3/4"	А	1	4/A-4	4/A-4			6	NONE TEXTURED FINISH HOUE	
109	3'-0" x 6'-8" x 1-3/4"	Д	1	4/4-4	4/4-4			6	NONE	
110	2'-8" x 6'-8" x 1-3/4"	A	1	2/A-4	3/A-4		_	4	NONE	
111	2'-8" x 6'-8" x 1-3/4"						-	1 -	EXISTING DOOR/FRAME	
112	3'-0" x 6'-8" x 1-3/4"	А	1	4/A-4	4/A-4			5	NONE	
113	3'-Ø" x 6'-8" x 1-3/4"	A	1	2/4-4	3/A-4			1	NONE	
114	3'-0" x 6'-8" x 1-3/4"	A	1	4/A-4	4/A-4	•• ••		1	NONE	
115	3'-Ø" x 6'-8" x 1-3/4"	A	1	4/A-4	4/A-4		-	1	NONE	
116	3'-0" × 6'-8" × 1-3/4"	А	1	2/A-4	3/A-4			3	NONE	
1177	3'-0" x 6'-8" x 1-3/4"	А	1	2/A-4	3/A-4			3	NONE	
118	3'-Ø" x 6'-8" x 1-3/4"	А	-			er 10	-	-	REAL PRODUCTION OF THE PRODUCT	NEW HC
119	3'-0" x 6'-8" x 1-3/4"	-	-			*	-		NEW HC LEVER HANDLE	
			•							

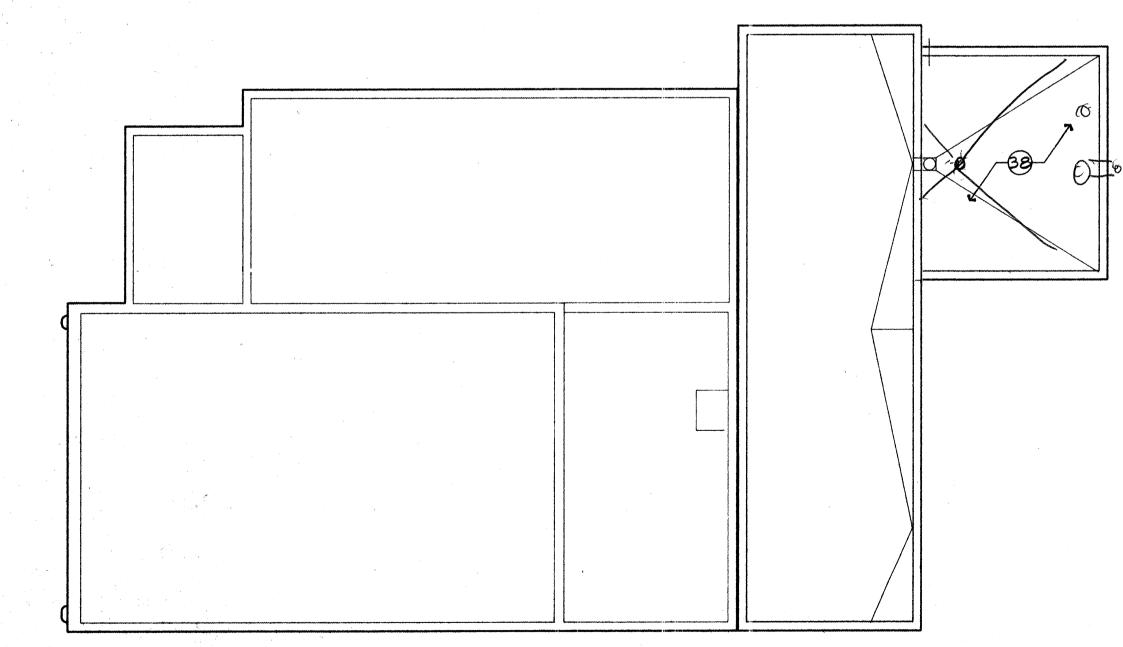



ROOF PLAN

SCALE: 1/8" = 1'-0"

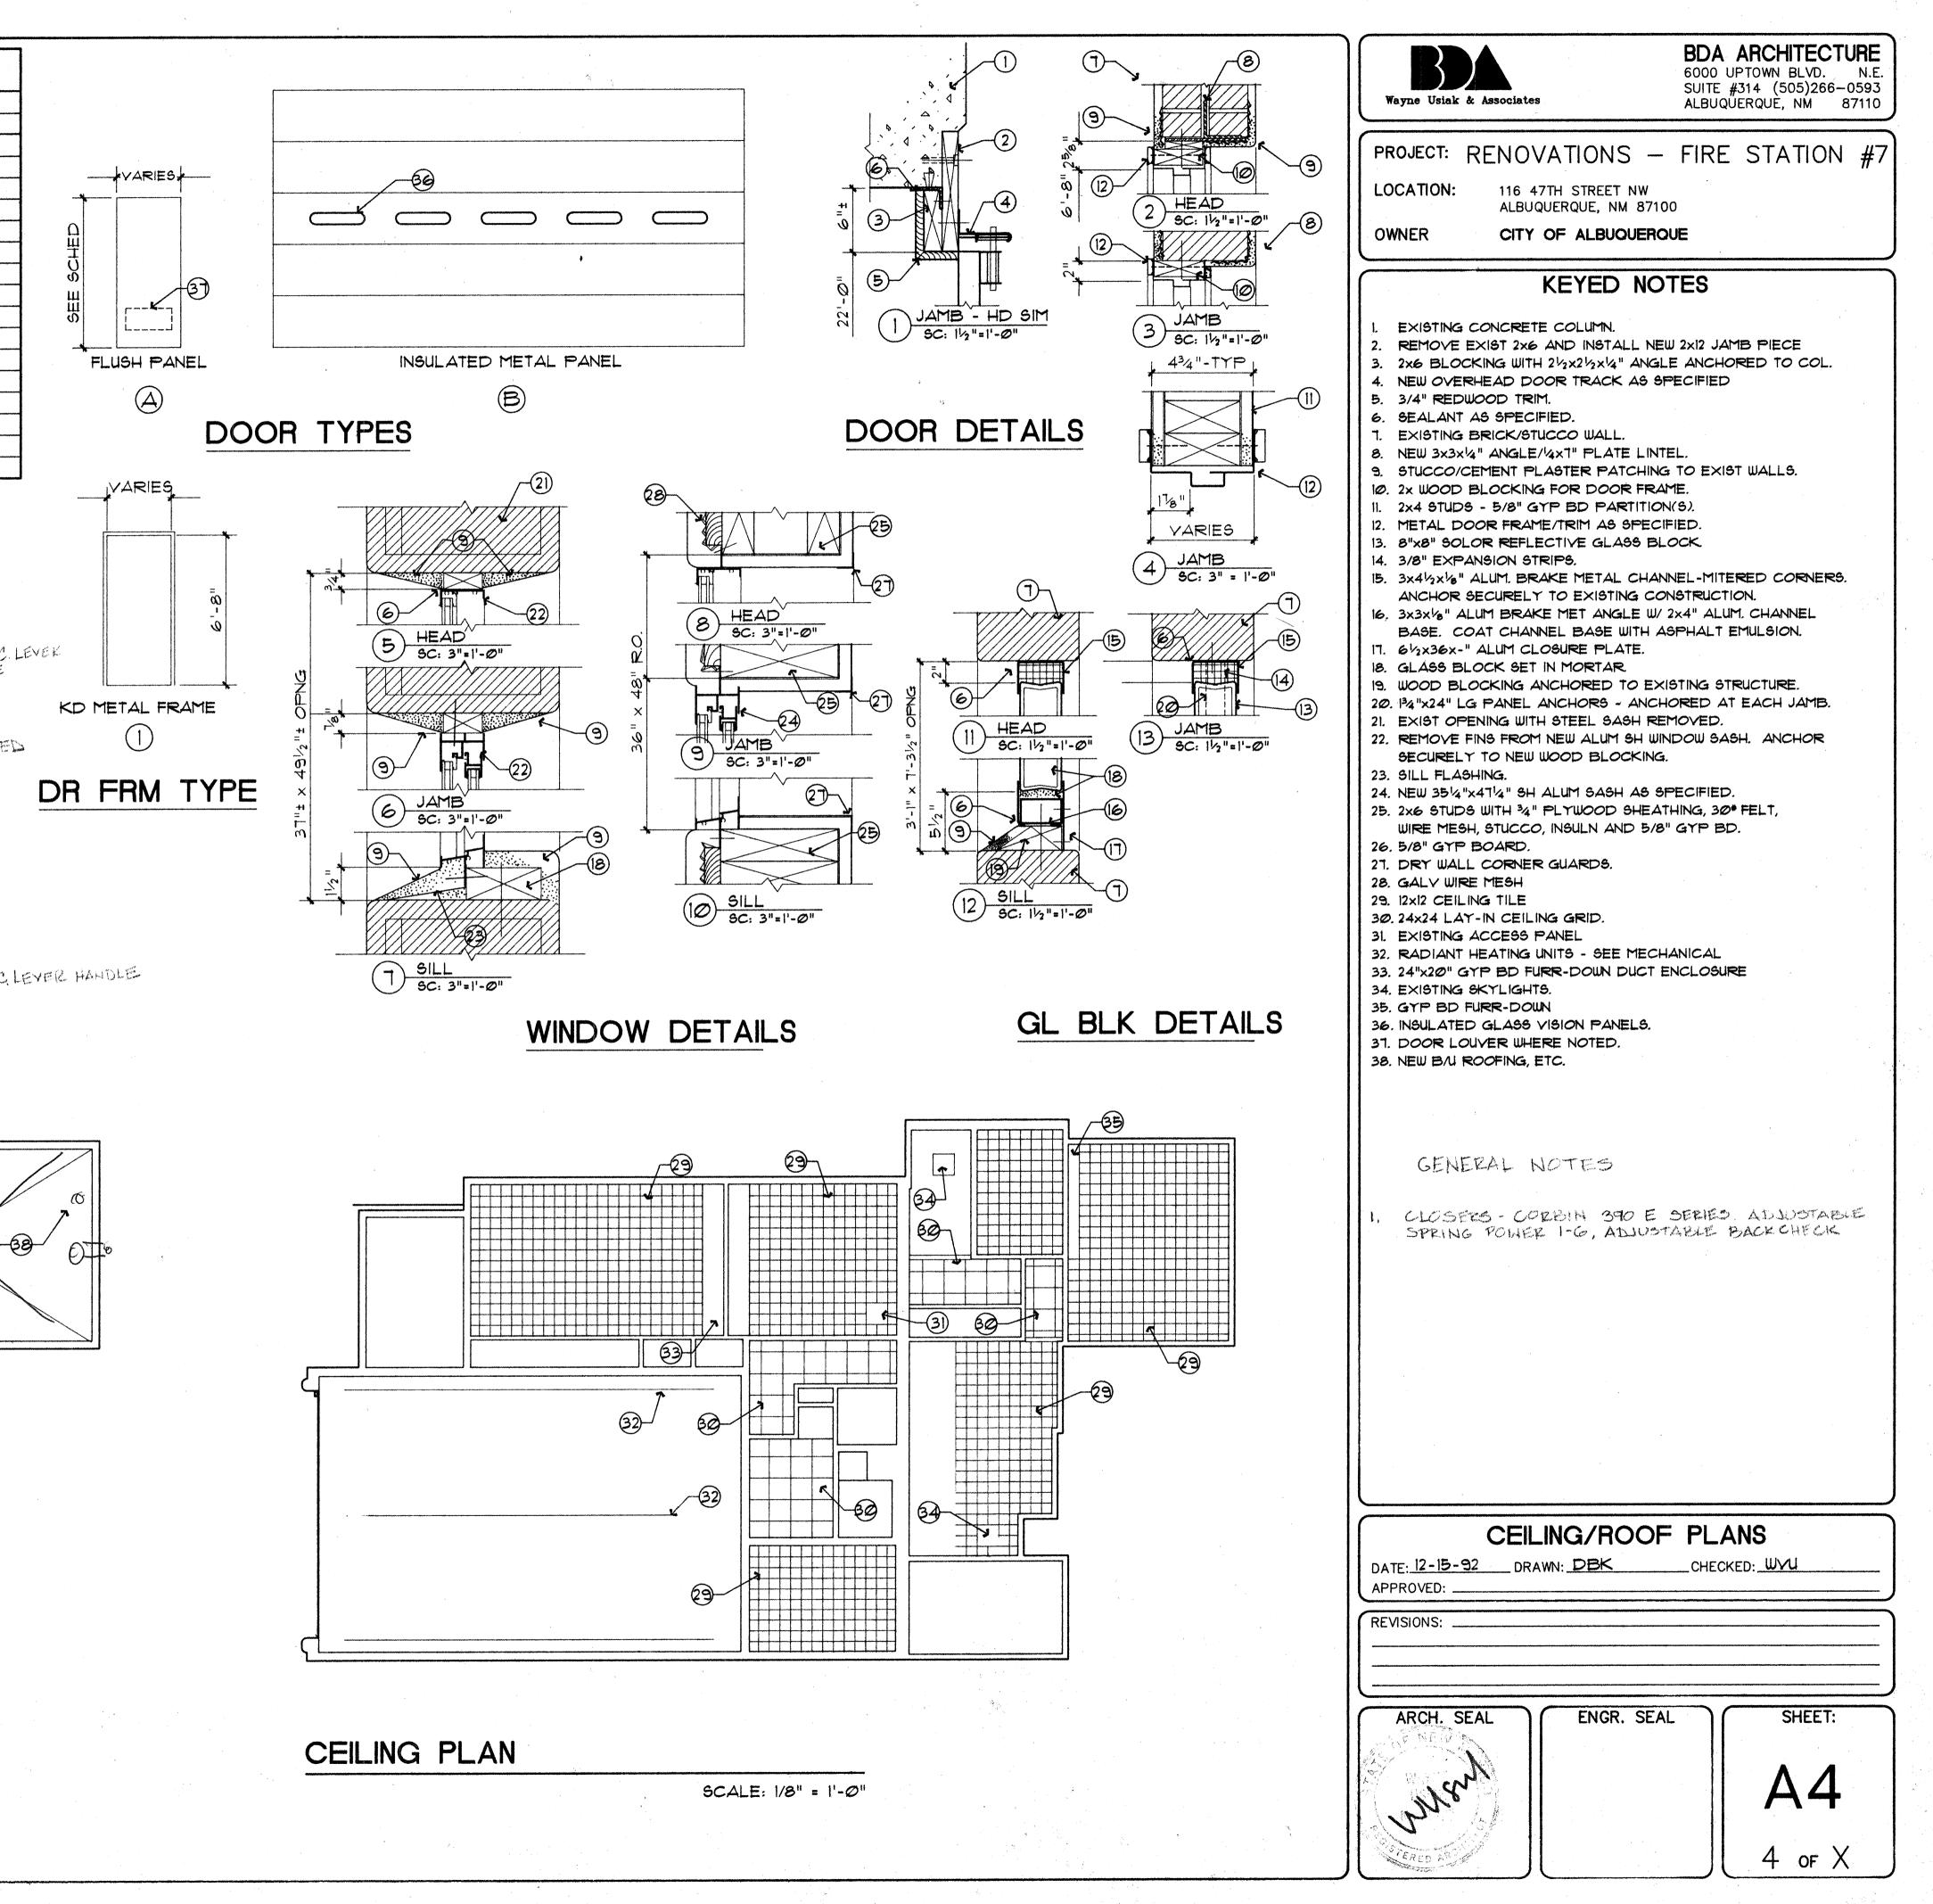

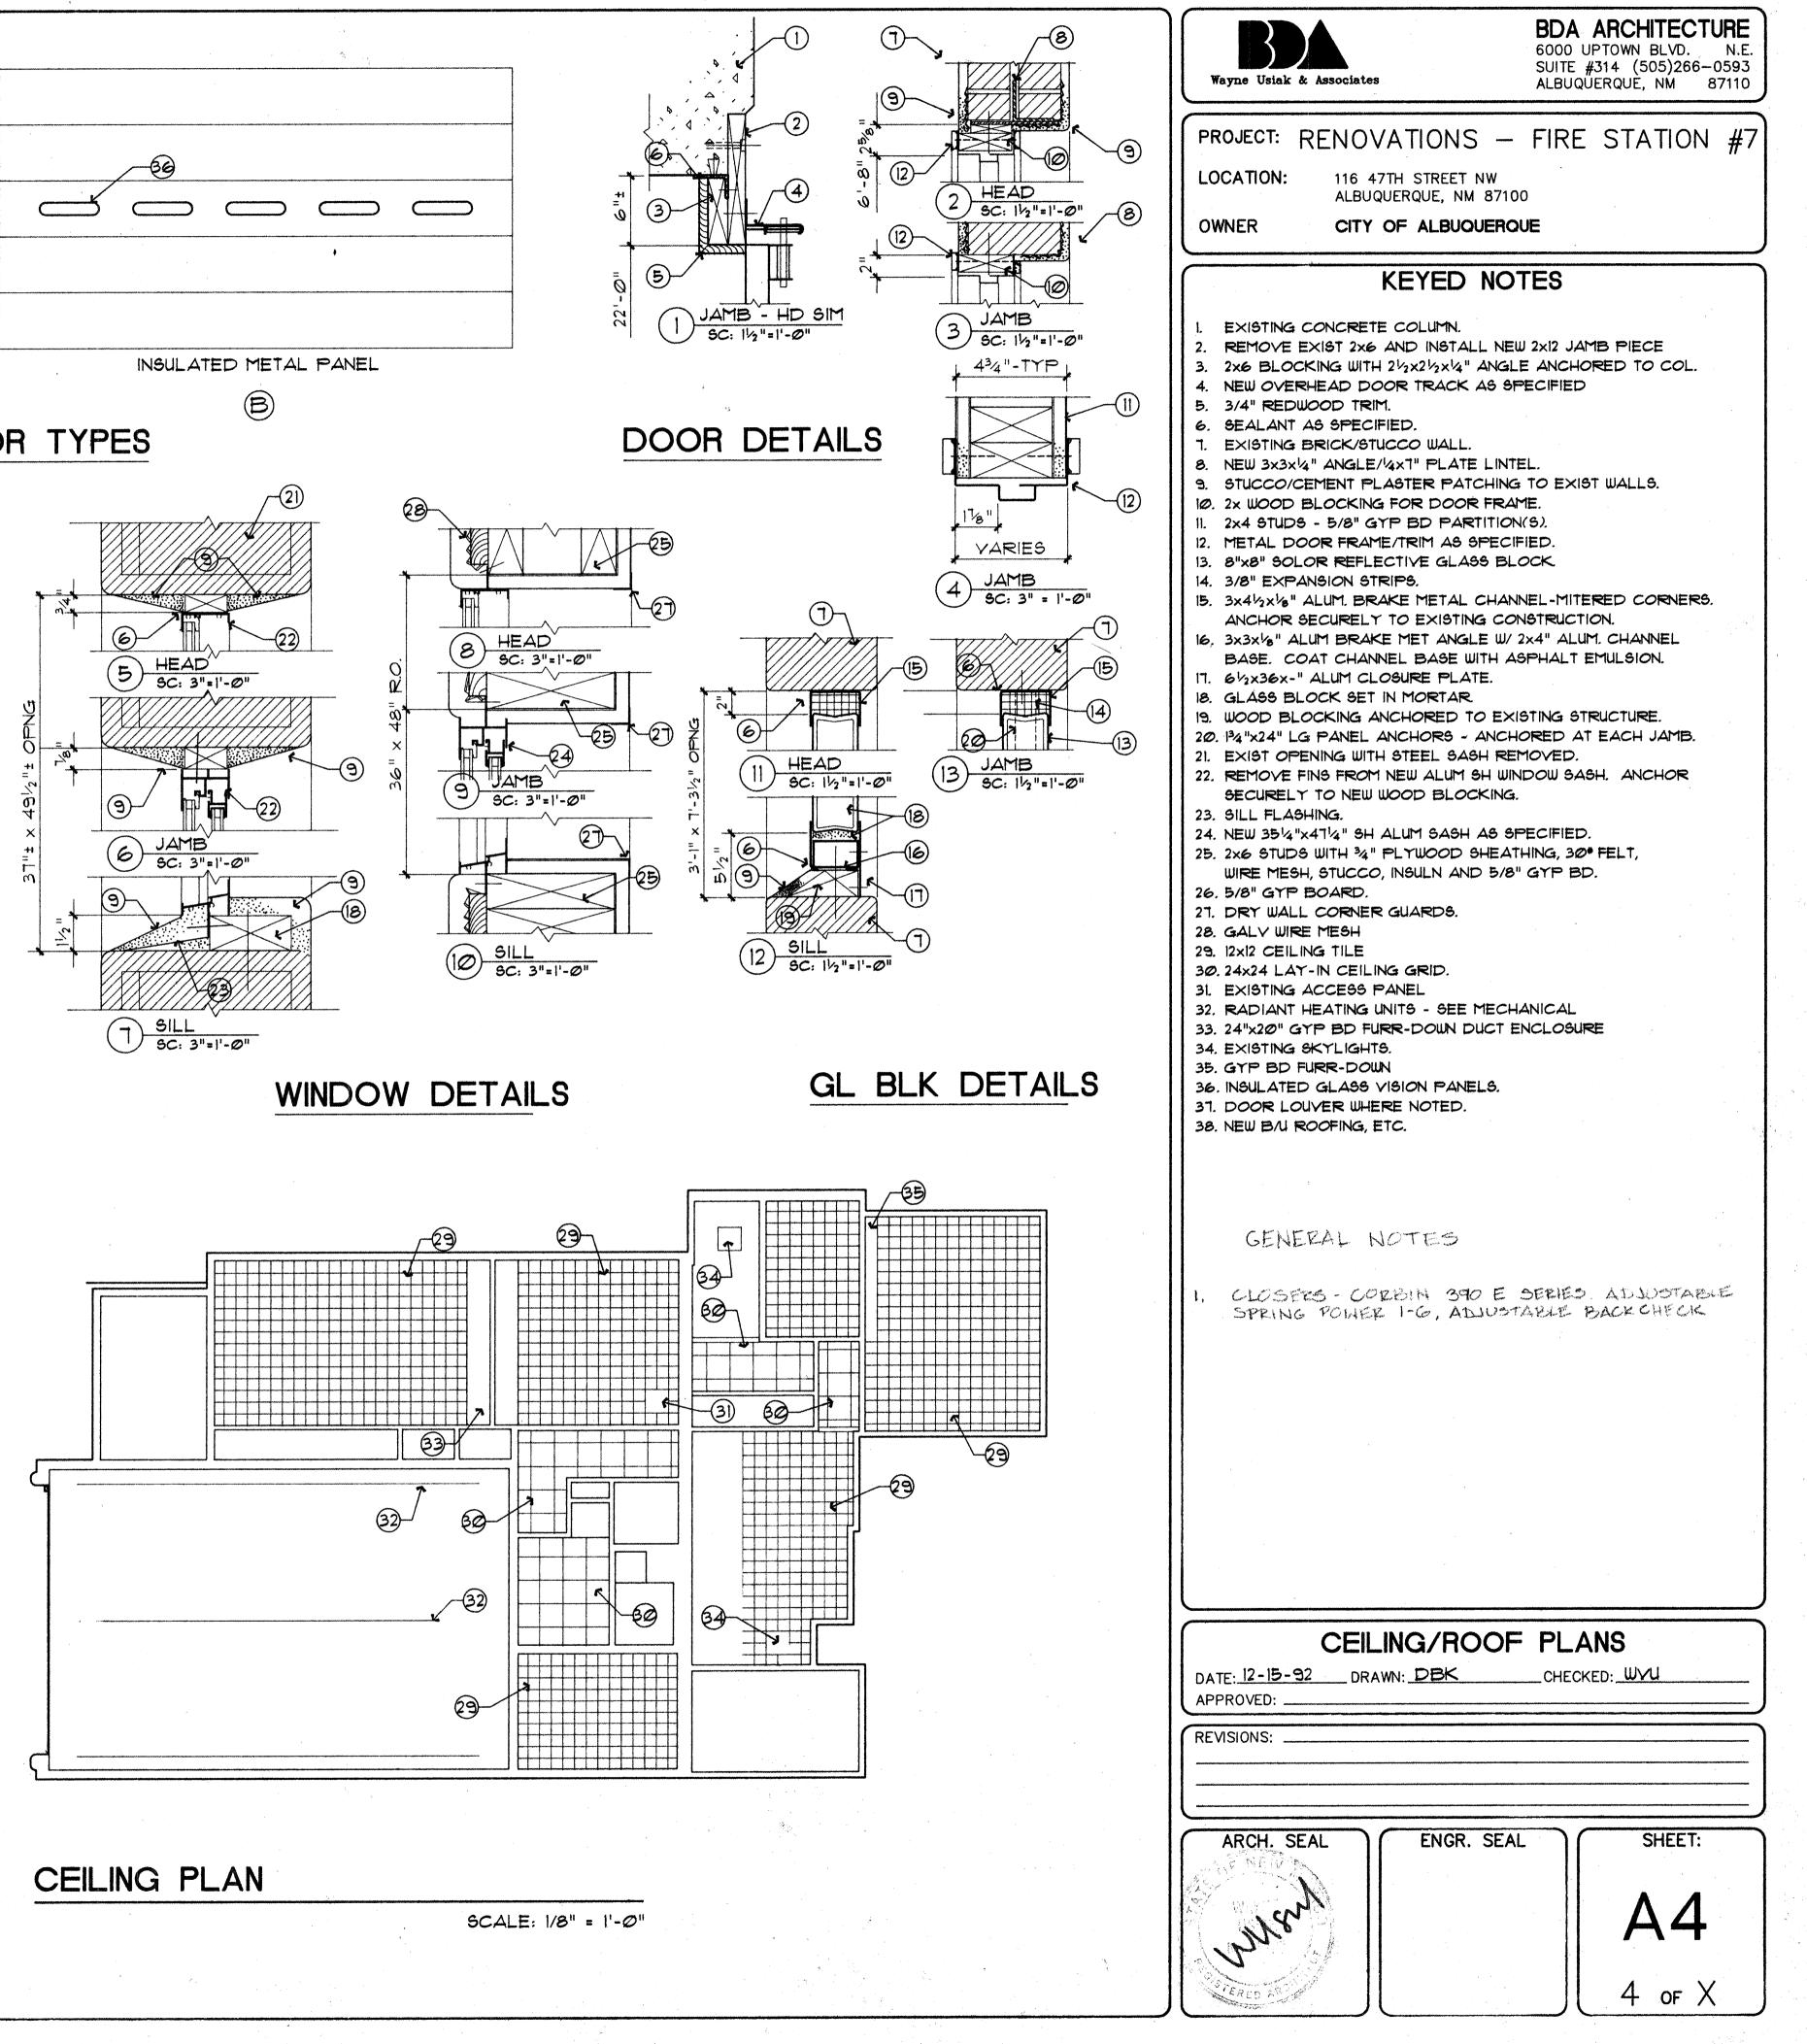

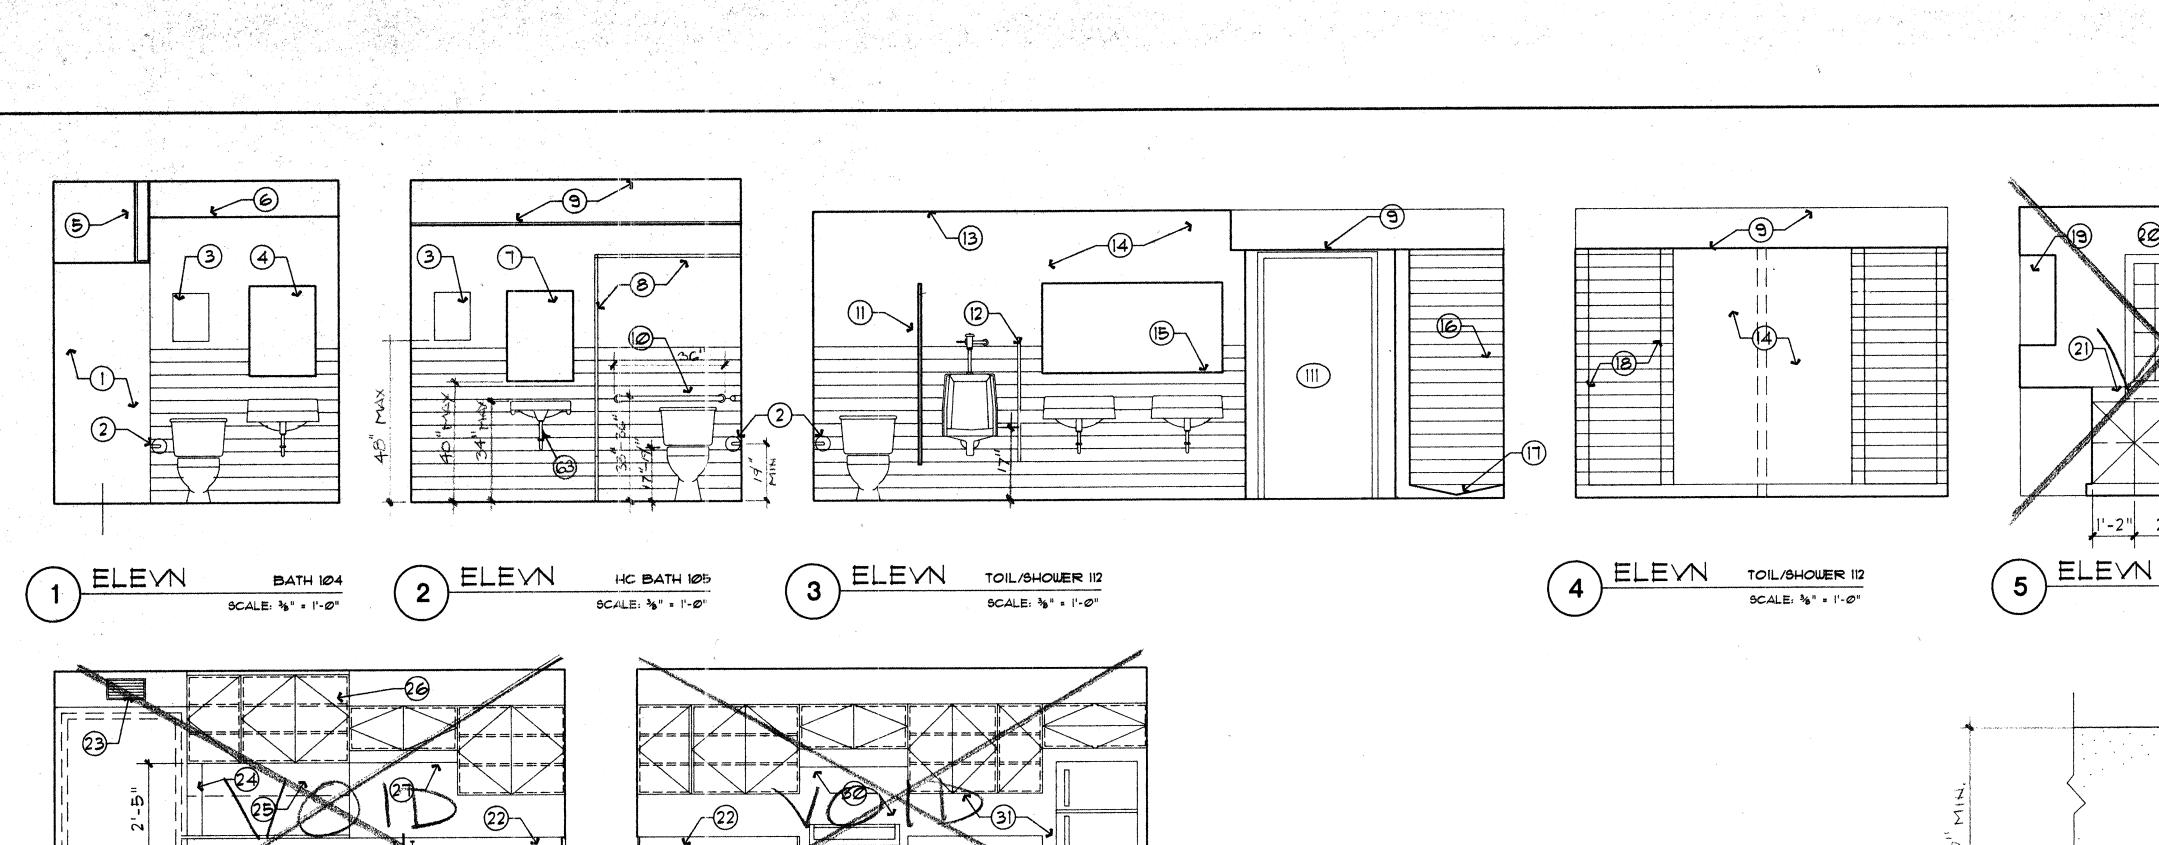

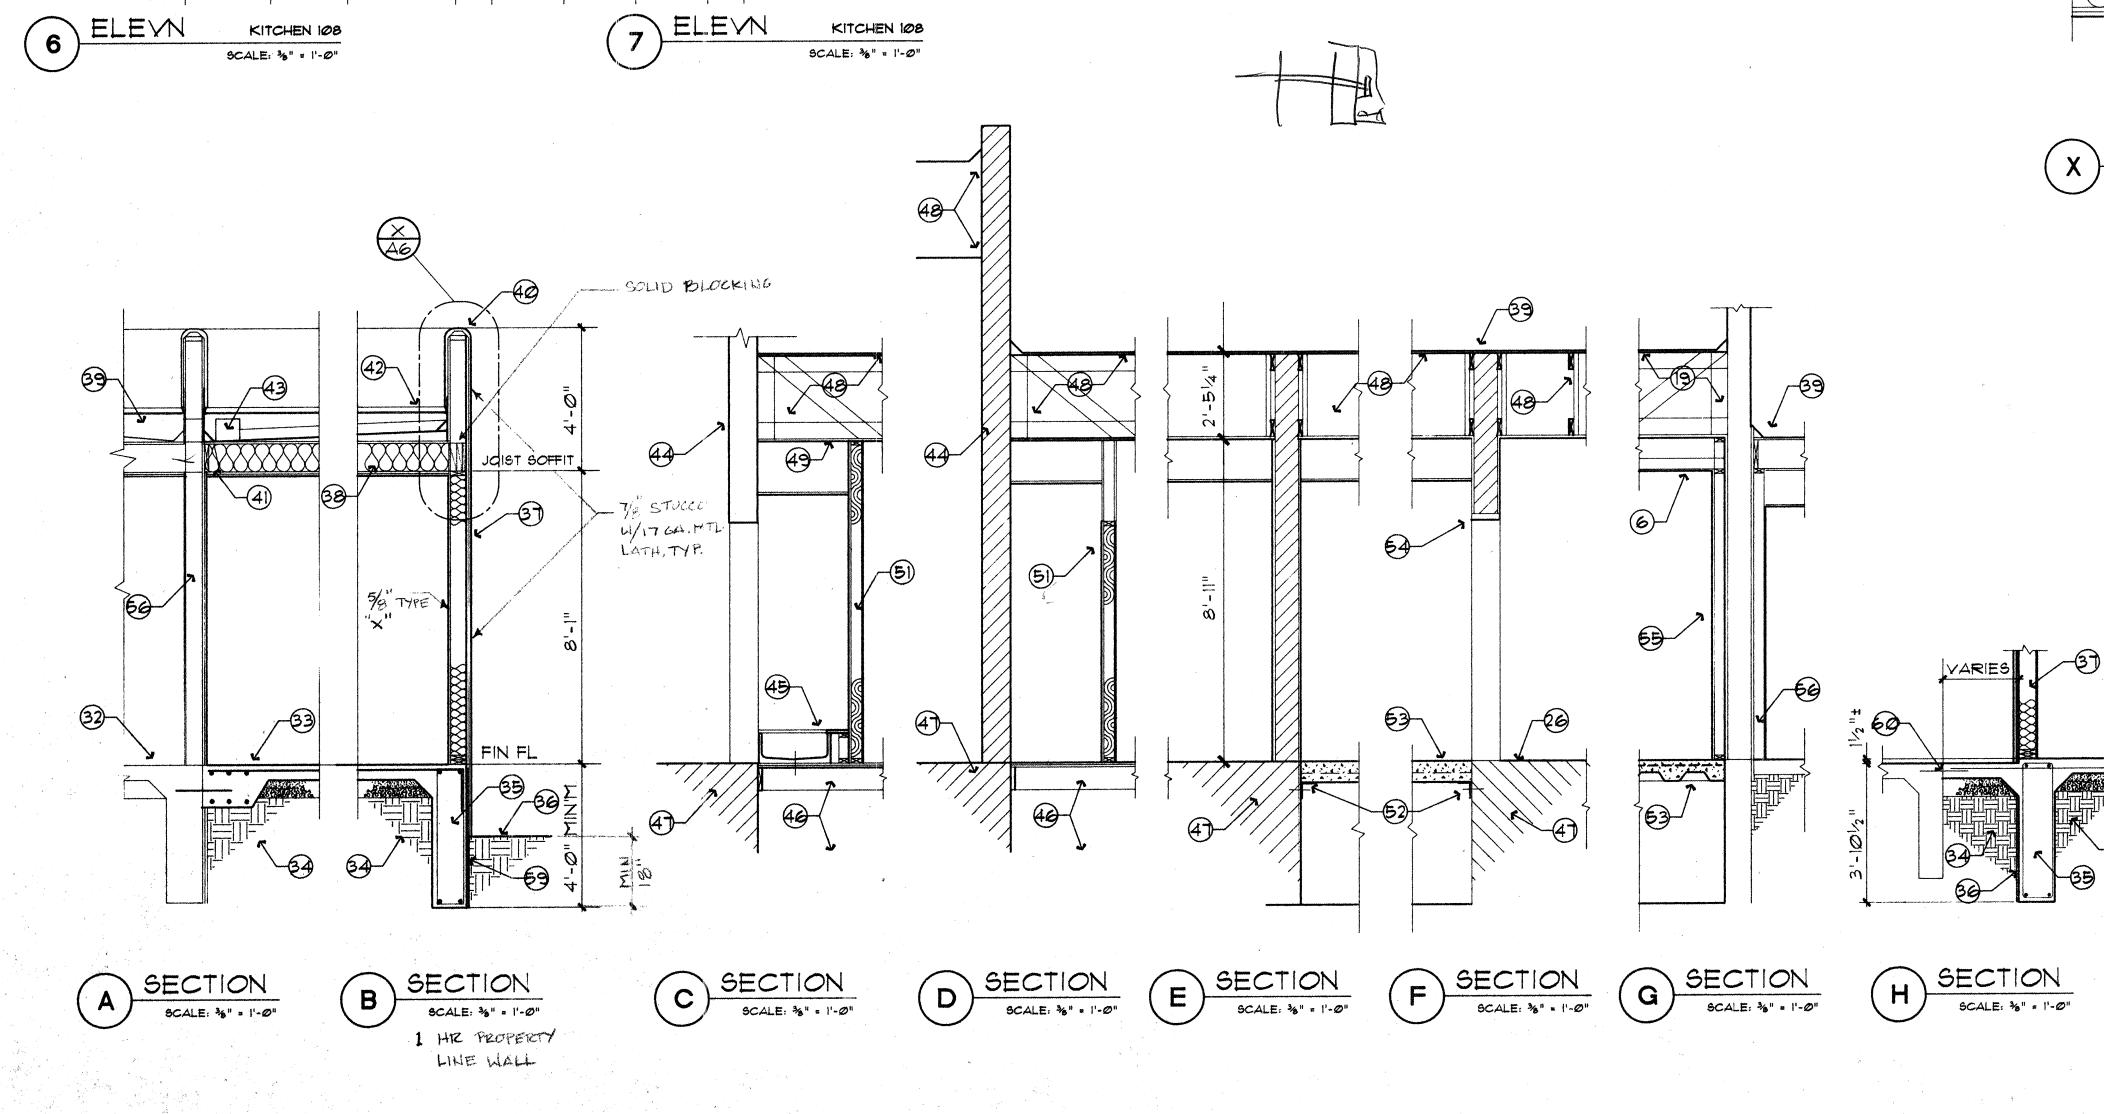

12" 2'-Ø"

2'-Ø"

KITCHEN 108


2'-4"


2'-Ø"

ELEVN


KITCHEN 108

17.08

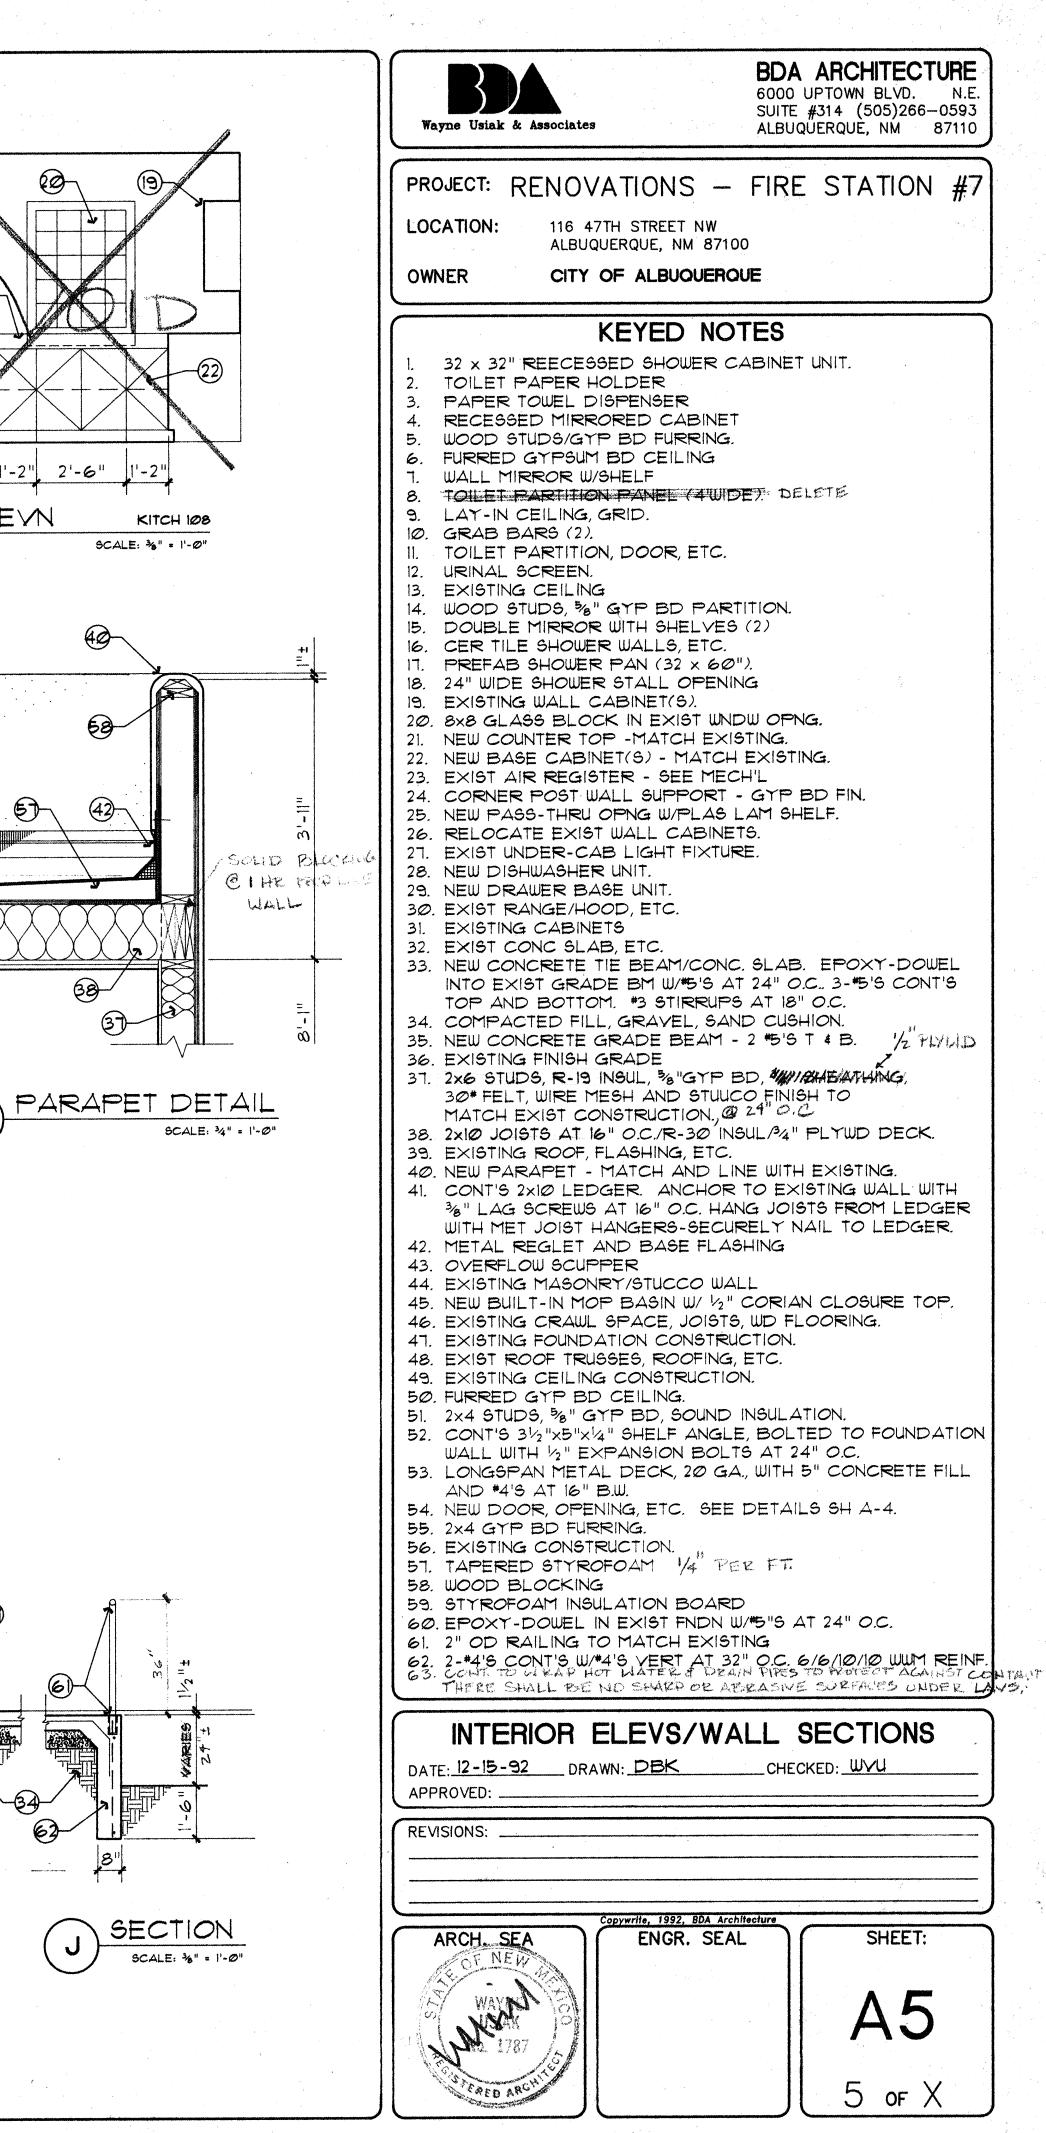


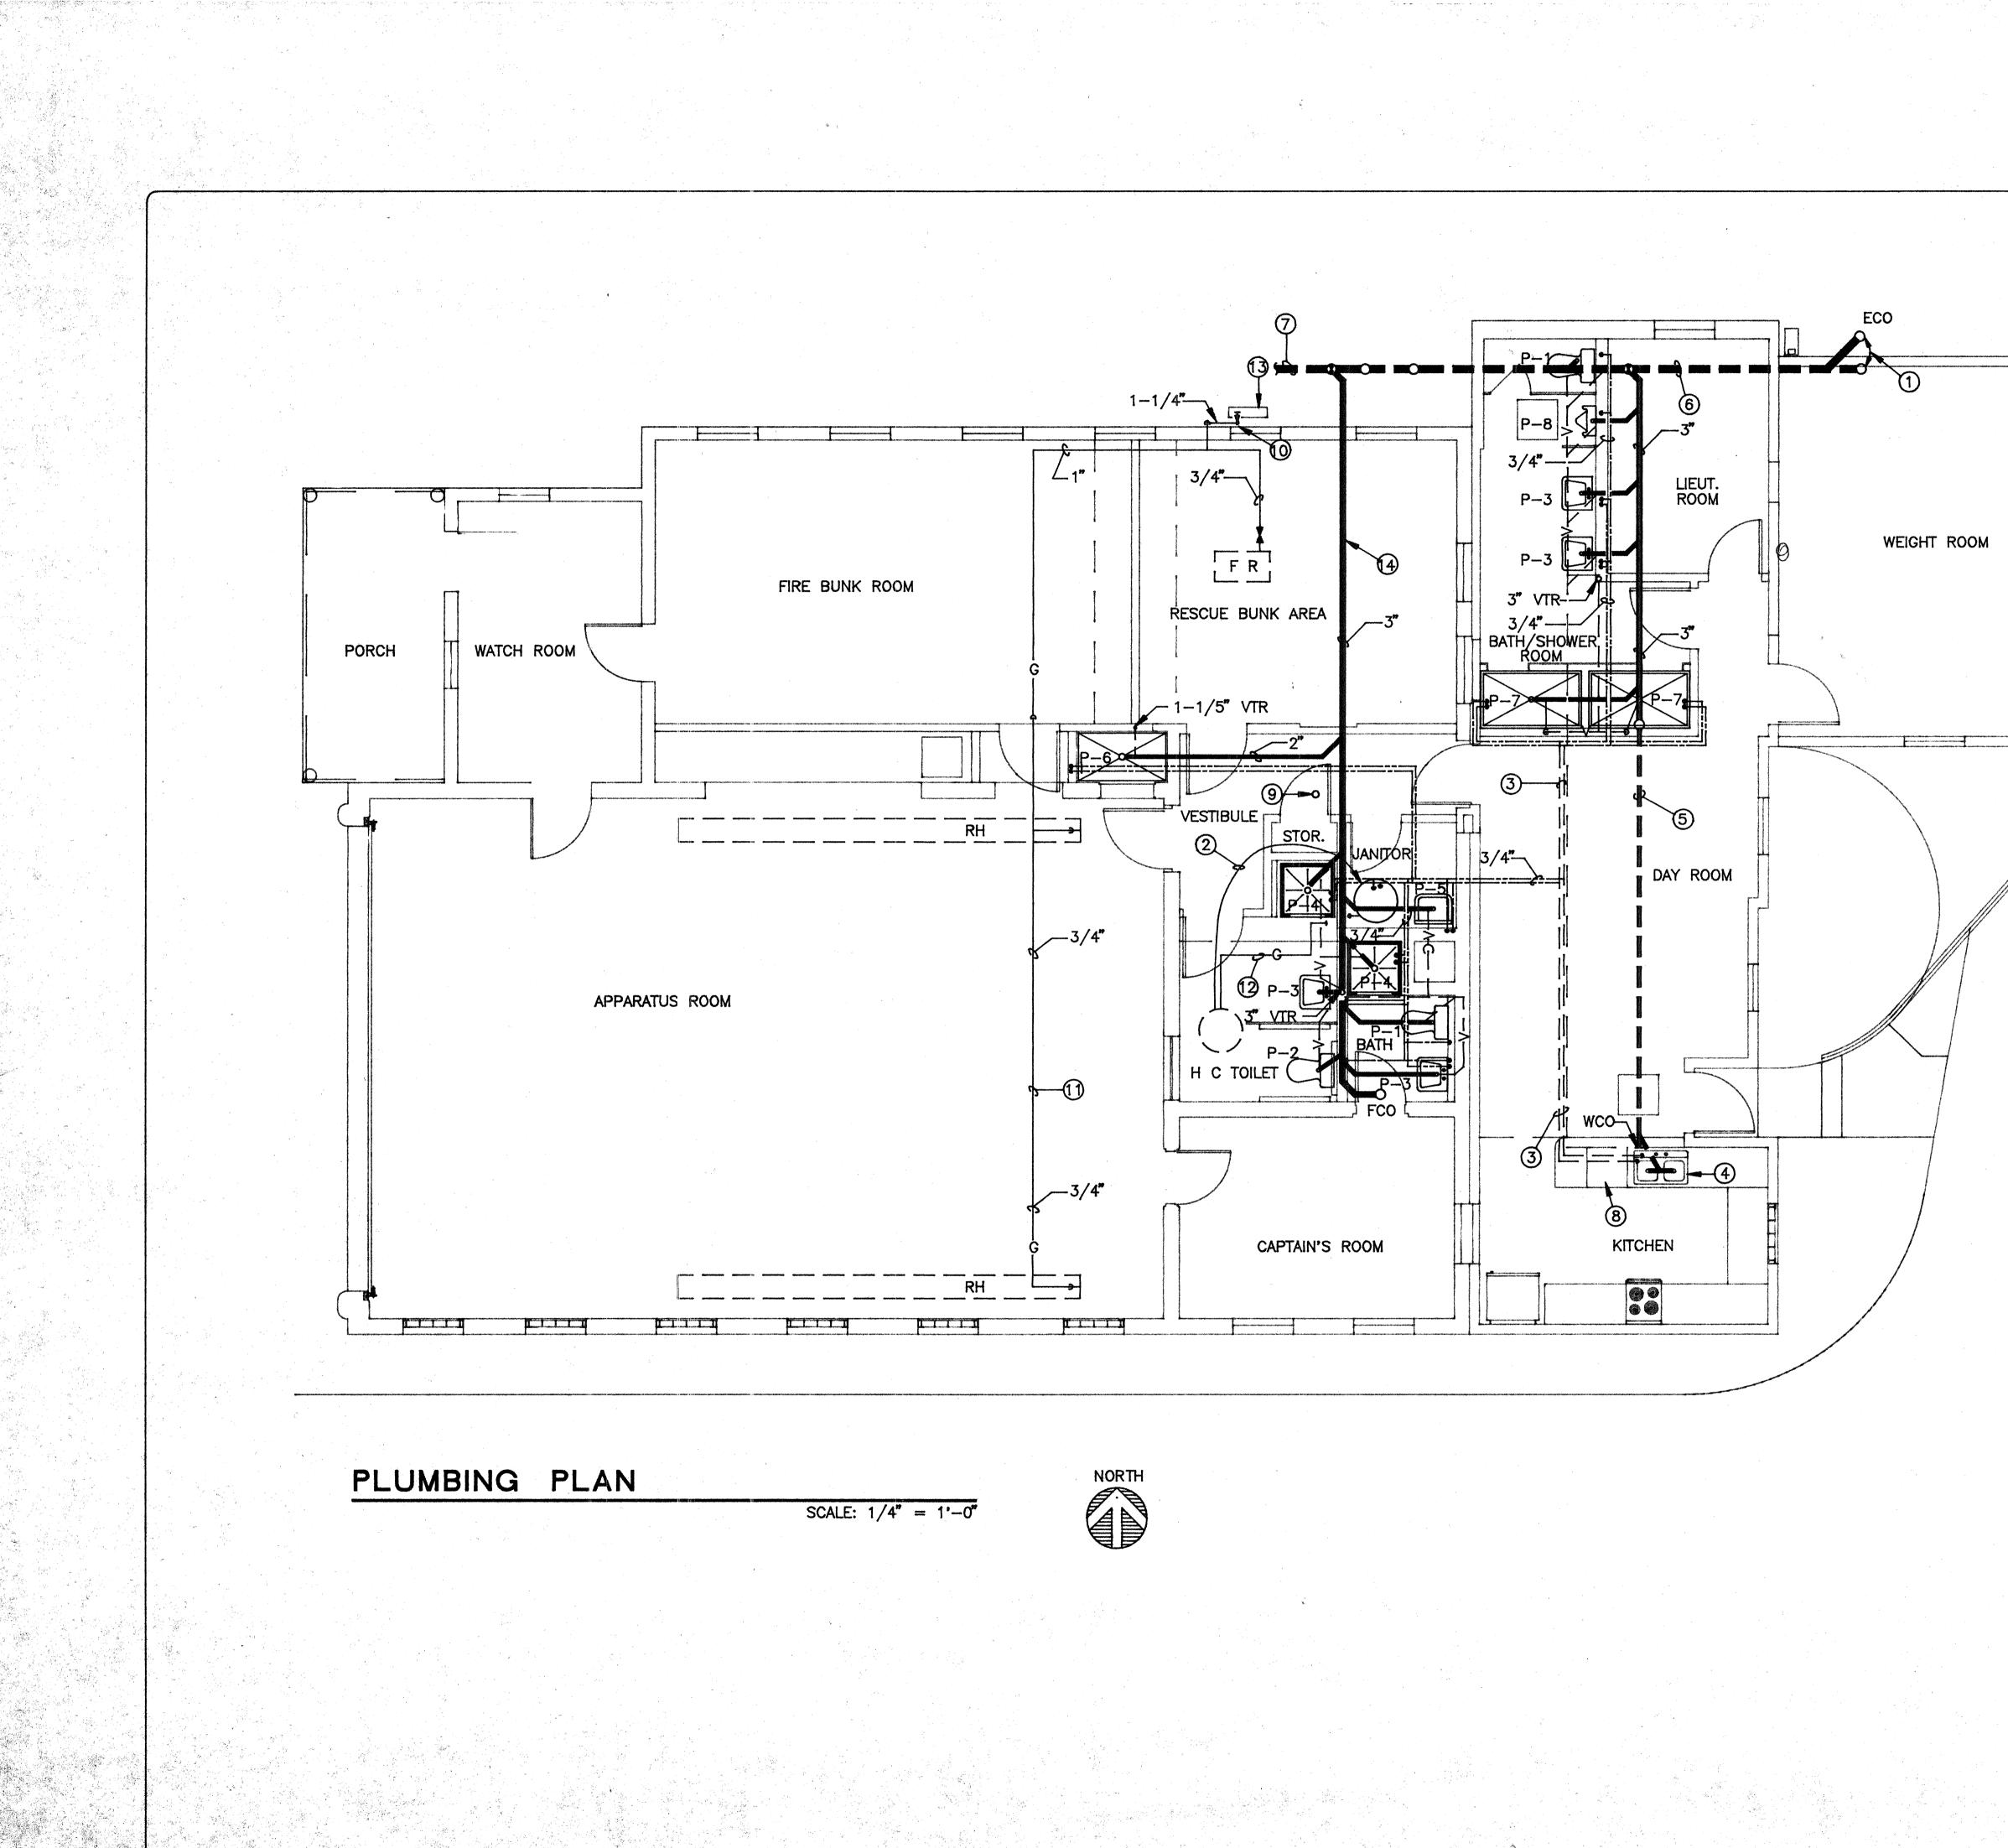



B Wayne Usiak & Associates Wayne Usiak & Associates B Wayne Usiak & Associates B B B B B B B B B B B B B B B B B B B
PROJECT: RENOVATIONS - FIRE STATION #7 LOCATION: 116 47TH STREET NW ALBUQUERQUE, NM 87100
OWNER CITY OF ALBUQUERQUE
KEYED NOTES ^{1.} RELOCATE EXISTING EXTERIOR CLEAN-OUT TO OUTSIDE THE NEW BUILDING ADDITION. ^{2.} RELOCATE EXISTING 50 GALLON WATER HEATER TO NEW LOCATION. CAP GAS, HOT WATER & COLD WATER LINES ABOVE CEILING. ^{3.} EXISTING 3/4" HOT AND COLD WATER LINES ABOVE CEILING TO REMAIN.
 ⁴-EXISTING SINK TO REMAIN. RECONNECT HOT & COLD WATER, VENT & SEWER LINES TO NEW DISHWASHER. SEE KEYED NOTE 8. ⁵-EXISTING 2" SEWER LINE TO REMAIN. ⁶-EXISTING 4" SEWER LINE TO REMAIN. ⁷-EXISTING 4" SEWER LINE TO OUTSIDE THE BUILDING TO REMAIN. ⁸ NEW DISHWASHER BY OTHERS, CONNECT COLD WATER TO EXISTING SINK COLD WATER LINE & WASTE WATER DISCHARGE TO THE FIXTURE SIDE OF THE EXISTING P-TRAP. INSTALL NEW VACUUM BREAKER ON EXISTING SINK AS REQUIRED. ⁹. EXISTING FLOOR DRAIN TO BE REMOVED. CAP SEWER PIPE BELOW FINISHED FLOOR. ¹⁰CONNECT NEW GAS LINE TO HOUSE SIDE OF THE EXISTING GAS METER UPSTREAM OF THE SHUT OFF VALVE.
METER UPSTREAM OF THE SHUT OFF VALVE. 11NEW GAS LINE ON THE ROOF. 12RECONNECT EXISTING 3/4" GAS LINE TO WATER HEATER AT NEW LOCATION WITH DIRT LEG & GAS COCK. 13EXISTING GAS METER SET FOR NEW LOAD OF 625 CFH & CHANGE DISCHARGE LINE TO 1-1/4" UP TO THE ROOF BRANCH. SEE KEYED NOTE 10.
14RUN NEW SEWER LINE INSIDE CRAWL SPACE. FIELD VERIFY LOCATION OF CRAWL SPACE.
PLUMBING PLAN
APPROVED:
ARCH. SEAL ENGR. SEAL SHEET:

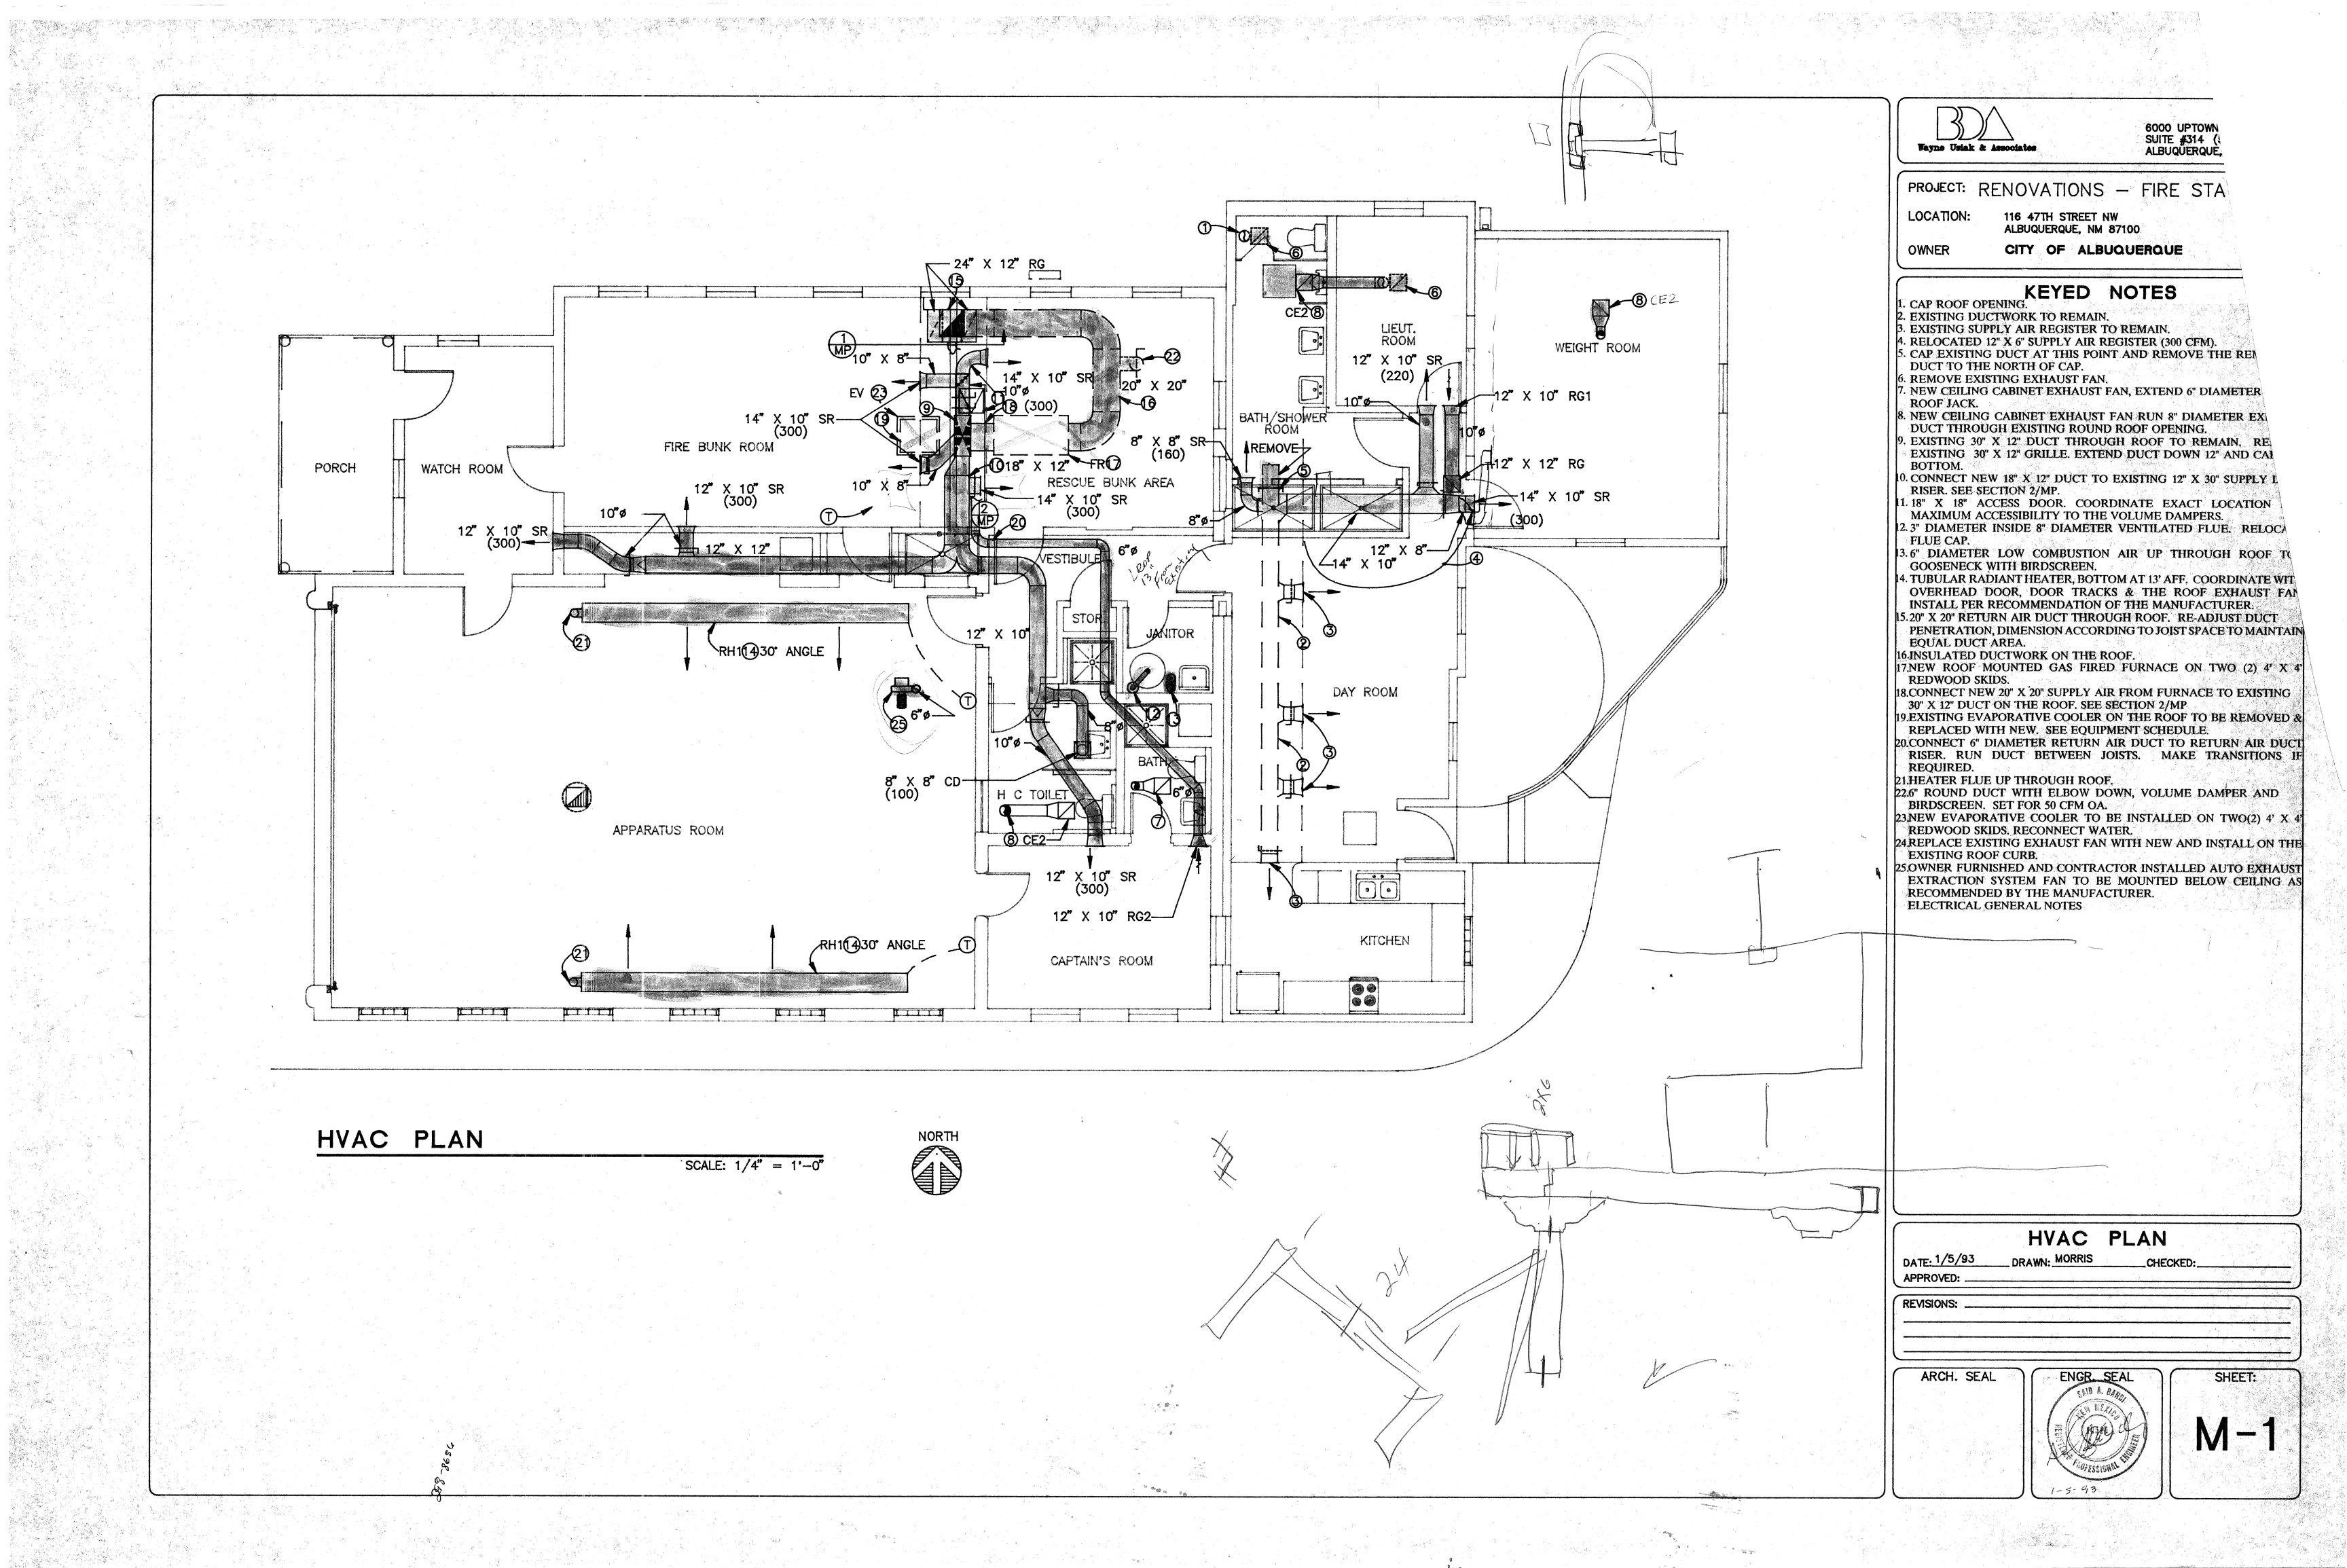


MECHANICAL LEGEND ABOVE FINISHED FLOOR A.F.F. AIR QUANTITY IN C.F.M. BALANCING DAMPER. DOMESTIC COLD WATER (INTERIOR) CO CLEAN OUT. DROP IN PIPING. DROP IN PIPING. J. ECO EXTERNAL CLEAN OUT ELECTRICAL CONTRACTOR. EC POINT OF CONNECTION, NEW TO EXISTING. FCO FLOOR CLEAN OUT. FD FLOOR DRAIN. FLANGED CONNECTION. FLEX CONNECTION FIRE DAMPER. NATURAL GAS PIPING. GATE VALVE. $\mathbf{\nabla}$ GENERAL CONTRACTOR. GC 6"Ø RA DUCT DOMESTIC HOT WATER MECHANICAL CONTRACTOR. MC 12" X 18" NIC NOT IN CONTRACT. NTS NOT TO SCALE. OA OUTSIDE AIR. RA RETURN AIR. RECIRCULATING HOT WATER. _____ EXHAUST OR RETURN AIR. RETURN DUCT, SECTION RISE IN PIPING. SUPPLY AIR. SA SOIL OR WASTE PIPING (INTERIOR) SUPPLY AIR. SUPPLY DUCT, SECTION. THERMOSTAT. (T)UNION. VALVE IN VERTICAL PIPE. VENT PIPING. VTR VENT THROUGH ROOF. TURNING VANES. It

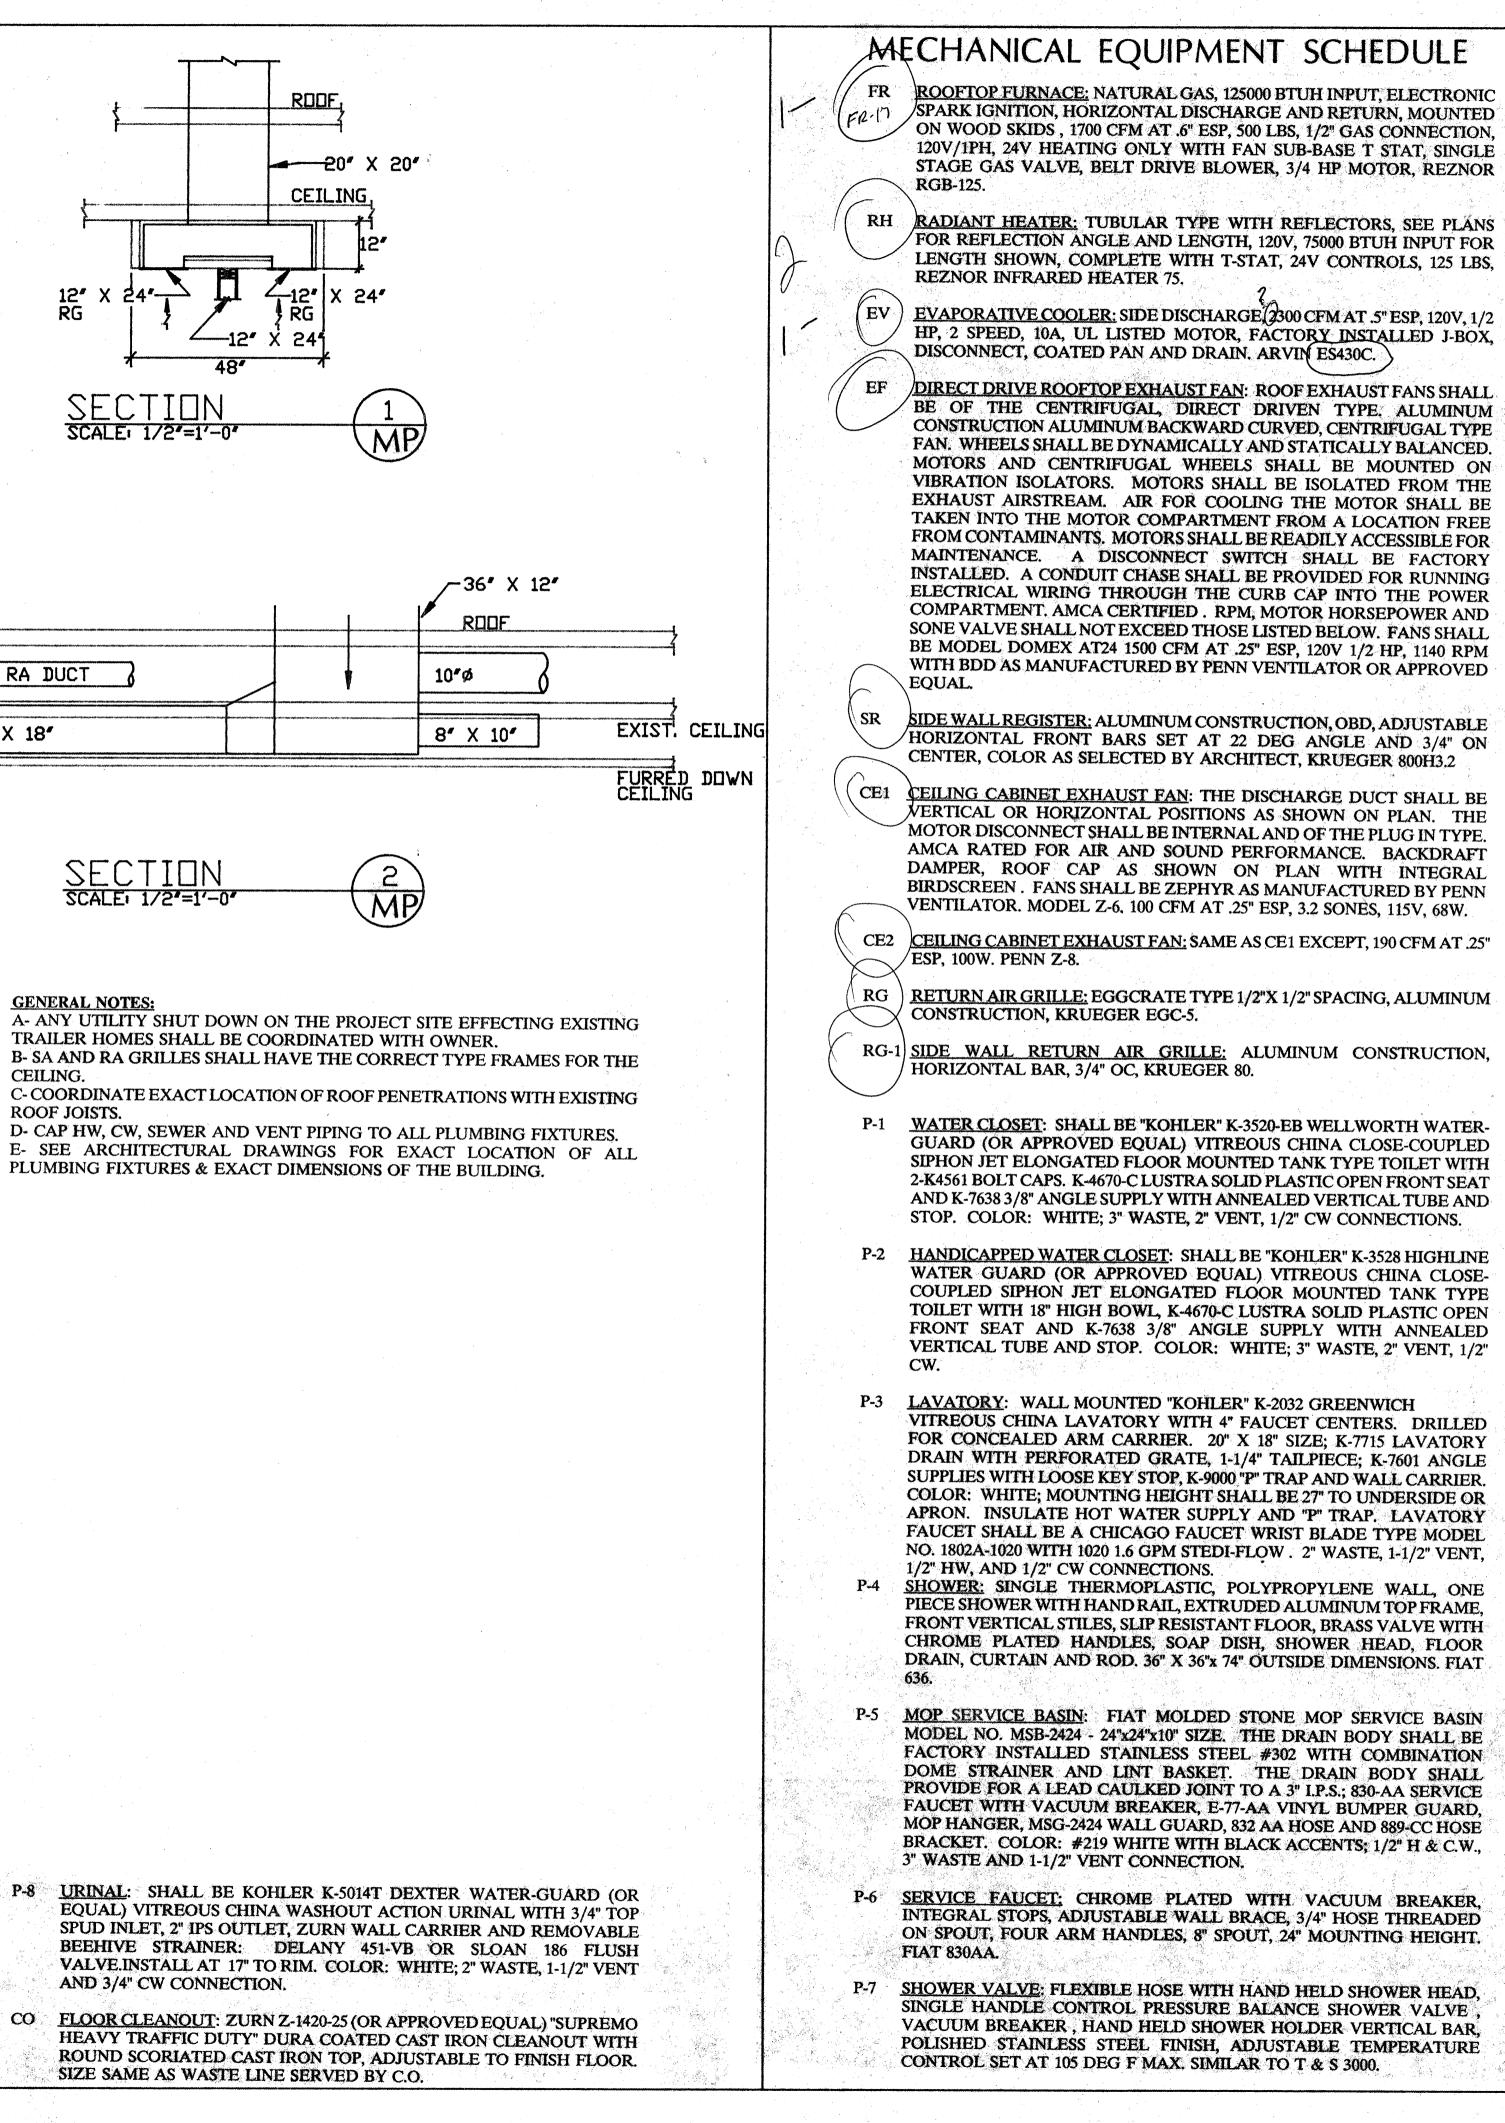


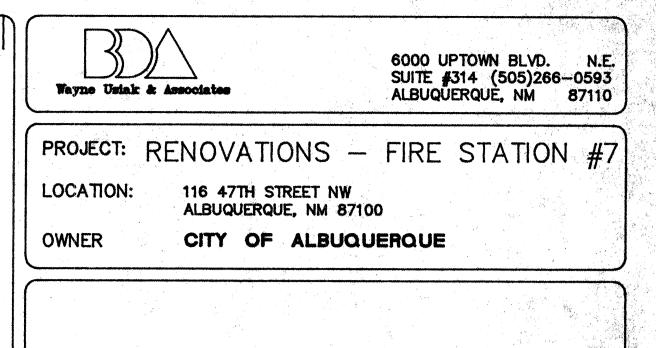

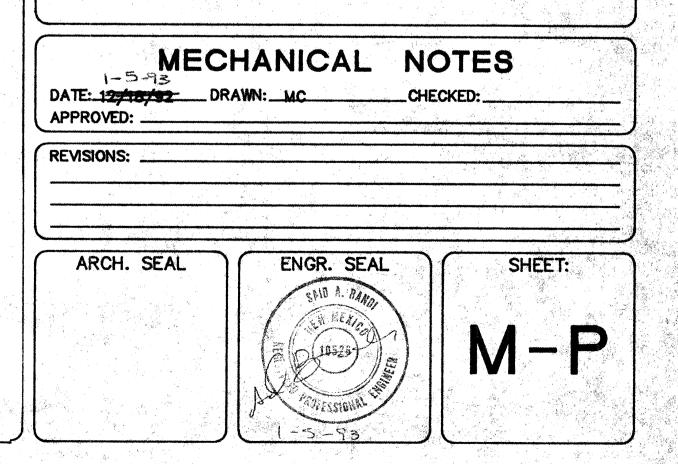

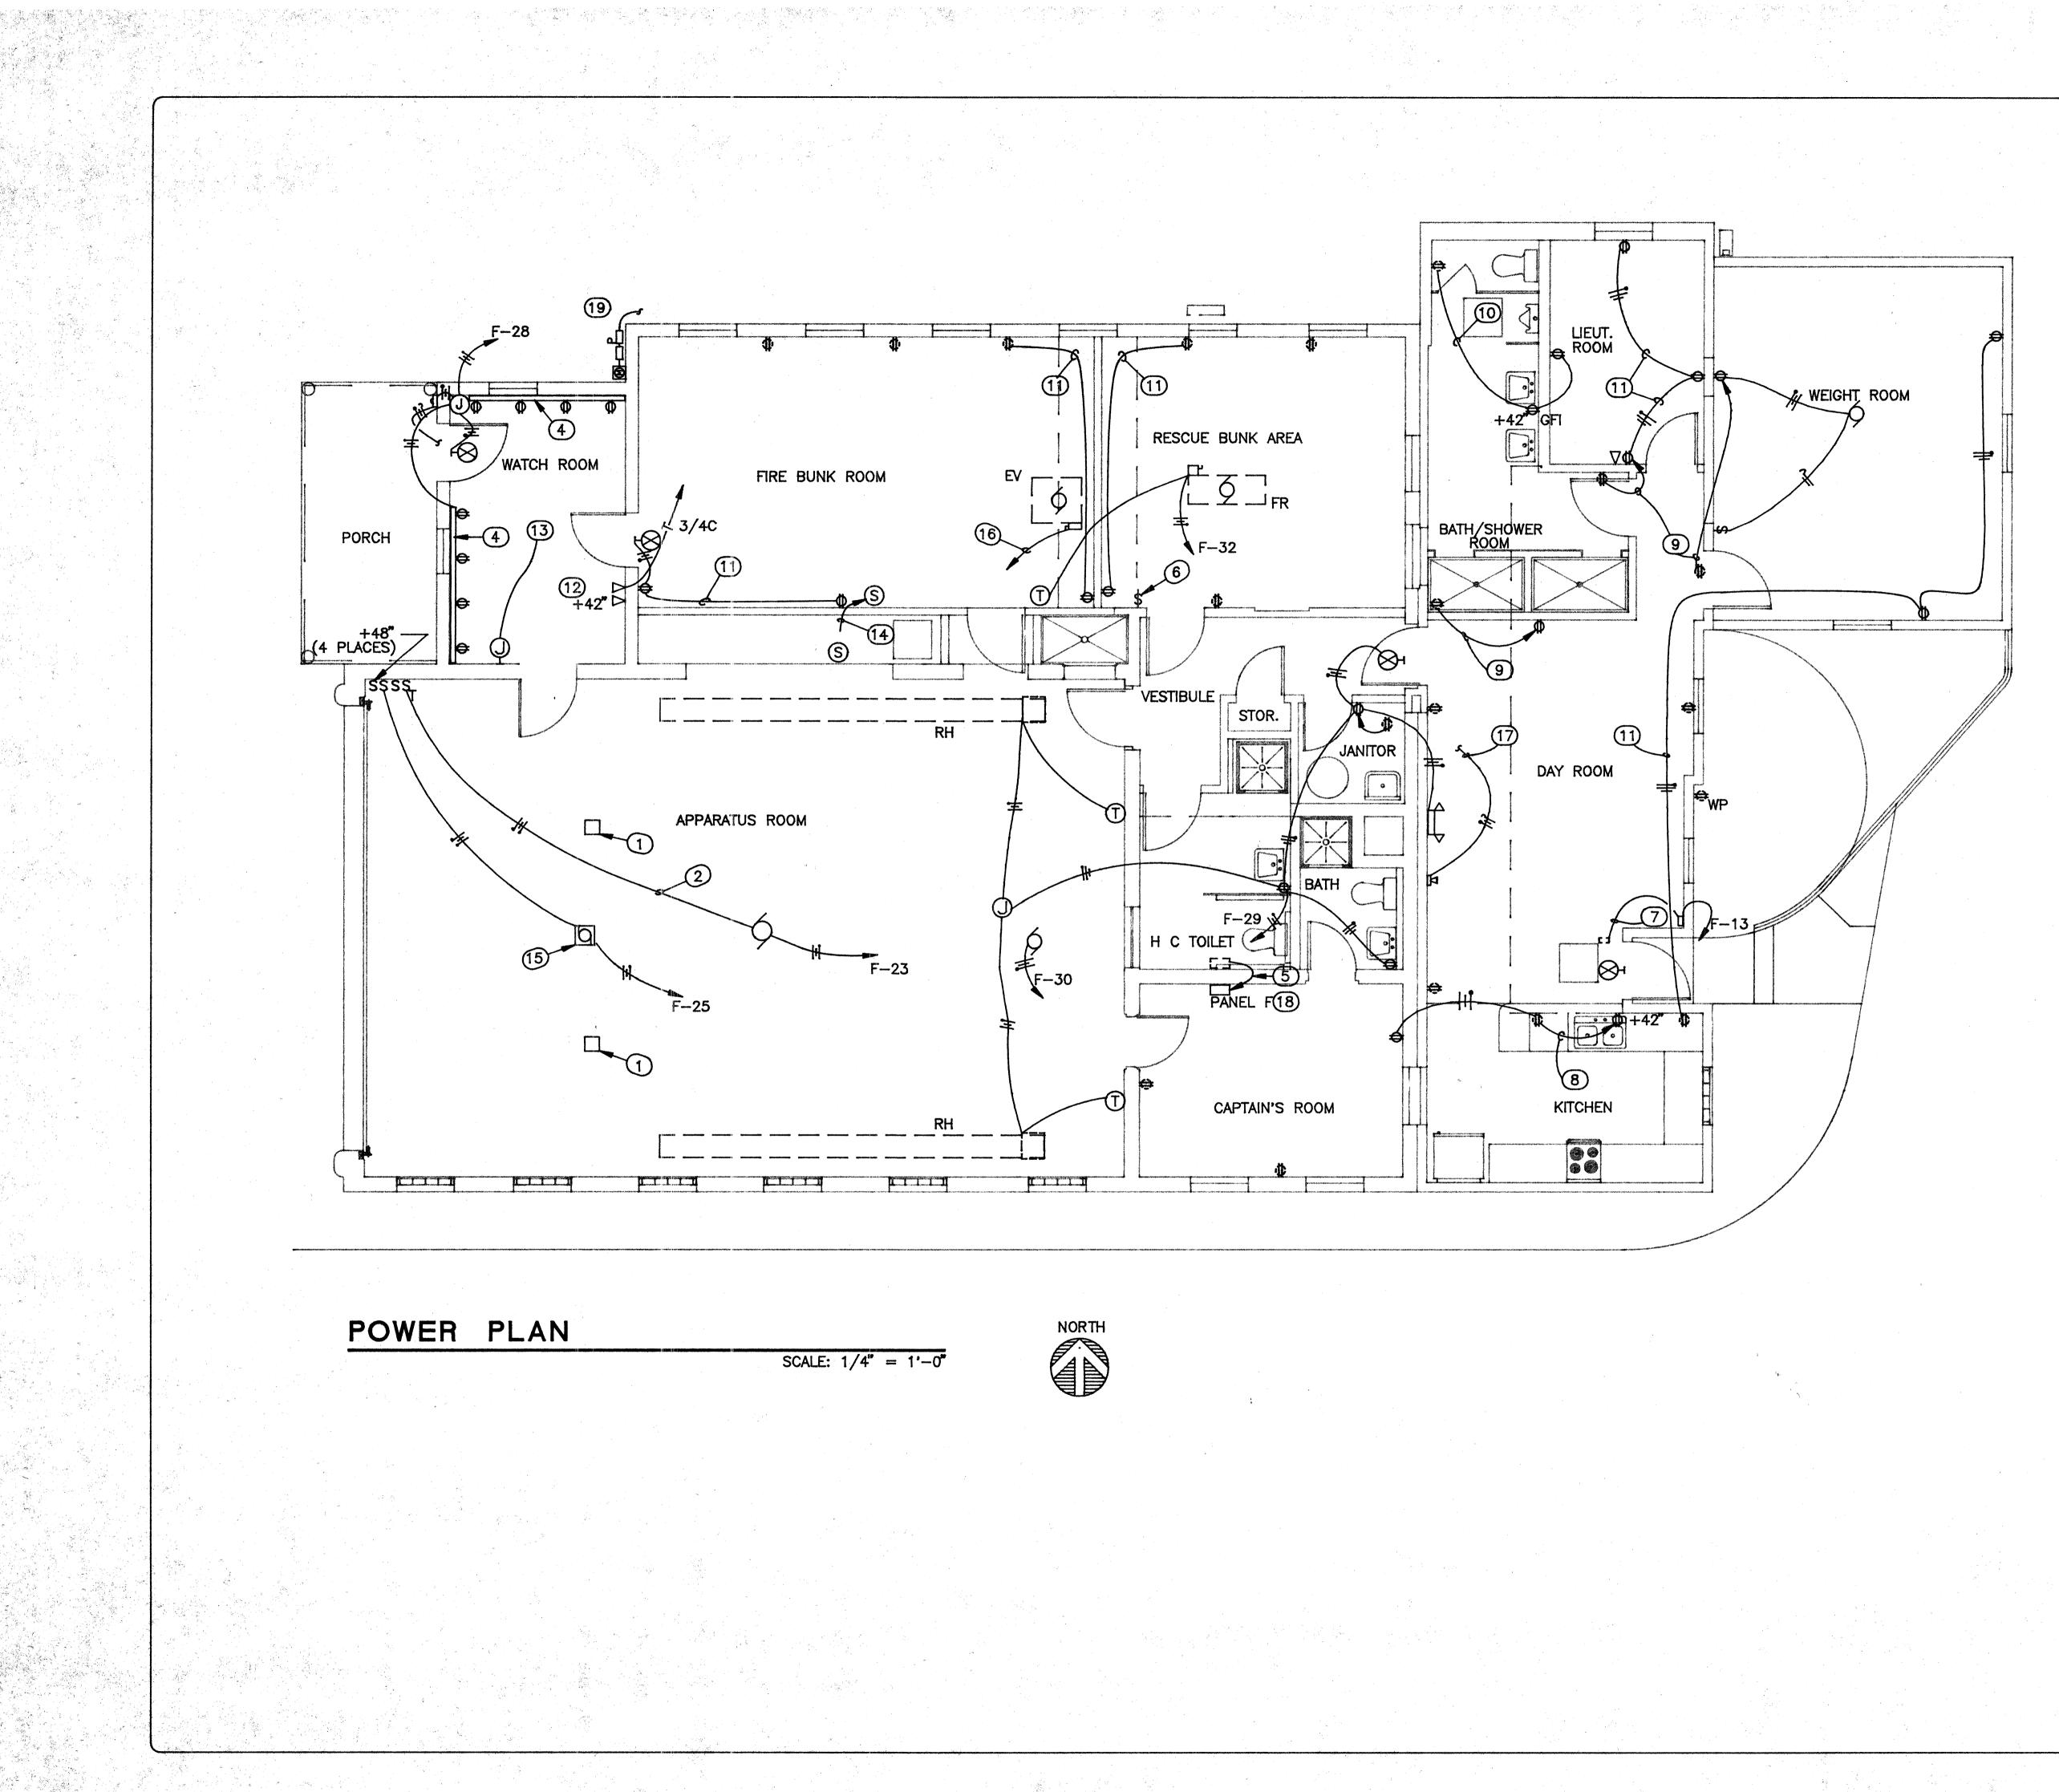


6000 UPTOWN BLVD. N.E. SUITE #314 (505)266-0593 ALBUQUERQUE, NM 87110 Wayne Usiak & Associates PROJECT: RENOVATIONS - FIRE STATION #7 116 47TH STREET NW ALBUQUERQUE, NM 87100 LOCATION: CITY OF ALBUQUERQUE OWNER **KEYED NOTES REMOVE EXISTING DOOR OPERATORS & CIRCUITS BACK TO THE** PANEL. REMOVE WALL CONTROL SWITCHES & REPLACE WITH NEW. SEE KEYED NOTE 15. . EXISTING CIRCUIT TO REMAIN. RECONNECT TO NEW ROOF MOUNTED EXHAUST FAN. REPLACE EXISTING FAN CONTROL SWITCH WITH A TIMER SWITCH OF THE SAME RATING. INSTALL RELOCATED 8' STRIPS @ 5' AFF. REMOVE EXISTING CIRCUITS FROM EXISTING COMPUTER ROOM BACK TO THE PANEL AFTER REMOVAL & RELOCATION OF STRIPS TO THE NEW LOCATION, REMOVE AND RELOCATE EXISTING 100A/120V/1PH/3W PANEL F TO NEW LOCATION SHOWN & RECONNECT ALL CIRCUITS. SEE NEW 6. EXISTING EVAPORATIVE CONTROL SWITCH TO REMAIN AND TO BERECONNECTED TO NEW EVAPORATIVE COOLER ON THE ROOF. SEE WIRING DIAGRAM. REMOVE AND RELOCATE EXISTING PUMP PUSH BUTTON CONTROL SWITCH & TIMER TO NEW LOCATION @ 48" AFF AND RE-RUN CIRCUIT BACK TO THE PANEL. TIMER SETTING SHALL REMAIN AS IS. NEW LOCATION SHALL BE BELOW COUNTER TOP LEVEL. B. RELOCATE EXISTING DUPLEX OUTLET AND GARBAGE DISPOSAL CONTROL SWITCH TO NEW LOCATION SHOWN, REMOVE AND RELOCATE EXISTING DUPLEX OUTLET TO NEW LOCATION SHOWN. 10REMOVE EXISTING OUTLET AND RELOCATE CIRCUIT TO NEW LOCATION AND CONNECT TO NEW GFI OUTLET. 1,EXTEND NEW 2 # 12 AWG IN 1/2" C FROM EXISTING(OR RELOCATED) DUPLEX OUTLET TO NEW DUPLEX OUTLETS. RUN CONDUITS INSIDE WALL AND ABOVE CEILING. **12:ONE OUTLET FOR NORMAL PHONE LINE AND ONE OUTLET FOR "FIRE** PHONE". MAKE APPROPRIATE CONNECTIONS. **13.PROVIDE FLUSH J-BOX WITH COVER AND GROMMET FOR ANTENNA** CABLE @ 24" ABOVE FINISHED FLOOR. EXACT LOCATION AS DIRECTED BY USER AND AS REQUIRED BY RADIO UNIT. **14.RELOCATE SMOKE DETECTOR TO NEW LOCATION.** 15.NEW 2HP (MAX) OH DOOR OPERATOR(BY OWNER). VERIFY ELECTRICAL REQUIREMENTS. **16. RECONNECT EXISTING EVAPORATIVE COOLER CIRCUIT TO NEW ONE 17. TO PUSH BUTTON DOOR BELL.** 18. LOCATION OF NEW PANEL P FOR NEW ELECTRICAL SERVICE ALTERNATE. RECONNECT ALL CIRCUITS TO NEW PANEL 19. LOCATION OF NEW ELECTRIC METER AND DISCONNECT FOR NEW ELECTRICAL SERVICE ALTERNATE. RUN SERVICE TO NEW PANEL P INSIDE THE BUILDING. POWER PLAN DATE: 1/5/93 DRAWN: MORRIS CHECKED: APPROVED: . **REVISIONS:** ENGR. SEAL ARCH. SEAL SHEET: 1-5-9

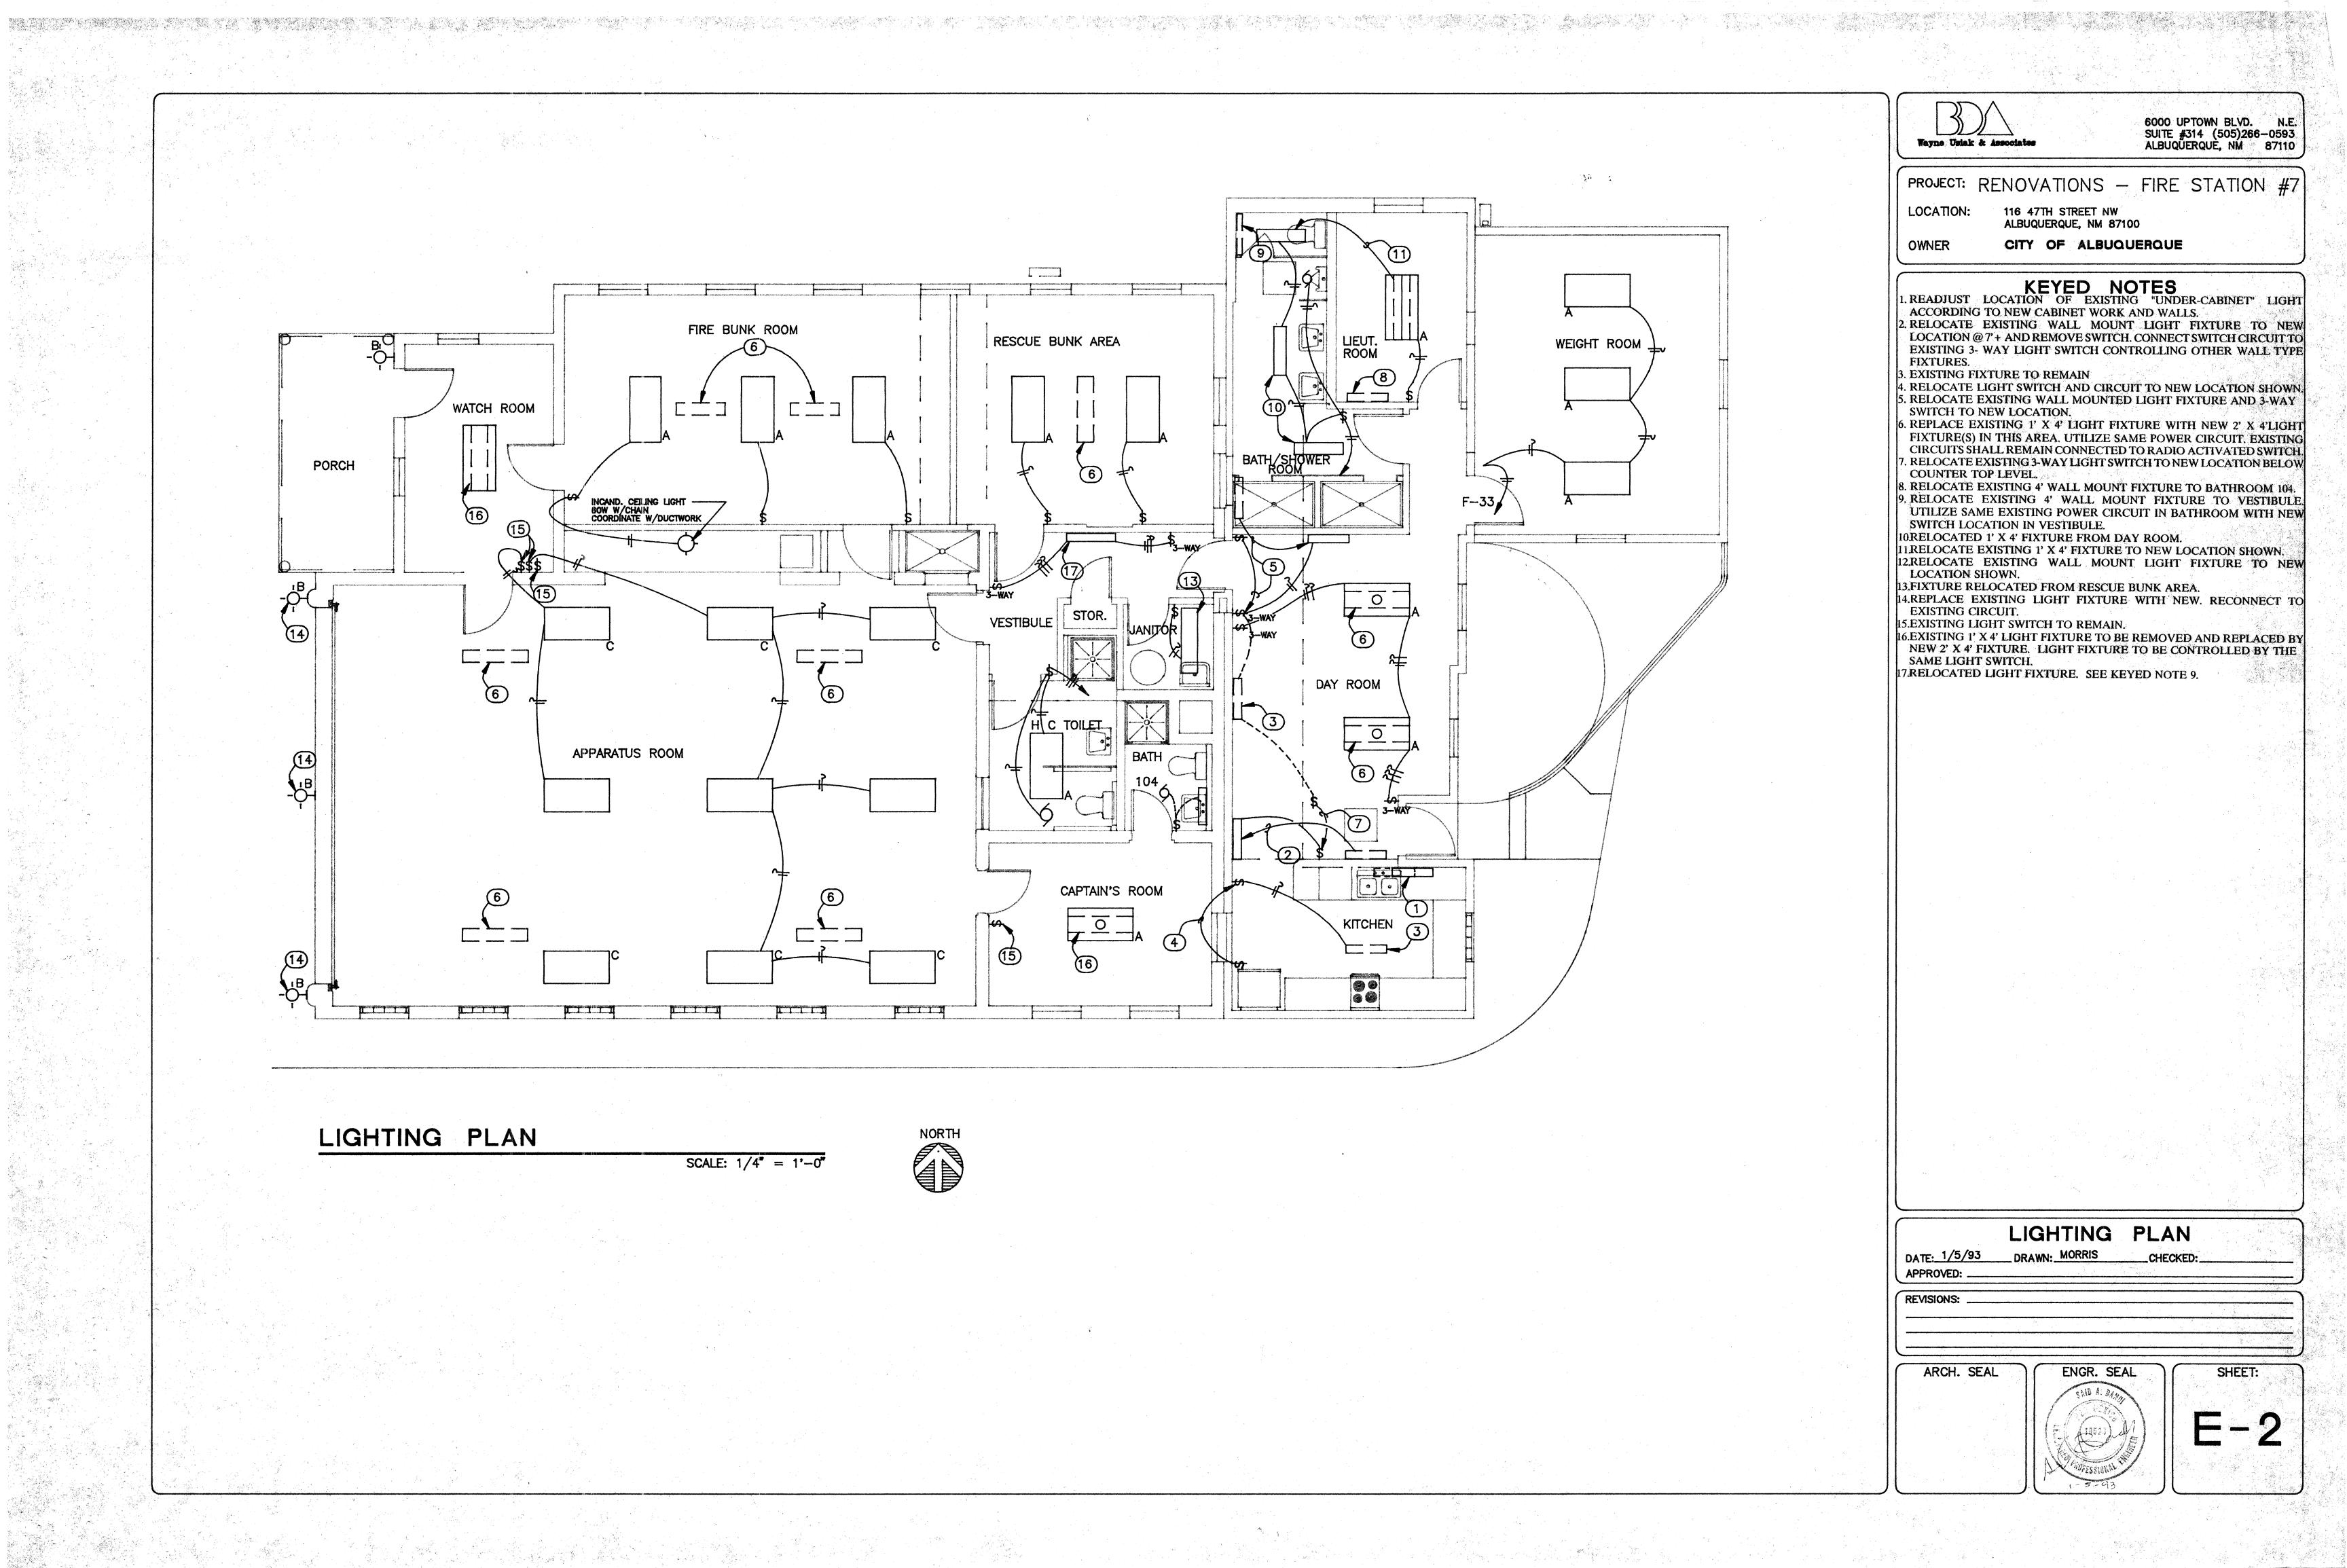

ELECTRICAL LEGEND DUPLEX RECEPTACLE, NEMA 5-15R, 15 AMP/125 VOLT, UP UNLESS OTHERWISE NOTED. Φ SINGLE POLE TOGGLE SWITCH UP 48" то воттом. THREE WAY TOGGLE SWITCH UP 48" **\$**3 TO BOTTOM ELECTRIC MOTOR OUTLET. NUMBER INDICATES HORSEPOWER. 2' x 4' SURFACE FLOURESCENT LIGHT FIXTURE. LETTER INDICATES 0 $\nabla \lambda$ Δ FIXTURE TYPE EMERGENCY BATTERY LIGHT. NUMBER OF HEADS & ORIENTATION AS SHOWN ON PLANS. EXTERIOR WALL BRACKET INCANDESCENT LIGHT FIXTURE ABOVE -Q DOOR. SAFETY SWITCH. EXIT LIGHT, CEILING MOUNTED. 48' EXIT LIGHT, WALL MOUNTED. THERMOSTAT BY MECHANICAL, UP СЧ & Φ J-BOX INSTALLED ABOVE CEILING. 48 \bigcirc SIZE PER NEC. J-BOX INSTALLED FLUSH IN WALL. SIZE PER NEC. METERING EQUIPMENT. TELEPHONE OUTLET, WALL MOUNTED UP 15TO BOTTOM. ELECTRICAL PANELBOARD. REFER TO 48" PANEL SCHEDULE FOR DESCRIPTION. CONDUIT RUN CONCEALED IN CEILING 0 OR WALL. TELEPHONE CONDUIT RUN CONCEALED. 3/4" CONDUIT. WIRING RUN CONCEALED IN CONDUIT. HASH MARKS INDICATE 1 NEUTRAL, 2 HOT(0) & 1 GROUND CONDUCTOR. ARROWS AND SUBSCRIPT INDICATE HOME RUN TO PANEL "A" CIRCUITS A-1.3 1 & 3. DOOR BELL BUTTON @+48". DOOR BELL @+84"

N

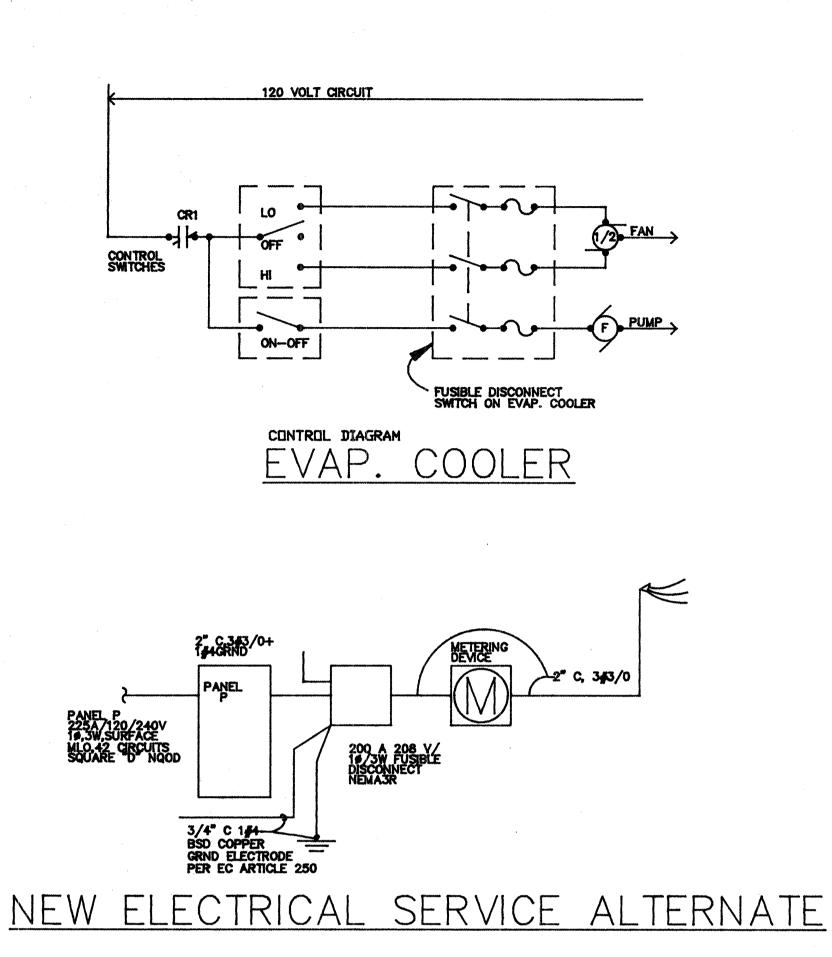

ELECTRICAL GENERAL NOTES

B.

C.

D.

F.

A. VERIFY CIRCUIT IDENTIFICATION NUMBERS WITH EXISTING PANEL SCHEDULES.

FIELD VERIFY EXACT LOCATION OF EXISTING LIGHTS AND OUTLETS. CIRCUITS SHALL NOT EXCEED 20A RATING OF EXISTING 20 A BREAKERS ON EXISTING 100A PANEL.

ALL CIRCUITS SHALL BE #12 MCM IN 1/2 " C. ALL ELECTRICAL WORK SHALL BE PERFORMED PER **REQUIREMENTS OF NEC LATEST EDITION.**

ALL RADIO AND SIGNAL LIGHT CONTROL CIRCUITS SHALL REMAIN AS IS. G. ALL LIGHT FIXTURES WHICH ARE TO BE RELOCATED SHALL BE

PROTECTED FROM DAMAGE AND PROPERLY CLEANED.

lan Ali Santa Santa	FIXTURE TYPE	DESCRIPTION							
	A	2'X 4' FLUORESCENT, 4 LA HARD CEILING, 120V, ACR							
fixe -	B ^{asi}	WALL MOUNTED WITH WA PATIO INCOND LIGHT 60W							
	С	1' X 4' FLUORESCENT, 2 SURFACE MOUNT, HARD							
	EMERGENCY LI	GHT	WALL MOUNTED, 120 TESTER, SELF CON BOTTOM AT 84".						
	EXIT LIGHT		WALL MOUNTED, 120						


MP, 34W EA., SURFACE MOUNT. RYLIC LENS.

VALL BRACKET WHITE DIFFUSER W. 120V

LAMP, 34W EA., WIRE GUARD, CEILING, 120V.

20V, 60W, BATTERY BACKUP AND ONTAINED WITH TOW BULBS,

WALL MOUNTED, 120V, 60W, GREEN LETTER, 6" HIGH WITH SELF CONTAINED BATTERY.

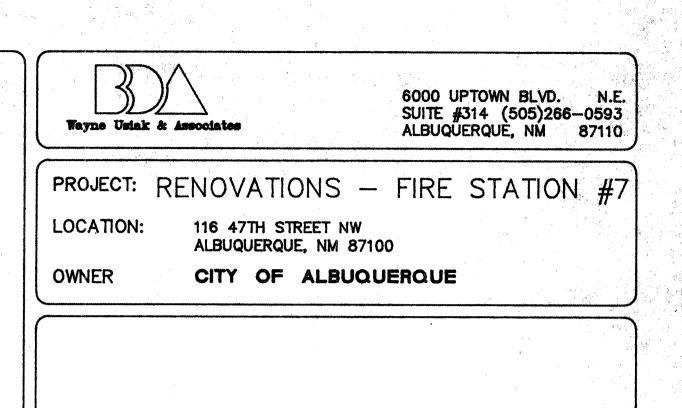

ELECTRICAL NOTES 1 - 5 - 95DATE: 12 Mar 102 _CHECKED: APPROVED: REVISIONS: ARCH. SEAL ENGR. SEAL SHEET:

and deside .

Transfer to the second second

