


CITY OF ALBUQUERQUE
NEW MEXICO
MUNICIPAL DEVELOPMENT DEPARTMENT



SPECIAL ASSESSMENT DISTRICT 204

PAVING, SIDEWALK, WATER, SANITARY SEWER, & STORM DRAINS

MARCH, 1985

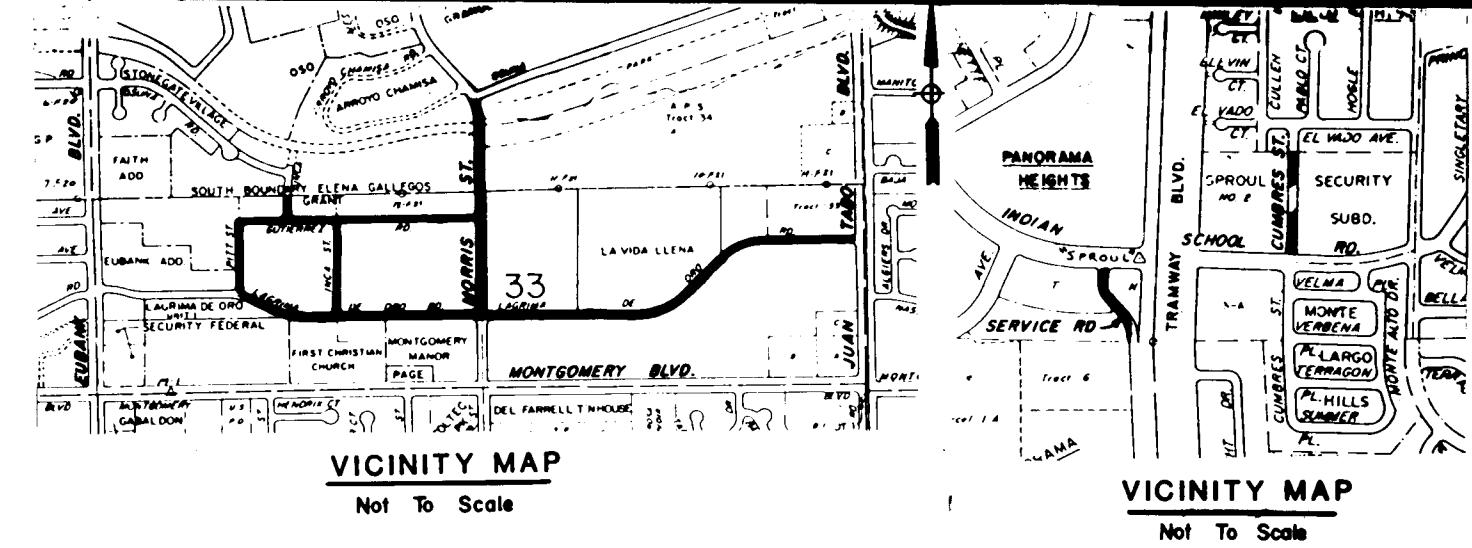

NOTICE TO CONTRACTORS

1. THE NEW MEXICO STANDARD SPECIFICATIONS FOR PUBLIC WORKS CONSTRUCTION, 1979 EDITION, WILL GOVERN THIS PROJECT EXCEPT AS REVISED, AMENDED, OR SUPPLEMENTED BY THE SUPPLEMENTAL GENERAL CONDITIONS, SPECIAL PROVISIONS AND TECHNICAL SPECIFICATIONS.
2. TWO (2) WORKING DAYS PRIOR TO ANY EXCAVATION, CONTRACTOR MUST CONTACT LINE LOCATING SERVICE, 765-1234, FOR LOCATION OF EXISTING UTILITIES.
3. PRIOR TO CONSTRUCTION, THE CONTRACTOR SHALL EXCAVATE AND VERIFY THE HORIZONTAL AND VERTICAL LOCATIONS OF ALL OBSTRUCTIONS. SHOULD A CONFLICT EXIST, THE CONTRACTOR SHALL NOTIFY THE ENGINEER OR SURVEYOR SO THAT THE CONFLICT CAN BE RESOLVED WITH A MINIMUM AMOUNT OF DELAY.
4. ALL UTILITIES AND UTILITY SERVICE LINES SHALL BE INSTALLED PRIOR TO PAVING.
5. BACKFILL COMPACTION SHALL BE ACCORDING TO SPECIFIED STREET USE.
6. TACK COAT REQUIREMENTS SHALL BE DETERMINED BY THE CITY ENGINEER.
7. ALL STORM DRAINAGE FACILITIES SHALL BE COMPLETED PRIOR TO FINAL ACCEPTANCE.

CONSTRUCTION OF SPECIAL ASSESSMENT DISTRICT NO. 204

DESCRIPTION

COVER SHEET & INDEX
LOCATION MAP
GENERAL NOTES & LEGEND
TYPICAL STREET SECTION & SCHEDULE

SHEET NO.

1
2
3
4

APPROVAL OF DRAWINGS
ASST CITY ENGR FIELD
DATE 2-19-85

PAVING PLAN & PROFILE

LAGRIMA DE ORO ROAD
GUTIERREZ ROAD
MORRIS STREET
PITT STREET
INCA STREET (GUTIERREZ TO LAGRIMA DE ORO)
INCA STREET (GUTIERREZ TO GRANT BOUNDARY)
SERVICE ROAD
CUMBRES STREET
INTERSECTION DETAILS

5 - 9
10 - 11
12 - 13
14
14
15
16
16
17 - 18

26 16460186

RECORD DRAWING
Drawings revised to reflect the best information available. Do not use without field verification.


SANITARY SEWER & WATER PLAN & PROFILE

LAGRIMA DE ORO ROAD
PITT STREET
INCA STREET (LAGRIMA DE ORO TO GUTIERREZ)
GUTIERREZ ROAD
INCA STREET (GUTIERREZ TO GRANT BOUNDARY)
SERVICE ROAD
CUMBRES STREET
MORRIS STREET

19 - 22
23
23
24 - 25
26
27
27
28

4	5, 8-10, 12-32			
3	5, 6, 14, 19, 23, 29, 30	10/1/85 DWL R. Pena	10/2/85 Traffic Eng. David A. Pena	10/6/85
2	12, 25, 29	10/1/85 DWL R. Pena	10/5/85 Traffic Eng. David A. Pena	9/13/85
1	4, 10, 11, 12 14, 15, 17, 23 24, 25, 26, 28, 32	10/1/85 DWL R. Pena	10/5/85 Traffic Eng. David A. Pena	9/13/85
REV	Sheets	CITY ENGINEER	DATE	USER DEPT DATE

	WILLIAM MATOTAN & ASSOCIATES, INC. ENGINEERS 230 TRUMAN N.E. ALBUQUERQUE, N.M. 87108 PHONE: 505-265-8467	APPROVED FOR CONSTRUCTION <i>O.H. Haynes</i>
	PROJECT NUMBER 1646	SHEET / OF 36

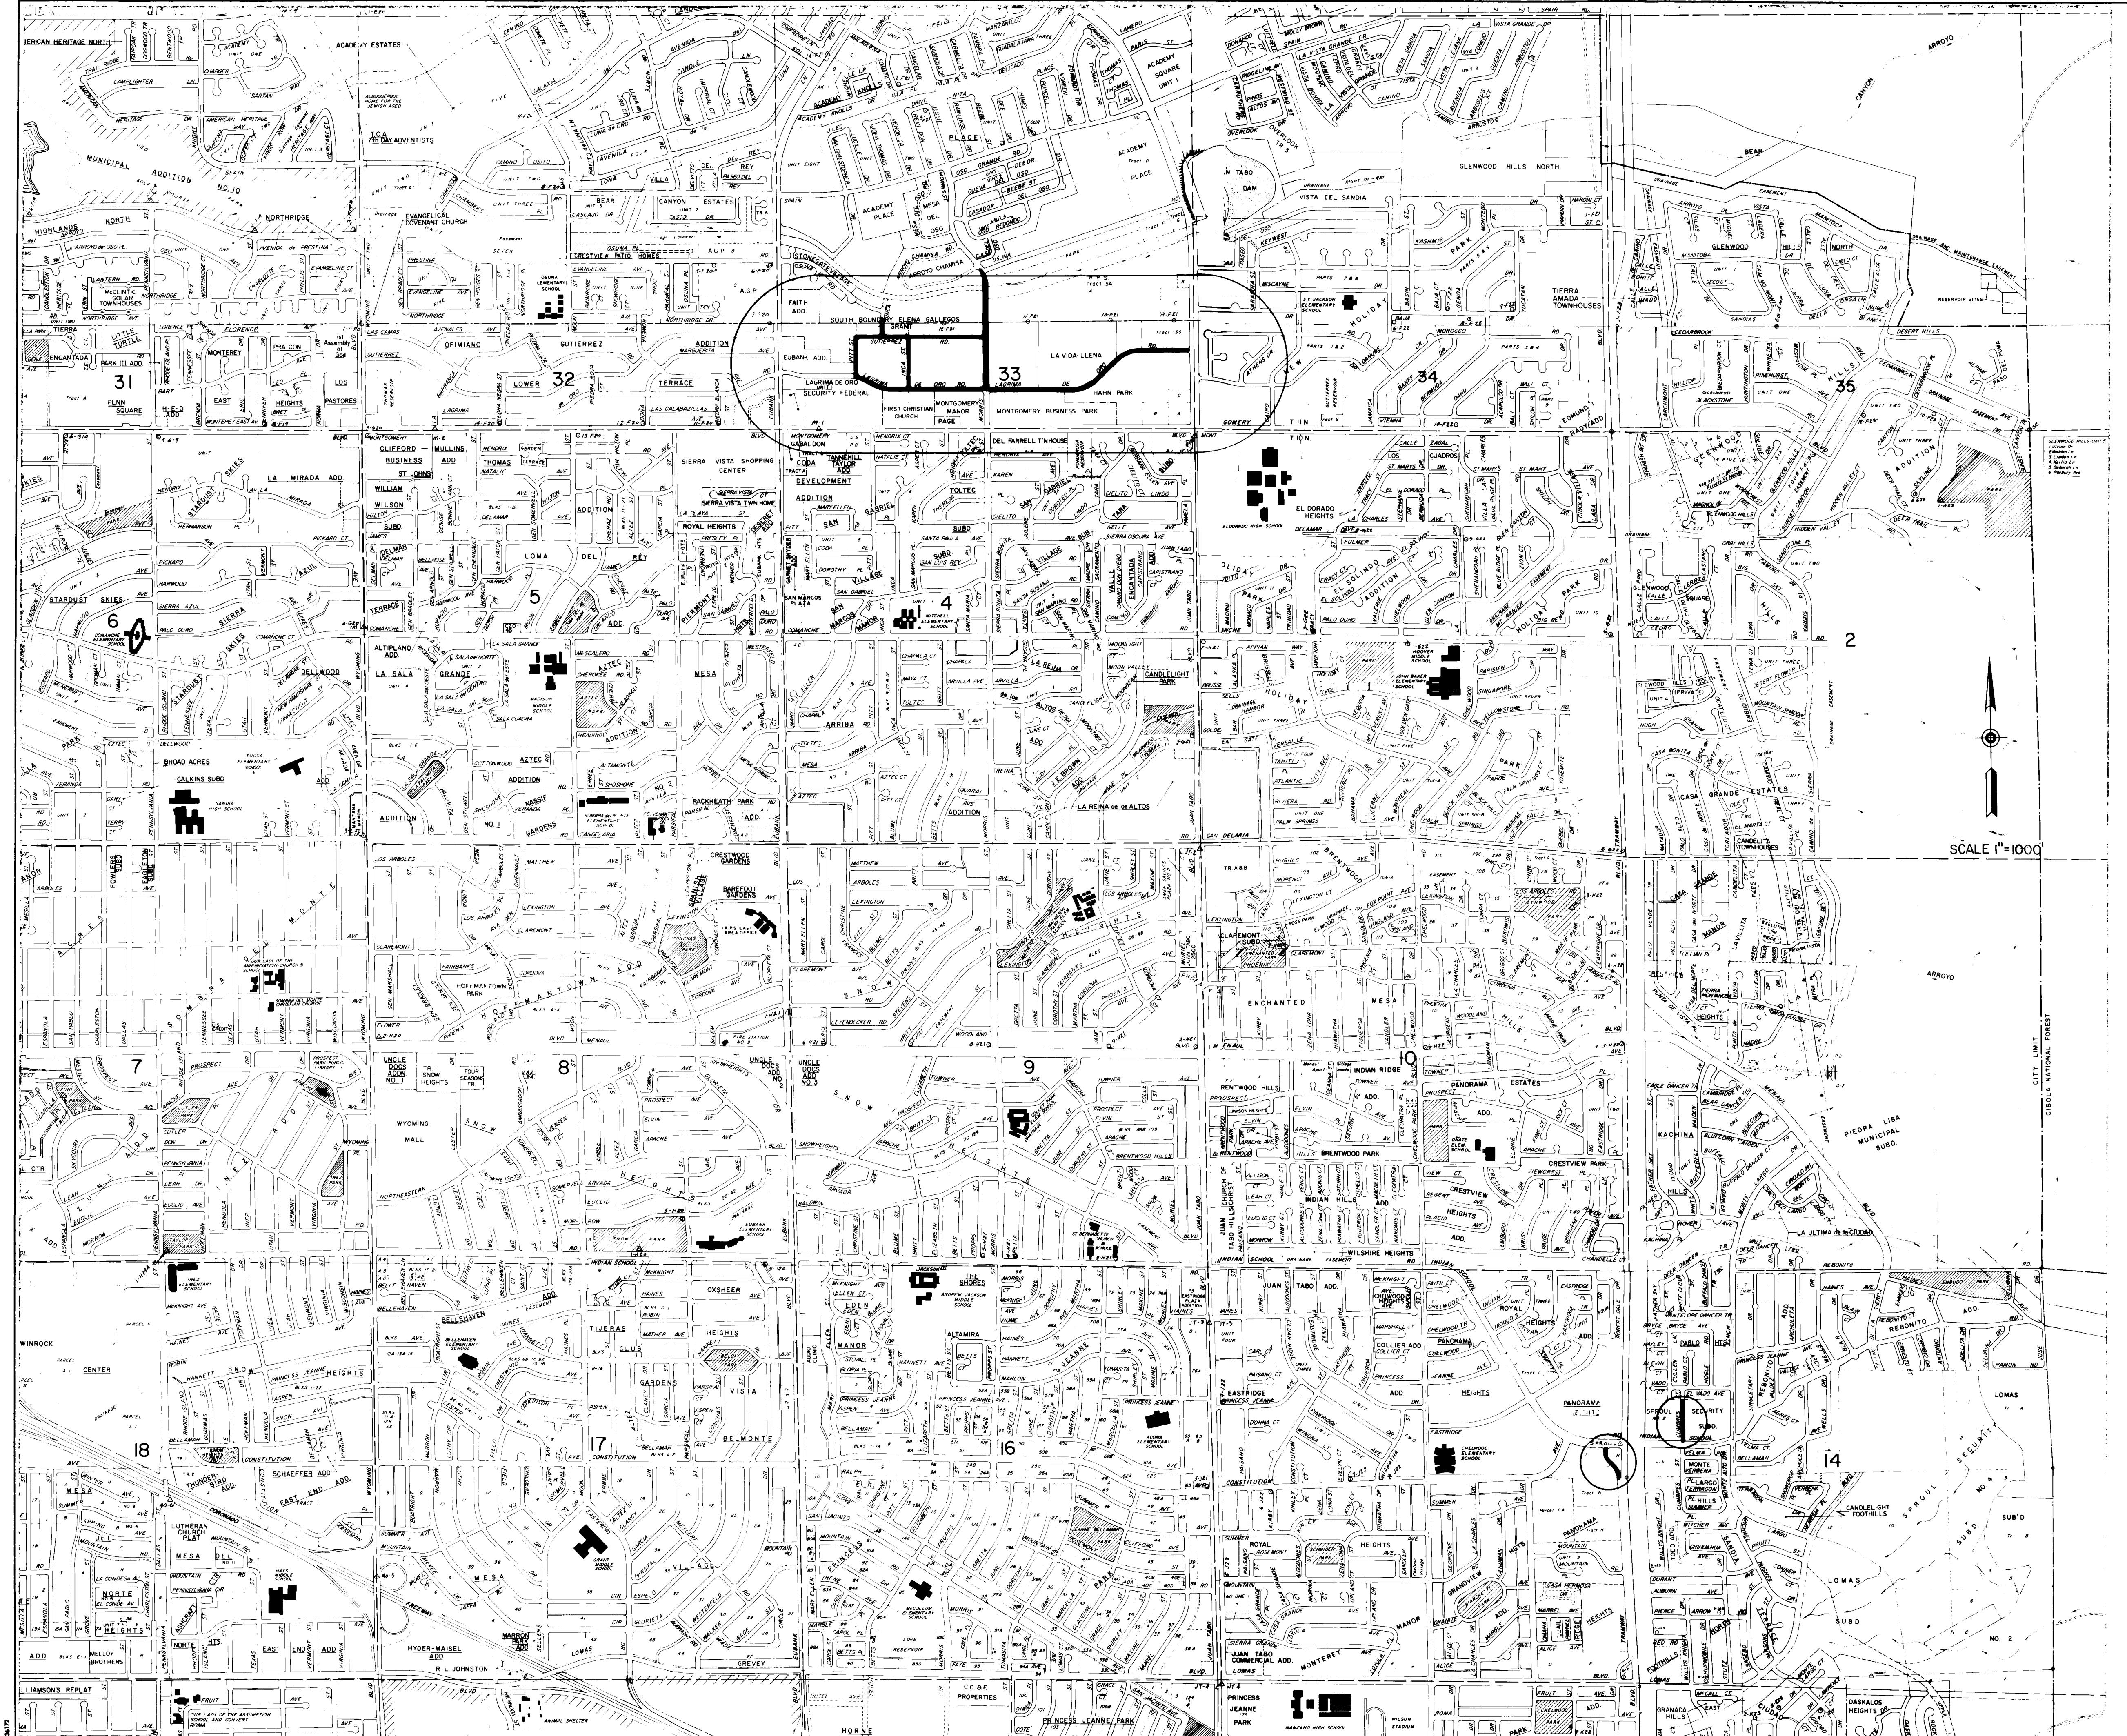

AS BUILT INFORMATION		BENCH MARKS	
CONTRACTOR	KNC INC.	WORKED BY	M.W.A.
INSPECTOR'S	M.W.A.	DATE	5/8/85
ACCEPTANCE BY	M.W.A.	DATE	5/8/85
FIELD CHECK BY	M.W.A.	DATE	5/8/85
RECORDED BY	M.W.A.	DATE	5/8/85
CORRECTED BY M.W.A. DATE 5/8/85			
MICROFILM INFORMATION			
RECORDED BY NO			

2616460286

RECORD DRAWING
Drawings revised to reflect the
best information available. Do
not use without field verification.

CITY OF ALBUQUERQUE
MUNICIPAL DEVELOPMENT DEPARTMENT
ENGINEERING DIVISION

TITLE: SPECIAL ASSESSMENT DISTRICT 204
LOCATION MAP

APPROVALS	ENGINEER	DATE	APPROVALS	ENGINEER	DATE
City Engineer	Chadrony [Signature]	5/8/85	Liquid Waste	Rosa	5/8/85
A.C.E.-Design	Hallie [Signature]	5/8/85	Traffic	Dick M. H.	5/8/85
A.C.E.-Hydrology	Newby [Signature]	5/8/85	Water	Rosa	5/8/85

DRAWING NO. 1646 MAP NO. SHEET 2 OF 36

LEGEND

DESCRIPTION	NEW	EXISTING
ARY SEWER LINE	—SAS—	- - - SAS - - -
ARY SEWER MANHOLE	—●—	- - - ○ - - -
SERVICE CONNECTION	—T T—	
M DRAIN LINE	—SD—	- - - SD - - -
M DRAIN MANHOLE	—○—	- - - ○ - - -
M DRAIN INLETS	—■—	□ —
R LINE	—W—	- - - W - - -
VALVE	—►—	- - - X - - -
ERFLY VALVE	— ○ —	- - - X - - -
YDRANTS	—●—	- - - ○ - - -
ERS	—►—	- - - ▲ - - -
R SERVICE CONNECTION	—■ ■—	- - - □ □ - - -
SES	—+— +— L— E—	- - - + - - - +— L— E—
PLUGS		
GUTTER	— — —	- - - - -
ALKS	{ — }	{ — }
g		
RARY PAVING	— / / / —	EXISTING
I TRANSITION AREA	— ▵ —	
Y GUTTERS	— □ —	- - - □ - - -
CHAIR RAMPS	— ▽ —	- - - ▽ - - -
OR TELEPHONE POLE		

1. ALL RADII OF CURB RETURNS ARE SHOWN FLOWLINE TO FLOWLINE OF CURB.
 2. UNLESS OTHERWISE SHOWN, ALL DIMENSIONS ARE FLOWLINE TO FLOWLINE OF CURB.
 3. ALL FINISH GRADES AND PROFILES SHOWN ARE TOP OF CURB GRADES, UNLESS OTHERWISE NOTED. MATCH FLOWLINES OF GUTTERS WHEN CONNECTING NEW CURB AND GUTTER TO EXISTING.
 4. ALL UTILITY POLES ARE TO BE RELOCATED BY OTHERS.
 5. CURB AND GUTTER SHOWN AS EXISTING AND NOT TO BE REMOVED UNDER THIS CONTRACT WHICH IS DAMAGED OR DISPLACED BY THE CONTRACTOR SHALL BE REMOVED AND REPLACED BY THE CONTRACTOR AT HIS EXPENSE.
 6. WHEN ABUTTING NEW PAVEMENT TO EXISTING, SAW CUT EXISTING PAVEMENT TO A STRAIGHT LINE AS REQUIRED TO REMOVE ANY BROKEN OR CRACKED PAVEMENT AND MATCH NEW TO EXISTING.
 7. WHEN REMOVAL OF EXISTING CURB AND GUTTER OR SIDEWALK IS REQUIRED, REMOVE BACK TO NEAREST JOINT.
 8. ALL GAS VALVE BOXES, GAS MANHOLES, ELECTRICAL MANHOLES, AND TELEPHONE MANHOLES WILL BE ADJUSTED TO GRADE BY OTHERS.
 9. 48 HOURS PRIOR TO ANY EXCAVATION, CONTRACTOR MUST CONTACT LINE AND CABLE LOCATING SERVICE, 765-1234.
 10. CONTRACTOR IS TO EXERCISE DUE CARE TO AVOID DISTURBING ANY EXISTING UNDERGROUND UTILITIES. IT SHALL BE HIS RESPONSIBILITY TO COORDINATE WITH THE UTILITY COMPANIES IN ORDER TO PREVENT ANY SERVICE DISRUPTION.
 11. EXACT LOCATION OF DRIVEPADS AND WHEELCHAIR RAMPS WILL BE DETERMINED IN THE FIELD BY THE FIELD ENGINEER. LOCATIONS SHOWN ON PLAN AND PROFILE SHEETS ARE APPROXIMATE.
 12. THE APPLICABLE CITY OF ALBUQUERQUE STANDARD DETAILS ARE INCLUDED AT THE BACK OF THE SPECIFICATIONS.
 13. ALL WATER VALVE BOXES AND SEWER MANHOLES IN THE CONSTRUCTION AREA ARE TO BE ADJUSTED TO FINISH GRADE UNDER THIS CONTRACT, AND WILL BE PAID FOR AT CONTRACT UNIT PRICES.
 14. SUBGRADE PREPARATION UNDER CURB AND GUTTER, DRIVEPADS AND SIDEWALK SHALL BE CONSIDERED INCIDENTAL TO THE CONSTRUCTION OF SUCH AND SHALL BE INCLUDED IN THE BID PRICE FOR SUCH ITEMS.
 15. A DISPOSAL SITE, COMPLYING WITH ALL CITY ORDINANCES, SHALL BE OBTAINED BY THE CONTRACTOR FOR THE DISPOSAL OF ALL EXCESS EXCAVATION MATERIAL ASPHALTIC PAVEMENT (EXCEPT MILLED BITUMINOUS CONCRETE PAVEMENT) AND OTHER WASTE MATERIALS. THE CONTRACTOR SHALL NOTIFY THE CITY OF ALBUQUERQUE OF THE LOCATION OF THE DISPOSAL SITE PRIOR TO THE REMOVAL AND ACTUAL DISPOSAL OF THE MATERIAL. ALL COSTS IN OBTAINING A DISPOSAL SITE AND HAUL THERETO SHALL BE CONSIDERED INCIDENTAL TO CONSTRUCTION AND NO DIRECT PAYMENT WILL BE MADE THEREFOR.
 16. THE CONTRACTOR WILL BE REQUIRED TO CONFINE HIS WORK WITHIN THE CONSTRUCTION LIMITS AND/OR R.O.W. TO PRESERVE EXISTING VEGETATION AND PRIVATE PROPERTY. OVERNIGHT PARKING OF CONSTRUCTION EQUIPMENT SHALL NOT OBSTRUCT DRIVEWAY OPENINGS OR DESIGNATED TRAFFIC LANES
 17. FIFTY (50) TON ROLLER OPERATION SHALL NOT BE USED IN THIS PROJECT WHERE UNDERGROUND UTILITIES ARE PRESENT. THE REQUIRED COMPACTION AT THESE LOCATIONS SHALL BE EFFECTED BY OTHER MEANS.
 18. ALL EXCAVATIONS FOR STORM DRAINS, AND OTHER EXCAVATIONS AS NECESSARY SHALL BE GOVERNED BY THE CONSTRUCTION SAFETY AND HEALTH STANDARDS (TITLE 29, CFR, PART 1926 AND PART 1910 AS APPLICABLE TO CONSTRUCTION WORK - PUBLISHED IN THE FEDERAL REGISTER ON FEBRUARY 9, 1979).
 19. ALL EXISTING REGULATORY SIGNS AND SIGNALS THAT NEED TO BE REMOVED, RELOCATED OR REINSTALLED SHALL BE DONE BY THE CITY OF ALBUQUERQUE TRAFFIC ENGINEERING DIVISION. NOTIFICATION MUST BE MADE TO THAT OFFICE 3 WORKING DAYS IN ADVANCE OF ANY REQUIRED WORK.
 20. PERMANENT SIGNING AND ALL STRIPING BY CITY FORCES. CONSTRUCTION SIGNING AND STRIPING BY CONTRACTOR. ALL COSTS INCURRED FOR CONSTRUCTION SIGNING AND STRIPING SHALL BE CONSIDERED INCIDENTAL TO CONSTRUCTION AND NO DIRECT PAYMENT WILL BE MADE THEREFOR UNLESS OTHERWISE PROVIDED.
 21. FIRE ALARM CABLES ARE TO BE ADJUSTED BY THE FIRE DEPARTMENT PERSONNEL. FOR INFORMATION CALL 243-6604.
 22. EXISTING MEDIAN CURB AND GUTTER AND STANDARD CURB AND GUTTER, NOT DISTURBED BY THE CONTRACTOR AND THAT IS OUT OF ALIGNMENT OR DISPLACED VERTICALLY OR IS BADLY BROKEN OR DETERIORATED WILL BE REPLACED AS DIRECTED BY THE FIELD ENGINEER, AND WILL BE PAID FOR AT CONTRACT UNIT PRICES.
 23. THE CONTRACTOR SHALL NOTIFY WATER SYSTEMS DIVISION AT LEAST TWO (2) WORKING DAYS IN ADVANCE OF WHEN FIRE HYDRANTS WILL BE TAKEN OUT OF SERVICE AND RETURNED TO SERVICE. THE CONTRACTOR SHALL NOT TAKE FIRE HYDRANTS OUT OF SERVICE WITHOUT THE APPROVAL OF WATER SYSTEMS DIVISION.
 24. THE NEW MEXICO STANDARD SPECIFICATIONS FOR PUBLIC WORKS CONSTRUCTION, 1979 EDITION, WILL GOVERN THIS PROJECT EXCEPT AS REVISED, AMENDED, OR SUPPLEMENTED BY THE SUPPLEMENTAL GENERAL CONDITIONS, SPECIAL PROVISIONS AND TECHNICAL SPECIFICATIONS.
 25. THE CONCRETE PAVEMENT FOR WHEELCHAIR RAMPS IS INCLUDED IN THE BID ITEM, "4-INCH CONCRETE SIDEWALK, INCLUDING 6-INCH SUBGRADE PREPARATION."
 26. WHEELCHAIR RAMPS SHALL BE CONSTRUCTED AT ALL CURB RETURNS, WHERE SIDEWALK IS BEING CONSTRUCTED ON THIS PROJECT, AT LOCATION SHOWN ON THE PLANS, IN ACCORDANCE WITH CITY STANDARD DETAILS. WHEELCHAIR RAMPS SHALL BE MEASURED AND PAID AS CONCRETE SIDEWALK AND CONCRETE CURB AND GUTTER. WHERE SIDEWALK IS NOT BEING CONSTRUCTED, THE CURB RETURNS SHALL BE DEPRESSED AS REQUIRED FOR FUTURE WHEELCHAIR RAMPS.
 27. ALL WATERLINES CONSTRUCTED AS A PART OF THIS PROJECT SHALL HAVE A MINIMUM OF 48" COVER FROM FINISHED GRADE TO TOP OF PIPE.
 28. CONCRETE BLOCKING WILL BE INSTALLED AS REQUIRED AND IN ACCORDANCE WITH CITY OF ALBUQUERQUE STANDARD DRAWINGS OR AS DIRECTED BY THE ENGINEER.
 29. MANHOLE RIM ELEVATIONS SHOWN ON THESE PLANS ARE APPROXIMATE AND WILL VARY IN ACCORDANCE WITH FINISHED PAVEMENT ELEVATIONS.
 30. CONTRACTOR SHALL FIELD VERIFY LOCATION AND TYPE OF EXISTING UTILITIES TO BE ADJUSTED OR EXTENDED.
 31. GENERAL NOTES FOR TRAFFIC CONTROL ARE INCLUDED IN THE TRAFFIC CONTROL SECTION ON SHEET 34.
 32. EXISTING PROFILES AND GRADES SHOWN MAY VARY DUE TO RECENT AND CURRENT WORK DONE BY OTHERS IN THE CONSTRUCTION AREA.
 33. ALL EXISTING UTILITIES SHOWN WERE TAKEN FROM RECORD DRAWINGS AND ARE LOCATED AS ACCURATELY AS POSSIBLE FROM INFORMATION AVAILABLE. IT WILL BE THE CONTRACTOR'S RESPONSIBILITY TO PROTECT, MAINTAIN IN SERVICE, AND AT POINTS REQUIRED, VERIFY EXACT LOCATION OF THESE UTILITIES DURING CONSTRUCTION OPERATIONS OF THIS PROJECT.
 34. WATER SERVICE - PLASTIC
SEWER SERVICE - C.I.
MAIN WATER - P.V.C.
MAIN SEWER - P.V.C.


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**CITY OF ALBUQUERQUE
MUNICIPAL DEVELOPMENT DEPARTMENT**

ENGINEERING DIVISION
SPECIAL ASSESSMENT DISTRICT 204

GENERAL NOTES AND LEGEND

VALS	ENGINEER	DATE	APPROVALS	ENGINEER	DATE
Engineer	C.D. Hager	5/3/85	Liquid Waste	Raven	5/8/85
Design	HCO Inc.	5/3/85	Traffic	Douglas W. Johnson	5/8/85
Hydrology	Van Hogen	5/3/85	Water	Raven	5/8/85
ING	1646		MAP NO.	SHEET	OF
				3	36

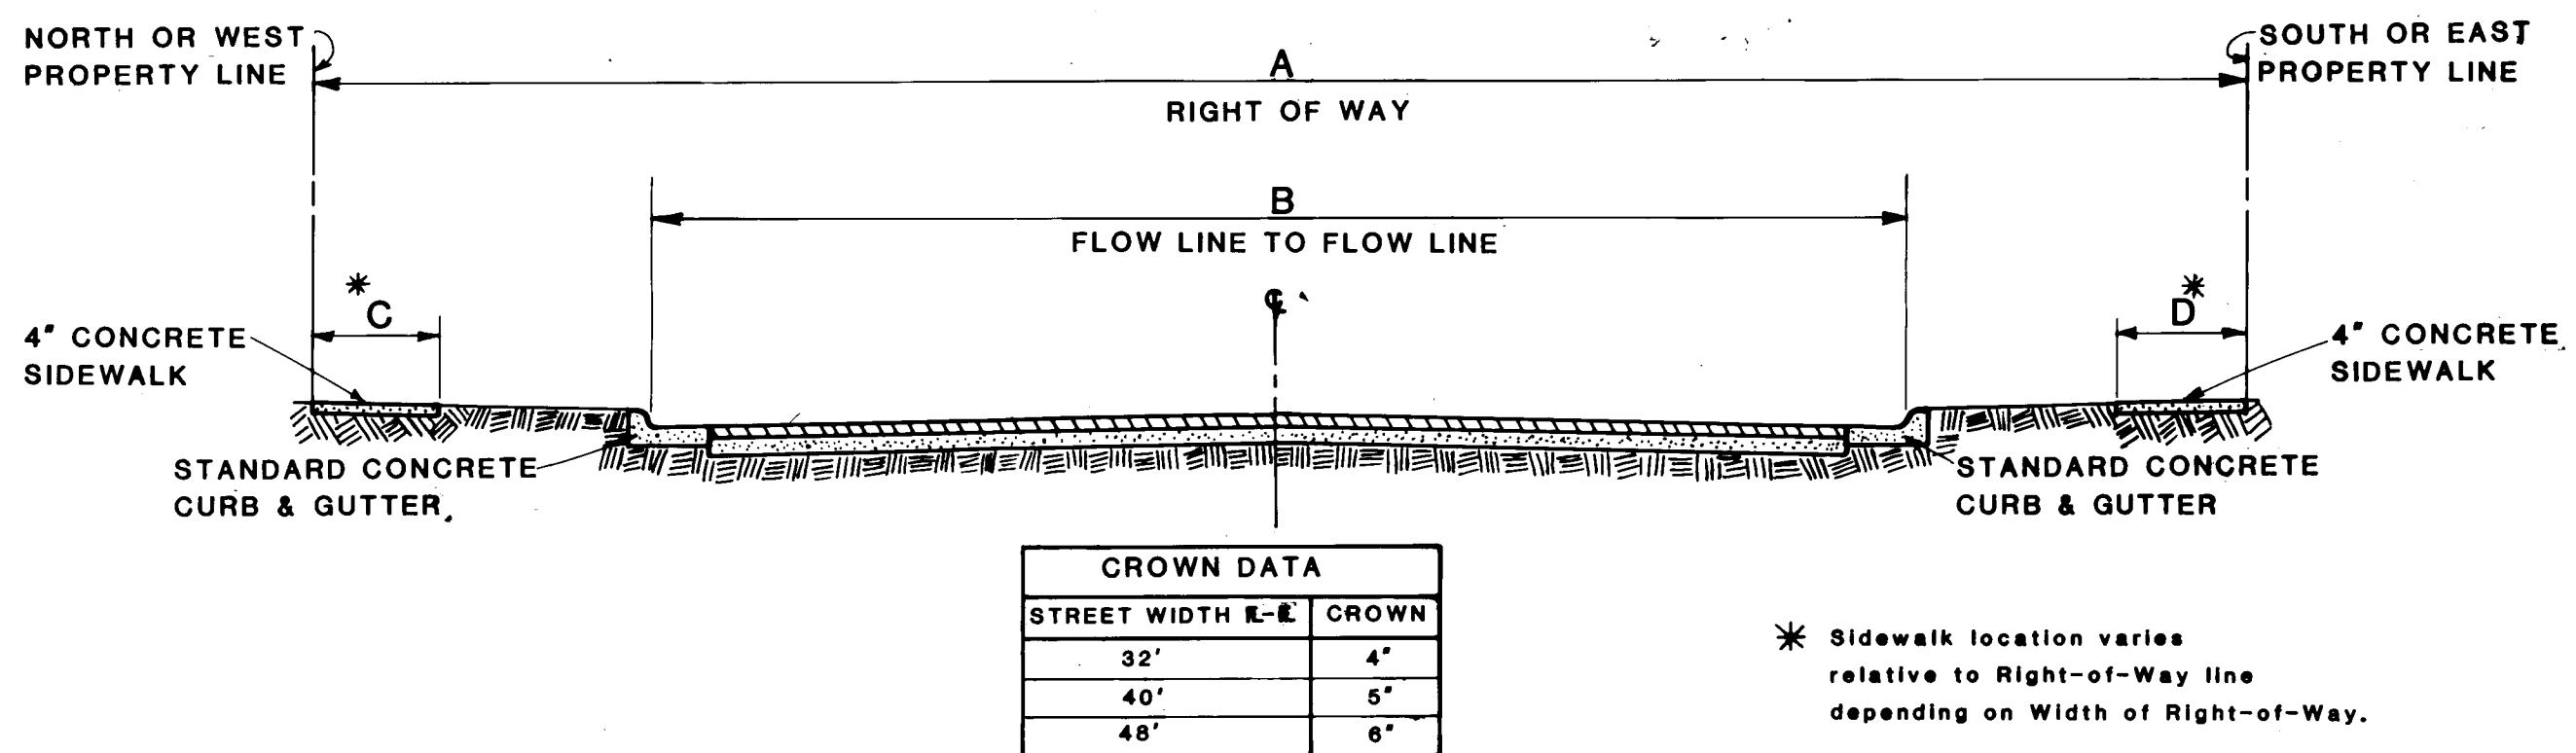


TYPICAL STREET SECTION

NOTE: 4' sidewalk on Gutierrez Road and Inca Street, adjacent to Michael's Subdivision Lots 1 through 42, to be 6 inches thick, and adjacent to Tract "A", 4 inches thick.


SCHEDULE OF STREET SECTIONS

STREET NAME	FROM	TO	MAP KEY	A	B	C	D	PAVEMENT SECTION
Lagrima De Oro Road	Pitt Street	Morris Street	F-21	60'-63'	40'	4'	4'	Residential
Lagrima De Oro Road	Morris Street	Juan Tabo Blvd.	F-21	60'	40'	4'	4'	Residential
Pitt Street	Gutierrez Road	Lagrima De Oro Road	F-21	50'-55'	40'	4' or 6'	0'	Residential
Gutierrez Road	Pitt Street	Morris Street	F-21	60'-55'	40'	4' or 6'	4'	Residential
Inca Street	Gutierrez Road	Lagrima De Oro Road	F-21	55'	40'	0'	4'	Residential
Inca Street	Elena Gallegos Grant Boundary	Gutierrez Road	F-21	50'	40'	4'	4'	Residential
Morris Street	Osuna Road	Lagrima De Oro Road	F-21	64'-66'	48'	4' or 6'	4' or 6'	Arterial
Cumbres	150' South of El Vado Ave.	Indian School Road	J-23	50'	40'	4'	4'	Residential
Service Road	Indian School Road	464' South of Indian School	J-22	40'	32'	4'	0'	Residential


** Sidewalk to be constructed only where street centerline to RW centerline dimension is 30 feet or greater.
*** See paving plans.

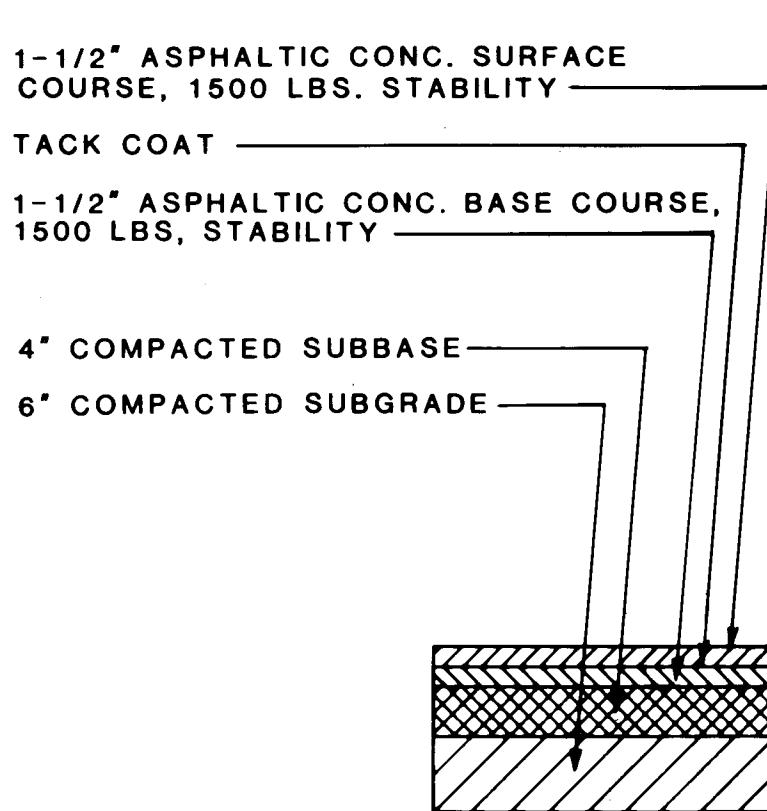

RESIDENTIAL PAVEMENT SECTION

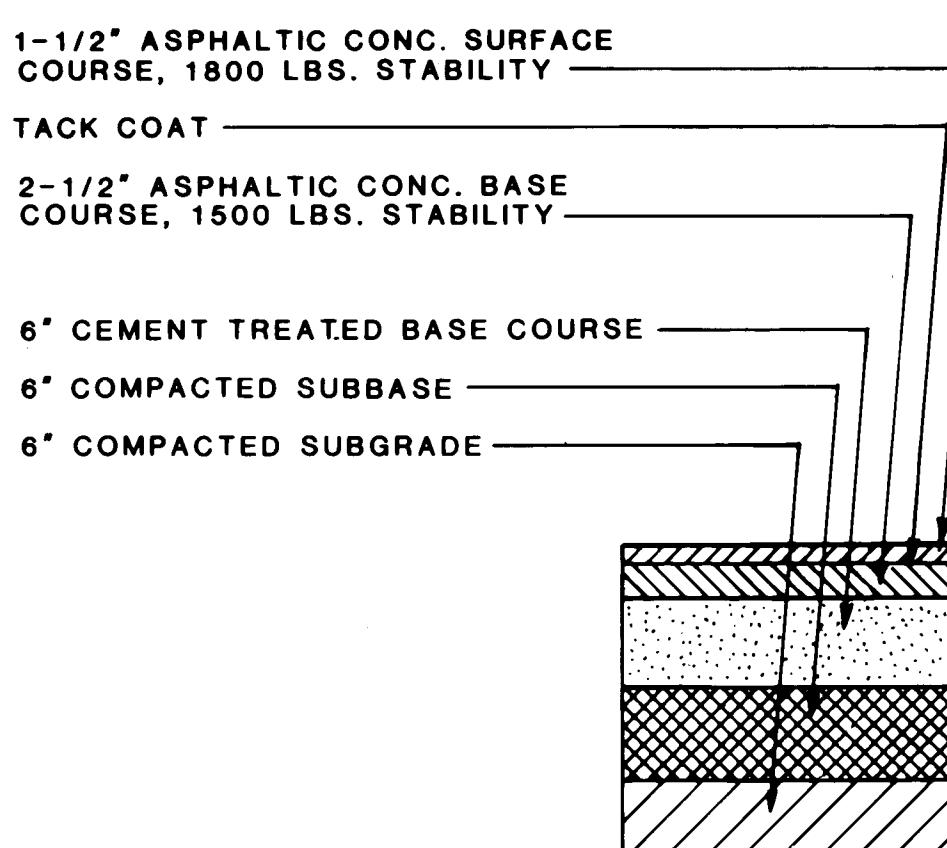

ARTERIAL PAVEMENT SECTION

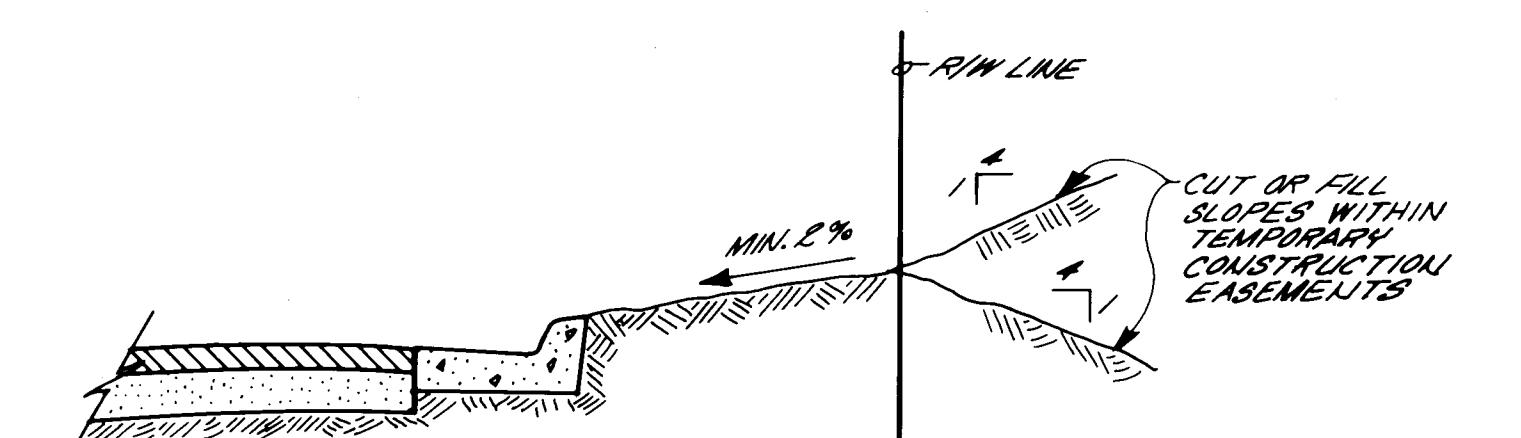

TYPICAL SHOULDER SECTION

WITHOUT SIDEWALK

NOT TO SCALE

AS BUILT INFORMATION	
CONTRACTOR	W.M.A.
WORK DAY	DATE 1/28/88
SUPERVISORS	W.M.A.
ACCEPTANCE BY	W.M.A.
FIELD	DATE 1/28/88
VERIFICATION BY	W.M.A.
CORRECTED BY	W.M.A.
MICRO-FILM INFORMATION	
RECORDED BY	NO

ENGINEER'S SEAL	SURVEY INFORMATION	BENCH MARKS
	FIELD NOTES	
	NO BY DATE	

REVISIONS	DESIGN	DATE Mar. 1985
REMARKS	DRAWN BY	DATE Mar. 1985
	CHECKED BY	DATE Mar. 1985

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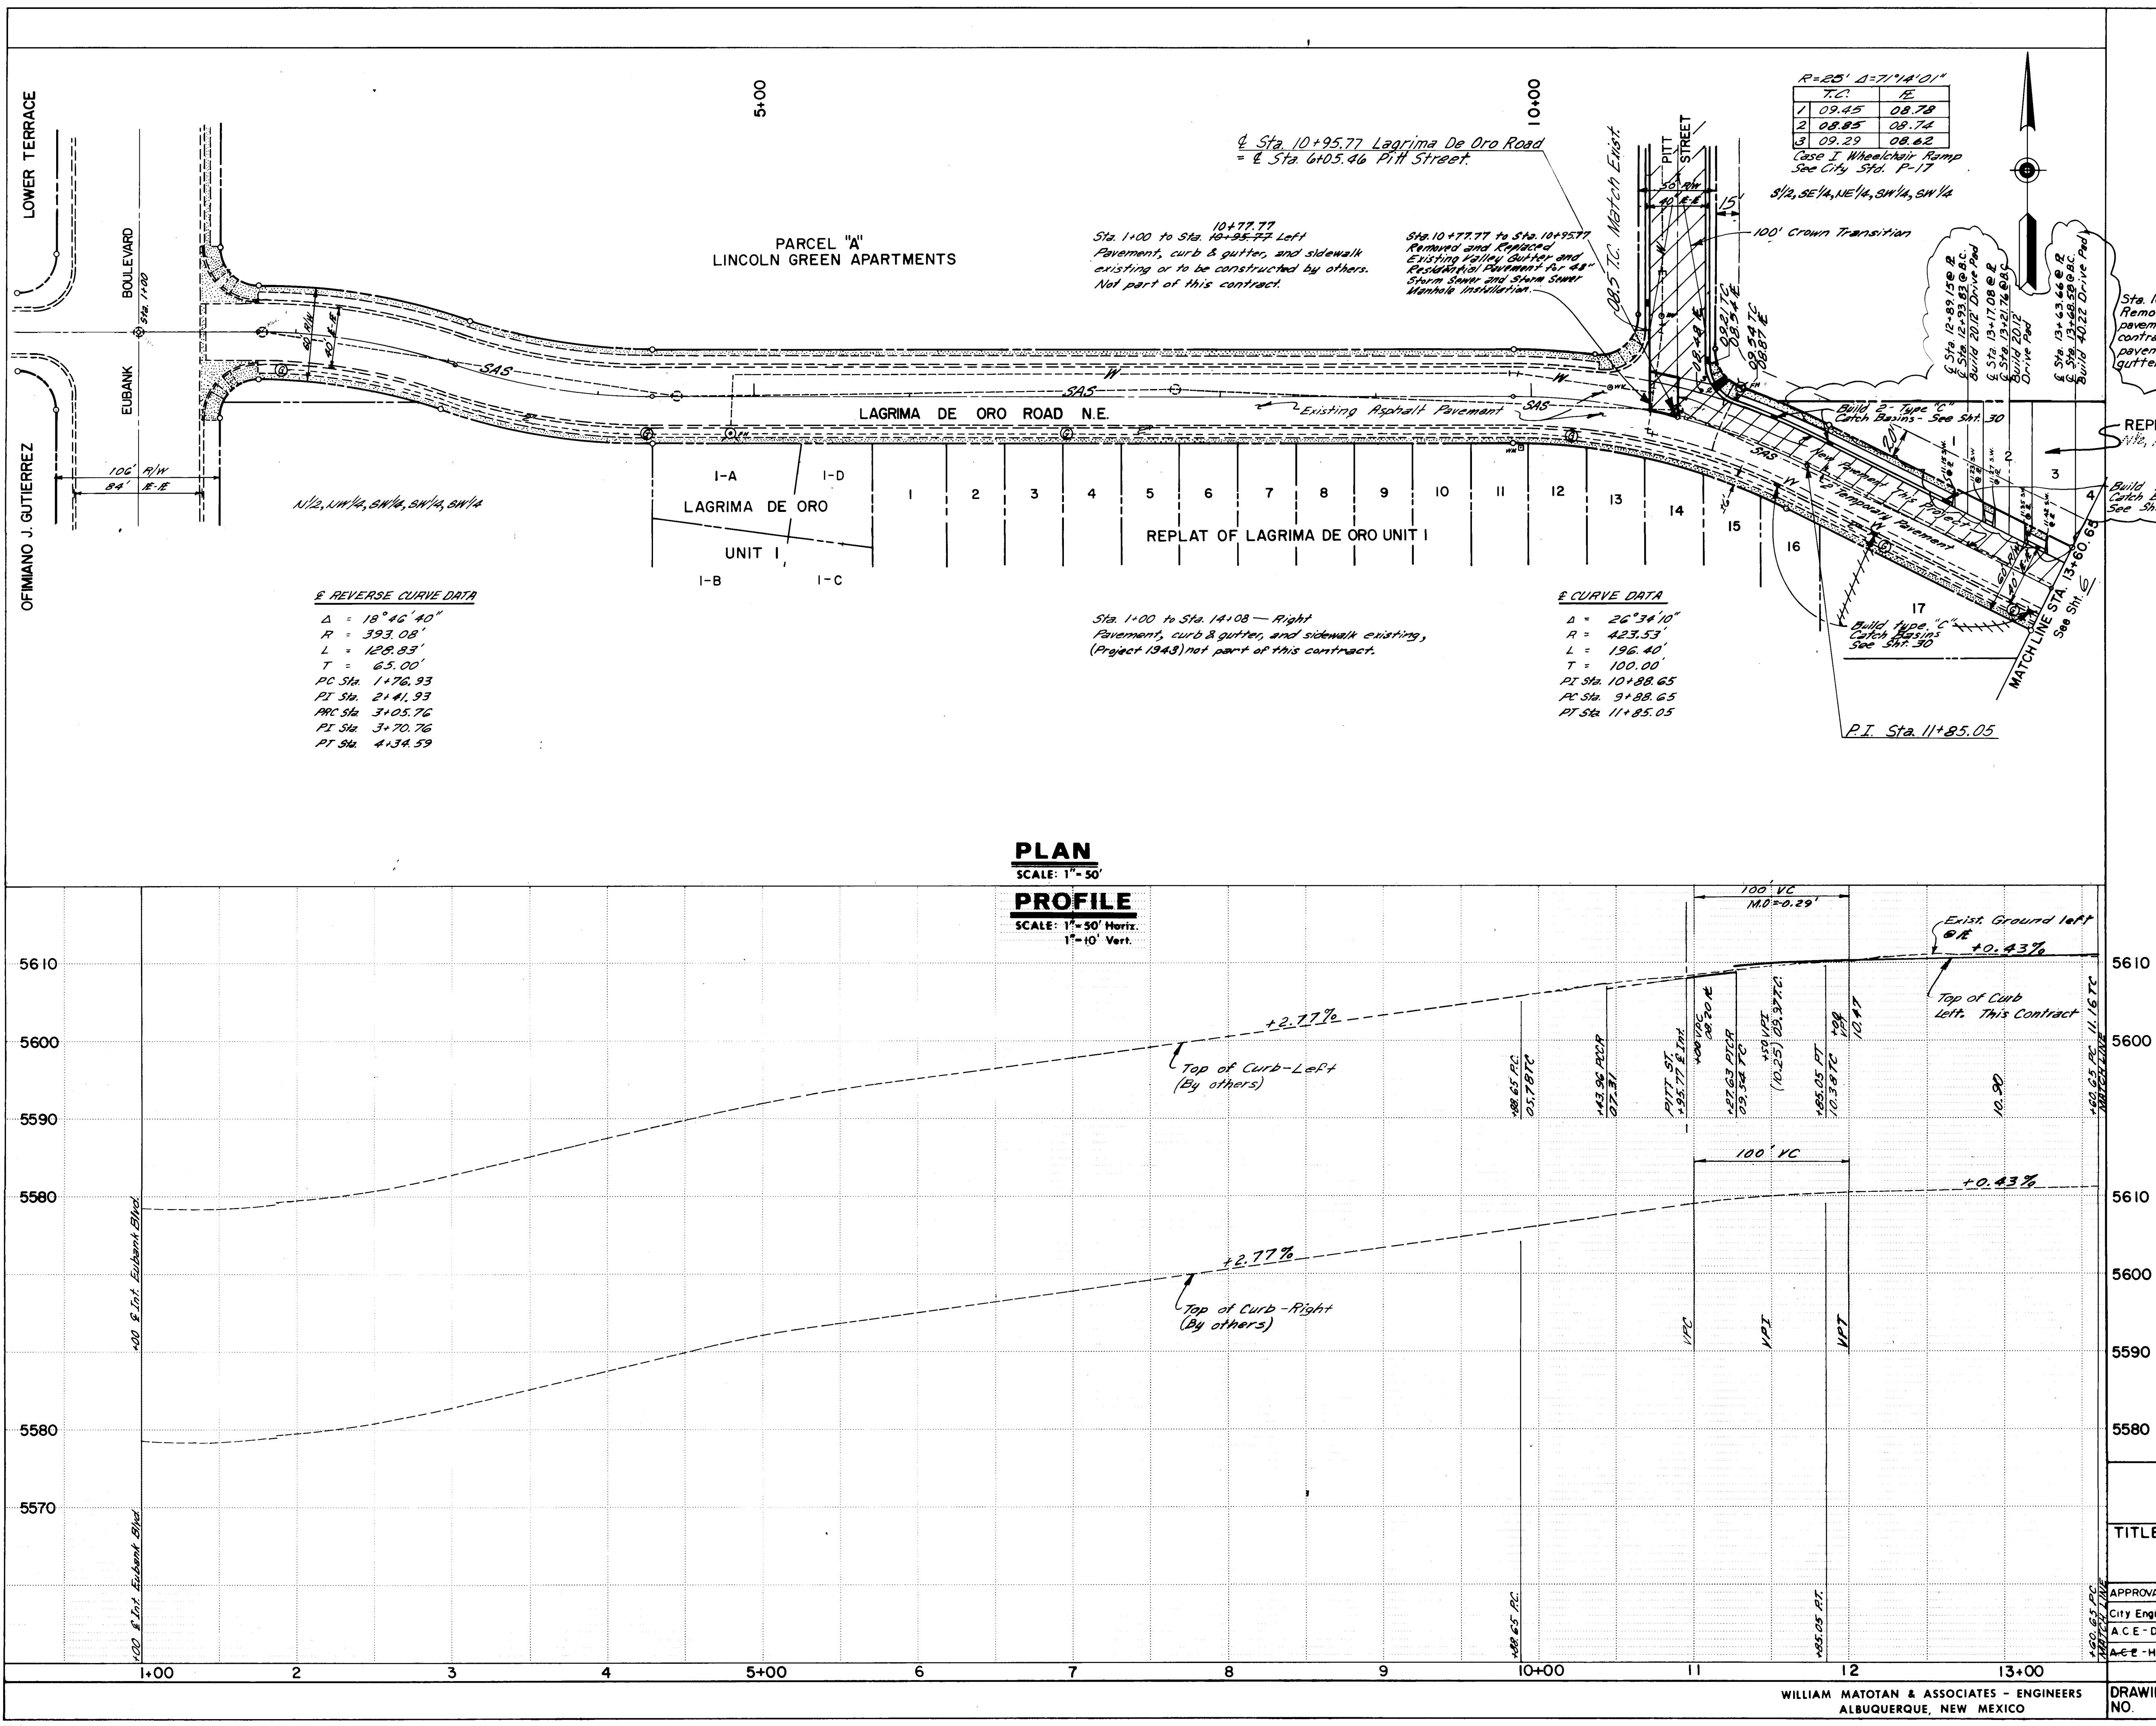
RECORD DRAWING
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CITY OF ALBUQUERQUE
MUNICIPAL DEVELOPMENT DEPARTMENT
ENGINEERING DIVISION

TITLE: SPECIAL ASSESSMENT DISTRICT 204
TYPICAL STREET SECTION & SCHEDULE

APPROVALS	ENGINEER	DATE	APPROVALS	ENGINEER	DATE
City Engineer	C. H. [Signature]	1/28/88	Liquid Waste	[Signature]	1/28/88
A.C.E.-Design	M. Ochoa	1/15/88	Traffic	D. J. W. [Signature]	1/28/88
A.C.E.-Hydrology	No. Legge	1/28/88	Water	R. [Signature]	1/28/88

DRAWING NO 1646 MAP NO SHEET 4 OF 36



RECORD DRAWING
Drawings revised to reflect the
best information available. Do
not use without field verification.

**CITY OF ALBUQUERQUE
MUNICIPAL DEVELOPMENT DEPARTMENT
ENGINEERING DIVISION**



**SPECIAL ASSESSMENT DISTRICT 204
LAGRIMA DE ORO ROAD
STA. I+00.00 TO STA. I3+60.65
PAVING**

ENGINEER	DATE	APPROVALS	ENGINEER	DATE
C. J. Doherty	5/8/85	Liquid Waste	R. Reina	5/8/85
H.R. Olson	5/13/85	Traffic	Daniel W. Hansen	5/8/85
Don Brown	5/8/85	Water	R. Reina	5/8/85

WILLIAM MATOTAN & ASSOCIATES - ENGINEERS
ALBUQUERQUE, NEW MEXICO

WING	MAP NO.	SHEET	OF
1646	F-21	5	36

0699005

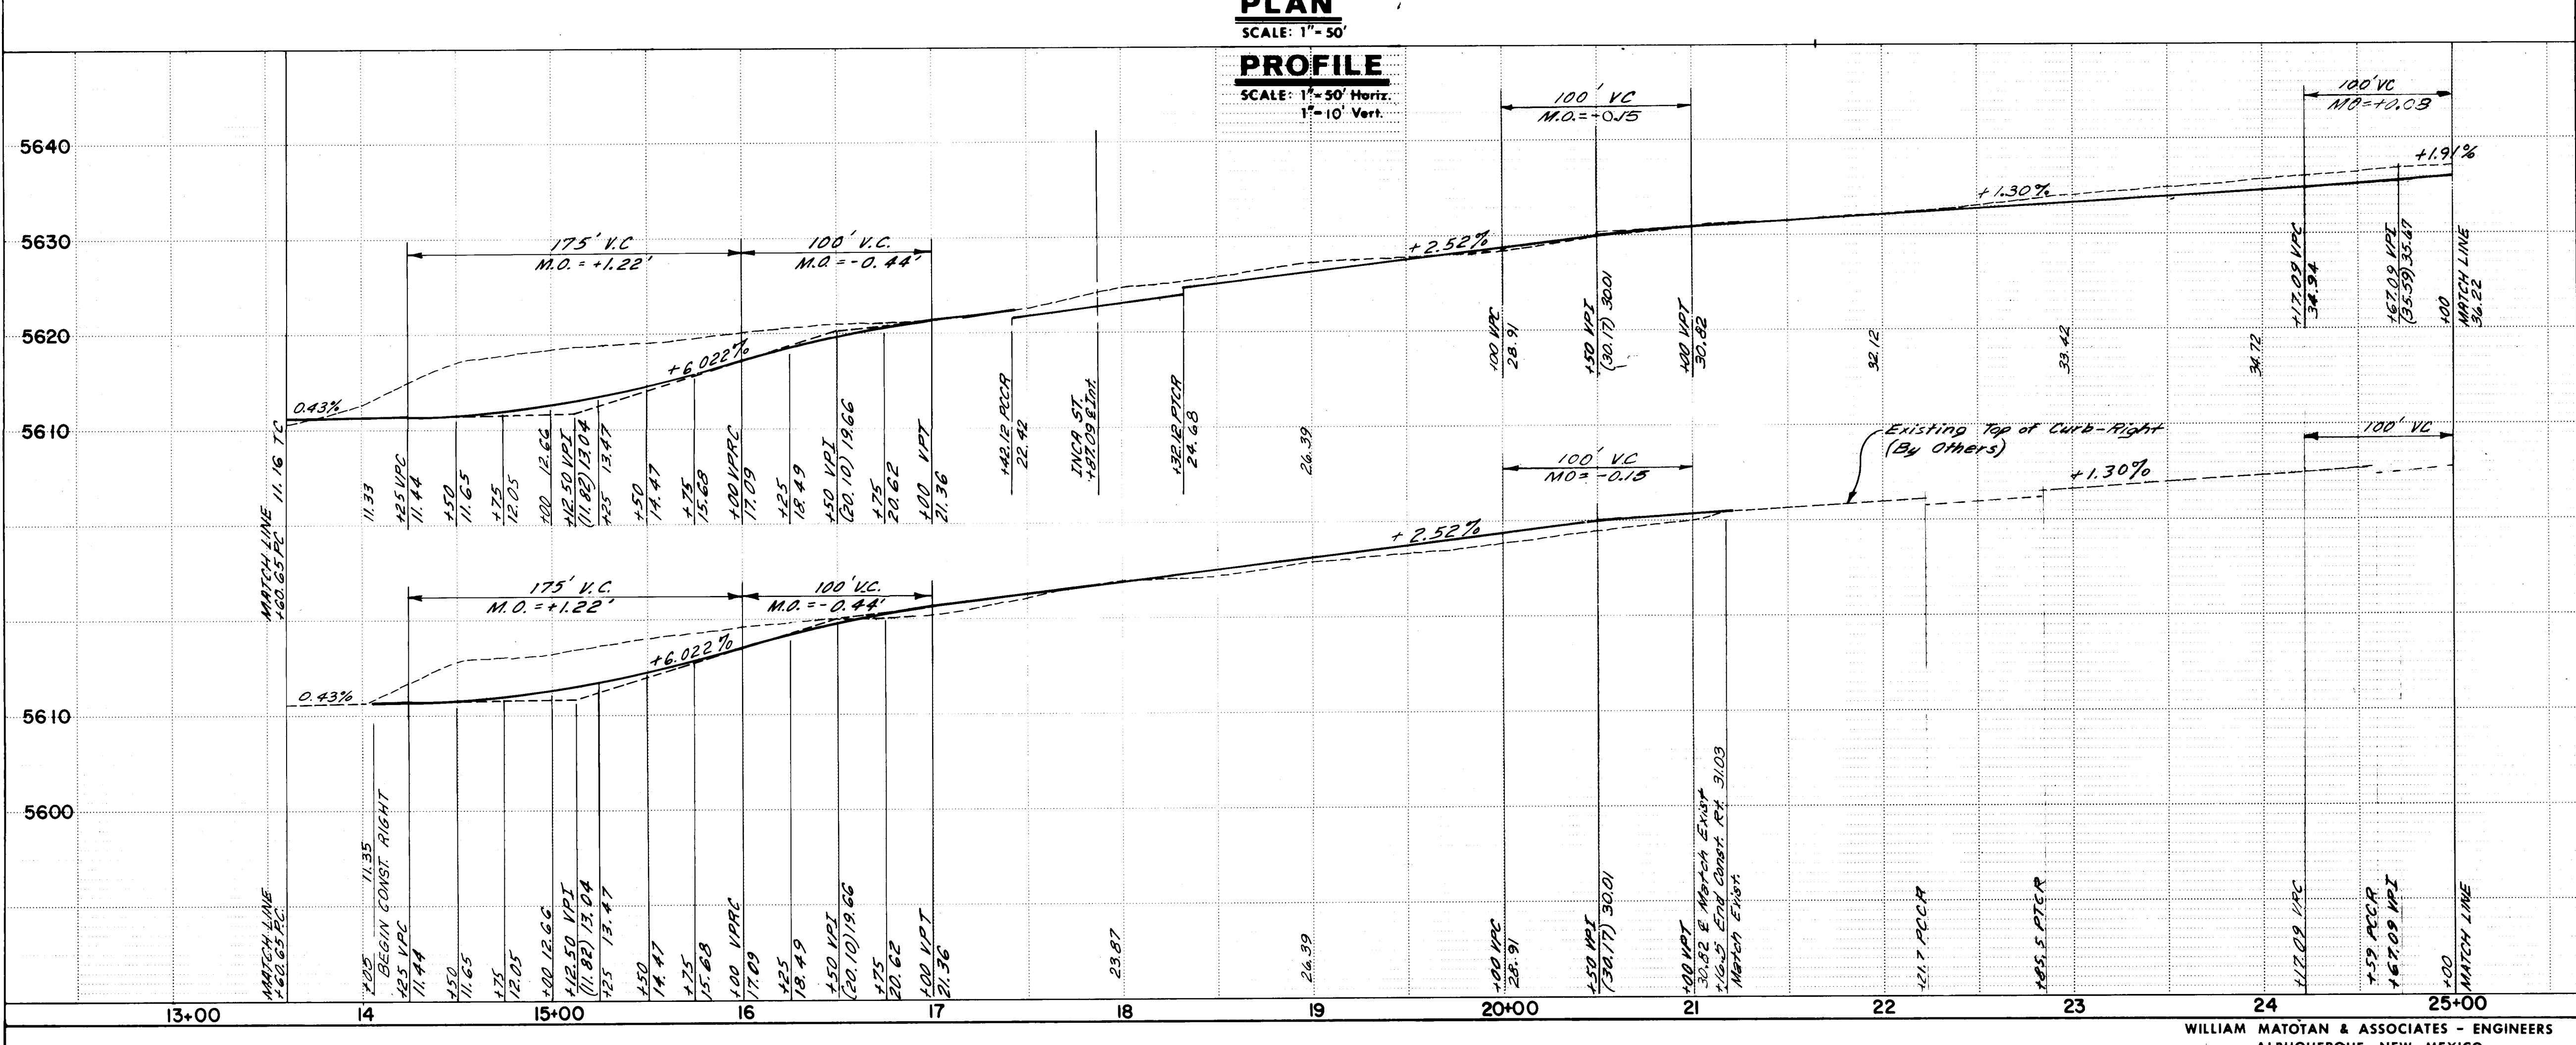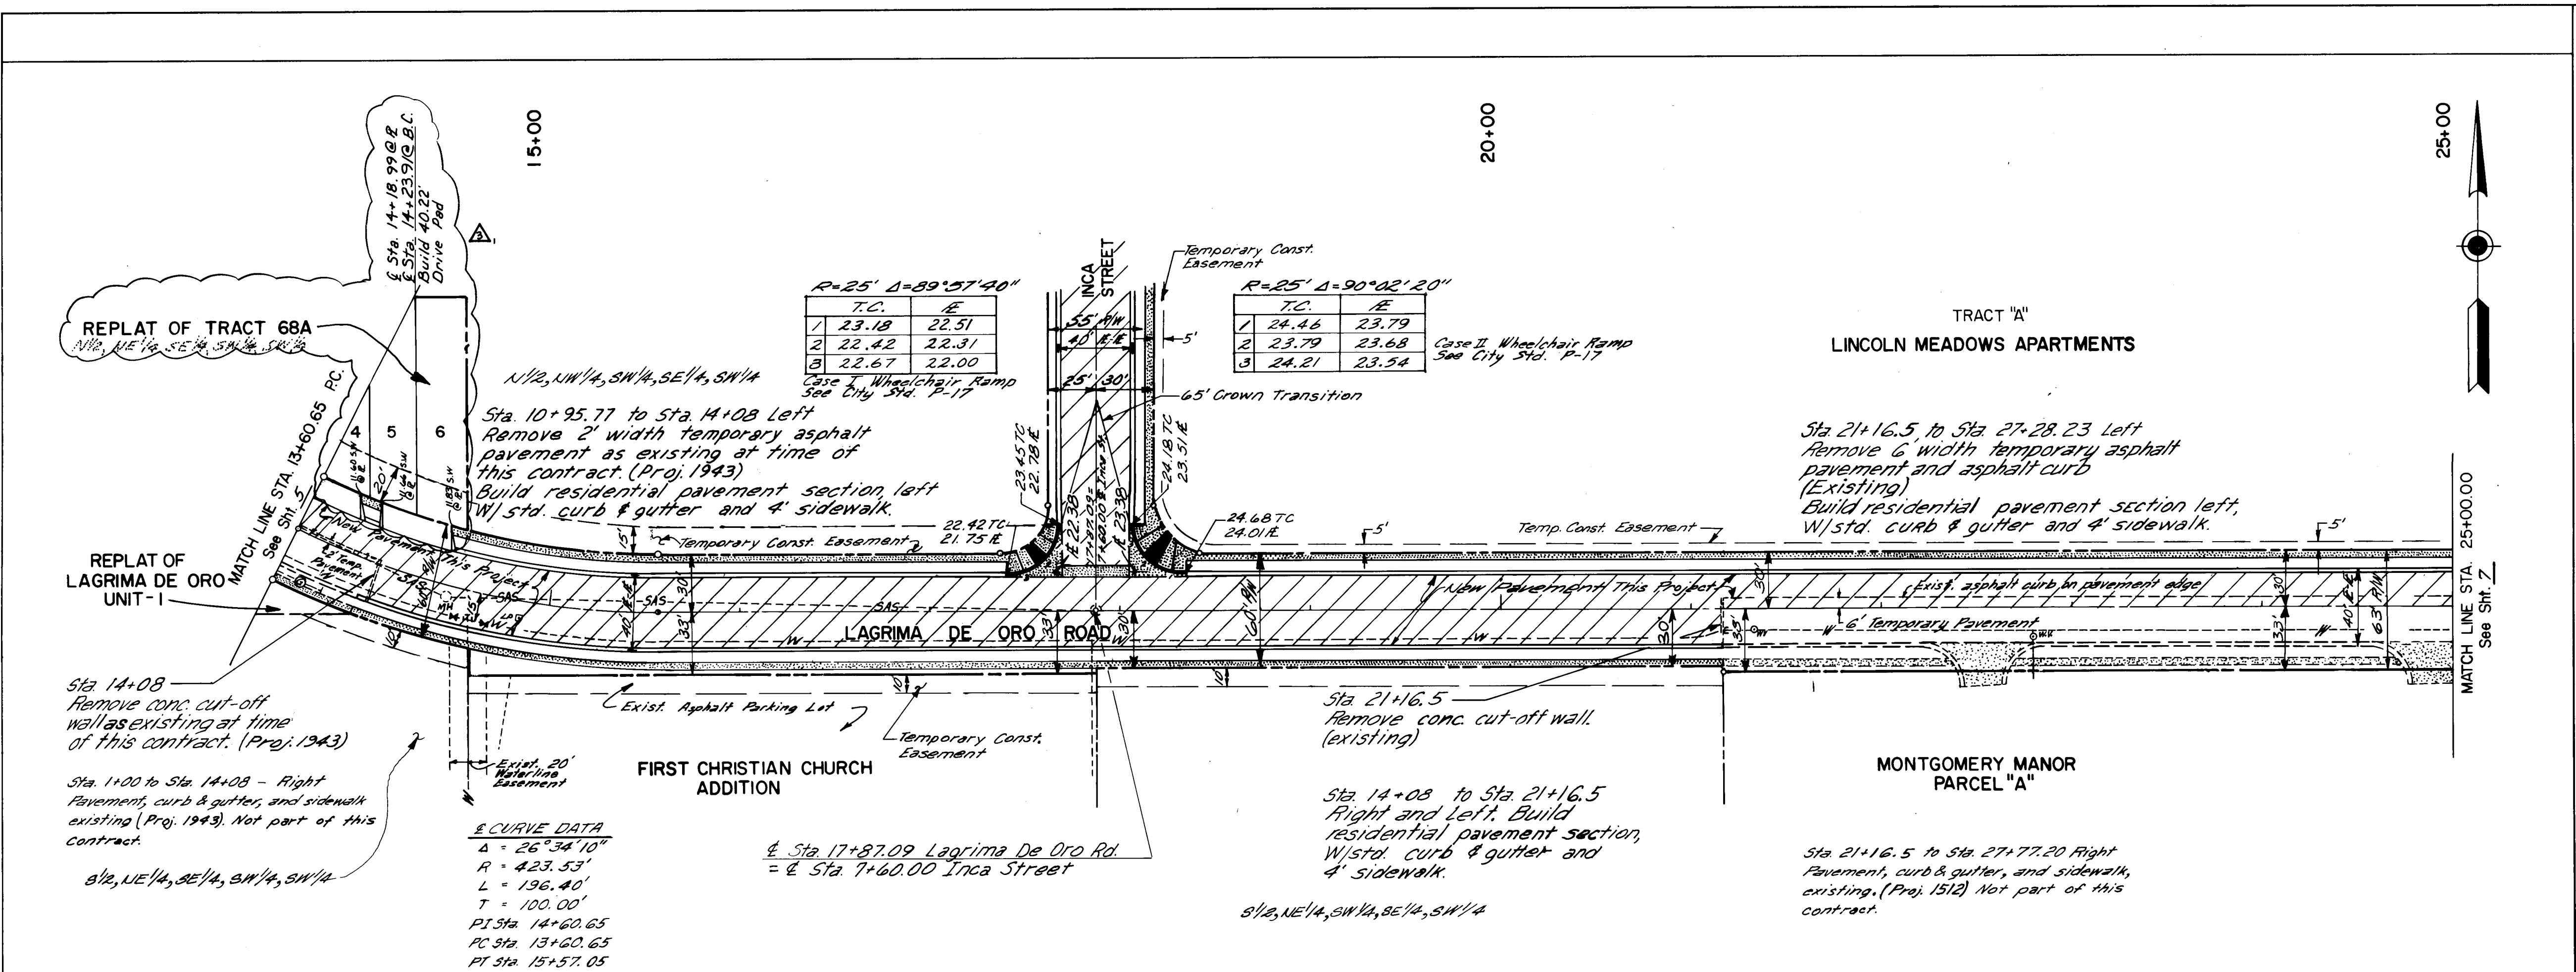

FIELD NOTES		BENCH MARKS		AS BUILT INFORMATION	
BY	DATE	CITY OF ALBUQUERQUE BRASS CAP 10 G-21 ON THE SOUTHWEST CURB RETURN OF MONTGOMERY AND MORRIS N.E. ELEV 5636.11	CONTRACTOR K.N.C. INC.	WORK STAKED BY W.M.A.	DATE 1-31-86
		INSPECTORS	INSPECTORS	ACCEPTANCE BY W.M.A.	DATE 1-31-86
				FIELD VERIFICATION BY W.M.A.	DATE 1-31-86
				DRAWINGS CORRECTED BY W.M.A.	DATE 1-31-86
MICRO-FILM INFORMATION					
RECORDED BY		DATE			
NO					

CITY OF ALBUQUERQUE

RECORD DRAWING
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best information available. Do
not use without field verification.

**CITY OF ALBUQUERQUE
MUNICIPAL DEVELOPMENT DEPARTMENT
ENGINEERING DIVISION**


ENGINEERING DIVISION
SPECIAL ASSESSMENT DISTRICT 204

APPROVALS	ENGINEER	DATE	APPROVALS	ENGINEER	DATE
City Engineer	C. D. Johnson	5/3/85	Liquid Waste	R. P. Davis	5/8/85
C.E. - Design	M. R. Olson	5/15/85	Traffic	David W. Hammes	5/8/85
C.E. - Hydrology	No Hoga	5/8/85	Water	R. P. Davis	5/8/85



24 **25-00**
WILLIAM MATOTAN & ASSOCIATES - ENGINEERS
ALBUQUERQUE, NEW MEXICO

DRAWING NO. 1646 | MAP NO. F-21 | SHEET 6 OF 36

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WILLIAM MATOTAN & ASSOCIATES - ENGINEERS
ALBUQUERQUE, NEW MEXICO

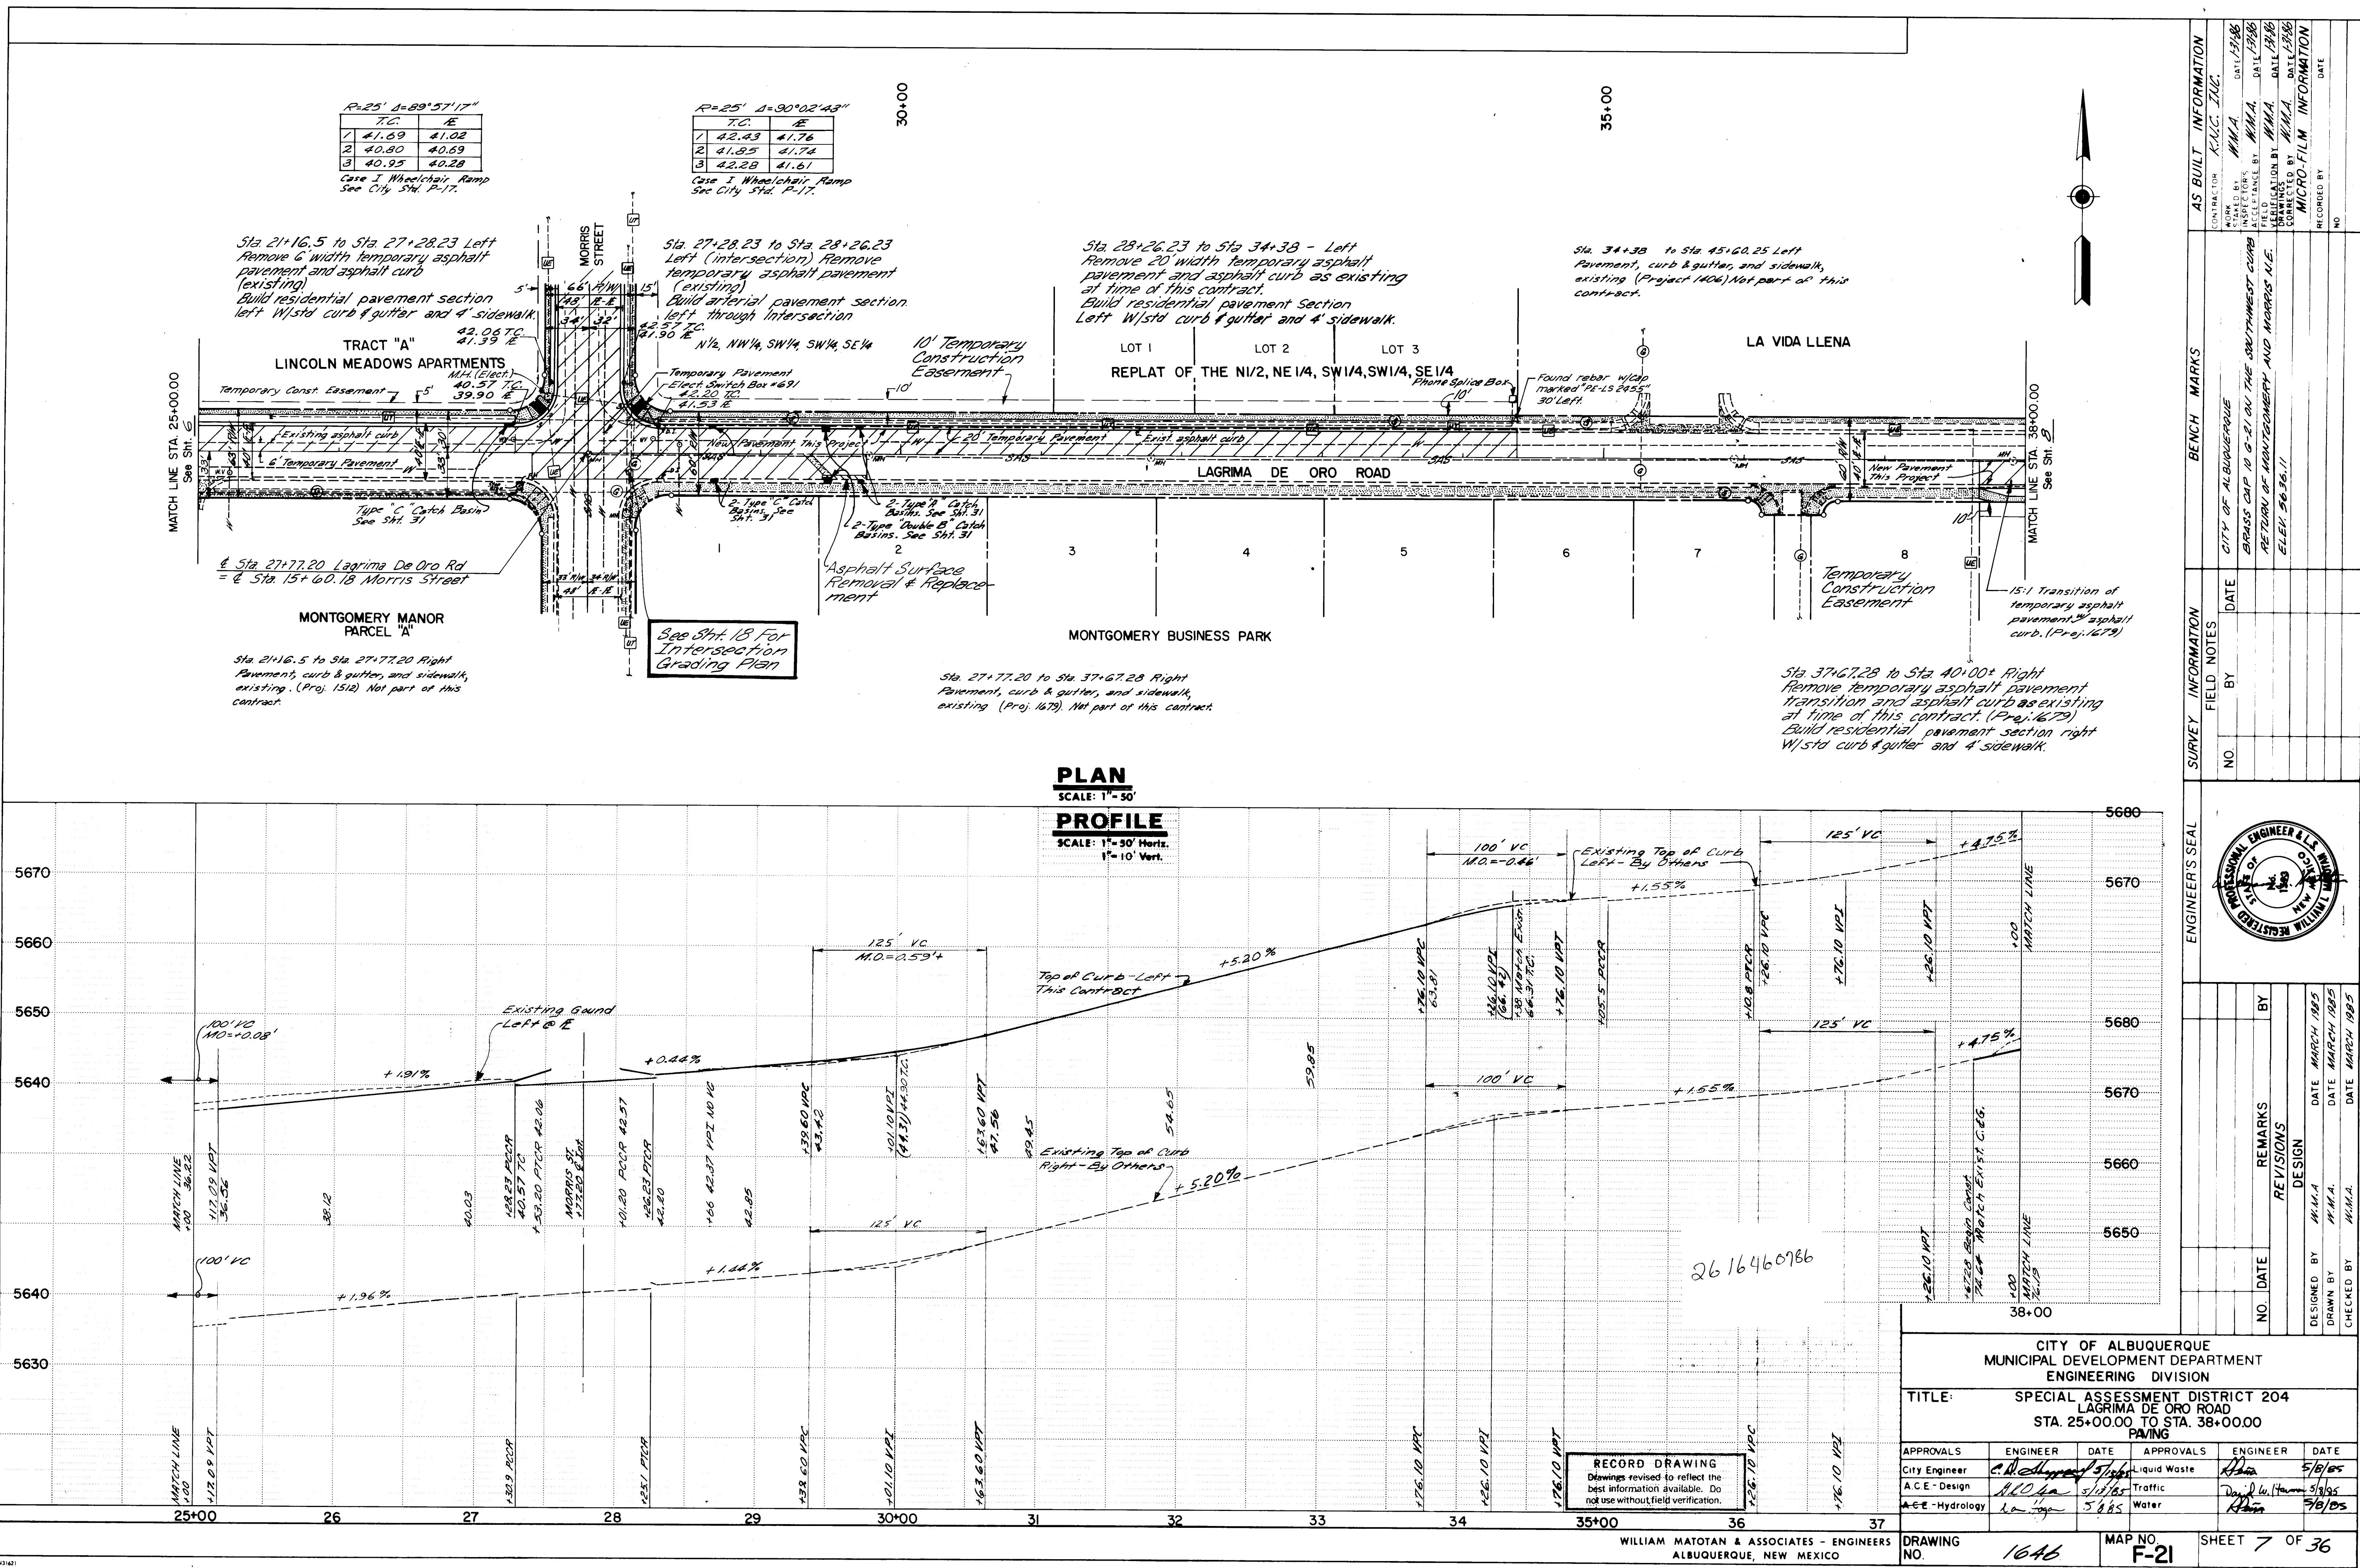PAVING					
ALS	ENGINEER	DATE	APPROVALS	ENGINEER	DATE
Engineer	C.H. Chapman	5/13/85	Liquid Waste	R. Dunn	5/8/85
Design	H.L. Olson	5/13/85	Traffic	Daryl W. Hansen	5/8/85
Hydrology	R. Dunn	5/18/85	Water	R. Dunn	5/8/85

RECORD DRAWING
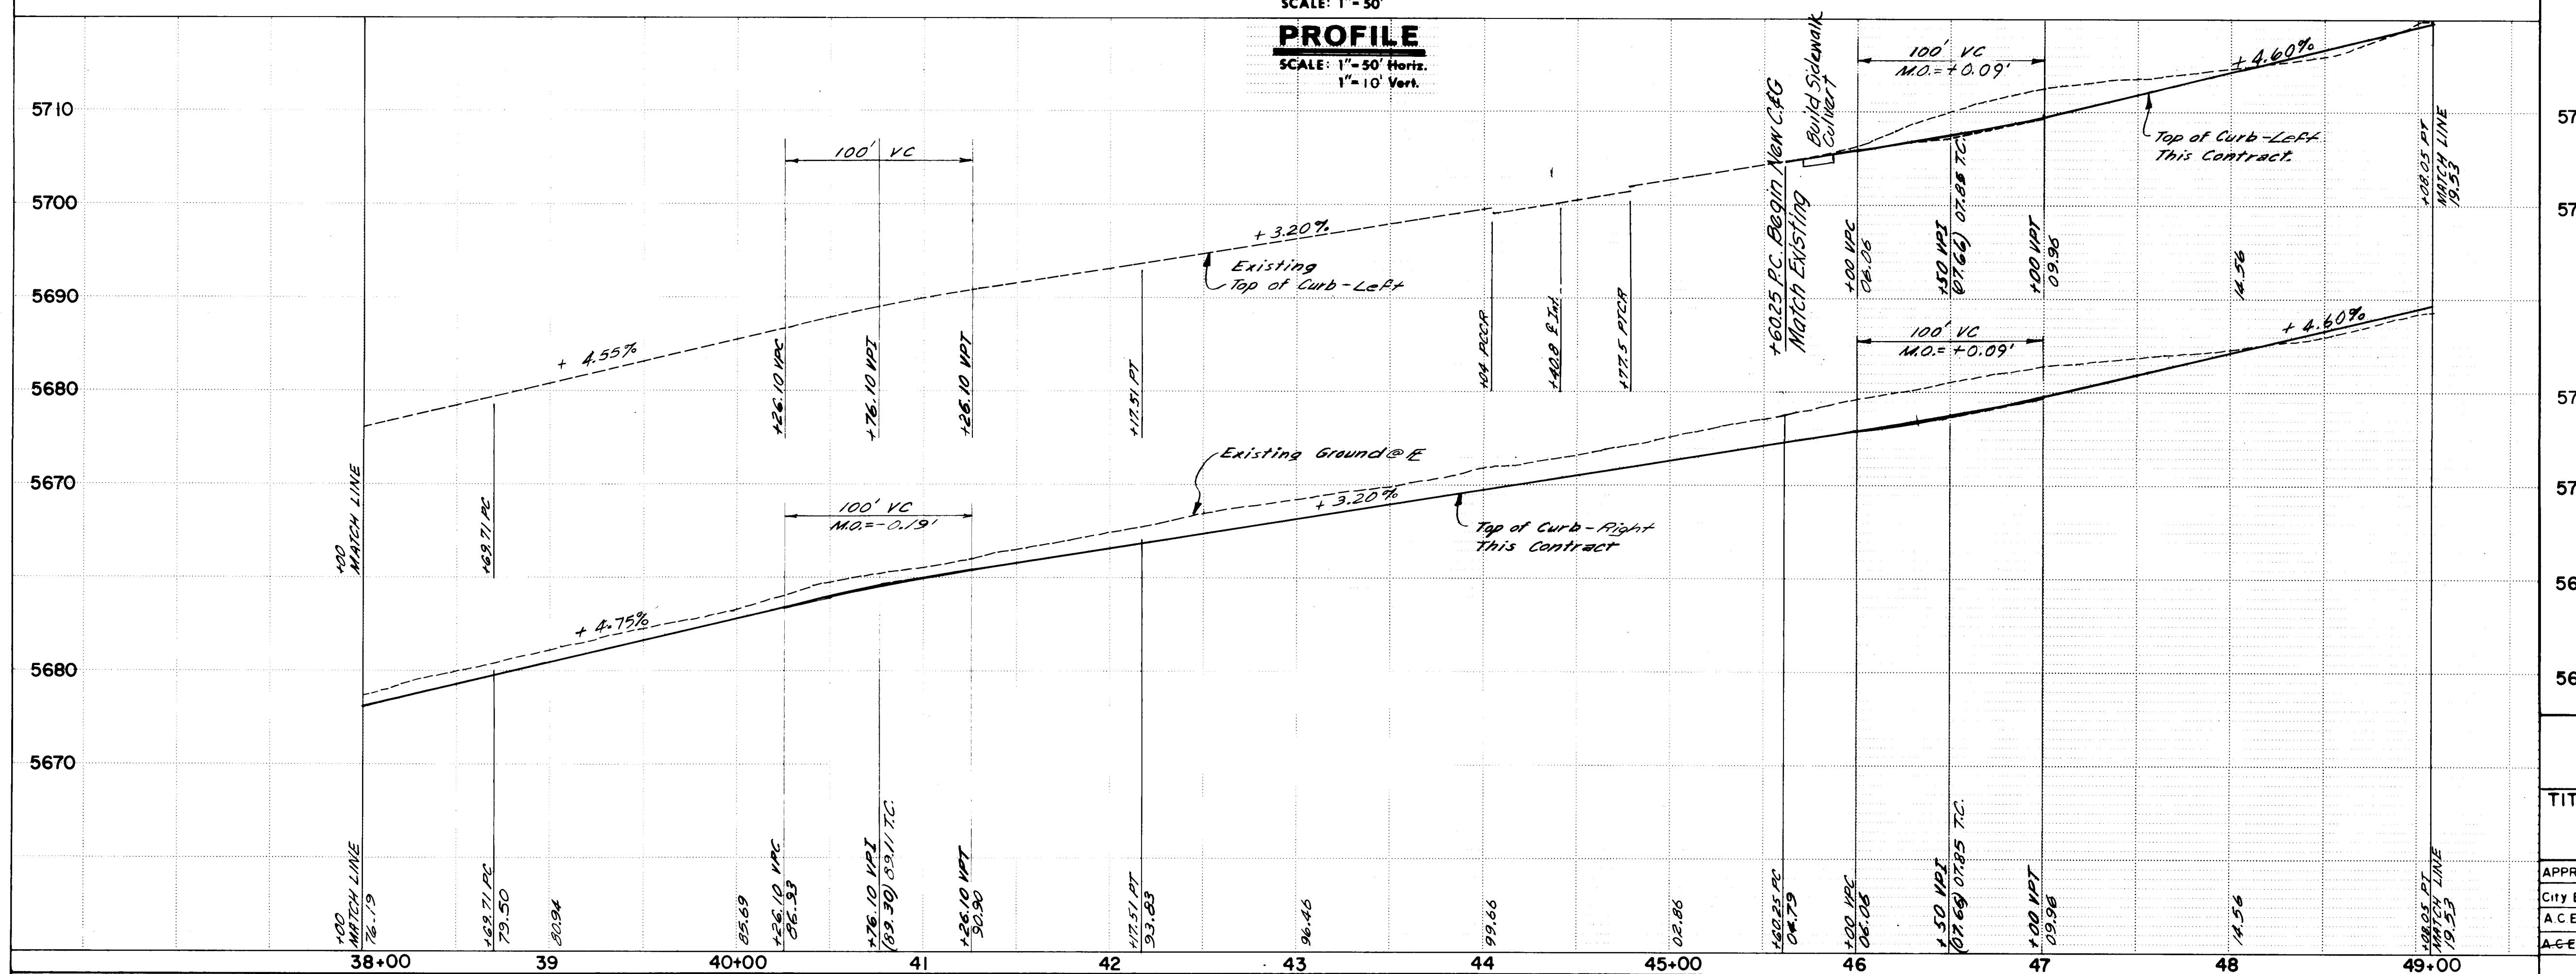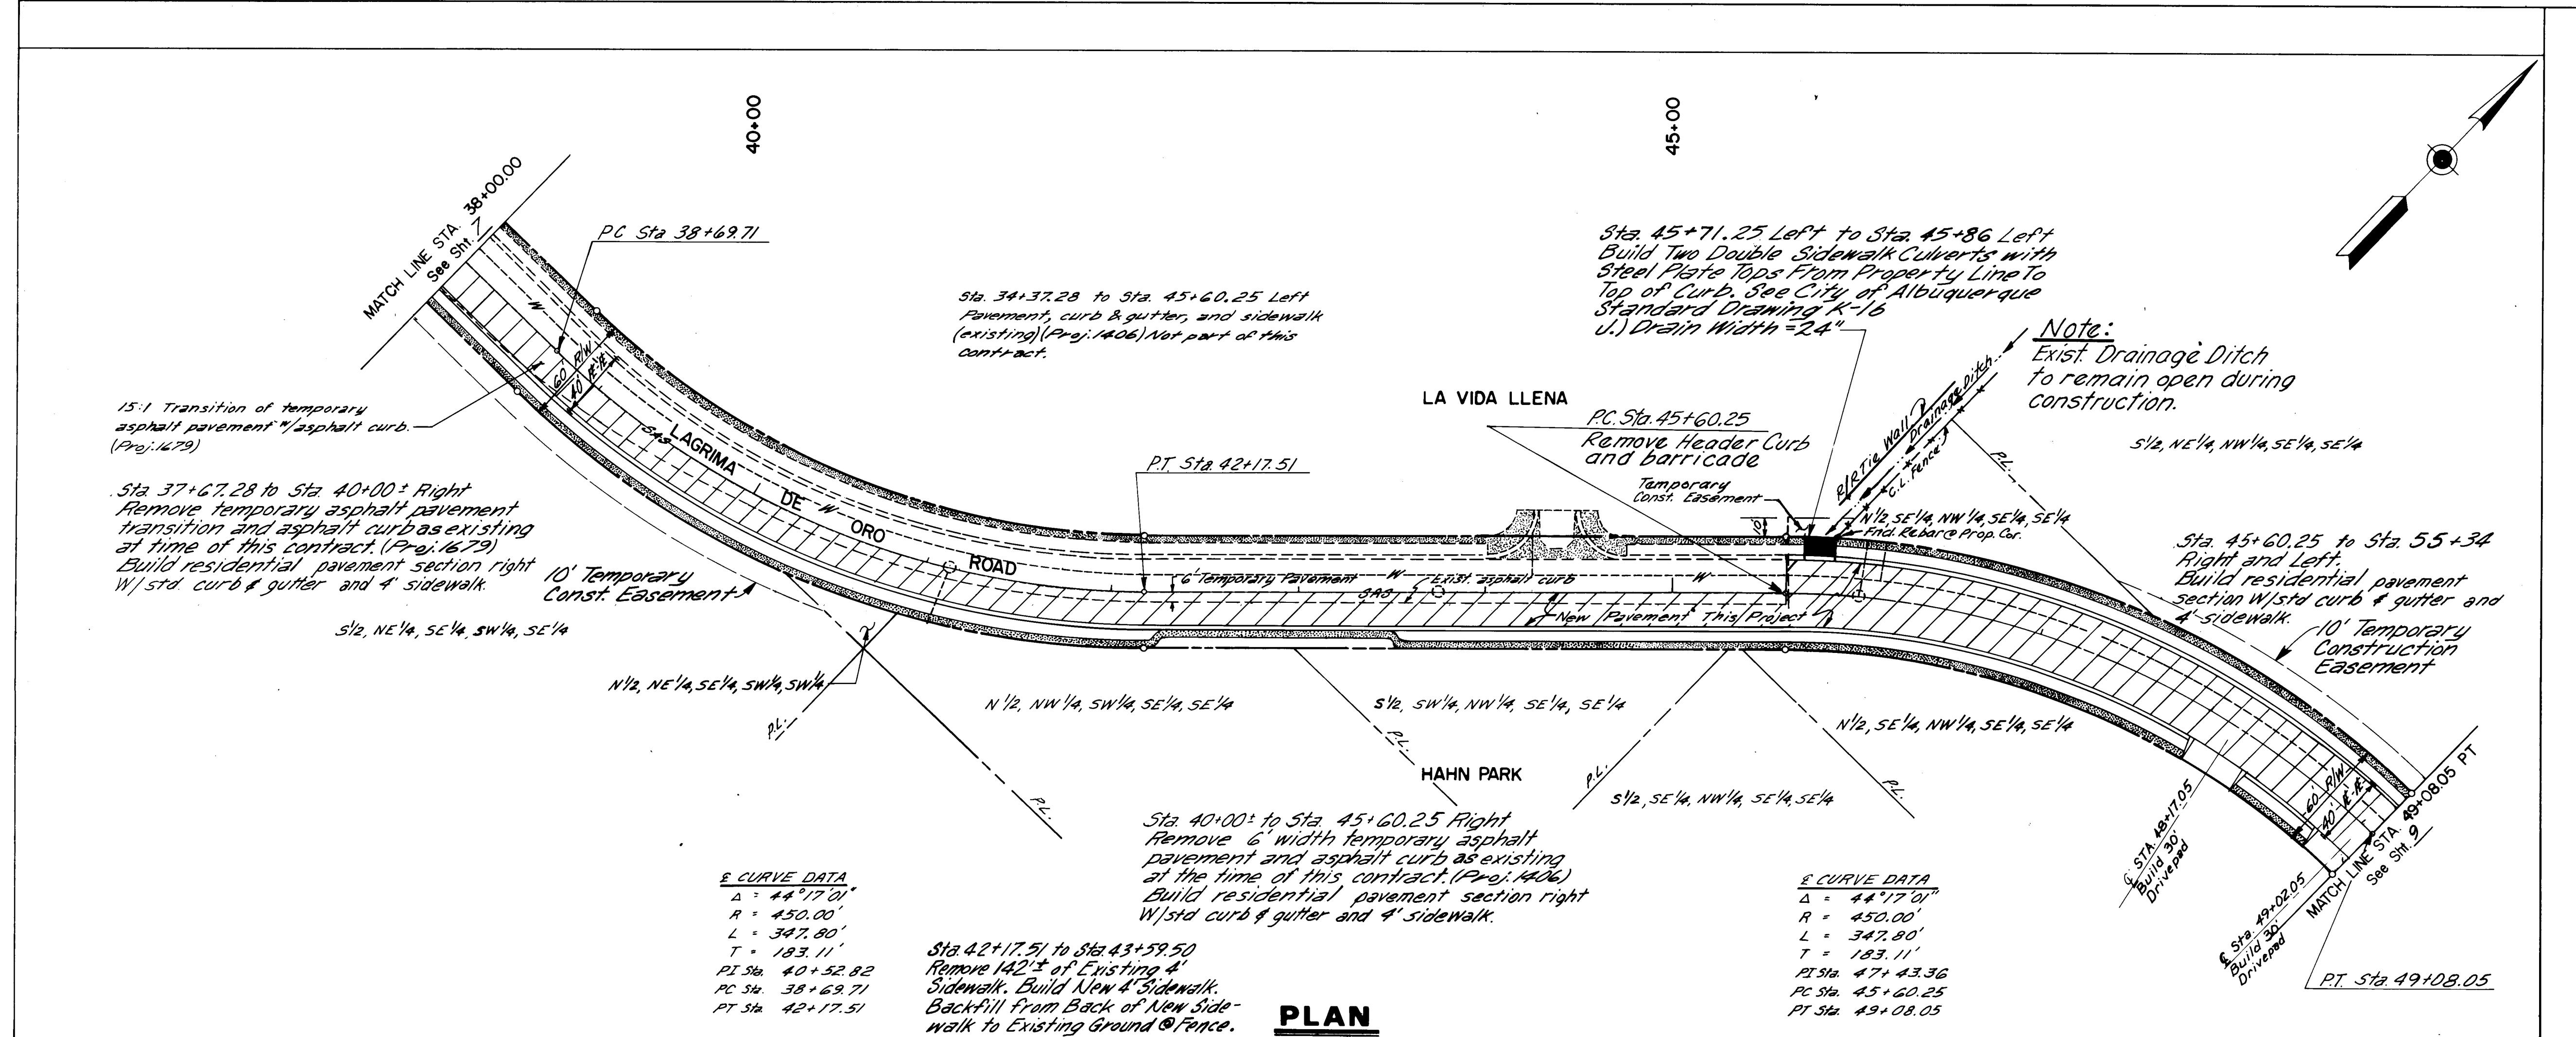
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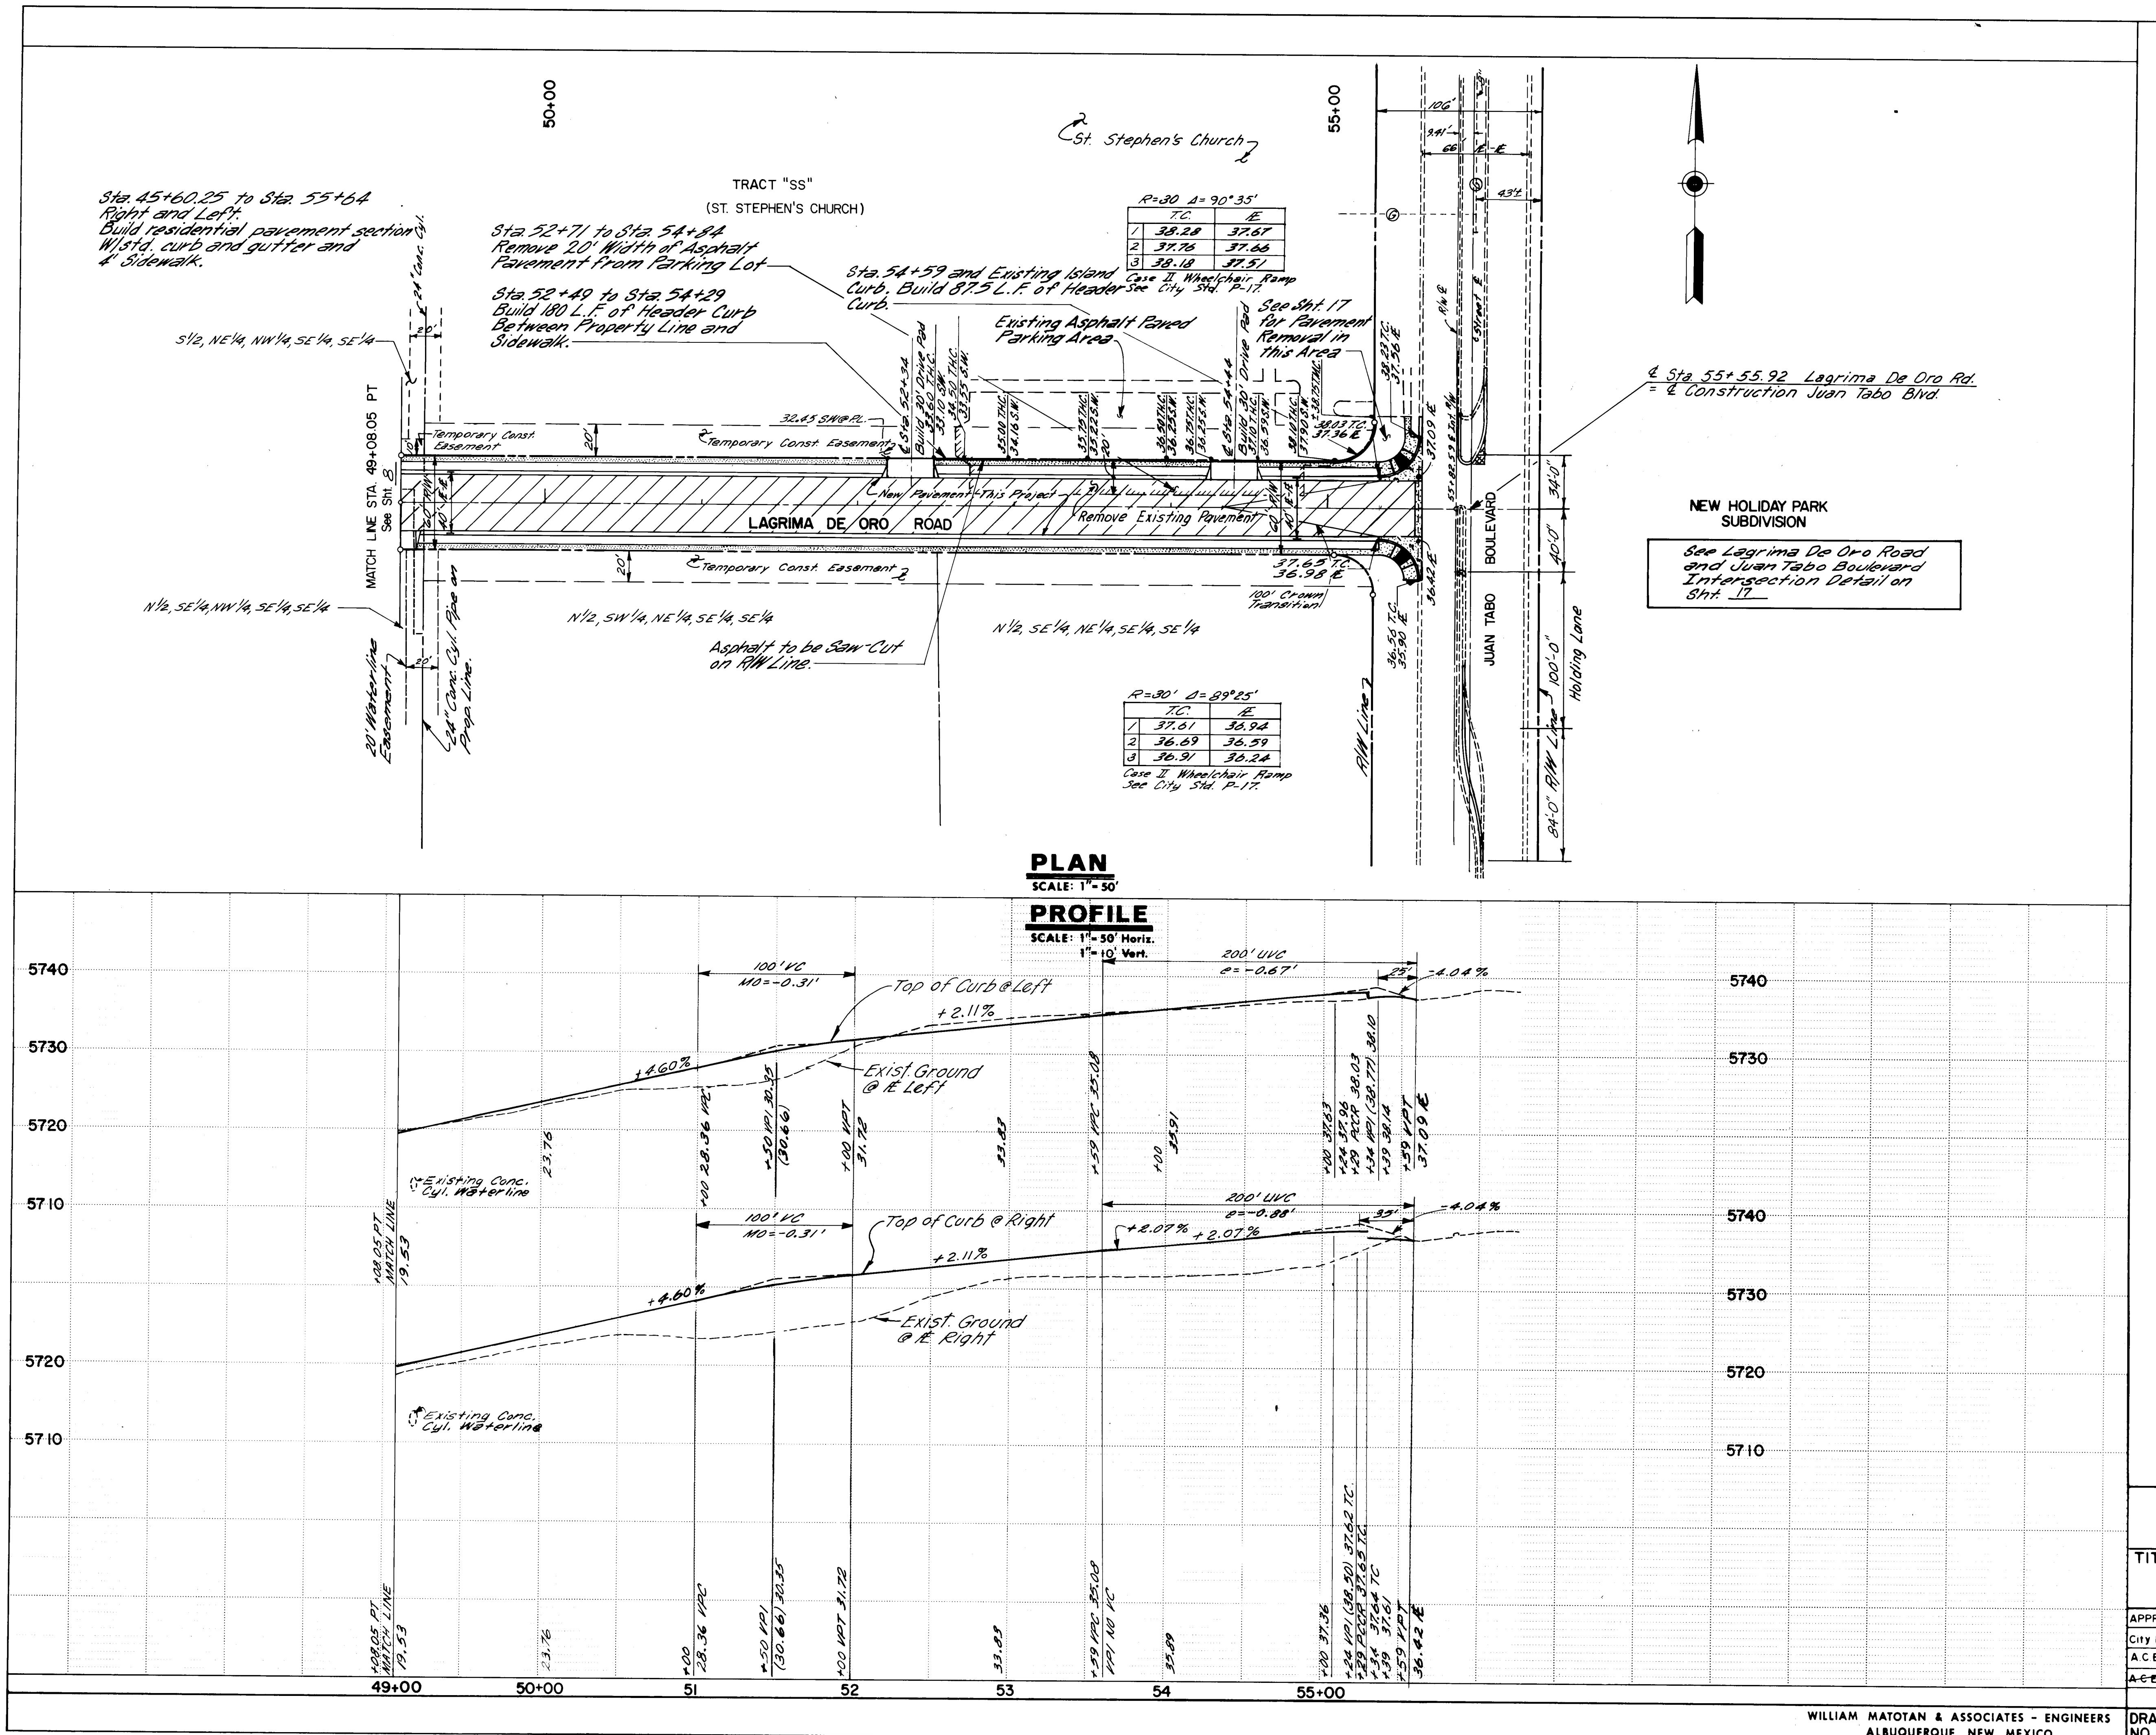
**CITY OF ALBUQUERQUE
MUNICIPAL DEVELOPMENT DEPARTMENT
ENGINEERING DIVISION**

E: SPECIAL ASSESSMENT DISTRICT 204
LAGRIMA DE ORO ROAD
STA. 38+00.00 TO STA. 49+07.98
PAVING

ALS	ENGINEER	DATE	APPROVALS	ENGINEER
Engineer	C. Johnson	5/1/04	Liquid Waste	R. Ranta


Design	H.C. Olson	5/13/85	Traffic	Douglas W. Hannum	5/8/85
Hydrology	2 1/2	1985	Water	8/10/85	5/8/85

NG 1646 MAP NO. F-21 SHEET 8 OF 36





AS BUILT INFORMATION						
CONTRACTOR: KING INC. DATE: 5/8/85 OWNER: CITY OF ALBUQUERQUE DATE: 5/8/85 INSPECTOR: WMA DATE: 5/8/85 ACCEPTANCE BY: WMA DATE: 5/8/85 FIELD DRAWINGS BY: WMA DATE: 5/8/85 DRAWINGS CORRECTED BY: WMA DATE: 5/8/85 MICRO-FILM INFORMATION DATE: NO						
SURVEY INFORMATION		BENCH MARKS		FIELD NOTES		
NO.	BY	CITY OF ALBUQUERQUE BRASS CAP 100-21 ON THE SOUTHWEST CORNER RETAIN OR MONUMENT AND MARKS NO.	ELEV.	DATE	BY	
12-19-85	AS-BUILT REVISIONS	WMA	56.36	ELEV. 56.36.11	REMARKS	
NO. DATE	REMARKS	BY				
REVISIONS						
DESIGNED BY <i>WMA</i> DATE <i>MAR 1985</i>	DRAWN BY <i>WMA</i> DATE <i>MAR 1985</i>	CHECKED BY <i>WMA</i> DATE <i>MAR 1985</i>				
INTERNATIONAL ENGINEERS INC. 1985 ALL RIGHTS RESERVED						
2616460986						
49+00 50+00 51 52 53 54 55+00						
WILLIAM MATOTAN & ASSOCIATES - ENGINEERS ALBUQUERQUE, NEW MEXICO						
DRAWING NO. 1646 MAP NO. F-21 SHEET 9 OF 36						

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WILLIAM MATOTAN & ASSOCIATES - ENGINEERS
ALBUQUERQUE, NEW MEXICO

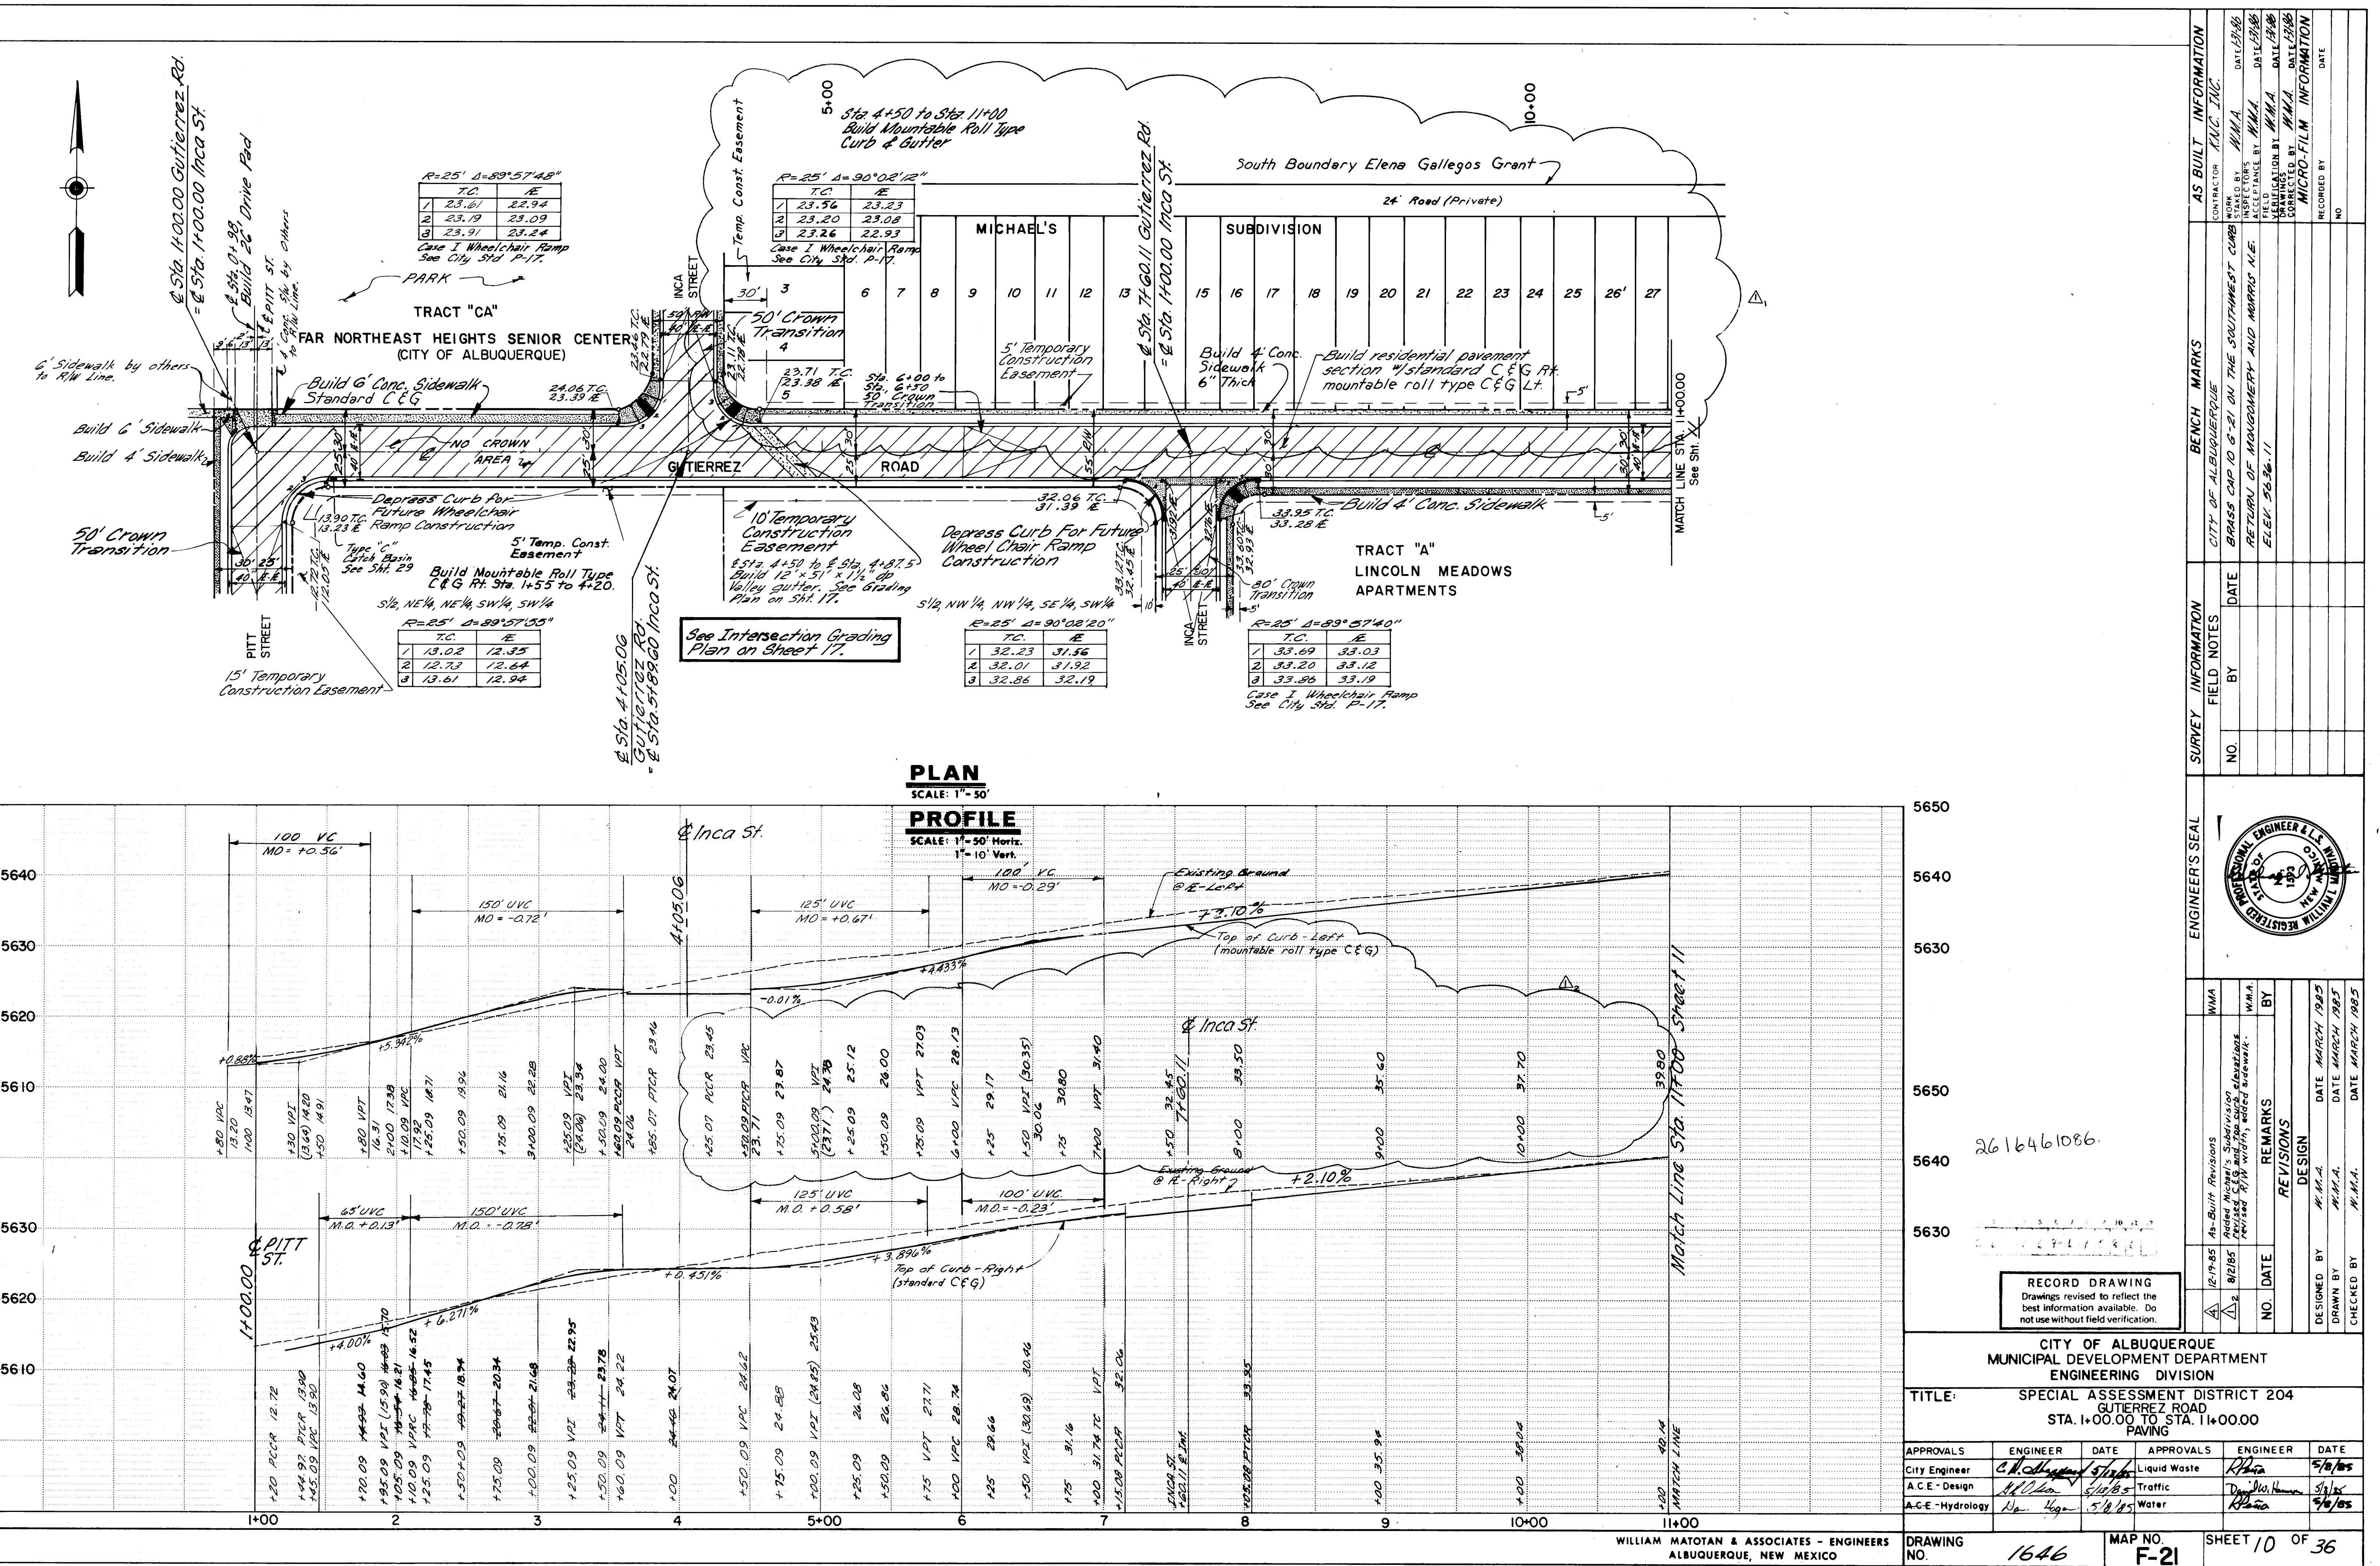LS	ENGINEER	DATE	APPROVALS	ENGINEER	DATE
eer	C. W. Haga	5/13/85	Liquid Waste	R. Peña	5/8/85
sign	H. O. Lee	5/13/85	Traffic	David W. Hansen	5/8/85
drology	John Haga	5/8/85	Water	R. Peña	5/8/85


RECORD DRAWING
Drawings revised to reflect the
best information available. Do
not use without field verification.

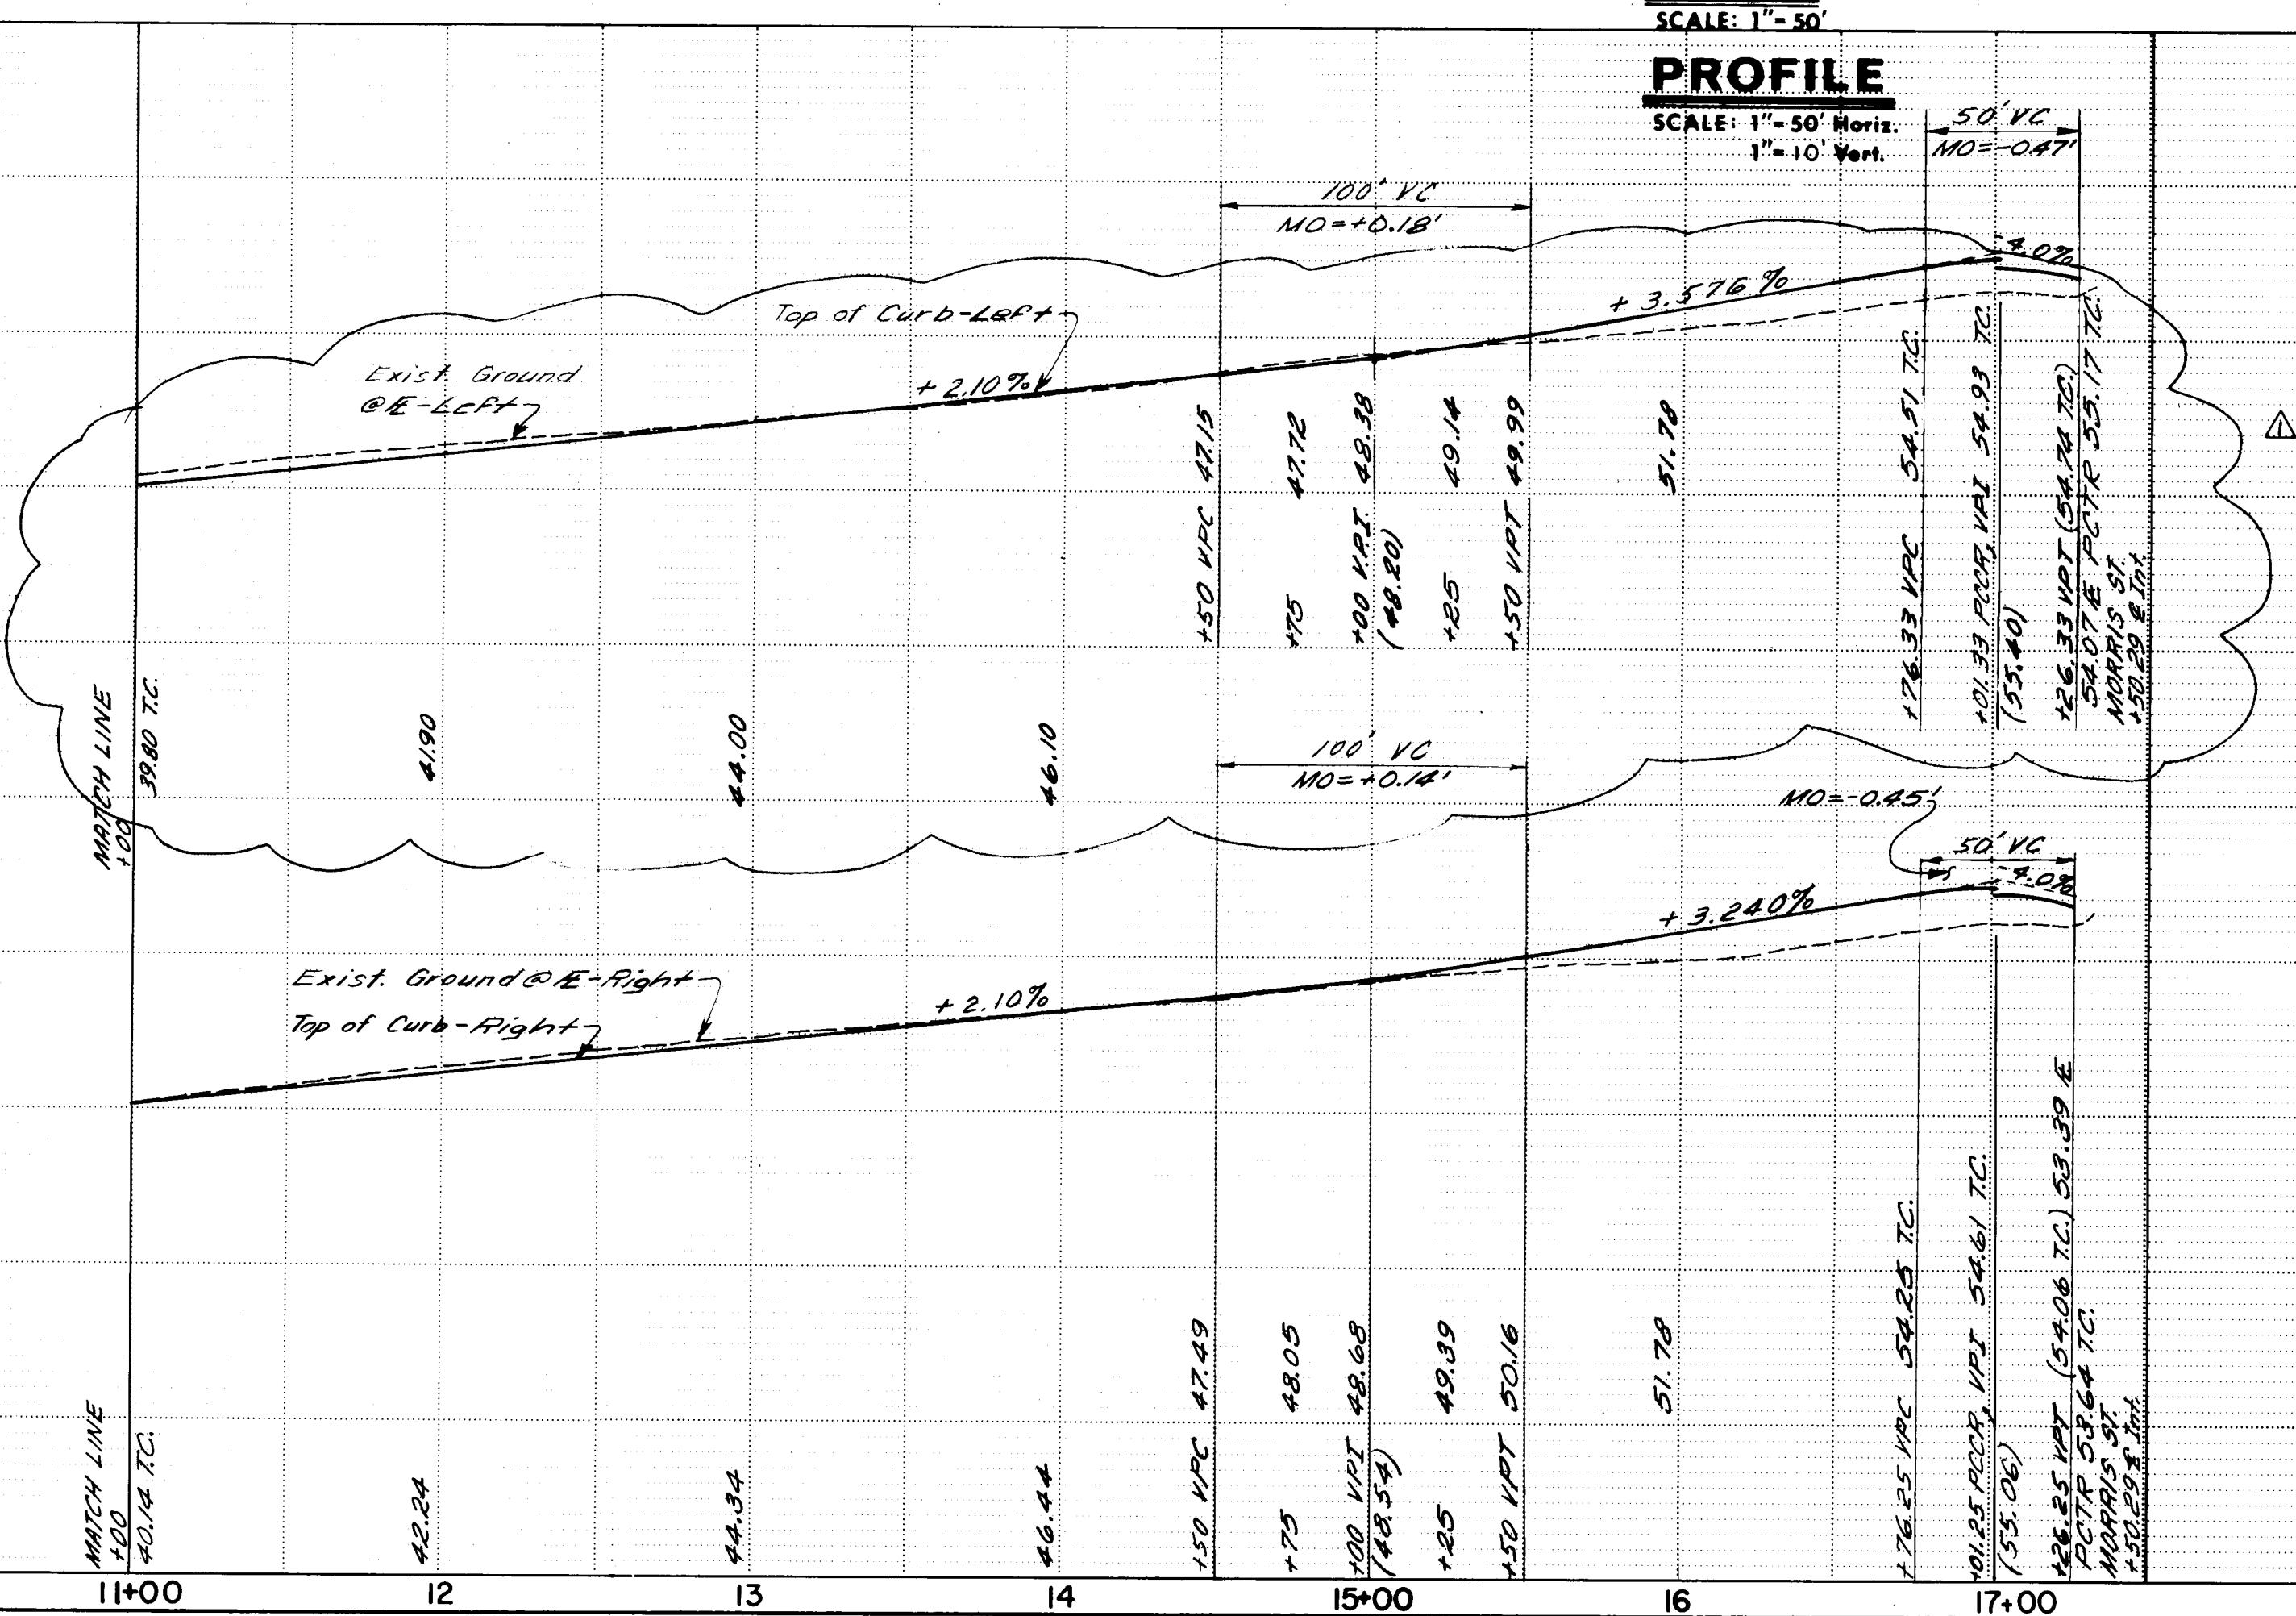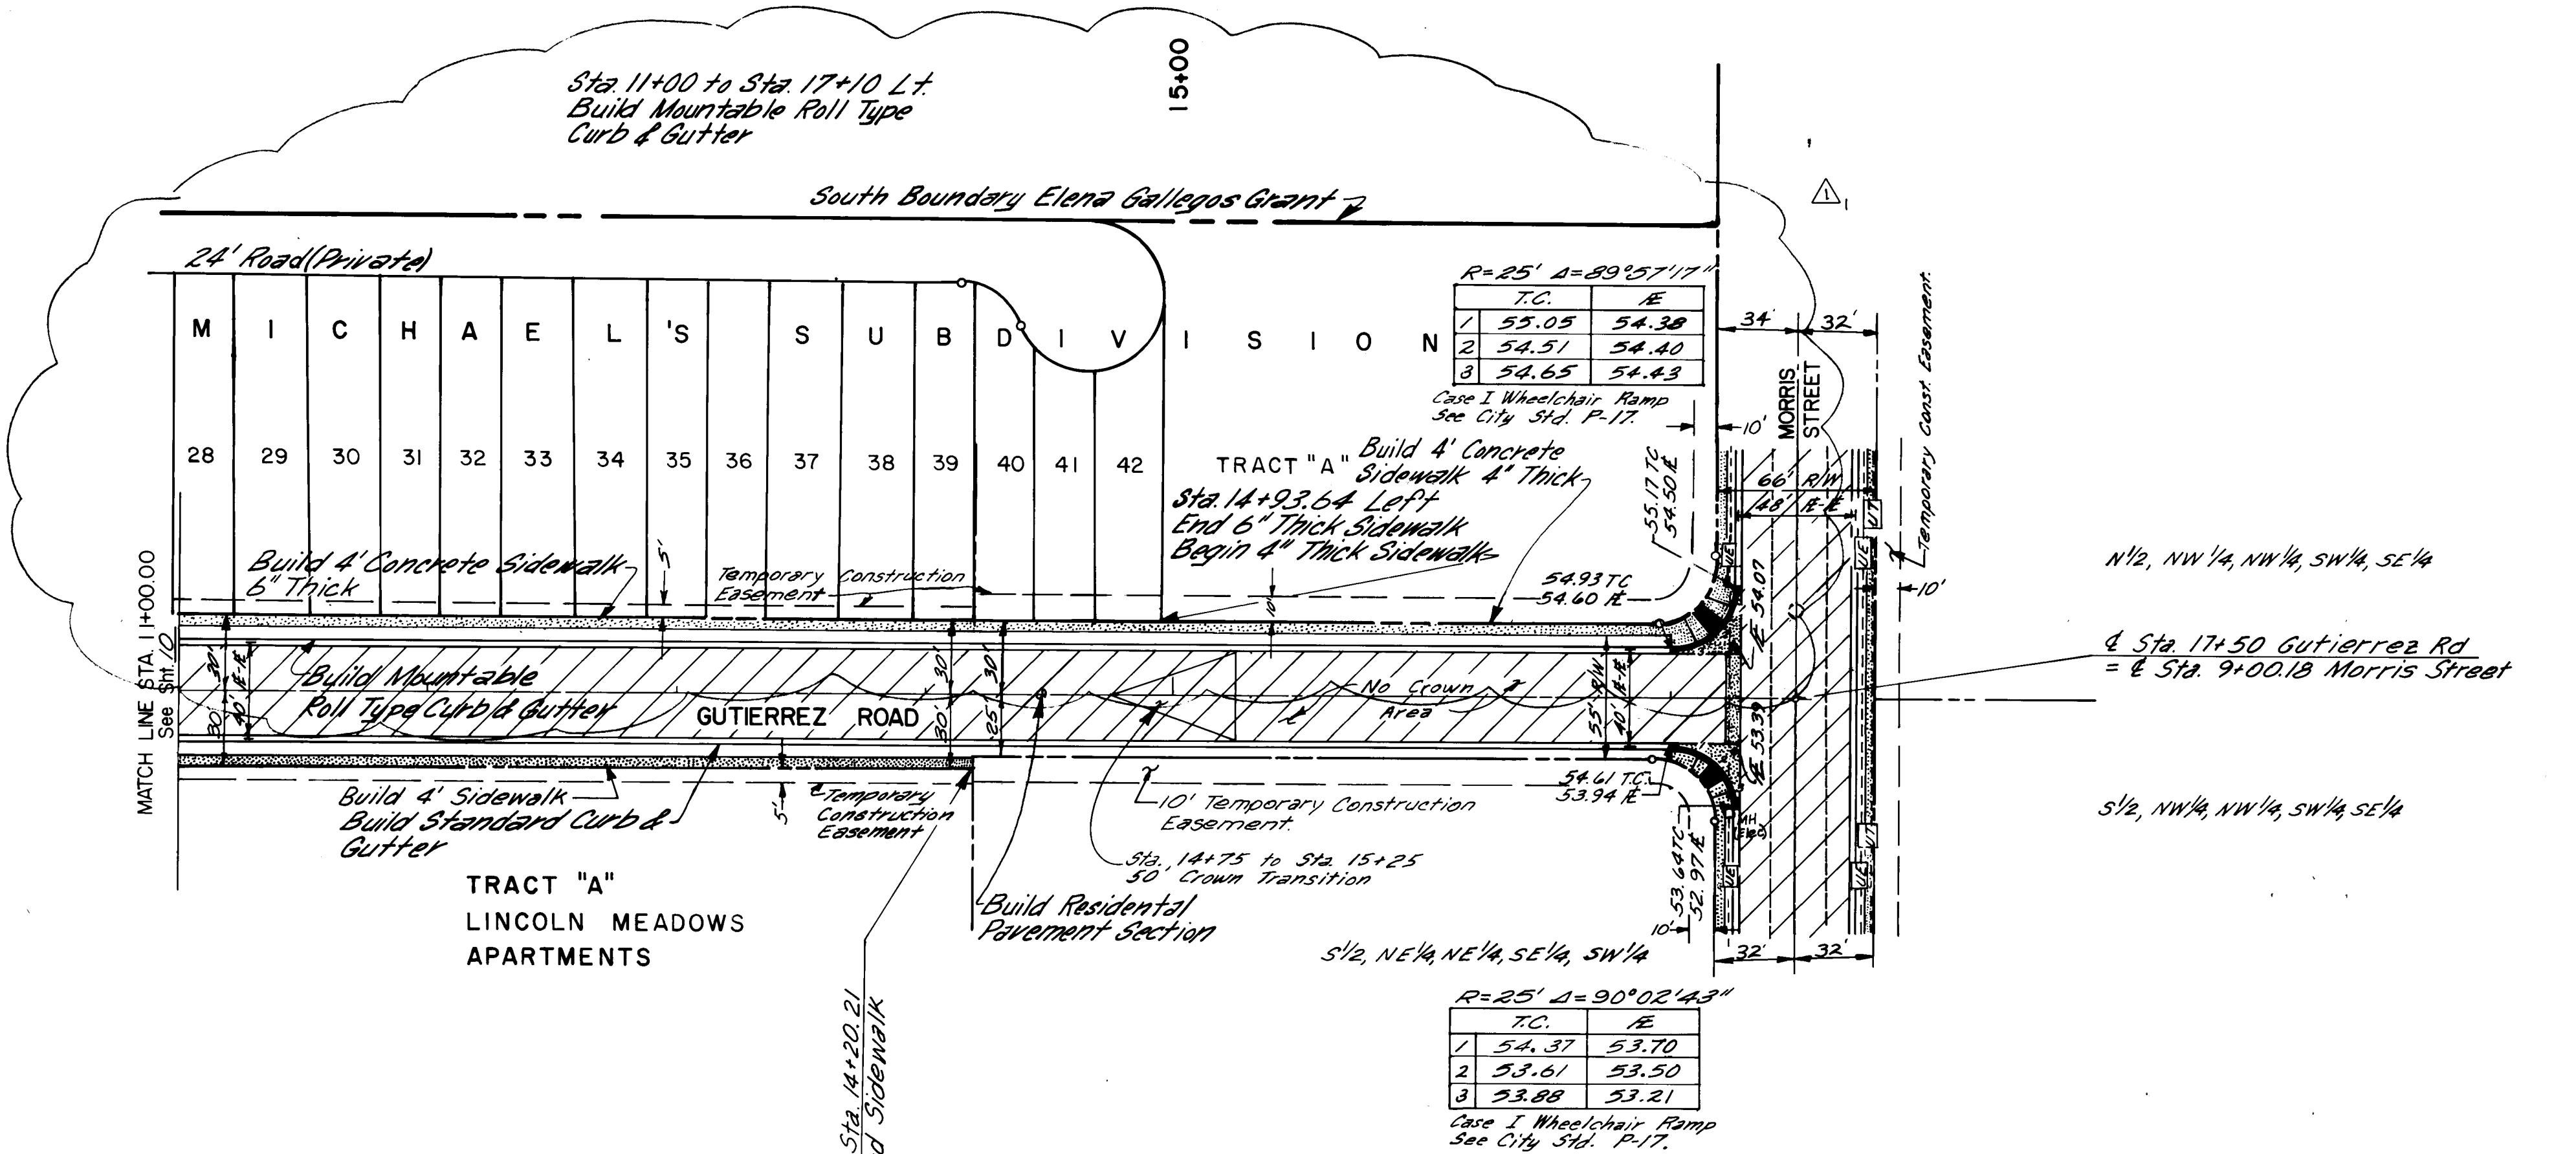**CITY OF ALBUQUERQUE
MUNICIPAL DEVELOPMENT DEPARTMENT
ENGINEERING DIVISION**

**SPECIAL ASSESSMENT DISTRICT 204
GUTIERREZ ROAD
STA. 11+00.00 TO STA. 17+00.00
PAVING**

SURVEY INFORMATION		BENCH MARKS		AS BUILT INFORMATION	
FIELD NOTES		CITY OF ALBUQUERQUE BRASS CAP 106-21 ON		CONTRACTOR	K.N.C. INC.
NO.	BY	DATE	THE SOUTHWEST CURB RETURN OF	WORK STAKED BY	W.M.A. DATE 1-31-86
			MONTGOMERY AND MORRIS N.E.	INSPECTORS	W.M.A. DATE 1-31-86
			ELEV. 5636.11	ACCEPTANCE BY	W.M.A. DATE 1-31-86
				FIELD	VERIFICATION BY W.M.A. DATE 1-31-86
				DRAWINGS	DRAWINGS CORRECTED BY W.M.A. DATE 1-31-86
				RECORDED BY	MICRO-FILM INFORMATION
				DATE	NO

069801/

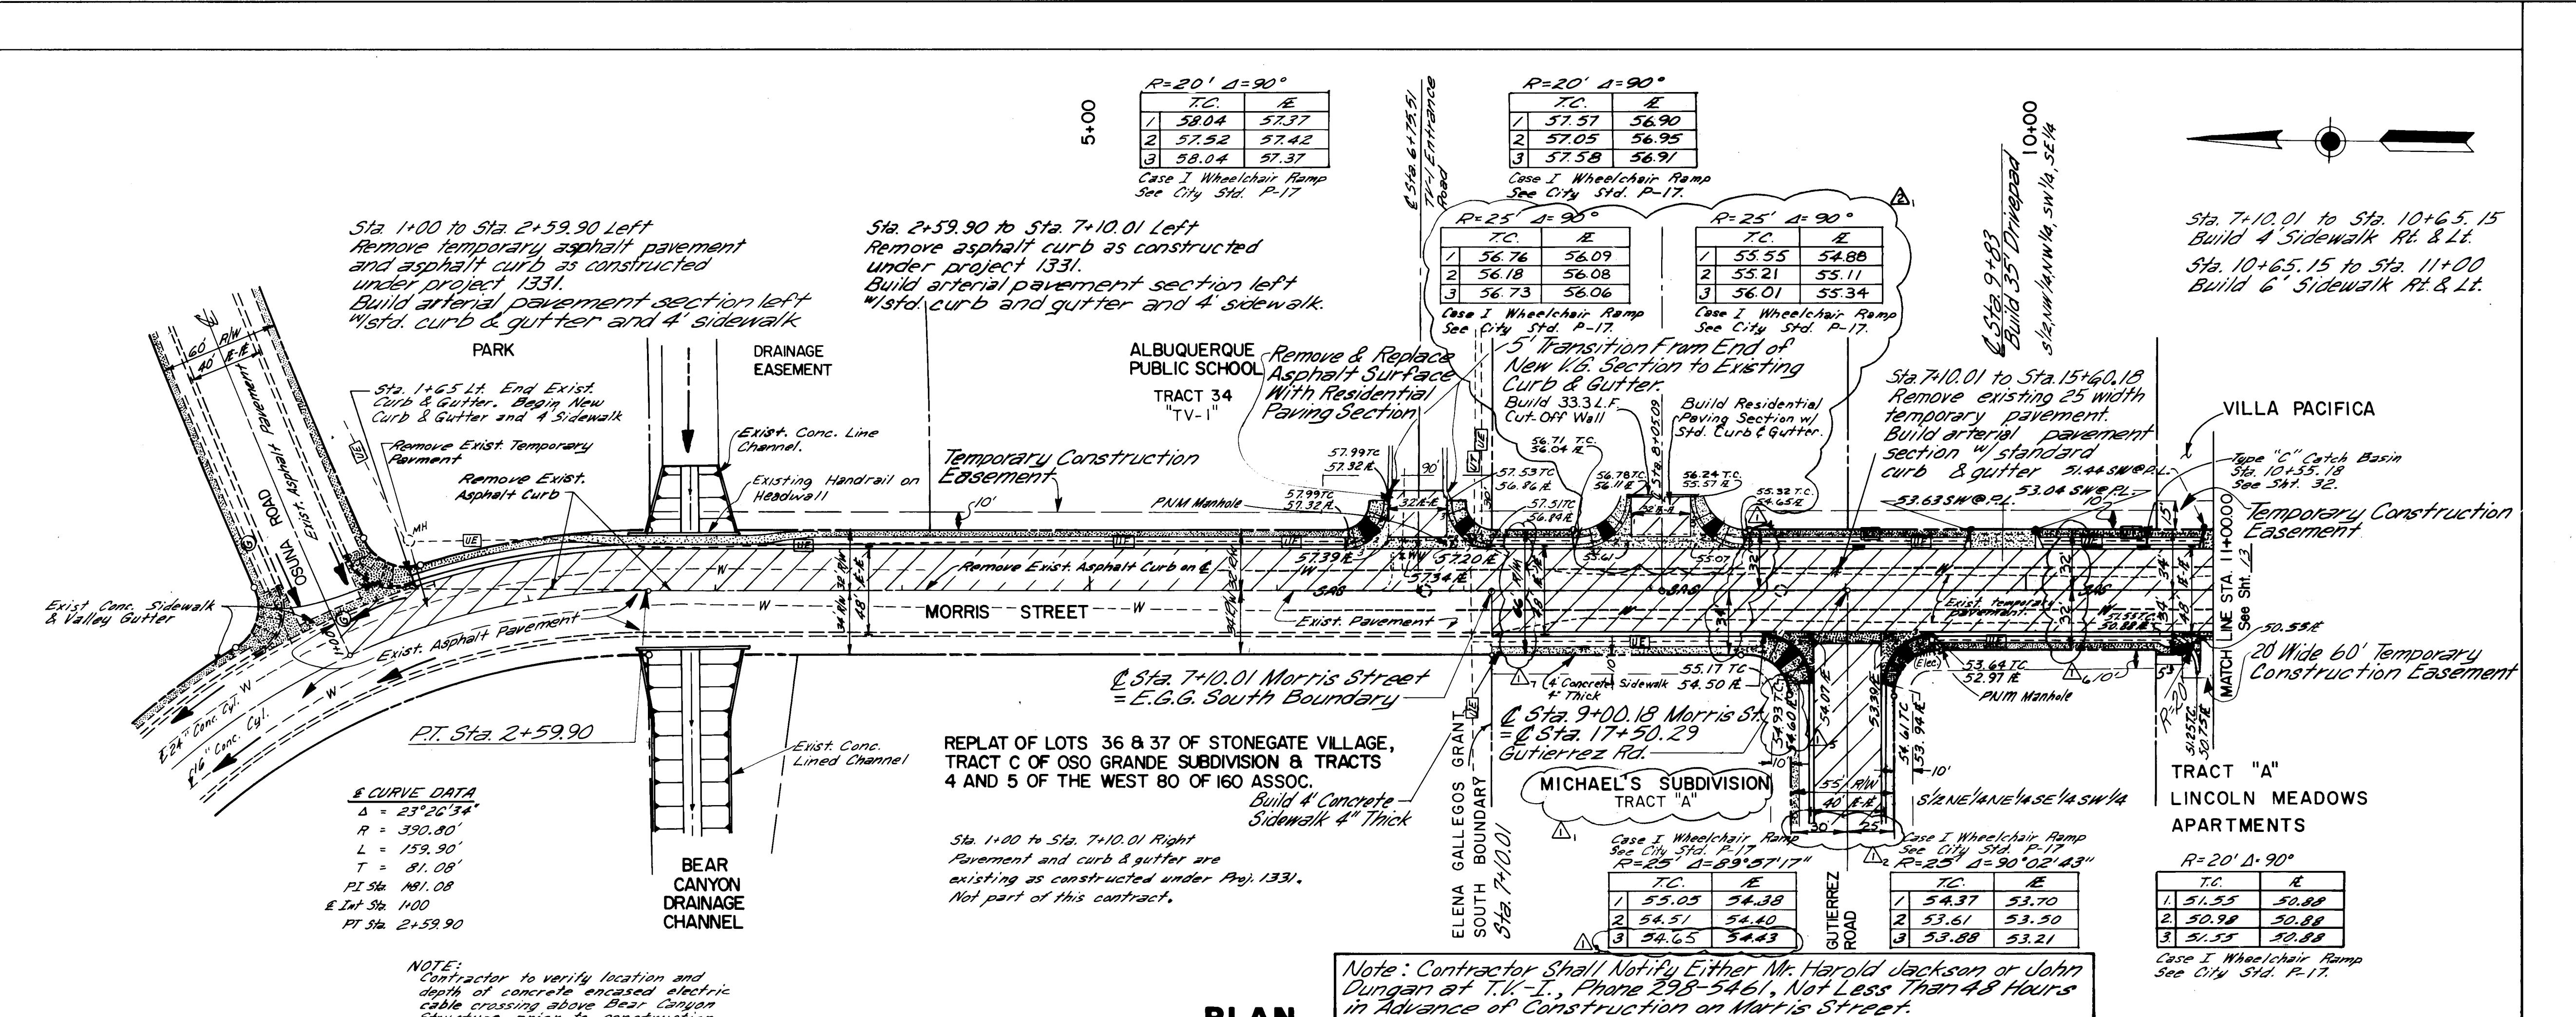

AS BUILT INFORMATION		SURVEY INFORMATION		BENCH MARKS	
NO.	BY	FIELD NOTES	DATE	CITY OF ALBUQUERQUE	MARK
1	W.M.A.	DATE 5/13/85 STAKE BY W.M.A.	DATE 5/13/85	BRASS CAP TO G-21 ON THE SOUTHEAST CURB	G-21
2	W.M.A.	DATE 5/13/85 INSPECTOR BY W.M.A.	DATE 5/13/85	RETURN OF MONTOMERY AND MORRIS NE	
3	W.M.A.	DATE 5/13/85 FIELD BY W.M.A.	DATE 5/13/85	MARKS BY W.M.A.	
4	W.M.A.	DATE 5/13/85 CALIBRATION BY W.M.A.	DATE 5/13/85	ADJUSTED BY W.M.A.	
5	W.M.A.	DATE 5/13/85 CORRECTED BY W.M.A.	DATE 5/13/85	MICRO-FILM INFORMATION	
6	W.M.A.	DATE 5/13/85	DATE	RECORDED BY	NO.

REVISIONS

DESIGNED BY	W.M.A.	DATE MARCH 1985
DRAWN BY	W.M.A.	DATE MARCH 1985
CHECKED BY	W.M.A.	DATE MARCH 1985


CITY OF ALBUQUERQUE
MUNICIPAL DEVELOPMENT DEPARTMENT
ENGINEERING DIVISION

TITLE: SPECIAL ASSESSMENT DISTRICT 204
MORRIS STREET
STA. 1+00.00 TO STA. 11+00.00
PAVING

APPROVALS

CITY ENGINEER	ENGINEER	DATE	APPROVALS	ENGINEER	DATE
Liquid Waste	Plaza	5/13/85	A.C.E. - Design	Plaza	5/13/85
Traffic	Douglas Homan	5/13/85	A.C.E. - Hydrology	Plaza	5/13/85
Water	Plaza	5/13/85			

DRAWING NO. 1646 **MAP NO.** F-21 **SHEET** 12 OF 36

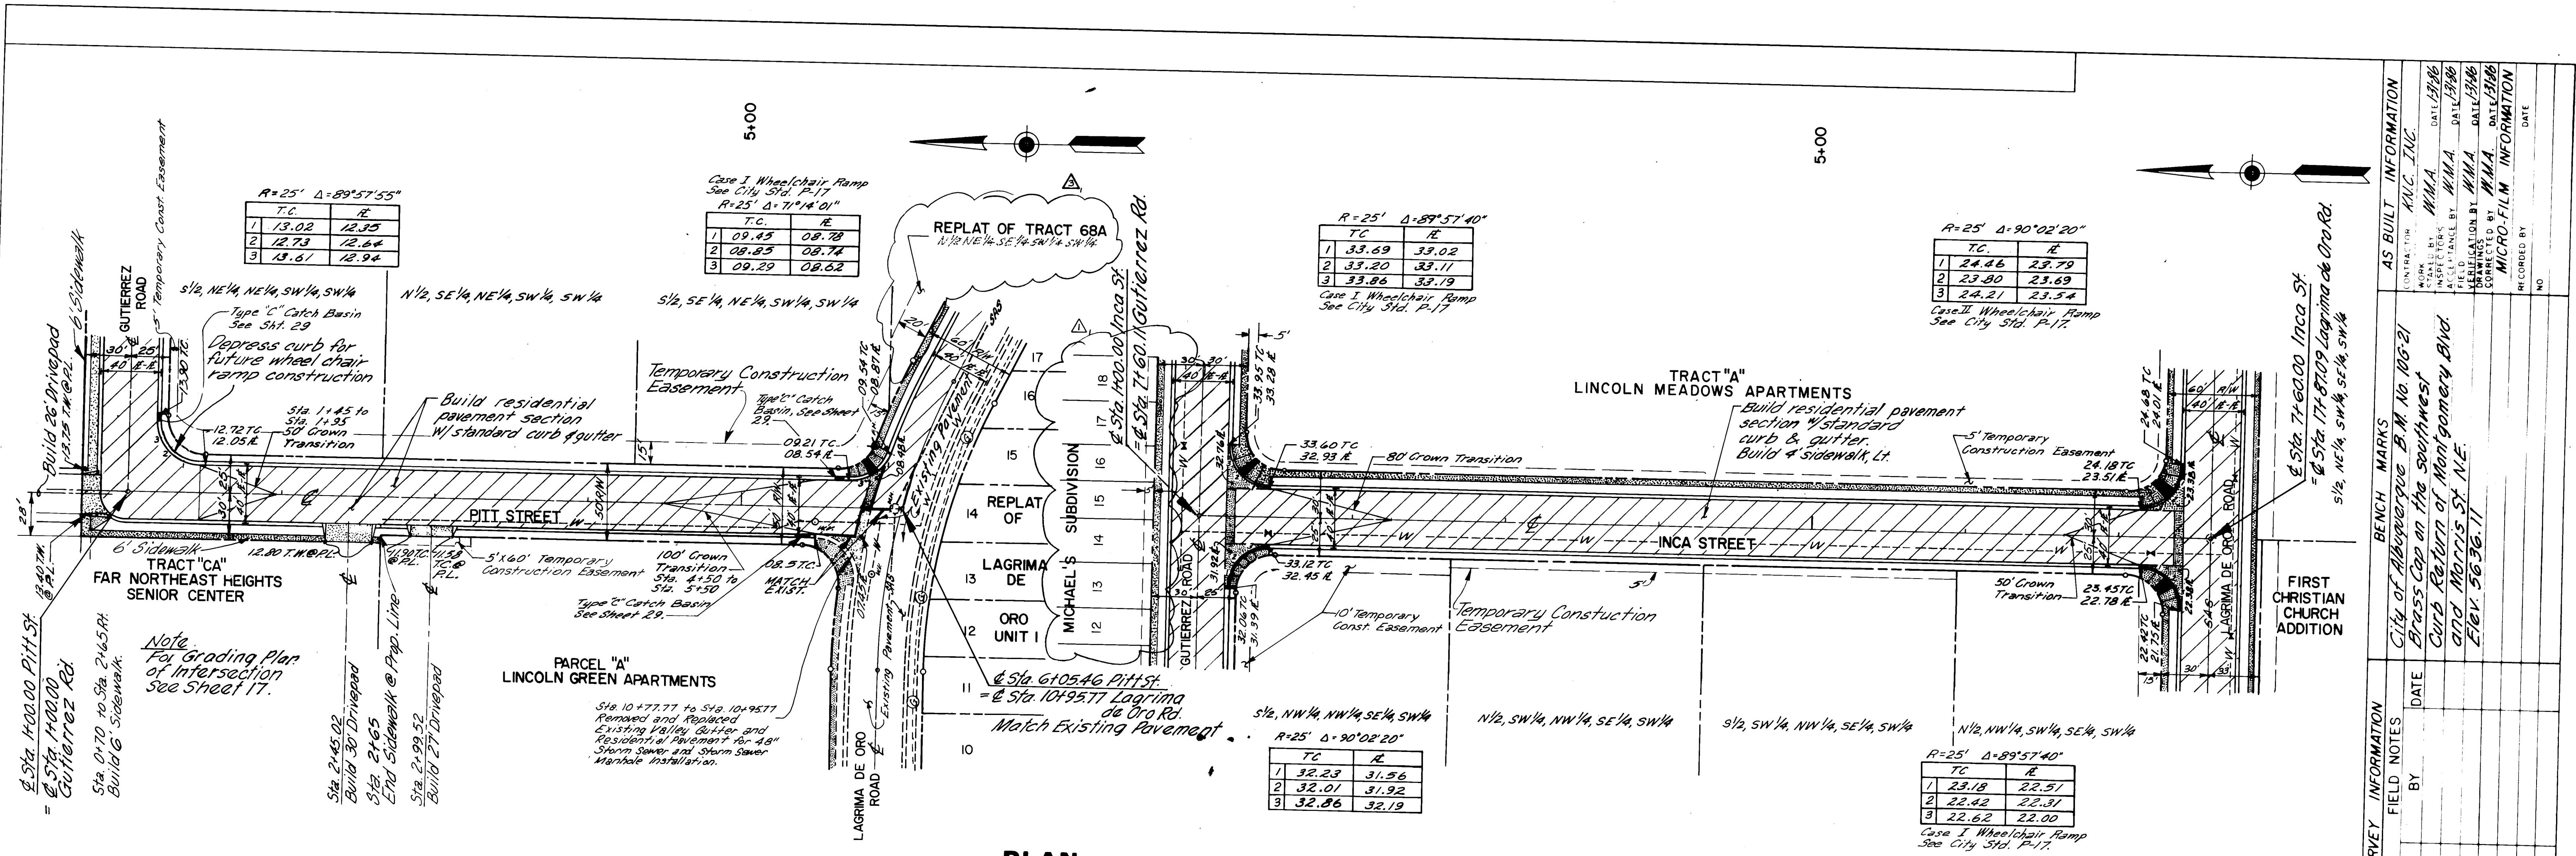

PLAN
SCALE: 1"-50'

PROFILE
SCALE: 1"-50' Horiz.
1"-10' Vert.

CITY OF ALBUQUERQUE
MUNICIPAL DEVELOPMENT DEPARTMENT
ENGINEERING DIVISION

TITLE: SPECIAL ASSESSMENT DISTRICT 204
PITT STREET STA. I+00.00 TO STA. 6+00.00 8 STA. I+00.00 TO STA. 6+00.00
PAVING



APPROVALS

ENGINEER


DATE

APPROVALS

ENGINEER

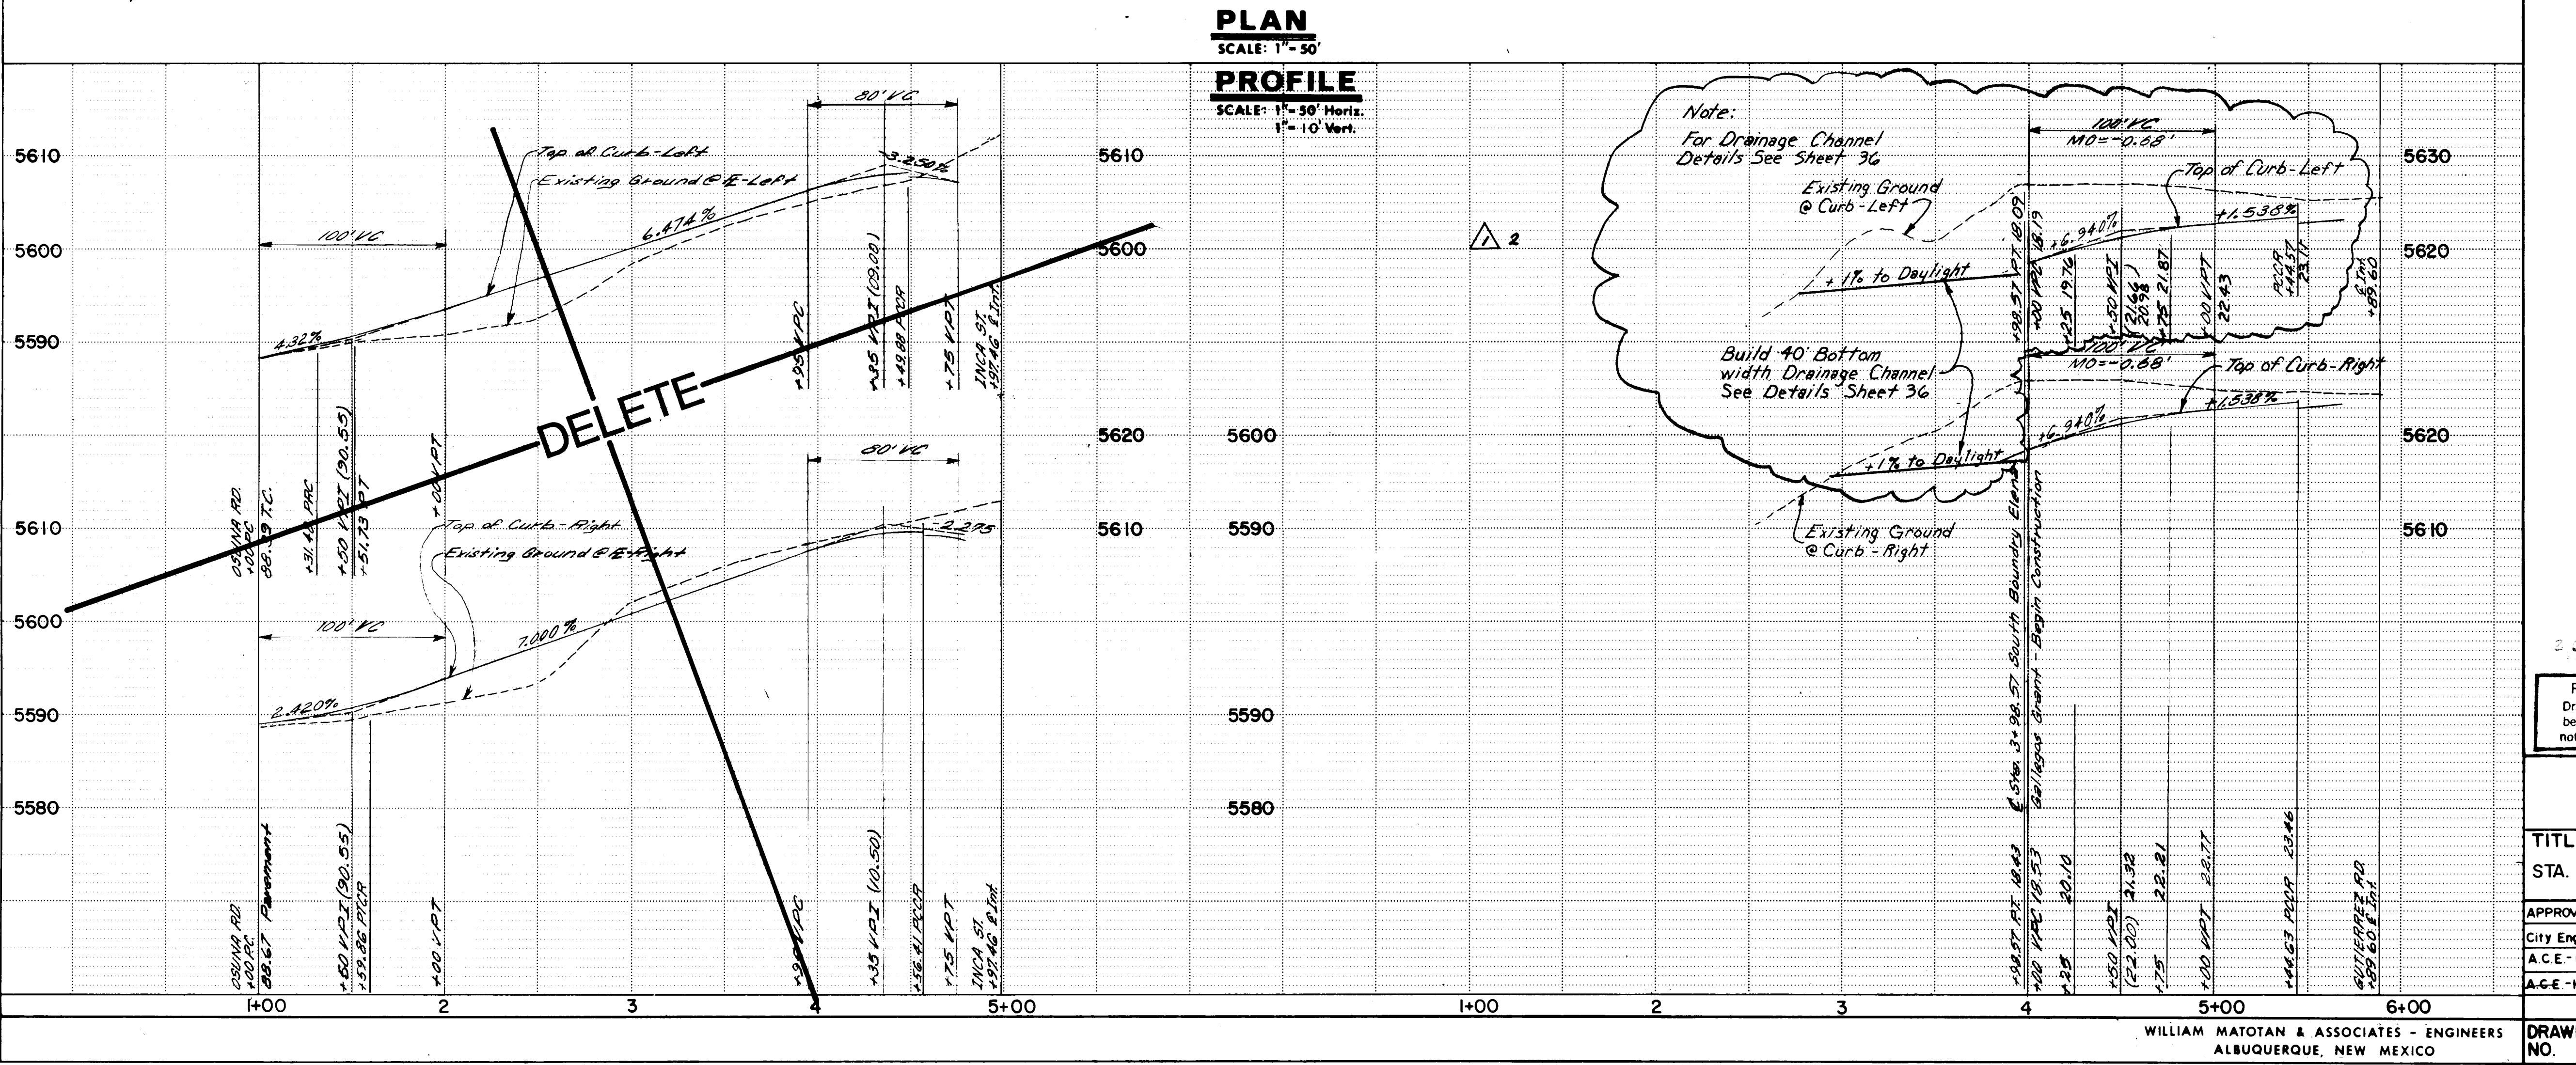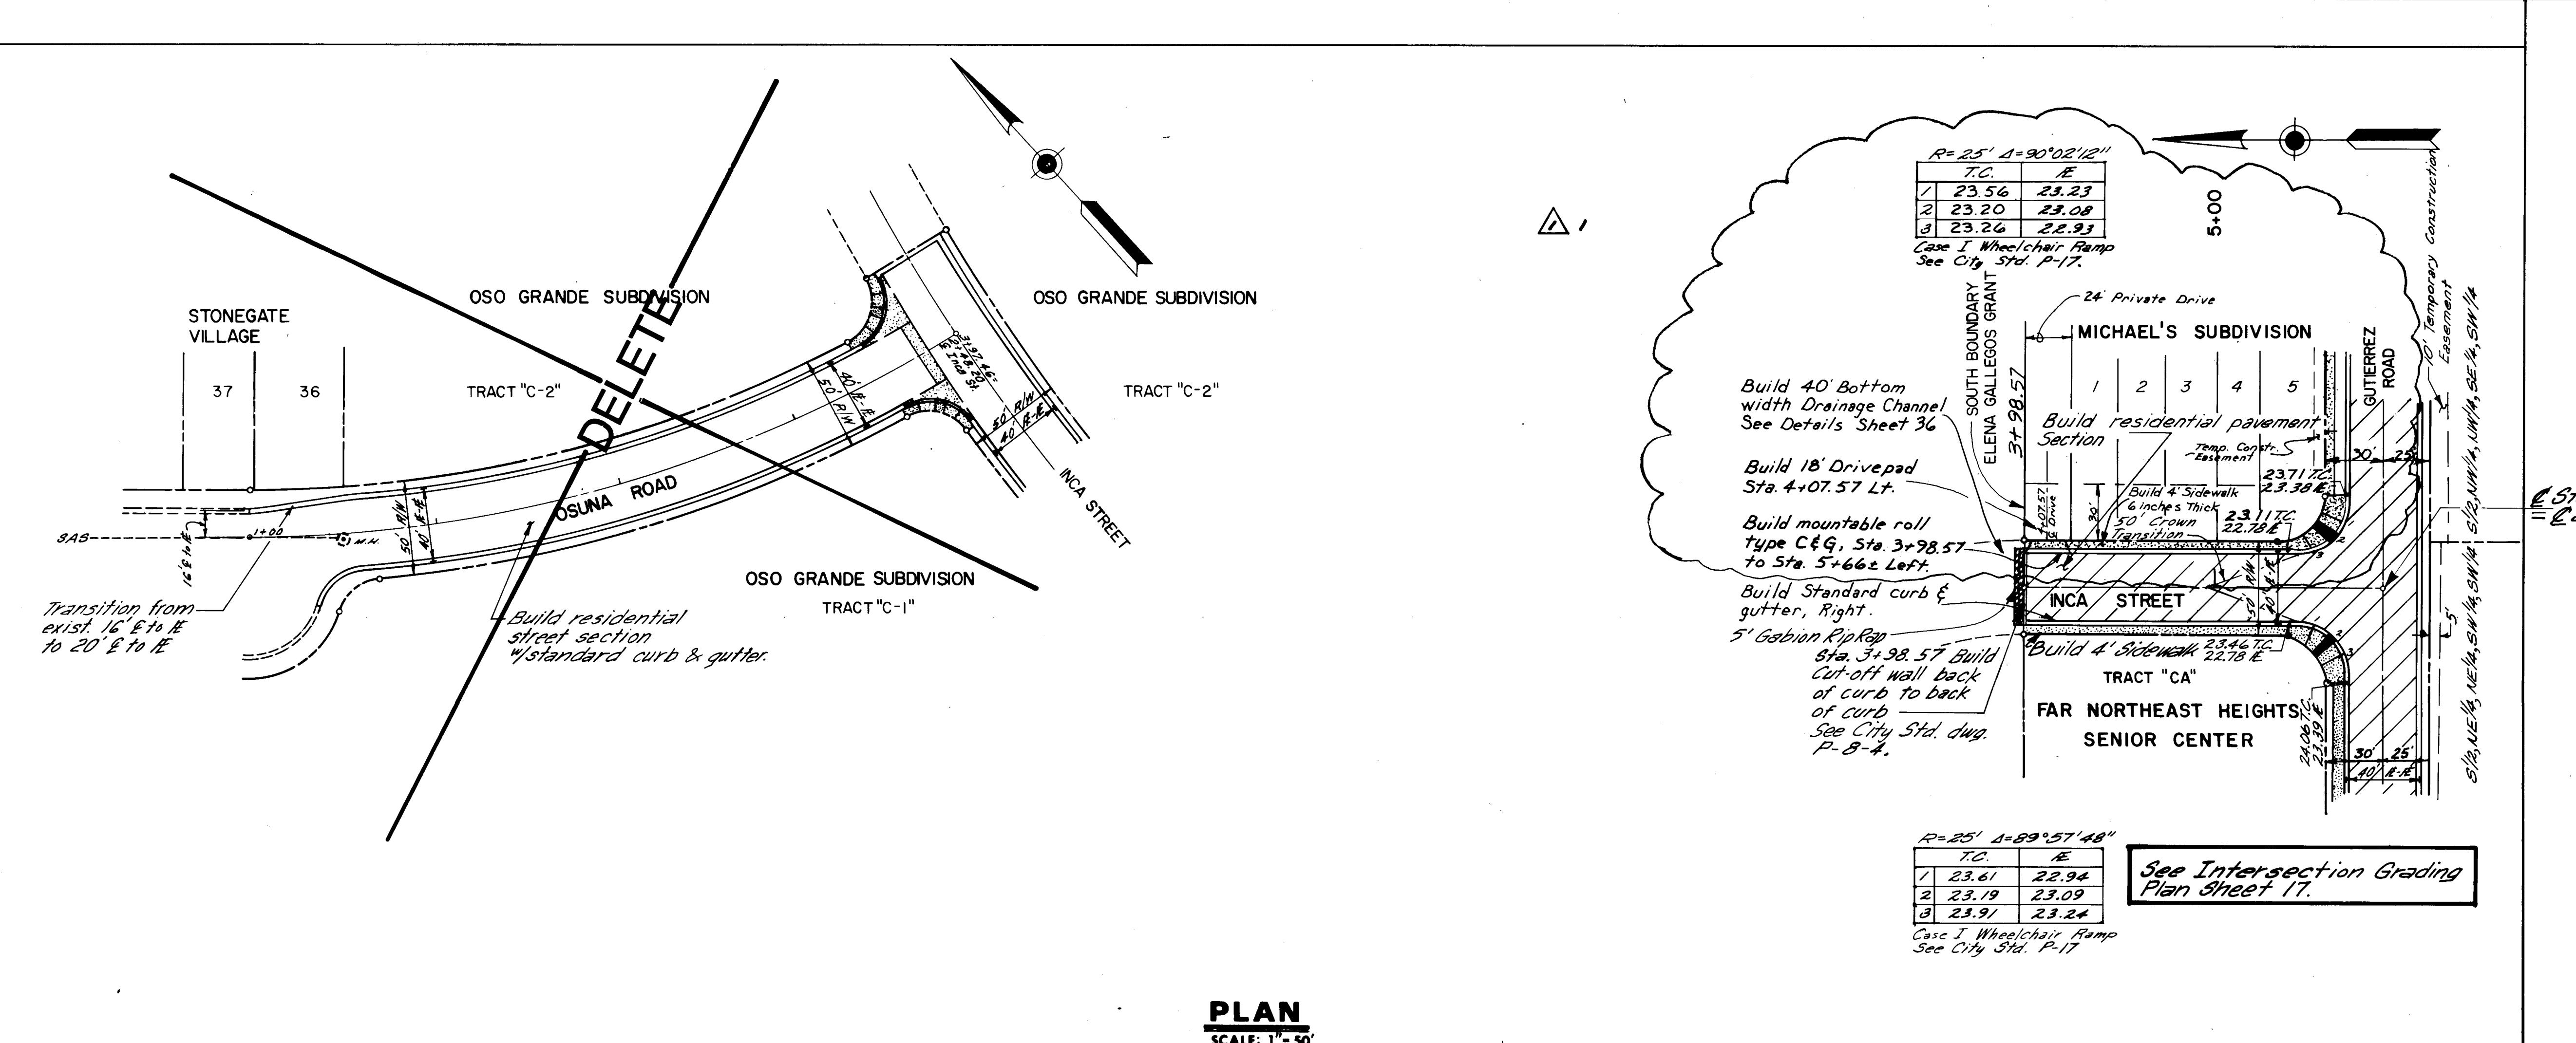

AS BUILT INFORMATION	
CONTRACTOR	KNC, INC.
WORK DONE BY	W.M.A.
INSPECTORS	W.M.A.
ACCEPTANCE BY	W.M.A.
FIELD	DATE 5/6/85
VERIFICATION BY	W.M.A.
CORRECTED BY	W.M.A.
MICRO-FILM INFORMATION	DATE 5/6/85
RECORDED BY	NO

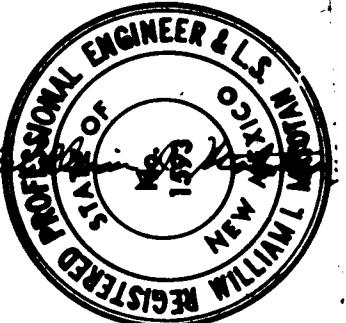


REVISIONS	BY	DATE
DESIGN	W.M.A.	MARCH 1985
DRAWN BY	W.M.A.	MARCH 1985
CHECKED BY	W.M.A.	MARCH 1985


261646 1586

CITY OF ALBUQUERQUE MUNICIPAL DEVELOPMENT DEPARTMENT ENGINEERING DIVISION


TITLE: SPECIAL ASSESSMENT DISTRICT 204 OSUNA ROAD INCA STREET STA. I+00.00 TO STA. 5+00.00 & STA. I+00.00 TO STA. 6+00.00 PAVING

APPROVALS	ENGINEER	DATE	APPROVALS	ENGINEER	DATE
City Engineer	C. D. [Signature]	5/6/85	Liquid Waste	R. [Signature]	5/6/85
A.C.E.-Design	[Signature]	5/6/85	Traffic	D. [Signature]	5/6/85
A.C.E.-Hydrology	[Signature]	5/6/85	Water	R. [Signature]	5/6/85

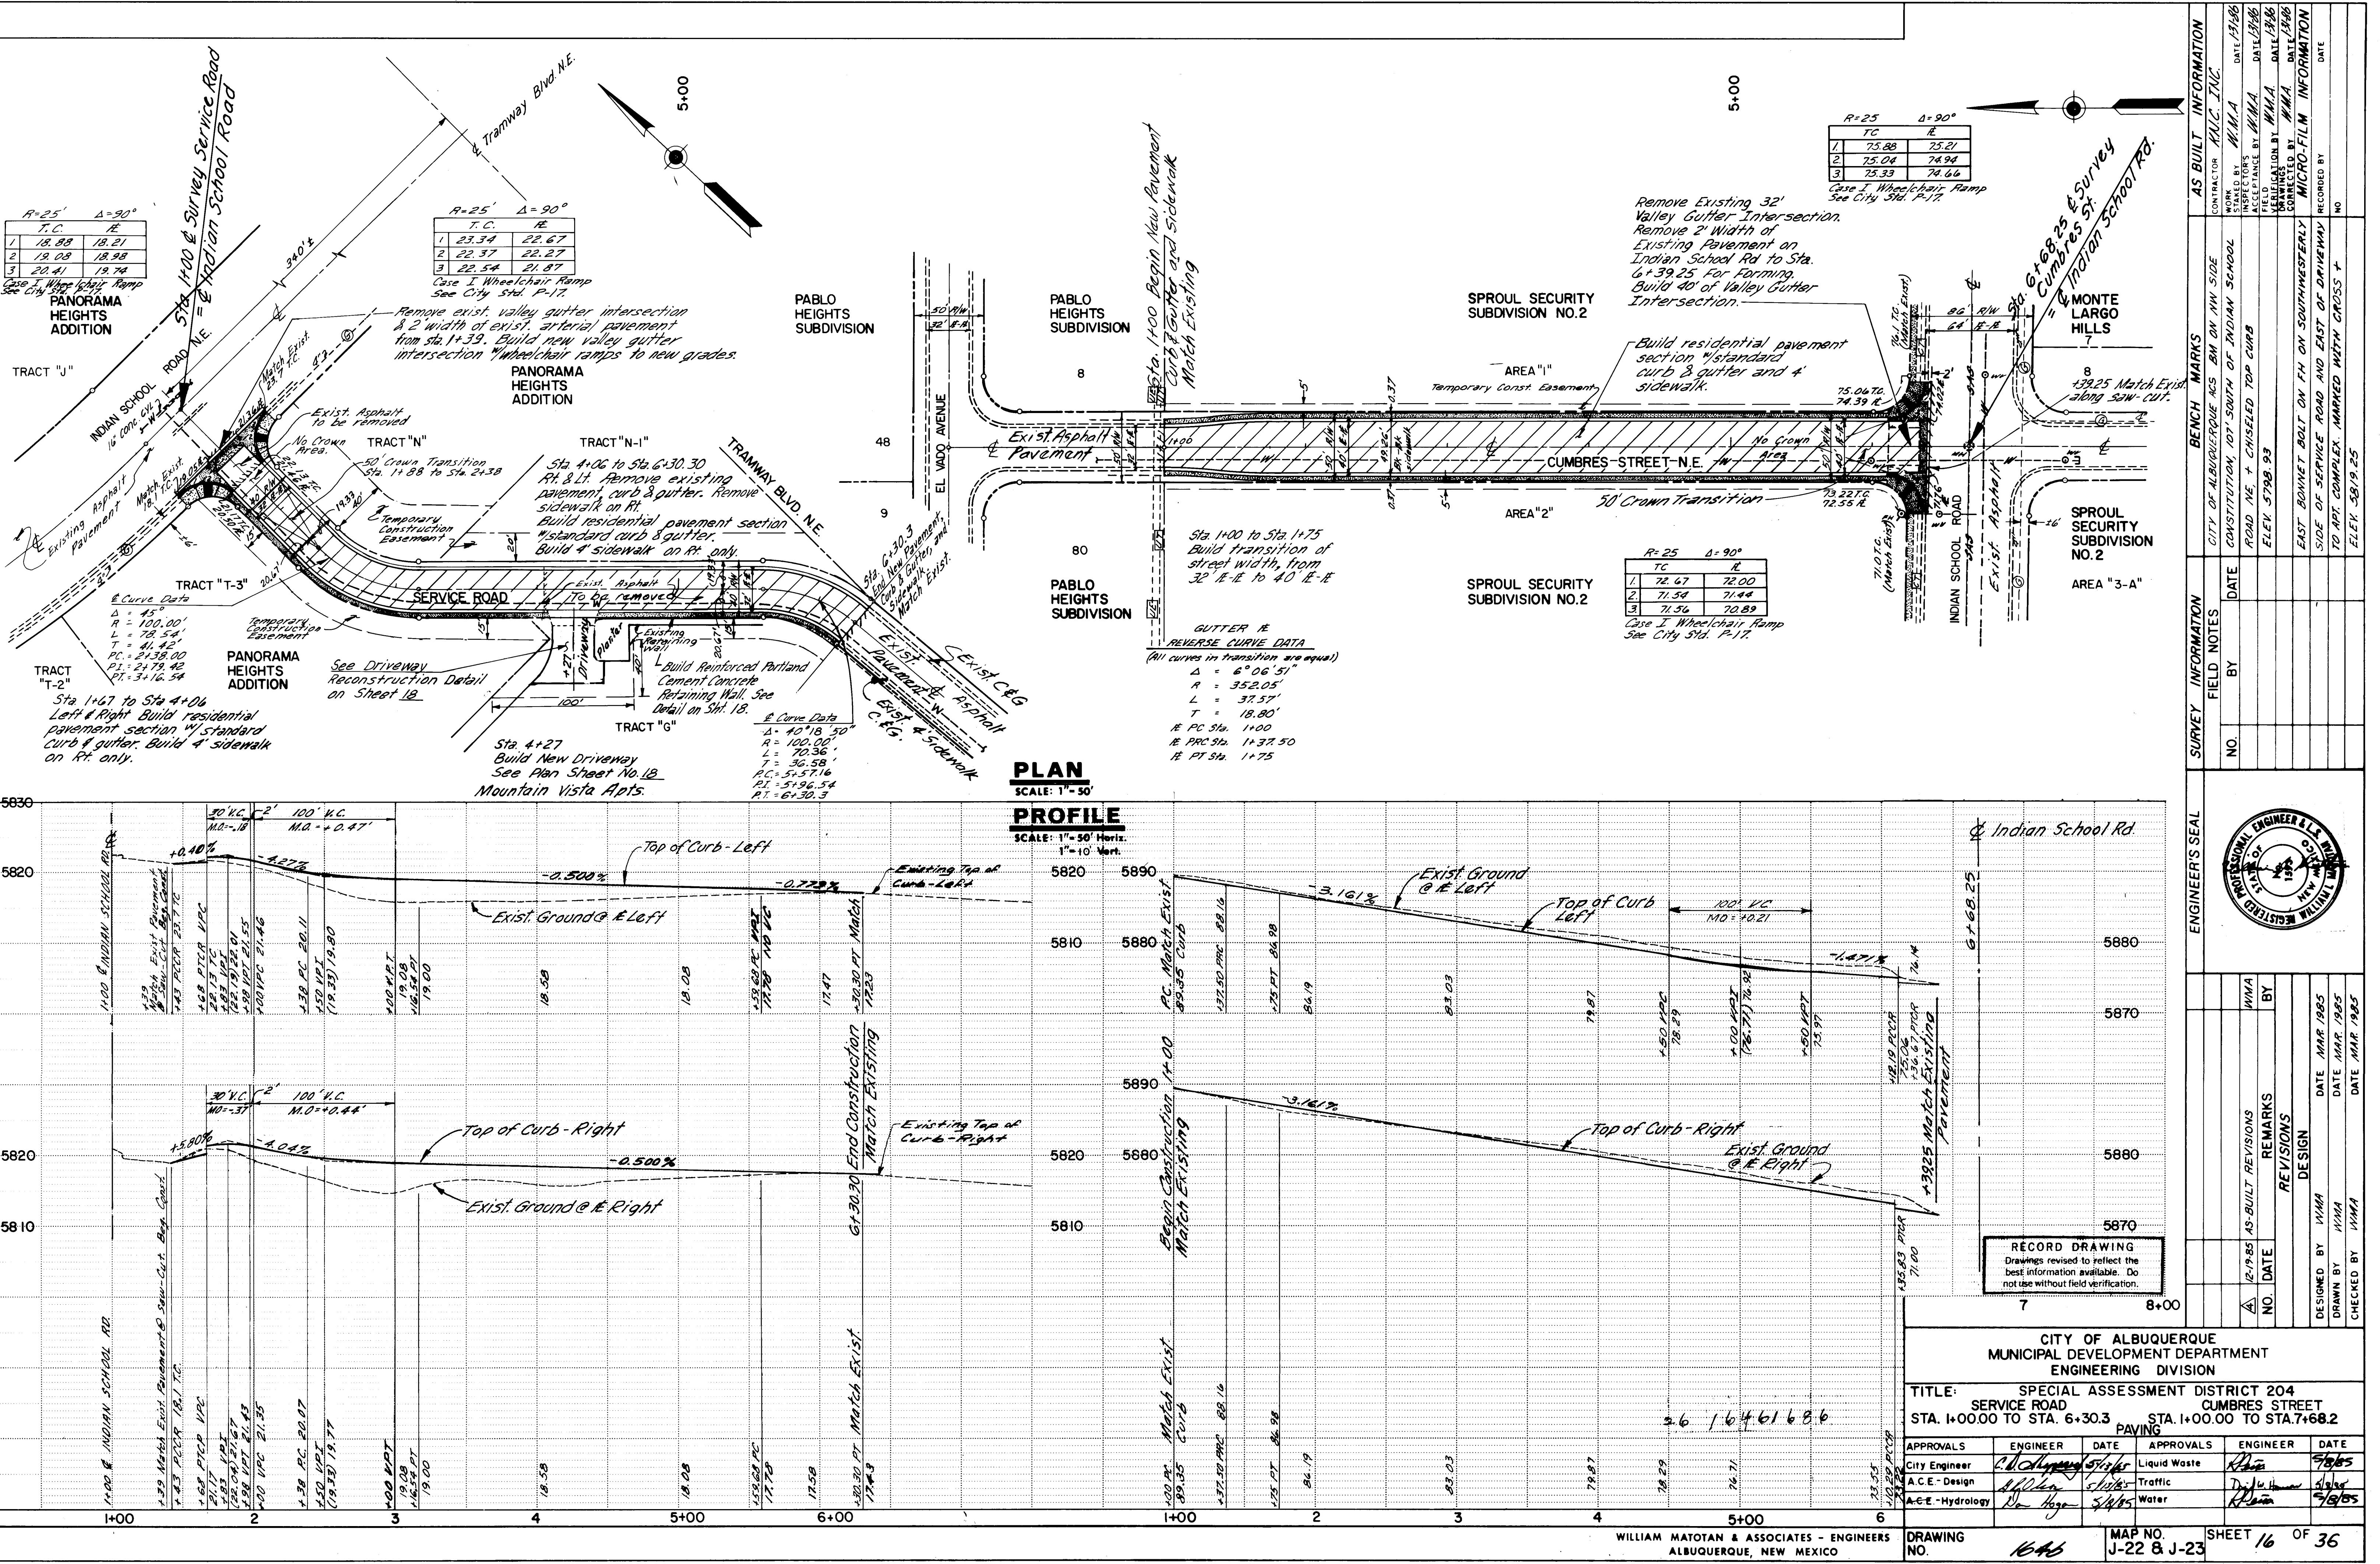


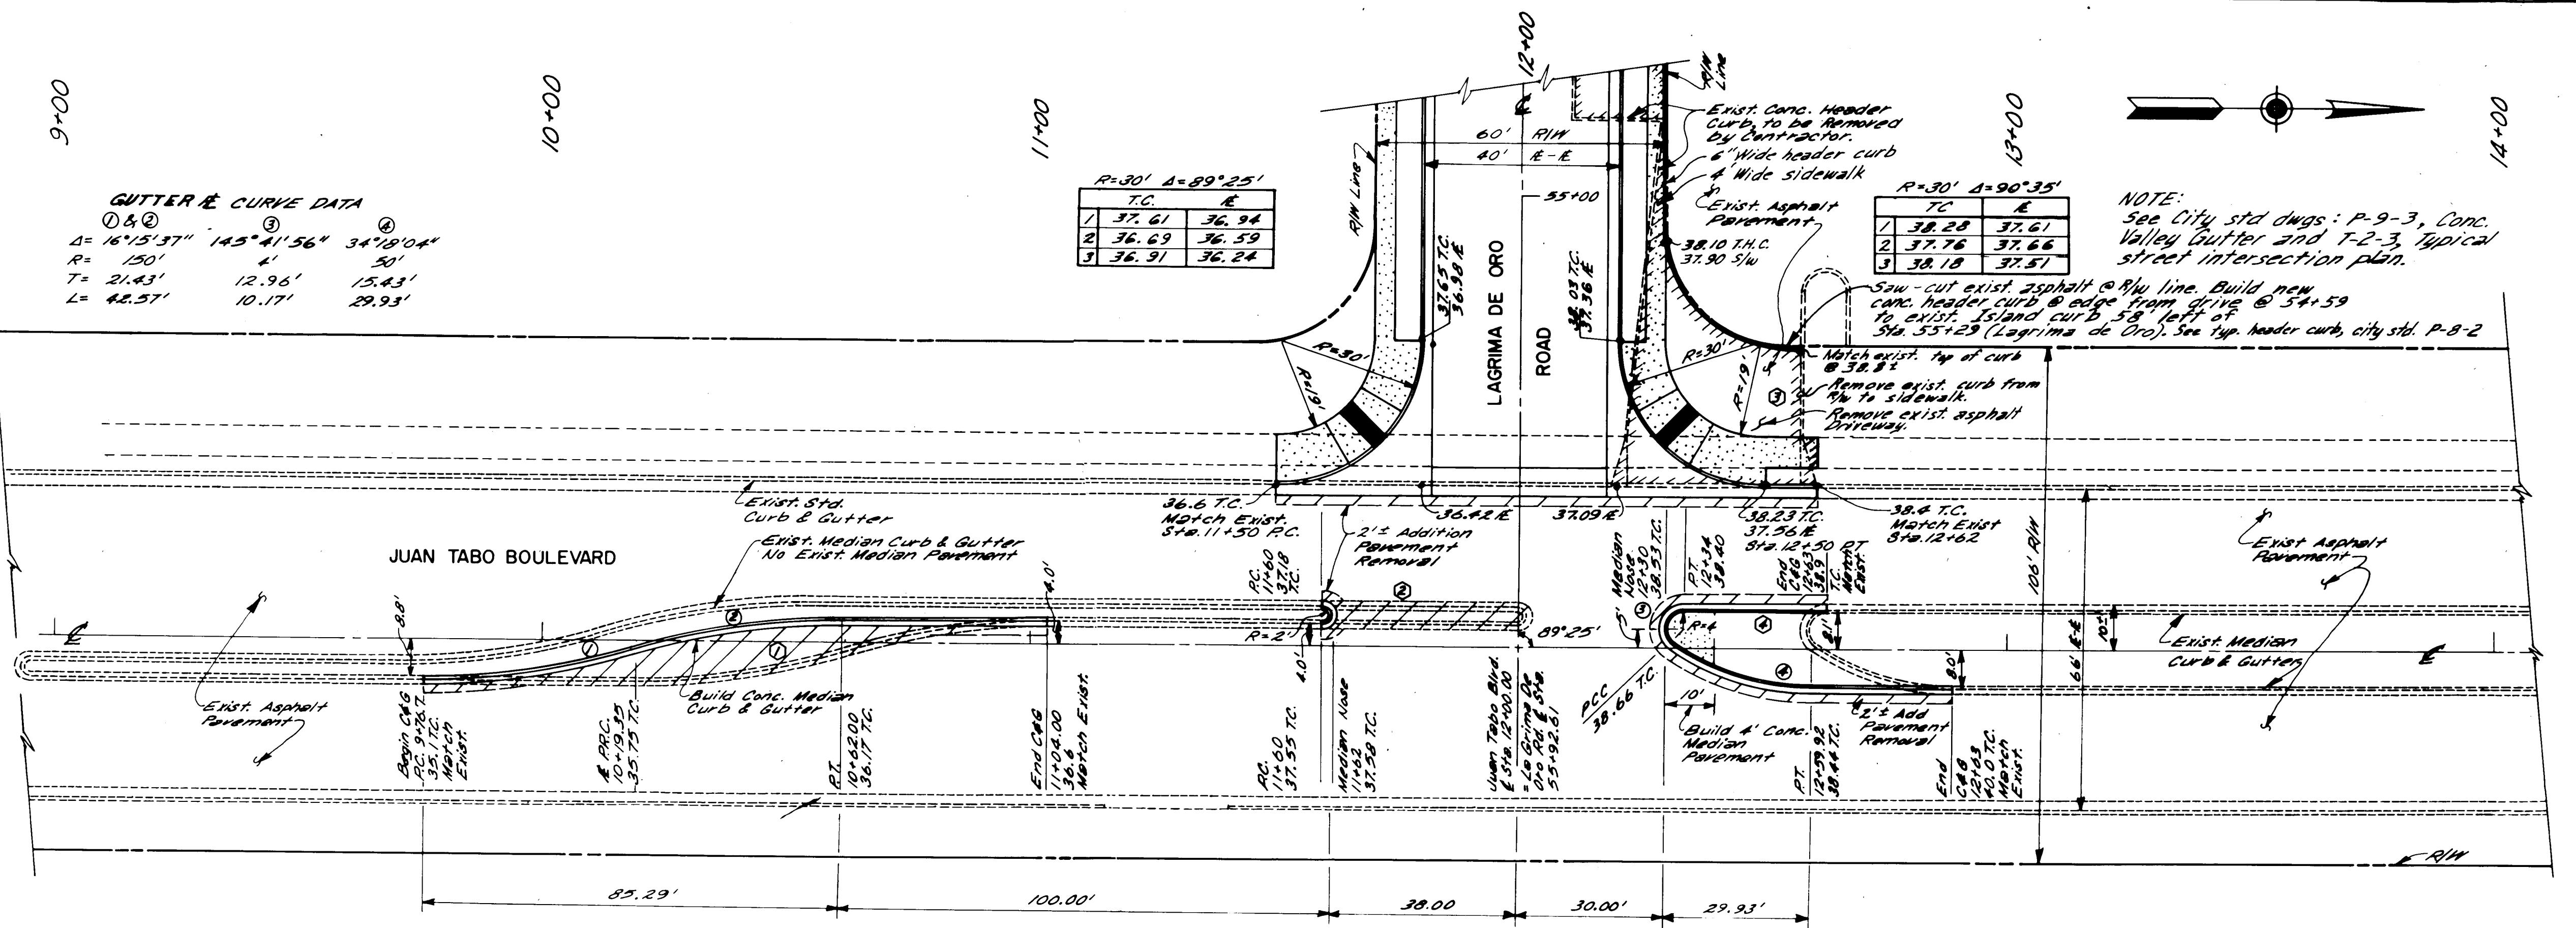


- Notes:**
- Contractor to remove exist. conc. median curb & gutter sta. 9+76.75 to sta. 11+04.0'. Build median curb and gutter as shown. Build arterial pavement where median is removed, and additional 2'⁴ as required for median construction.
 - Contractor to remove existing median sta. 11+60' to sta. 12+02'. Build median nose as shown. Patch arterial pavement where median is removed and 2'⁴ additional required for median construction.
 - Contractor to remove exist. conc. header curb & asphalt paved parking area pavement within R/W, west curb & gutter from sta. 11+50 to north end of drive pad/sta. 12+62' and 6' conc. sidewalk from sta. 11+50 to sta. 12+50'. Build std valley gutter intersection as shown. Remove and replace 2'⁴ add'l width of arterial pavement as required for construction.
 - Contractor to remove exist. conc. median curb & gutter nose from sta. 12+59' to sta. 12+63'. Build median nose as shown with conc. median pavement. Remove and replace additional 2'⁴ arterial pavement as required for construction.

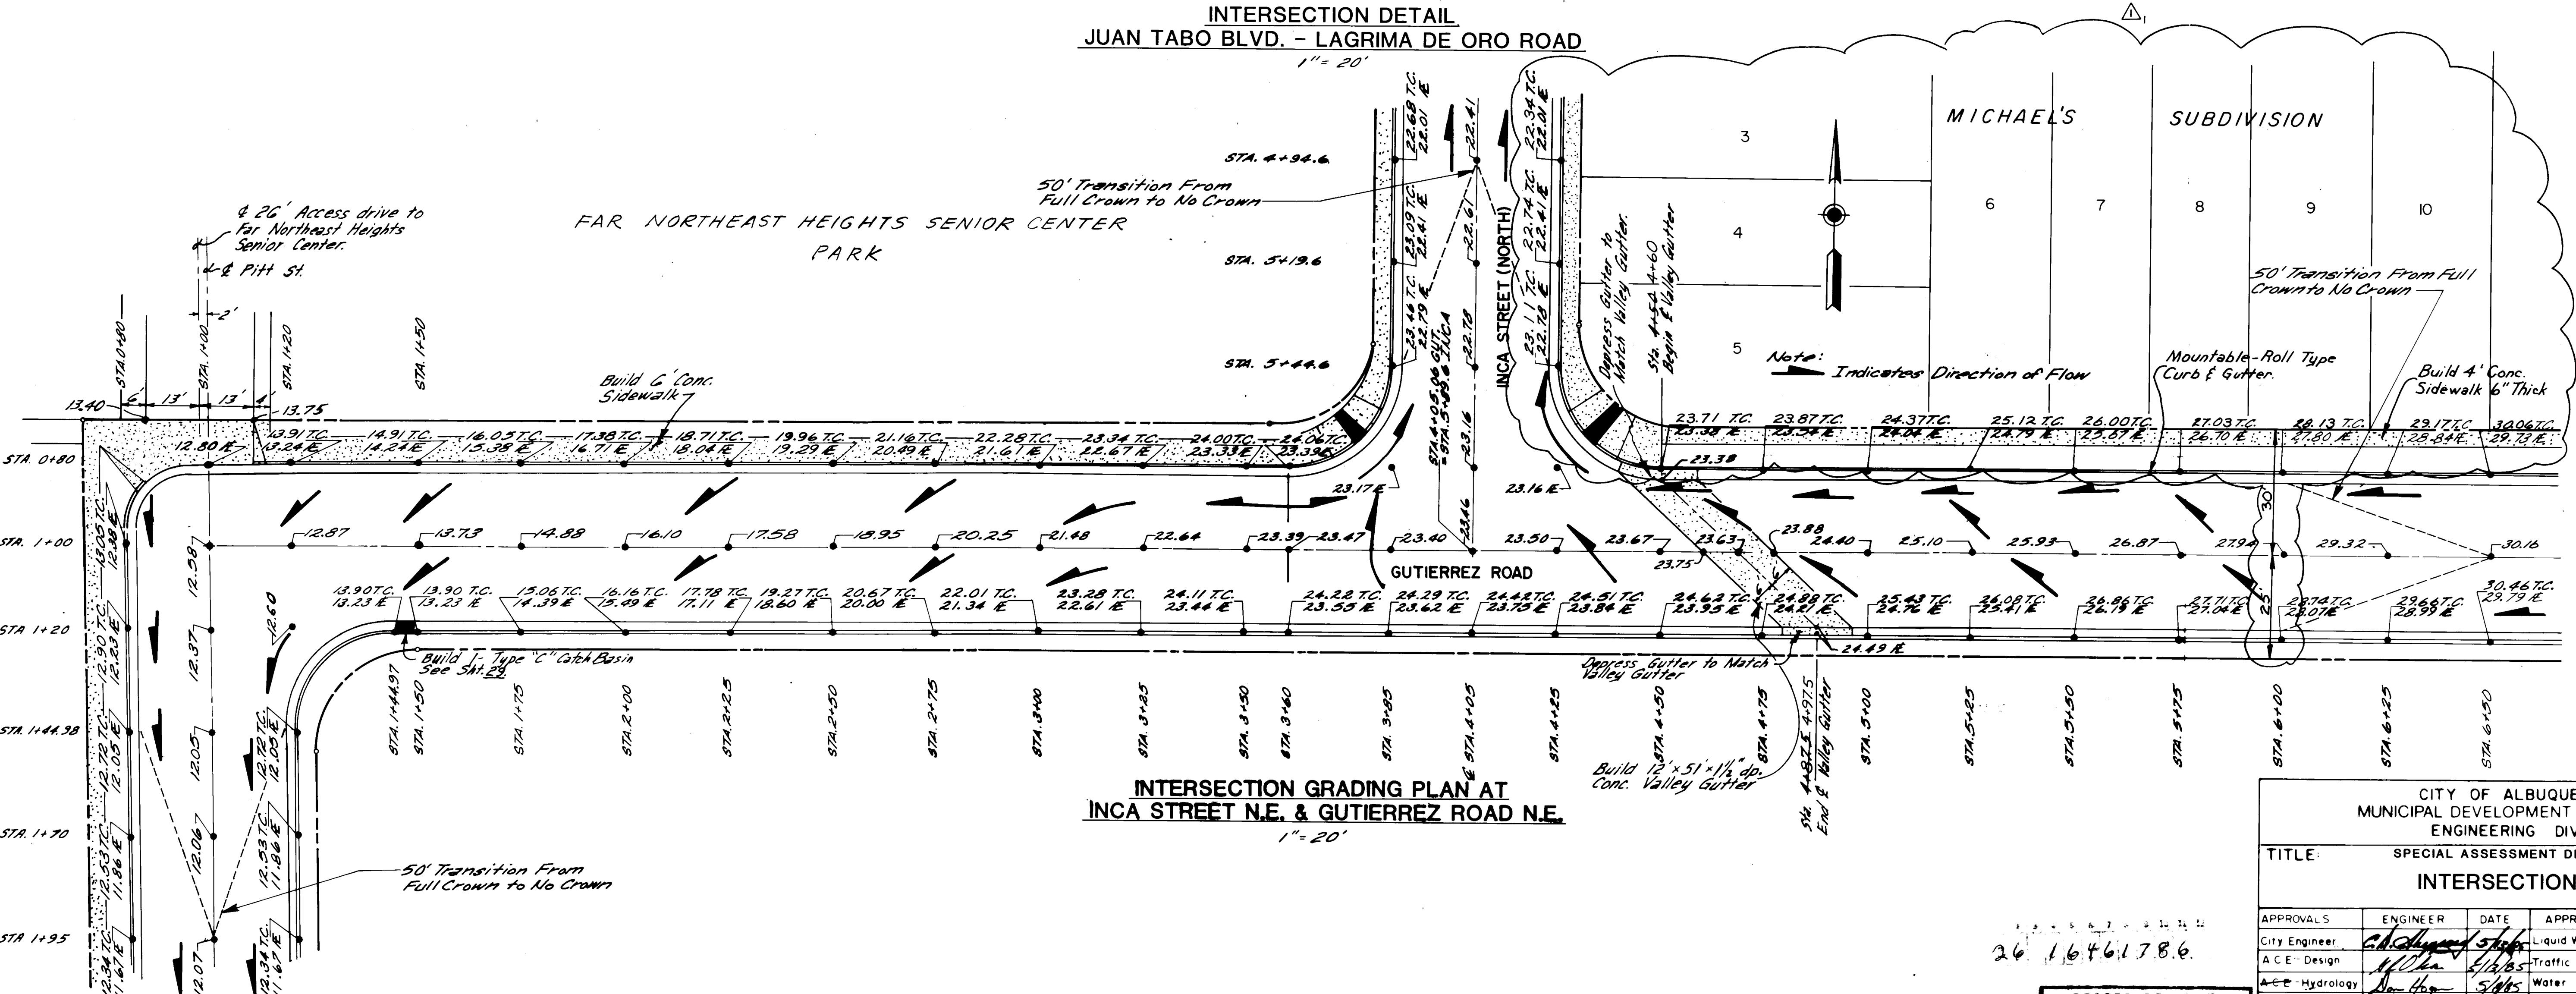


AS BUILT INFORMATION	
CONTRACTOR	KMC INC.
WORK	WMA
INSPECTORS	WMA
STAKE DATE	5/15/85
FIELD DATE	5/15/85
DRAWINGS BY	WMA
FEEDBACK TO	WMA
DATE	5/15/85
MICRO-FILM INFORMATION	
RECORDED BY	NO

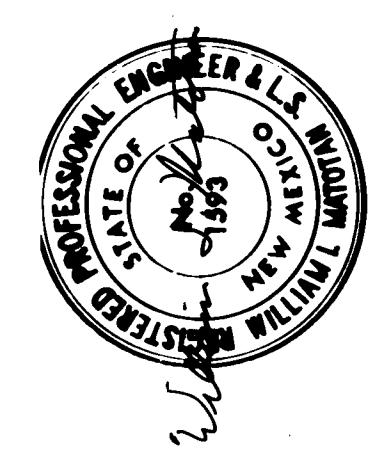

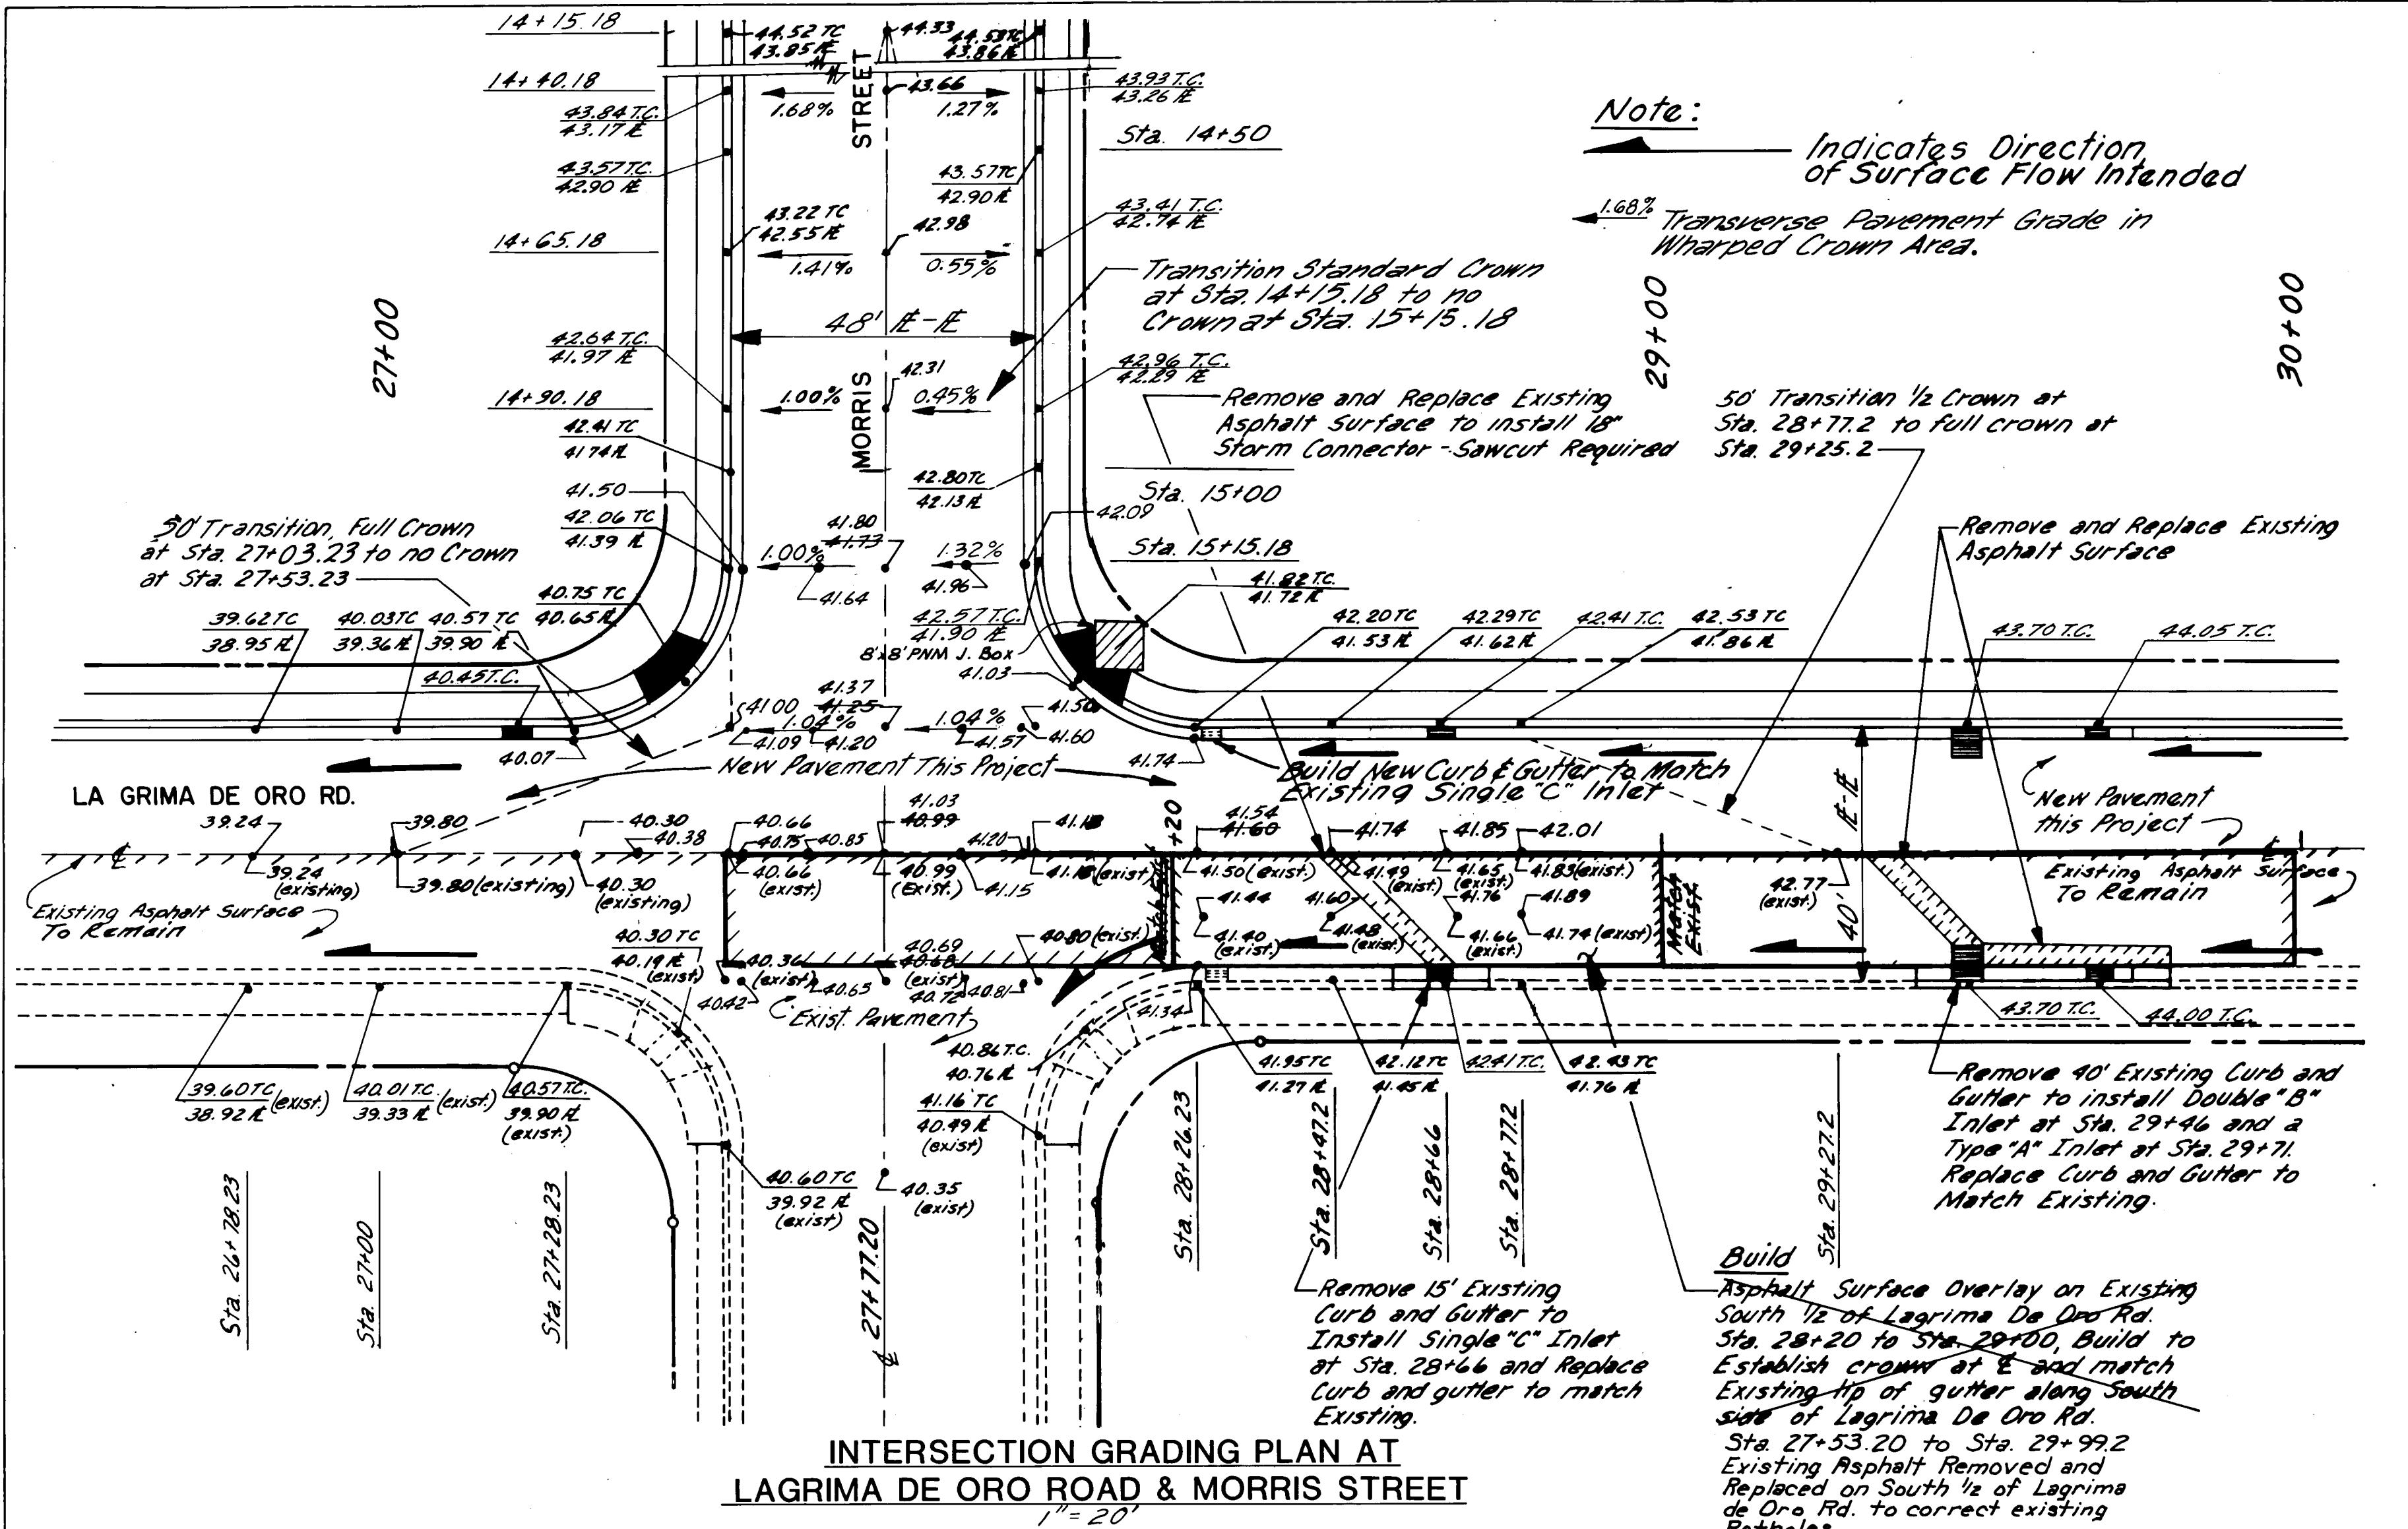


INTERSECTION GRADING PLAN AT
LAGRIMA DE ORO ROAD & MORRIS STREET

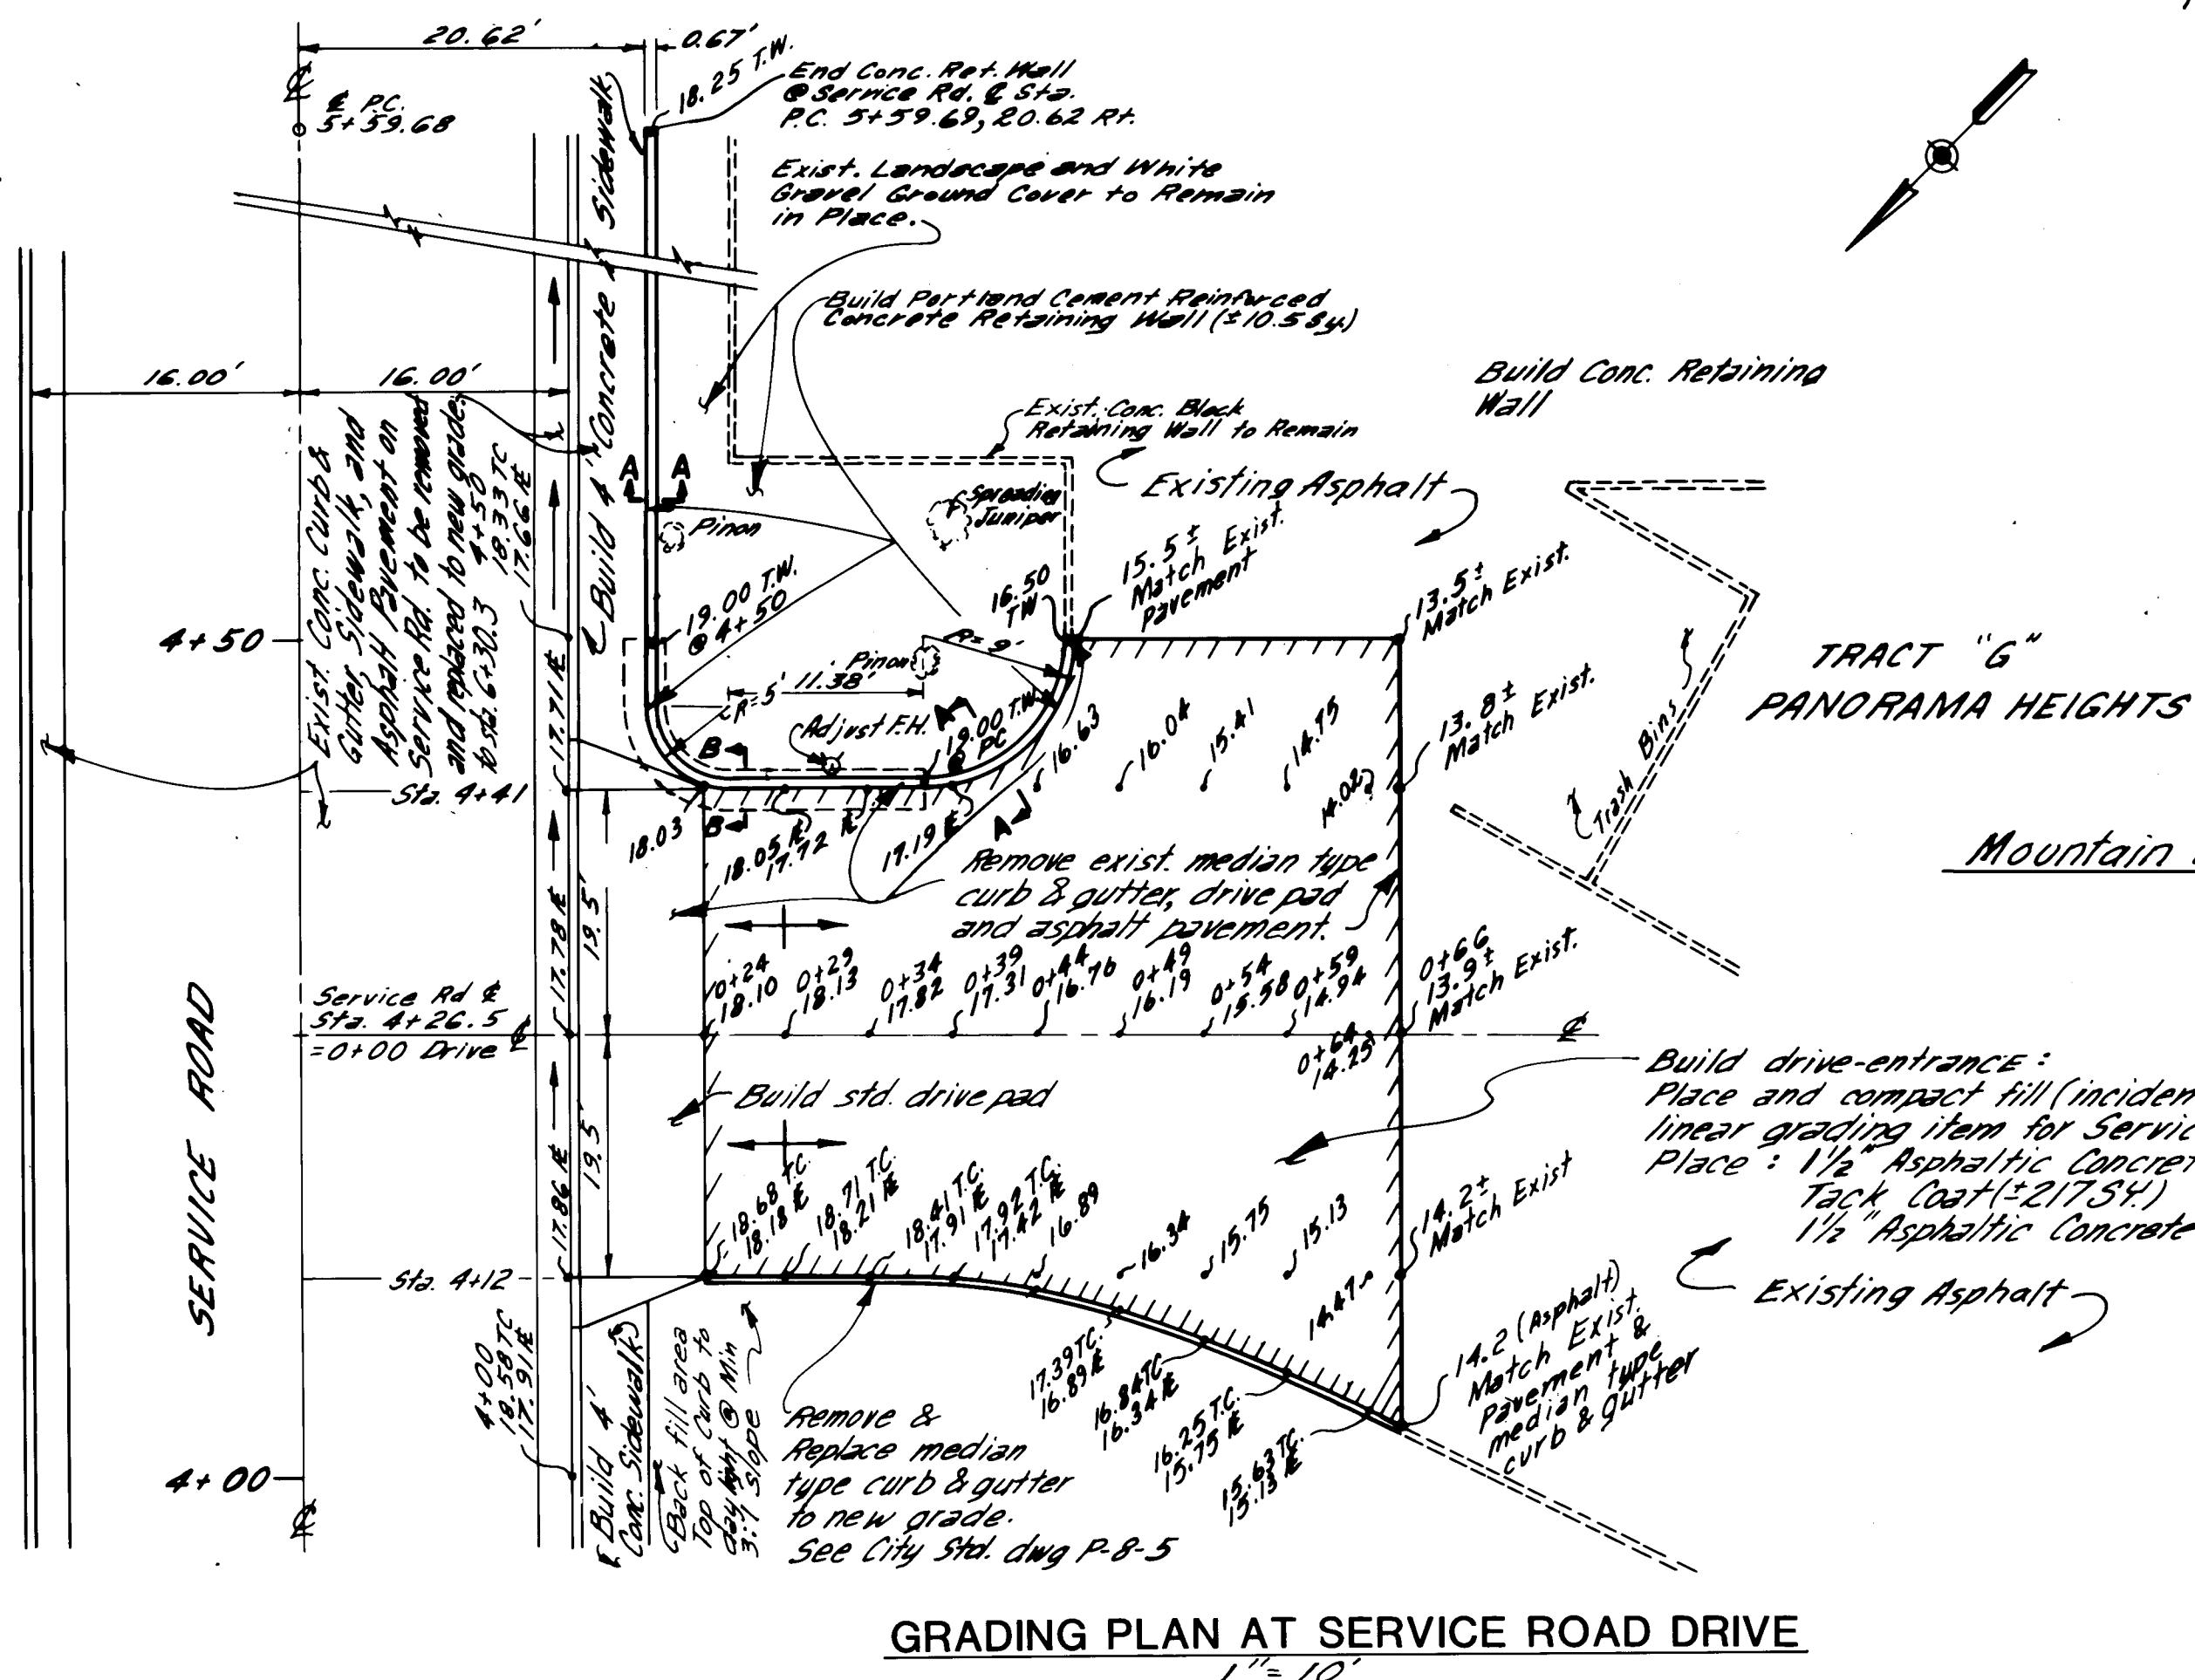

GRADING PLAN AT SERVICE ROAD DRIVE


SECTION A-A

SCALE 1/8" = 1'-0"

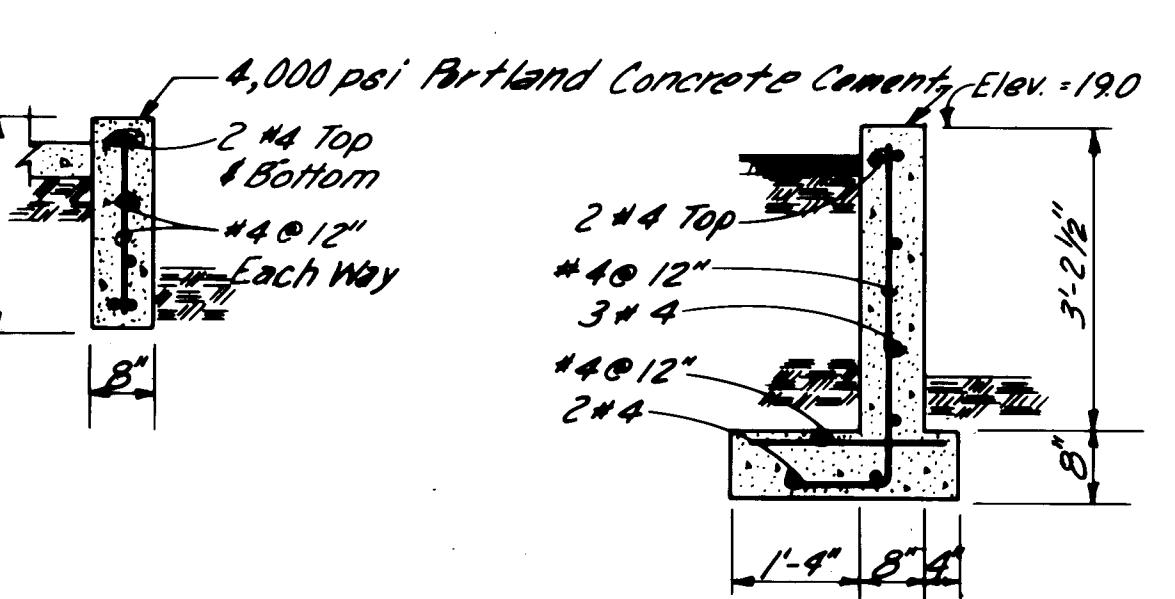


SECTION B-B


SCALE 1/8" = 1'-0"

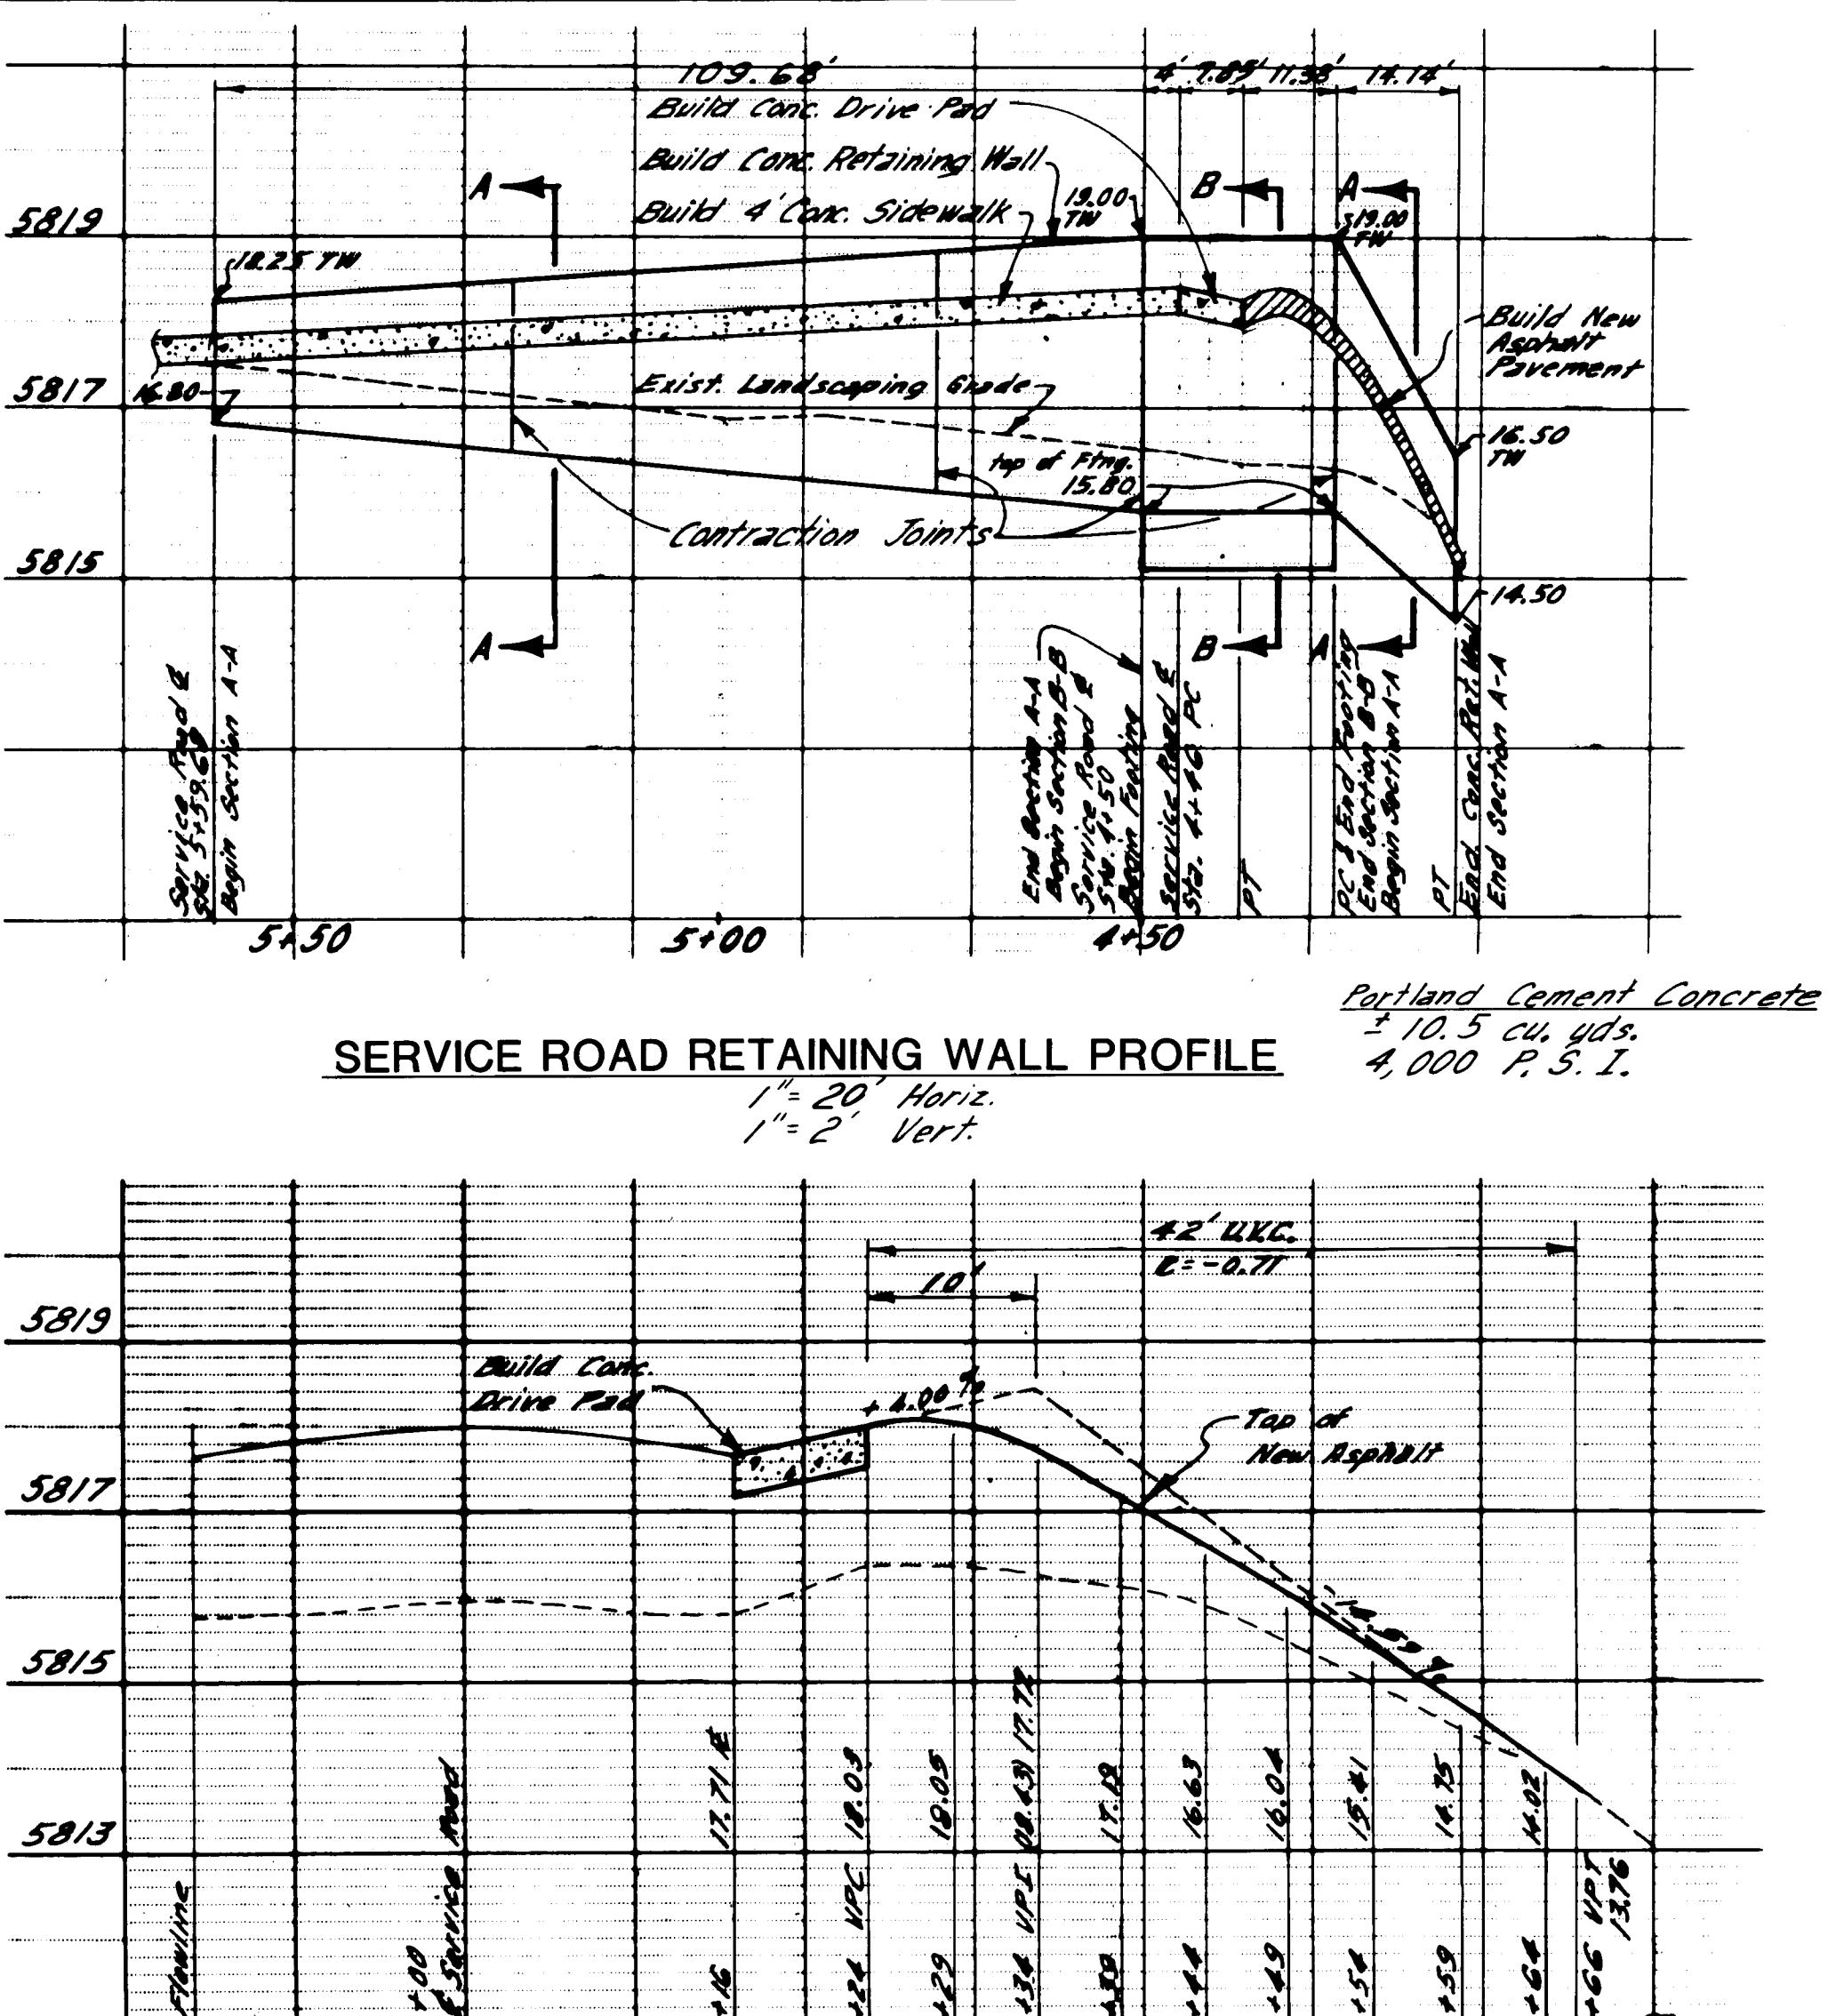


PROFILE AT EDGE OF DRIVE
RIGHT OF SERVICE RD. STA. 4+41

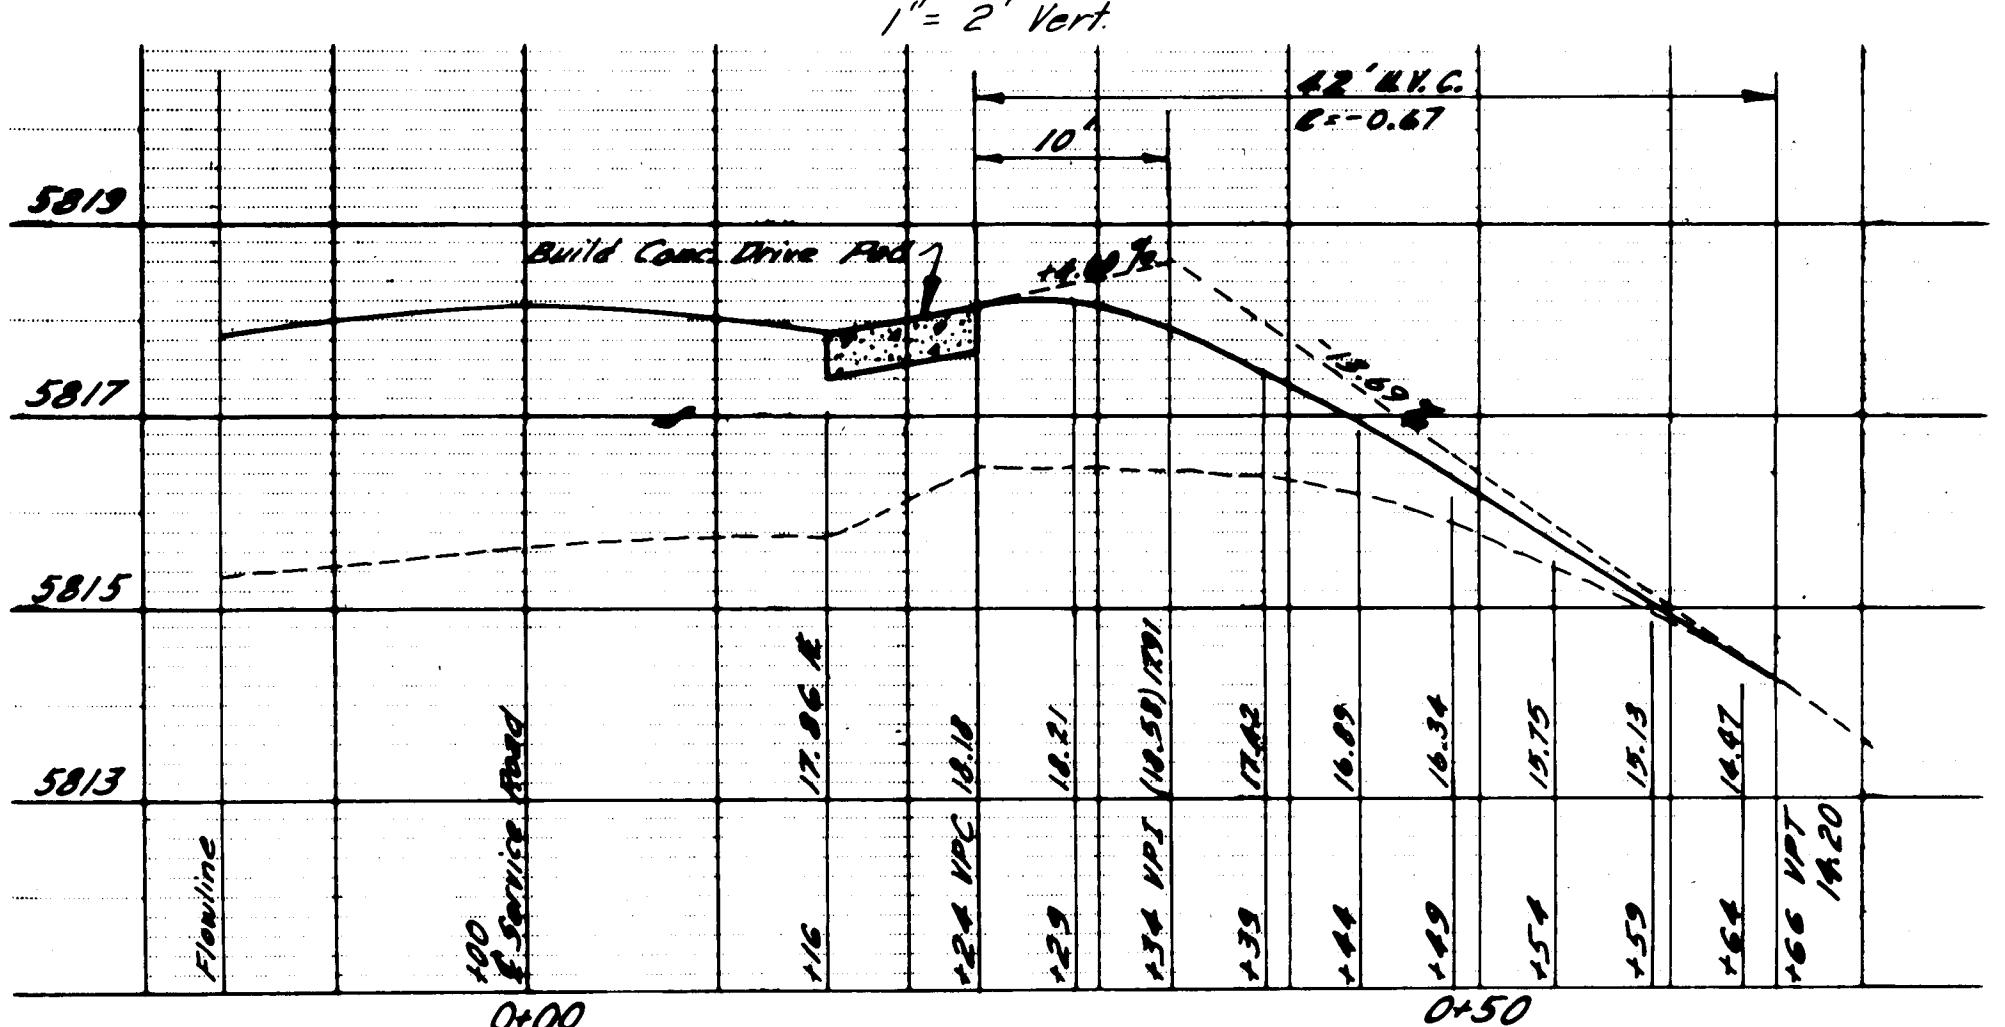


PROFILE AT EDGE OF DRIVE
RIGHT OF SERVICE ROAD STA. 4+12

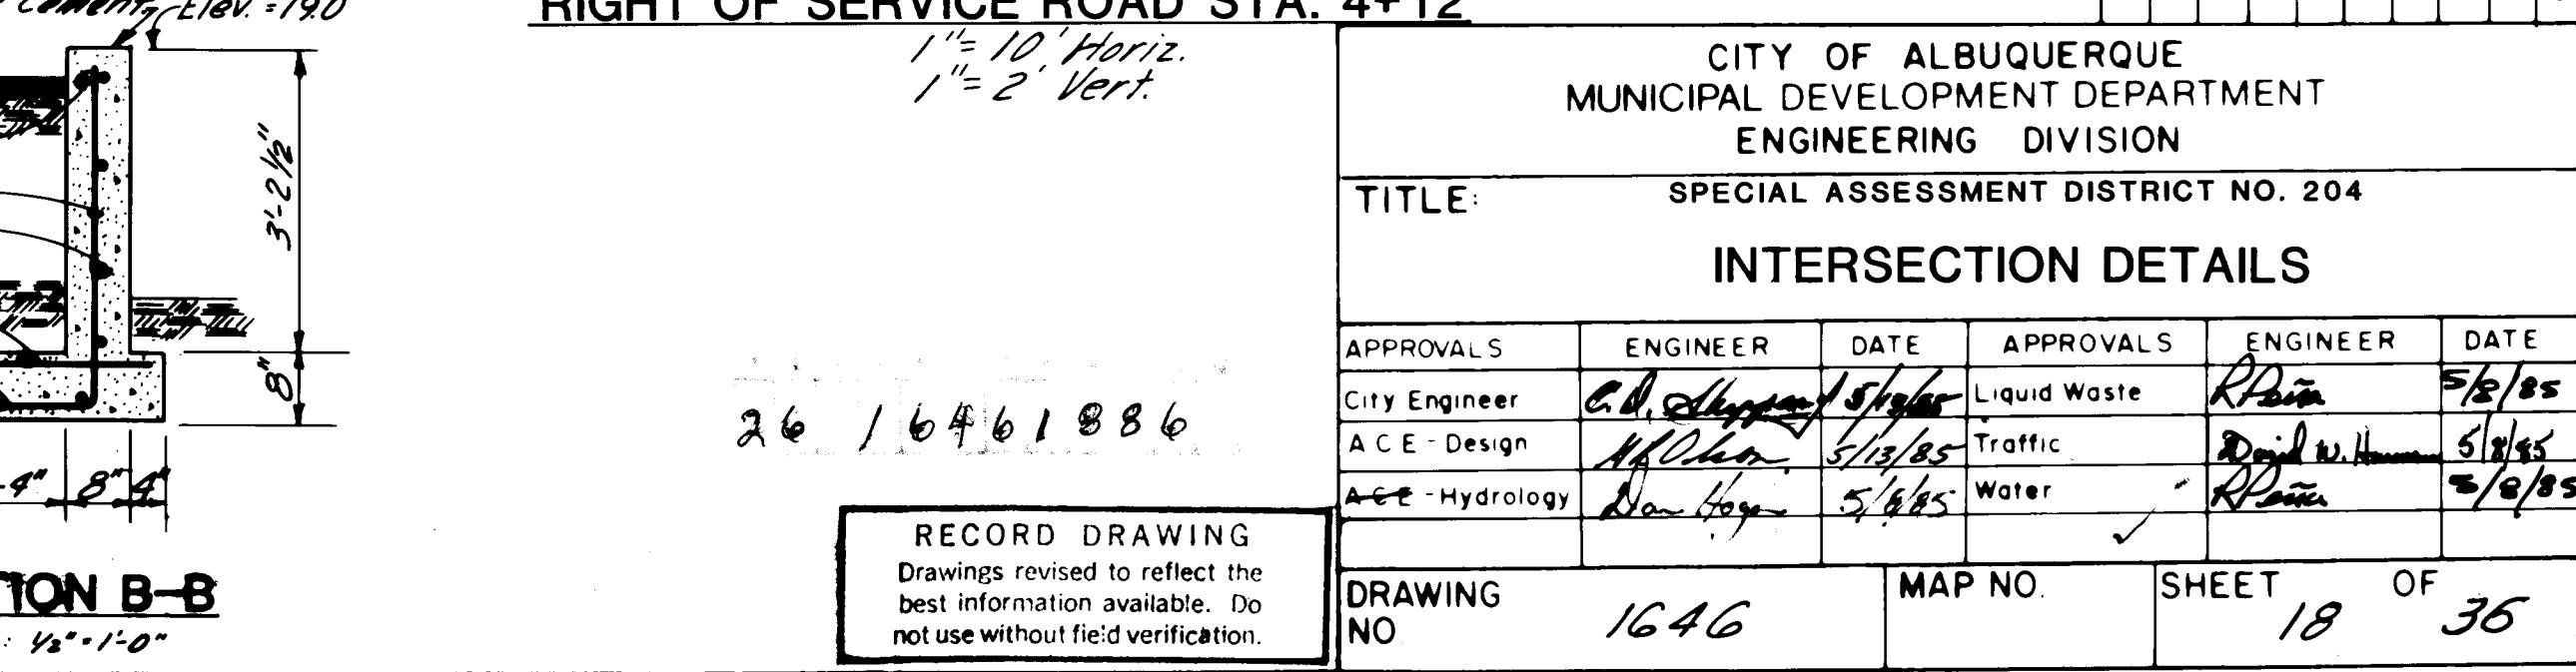

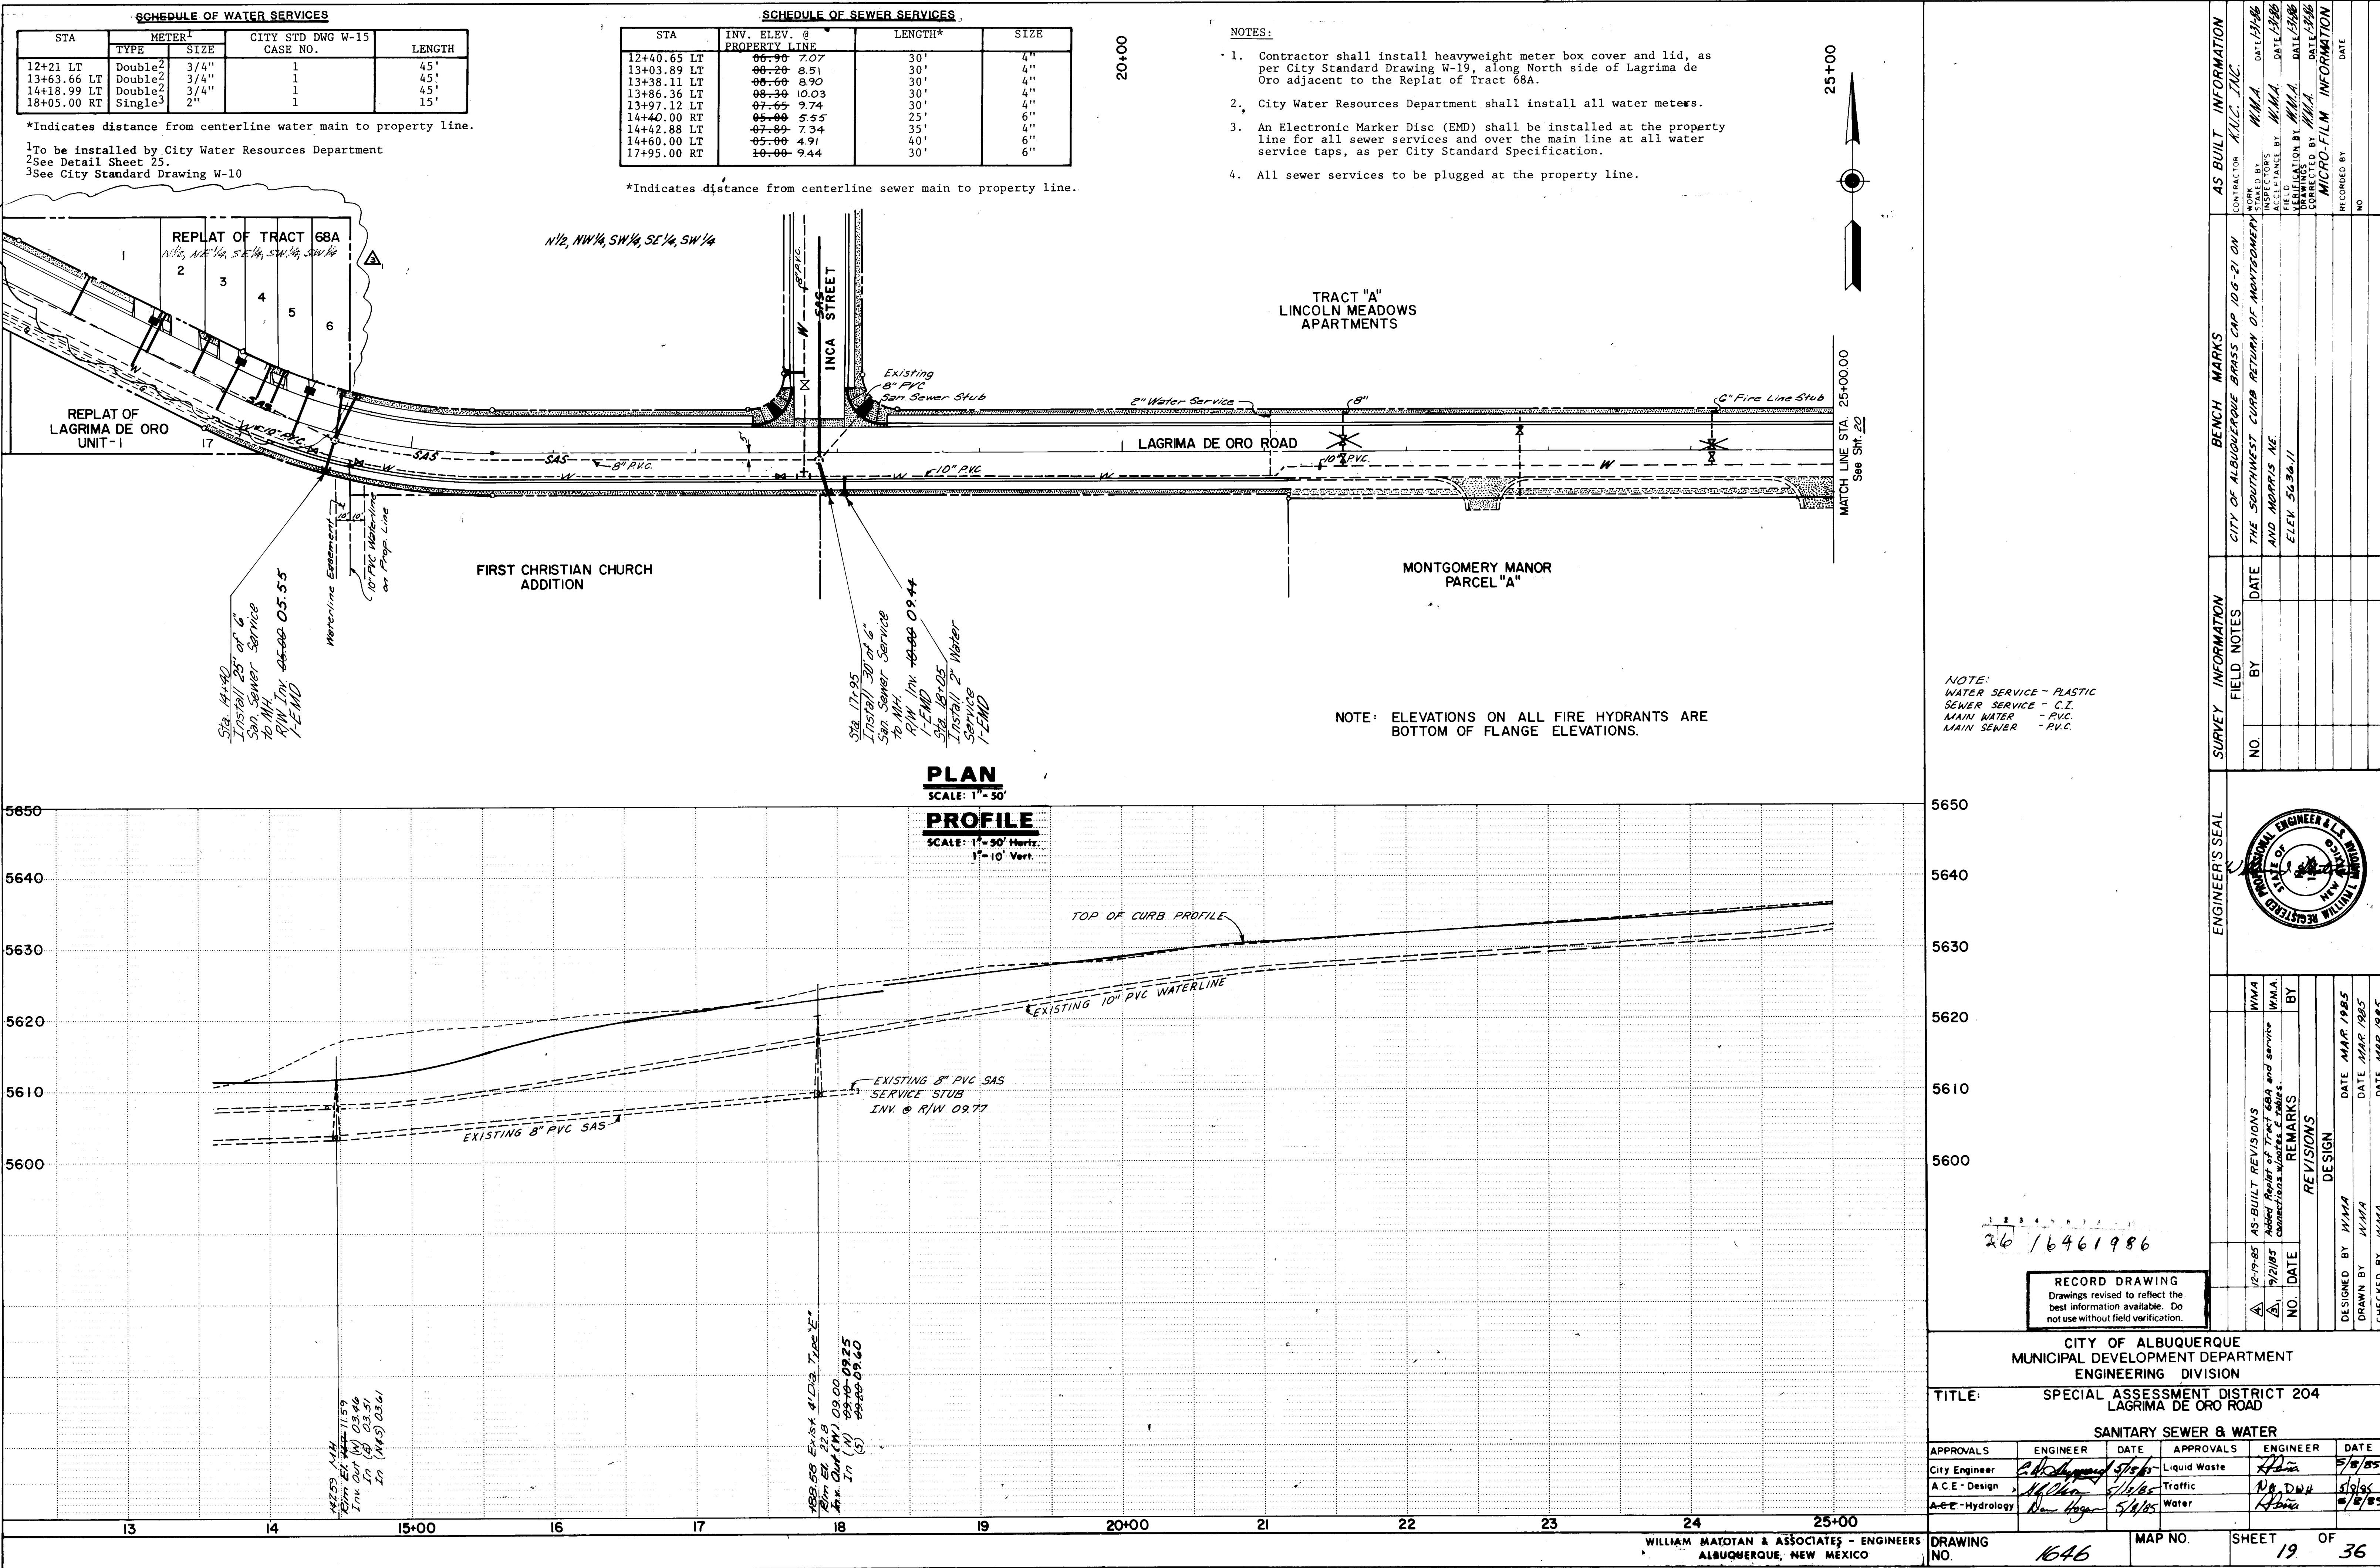

210800

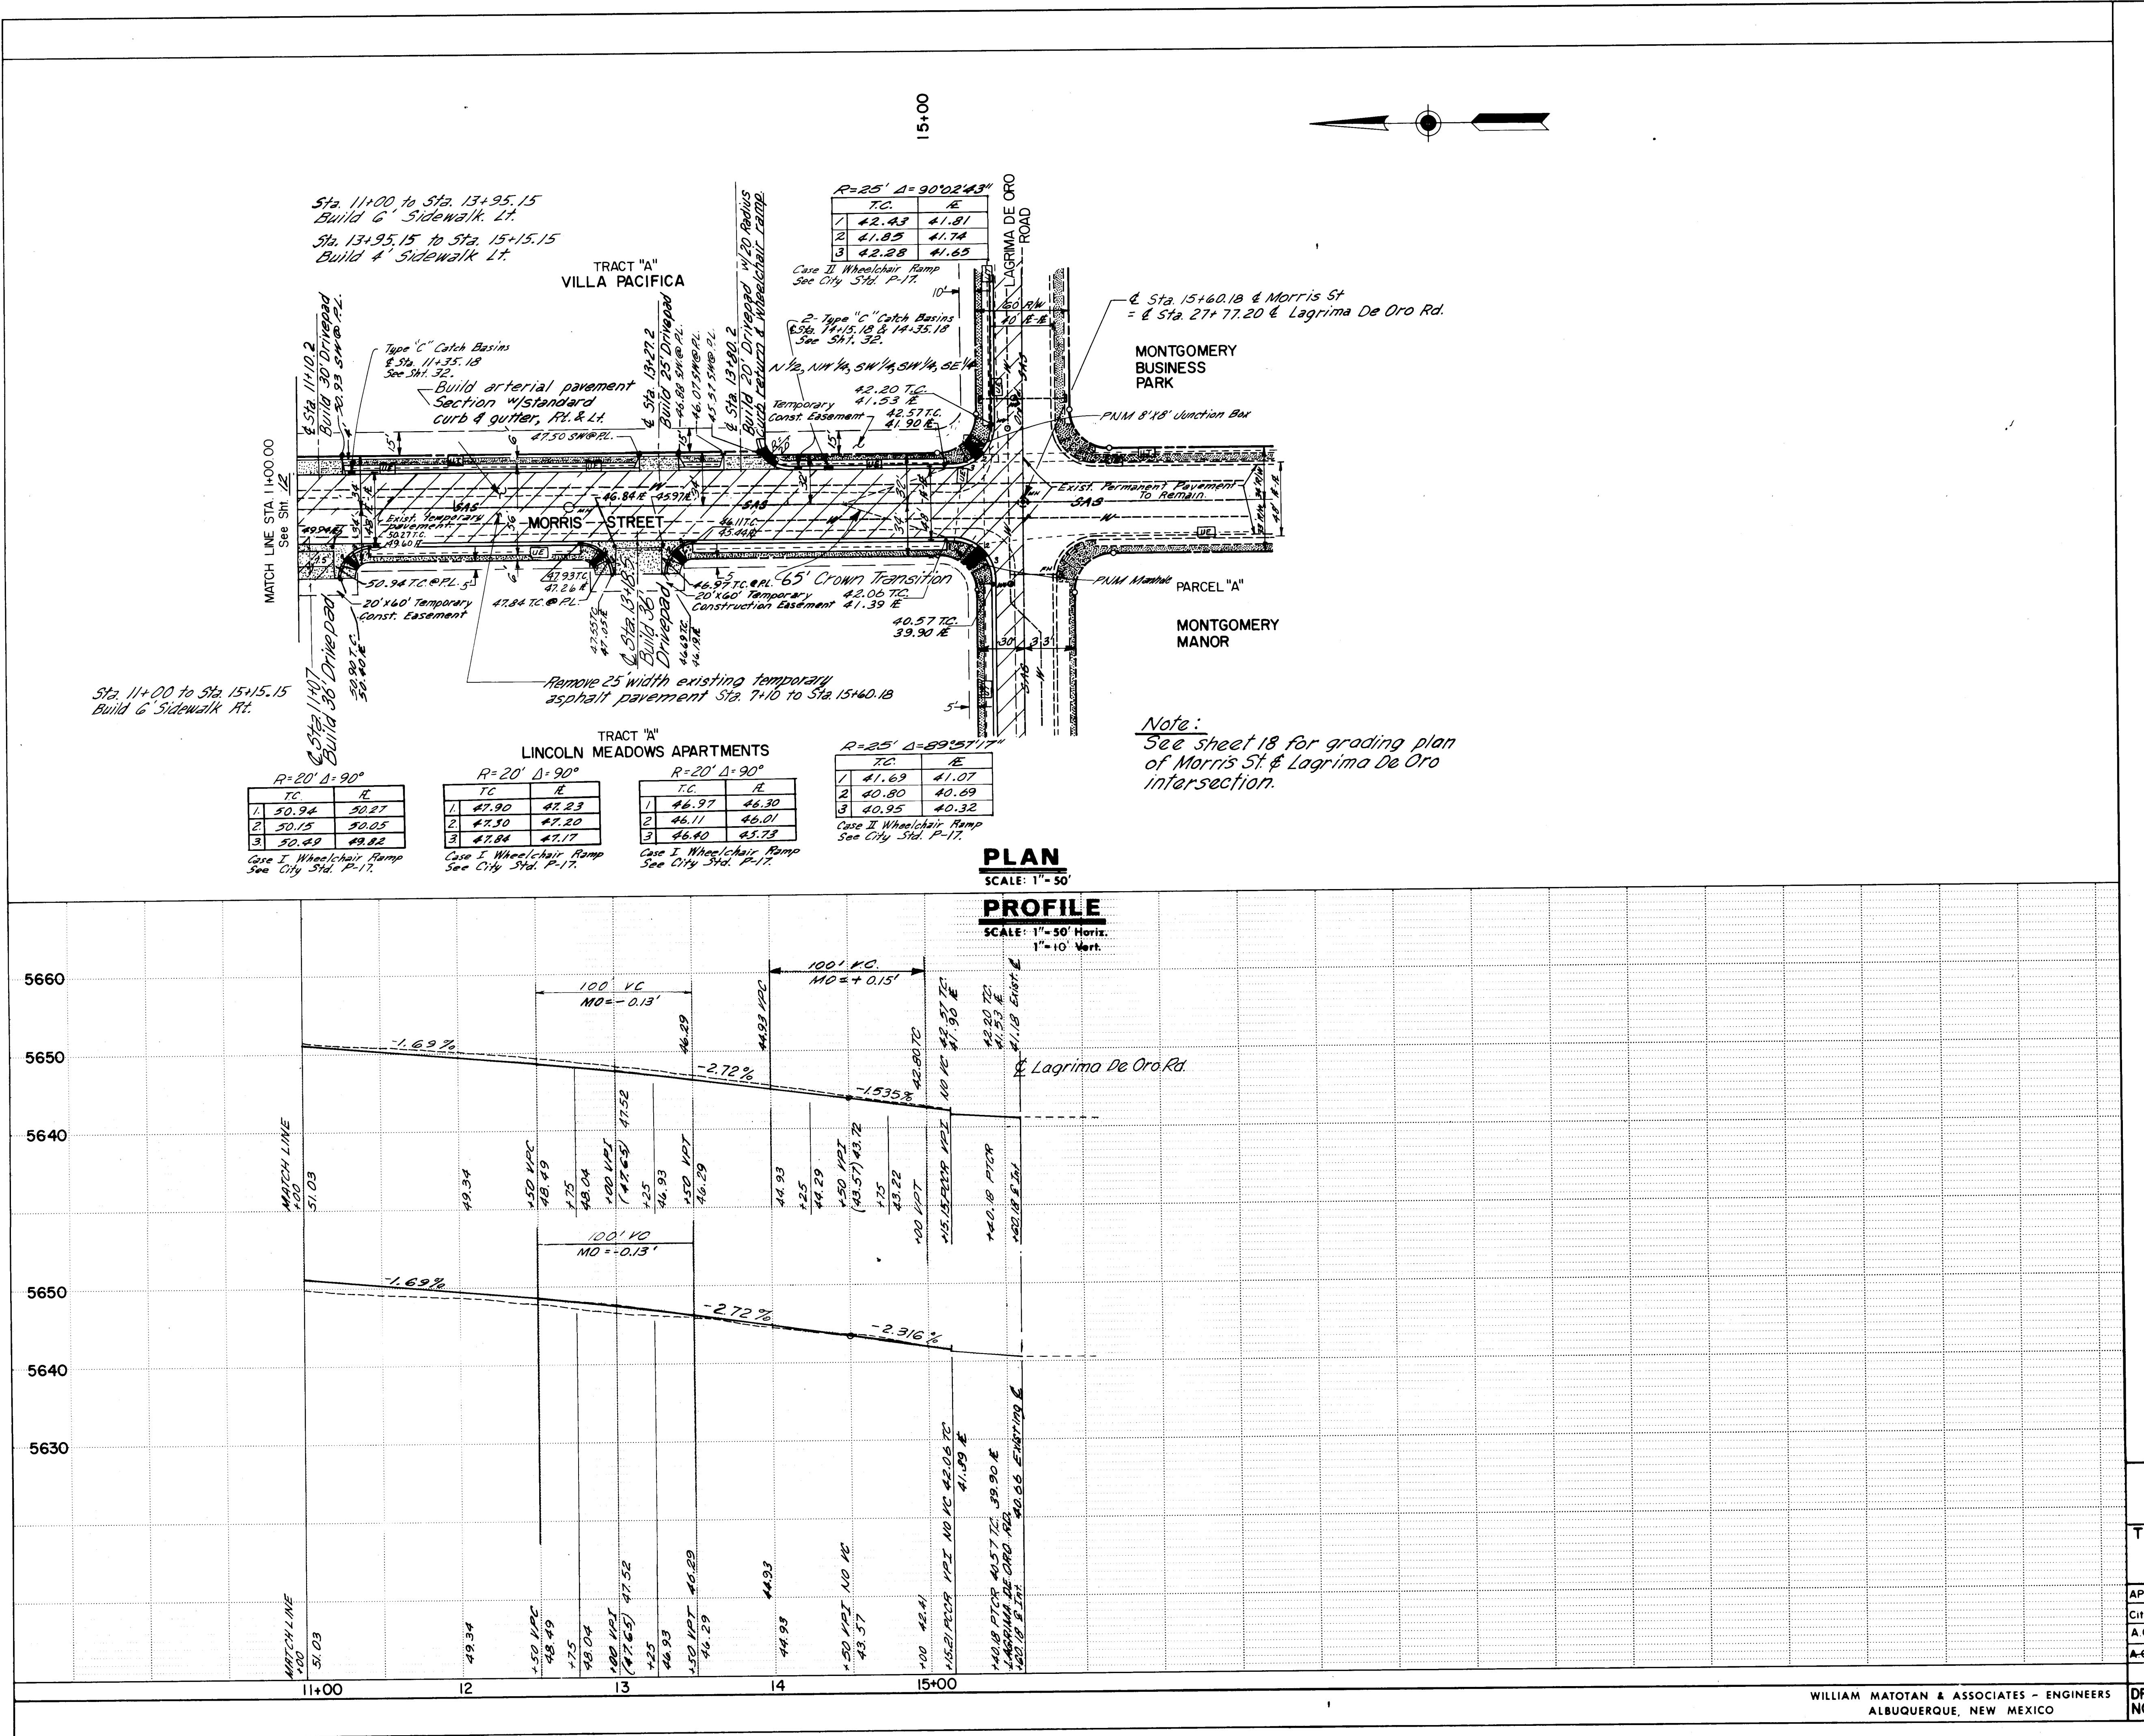

RECORD DRAWING
Drawings revised to reflect the
best information available. Do
not use without field verification.



**CITY OF ALBUQUERQUE
MUNICIPAL DEVELOPMENT DEPARTMENT
ENGINEERING DIVISION**


**SPECIAL ASSESSMENT DISTRICT 204
MORRIS STREET
STA. 11+00.00 TO STA. 15+00.00
PAVING**



S	ENGINEER	DATE	APPROVALS	ENGINEER	DATE
eer	C.W. Chapman	5/13/85	Liquid Waste	Rena	5/8/85
sign	H.G. Olson	5/13/85	Traffic	Douglas W. Hansen	5/8/85

WILLIAM MATOTAN & ASSOCIATES - ENGINEERS
ALBUQUERQUE, NEW MEXICO


G 1646 MAP NO. F-21 SHEET 13 OF 36

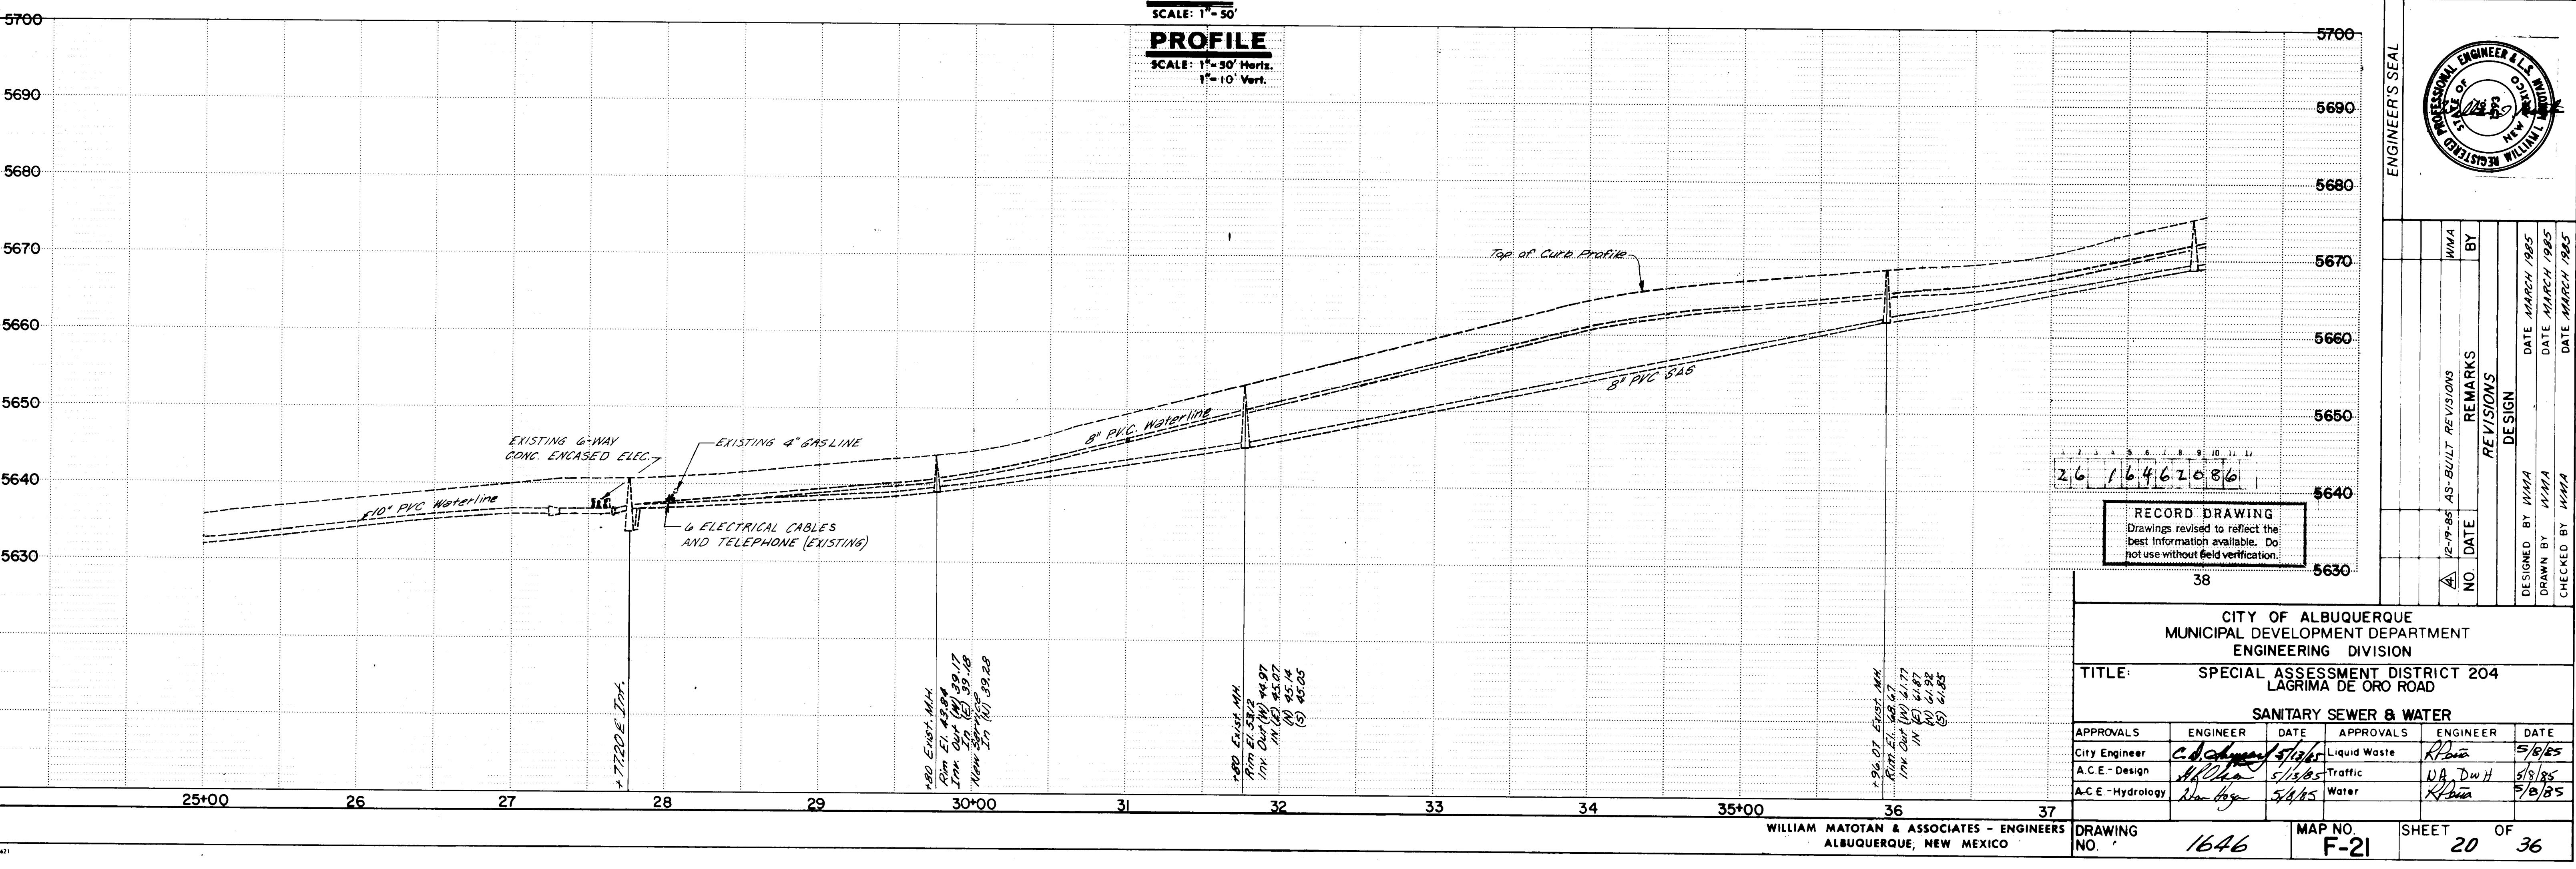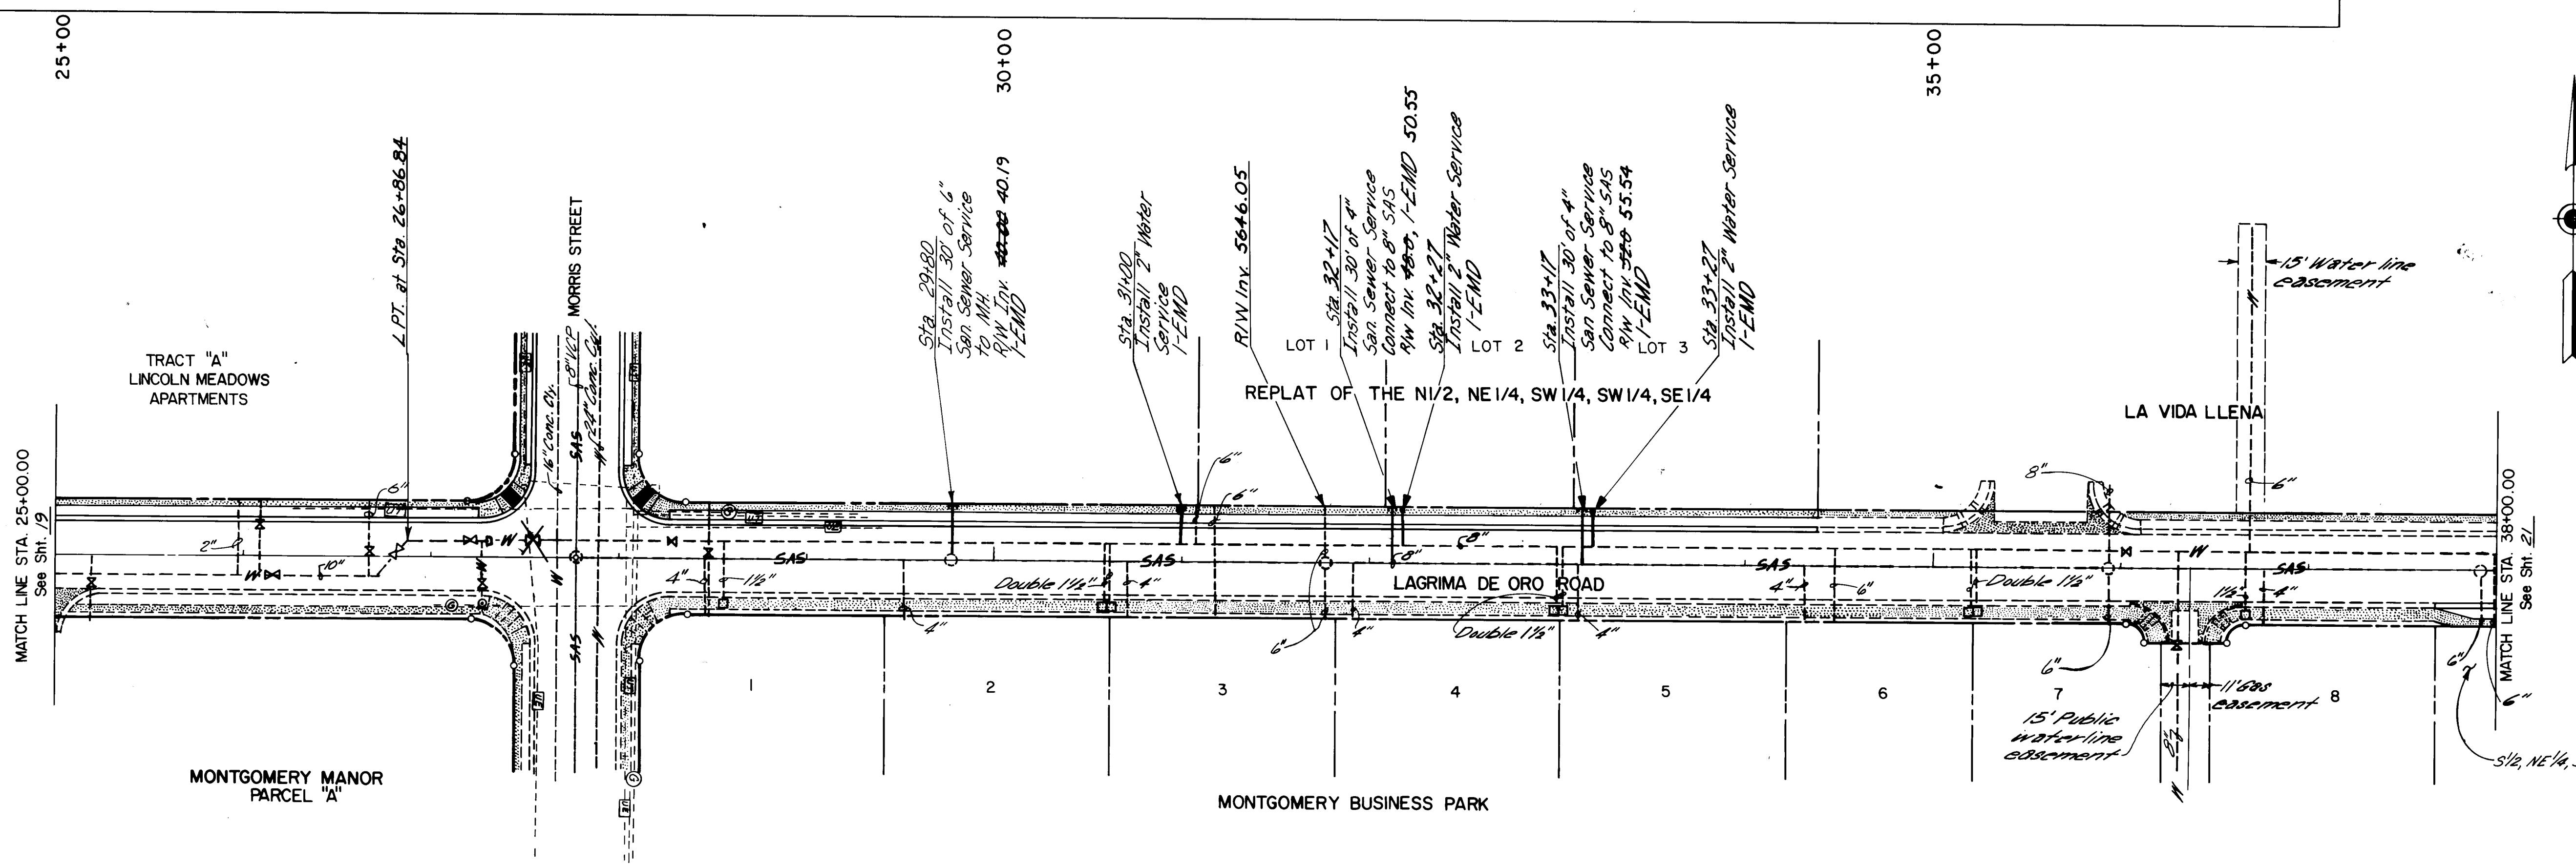

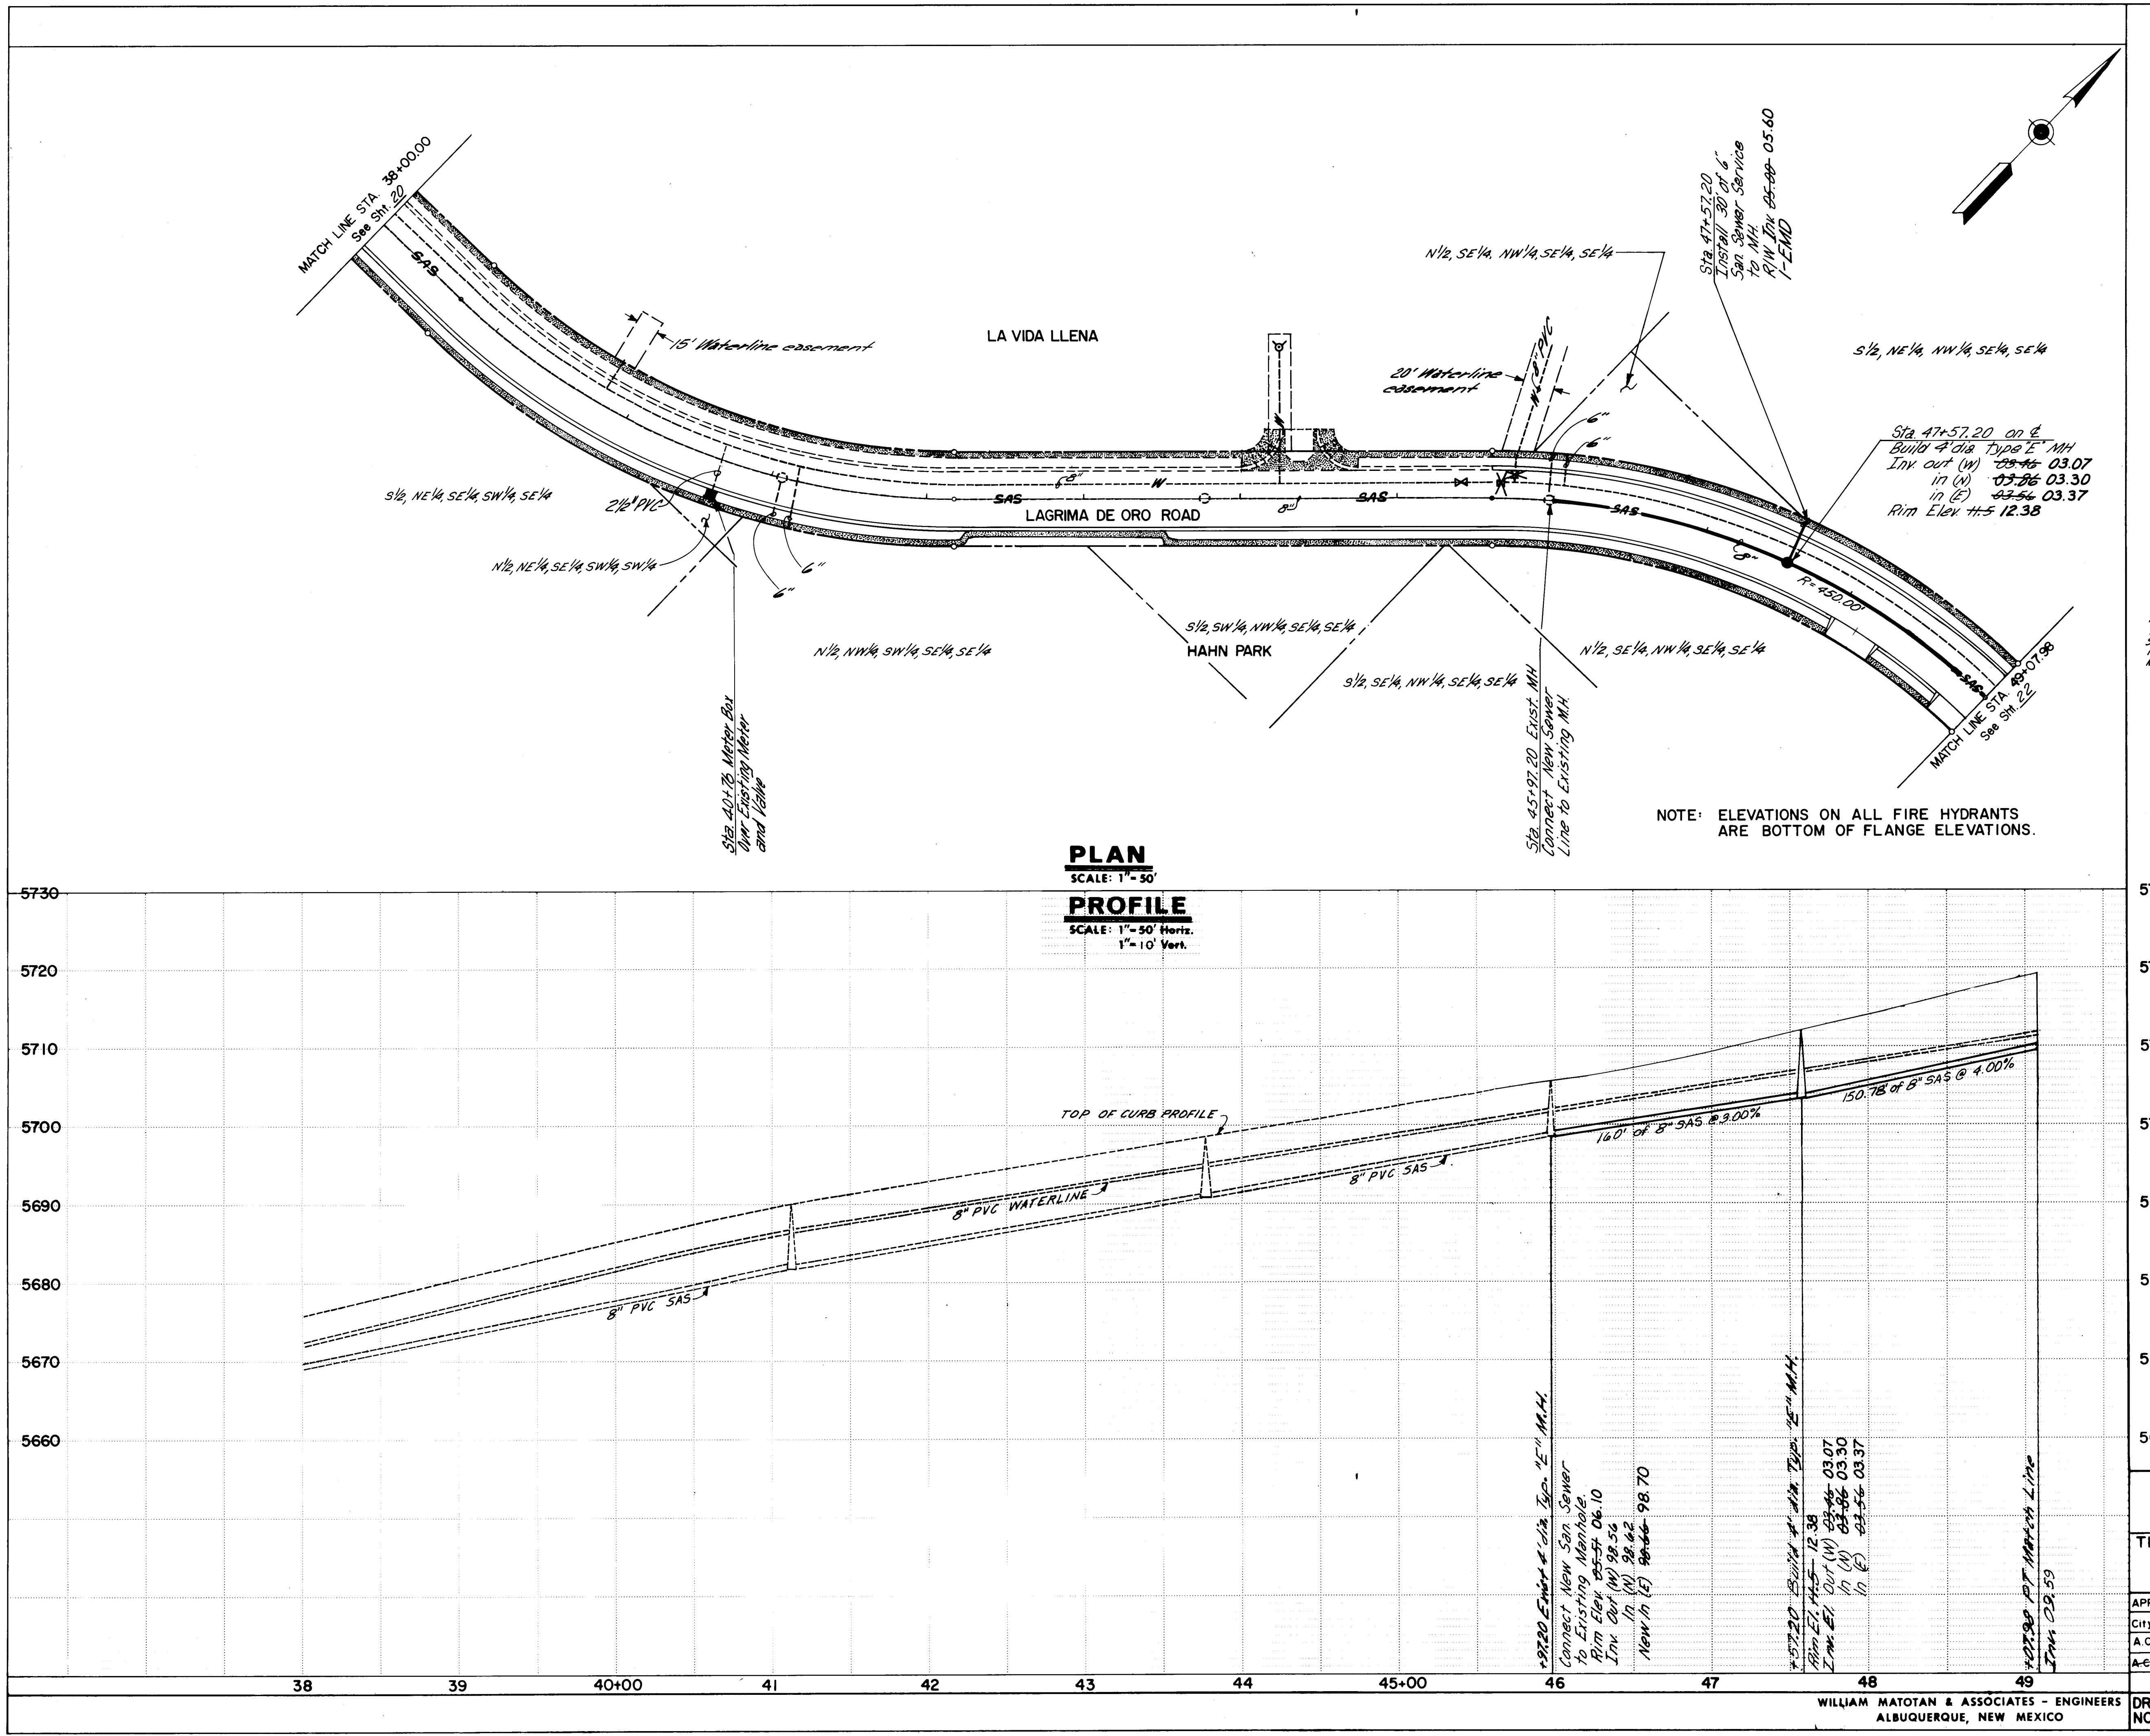

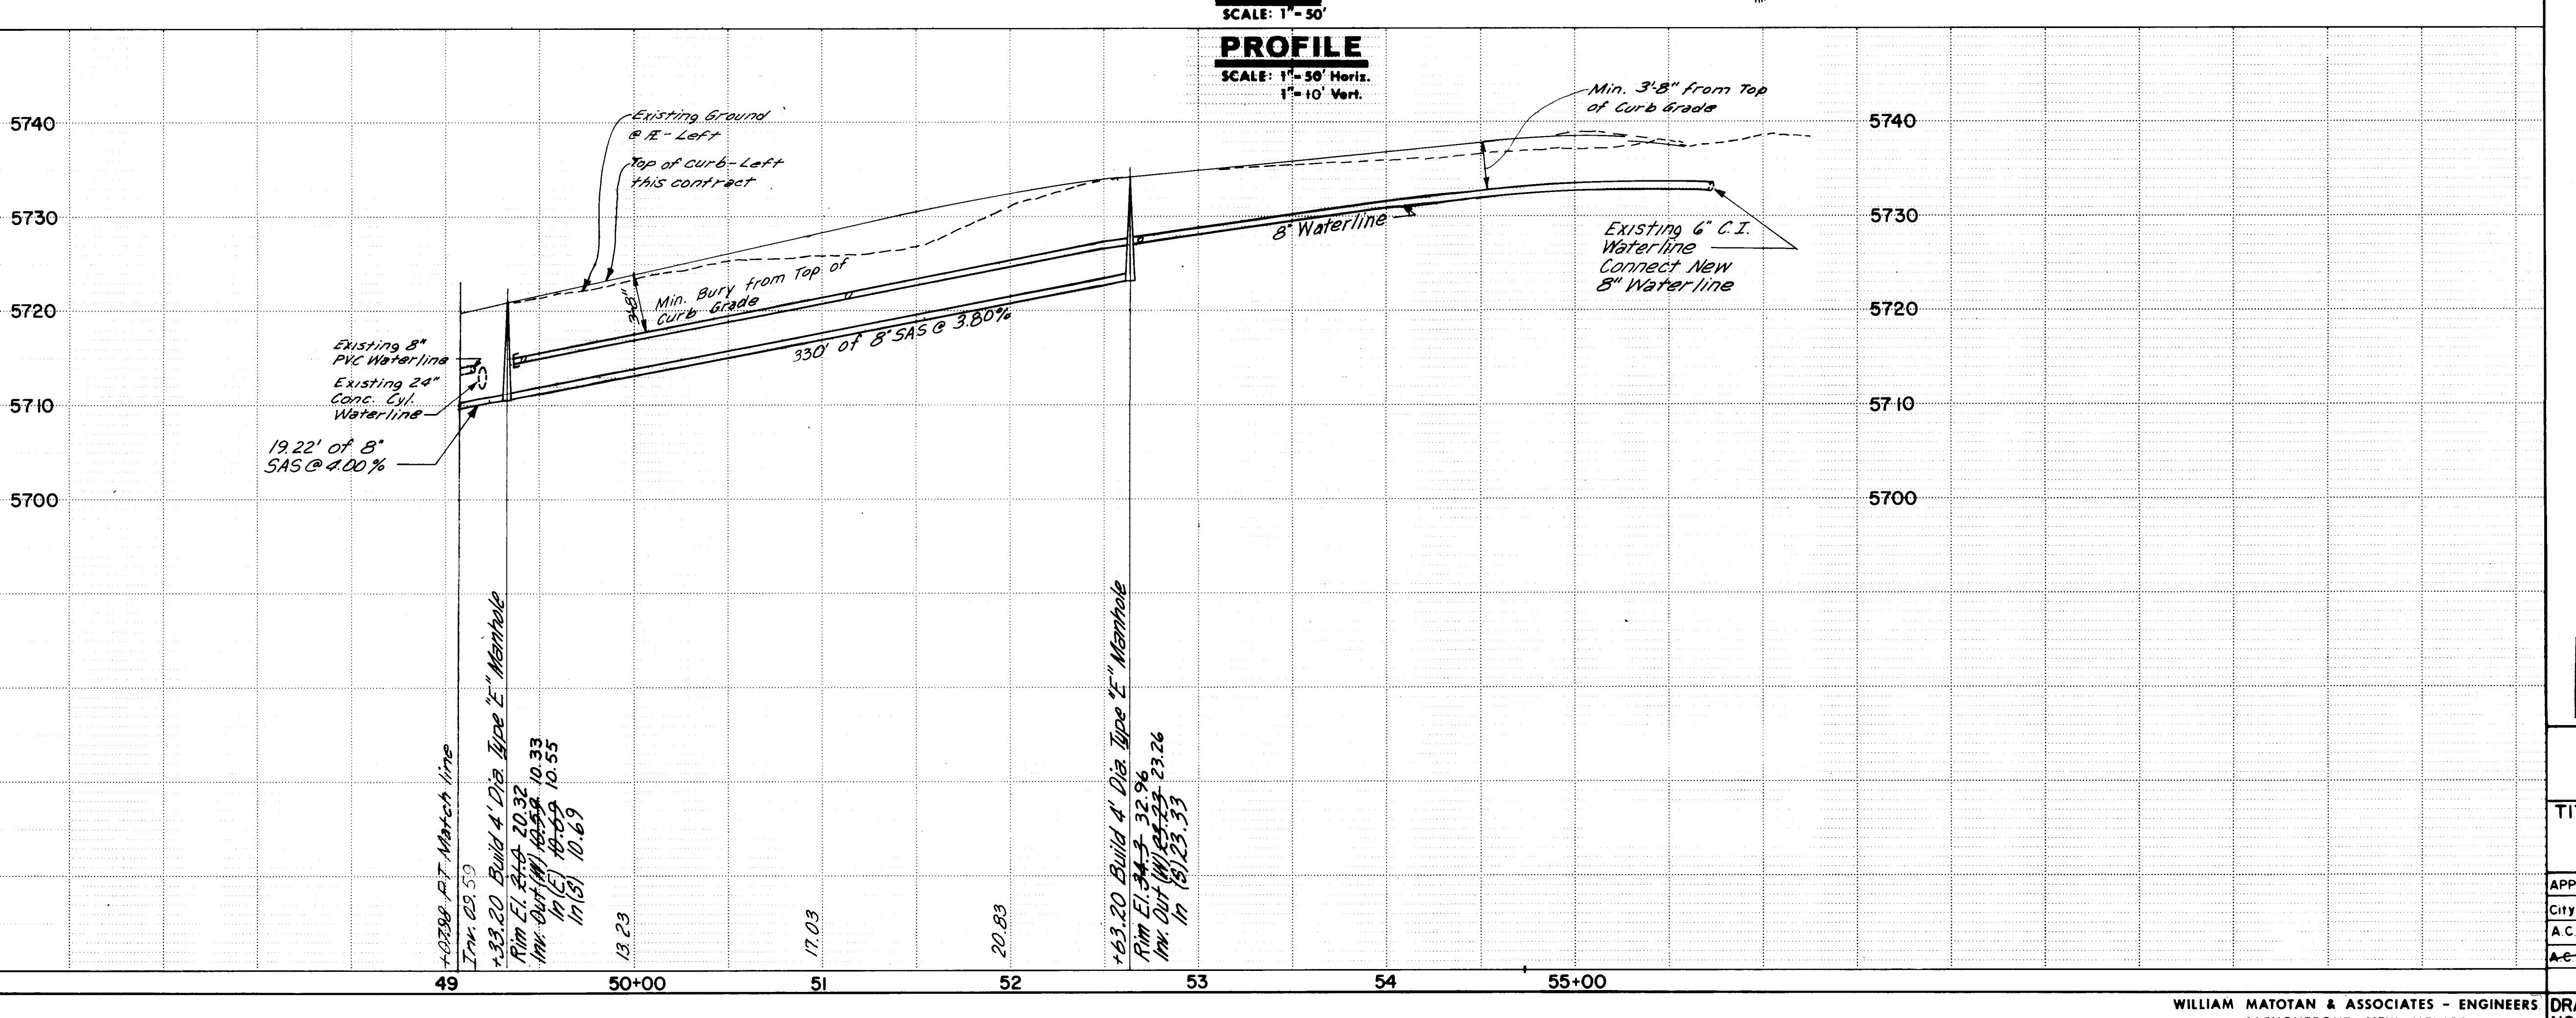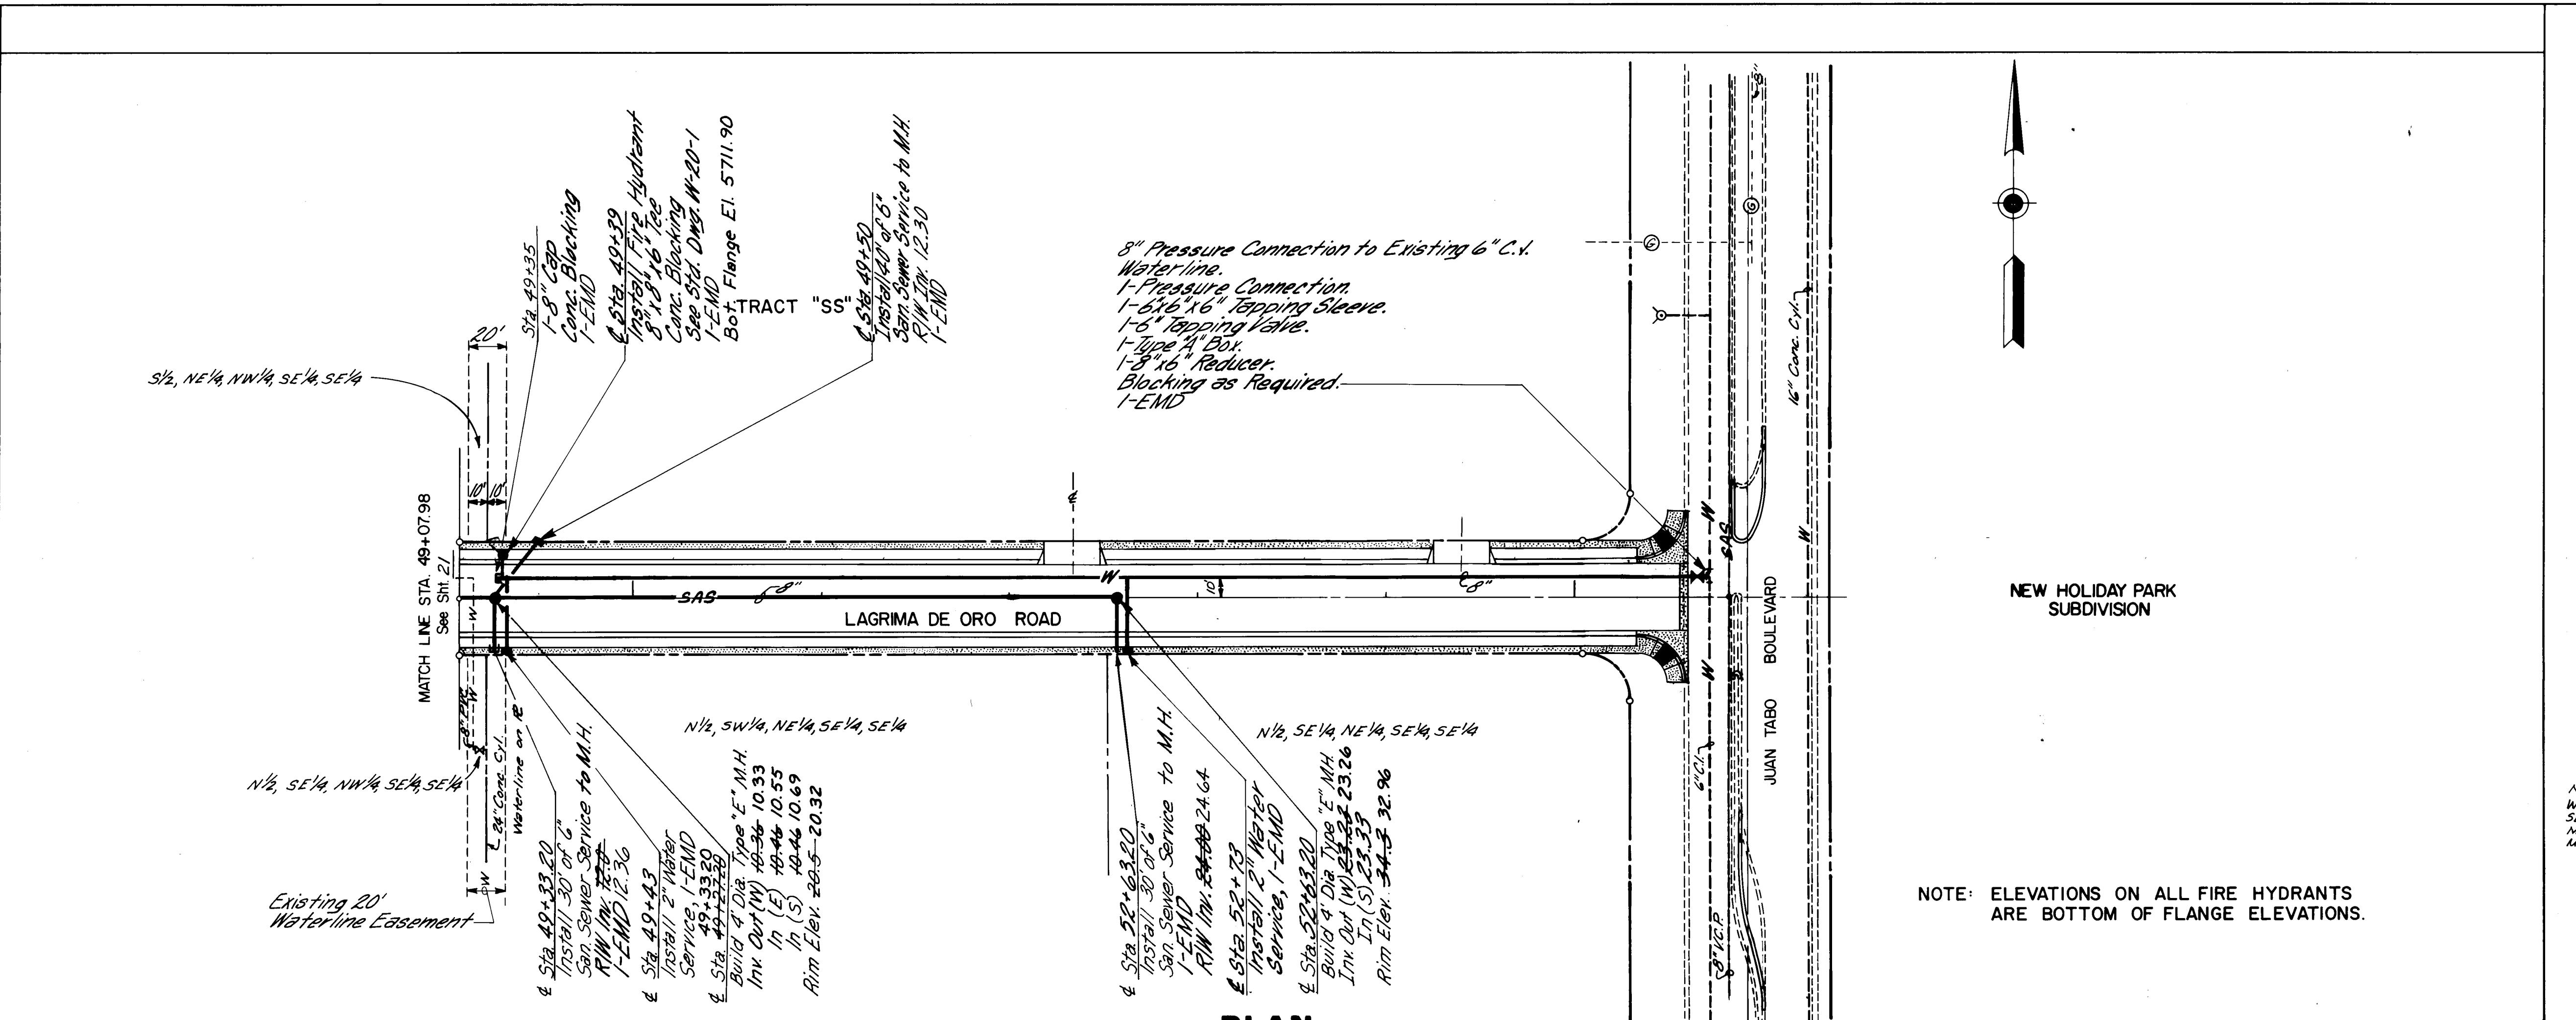




AS BUILT INFORMATION					
CONTRACTOR	KMC INC.	WORK	CITY OF ALBUQUERQUE BRASS CO. TO G-21 ON THE SOUTHWEST CORNER AND MORRIS NE	INSPECTOR	W.M.A. DATE 5/8/85
STANDED BY		FIELD	THE SOUTHWEST CORNER AND MORRIS NE	VERIFICATION BY	W.M.A. DATE 5/8/85
DATE 5/8/85		DRAWINGS	ELEV. 56-36-11	CORRECTED BY	W.M.A. DATE 5/8/85
		RECORDED BY	MICRO-FILM INFORMATION		NO DATE


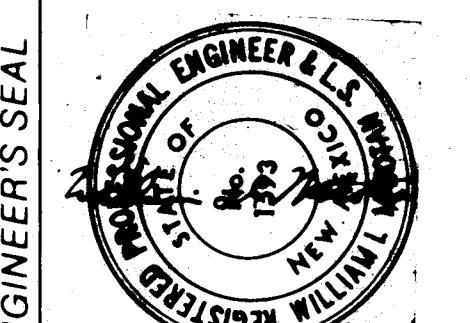




26 16 46 2286

0698020

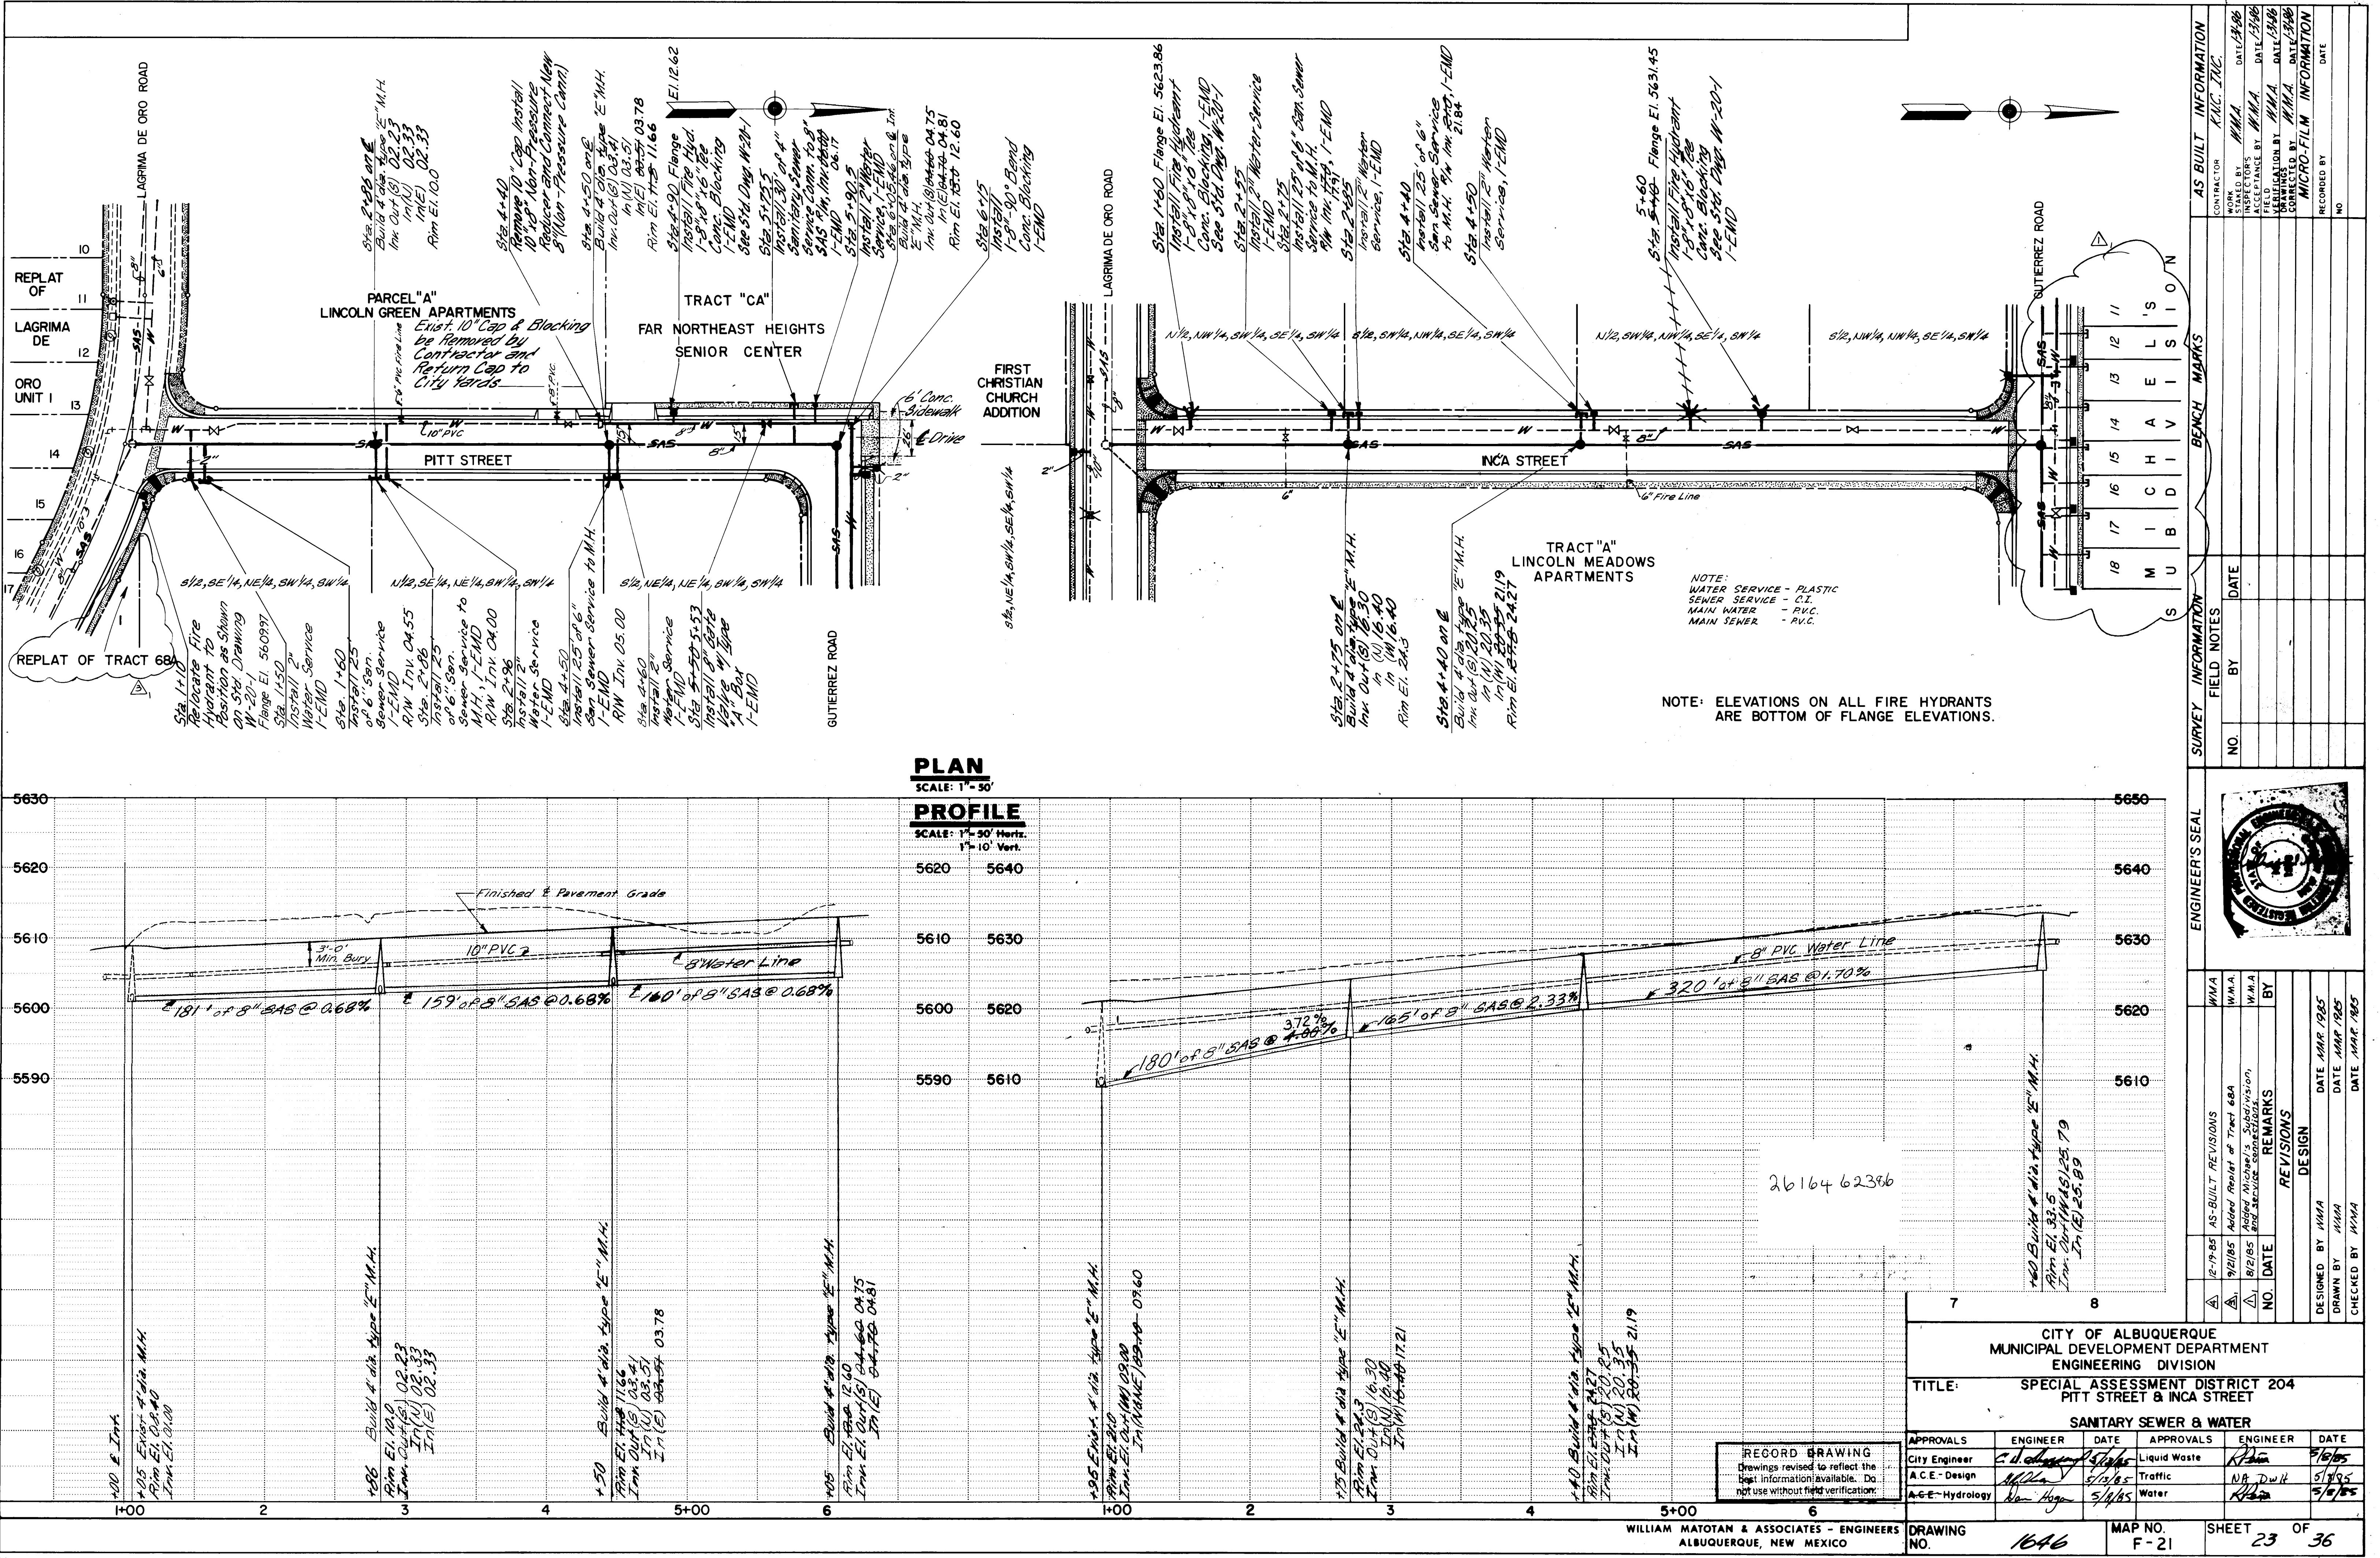

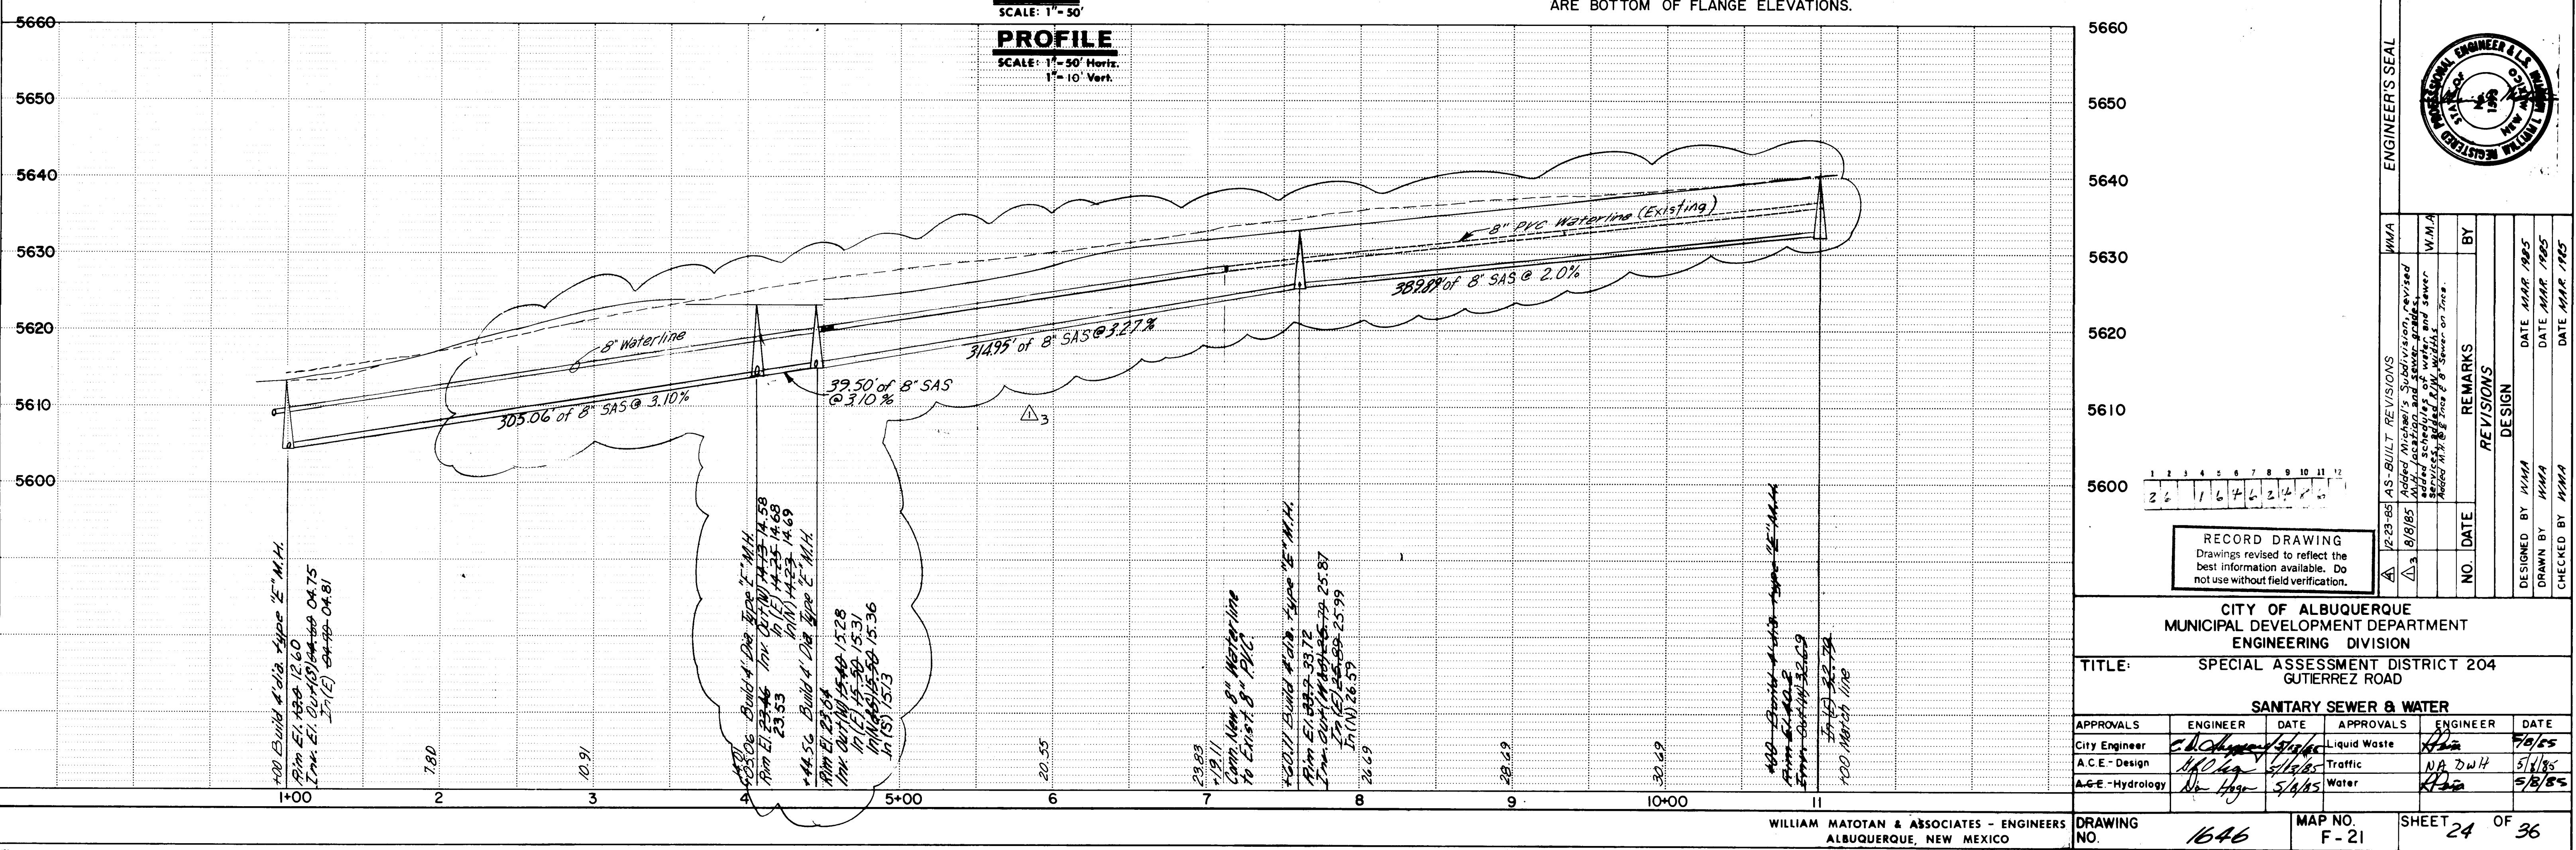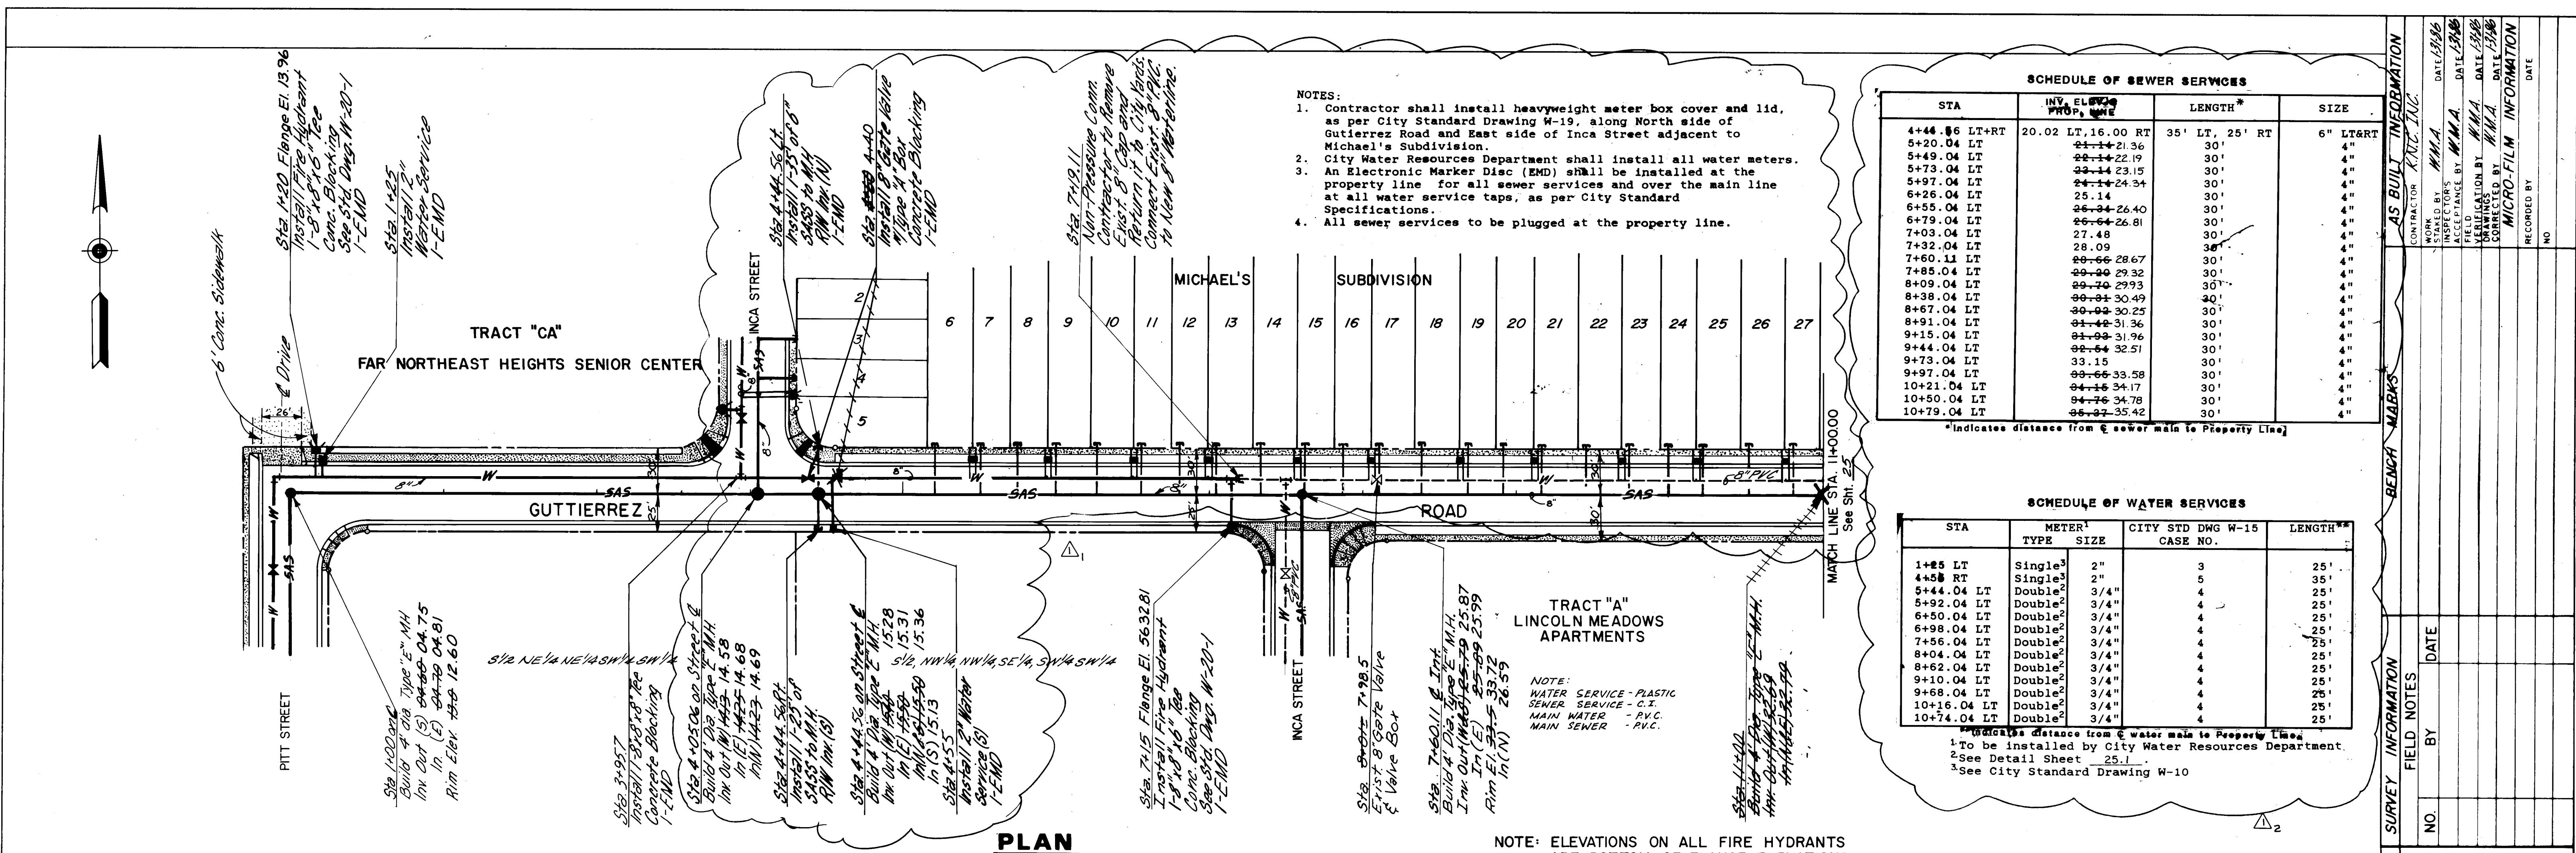

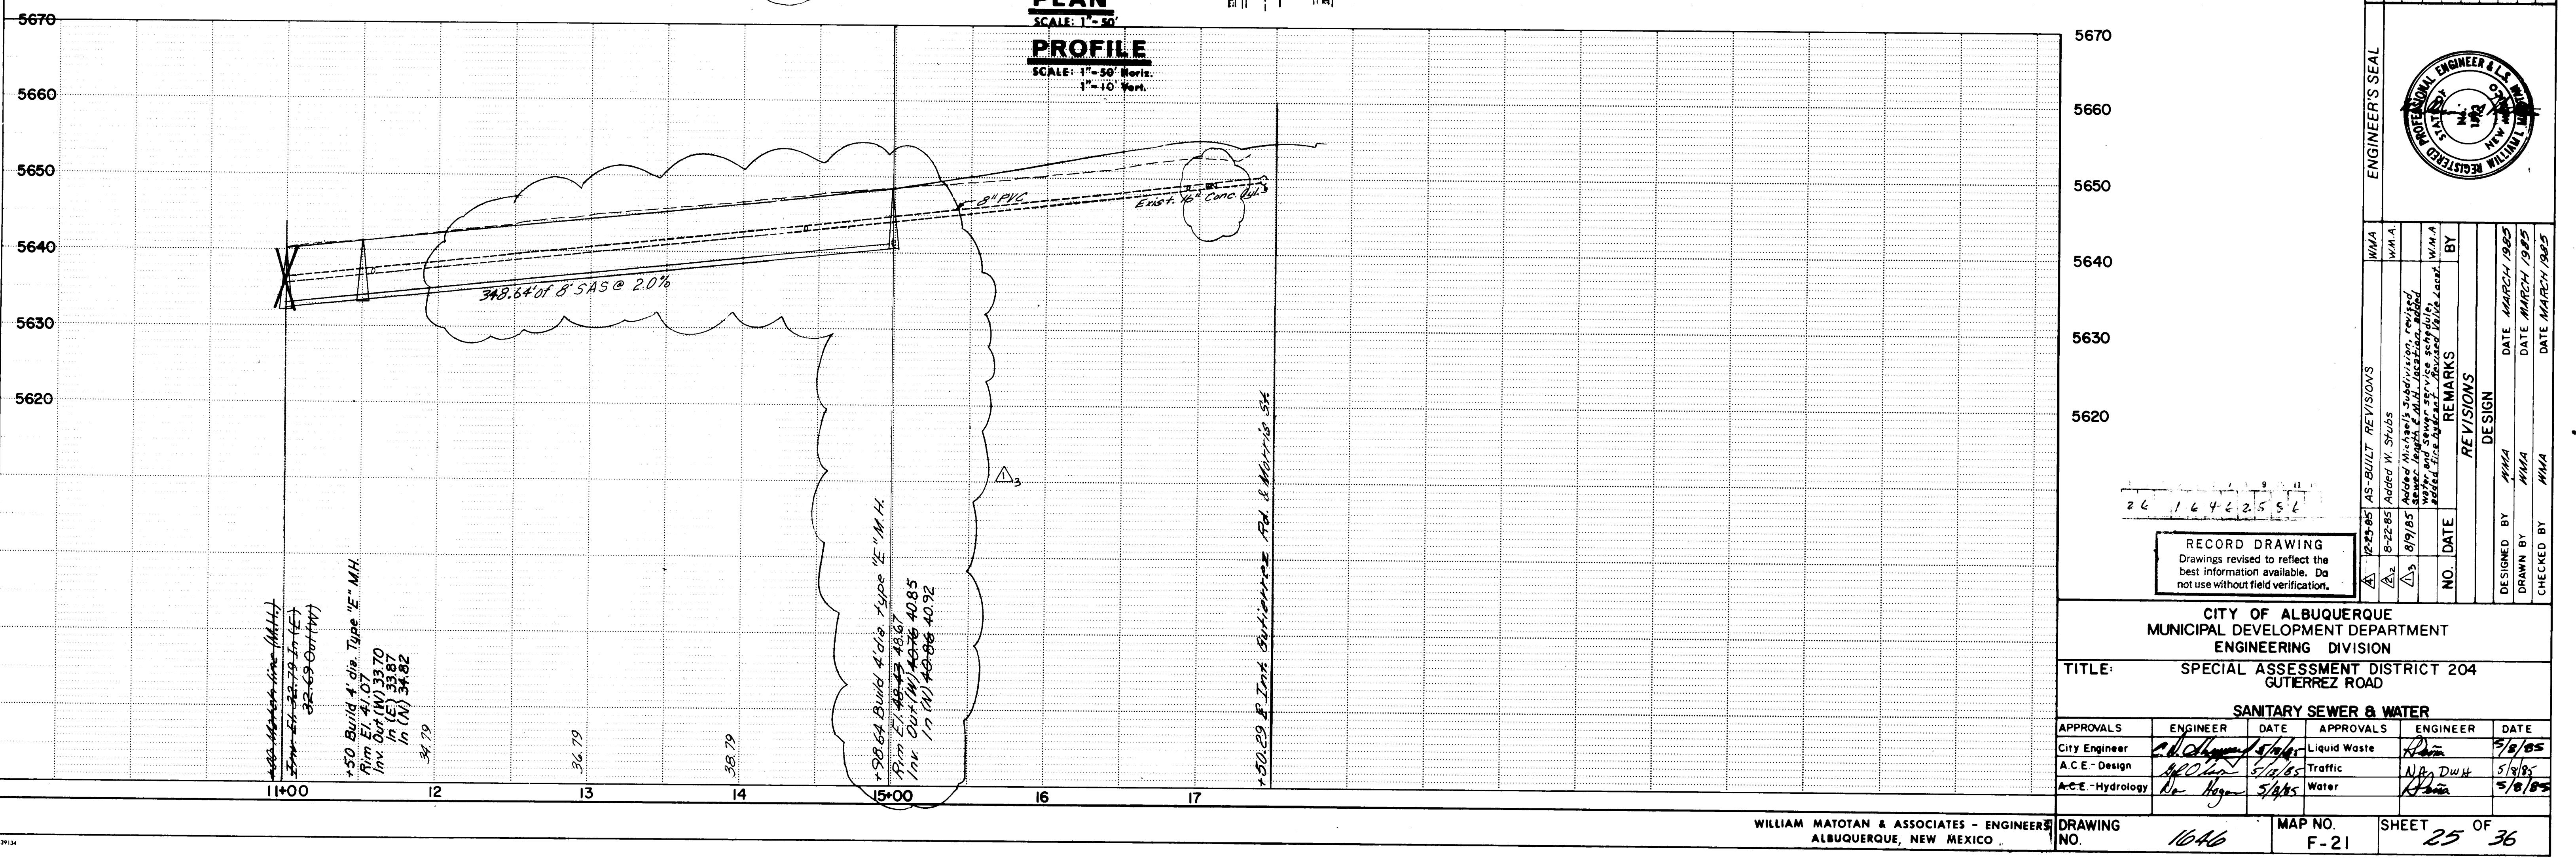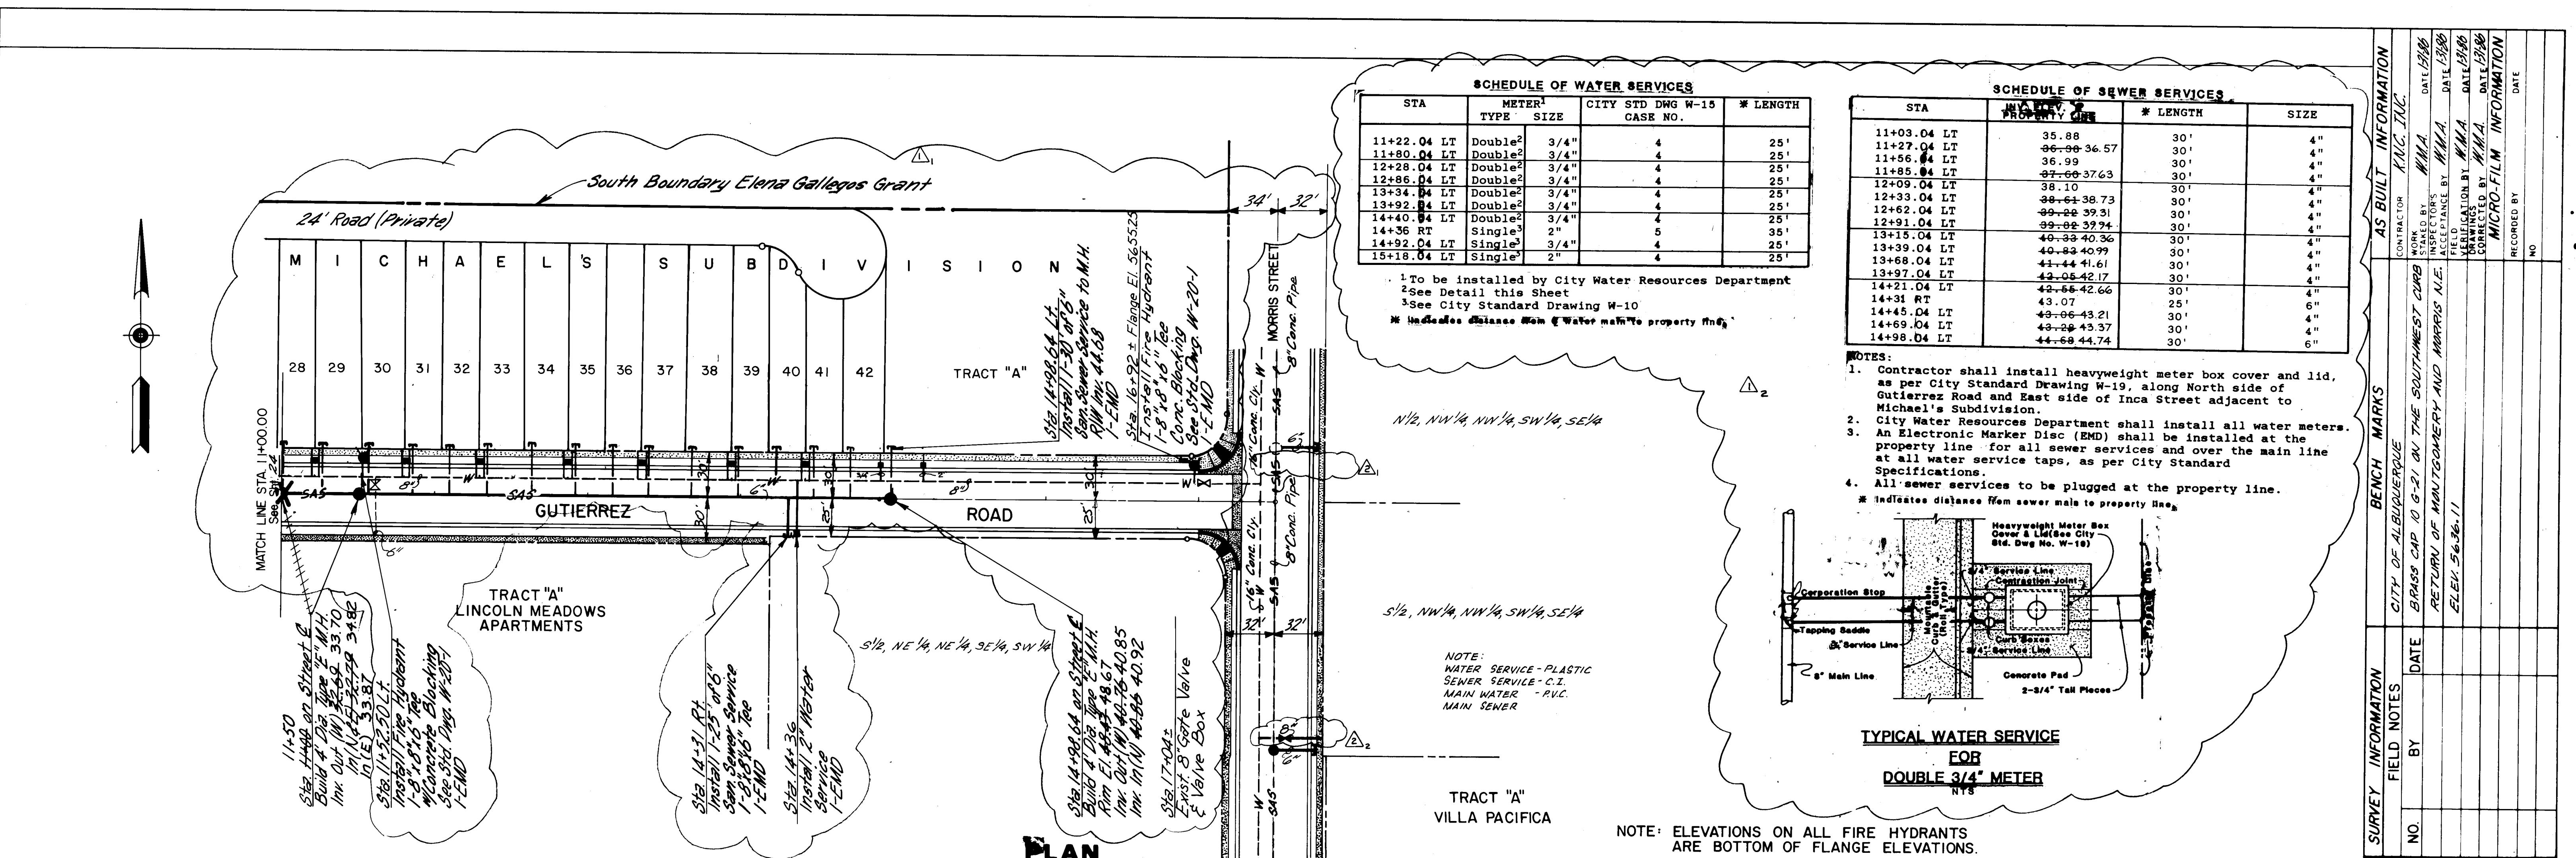

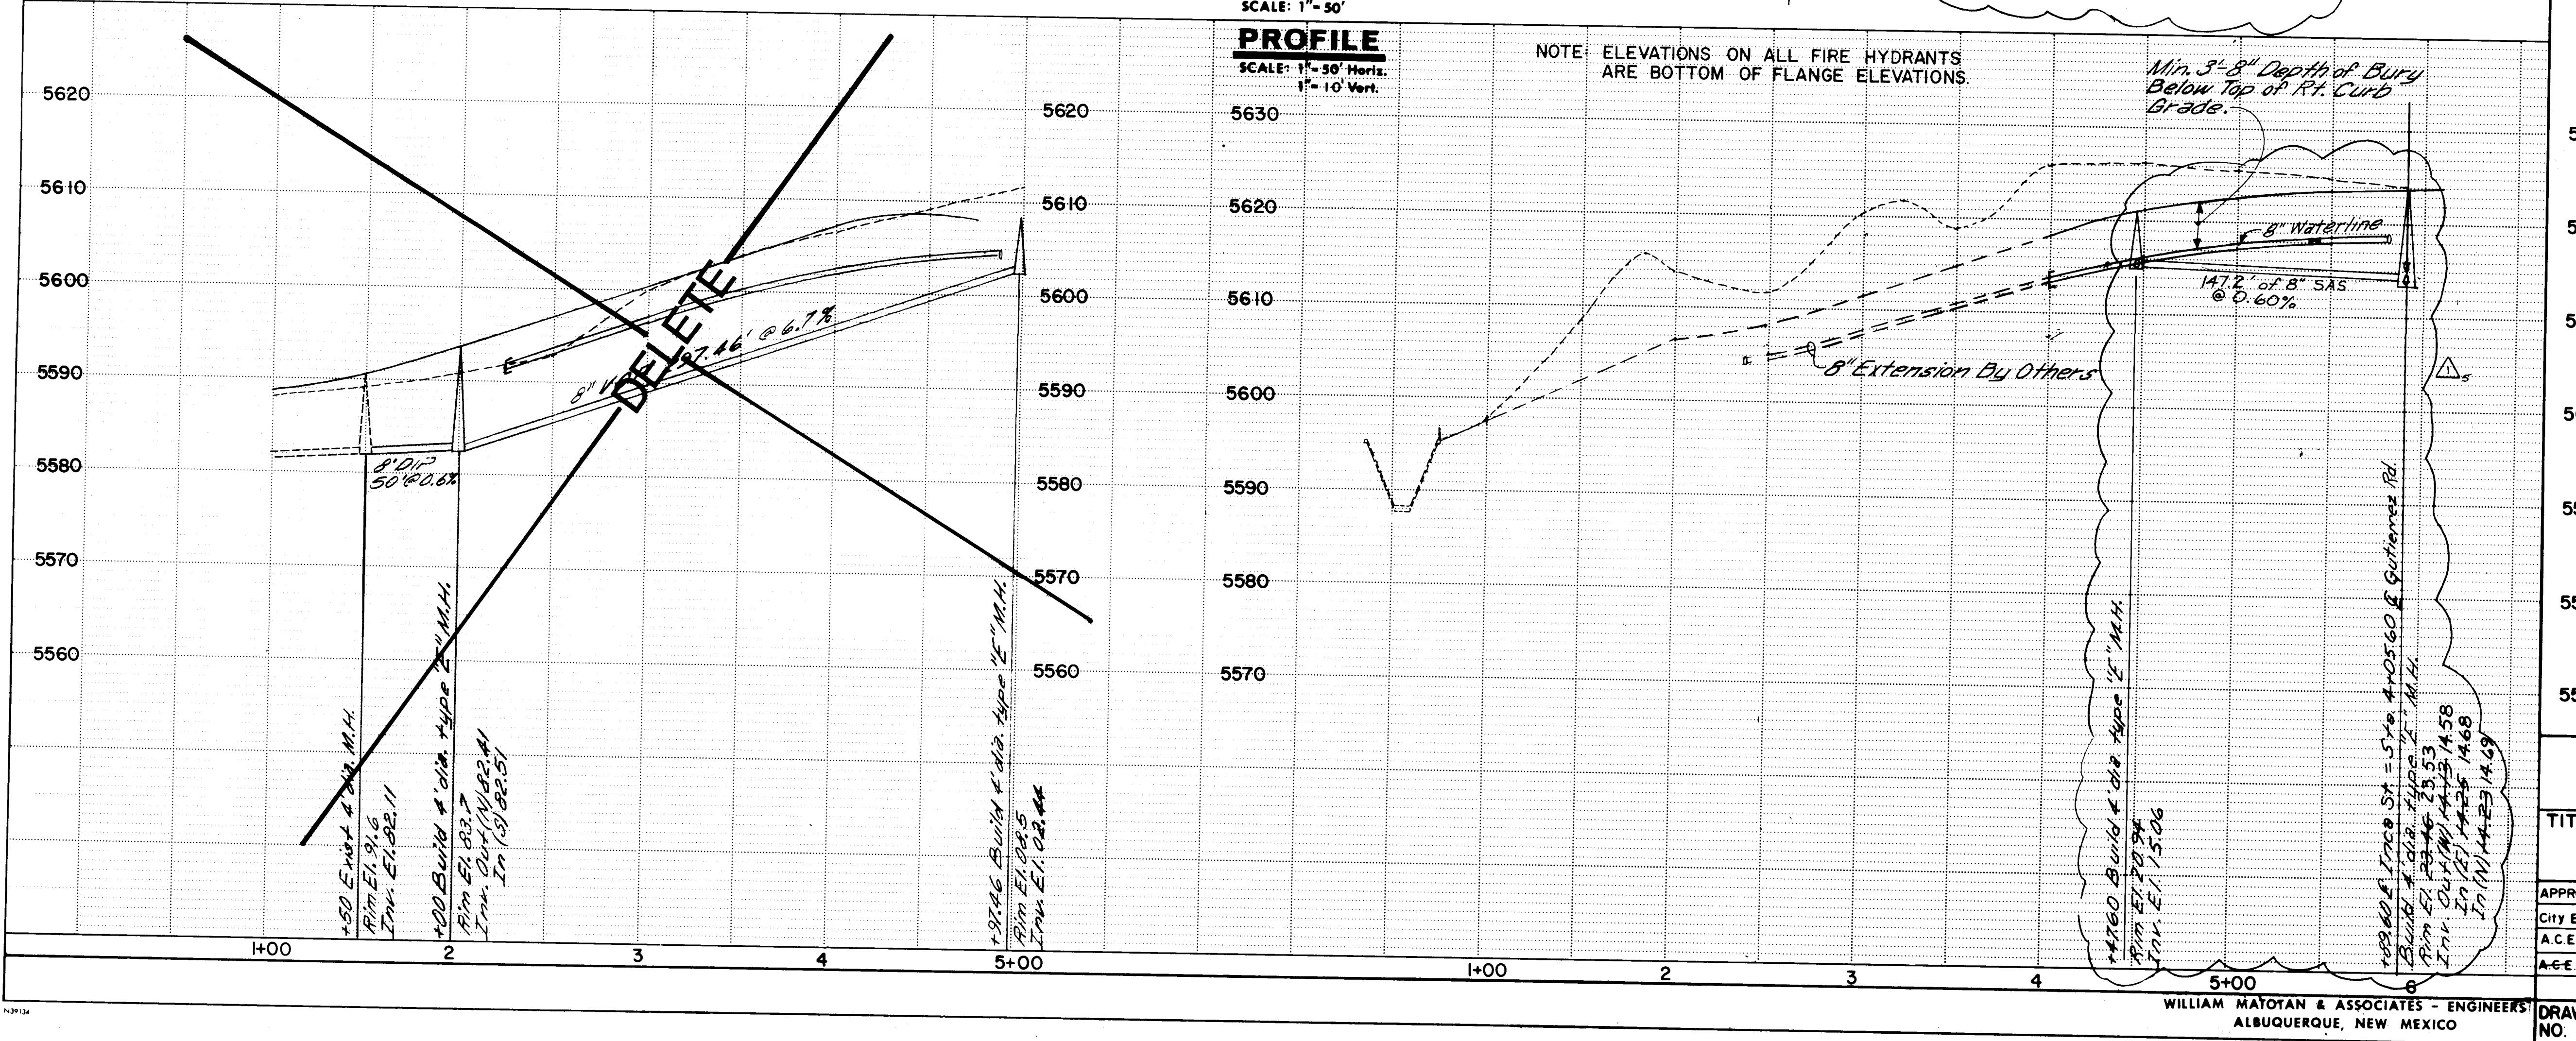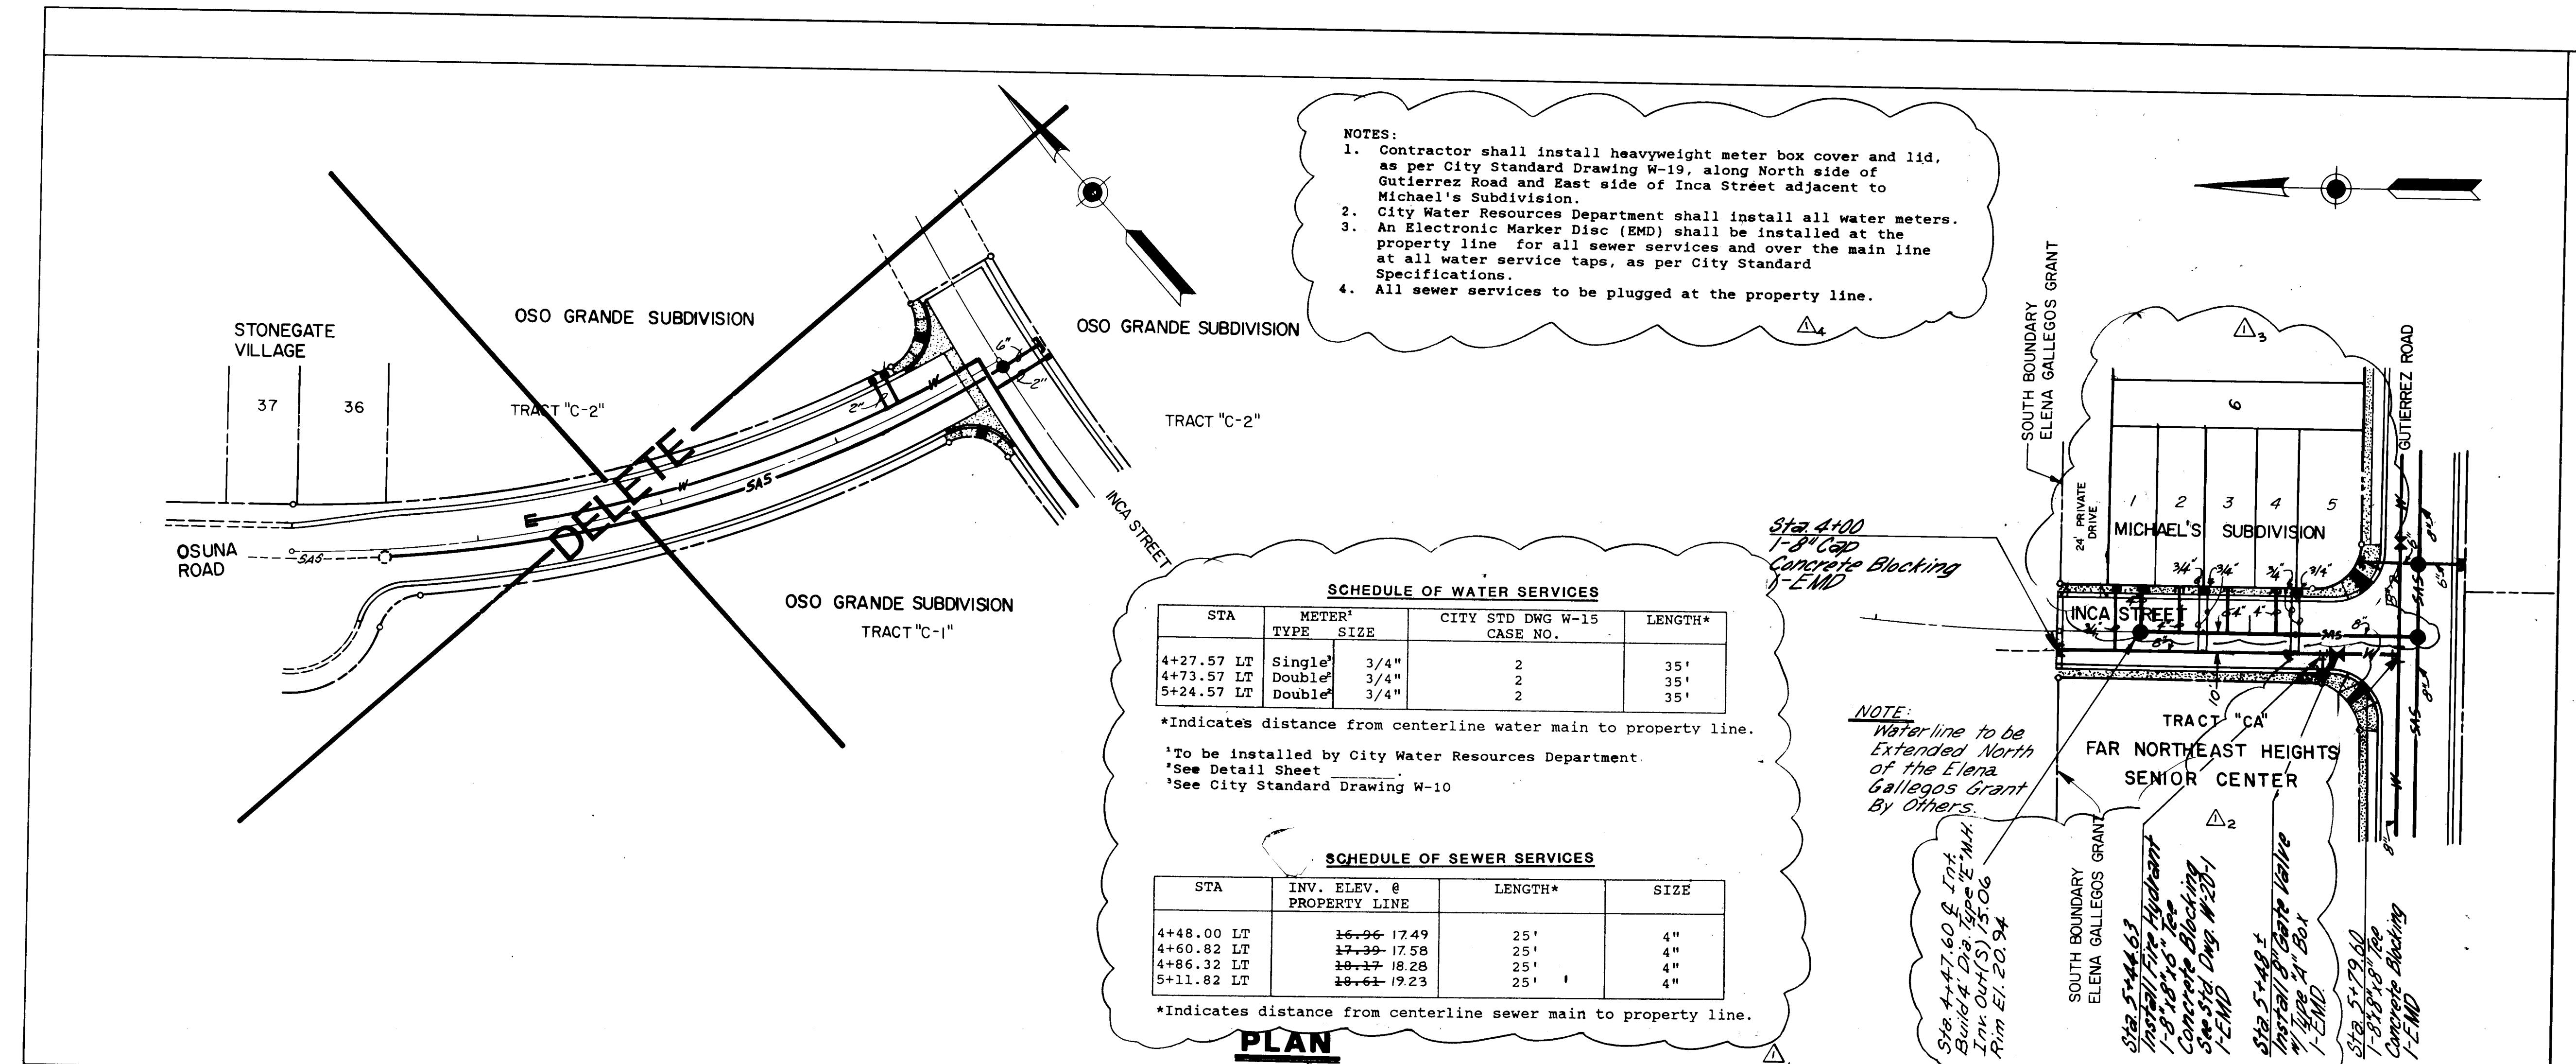

AS BUILT INFORMATION		BENCH MARKS	
CONTRACTOR	KMC INC.	WORK STATED BY	W.M.A.
INSPECTOR'S NAME		ACCURANCE BY	W.M.A.
DRAWINGS BY		VERIFICATION BY	W.M.A.
CORRECTED BY		RECORDED BY	W.M.A.
MICRO-FILM INFORMATION			
DATE			

RECORD DRAWING
Drawings revised to reflect the best information available. Do not use without field verification.

△ 12-23-85 AS-BUILT REVISIONS	W.M.A.
△ 5/8/85 Added Michael's Subdivision added	W.M.A.
▲ 5/8/85 Added 8" Sewer Service - 8" SAS	W.M.A.
▲ 5/8/85 8" SAS - 8" M.H.	W.M.A.
REMARKS	BY
REVISIONS	BY
DESIGN	DATE MARCH 1985
DRAWN BY	W.M.A.
DRAWN BY	W.M.A.
CHECKED BY	W.M.A.

CITY OF ALBUQUERQUE
MUNICIPAL DEVELOPMENT DEPARTMENT
ENGINEERING DIVISION


TITLE: SPECIAL ASSESSMENT DISTRICT 204
OSUNA ROAD & INCA STREET


SANITARY SEWER & WATER

APPROVALS	ENGINEER	DATE	APPROVALS	ENGINEER	DATE
City Engineer	G. Johnson	5/8/85	Liquid Waste	R. Mata	5/8/85
A.C.E.-Design	H. O. Lien	5/8/85	Traffic	N. A. D. W.	5/8/85
A.C.E.-Hydrology	Don Hayes	5/8/85	Water	R. Mata	5/8/85


WILLIAM MATOTAN & ASSOCIATES - ENGINEERS
ALBUQUERQUE, NEW MEXICO

DRAWING NO. 1046 MAP NO. F-21 SHEET OF 36

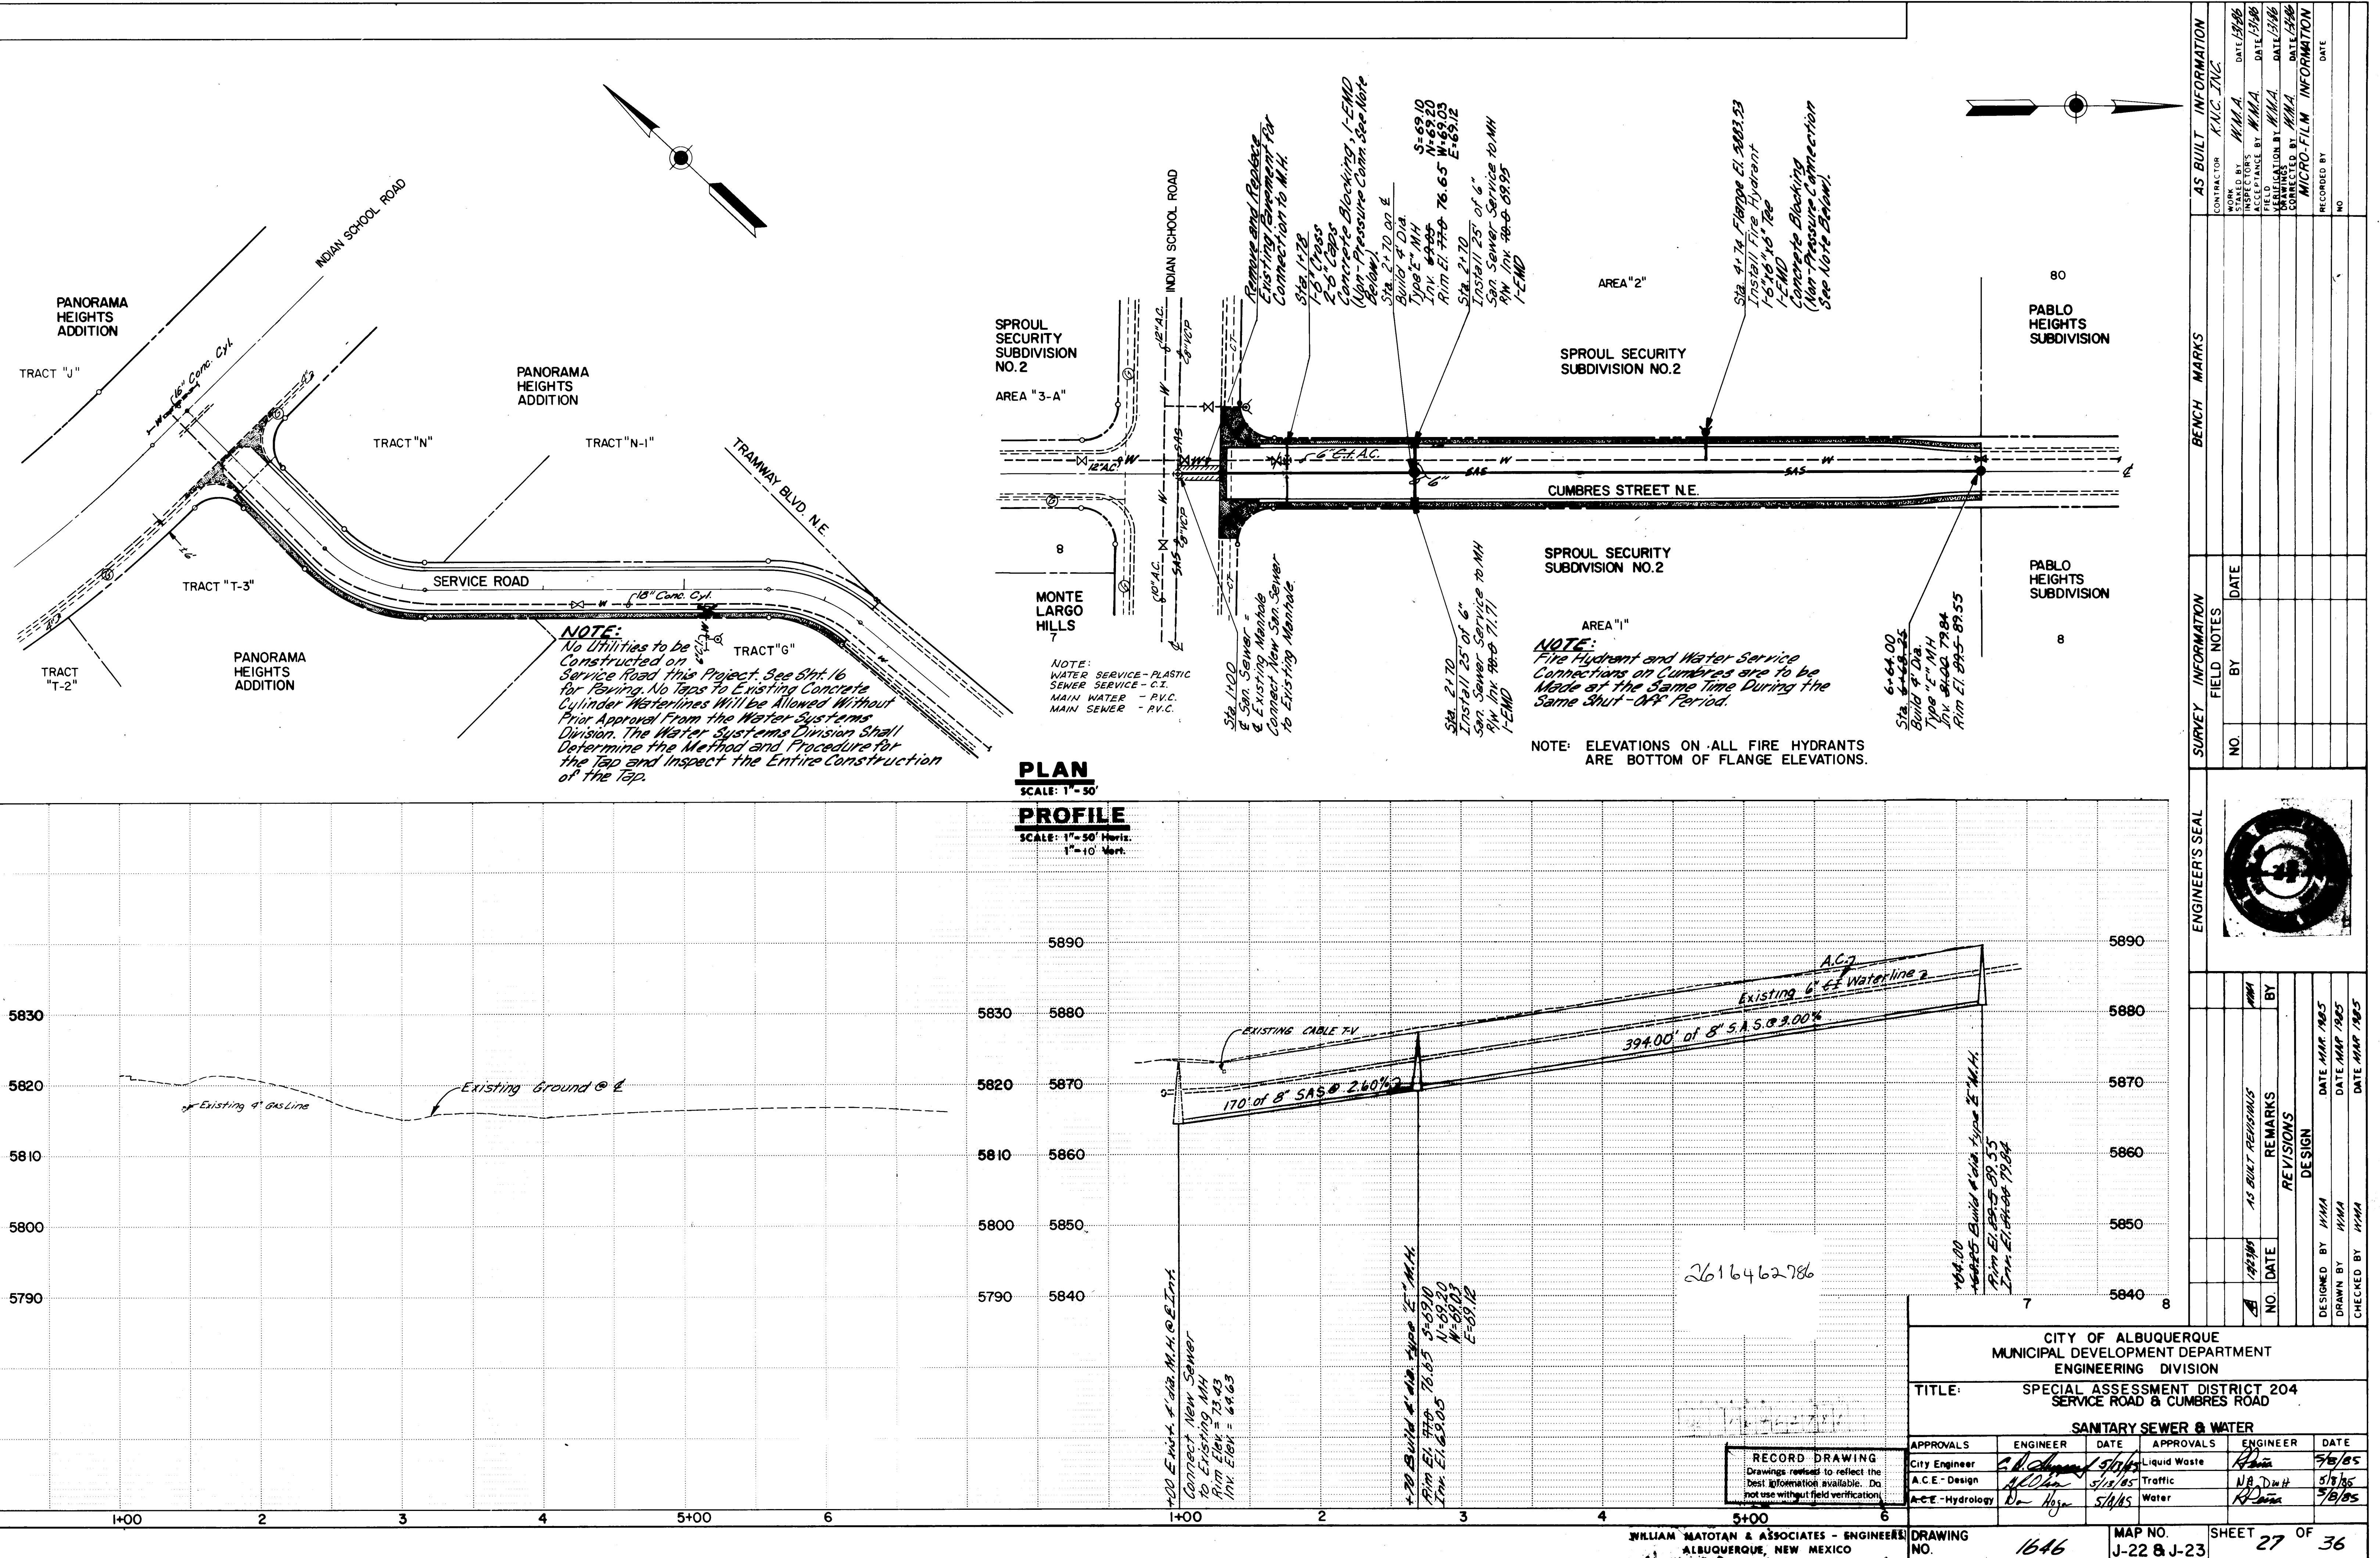

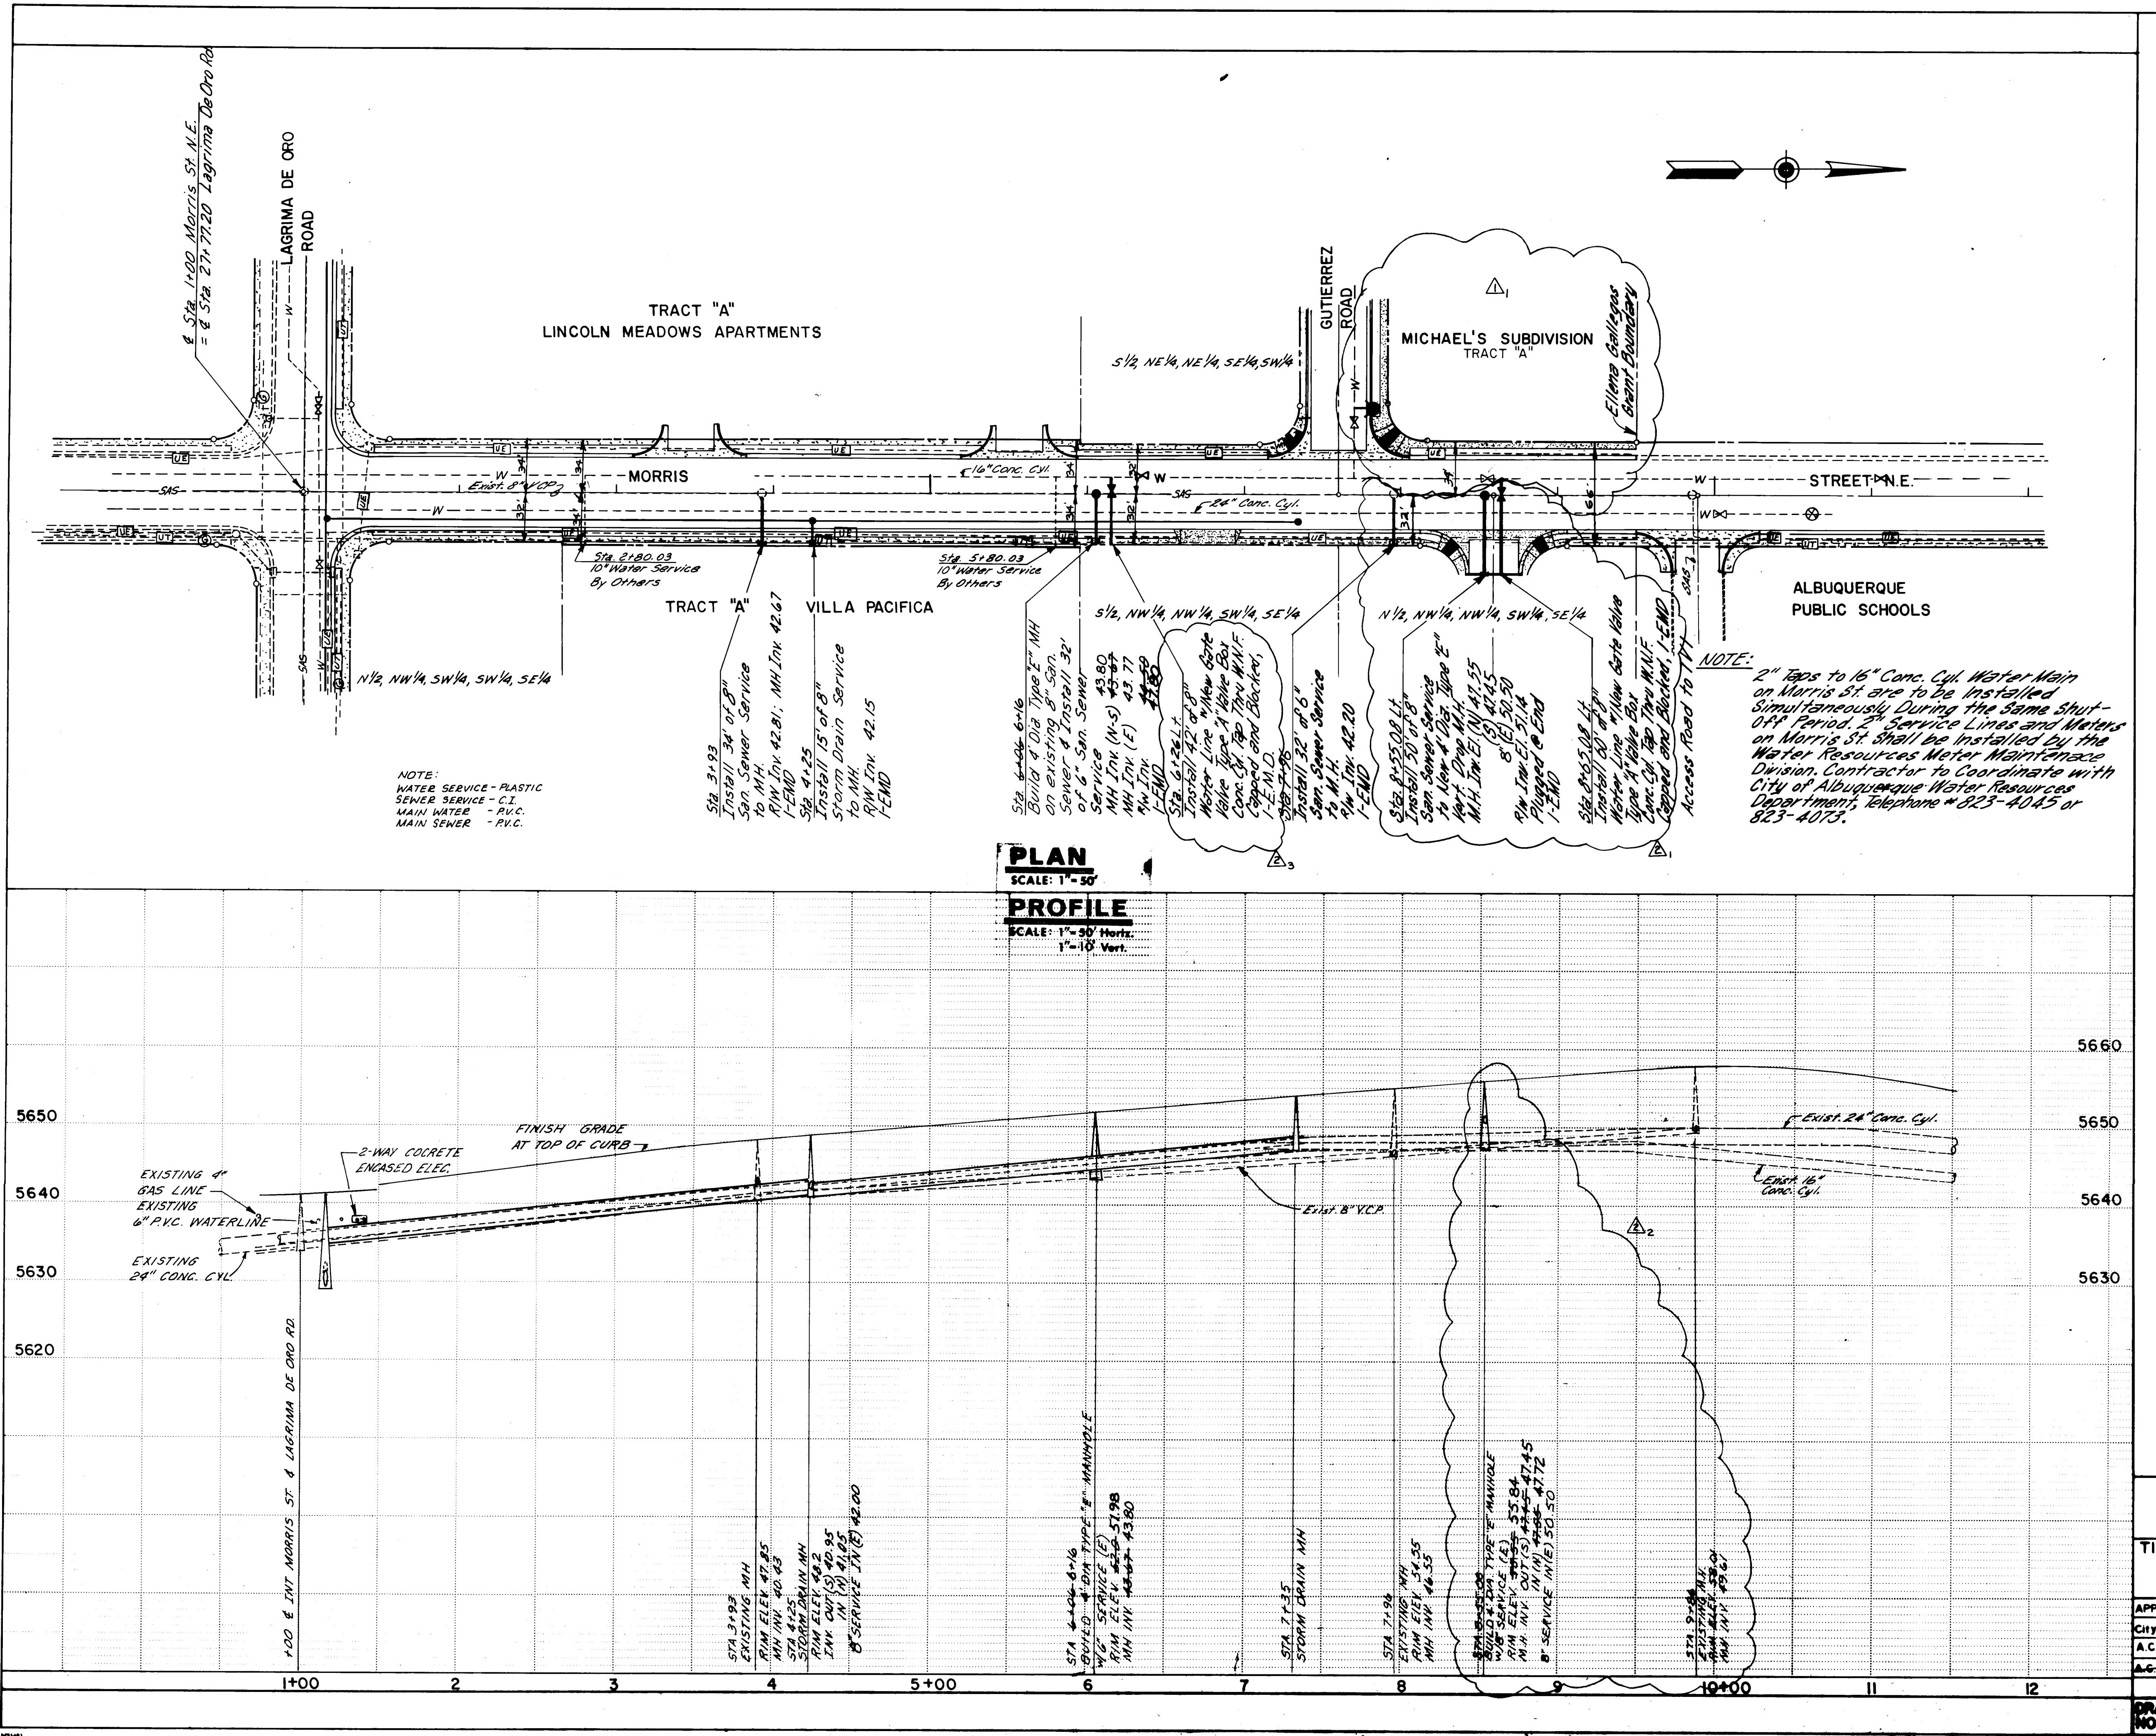

AS BUILT INFORMATION	
CONTRACTOR	KUC, INC.
WORK PERFORMED	1/2/85
INSPECTORS	M.W.A.
ACCEPANCE BY M.W.A.	1/2/85
FIELD SURVEY	1/2/85
DRAWINGS BY M.W.A.	1/2/85
CORRECTED BY M.W.A.	1/2/85
MICRO-FILM INFORMATION	1/2/85
RECORDED BY	NO

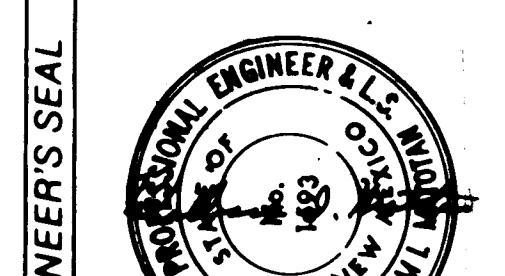

REGISTRATION BOARD
CITY OF ALBUQUERQUE
NEW MEXICO

PROFESSIONAL ENGINEERS & LAND SURVEYORS


NEW MEXICO




LAND SURVEYORS

PROFESSIONAL ENGINEERS



NEW MEXICO

LAND SURVEYORS

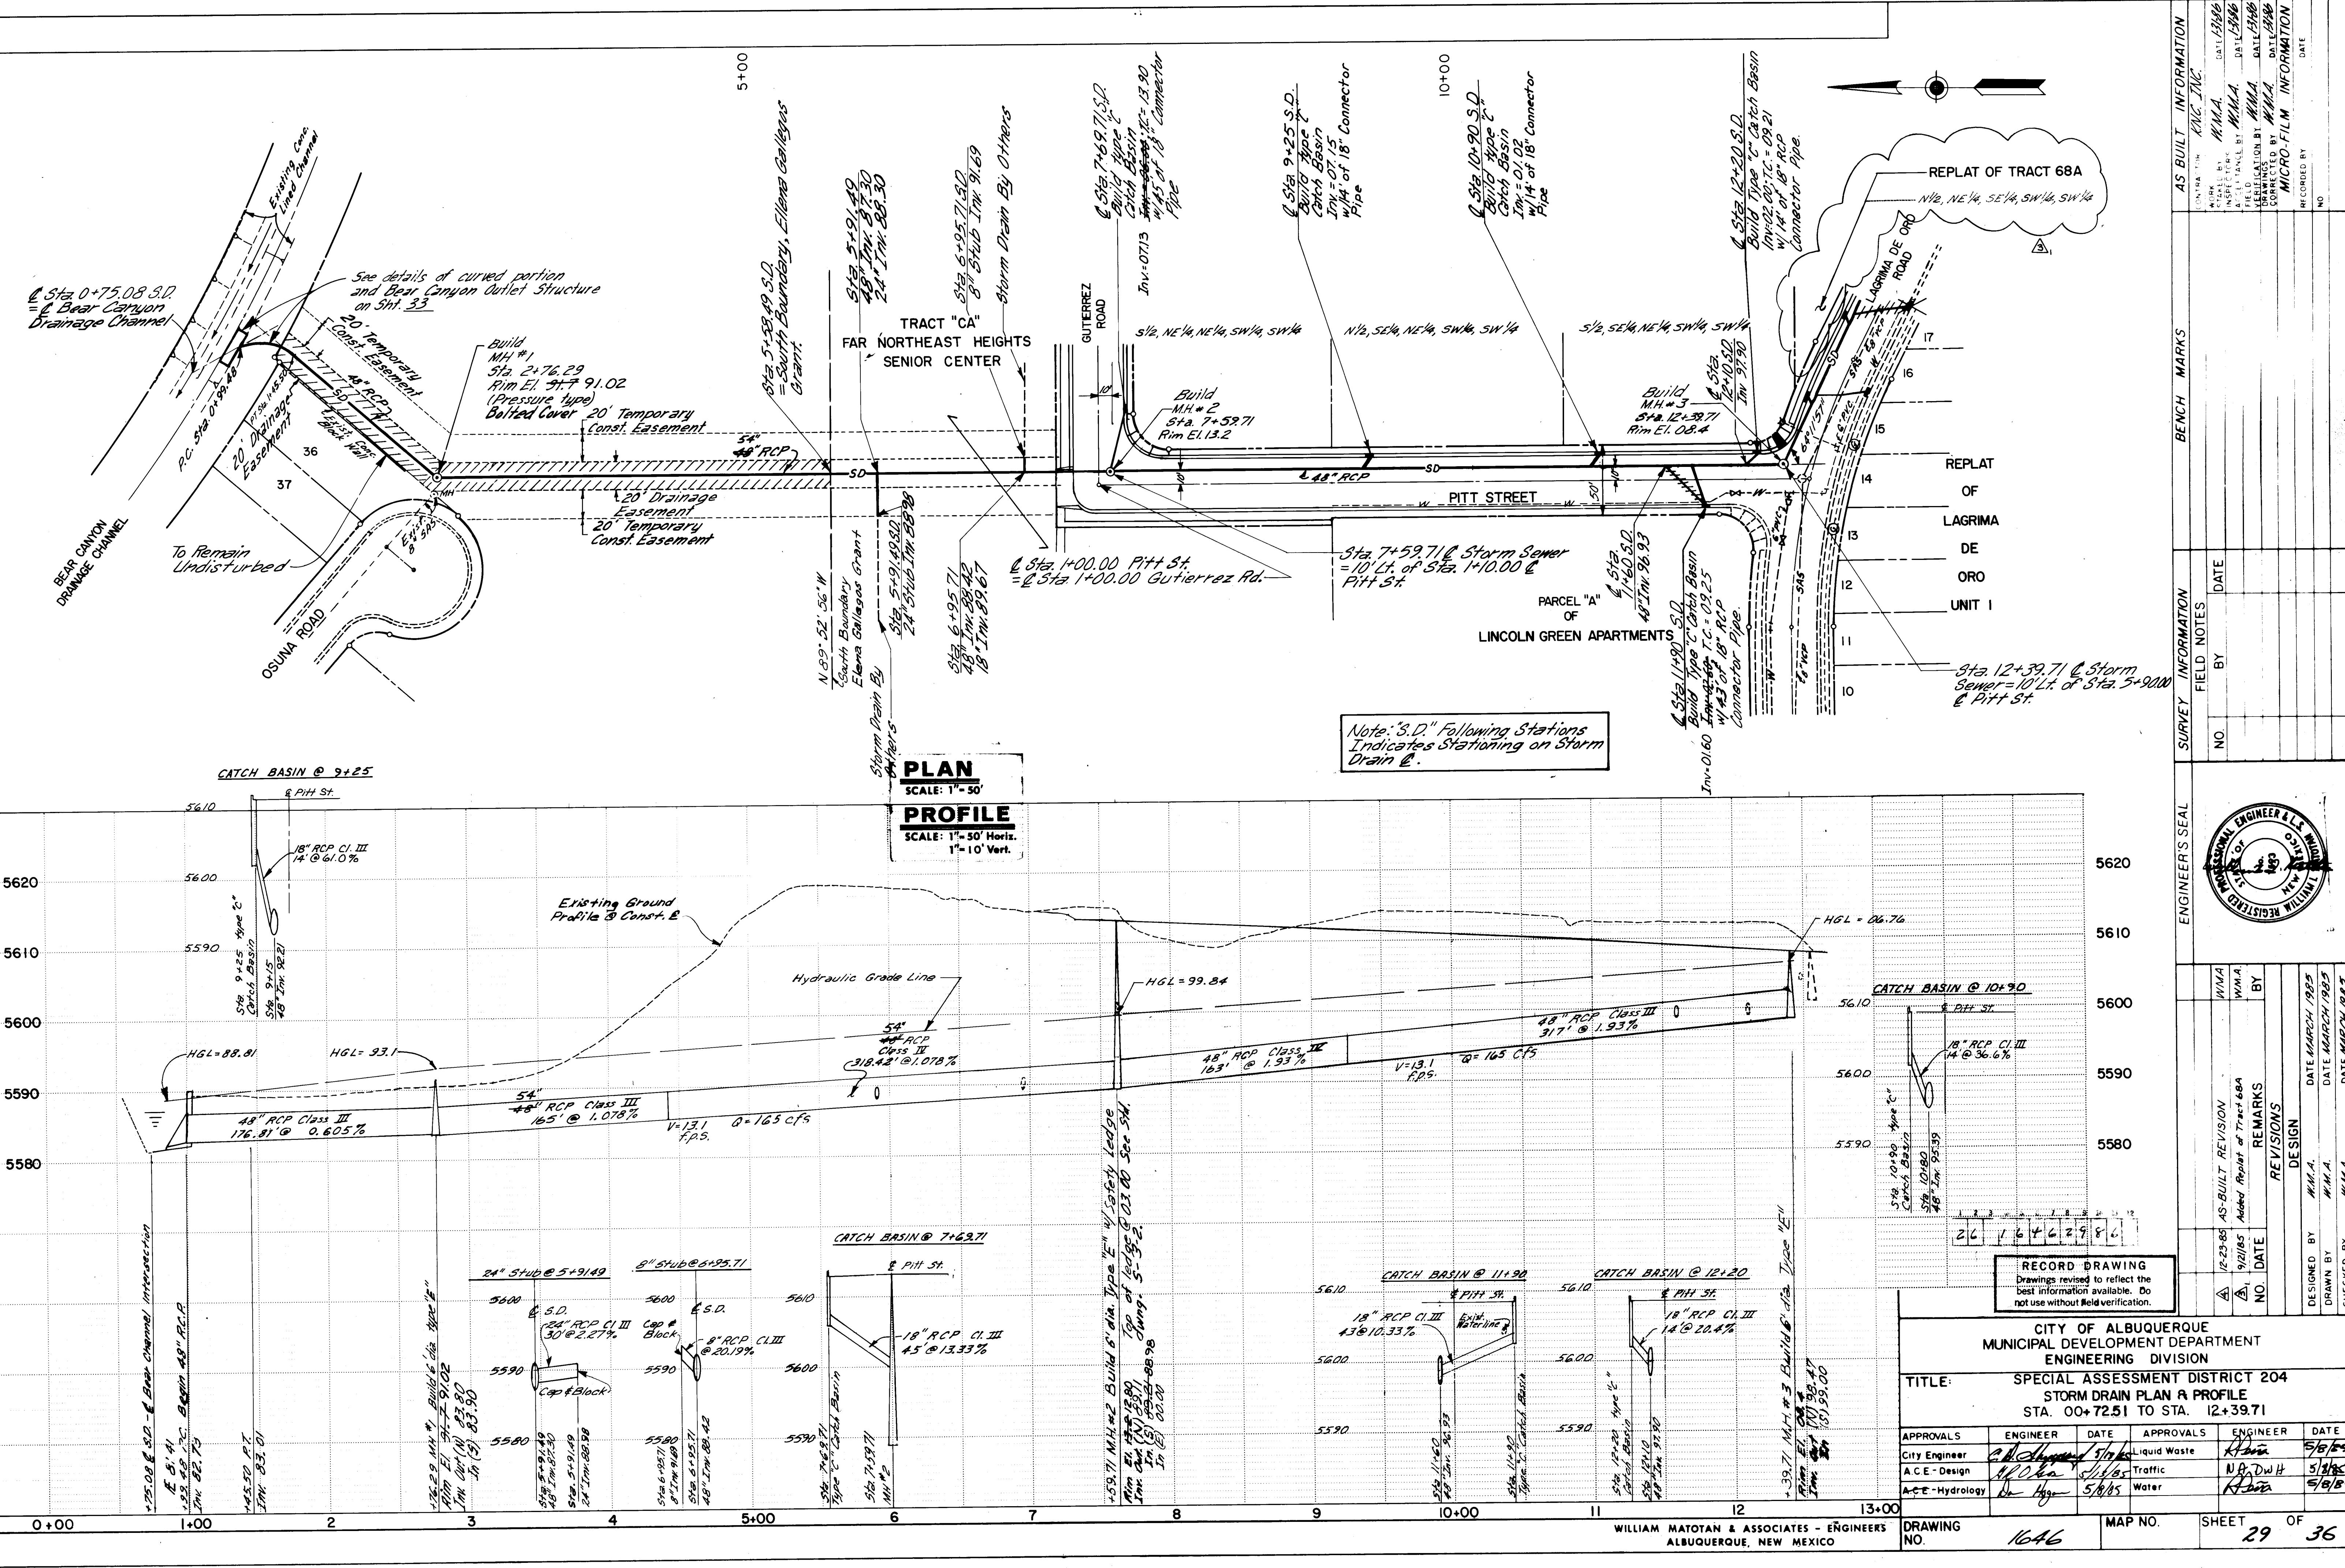

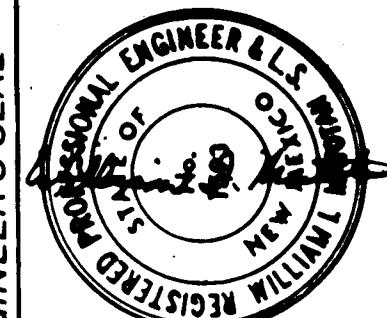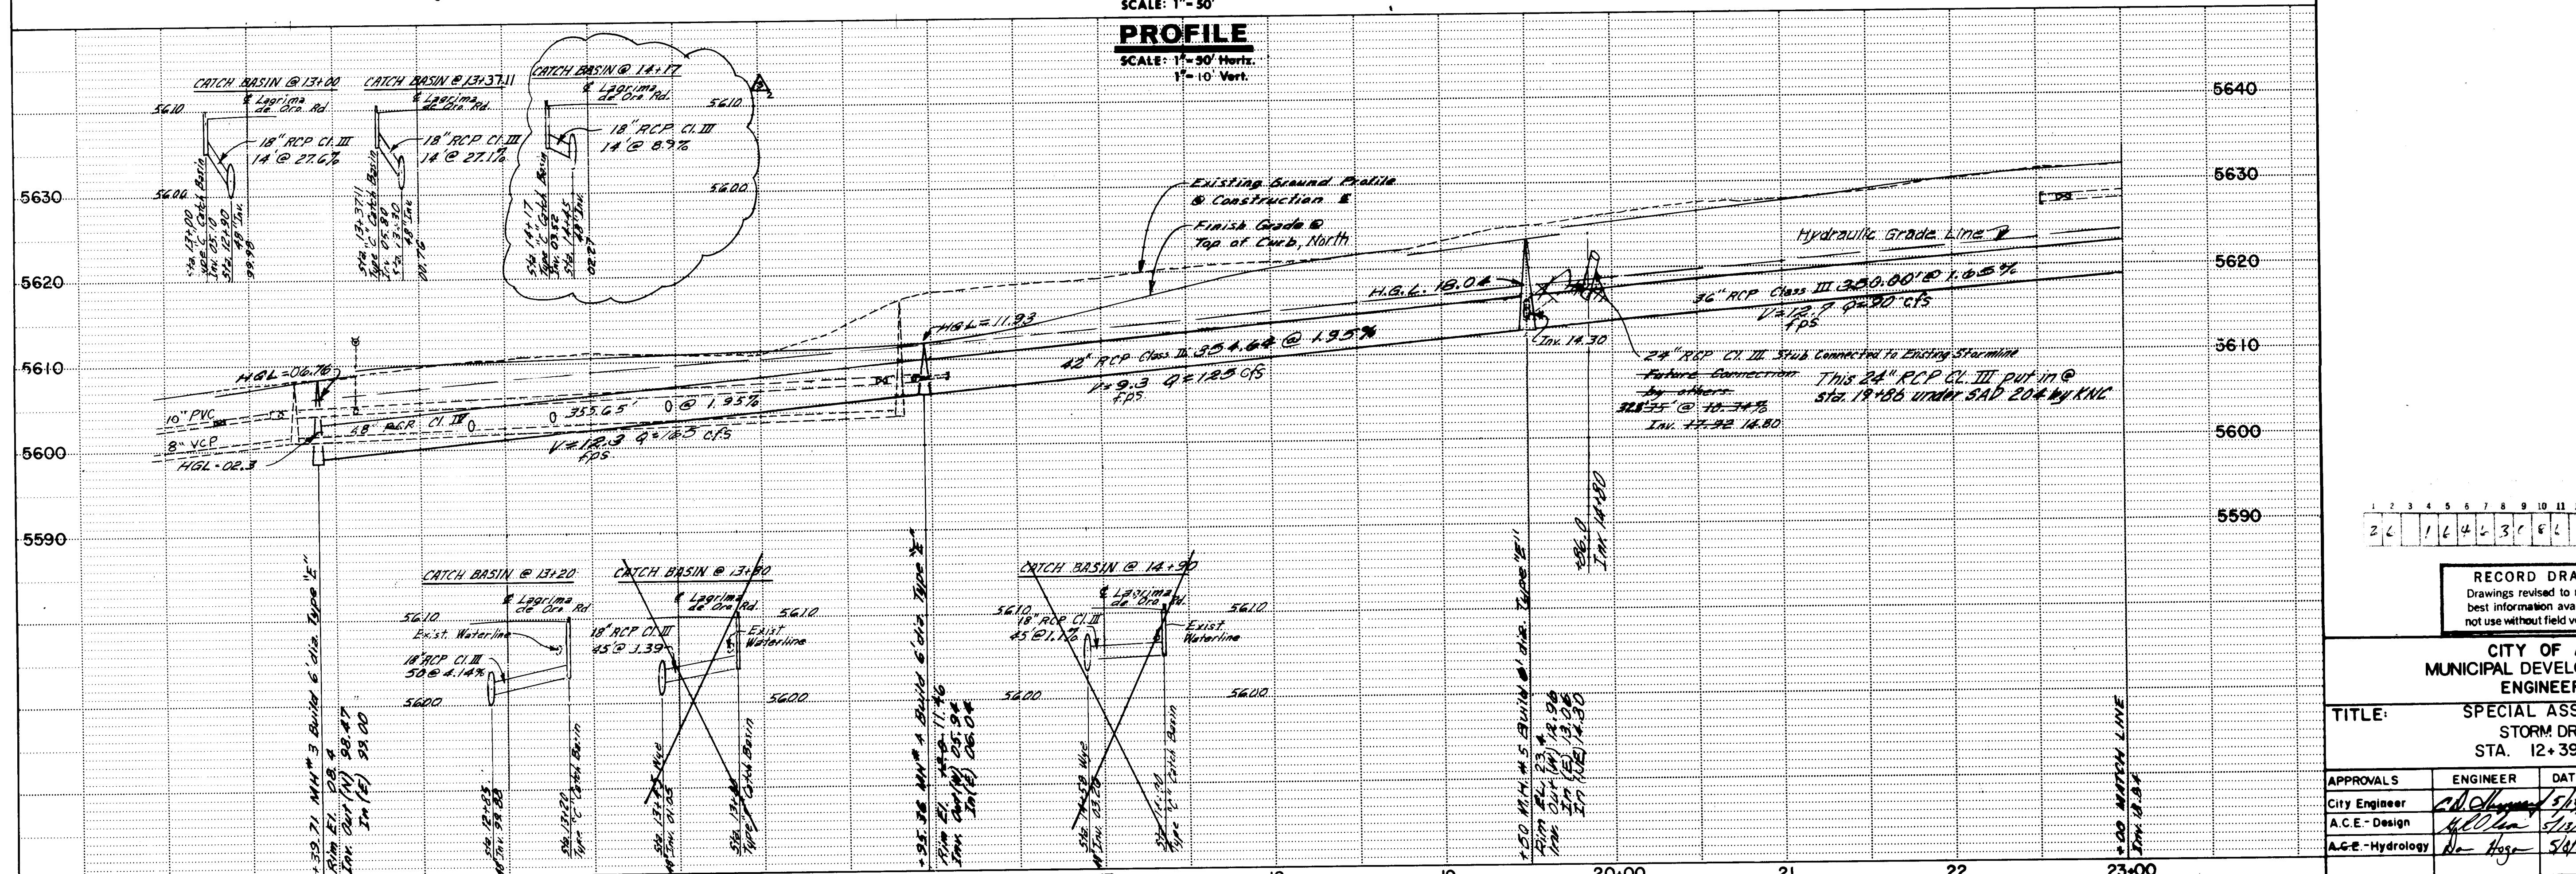
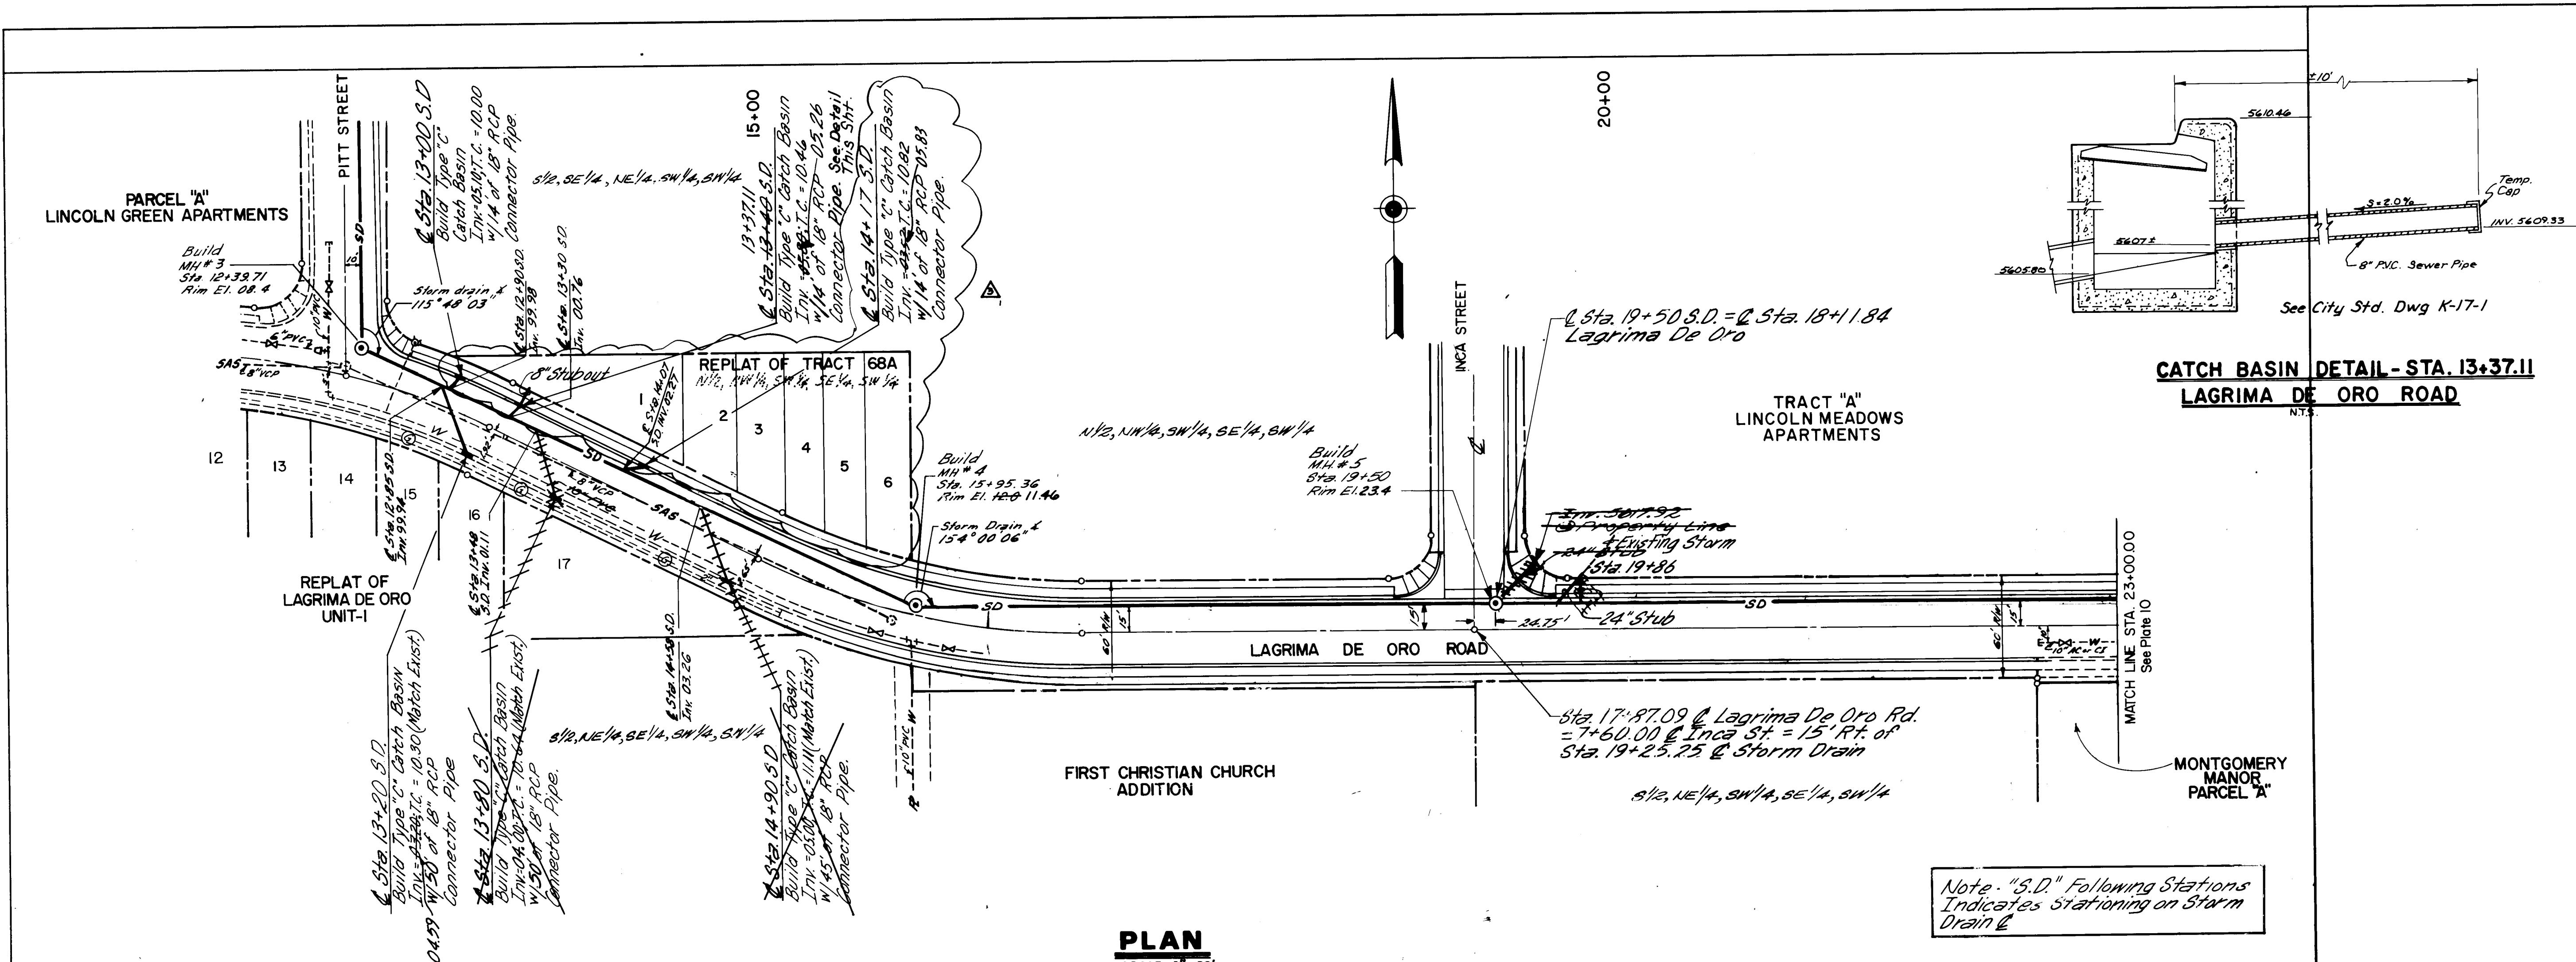


DRAWING reflect the available. DO verification.			12/23	9/2/11	NO. DAT	DESIGNED	DRAWN BY	CHECKED
ALBUQUERQUE OPMENT DEPARTMENT RING DIVISION SESSMENT DISTRICT 204 RAIN PLAN & PROFILE .71 TO STA. 23+00.00								
E	APPROVALS	ENGINEER	DATE					
1/85	Septic Liquid Waste	R. Davis	3/8/05					
1/85	Traffic	N.A. Dow H	3/8/05					
1/85	Water	R. Davis	3/8/05					

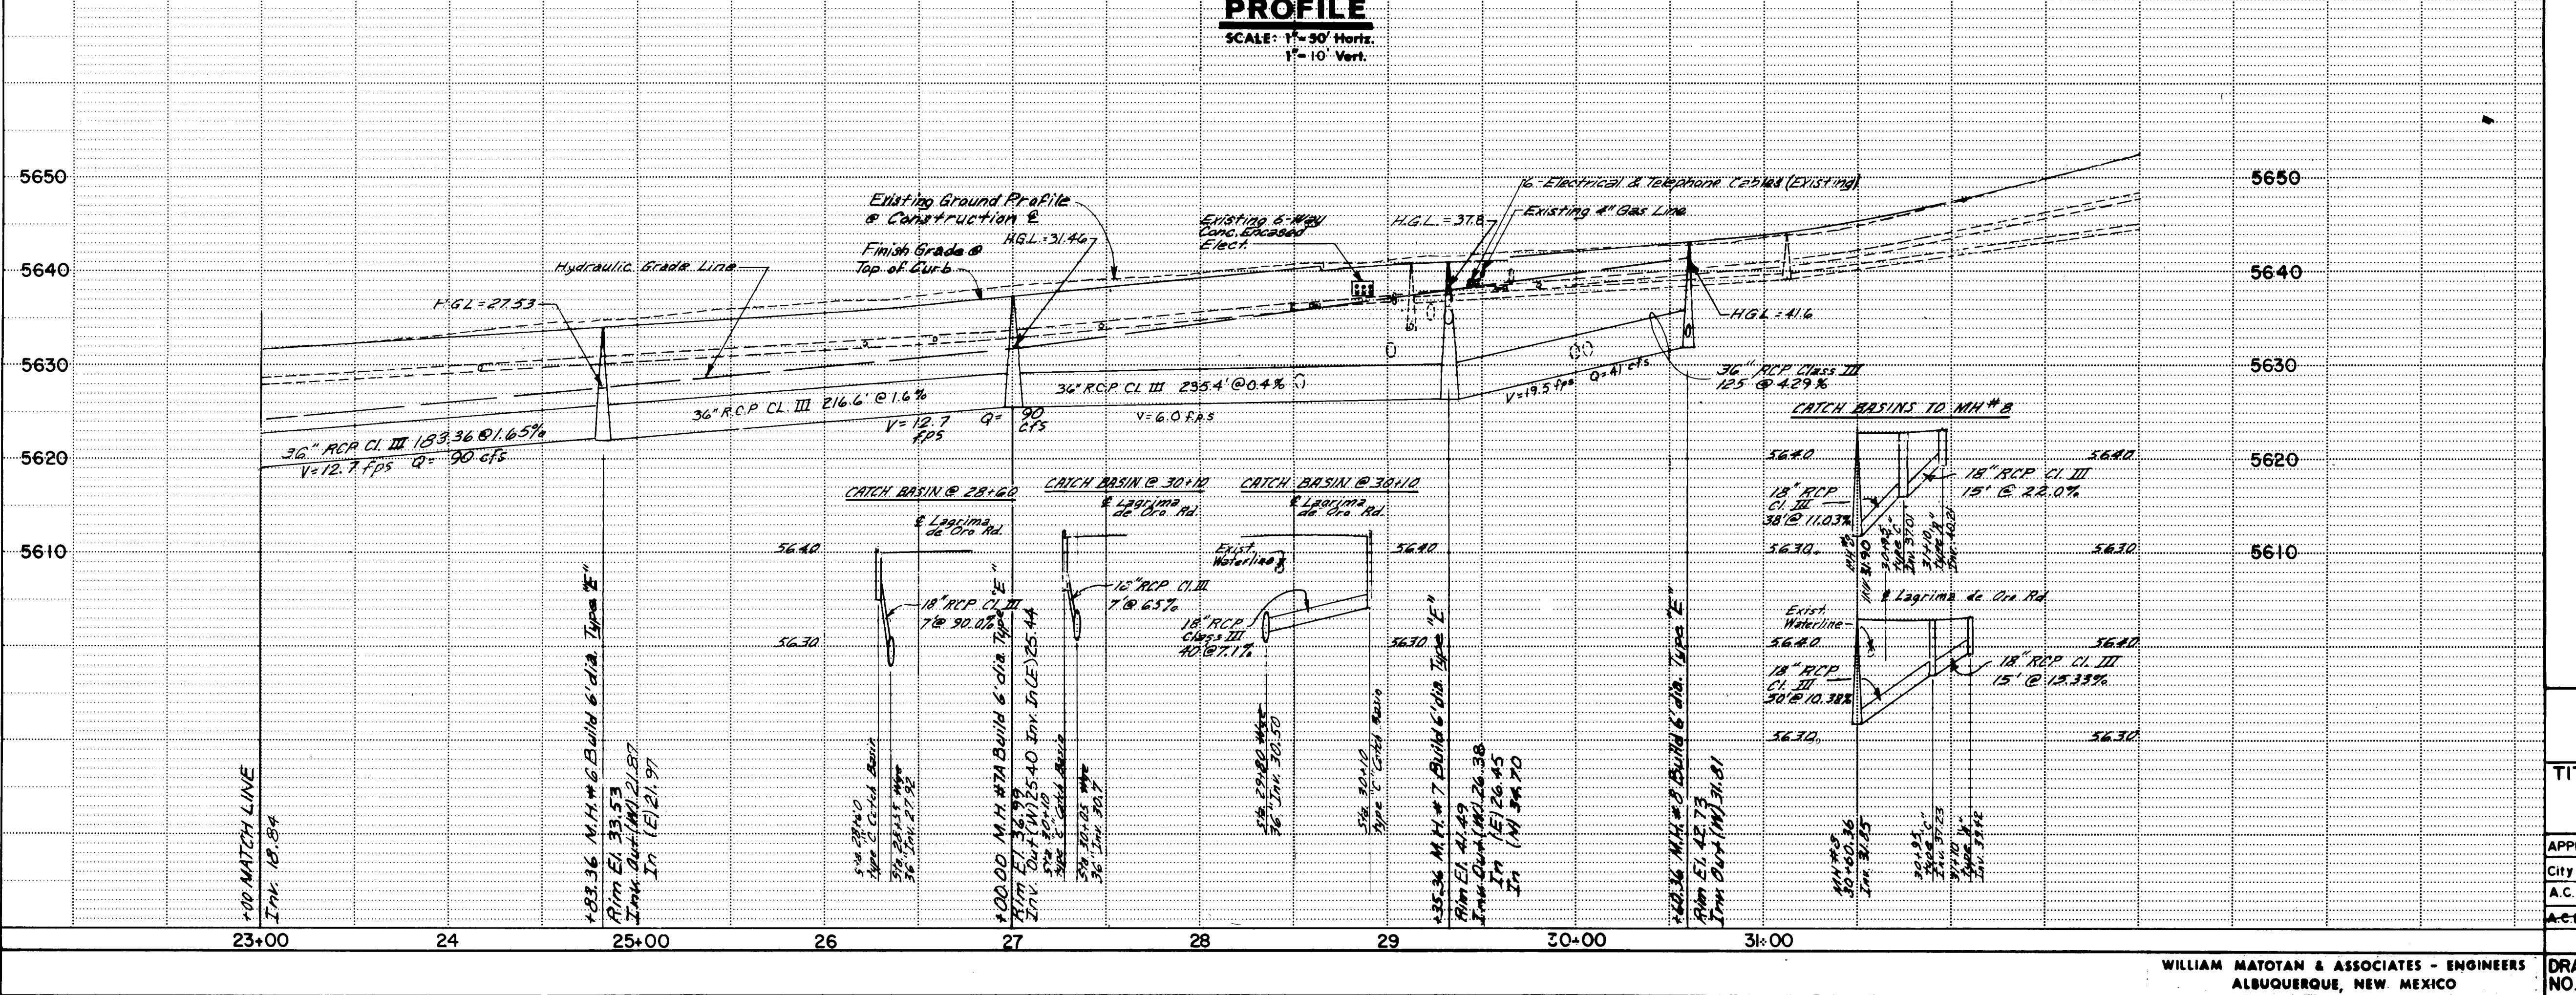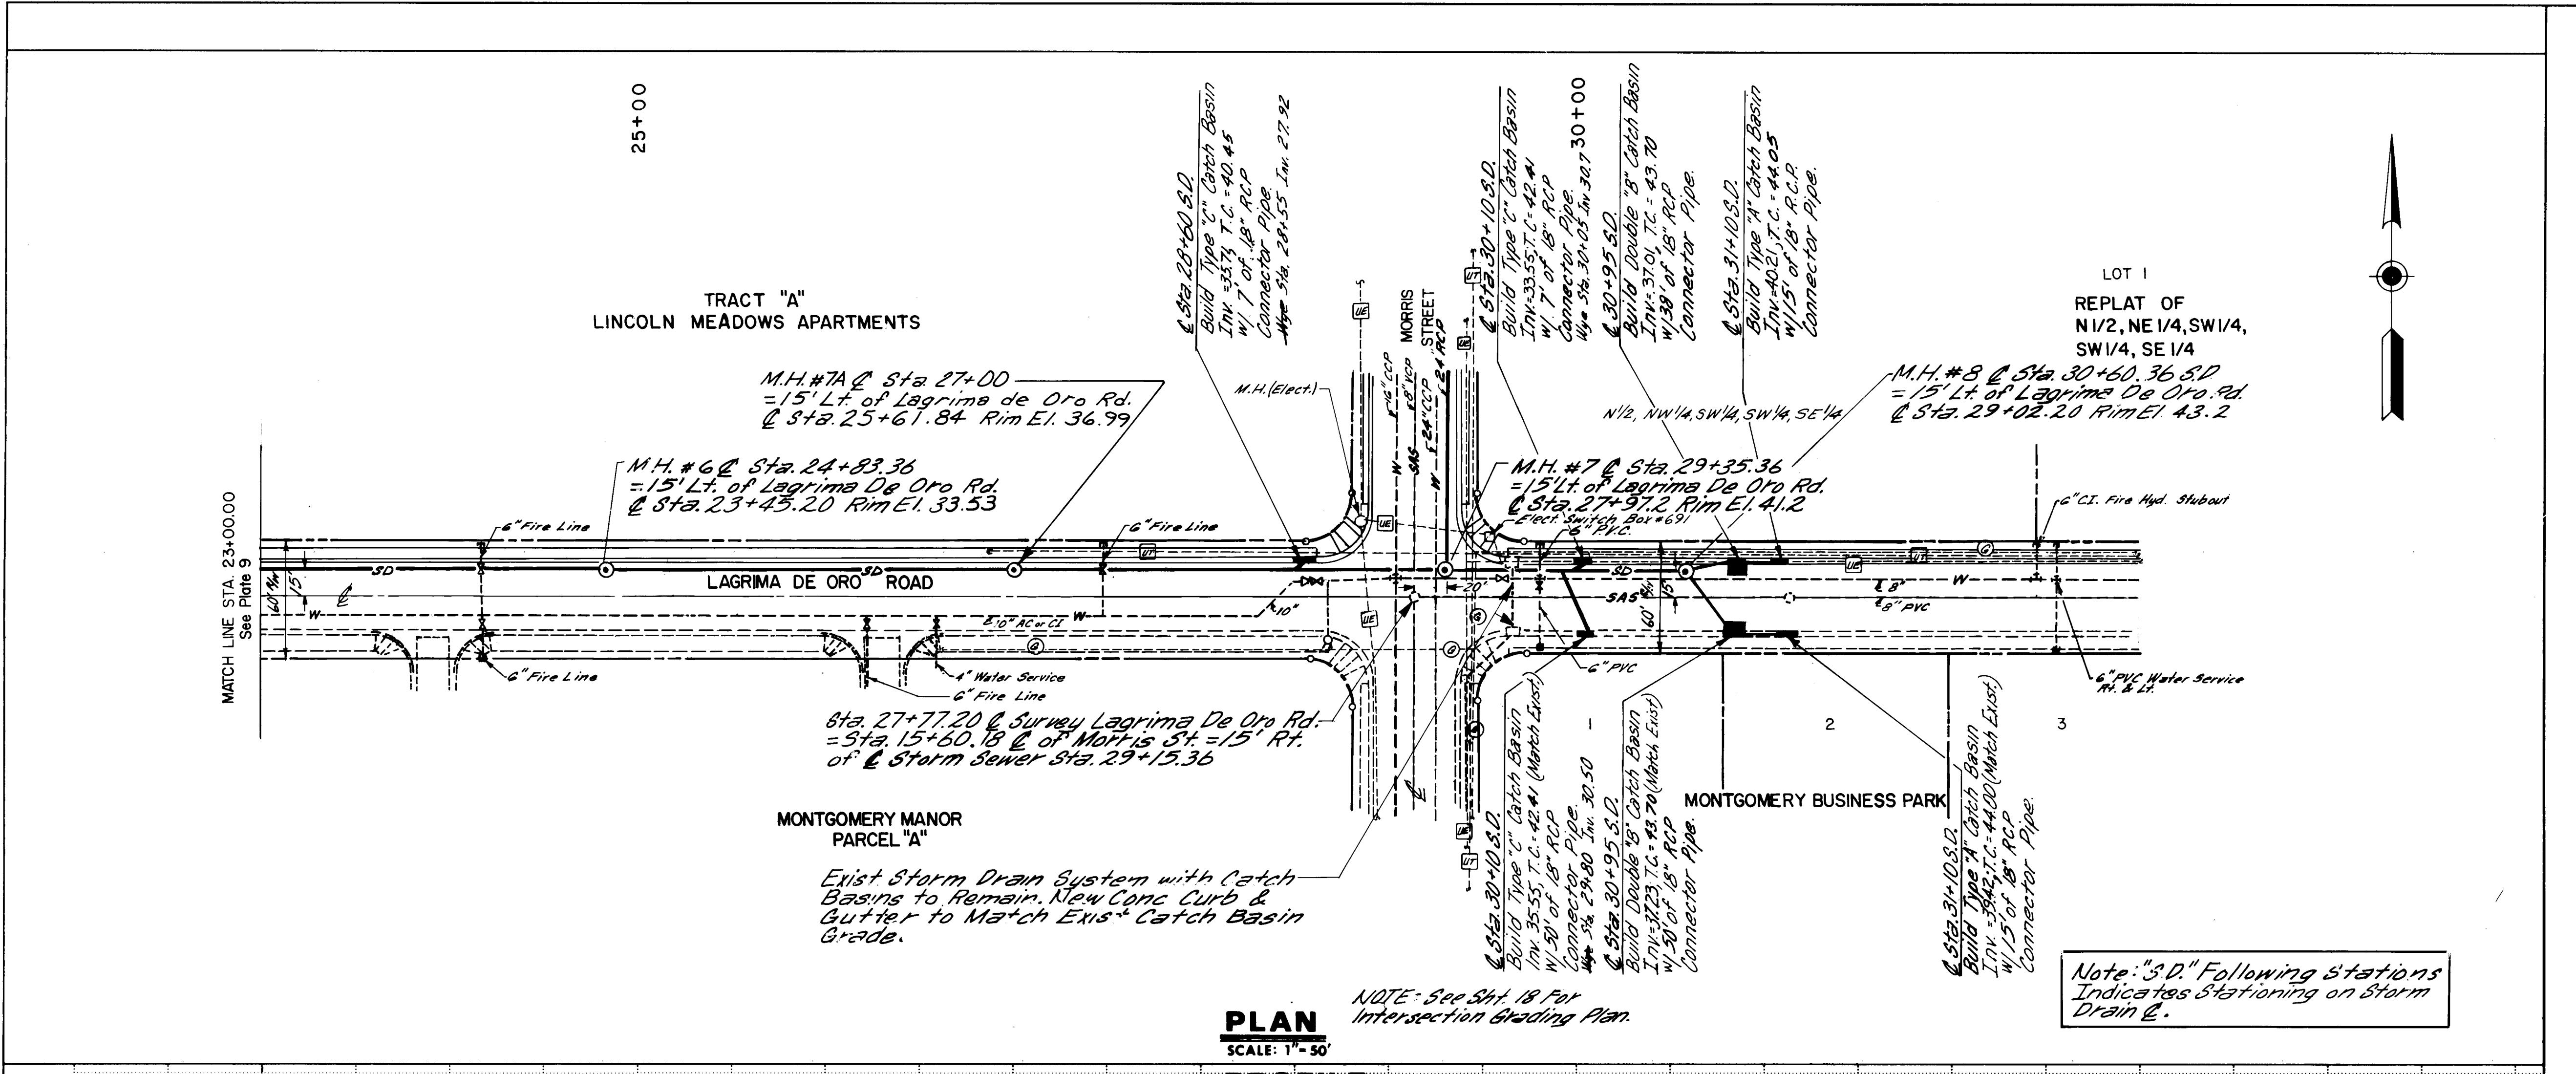



AS BUILT INFORMATION					
CONTRACTOR	KMC, INC.	WORK D. BY	W.M.A.	DATE 5/1/85	INSPECTORS
FIELD		ACCEPTANCE BY	W.M.A.	DATE 5/1/85	
REVISION		REVISION BY	W.M.A.	DATE 5/1/85	
RECORDED BY		MICRO-FILM INFORMATION		DATE	
NO	BY	DATE			

SEAL
FEDERAL ENGINEER & INSPECTOR
NEW MEXICO

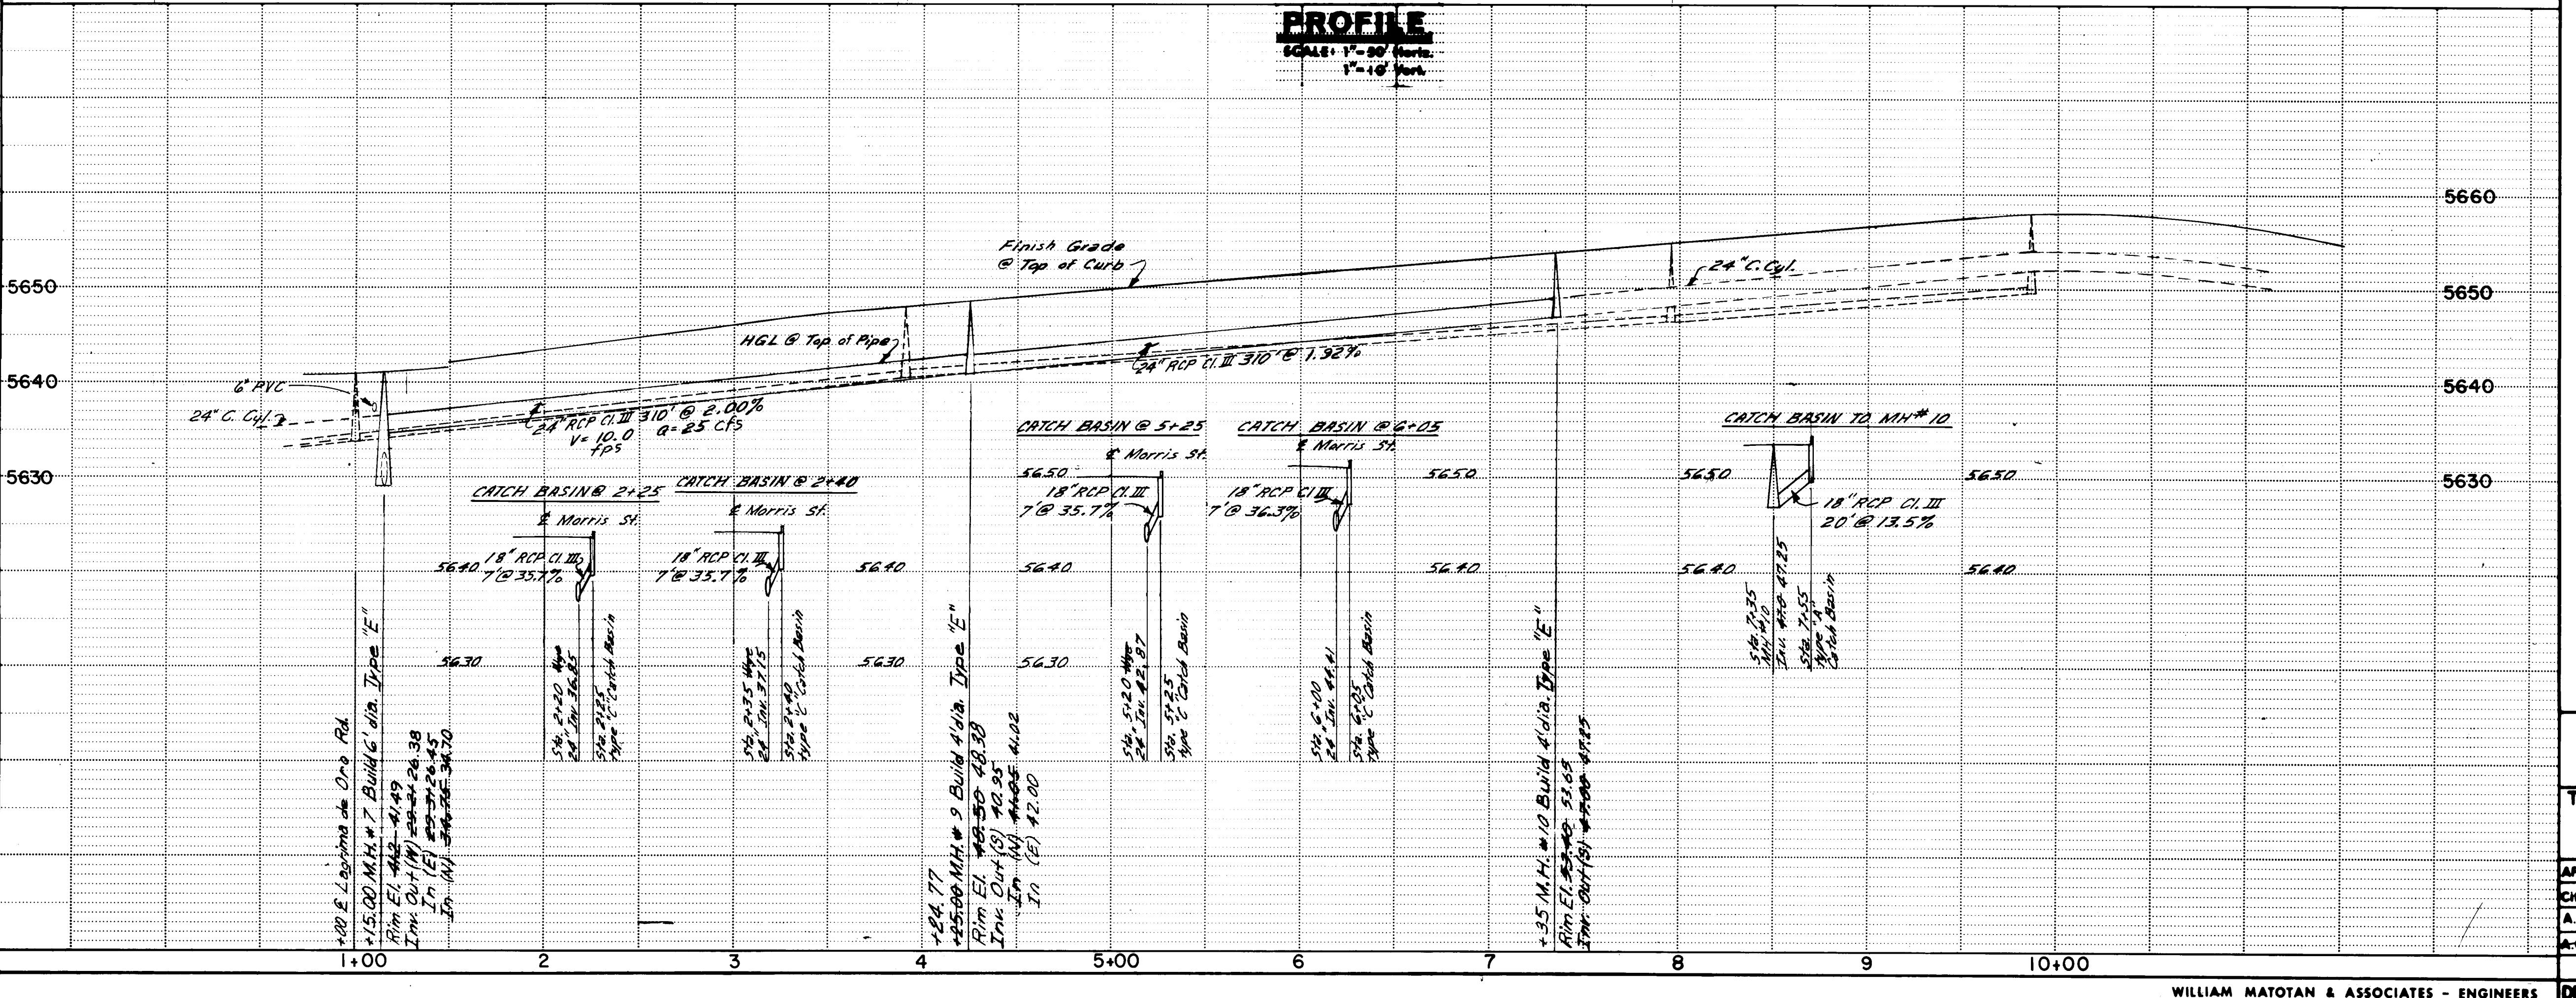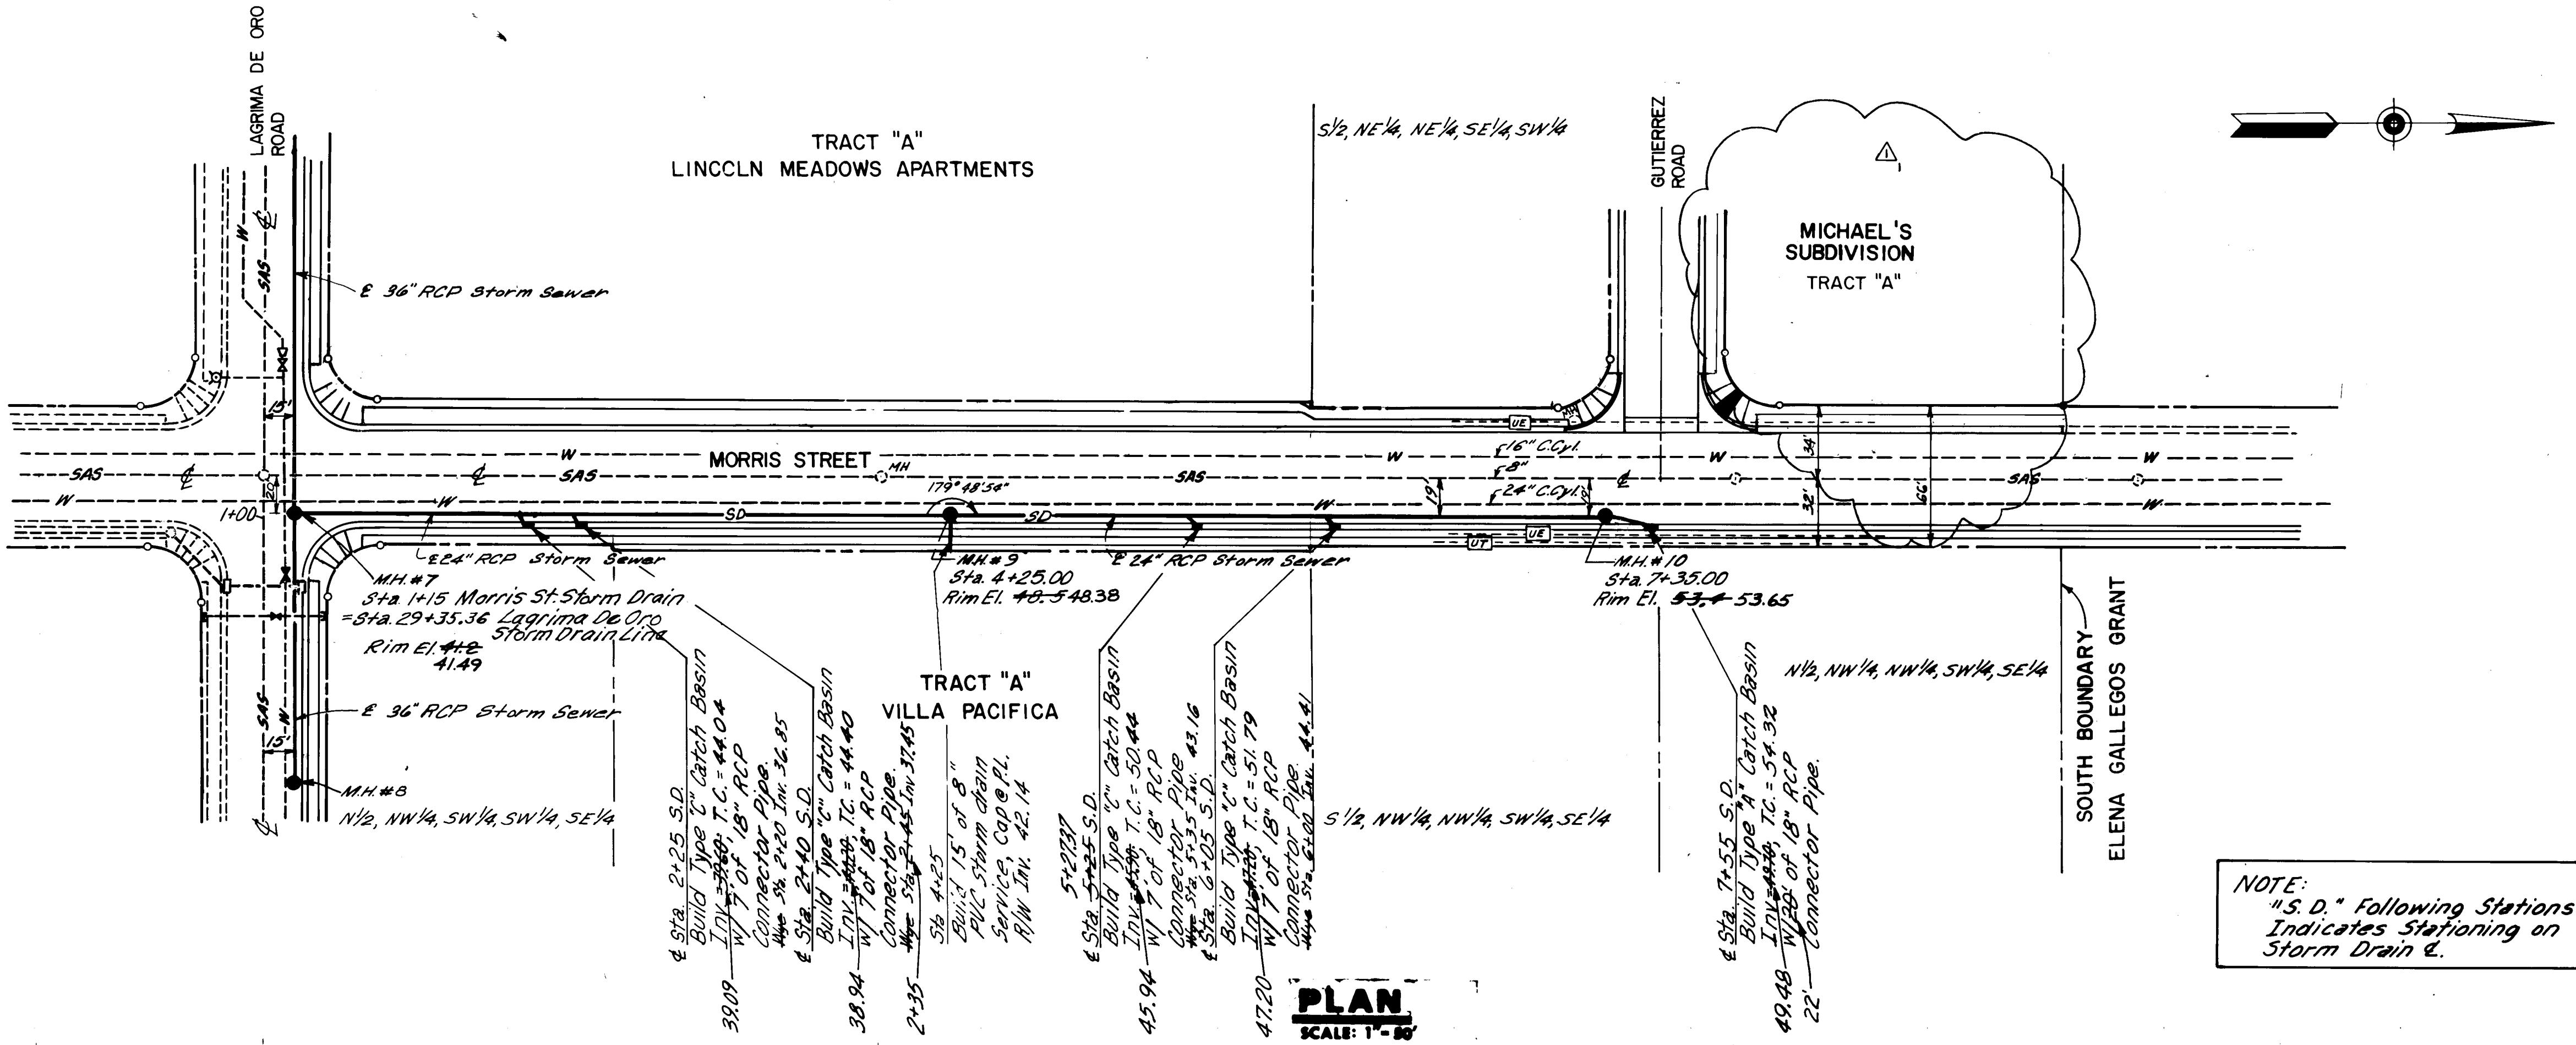

AS BUILT INFORMATION	
CONTRACTOR K.N.C. INC.	DATE 5/6/85
WORK STATED BY MM&A	ACCEPTANCE BY MM&A
INSPECTORS BY MM&A	FIELD VERIFICATION BY MM&A
FIELD WORKS BY MM&A	DATE 5/6/85
MANUFACTURERS BY MM&A	DATE 5/6/85
CONNECTED BY MM&A	DATE 5/6/85
MICRO-FILM INFORMATION	DATE
RECORDED BY NO	DATE

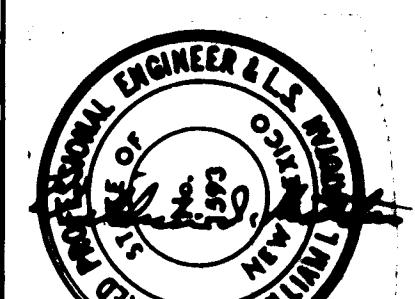

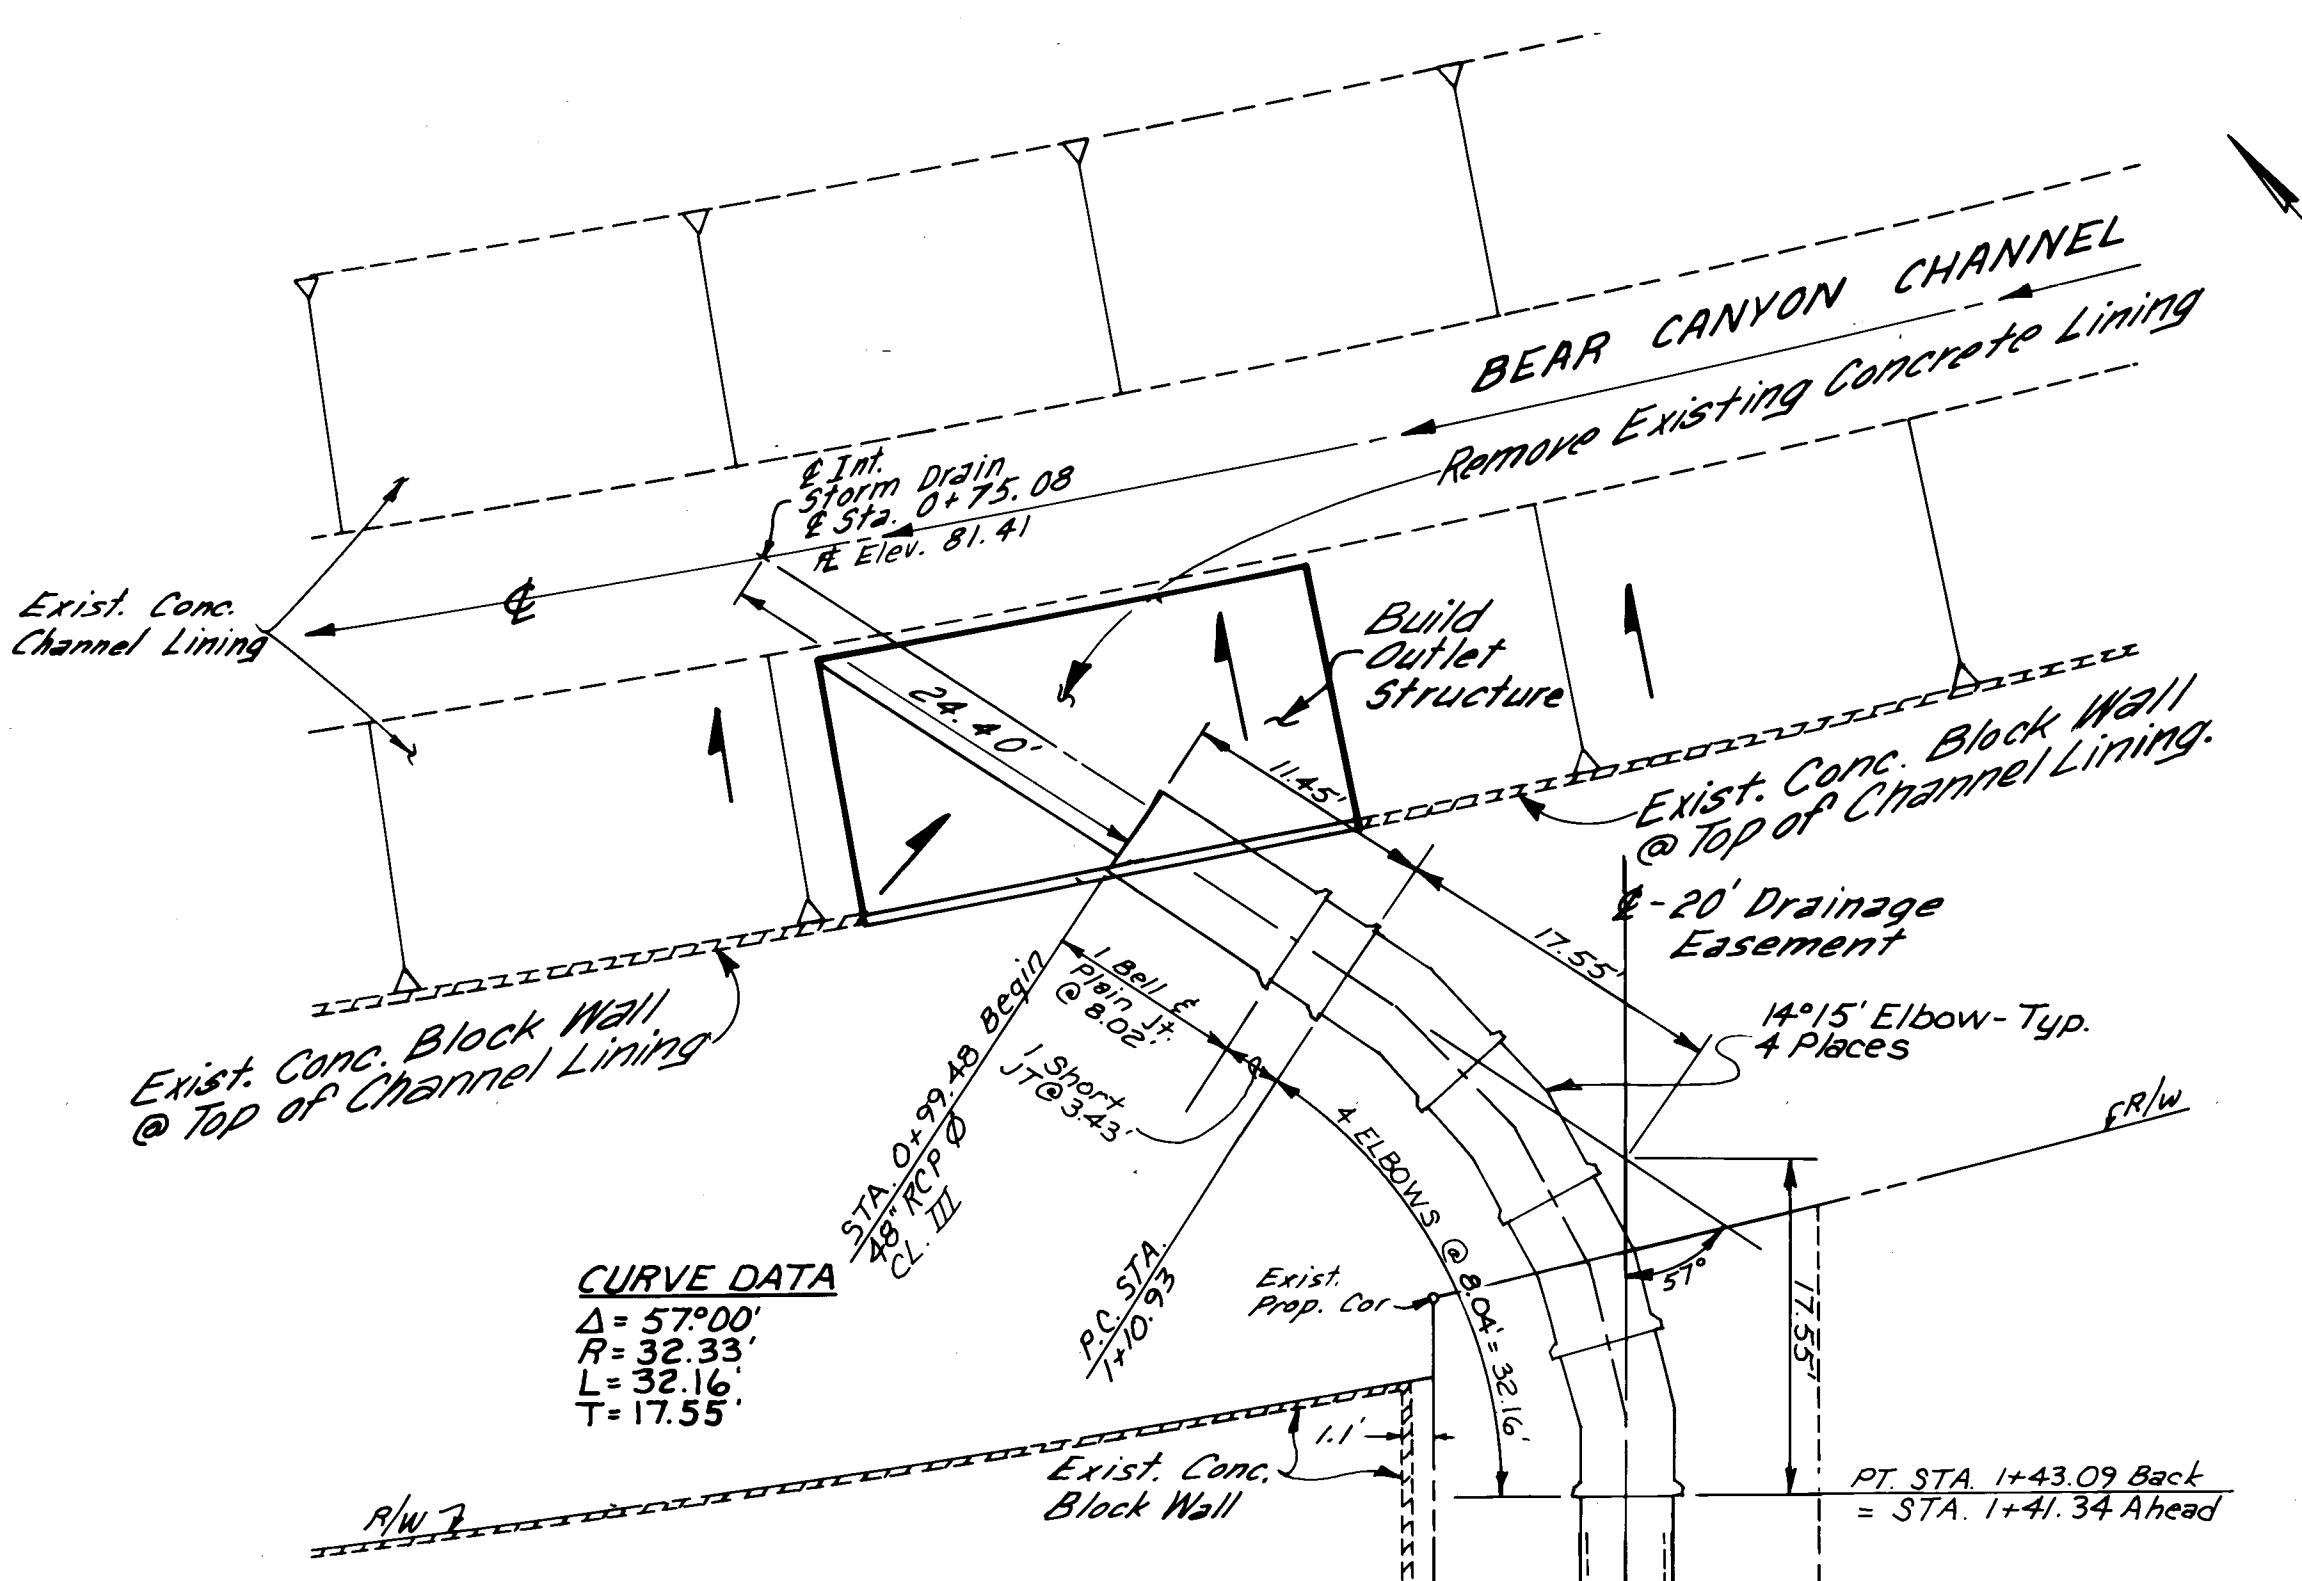

LAYOUT PLAN OF STORM DRAIN

OUTLET TO BEAR CANYON CHANNEL

ESTIMATED QUANTITIES	
Reinf. P.C. Conc. Retaining Wall	4.5 cu.
Fly Ash Concrete Channel Lining	350 sq.ft.
8" Block Wall*	35 sq.ft.
Reinforcing Steel	540 lbs.
Removal & Disposal of Exist. Channel Lining.	10 cu.

BEAR CANYON CHANNEL

26'-0" CHANNEL LINING TO BE REMOVED

81.41 EXIST.

14'6"

13'-6"

4'-0"

8"

7'-10"

5'-0" $\frac{1}{2}$ Bottom Width

81.87 SURVEY

CUT LINE

82.00 TOP OF LINING

D

A

E

E

CUT LINE

TOP OF LINING

4"

S = 0.0471'/ft.

TOE of slope lining

SLOPE

EXISTING CHANNEL LINING

88.6 Match Exist

B

C

CUT LINE

LAP REINF. FROM EXISTING CHANNEL LINING 1'-3" WITH NEW REINF.

82.31

2-#4 x 2¹/₂" TOP ADD'L

82.51

14'-0"

13'-6"

SLOPE

82.31

5'-8"

End of 48" RCP
Sta. 0+99.48
Inv. 82.73

2'-6"

82.31

89.2 Match Exist

F

F

NOTE: ELEVATIONS SHOWN ARE FINISHED CONC. SURFACE.


Remove existing and build new concrete block wall.

1/2" PLASTAZOTE & CALKING IN BLOCK WALL


48" R.C.P.

PLAN OF OUTLET STRUCTURE


3/8" = 1'-0"

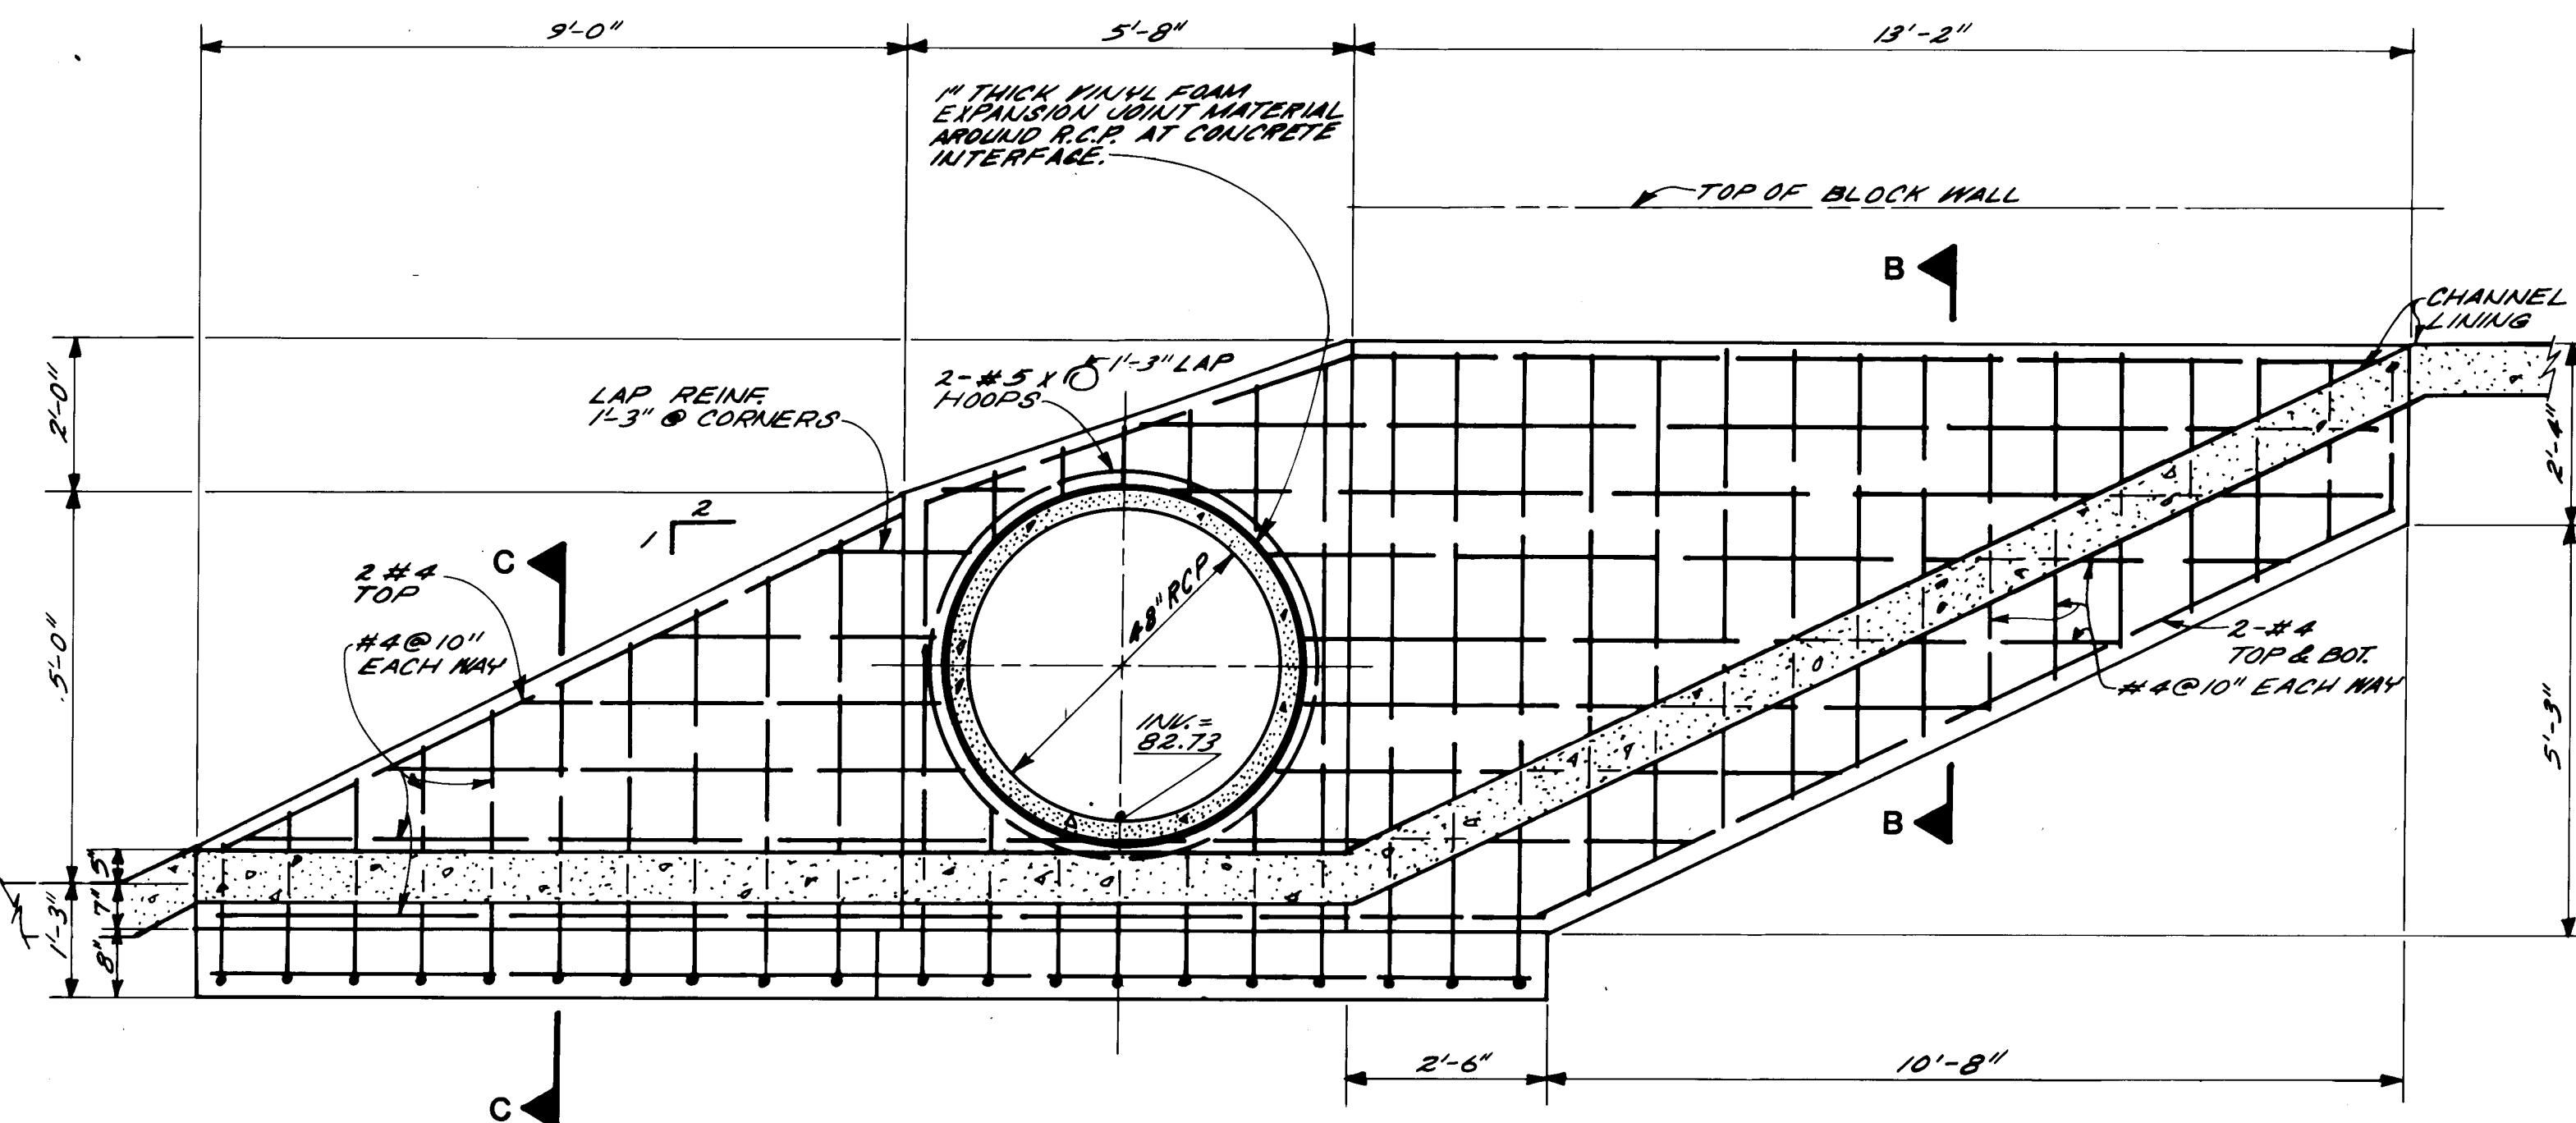


SECTION A-A

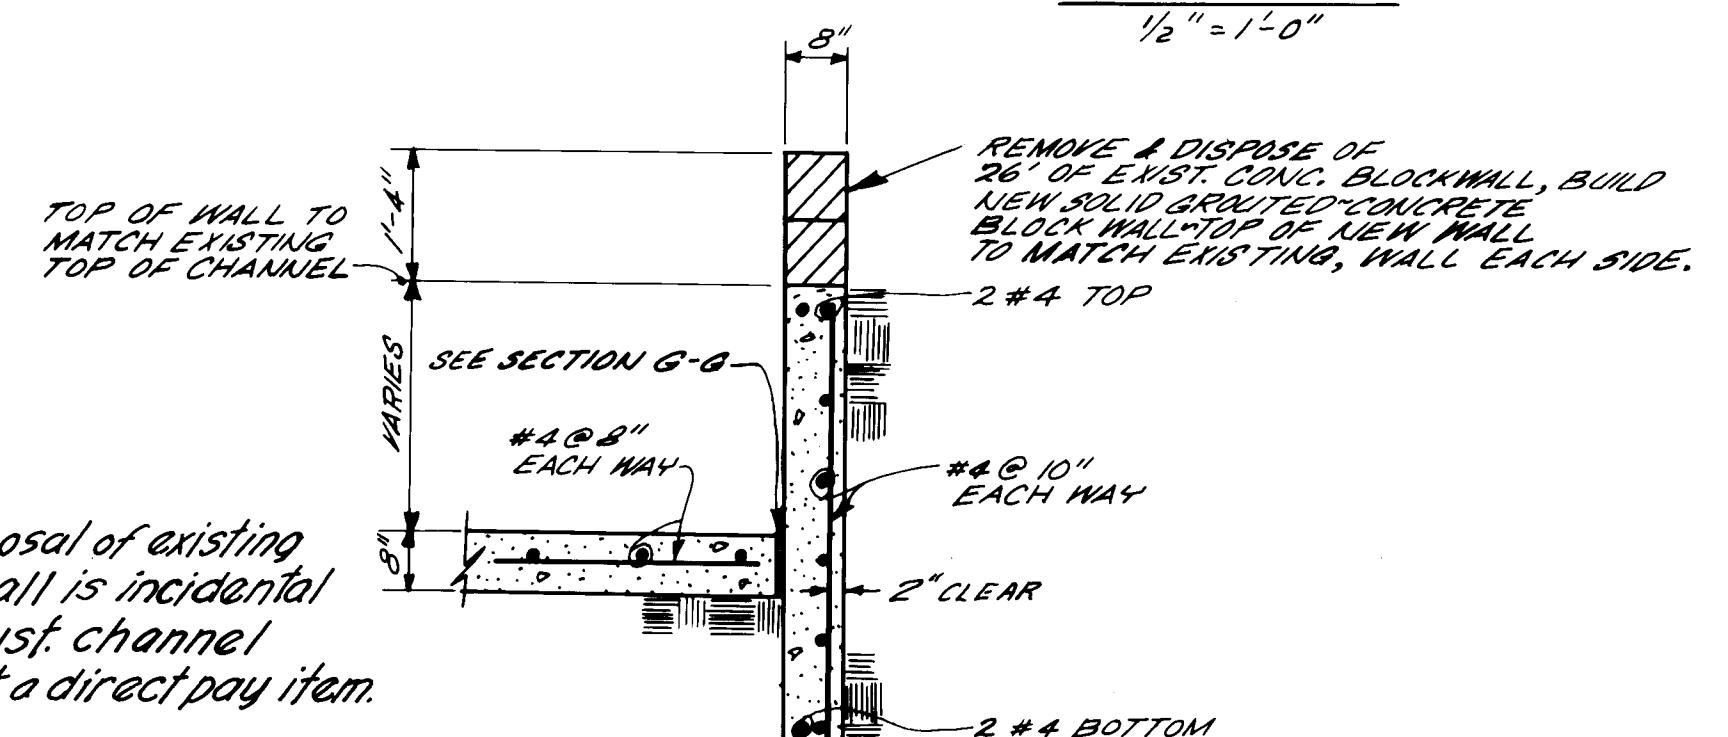

SECTION B-B

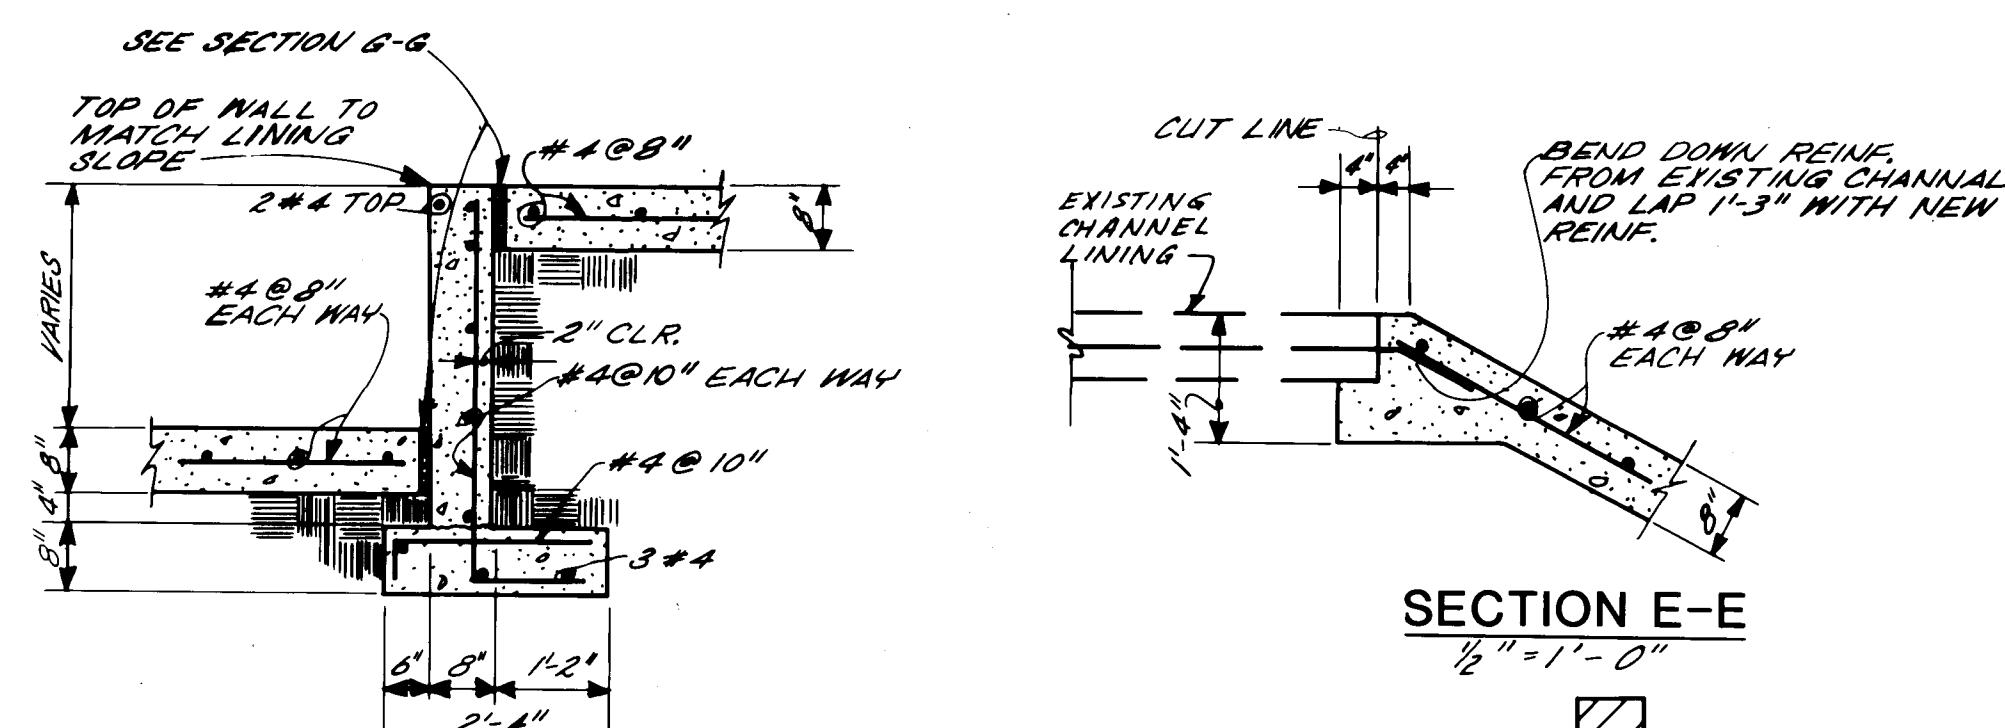

SECTION C-C

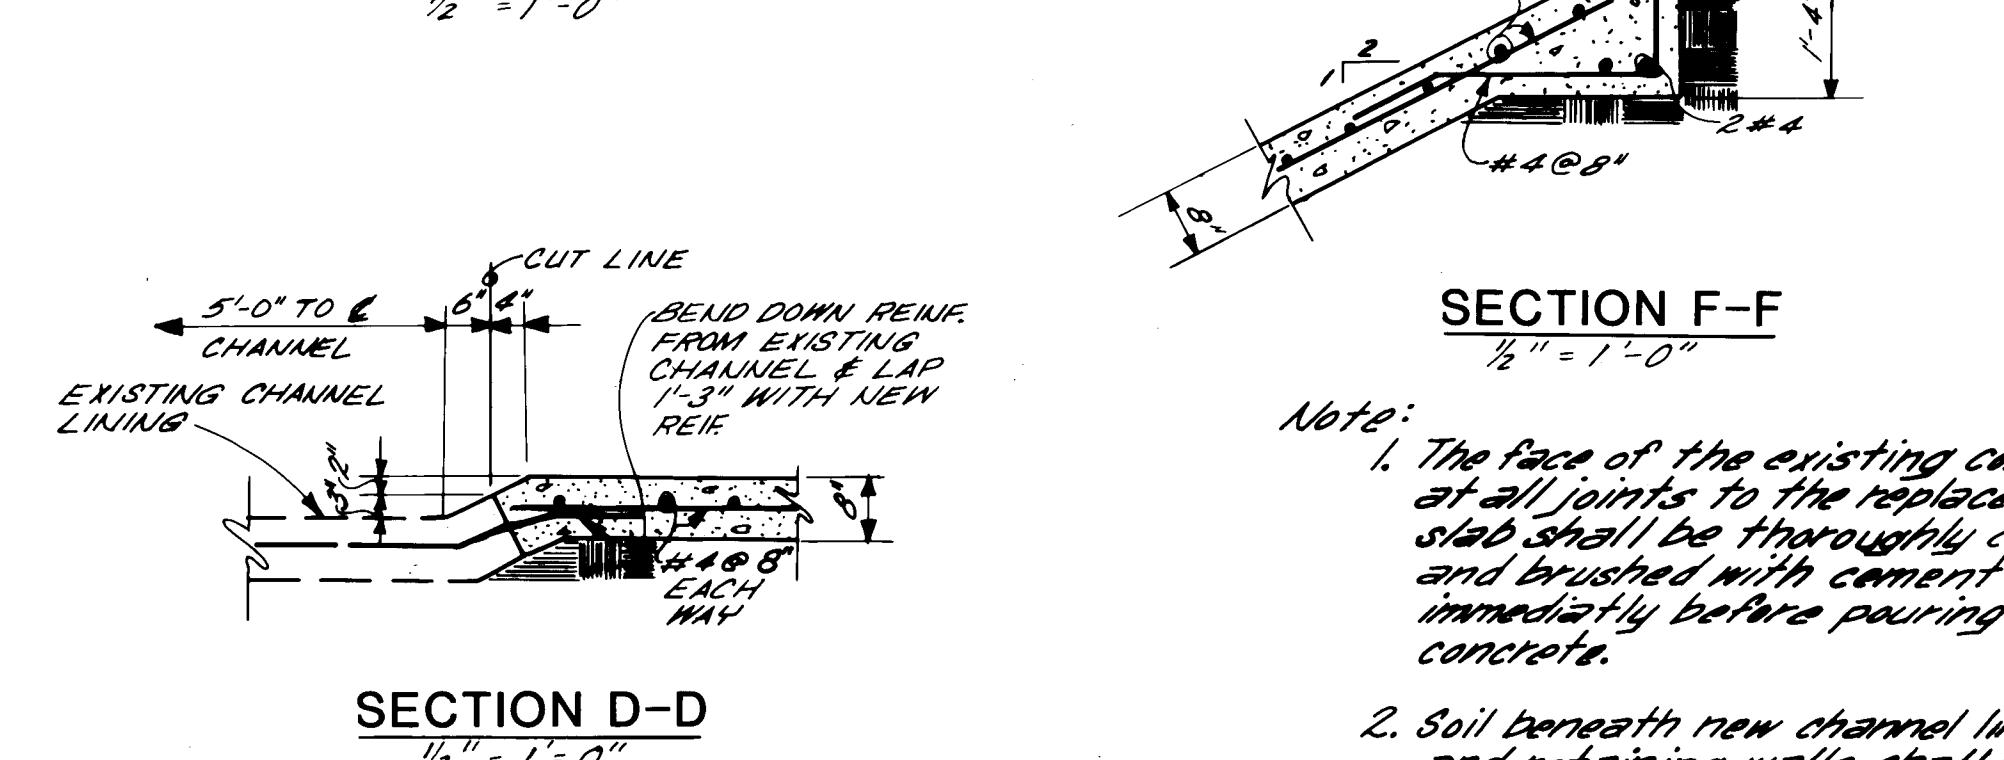

Note:

1. The face of the existing concrete at all joints to the replacement slab shall be thoroughly cleaned and brushed with cement slurry immediately before pouring new concrete.
2. Soil beneath new channel lining and retaining walls shall be compacted to 95% density per A.S.T.M. D-1557 for 6" depth.

<p style="margin: 0;">NOTICE OF PUBLIC HEARING</p> <p style="margin: 0; font-size: 1.5em;">CITY OF ALBUQUERQUE</p> <p style="margin: 0; font-size: 1.2em;">MUNICIPAL DEVELOPMENT DEPARTMENT</p> <p style="margin: 0; font-size: 1.2em;">ENGINEERING DIVISION</p>					
TITLE		SPECIAL ASSESSMENT DISTRICT 204			
<p style="margin: 0; font-size: 1.2em;">DETAILS OF STORM DRAIN OUTLET</p> <p style="margin: 0; font-size: 1.2em;">TO BEAR CANYON</p>					
POSITION	ENGINEER	DATE	APPROVALS	ENGINEER	DATE
City Engineer	C. J. Chapman	5/10/05	Liquid Waste	R. Reina	5/8/05
CE Design	H. O. Lasa	5/13/05	Traffic	N. A. Dault	5/8/05
EE Hydrology	Ron Hogan	5/8/05	Water	R. Reina	5/8/05
DRAWING NO.	MAP NO.		SHEET 33 OF 36		
1646					

AS BUILT INFORMATION	
CONTRACTOR	KUC, INC.
WORK	DATE 1/3/86
INSPECTOR	MMA
FIELD	DATE 1/3/86
VERIFICATION BY	MMA
DRAWINGS BY	MMA
CORRECTED BY	MMA
MICRO-FILM INFORMATION	
RECORDED BY	
NO	

26 16 463486

1 2 3 4 5 6 7 8 9 10 11 12 13 14 15 16 17 18 19 20 21 22 23 24 25 26 27 28 29 30 31 32 33 34 35

RECORD DRAWING

Drawings revised to reflect the

best information available. Do

not use without field verification.

NO. DATE

REMARKS

BY

DESIGN

DATE Mar. 1985
















DRAWN BY

DATE Mar. 1985

CHECKED BY

KUMA

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SIGN FACE DETAILS

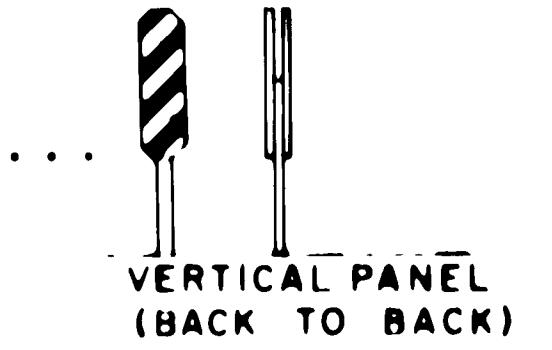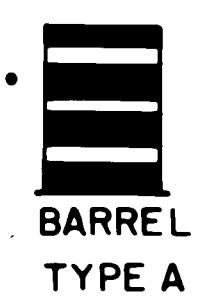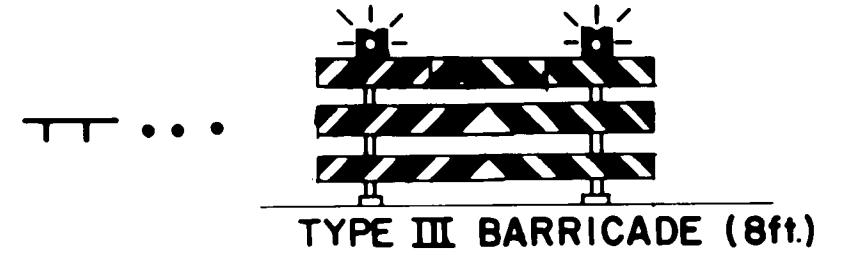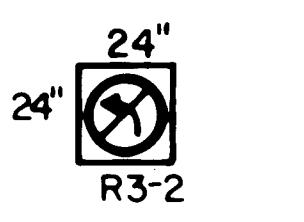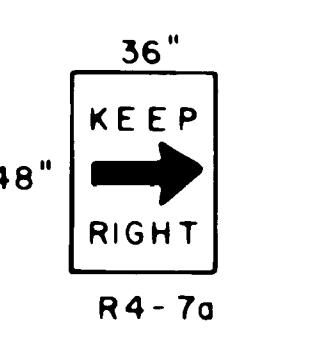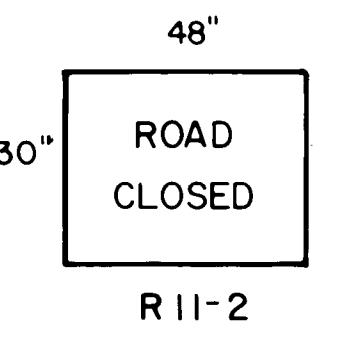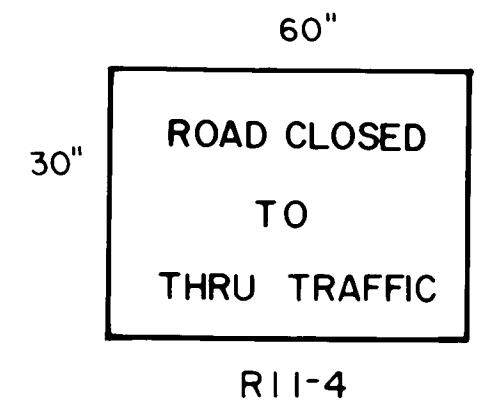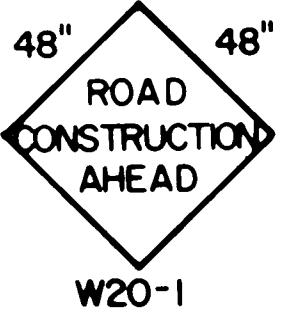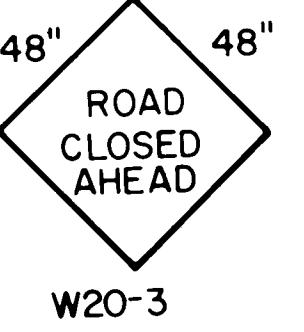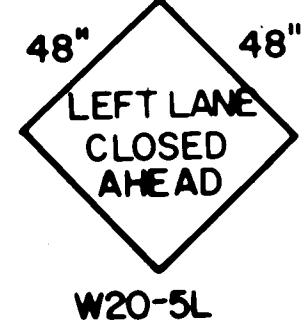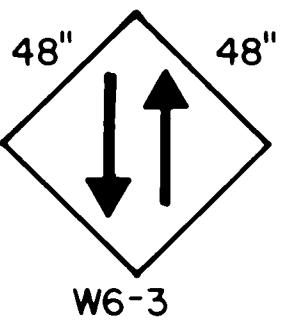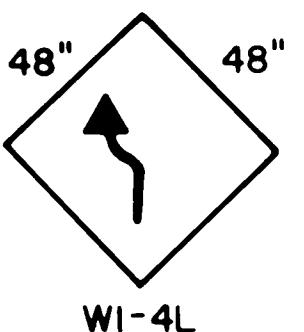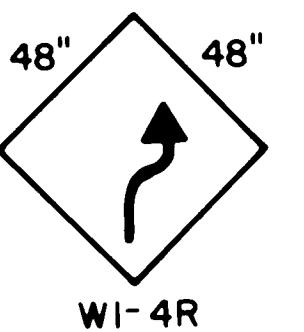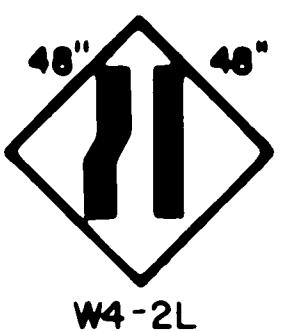
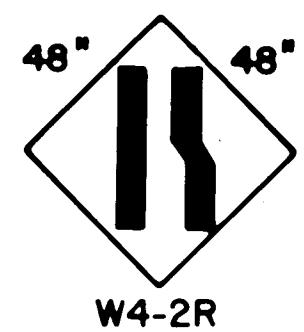
GENERAL NOTES FOR TRAFFIC CONTROL

1. ALL TRAFFIC CONTROL DEVICES SHALL COMPLY WITH CHAPTER VI OF THE 1978 EDITION OF THE "MANUAL FOR UNIFORM TRAFFIC CONTROL DEVICES".
2. THE CONTRACTOR SHALL PREPARE AND SUBMIT TO THE PROJECT ENGINEER A DETAILED CONSTRUCTION SCHEDULE, WHICH IS SUBJECT TO THE APPROVAL OF THE CITY TRAFFIC ENGINEER, THREE (3) WORKING DAYS PRIOR TO COMMENCING CONSTRUCTION.
3. UNLESS OTHERWISE PROVIDED AS PART OF THE CONSTRUCTION DOCUMENTS, THE CONTRACTOR SHALL PREPARE AND SUBMIT TO THE PROJECT ENGINEER A DETAILED TRAFFIC CONTROL PLAN, WHICH IS SUBJECT TO THE APPROVAL OF THE CITY TRAFFIC ENGINEER, THREE (3) WORKING DAYS IN ADVANCE OF ANY REQUIRED CLOSURES.
4. CONTRACTOR SHALL NOTIFY THE FOLLOWING SERVICES 24 HOURS IN ADVANCE OF ANY COMPLETE CLOSURES: POLICE DEPARTMENT, FIRE DEPARTMENT, AMBULANCE SERVICES, AND THE TRANSIT DEPARTMENT.
5. PERMITS TO BARRICADE OR DETOUR TRAFFIC MUST BE OBTAINED FOR EACH PHASE OF CONSTRUCTION THROUGH THE TRAFFIC ENGINEERS OFFICE AT LEAST 24 HOURS IN ADVANCE OF CONSTRUCTION ACTIVITIES.
6. ALL ADVANCE WARNING SIGNS AND BARRICADES MUST BE INSTALLED BEFORE CONSTRUCTION BEGINS AS DIRECTED BY THE ENGINEER.
7. ALL SIGN LOCATIONS WILL BE SELECTED IN THE FIELD AND APPROVED BY THE PROJECT ENGINEER.
8. ALL ADVANCE WARNING SIGNS SHALL BE 48" X 48" MINIMUM.
9. ALL ADVANCE WARNING SIGNS NOT DIRECTLY APPLICABLE SHALL BE REMOVED, COMPLETELY COVERED OR TURNED AWAY FROM ONCOMING TRAFFIC.
10. ALL CONSTRUCTION SIGNING SHALL BE BLACK ON A REFLECTORIZED ORANGE FIELD UNLESS OTHERWISE SPECIFIED.
11. ALL SIGNS WILL BE GROUND MOUNTED ON SINGLE OR DOUBLE POSTS WITH THE BOTTOM OF THE SIGN SEVEN (7) FEET ABOVE SIDEWALK LEVEL. EXISTING POSTS MAY BE USED AT SOME LOCATIONS, WITH THE APPROVAL OF THE PROJECT ENGINEER. PORTABLE SIGNS SUPPORTS WILL BE ACCEPTABLE AS AN ALTERNATE FOR SIGNS WHICH ARE IN PLACE FOR LESS THAN ONE (1) WEEK.
12. ALL EXISTING REGULATORY SIGNS THAT NEED TO BE REMOVED, RELOCATED OR REINSTALLED SHALL BE DONE BY THE CITY OF ALBUQUERQUE, TRAFFIC ENGINEERING DIVISION. THE CONTRACTOR SHALL NOTIFY THE TRAFFIC ENGINEERING DIVISION THREE (3) WORKING DAYS IN ADVANCE OF ANY REQUIRED WORK.
13. TRAFFIC CONTROL DEVICES REQUIRED AFTER DARK ARE TO BE EQUIPPED WITH WARNING LIGHTS. TYPE (A) FLASHING WARNING LIGHTS SHALL BE USED ON ALL ADVANCE WARNING SIGNS AND ON ALL DEVICES WHICH ARE INTENDED TO WARN MOTORISTS OR PEDESTRIANS OF HAZARDS OR OBSTRUCTIONS IN OR NEAR THE TRAVEL PATH. TYPE (C) STEADY BURN LIGHTS SHALL BE USED ON ALL DEVICES WHICH ARE INTENDED TO DEFINE THE TRAVEL PATH.
14. ALL SIGNS, BARRICADES AND/OR BARRELS WILL BE REFLECTORIZED. ALL BARRELS MAY HAVE SAND OR WATER BALLAST LIMITED TO 100 LBS.
15. ALL SIGNS, BARRICADES, AND/OR BARRELS WILL BE MOVED FORWARD AS THE CONSTRUCTION PROGRESSES (WHERE APPLICABLE).
16. CONTRACTOR SHALL INSPECT AND MAINTAIN ALL BARRICADES AT LEAST ONCE EACH DAY EXCEPT FOR BARRICADES ON/OR ADJACENT TO ARTERIAL AND COLLECTOR STREETS WHICH SHALL BE CHECKED TWICE DAILY, INCLUDING INSPECTION DURING HOURS OF DARKNESS.
17. BARRELS AND BARRICADES ARE NOT TO BE INTERMIXED IN THE SAME SERIES OF CHANNELIZATION.
18. EXCAVATIONS MUST BE PLATED OR PATCHED PRIOR TO OPENING OF TRAFFIC.
19. A MINIMUM WIDTH OF 11 FEET SHALL BE PROVIDED FOR TRAFFIC IN ONE DIRECTION.
20. EQUIPMENT AND MATERIALS ARE NOT TO BE STORED WITHIN THE STREET RIGHT-OF-WAY DURING NON-WORKING HOURS.
21. THE CONTRACTOR SHALL MAINTAIN ACCESS TO BUSINESSES AND RESIDENCES ADJACENT TO THE CONSTRUCTION AREA.
22. THE CONTRACTOR SHALL PROVIDE AND MAINTAIN A SAFE AND ADEQUATE MEANS OF CHANNELIZING PEDESTRIAN TRAFFIC AROUND ALL WORK AREAS THROUGHOUT THE PERIOD OF CONSTRUCTION. ALL SUCH CHANNELIZATION SHALL BE ARRANGED TO PREVENT PEDESTRIANS FROM HAVING TO ENTER THE ROADWAY IN ORDER TO PASS AROUND THE WORK AREAS.
23. THE CONTRACTOR SHALL BE REQUIRED TO KEEP THE PUBLIC INFORMED, THROUGH THE LOCAL NEWS MEDIA, OF CONSTRUCTION OPERATIONS INVOLVING STREET OR LANE CLOSURES, AND SHALL PROVIDE THE CITY TRAFFIC ENGINEER DOCUMENTED PROOF THAT THIS HAS BEEN DONE.
24. ALL SIGNS MUST BE MOUNTED ON SIGN STANDS OR TYPE III BARRICADES.
25. TWO-WAY TRAFFIC MUST BE MAINTAINED ON MORRIS STREET DURING INSTALLATION OF THE REQUIRED STORM DRAIN ALONG MORRIS STREET.
26. MORRIS MAY BE CLOSED FROM LAGRIMA DE ORO TO OSUNA DURING INSTALLATION OF THE NEW PAVEMENT PROVIDED THE CONTRACTOR COORDINATES THE CLOSURE WITH T.V.I. SO THERE WILL BE MINIMAL EFFECT TO T.V.I.'S ACCESS AT MORRIS STREET. A WRITTEN AGREEMENT STATING THE EXTENT AND DURATION OF THE CLOSURE SIGNED BY AN AUTHORIZED REPRESENTATIVE OF T.V.I. MUST BE OBTAINED BY THE CONTRACTOR AND A COPY DELIVERED TO TRAFFIC ENGINEERING PRIOR TO CLOSING MORRIS STREET. AN ADDITIONAL TYPE III BARRICADE WITH "T.V.I. TRAFFIC USE JUAN TABO ENTRANCE", WILL BE REQUIRED AT MONTGOMERY BLVD. FOR THE DURATION OF THE CLOSURE.
27. LAGRIMA DE ORO, GUTIERREZ, AND PITTS STREET MAY BE CLOSED A BLOCK AT A TIME AS PER PLANS, PROVIDED THE CONTRACTOR MAINTAINS ACCESS TO ALL BUSINESSES AND RESIDENCES AT ALL TIMES.
28. JUAN TABO TRAFFIC MAY BE DIVERTED AS SHOWN IN BARRICADE SCHEME NO. 2, IN ORDER TO INSTALL REQUIRED WATERLINE TIE-IN AT LAGRIMA DE ORO. THIS SET-UP MAY BE USED FROM 9 A.M. TO 4 P.M. ONLY, AT ALL OTHER TIMES TRAFFIC MUST BE MAINTAINED ON THE PROPER SIDE OF THE MEDIAN.
29. JUAN TABO AND LAGRIMA DE ORO TRAFFIC MAY BE DIVERTED AS SHOWN IN BARRICADE SCHEME NO. 1 IN ORDER TO INSTALL THE VALLEY GUTTER AND PAVEMENT REQUIRED. SEE BARRICAADING SCHEME NO. 4 FOR BARRICAADING REQUIRED ON LAGRIMA DE ORO ROAD.
30. JUAN TABO TRAFFIC MAY BE DIVERTED AS SHOWN IN BARRICADE SCHEME NO. 3 IN ORDER TO ACCOMPLISH THE REQUIRED MEDIAN WORK. THIS SET-UP MAY BE USED FROM 9 A.M. TO 4 P.M. ONLY, WITH THE BARRELS BEING PULLED BACK TO THE CURB LINE AT OTHER TIMES.
31. AT NO TIME SHALL BOTH JUAN TABO BLVD. AND MORRIS STREET TRAFFIC BE EFFECTED BY CONSTRUCTION ACTIVITIES.

26 16 46 35 86

RECORD DRAWING
Drawings revised to reflect the best information available. Do not use without field verification.

CITY OF ALBUQUERQUE MUNICIPAL DEVELOPMENT DEPARTMENT ENGINEERING DIVISION					
TITLE SPECIAL ASSESSMENT DISTRICT NO. 204					
SIGN FACE DETAILS & GENERAL NOTES					
APPROVALS	ENGINEER	DATE	APPROVALS	ENGINEER	DATE
City Engineer	<i>[Signature]</i>	5/8/85	Liquid Waste	<i>[Signature]</i>	5/8/85
A.C.E. Design	<i>[Signature]</i>	5/8/85	Traffic	<i>[Signature]</i>	5/8/85
A.C.E. Hydrology	<i>[Signature]</i>	5/8/85	Water	<i>[Signature]</i>	5/8/85
DRAWING NO	1646	MAP NO	35	SHEET OF	35

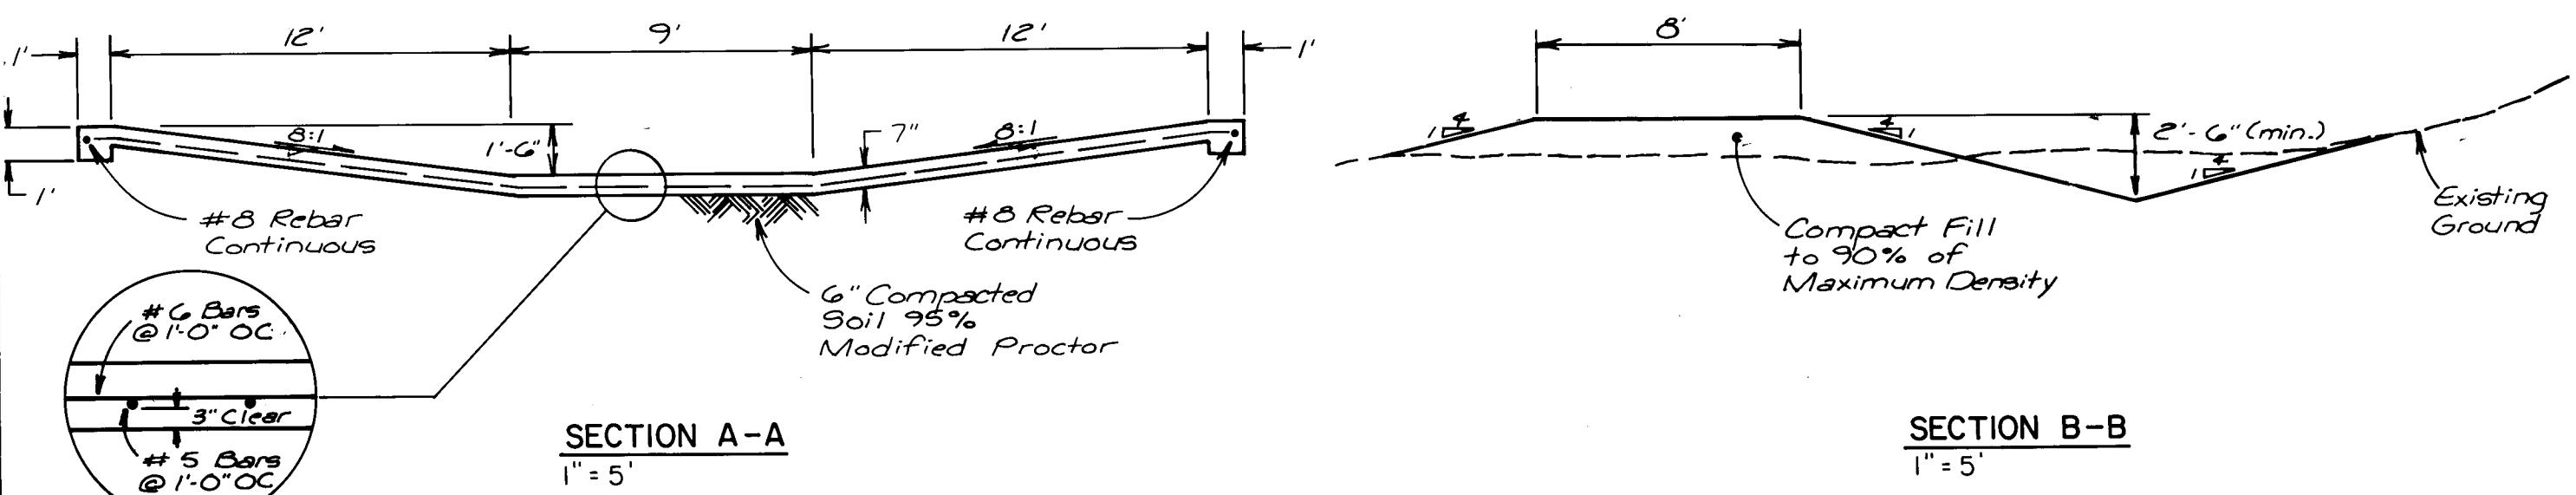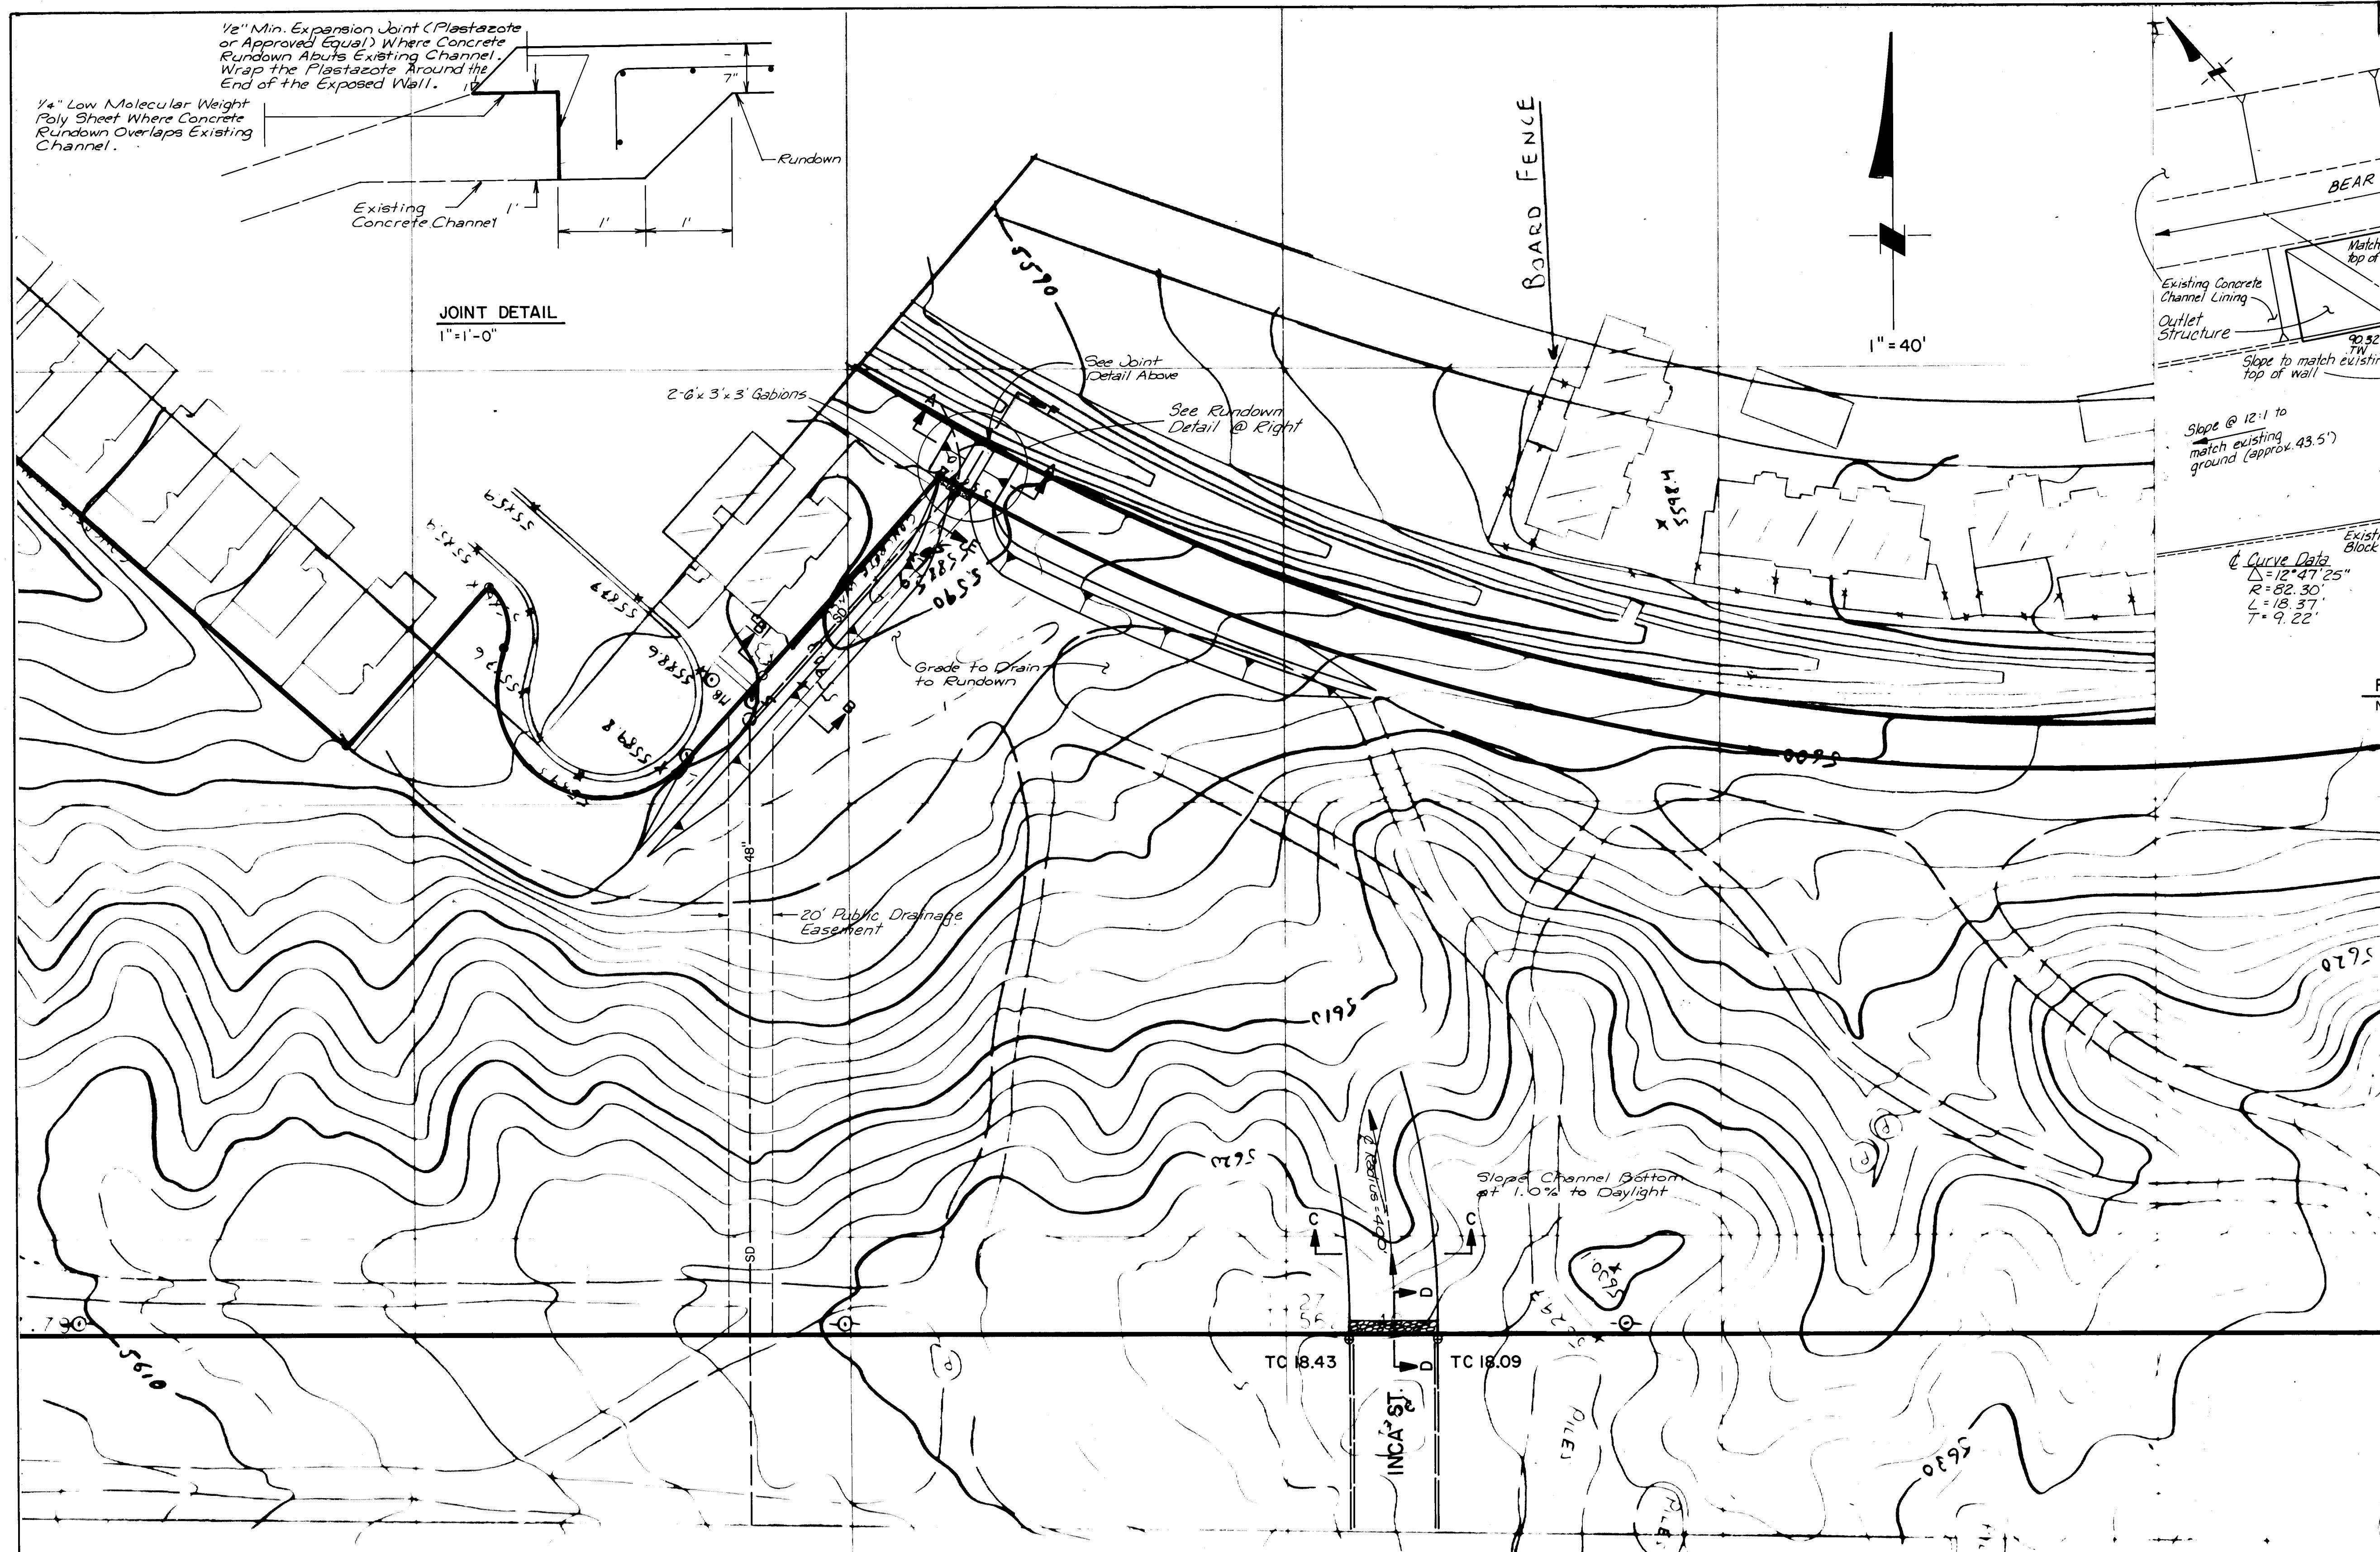

AS BUILT INFORMATION		BENCH MARKS	
CONTRACTOR	KMC INC.	WORK STATED BY	M.M.A.
INSPECTOR'S DATE	5/8/85	ACCEPTANCE BY	M.M.A.
DRAWINGS BY	M.M.A.	RECORDED BY	M.M.A.
MICRO-FILM INFORMATION		DATE	
		NO	

SURVEY INFORMATION		FIELD NOTES	
NO.	BY	DATE	THE SOUTHWEST CURB RETURN OF MONTGOMERY AND MORRIS NE. ELEV. 5636.11
6/20/85			

ENGINEER'S SEAL		RECORD DRAWING	
DESIGN	REVISIONS	DRAWINGS revised to reflect the best information available. Do not use without field verification.	REMARKS
6/20/85			
26 1 4 6 3 6 8 6			

APPROVED FOR CONSTRUCTION											
CITY ENGINEER		CITY OF ALBUQUERQUE									
CITY ENGINEER		CITY OF ALBUQUERQUE									
TITLE: SAD-204		RUNDOWN TO BEAR CANYON ARROYO									
APPROVALS	ENGINEER	DATE	APPROVALS	ENGINEER	DATE	APPROVALS	ENGINEER	DATE	APPROVALS	ENGINEER	DATE
City Engineer		5/12/85	Liquid Waste		5/12/85	Traffic		5/12/85	Water		5/12/85
A.C.E.-Design		5/12/85									
A.C.E.-Hydrology		5/12/85									
DRAWING NO.		MAP NO.		SHEET		36 OF		36		36	
1646		F-21		36		36		36		36	