


ALBUQUERQUE ACADEMY CAMPUS MIDDLE SCHOOL

ALBUQUERQUE, NEW MEXICO

OFF-SITE DRAINAGE, PAVING AND TRAFFIC IMPROVEMENTS

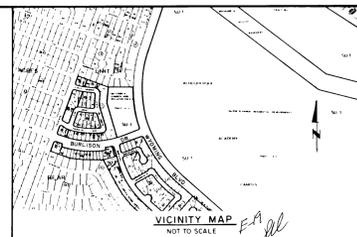

GENERAL NOTES

- NOTICE TO CONTRACTORS**
1. NEW MEXICO STANDARD SPECIFICATIONS FOR PUBLIC WORKS CONSTRUCTION-1979 EDITION WILL BE REFERRED TO HEREON AS THE "STANDARD SPECIFICATION"
 2. ALL WORK DETAILED ON THESE PLANS TO BE PERFORMED UNDER CONTRACT SHALL, EXCEPT AS OTHERWISE STATED OR PROVIDED FOR HEREON, BE CONSTRUCTED IN ACCORDANCE WITH "CONTRACT DOCUMENTS FOR CITY-WIDE UTILITIES AND CASH PAVING NO. 31" AND THE STANDARD SPECIFICATION.
 3. TWO WORKING DAYS PRIOR TO ANY EXCAVATION, CONTRACTOR MUST CONTACT LINE LOCATING SERVICE, 765-1234, FOR LOCATION OF EXISTING UTILITIES.
 4. PRIOR TO CONSTRUCTION, THE CONTRACTOR SHALL EXCAVATE AND VERIFY THE HORIZONTAL AND VERTICAL LOCATIONS OF ALL UTILITIES. SHOULD A CONFLICT EXIST, THE CONTRACTOR SHALL NOTIFY THE ENGINEER OR SUPERVISOR SO THAT THE CONFLICT CAN BE RESOLVED WITH A MINIMUM AMOUNT OF DELAY.

THE FOLLOWING NOTES ALSO APPLY WHEN CHECKED

- ALL UTILITIES AND UTILITY SERVICE LINES SHALL BE INSTALLED PRIOR TO PAVING.
- BACKFILL COMPACTION SHALL BE ACCORDING TO SPECIFIED STREET USE (SEE SHEET 5).
- TACK COAT REQUIREMENTS SHALL BE DETERMINED BY THE CITY ENGINEER.
- SIDEWALKS AND WHEELCHAIR RAMPS WITHIN THE CURB RETURNS SHALL BE CONSTRUCTED WHENEVER A NEW CURB RETURN IS CONSTRUCTED.
- IF CURB IS DEPRESSED FOR A DRIVEPAD, THE DRIVEPAD SHALL BE CONSTRUCTED PRIOR TO ACCEPTANCE OF CURB AND GUTTER.
- ALL STORM DRAINAGE FACILITIES SHALL BE COMPLETED PRIOR TO FINAL ACCEPTANCE.
- THE REQUESTOR OR DEVELOPER SHALL BE RESPONSIBLE FOR REPAIR OR REPLACEMENT OF ALL CURB AND GUTTER OR SIDEWALK DAMAGED AFTER APPROVAL BY THE CITY ENGINEER OF WORK COMPLETED BY THE CONTRACTOR.

INDEX

SHEET NO.	DESCRIPTION
1	TITLE SHEET
2-3	SUBDIVISION PLAT
4	MIDDLE SCHOOL ENTRANCE & DRAINAGE PLAN
5	ENTRANCE DETAIL & SIDEWALK CULVERT DETAILS

W. J. Weppner
8-7-85

26 19500185

REV	SHEETS	DATE	USER	DEPT	DATE
1	6	8-7-85	C. M. Chapman	CITY ENGINEER	
2		11-5-89	M. L. Licon	DESIGN	

APPROVAL OF REVISIONS

	<p>BOHANNON - HUSTON INC. ALBUQUERQUE - SANTA FE - EL PASO</p> <p>ENGINEERS - PLANNERS - PHOTOGRAMMETRISTS</p>	<p>APPROVED FOR CONSTRUCTION</p> <p><i>C. M. Chapman</i> 5/2/86 CE</p>
<p>PROJECT NUMBER</p> <p style="font-size: 1.2em;">1950</p>		<p>SHEET 1 OF 5</p>

1220


0221

0221

1220

REPLAT OF
TRACT A-1 and TRACT A-2
ALBUQUERQUE ACADEMY CAMPUS
(FILED: JANUARY 20, 1982)
IN
SECTION 29 & 30, T11N, R4E, N.M.P.M.
NOW COMPRISING
TRACT A-1-A and TRACT A-2-A
ALBUQUERQUE ACADEMY CAMPUS
ALBUQUERQUE, NEW MEXICO
SCALE: 1"=300'
JULY 1983

PROJECT 1950
RECORDED PLAT SHEET 3 OF 5

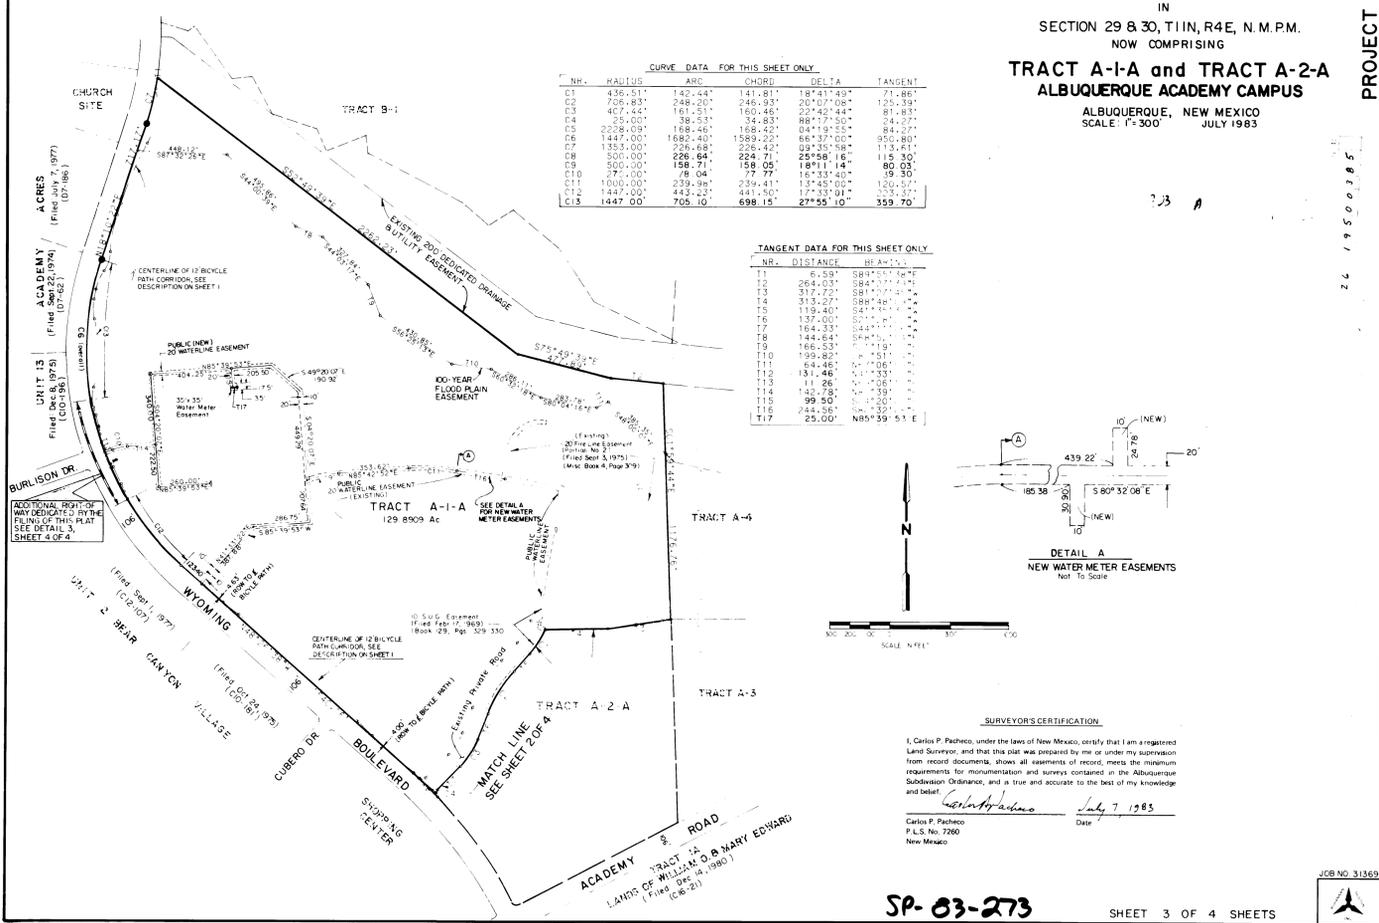


SP-83-273

SHEET 3 OF 4 SHEETS



C22-42

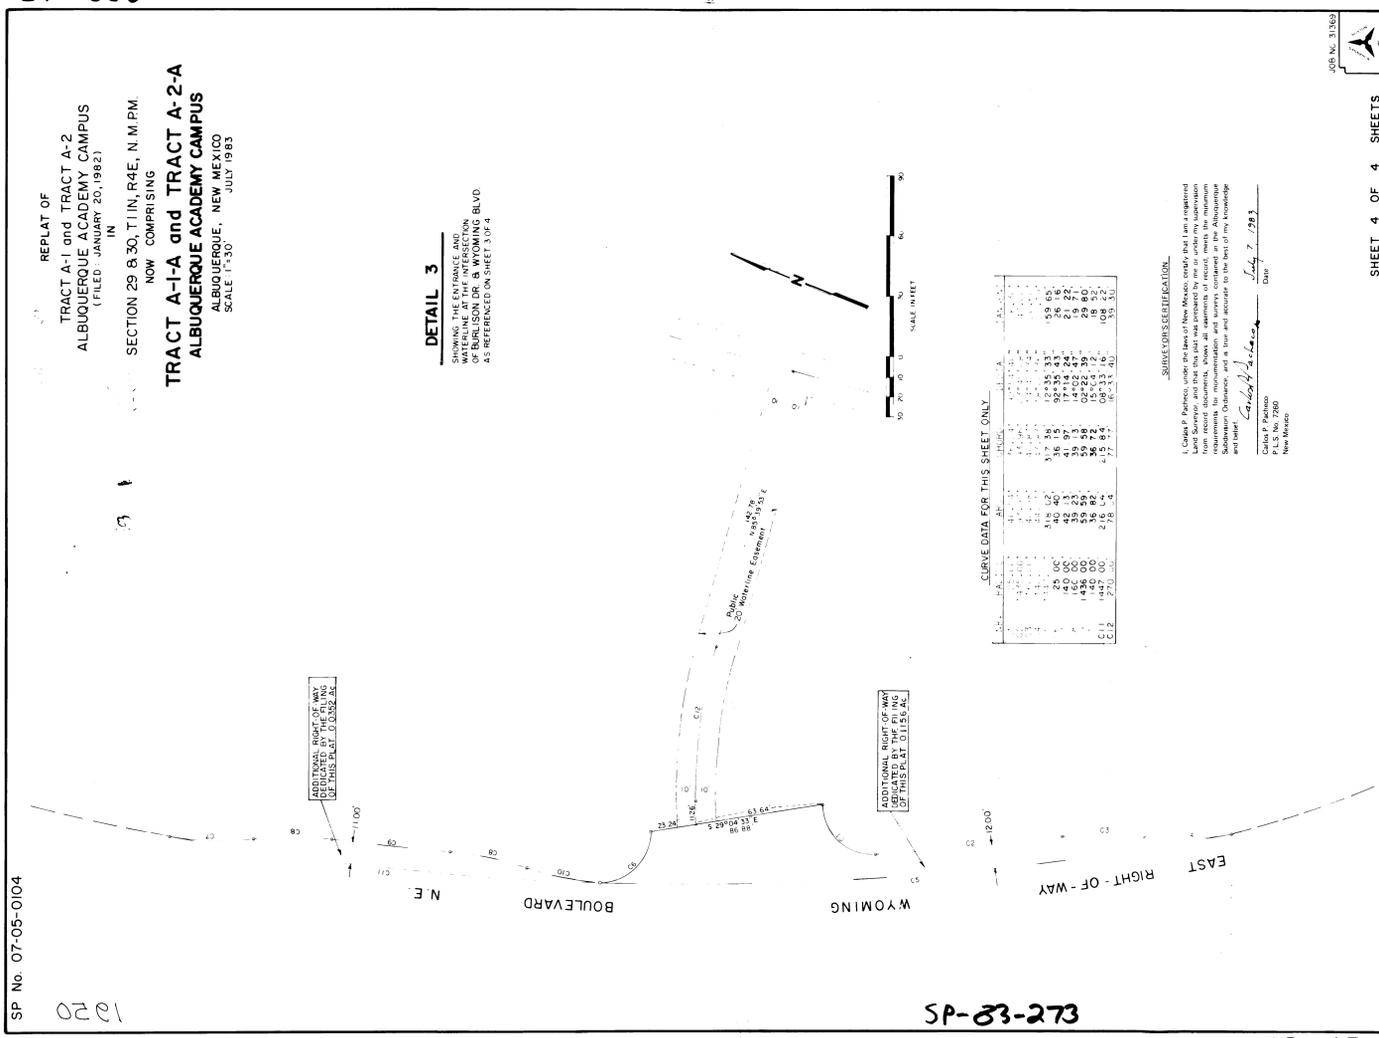


SP-83-273

C22-42

SHEET 4 OF 4 SHEETS

1020


1020

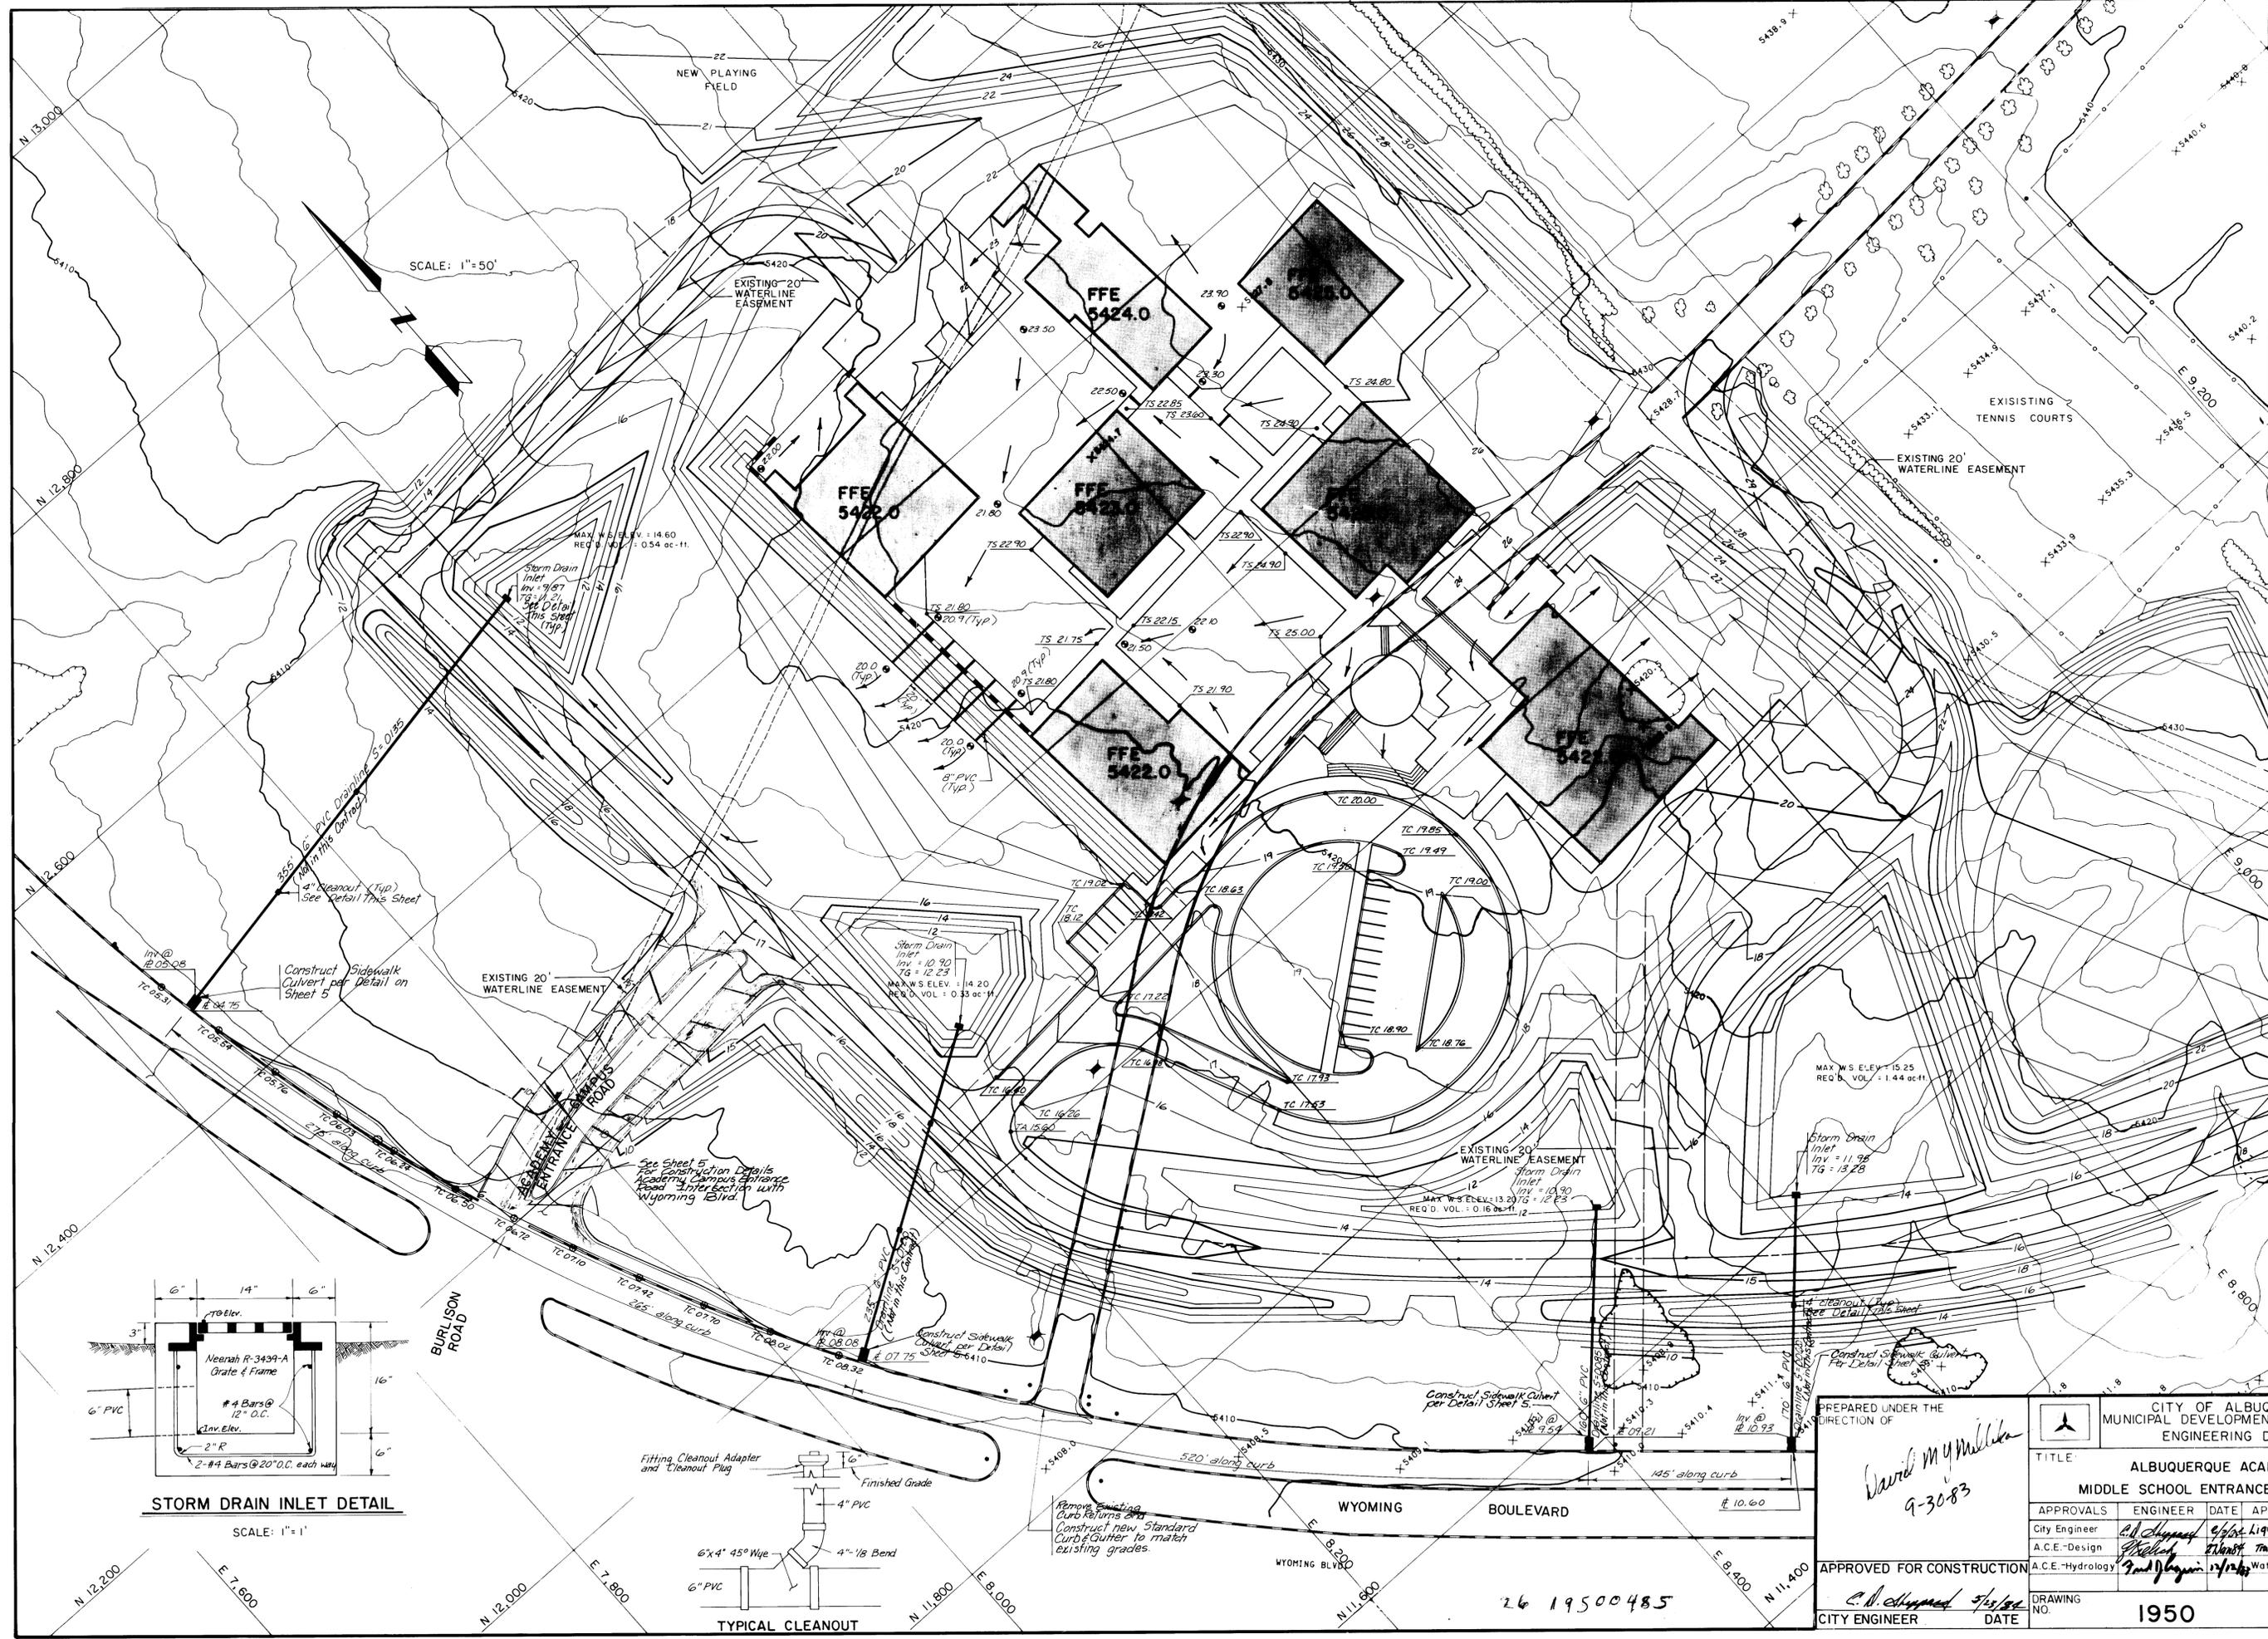

SCALE: 1"=50'


BURLISON ROAD

WYOMING BOULEVARD

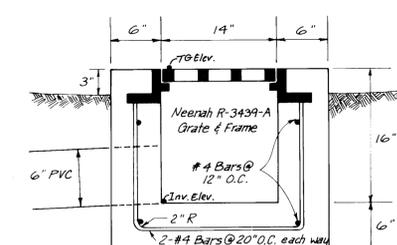

STORM DRAIN INLET DETAIL

SCALE: 1"=1'

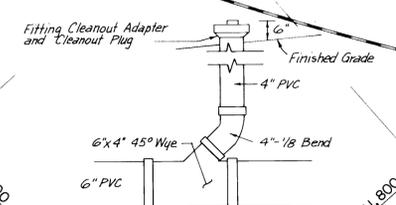

TYPICAL CLEANOUT

PREPARED UNDER THE DIRECTION OF
David M. Williams
 9-30-83

APPROVED FOR CONSTRUCTION
C. N. Williams
 CITY ENGINEER DATE

CITY OF ALBUQUERQUE MUNICIPAL DEVELOPMENT DEPARTMENT ENGINEERING DIVISION	
TITLE: ALBUQUERQUE ACADEMY CAMPUS MIDDLE SCHOOL ENTRANCE & DRAINAGE PLAN	
APPROVALS	ENGINEER DATE APPROVALS ENGINEER DATE
City Engineer	<i>C. N. Williams</i> 9/28/83
A.C.E.-Design	<i>Richard</i> 9/28/83
A.C.E.-Hydrology	<i>Richard</i> 9/28/83
DRAWING NO.	1950
SHEET	4 OF 5

BENCH MARKS		AS-BUILT INFORMATION	
CONTRACTOR	DATE	CONTRACTOR	DATE
INSPECTOR'S	DATE	INSPECTOR'S	DATE
ACCEPTANCE BY	DATE	ACCEPTANCE BY	DATE
VERIFICATION BY	DATE	VERIFICATION BY	DATE
UNAPPROVED BY	DATE	UNAPPROVED BY	DATE
MICRO-FILM INFORMATION		MICRO-FILM INFORMATION	
RECORDED BY	NO.	RECORDED BY	NO.


REFERENCES		SURVEY INFORMATION	
MAP NO. E-19	DATE	BY	DATE
EST. NO.	W/O NO.	NO.	NO.

REVISIONS	
NO.	DATE
DESIGN	DATE 9-83
CHECKED BY	DATE 9-83
DRAWN BY	DATE 9-83
DESIGNED BY	DATE 9-83

26 19500485


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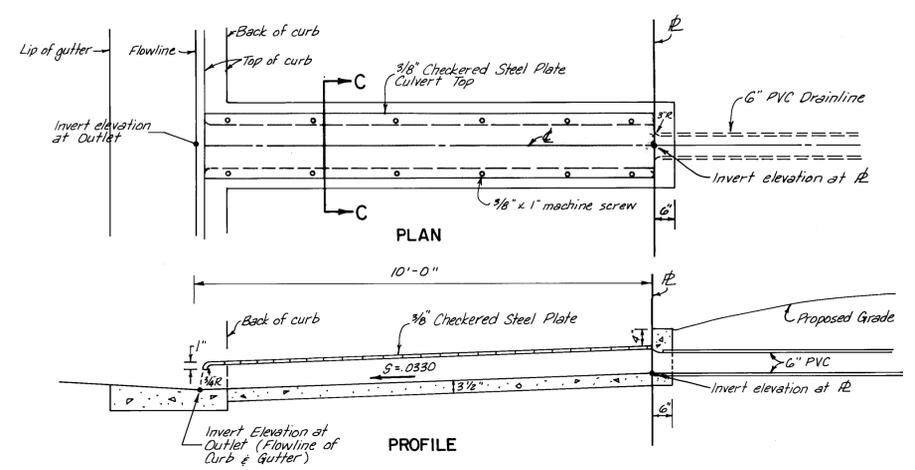
Notes:

1. An Easement Has Been Dedicated For The Bicycle Path
2. Flowline Of New 4' Valley Gutter Shall Be 0.67' Below Existing Top Of Curb (TC) Grades Shown.
3. Ultimate location of Bike Path may vary from locations shown. Locations shown are based upon preliminary construction drawings for Project # 1548.

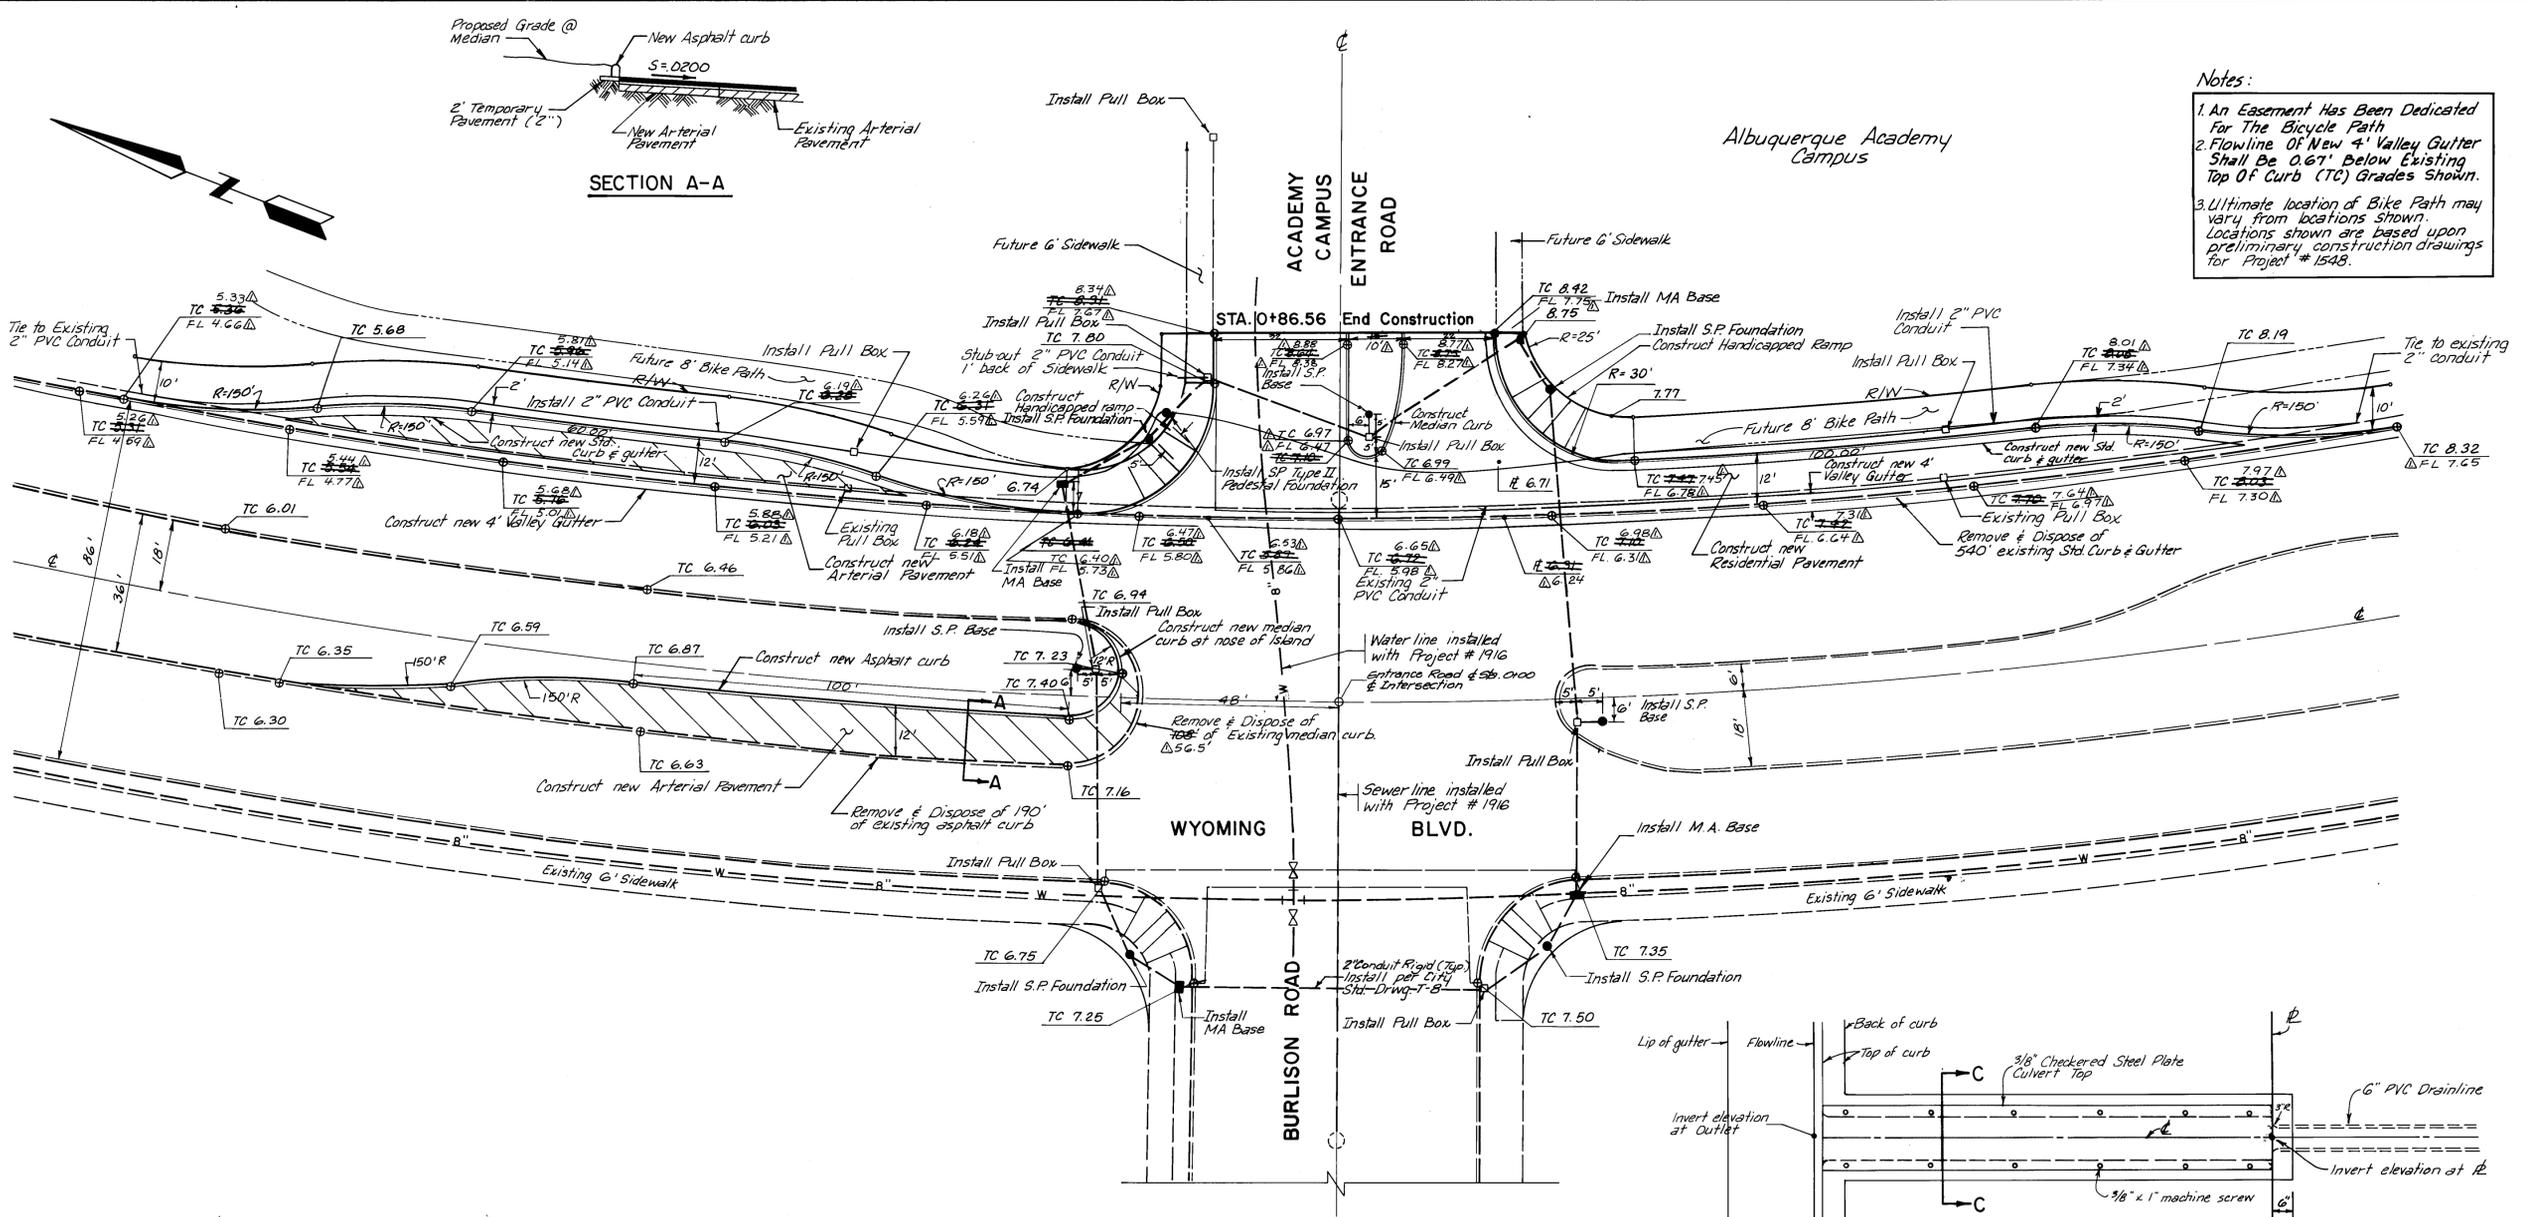

SIDEWALK CULVERT DETAIL
SECTION C-C
NO SCALE

- Notes:
1. Placement of sidewalk culvert through sidewalk or curb & gutter will require removal & replacement of entire stone of sidewalk or curb & gutter.
 2. Bottom slab of culvert shall be poured monolithically with new gutter.
 3. The invert shall be troweled & re-troweled to produce a hard polished surface of maximum density & smoothness. "V" invert shall be V-shaped to within 3" of the outlet & warped from this point to the outlet. Invert at outlet shall parallel gutter flowline.
 4. Surface of all exposed concrete shall match the grade, color, finish and scoring of adjacent curb & sidewalk.
 5. Stainless steel rod anchors drilled & tapped for flathead machine screws. Space at 24" o.c. with a min. of 2 per side per plate. There shall be an anchor within 6" of each end.
 6. The culvert steel top plate shall be cut perpendicular to the walls. Lengths shall be such that the weight per plate does not exceed 300 lbs. Each plate shall be stress relieved after fabrication. After cleaning surface of scale, rust etc. the plate(s) shall be painted with one shop coat red oxide & two finish coats of aluminum paint (AASHO M29).
 7. Maintenance of the sidewalk culvert shall be the responsibility of the owner of the drainline which discharges into the sidewalk culvert.

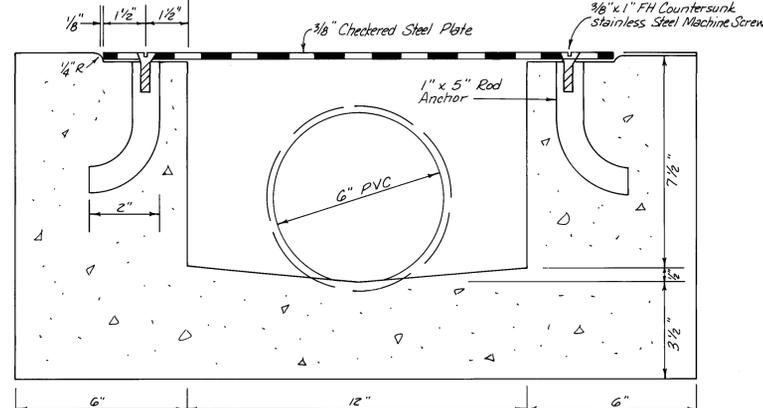

SIDEWALK CULVERT DETAIL 26 19500585

AS-BUILT INFORMATION		BENCH MARKS		SURVEY INFORMATION		REFERENCES		REVISIONS	
CONTRACTOR	DATE	THE STATION IS A STANDARD ACS BRASS TABLET	STAMPED "11-E19" SET FLUSH WITH THE CURB AT THE NORTHEAST CORNER OF THE INTERSECTION OF WYOMING BLVD. AND ACADEMY RD NE ELEV. = 5448.73	NO.	BY	MAP NO. E-19	EST. NO.	NO.	DATE
INSPECTOR'S ACCEPTANCE BY	DATE								
VERIFICATION BY	DATE								
RECORDED BY	DATE								
MICRO-FILM INFORMATION									
NO.	DATE								
DESIGN		DESIGNED BY BGG, DMYM DATE 9-83		DRAWN BY PE, UK DATE 9-83		CHECKED BY DMYM DATE 9-83			

NO SCALE

PREPARED UNDER THE DIRECTION OF

CITY OF ALBUQUERQUE MUNICIPAL DEVELOPMENT DEPARTMENT ENGINEERING DIVISION

TITLE: ALBUQUERQUE ACADEMY CAMPUS ENTRANCE DETAIL & SIDEWALK CULVERT DETAIL

APPROVALS	ENGINEER	DATE	APPROVALS	ENGINEER	DATE
City Engineer	<i>C. D. Shepard</i>	9/20/83	Liquid Waste	NA	11/28/83
A.C.E.-Design	<i>[Signature]</i>	9/20/83	Traffic	TR/Annex	11/30/83
A.C.E.-Hydrology	<i>[Signature]</i>	11/16/83	Water	NA	11-28-83

APPROVED FOR CONSTRUCTION

SCALE: 1" = 20'

CITY ENGINEER: *C. D. Shepard* DATE: 9/20/83

DRAWING NO. 1950 SHEET 5 OF 5

BRUNING 44-132 52753