


CONSTRUCTION PLANS FOR ACADEMY RIDGE EAST PHASE I ALBUQUERQUE, NEW MEXICO

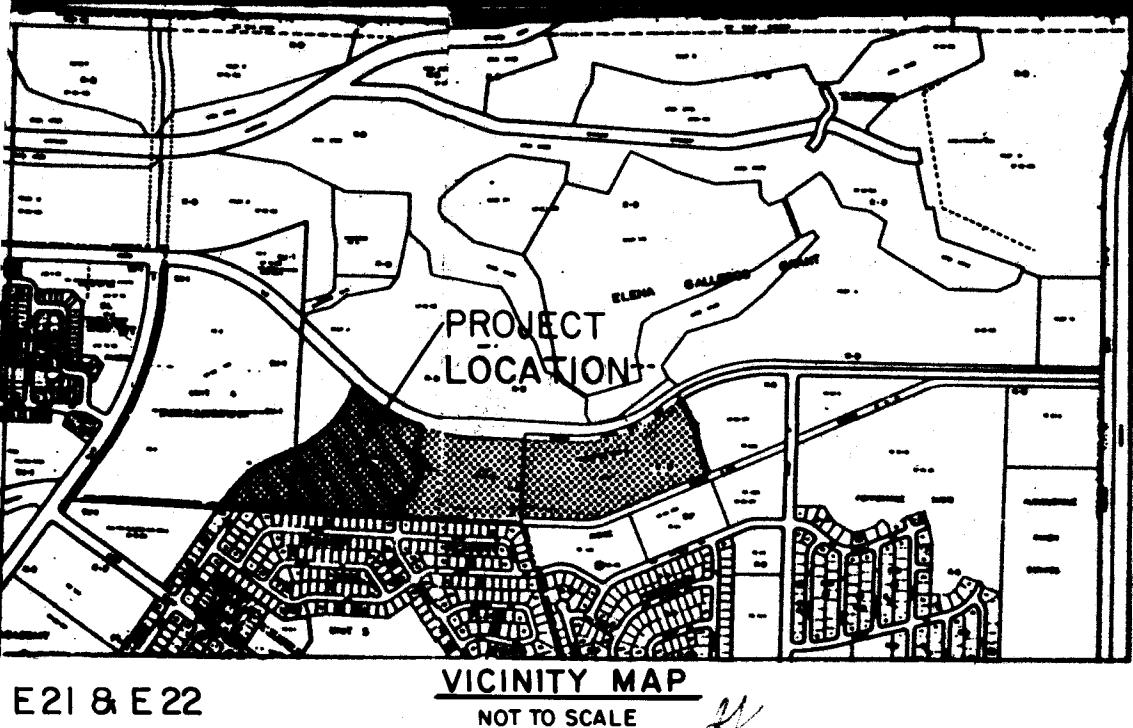

NO.	DESCRIPTION
1	TITLE SHEET
2-6	PLAT
7	PAVING LAYOUT
8	WATER DISTRIBUTION PLAN
9	SANITARY SEWER LAYOUT
10-11	GRADING PLAN
12	RETAINING WALL & DRAINAGE DETAILS
13	CARRUTHERS STREET
14	MALAGUENA LANE
15	MALAGUENA LANE - ACADEMY RIDGE COURT
16	ACADEMY RIDGE ROAD
17	PUBLIC DRAINAGE & ACCESS RIGHT-OF-WAY
18	MISCELLANEOUS DETAILS
19	PROSPECTOR'S POINT ALLEYWAY

GENERAL NOTES

NOTICE TO CONTRACTORS

1. NEW MEXICO STANDARD SPECIFICATIONS FOR PUBLIC WORKS CONSTRUCTION-1979 EDITION WILL BE REFERRED TO HEREON AS THE "STANDARD SPECIFICATION".
2. ALL WORK DETAILED ON THESE PLANS TO BE PERFORMED UNDER CONTRACT SHALL, EXCEPT AS OTHERWISE STATED OR PROVIDED FOR HEREON, BE CONSTRUCTED IN ACCORDANCE WITH "PUBLIC WORKS CONTRACT 85-1 AND THE NEW MEXICO STANDARD SPECIFICATIONS FOR PUBLIC WORKS CONSTRUCTION, 1979 EDITION.
3. TWO WORKING DAYS PRIOR TO ANY EXCAVATION, CONTRACTOR MUST CONTACT LINE LOCATING SERVICE, 765-1234, FOR LOCATION OF EXISTING UTILITIES.
4. PRIOR TO CONSTRUCTION, THE CONTRACTOR SHALL EXCAVATE AND VERIFY THE HORIZONTAL AND VERTICAL LOCATIONS OF ALL OBSTRUCTIONS. SHOULD A CONFLICT EXIST, THE CONTRACTOR SHALL NOTIFY THE ENGINEER OR SURVEYOR SO THAT THE CONFLICT CAN BE RESOLVED WITH A MINIMUM AMOUNT OF DELAY.

THE FOLLOWING NOTES ALSO APPLY WHEN CHECKED


- ALL UTILITIES AND UTILITY SERVICE LINES SHALL BE INSTALLED PRIOR TO PAVING.
- BACKFILL COMPACTION SHALL BE ACCORDING TO SPECIFIED STREET USE.
- TACK COAT REQUIREMENTS SHALL BE DETERMINED BY THE CITY ENGINEER.
- SIDEWALKS AND WHEELCHAIR RAMPS WITHIN THE CURB RETURNS SHALL BE CONSTRUCTED WHEREVER A NEW CURB RETURN IS CONSTRUCTED.
- IF CURB IS DEPRESSED FOR A DRIVEPAD, THE DRIVEPAD SHALL BE CONSTRUCTED PRIOR TO ACCEPTANCE OF CURB AND GUTTER.
- ALL STORM DRAINAGE FACILITIES SHALL BE COMPLETED PRIOR TO FINAL ACCEPTANCE.
- THE REQUESTOR OR DEVELOPER SHALL BE RESPONSIBLE FOR REPAIR OR REPLACEMENT OF ALL CURB AND GUTTER OR SIDEWALK DAMAGED AFTER APPROVAL BY THE CITY ENGINEER OF WORK COMPLETED BY THE CONTRACTOR.

1	2	3	4	5	6	7	8	9	10	11	12
26	22	89	01	96							


APPROVAL OF AS BUILT DRAWINGS	
ASST. CITY ENGINEER: FIELD	
<i>W.J. McNamara</i>	
DATE 1-20-86	

REV	1	2	3	4	5	6	7	8	9	10	11	12
1	I-19	<i>C.J. Shippard</i>	As-Builts	12/85	<i>B.H. Trulock, Jr., Inc.</i>	11/1/86						
2	I-19	<i>C.J. Shippard</i>		9/9/85	<i>A.C.E. A.O. Oliva</i>	9/15/85	<i>Approved by the City Engineer</i>					
1	I-18	<i>C.J. Shippard</i>	For CDS	7/23/85	<i>A.C.E. A.O. Oliva</i>	8/5/85	<i>Approved by the City Engineer</i>					

APPROVAL OF REVISIONS
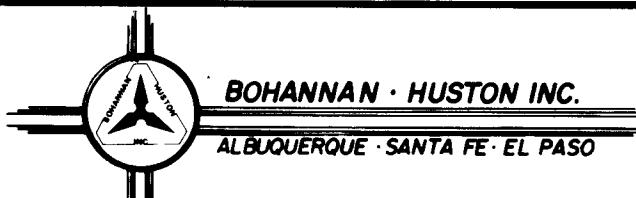
<i>Brent Bennett</i> 5-23-85	 BOHANNAN-HUSTON INC. ALBUQUERQUE-SANTA FE-EL PASO ENGINEERS PLANNERS PHOTOGRAHMETRISTS	APPROVED FOR CONSTRUCTION <i>C.J. Shippard</i> C.E.
PROJECT NUMBER 2289		SHEET 1 OF 19

1-Z8-132-1

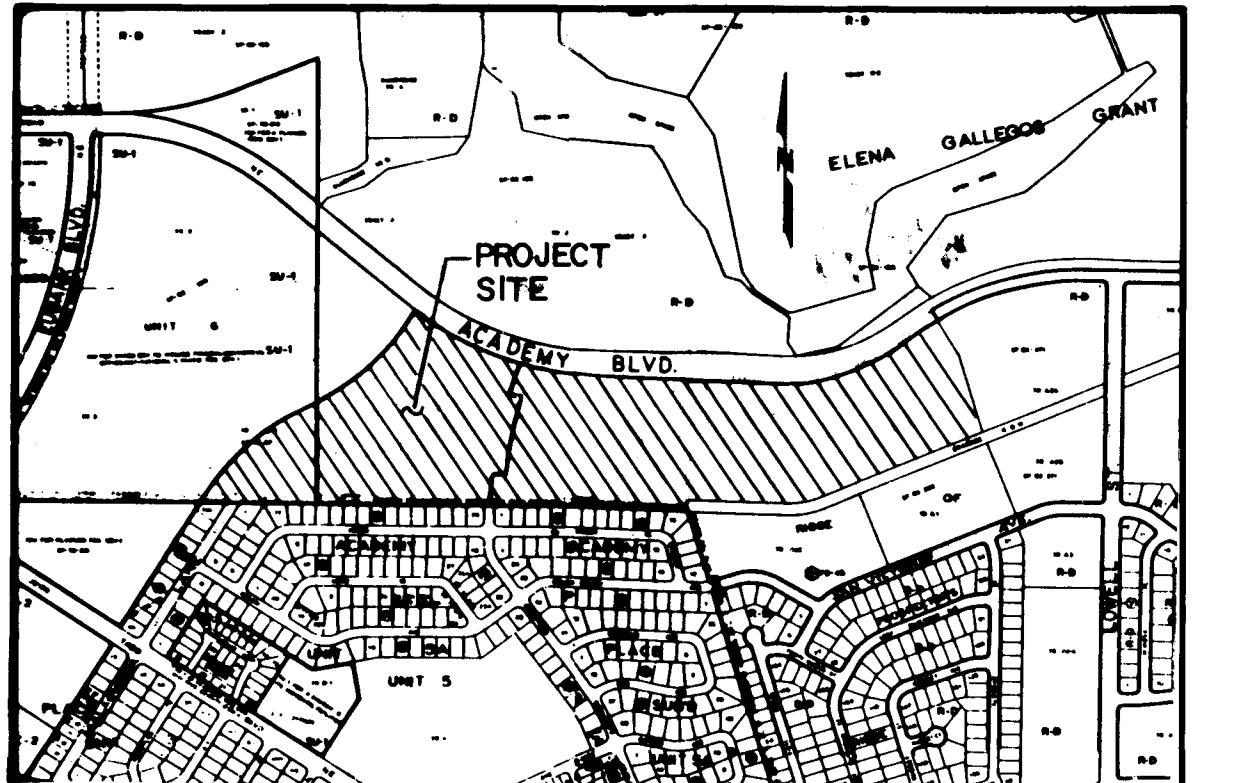

LOCATION MAP
Zone Atlas Map No E-21-Z & E-22-Z

NOTES

1. Bearings are New Mexico State Plane Grid Bearings (Central Zone).
2. Distances are ground distances.
3. Record Bearings and distances are shown in parenthesis.

SUBDIVISION DATA

1. DRB Number **S-84-23 DRB-84-212, V-84-41**
2. Zone Atlas Index No. E-21 and E-22.
3. Gross Subdivision Acreage: 35.7731 Acres.
4. Total Number of Tracts Created: 128 Tracts.
5. Total Mileage of Full-Width Streets Created: 0.710 mile.
6. Plat was prepared from existing Plats of Record.

APPROVALS

PLAT NUMBER	S-84-23
for PLANNING DIRECTOR	<i>Reserve</i> Dwain Weaver 10-16-85
CITY ENGINEER	<i>Reserve</i> Dwain Weaver 10-15-85
3rd M.P.C.A.	<i>Reserve</i> Dwain Weaver 10-15-85
TRAFFIC ENGINEER	<i>Reserve</i> Dwain Weaver 6-3-85
CITY SURVEYOR	<i>Reserve</i> Dwain Weaver 6-3-85
PROPERTY MANAGEMENT	<i>Reserve</i> Dwain Weaver 5-30-85
WATER RESOURCES DEPARTMENT	<i>Reserve</i> Dwain Weaver 6-4-85
PARKS & RECREATION DEPARTMENT	<i>Reserve</i> Dwain Weaver 6-4-85
PUBLIC SERVICE COMPANY OF NEW MEXICO	<i>Reserve</i> Dwain Weaver 5-30-85
GAS COMPANY OF NEW MEXICO	<i>Reserve</i> Dwain Weaver 5-30-85
MOUNTAIN CELL	<i>Reserve</i> Dwain Weaver 5-30-85

SUBDIVISION PLAT MAP FOR 85 36950

UNIT ONE
ACADEMY RIDGE EAST

WITHIN PROJECTED SECTIONS 27 and 28, TIN, R4E, N.M.P.M.

ALBUQUERQUE, NEW MEXICO
JANUARY 1985

DESCRIPTION

A certain tract of land situate within projected Sections 27 and 28, TIN, R4E, N.M.P.M., within the Elena Gallegos Grant, City of Albuquerque, Bernalillo County, New Mexico, comprising Tract B-1, LANDS OF AMHOME IV filed in the Office of the County Clerk of Bernalillo County, New Mexico on May 8, 1984 and being more particularly described by New Mexico State Plane Grid Bearings (Central Zone) and ground distances as follows:

BEGINNING at the southeast corner of the tract herein described, also being the southeast corner of said Tract B-1, whence the ACS Monument "HARRY", a brass tablet (having New Mexico State Plane Grid Coordinates, Central Zone: X = 423,375.12 and Y = 1,505,887.52) bears S30°57'31"E, 4223.92 feet and from said point of beginning running thence along the southern boundary of said tract B-1, N88°53'33"W, 2464.96 feet to the southwest corner of said tract B-1; thence, N33°10'12"E, 300.00 feet to a point of curvature; thence, 379.26 feet along the arc of a curve to the right having a radius of 500.00 feet and a chord bearing N54°53'59"E, 370.23 feet to a point of reverse curvature; thence, 670.00 feet along the arc of a curve to the left having a radius of 1000.00 feet and a chord bearing N57°26'08"E, 657.54 feet to a point of non-tangency; thence, N38°17'17"E, 166.85 feet to the northwest corner of said tract B-1 also being a point on curve on the southerly right-of-way of Academy Road N.E.; thence continuing along said right-of-way and the northerly boundary of said tract B-1, 962.80 feet along the arc of a curve to the left having a radius of 1485.40 feet and a chord bearing S70°19'27"E, 946.04 feet to a point of tangency; thence, S88°53'35"E, 462.13 feet to the northeast corner of said Tract B-1; thence leaving said right-of-way and continuing along the easterly boundary of said Tract B-1, S01°06'25"W, 669.17 feet to the point and place of beginning.

Tract contains 35.7731 acres, more or less.

State of New Mexico) SS
City of Bernalillo)
Name was the record
Date 1-16-85
..... Rec'd in Vol G28
..... Bernalillo County Folio 732
..... Clerk & Recorder
..... Deputy Clerk

DEDICATION

The subdivision of the land herein shown is with the free consent and in accordance with the desires of the undersigned owner(s) and/or proprietor(s) thereof and said owner(s) and/or proprietor(s) do grant all easements shown hereon. Electrical Power and Communication easements are reserved for buried distribution lines, conduits and pipes for underground utilities where shown or indicated, including the right of ingress and egress for construction and maintenance, and the right to trim interfering trees and shrubs. Future development of Tract A and Tract B will require additional PNM easements to serve future customers.

AMERIWEST CORPORATION

Allan L. Whitesel
Allan L. Whitesel
Vice President, AmeriWest Corporation

State of New Mexico)
County of Bernalillo) SS

The foregoing instrument was acknowledged before me this 30th day of May, 1985, by Allan L. Whitesel, Vice President, AmeriWest Corporation, a New Mexico Corporation on behalf of said Company.

My Commission Expires: **10-11-88** *Frank Cornwell* Notary Public

10-11-88

SURVEYOR'S CERTIFICATION

I, A. Dwain Weaver, under the laws of New Mexico, certify that I am a registered Land Surveyor, and that this plat was prepared by me or under my supervision, shows all easements of record, meets the minimum requirements for monumentation and surveys contained in the Albuquerque Subdivision Ordinance, and is true and accurate to the best of my knowledge and belief.



A. Dwain Weaver
Bohannan-Huston Inc.
4125 Carlisle Blvd., N.E.
Albuquerque, NM 87107

State of New Mexico)
County of Bernalillo) SS

The foregoing instrument was acknowledged before me this 5th day of February, 1985, by A. Dwain Weaver.

Dwain Weaver
Notary Public

1 2 3 4 5 6 7 8 9 10 11 12
2 6 2 2 8 9 0 2 8 6


Job No 41449

SHEET 1 OF 5 S

C28-132

PROJECT NUMBER SHE
2289

2-281-82

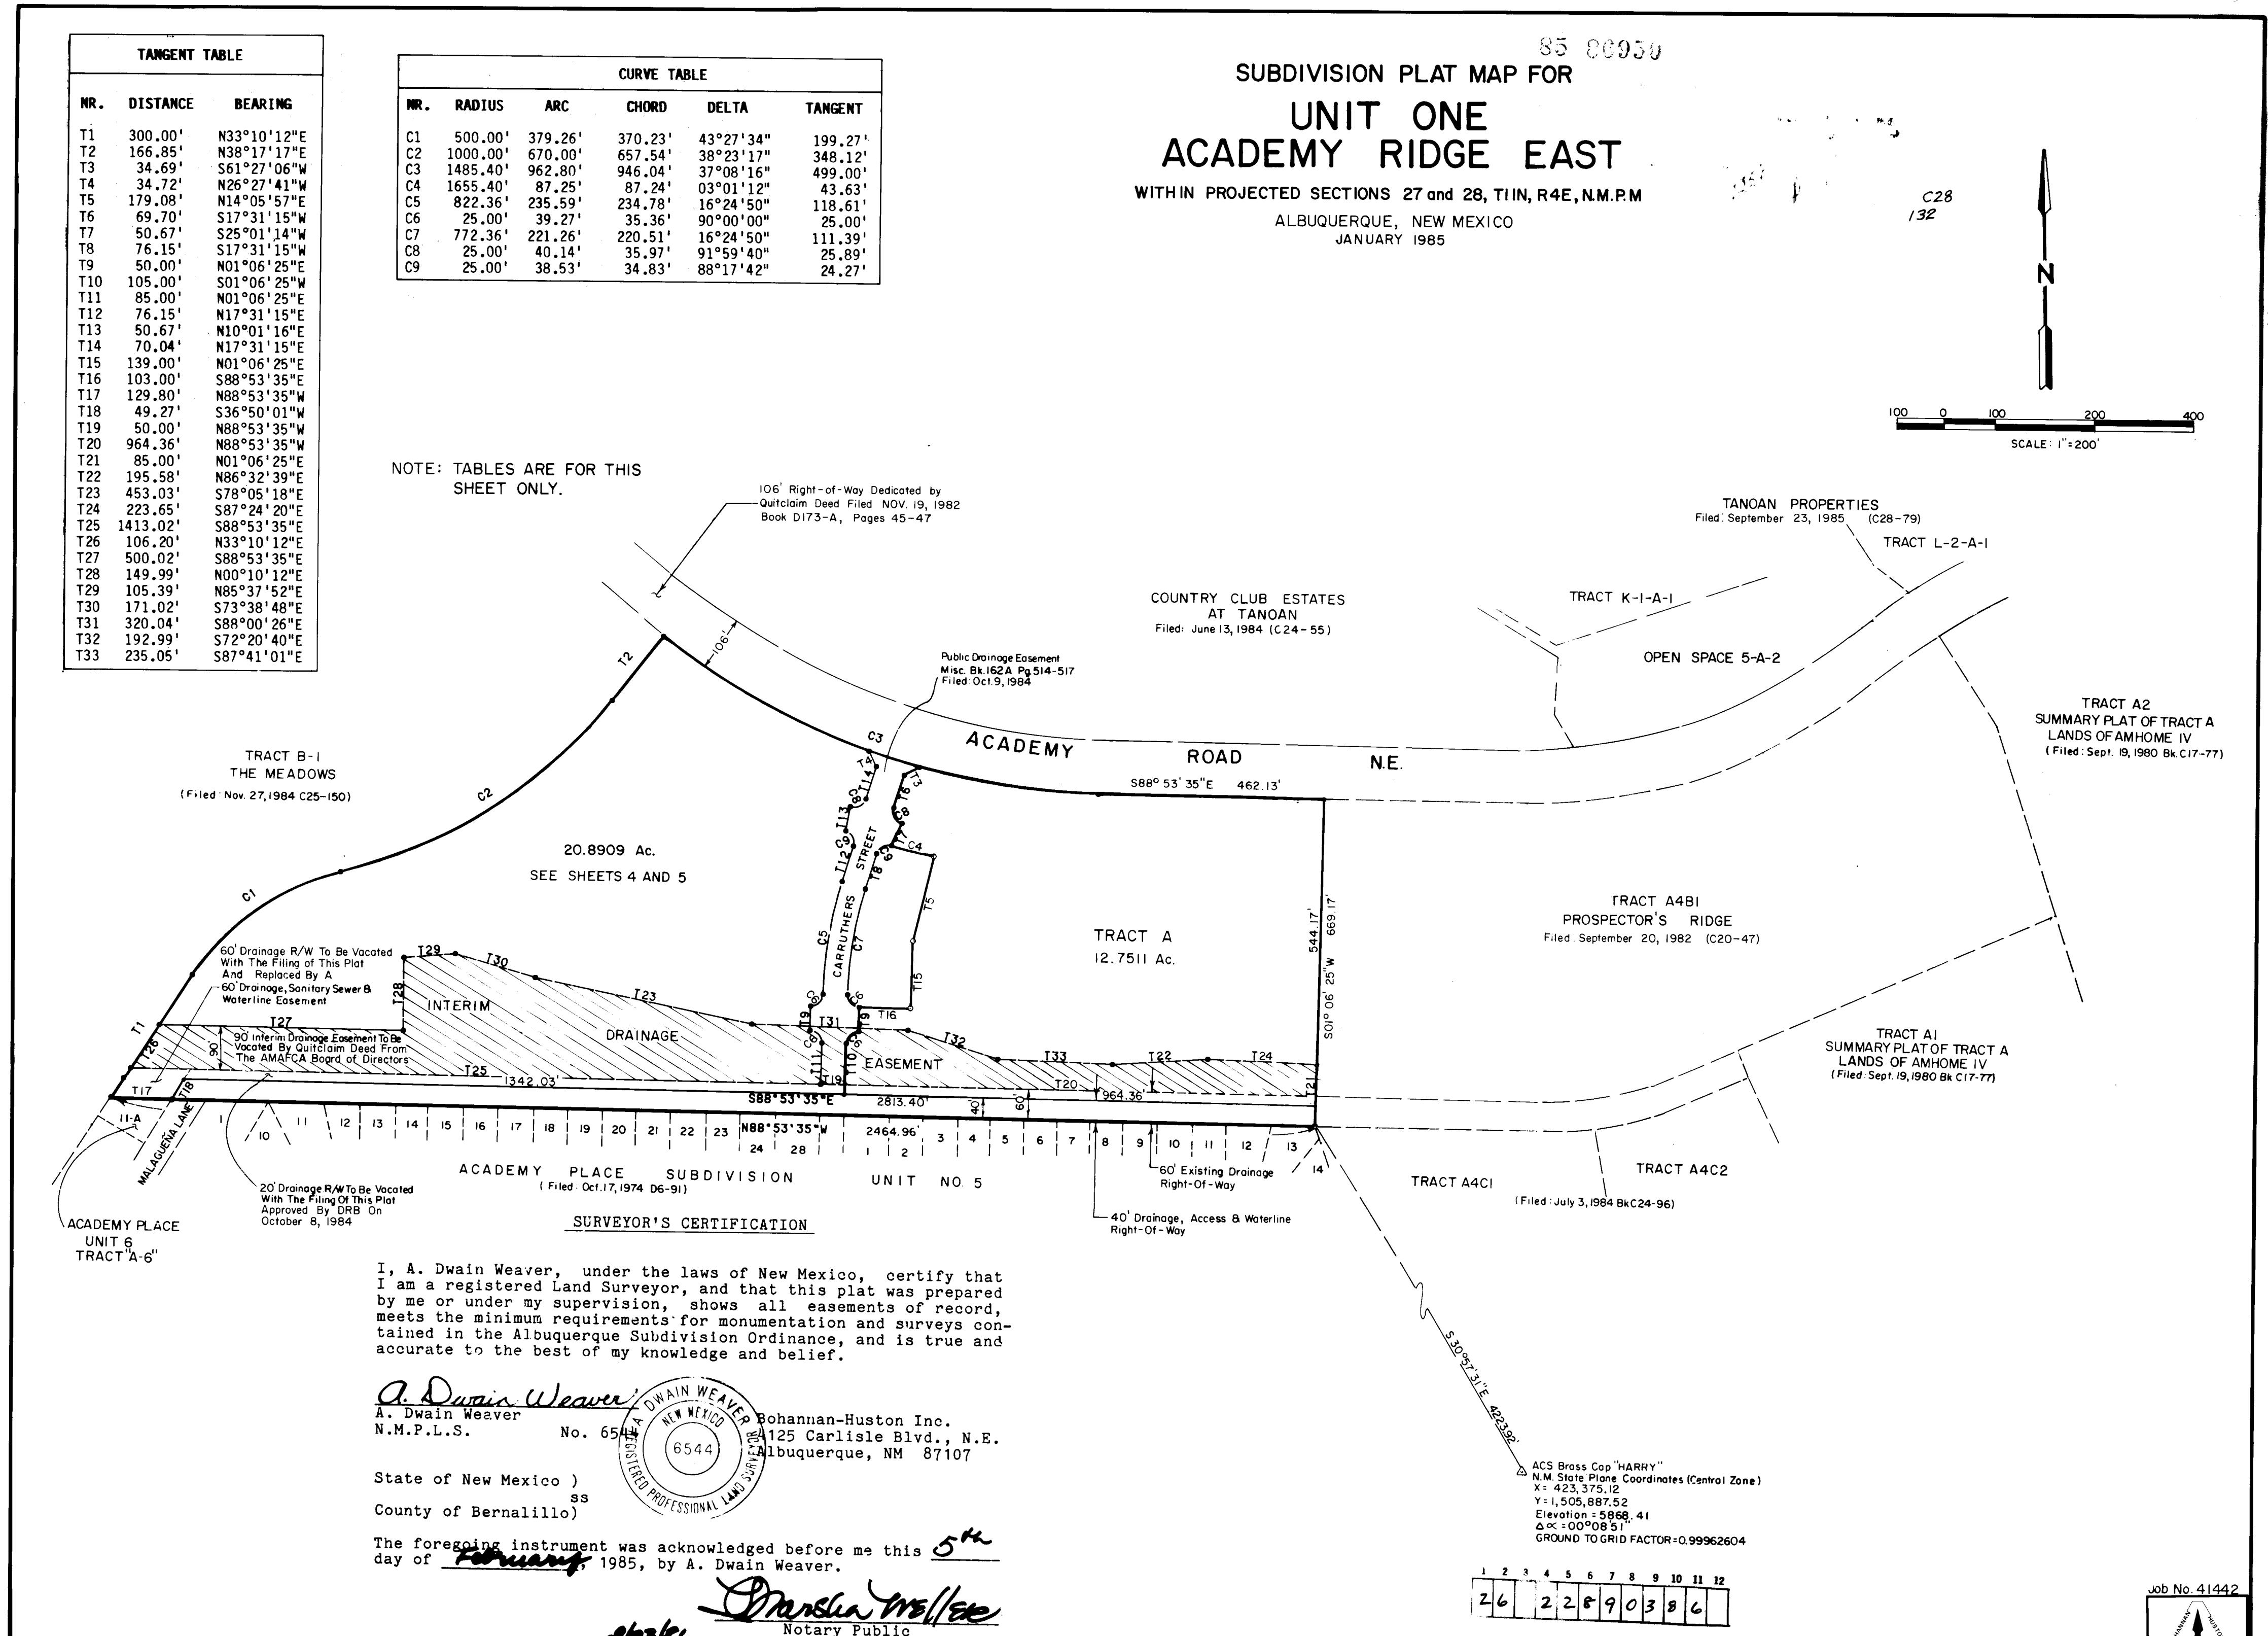

E-281-82

83 8303U

**SUBDIVISION PLAT MAP FOR
UNIT ONE
ACADEMY RIDGE EAST**

WITHIN PROJECTED SECTIONS 27 and 28, T11N, R4E, N.M.P.M.
ALBUQUERQUE, NEW MEXICO
JANUARY 1985

C28
732

TABLES FOR SHEETS 4 AND 5 ONLY

CURVE TABLE

NR.	RADIUS	ARC	CHORD	DELTA	TANGENT
C1	100.00'	187.71'	156.85'	08° 51' 46"	78.67'
C2	148.40'	59.71'	58.00'	22° 11' 44"	30.95'
C3	113.05'	140.09'	138.33'	07° 05' 25"	70.13'
C4	100.00'	138.33'	127.56'	79° 15' 21"	82.81'
C5	163.040'	367.02'	366.25'	12° 53' 52"	184.29'
C6	70.00'	22.34'	22.64'	14° 43' 41"	115.01'
C7	25.00'	8.34'	8.51'	87° 51' 43"	10.08'
C8	25.00'	40.14'	35.97'	91° 59' 40"	25.89'
C9	25.00'	38.53'	34.83'	88° 17' 42"	24.27'
C10	25.00'	39.27'	35.36'	80° 00' 00"	25.00'
C11	25.00'	39.27'	35.36'	55° 59' 59"	25.00'
C12	148.40'	54.08'	54.08'	02° 05' 10"	27.04'
C13	100.00'	40.00'	40.00'	02° 17' 31"	20.00'
C14	110.705'	44.53'	44.53'	02° 18' 17"	22.27'
C15	110.705'	44.53'	44.53'	02° 18' 17"	22.27'
C16	125.00'	13.88'	13.88'	04° 16' 32"	18.85'
C17	110.705'	30.89'	30.89'	01° 35' 55"	15.44'
C18	1000.00'	37.00'	37.00'	02° 07' 12"	18.50'
C19	25.00'	21.48'	20.81'	49° 10' 38"	11.44'
C20	148.40'	21.48'	21.48'	11° 57' 59"	11.44'
C21	45.00'	3.45'	3.45'	04° 23' 41"	1.73'
C22	25.00'	2.93'	2.93'	08° 43' 03"	1.47'
C23	148.40'	78.76'	78.76'	03° 02' 17"	39.39'
C24	100.00'	42.44'	42.44'	02° 37' 20"	24.46'
C25	148.40'	68.61'	68.61'	03° 07' 24"	34.86'
C26	45.00'	43.70'	42.00'	55° 38' 11"	23.74'
C27	148.40'	40.08'	01° 32' 37"	20.01'	
C28	1605.40'	14.81'	14.81'	00° 09' 53"	2.31'
C29	100.00'	1.25'	1.25'	04° 23' 41"	1.73'
C30	45.00'	3.45'	3.45'	04° 23' 41"	1.73'
C31	1605.40'	43.23'	01° 32' 35"	21.82'	
C32	148.40'	36.01'	36.00'	01° 23' 20"	18.00'
C33	100.00'	41.00'	41.00'	01° 23' 20"	20.75'
C34	110.705'	40.00'	01° 23' 20"	20.00'	
C35	110.705'	40.01'	01° 58' 52"	20.01'	
C36	110.705'	59.36'	59.55'	02° 58' 58"	29.79'
C37	75.00'	13.64'	13.62'	10° 38' 45"	6.99'
C38	110.705'	60.00'	02° 32' 50"	39.02'	
C39	75.00'	66.38'	61.68'	65° 39' 13"	40.89'
C40	75.00'	3.43'	3.43'	02° 37' 23"	1.72'
C41	1685.40'	67.32'	67.32'	02° 48' 49"	33.67'
C42	100.00'	44.20'	44.20'	01° 31' 20"	22.10'
C43	1685.40'	42.44'	01° 23' 13"	18.00'	
C44	1685.40'	40.00'	01° 23' 04"	20.00'	
C45	1685.40'	88.90'	88.89'	03° 04' 37"	44.46'
C46	822.36'	7.00'	7.00'	00° 28' 18"	3.50'
C47	822.36'	4.68'	4.68'	03° 04' 37"	24.01'
C48	822.36'	36.56'	36.56'	02° 32' 50"	18.28'
C49	85.00'	1.45'	1.45'	03° 19' 55"	.73'
C50	25.00'	29.82'	28.09'	68° 21' 01"	16.97'
C51	45.00'	33.47'	34.00'	45° 57' 14"	19.78'
C52	45.00'	47.23'	46.08'	00° 08' 12"	20.10'
C53	45.00'	30.00'	29.45'	38° 11' 50"	15.58'
C54	45.00'	33.17'	32.43'	42° 14' 12"	17.38'
C55	45.00'	21.69'	21.48'	27° 37' 12"	11.06'
C56	1605.40'	67.32'	03° 02' 52"	19.94'	
C57	772.36'	54.34'	54.33'	04° 01' 51"	24.18'
C58	772.36'	54.01'	54.00'	04° 00' 24"	27.02'
C59	772.36'	54.59'	54.58'	04° 03' 00"	27.31'
C60	772.36'	47.88'	47.88'	03° 33' 08"	23.95'

CURVE TABLE

NR.	RADIUS	ARC	CHORD	DELTA	TANGENT
C61	500.00'	378.28'	370.23'	43° 27' 34"	189.27'
C62	1000.00'	512.89'	507.38'	29° 23' 31"	262.27'
C63	800.00'	632.87'	602.50'	40° 22' 14"	241.97'
C64	839.67'	82.30'	82.27'	05° 38' 58"	41.18'
C65	839.67'	499.32'	492.43'	33° 23' 22"	251.83'
C66	1132.05'	361.70'	360.18'	18° 18' 23"	182.40'
C67	117.18'	94.28'	92.46'	17° 56' 17"	50.00'
C68	864.67'	42.00'	42.00'	02° 47' 00"	21.01'
C69	864.67'	40.00'	40.00'	02° 39' 03"	20.01'
C70	500.00'	38.05'	38.04'	04° 21' 37"	19.03'
C71	864.67'	40.00'	40.00'	02° 39' 03"	20.01'
C72	500.00'	48.84'	48.83'	05° 22' 04"	13.44'
C73	500.00'	48.84'	48.82'	05° 22' 03"	13.44'
C74	500.00'	48.84'	48.82'	05° 22' 03"	13.44'
C75	500.00'	48.84'	48.84'	05° 22' 00"	13.45'
C76	500.00'	32.28'	31.31'	13.28'	18.84'
C77	1000.00'	37.00'	36.99'	01° 31' 20"	17.00'
C78	864.67'	34.00'	34.00'	02° 15' 11"	17.00'
C79	1000.00'	40.31'	40.31'	02° 19' 34"	20.18'
C80	1000.00'	40.14'	40.14'	02° 19' 00"	20.07'
C81	1000.00'	40.00'	40.00'	02° 17' 31"	20.06'
C82	1000.00'	40.00'	40.00'	02° 17' 31"	20.06'
C83	1107.05'	14.69'	14.69'	00° 45' 37"	7.35'
C84	1107.05'	44.48'	44.48'	02° 18' 08"	22.25'
C85	1107.05'	44.48'	44.48'	02° 18' 10"	22.25'
C86	1107.05'	44.51'	44.50'	02° 18' 12"	22.26'
C87	1107.05'	44.51'	44.50'	02° 18' 13"	22.26'
C88	1107.05'	44.51'	44.51'	02° 18' 13"	22.26'
C89	1107.05'	44.52'	44.51'	02° 18' 14"	22.26'
C90	1107.05'	44.52'	44.51'	02° 18' 14"	22.26'
C91	1107.05'	44.53'	44.53'	02° 18' 15"	22.27'
C92	92.97'	73.85'	71.92'	45° 30' 41"	39.00'
C93	92.97'	47.38'	46.60'	108° 35' 08"	34.78'
C94	81.48'	13.20'	13.20'	00° 55' 43"	6.80'
C95	81.48'	9.00'	8.00'	03° 12' 22"	4.00'
C96	1157.05'	32.80'	31.37'	16.40'	32.00'
C97	1157.05'	40.00'	40.00'	01° 58' 51"	20.00'
C98	814.67'	63.31'	63.29'	04° 27' 08"	31.87'
C99	814.67'	40.00'	40.00'	02° 48' 51"	20.01'
C100	814.67'	40.25'	40.25'	02° 49' 51"	20.13'
C101	814.67'	40.52'	40.52'	02° 51' 00"	20.27'
C102	814.67'	40.90'	40.90'	02° 52' 38"	20.48'
C103	814.67'</td				

C28-132-4

SUBDIVISION PLAT MAP FOR 83-34950

UNIT ONE ACADEMY RIDGE EAST

WITHIN PROJECTED SECTIONS 27 and 28, T11N, R4E, N.M.P.M.

ALBUQUERQUE, NEW MEXICO
JANUARY 1985 SCALE : 1" = 50'


SURVEYOR'S CERTIFICATION

I, A. Dwain Weaver, under the laws of New Mexico, certify that I am a registered Land Surveyor, and that this plat was prepared by me or under my supervision, shows all easements of record, meets the minimum requirements for monumentation and surveys contained in the Albuquerque Subdivision Ordinance, and is true and accurate to the best of my knowledge and belief.

A. Dwain Weaver
A. Dwain Weaver
N.M.P.L.S. No. 6544
1977 A NEW MEXICO 6544 Bohannan-Huston Inc.
25 Carlisle Blvd., N.E.
Albuquerque, NM 87107

State of New Mexico)
ss
County of Bernalillo)

The foregoing instrument was acknowledged before me this 5
day of February 1985 by A. Duain Weaver

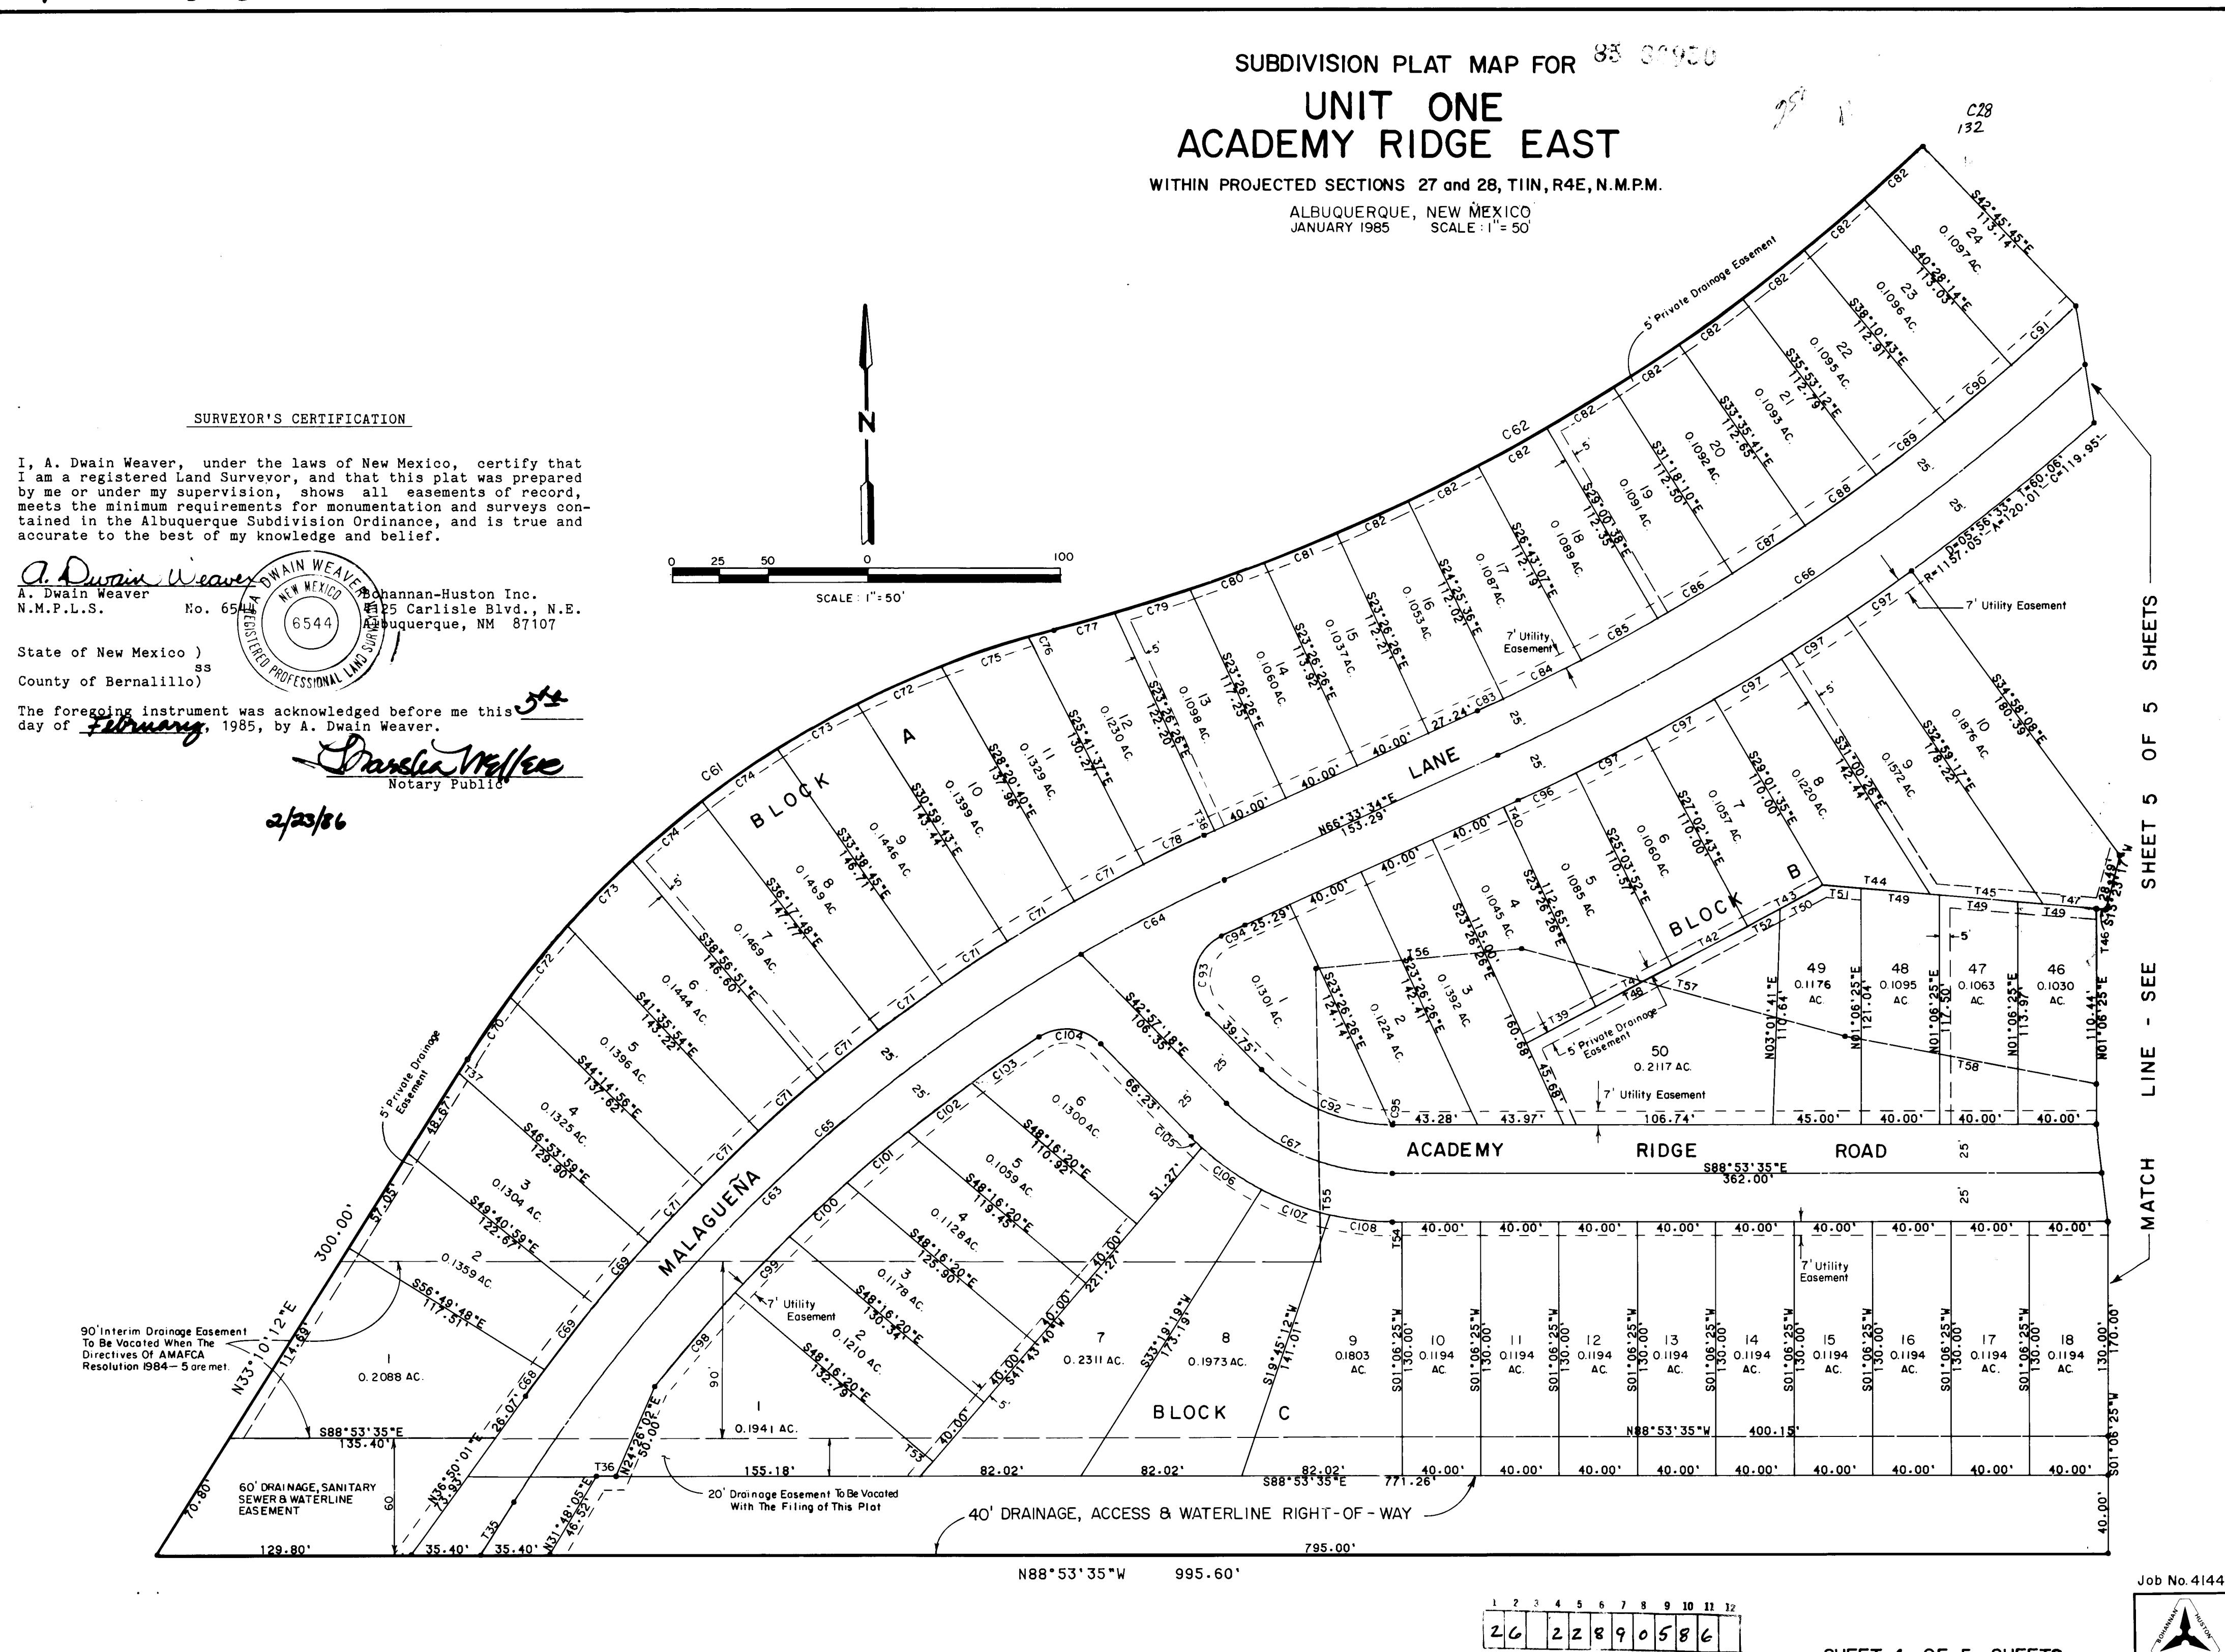

b No. 41442

SHEET 4 OF 5 SHEETS

C 28-132-4

PROJECT NUMBER SHEET OF
2289 5 19

S-28-132-5




SUBDIVISION PLAT MAP FOR
UNIT ONE
ACADEMY RIDGE EAST

WITHIN PROJECTED SECTIONS 27 and 28, T11N, R4E, N.M.P.M.

ALBUQUERQUE, NEW MEXICO
JANUARY 1985

SCALE: 1" = 50'



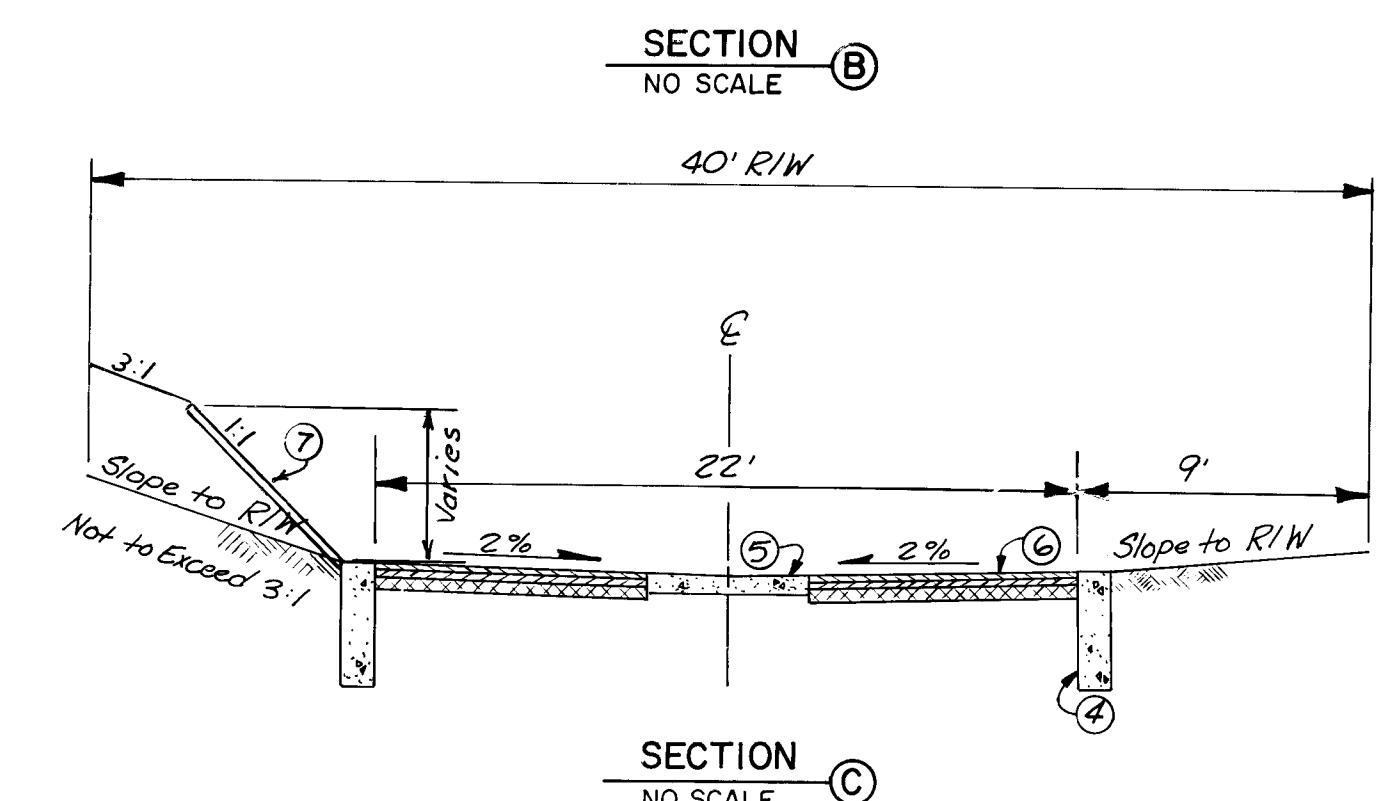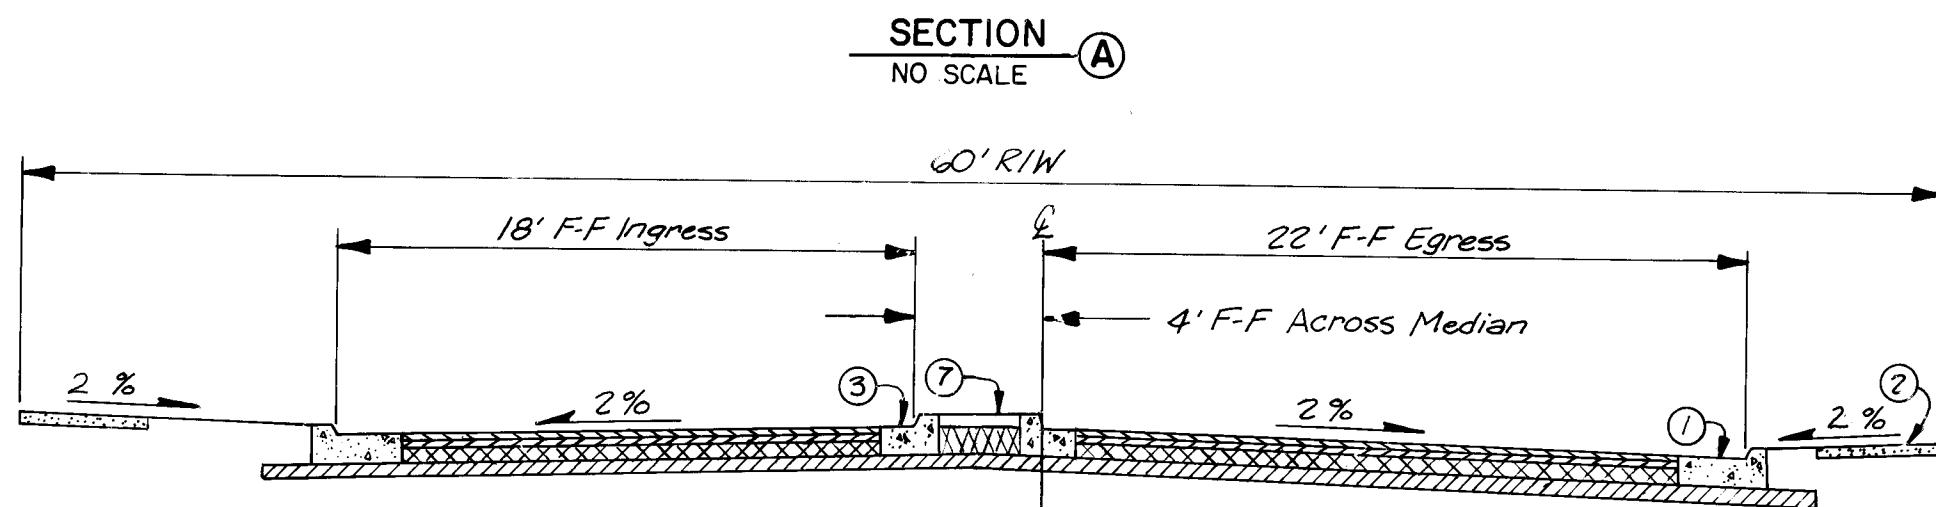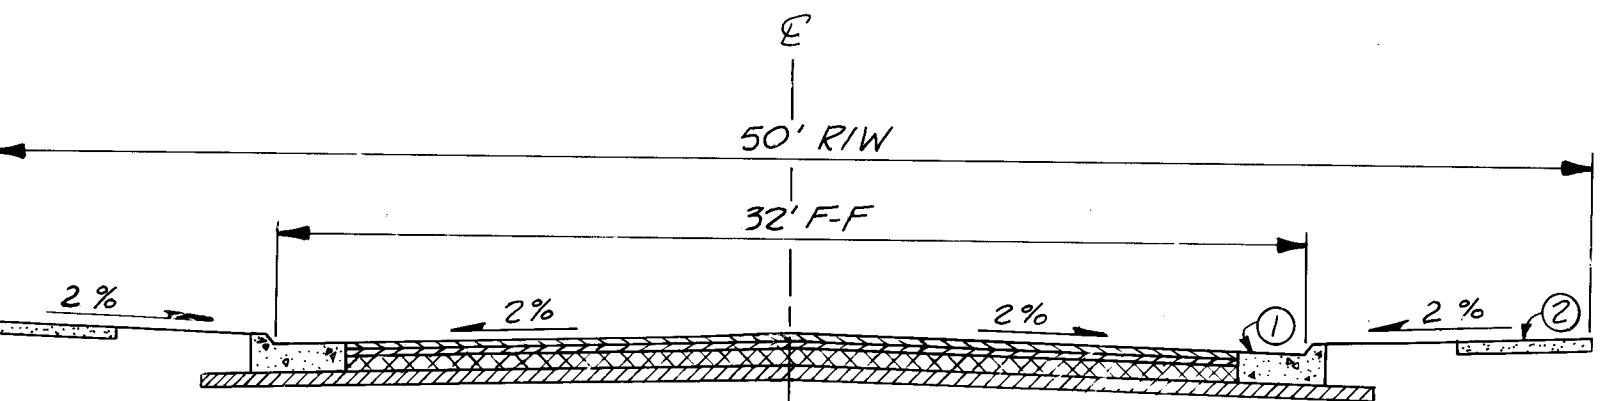


PAVEMENT SECTION
NO SCALE

-1/2" Surface Course, 1500 LBS. Stability
Tack Coat
-1/2" Surface Course, 1500 LBS. Stability
4" Compacted Subbase
6" Compacted Subgrade
(To be considered incidental to Paving Contract Items)


NOTES:

- ① Standard 8" Barrier Curb & Gutter
- ② 4' Sidewalk, 4" Thick (Typ.)
- ③ Standard 6" Median Curb & Gutter
- ④ 6"x18" P.C.C. Header Curb
- ⑤ Standard Alley Gutter
- ⑥ All Streets & Alleys Use Standard Residential Pavement Section
- ⑦ 4" thick Patterned Concrete, 4"x8" Running Bond Brick
Baja Red Davis 160 or Engineer Approved Equivalent
See City of Albuquerque Public Works Contract, Section 346
for Specifications.

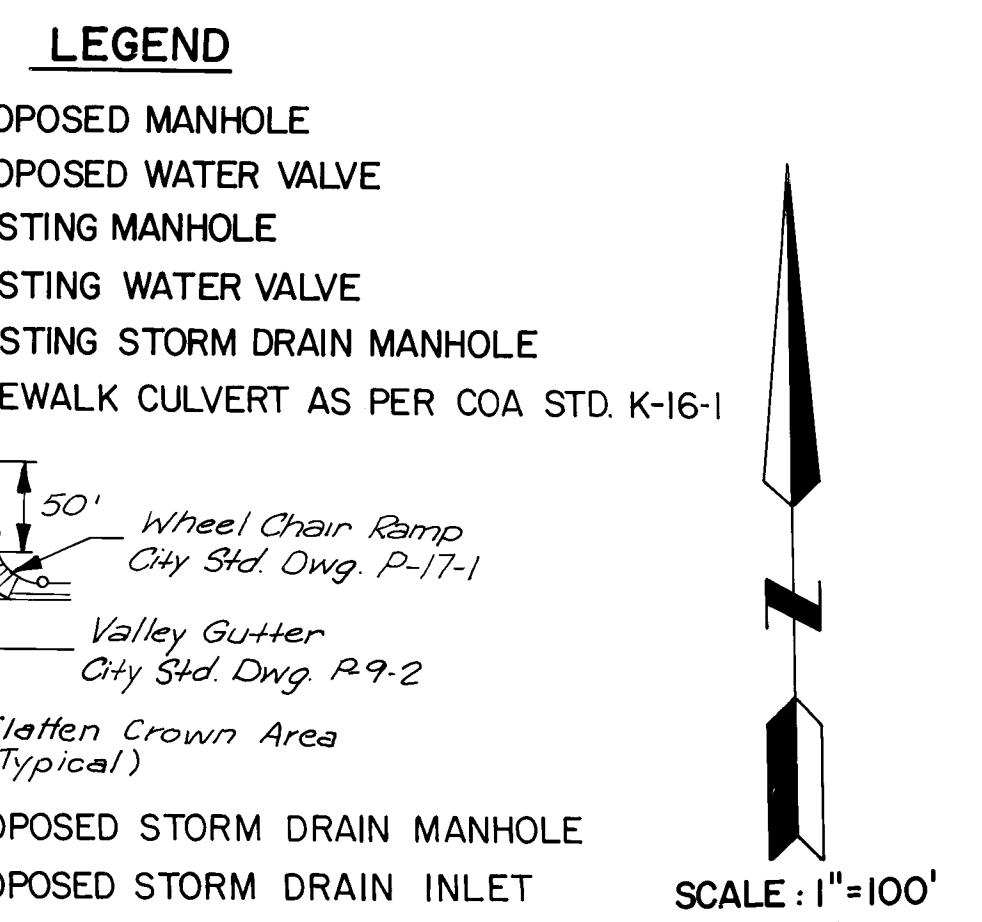

NOTES:

- 1) All Curb Return Radii Shall Be 25' Unless Otherwise Specified.
- 2) Shaded Sidewalks and Only WheelChair Ramps to be Constructed Under Project 2289. Unshaded Sidewalks are not a Part of This Work Order.
- 3) All Phases of This Project are to be Coordinated with SAD - 205.
- 4) The Contractor is to Field Verify All Existing Utility Locations and Notify the Engineer Immediately of Any Discrepancies.

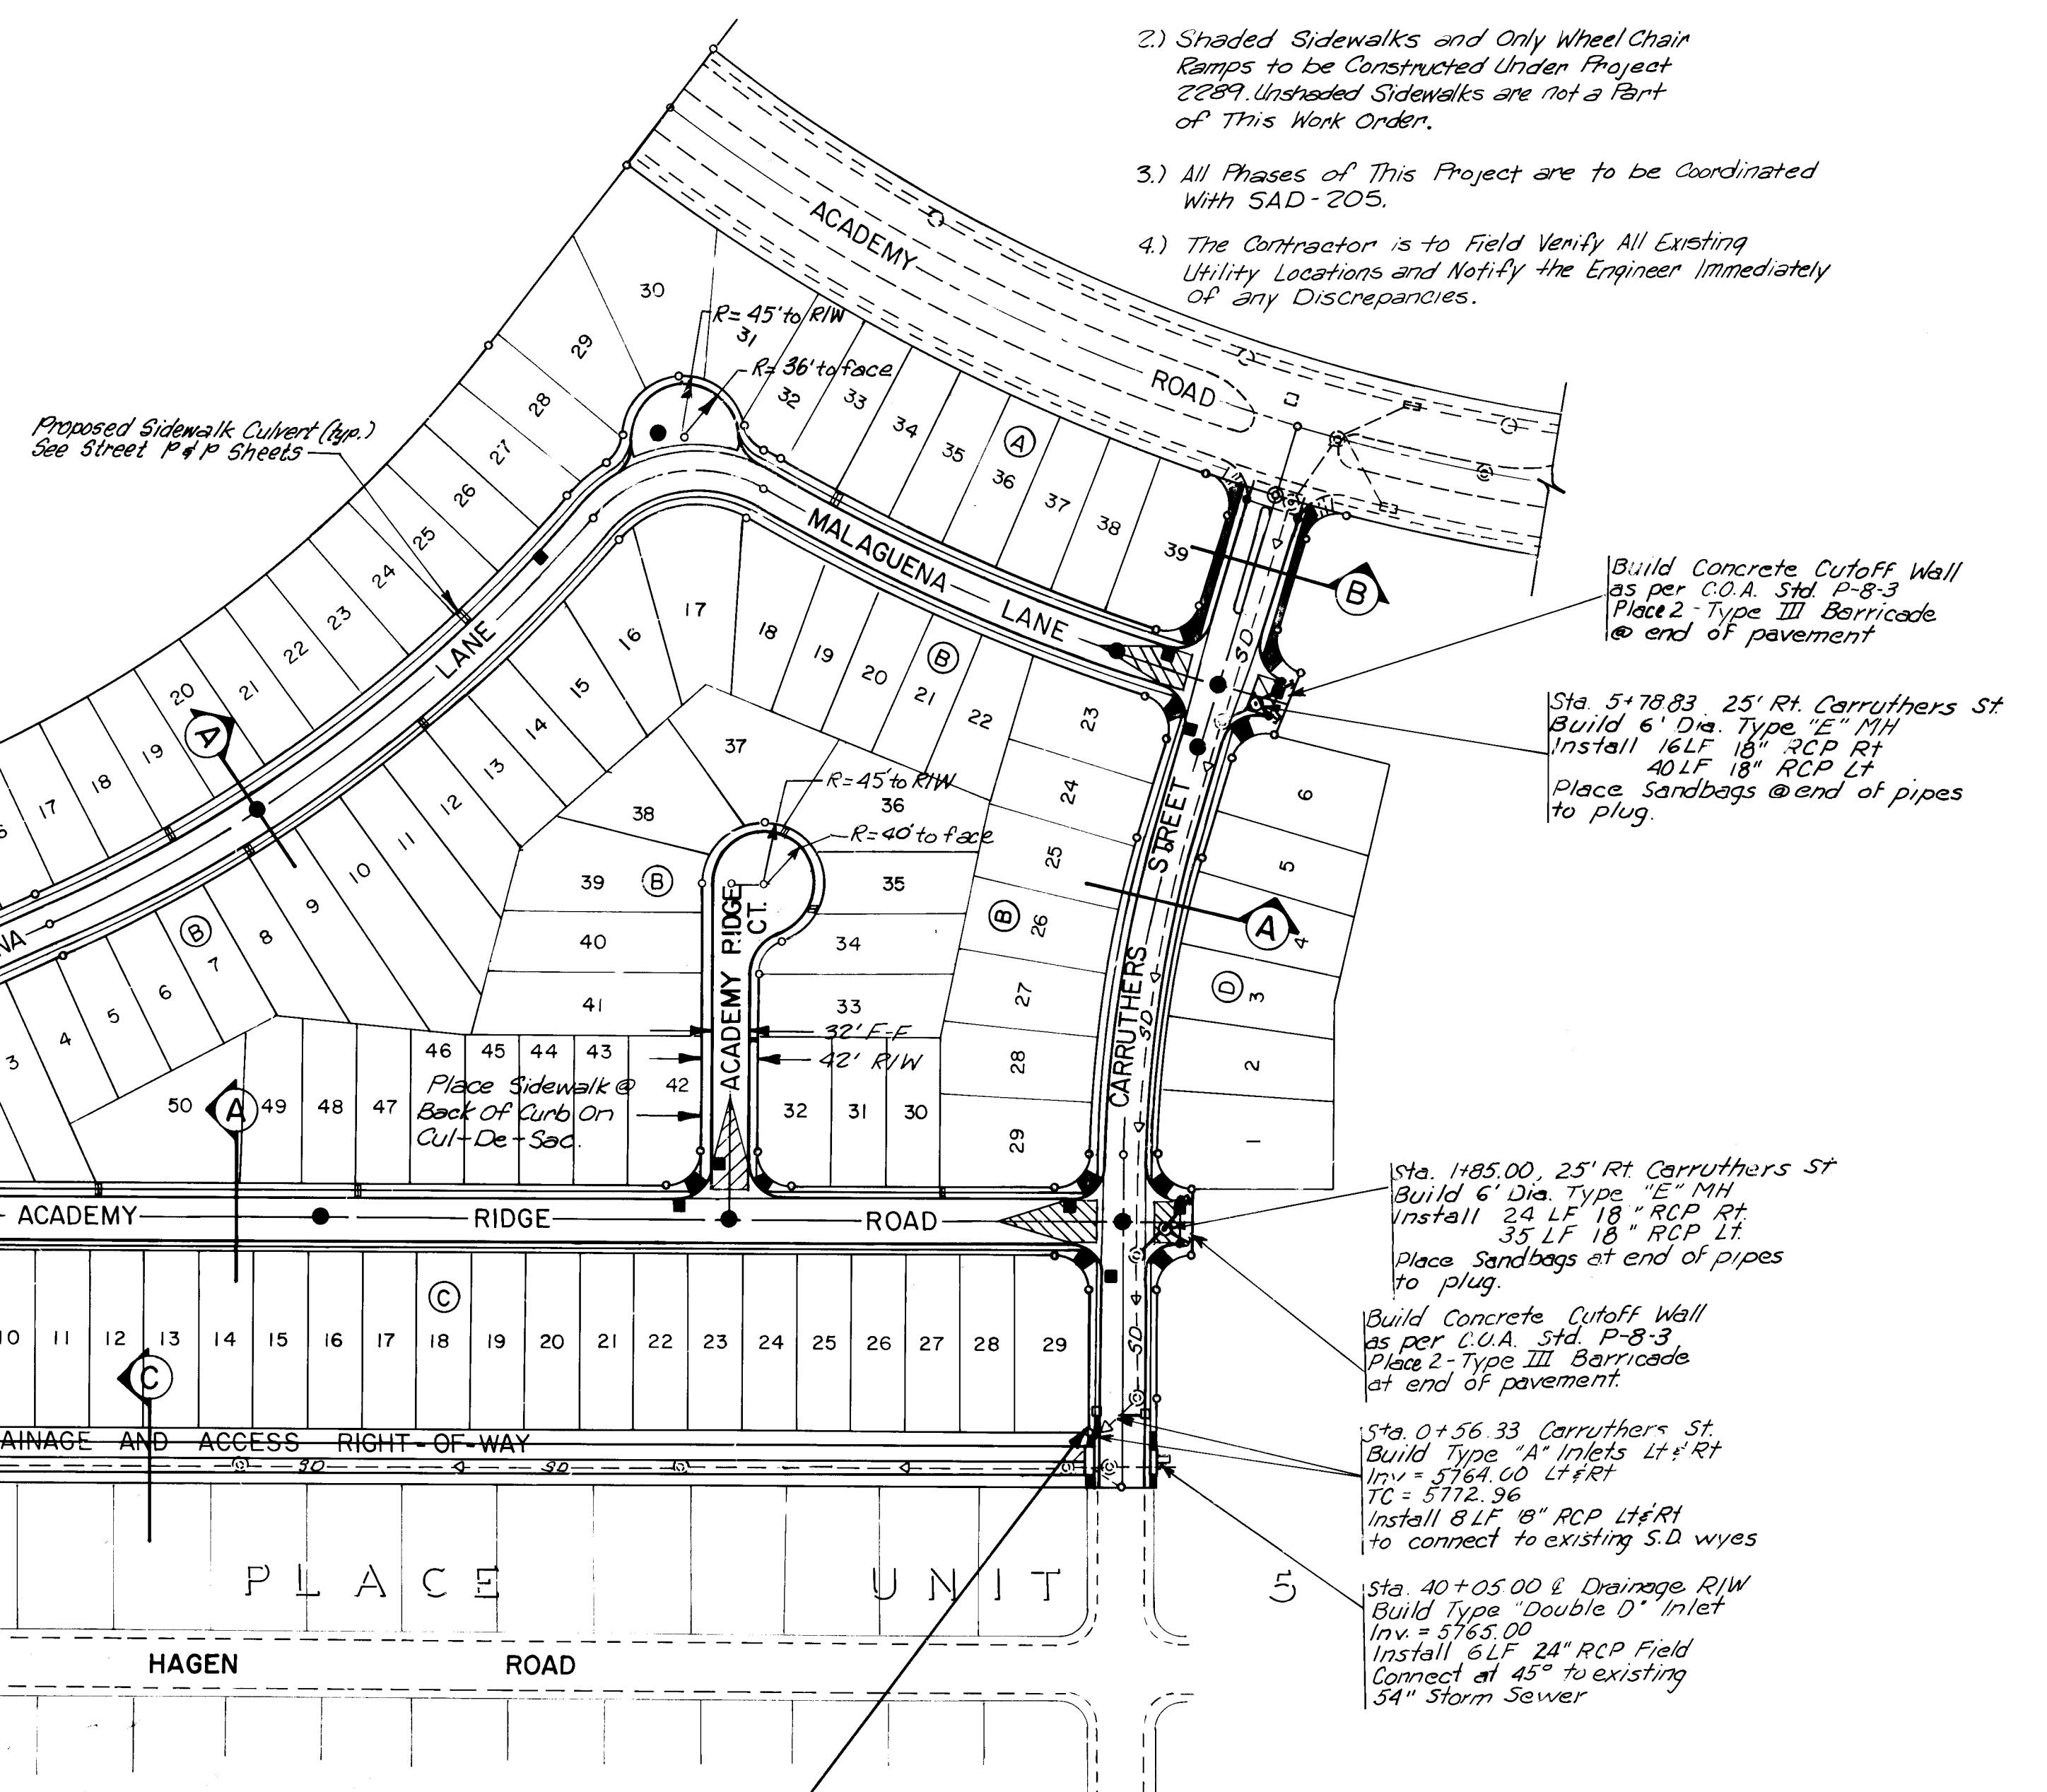

SEE TRANSITION DETAIL
SHEET 18 OF 18

Note:
This existing storm sewer inlet with associated training ditch and desilting basin shall not be altered or destroyed, nor shall any paving be completed until all proposed storm sewer improvements are completed and functioning on Malaguena Lane.

NOTE:
SEE SHEET 18 OF 18 FOR
STORM DRAINAGE DETAILS

AS BUILT INFORMATION		BENCH MARKS
		Elev 5934.53
		Location is 1/2 miles East of the Intersection of Academy Rd N.E. & Eubank Blvd, N.E.
		Station is then 375' South on the South Arm of the Bear Canyon Tributary.
FIELD NOTES	BY	
DATE		
INSTRUMENT USED: KCC Inc.		
INSTRUMENT CALIBRATED DATE: 1/1/85		
DRAWINGS CORRECTED BY: Micro Film		
MICRO FILM INFORMATION		
RECORDED BY: N/A		

John Scott
5-23-85




RECORD DRAWINGS
DATE 12/85

CITY OF ALBUQUERQUE
MUNICIPAL DEVELOPMENT DEPARTMENT
ENGINEERING DIVISION

TITLE: ACADEMY RIDGE EAST PHASE I
STREET PAVING LAYOUT

APPROVALS	ENGINEER	DATE	APPROVALS	ENGINEER	DATE
City Engineer	John Scott	6/17/85	Liquid Waste	William L. Scott	6/17/85
ACE-Design	John Scott	6/17/85	Traffic	John Scott	6/17/85
Hydrology	N.A. B.A.	6/20/85	Water	John Scott	6/20/85

DRAWING NO. 2289 MAP NO. E-21 SHEET 7 OF 19

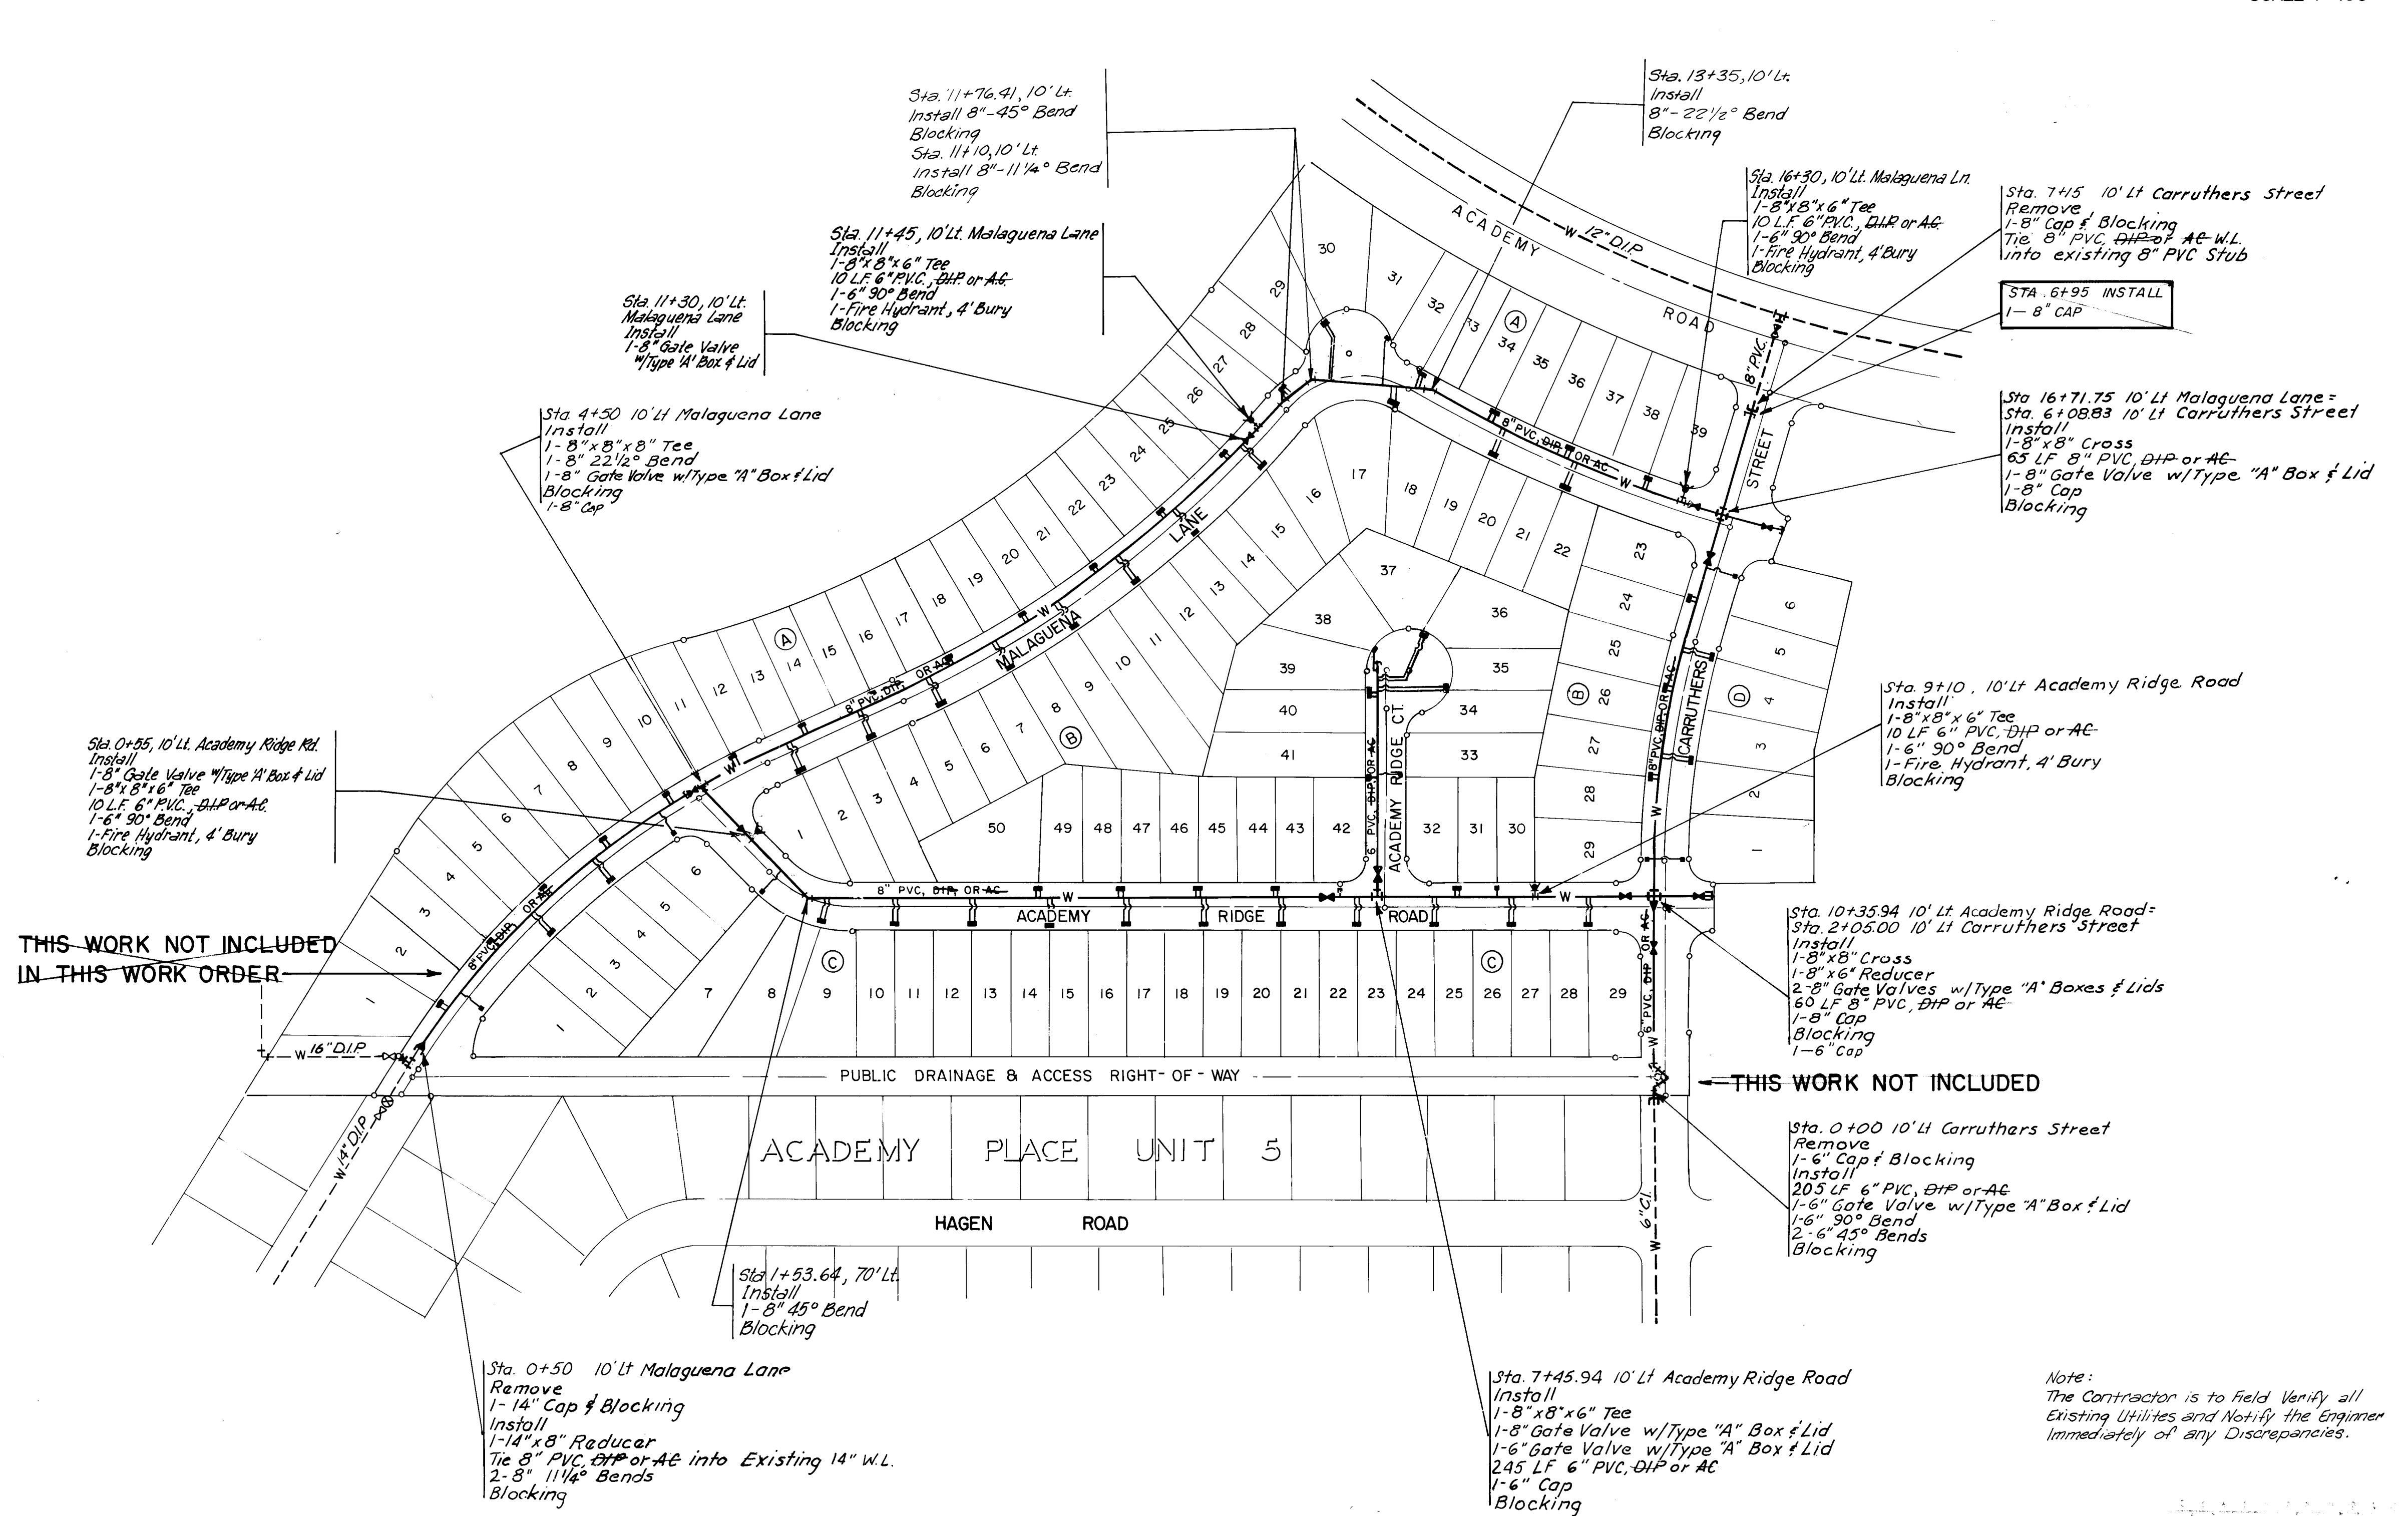

Note:
The Contractor is to Field Verify all
existing Utilities and Notify the Engineer
immediately of any Discrepancies.

6 22890886

ENGINEER'S SEAL		SURVEY INFORMATION		BENCH MARKS		AS BUILT INFORMATION	
NO.	BY	FIELD NOTES	DATE	Elev.	Location	Contractor	Date
2	9/9/85	<u>ADDED SHT. 19 & REMAINING WORK</u>	KLD	53	"6-E22"	C. L. Lee	7/17/85
1	7/23/85	<u>ADDED CURB & GUTTER</u>	KLD		Location is 1.2 miles East of the Intersection of Academy Road N.E. & Eubank Blvd. N.E.	INSPECTOR'S APPROVAL DATE	
NO.	DATE	REMARKS	BY		Station is then 375' South on the South Rim of the Bear Canyon Tributary.	FIELD DRAWINGS DATE	
		REVIZIONS				VERIFICATION BY	
		DESIGN				CORRECTED BY	
						MICRO-FILM INFORMATION	
						RECORDED BY	DATE
						NO	NO

*William L. Lee
REGISTERED PROFESSIONAL ENGINEER
8131 12-31-85*

RECORD DRAWINGS
DATE 12/85


**CITY OF ALBUQUERQUE
MUNICIPAL DEVELOPMENT DEPARTMENT
ENGINEERING DIVISION**

**ACADEMY RIDGE EAST PHASE I
WATER DISTRIBUTION PLAN**

ROLE	ENGINEER	DATE	APPROVALS	ENGINEER	DATE
Designer	R. D. Weeks	6/21/85	Liquid Waste	William J. Babb	5/29/85
Hydrology	N.A. B.G.R.	5/29/85	Traffic	N.A. D. W.H.	5/29/85
			Water	William J. Babb	5/29/85

MAP NO. E-21 SHEET 8 OF 19

2289

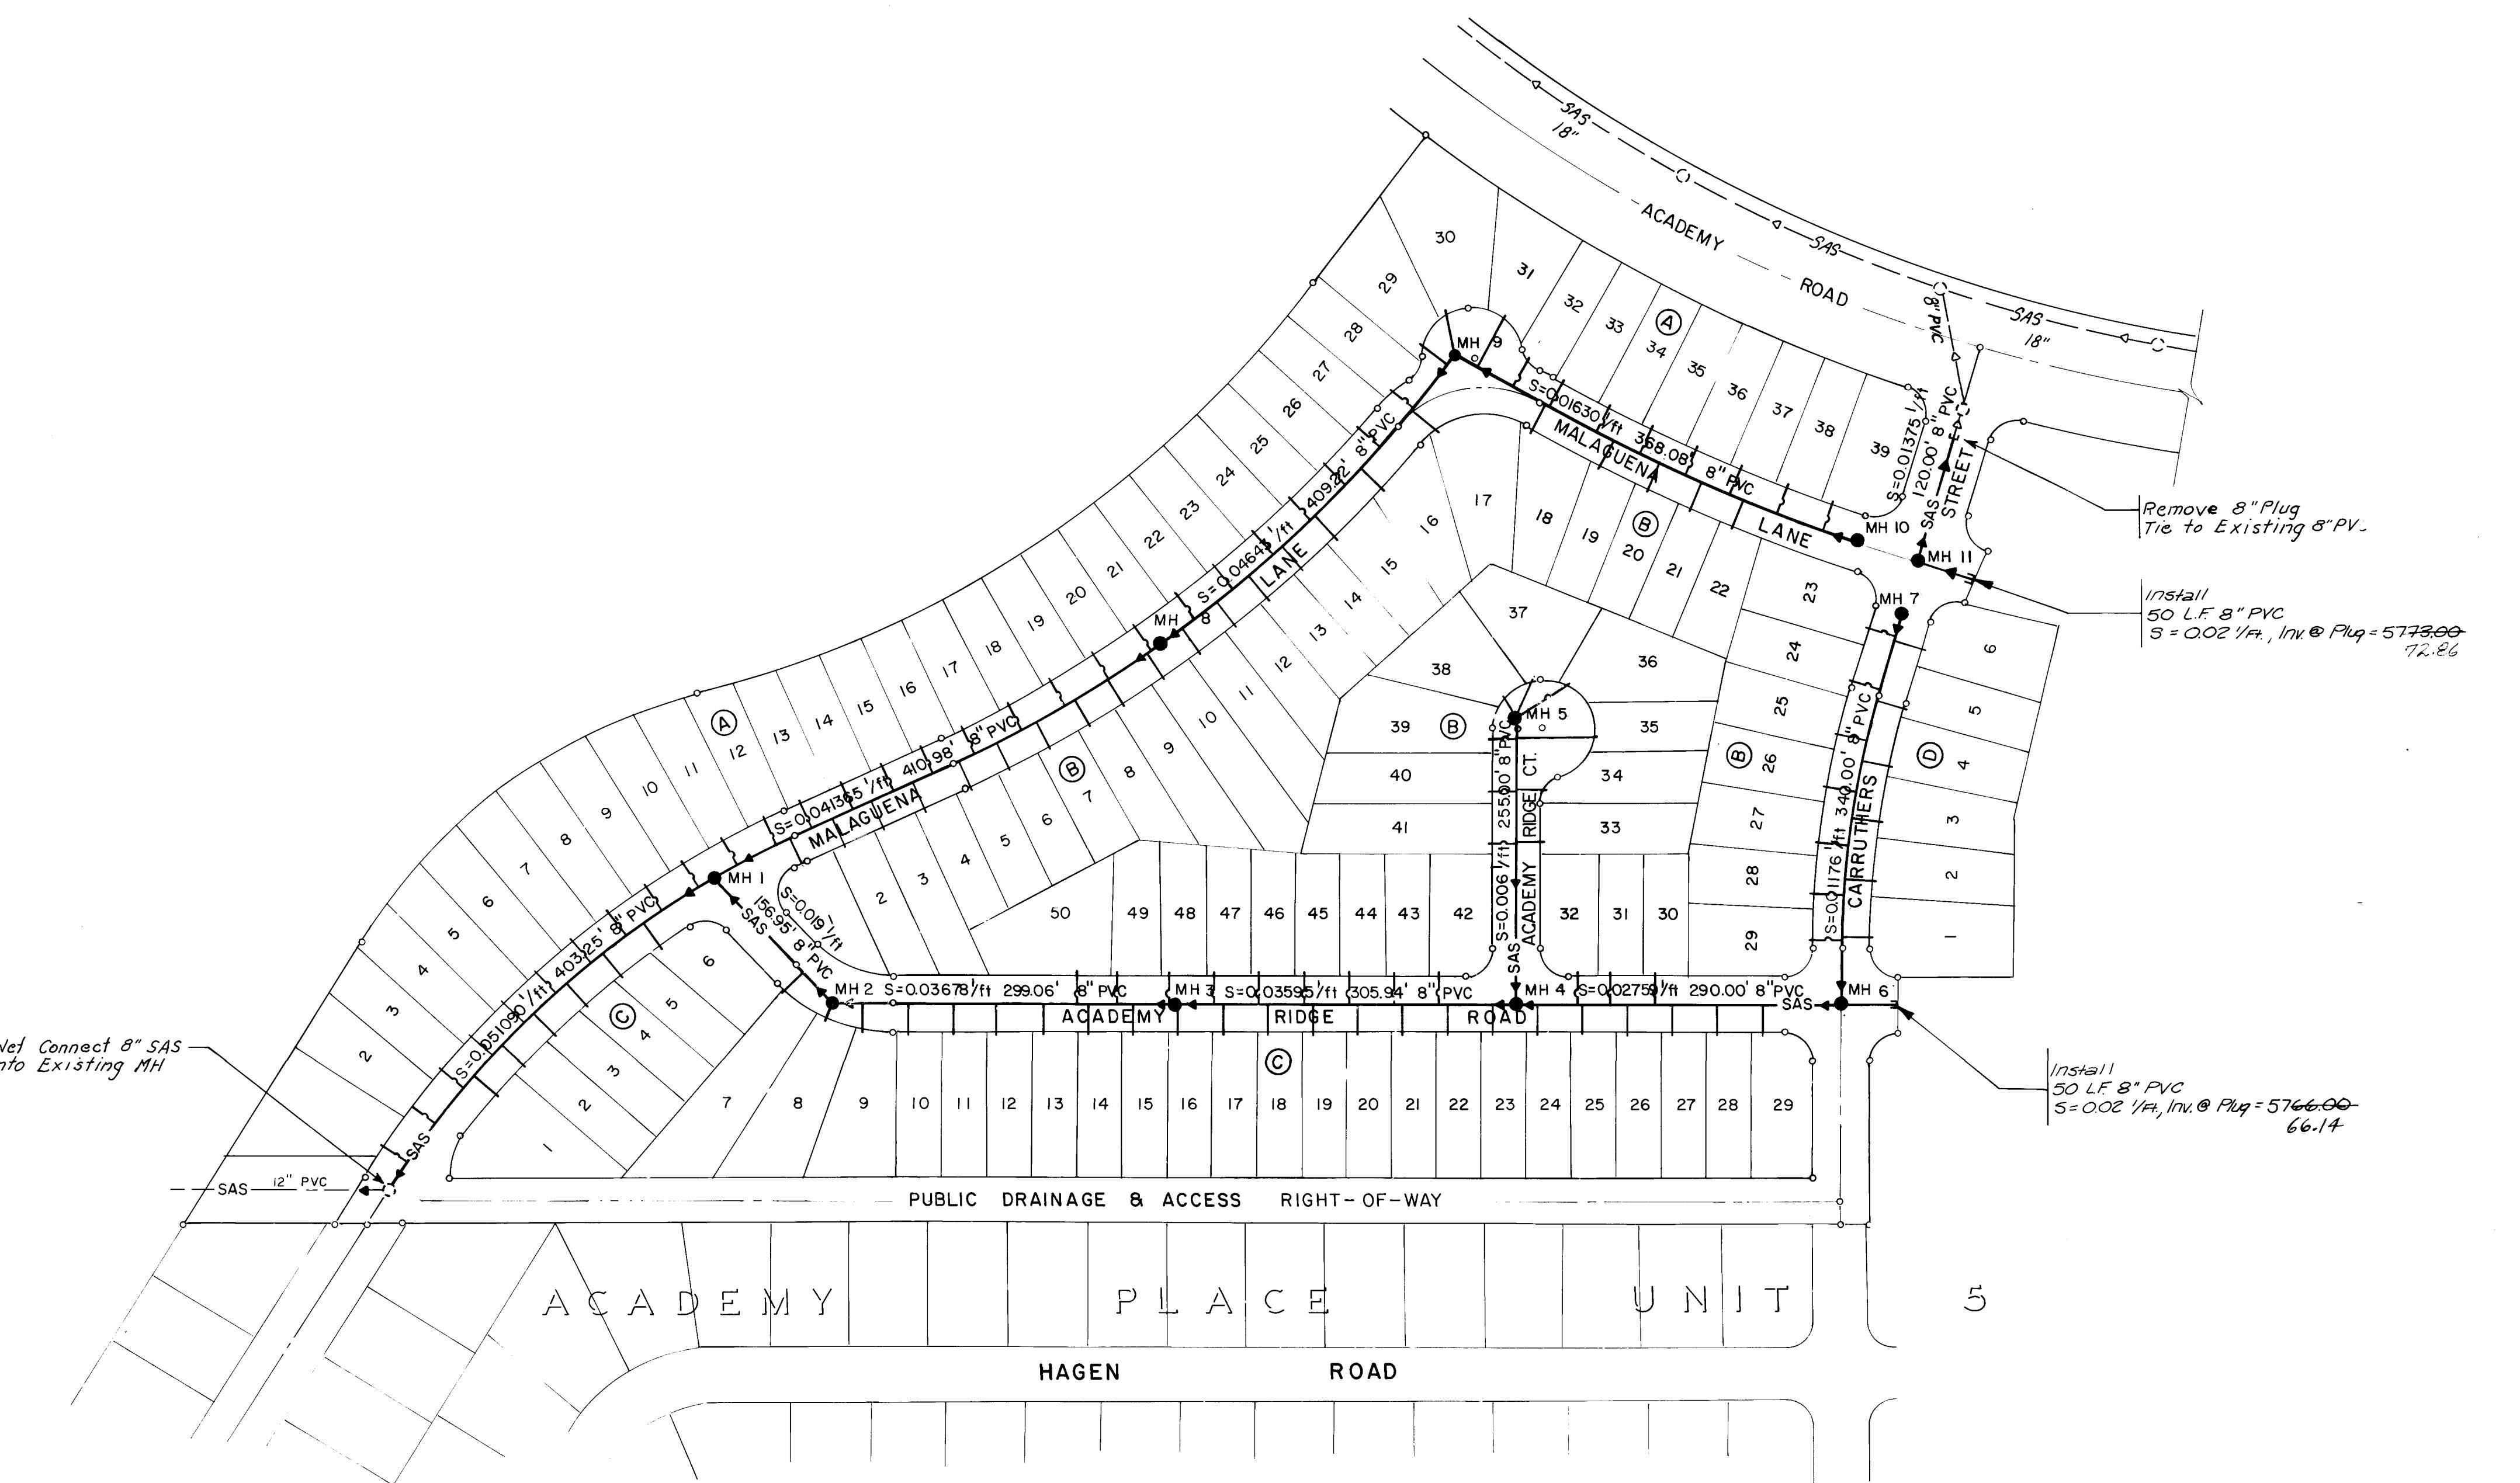

NOTE:
The Contractor is to Field Verify all Existing Utility Locations and Notify the Engineer Immediately of any Discrepancies.

26 22 89 09 86

		CITY OF ALBUQUERQUE MUNICIPAL DEVELOPMENT DEPARTMENT ENGINEERING DIVISION			
TITLE: ACADEMY RIDGE EAST PHASE I SANITARY SEWER PLAN					
APPROVALS City Engineer ACE - Design Hydrology	ENGINEER John [Signature] NA [Signature] NA [Signature]	DATE 6/2/85 6/17/85 6/29/85	APPROVALS Liquid Waste Traffic Water	ENGINEER Williams [Signature] NA DWR Williams & Peeler [Signature]	DATE 5/29/85 5/16/85 5/29/85
DRAWING NO. 2289		MAP NO. E-21	SHEET 9 OF 19		


AS BUILT INFORMATION	
BENCH MARKS	
SURVEY INFORMATION	
FIELD NOTES	
ACB Brass Cap "6-E22" Elev 5934.53	
Location is 1/2 miles East of the intersection of Academy Road NE & Lubank Blvd, NE	
ACCEPTANCE BY City Engineers [Signature]	
VERIFICATION BASED ON DATE [Signature]	
CORRECTED BY [Signature] DATE [Signature]	
MICRO FILM INFORMATION	
RECORDED BY	NO


John Bent


5-23-85

William [Signature]
12-21-85

RECORD DRAWINGS
DATE 12/85

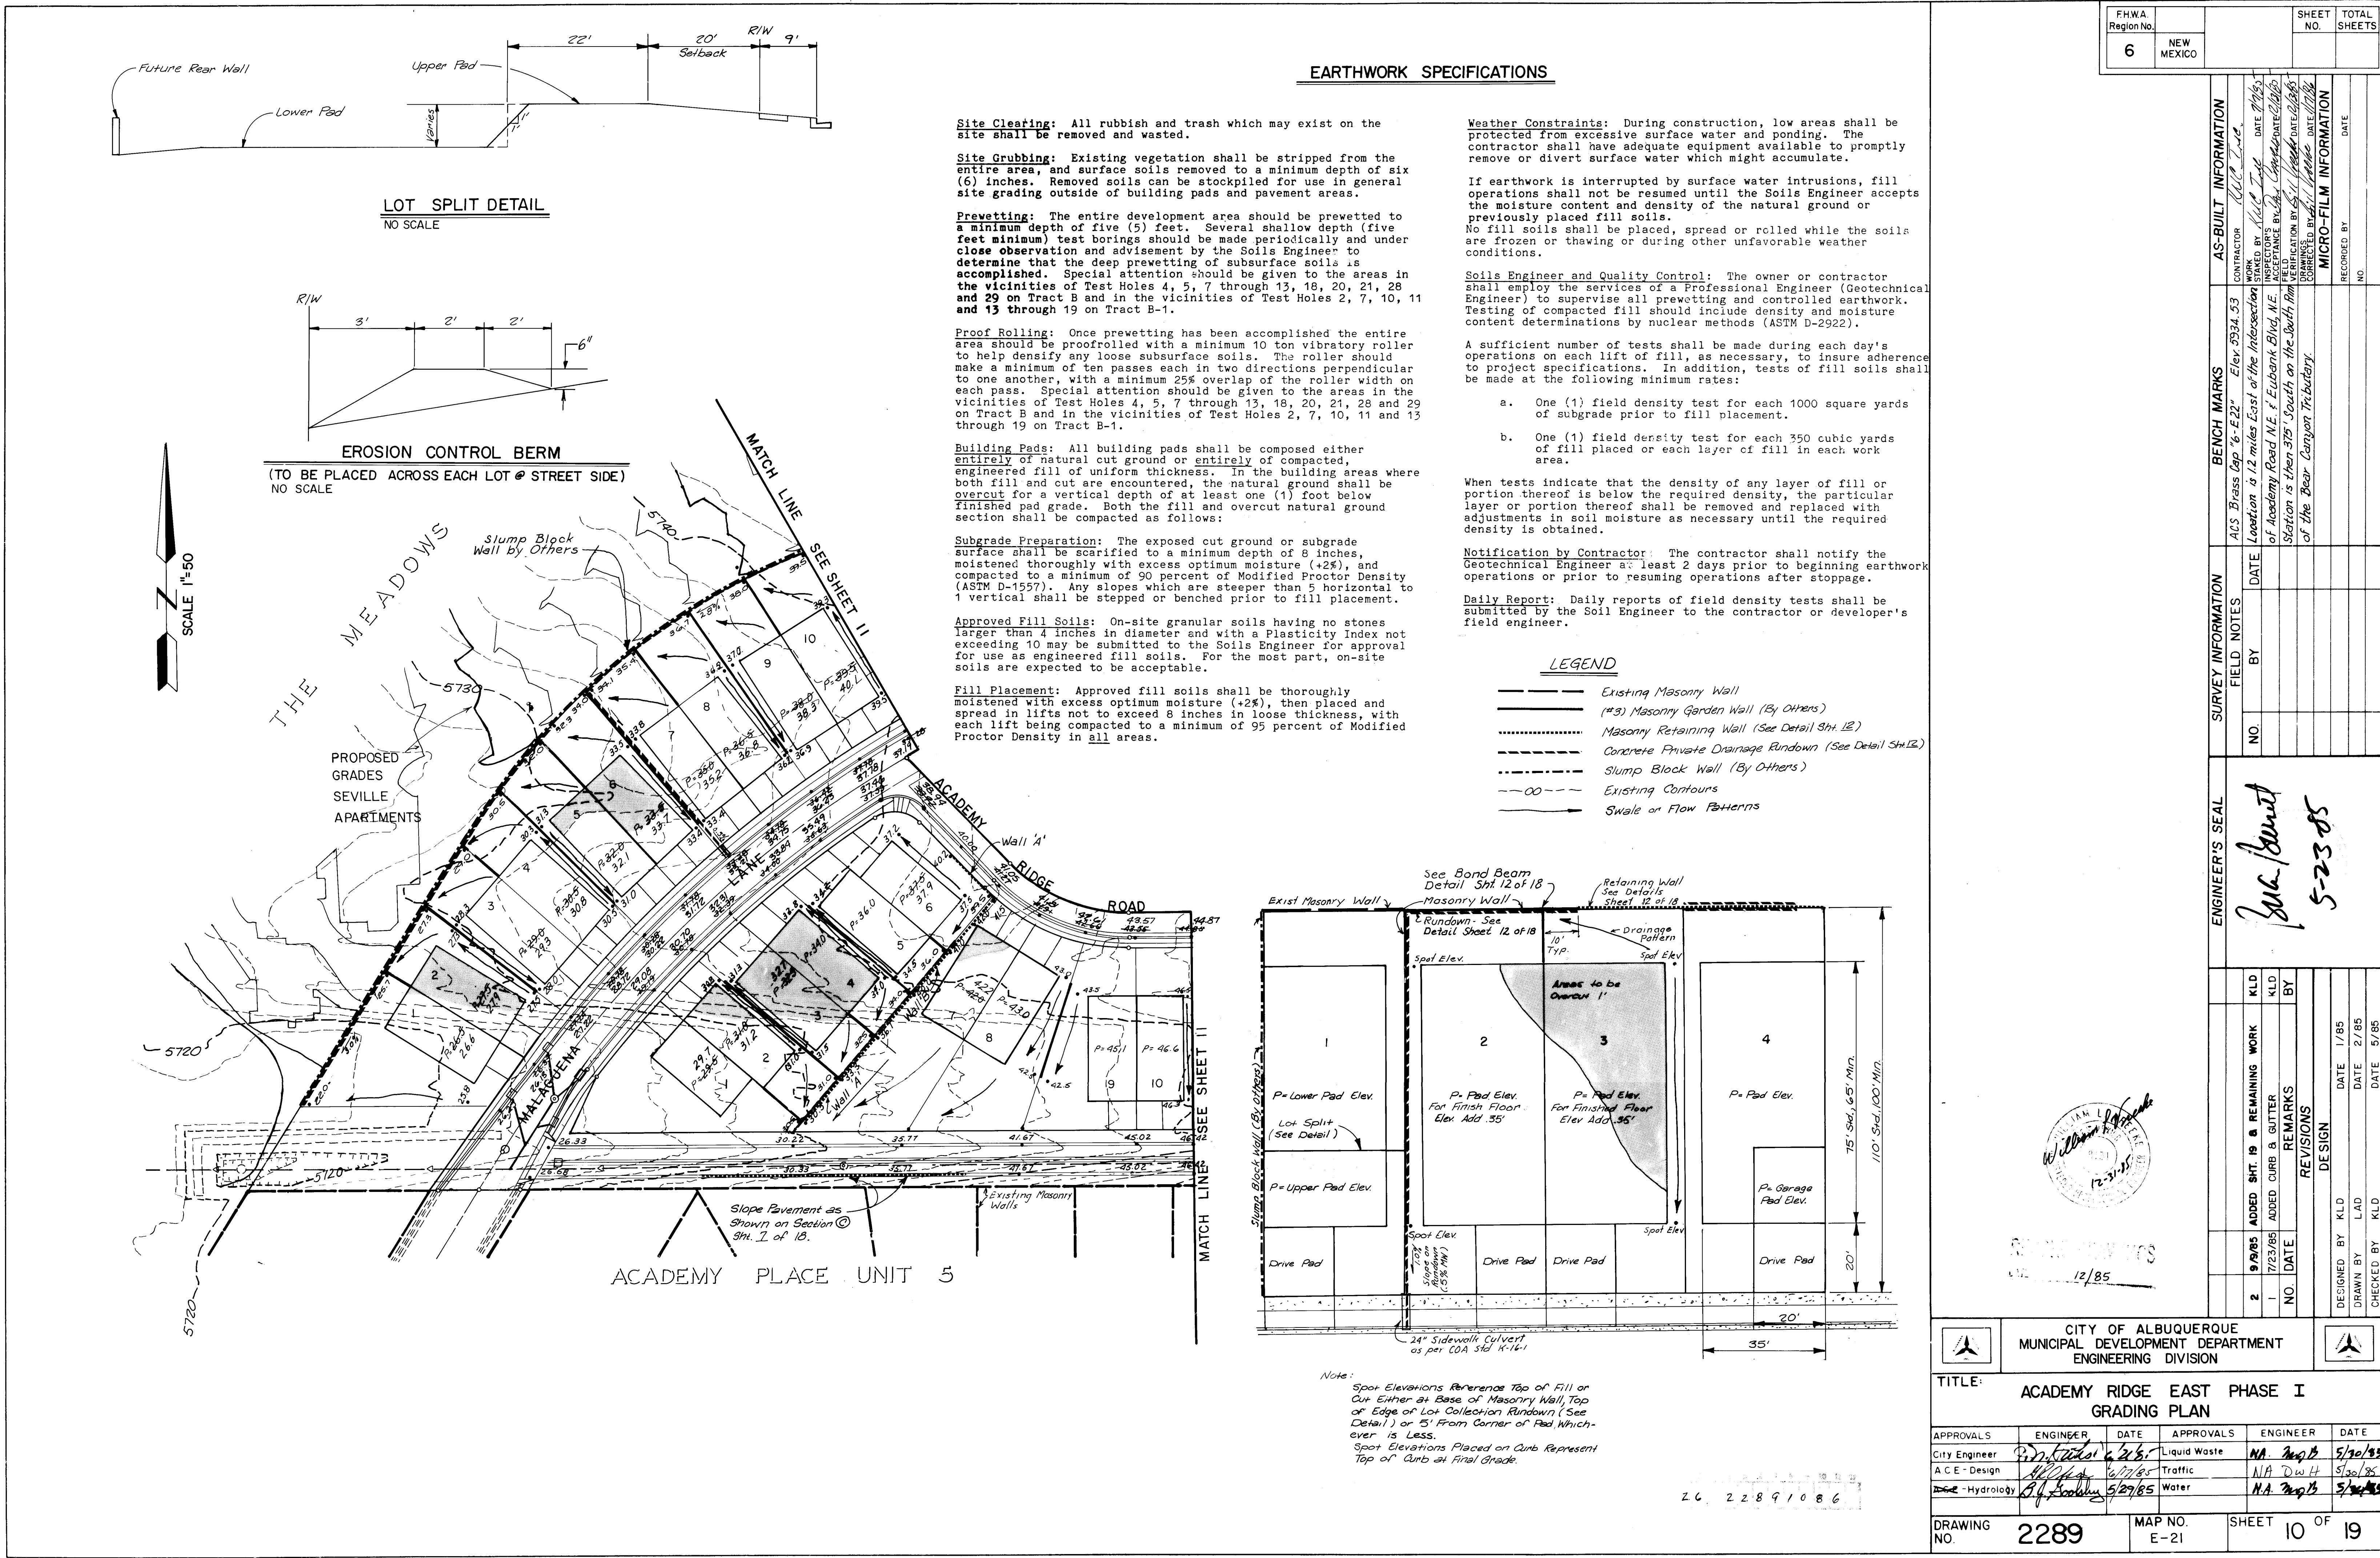


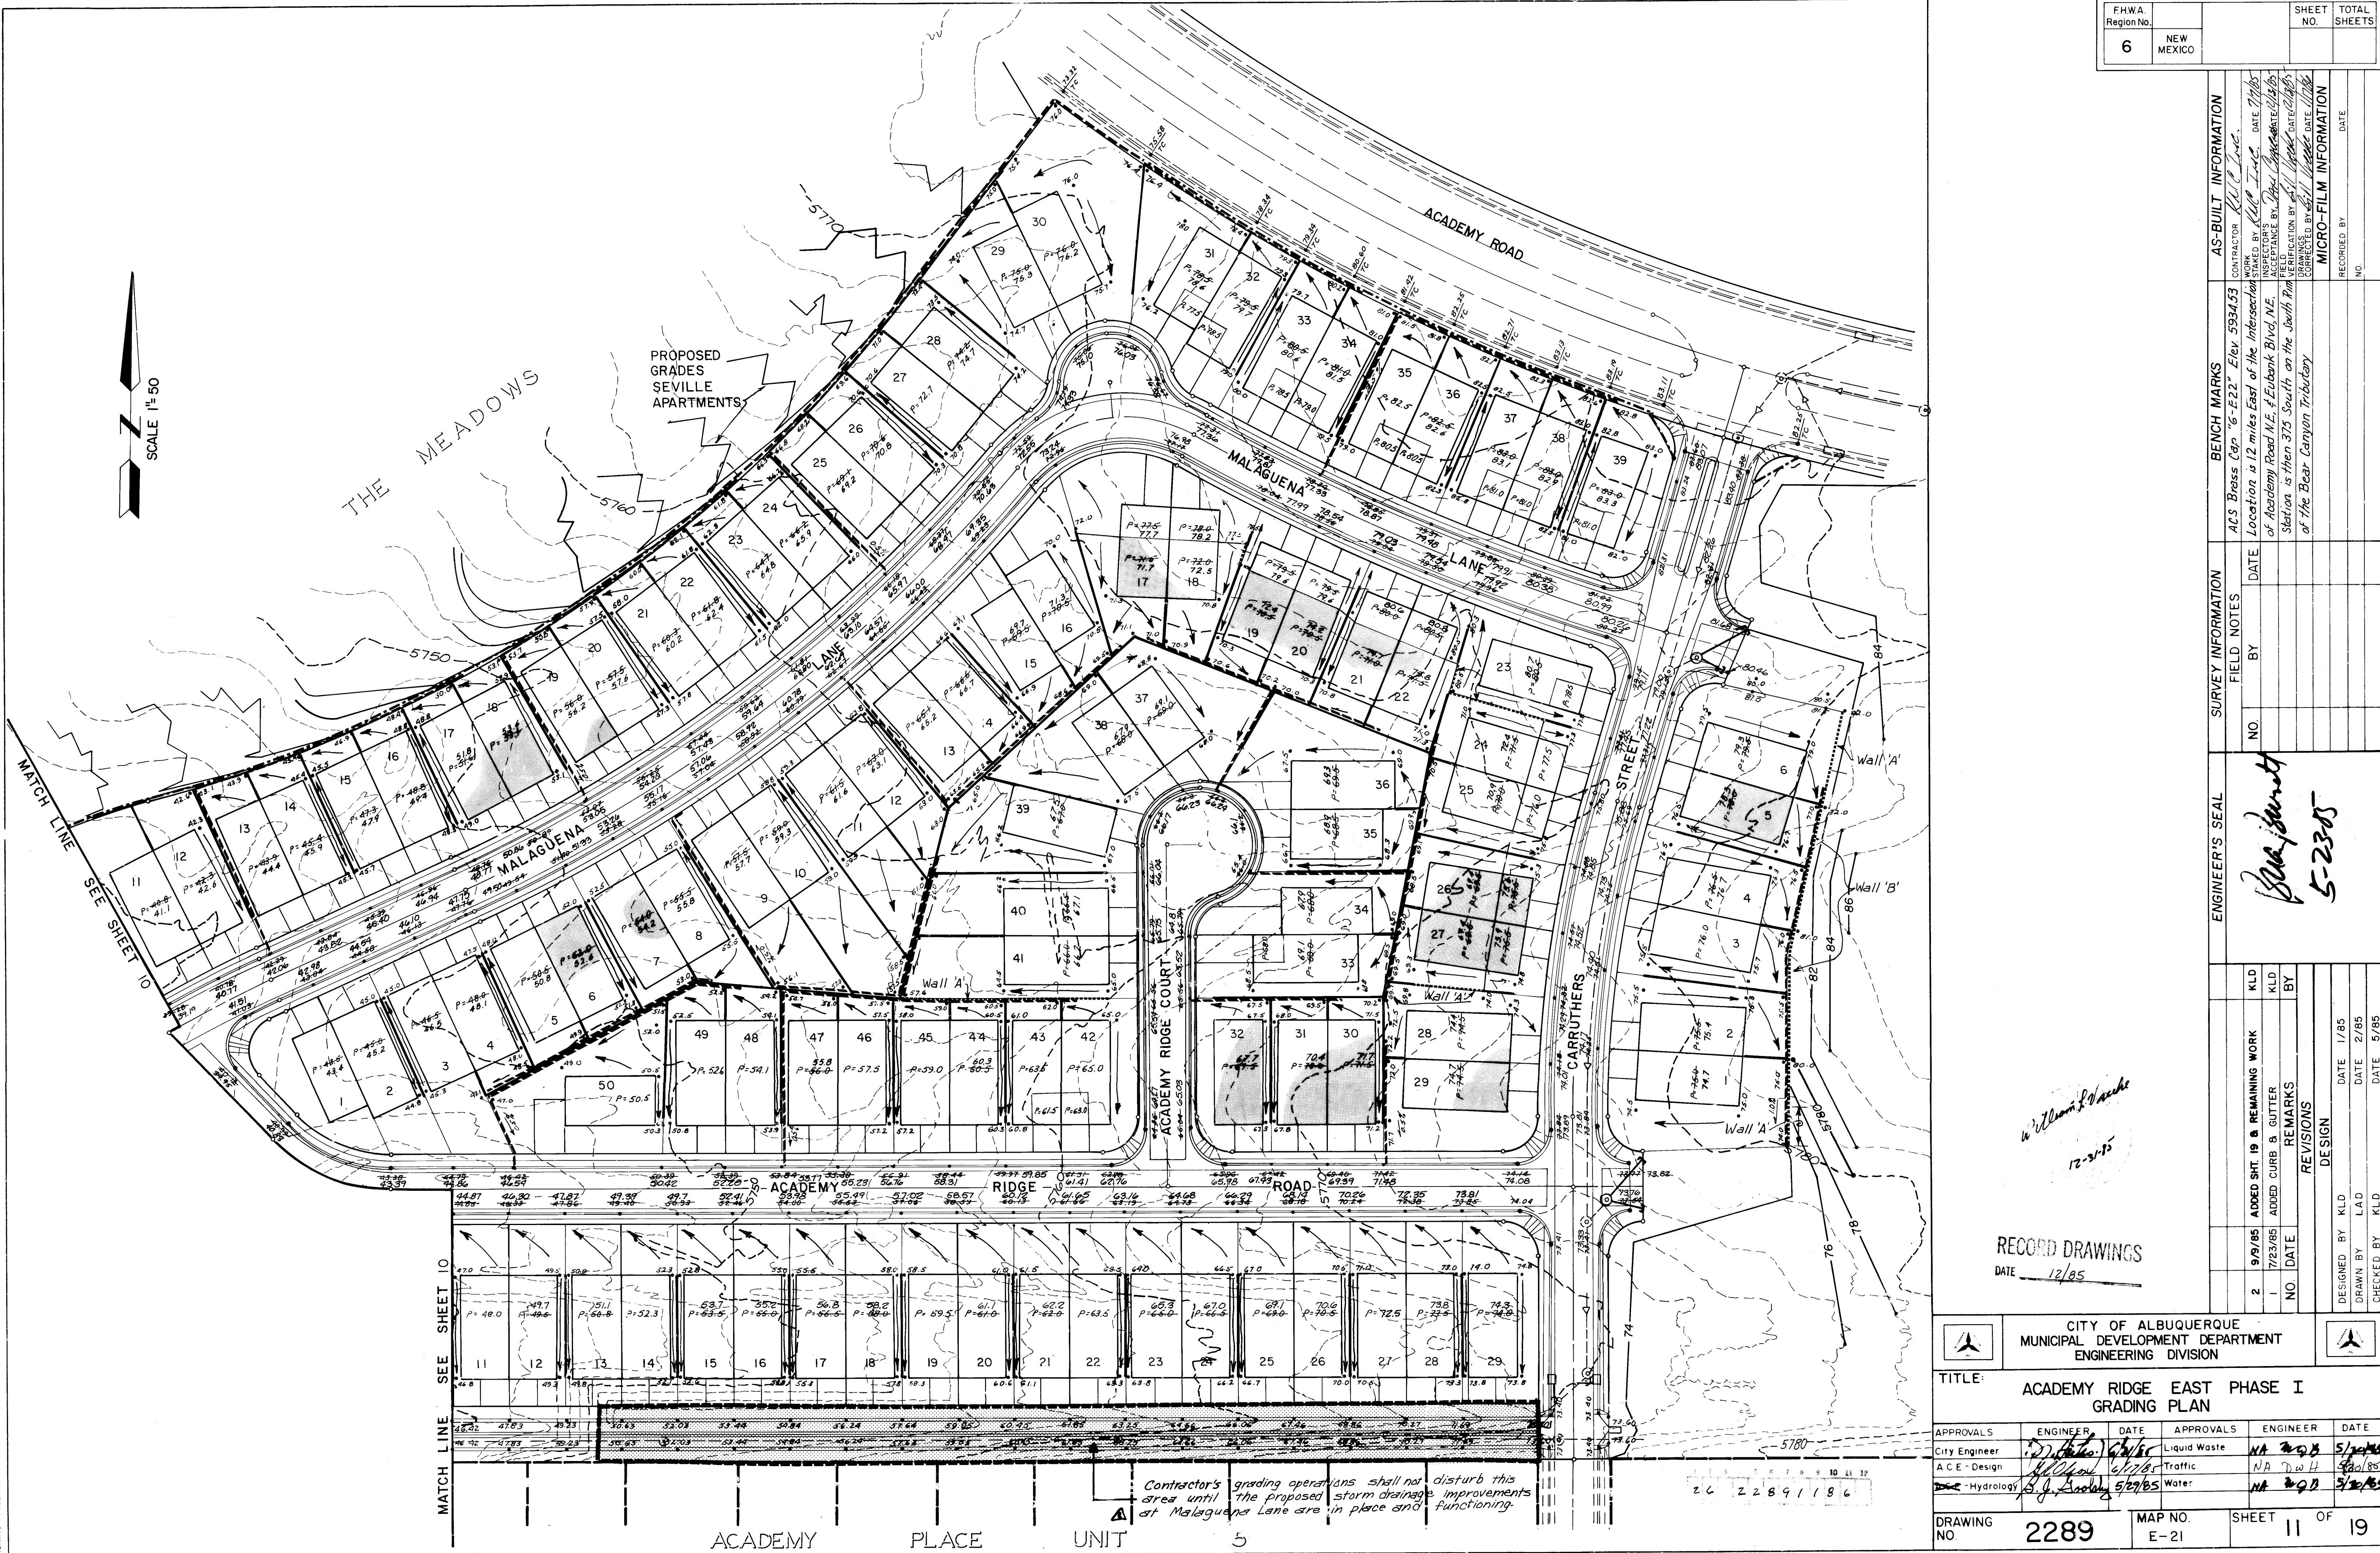

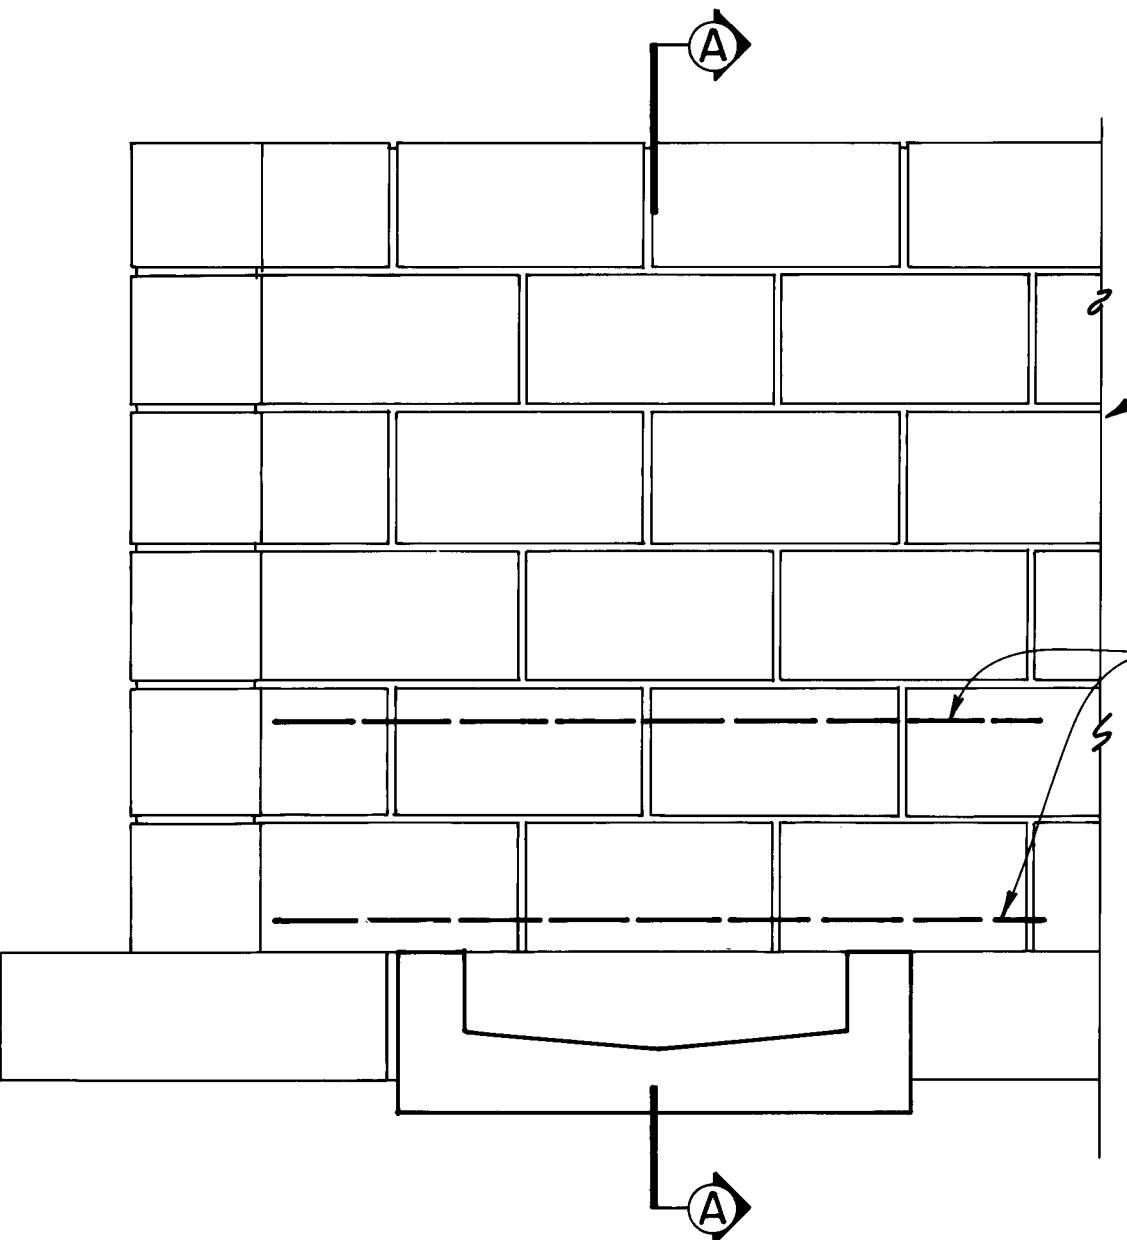


DRAINAGE RUNDOWN PLACEMENT

SECTION A-A

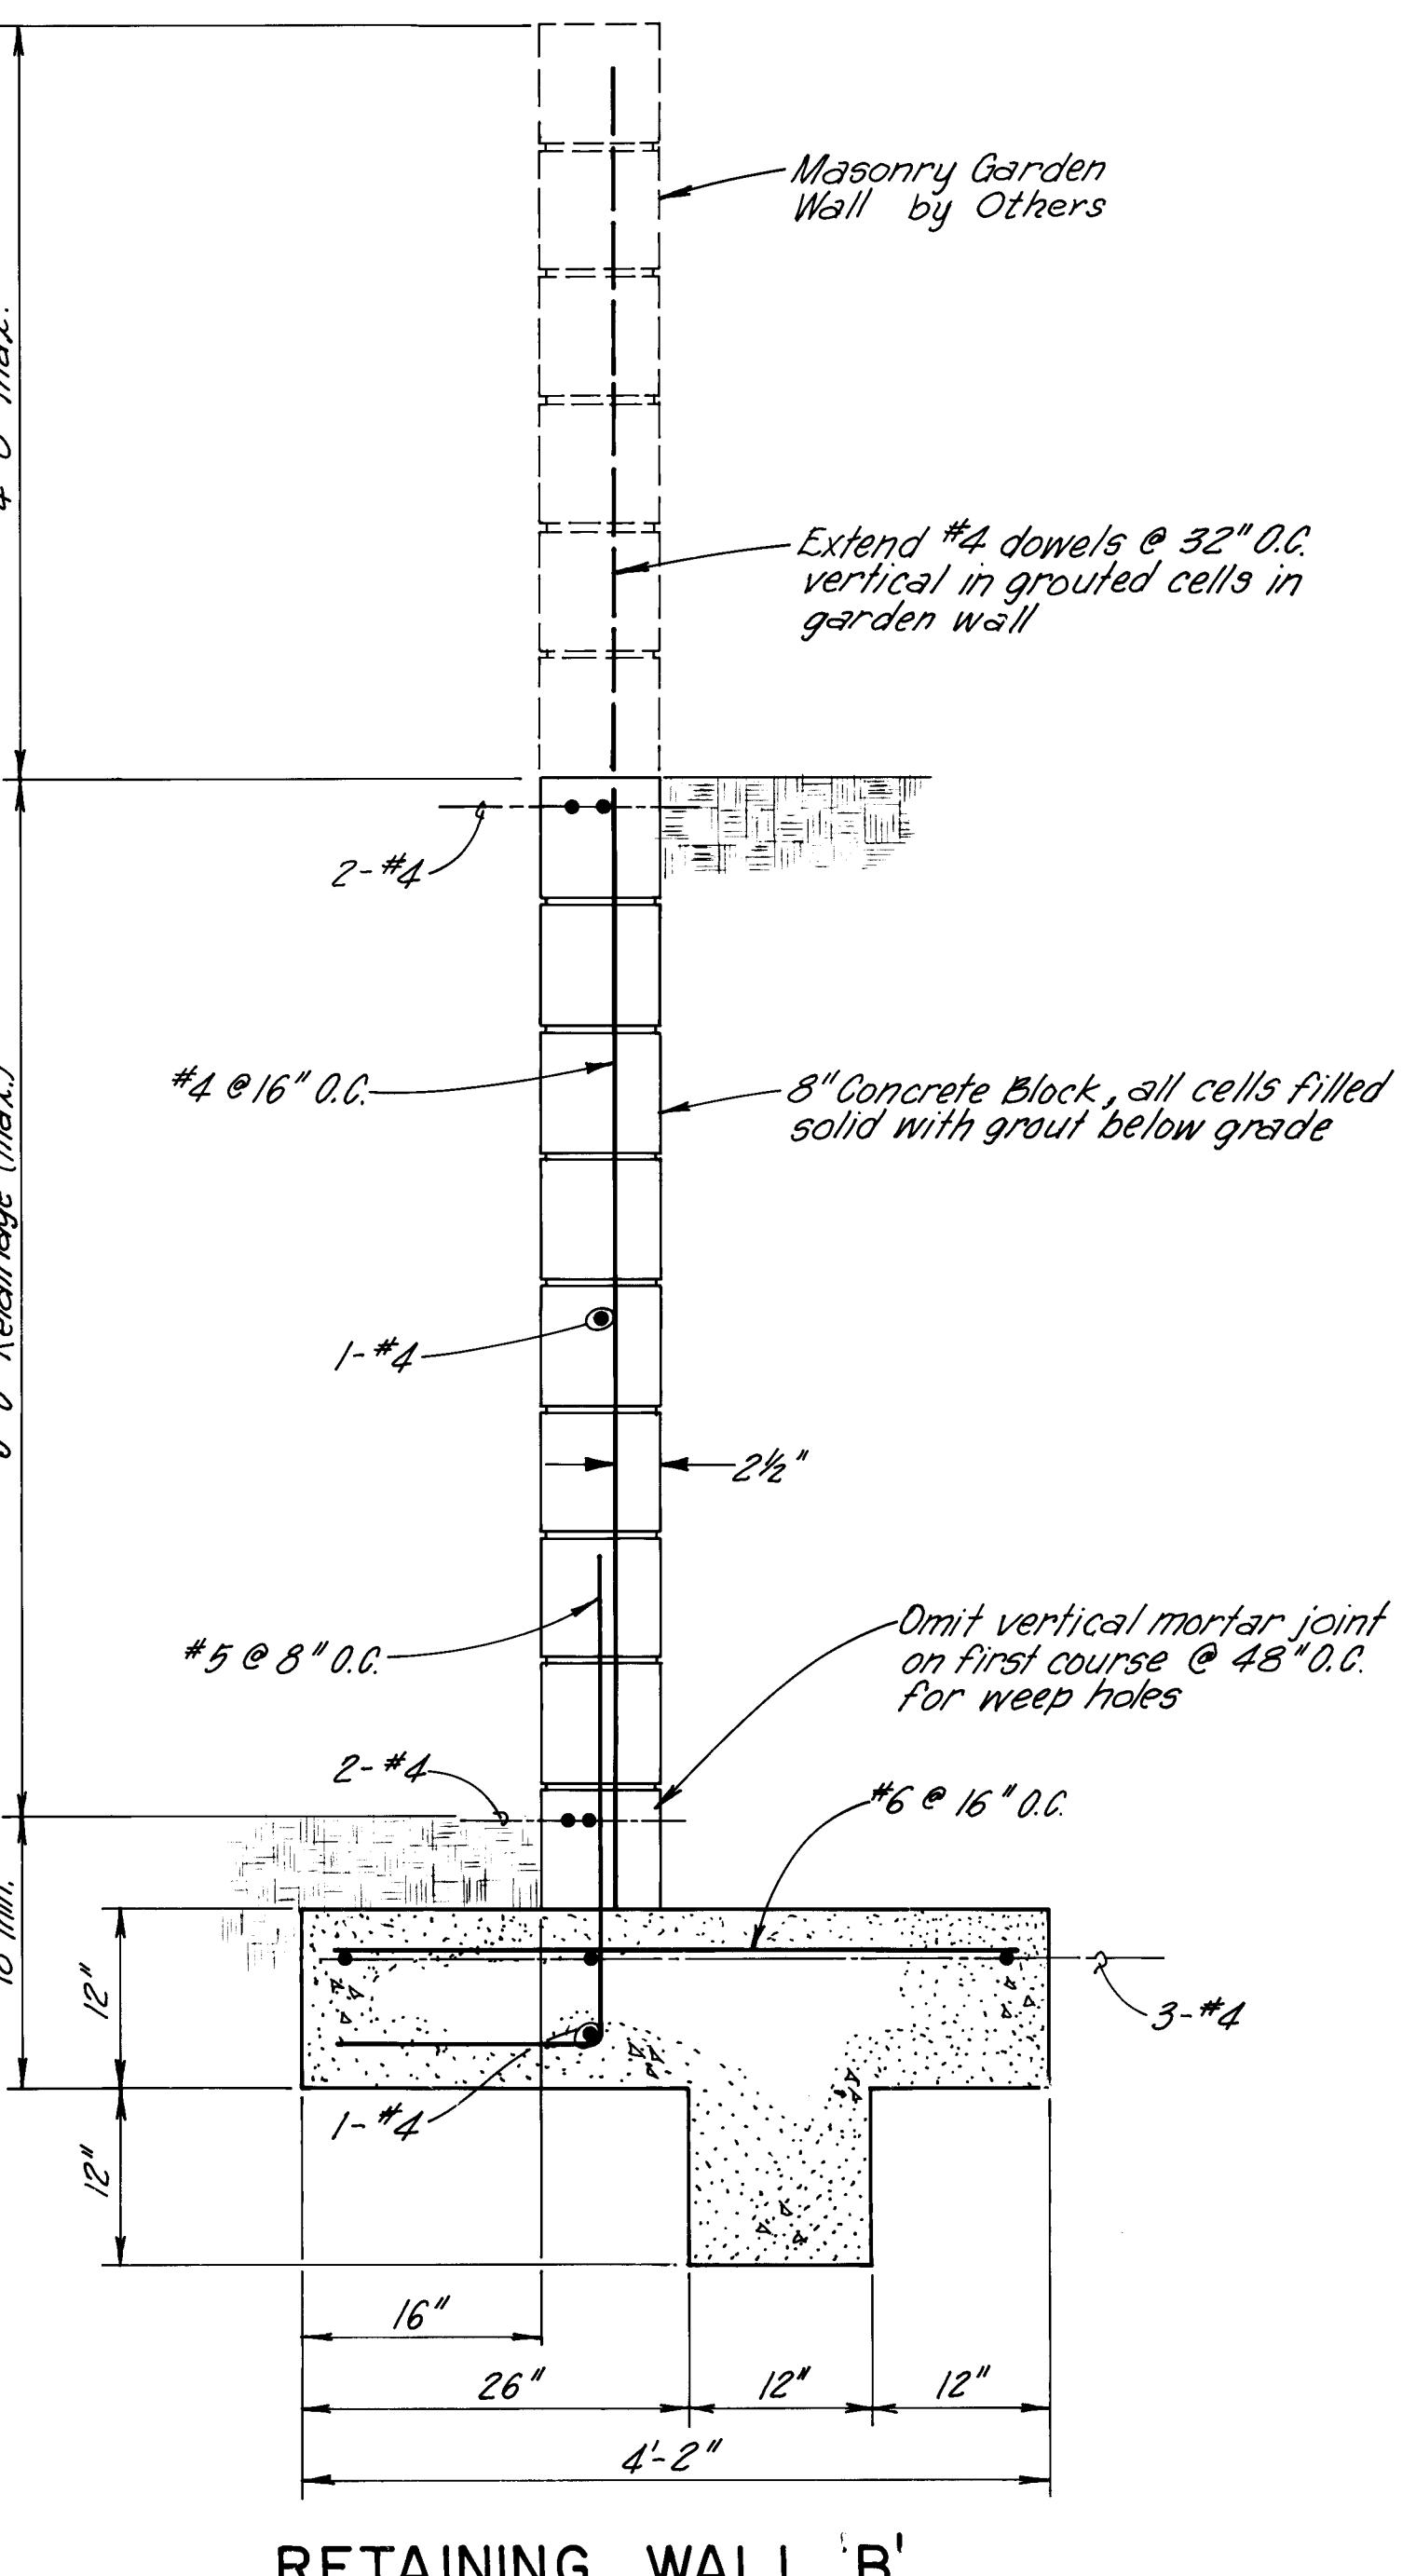


RETAINING WALL 'A'

RETAINING WALL 'B'

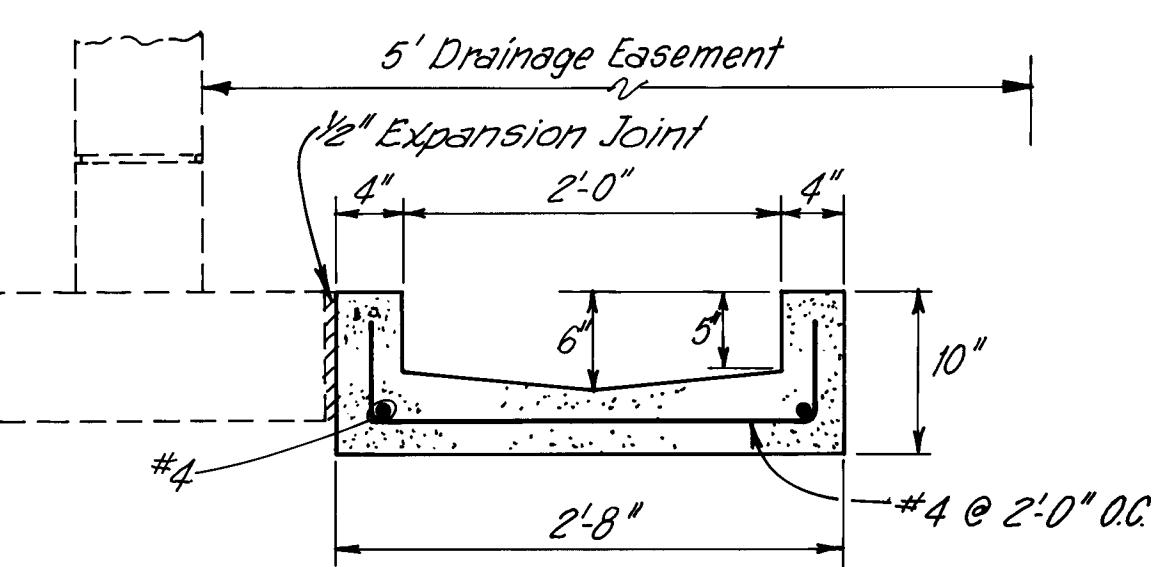


DRAINAGE RUNDOWN DETAIL


To Be Built by Others

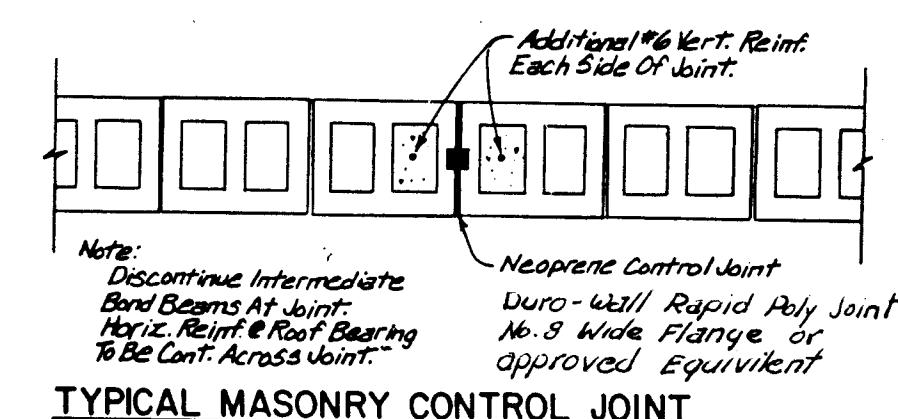

TYPICAL MASONRY CONTROL JOINT

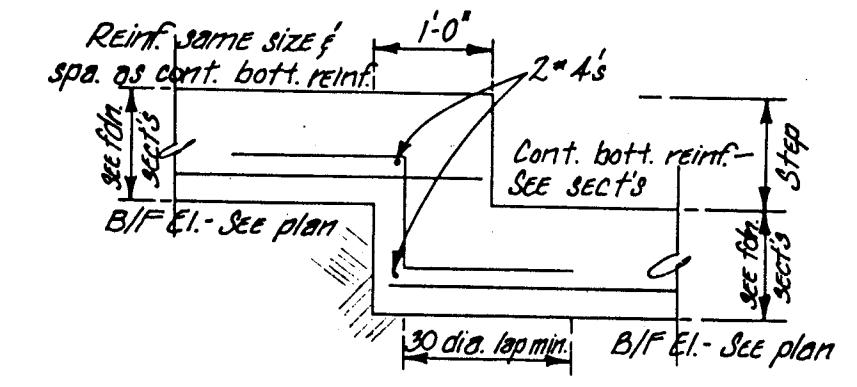

TYPICAL STEPPED FOOTING DETAIL

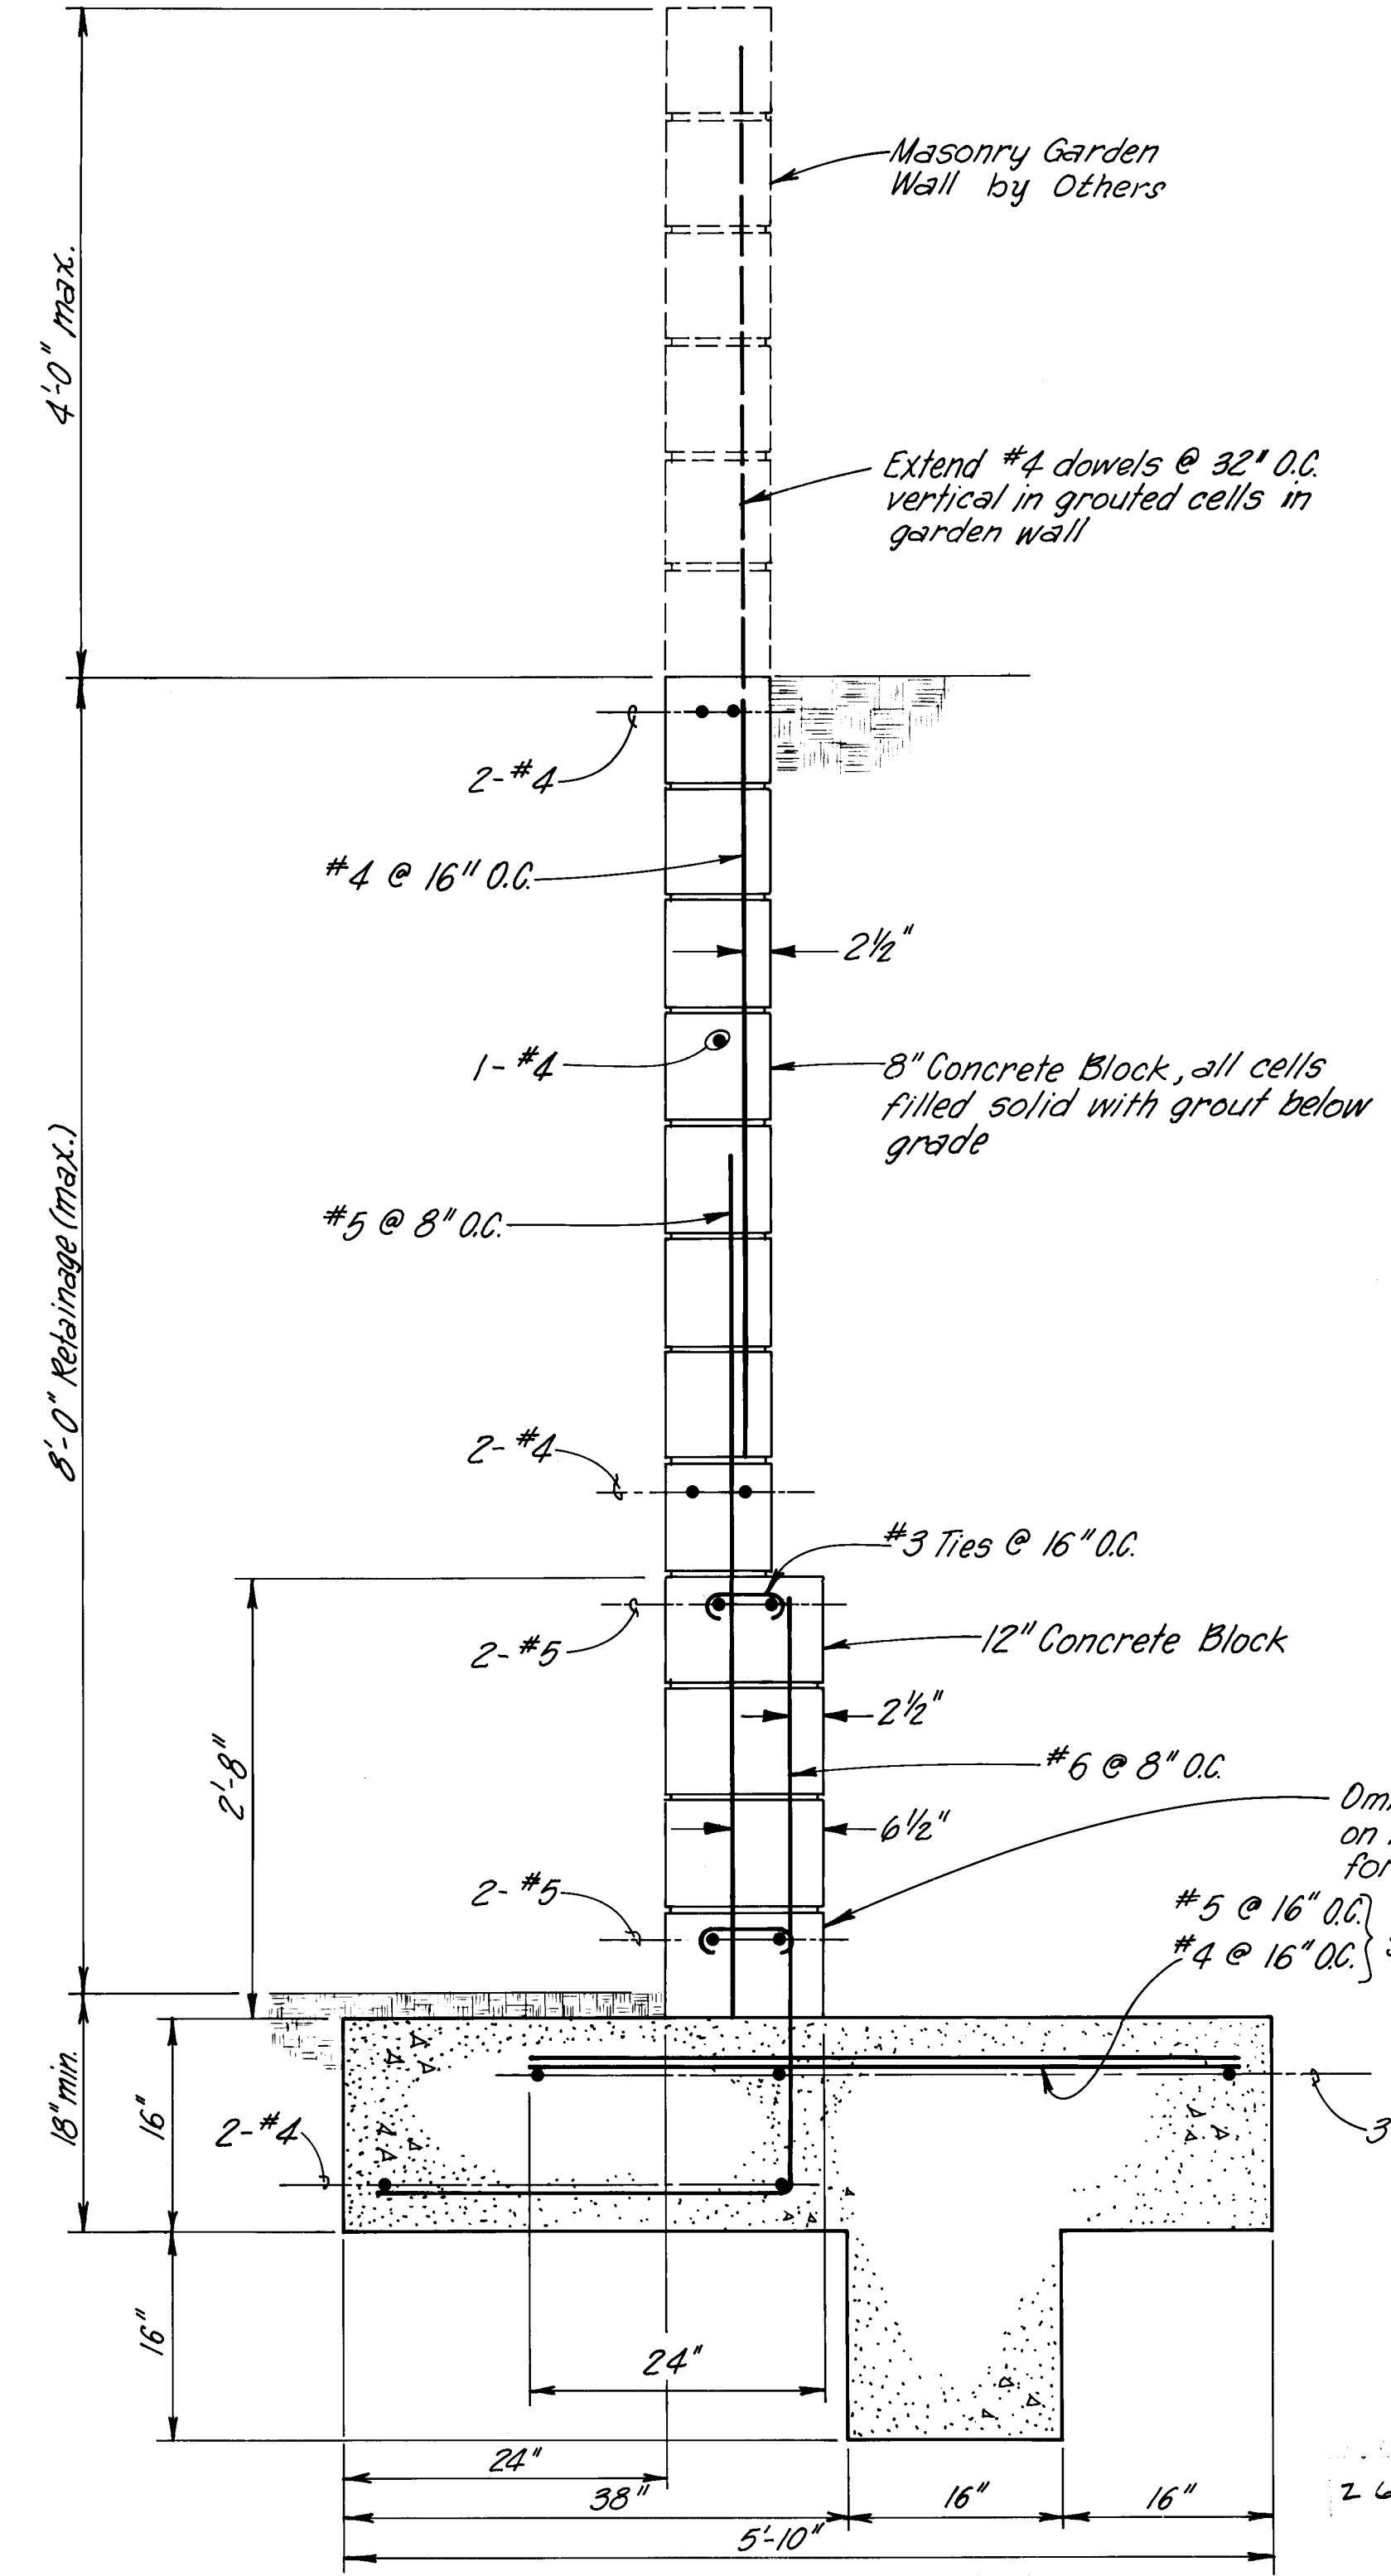

RETAINING WALL 'C'

GENERAL NOTES

1. Retaining wall footings shall be placed on a minimum of 2'-0" of engineered fill extending a minimum of 2'-6" from the edge of the footing and compacted to a minimum of 95 percent optimum density (ASTM D-1557).

Backfill shall be free draining material and shall be placed in 8" loose lifts and compacted to 90 percent optimum density (ASTM D-1557) with light vibratory compacting equipment.

2. Retaining wall shall not be backfilled until at least 7 days after placing of final grout level.

3. Vertical control joints with PVC inserts shall be placed at intervals not to exceed 30'-0" on center.

4. Minimum lap splice on reinforcing bars shall be 30 bar diameters or 1'-6" minimum.

5. Construction of retaining walls shall conform to requirements of the Uniform Building Code Section 24, low lift grouting method.

6. All garden walls that retain over 6" of soil, erected not in conjunction with retaining walls, shall be reinforced with 1-#4 in grouted cells at 16" o.c. extending to within 2" of the bottom of garden wall footing.

7. DESIGN DATA
Block Weight 12"-130 psf.
Block Weight 8"-85 psf.
Soil Weight 130 psf.
Equiv. Fluid Press. = 43 psf.
Soil Bearing Press. = 1500 psf.
(1/3 Increase for Wind/Seismic)
Coefficient of Friction = 0.4
Passive Soil Pressure = 90 psf.
Concrete f'c(28 Days) = 3000 psi.
Concrete Strength = 2000 psi.
Grout Strength = 2000 psi.
CMU Grade N = 1500 psi (Grouted)
Reinforcement = 60 ksi ASTM A-615

8. Colored and patterned concrete.

After proper consolidation of concrete, level and screed to compact the surface and float to attain a smooth, level, regular surface of uniform texture. A pattern, as specified on the plans or by the ENGINEER, is then to be pressed into the surface, to a depth not to exceed 3/16", by using embossing tools as manufactured by Boninite, Impresco, or approved equal. The Contractor shall provide a test slab of approximately 2' - 6" x 5' for the ENGINEER's approval prior to proportion of the large areas.

See Below
5-23-85

William J. Nichols
12-31-85

RECORD DRAWINGS

DATE 12/85

THIS SHEET FOR INFORMATION ONLY. A SEPERATE BUILDING PERMIT IS REQUIRED FOR RETAINING WALL CONSTRUCTION

See Below
5-23-85


CITY OF ALBUQUERQUE
MUNICIPAL DEVELOPMENT DEPARTMENT
ENGINEERING DIVISION

TITLE: ACADEMY RIDGE EAST PHASE I
RETAINING WALL & DRAINAGE DETAILS

APPROVALS	ENGINEER	DATE	APPROVALS	ENGINEER	DATE
City Engineer	J. D. Smith	6/21/85	Liquid Waste	NA	7/2/85
A/C E - Design	J. D. Smith	6/21/85	NA DW/H	8/2/85	
Hydrology	J. D. Smith	6/21/85	Water	NA	7/2/85


See Below
5-23-85

SCALE : 1" = 1'-0" DRAWING NO. 2289 MAP NO. E-21 SHEET 12 OF 19

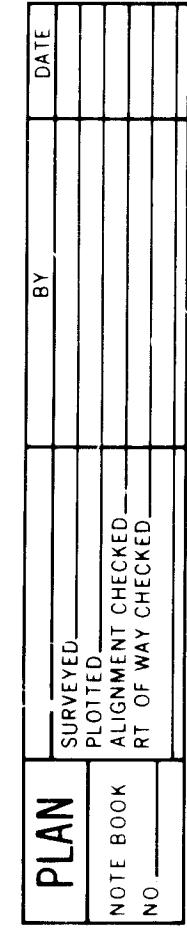


NOTE:
**SEE SHT. 18 FOR STORM
DRAIN DETAILS.**

SANITARY SEWER SERVICE			
STA.	LENGTH	INV. @ PLUG	
2+56 Lt.	26'	67.80.54	
+70			
2+69 Rt.	26'	67.95.76	
+89			
2+85 Lt.	26'	68.20.14	
+08			
3+05 Rt.	26'	68.37.03	
3+37 Lt.	26'	68.75.69	
+62			
3+61 Rt.	26'	69.03.68.84	
+81			
3+83 Lt.	26'	69.24.10	
4+17 Rt.	26'	69.69.14	
+33			
4+50 Lt.	26'	69.84.48	
4+73 Rt.	26'	70.35.50	
+75			
4+70 Lt.	26'	70.89.25	
5+21 Rt.	26'	70.98.71.00	
5+23 Lt.	26'	70.94.75	

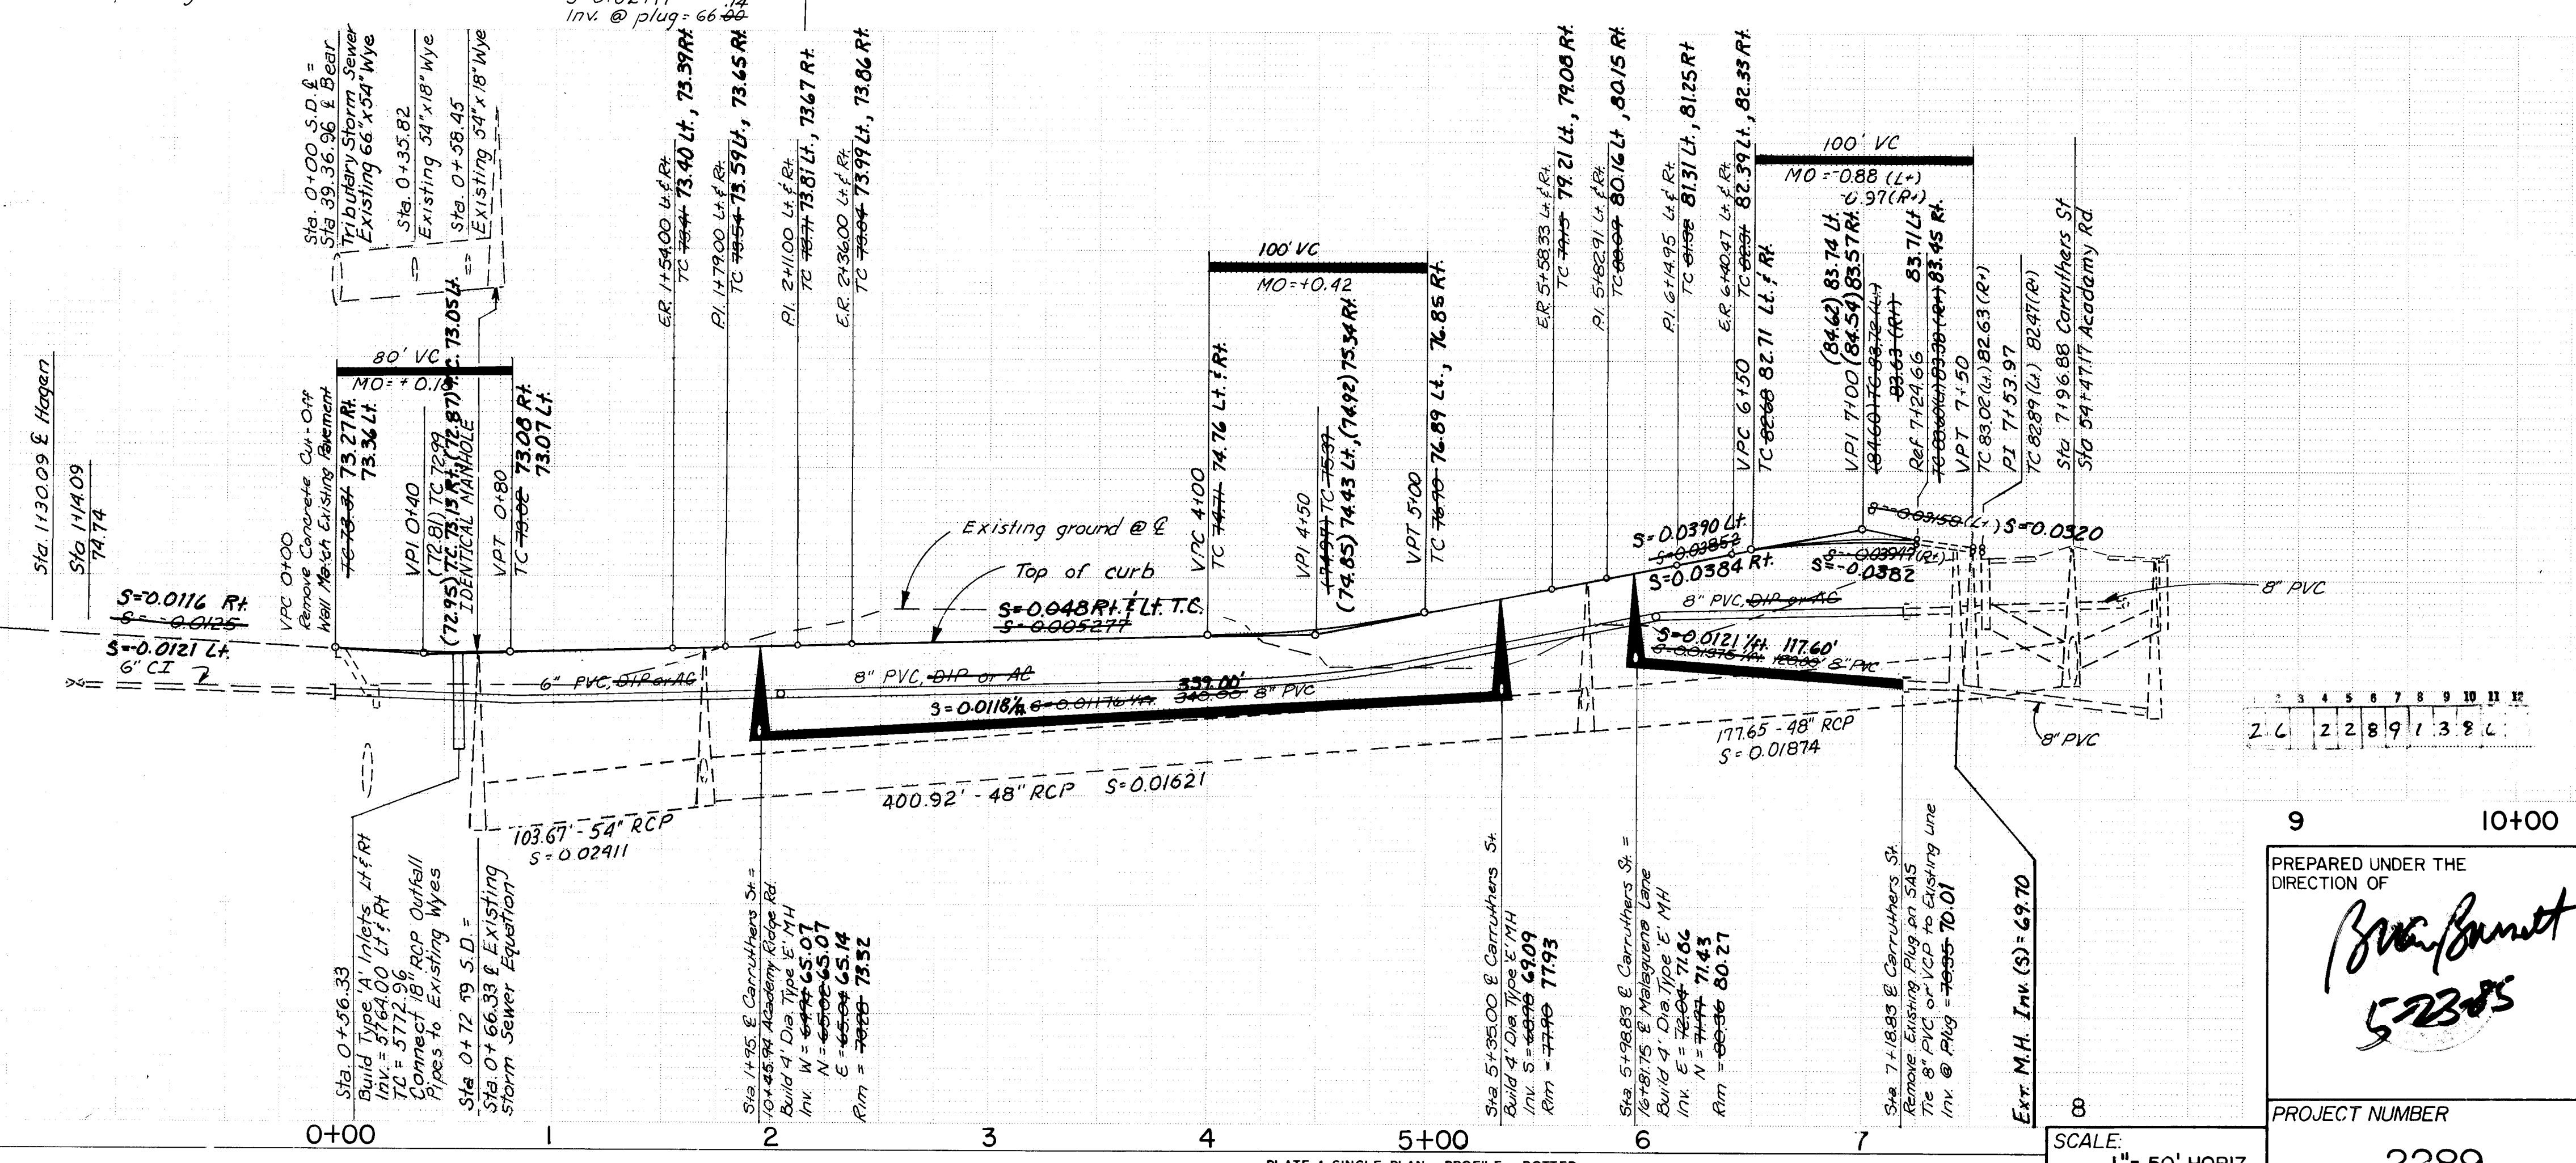

BRIINING 11.132 52753

E.H.W.A. Region No.				SHEET NO.	TOTAL SHEETS
6	NEW MEXICO				

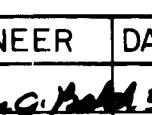SURVEY INFORMATION		REFERENCES		BENCH MARKS		AS-BUILT INFORMATION	
2	9/9/85 ADDED SHT. 19 & REMAINING WORK	KLD	EST. NO.	MAP NO. E- 21	ACS Brass Cap "6-E22"	CONTRACTOR <i>Kirk Inc.</i>	DATE 5/934.53
1	7/23/85 ADDED CURB & GUTTER	KLD	NO.	W.O. NO.	Location is 1.2 miles East of the intersection of Academy Road N.E. & Eubank Blvd. N.E.	WORK STAKED BY <i>John Chapman</i>	DATE 7/18/85
	NO. DATE	REMARKS	BY		Station is then 375' South on the South Rim of the Bear Canyon Tributary	INSPECTOR'S ACCEPTANCE BY <i>John Chapman</i>	DATE 7/18/85
		REVISIONS				FIELD VERIFICATION BY <i>John Chapman</i>	DATE 7/18/85
						DRAWINGS CORRECTED BY <i>John Chapman</i>	DATE 7/18/85
MICRO-FILM INFORMATION							
DESIGNED BY	KLD	DATE	1/85	RECORDED BY		DATE	
DRAWN BY	LAD	DATE	2/85	RECORDED BY		DATE	
CHECKED BY	KLD	DATE	5/85	RECORDED BY		DATE	
OF ALBUQUERQUE DEVELOPMENT DEPARTMENT ENGINEERING DIVISION							
BRIDGE EAST PHASE I RUTHERS STREET							
R	DATE	APPROVALS	ENGINEER	DATE			
6/21/85		Liquid Waste	<i>William J. Baker</i>	5/22/85			
6/21/85		Traffic	<i>David W. Hamm</i>	5/22/85			
5/29/85		Water	<i>William J. Baker</i>	5/22/85			
				SHEET	13	OF	19


9 10-00
PREPARED UNDER THE
DIRECTION OF


52385
PROJECT NUMBER
2289


PLAN	SUBDIVIDED	BY	DATE
PILOTTED			
GRADES CHECKED			
STRUCTURE ROTATING CH'kd			

PROFILE	SUBDIVIDED	BY	DATE
PILOTTED			
GRADES CHECKED			
STRUCTURE ROTATING CH'kd			

BRUNING 44-132-52753

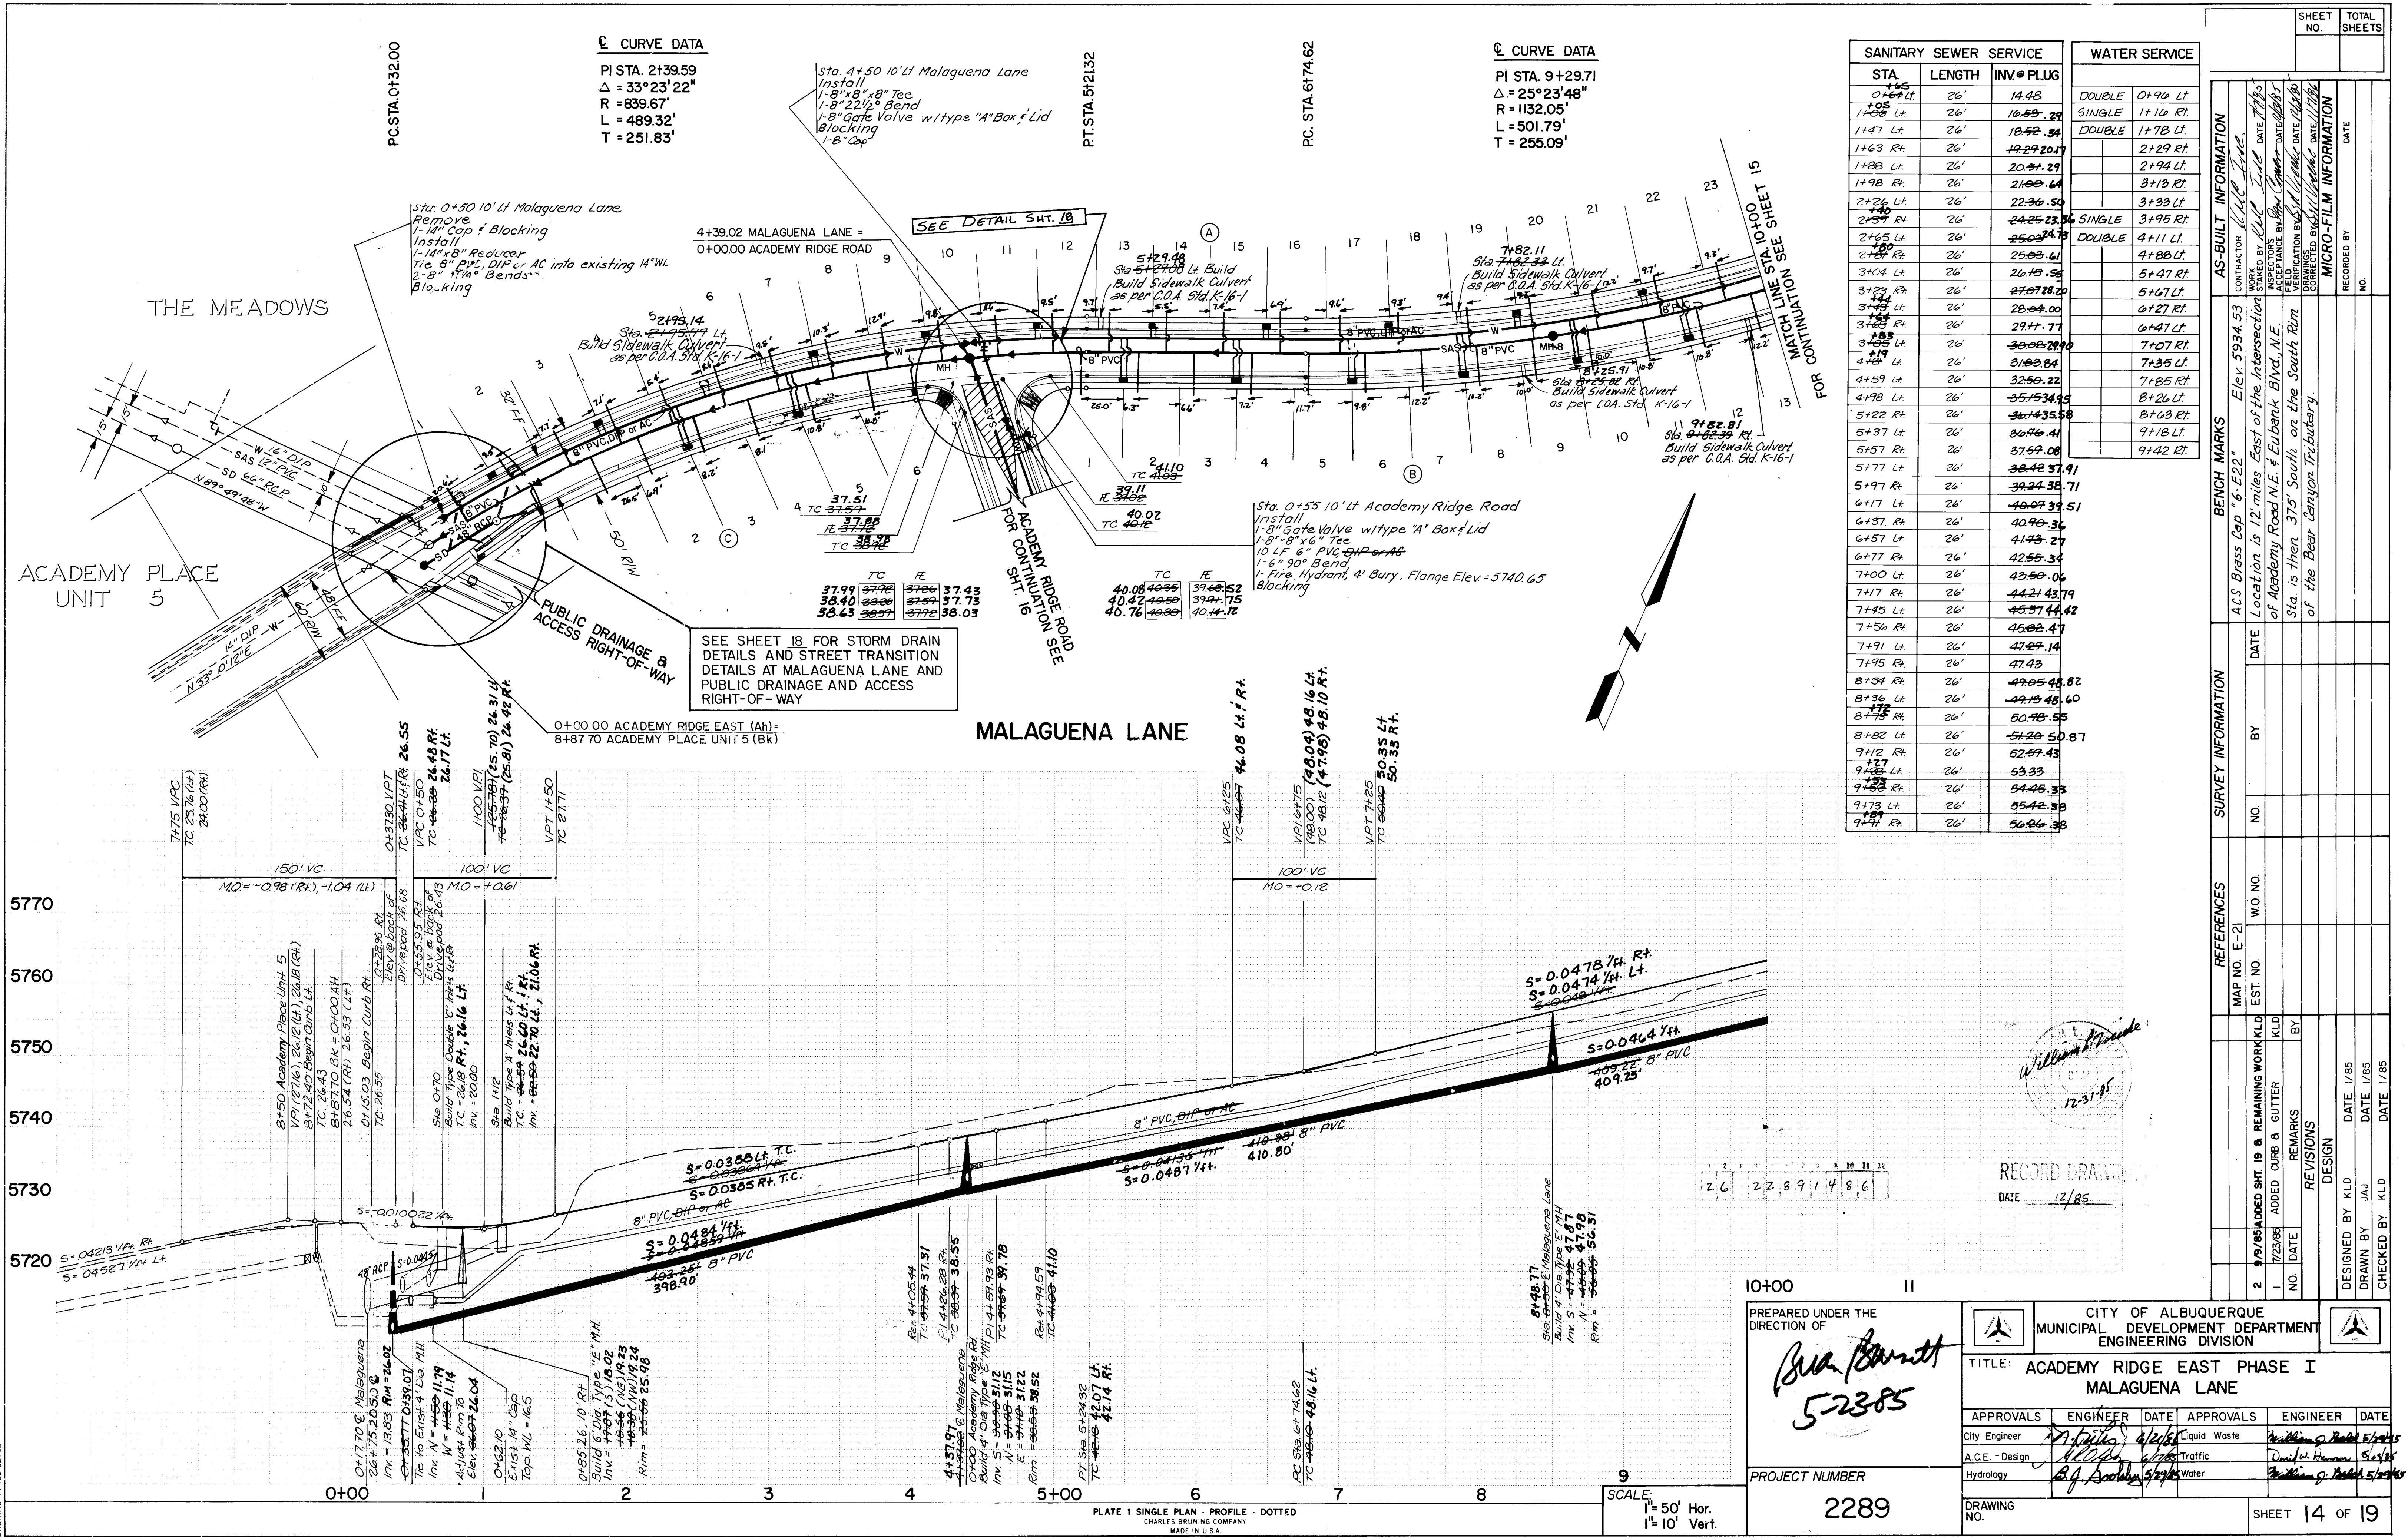

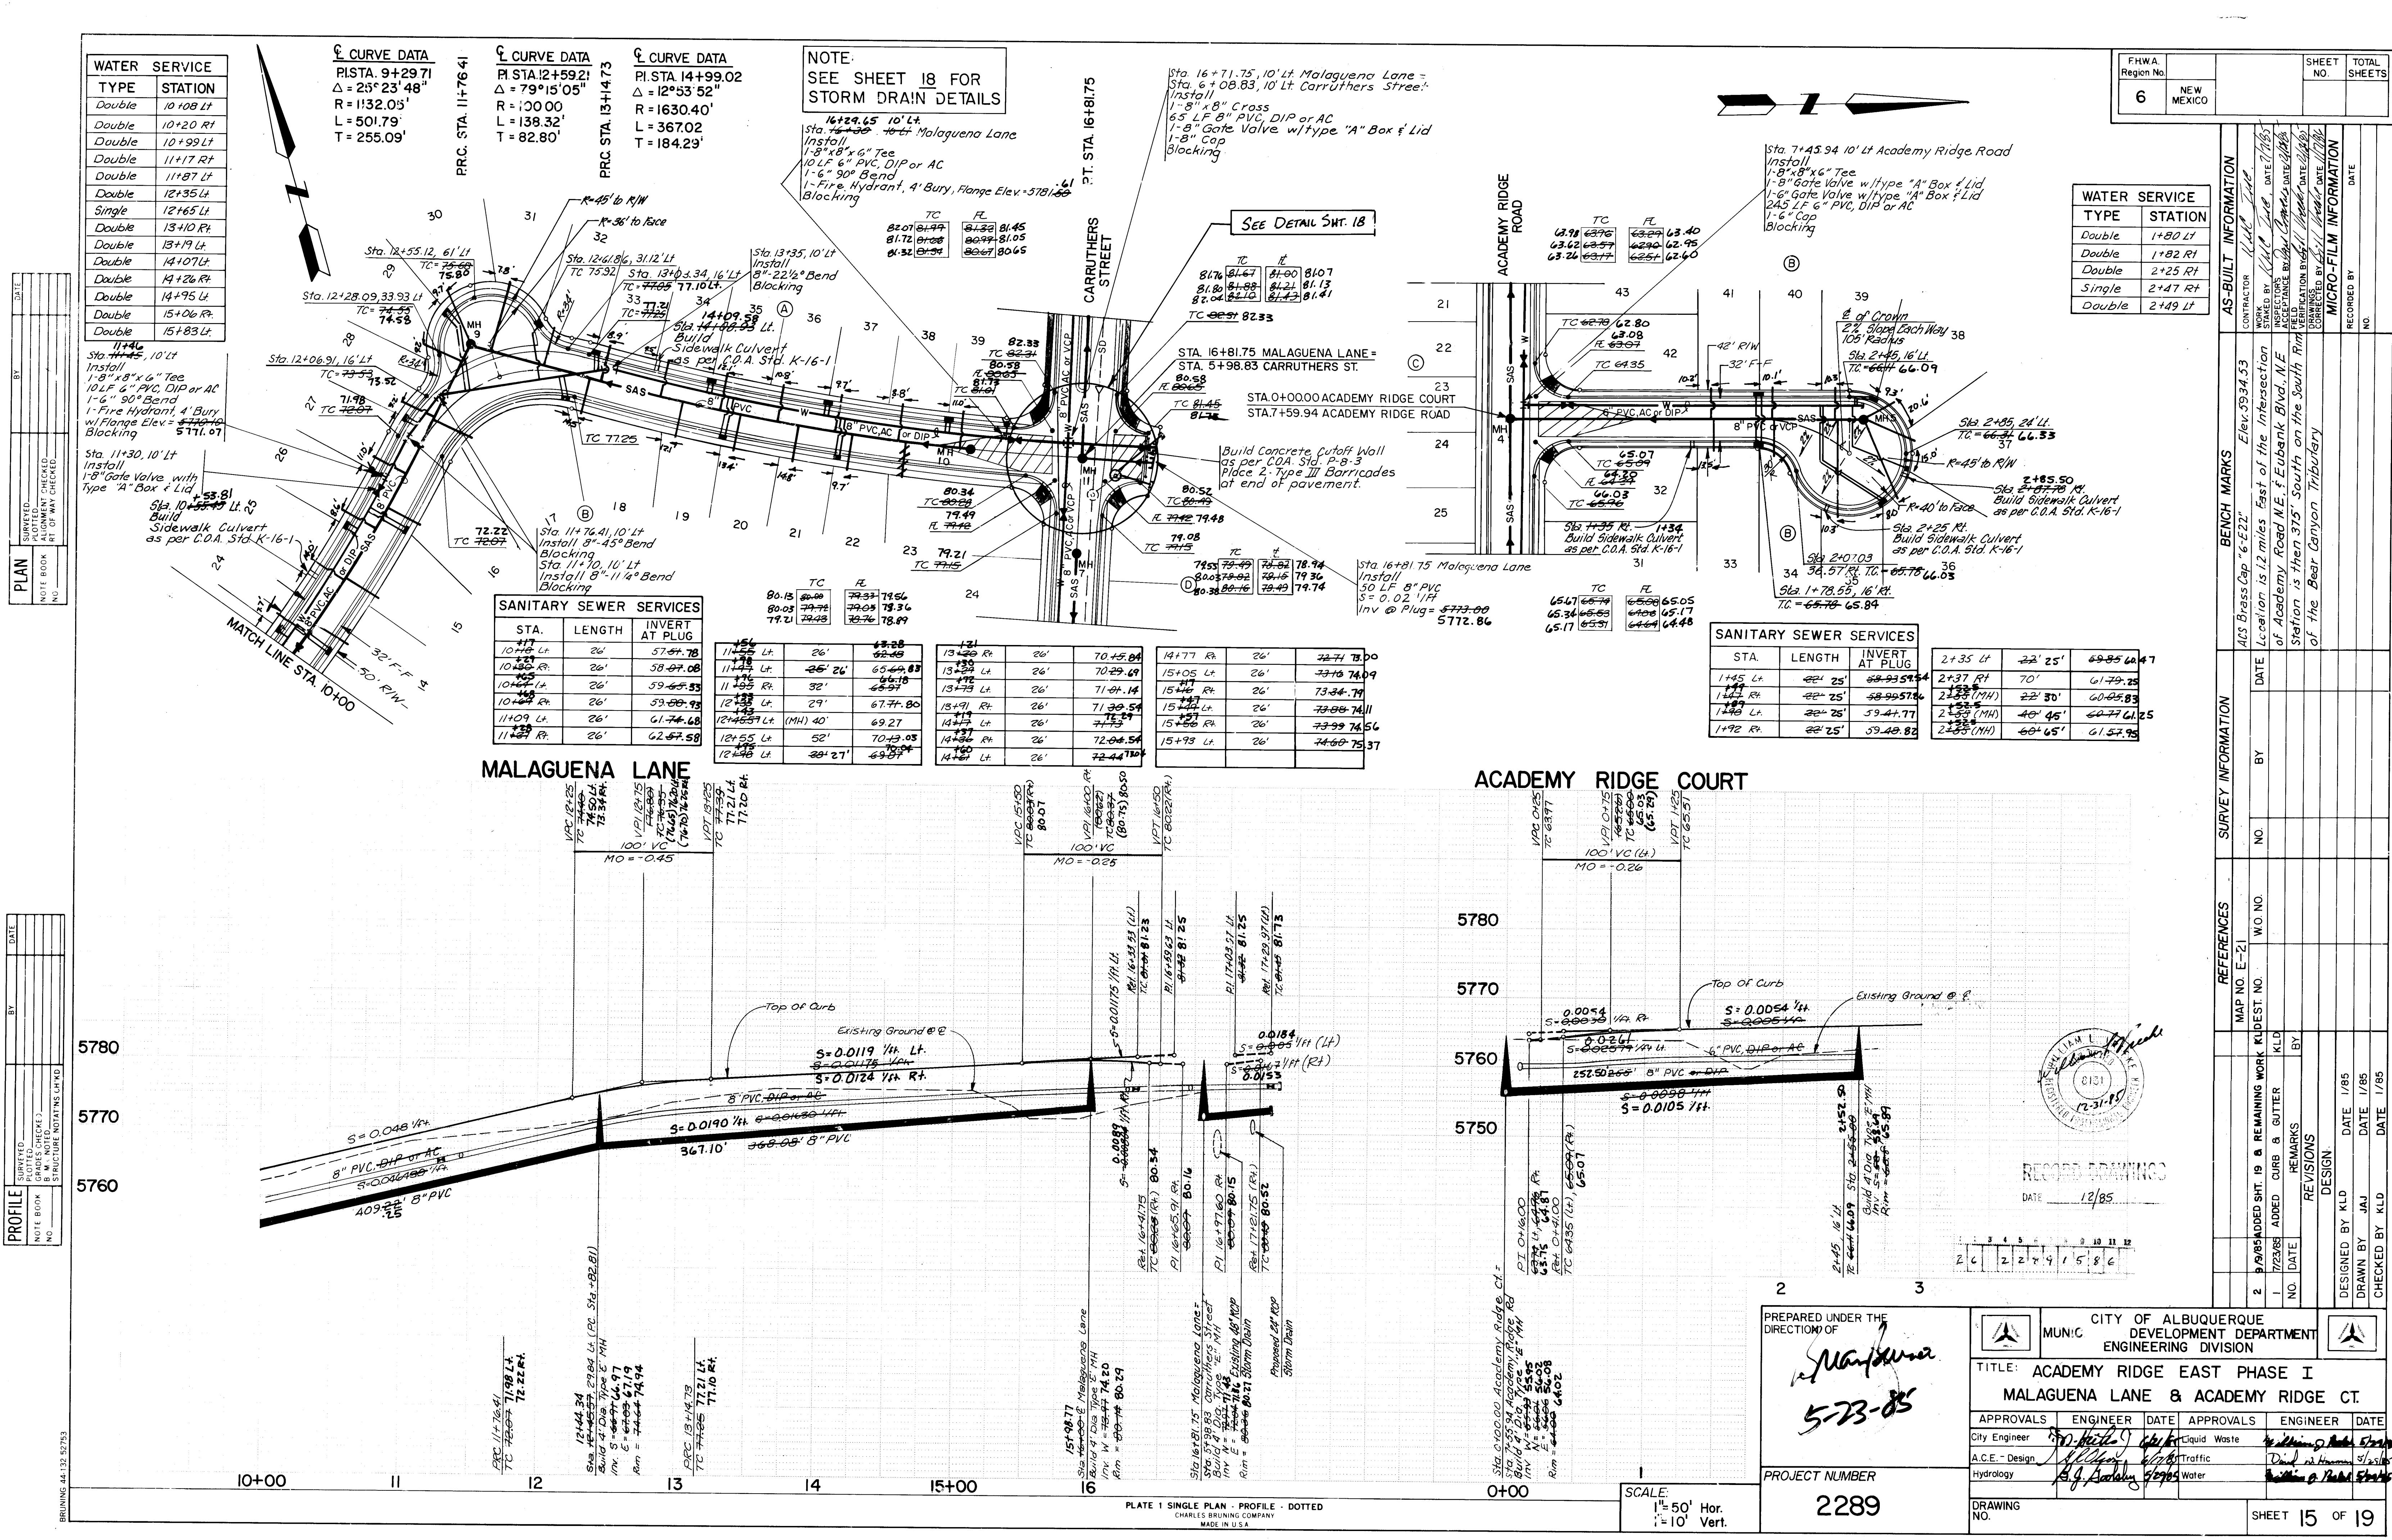

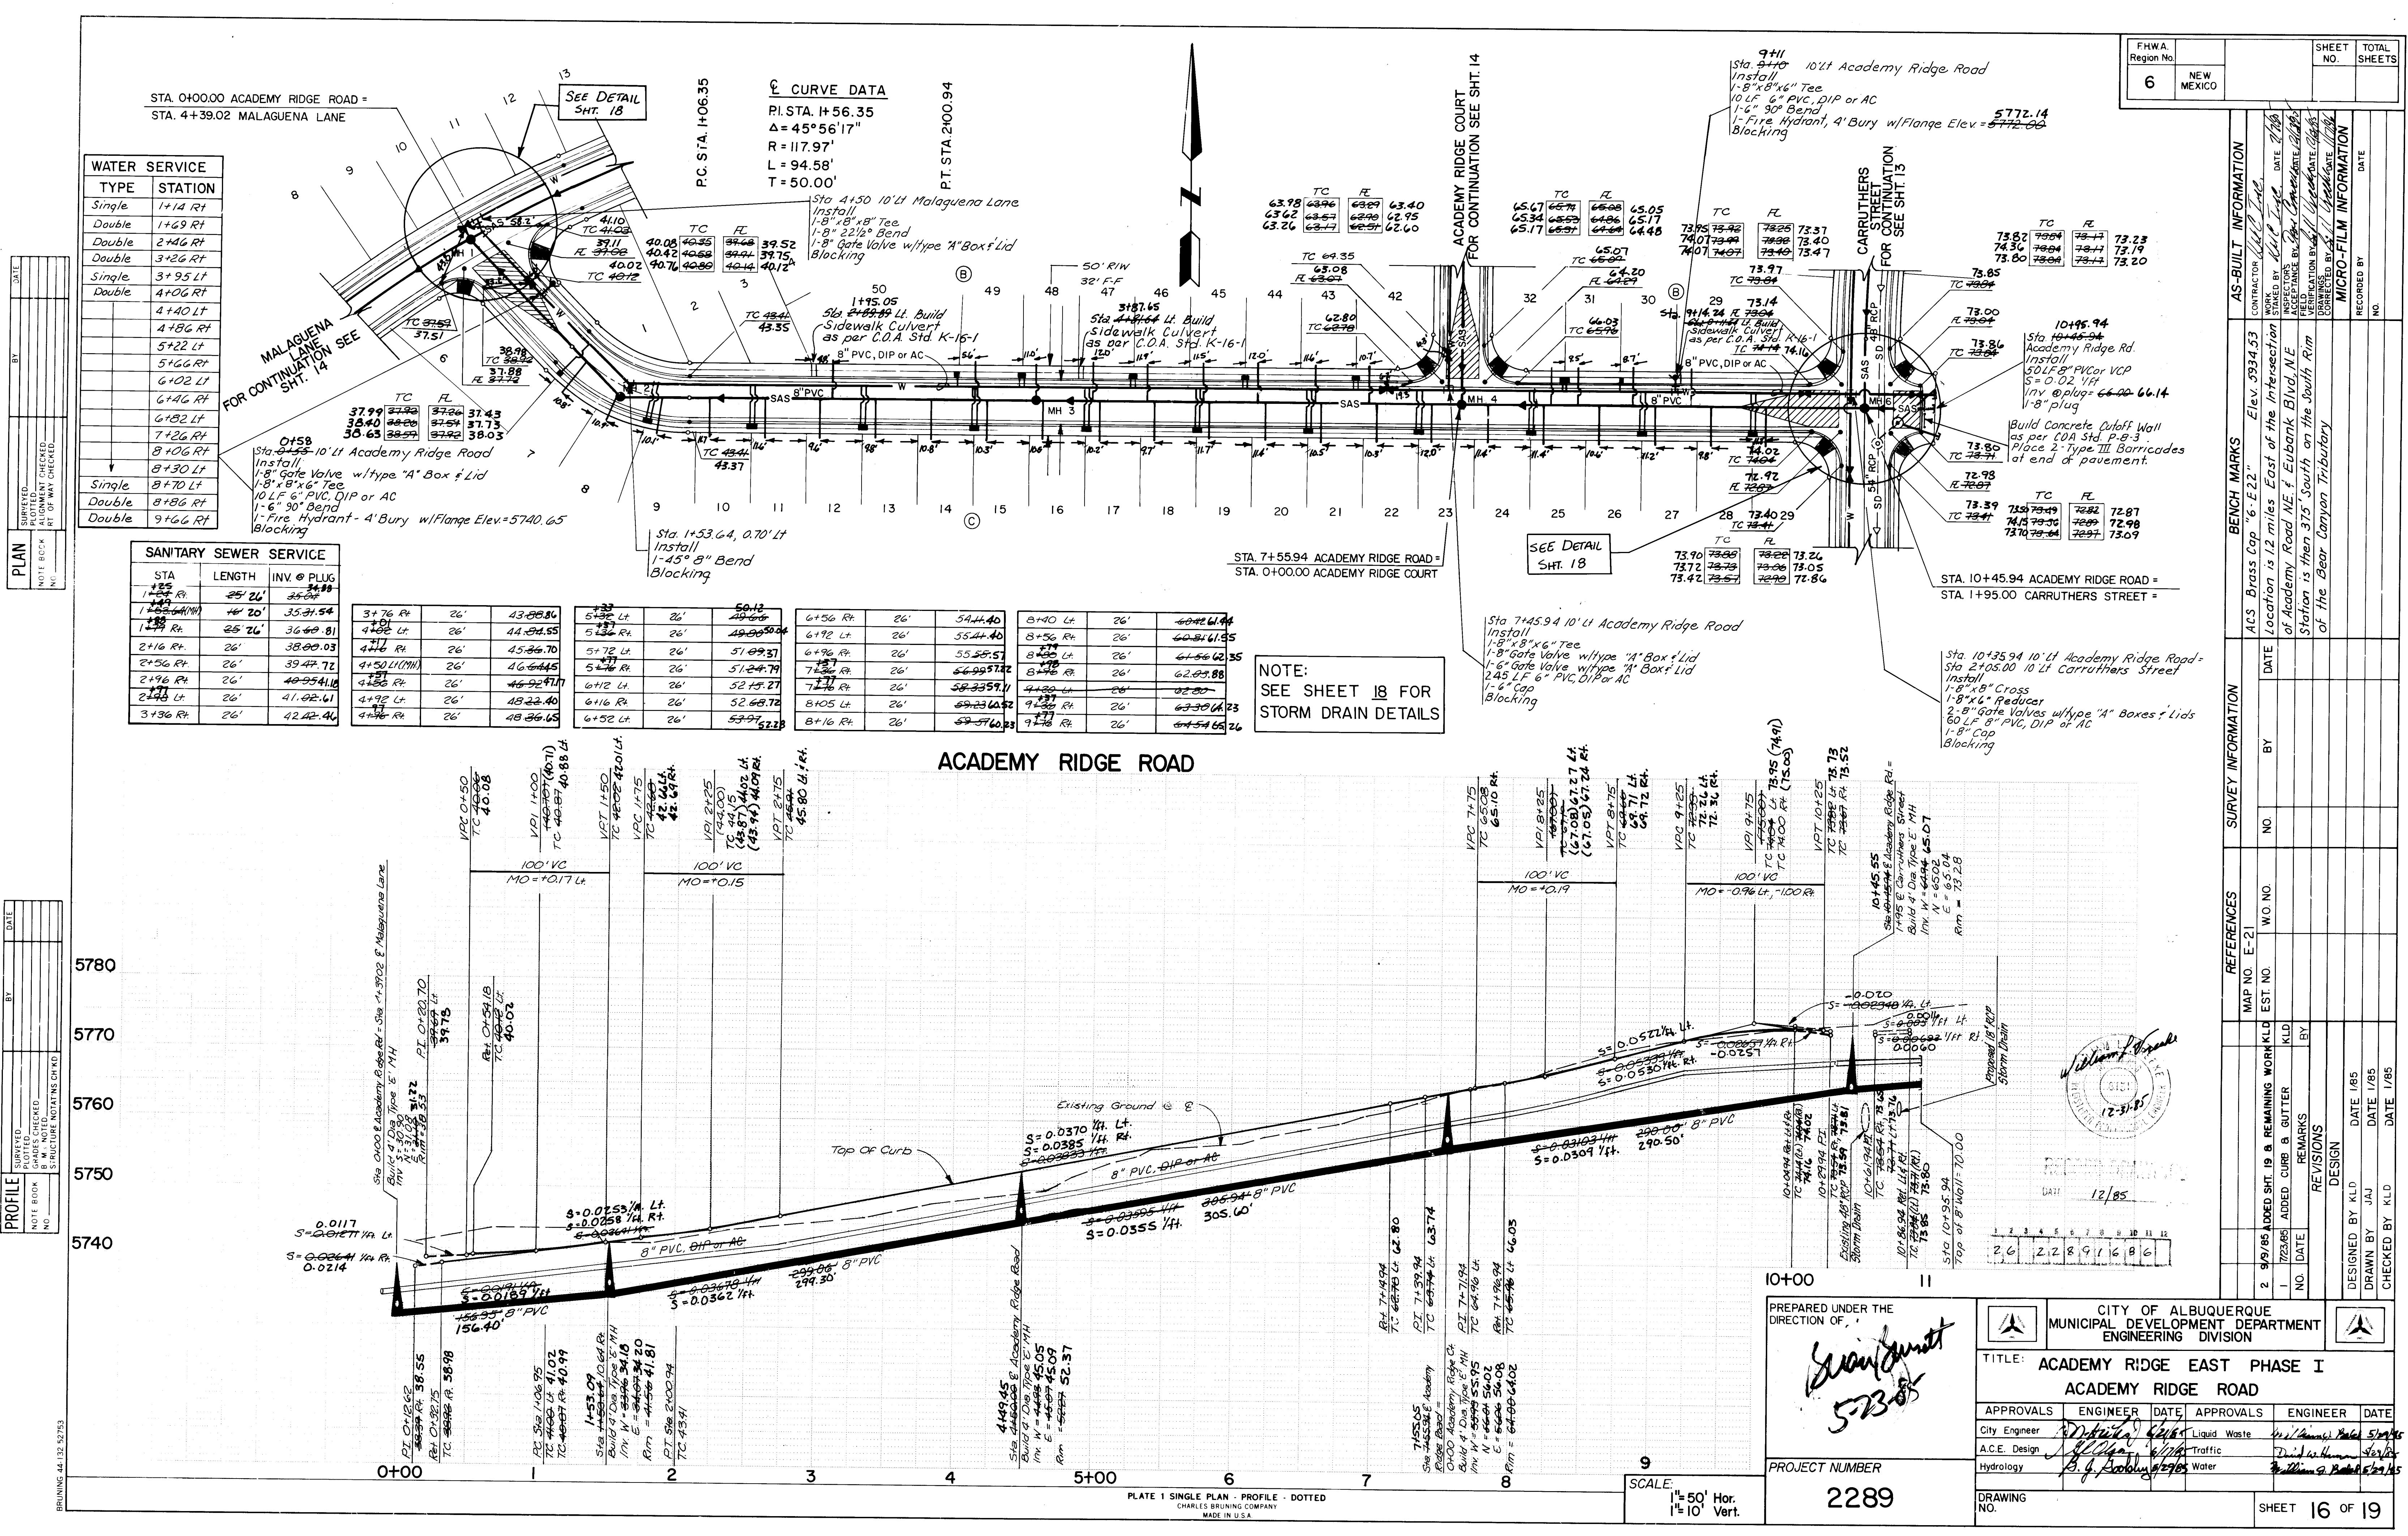

FHWA Region No.	6	NEW MEXICO
SHEET NO.		TOTAL SHEETS

PLAN	SUPERSEDED BY
NOTE BOOK	DATE
PLOTTED	
GRADES CHECKED	
STRUCTURE NOTATIONS CHKD	

See Sheet 18 for Storm Drain and Pavement Transition Details

MALAGUENA LANE FOR CONTINUATION SEE SHT. 14

26.27 26.29

26.66 26.68

SEE DETAIL SHT. 18

22' Std. Alley Section As Per COA Std. P-5-6

73.49 73.50

73.46 73.46

SEE DETAIL SHT. 18

Construct Std Alley Intersection as per C.O.A. Std. P-12

CARRUTHERS STREET FOR CONTINUATION SEE SHT. 13


ACADEMY PLACE UNIT

HAGEN ROAD

PROFILE	SUPERSEDED BY
NOTE BOOK	DATE
PLOTTED	
GRADES CHECKED	
S.M. NORTH	
STRUCTURE NOTATIONS CHKD	

<img alt="A detailed profile drawing of the Public Drainage & Access Right-of-Way. It shows elevation changes along a 100' vertical distance, with specific elevations like 26+78.35, 27+06.39, 27+19.75, 28+00.00, 28+72.72, 28+24.43, 29+00.00, 29+15.00, 30+00.00, 30+50.00, 31+00.00, 31+15.00, 31+30.00, 31+45.00, 31+60.00, 31+75.00, 31+90.00, 32+05.00, 32+20.00, 32+35.00, 32+50.00, 32+65.00, 32+80.00, 32+95.00, 33+10.00, 33+25.00, 33+40.00, 33+55.00, 33+70.00, 33+85.00, 33+00.00, 33+15.00, 33+30.00, 33+45.00, 33+60.00, 33+75.00, 33+90.00, 34+05.00, 34+20.00, 34+35.00, 34+50.00, 34+65.00, 34+80.00, 34+95.00, 35+00.00, 35+15.00, 35+30.00, 35+45.00, 35+60.00, 35+75.00, 35+90.00, 36+05.00, 36+20.00, 36+35.00, 36+50.00, 36+65.00, 36+80.00, 36+95.00, 37+00.00, 37+15.00, 37+30.00, 37+45.00, 37+60.00, 37+75.00, 37+90.00, 38+00.00, 38+15.00, 38+30.00, 38+45.00, 38+60.00, 38+75.00, 38+90.00, 39+00.00, 39+15.00, 39+30.00, 39+45.00, 39+60.00, 39+75.00, 39+90.00, 40+00.00, 40+15.00, 40+30.00, 40+45.00, 40+60.00, 40+75.00, 40+90.00, 41+00.00, 41+15.00, 41+30.00, 41+45.00, 41+60.00, 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FHWA Region No.	Sheet No.	Total Sheets
6	NEW MEXICO	

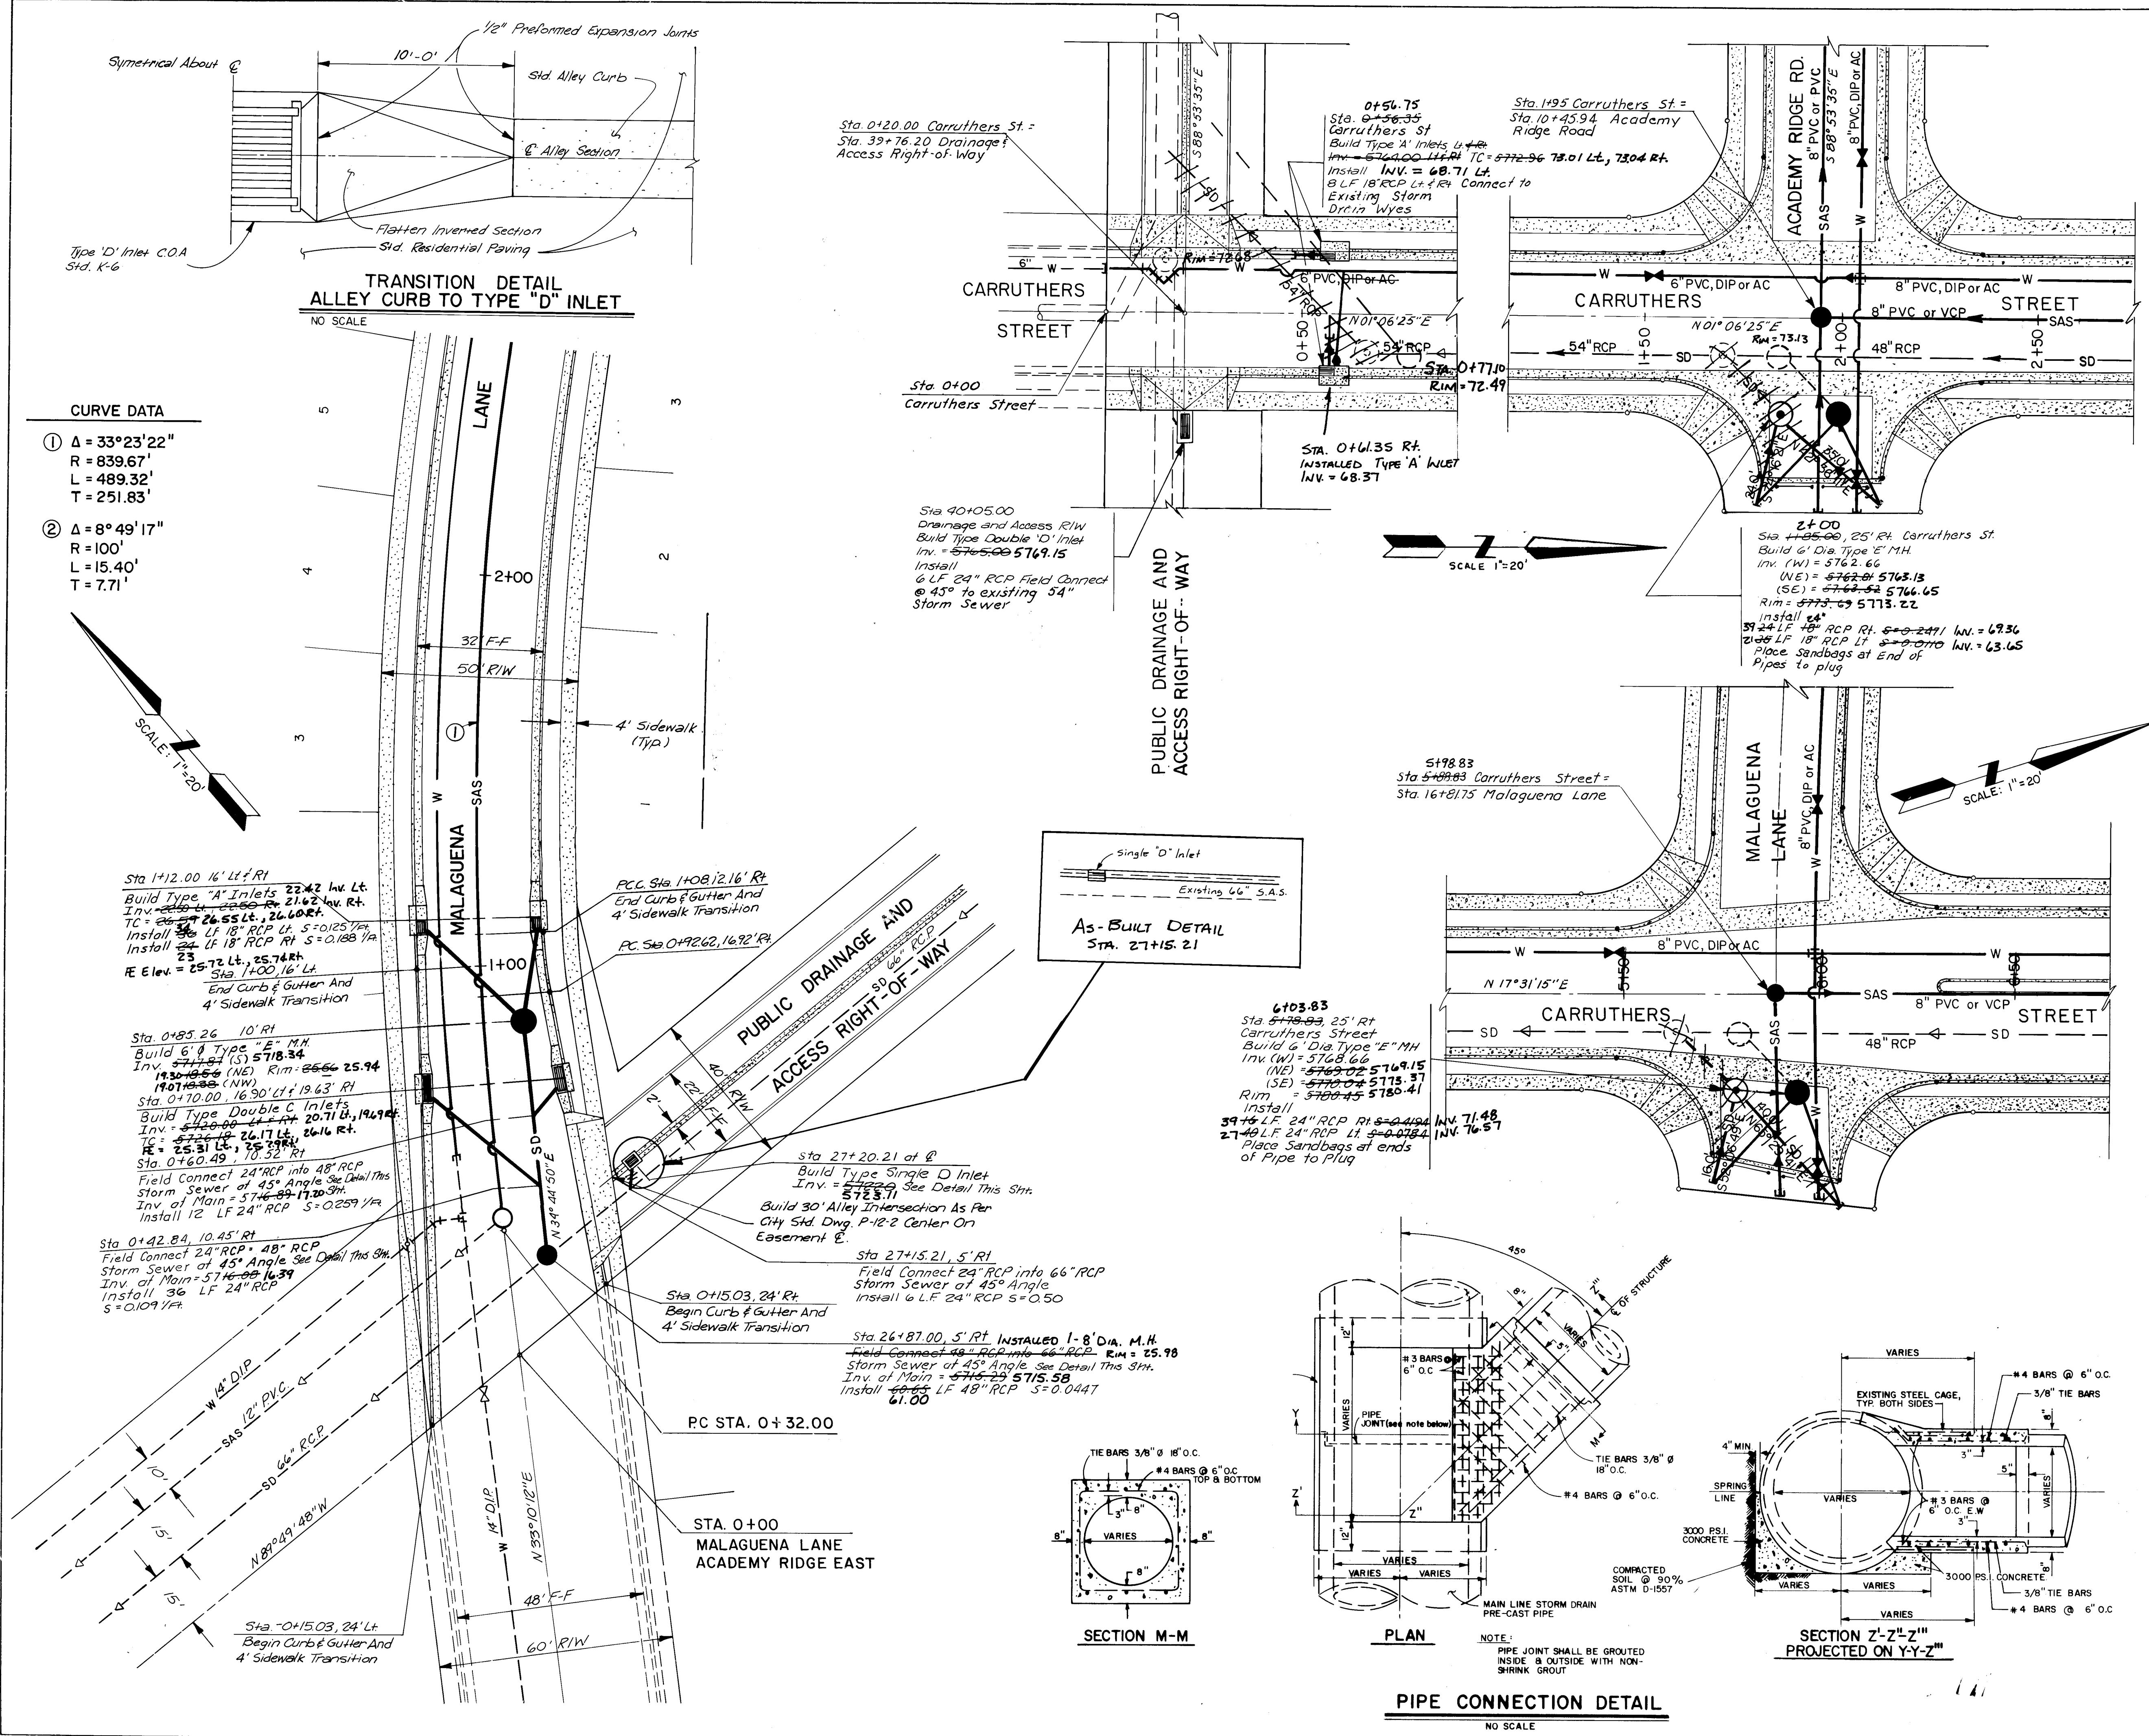

AS-BUILT INFORMATION		BENCH MARKS	
CONTRACTOR	Rudzak	INSPECTOR	None
SUPERVISOR	Date 12/31/85	ACCEPTANCE BY	Date 12/31/85
LOCATION BY	Date 12/31/85	RECORDED BY	Date 12/31/85
MICRO-FILM INFORMATION			
DRAWN BY			
RECORDED BY			
NO			

ENGINEER'S SEAL
Boone
5-23-85

SURVEY INFORMATION

FIELD NOTES	BY	DATE
NO.	BY	DATE

REVISIONS
William J. Steele
12-31-85


RECEIVED
DATE 12/31/85

CITY OF ALBUQUERQUE
MUNICIPAL DEVELOPMENT DEPARTMENT
ENGINEERING DIVISION

TITLE: ACADEMY RIDGE EAST PHASE I
MISCELLANEOUS DETAILS


APPROVALS	ENGINEER	DATE	APPROVALS	ENGINEER	DATE
City Engineer	J. R. Reed	5/29/85	Liquid Waste	B. L. Hause	5/29/85
A.C.E. - Design	J. R. Reed	5/29/85	Traffic	D. L. Norman	5/29/85
A.G.E. - Hydrology	B. C. Anthony	5/29/85	Water	B. L. Hause	5/29/85

DRAWING NO. 2289 **MAP NO.** E-21 **SHEET OF** 18 **OF** 19

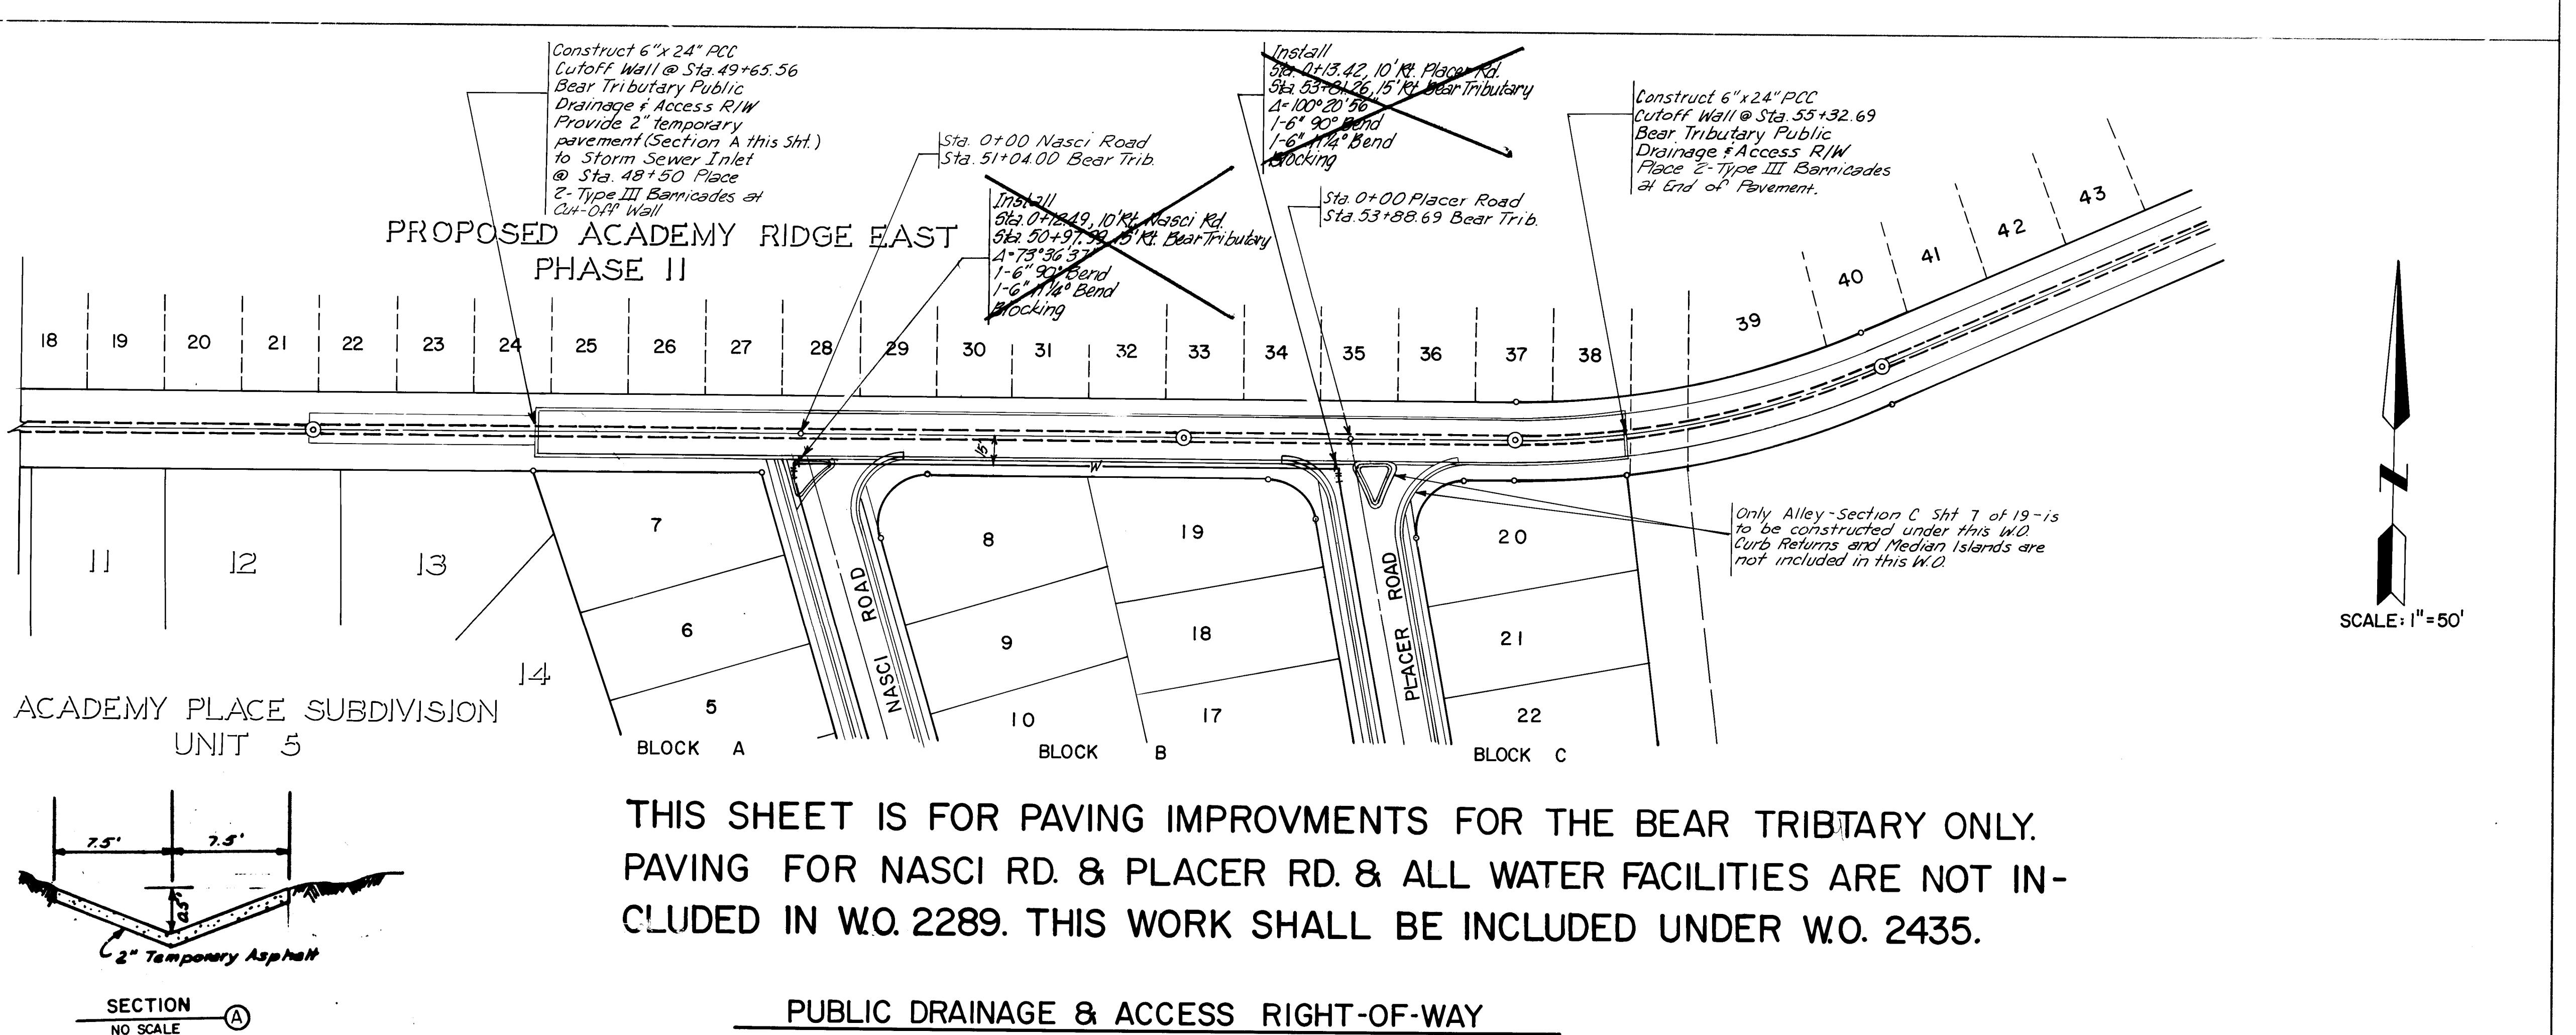

THIS SHEET IS FOR PAVING IMPROVEMENTS FOR THE BEAR TRIBUTARY ONLY.
PAVING FOR NASCI RD. & PLACER RD. & ALL WATER FACILITIES ARE NOT INCLUDED IN W.O. 2289. THIS WORK SHALL BE INCLUDED UNDER W.O. 2435.

PUBLIC DRAINAGE & ACCESS RIGHT-OF-WAY

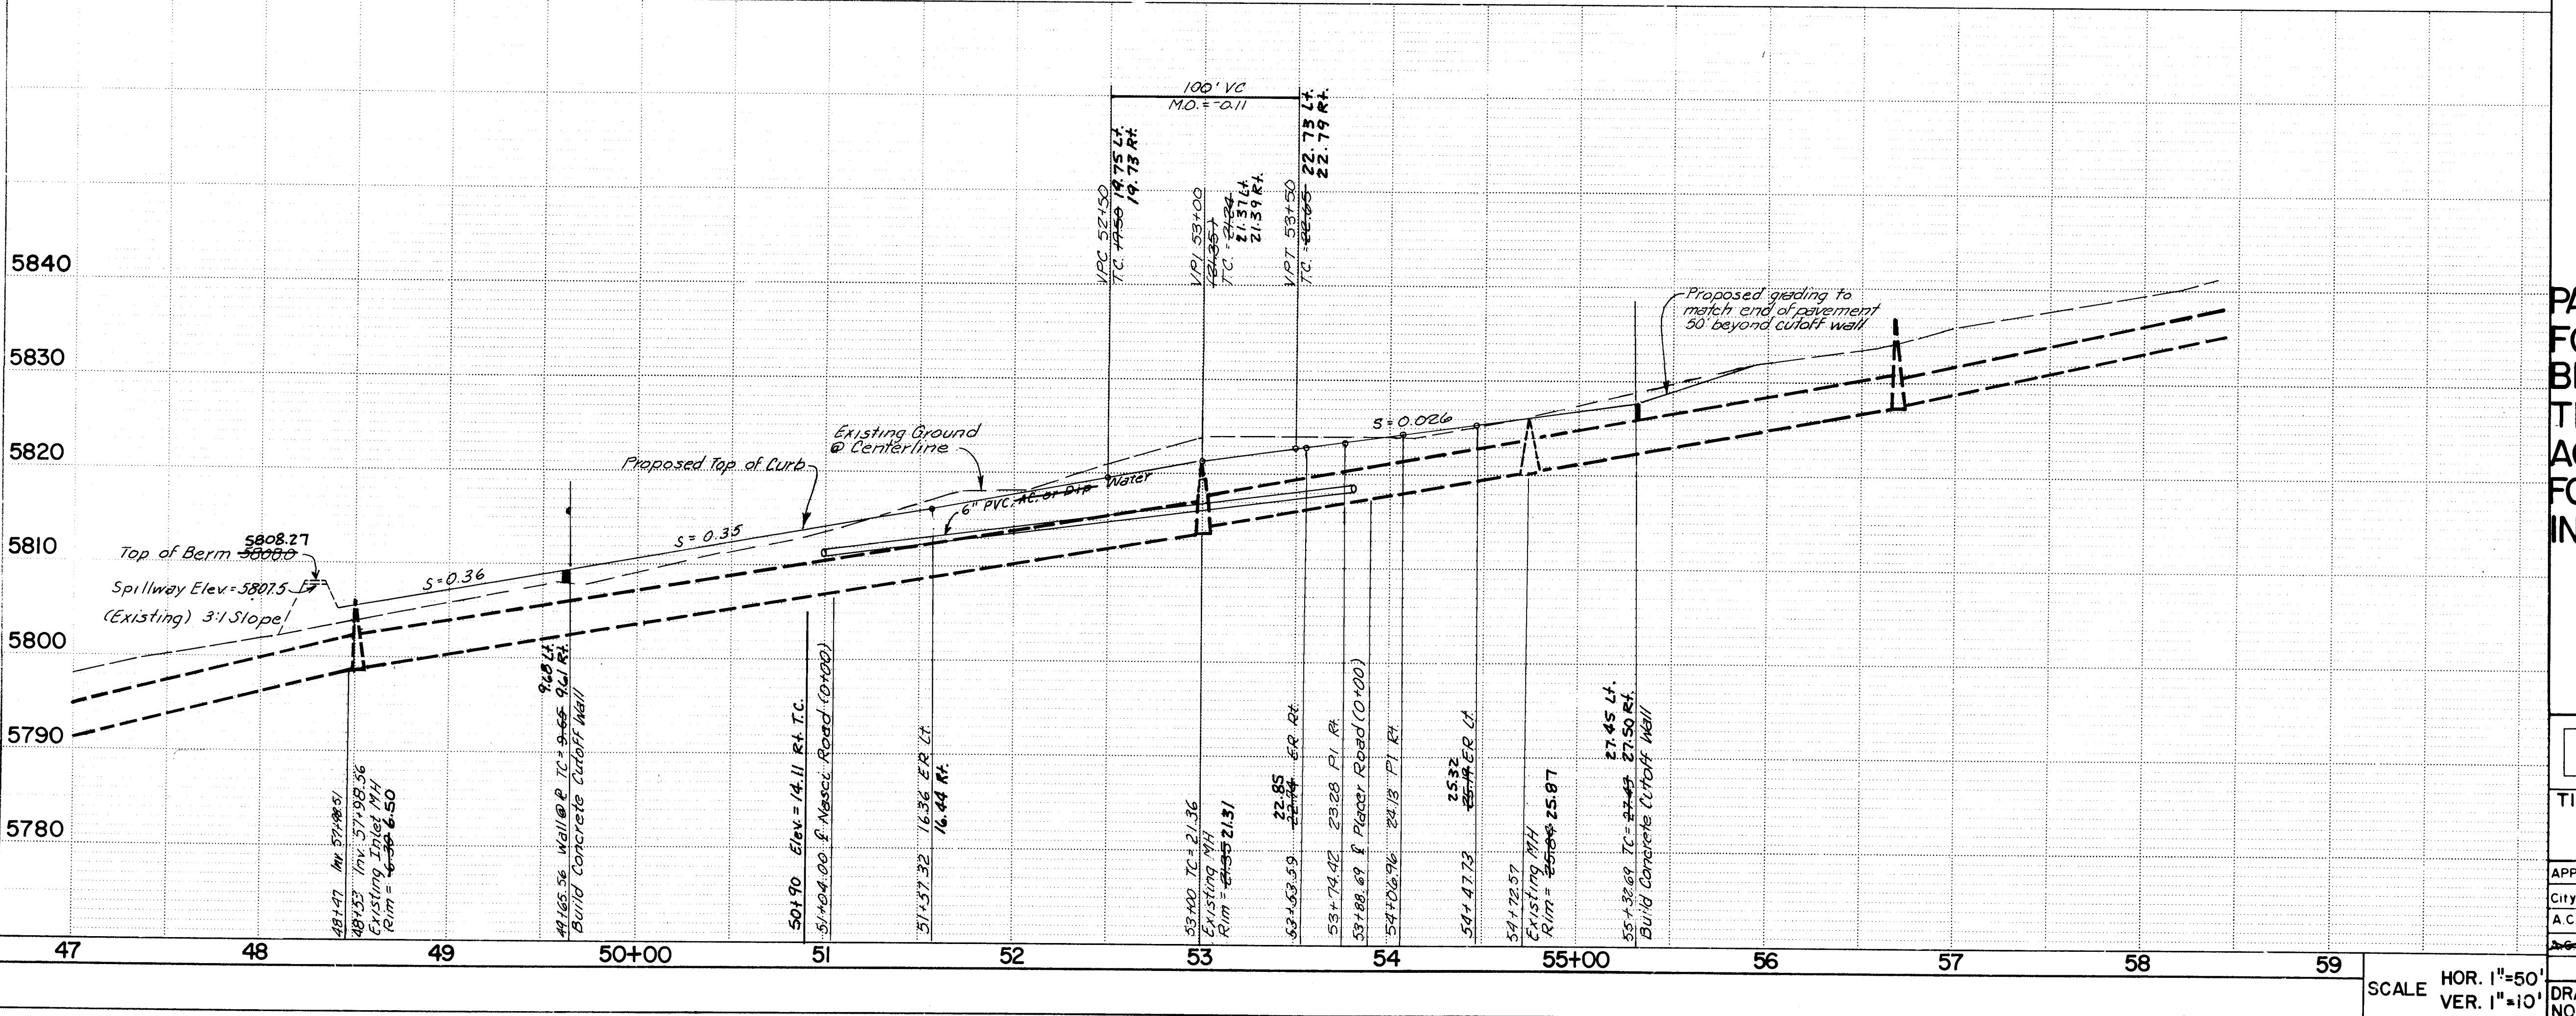

PAVING IMPROVEMENTS
FOR 2435 WILL NOT
BE ACCEPTED UNTIL
THE PAVING & DRAIN-
AGE IMPROVEMENTS
FOR THE ALLEY ARE
IN PLACE & ACCEPTED.

SECOND DRAWINGS

**CITY OF ALBUQUERQUE
MUNICIPAL DEVELOPMENT DEPARTMENT
ENGINEERING DIVISION**

PROSPECTOR'S POINT SUBDIVISION PUBLIC DRAINAGE & ACCESS R/W

ENGINEER	DATE	APPROVALS	ENGINEER
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C. D. Chapman 8/6/85	Liquid Waste	William G. Balch 5/29/85
AC 0100	Traffic	Douglas Hansen 6/2/85
gy /3 J. A. Kosloshy 6/5/85	Water	William G. Balch 5/29/85