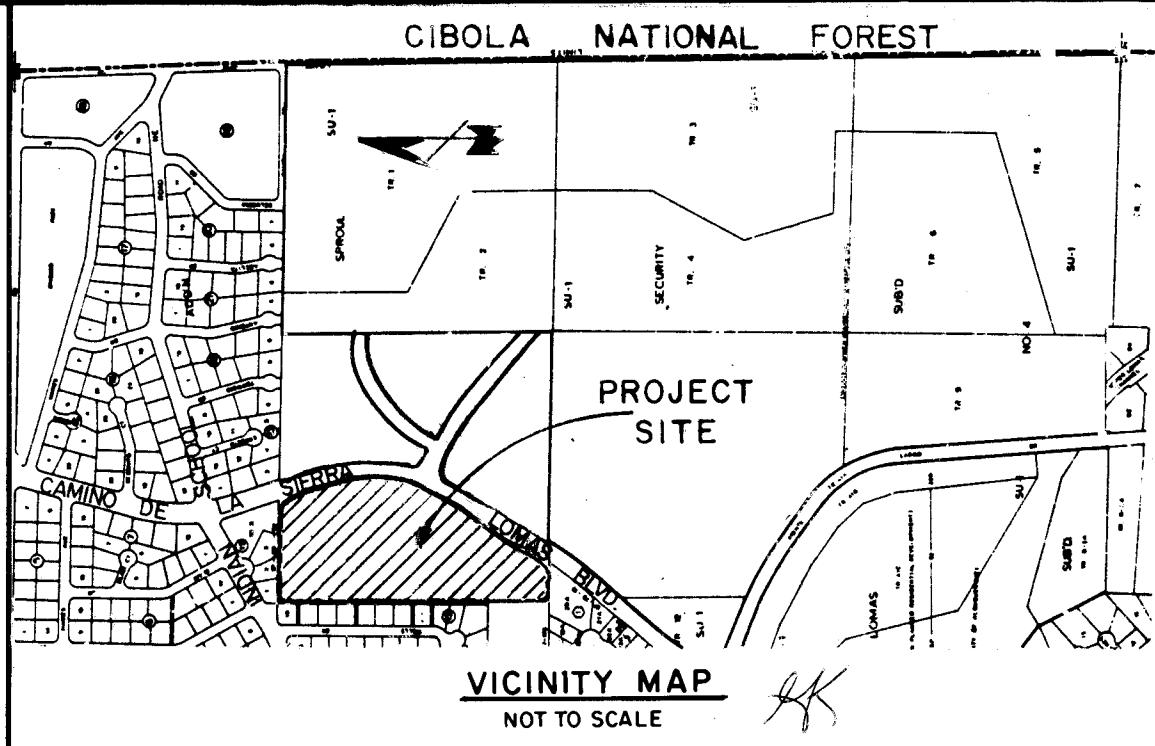


SUMMIT HILLS SUBDIVISION

WATER, SANITARY SEWER & PAVING IMPROVEMENTS

ALBUQUERQUE, NEW MEXICO



GENERAL NOTES

NOTICE TO CONTRACTORS

1. NEW MEXICO STANDARD SPECIFICATIONS FOR PUBLIC WORKS CONSTRUCTION-1979 EDITION WILL BE REFERRED TO HEREON AS THE "STANDARD SPECIFICATION."
2. ALL WORK DETAILED ON THESE PLANS TO BE PERFORMED UNDER CONTRACT SHALL, EXCEPT AS OTHERWISE STATED OR PROVIDED FOR HEREON, BE CONSTRUCTED IN ACCORDANCE WITH "PUBLIC WORKS CONTRACT 84-3" AND THE NEW MEXICO STANDARD SPECIFICATIONS FOR PUBLIC WORKS CONSTRUCTION, 1979 EDITION.
3. TWO WORKING DAYS PRIOR TO ANY EXCAVATION, CONTRACTOR MUST CONTACT LINE LOCATING SERVICE, 765-1234, FOR LOCATION OF EXISTING UTILITIES.
4. PRIOR TO CONSTRUCTION, THE CONTRACTOR SHALL EXCAVATE AND VERIFY THE HORIZONTAL AND VERTICAL LOCATIONS OF ALL OBSTRUCTIONS. SHOULD A CONFLICT EXIST, THE CONTRACTOR SHALL NOTIFY THE ENGINEER OR SURVEYOR SO THAT THE CONFLICT CAN BE RESOLVED WITH A MINIMUM AMOUNT OF DELAY.

THE FOLLOWING NOTES ALSO APPLY WHEN CHECKED

- ALL UTILITIES AND UTILITY SERVICE LINES SHALL BE INSTALLED PRIOR TO PAVING.
- BACKFILL COMPACTION SHALL BE ACCORDING TO SPECIFIED STREET USE.
- TACK COAT REQUIREMENTS SHALL BE DETERMINED BY THE CITY ENGINEER.
- SIDEWALKS AND WHEELCHAIR RAMPS WITHIN THE CURB RETURNS SHALL BE CONSTRUCTED WHEREVER A NEW CURB RETURN IS CONSTRUCTED.
- IF CURB IS DEPRESSED FOR A DRIVEPAD, THE DRIVEPAD SHALL BE CONSTRUCTED PRIOR TO ACCEPTANCE OF CURB AND GUTTER.
- ALL STORM DRAINAGE FACILITIES SHALL BE COMPLETED PRIOR TO FINAL ACCEPTANCE.
- THE REQUESTOR OR DEVELOPER SHALL BE RESPONSIBLE FOR REPAIR OR REPLACEMENT OF ALL CURB AND GUTTER OR SIDEWALK DAMAGED AFTER APPROVAL BY THE CITY ENGINEER OF WORK COMPLETED BY THE CONTRACTOR.

SHEET
NO.

DESCRIPTION

- | | |
|-------|--|
| 1 | TITLE SHEET |
| 2 - 4 | SUBDIVISION PLAT |
| 5 | GRADING PLAN |
| 6 | PAVING & STORM DRAIN PLAN |
| 7 | WATER & SANITARY SEWER DISTRIBUTION PLAN |
| 8 | WATER, SEWER, PAVING P & P-SUMMIT HILLS DRIVE |
| 9 | WATER, SEWER, PAVING P & P -
SUMMIT HILLS DRIVE/SUMMIT HILLS ROAD |
| 10 | WATER, SEWER, PAVING P & P-SUMMIT HILLS PLACE /
PINNACLE VIEW PLACE |
| 11 | WATER, SEWER, PAVING P & P -
PINNACLE VIEW PLACE /PINNACLE VIEW COURT |
| 12 | OFFSITE SANITARY SEWER P&P-TRACT A-I EASEMENT |
| 13 | STORM SEWER P&P -LOMAS BLVD. |
| 14 | DETAIL SHEET |


APPROVAL OF AS BUILT DRAWINGS
ASST. CITY ENGINEER-FIELD
W.F. McNamee
DATE 3-19-86

1	2	3	4	5	6	7	8	9	10	11	12
26	24	25	01	86							

AS CONSTRUCTED

△	6, 13 of 14	<i>Holden for cosigner</i>	1/4/85				
REV	Sheets	CITY ENGINEER	DATE	USER DEPT.	DATE	USER DEPT.	DATE
APPROVAL OF REVISIONS							

<i>Boehnert</i> NEW MEXICO REGISTERED PROFESSIONAL ENGINEER BS 44-4335	BOHANNAN - HUSTON INC. ALBUQUERQUE - SANTA FE - EL PASO ENGINEERS PLANNERS PHOTOGRAMMETRISTS	APPROVED FOR CONSTRUCTION <i>A. J. Chapman</i> 5/5/85 C.E.
PROJECT NUMBER 2425		SHEET 1 OF 14

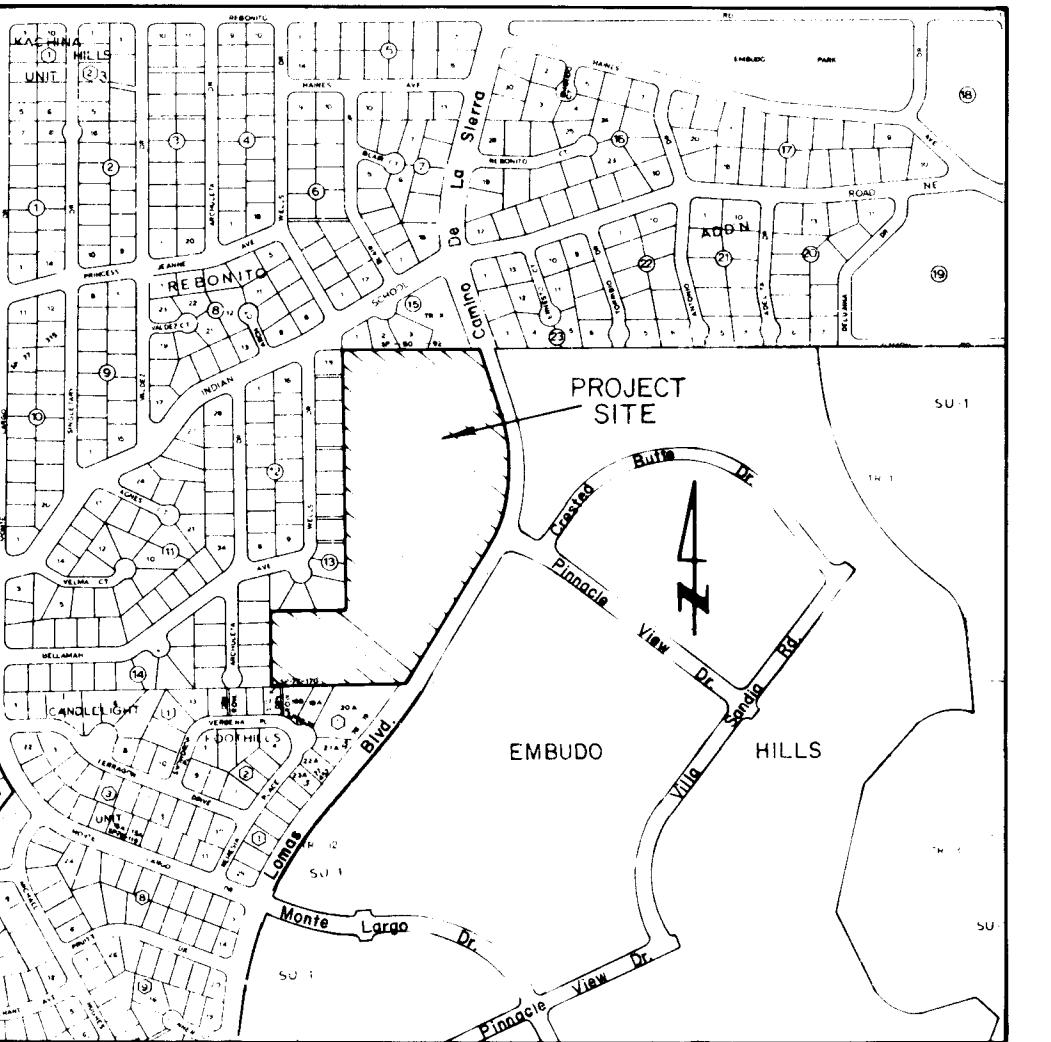

SITE MAP
NOT TO SCALE
ZONE ATLAS INDEX NO. J-23-Z

NOTES

- Bearings are New Mexico State Plane Grid Bearings (Central Zone).
- Distances are ground distances.
- Record bearings and distances of adjoining recorded plats are shown in parentheses.
- Utility Easements: The ten (10) foot utility easement shown on this plat is granted for the common and joint use of, including, but not limited to, the Gas Company of New Mexico for installation and maintenance of natural gas lines, valves and other equipment and facilities reasonably necessary to provide gas to the residents of the subdivision which shall include the rights of ingress and egress.

SUBDIVISION DATA

- DRB Number **84-438**
- Zone Atlas Index No.: **J-13-Z**
- Gross Subdivision Acreage: **17.3705 Acres.**
- Total Number of Tracts Created: **68 Tracts.**
- Total Mileage of Full Width Streets Created: **0.526 Miles.**
- 5/8"** rebar with **#1-1/4"** red plastic cap stamped "WEAVER LS 6544" were set on corners designated by ●

SURVEYOR'S CERTIFICATION

I, A. Dwain Weaver, a registered New Mexico Land Surveyor, certify that this plat was prepared by me or under my supervision, shows all easements of record, meets the minimum requirements for monumentation and surveys contained in the Albuquerque Subdivision Ordinance, and is true and accurate to the best of my knowledge and belief.

A. Dwain Weaver
A. Dwain Weaver
P.L.S. No. 6544
New Mexico
4125 Carlisle N.E.
Albuquerque, NM 87107

State of New Mexico)
ss
County of Bernalillo)

The foregoing instrument was acknowledged before me this **20** day of **February 1985**, by A. Dwain Weaver.

OFFICIAL SEAL
Marscha Weller
MARTY PUBLIC STATE OF NEW MEXICO
Notary Bond Filed with Secretary of State
2/23/86

DESCRIPTION

A certain tract of land situate within Section 14, T10N, R4E, N.M.P.M.; within the City of Albuquerque, Bernalillo County, New Mexico, being Tract "A," EMBUDO HILLS, as the same is shown and designated on the plat filed in the office of the County Clerk of Bernalillo County, New Mexico on April 19, 1984 and being more particularly described by New Mexico State Plane Grid Bearings (Central Zone) and ground distances as follows:

BEGINNING at the northeast corner of the tract herein described, said corner being the northeast corner of said Tract "A," and also being a point on the westerly right-of-way of Camino De La Sierra, whence the ACS Control Station "SIN," a brass cap (having New Mexico State Plane Grid Coordinates, Central Zone: X=429,907.35, Y=1,489,994.00), bears S43°07'53"E, 922.88 feet, and from said point of beginning running thence along the easterly boundary of said Tract "A" and also along the westerly right-of-way of Camino De La Sierra and Lomas Boulevard, S18°54'46"E, 76.01 feet to a point of curvature; thence, 47.77 feet along the arc of a curve to the right having a radius of 25.00 feet and a chord bearing S35°44'21"W, 40.82 feet to a point of tangency; thence, S30°31'55"E, 58.34 feet to a point of curvature; thence, 28.59 feet along the arc of a curve to the right having a radius of 25.00 feet and a chord bearing S56°45'39"E, 27.06 feet to a point of compound curvature; thence, 116.85 feet along the arc of a curve to the right having a radius of 1338.96 feet and a chord bearing S21°29'46"E, 116.81 feet to a point of tangency; thence, S18°59'46"E, 16.94 feet to a point of curvature; thence, 45.61 feet along the arc of a curve to the right having a radius of 521.49 feet and a chord bearing S05°58'41"W, 440.36 feet to a point of tangency; thence, S30°57'08"W, 397.49 feet to a point of curvature; thence, 128.23 feet along the arc of a curve to the right having a radius of 2841.52 feet and a chord bearing S32°14'42"W, 128.22 feet to a point of compound curvature; thence, 39.61 feet along the arc of a curve to the right having a radius of 25.00 feet and a chord bearing S78°55'28"E, 35.59 feet to a point of tangency; thence, S34°47'57"W, 50.00 feet to a point of curvature; thence, 39.82 feet along the arc of a curve to the right having a radius of 25.00 feet and a chord bearing S10°03'30"E, 35.74 feet to a point of compound curvature; thence, 46.12 feet along the arc of a curve to the right having a radius of 2841.52 feet and a chord bearing S36°02'14"W, 46.11 feet to the southeast corner of the tract herein described, also being the southeast corner of said Tract "A"; thence leaving said easterly boundary and said westerly right-of-way and continuing along the southerly boundary of said Tract "A," S89°26'00"W, 219.11 feet to a point; thence, S89°45'46"W, 291.73 feet to the southwest corner of the tract herein described, also being the southwest corner of said Tract "A"; thence continuing along the westerly boundary of said Tract "A," N00°06'33"W, 295.16 feet to a point; thence, S89°35'33"E, 295.16 feet to a point; thence, N00°06'33"W, 1010.97 feet to the northwest corner of the tract herein described, also being the northwest corner of said Tract "A"; thence continuing along the northerly boundary of said Tract "A," S89°31'32"E, 498.56 feet to a point; thence, S89°31'45"E, 21.21 feet to the point and place of beginning

Tract contains 17.3705 acres, more or less.

CURVE DATA

NR.	RADIUS	ARC	CHORD	DELTA	TANGENT
C1	521.49'	454.61'	440.36'	49°56'54"E	242.89'
C2	280.52'	228.23'	228.23'	00°35'08"E	64.13'
C3	301.59'	267.11'	267.11'	00°35'08"E	134.10'
C4	2841.52'	46.12'	46.11'	00°55'47"E	23.06'
C5	25.00'	39.82'	35.74'	91°15'41"E	25.56'
C6	45.00'	39.59'	39.59'	08°54'46"E	3.51'
C7	45.00'	39.59'	39.59'	08°54'46"E	21.09'
C8	45.00'	34.38'	33.55'	43°46'31"E	18.08'
C9	45.00'	6.00'	6.00'	07°38'22"E	3.00'
C10	45.00'	1.50'	1.50'	03°25'38"E	.75'
C11	23.00'	8.86'	8.86'	18.21'34"E	4.04'
C12	23.00'	8.86'	8.86'	18.21'34"E	21.77'
C13	45.00'	43.39'	39.91'	51°00'14"E	21.77'
C14	45.00'	35.76'	34.83'	45°31'48"E	18.88'
C15	45.00'	29.22'	28.71'	37°12'25"E	15.15'
C16	45.00'	9.51'	9.45'	21°47'12"E	4.81'
C17	23.00'	4.07'	4.07'	108.00'00"E	35.35'
C18	25.00'	28.59'	27.06'	25°31'46"E	16.09'
C19	1338.96'	78.70'	78.69'	03°22'04"E	39.36'
C20	1338.96'	38.14'	38.14'	01°37'56"E	19.07'
C21	521.49'	100.15'	100.00'	11°00'14"E	50.23'
C22	521.49'	100.15'	100.00'	11°00'14"E	41.91'
C23	521.49'	18.83'	19.93'	02°11'25"E	9.07'
C24	2841.52'	40.00'	40.00'	00°48'24"E	20.00'
C25	2841.52'	88.23'	88.23'	01°46'45"E	44.12'
C26	1338.96'	116.85'	116.85'	05°00'00"E	58.46'
C27	2841.52'	50.85'	50.85'	01°11'00"E	25.56'
C28	25.00'	39.61'	35.59'	90°46'23"E	25.41'
C29	50.00'	48.50'	46.62'	55°34'48"E	26.35'
C30	25.00'	39.52'	35.53'	90°35'00"E	25.26'
C31	25.00'	25.00'	24.64'	24.64'	14.16'
C32	45.00'	38.38'	38.38'	59°03'00"E	8.85'
C33	45.00'	42.04'	40.53'	33.52'55"E	2.05'
C34	45.00'	35.64'	34.72'	45°22'55"E	22.70'
C35	45.00'	36.19'	37.05'	48°37'32"E	20.33'
C36	45.00'	36.95'	48.23'	08°20'00"E	20.26'
C37	45.00'	23.37'	22.51'	23°51'55"E	16.56'
C38	25.00'	16.09'	15.81'	36°52'12"E	8.33'
C39	25.00'	39.02'	35.17'	89°24'59"E	24.75'
C40	25.00'	19.38'	18.90'	44°24'55"E	10.21'
C41	45.00'	14.83'	14.83'	22.00'00"E	8.85'
C42	45.00'	38.62'	37.44'	49°10'13"E	20.59'
C43	45.00'	26.45'	26.07'	33°40'47"E	13.62'
C44	416.49'	7.92'	7.92'	01°05'23"E	3.96'
C45	416.49'	66.72'	66.72'	09°11'19"E	33.47'
C46	416.49'	14.83'	14.83'	02°36'38"E	7.43'
C47	45.00'	24.45'	22.48'	30°46'16"E	10.39'
C48	45.00'	31.75'	31.10'	40°25'43"E	16.57'
C49	45.00'	30.85'	30.25'	39°17'01"E	16.06'
C50	25.00'	13.53'	13.36'	31°00'10"E	6.93'
C51	11.00'	7.05'	7.05'	00°00'00"E	5.57'
C52	45.00'	69.60'	62.87'	88°35'59"E	43.83'
C53	366.49'	61.27'	61.19'	09°34'41"E	30.70'
C54	366.49'	78.26'	78.14'	12°14'20"E	39.29'
C55	45.00'	54.64'	51.34'	69°34'00"E	31.26'
C56	55.49'	43.73'	43.73'	46°10'04"E	23.07'
C57	551.49'	33.02'	33.01'	03°25'50"E	16.51'
C58	287.52'	256.33'	256.25'	05°06'53"E	128.25'
C59	391.49'	267.84'	262.65'	39°11'58"E	139.40'


NR.	DISTANCE	BEARING
T1	21.21'	S89°31'45"E
T2	10.00'	S34°18'39"E
T3	31.10'	N55°41'21"W
T4	10.00'	S30°31'55"E
T5	10.00'	S00°28'28"E
T6	22.77'	S89°31'32"E
T7	20.97'	S61°59'33"E
T8	10.00'	S98°36'00"E
T9	17.83'	S30°31'55"E
T10	29.17'	S30°31'55"E
T11	25.00'	S34°47'57"W
T12	9.94'	S18°59'46"E
T13	7.03'	S89°31'32"E
T14	12.89'	S89°31'32"E
T15	33.80'	S89°31'32"E
T16	18.57'	S89°31'32"E
T17	25.56'	S89°31'32"E
T18	22.26'	S89°31'32"E
T19	52.19'	N60°19'09"E
T20	73.74'	S60°19'09"E
T21	89.54'	S60°19'09"E
T22	68.00'	S60°19'09"E
T23	44.00'	S00°28'28"E
T24	80.00'	S89°02'52"E
T25	75.48'	S59°02'52"E
T26	110.48'	S89°31'32"E
T27	70.00'	S89°31'32"E
T28	89.54'	S89°31'32"E
T29	75.00'	S89°31'32

SUBDIVISION PLAT MAP FOR
SUMMIT HILLS


WITHIN SECTION 14, T1ON, R4E, N.M.P.M.
ALBUQUERQUE, NEW MEXICO

FEBRUARY, 1985

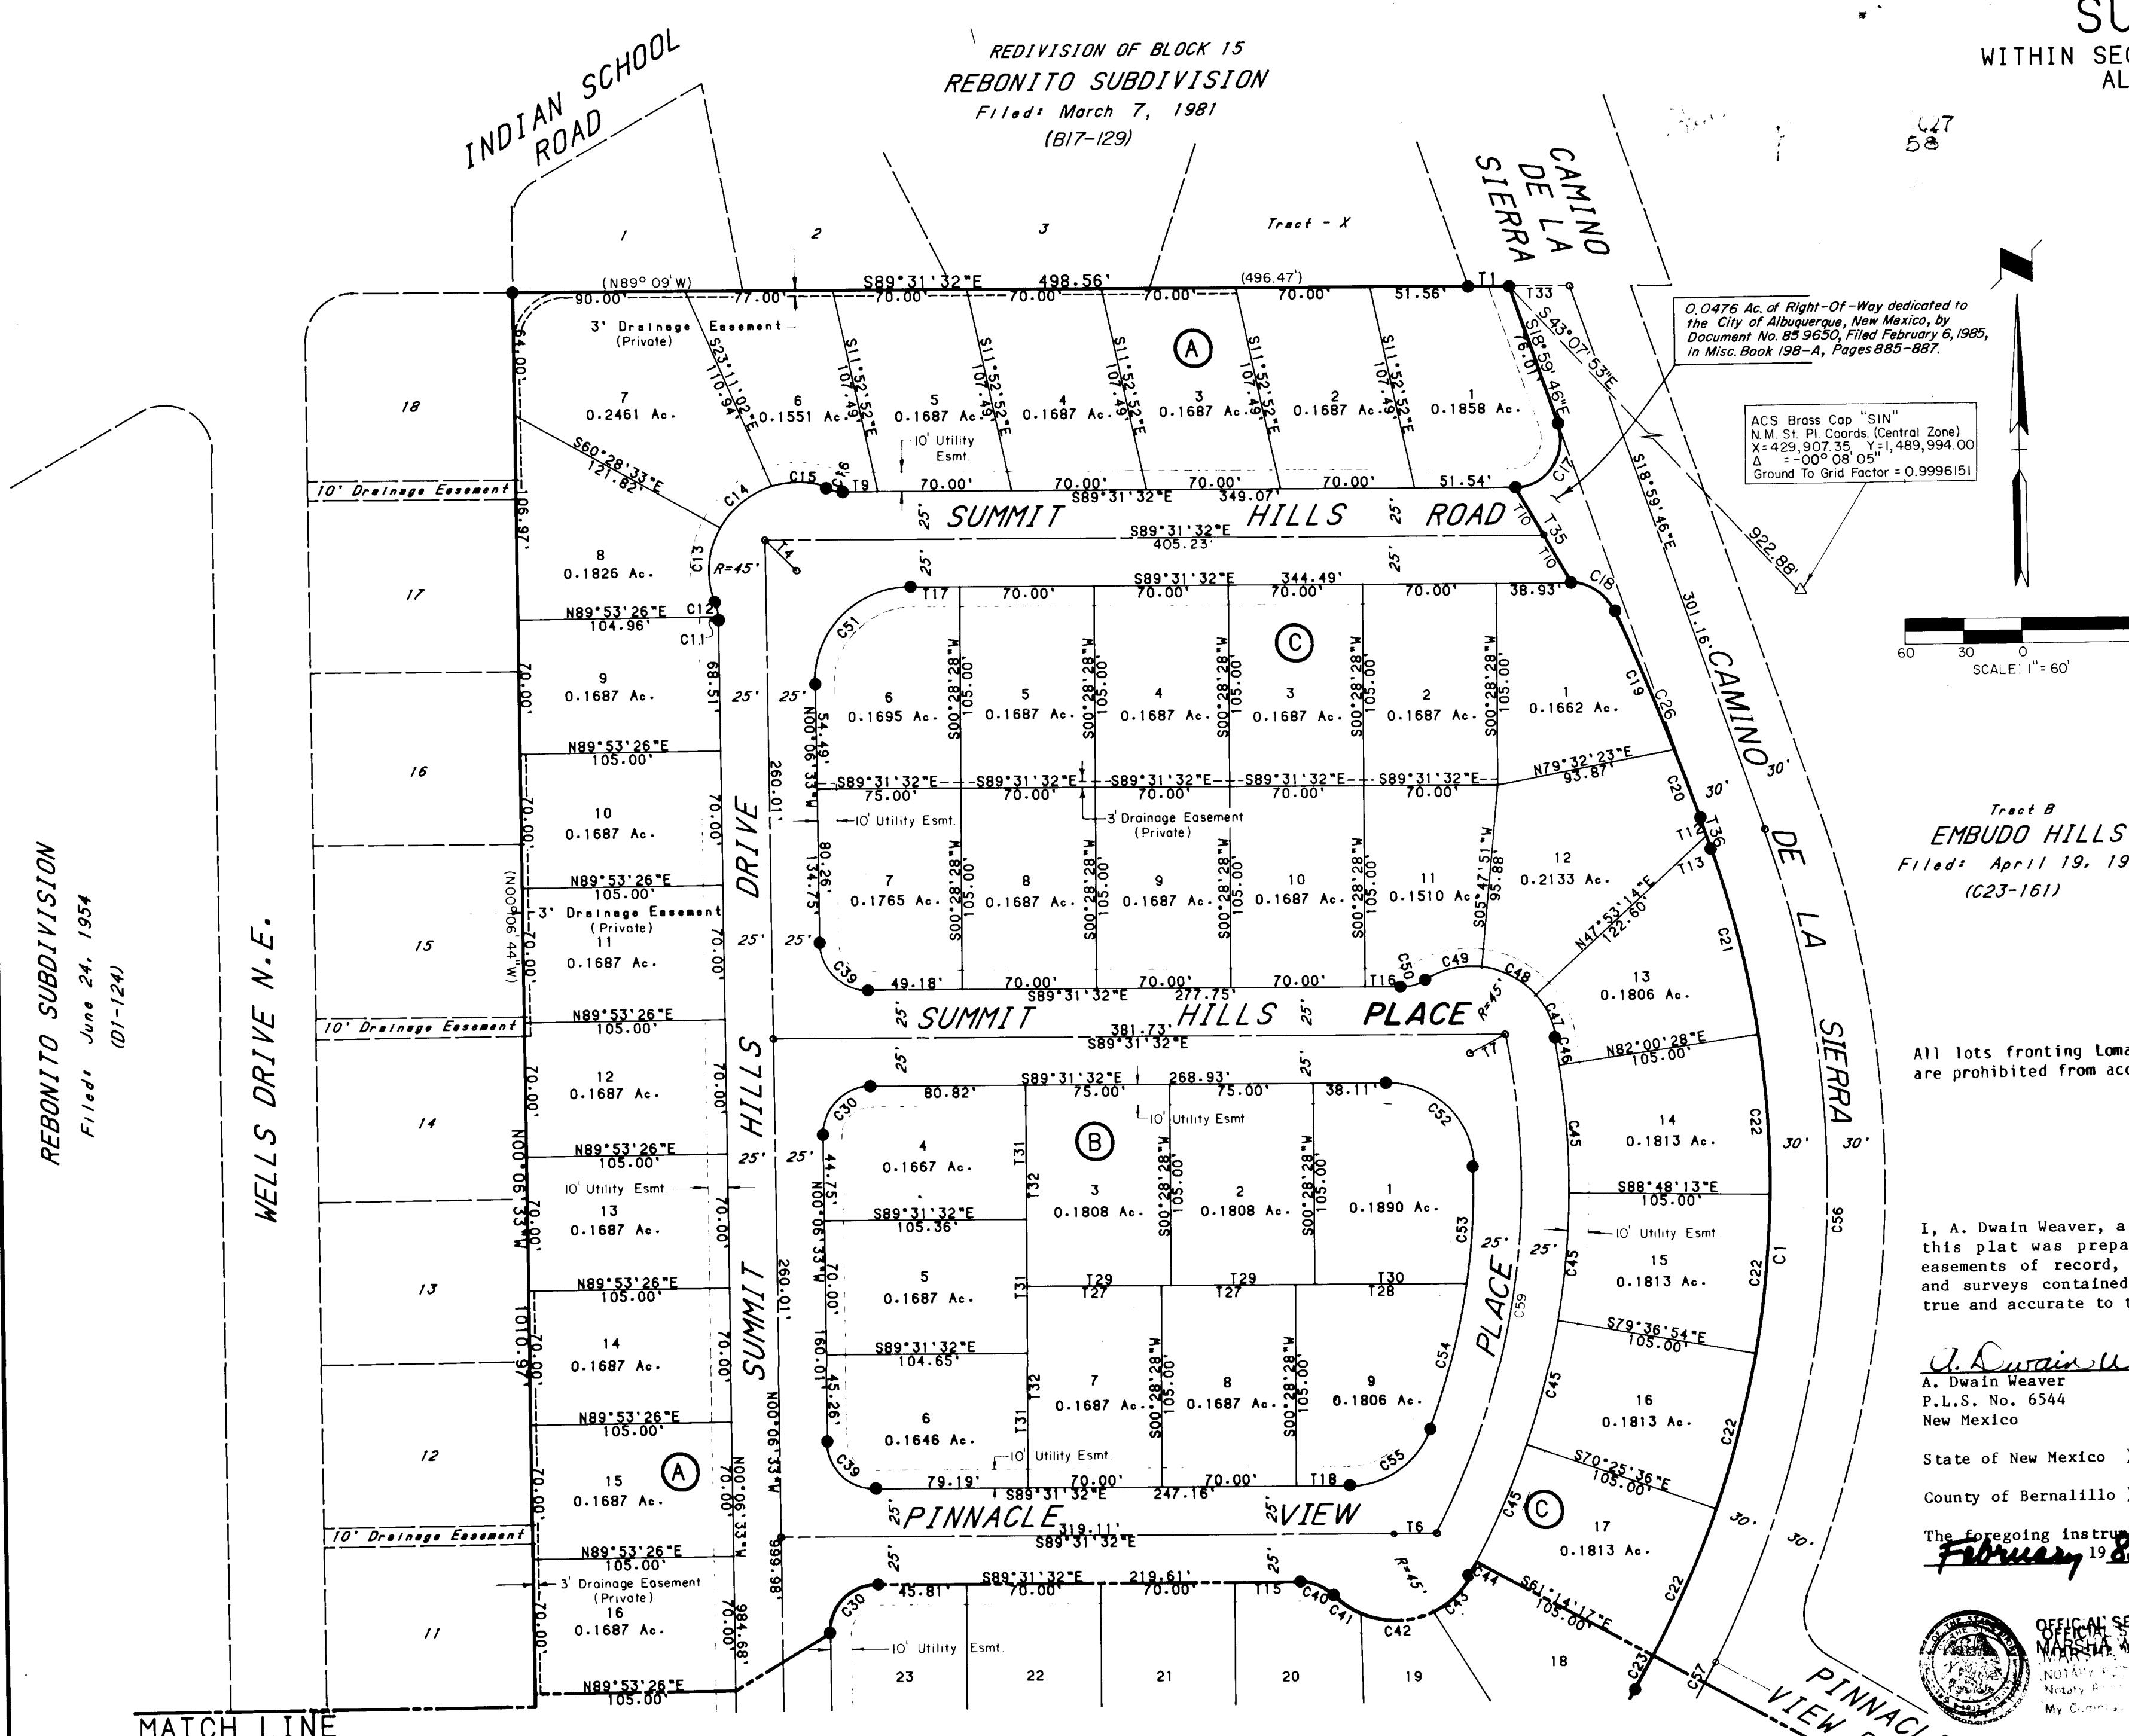REDIVISION OF BLOCK 15
REBONITO SUBDIVISION
Filed: March 7, 1981
(B17-129)



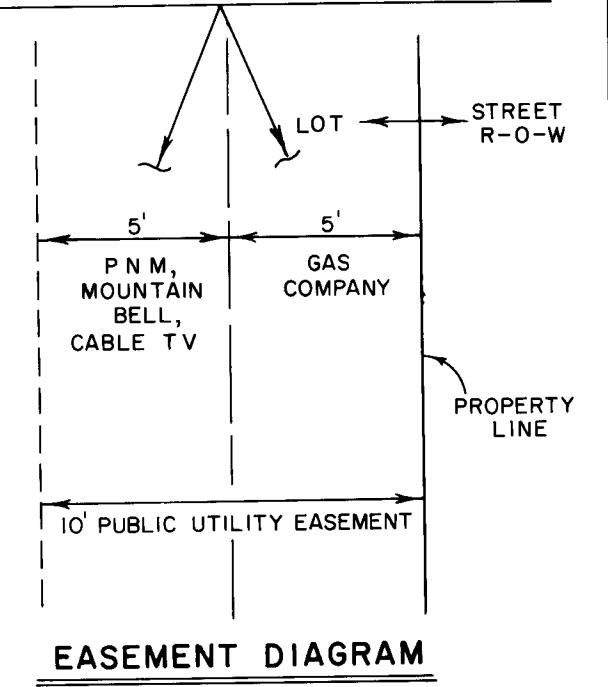Within the 10' Public Utility Easement, typical 5' wide lanes are designated for underground installation use specifically by the utilities indicated in the diagram. Each utility shall have the right to make perpendicular crossings in the opposite lane.



EASEMENT DIAGRAM
NOT TO SCALE

Tract 8
EMBUDO HILLS
Filed: April 19, 1984
(C23-161)

NOTE

All lots fronting Lomas Boulevard or Camino de la Sierra right-of-way are prohibited from access to same.

SURVEYOR'S CERTIFICATION

I, A. Dwain Weaver, a registered New Mexico Land Surveyor, certify that this plat was prepared by me or under my supervision, shows all easements of record, meets the minimum requirements for monumentation and surveys contained in the Albuquerque Subdivision Ordinance, and is true and accurate to the best of my knowledge and belief.

A. Dwain Weaver

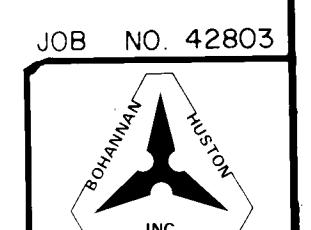
A. Dwain Weaver
P.L.S. No. 6544
New Mexico

State of New Mexico)
County of Bernalillo)

The foregoing instrument was acknowledged before me this 20 day of February 1985, by A. Dwain Weaver.

Dwain Weaver
Notary Public
My Comm. No. 123456
1/23/85

OFFICIAL SEAL
NEW MEXICO
NOTARY PUBLIC
DWAIN WEAVER
My Comm. No. 123456
1/23/85



JOB NO. 42803

2 3 4 5 6 7 8 9 10 11 12
Z G Z 4 2 5 0 3 8 6

SHEET 2 OF 3 SHEETS


AS CONSTRUCTED

PROJECT NUMBER	2425	SHEET 3 OF 14
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SUBDIVISION PLAT MAP FOR
SUMMIT HILLS

WITHIN SECTION 14, T10N, R4E, N.M.P.M.
ALBUQUERQUE, NEW MEXICO
FEBRUARY, 1985

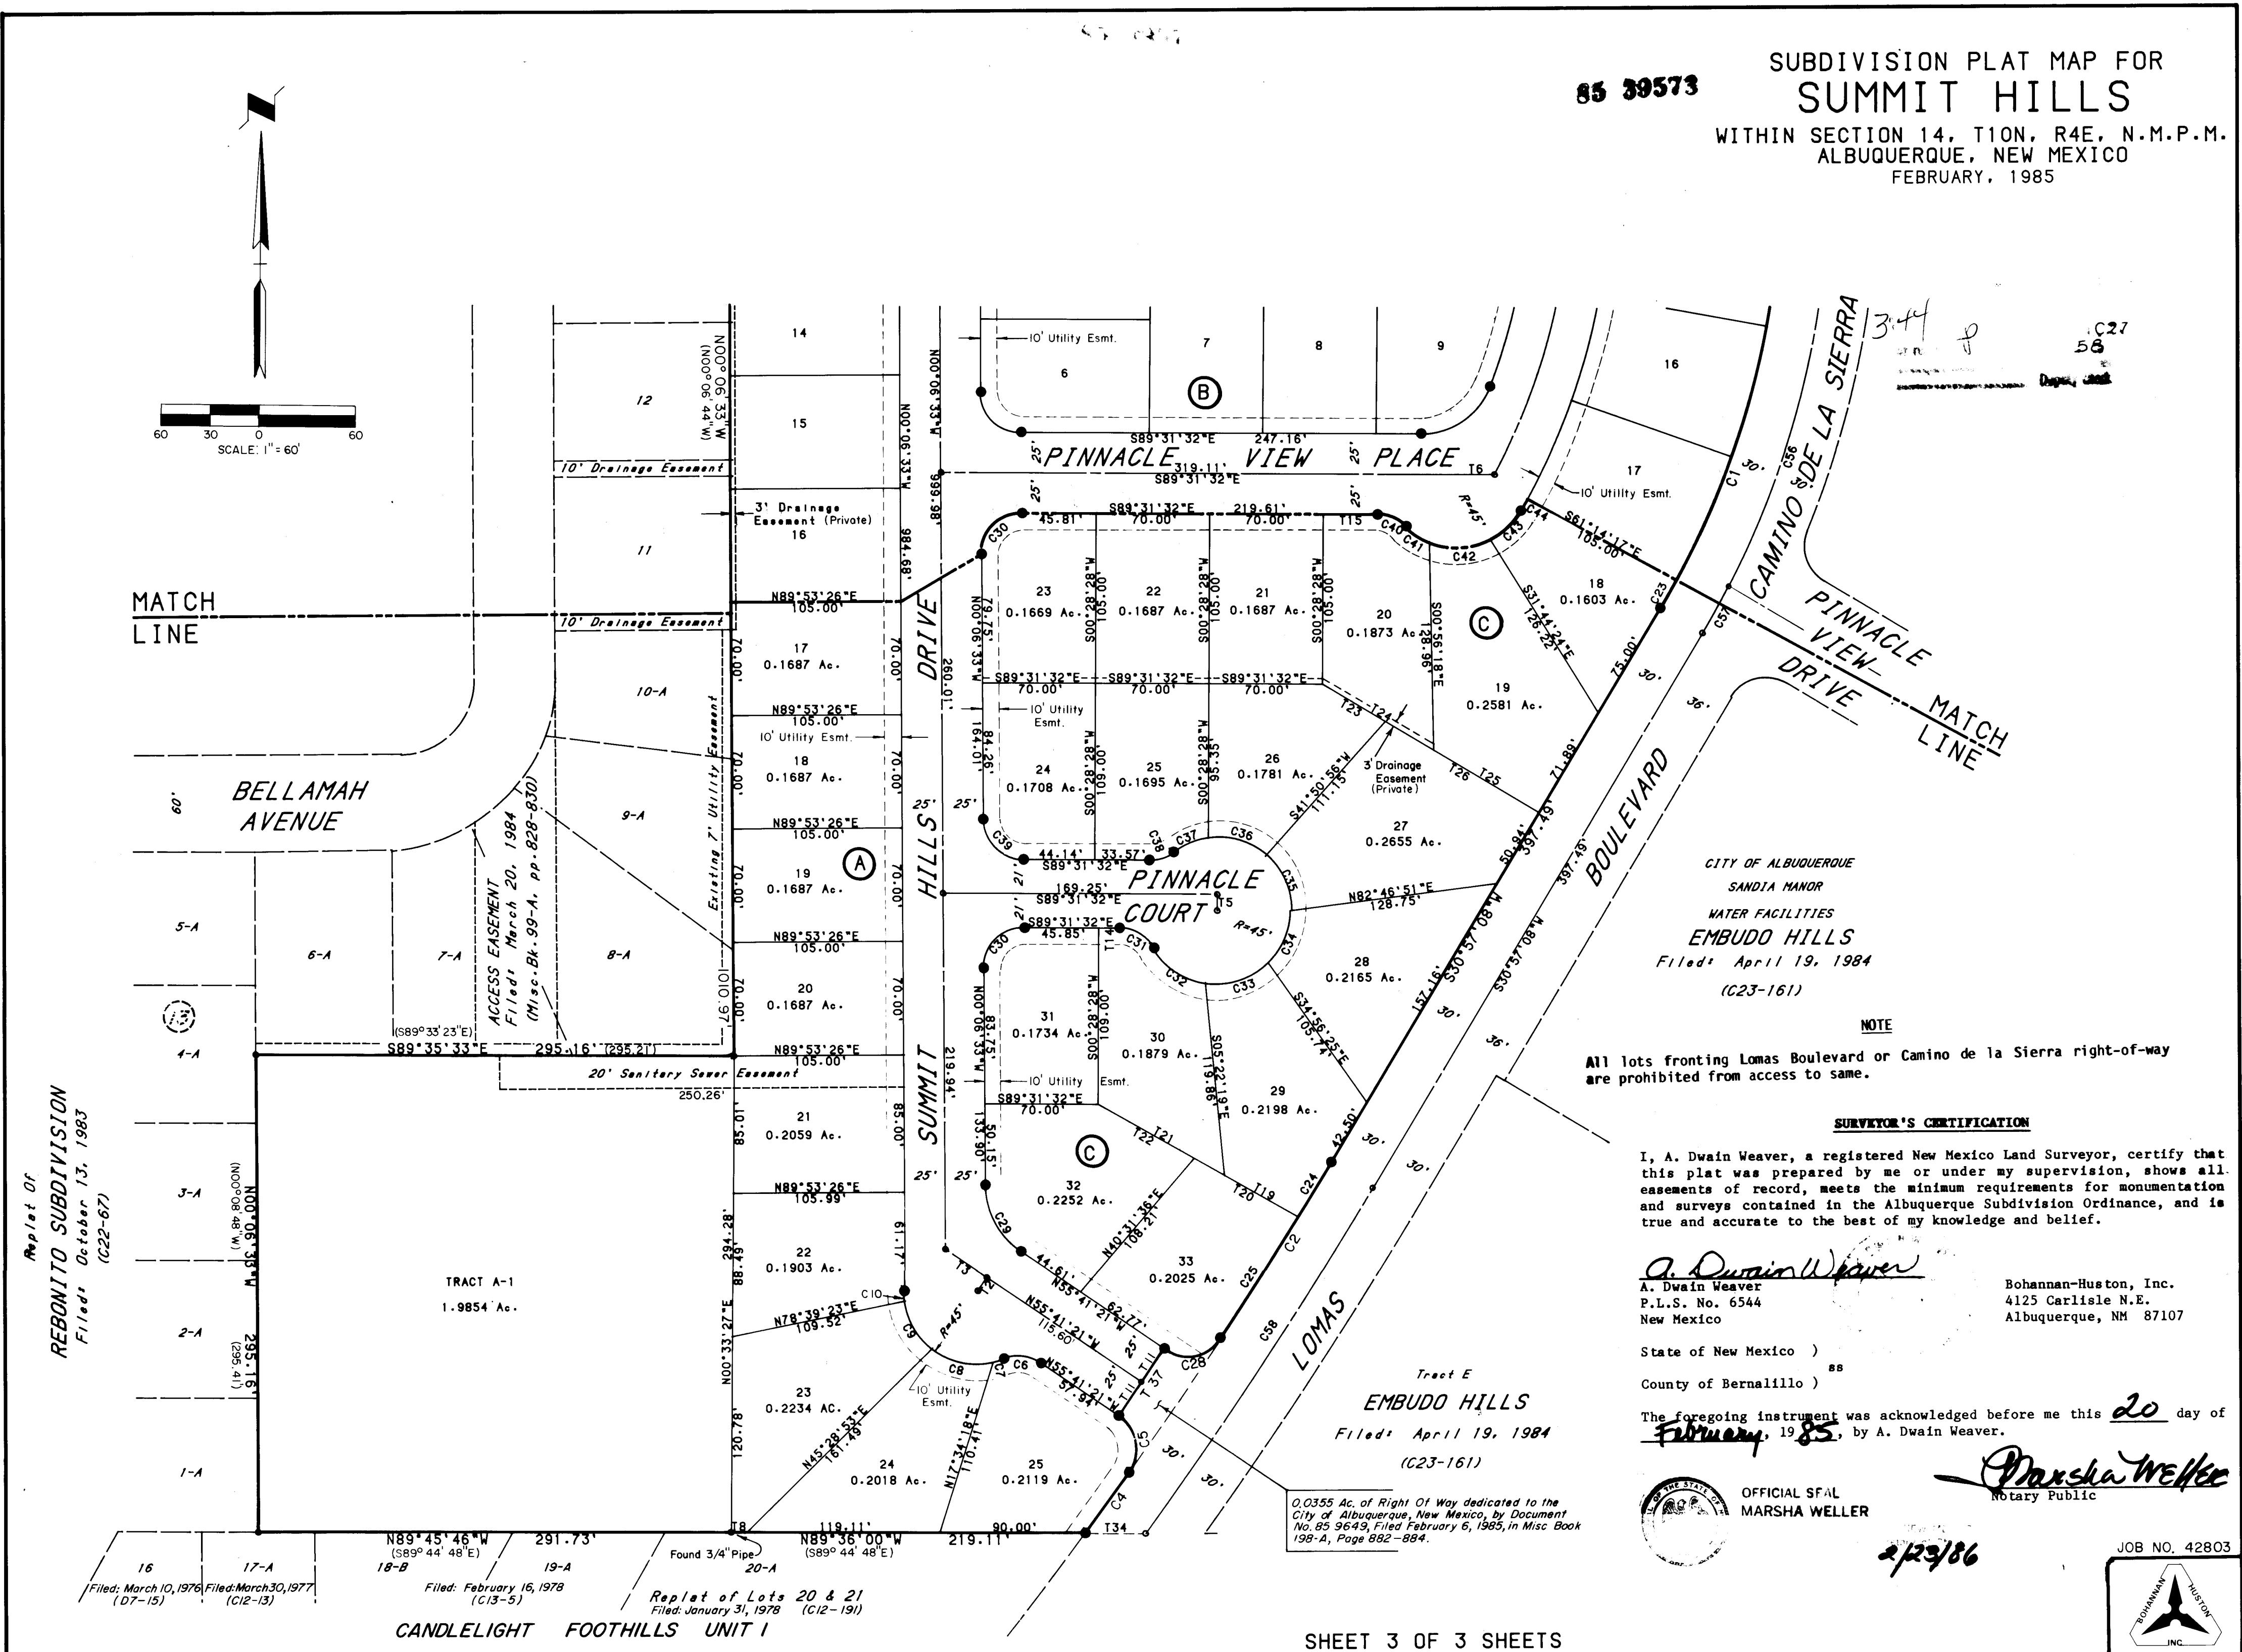85 39573






SHEET 3 OF 3 SHEETS

1 2 3 4 5 6 7 8 9 10 11 12
2 6 12 4 2 5 1 0 4 8 6

AS CONSTRUCTED

PROJECT NUMBER	2425
SHEET 4 OF 14	

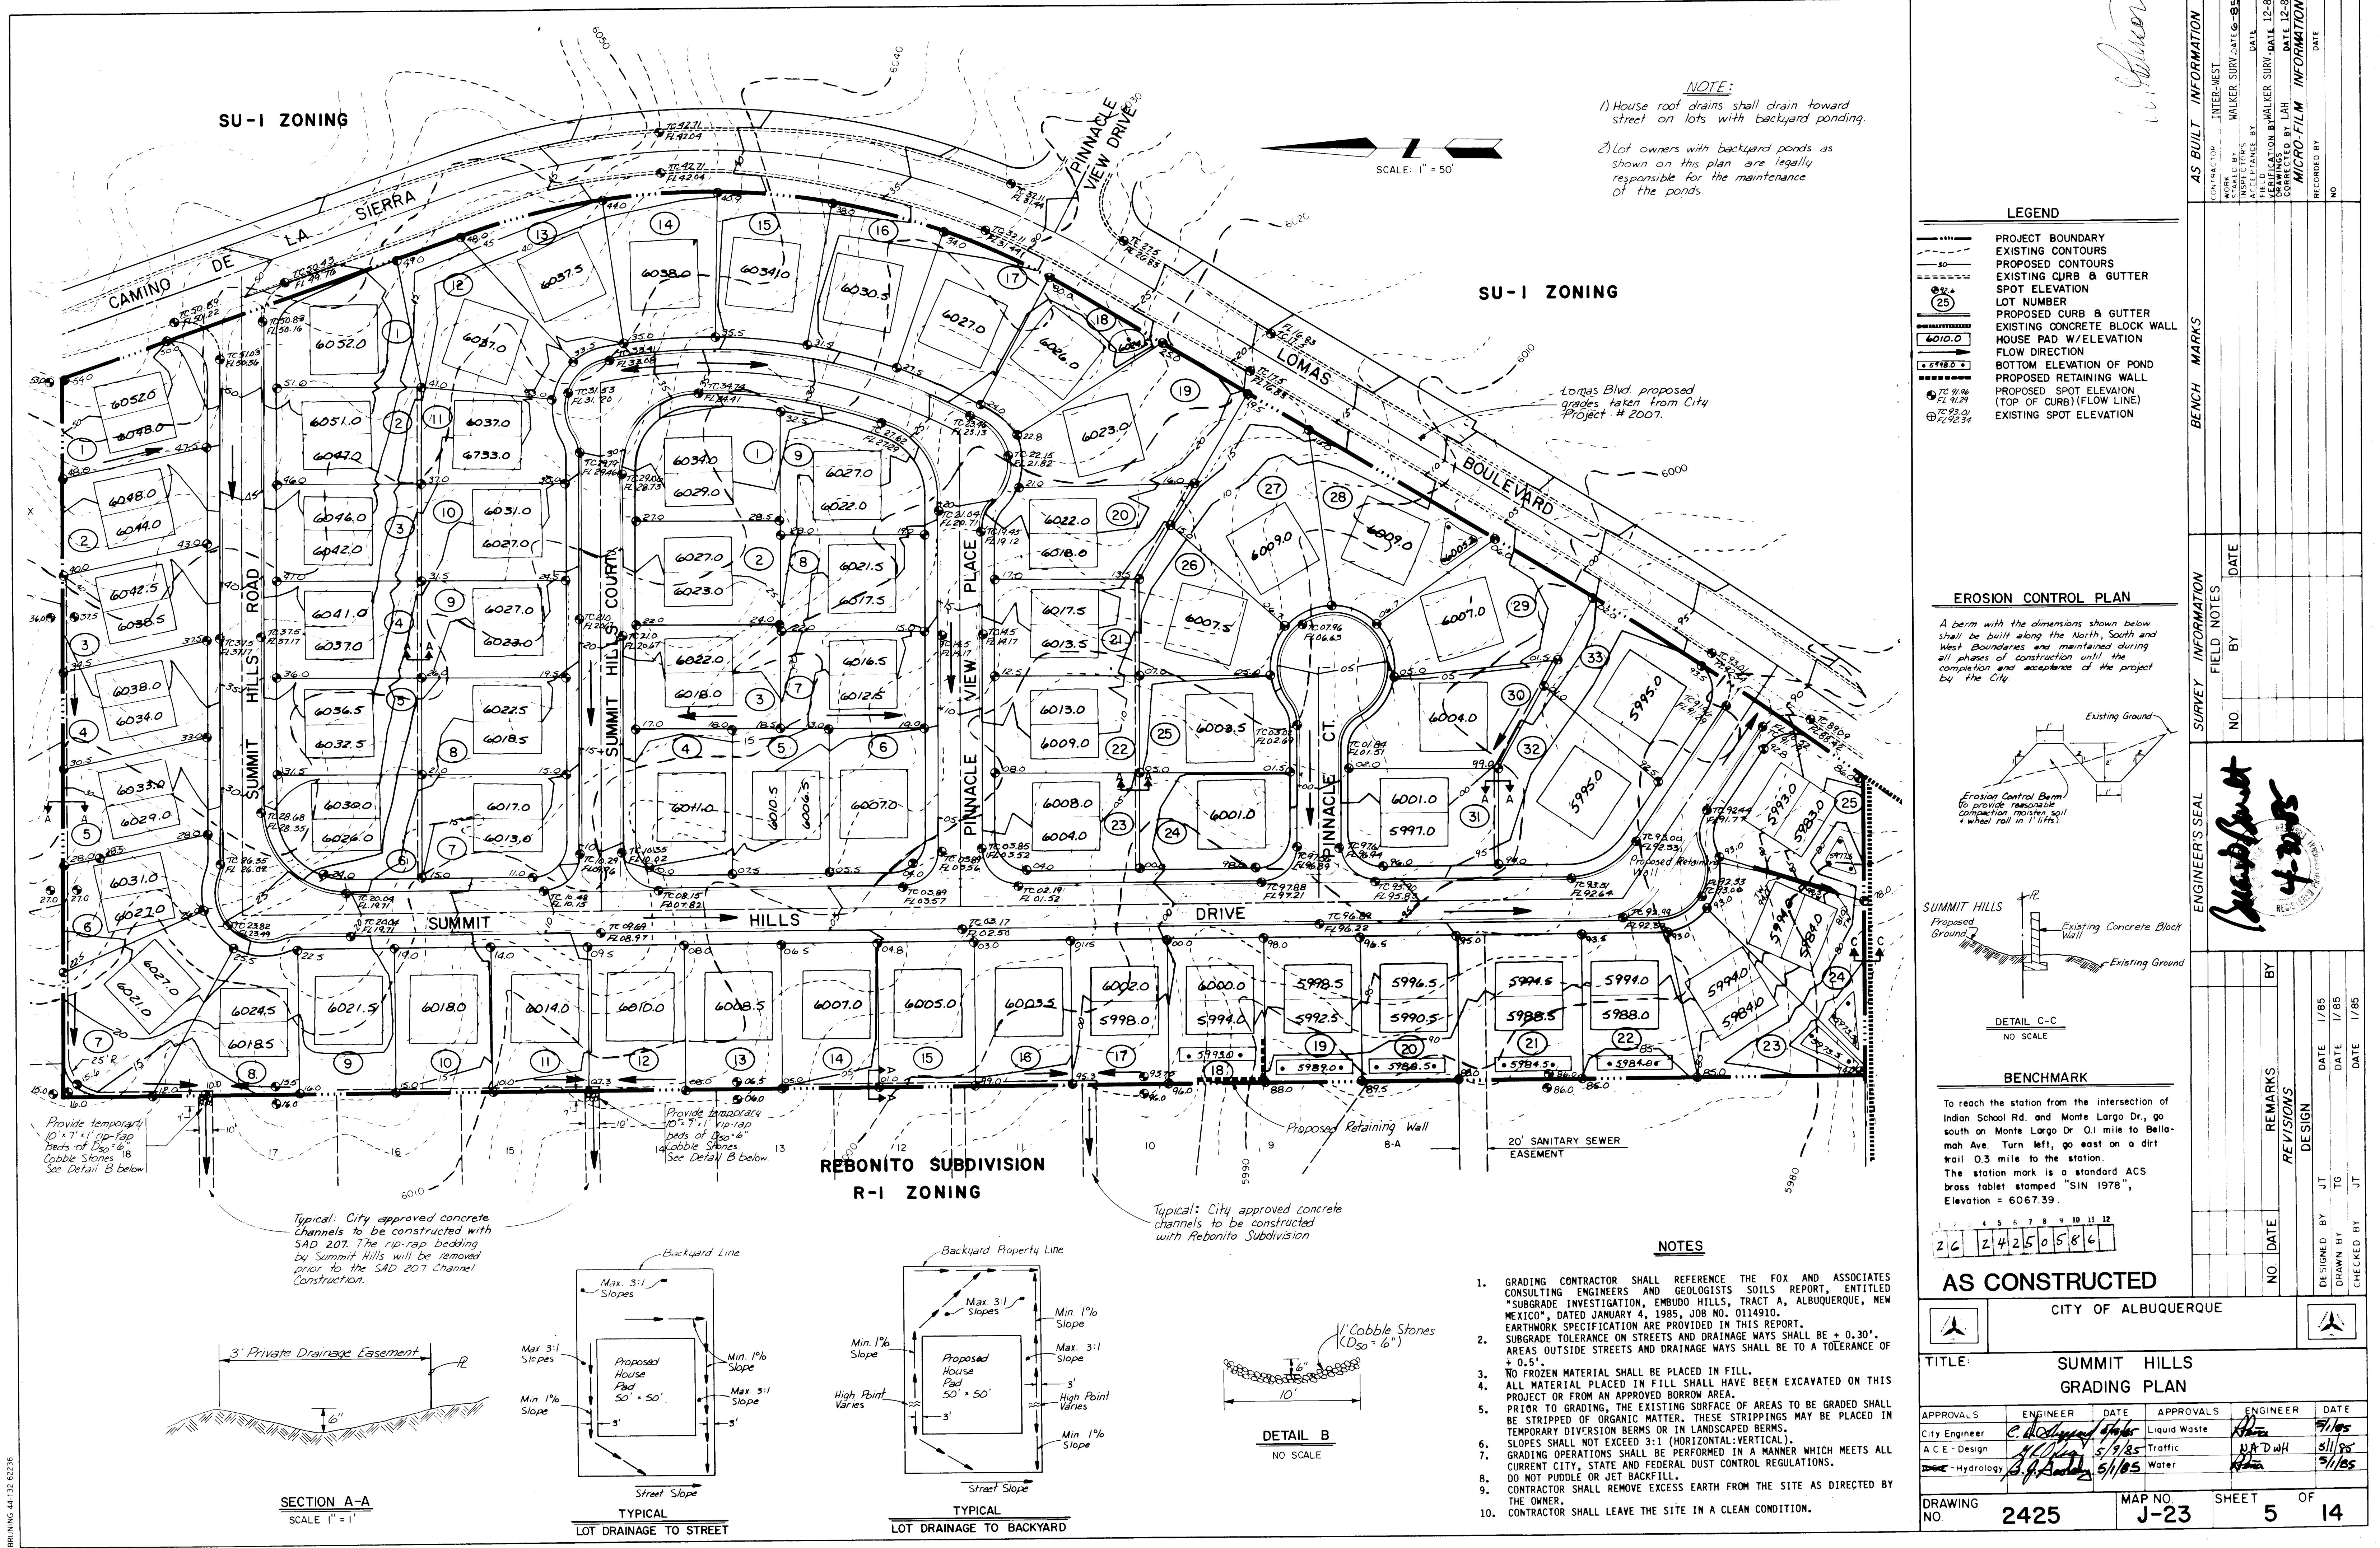

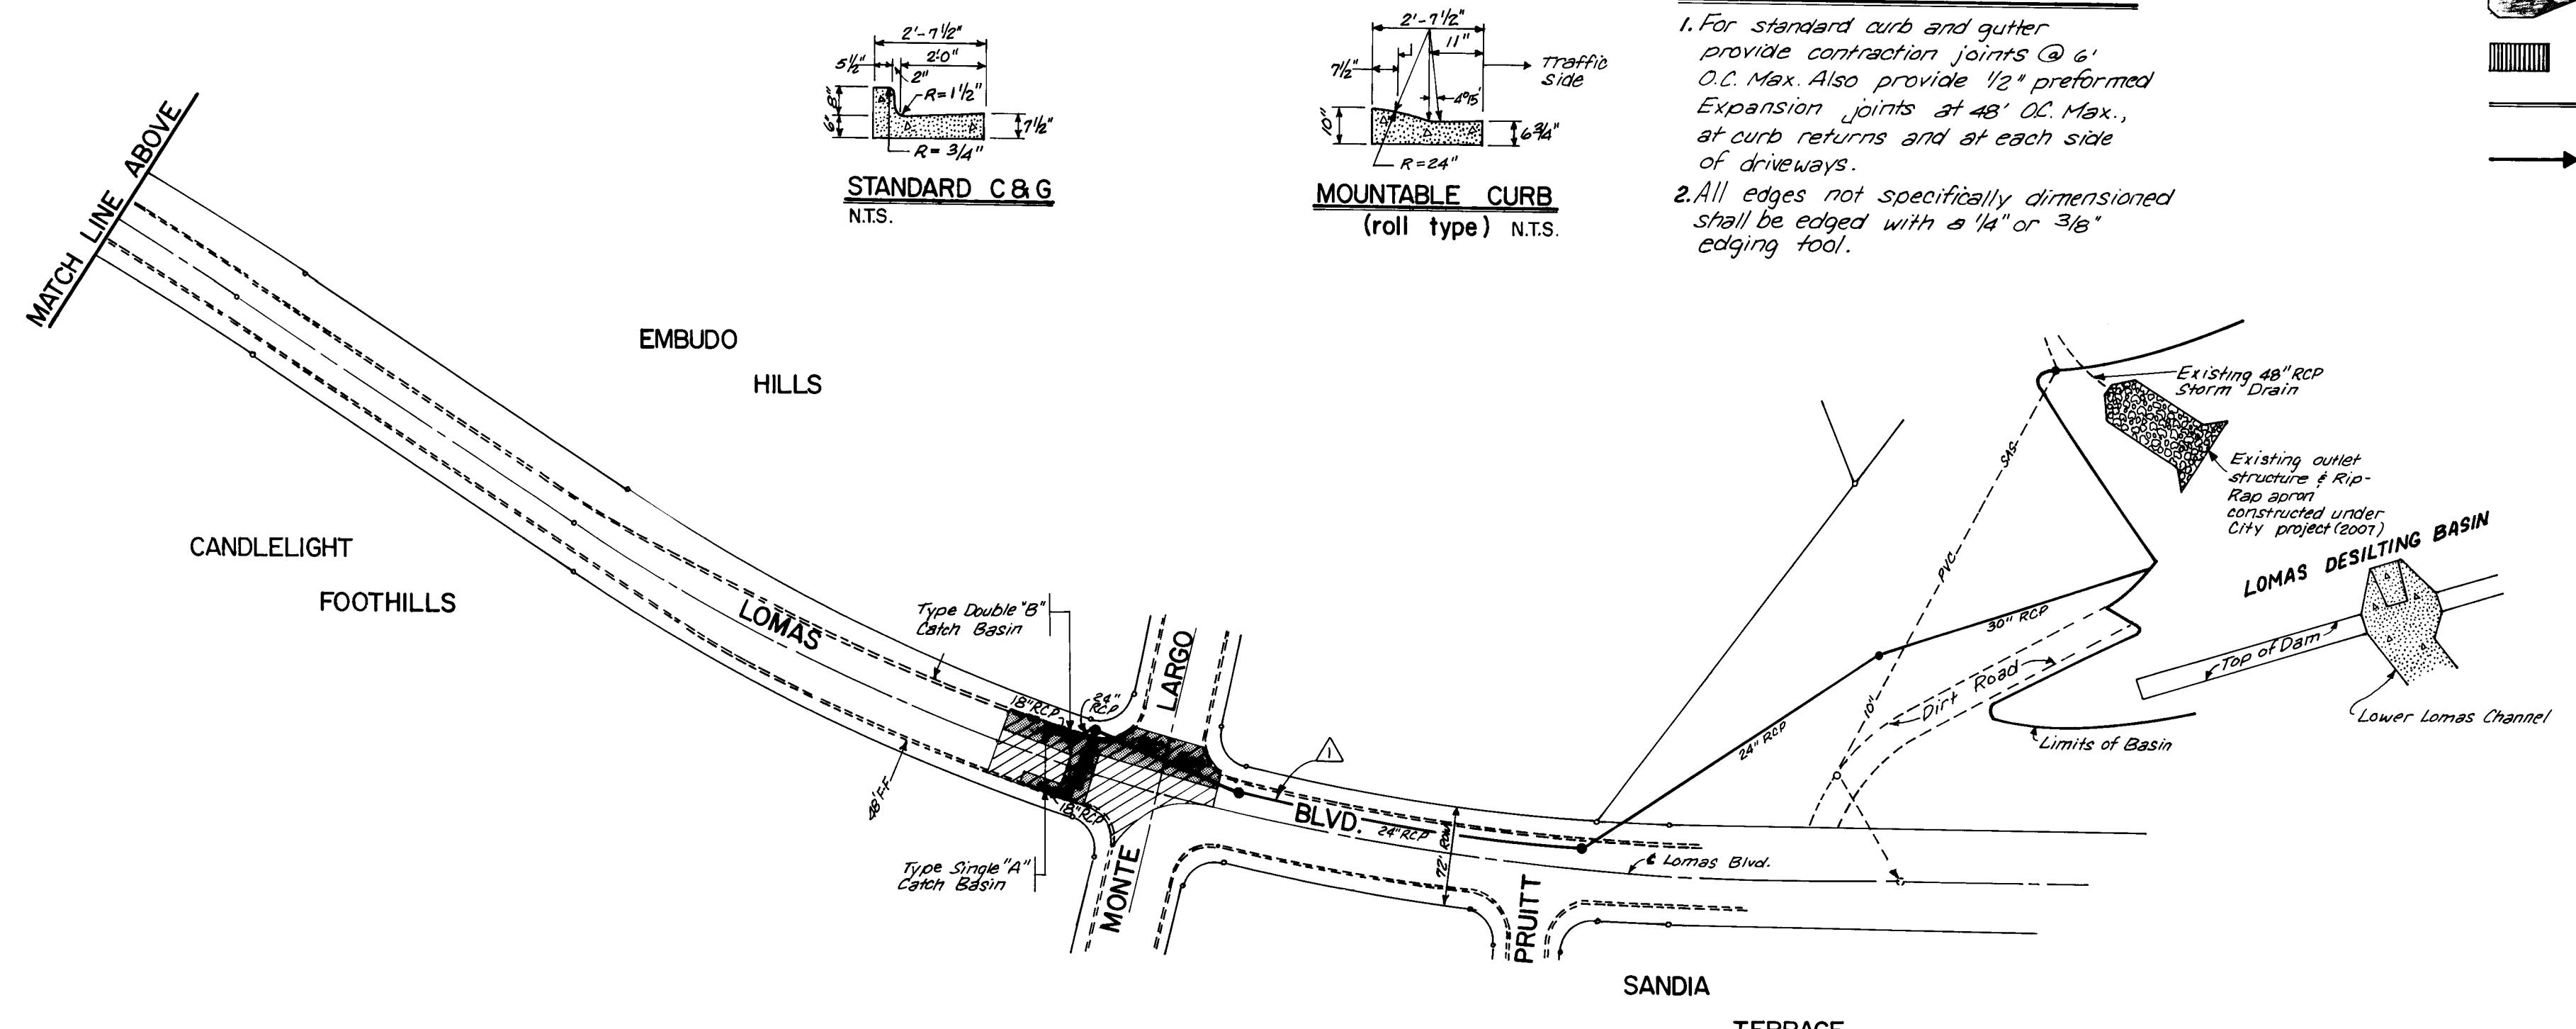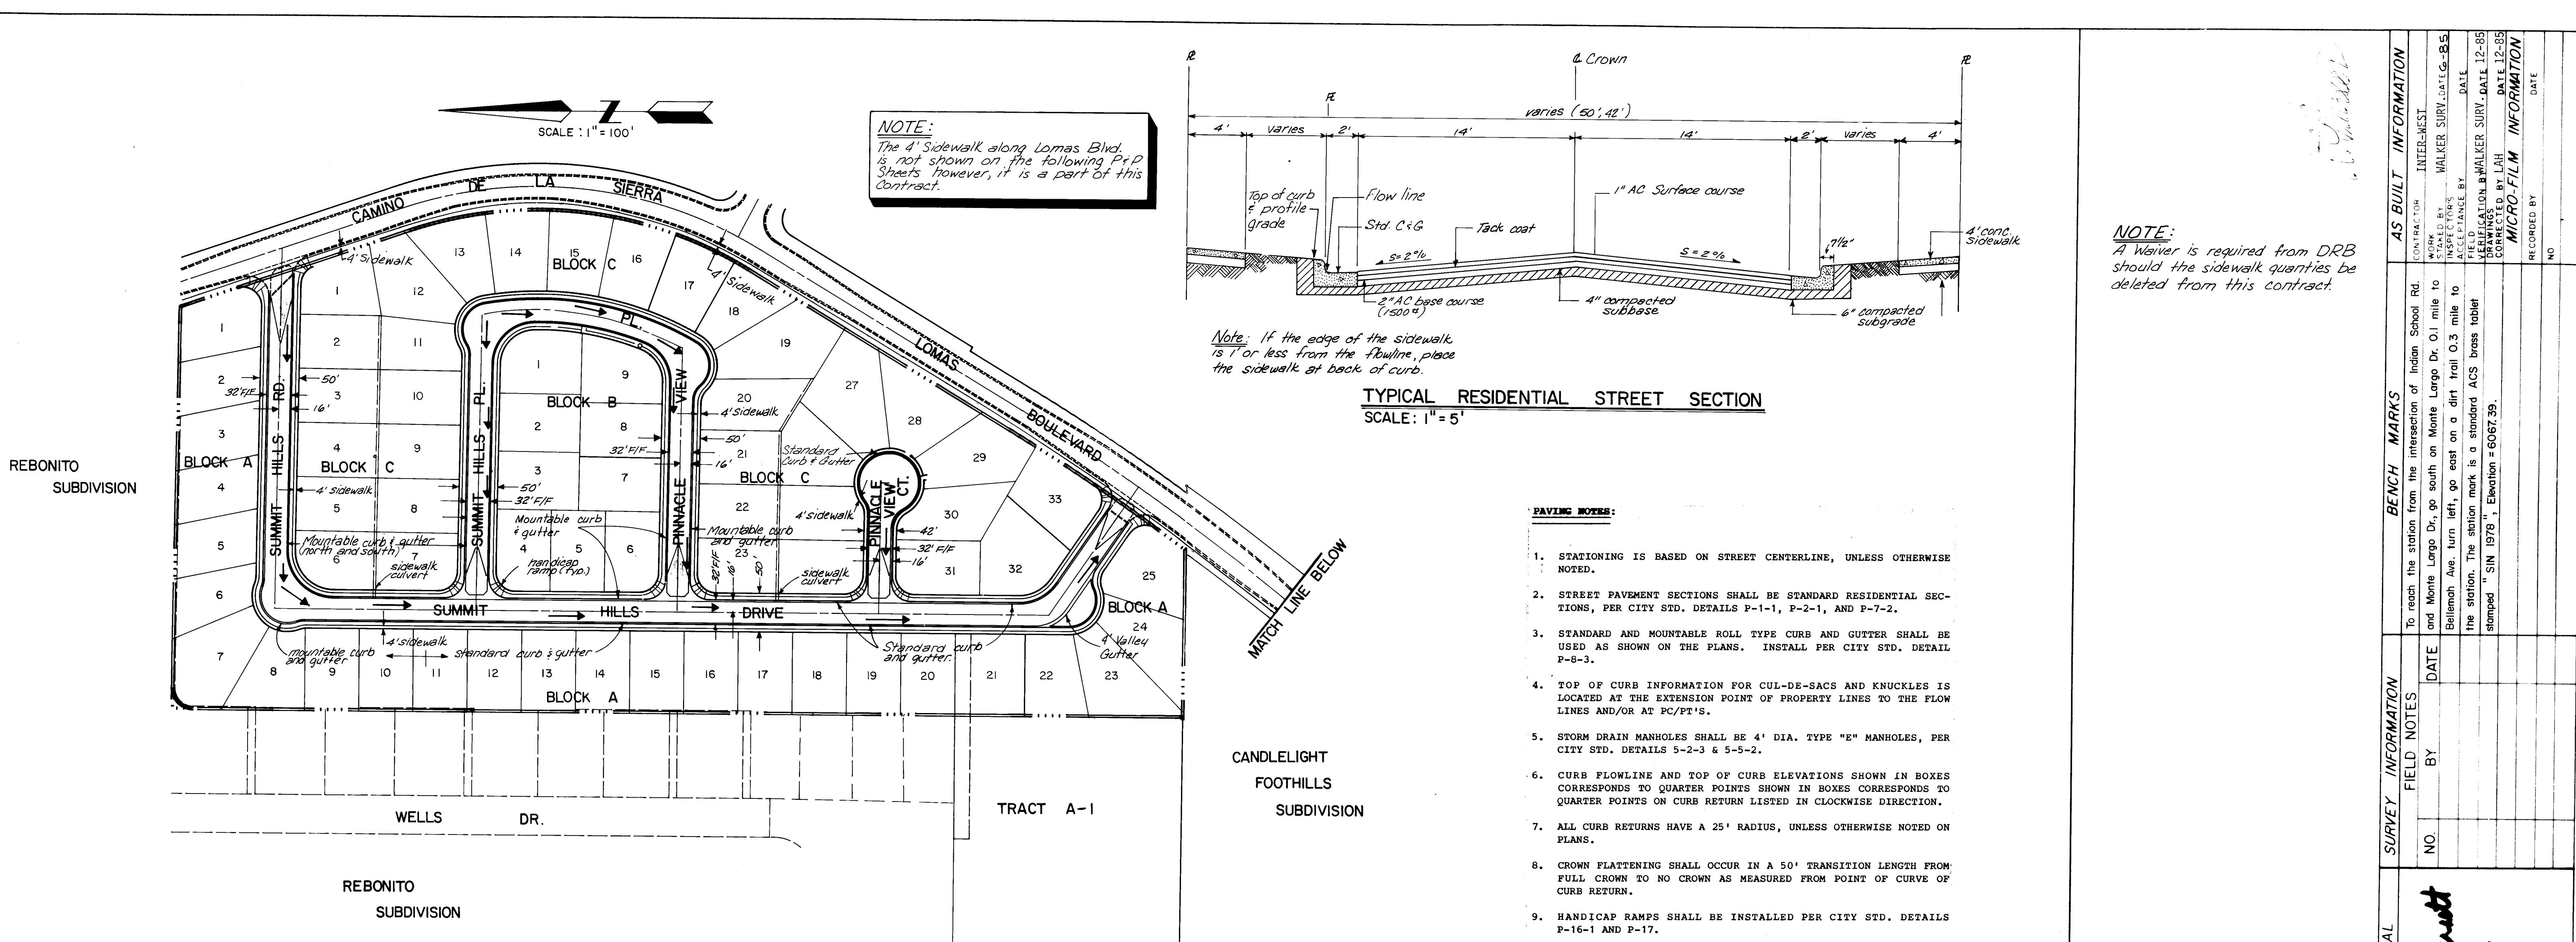


LEGEND

- HANDICAP RAMP
- CROWN FLATTENING
- STORM DRAIN INLET
- STANDARD CURB AND GUTTER
- DIRECTION OF FLOW

NOTE:


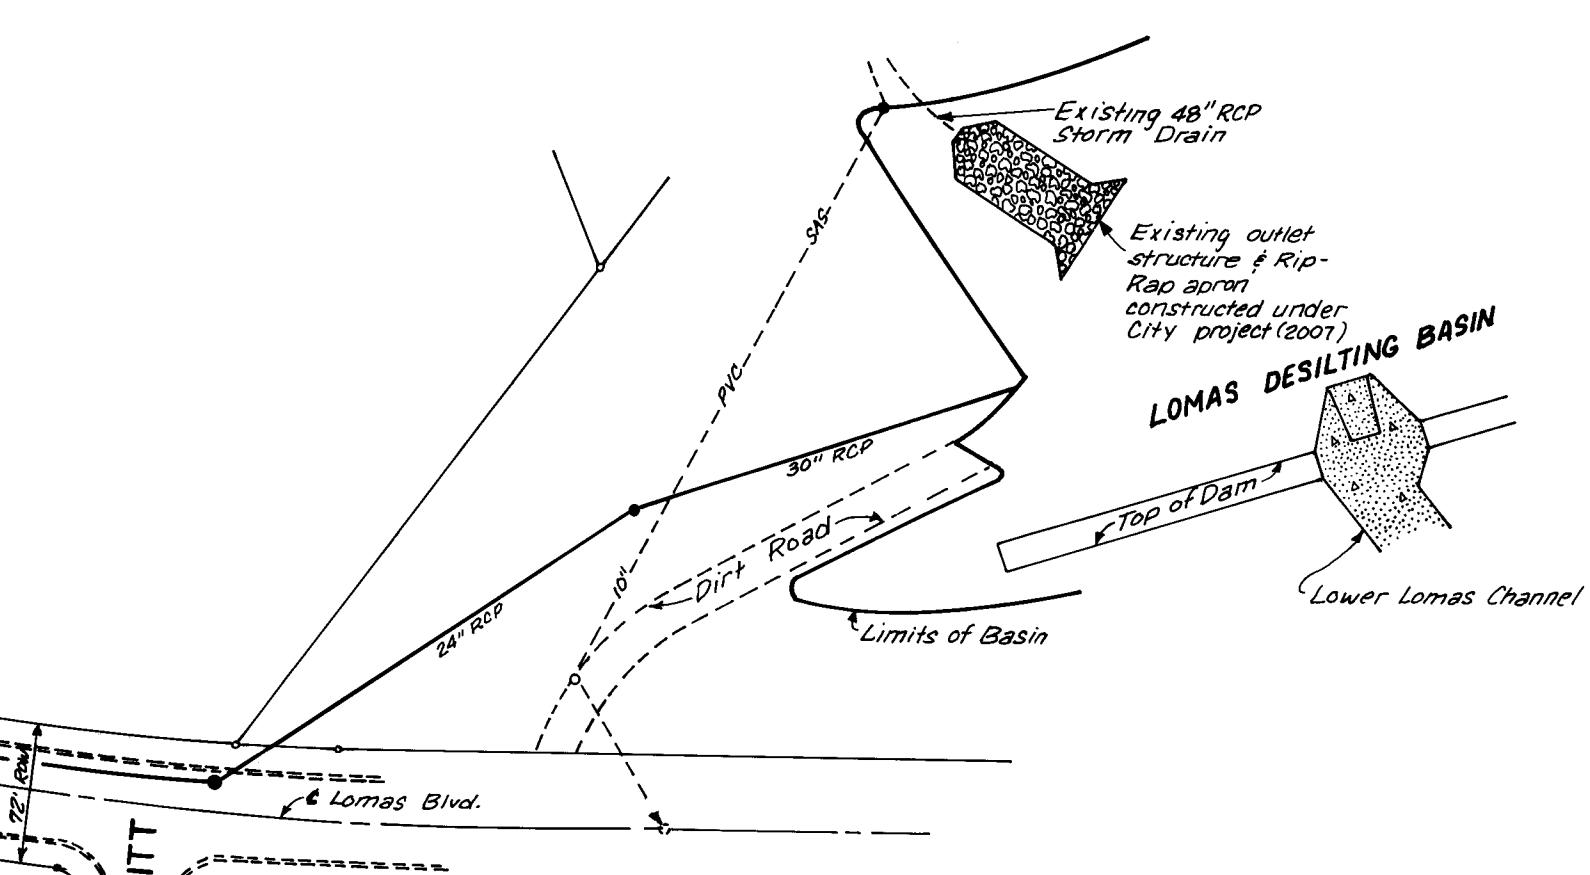
- For standard curb and gutter provide contraction joints @ 6' O.C. Max. Also provide 1/2" preformed Expansion joints at 48" O.C. Max., at curb returns and at each side of driveways.
- All edges not specifically dimensioned shall be edged with a 1/4" or 3/8" edging tool.



AS BUILT INFORMATION		BENCH MARKS	FIELD NOTES	SURVEY INFORMATION	ENGINEER'S SEAL
CONTRACTOR	INTER-WEST	TO reach the station from the intersection of Indian School Rd. and Monte Largo Dr. go south on Monte Largo Dr. 0.1 mile to Bellemah Ave. turn left, go east on a dirt trail 0.3 mile to the station. The station mark is a standard ACS brass tablet stamped "SIN 1978", Elevation 6067.39.	BY	NO. DATE	BY
INSPECTOR	WALKER SURV. DATE 5/1/85		DATE	RECORDED BY	NO.
ACCEPTANCE BY					
FIELD DRAWINGS & WALKER SURV. DATE 12-85	DATE 12-85				
MICRO-FILM INFORMATION					
RECORDED BY	NO.				

*Joe Bennett
1.4.30.85*

AS CONSTRUCTED		CITY OF ALBUQUERQUE			
DESIGNED BY JRT	DRAWN BY SVR	REVISIONS	DATE 1-85		
NO. DATE	REMARKS	DESIGN	DATE 1-85		
APPROVED BY	DRAWN BY	REVIEWED BY	DATE 1-85		
CHECKED BY	APPROVED BY	APPROVED BY	DATE 1-85		
TITLE: SUMMIT HILLS PAVING & STORM DRAIN PLAN					
APPROVALS	ENGINEER	DATE	APPROVALS	ENGINEER	DATE
City Engineer	John H. Johnson	5/1/85	Liquid Waste	R. R. Brown	5/1/85
A.C.E. Design	John H. Johnson	5/1/85	Traffic	David W. Hamner	5/1/85
Hydrology	P. J. Stoeckly	5/1/85	Water	R. R. Brown	5/1/85
DRAWING NO.	MAP NO.	SHEET OF			
2425	J-23	6	14		

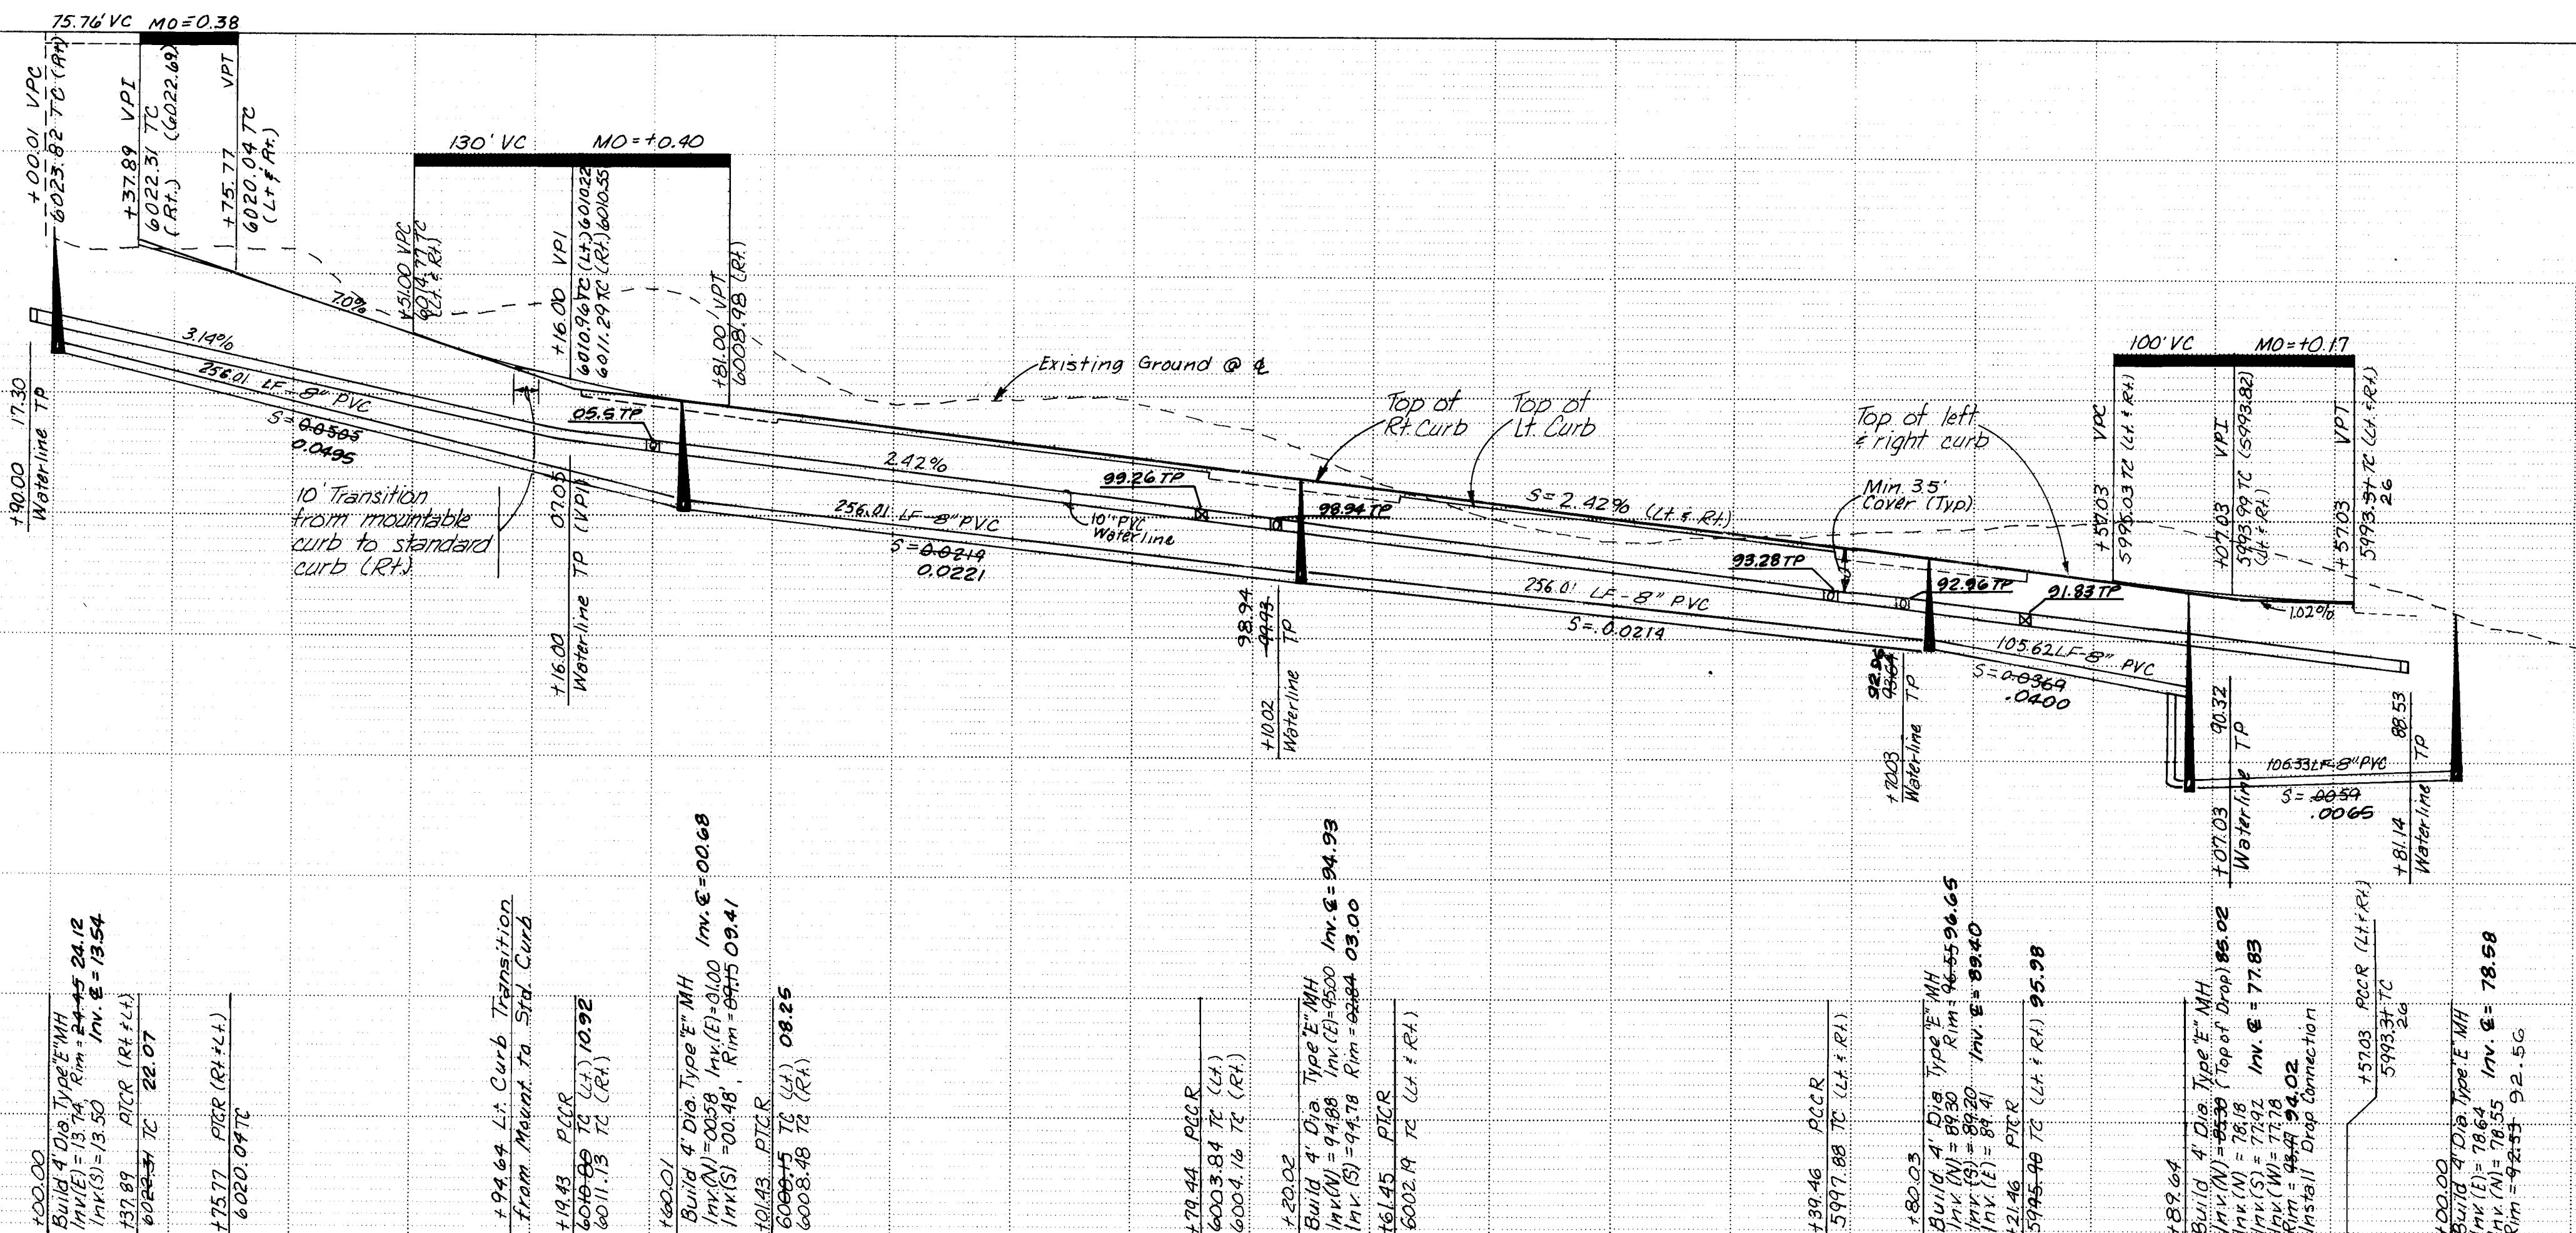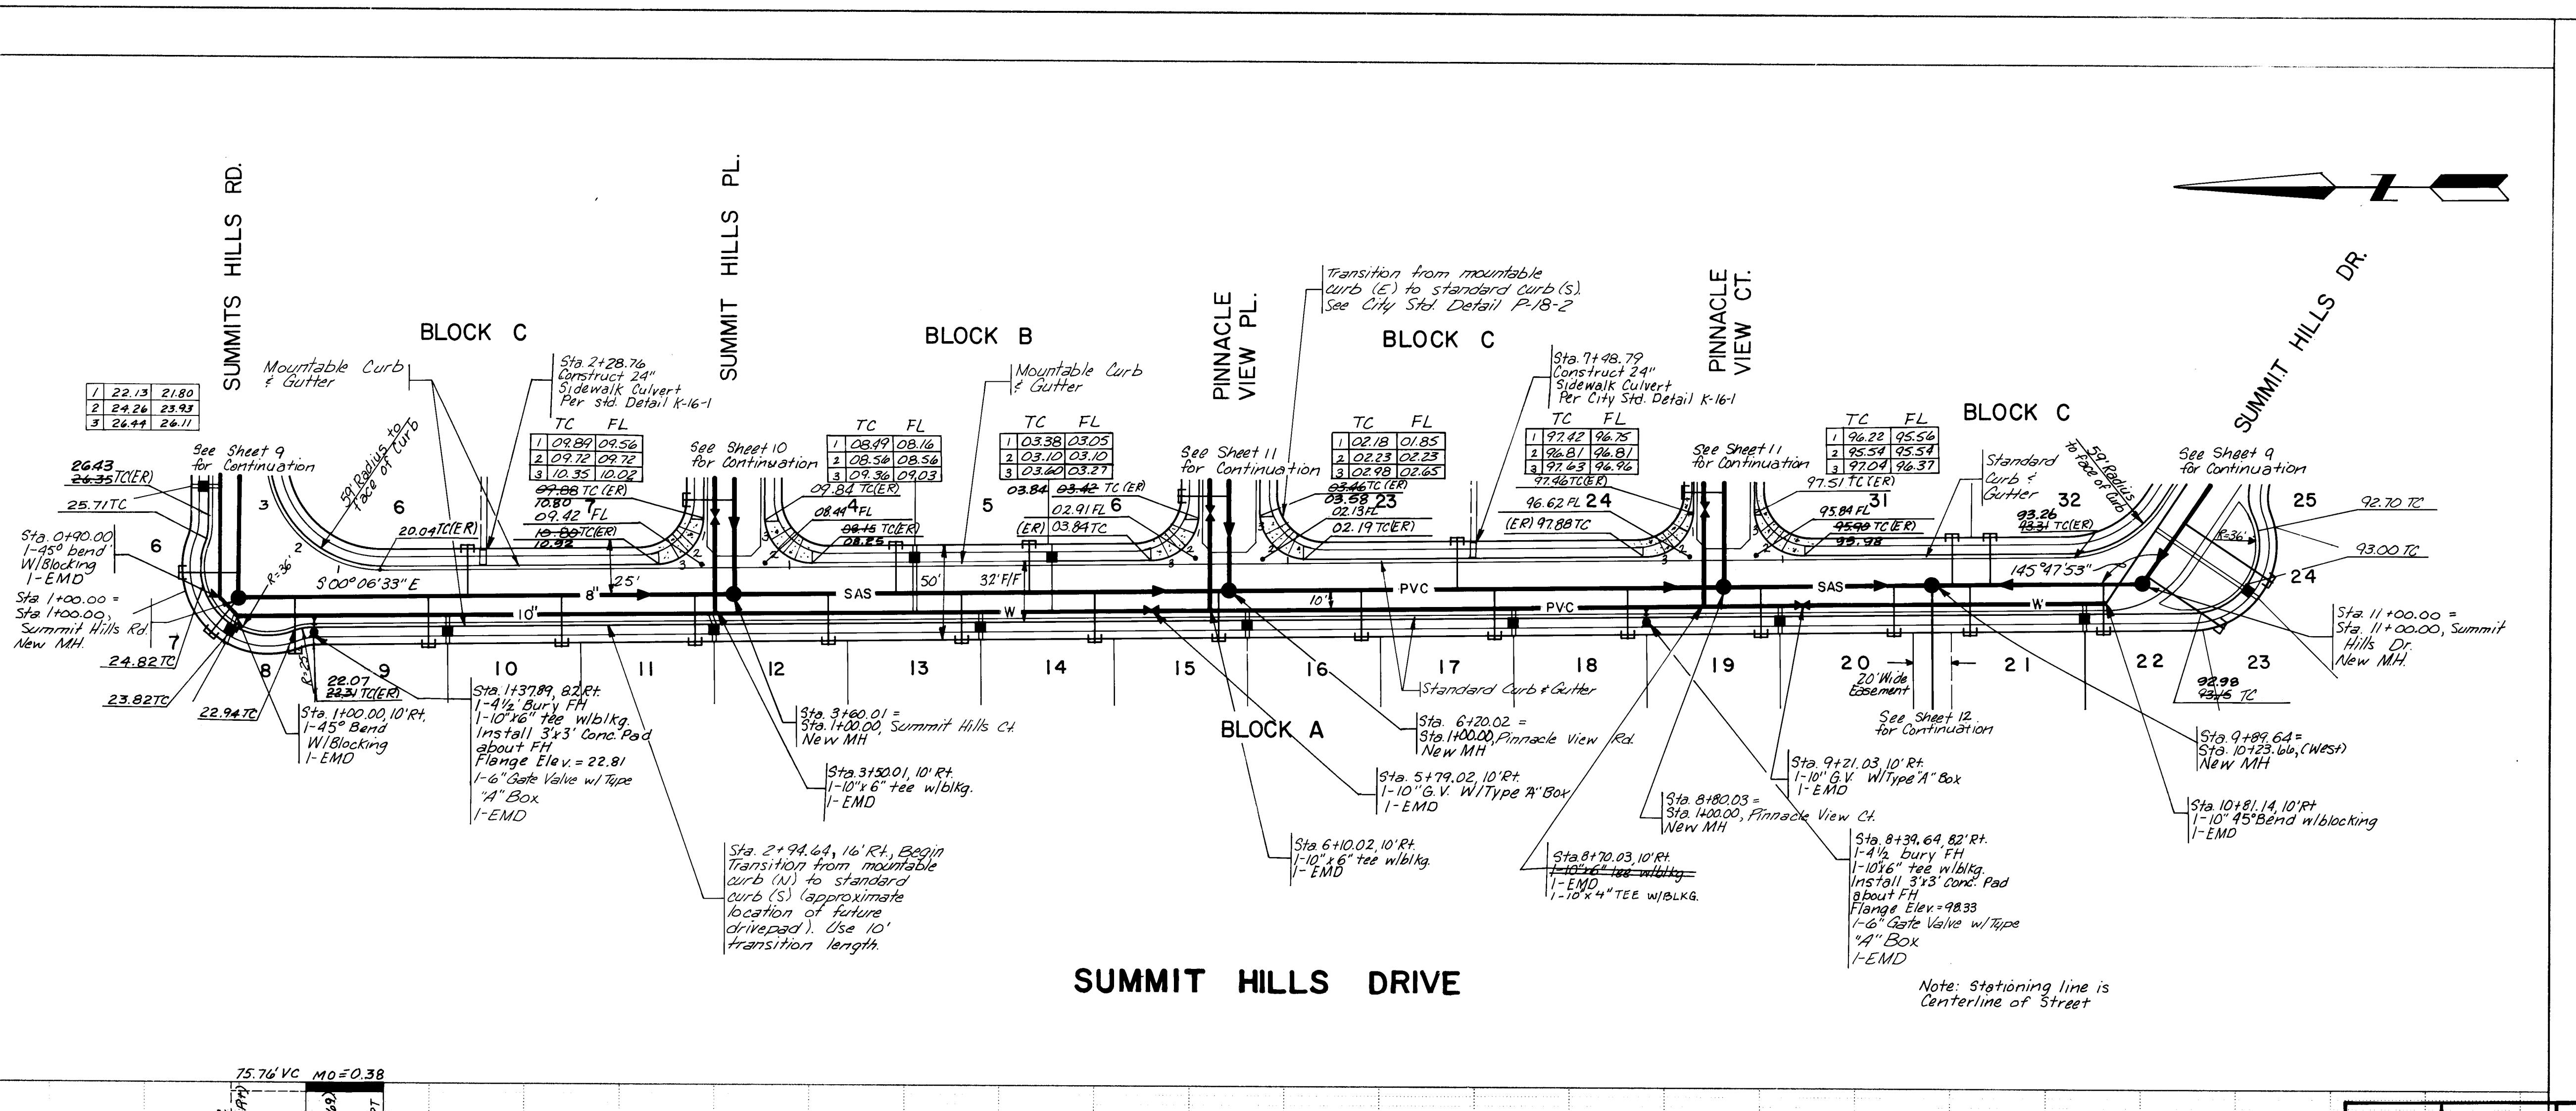

WATER STATION	SANITARY SEWER STATION	LOT NO./BLK.	WATER SERVICE LENGTH	SANITARY SEWER SERVICE	
				LENGTH	INVERT @ R.
0+94 (24' RT)	0786 (18' RT)	7/A	15'	25' 27.0'	15.0 15.5
0+94 (24' RT)	1+31.87	8/A	15'	25' 28.8'	12.1 13.9
2+09.66	1+99.66	9/A	15'	25' 25.8'	12.5 12.2
2+09.66	2+69.66	10/A	15'	25' 25.8'	8.5 8.0
3+49.66	3+39.66	11/A	15'	25' 26.0'	5.5 5.4
3+49.66	4+09.66	12/A	15'	25' 25.7'	4.0 3.7
4+89.66	4+79.66	13/A	15'	25' 26.0'	2.25 2.1
4+89.66	5+49.66	14/A	15'	25' 25.8'	0.50 0.4
6+29.66	6+14.66	15/A	15'	25' 26.0'	99.0 98.9
6+29.66	6+89.66	16/A	15'	25' 26.2'	97.1 97.3
7+69.66	7+59.66	17/A	15'	25' 25.8'	94.6 95.0
7+69.66	8+29.66	18/A	15'	25' 26.0'	98.6 92.6
9+09.66	8+99.66	19/A	15'	25' 25.8'	88.6 90.8
9+09.66	9+69.66	20/A	15'	25' 28.5'	87.1 87.7
10+69.66	10+09.66	21/A	15'	25' 30.6'	85.1 84.7
10+69.66	10+79.66	22/A	15'	25' 26.0'	84.6 85.4
—	2+20.28	6/C	—	25' 25.8'	4.2 11.1
4+55.29	4+45.29	4/B	35'	25' 25.5'	83.0 3.7
4+55.29	5+15.30	5/B	35'	25' 25.8'	61.4 1.6
5+27.30	2+38.69	6/B	35'	—	—
—	7+40.31	23/C	—	25' 26.0'	95.7 96.1
—	10+00.32	31/C	—	25' 26.0'	89.6 89.2
—	10+20.32	32/C	—	25' 25.8'	89.0 88.6

AS CONSTRUCTED

**CITY OF ALBUQUERQUE
MUNICIPAL DEVELOPMENT DEPARTMENT
ENGINEERING DIVISION**

TITLE: SUMMIT HILLS



**WATER, SEWER, PAVING, P & P-
SUMMIT HILLS DRIVE**

APPROVALS	ENGINEER	DATE	APPROVALS	ENGINEER	DATE
Project Engineer	C. J. Thompson	5/13/85	Liquid Waste	R. A. Ritter	5/1/85
C.E. - Design	H. P. J. /	5/10/85	Traffic	D. W. Hamm	5/1/85

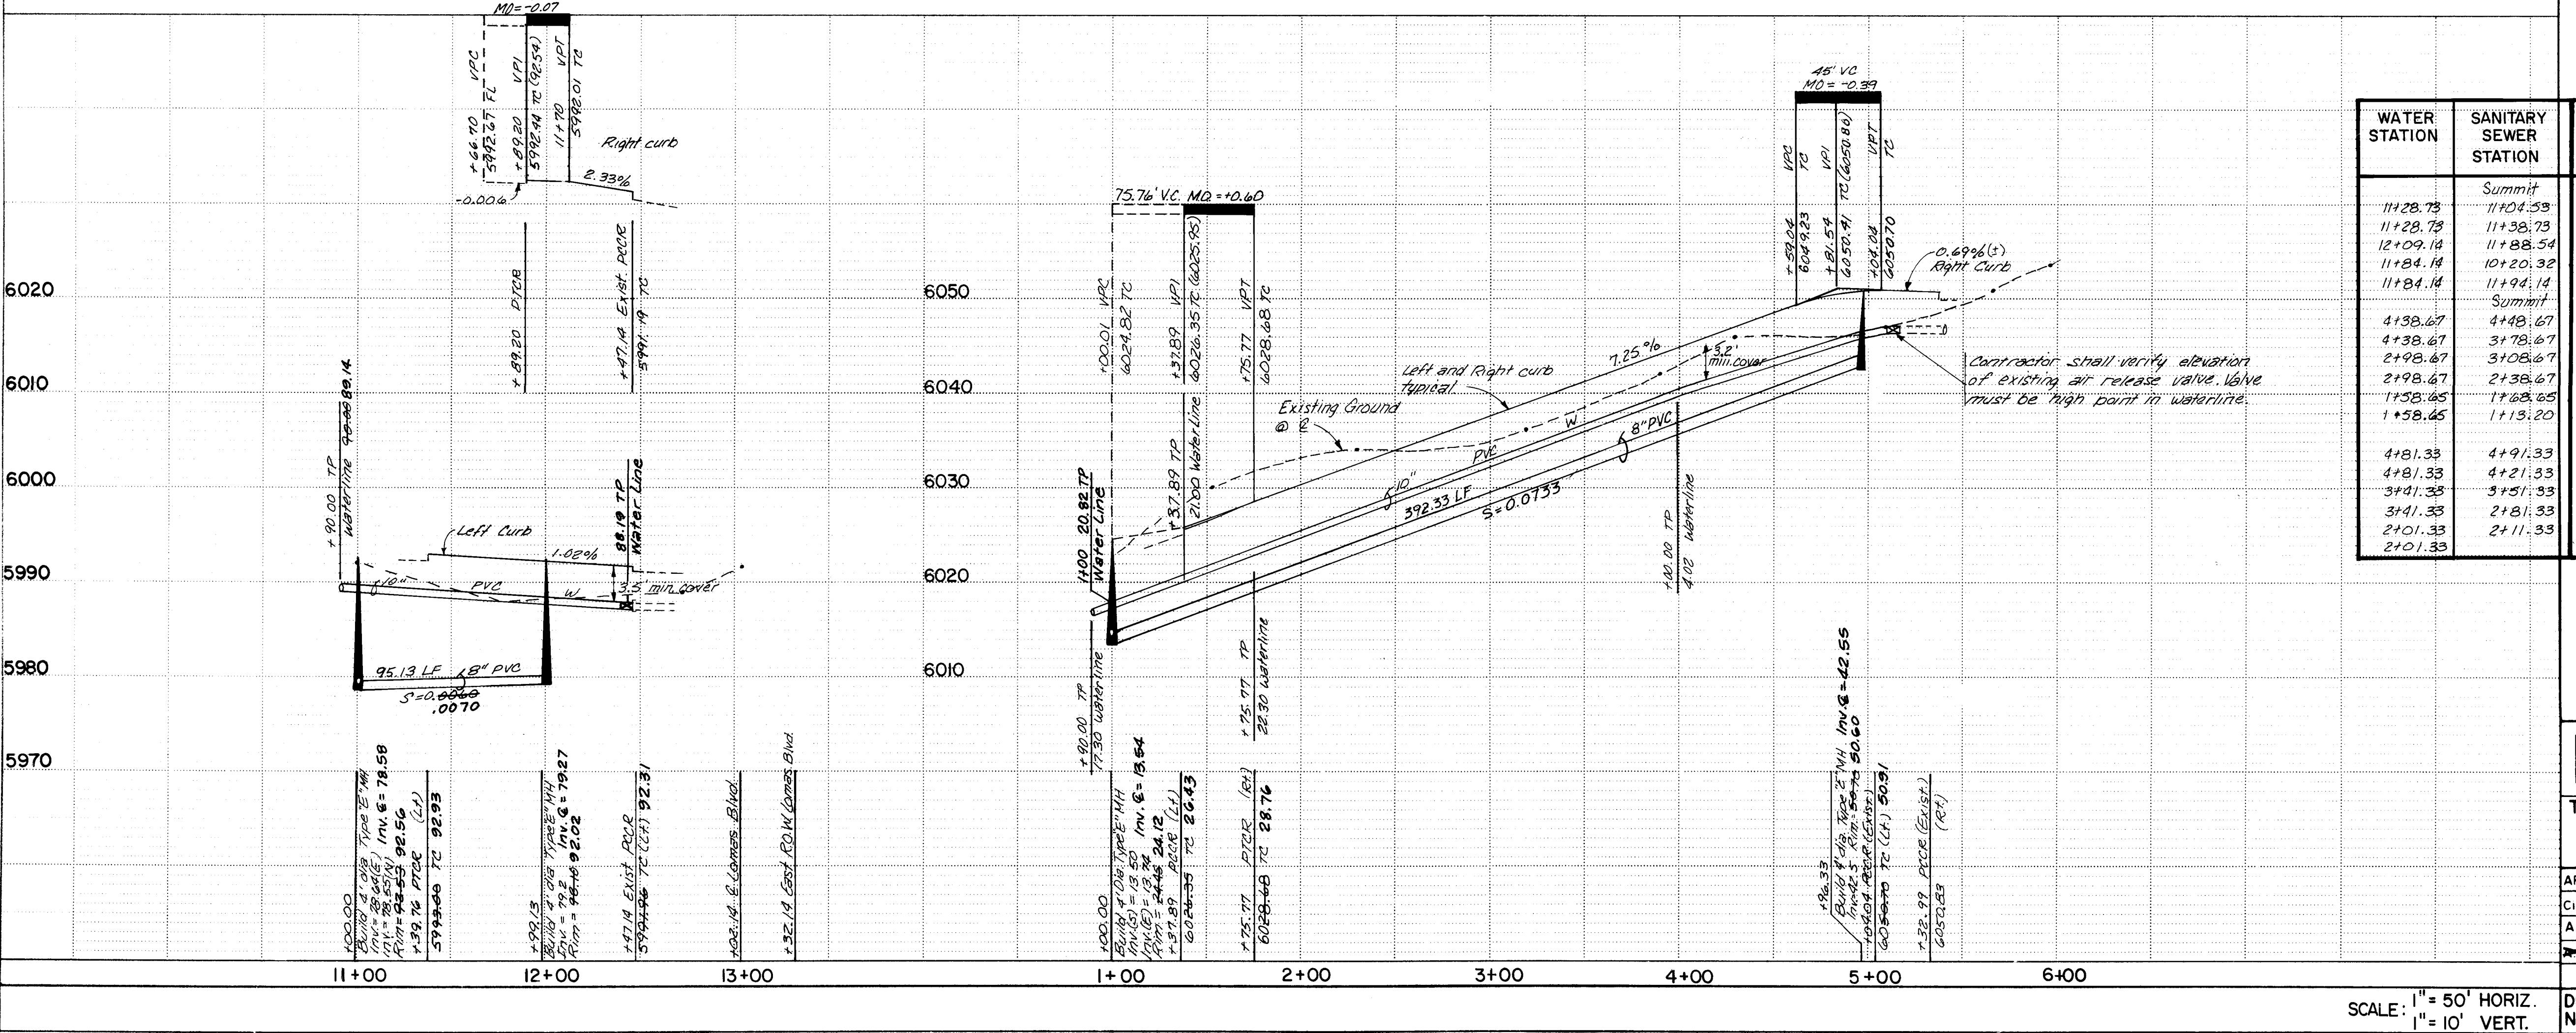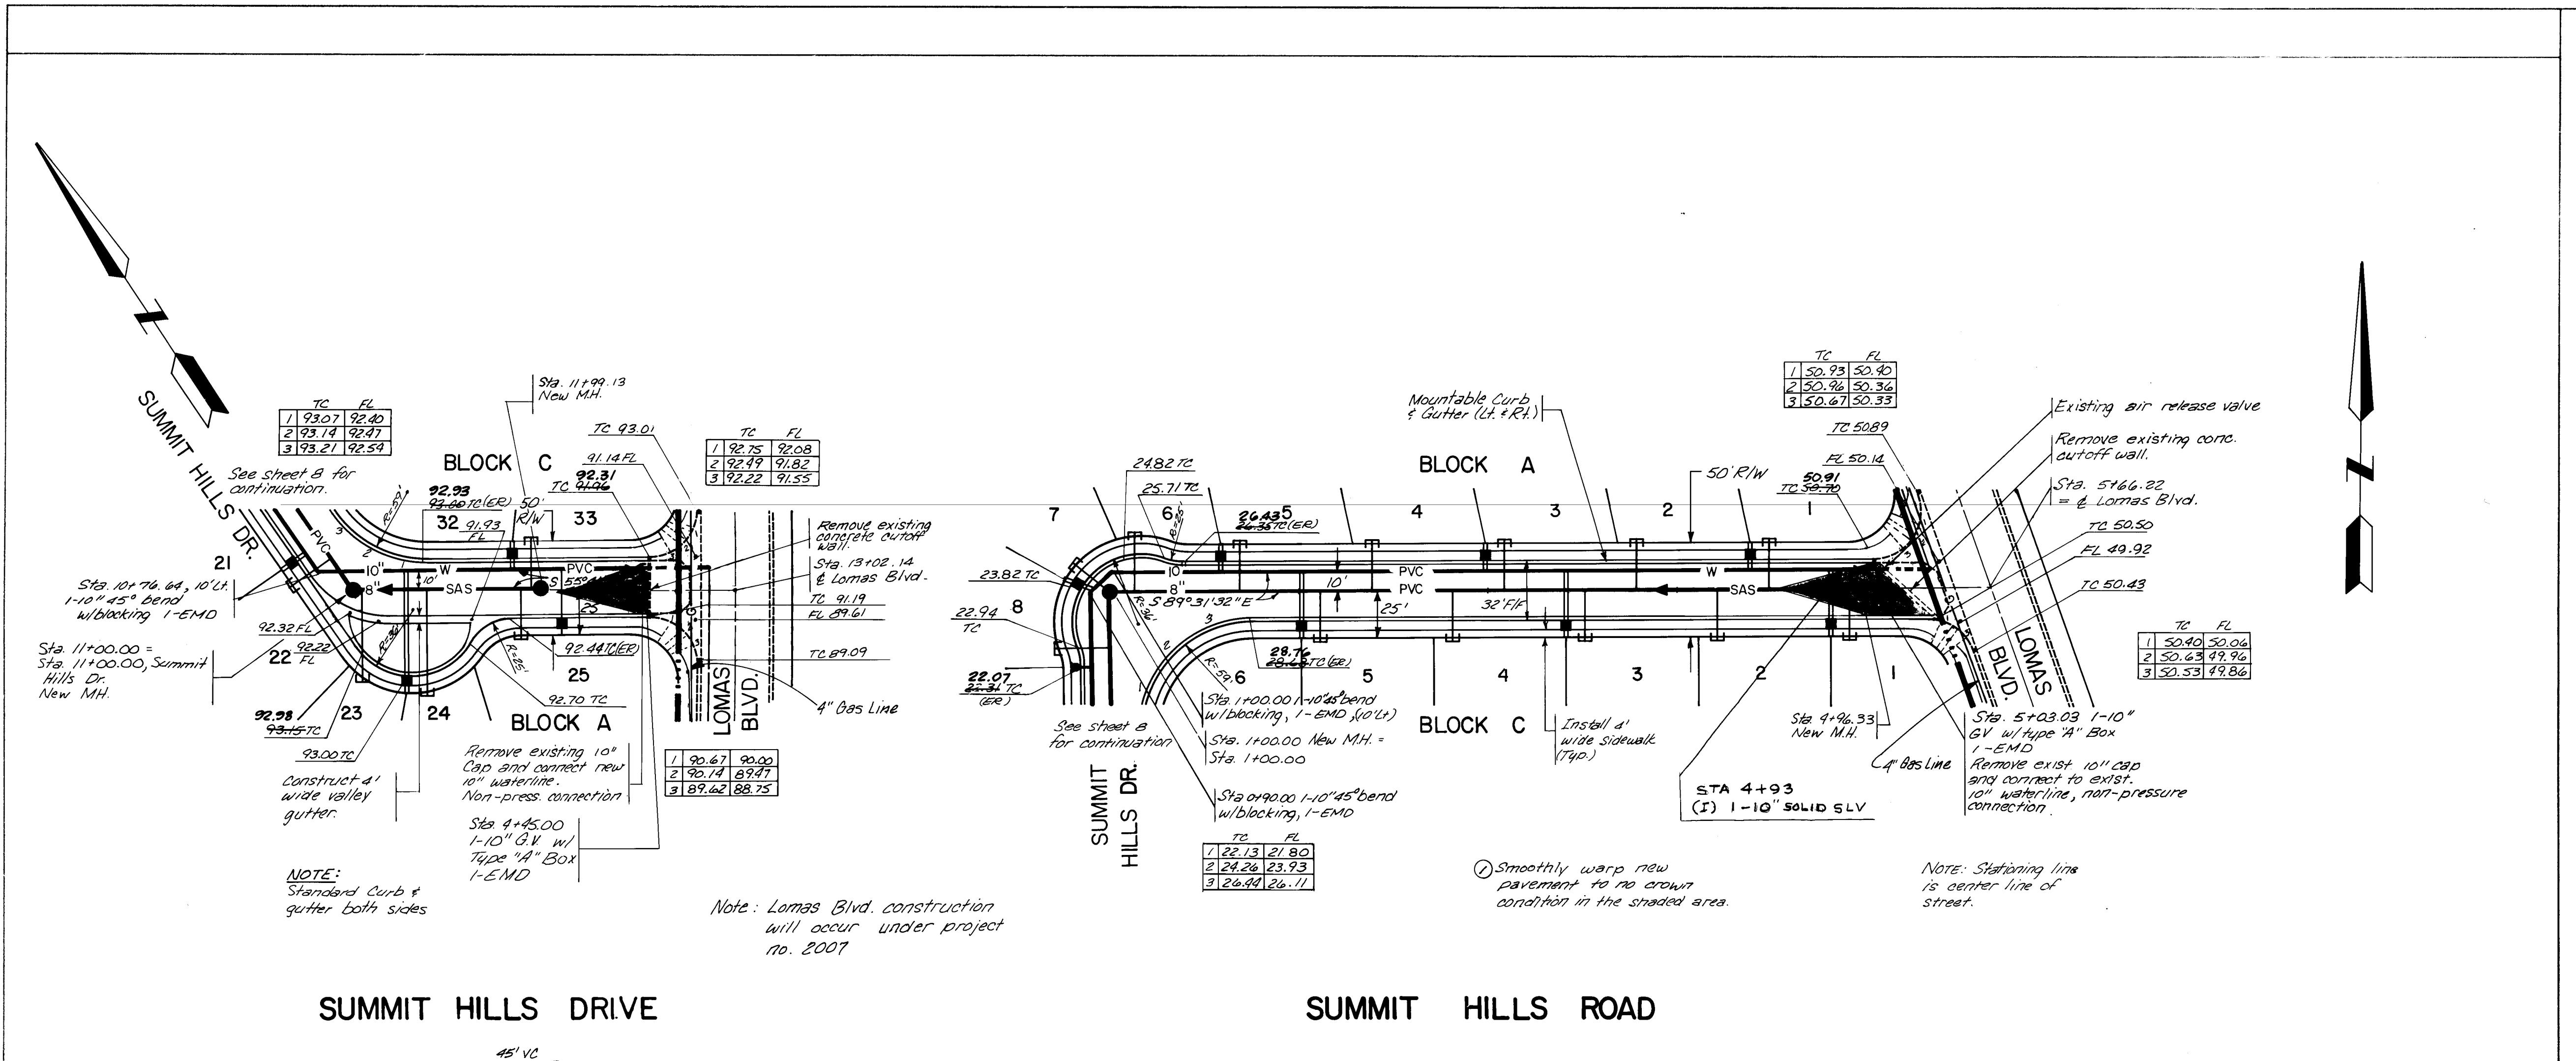EE-Hydrology	<u>B. J. Kirby</u>	<u>5/1/85</u>	Water	<u>Rain</u>	<u>5/1/85</u>
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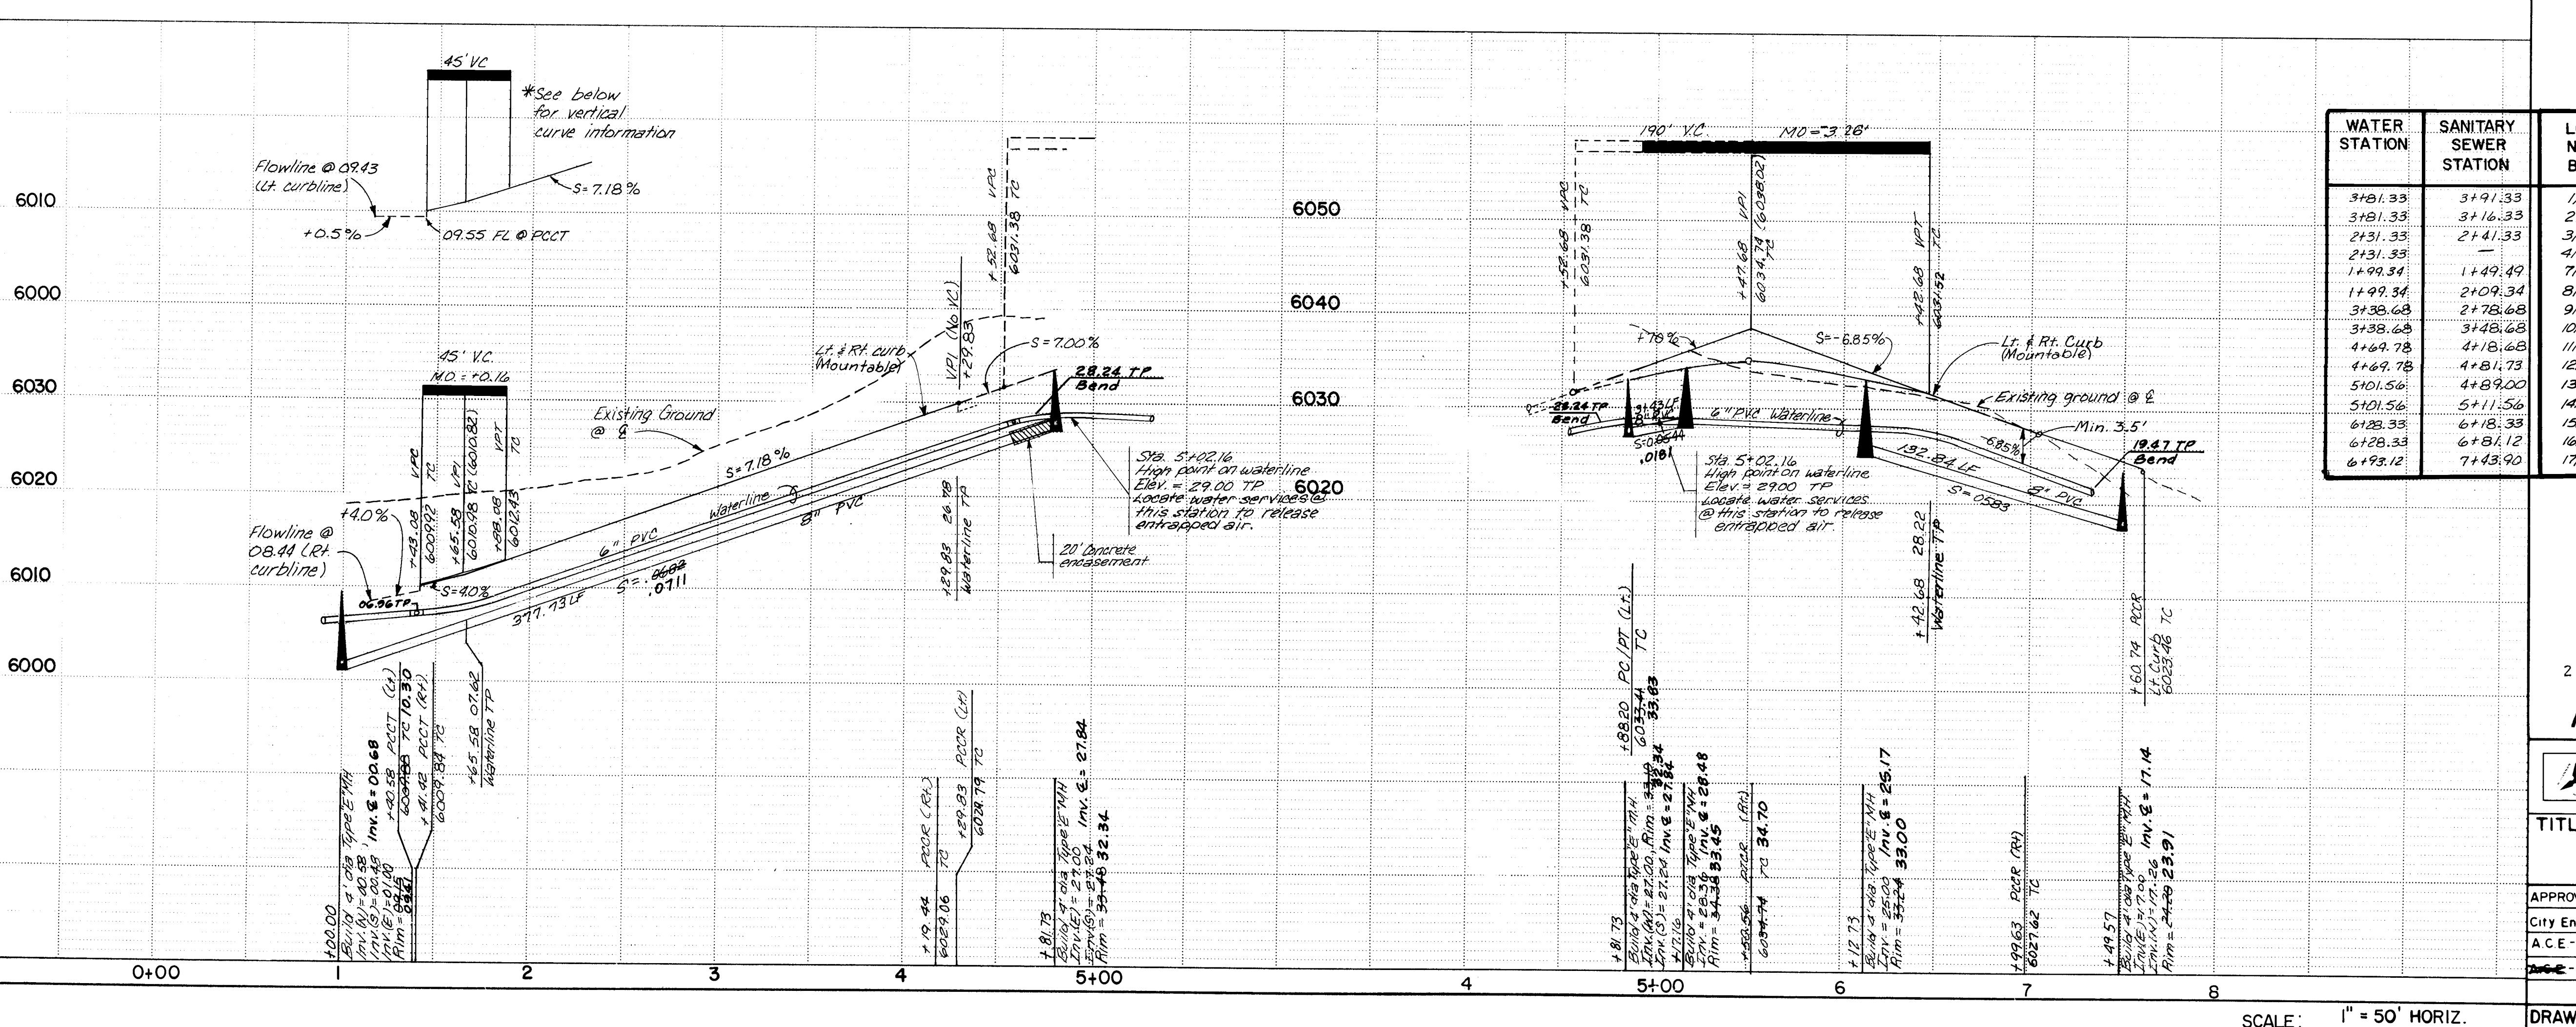
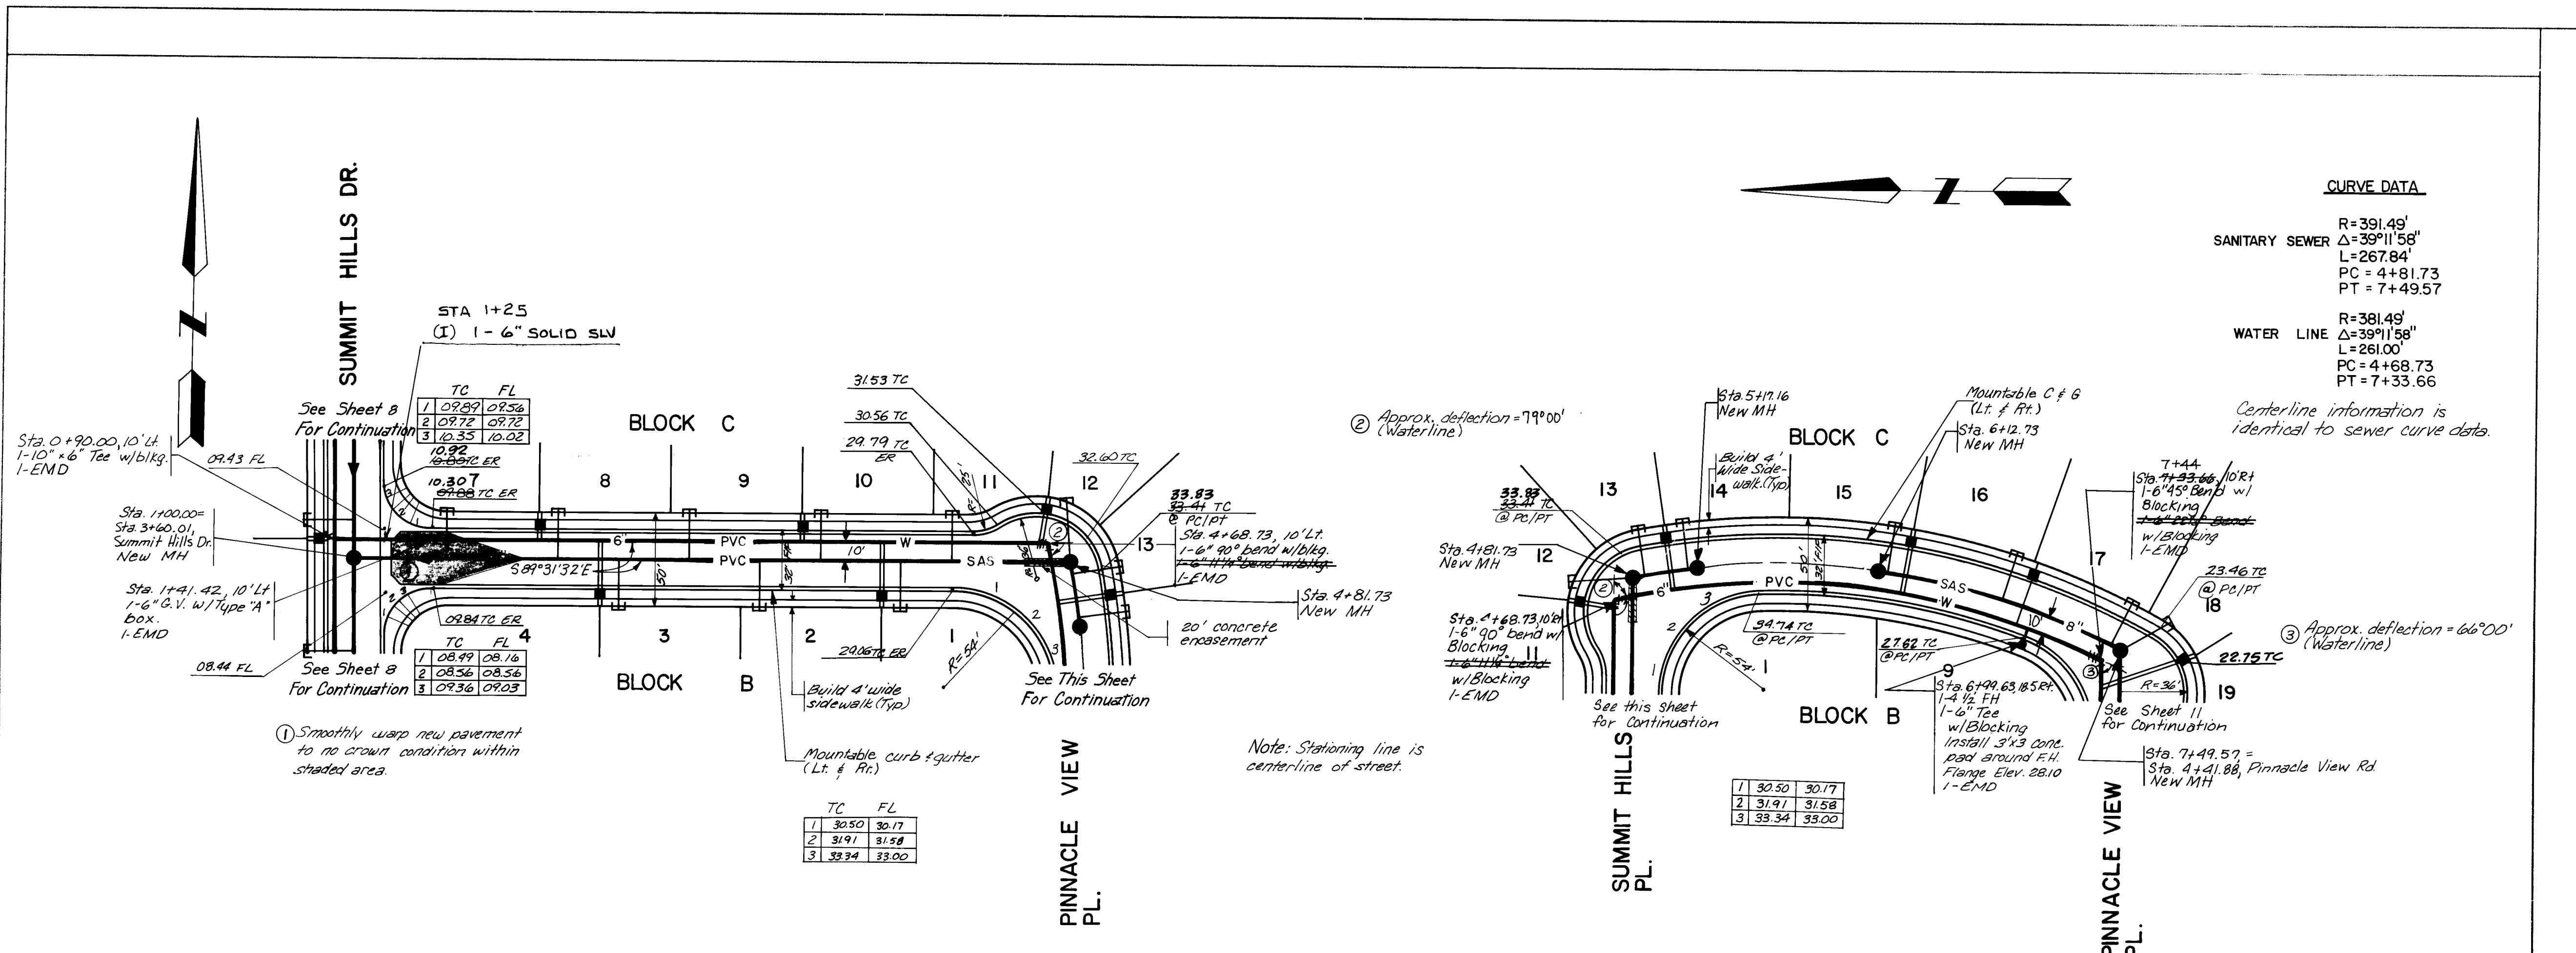
DRAWING NO. 2425 | MAP NO. J-23 | SHEET 8 OF 14

100



26 24260986

	CITY OF ALBUQUERQUE MUNICIPAL DEVELOPMENT DEPARTMENT ENGINEERING DIVISION				
<p>TITLE: SUMMIT HILLS WATER, SEWER, PAVING, P&P- SUMMIT HILLS DRIVE/SUMMIT HILLS ROAD</p>					
APPROVALS	ENGINEER	DATE	APPROVALS	ENGINEER	DATE
City Engineer	<i>C. J. O'Connor</i>	5/3/85	Liquid Waste	<i>R. Pena</i>	5/1/85
C.E. - Design	<i>H. L. O'Farrill</i>	5/9/85	Traffic	<i>Douglas W. Hammar</i>	5/1/85
EE - Hydrology	<i>B. J. Goodling</i>	5/1/85	Water	<i>R. Pena</i>	5/1/85
RAWING O.	2425		MAP NO. J-23	SHEET 9	OF 14




WATER STATION	SANITARY SEWER STATION	LOT NO./ BLK.	WATER SERVICE LENGTH	SANITARY SEWER SERVICE	
				LENGTH	INVERT E.R.
3+81.33	3+91.33	1/B	35'	25' 25.9'	23.0233
3+81.33	3+16.33	2/B	35'	25' 26.0'	17.9
2+31.33	2+41.33	3/B	35'	25' 26.0'	12.5 13.0
2+31.33	—	4/B	35'	—	—
1+99.34	1+49.49	7/C	15'	25' 26.0'	06.5 6.6
1+99.34	2+09.34	8/C	15'	25' 25.8'	10.4 10.9
3+38.68	2+78.68	9/C	15'	25' 26.0'	15.0 15.1
3+38.68	3+48.68	10/C	15'	25' 26.0'	20.0 20.2
4+69.78	4+18.68	11/C	25'	25' 26.3'	24.7 24.9
4+69.78	4+81.73	12/C	25'	28.5 28.7'	27.0 29.1
5+01.56	4+89.00	13/C	35'	25' 26.0'	28.5 29.6
5+01.56	5+11.56	14/C	35'	25' 25.7'	29.5 30.1
6+28.33	6+18.33	15/C	35'	25' 26.0'	27.5 27.3
6+28.33	6+81.12	16/C	35'	25' 26.0'	24.0 24.5
6+93.12	7+43.90	17/C	35'	25' 26.2'	14.5 19.3

S CONSTRUCTED


**CITY OF ALBUQUERQUE
MUNICIPAL DEVELOPMENT DEPARTMENT
ENGINEERING DIVISION**

**SUMMIT HILLS
WATER, SEWER, PAVING, P&P -
SUMMIT HILLS PLACE/PINNACLE VIEW PLACE**


LS	ENGINEER	DATE	APPROVALS	ENGINEER	DATE
eer	C.J. Chapman	5/13/85	Liquid Waste	R. Anna	5/1/85
esign	H.F. Cope	5/9/85	Traffic	David W. Hanan	5/1/85
drology	B.J. Roolday	5/1/85	Water	R. Anna	5/1/85

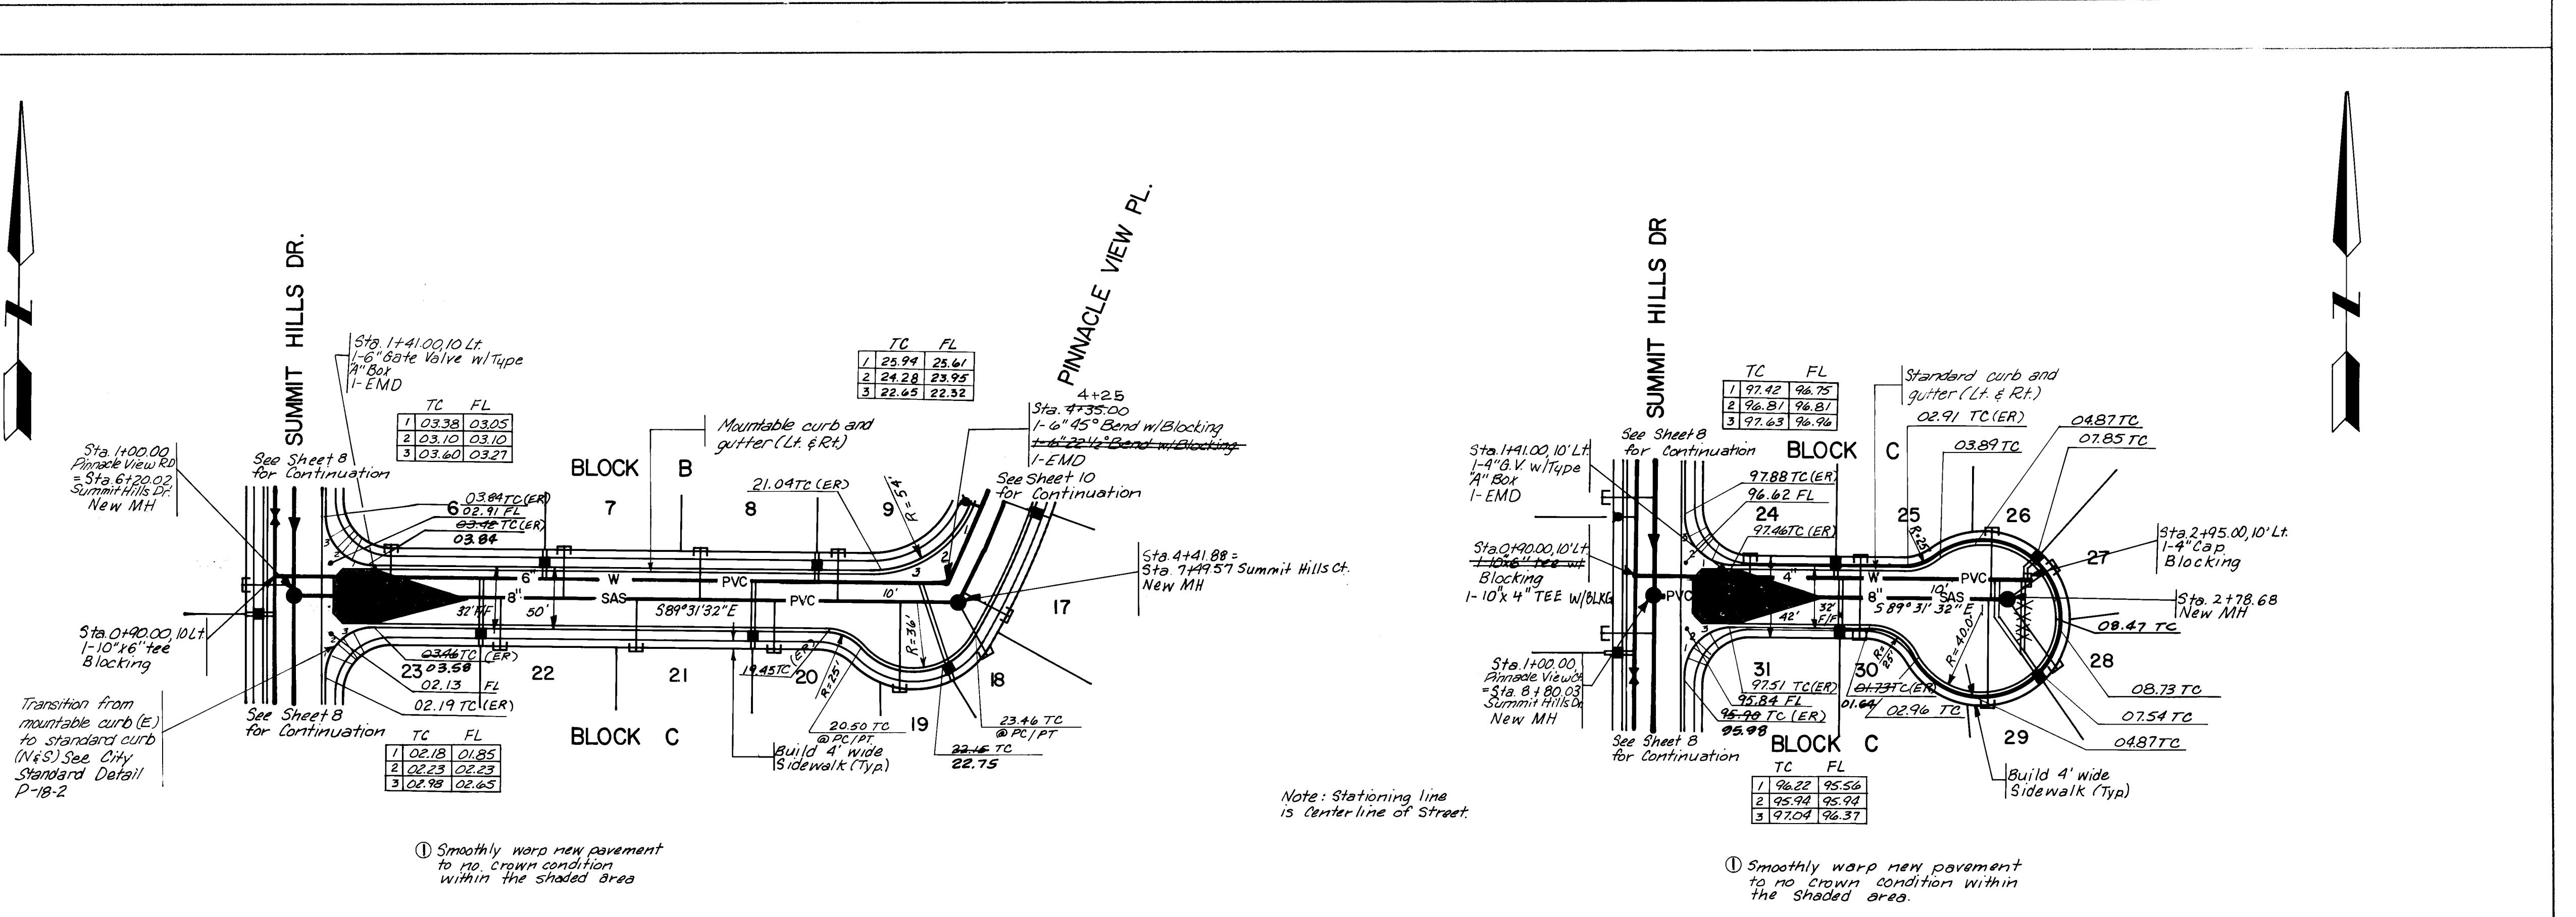

PINNACLE VIEW PLACE

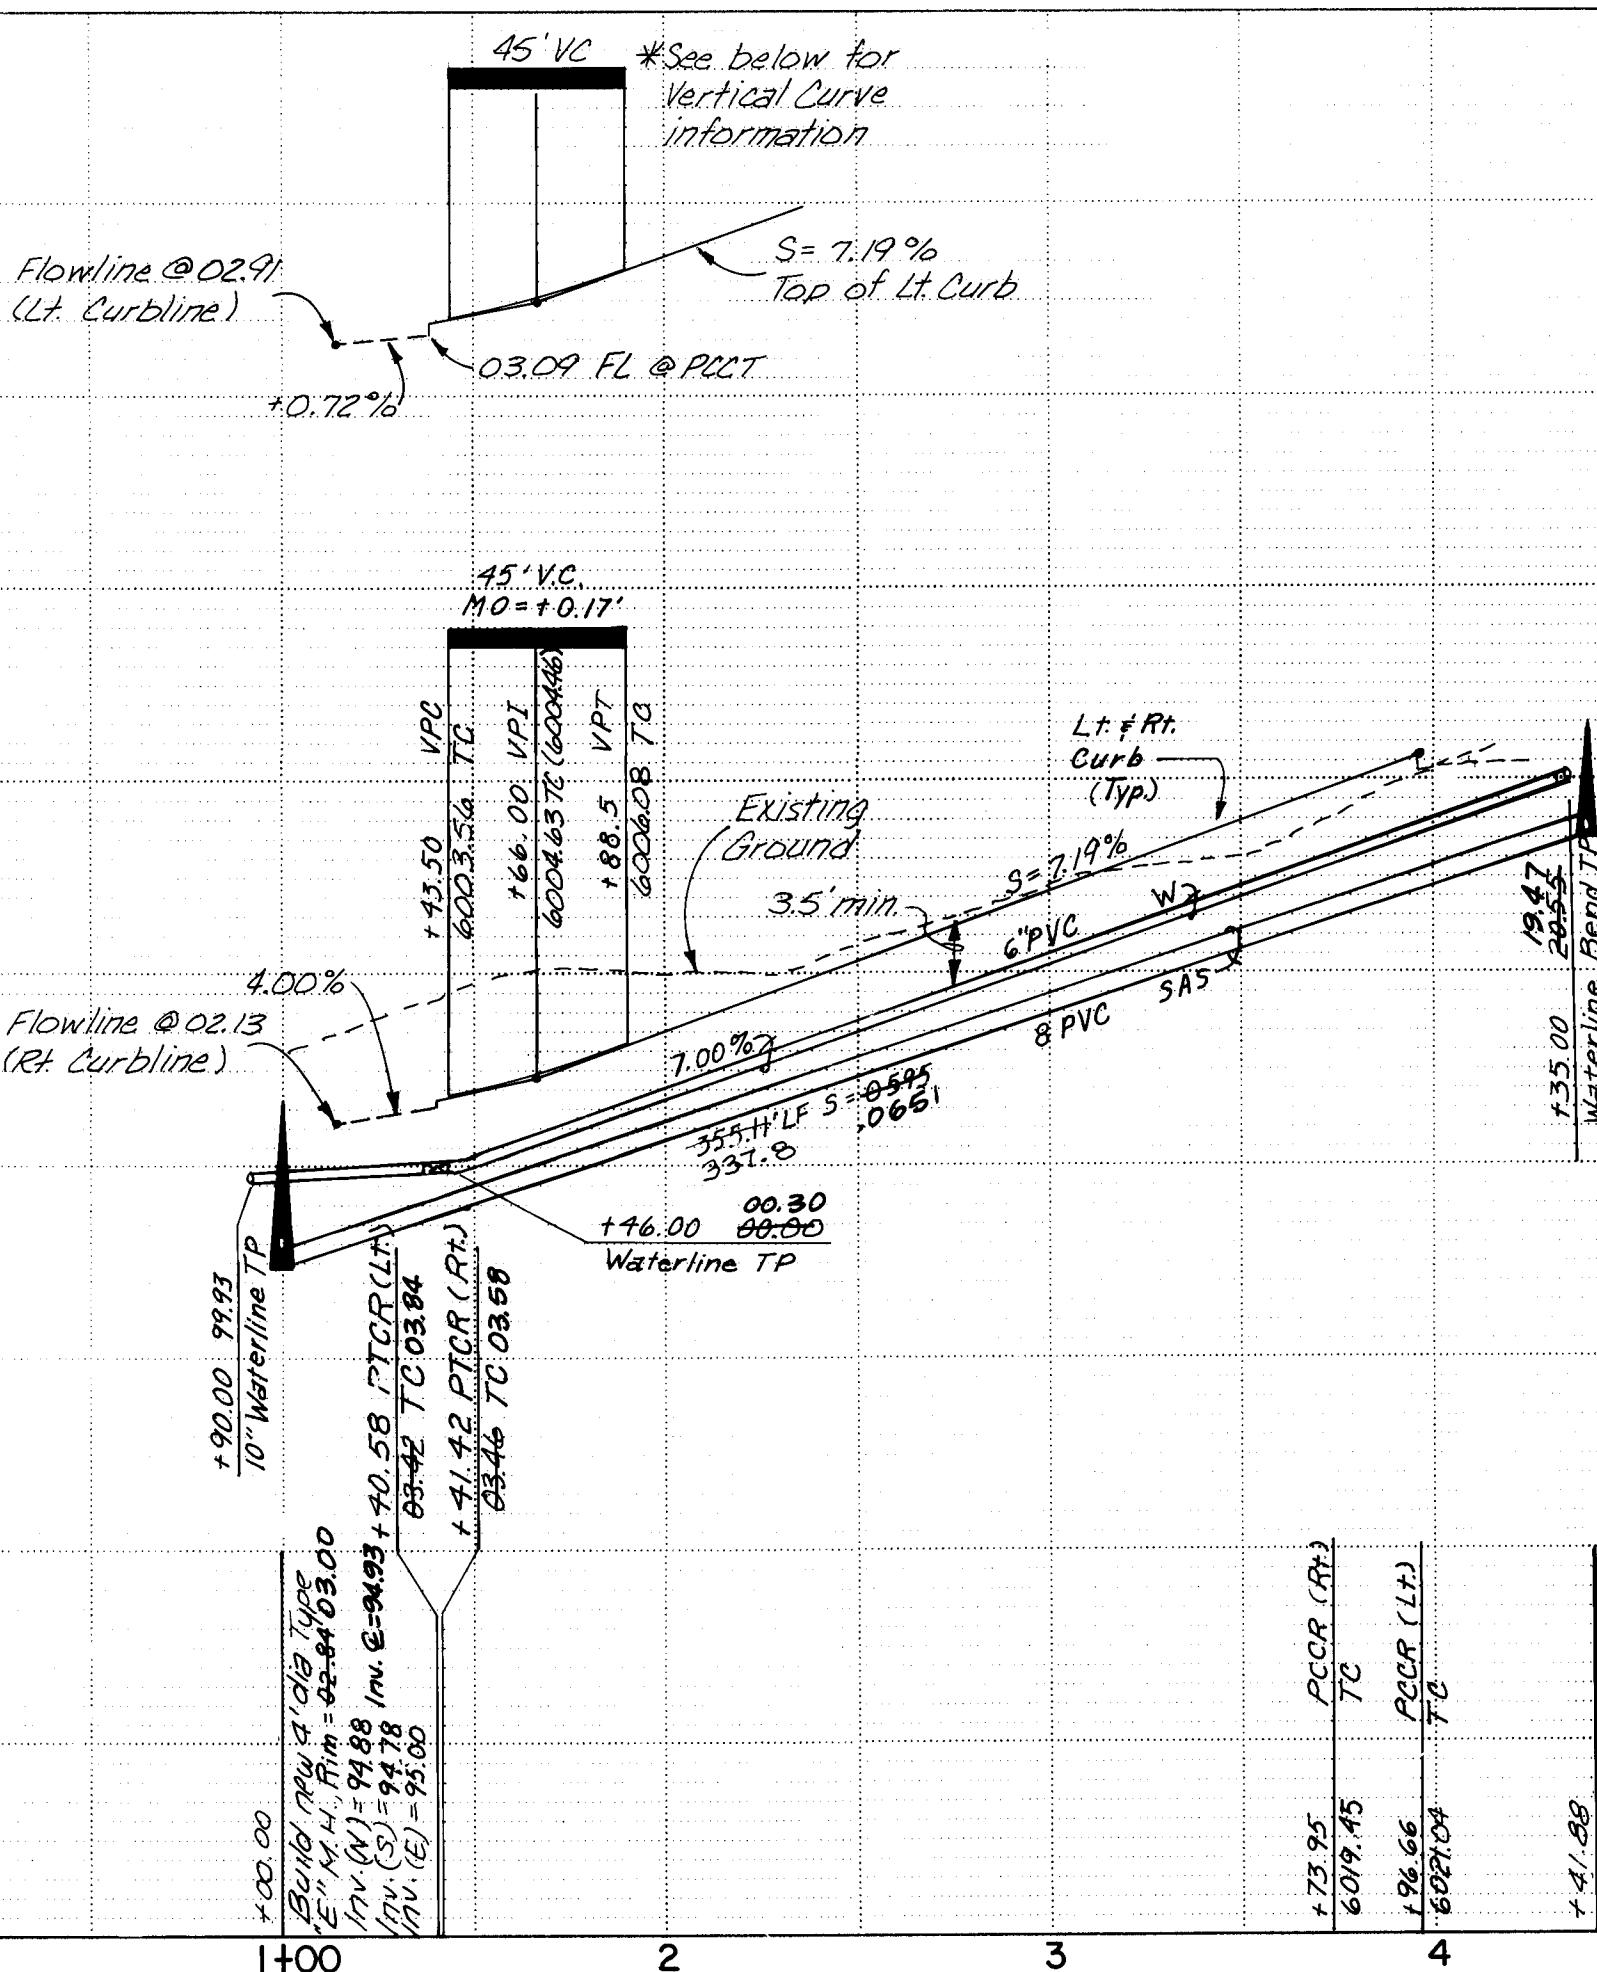

PINNACLE VIEW COURT

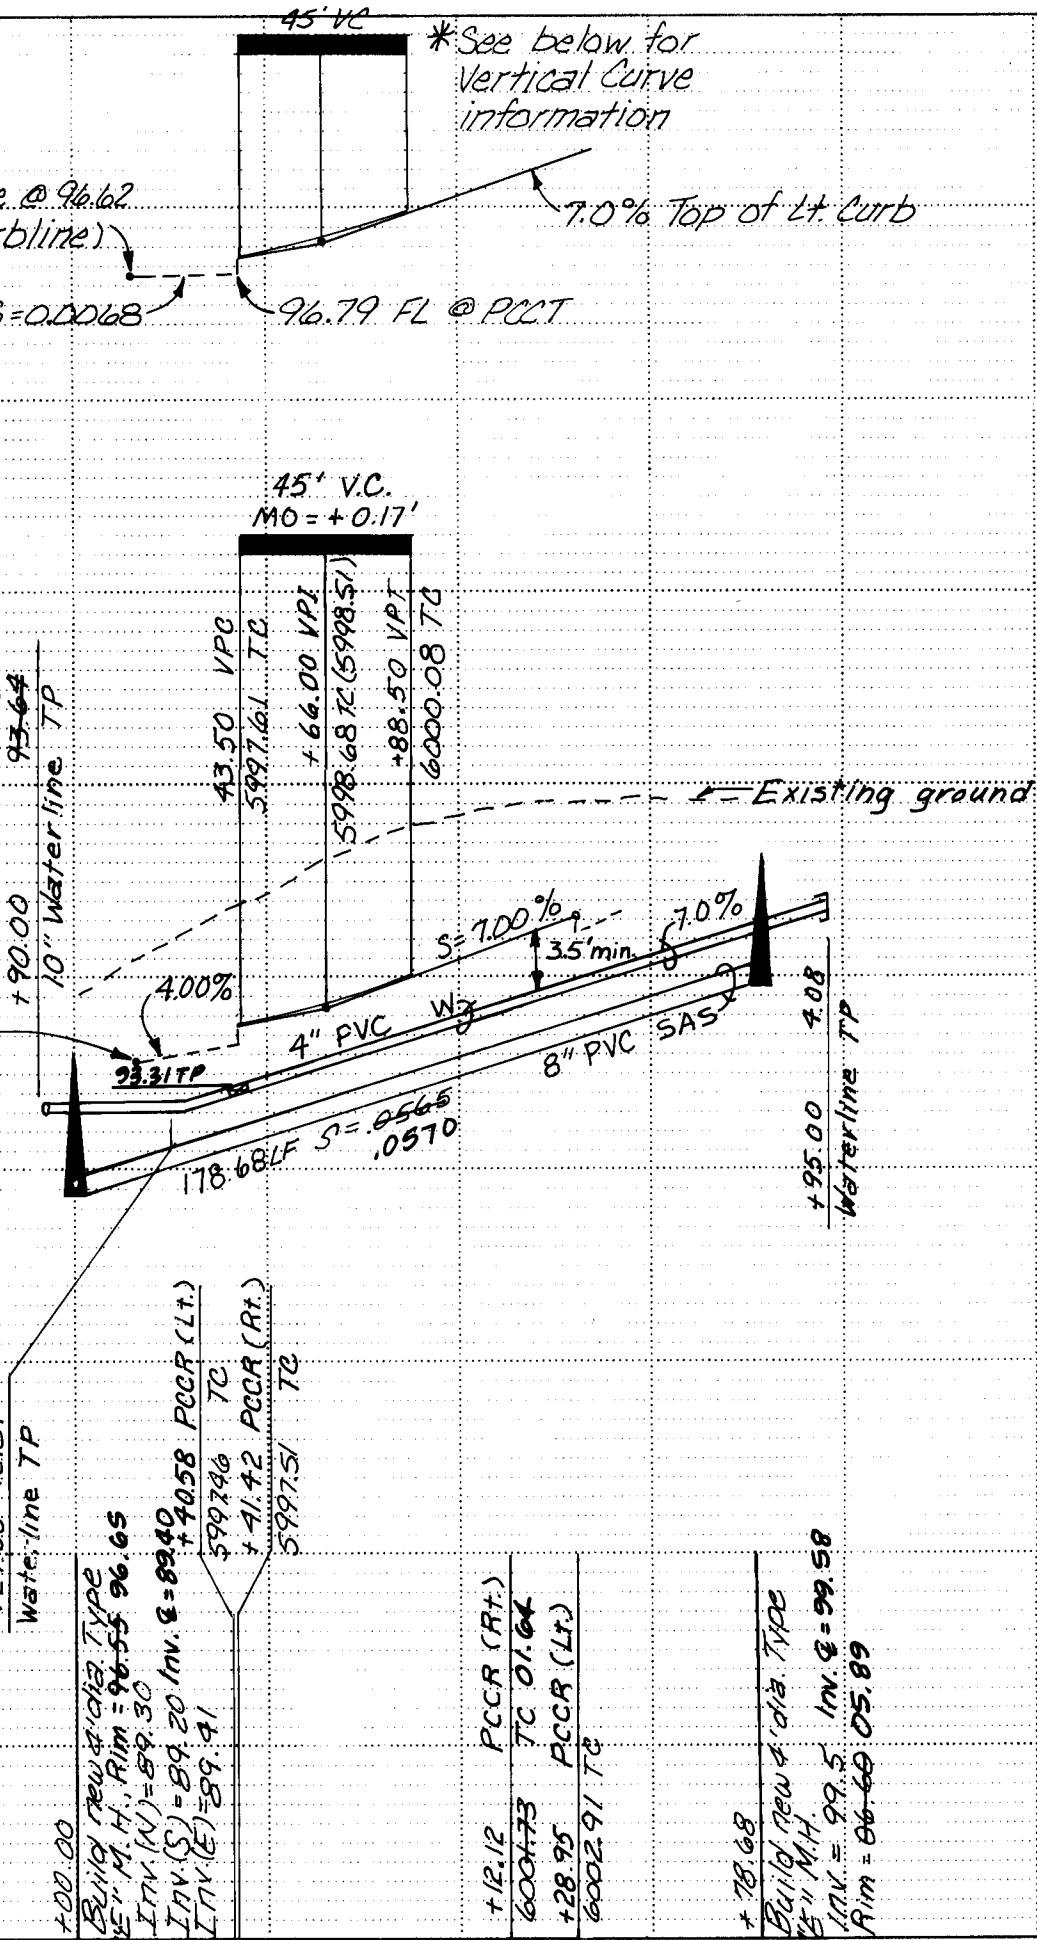

WATER STATION	SANITARY SEWER STATION	LOT NO./BLK.	WATER SERVICE LENGTH	SANITARY SEWER SERVICE	
				LENGTH	INVERT & RL
	Pinnacle		View		Place
2+28.69	1+49.50	6/B	15'	25'26.3'	04 0.3
2+28.69	2+38.69	7/B	15'	25'26.3'	05.7 6.3
3+69.69	3+08.69	8/B	15'	25'25.9'	10.7 11.0
3+69.69	3+79.69	9/B	15'	25'26.0'	15.5 14.8
4+40.3 (40'Rt)	4+55.88 (25'Rt)	18/C	52'	27'	18.5 18.2
4+40.3 (40'Rt)	4+12.09	19/C	52'	42'44.3'	16.5 17.2
3+37.32	3+47.32	20/C	35'	25'26.0'	13.2 12.8
3+37.32	2+76.32	21/C	35'	25'26.0'	08.4 8.6
1+96.32	2+06.32	22/C	35'	25'25.7'	03.5 3.7
1+96.32	—	23/C	35'	—	—
	Pinnacle		View		COURT
1+96.32	1+49.53	24/C	10'	24'22.1'	93.7 94.4
1+96.32	2+06.32	25/C	10'	24'22.2'	97.2 97.4
2+99.00	2+73.77	26/C	15'	33'34.0'	04.0 1.3
2+99.00	3+02.68 (17.5'L)	27/C	15'	26'27.5'	03.5 3.2
3+00.85	3+04.16 (34'Rt)	28/C	53'	44'45.4'	03.9
3+00.85	2+72.78	29/C	53'	58'54.2'	04.0 1.1
1+96.33	2+06.33	30/C	32'	24'22.1'	97.2 97.4
1+96.33	—	31/C	32'	—	—

AS CONSTRUCTED



CITY OF ALBUQUERQUE
MUNICIPAL DEVELOPMENT DEPARTMENT
ENGINEERING DIVISION

**SUMMIT HILLS
WATER, SEWER, PAVING, P&P -
PACLE VIEW PLACE/ PINNACLE VIEW COURT**

ENGINEER	DATE	APPROVALS	ENGINEER	DATE
P. W. Thompson	5/18/85	Liquid Waste	R. Rana	5/1/85
J. L. Oyer	5/9/85	Traffic	Vernell W. Hansen	5/1/85
B. J. Sookay	5/1/85	Water	R. Rana	5/1/85

SCALE: 1" = 50' HORIZ.
1" = 10' VERT.



425	MAP NO. J-23	SHEET 11	OF 14
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TRACT A-I EASEMENT

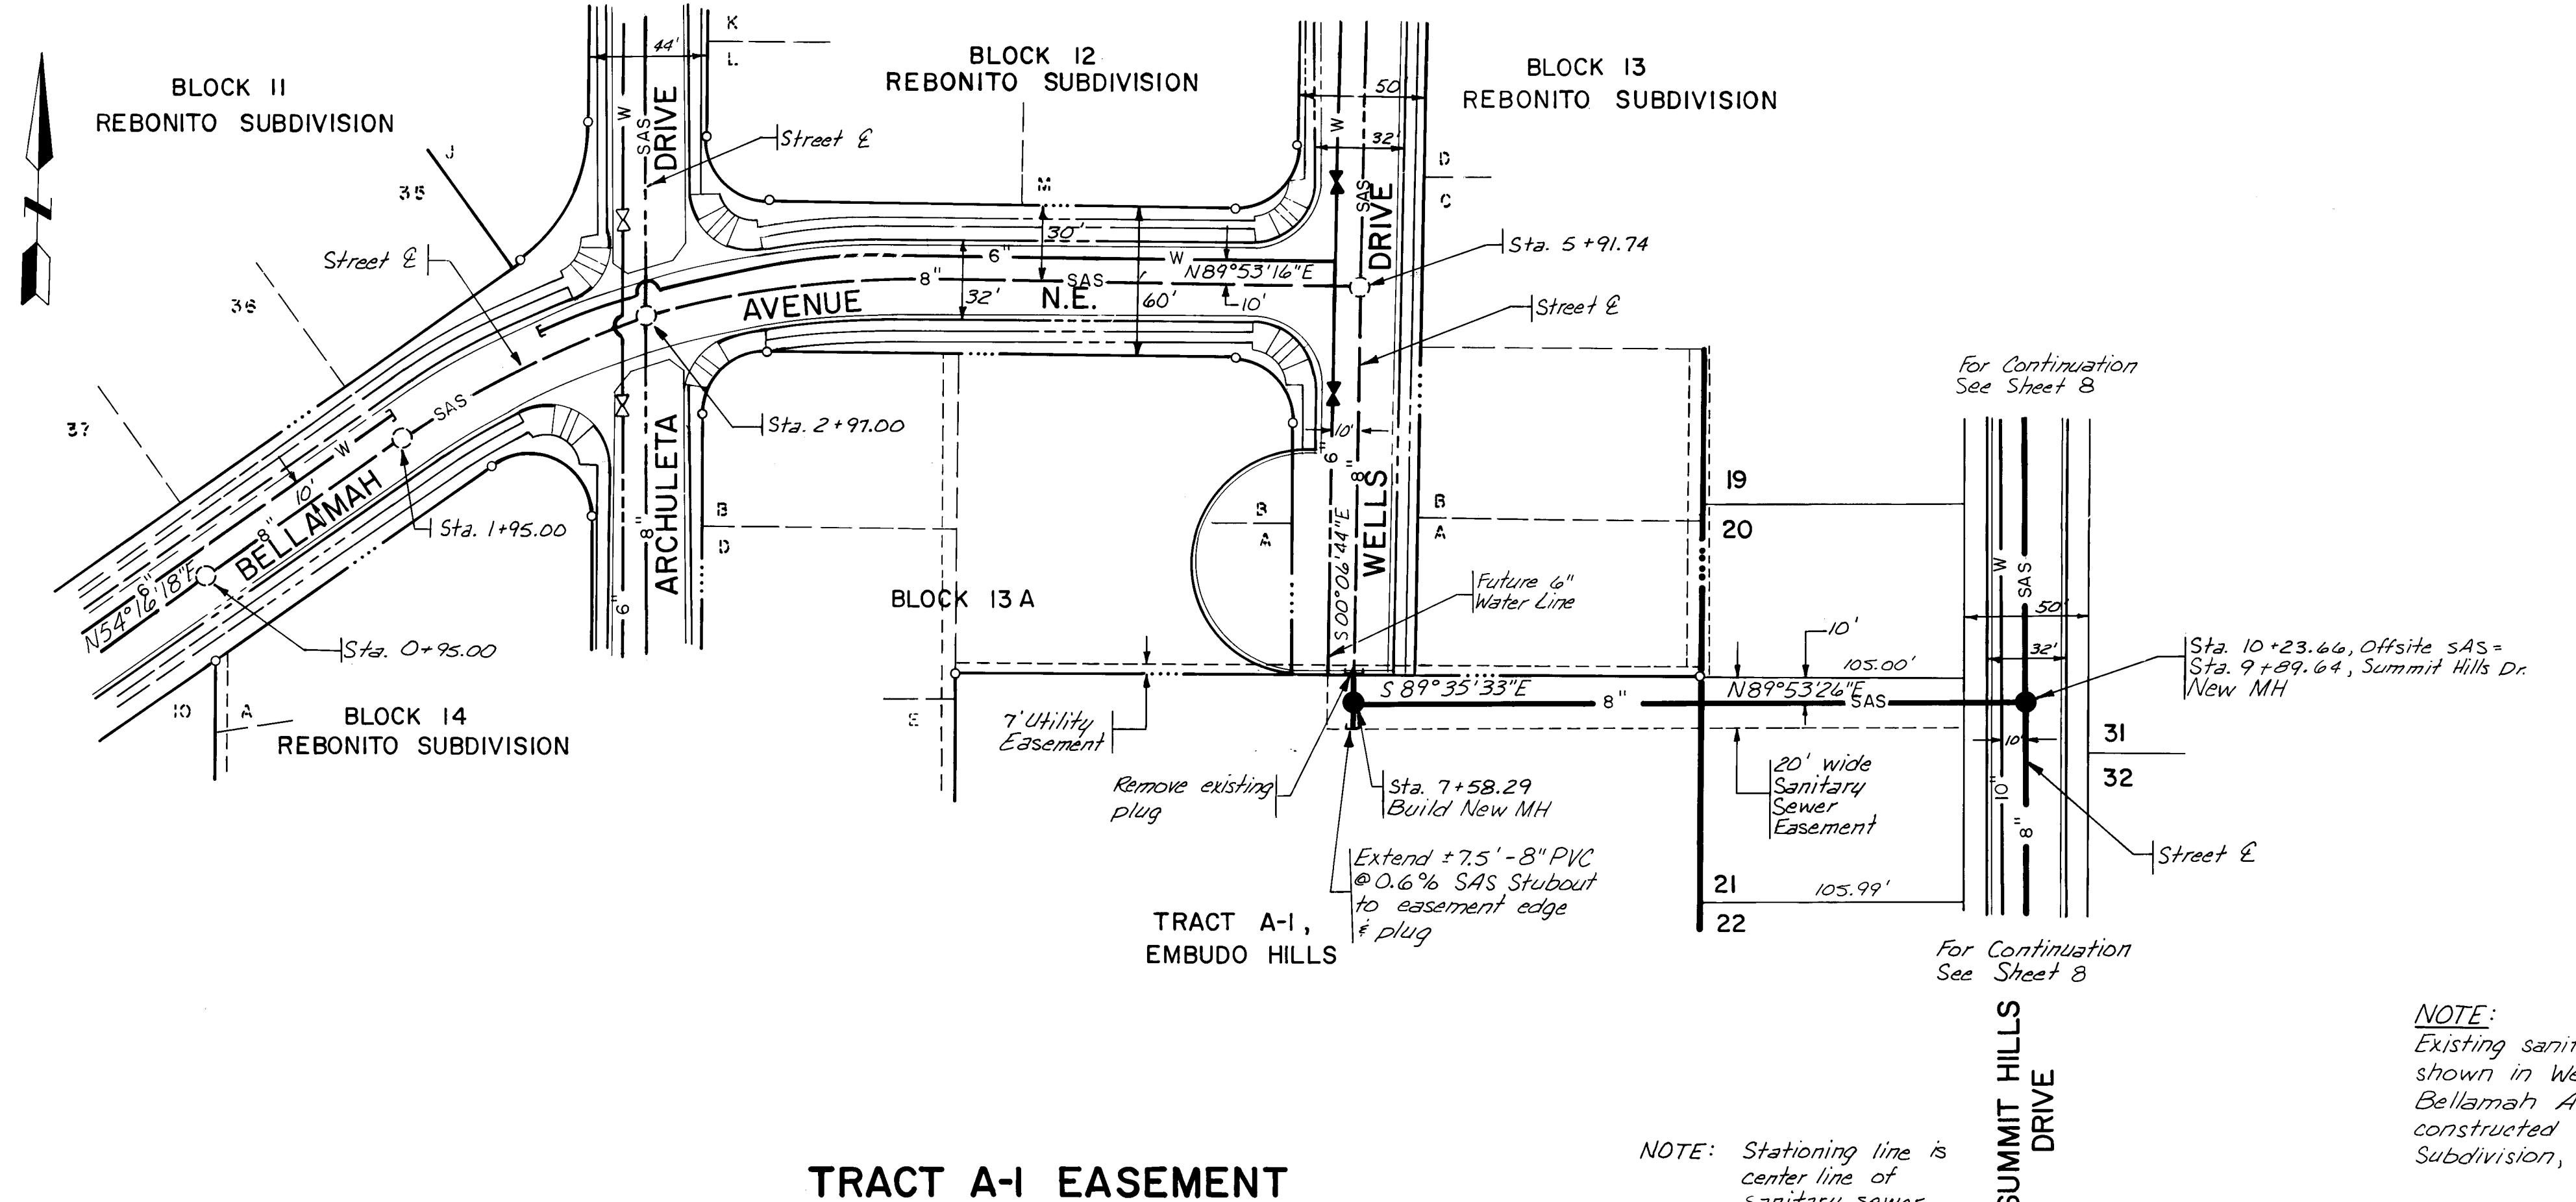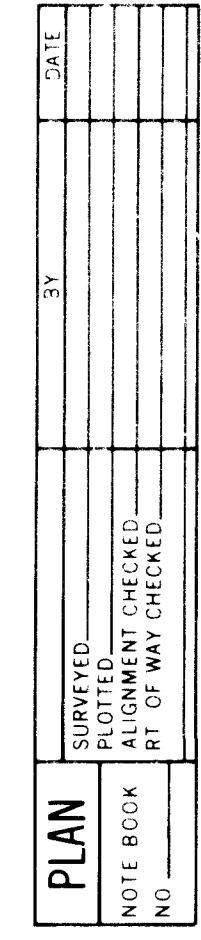NOTE: Stationing line is center line of sanitary sewer.

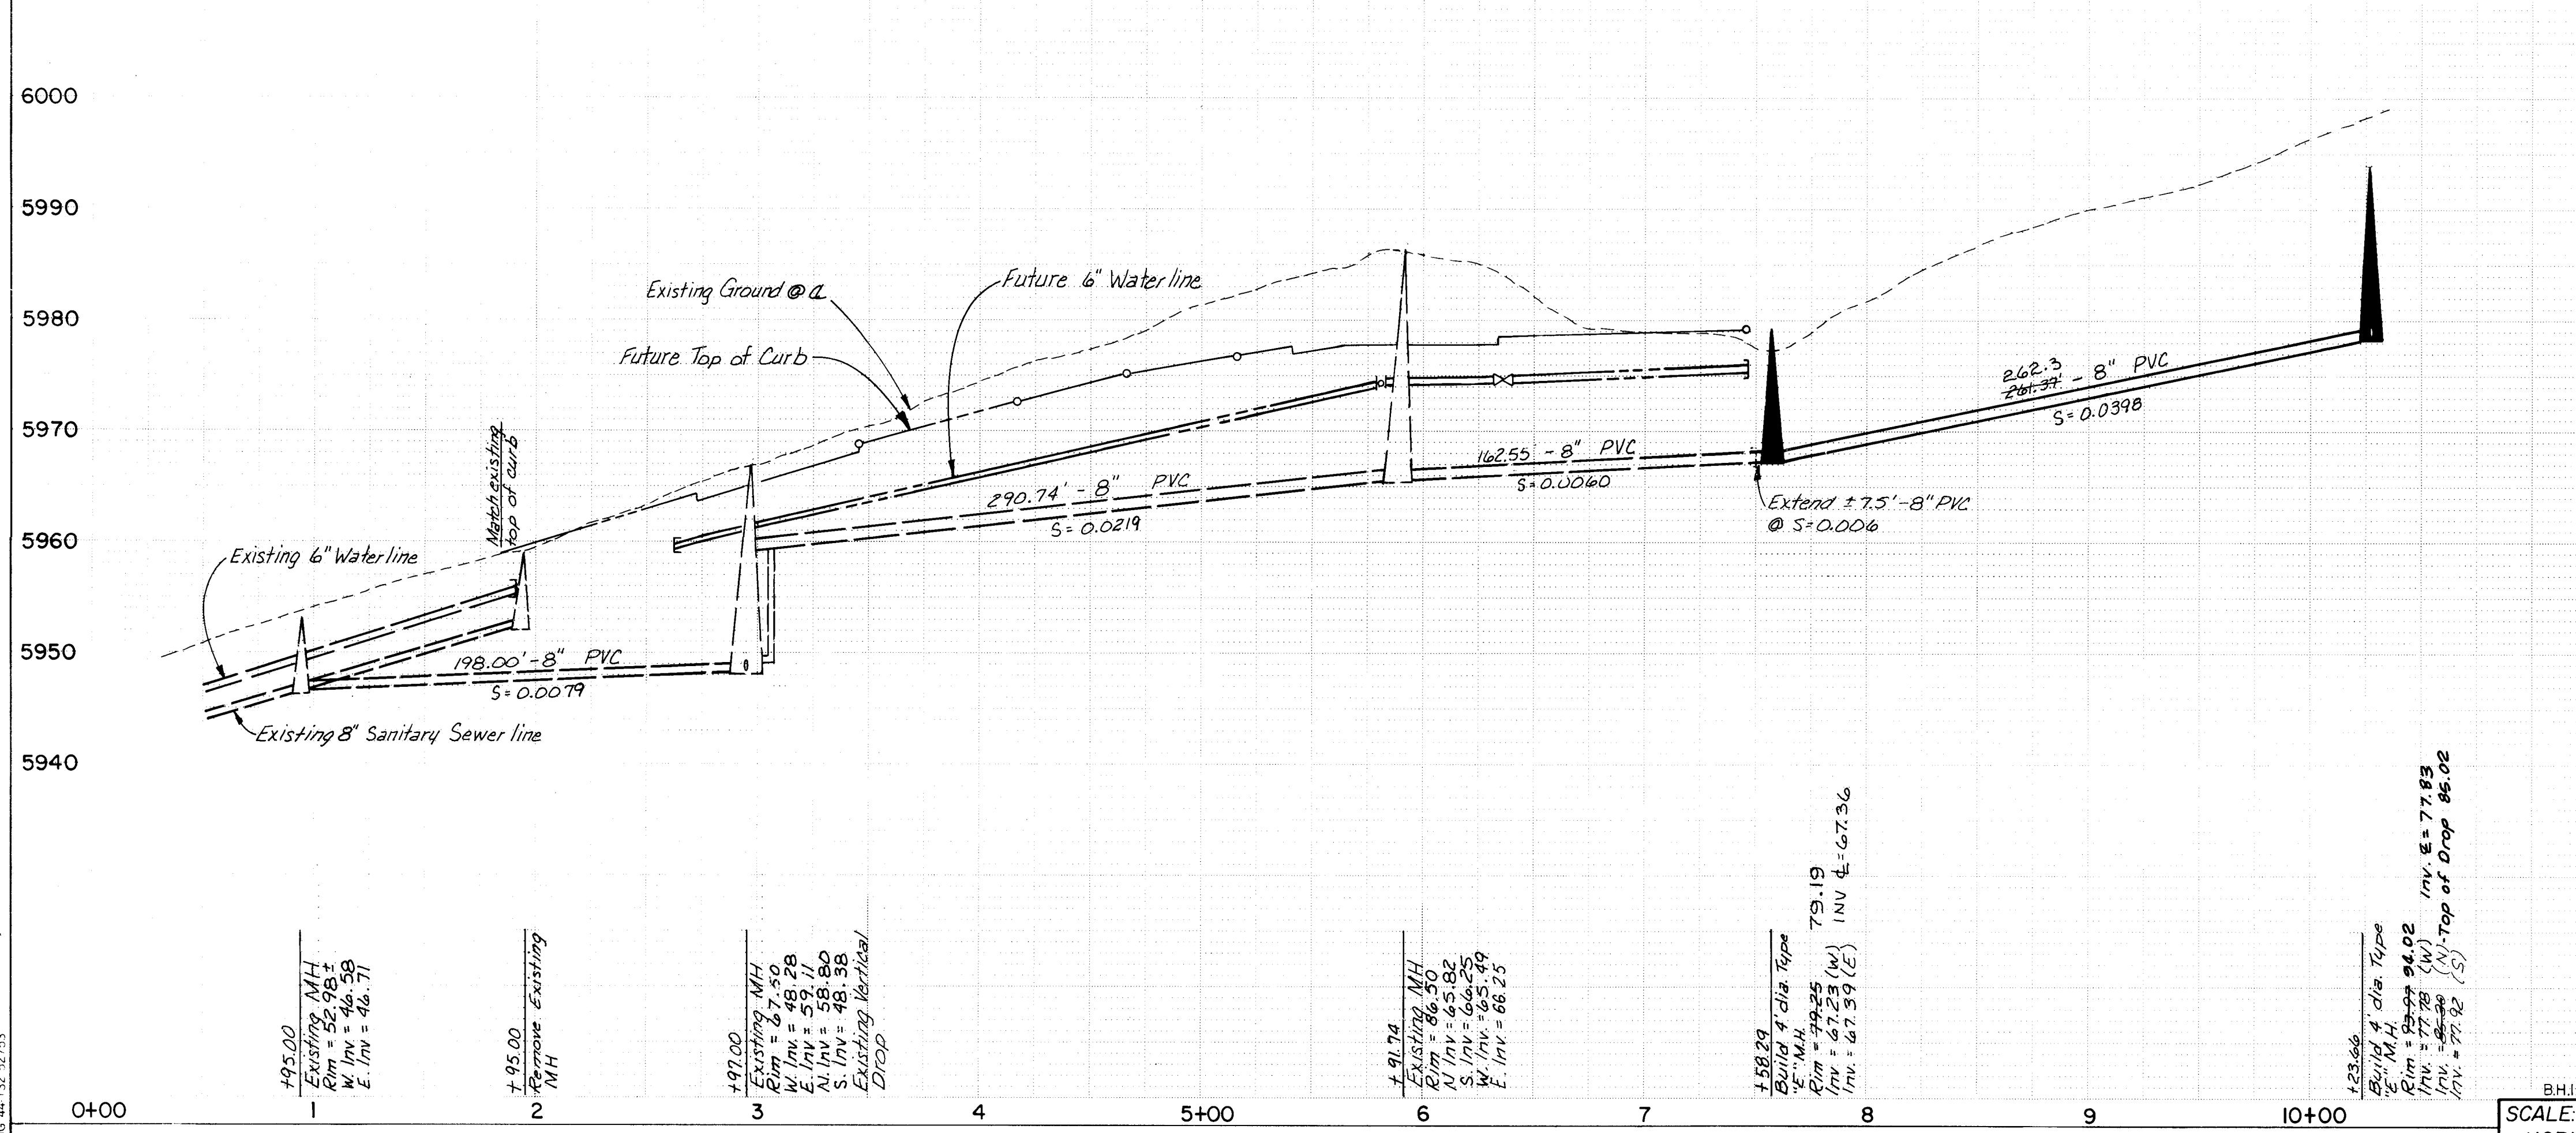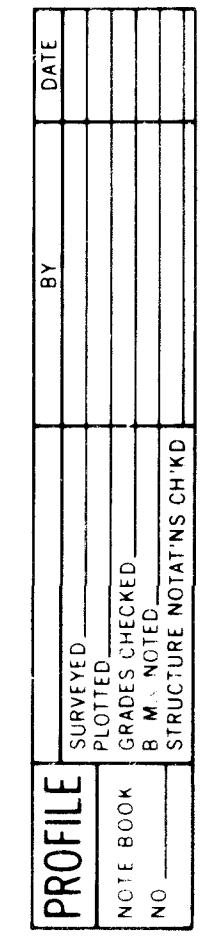NOTE:
Existing sanitary sewer line
shown in Wells Drive and
Bellamah Ave. to be
constructed by Rebonito
Subdivision, Project #2176



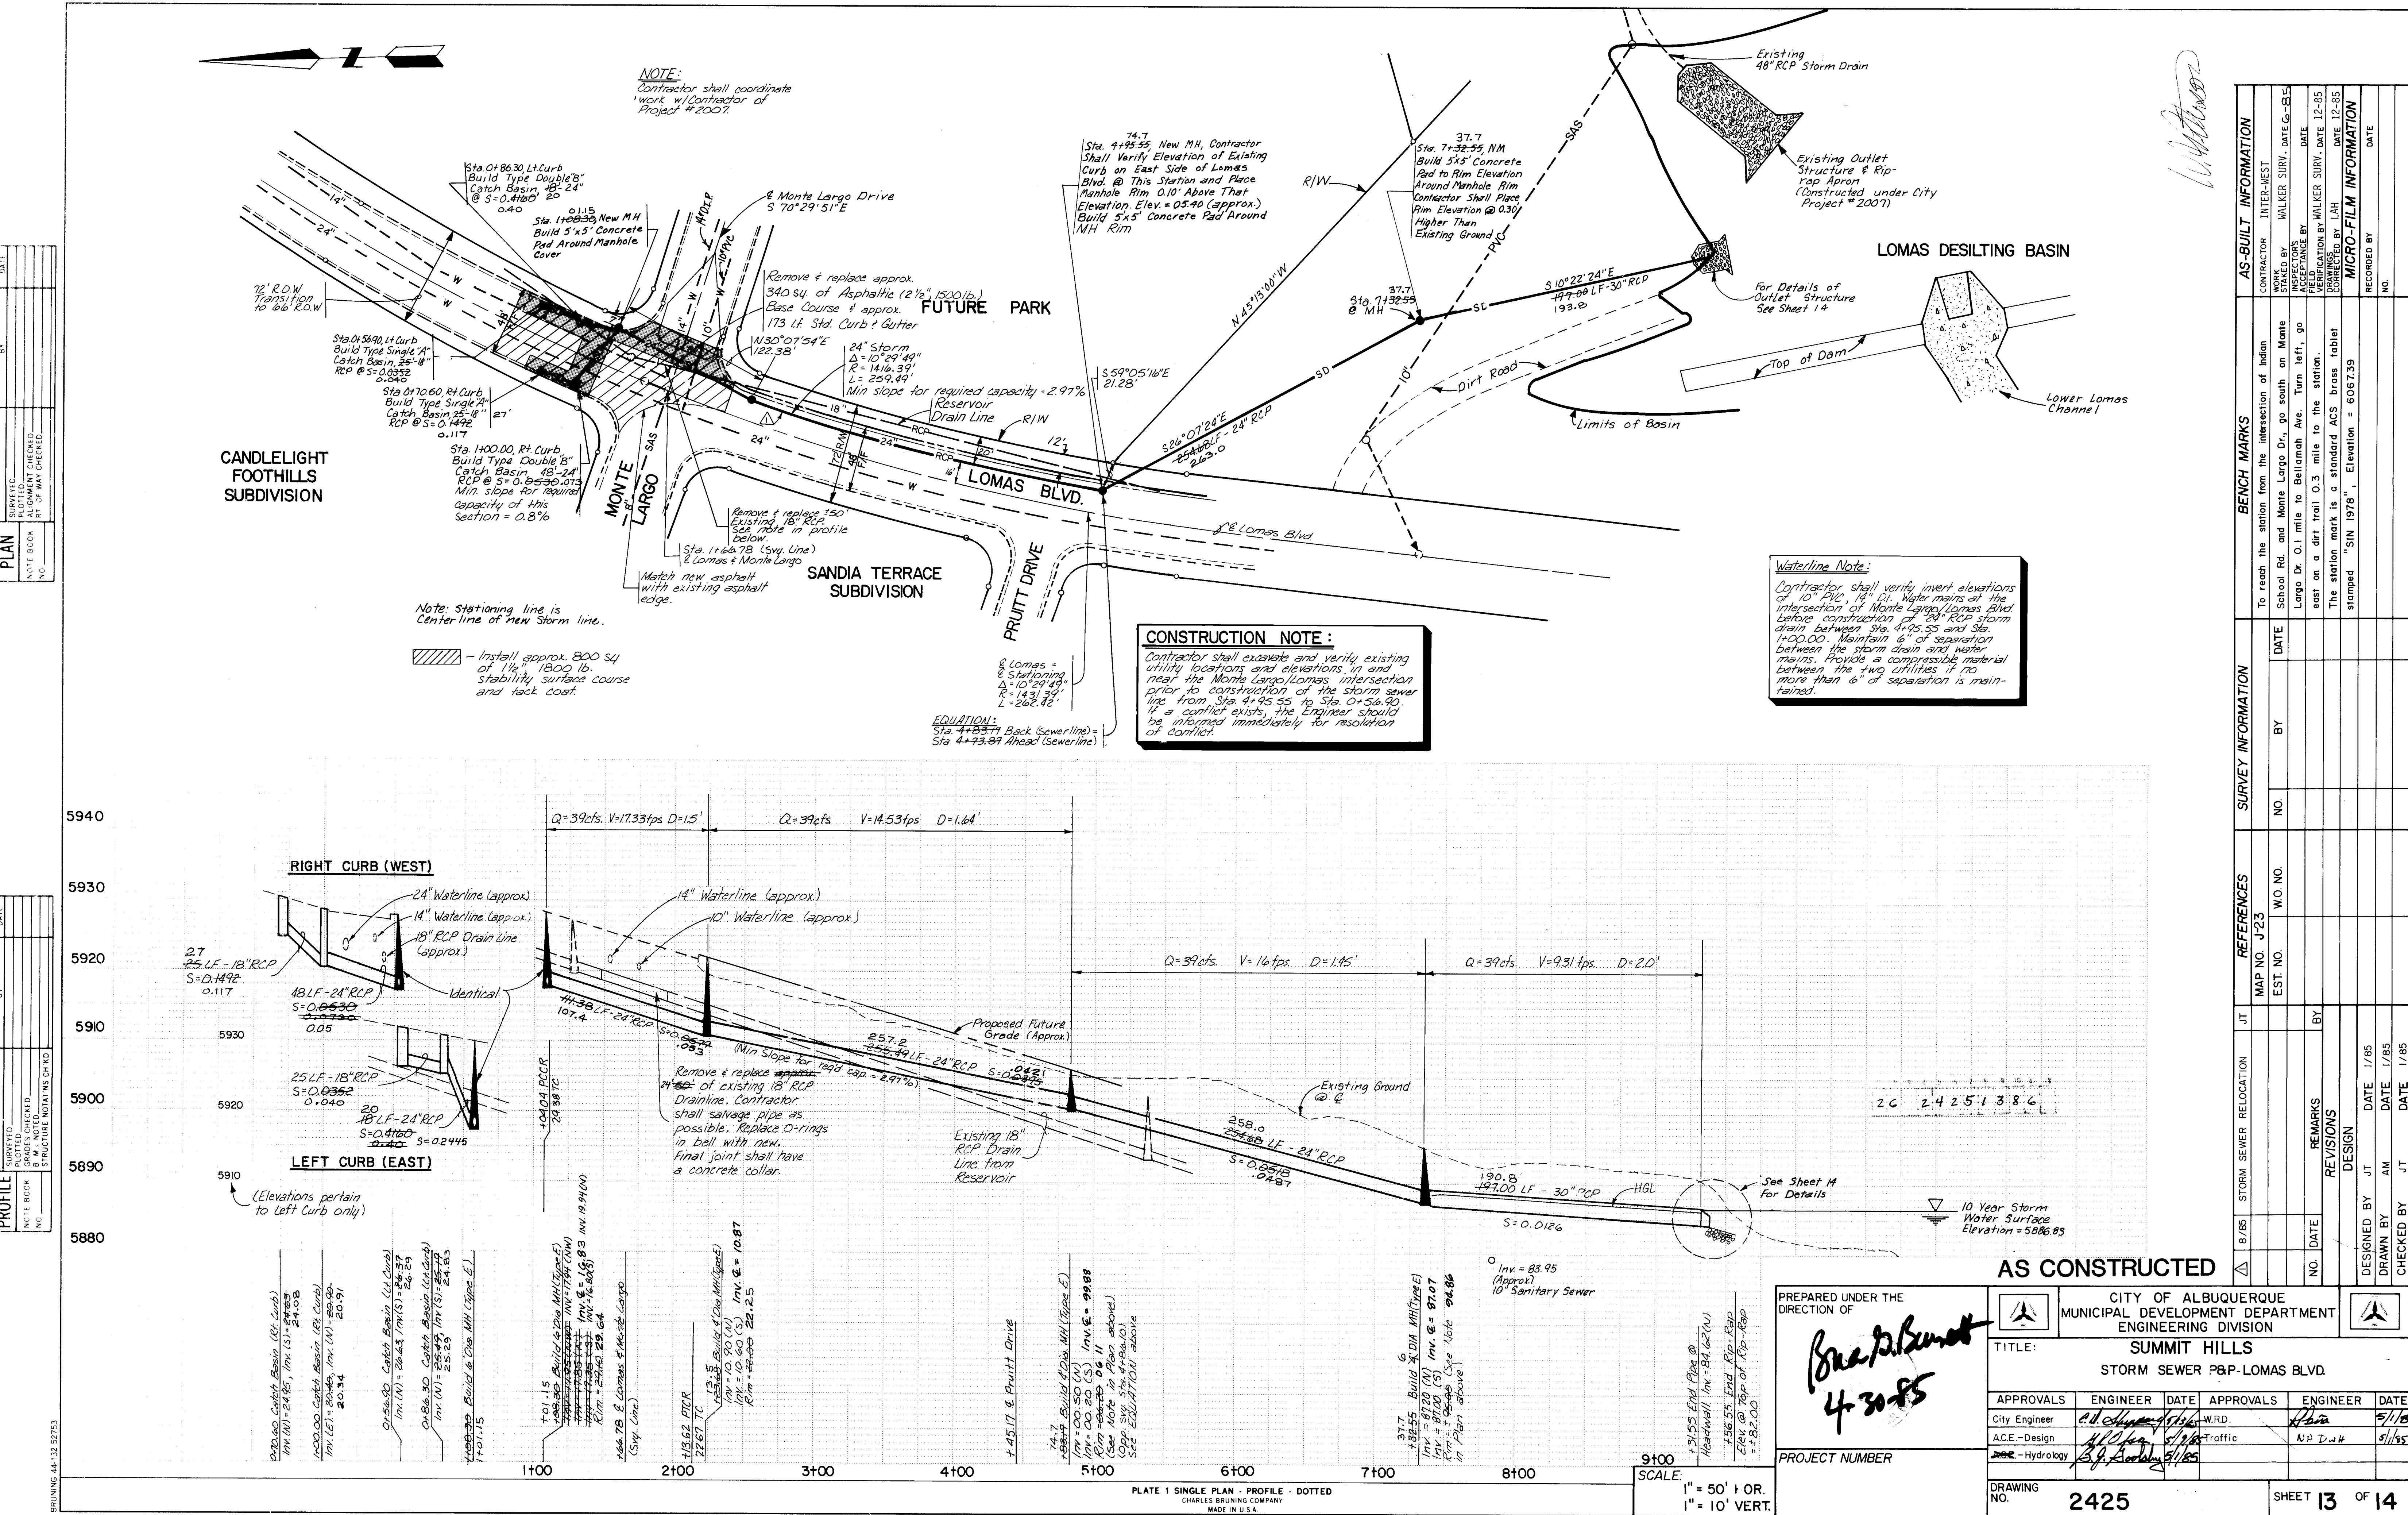
AS CONSTRUCTED



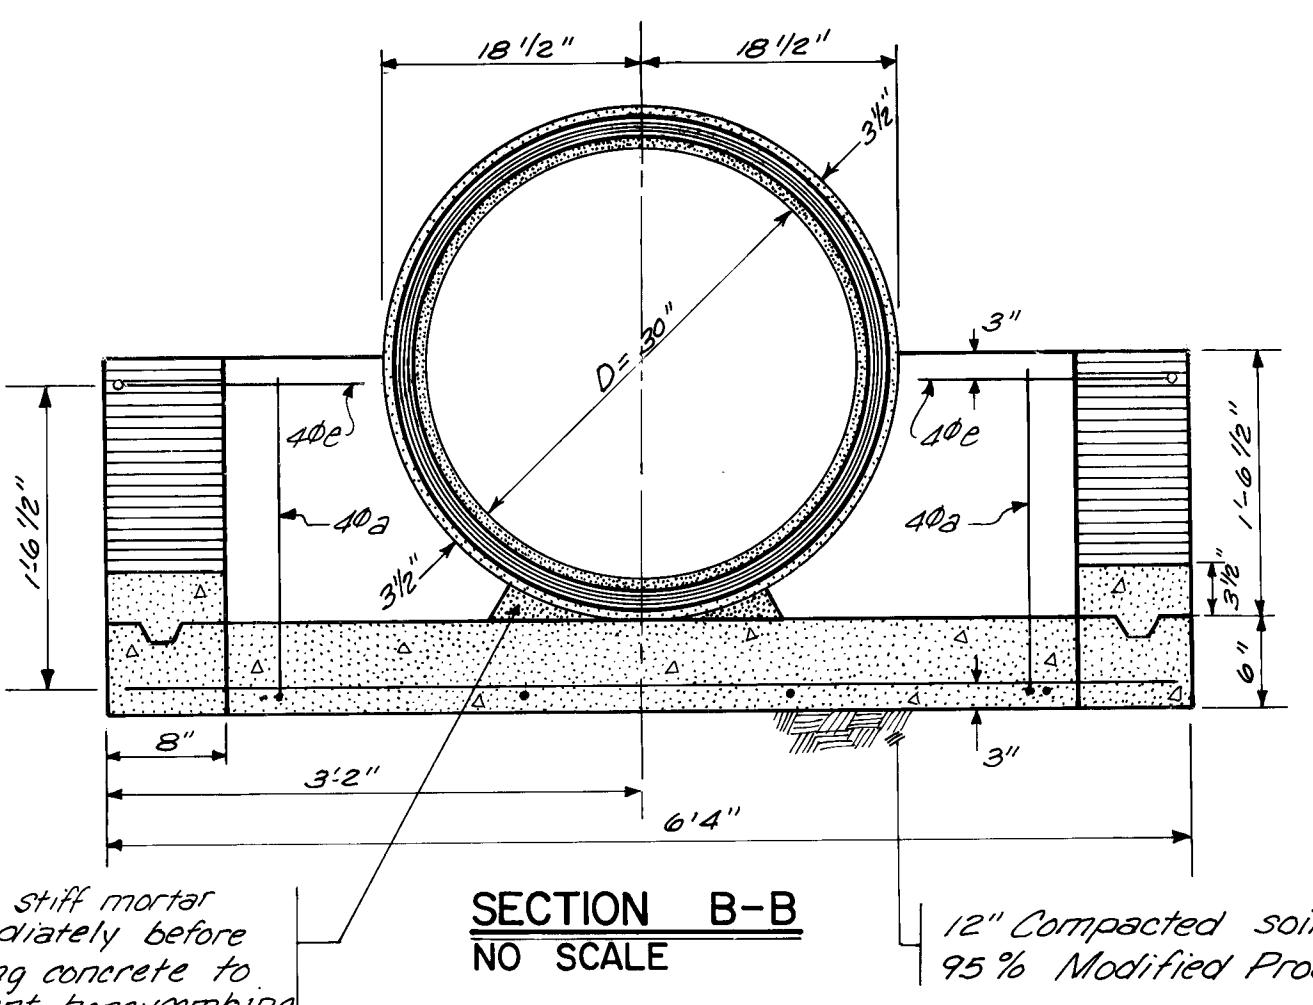
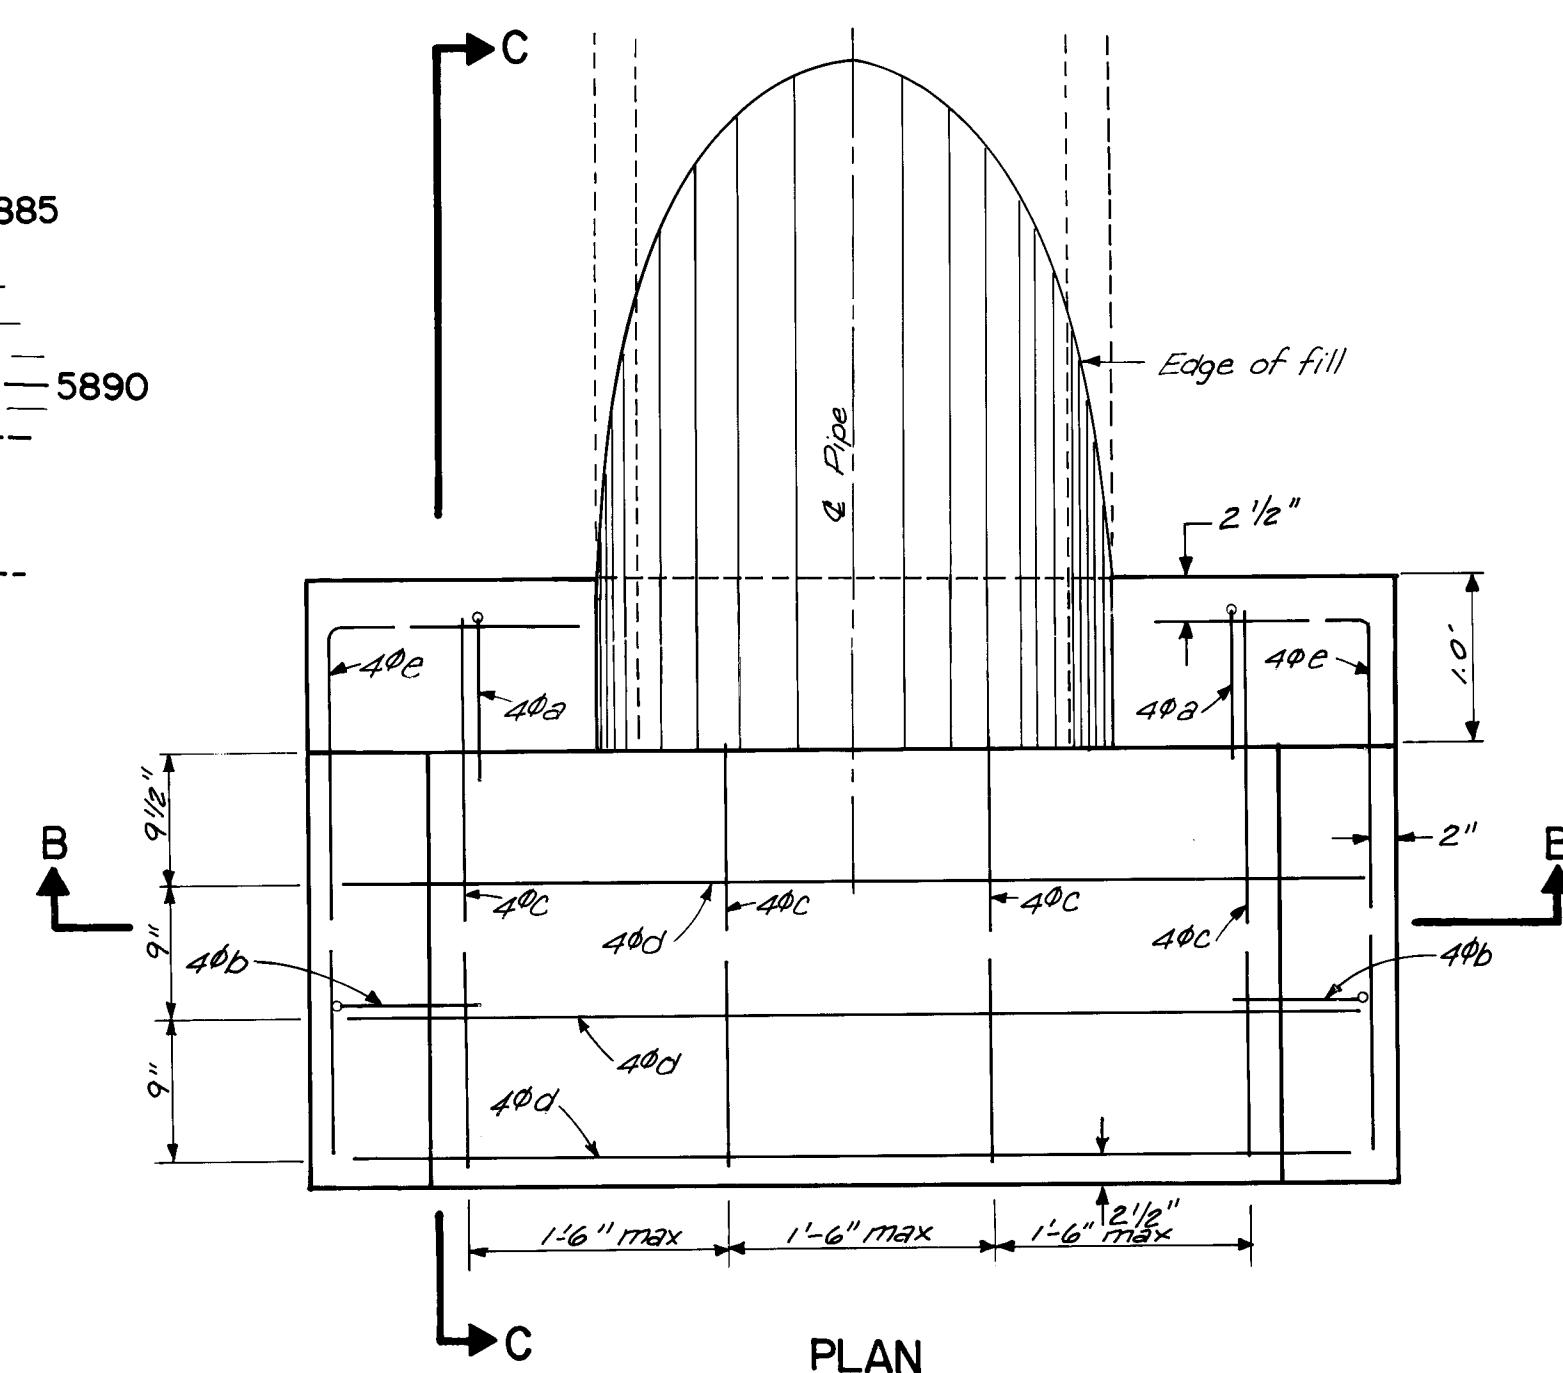
PREPARED UNDER THE DIRECTION OF			CITY OF ALBUQUERQUE MUNICIPAL DEVELOPMENT DEPARTMENT ENGINEERING DIVISION			
<i>Robert P. Bennett</i> <i>4-30-85</i>		TITLE: SUMMIT HILLS OFFSITE SANITARY SEWER P&P - TRACT A-I EASEMENT				
APPROVALS	ENGINEER	DATE	APPROVALS	ENGINEER	DATE	
City Engineer	<i>C.D. Shippard</i>	<i>5/1/85</i>	W.R.D.	<i>Rain</i>	<i>5/1/85</i>	
A.C.E.-Design	<i>H.C. Long</i>	<i>5/1/85</i>	Traffic	<i>N.A. D.W.H.</i>	<i>5/1/85</i>	
A.C.E. - Hydrology	<i>N.A. S.G.</i>	<i>5/1/85</i>				
PROJECT NUMBER		DRAWING NO. 2425			SHEET 12 OF 14	

PLATE 1 SINGLE PLAN - PROFILE - DOTTED
CHARLES BRUNING COMPANY
MADE IN U.S.A.

SCALE:
HORIZ. 1" = 50'
VERT. 1" = 10'

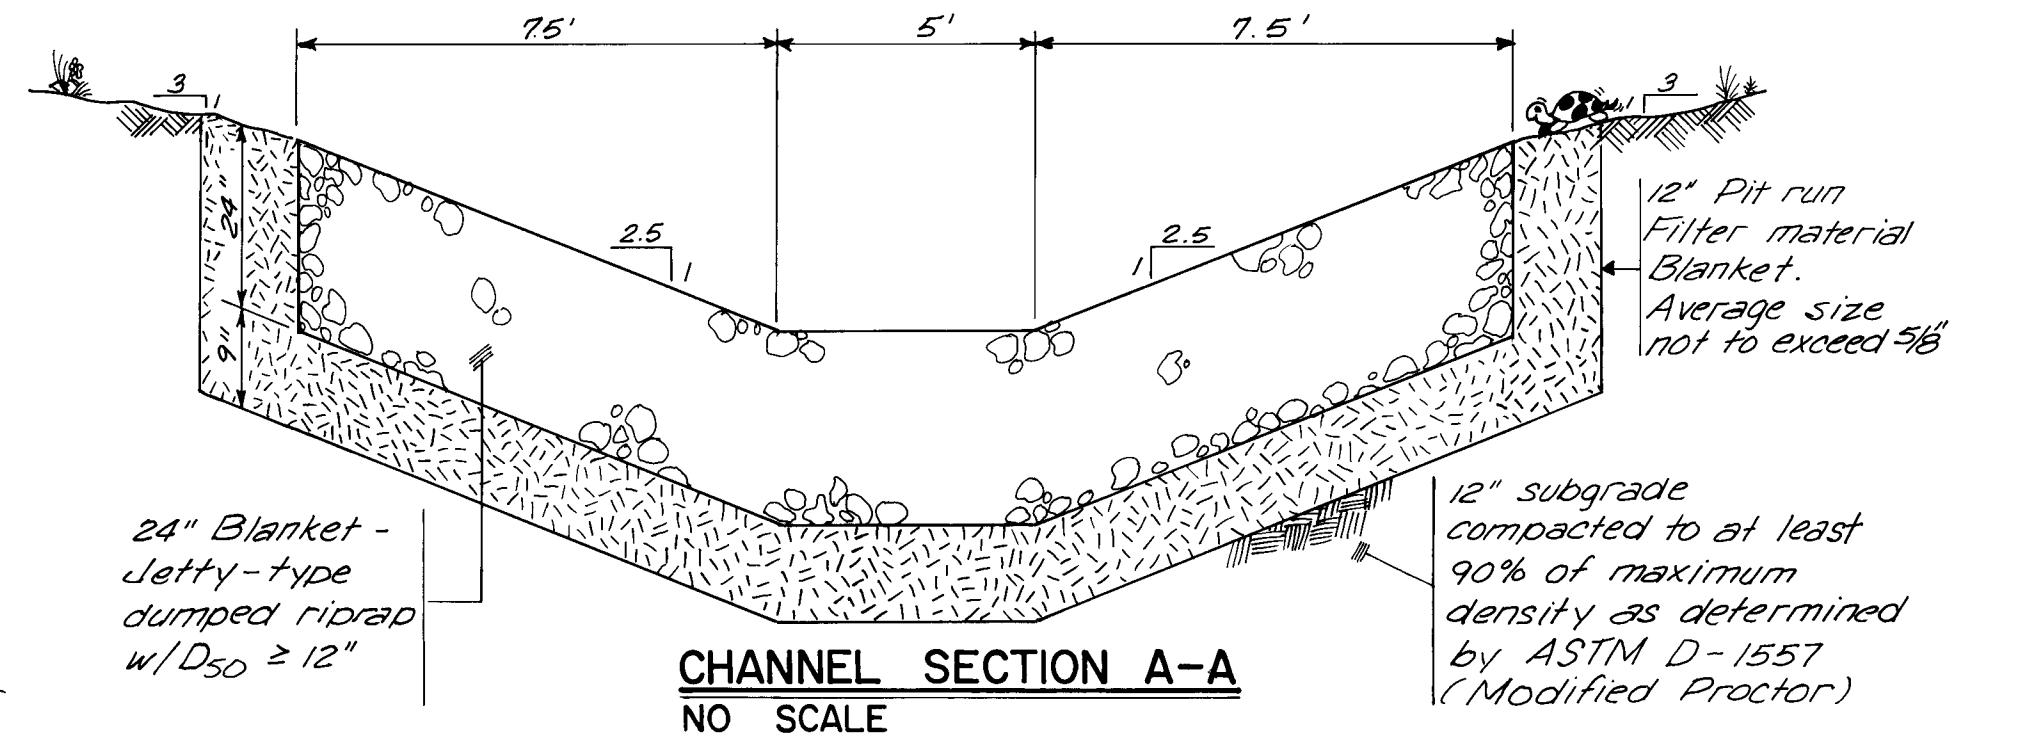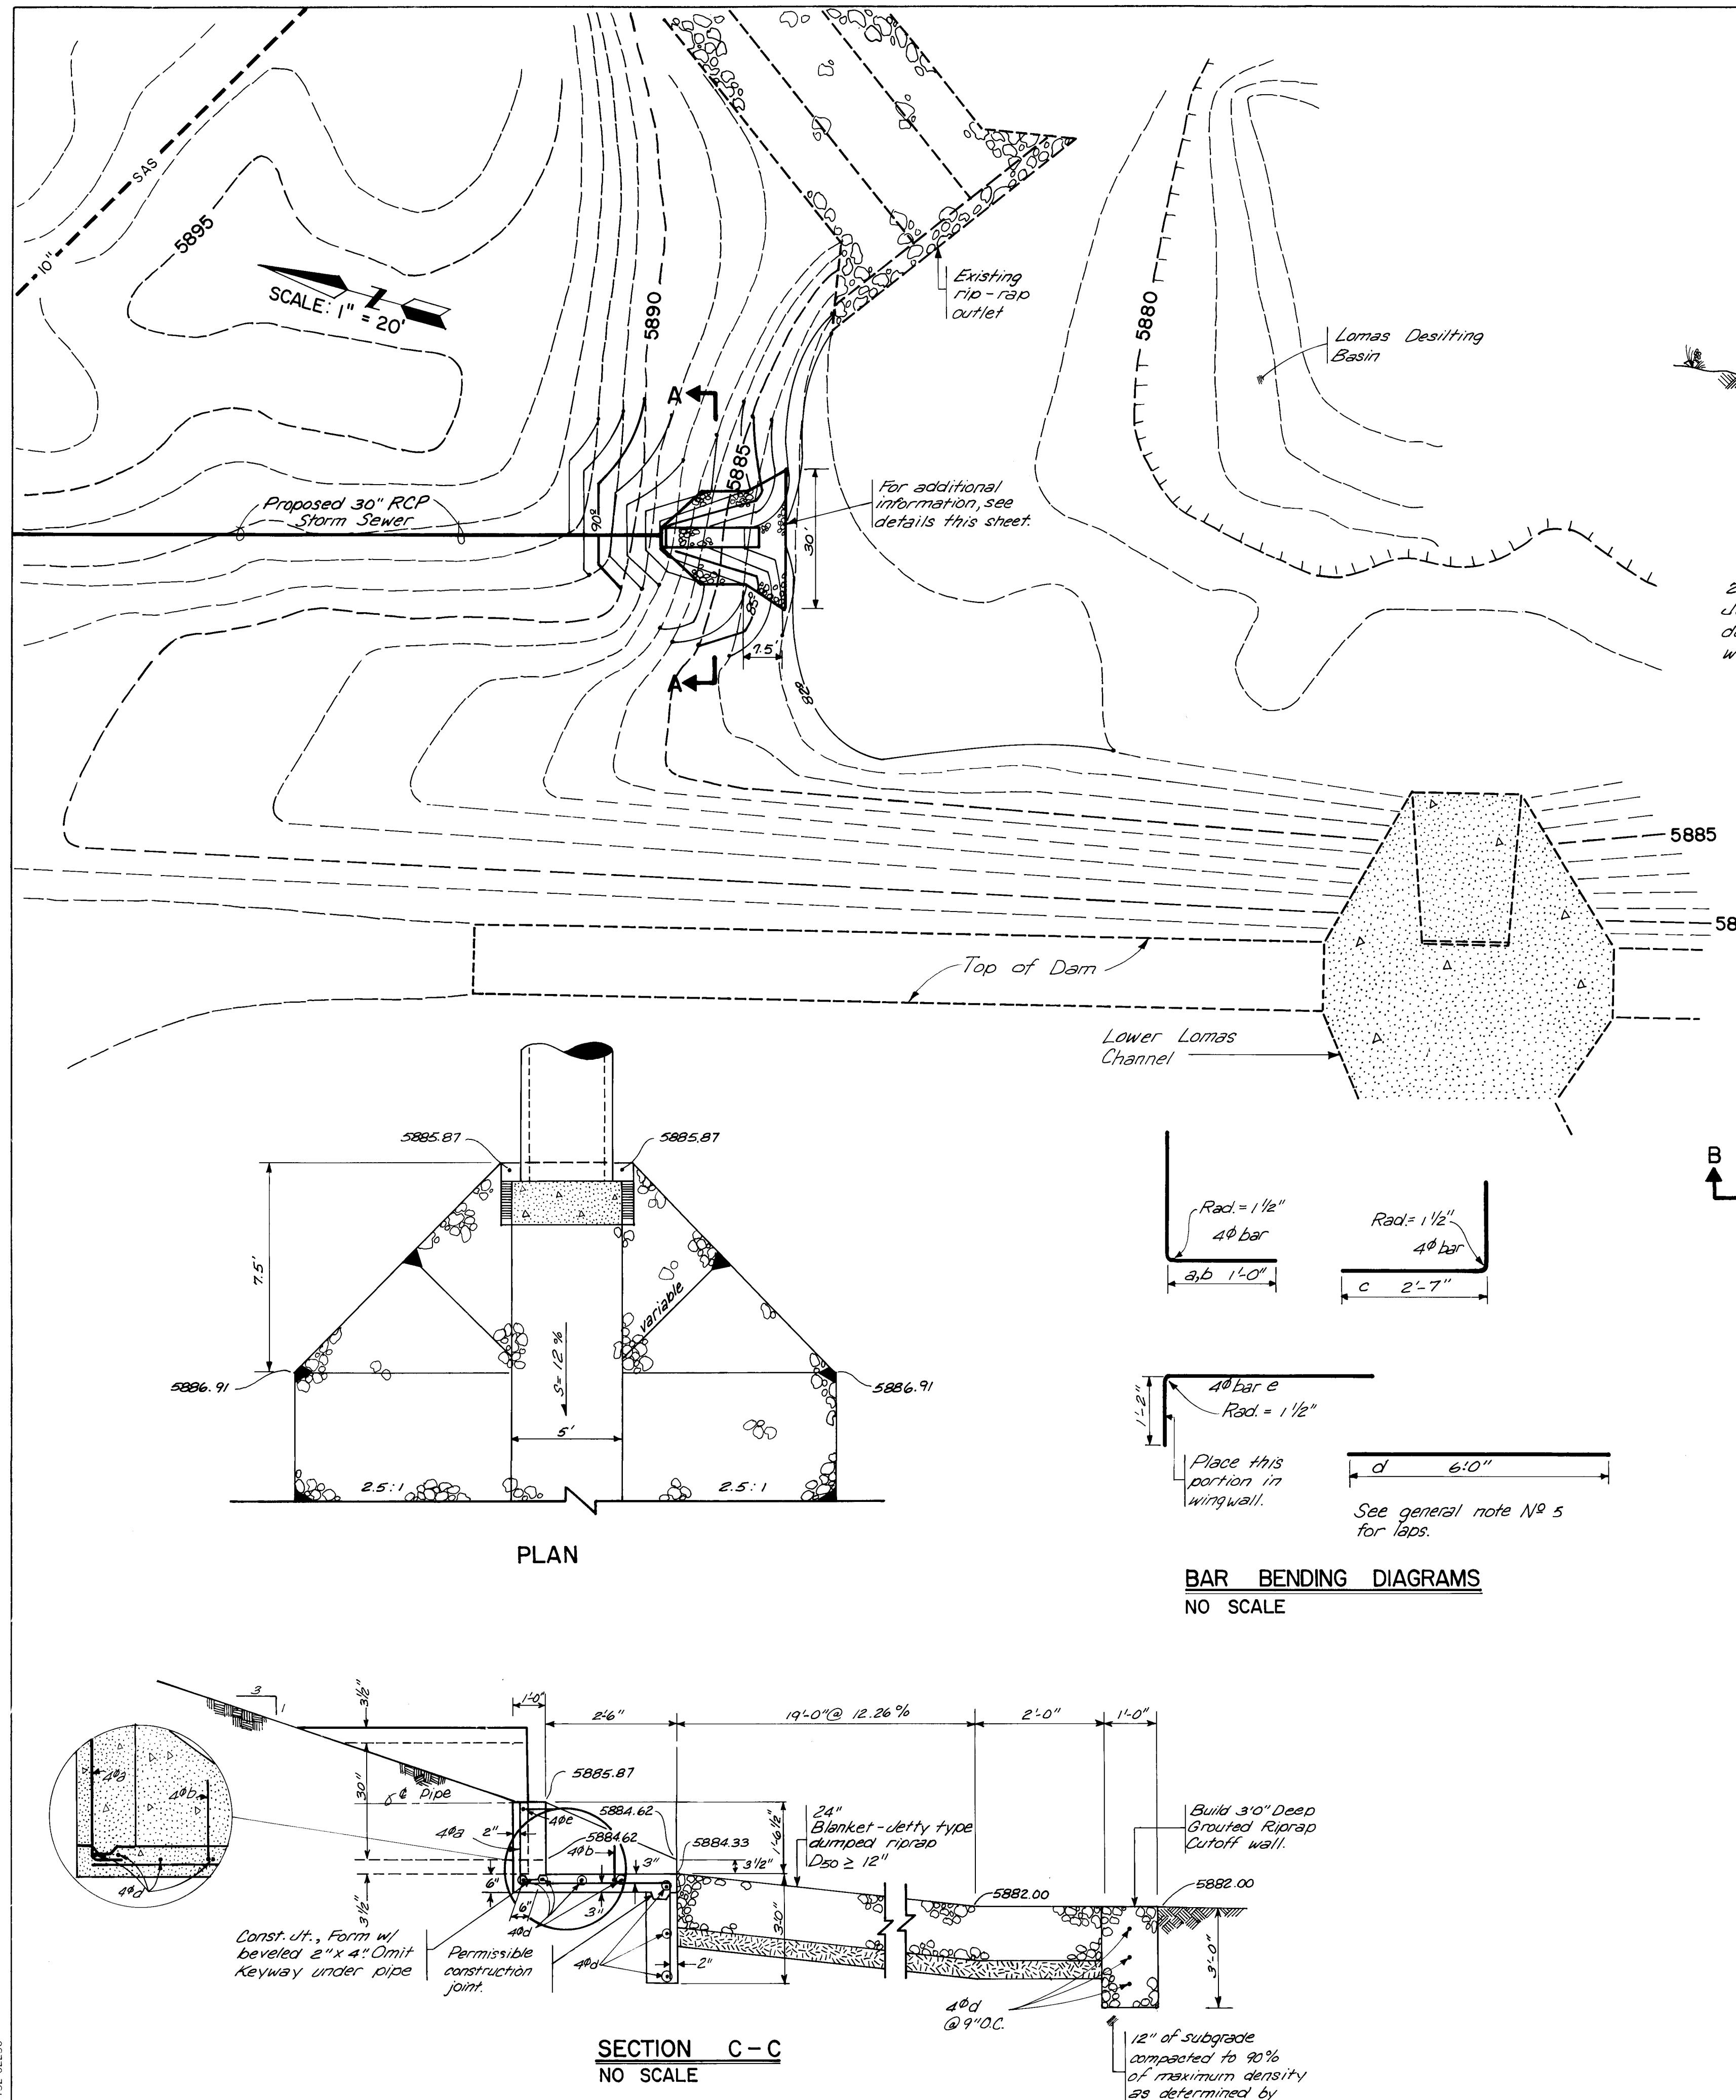SHEET 12 OF 14





GENERAL NOTES

- | AS BUILT INFORMATION | |
|--|--|
| BENCH | MARKS |
| Materials and workmanship to conform to NMSH Commission Specifications. | To reach the station from the intersection of Indian School Rd |
| Design based on a minimum concrete compressive strength of 3000 pounds per sq. inch at 28 days. Chamfer all exposed edges $\frac{3}{4}$ " | |
| Reinforcing steel to be deformed bars, intermediate grade conforming to A.A.S.H.O. specifications M-31 and M-137. Dimensions refer to ℓ of bar. | |
| Place 3 d-bars in grouted riprap cutoff wall. | |
| d-bars may be spliced when necessary by lapping at least 20 bar diameters. | |
| Forms shall be placed on the outside edge of the cut-off wall. Forms on the inside edge of the cut-off wall will not be required. Pay quantities are to be based on dimensions as shown. | |
| The design shown uses the following quantities:
Reinforcing steel - 40 lbs,
Concrete - 0.94 cu. yds. | EIELD NOTES |

FIELD NOTES		DATE	BY	CONTRACTOR	INTER-MWEST
				WALKER SURV. DATE 6-85	
				WORK STAKED BY INSPECTOR	
				ACCEPTANCE BY FIELD	DATE
				VERIFICATION BY WALKER SURV. DATE 12-85	
				DRAWINGS BY LAH	DATE 12-85
				MICRO-FILM INFORMATION	
				RECORDED BY	DATE
				NO	

Ms. B. 1.6 v. 10, front

S CONSTRUCTED

**CITY OF ALBUQUERQUE
MUNICIPAL DEVELOPMENT DEPARTMENT
ENGINEERING DIVISION**

ENGINEERING DIVISION
SUMMIT HILLS
BASIN OUTLET DETAILS

VALS	ENGINEER	DATE	APPROVALS	ENGINEER	DATE
Engineer	C. D. Shippard	5/3/85	Liquid Waste	Ram	5/1/85
Design	H. Oleg	5/7/85	Traffic	NAD 104	5/1/85
hydrology	B. J. Gooday	5/1/85	Water	Ram	5/1/85

ING 2425 MAP NO. J-23 SHEET 14 OF 14