


CITY OF ALBUQUERQUE

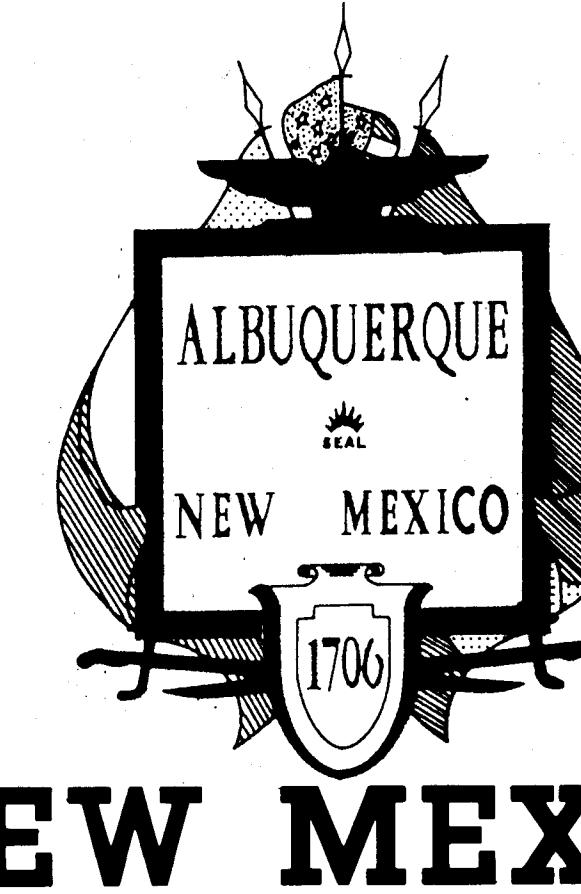

NEW MEXICO


CONSTRUCTION PLANS

FOR

NORTH VALLEY
DRAINAGE SYSTEM IMPROVEMENTS

MONTANO ROAD - SYSTEM A
GRIEGOS ROAD - SYSTEMS B and C
PROJECT No. 2461

1 2 3 4 5 6 7 8 9 10 11 12
26 2461 00 88

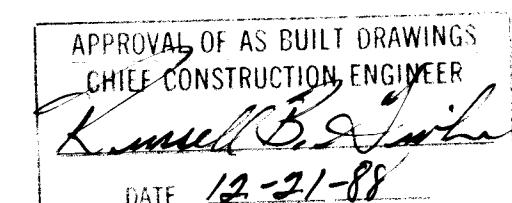

REV.	SHEETS	CITY	ENGR.	DATE	USER	DEPT.	DATE	USER	DEPT.	DATE
APPROVAL OF REVISIONS										




SCANLON & ASSOCIATES
CONSULTING ENGINEERS

NOVEMBER 1987

SET NO. _____
JOB NO. 8513

RECORD DRAWING

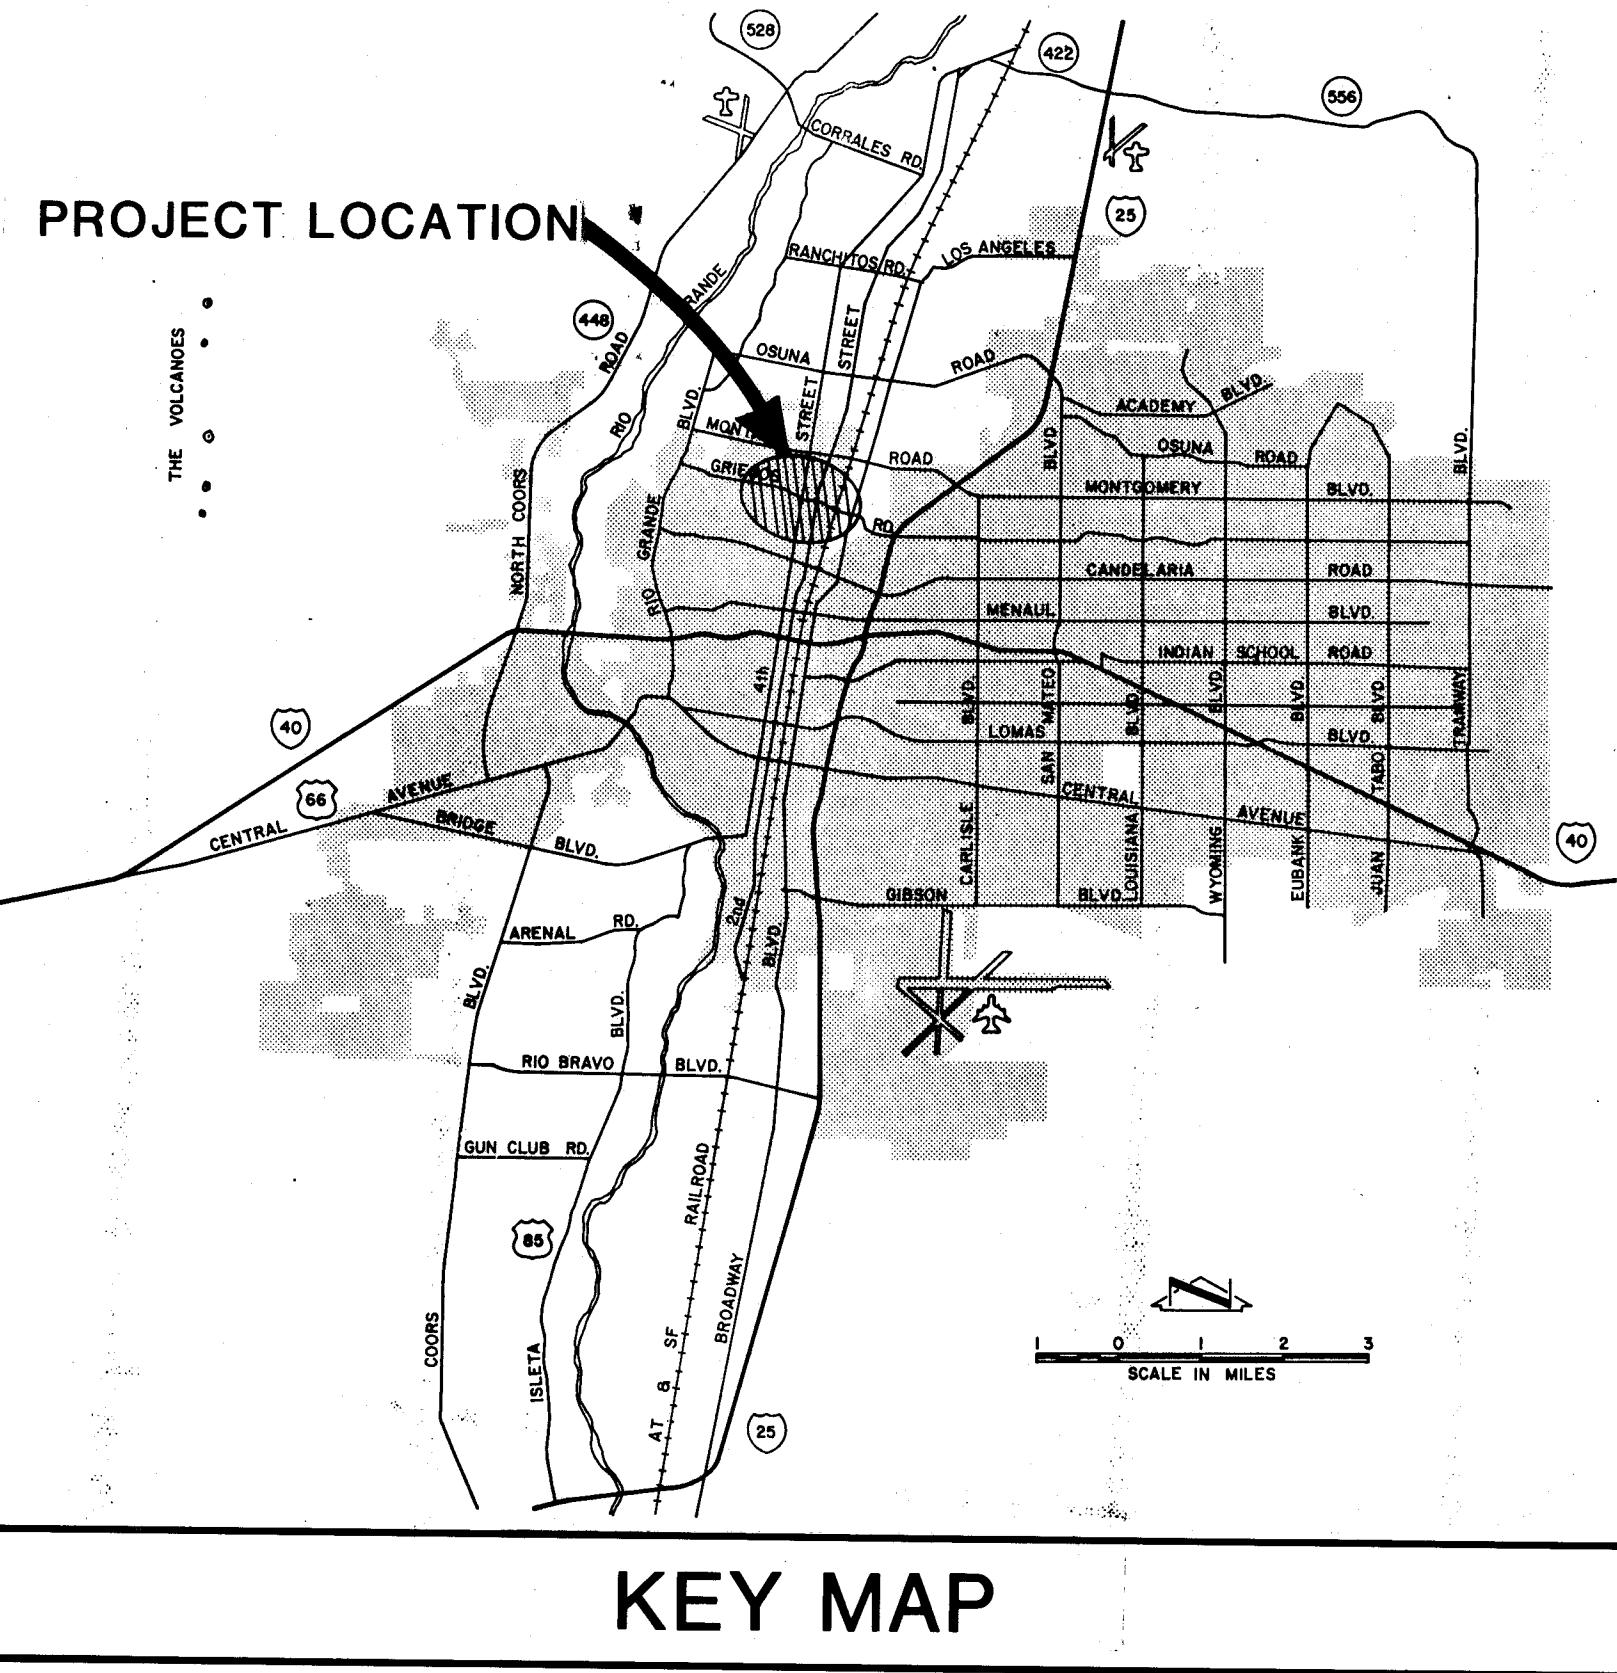

CITY OF ALBUQUERQUE



NEW MEXICO

INDEX TO SHEETS


SHEET NO.	DESCRIPTION
1	Title Sheet
2	General Notes and Details
3	Site Plan Legend and Traffic Control Notes
4	Storm Drain Plan & Profile Sta. 2+88 to 4+50
5	Storm Drain Plan & Profile Sta. 4+50 to 9+00
6	Storm Drain Plan & Profile Sta. 9+00 to 13+50
7	Storm Drain Plan & Profile Sta. 13+50 to 18+00
8	Storm Drain Plan & Profile Sta. 18+00 to 22+50
9	Storm Drain Plan & Profile Sta. 22+50 to 27+00
10	Storm Drain Plan & Profile Sta. 27+00 to 31+50
11	Storm Drain Plan & Profile Sta. 31+50 to 36+00
12	Storm Drain Plan & Profile Sta. 36+00 to 38+63
13	Sanitary Sewer Plan & Profile Sta. 16+00 to 20+00
14	Sanitary Sewer Plan & Profile Sta. 20+00 to 24+00
15	Sanitary Sewer Plan & Profile Sta. 24+00 to 28+00
16	Sanitary Sewer Plan & Profile Sta. 27+00 to 31+50
17	Sanitary Sewer Plan & Profile Sta. 31+50 to 36+00
18	Sanitary Sewer Plan & Profile Sta. 36+00 to 37+00
19	Outlet Structure Plan & Details
20-21	Traffic Control Plan

CONSTRUCTION PLANS FOR NORTH VALLEY DRAINAGE SYSTEM IMPROVEMENTS

GRIEGOS ROAD SYSTEMS (B&C)



SET NO. _____
JOB NO. 85113

100-1000-00000000 CONSTRUCTION DRAWINGS
Russell B. Lakin 12-21-18 26 24610188

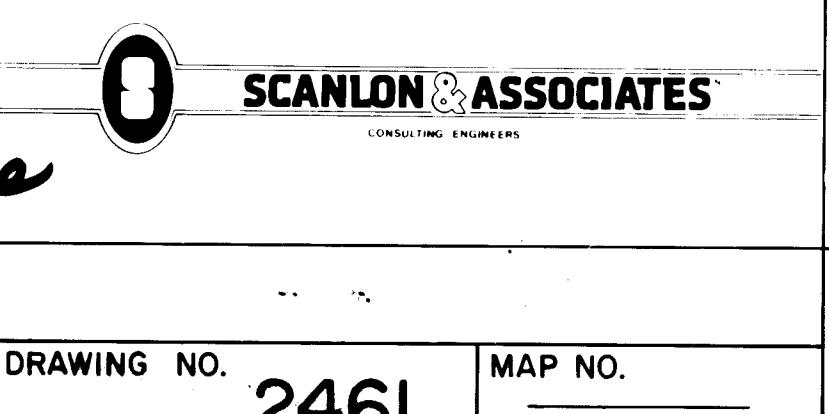REV.	Sheets	City	Engr.	Date	User	Dept.	Date	User	Dept.	Date
APPROVAL OF REVISIONS										
 										
APPROVED FOR CONSTRUCTION 10/28/87 C.E.										
DRAWING NO.	MAP NO.	SHEET <u>1</u> OF <u>21</u>								

GENERAL NOTES


1. The City of Albuquerque Interim Standard Specifications for Public Works Construction, 1985 Edition, and any revisions and or additions in the Specifications and Contract Documents, shall govern the construction of this project.
2. The Contractor shall notify all utility companies when working near their systems. Two days prior to any excavation, Contractor must contact Line Locating Service, 765-1234, for location of existing utilities.
3. All existing utilities shown here were taken as accurately as possible from record drawings and surface indications. It shall be the Contractor's responsibility to protect, maintain in service, and verify exact locations of all affected utilities during construction of this project, including service lines.
4. All utilities which are to be abandoned under this contract shall be plugged with concrete at each end of the portion to be abandoned. Payment for this work will be made on the basis of the contract unit price bid.
5. Curb return radii and street widths are to the face of the curb unless otherwise indicated in the plans.
6. Where removal of existing curb and gutter or sidewalk is required, remove to the nearest joint or saw cut.
7. When abutting new paving to existing, saw cut existing paving on a right angle, or as required by the Project Engineer to remove any broken, raveled, or cracked paving and match the new paving grade to the existing. No separate payment shall be made for saw cut but shall be considered incidental to the Contract Unit Price for pavement removal and replacement.
8. Curb and gutter shown as existing and not to be removed under this contract which is damaged or displaced by the Contractor or his subcontractors, shall be replaced by the Contractor at his expense.
9. Existing materials to be removed and paid for on a unit price basis shall be measured and the quantities approved by the Engineer before removal.
10. Remove all valve boxes from abandoned water lines. Payment will be considered incidental to the contract unit price for pavement removal and replacement.
11. All abandoned valve and meter box frames and covers shall be returned to the Water System Division city yard and all storm and sanitary manhole lids and inlet grates, castings, and frames not reused and in usable condition, shall be returned to the Liquid Waste Division warehouse. There shall be no direct payment for these items. Cost shall be considered incidental to other items of work.
12. No separate payment shall be made for sewer by-pass pumping if required. It shall be considered incidental to sewer line construction.
13. The Contractor shall expose existing water and sewer lines at locations where new storm sewer lines cross or parallel such lines in order to adequately establish the proximity of water and sewer lines. The cost of this work shall be incidental to other items of work.
14. Prior to construction, exploratory excavation may be required as directed by the Project Engineer to more specifically locate utility lines. There will be no direct payment for this item of work. Cost will be considered incidental to other items of work.
15. All water meters, water valve boxes, and sewer manholes in the construction area where street grades change are to be adjusted by the Contractor to finished grade under this contract. The Contractor shall be required to set reference points for locating manholes prior to any grading operation. Measurement and payment for this work shall be considered incidental to the unit price bid for pavement removal and replacement.
16. The Contractor will be responsible to replace at his expense any and all property corners destroyed in the process of construction. All property corners must be set by a Registered Land Surveyor.
17. The Contractor will be required to confine his work within the construction limits and/or right-of-way to preserve existing vegetation and private property. Contractor is not to store equipment or materials in R.O.W. overnight.
18. Public mail boxes within new construction will be relocated to the right-of-way line by the U.S. Post Office. The Contractor shall coordinate relocation of private mail boxes with property owner or resident and the U.S. Post Office. The Contractor shall notify the U.S. Post Office, Delivery and Collection Department, at least 48 hours in advance of construction affecting mailboxes. Cost of this work will be considered incidental to other items.
19. Utility relocation schedules shall be coordinated at the pre-construction conference.
20. Utility relocations required by the construction of this project are to be coordinated by the Contractor during construction. No additional compensation will be allowed for delays or inconveniences caused by utility company work crews. The Contractor may be required to reschedule his activities to allow utility crews to perform their required work.
21. Access to local business and residences shall be kept open at all times. In the event that access closures are unavoidable, closures must be scheduled at least twenty-four (24) hours in advance with property owners and approved by the Engineer. Access closures to business shall not exceed two (2) hours during business hours and for residences shall not exceed eight (8) hours. Alternate access provided if required.
22. All valve box rings and covers shall be painted with blue enamel or epoxy paint. Color shall be equivalent to "Safety Blue".

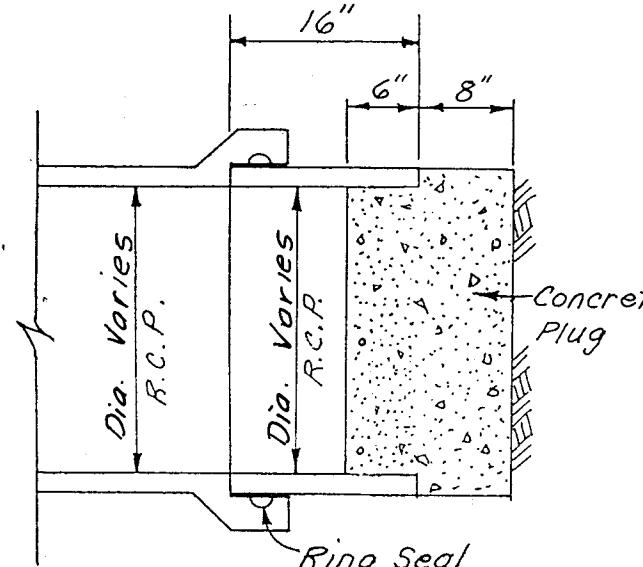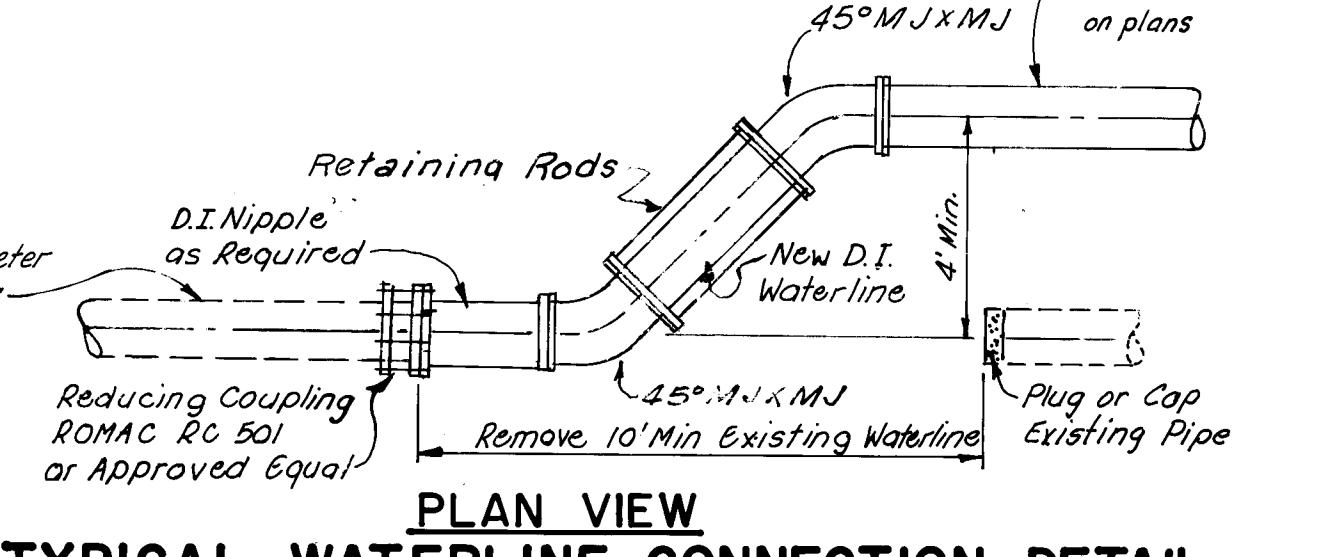

REMOVABLE WATERTIGHT PLUG

Not to Scale

40. Numerous potential conflicts with proposed storm drain facilities and existing gas lines exist. The Contractor will be required to expose gas lines prior to construction as directed by the Engineer, to more specifically identify these conflicts.
41. The Contractor is required to contact the Gas Company at least three (3) days prior to beginning construction in any phase and to coordinate his work with the Gas Company during construction.
42. With regard to gas line relocations during construction, the Contractor will be required to backfill and compact all excavations to the top of subgrade. The Gas Company will provide trenching, backfilling, and compaction for their facilities after subgrade has been prepared.
43. Trench depth shall be measured from bottom of pavement to invert of pipe at centerline of pipe.

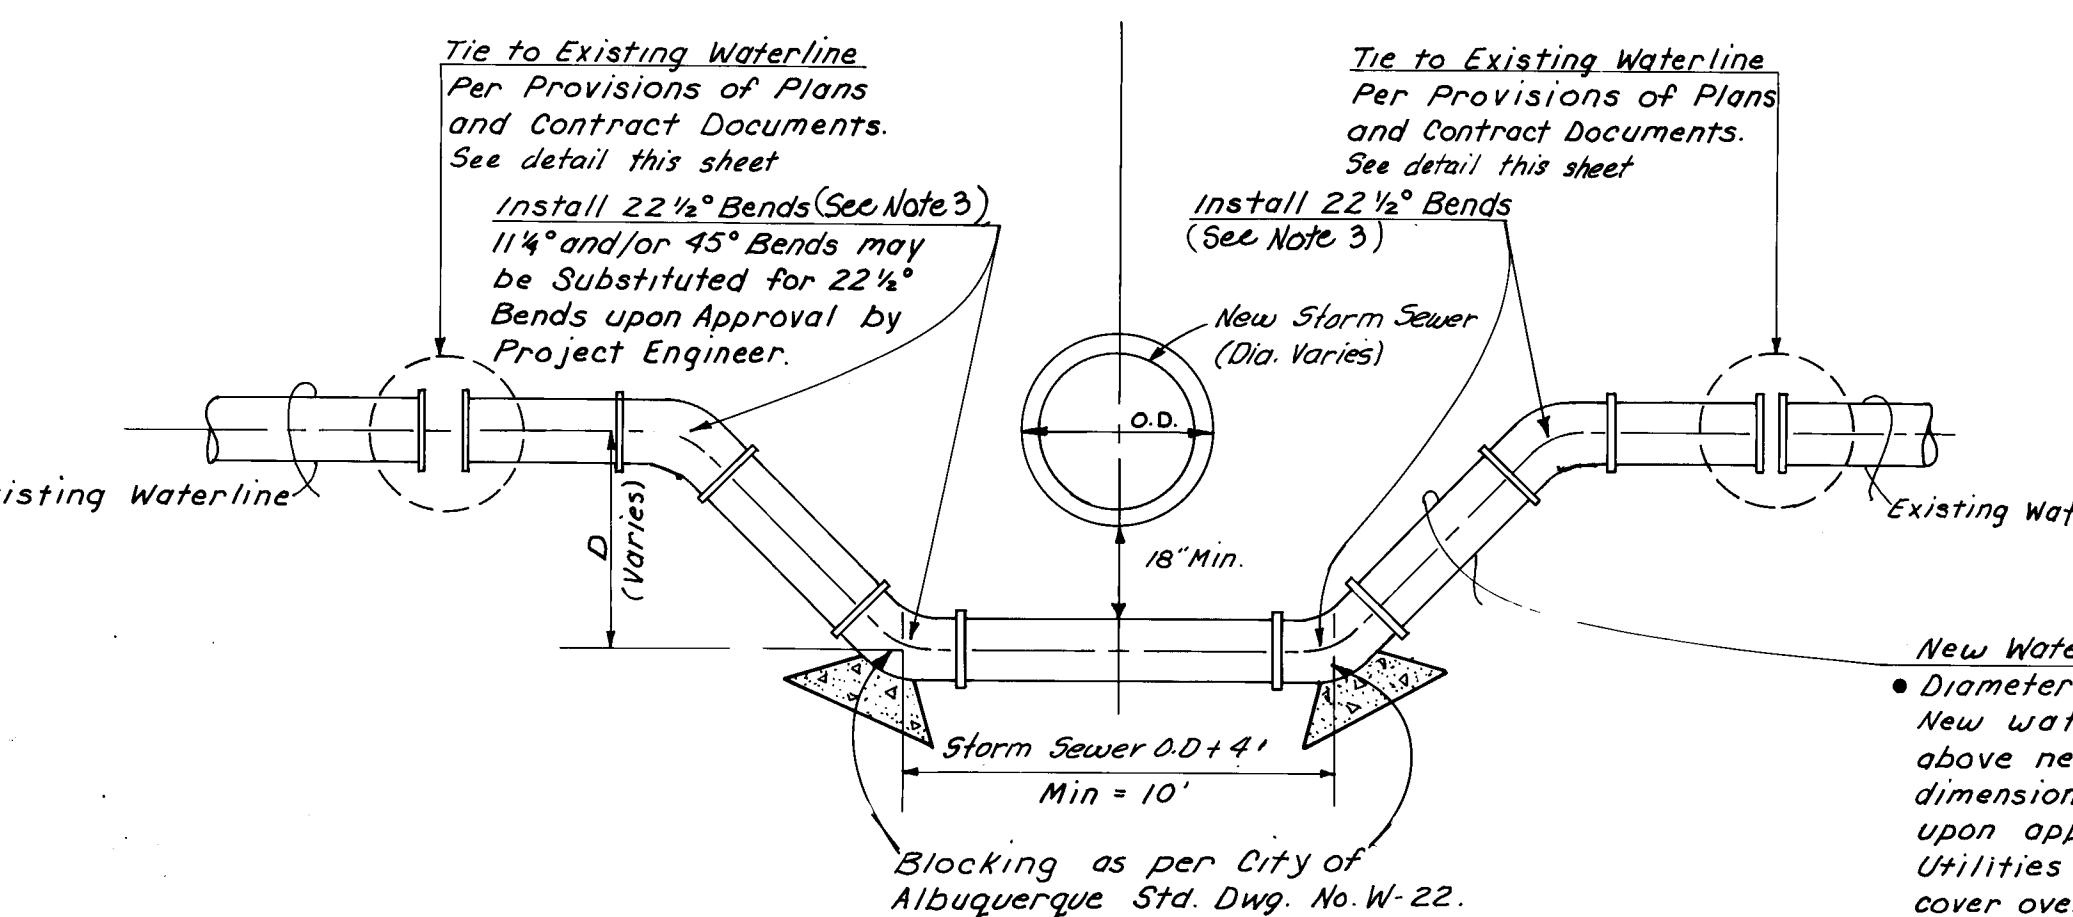


ELEVATION

TYPICAL WATERLINE RELOCATION DETAIL


Not to Scale

- NOTES**
1. Lengths of Waterline Relocation may be extended at direction of Project Engineer until suitable existing material is found to make connection, in some cases maybe, to existing main or valve.
 2. Joints subject to upward thrust shall be installed as Rigid Joints per the Requirements of Section 701.13.3 of the Interim Standard Specifications subject to Approval of the Engineer.

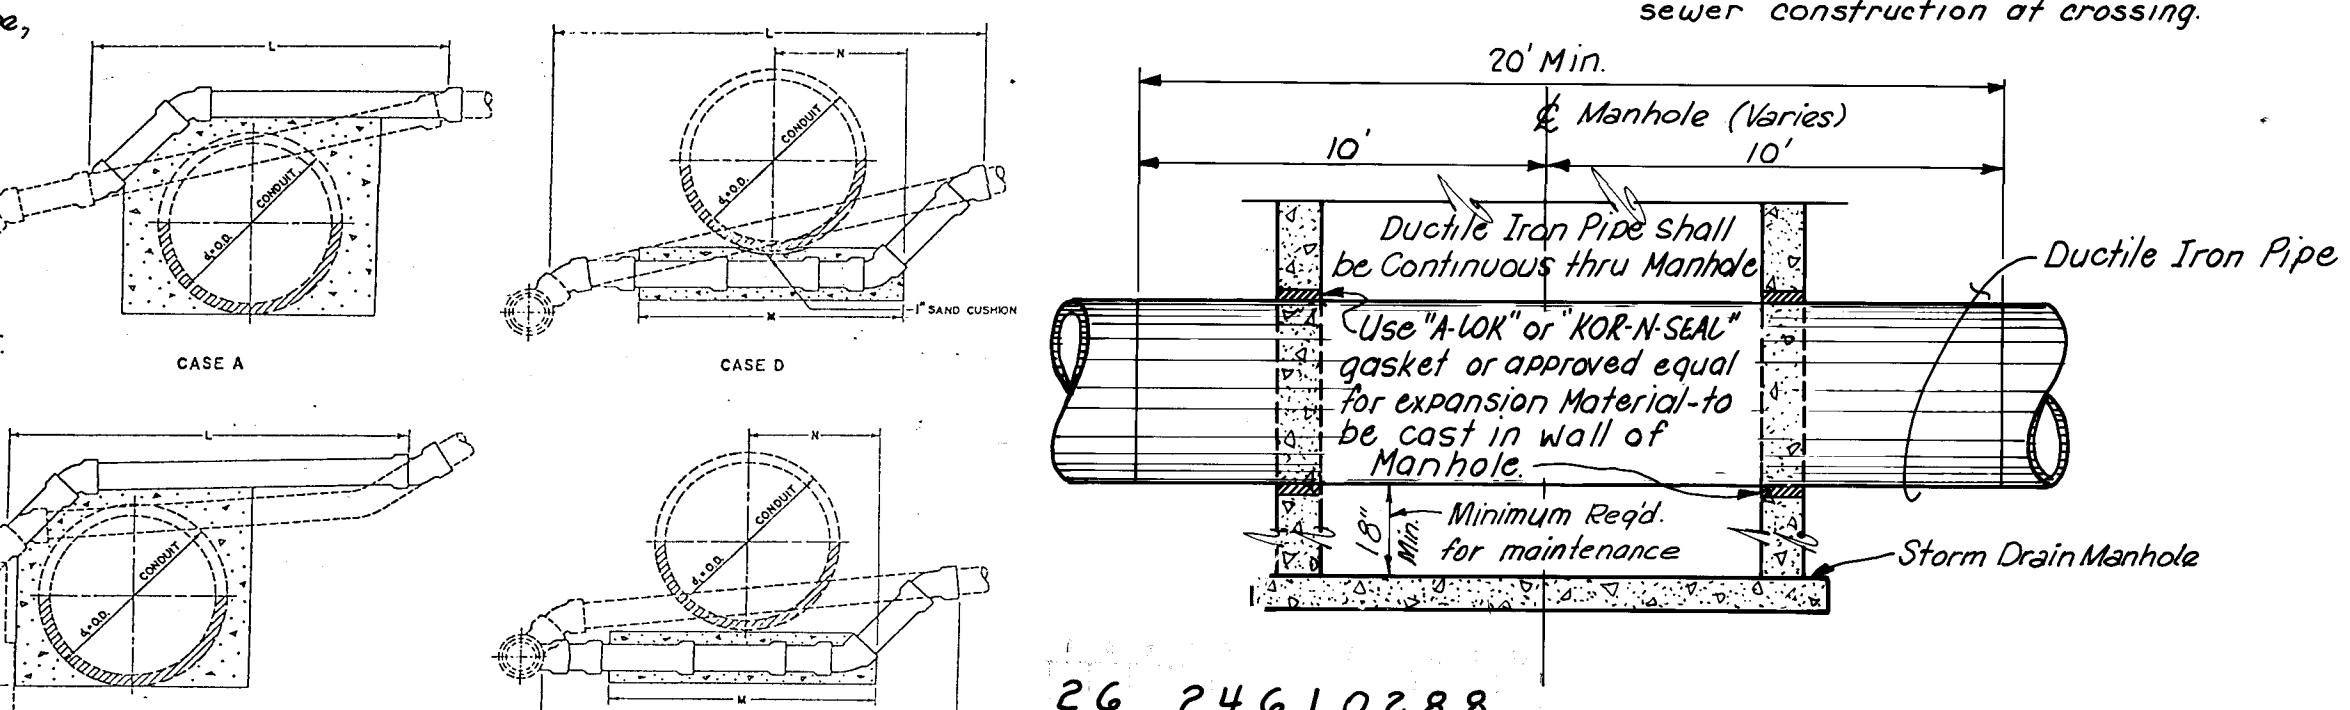

TYPICAL SAS LINE THRU STORM DRAIN MANHOLE

NTS

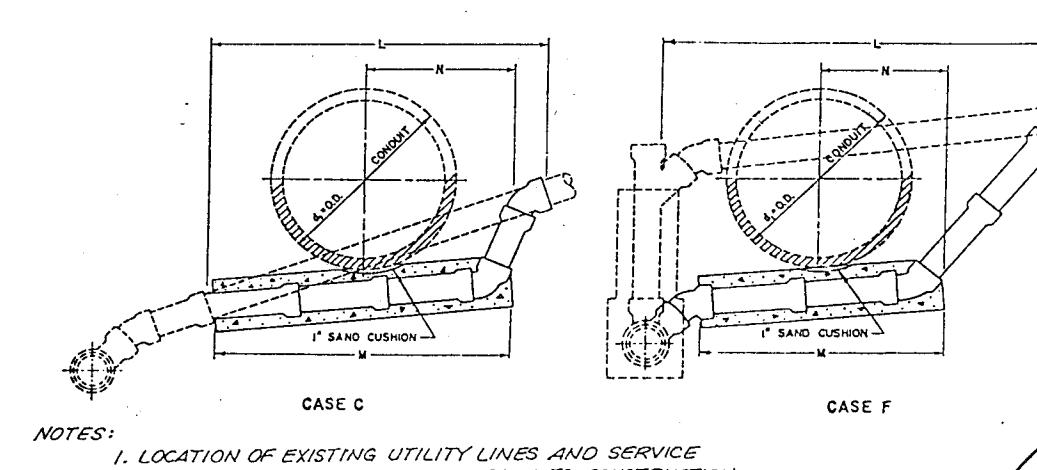


TYPICAL SAS SERVICE LINE RELocation DETAIL

NTS

CITY OF ALBUQUERQUE MUNICIPAL DEVELOPMENT DEPARTMENT ENGINEERING DIVISION					
TITLE: NORTH VALLEY DRAINAGE SYSTEM IMPROVEMENTS GENERAL NOTES AND DETAILS GRIEGOS ROAD SYSTEMS (B&C)					
APPROVALS	ENGINEER	DATE	APPROVALS	ENGINEER	DATE
City Engineer	SCOTT A. VERNINES	10/27/87	Liquid Waste	Albuquerque	10/27/87
A.C.E - Design	SCOTT A. VERNINES	10/27/87	Traffic	Albuquerque	10/27/87
A.C.E - Hydrology	Steve Bobay	9/22/87	Water	Albuquerque	10/27/87
DRAWING NO. 2461		MAP NO.	SHEET OF	2	21

Scanlon Job No. 85113

RECORD DRAWING

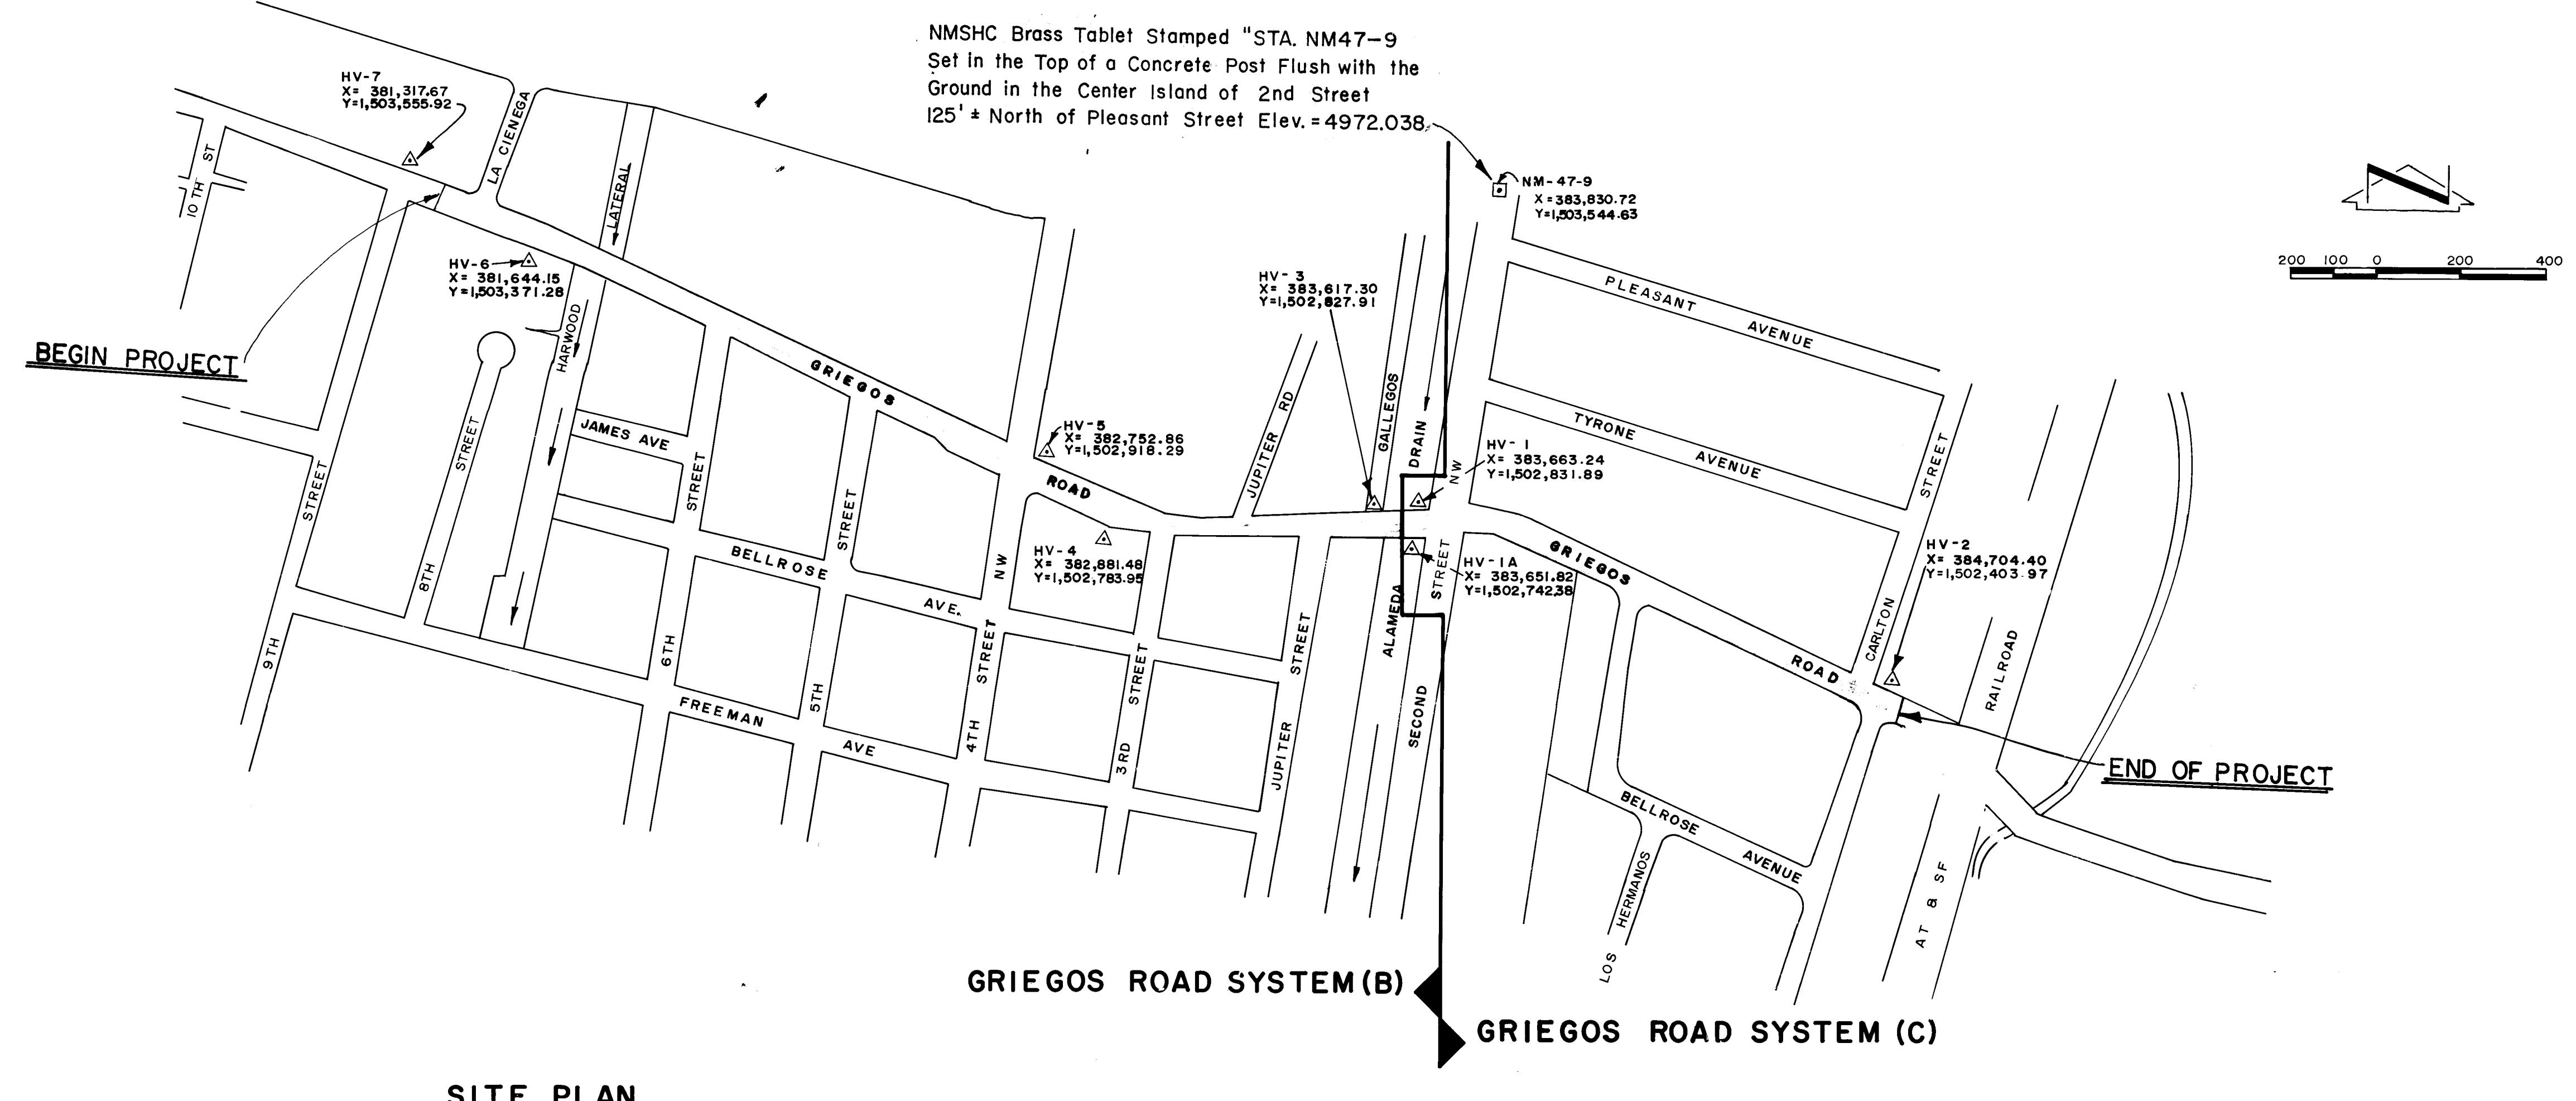

LEGEND

=====	EXISTING CURB AND GUTTER
=====	NEW STANDARD AND MEDIAN CURB AND GUTTER
=====	NEW ASPHALT CURB
=====	EXISTING SIDEWALK
=====	NEW SIDEWALK PATCH
=====	NEW MEDIAN PATCH
=====	PAVEMENT REPLACEMENT PER C.O.A. STD. DWG P-25
○	EXISTING SIGN
○	EXISTING POLE
○○○○	EXISTING CHAIN LINK FENCE
=====	EXISTING BLOCK WALL
—x—x—	EXISTING WIRE FENCE
—x—x—	EXISTING WOOD FENCE
●●●	NEW CHAIN LINK FENCE
△	PI OR CONTROL POINT
— — —	CONSTRUCTION & AND SURVEY &
— — —	R/W LINE
HGL 100.00	ELEVATION OF HYDRAULIC GRADE LINE
Q ₁₀₀ = 10.0	FLOW RATE C.F.S. 100 YEAR-6 HOUR RUNOFF
V ₁₀₀ = 5.0	VELOCITY (FT./SEC) 100 YEAR-6 HOUR RUNOFF


SITE PLAN

TRAFFIC CONTROL NOTES

- All traffic control devices, and their placement, shall comply with Chapter VI of the 1978 Edition MANUAL FOR UNIFORM TRAFFIC CONTROL DEVICES.
- The Contractor shall prepare and submit to the Project Engineer a detailed detour plan, which must be approved by the City Traffic Engineer three (3) working days in advance of any required lane closures.
- All signs must be installed before construction begins as directed by the Project Engineer. Sign heights shall be 7 ft. from the bottom of the sign to the sidewalk level.
- All drums or barrels may have sand or water ballast limited to 100 lbs.
- All sign locations will be selected in the field and approved by the City Traffic Engineer or Project Engineer. Distances may be adjusted for local conditions.
- All signs will be ground mounted on single or double posts. Existing posts may be used at some locations, with the approval of the Project Engineer. Portable sign supports will be acceptable as an alternate.
- All signs will be moved forward as the construction progresses, as determined appropriate by the Project Engineer.
- Construction equipment and materials shall not be stored within the roadway or on the median during non-work hours.
- When barriers are required after dark, all advance warning signs and all barricades shall be equipped with flashing warning lights (Type A), except that all channelizing devices shall have steady burning warning lights (Type C).
- All existing regulatory signs and signals that need to be removed, relocated or reinstalled shall be done by the City of Albuquerque Traffic Engineering Division. The Contractor shall notify the Traffic Engineering Division three (3) working days in advance of any required work.
- Exact locations of relocated traffic signal foundations shall be determined by the Traffic Engineering Division.
- The Contractor shall provide and maintain a safe and adequate means of channelizing pedestrian traffic around all work areas throughout the period of construction. All such channelization shall be arranged to prevent pedestrians from having to enter an open traffic lane in order to pass around the work areas.
- All construction signing shall be black on a reflectorized orange field unless otherwise specified. All construction barricades and channelization devices shall be orange on white, reflectorized, unless otherwise specified.
- The Contractor shall prepare and submit to the Project Engineer a detailed project phasing plan at the pre-construction conference for approval prior to beginning construction.

26 24610388

CITY OF ALBUQUERQUE MUNICIPAL DEVELOPMENT DEPARTMENT ENGINEERING DIVISION					
TITLE: GRIEGOS ROAD SYSTEM SITE PLAN					
LEGEND & TRAFFIC CONTROL NOTES					
APPROVALS	ENGINEER	DATE	APPROVALS	ENGINEER	DATE
City Engineer	<i>[Signature]</i>	10/27/87	Liquid Waste	<i>[Signature]</i>	10/27/87
A.C.E.-Design	<i>[Signature]</i>	10/27/87	Traffic	<i>[Signature]</i>	10/27/87
A.C.E.-Hydrology	<i>[Signature]</i>	10/27/87	Water	<i>[Signature]</i>	10/27/87
DRAWING NO.	2461	MAP NO. F14, G14	SHEET OF 3 21		

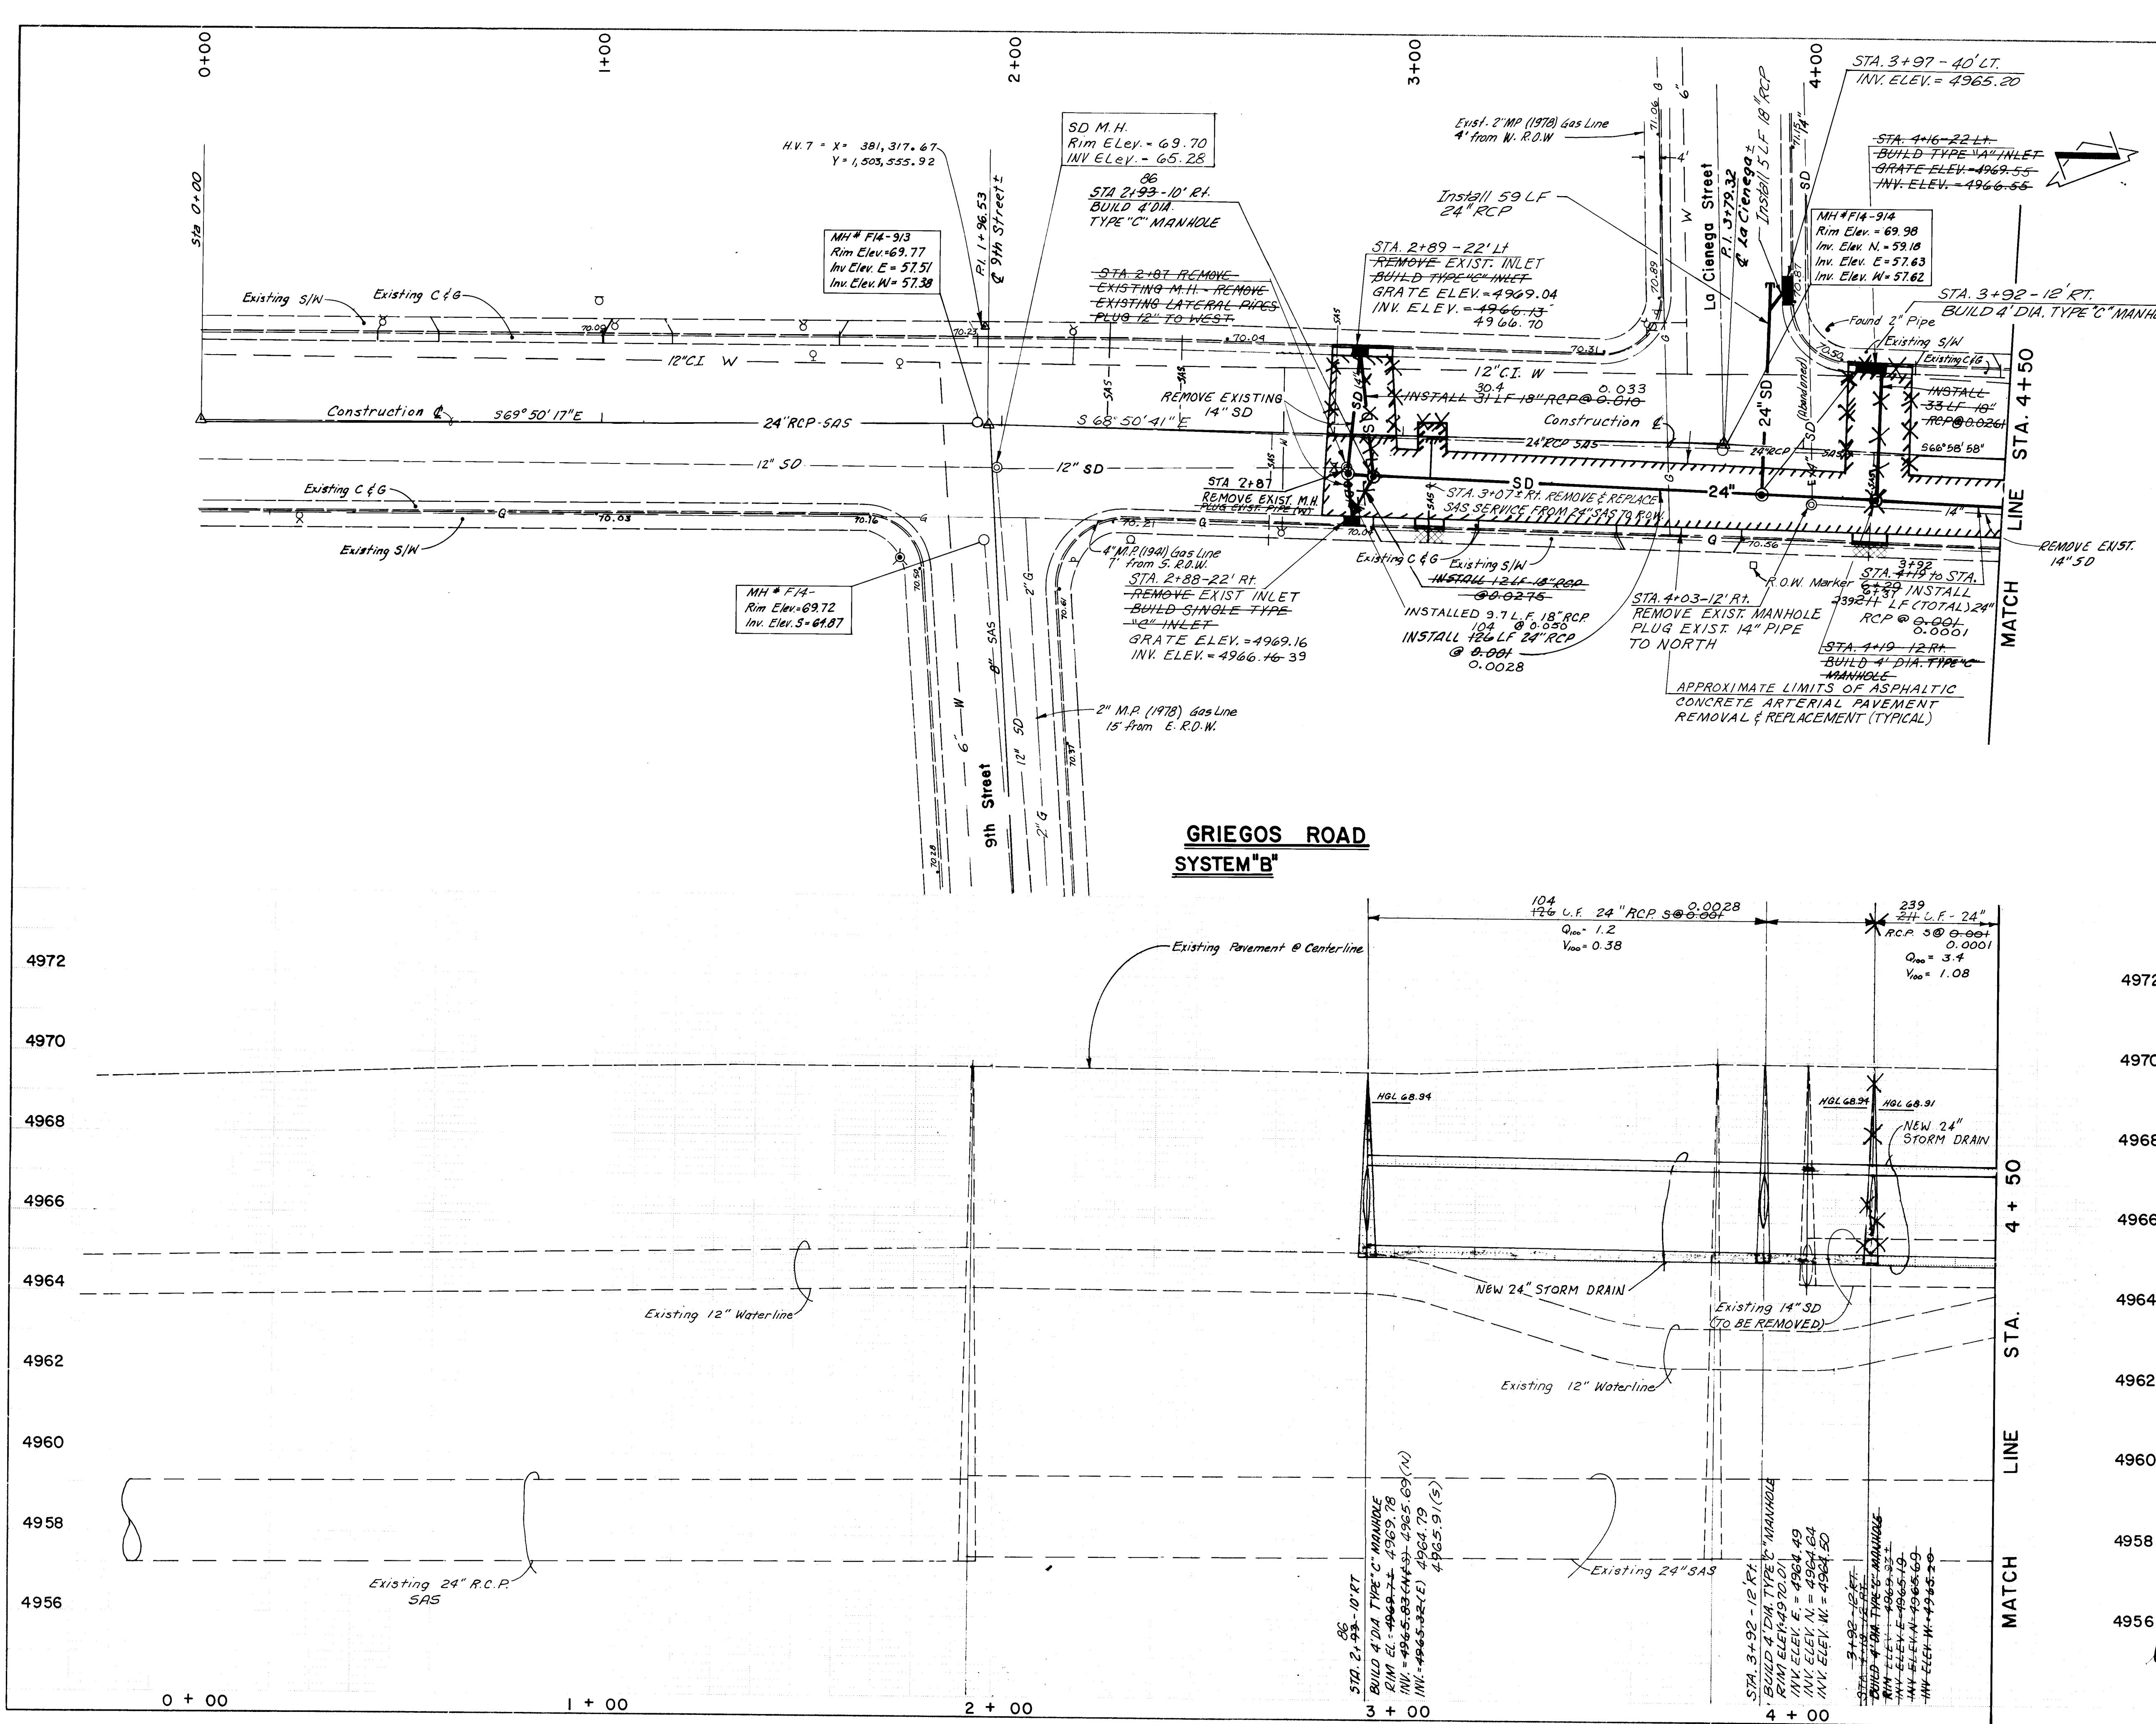

NOTES

1. All spot elevations shown are at existing top of curb unless otherwise noted.
 2. All R.C.P. shall conform to ASTM C-76. See General Notes for pipe class.
 3. It will be the responsibility of the contractor to support all gas main and service lines where they are within the area of excavation

ENGINEER'S SEAL		SURVEY INFORMATION		BENCH MARKS		AS BUILT INFORMATION	
				NMSHC Brass Tablet Stamped "STA. NM47-9"		CONTRACTOR New Concepts, Inc.	
NO.	DATE	FIELD NOTES BY	DATE	WORK STAKED BY	Scanlon & Associates	DATE	11-88
				INSPECTORS			
REMARKS	DATE	REVISIONS	DATE	ACCEPTANCE BY	FIELD	DATE	DATE
					DRAWINGS	Scanlon &	11-88
DESIGN	BY	VERIFICATION BY	DATE	CORRECTED BY ASSOCIATES			
DESIGNED BY	S.A.V.	DATE	FEB 86				
DRAWN BY	C.L.W.	DATE	FEB 86				
CHECKED BY		DATE					
ALBUQUERQUE MUNICIPAL GOVERNMENT DEPARTMENT OF PUBLIC WORKS WATER SYSTEM IMPROVEMENTS MANHATTAN ROAD SYSTEM (B) SECTION 2+88 TO 4+50							
APPROVALS		ENGINEER		DATE			
Waste	Water	W. H. Hensler	R. C.	10/17/87			
Traffic				10/22/87			
Water				10/17/87			
NO.	SHEET	OF		4	21		
- 14							

24610488

CALES
ORIZONTAL 1" = 20'
VERTICAL 1" = 20'

**CITY OF ALBUQUERQUE
MUNICIPAL DEVELOPMENT DEPARTMENT
ENGINEERING DIVISION**

**NORTH VALLEY DRAINAGE SYSTEM IMPROVEMENTS
GRIEGOS ROAD SYSTEM (B)
STORM DRAIN - STATION 2+88 TO 4+50**

AL'S	ENGINEER	DATE	APPROVALS	ENGINEER	DATE
	/ / /	1/1/68	✓ ✓ ✓	/ / /	1/1/68

Engineer	John H.	10/27/87	Liquid Waste	Wimmer	10/27/87
Design	" "	"	Traffic	RL	10/27/87
Hydrology	Steve Bobberg	10/22/87	Water	Wimmer	10/27/87


NG 2461 MAP NO. F - 14 SHEET 4 OF 21

on Job No. 85113

NOTES

- All spot elevations shown are existing top of curb unless otherwise noted.
- All RCP shall conform to ASTM C-76. See General Notes for pipe class.
- It will be the responsibility of the contractor to support oil/gas main and service lines where they are within the area of excavation.
- Remove and Replace Existing SAS Service Lines at Sta. 4+635', 4+931', 5+262', 6+042', 7+285', 7+985' and 8+835' from R.O.M. Line to Existing 24" SAS.
- Remove and Replace Existing Water Service Lines at Sta. 5+605', 8+455' and 8+725' from Main to Meter.



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INSPECTOR DATE	
ACCIDENTAL BY DATE	
DRAWING BY Scanlon & Associates DATE	
CORRECTED BY Scanlon & Associates DATE	
MICRO-FILM INFORMATION	
RECORDED BY NO	
BENCH MARK	
NMSHC Brass Tablet Stamped "STA. NM47-9"	
Set in the Top of a Concrete Post Flush with the Street by Scanlon & Associates Inc. 11-88	
INSPECTOR DATE	
ACCIDENTAL BY DATE	
DRAWING BY Scanlon & Associates DATE	
CORRECTED BY Scanlon & Associates DATE	
MICRO-FILM INFORMATION	
RECORDED BY NO	
SURVEY INFORMATION	
FIELD NO. 5	
DATE	
A. Pipeline as Shown on Plans	
B. 2" No. 4 Bars, Cont. with 3" Clearance	
C. No. 4 Bars, at 36" O.C. with 2" Clearance at Bottom Ends.	
HARWOOD LATERAL CONCRETE ENCASEMENT DETAIL	
ENGINEER'S SEAL	
VERNESES LLOWS PROFESSIONAL	
SCALES HORIZONTAL 1" = 20' VERTICAL 1" = 10'	
DESIGN DATE FEB 26'	
DRAWN BY C.L.W. DATE FEB 26'	
CHECKED BY DATE	
REVISIONS	
NO DATE	
REMARKS	
BY	

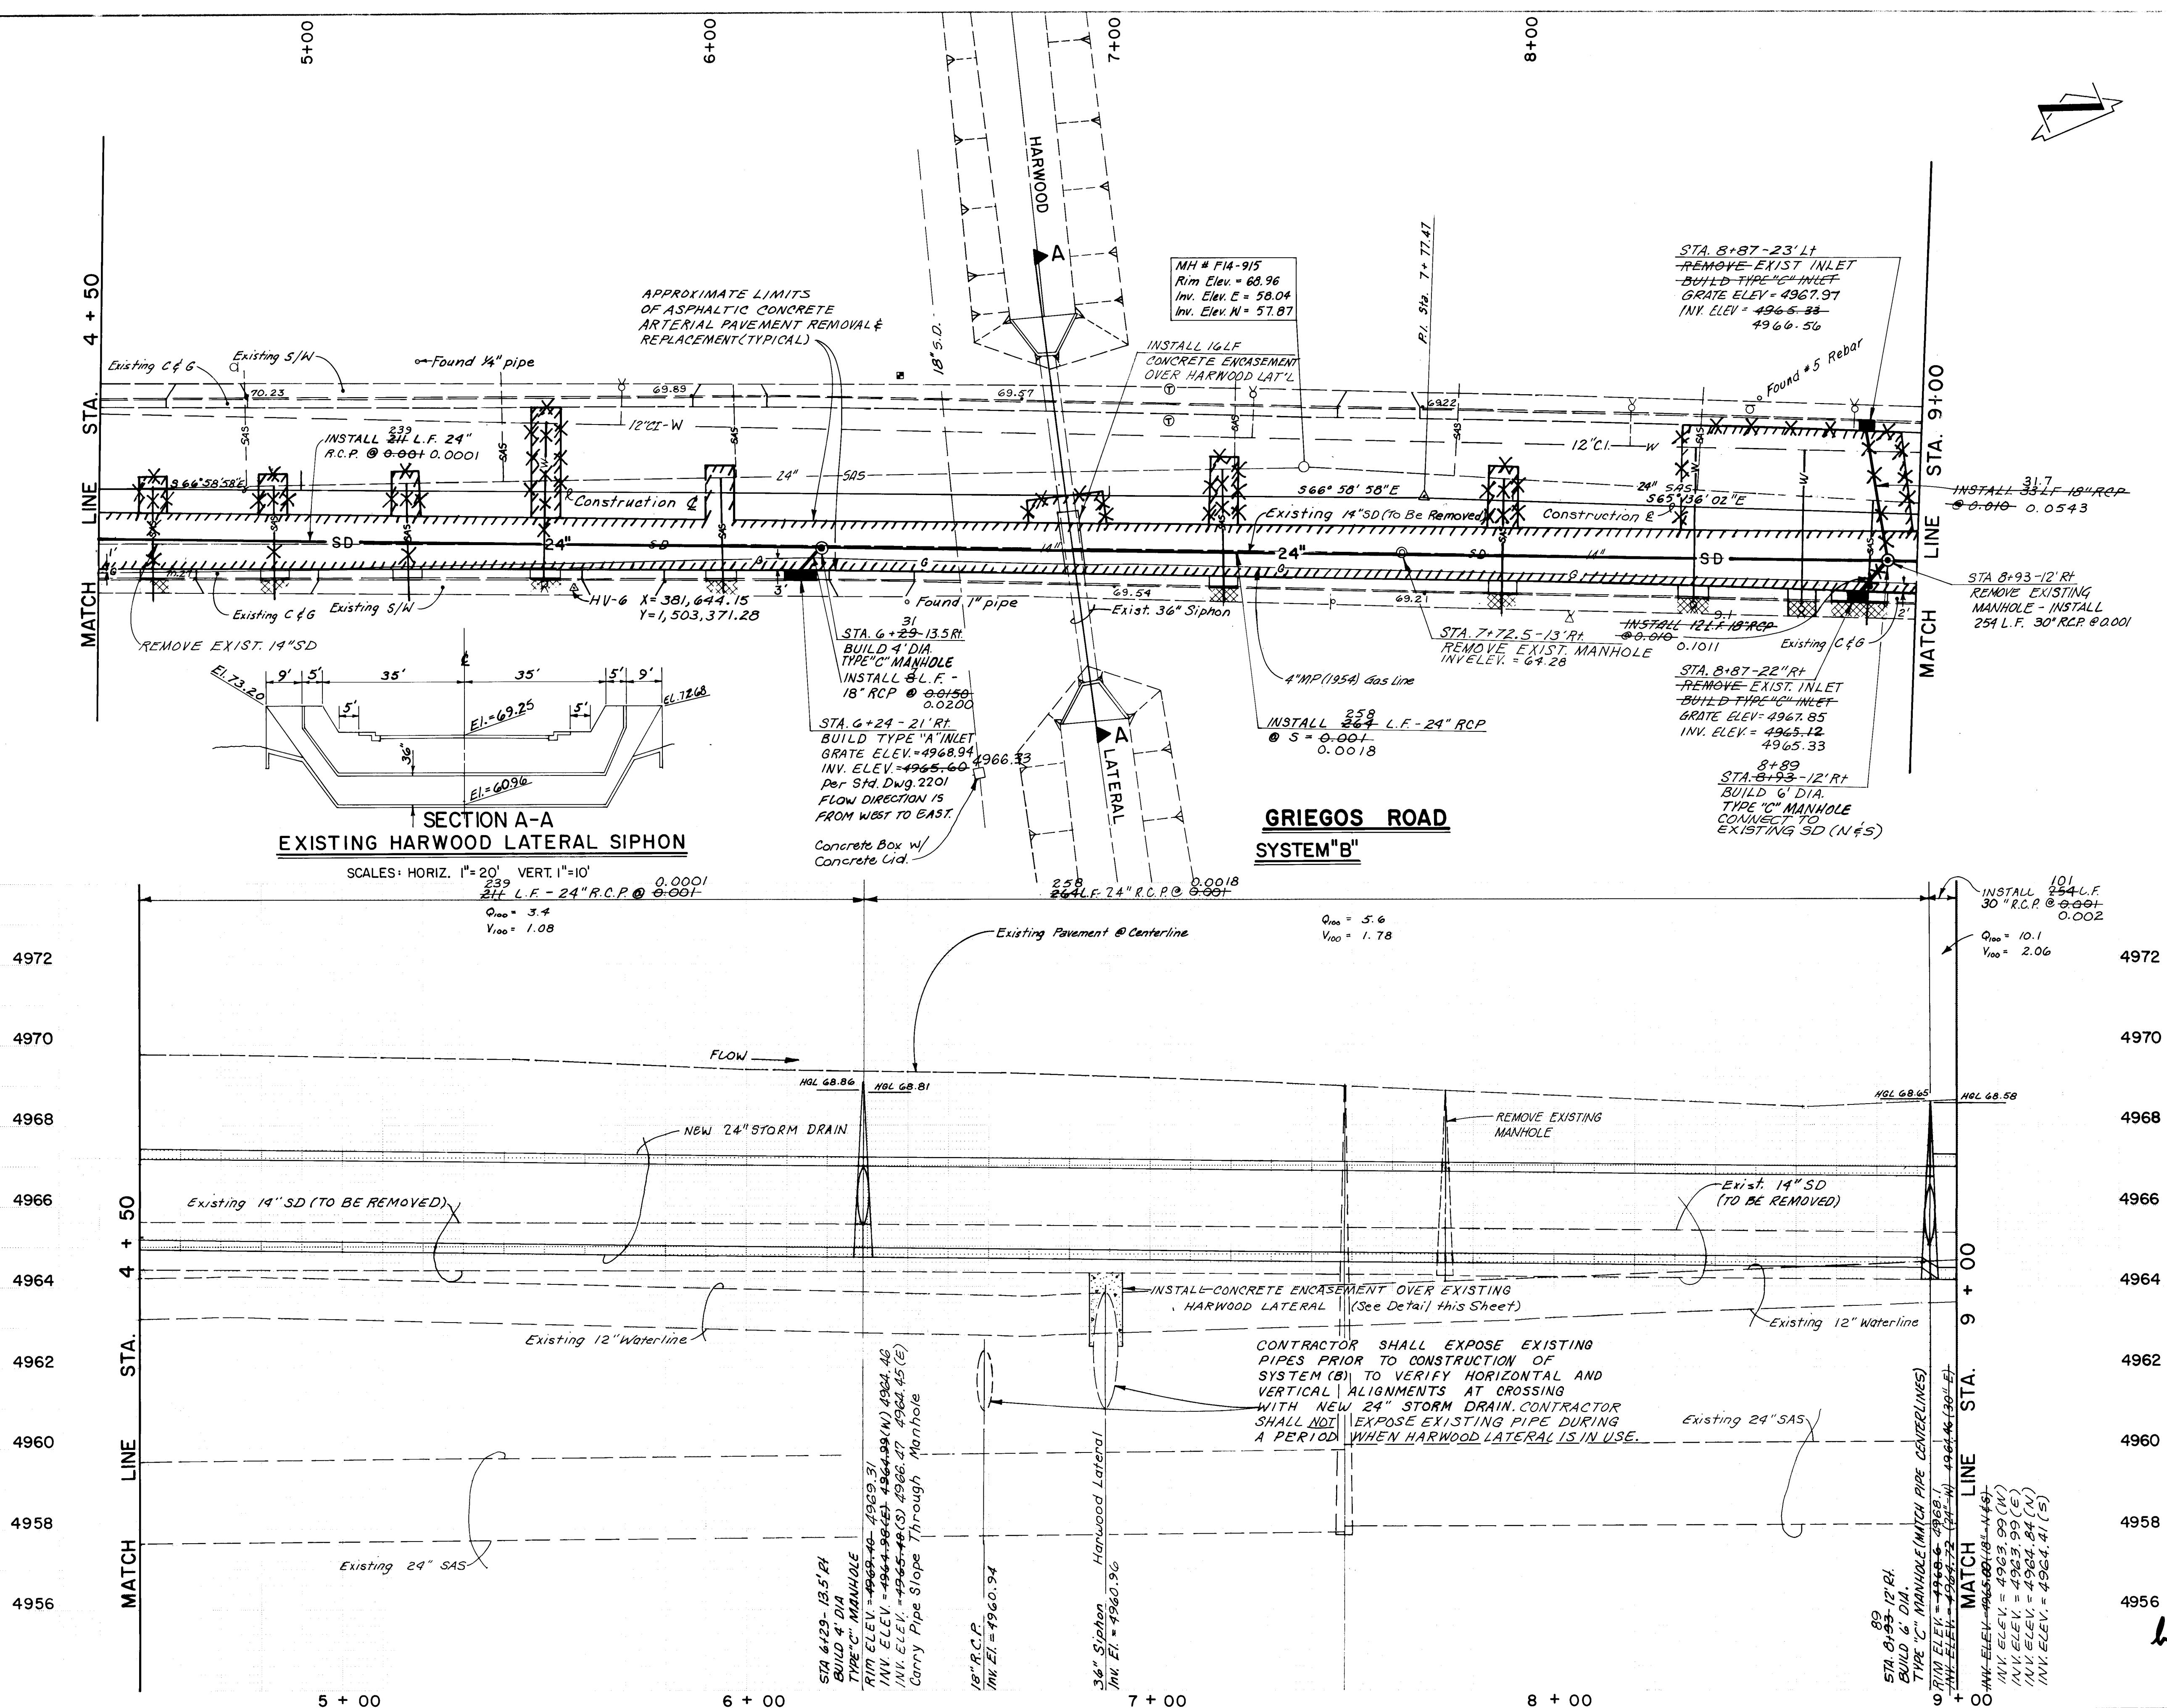

CITY OF ALBUQUERQUE MUNICIPAL DEVELOPMENT DEPARTMENT ENGINEERING DIVISION					
TITLE NORTH VALLEY DRAINAGE SYSTEM IMPROVEMENTS GRIEGOS ROAD SYSTEM (B) STORM DRAIN - STATION 4+50 TO 9+00					
APPROVALS	ENGINEER	DATE	APPROVALS	ENGINEER	DATE
City Engineer	<i>[Signature]</i>	10/27/87	Liquid Waste	<i>[Signature]</i>	10/27/87
ACE - Design			Traffic	<i>[Signature]</i>	10/27/87
ACE - Hydrology	<i>[Signature]</i>	Steve Bailey 10/22/87	Water	<i>[Signature]</i>	10/27/87
DRAWING NO.	MAP NO.	SHEET OF			
2461	F - 14	5 21			

Scanlon Job No. 85113

RECORD DRAWING

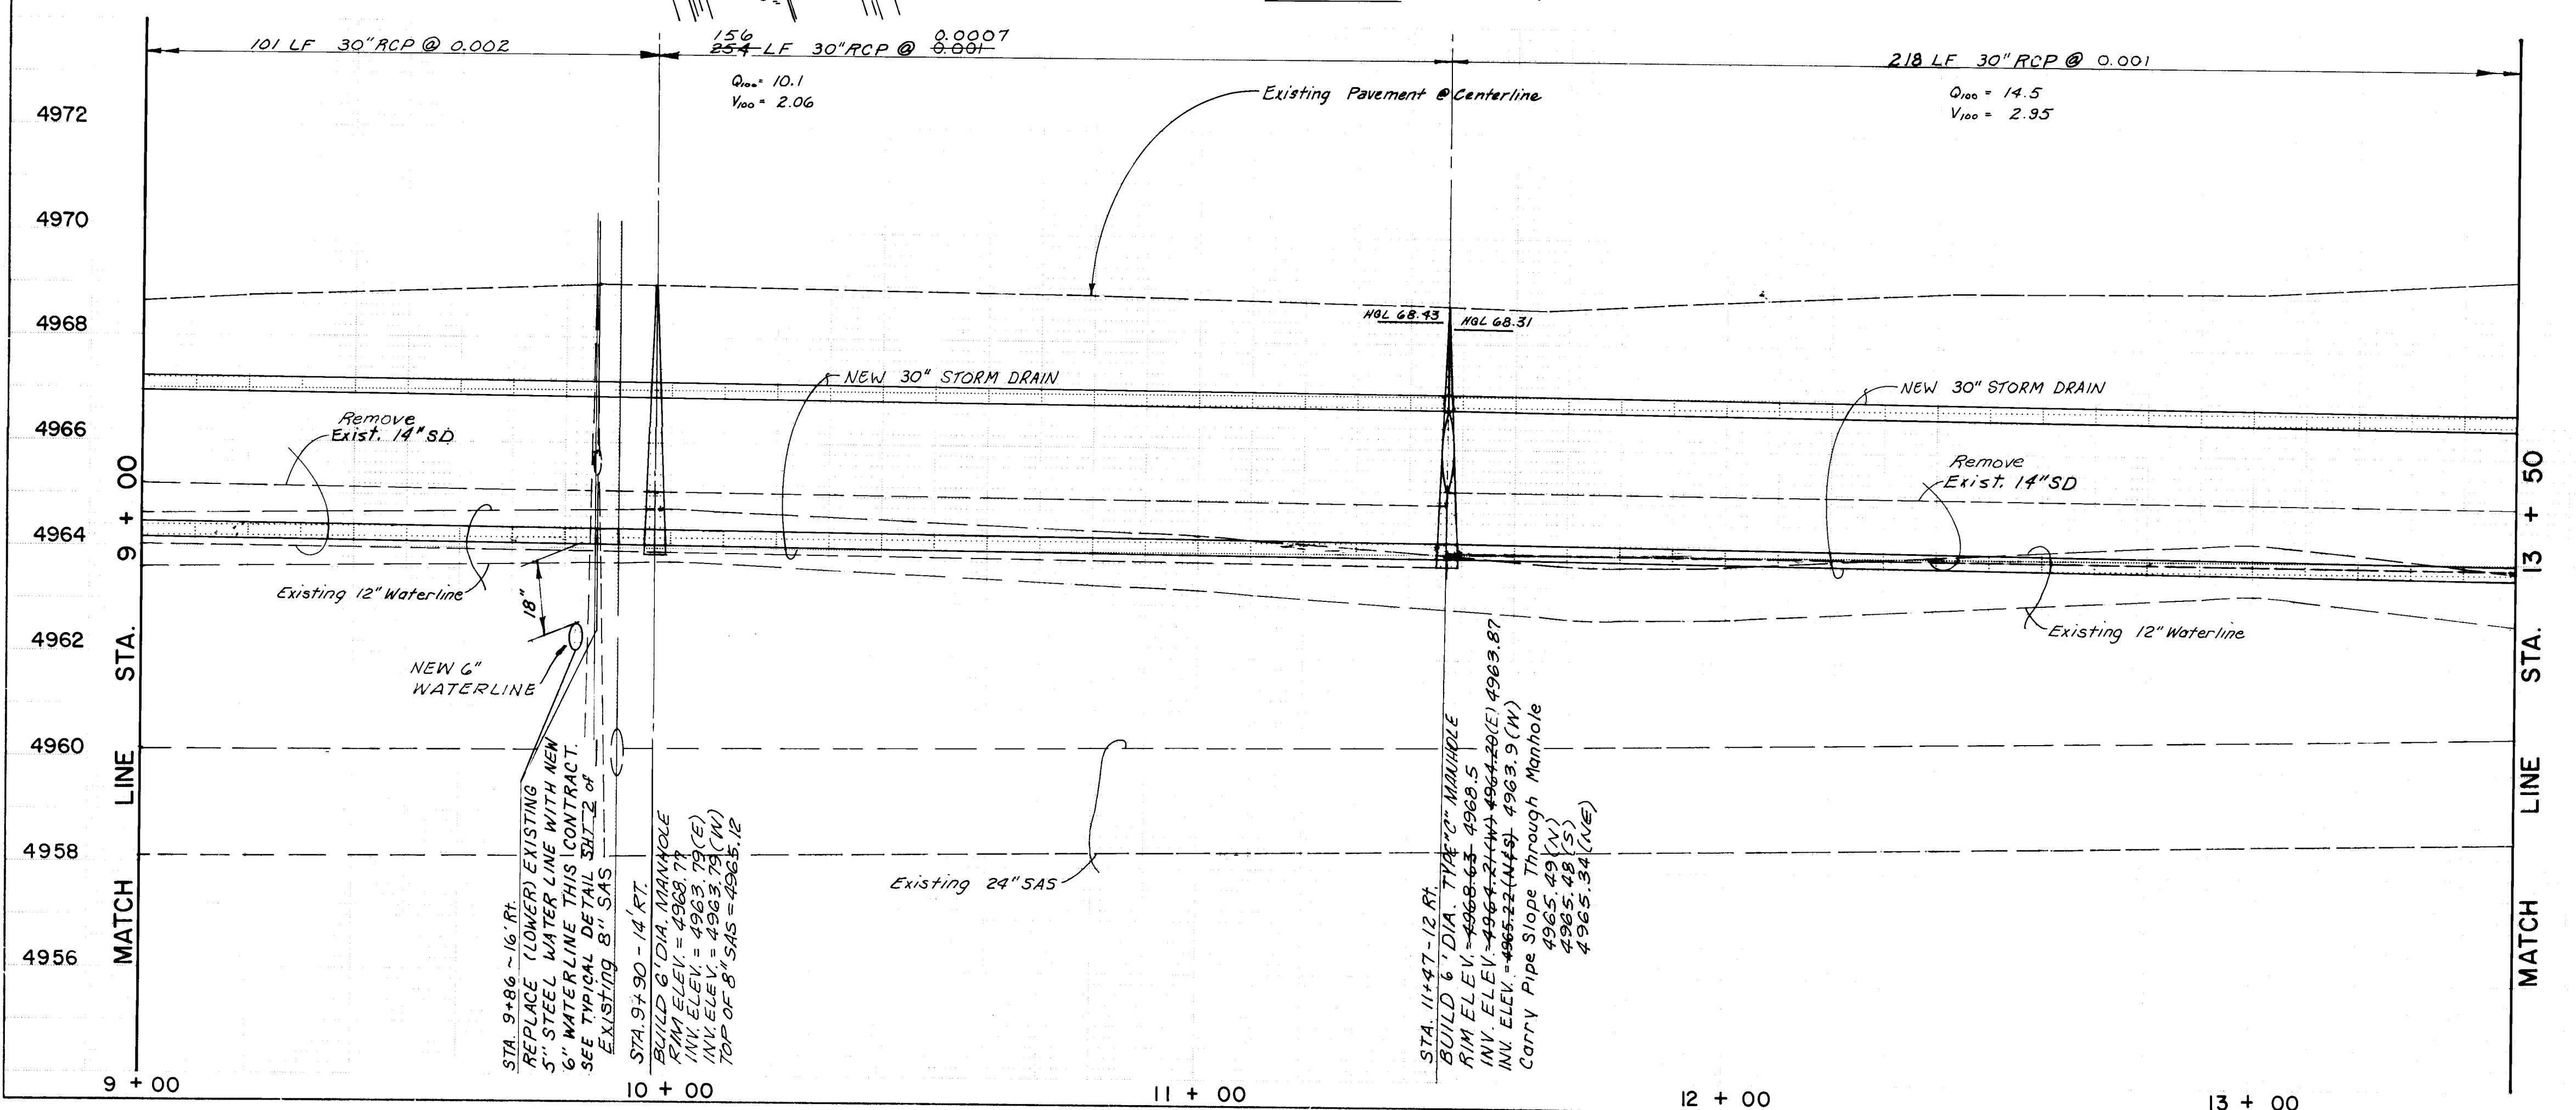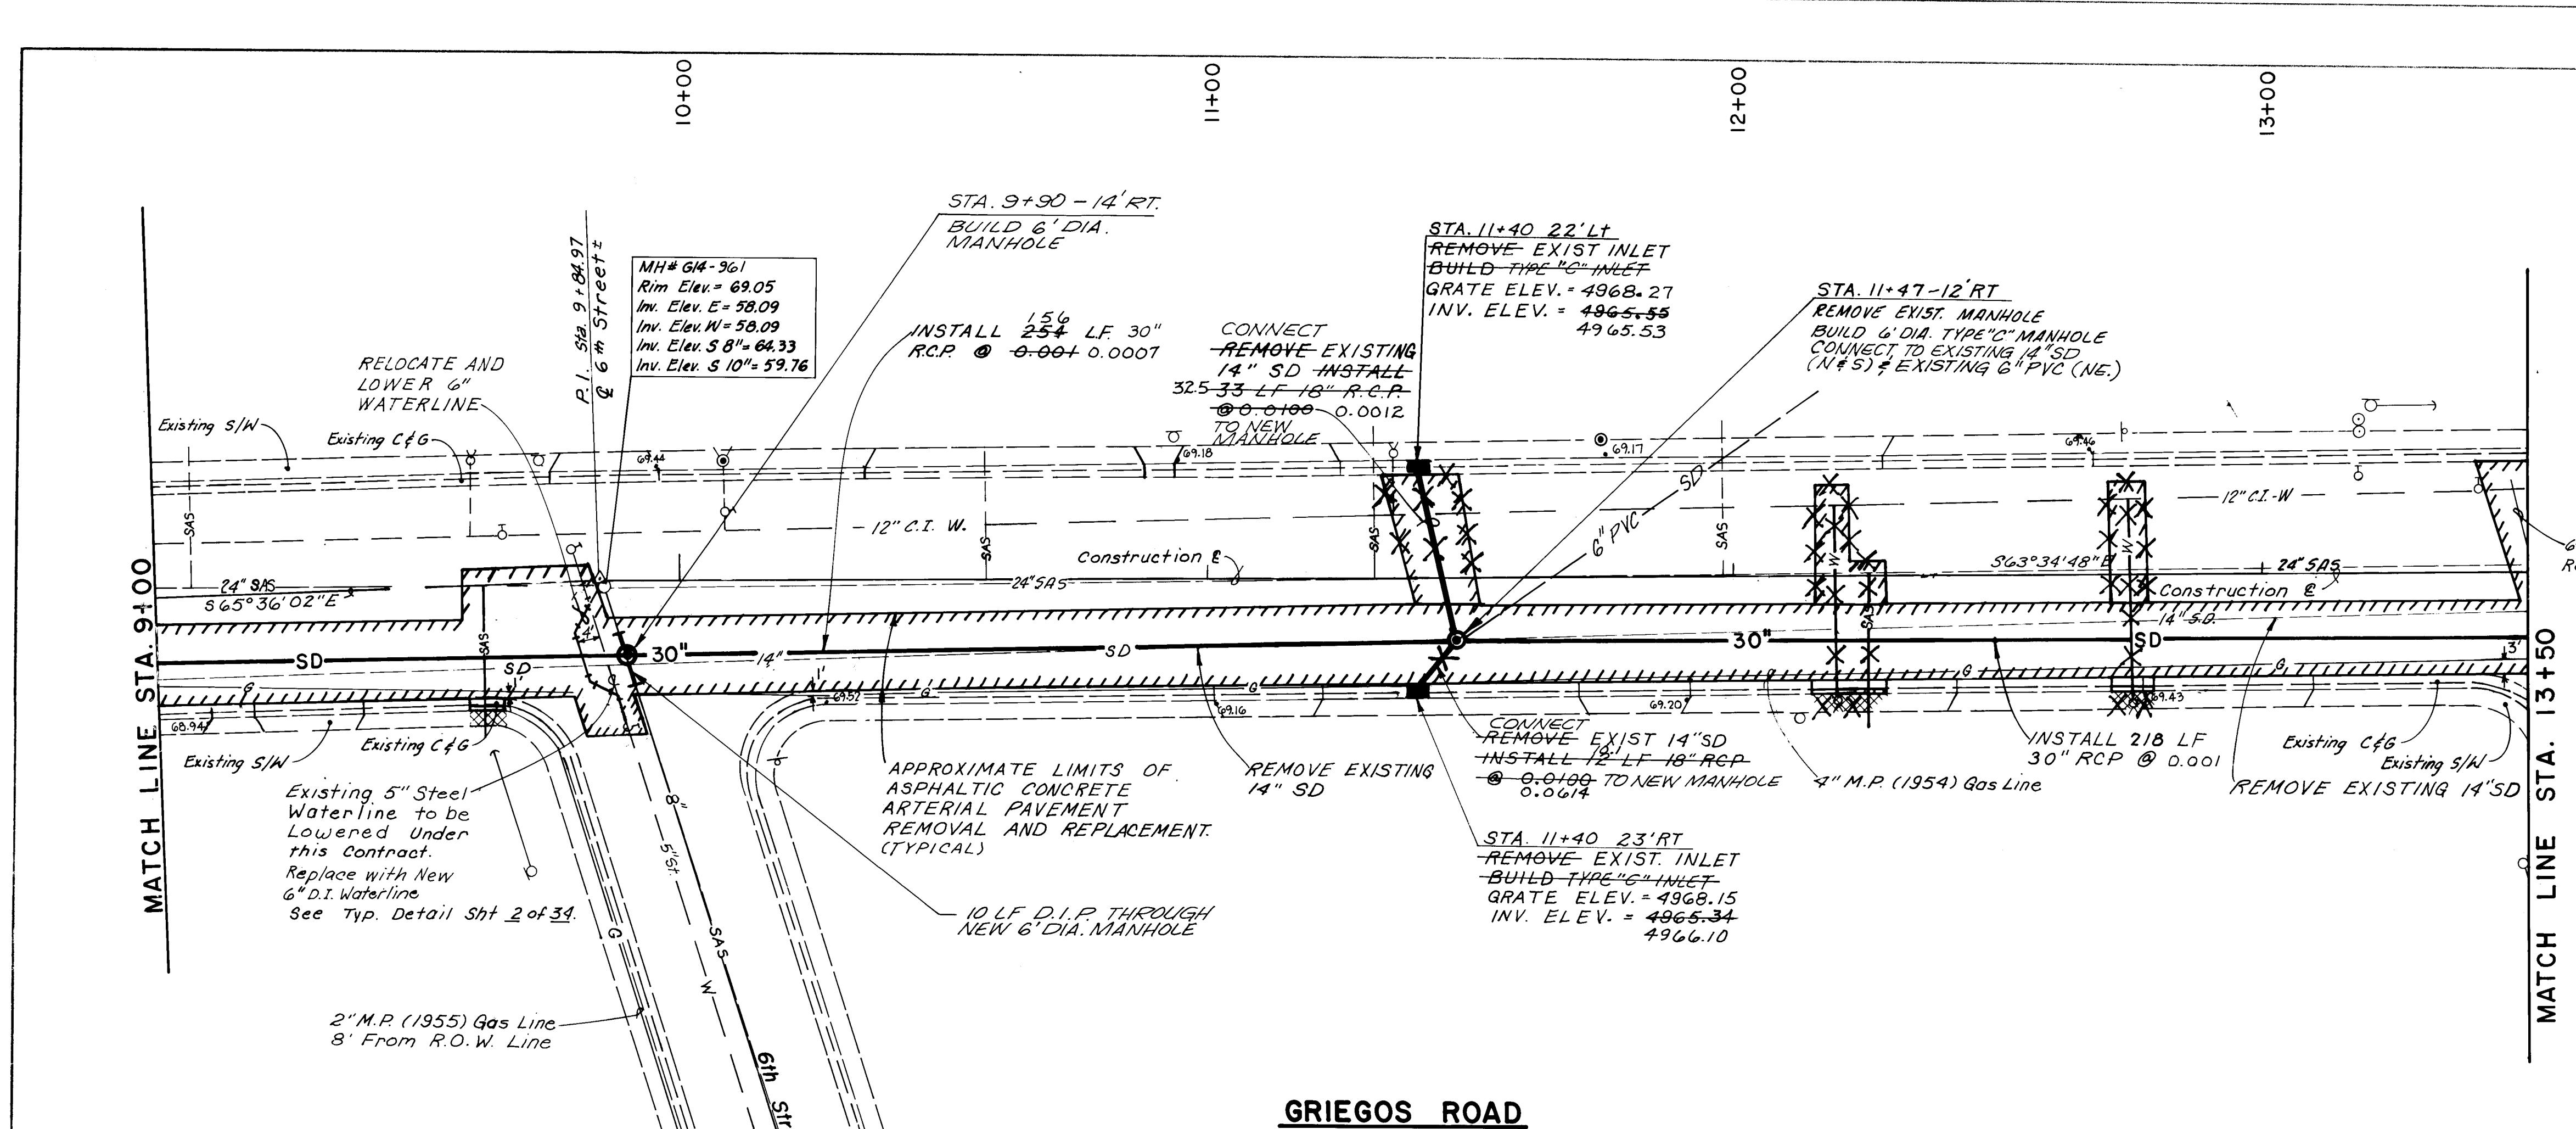

NO.	BY	FIELD NOTES	SURVEY INFORMATION
4958	REVISIONS	BY	REVISIONS
4956	DESIGN	DATE: 1/25/88	DESIGN
4960	DRAWN BY	DATE: 1/25/88	DRAWN BY
4962	C.L.W.	DATE: 1/25/88	C.L.W.
4964	CHECKED BY	DATE: 1/25/88	CHECKED BY
4966	APPROVED	DATE: 1/25/88	APPROVED
4968	APPROVED	DATE: 1/25/88	APPROVED
4970	APPROVED	DATE: 1/25/88	APPROVED
4972	APPROVED	DATE: 1/25/88	APPROVED

CITY OF ALBUQUERQUE MUNICIPAL DEVELOPMENT DEPARTMENT ENGINEERING DIVISION

TITLE NORTH VALLEY DRAINAGE SYSTEM IMPROVEMENTS GRIEGOS ROAD SYSTEM (B) STORM DRAIN - STATION 9+00 TO 13+50

APPROVALS

City Engineer	Engineer	Date	APPROVALS	Engineer	Date
A.C.E. Design			Liquid Waste	Albuquerque	10/26/87
A.C.E. Hydrology			Traffic	PC	10/26/87
Steve Bailey (10/26/87)			Water	Albuquerque	10/26/87

SCALES


HORIZONTAL 1" = 20'
VERTICAL 1" = 2'

REMARKS

26 24610688

DRAWING NO. 2461 **MAP NO.** G-14 **SHEET OF** 6 21

RECORD DRAWING

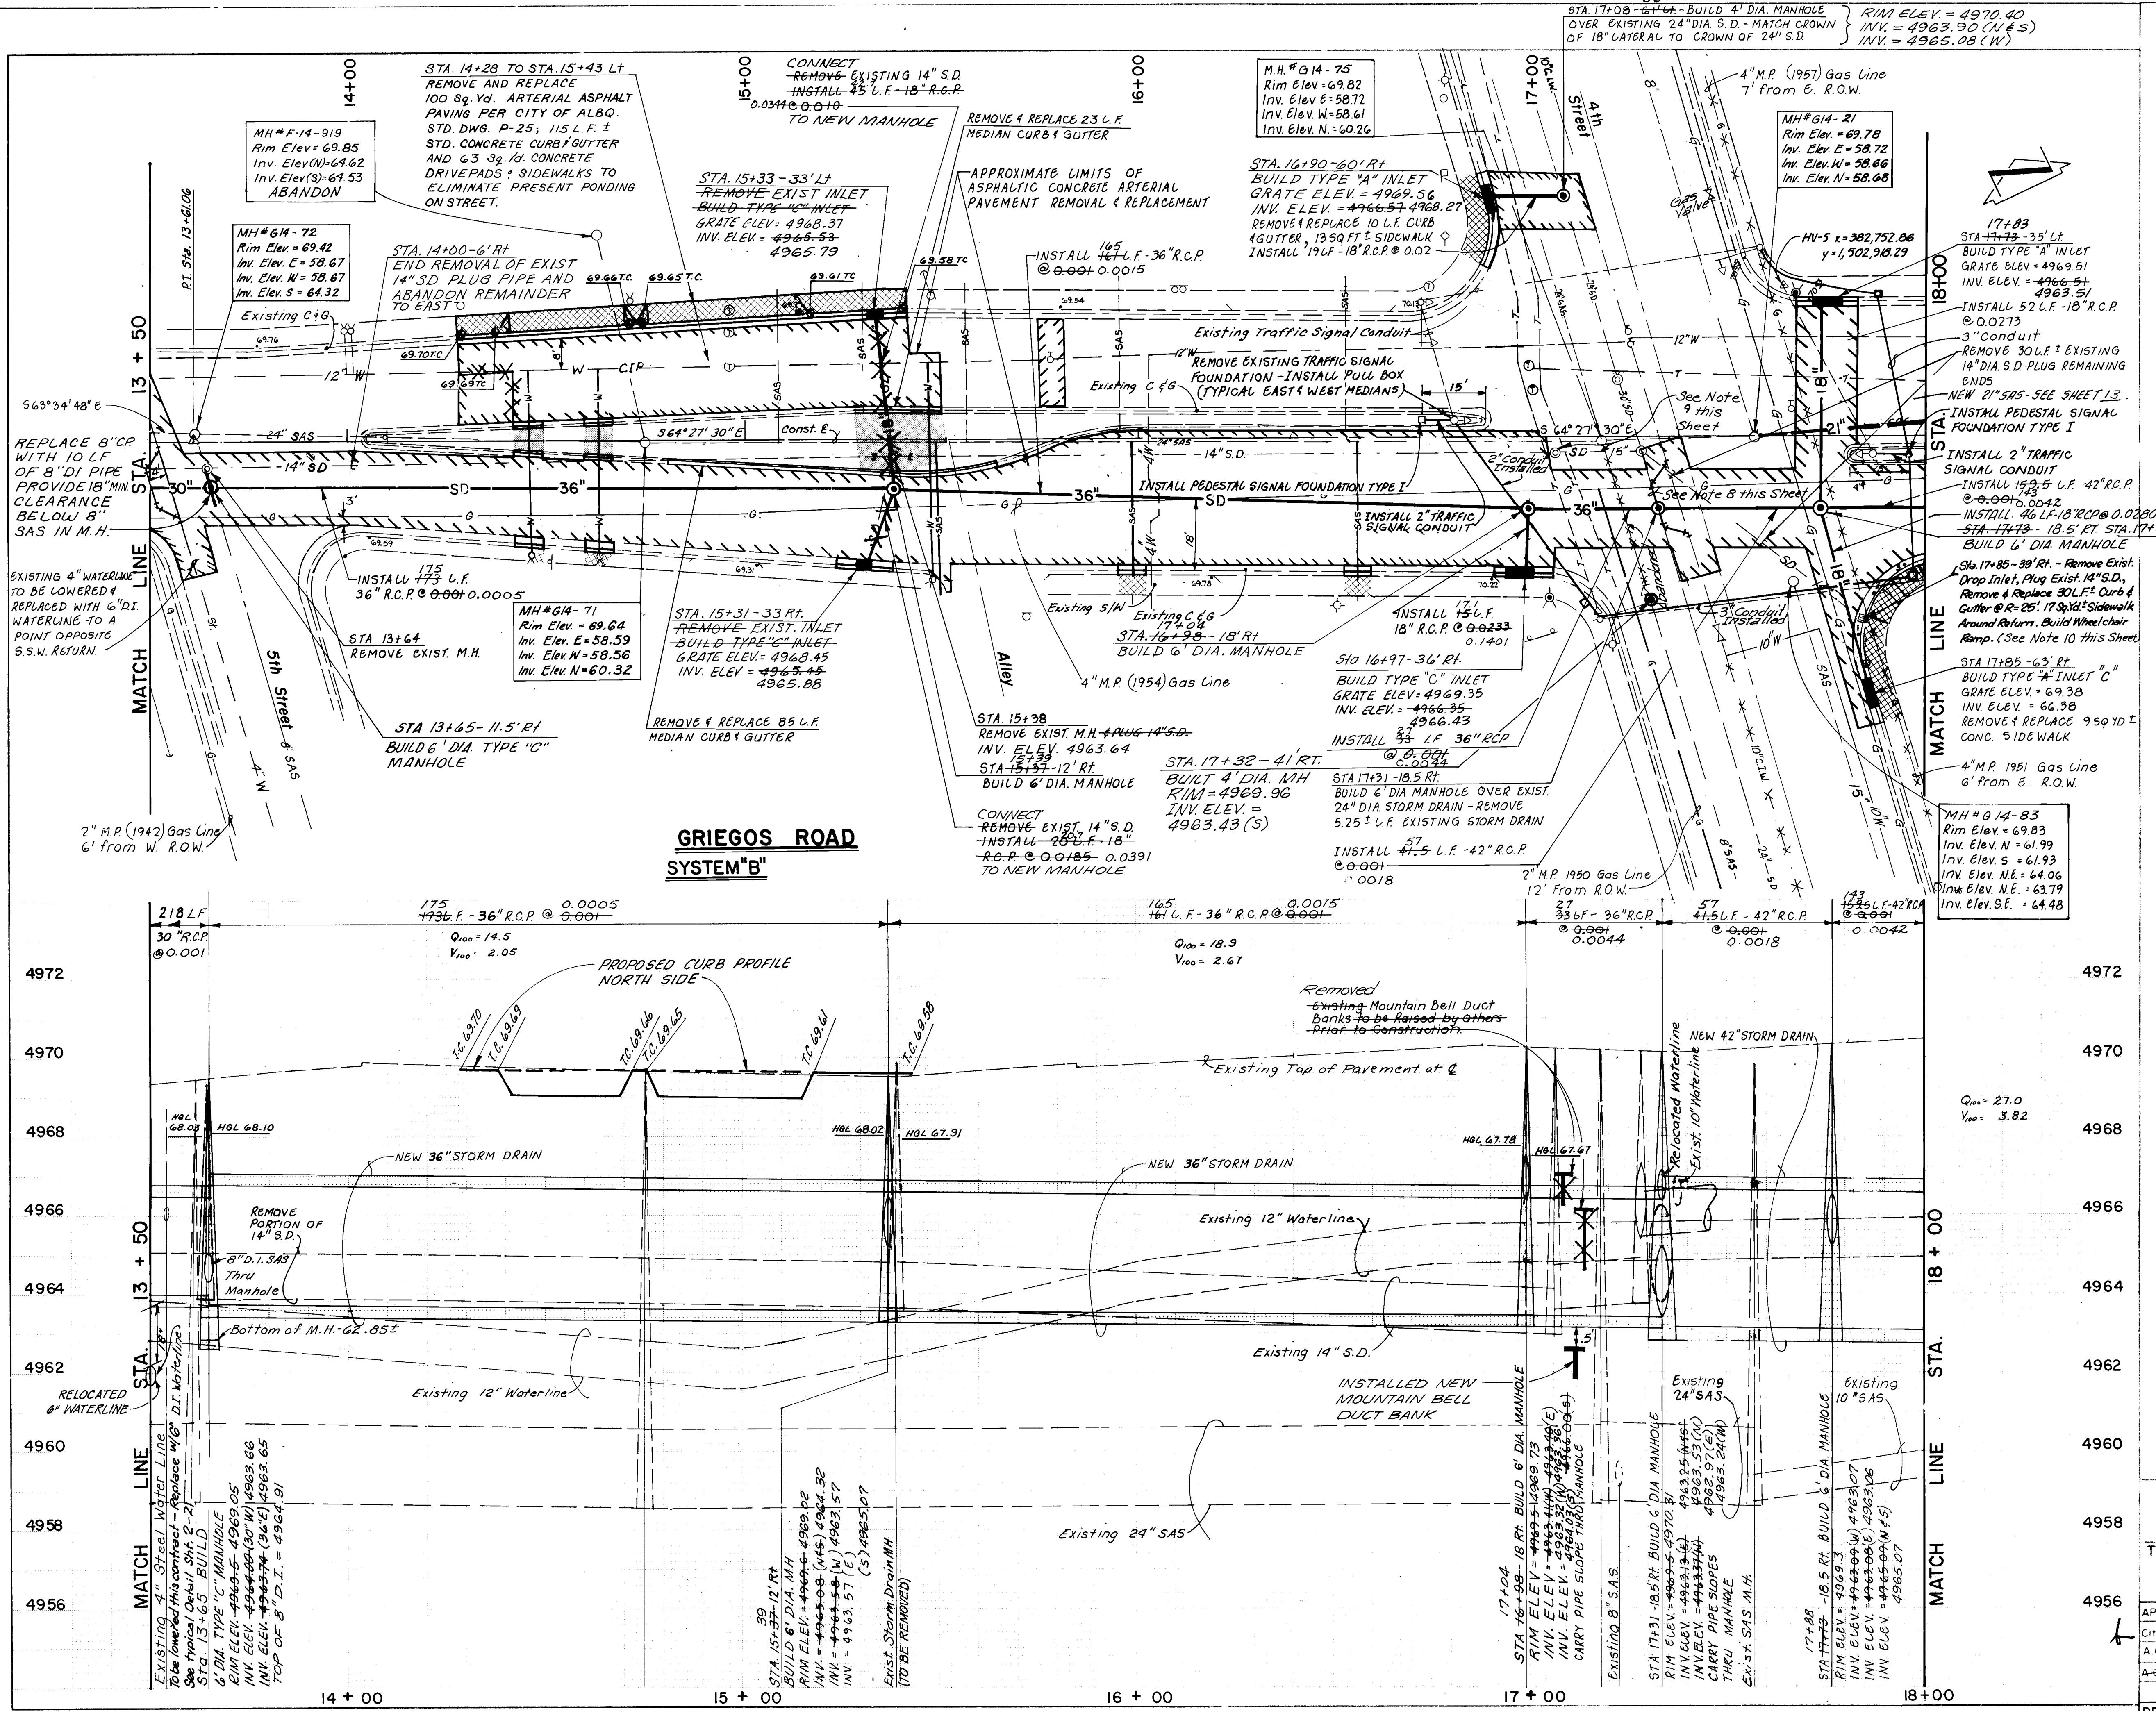

NOTES

1. All spot elevations shown are at existing top of curb unless otherwise noted.

2. All Reinforced Concrete Storm Drain Pipe shall conform to ASTM C-16. See General Notes for Pipe Class

3. It will be the responsibility of the Contractor to support all gas Main and Service Lines where they are within the area of excavation.

4. When crossing existing signal conduit replace from median to curb line.

5. Contractor shall excavate to locate Existing 12" Waterline Prior to Construction of 18" Laterals at Stations 16+95 to 17+16. Loft Inverts may be adjusted at Inlets and Manholes based on Field Conditions encountered at direction of Project Engineer.

6. Remove and Replace Existing SAS Service Lines at Sta. 15+48, 15+58, and 16+56 from R.O.W. Line to Existing 24"SAS.

7. Remove and Replace Existing Water Service Lines at Sta. 14+40, 14+64, and 15+47 from Main to Meter.

8. Relocate Existing 10" Waterline through New Storm Drain Manhole, 16+10. Ductile Iron Waterline continuous through Manhole. Provide 3" Minimum cover on Waterline.

10" Waterline Lowered below S.D. -

9. Abandon Existing SD Manhole and 15" Storm Drain between Manholes. Plug ends of Pipe Inside Manholes.

10. Contractor shall Set Reference Stakes Prior to Removal of Existing Curb to Maintain current Radius when Replaced.

PT	R.ELEV.
1	4969.44
2	4969.50
3	4969.56

CITY OF ALBUQUERQUE
MUNICIPAL DEVELOPMENT DEPARTMENT
ENGINEERING DIVISION

TITLE NORTH VALLEY DRAINAGE SYSTEM IMPROVEMENTS
GRIEGOS ROAD SYSTEM(B)


STORM DRAIN - STATION 13+50 TO 18+00

APPROVALS	ENGINEER	DATE	APPROVALS	ENGINEER	DATE
City Engineer	A.H.	1/27/07	Liquid Waste	M. Hernandez	1/27/07
A.C.E. Design	"	"	Traffic	"	1/27/07
A.C.E. Hydrology	S. B. Bolding	1/22/07	Water	M. Hernandez	1/27/07

DRAWING NO. 2461 MAP NO. G-14 SHEET 7 OF 21

Scanton Job No. 85113


RECORD DRAWING

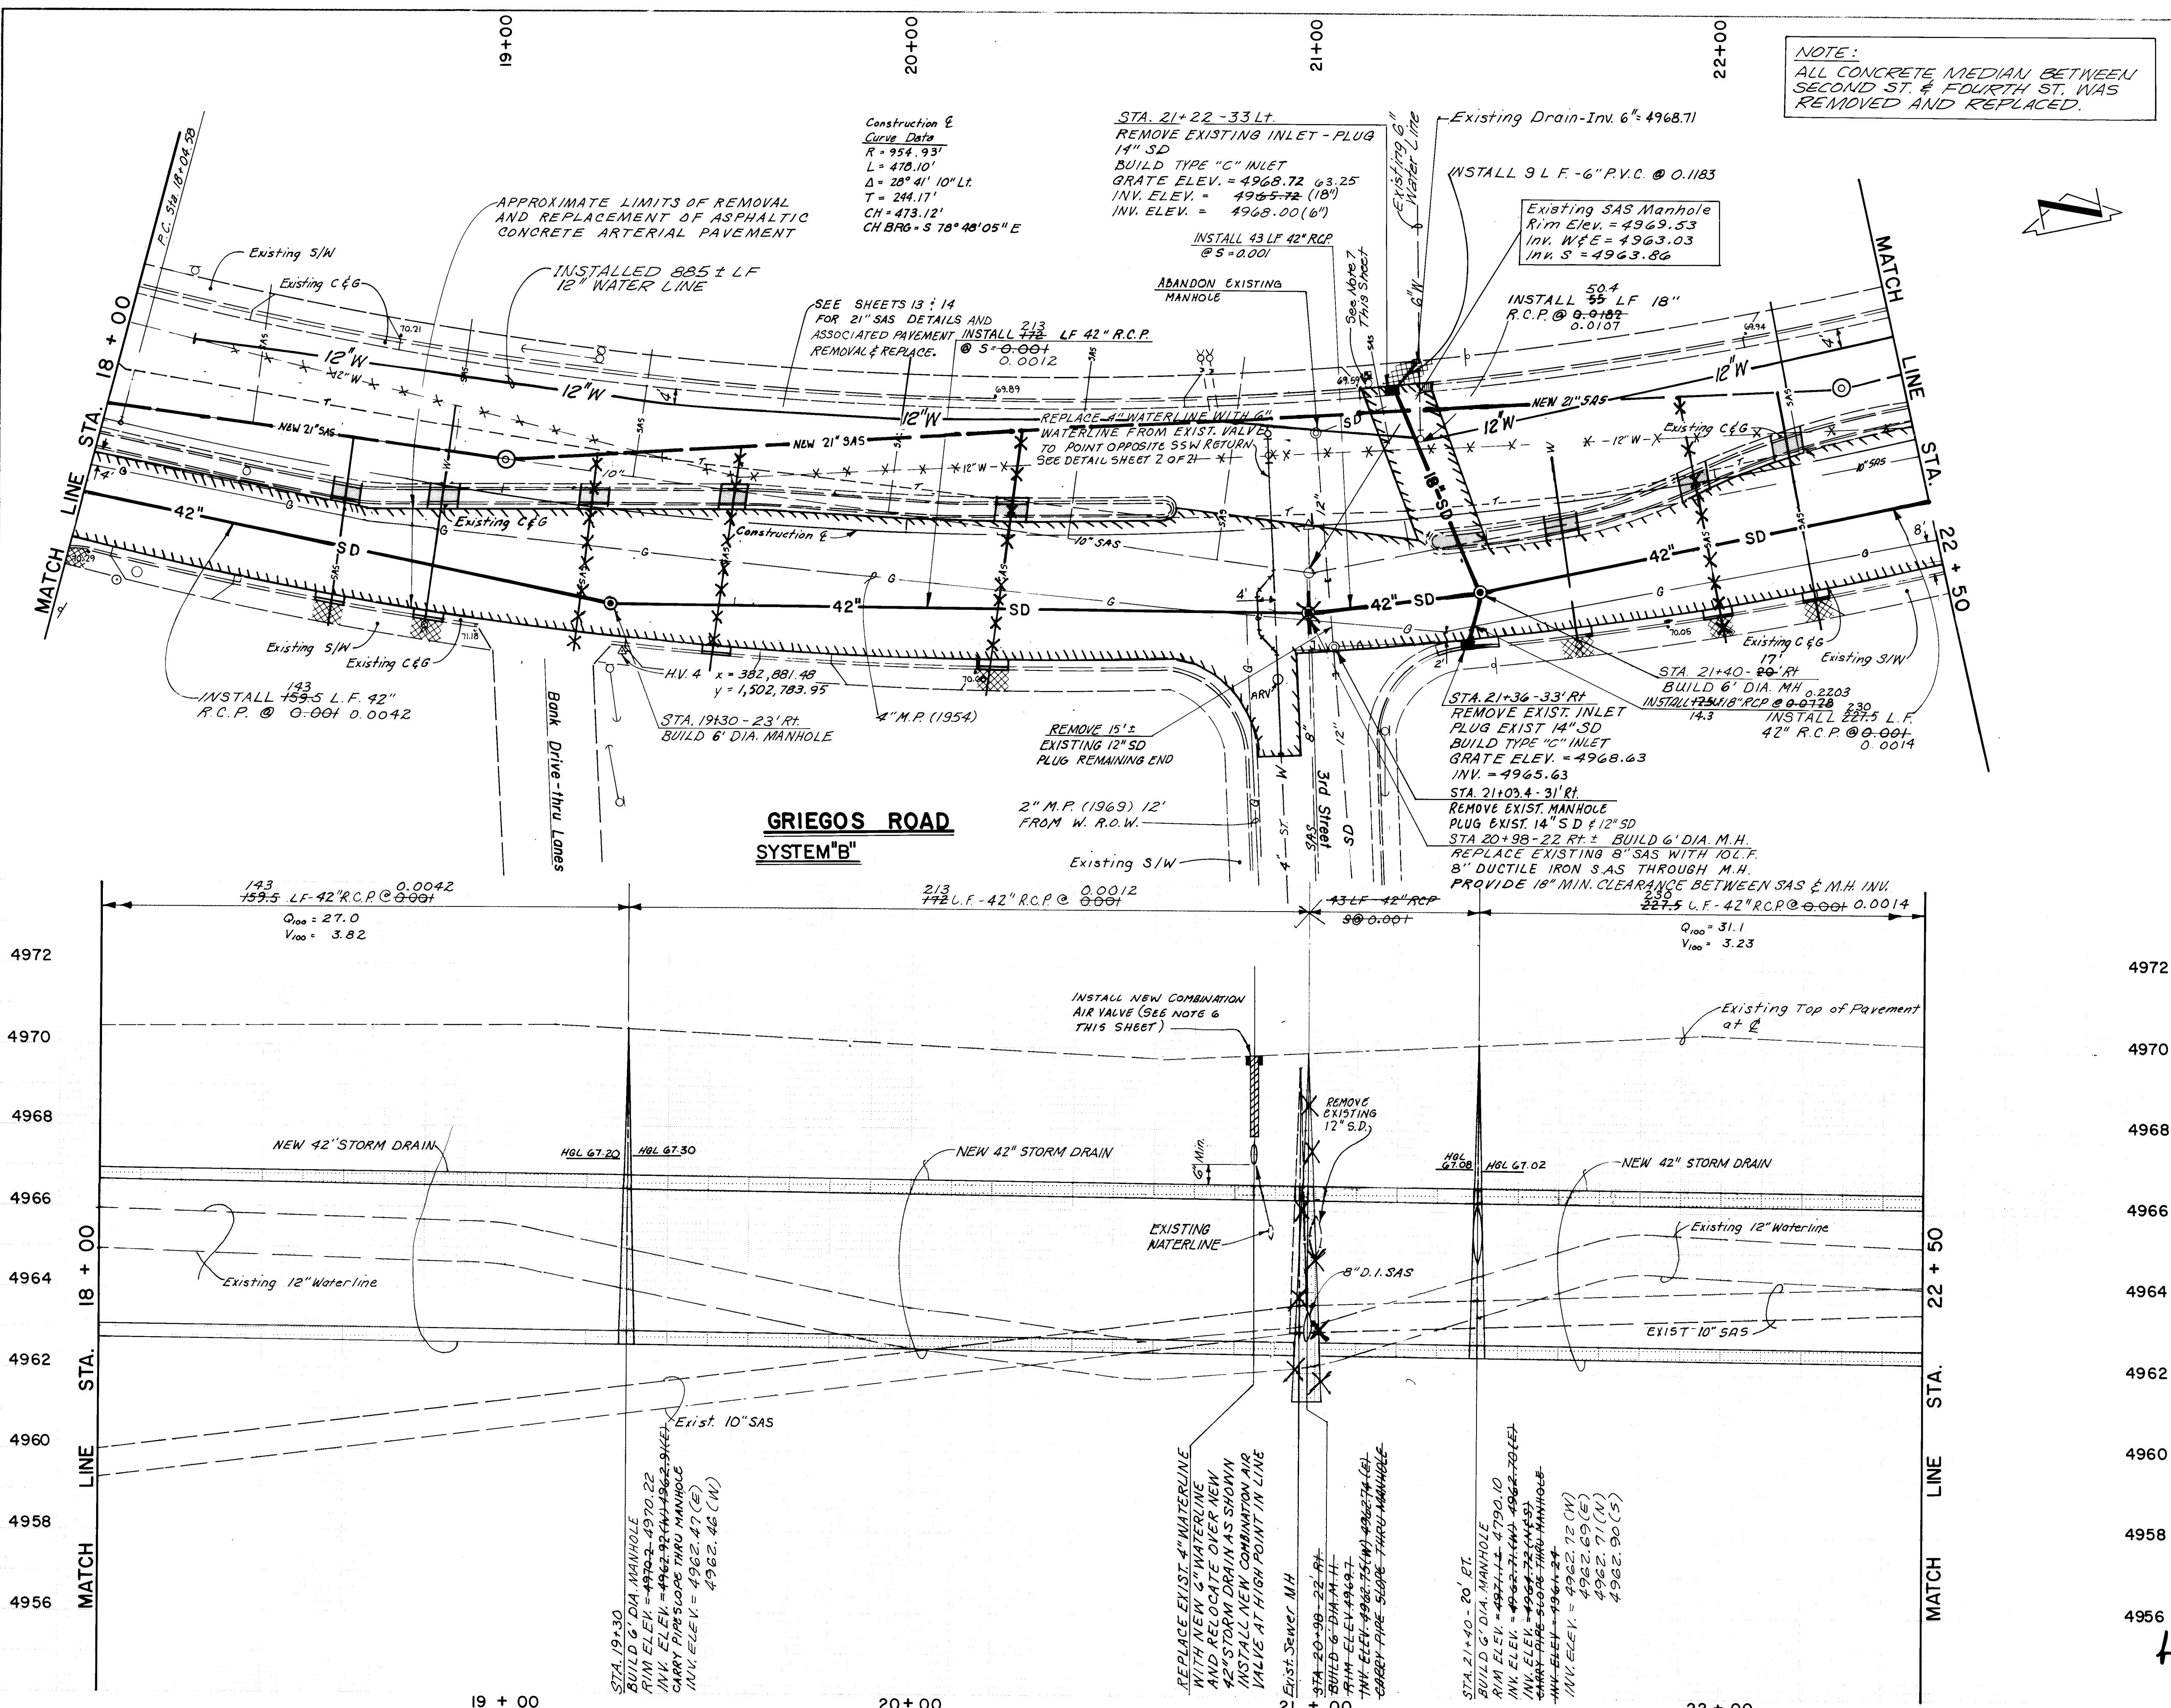


NOTES						
1. All spot elevations shown are at existing top-of-curb unless otherwise noted.						
2. All R.C.P. shall conform to ASTM C-76. General Notes for pipe class.						
3. It will be the responsibility of the Contractor to support all gas mains and service lines where they are within the area of excavation.						
4. Remove and Replace Existing SAS Service Lines at Sta. 18+86 1/2, 19+23 1/2, 19+58 1/2, 20+25 1/2, 21+95 1/2, and 22+18 1/2 Reconnected to Proposed 21" SAS. See Sheets 134-14.						
5. Remove and Replace Existing Water Service Lines at Sta. 18+86 1/2 and 21+61 1/2 from Main to Meter.						
6. New Combination Air Valve Shall be "Val-Matic Model No. 202c" or Approved Equal.						
7. The Contractor shall coordinate with P.N.M for Support of this Pole during Construction. Any associated cost will be considered incidental to the cost of construction.						

AS BUILT INFORMATION						
BENCH MARKS		SURVEY INFORMATION				
NMSHC Brass Tablet Stamped "STA. NM47-9"		FIELD NOTES				
CONTRACTOR:	Scalan Concepts, Inc.	WORK:	WATER & SEWER	DATE:	1-18-98	
DESIGNER:	Scalan Associates	INSPECTOR:	B.Y.	FIELD DATE:		
CHIEF ENGINEER:		GRADE:		RECORDED BY:		
RECORDED DATE:		STREET ELEVATION:		RECORDED ASSOCIATES:		
RECORDED TIME:		STREET ELEV.:		RECORDED DATE:		
RECORDED BY:		RECORDED BY:		RECORDED DATE:		
RECORDED TIME:		RECORDED TIME:		RECORDED DATE:		
RECORDED BY:		RECORDED BY:		RECORDED DATE:		
RECORDED TIME:		RECORDED TIME:		RECORDED DATE:		
4972	4972	4970	4968	4966	4964	4962
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4958	4958	4956	4954	4952	4950	4948
4956	4956	4954	4952	4950	4948	4946

CITY OF ALBUQUERQUE MUNICIPAL DEVELOPMENT DEPARTMENT ENGINEERING DIVISION					
TITLE NORTH VALLEY DRAINAGE SYSTEM IMPROVEMENTS GRIEGOS ROAD SYSTEM(B) STORM DRAIN - STATION 18+00 TO 22+50					
APPROVALS	ENGINEER	DATE	APPROVALS	ENGINEER	DATE
City Engineer			Liquid Waste		10/1/07
ACE Design			Traffic		10/2/07
ACE Hydrology			Water		10/3/07
Stakeholder			Albuquerque		10/3/07
DRAWING NO.	MAP NO.	SHEET OF			
2461	G-14	8			
Scanlon Job No. 85113					

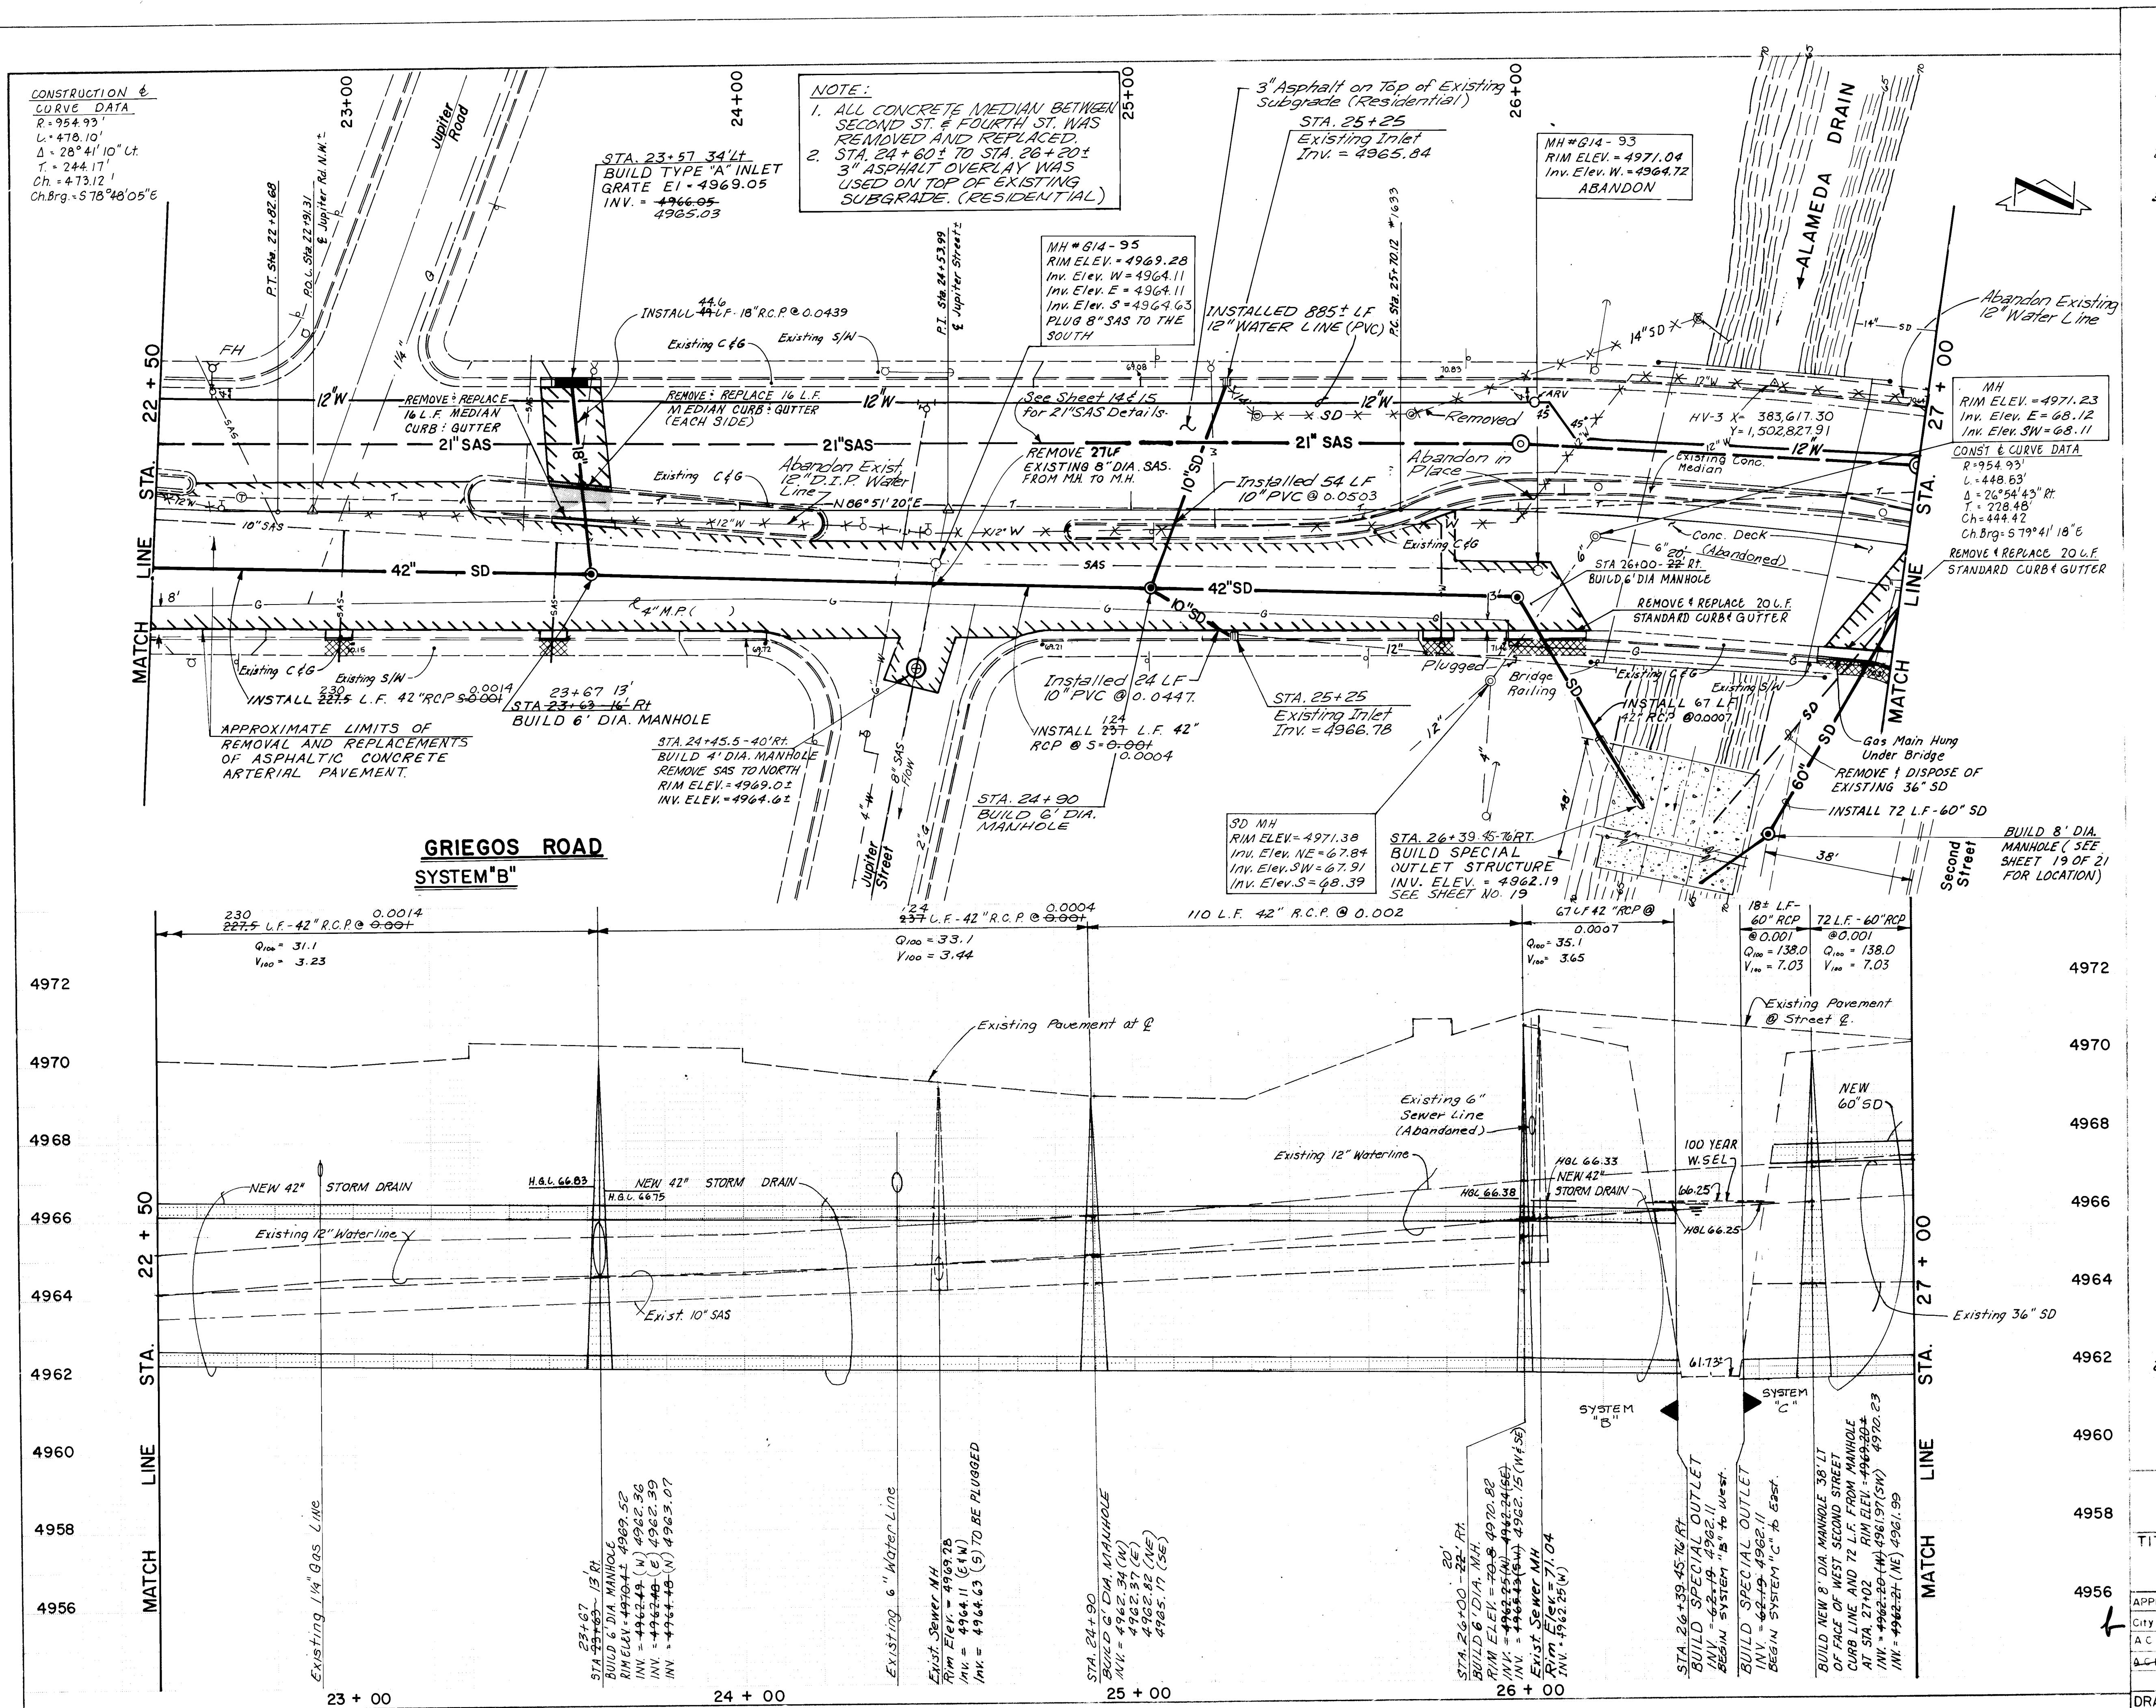

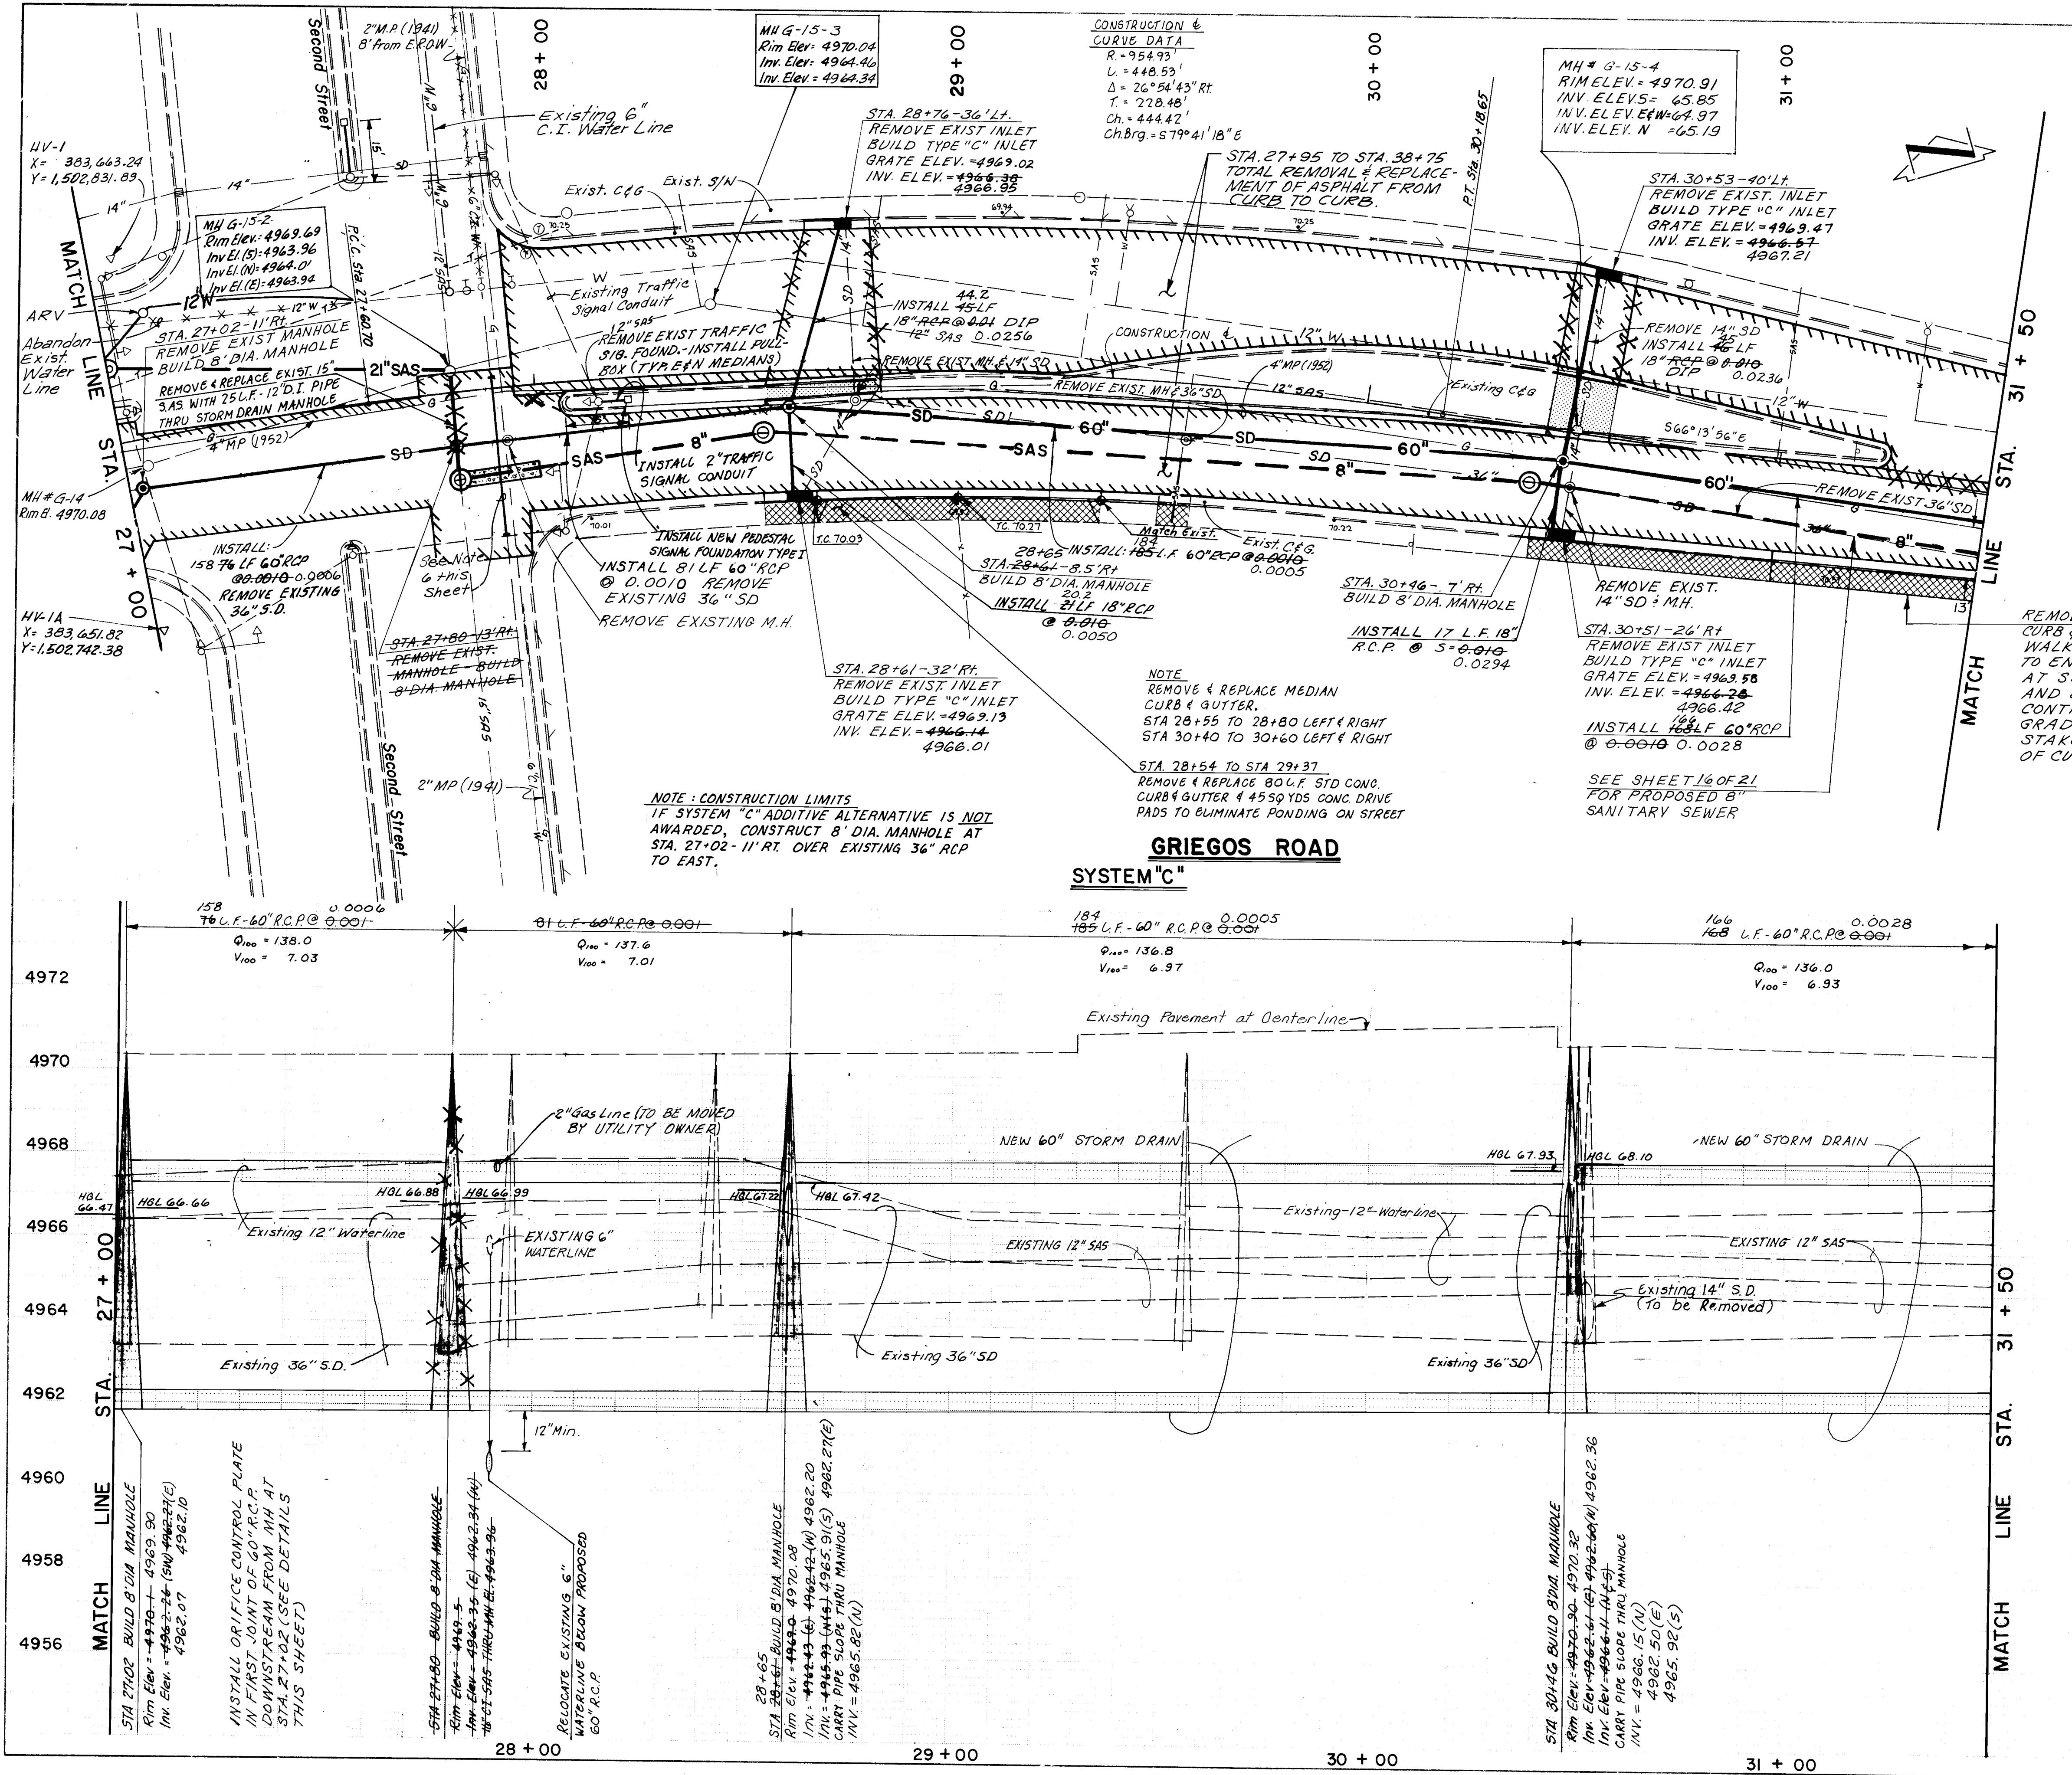

NOTES

vations shown are at
-of-curb unless otherwise

- 11 R.C.P. shall conform to ASTM
-76. See General Notes for
pipe class.

will be the responsibility of the
contractor to support all gas main
and Service lines where they
are within the Area of
excavation.

When crossing Existing Signal
conduit - Replace from Median
Curb Line.

When crossing Traffic Signal Conduit
Replace with 2" Conduit from
Curb line to Median.

Locate Existing 6" Waterline
below Proposed 60" S.D. and 8"
S. Encase 8" SAS With Concrete
Std. Details a minimum of
6 feet each Side of 6" Waterline.
Existing 4" Gas Line is to be
located by Others from Second St.
Carlton Ave., Prior to Construction,
along the North Curb Line.


FIELD NOTES			
NO.	BY	DATE	
NMSHC Brass Tablet Stamped "STA. NM47-9 Set in the Top of a Concrete Post Flush with the Ground in the Center Island of 2nd Street 125' ± North of Pleasant Street Elev. = 4972.038			
REVISIONS			
DESIGN BY S.A.V. DATE FEB 86			
DRAWN BY C.L.W. DATE FEB 86			
CHECKED BY NO.			
RECORDED BY DATE			
VERMINE SCOTT & NEW MEXICO REGISTERED PROFESSIONAL ENGINEERS 8796			
<i>John J. Johnson</i>			




ORIFICE PLATE DETAIL

NOT TO SCALE

NOTE: All Steel Shall be Grade 60
Orifice plate shall be Painted w/two
coats of Red Lead Primer & two coats
of Aluminum paint per Sect. 157.3 of
the Standard Spec's.

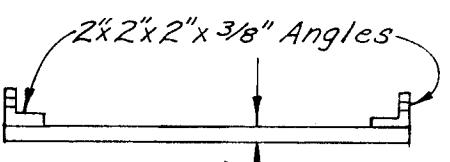

SECTION A

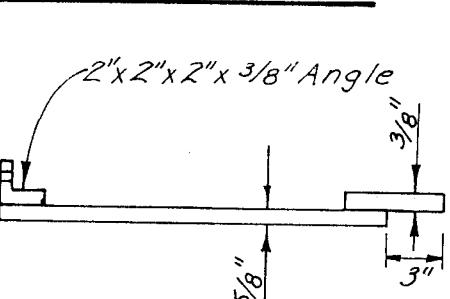

SECTION E

A $3/8$ " Spacer Shall be Provided at the Pipe Joint if the Orifice Plate is not Installed Simultaneously with the Pipe Laying Operation.

26 24611088

DONTAL 1" = 20'
CAL 1" = 2'

**CITY OF ALBUQUERQUE
MUNICIPAL DEVELOPMENT DEPARTMENT
ENGINEERING DIVISION**

ENGINEERING DIVISION
NORTH VALLEY DRAINAGE SYSTEM IMPROVEMENTS
GRIEGOS ROAD SYSTEM (C)
STORM DRAIN STATION 27 + 00 TO 31 + 50

ENGINEER	DATE	APPROVALS	ENGINEER	DATE
Alfie	10/27/87	Liquid Waste	Alfie	10/27/87
" "	"	Traffic	JRC	10/22/87
g) Steve Boring	10/22/87	Water	Alfie	10/27/87

2461	MAP NO. G-14.	SHEET 10	OF 21
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NOTES

1. All spot elevations shown are at existing top-of-curb unless otherwise noted.

2. All P.C.P shall conform to ASTM C-76. See General Notes for Pipe class.

3. It will be the responsibility of the Contractor to support all gas mains and service lines where they are within the area of excavation.

4. Remove and Replace Existing Water Service Lines at Sta. 33+18 $\frac{1}{2}$, 34+78 $\frac{1}{2}$ and 35+57 $\frac{1}{2}$ from Main to Meter.


5. Remove & Replace Existing Curb and Gutter and Sidewalk from Sta. 31+00 Rt. to End of Curb Return at SW Corner Griegos and Los Hermanos. Contractor Shall Set Grade Reference Stakes Prior to Removal of Curb & Gutter.


6. The Existing 4" Gas Line is to be relocated by others from Second Street to Carlton Avenue, prior to Construction, along the North Curb Line.

AS BUILT INFORMATION		BENCH MARKS	
CONTRACTOR:	New Concepts, Inc.	WORK:	Scandon & Associates DATE 11-88
WORK:	Scandon & Associates	INSPECTOR:	DATE
FIELD INSPECTOR:		DRAWINGS:	Scandon & Associates DATE 11-88
		CORRECTED LESSONS LEARNED:	MICRO-FILM INFORMATION
			RECORDED BY
			NO

Scandon
Scandon & Associates
Engineering Services

GRIEGOS ROAD SYSTEM "C"

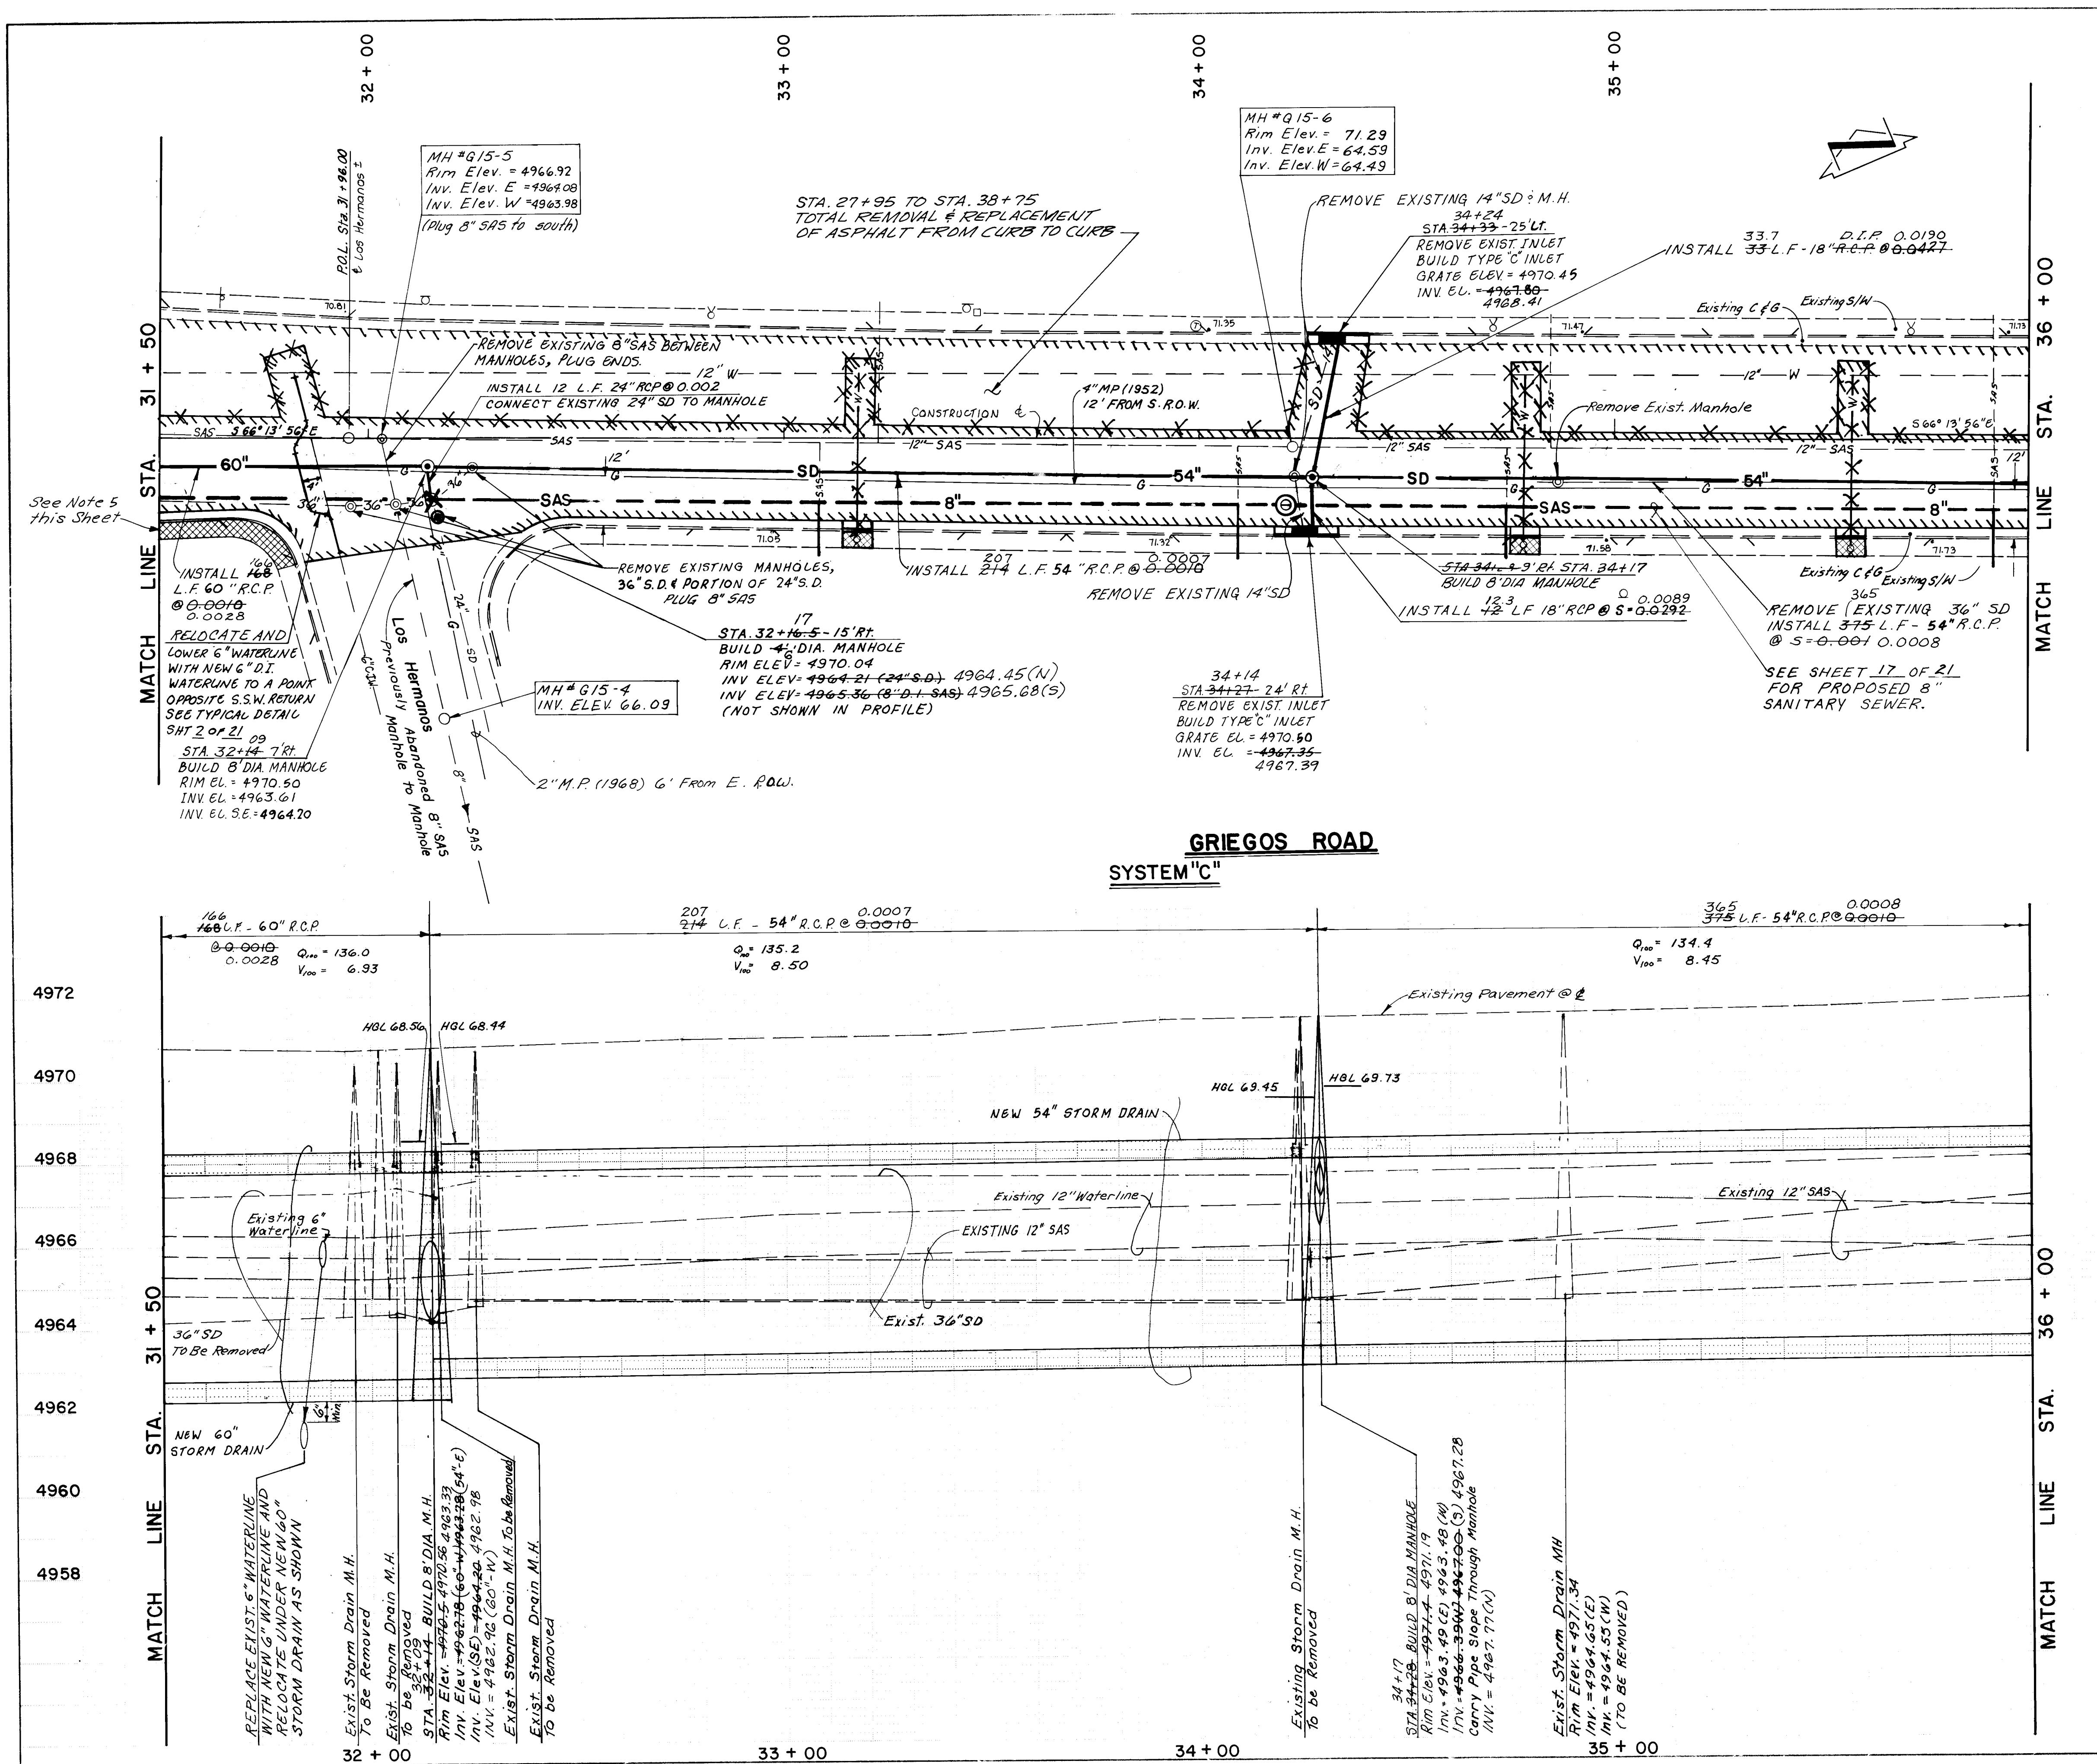

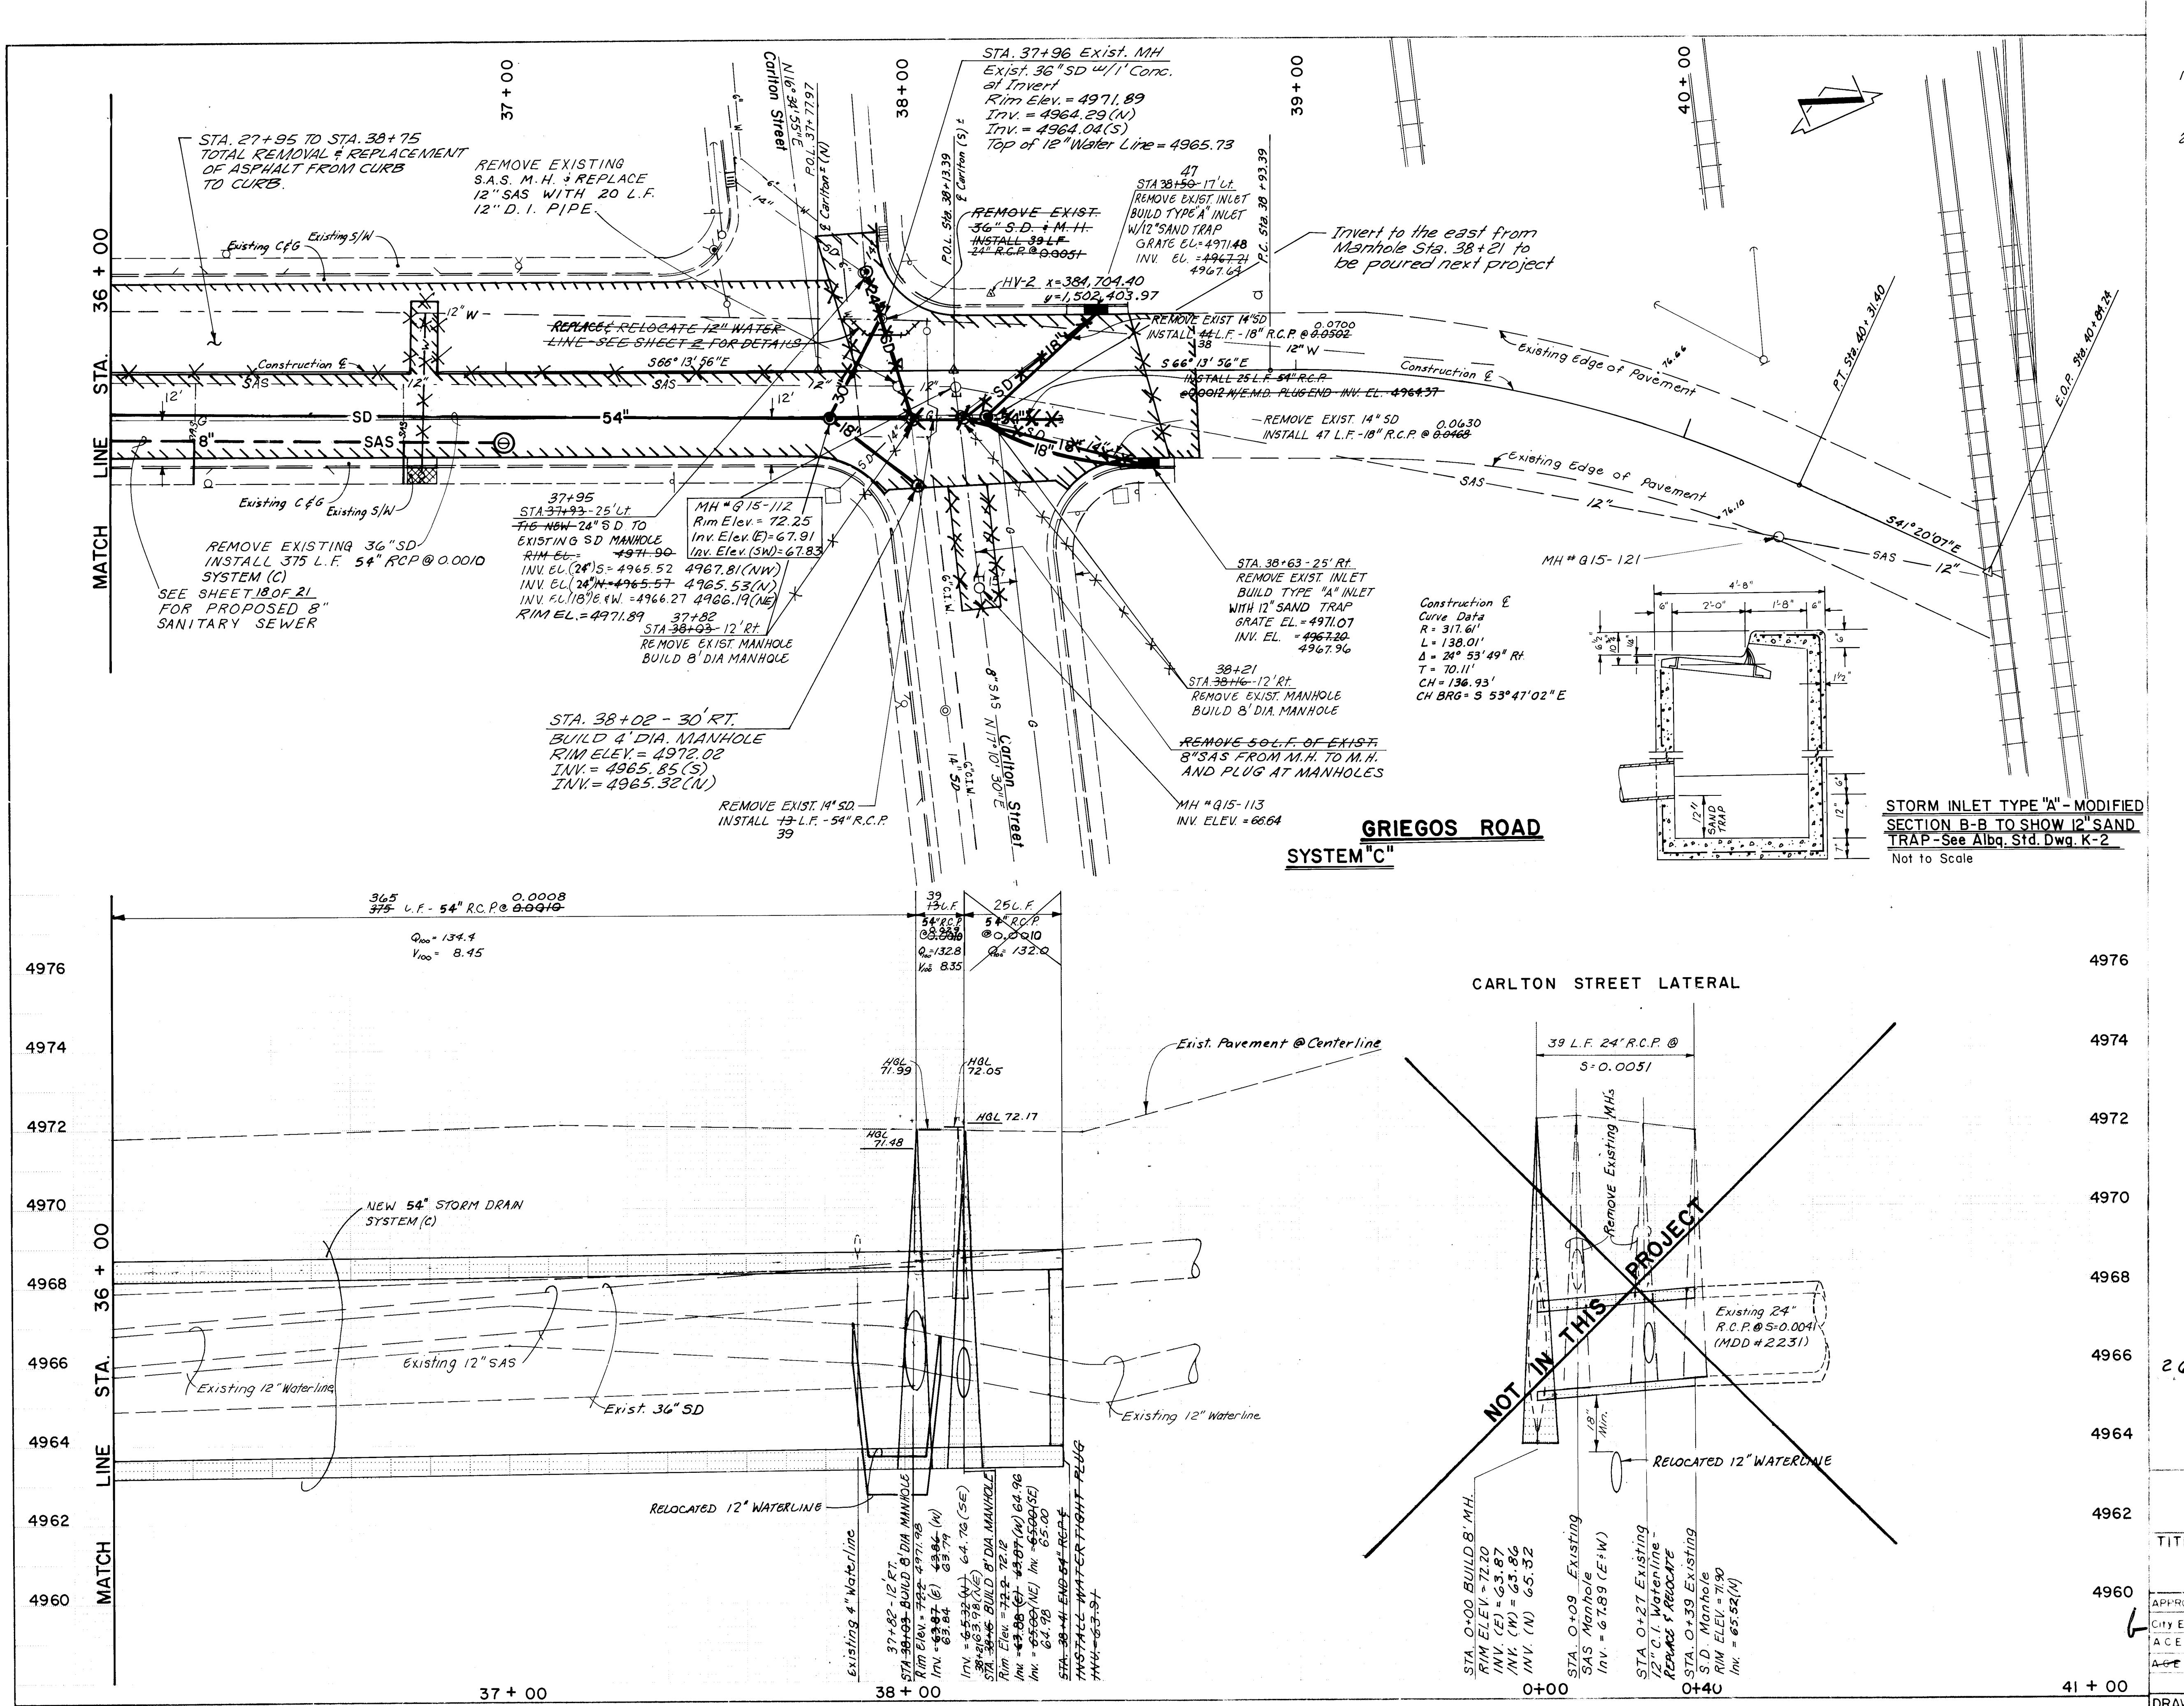

AS BUILT INFORMATION	
NO.	FIELD NOTES
1	NMSHC Brass Tablet Stamped "STA. NM47-9" Set in the Top of a Concrete Post Flush with the Ground in the Center Island of 2nd Street I25 ± North of Pleasant Street Elev. = 4972.038
2	Scanton & Associates Inspected by _____ Accepted by _____ Date _____
3	Scanton & Associates Drawings Verified by _____ Corrected Drawings _____ Microfilm Information _____ Recorded by _____ Date _____


26 24611288

SCALES

HORIZONTAL	1" = 20'
VERTICAL	1" = 2'

NOTES



- Remove and Replace Existing Water Service Lines at Sta. 36+79 from Main to Meter.
- The Existing 4" Gas Line is to be Relocated by others from Second Street to Carlton Avenue, Prior to Construction, along the North Curb line.

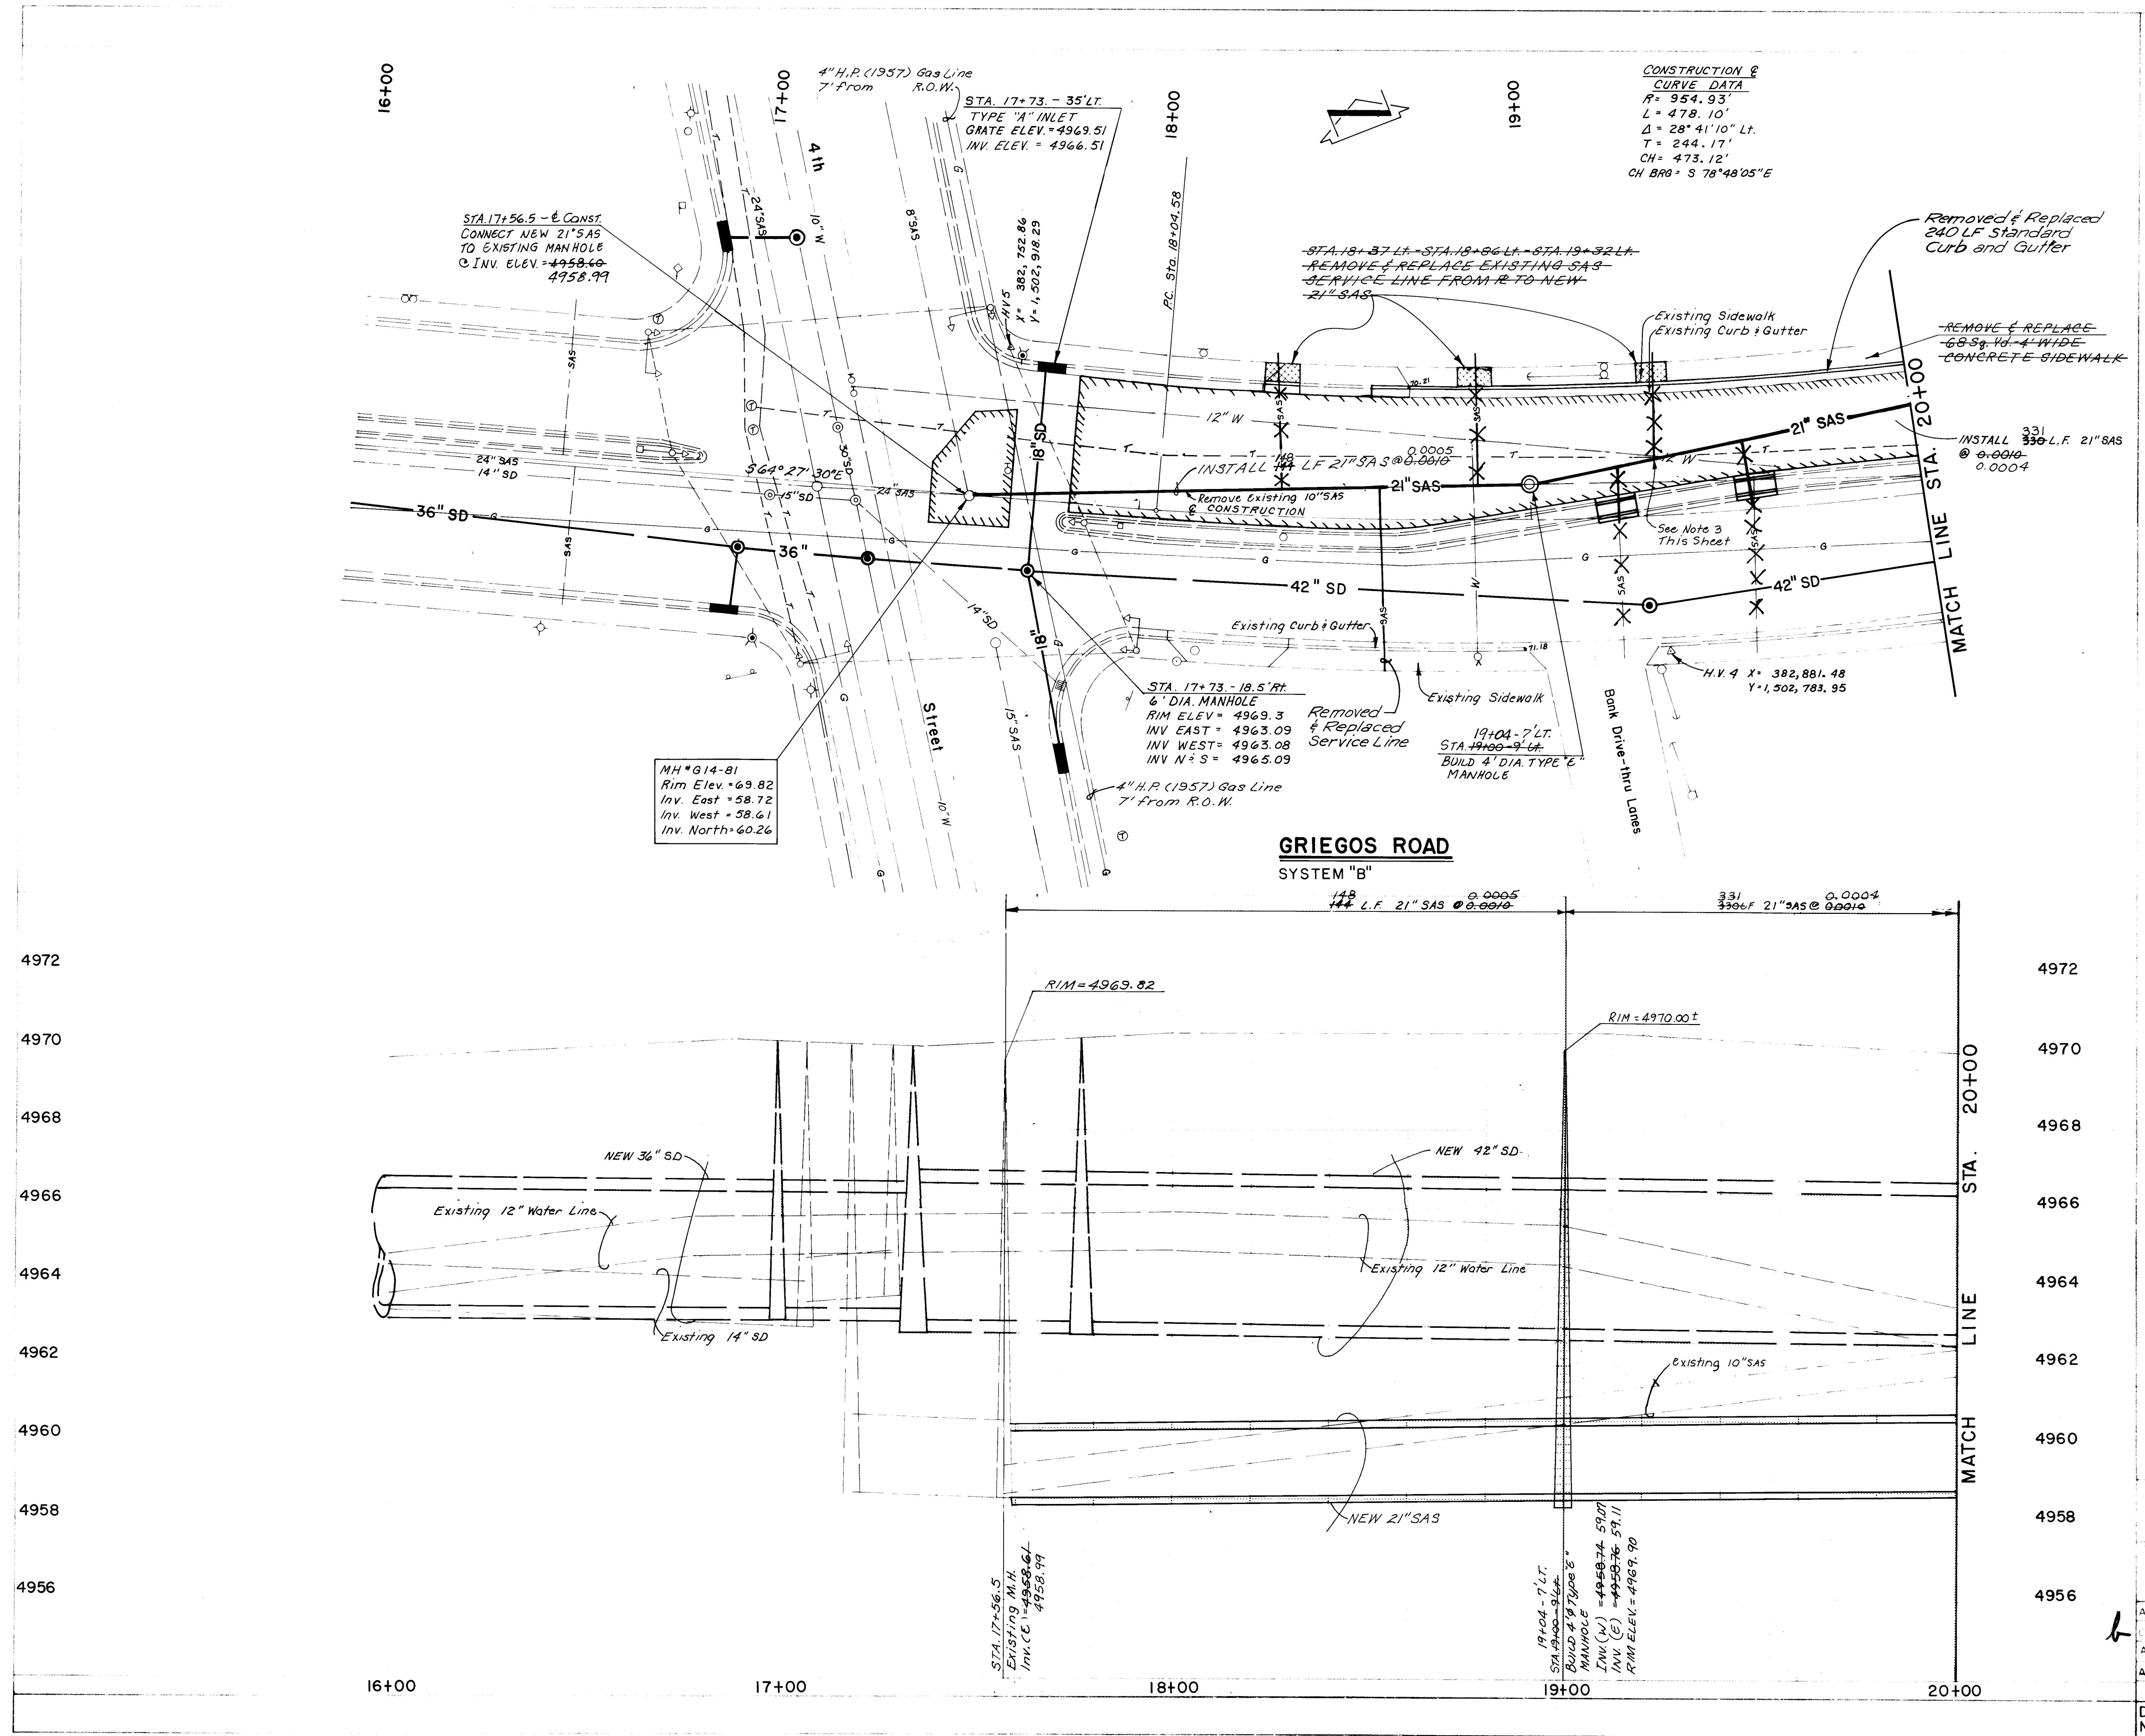

AS BUILT INFORMATION					
NMSHC Brass Tablet Stamped "STA NM-27-9"	BENCH MARKS				
Set in the Top of a Concrete Post Flush with the Ground in the Center Island of 2nd Street					
125' ± North of Pleasant Street Elev = 4972.038					
FIELD NOTES					
NO.	BY	DATE			
81					
SURVEY INFORMATION					
NO.	BY	DATE			
4972					
4970					
4968					
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4958					
4956					
REVISIONS					
NO.	DATE	REMARKS			
26 24611388					
SCALES:					
HORIZONTAL 1" = 20'					
VERTICAL 1" = 2'					
CITY OF ALBUQUERQUE					
MUNICIPAL DEVELOPMENT DEPARTMENT					
ENGINEERING DIVISION					
TITLE	North Valley Drainage System Improvements				
GRIGEOS ROAD SYSTEM (B)					
SANITARY SEWER - STATION 16+00 TO 20+00					
APPROVALS	NUMBER	DATE	APPROVALS	ENGINEER	DATE
Cty Engineer	10/21/87		Liquid Waste	W. M. W.	10/21/87
ACE Design	"		Traffic	"	10/21/87
ACE Hydrology	Ester Boling 10/22/87		Water	"	10/21/87
DRAWING NO.	2461	MATERIAL	G-15	SHEET	13 OF 21

Scanlon and Associates Job No. 8513.2

RECORD DRAWING

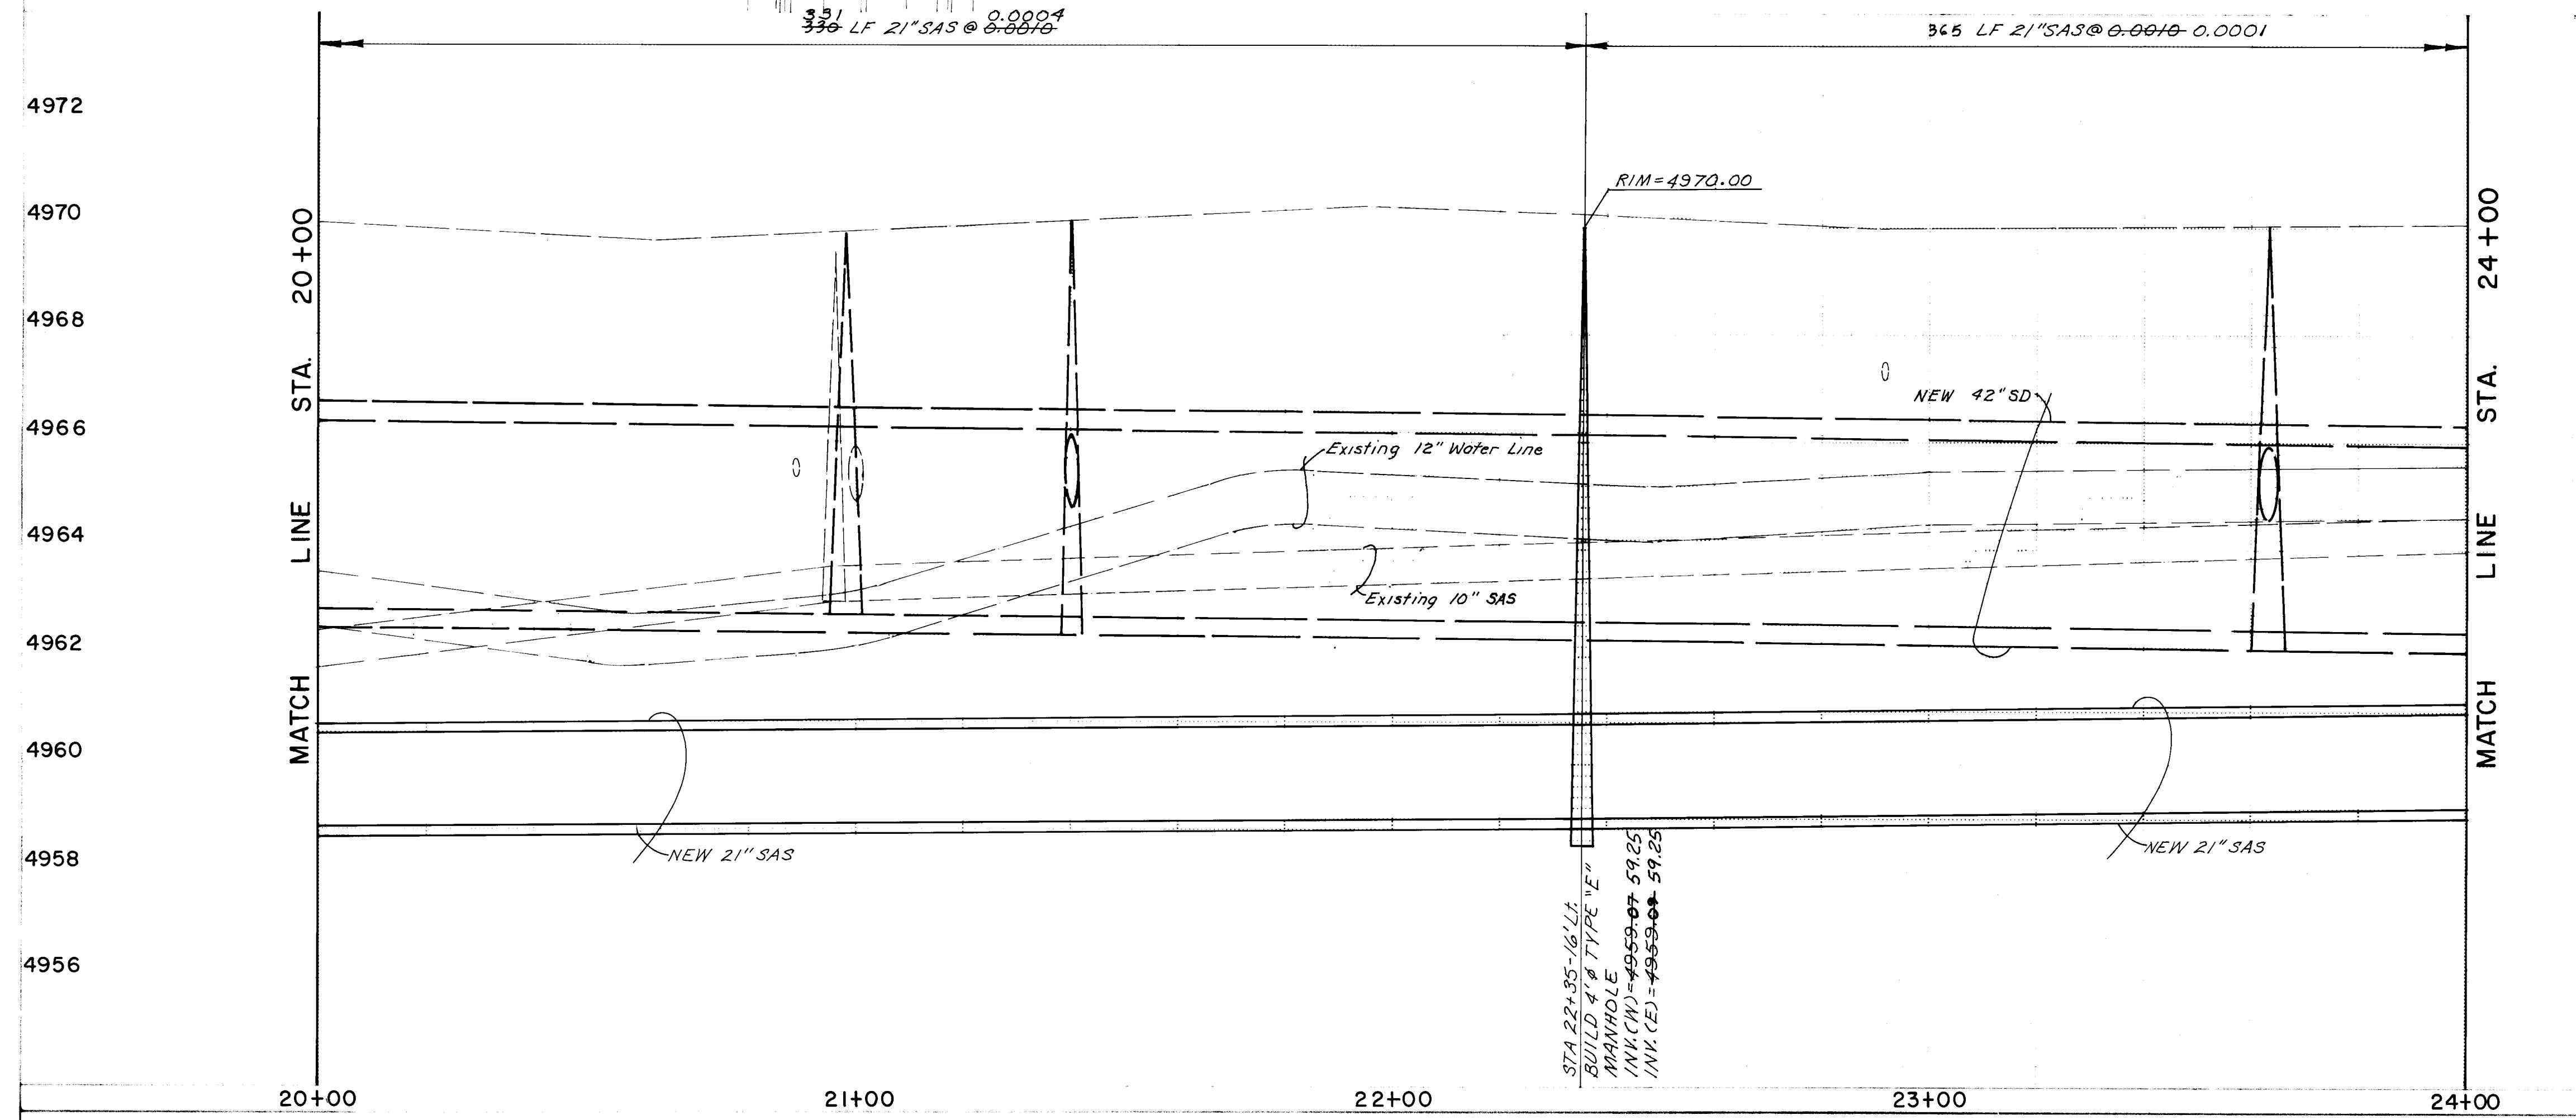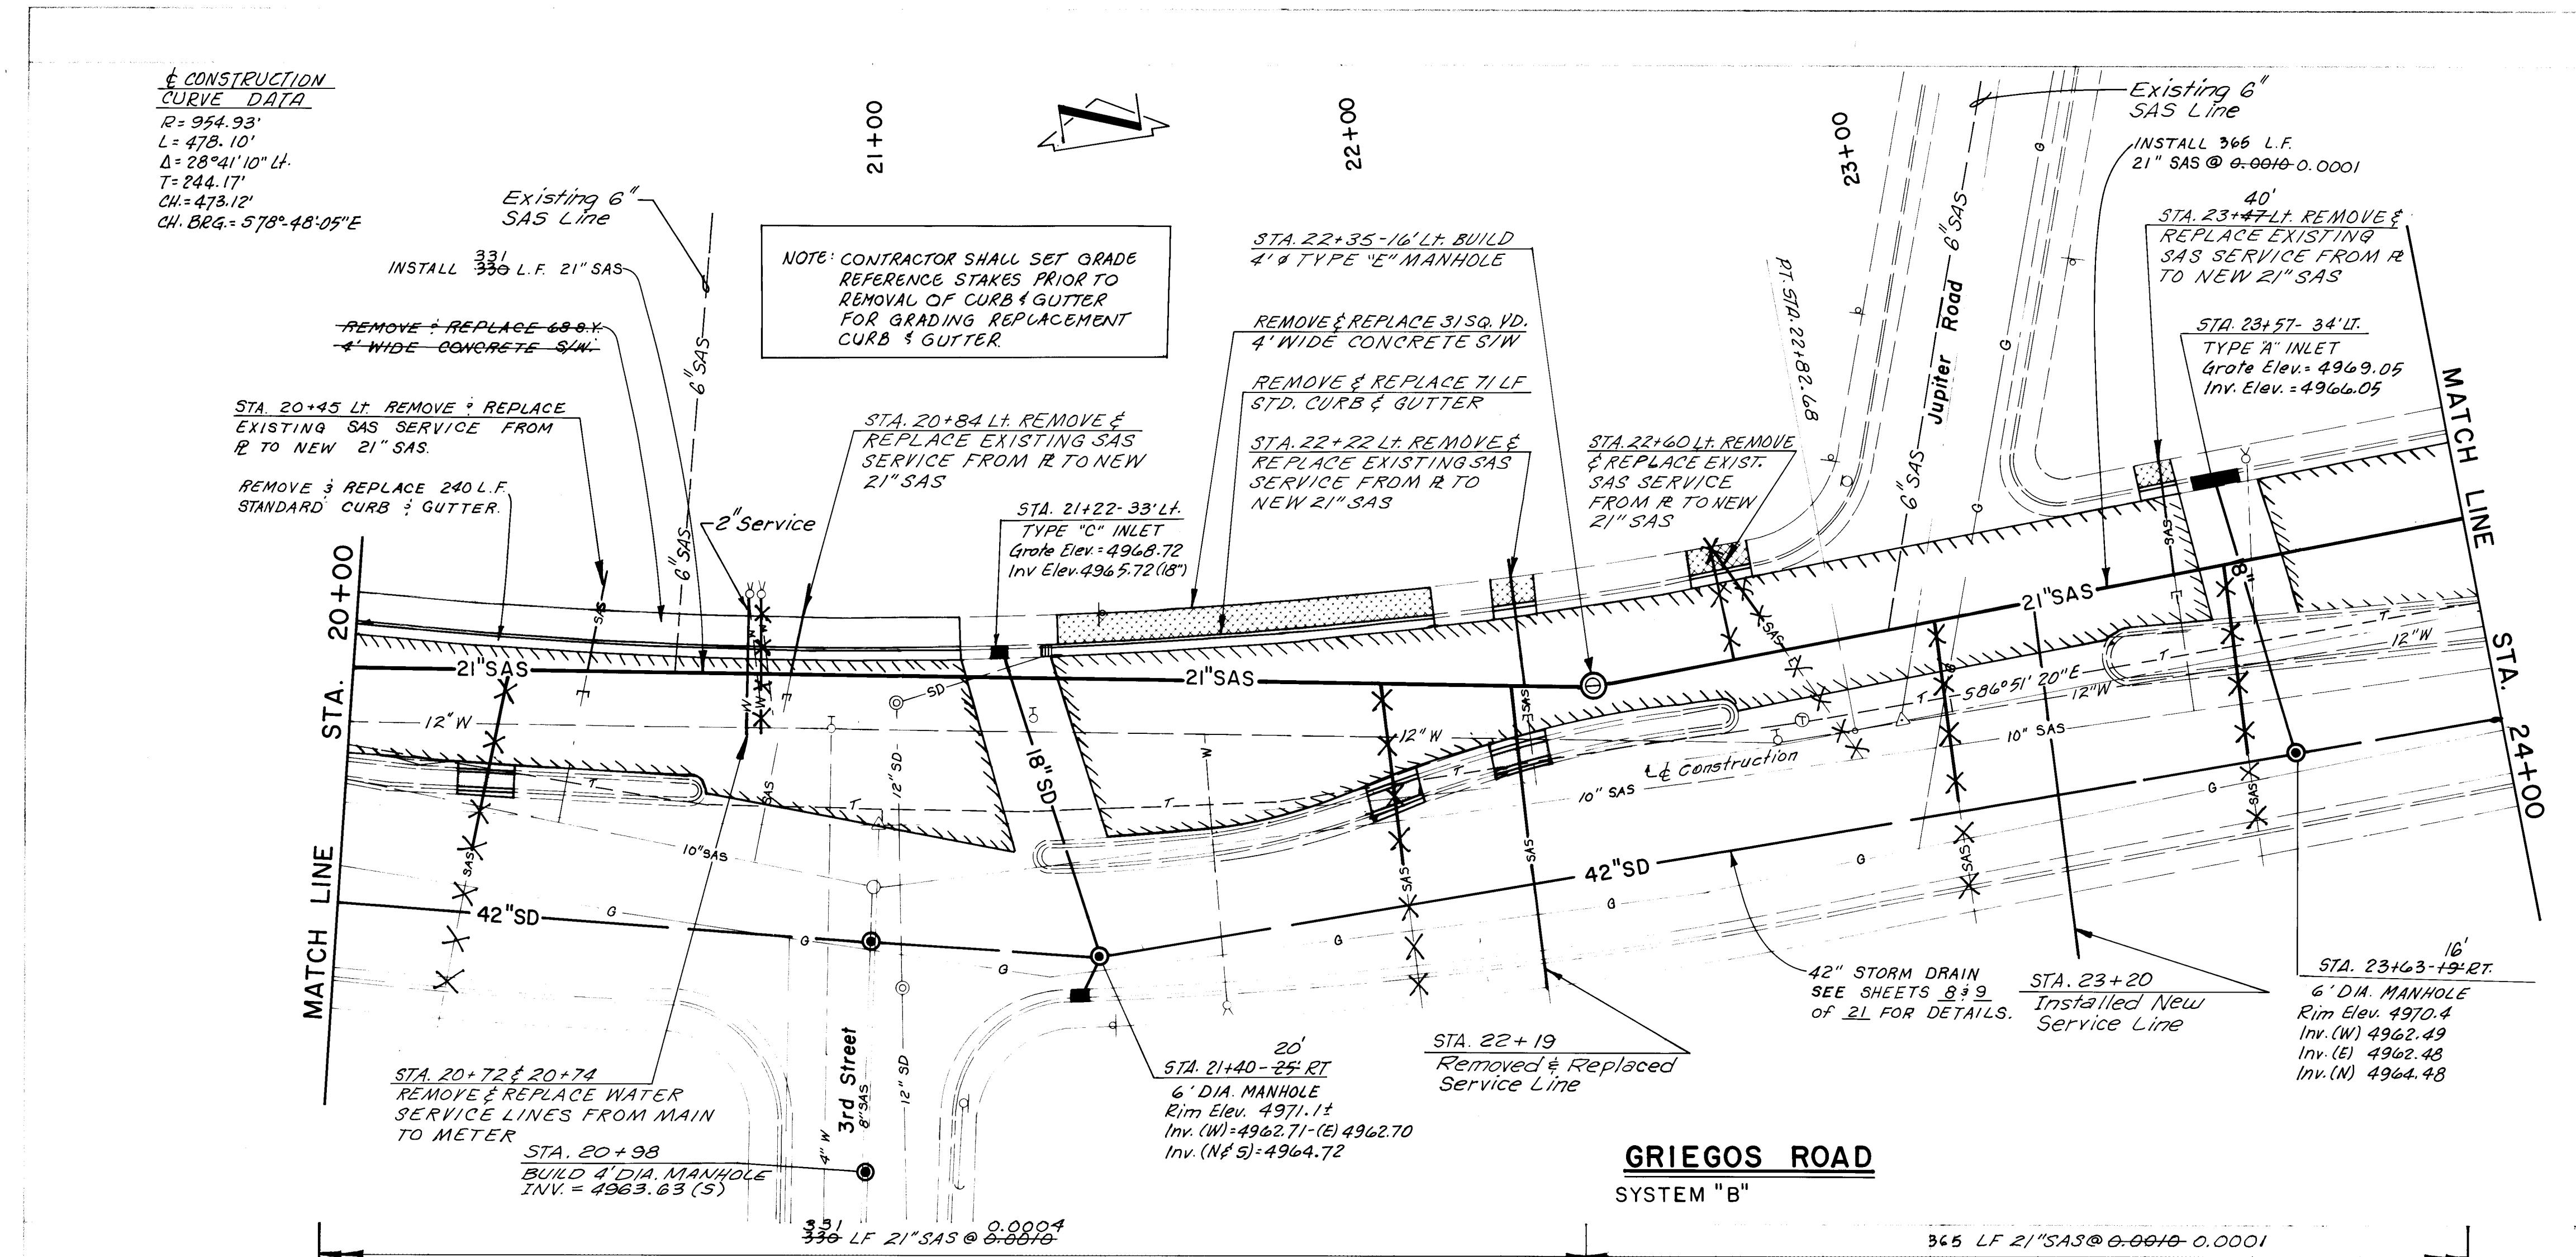


NOTES:


- The existing 10" SAS is to be abandoned from Sta. 17156.5 to Sta. 26+05. All Existing Services shown on the Plans or encountered during Construction are to be disconnected from the 10" SAS and reconnected to the new 21" SAS. The Contractor shall be required to remove & replace existing services to a point where a minimum 2% slope can be maintained.
- All SAS Service disconnections from the existing 10" SAS main shall be plugged with Concrete at the main.

AS BUILT INFORMATION	
NSMHC Brass Tablet Stamped STA. NM 47-9"	MATCH MARKS
Set in the Top of a Concrete Post Flush with the Ground in the Center Island of 2nd Street	BENCH MARKS
125 ± North of Pleasant Street Elev. = 4972.038	DATE
REF ID: A1-A1	BY
DRAWINGS BY Scanlon & Associates ORILL-BB	RECORDED BY
MICRO-FILM INFORMATION	

SURVEY INFORMATION	
FIELD NOTES	BY
NO.	DATE
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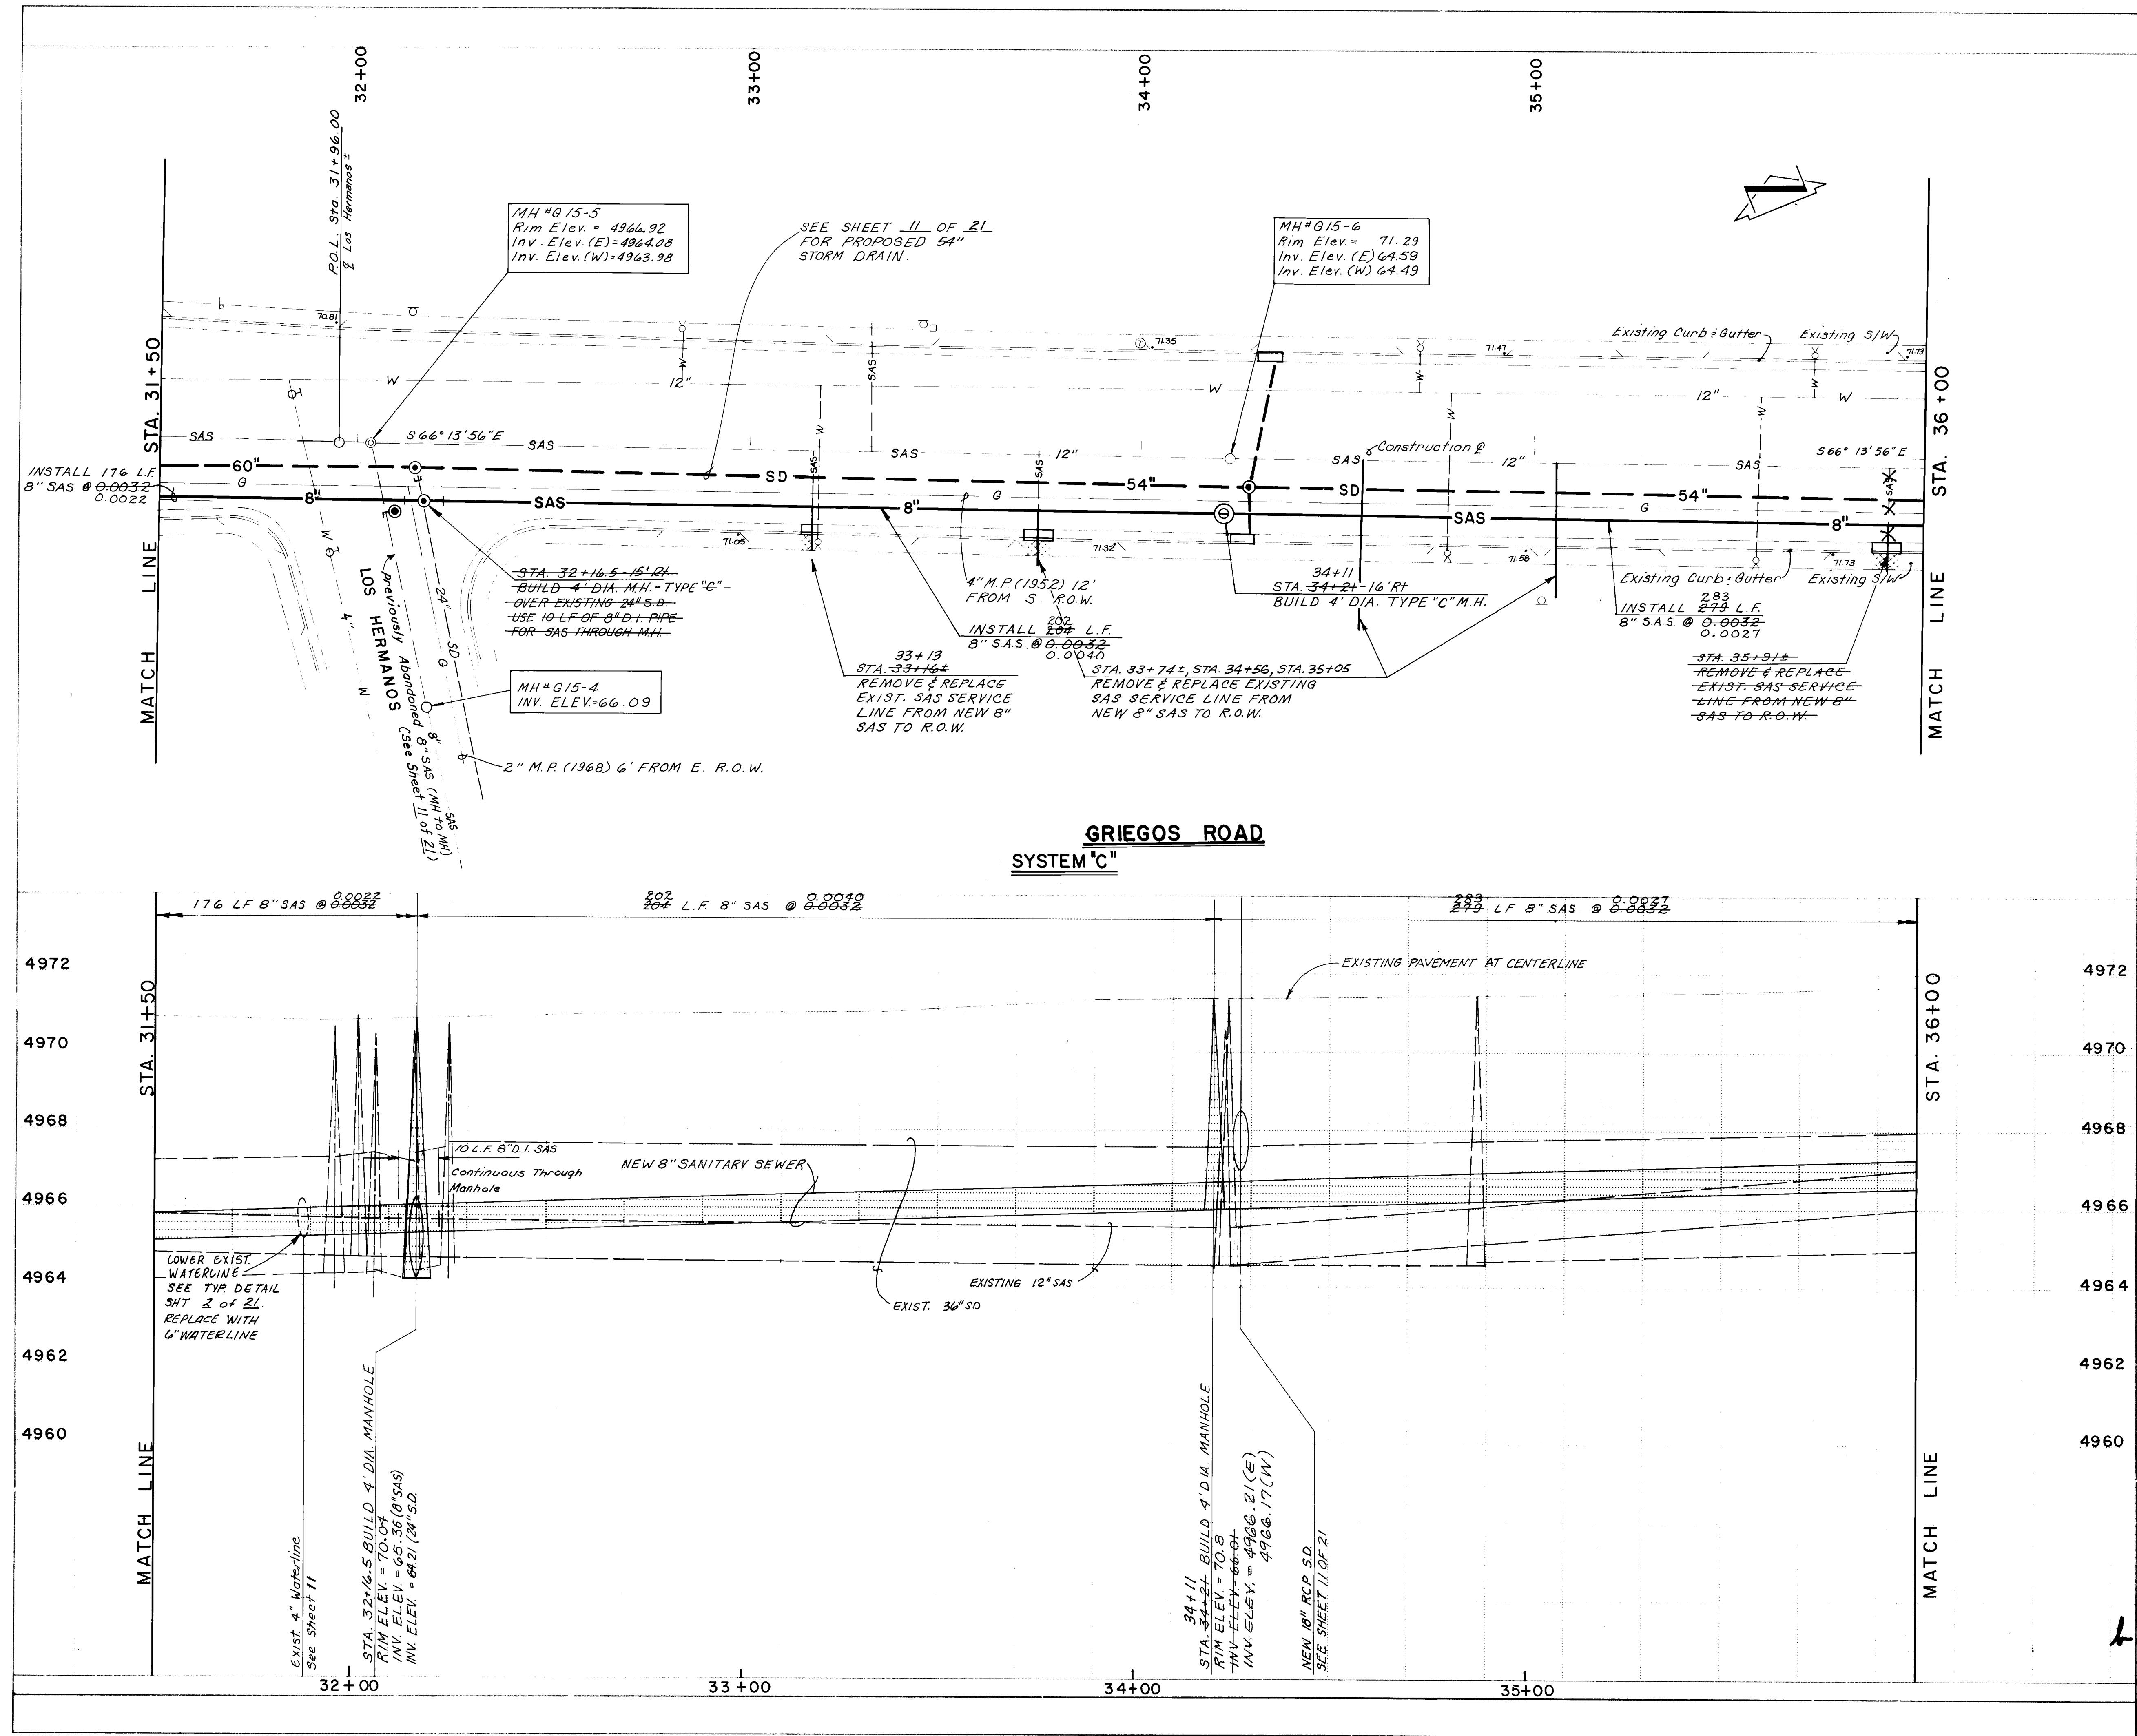


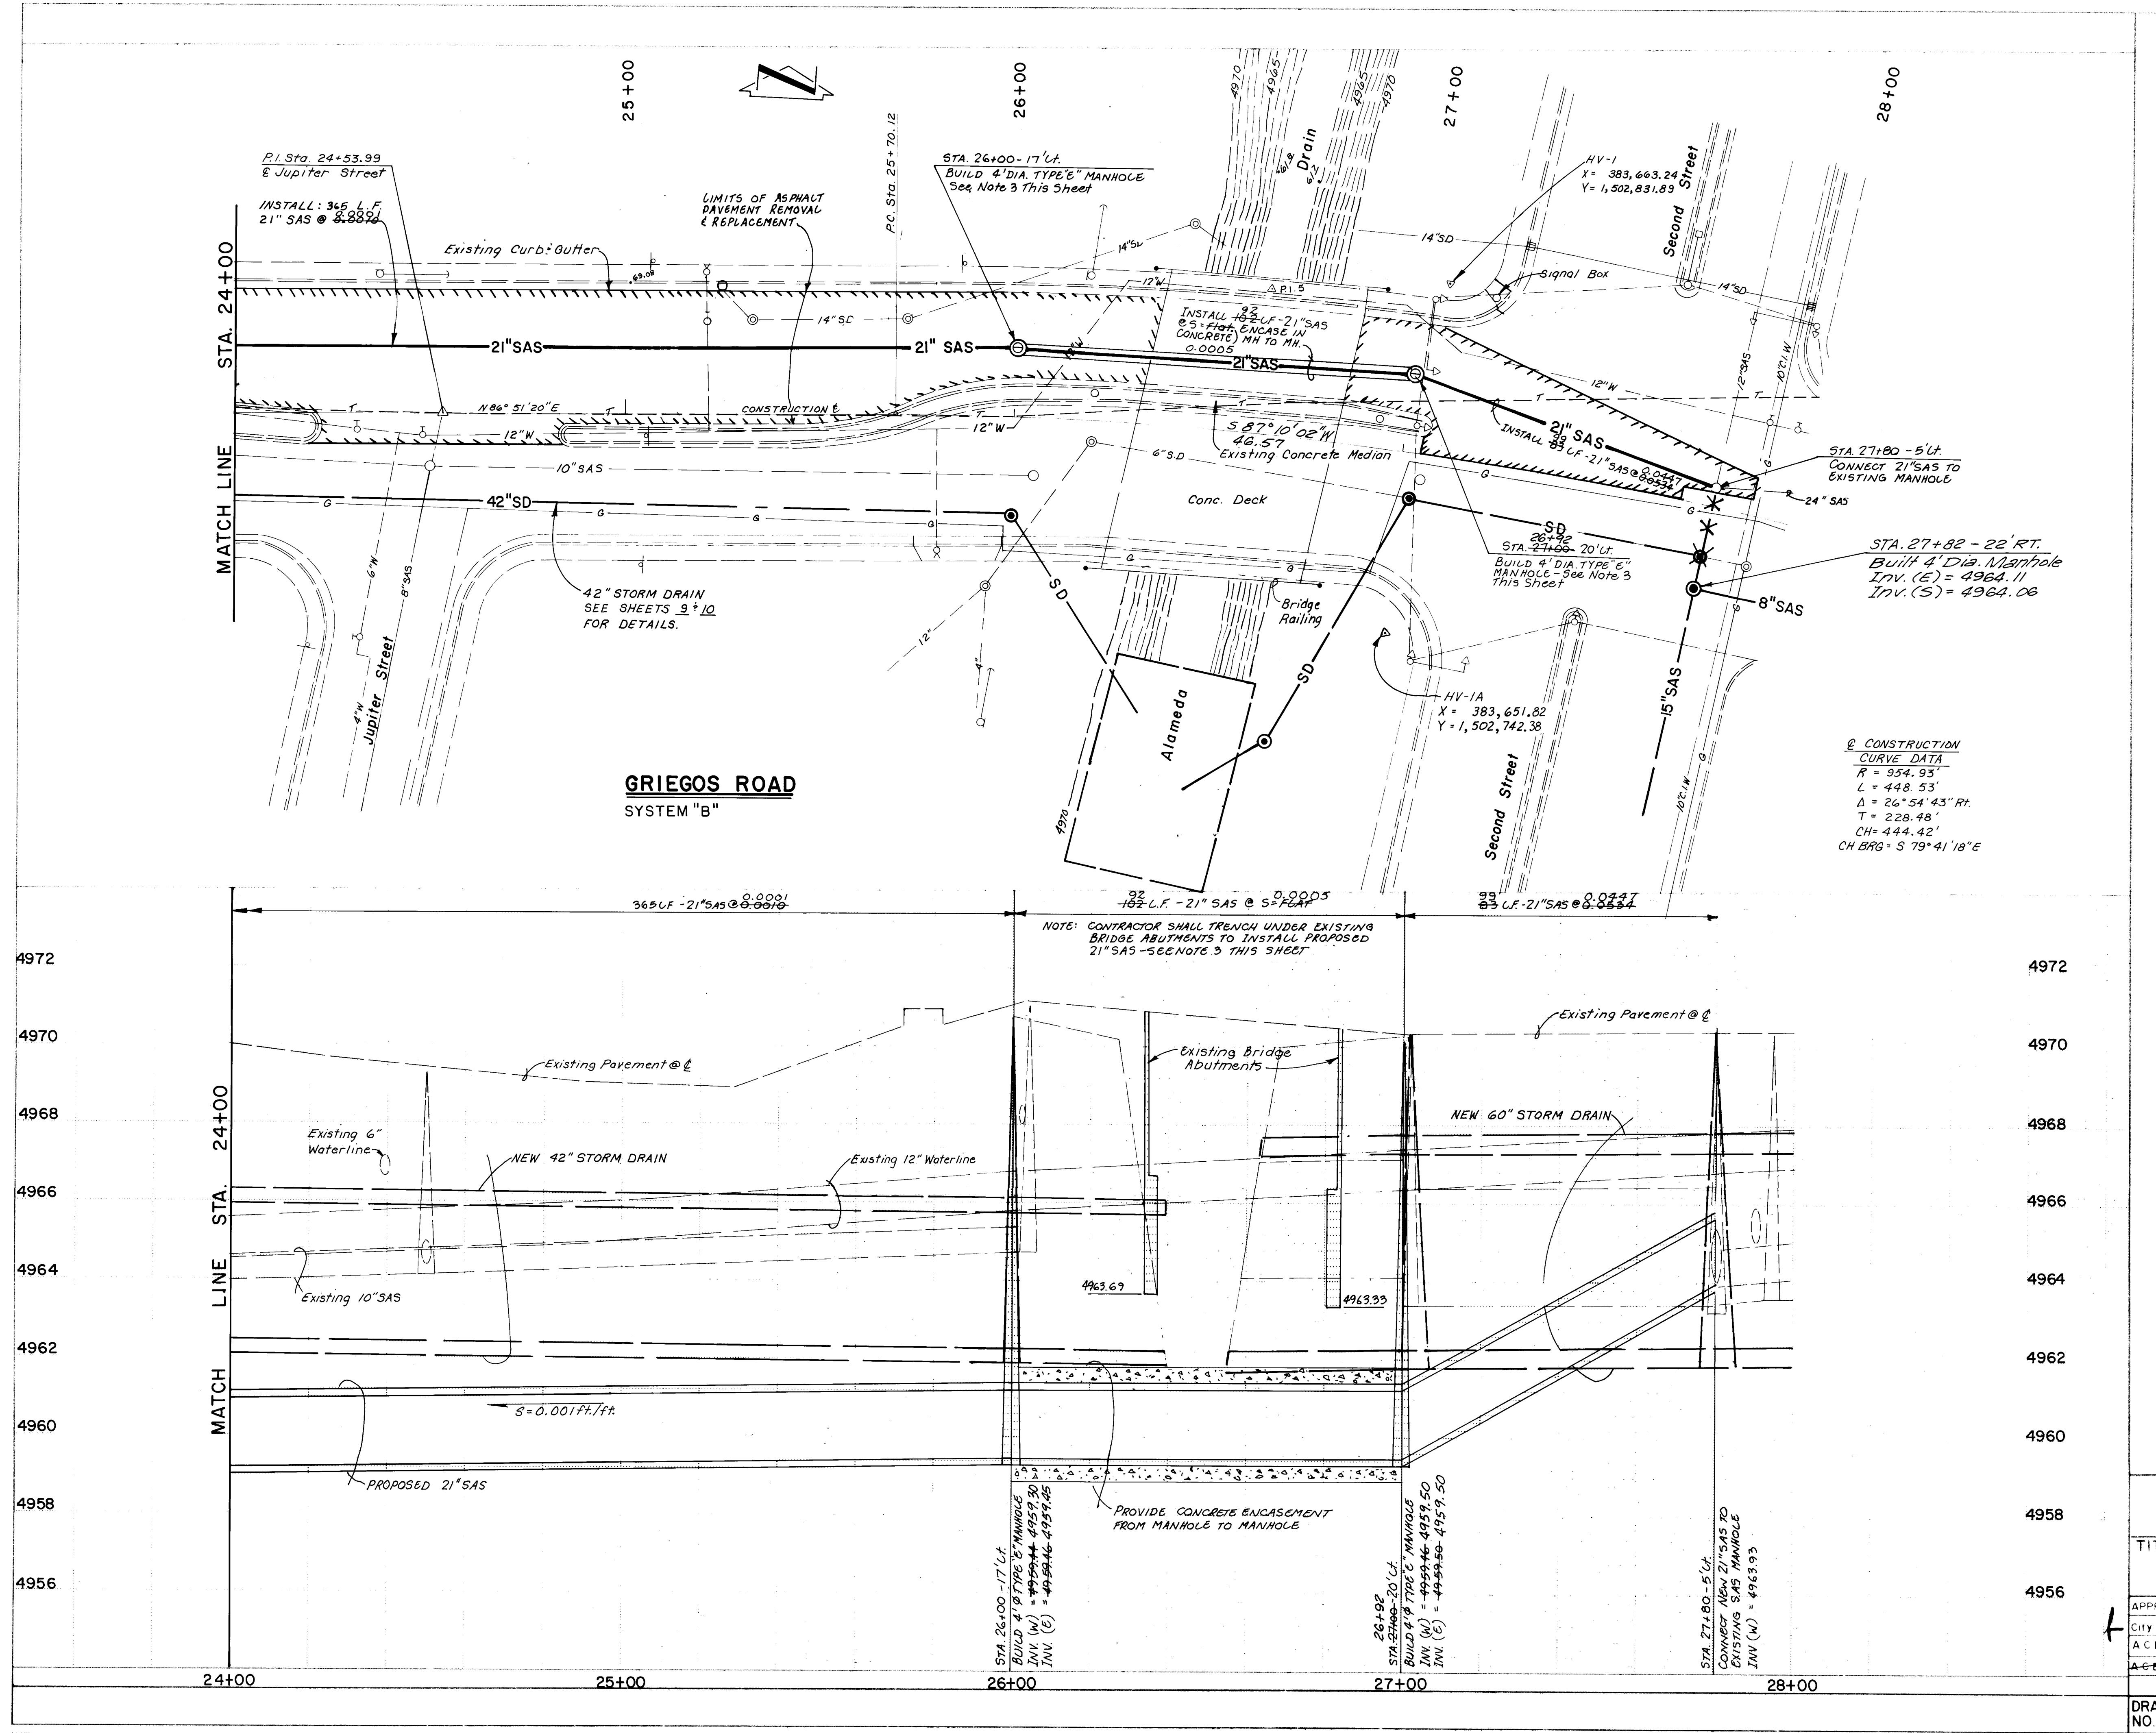AS BUILT INFORMATION					
NO.	DATE	FIELD NOTES	SURVEY INFORMATION	BENCH MARKS	
1	11/83	New Concepts, Inc.	MM47-9	Set in the Top of a Concrete Post Flush with the Ground in the Center of 2nd Street	
2	11/83	Scanton & Associates	125 ± North of Pleasant Street Elev. = 492.038		
3	11/83	Scanton & Associates	125 ± North of Pleasant Street Elev. = 492.038		
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100	11/83	Scanton & Associates	125 ± North of Pleasant Street Elev. = 492.038		</

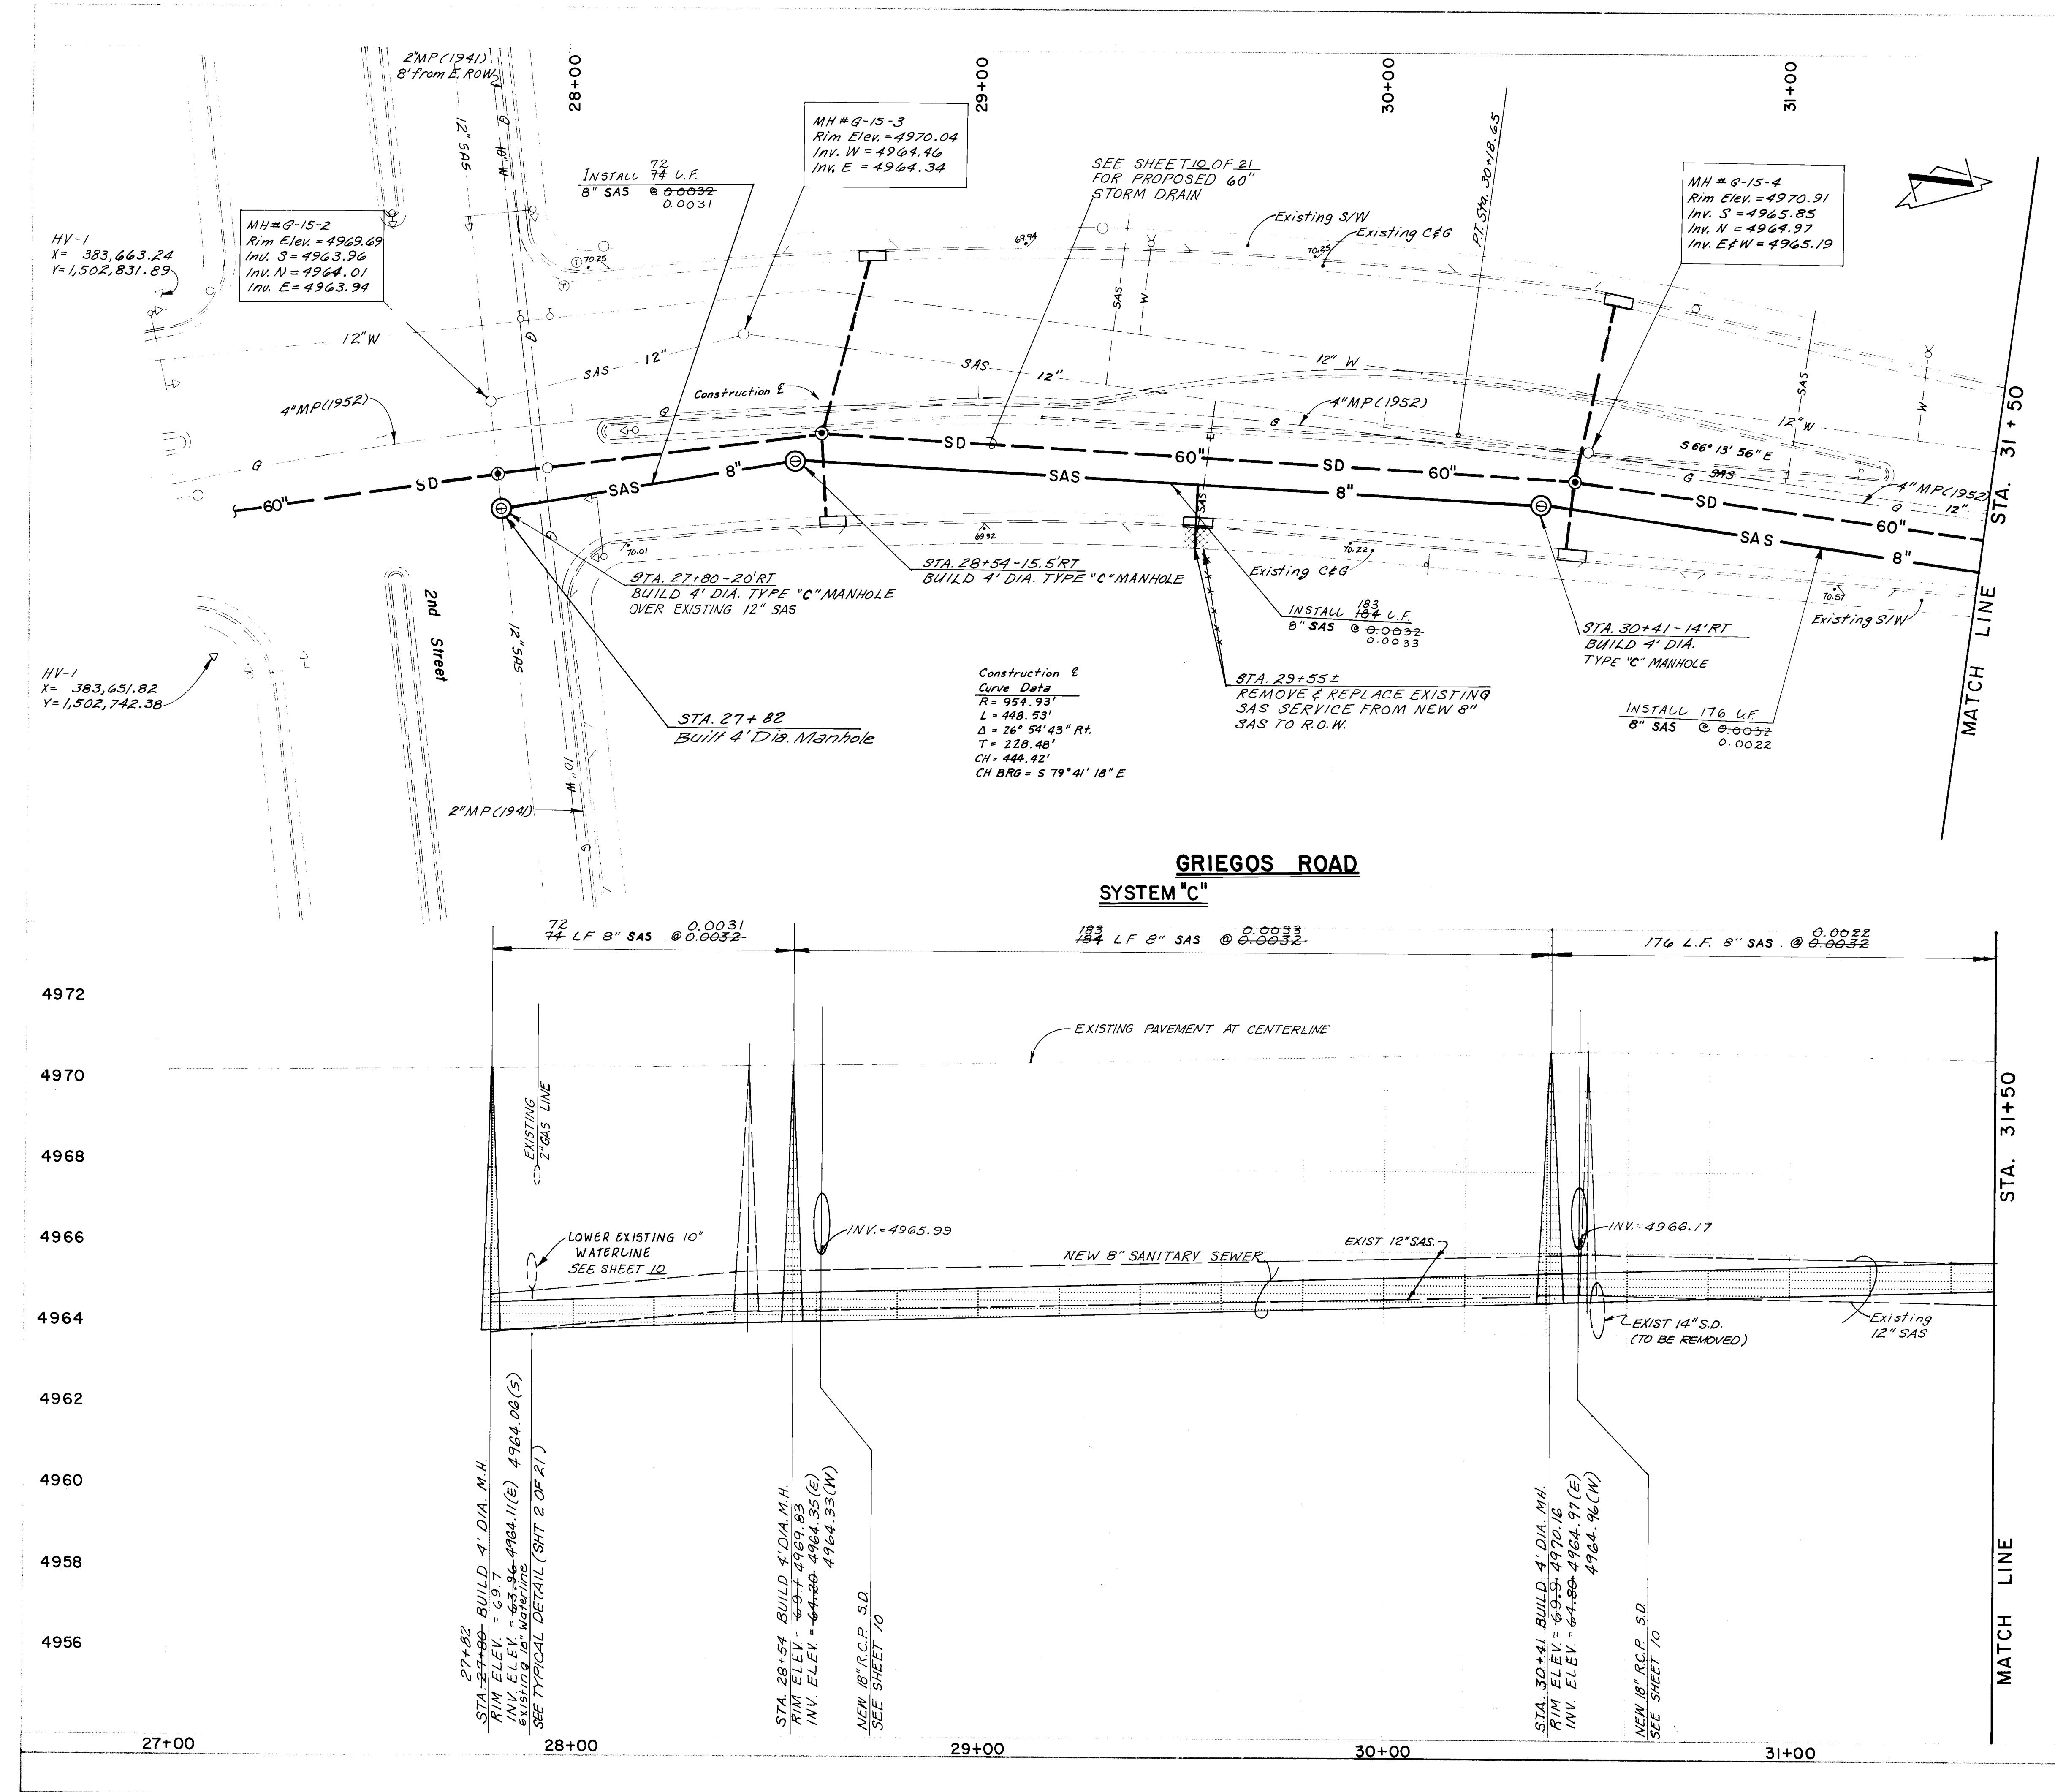

NOTES	
1. All spot elevations shown are at existing top of curb unless otherwise noted.	
2. It will be the responsibility of the Contractor to support all gas mains and service lines where they are within the area of excavation.	
3. See sheet 10 for approximate limits of pavement removal.	
4.5 BUILD INFORMATION	
NMSHC Brass Tablet Stamped "STA NM47-9"	
Set in the Top of a Concrete Post with the Ground in the Center Island of 2nd Street	
125' N of North of Pleasant Street Elev. = 4972.038	
5. DRAWINGS	
DRAWINGS BY Scanlon & Associates Inc. DATE 11-88	
CORRECTED BY Scanlon & Associates Inc. DATE 11-88	
MICRO-FILM INFORMATION	
RECORDED BY NO	

NO.	BY	INFORMATION	BENCH MARKS
1		NMSHC Brass Tablet Stamped "STA NM47-9"	
2		Set in the Top of a Concrete Post with the Ground in the Center Island of 2nd Street	
3		125' N of North of Pleasant Street Elev. = 4972.038	
NO.	BY	FIELD NOTES	DATE
4		SEE SHEET 10 OF 21 FOR PROPOSED 60" STORM DRAIN	11-88
NO.	BY	INFORMATION	BENCH MARKS
5		NMSHC Brass Tablet Stamped "STA NM47-9"	
6		Set in the Top of a Concrete Post with the Ground in the Center Island of 2nd Street	
7		125' N of North of Pleasant Street Elev. = 4972.038	
NO.	BY	INFORMATION	BENCH MARKS
8		NMSHC Brass Tablet Stamped "STA NM47-9"	
9		Set in the Top of a Concrete Post with the Ground in the Center Island of 2nd Street	
10		125' N of North of Pleasant Street Elev. = 4972.038	
NO.	BY	INFORMATION	BENCH MARKS
11		NMSHC Brass Tablet Stamped "STA NM47-9"	
12		Set in the Top of a Concrete Post with the Ground in the Center Island of 2nd Street	
13		125' N of North of Pleasant Street Elev. = 4972.038	
NO.	BY	INFORMATION	BENCH MARKS
14		NMSHC Brass Tablet Stamped "STA NM47-9"	
15		Set in the Top of a Concrete Post with the Ground in the Center Island of 2nd Street	
16		125' N of North of Pleasant Street Elev. = 4972.038	
NO.	BY	INFORMATION	BENCH MARKS
17		NMSHC Brass Tablet Stamped "STA NM47-9"	
18		Set in the Top of a Concrete Post with the Ground in the Center Island of 2nd Street	
19		125' N of North of Pleasant Street Elev. = 4972.038	
NO.	BY	INFORMATION	BENCH MARKS
20		NMSHC Brass Tablet Stamped "STA NM47-9"	
21		Set in the Top of a Concrete Post with the Ground in the Center Island of 2nd Street	
22		125' N of North of Pleasant Street Elev. = 4972.038	
NO.	BY	INFORMATION	BENCH MARKS
23		NMSHC Brass Tablet Stamped "STA NM47-9"	
24		Set in the Top of a Concrete Post with the Ground in the Center Island of 2nd Street	
25		125' N of North of Pleasant Street Elev. = 4972.038	
NO.	BY	INFORMATION	BENCH MARKS
26		NMSHC Brass Tablet Stamped "STA NM47-9"	
27		Set in the Top of a Concrete Post with the Ground in the Center Island of 2nd Street	
28		125' N of North of Pleasant Street Elev. = 4972.038	
NO.	BY	INFORMATION	BENCH MARKS
29		NMSHC Brass Tablet Stamped "STA NM47-9"	
30		Set in the Top of a Concrete Post with the Ground in the Center Island of 2nd Street	
31		125' N of North of Pleasant Street Elev. = 4972.038	
NO.	BY	INFORMATION	BENCH MARKS
32		NMSHC Brass Tablet Stamped "STA NM47-9"	
33		Set in the Top of a Concrete Post with the Ground in the Center Island of 2nd Street	
34		125' N of North of Pleasant Street Elev. = 4972.038	
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35		NMSHC Brass Tablet Stamped "STA NM47-9"	
36		Set in the Top of a Concrete Post with the Ground in the Center Island of 2nd Street	
37		125' N of North of Pleasant Street Elev. = 4972.038	
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38		NMSHC Brass Tablet Stamped "STA NM47-9"	
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40		125' N of North of Pleasant Street Elev. = 4972.038	
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41		NMSHC Brass Tablet Stamped "STA NM47-9"	
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43		125' N of North of Pleasant Street Elev. = 4972.038	
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46		125' N of North of Pleasant Street Elev. = 4972.038	
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47		NMSHC Brass Tablet Stamped "STA NM47-9"	
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49		125' N of North of Pleasant Street Elev. = 4972.038	
NO.	BY	INFORMATION	BENCH MARKS
50		NMSHC Brass Tablet Stamped "STA NM47-9"	
51		Set in the Top of a Concrete Post with the Ground in the Center Island of 2nd Street	
52		125' N of North of Pleasant Street Elev. = 4972.038	
NO.	BY	INFORMATION	BENCH MARKS
53		NMSHC Brass Tablet Stamped "STA NM47-9"	
54		Set in the Top of a Concrete Post with the Ground in the Center Island of 2nd Street	
55		125' N of North of Pleasant Street Elev. = 4972.038	
NO.	BY	INFORMATION	BENCH MARKS
56		NMSHC Brass Tablet Stamped "STA NM47-9"	
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59		NMSHC Brass Tablet Stamped "STA NM47-9"	
60		Set in the Top of a Concrete Post with the Ground in the Center Island of 2nd Street	
61		125' N of North of Pleasant Street Elev. = 4972.038	
NO.	BY	INFORMATION	BENCH MARKS
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67		125' N of North of Pleasant Street Elev. = 4972.038	
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68		NMSHC Brass Tablet Stamped "STA NM47-9"	
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70		125' N of North of Pleasant Street Elev. = 4972.038	
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71		NMSHC Brass Tablet Stamped "STA NM47-9"	
72		Set in the Top of a Concrete Post with the Ground in the Center Island of 2nd Street	
73		125' N of North of Pleasant Street Elev. = 4972.038	
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98		NMSHC Brass Tablet Stamped "STA NM47-9"	
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101		NMSHC Brass Tablet Stamped "STA NM47-9"	
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124		125' N of North of Pleasant Street Elev. = 4972.038	
NO.	BY	INFORMATION	BENCH MARKS
125		NMSHC Brass Tablet Stamped "STA NM47-9	



Scanton Job No. 85113

RECORD DRAWING

ENGINEER'S SEAL

DESIGNED BY S.A.V. DATE FEB 86

DRAWN BY C.L.W. DATE FEB 86

CHECKED BY

REGISTERED PROFESSIONAL ENGINEER

NO. DATE

REVISIONS

REMARKS

SCALES

HORIZONTAL 1" = 20'
VERTICAL 1" = 2'

CITY OF ALBUQUERQUE MUNICIPAL DEVELOPMENT DEPARTMENT ENGINEERING DIVISION

**TITLE: NORTH VALLEY DRAINAGE SYSTEM IMPROVEMENTS
GRIGEOS ROAD SYSTEM (C)
SANITARY SEWER - STATION 31+50 TO 36+00**


APPROVALS

City Engineer	Engineer	Date	Approvals	Engineer	Date
ACE - Design	"	"	Liquid Waste	"	"
ACE - Hydrology	Stan Bolger	10/23/01	Traffic	"	"
			Water	"	"

DRAWING NO. 2461

MAP NO. G-15

SHEET 17 OF 21

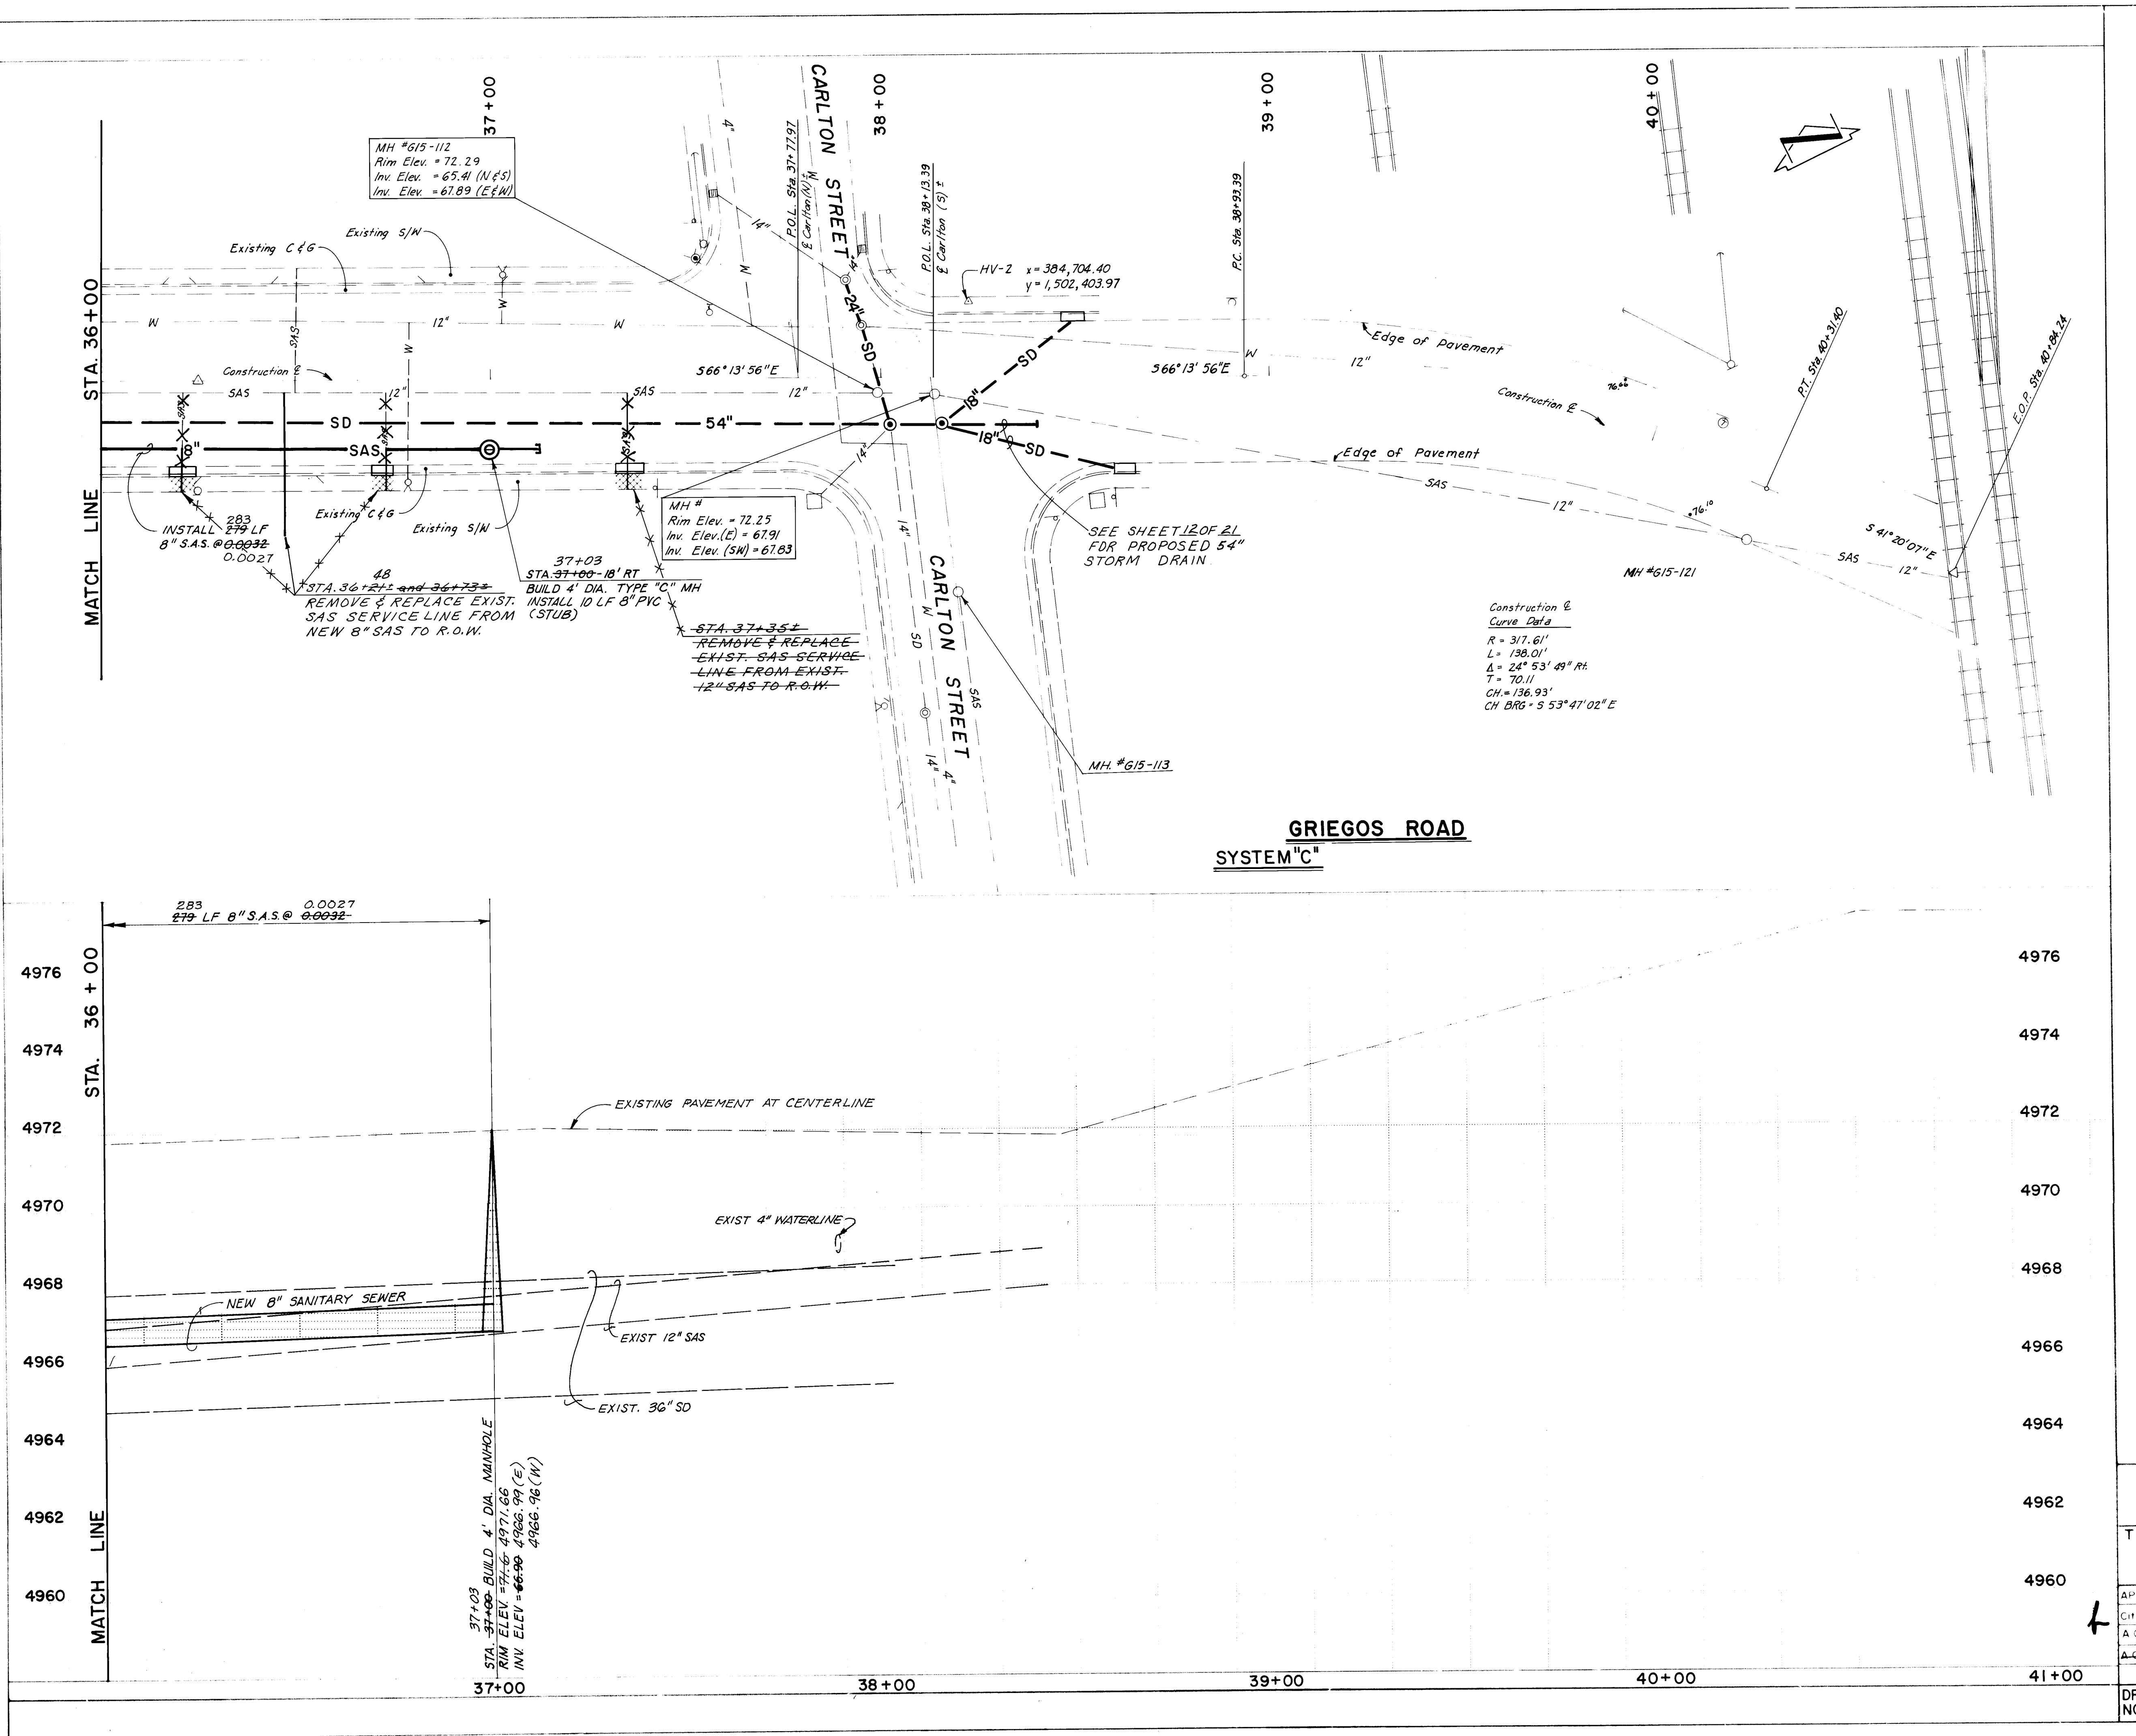

NOTES

All spot elevations shown are at existing top of curb unless otherwise noted.

It will be the responsibility of the Contractor to support all gas mains and service lines where they are within the area of excavation.

See sheet 12 for approximate limits for pavement removal.

NOTES					
1. All spot elevations shown are at existing top-of-curb unless otherwise noted.					
2. All R.C.P shall be ASTM C-76, Class IV.					
3. It will be the responsibility of the Contractor to support all gas mains and Service Lines where they are within the area of excavation.					

AS BUILT INFORMATION					
SURVEY INFORMATION		BENCH MARKS		FIELD NOTES	
CONTRACTOR	NMSHC Brass Tablet Stamped "STA. NM47-9"	WORK	Set in the Top of a Concrete Post Flush with	NO.	DATE
INSPECTORS	the Ground in the Center Island of 2nd Street	FIELD	125' + North of Pleasant Street	RECORDED BY	DATE
VERIFIED BY	Elev. = 4972.038	DRAWINGS BY	Micro-Film Information	RECORDED BY	DATE
DRAWINGS BY	NO.	RECORDED BY	NO.	RECORDED BY	DATE




[Signature]

26 24611988

CITY OF ALBUQUERQUE
MUNICIPAL DEVELOPMENT DEPARTMENT
ENGINEERING DIVISION


TITLE: NORTH VALLEY DRAINAGE SYSTEM IMPROVEMENTS
OUTLET STRUCTURE PLAN AND DETAILS
GRIEGOS ROAD SYSTEM

APPROVALS	ENGINEER	DATE	APPROVALS	ENGINEER	DATE
City Engineer	<i>H.H. [initials]</i>		Liquid Waste	<i>PEDO</i>	10/27/87
A.C.E. Design	"	"	Traffic	<i>JRC</i>	10/27/87
A.C.E-Hydrology	<i>Stan Bolley</i>	10/23/87	Water	<i>PEDO</i>	10/27/87
DRAWING NO.	2461		MAP NO.	G-15	SHEET 19 OF 21

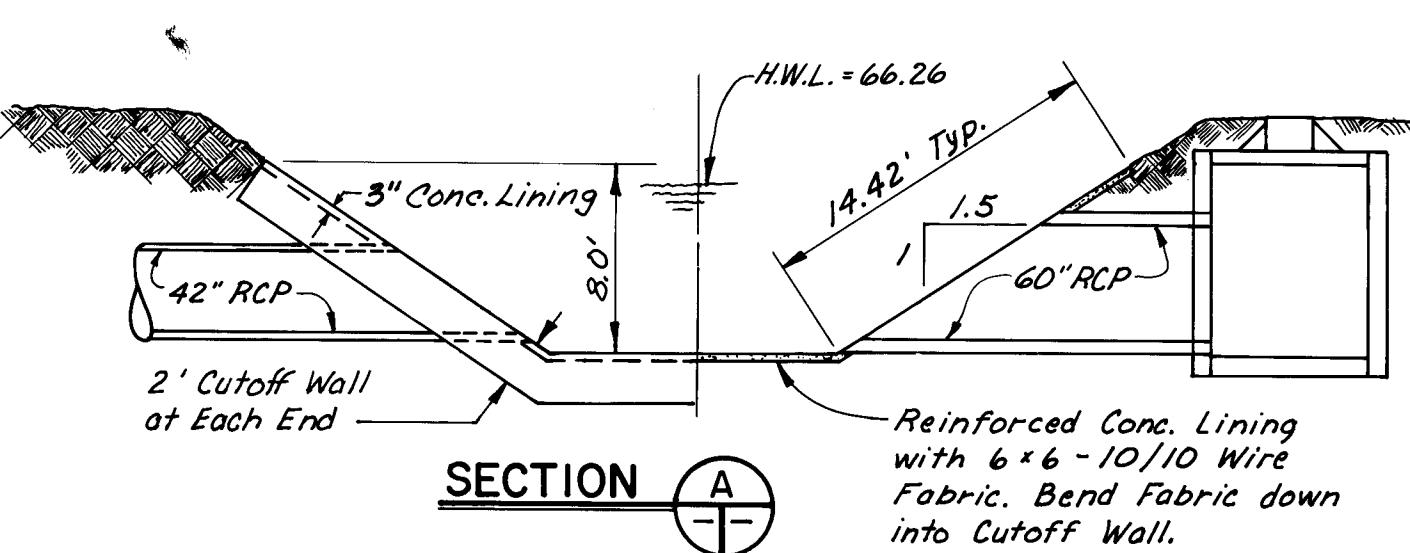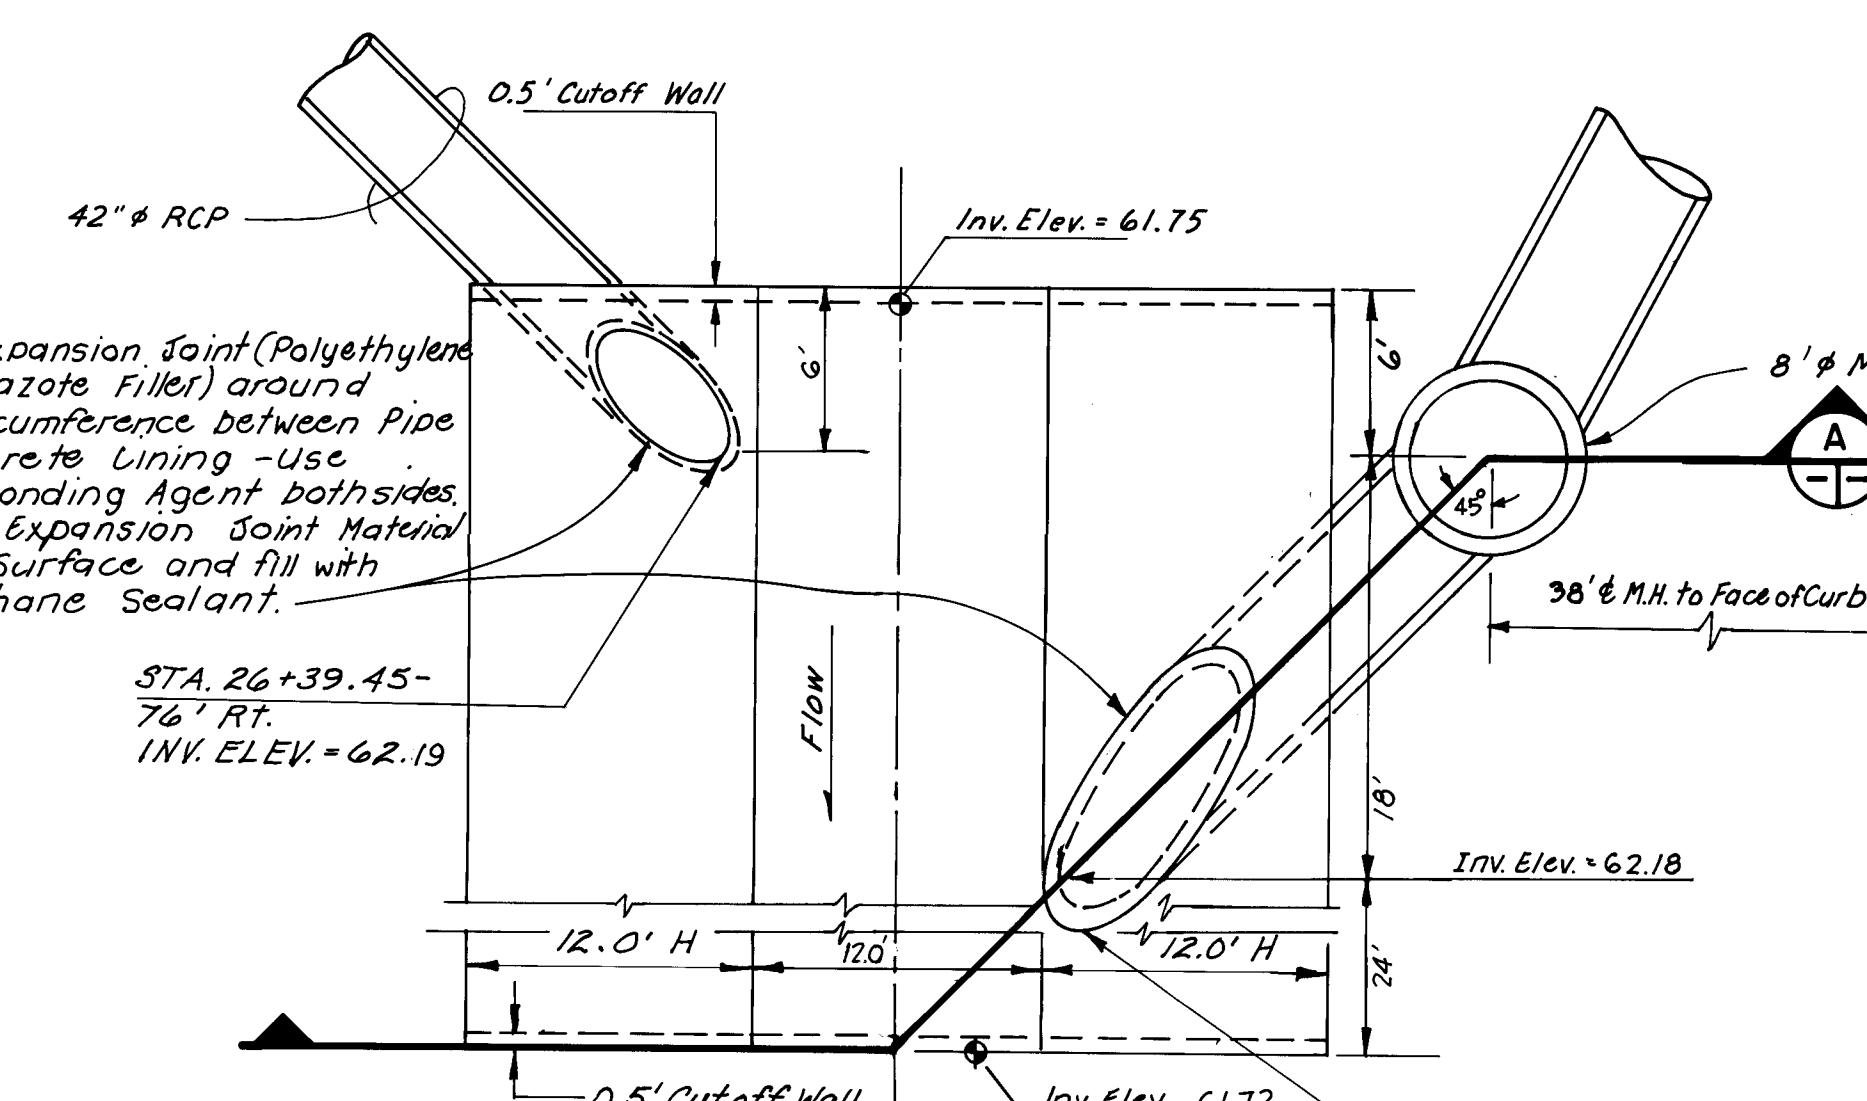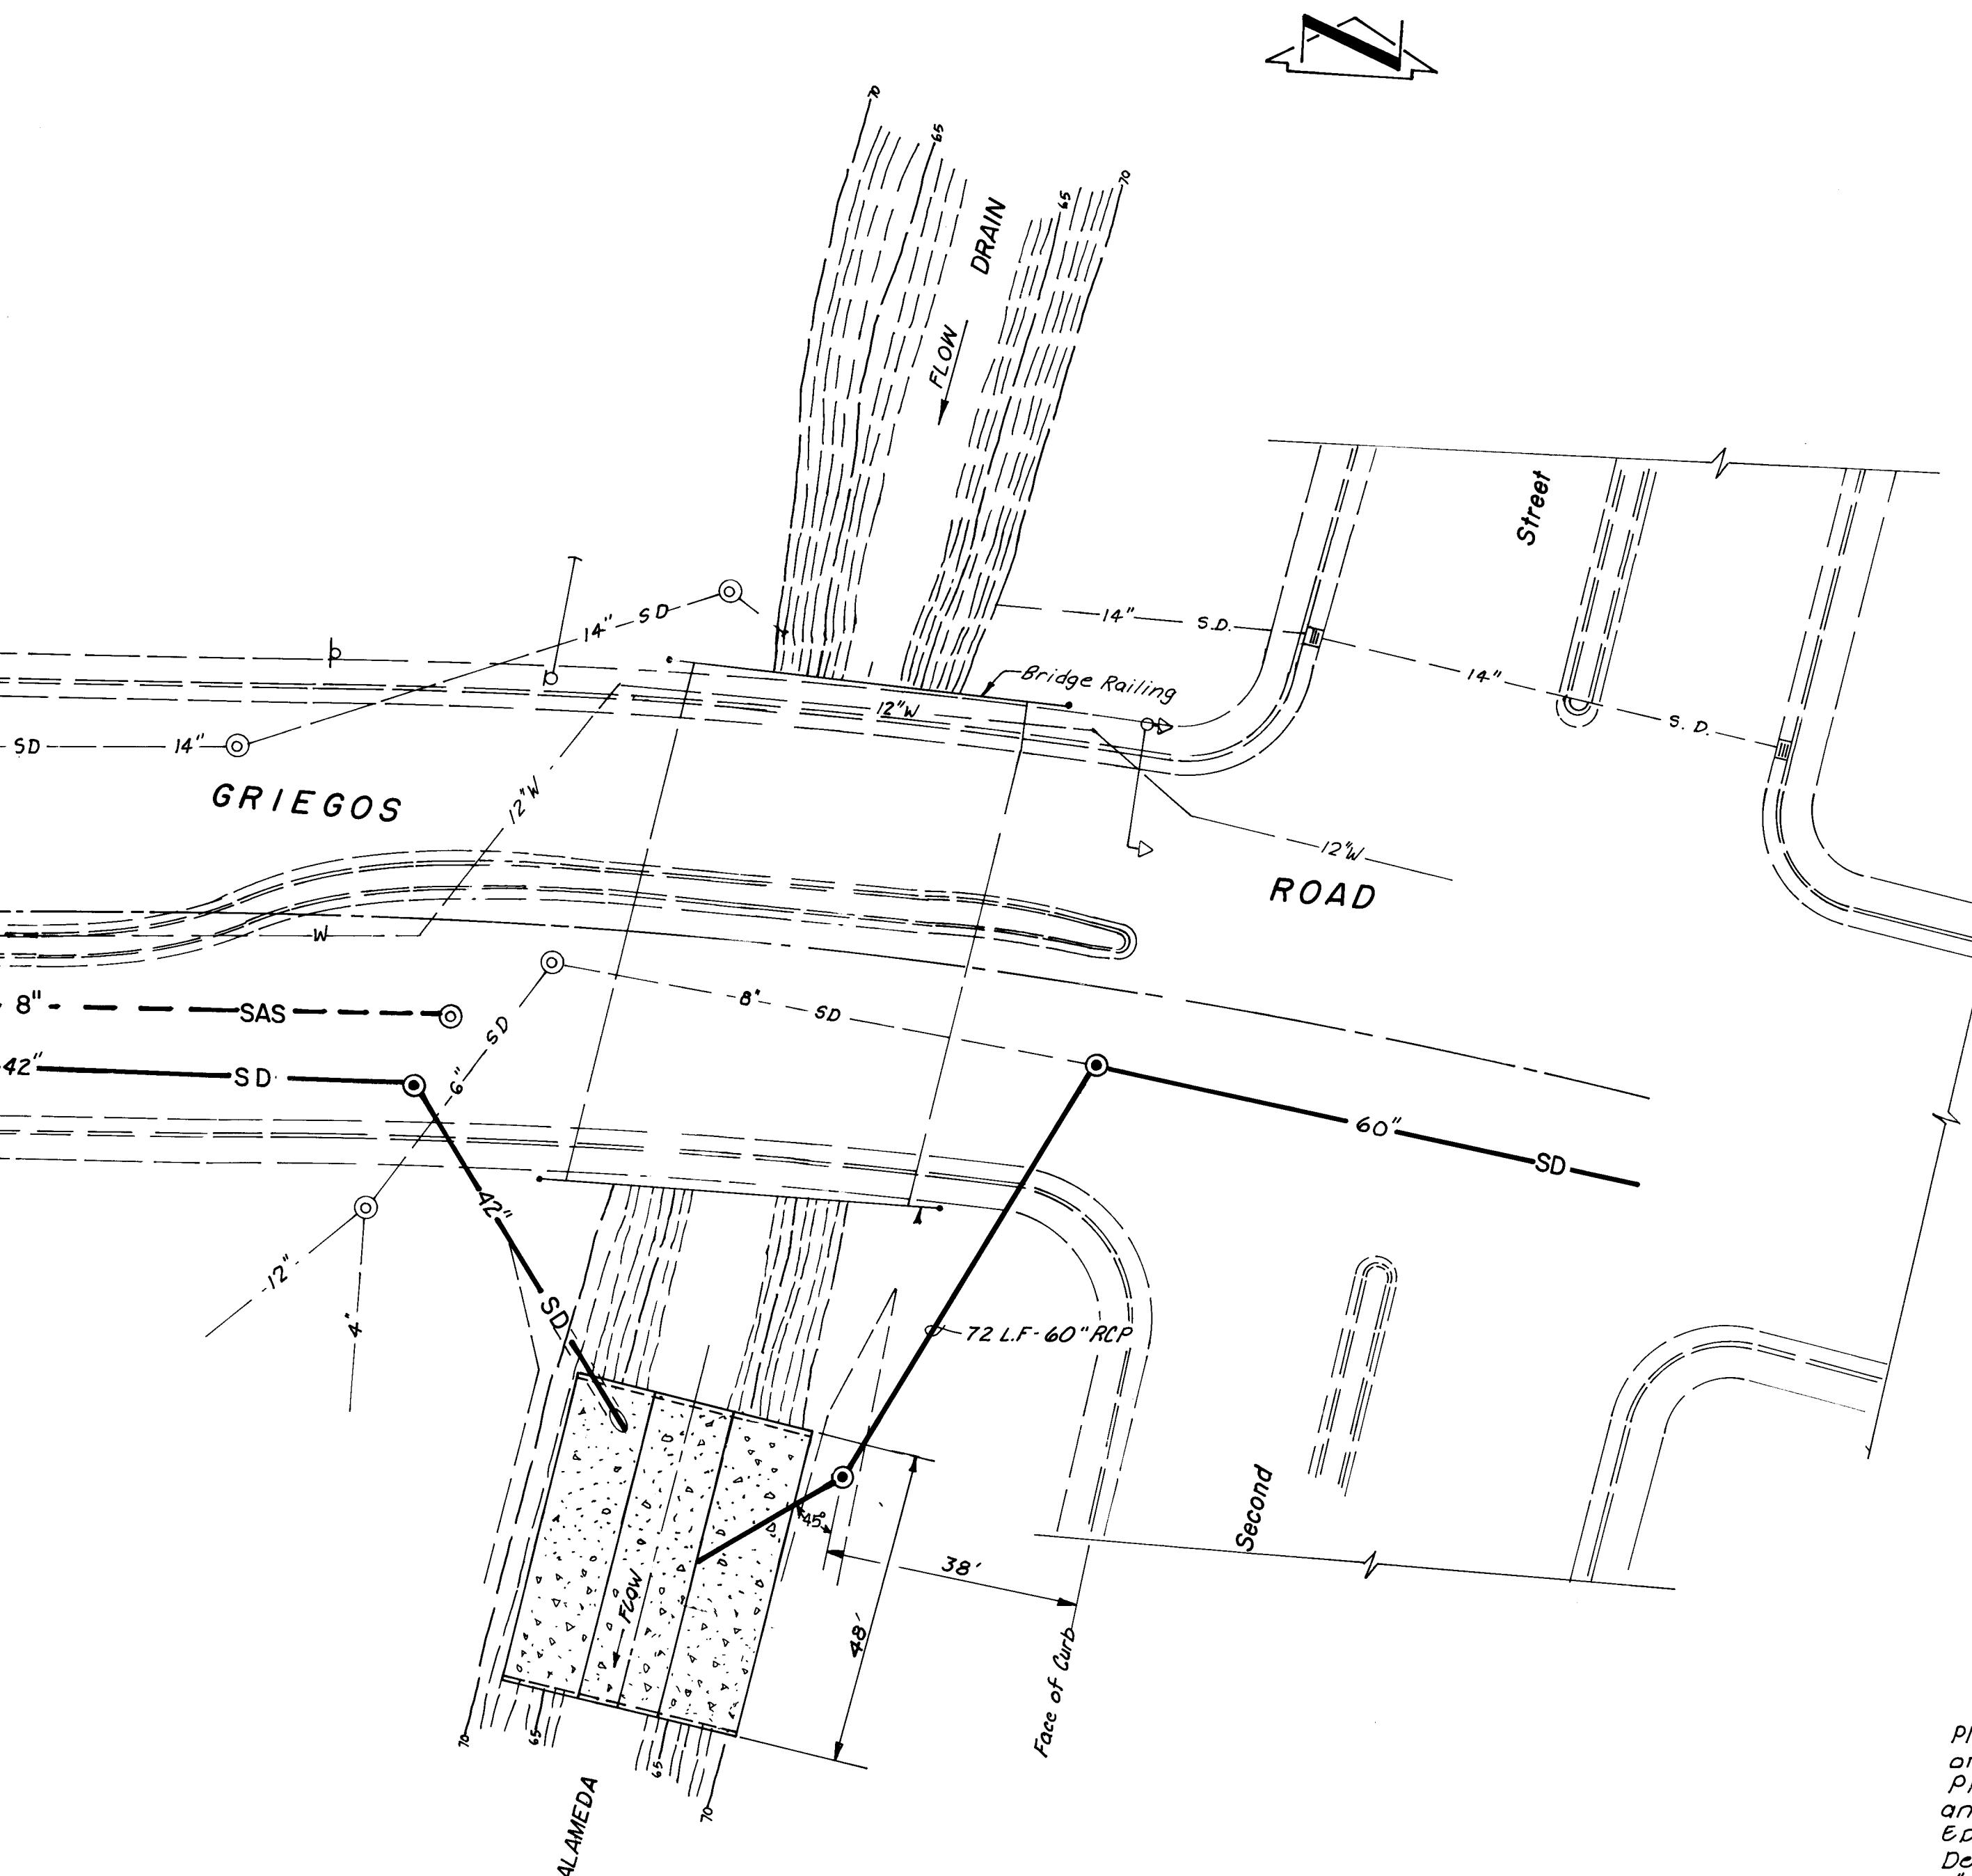


SOUTH OUTLET STRUCTURE


Scale: 1/8" = 1'-0"

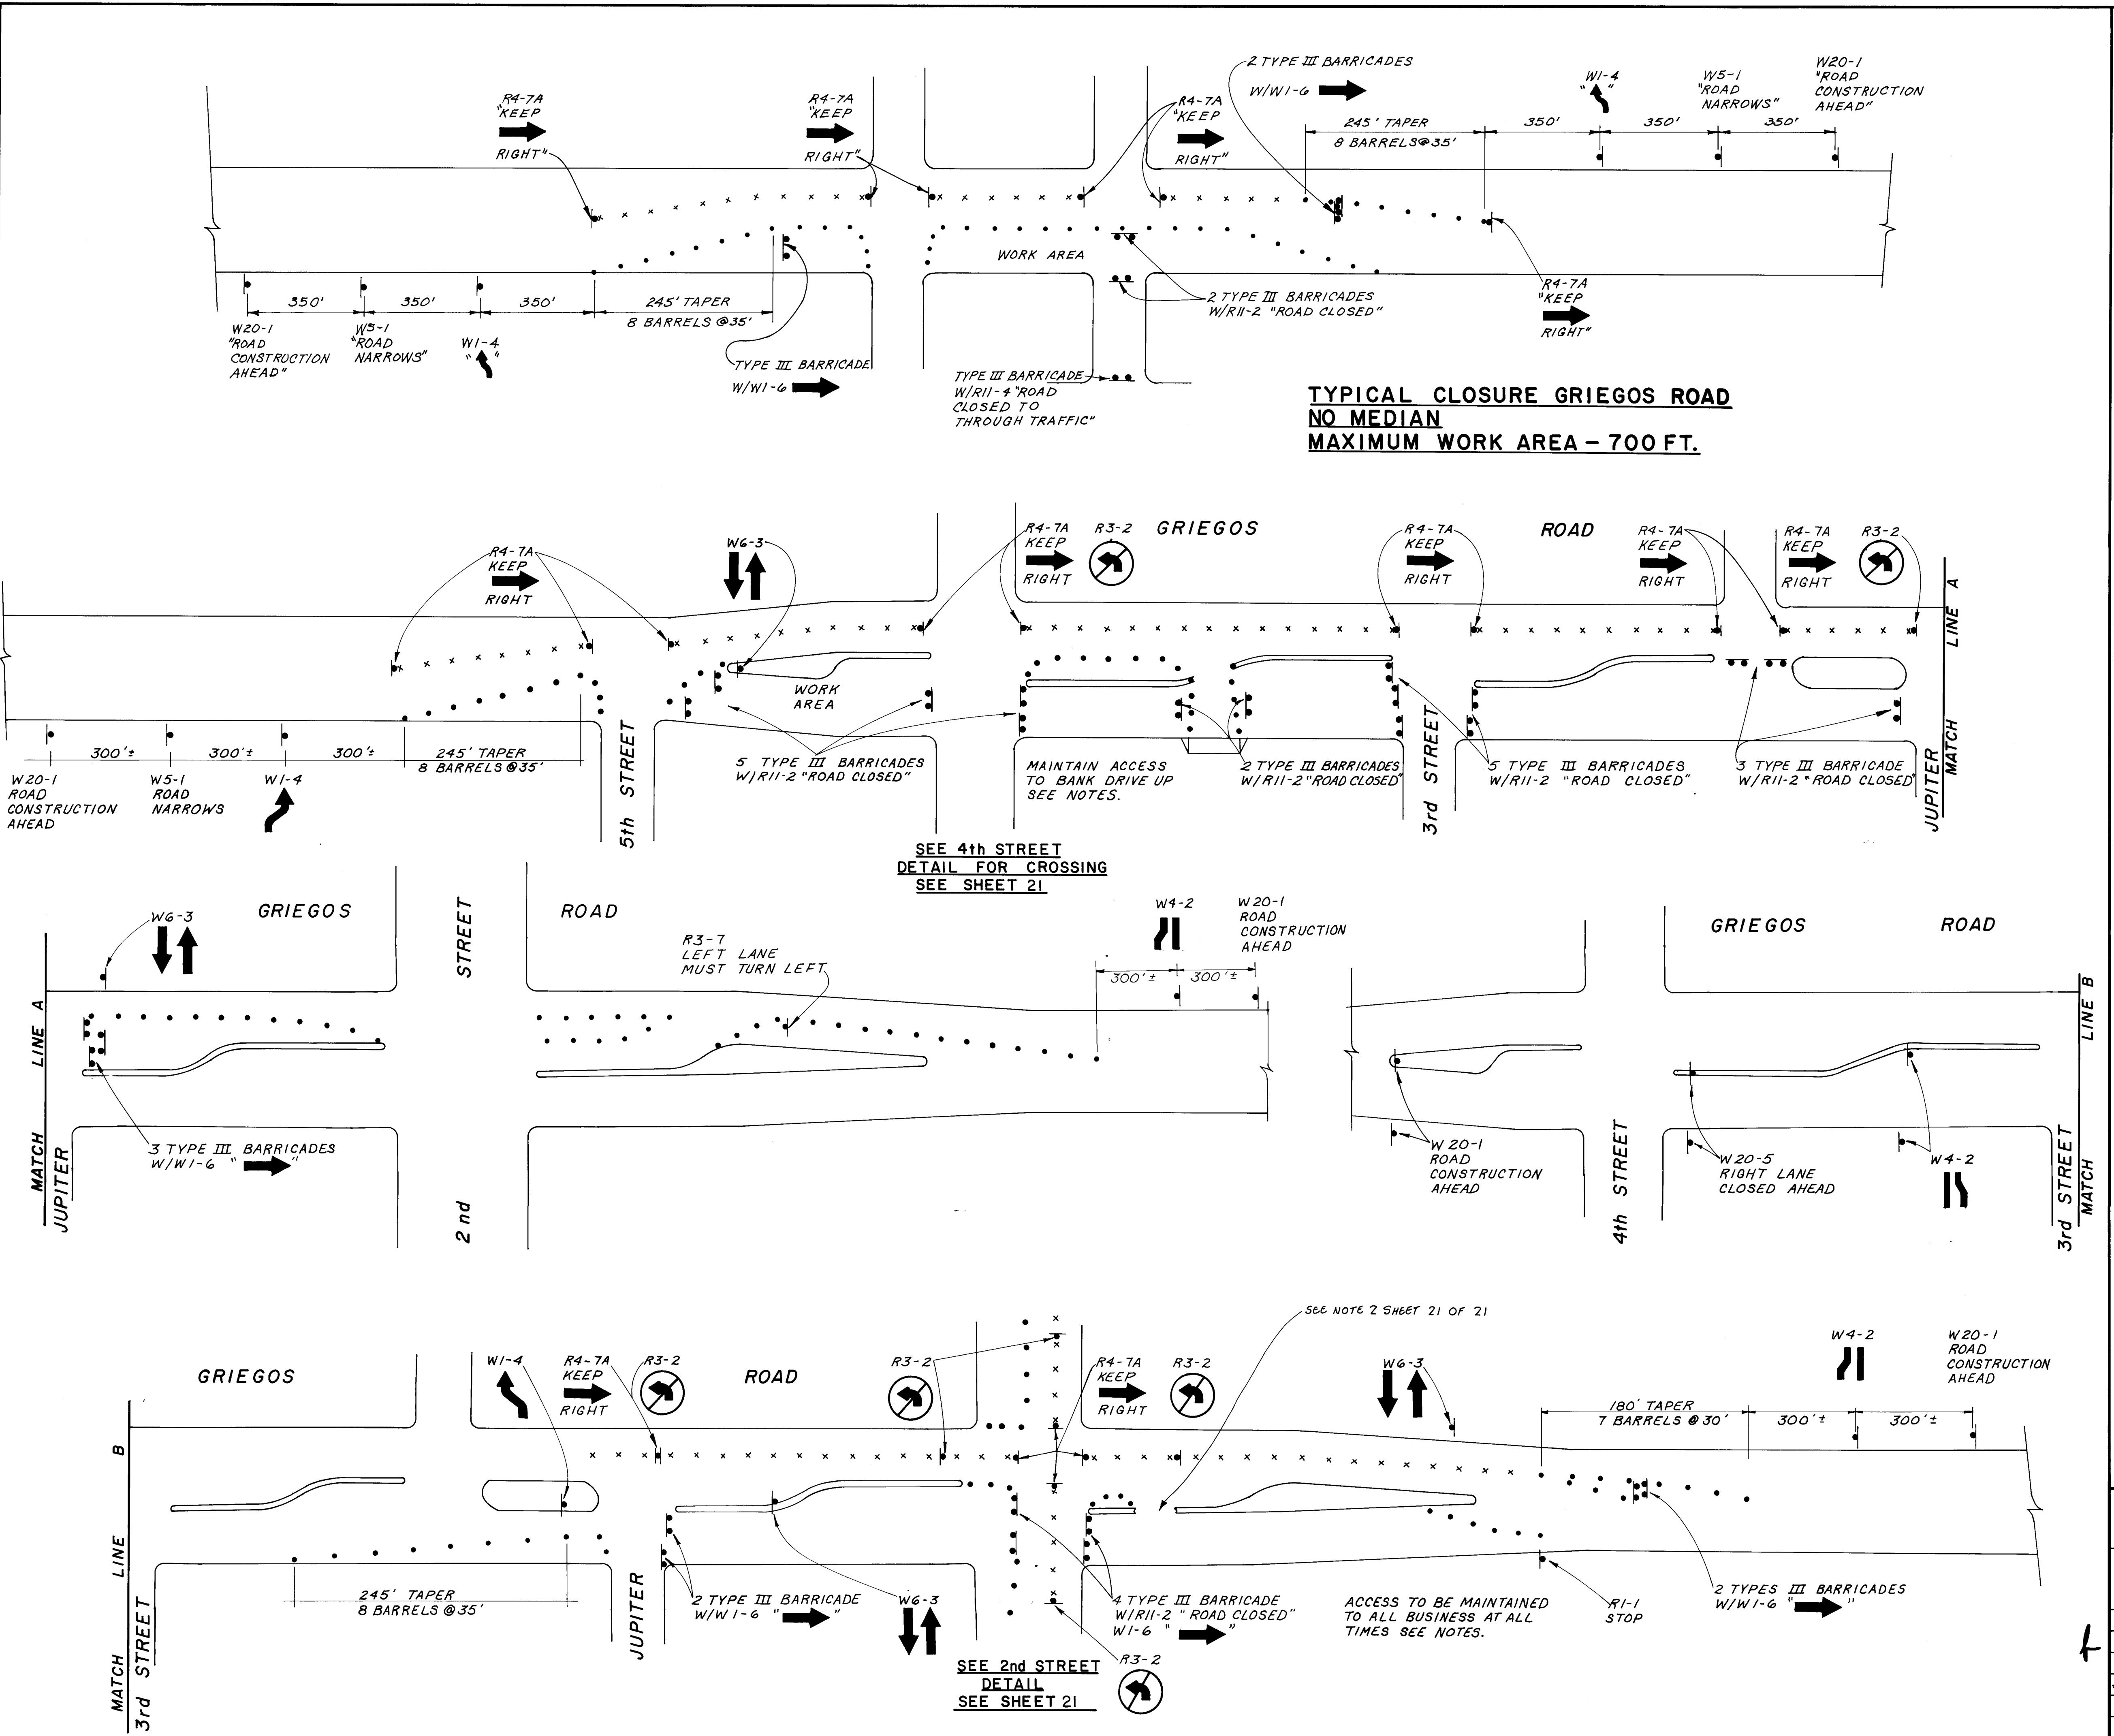


NOTES

1. See Traffic Control Notes Sheet
3 of 21.

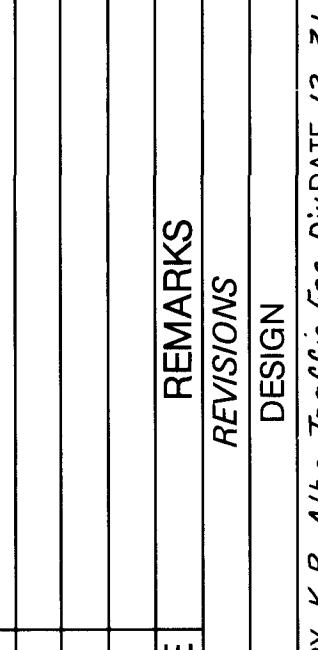SURVEY INFORMATION					
FIELD NOTES		BENCH MARKS		AS BUILT INFORMATION	
NMSHC Brass Tablet Stamped "STA. NM47-9		Set in the Top of a Concrete Post Flush with the Ground in the Center Island of 2nd Street		CONTRACTOR WORK STAKED BY INSPECTOR'S ACCEPTANCE BY FIELD VERIFICATION BY DRAWINGS CORRECTED BY	
NO. BY DATE		125' + North of Pleasant Street ELEV. = 4972.038		DATE DATE DATE DATE	
ENGINEER'S SEAL					
					
MICRO-FILM INFORMATION					
RECORDED BY K.B. A/bq. Traffic Eng. Div. DATE 10/27/86		DRAWN BY CW RLH DATE 10/27/86		CHECKED BY DATE	
REV/S/ONS DESIGN					
26 24612088					
CITY OF ALBUQUERQUE MUNICIPAL DEVELOPMENT DEPARTMENT ENGINEERING DIVISION					
TITLE: NORTH VALLEY DRAINAGE SYSTEM IMPROVEMENTS TRAFFIC CONTROL PLAN GRIEGOS ROAD SYSTEMS (B & C)					
APPROVALS		APPROVALS		APPROVALS	
City Engineer		Liquid Waste		Engineer DATE	
A.C.E. Design		Traffic		PEGO 10/27/86	
C.E.-Hydrology		Water		PEGO 10/27/86	
DRAWING NO.		MAP NO.		SHEET OF	
2461		G-15		20 21	

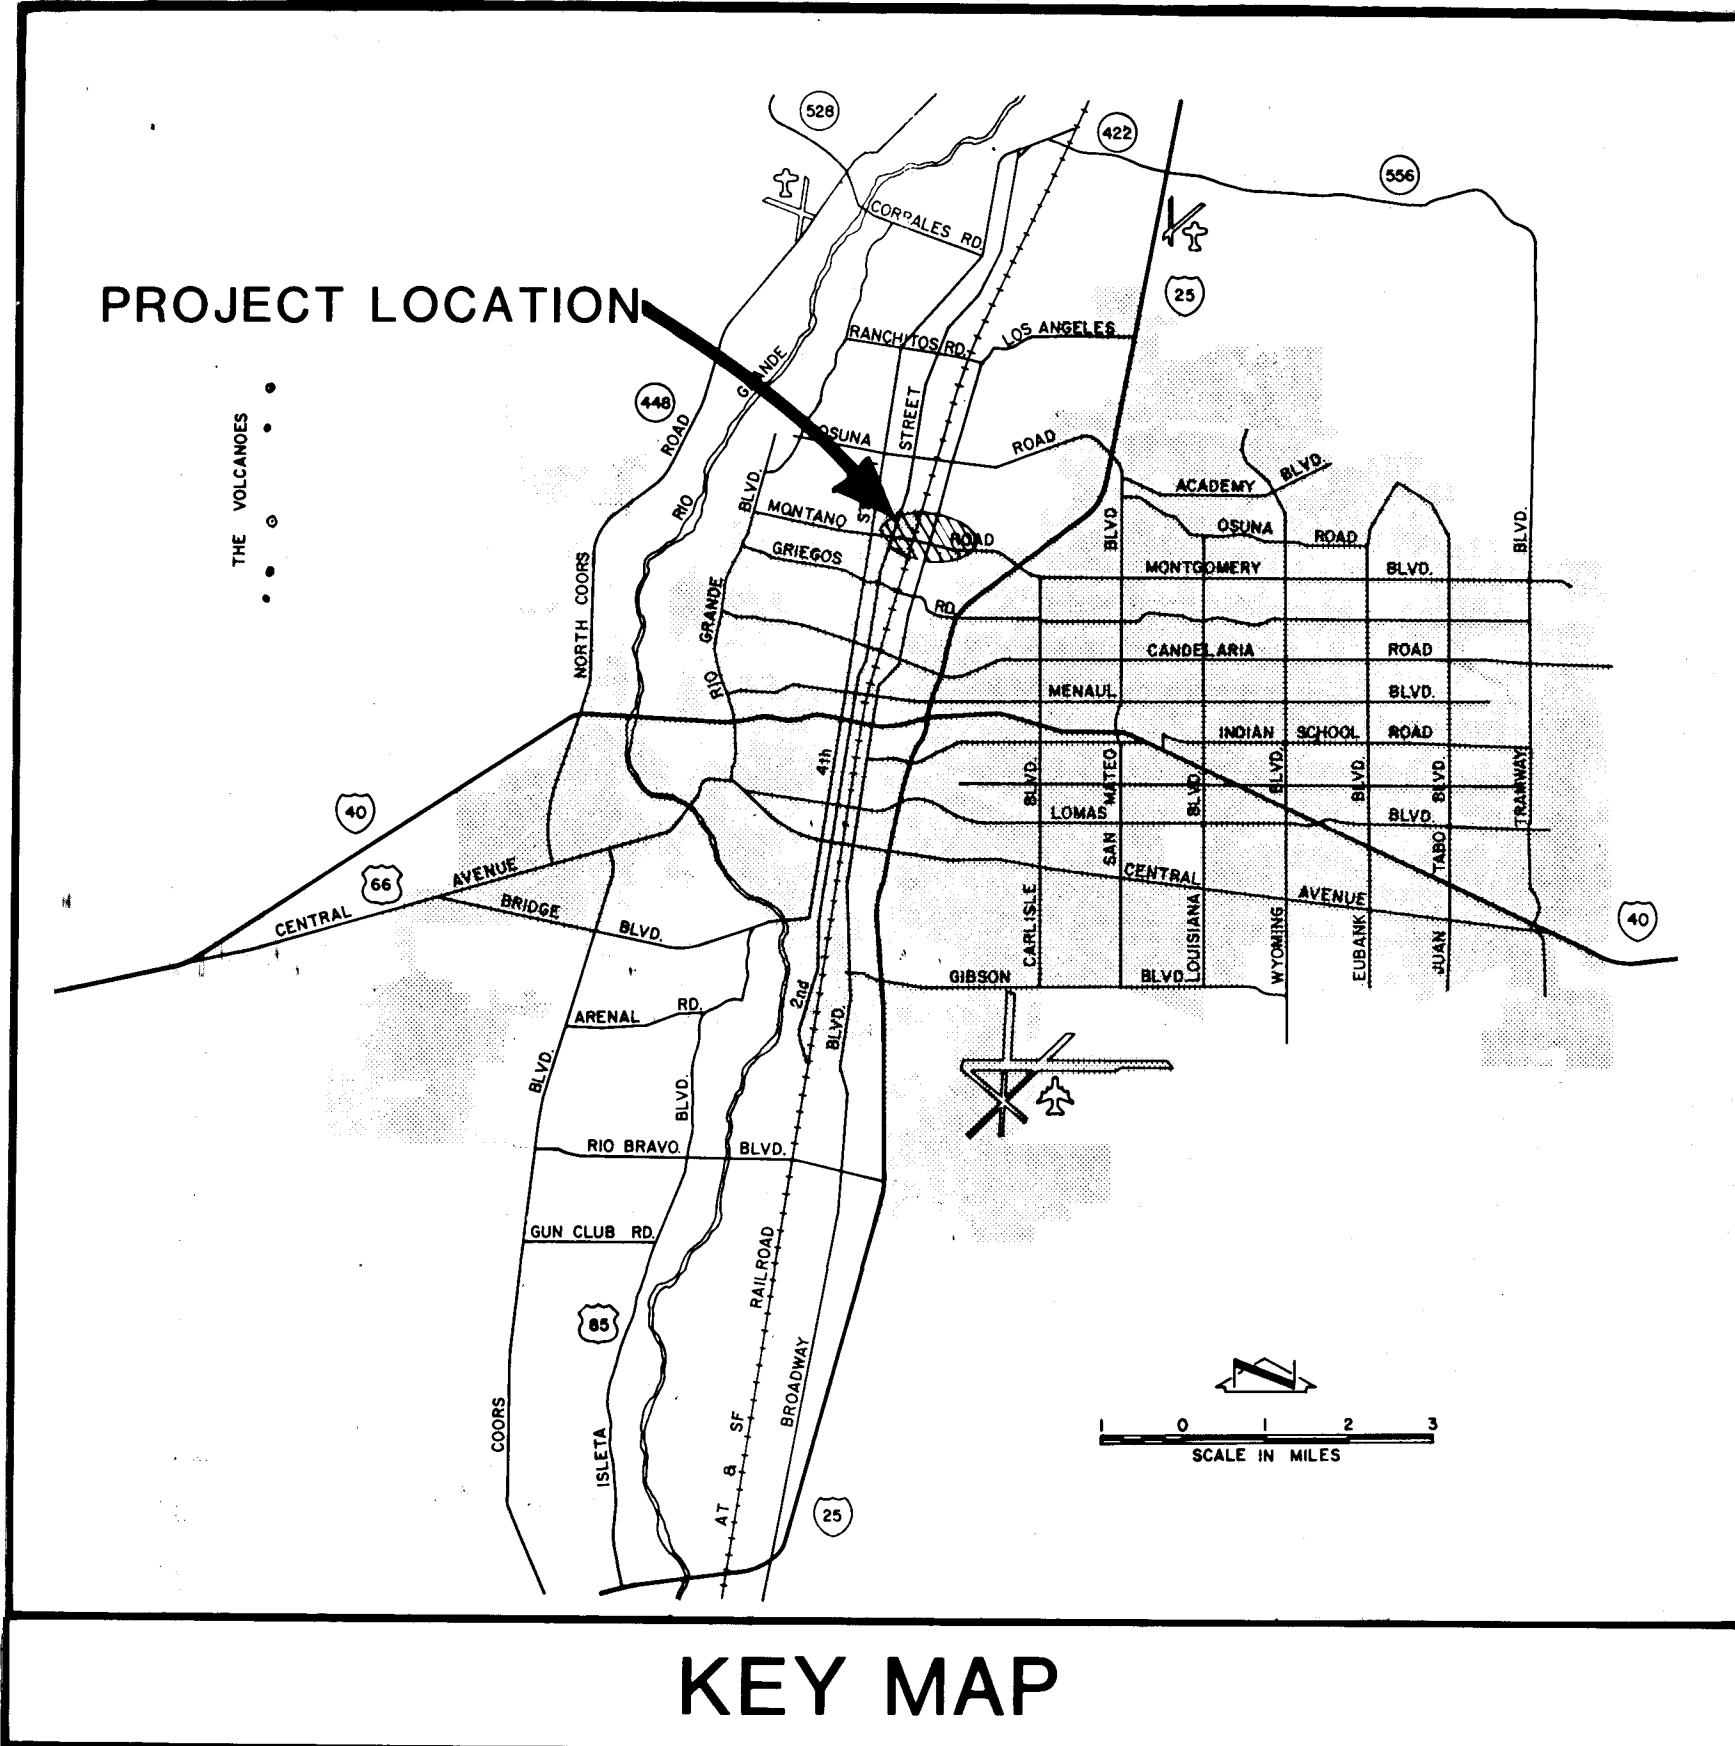

CITY OF ALBUQUERQUE

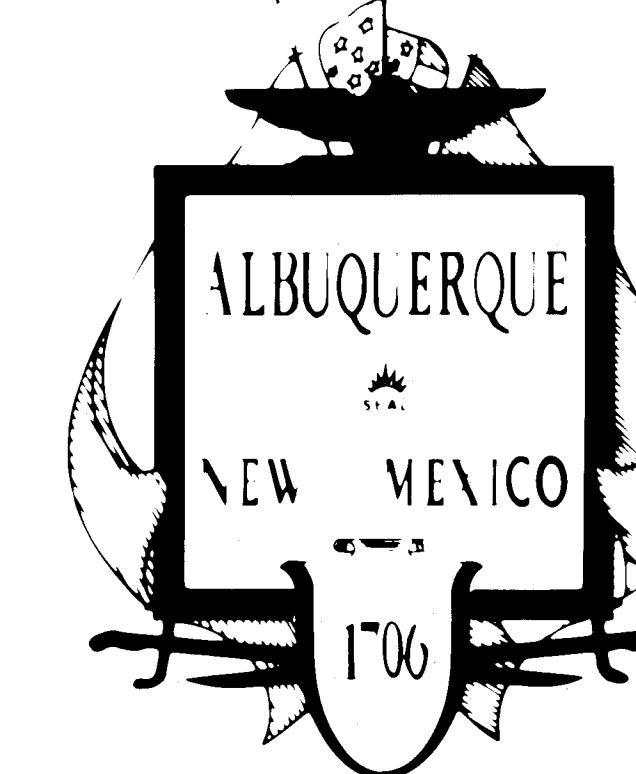

NEW MEXICO

INDEX TO SHEETS

SHT. NO.	DESCRIPTION
1.	TITLE SHEET
2.	GENERAL NOTES AND DETAILS
3-17.	MONTANO ROAD SYSTEM (A)
3.	SITE PLAN, LEGEND, AND TRAFFIC CONTROL NOTES
4.	STORM DRAIN PLAN-PROFILE STA. 1+66 to 4+50
5.	STA. 4+50 to 9+00
6.	STA. 9+00 to 13+75
7.	STA. 13+75 to 18+00
8.	STA. 18+00 to 22+50
9.	STA. 22+50 to 27+00
10.	STA. 27+00 to 31+50
11.	STA. 31+50 to 36+00
12.	STA. 36+00 to 40+50
13.	STA. 40+50 to 45+00
14.	STA. 45+00 to 46+92.55
15.	SANITARY SEWER PLAN-PROFILE STA. 7+00 to 12+00
16.	STA. 12+00 to 17+00
17.	OUTLET STRUCTURE PLAN AND DETAILS
18-19.	TRAFFIC CONTROL PLAN

CONSTRUCTION PLANS FOR NORTH VALLEY DRAINAGE SYSTEM IMPROVEMENTS MONTANO ROAD SYSTEM (A)

26 24610188


REV.	Sheets	CITY	ENGR.	DATE	USER	DEPT.	DATE	USER	DEPT.	DATE
APPROVAL OF REVISIONS										
CITY OF ALBUQUERQUE										
APPROVED FOR CONSTRUCTION										
O SCANLON ASSOCIATES										
 SHEET 1 OF 19										
DRAWING NO. 2461 MAP NO. _____										

SET NO.

JOB NO. 85113


GENERAL NOTES

1. The City of Albuquerque Interim Standard Specifications for Public Works Construction, 1985 Edition, and any revisions and/or additions in the Specifications and Contract Documents, shall govern the construction of this project.
2. The Contractor shall notify all utility companies when working near their systems. Two days prior to any excavation, Contractor must contact Line Locating Service, 765-1234, for location of existing utilities.
3. All existing utilities shown here were taken as accurately as possible from record drawings and surface indications. It shall be the Contractor's responsibility to protect, maintain in service, and verify exact locations of all affected utilities during construction of this project, including service lines.
4. All utilities which are to be abandoned under this contract shall be plugged with concrete at each end of the portion to be abandoned. Payment for this work will be made on the basis of the contract unit price bid.
5. Curb return radii and street widths are to the face of the curb unless otherwise indicated in the plans.
6. Where removal of existing curb and gutter or sidewalk is required, remove to the nearest joint or saw cut.
7. When abutting new paving to existing, saw cut existing paving on a right angle, or as required by the Project Engineer to remove any broken, raveled, or cracked paving and match the new paving grade to the existing. No separate payment shall be made for saw cut but shall be considered incidental to the Contract Unit Price for pavement removal and replacement.
8. Curb and gutter shown as existing and not to be removed under this contract which is damaged or displaced by the Contractor or his subcontractors, shall be replaced by the Contractor at his expense.
9. Existing materials to be removed and paid for on a unit price basis shall be measured and the quantities approved by the Engineer before removal.
10. Remove all valve boxes from abandoned water lines. Payment will be considered incidental to the contract unit price for pavement removal and replacement.
11. All abandoned valve and meter box frames and covers shall be returned to the Water System Division city yard and all storm and sanitary manhole lids and inlet grates, castings, and frames not reused and in usable condition, shall be returned to the Liquid Waste Division warehouse. There shall be no direct payment for these items. Cost shall be considered incidental to other items of work.
12. The maximum allowable quantities for payment for removal and replacement of pavement where water, sanitary sewer, and storm sewer are to be installed under existing pavement will be computed in accordance with the Contract Documents.
13. The Contractor shall expose existing water and sewer lines at locations where new storm sewer lines cross or parallel such lines in order to adequately establish the proximity of water and sewer lines. The cost of this work shall be incidental to other items of work.
14. Prior to construction, exploratory excavation may be required as directed by the Project Engineer to more specifically locate utility lines. There will be no direct payment for this item of work. Cost will be considered incidental to other items of work.
15. All water meters, water valve boxes, and sewer manholes in the construction area where street grades change are to be adjusted by the Contractor to finished grade under this contract. The Contractor shall be required to set reference points for locating manholes prior to any grading operation. Measurement and payment for this work shall be considered incidental to the unit price bid for pavement removal and replacement.
16. The Contractor will be responsible to replace at his expense any and all property corners destroyed in the process of construction. All property corners must be set by a Registered Land Surveyor.
17. The Contractor will be required to confine his work within the construction limits and/or right-of-way to preserve existing vegetation and private property. Contractor is not to store equipment or materials in R.O.W. overnight.
18. Mail boxes within new construction will be relocated to the right-of-way line by the U.S. Post Office. The Contractor shall coordinate relocation of mailboxes with property owner or resident and the U.S. Post Office. The Contractor shall notify the U.S. Post Office, Delivery and Collection Department, at least 48 hours in advance of construction affecting mailboxes. Cost of this work will be considered incidental to other items.
19. Utility relocation schedules shall be coordinated at the pre-construction conference.
20. Utility relocations required by the construction of this project are to be coordinated by the Contractor during construction. No additional compensation will be allowed for delays or inconveniences caused by utility company work crews. The Contractor may be required to reschedule his activities to allow utility crews to perform their required work.
21. Access to local business and residences shall be kept open at all times. In the event that access closures are unavoidable, closures must be scheduled at least twenty-four (24) hours in advance with property owners and approved by the Engineer. Access closures to business shall not exceed two (2) hours during business hours and for residences shall not exceed eight (8) hours. Alternate access provided if required.
22. All valve box rings and covers shall be painted with blue enamel or epoxy paint. Color shall be equivalent to "Safety Blue".
23. Sidewalks and wheelchair ramps within the curb returns shall be constructed wherever a new curb return is constructed. Wheelchair ramps shall be paid for at the unit price for sidewalks. If curb is depressed for a drivepad or wheelchair ramp, the ramp or drivepad shall be constructed prior to acceptance of the curb and gutter.
24. A disposal site for all excess excavation material, asphaltic paving, concrete paving, etc. shall be obtained by the Contractor, and approved by the Project Engineer in compliance with applicable regulations. All costs incurred in obtaining a disposal site and haul thereto shall be considered incidental to the contract unit price for other items.
25. Fifty ton roller operation shall not be used on this project where underground utilities are present. The required compaction of these locations shall be effected by other types of approved compaction methods.
26. All work on this project shall be performed in accordance with applicable Federal, State, and local laws, rules, and regulations concerning construction safety and health.
27. WARNING - If any utility lines, pipelines or underground utility lines are shown on these drawings, they are shown in approximate manner only, and other such lines may exist where none are shown. If any such existing lines are shown, the location is based upon information provided by the Utility or pipeline company, the Owner, or by others (except where specifically noted as field verified), and the information may be incomplete, or may be obsolete by the time construction commences. The Engineer has undertaken limited field verification of the location, depth, size or type of existing utility lines, pipelines, or underground utility lines, and makes no representation pertaining thereto, and assumes no responsibility or liability therefor. The Contractor shall inform himself of the location of any utility line, pipeline, or underground utility line in or near the area of the work in advance of and during the excavation work. The Contractor is fully responsible for any and all damage caused by failure to locate, identify, and preserve any and all existing utilities, pipelines, and underground utility lines. The Contractor shall comply with State statutes, Municipal and Local ordinances, rules and regulations, if any, pertaining to the location of these lines and facilities, in planning and conducting excavation, whether by calling or notifying the utilities, complying with "line locating" procedures, or otherwise. (See also Note 2)
28. Steps are required in all drop inlets and manholes over 4 feet deep. All manhole and drop inlet steps shall be 1/2" grad 60 steel reinforcing rod encapsulated in a co-polymer polypropylene as manufactured by M.A. Industries, Inc. (model #P-2-PFS) or equal. Steps are not to be precast in place but shall be installed as recommended by the manufacturer after the manhole or catch basin has been constructed. Top two steps to protrude 4 inches into manhole, all other 5 inches. Spacing between steps to be 16 inches O.C., first step to be 18 inches from manhole rim, last step to be 18 inches maximum from manhole invert. For step placement in drop inlets, see appropriate Standard Detail (K-1 or K-4).
29. It shall be the responsibility of the Contractor to maintain sanitary sewer services at all times throughout the duration of the project, to include by-pass pumping of sewerage as required.
30. The Contractor is responsible for coordination during construction for work over or into Middle Rio Grande Conservancy District (MRGCD) facilities. These facilities include but are not limited to the Alameda Drain, Alameda Lateral, and Harwood Lateral. The Contractor shall obtain the necessary approvals from MRGCD regarding dewatering, scheduling, etc., during construction. The Contractor shall post a damage deposit with MRGCD for work which affects MRGCD facilities. There shall be no direct payment made for these items under this contract, but shall be considered incidental to other items of work.
31. All Reinforced Concrete Pipe (RCP) storm drain shall conform to ASTM C 76 specifications as set forth in the Contract Documents. The following pipe strength classes will apply for this project, unless otherwise noted:
 - (a) RCP less than thirty (30) inches in diameter (I.D.) - Class IV.
 - (b) RCP greater than or equal to thirty (30) inches in diameter (I.D.) - Class III.
32. Removal and replacement of existing curb and gutter required for the construction of new catch basins shall be considered incidental to the contract unit price for removal of existing catch basins and construction of new catch basins and no separate payment shall be made therefore.
33. Catch basin grate elevations shown on the plans are at the flowline at face of curb and are computed at 10 3/4" below top of curb.
34. All water service relocations or replacements required by the construction of new storm drain must be replaced from the water main to the existing meter. Splicing into existing service lines is not permitted.
35. Use Type "C" manholes for SAS and storm drain depths of less than 6' measured from invert to rim. Use Type "E" manholes for all depths greater than or equal to 6' measured from invert to rim.
36. For payment purposes, the maximum pavement cut width shall be as defined in Section 801.17.8.2. of the Interim Standard Specifications as defined in General Note 1 above.
37. Trench dewatering if required due to groundwater conditions encountered during construction shall be paid for by contract change order during construction.
38. Use of City approved alternate grates for storm inlets per City of Albuquerque Standard Drawing K-10 shall be limited to roadway slopes of one percent (1%) or greater.
39. Trench depth shall be measured from bottom of pavement to invert of pipe at centerline of pipe.

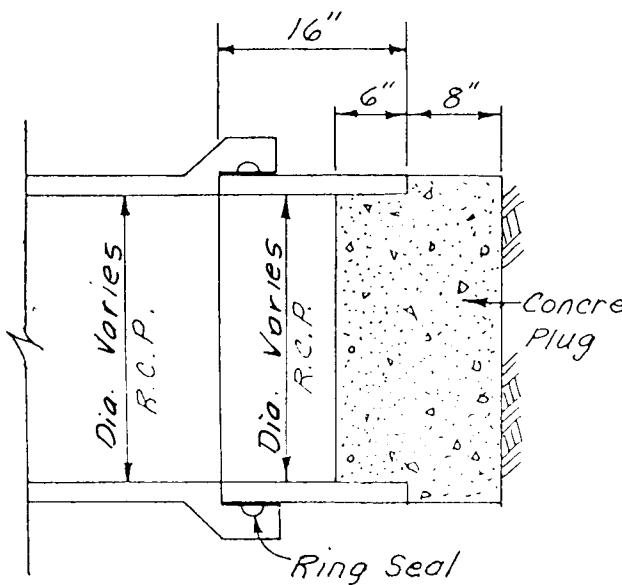

REMOVABLE WATERTIGHT PLUG


Not to Scale

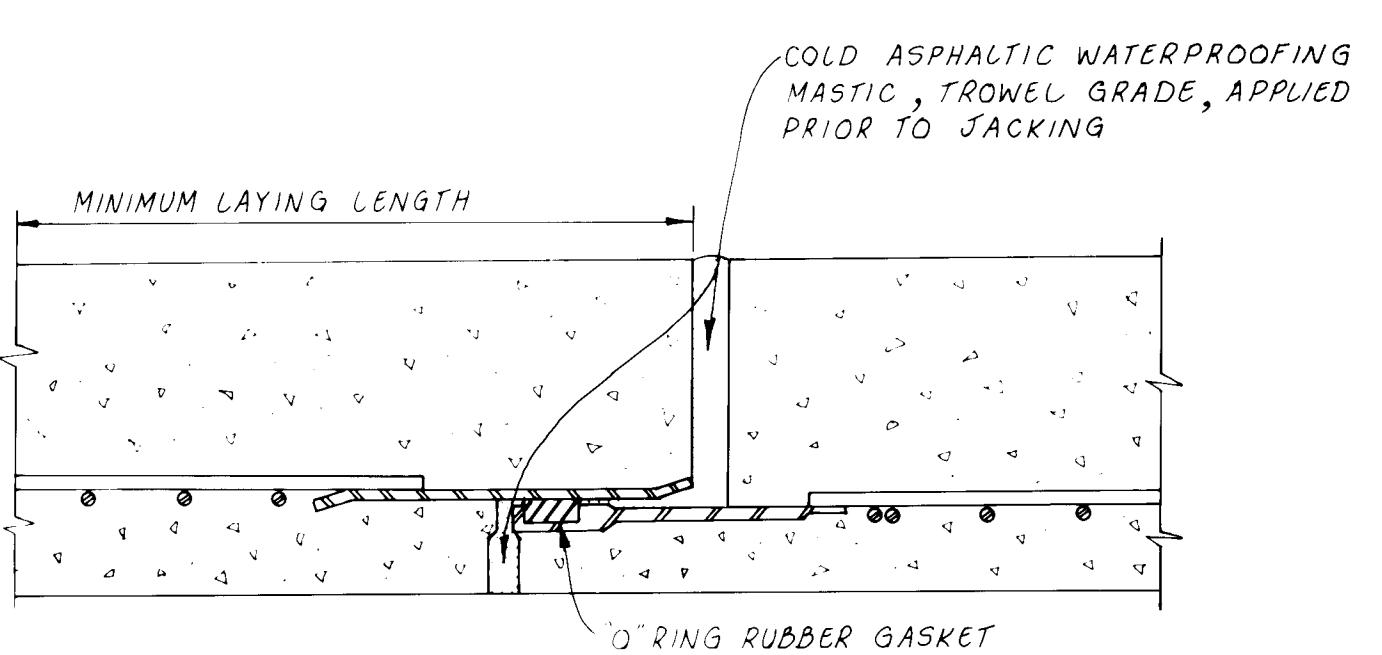

54" R.C.P.-STEEL END RING JOINT DETAIL


Not to Scale
Minimum Pipe Class = V
Pipe Inside Diameter = 54"
Wall Type = C
Bell Ring Min. Thickness = 1/4"
Min. Laying Length = 8.0'

MONTANO ROAD SYSTEM 'A'
S1a 16t14 to S1a 16t19

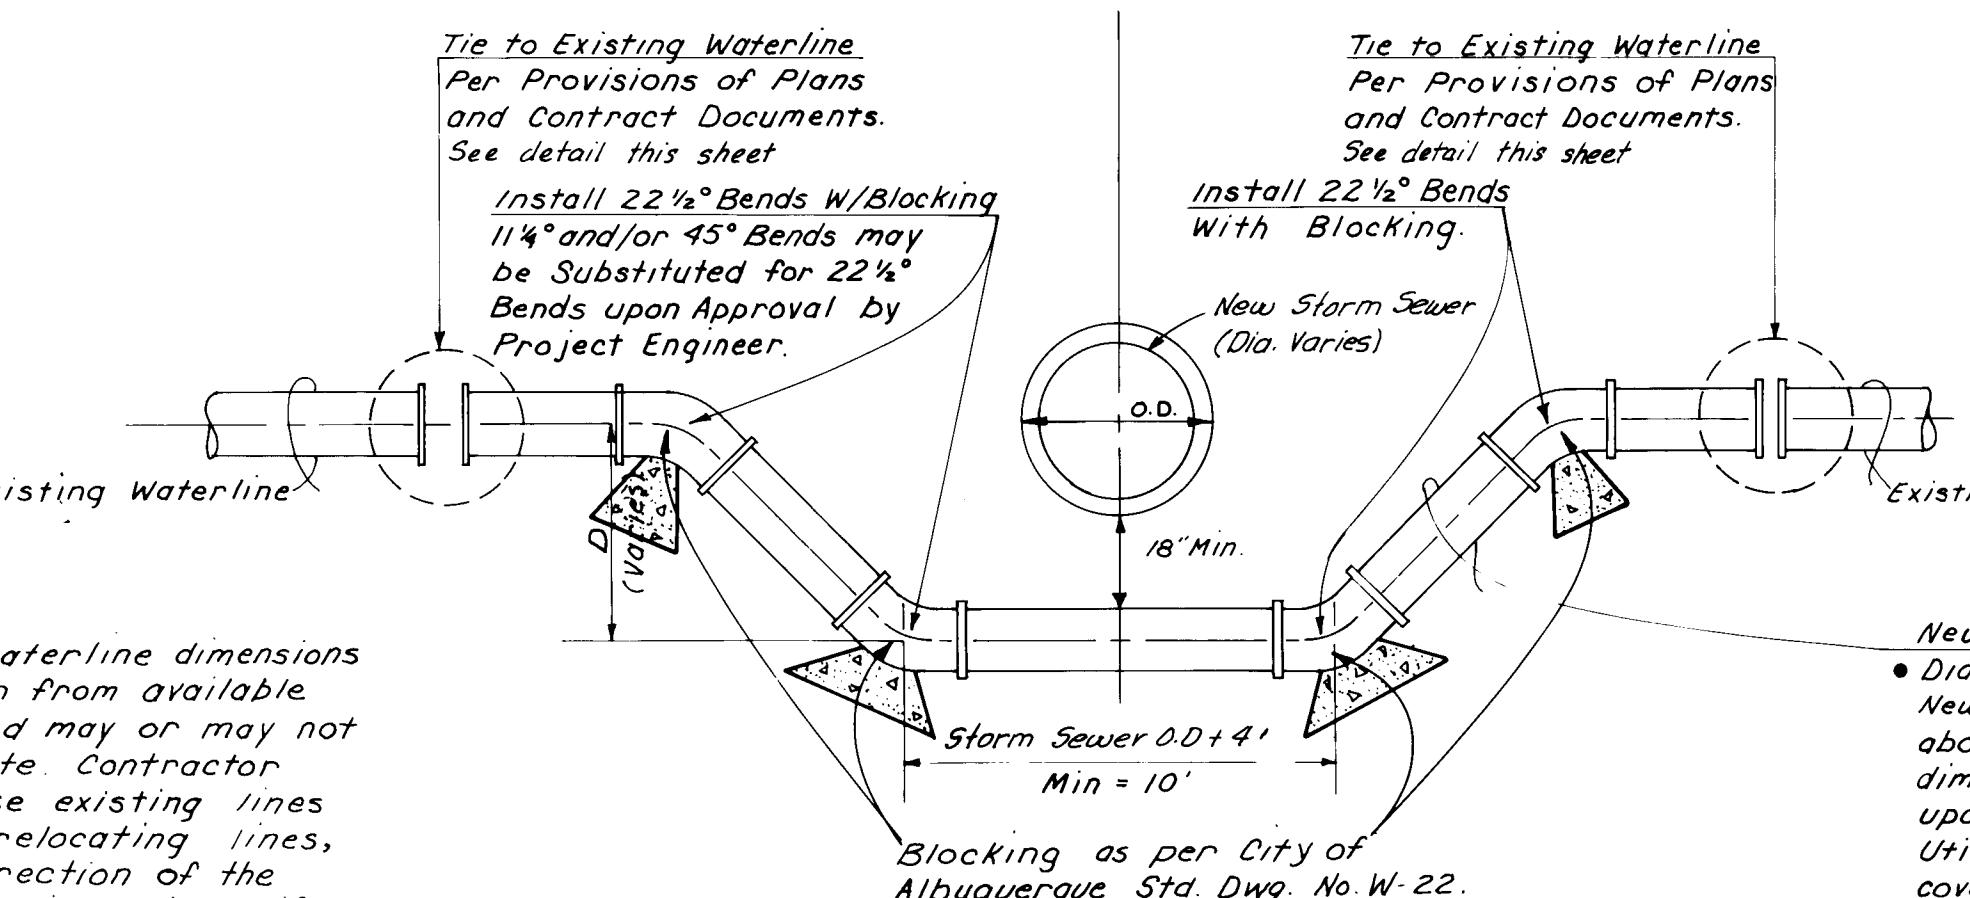

TYPICAL WATERLINE RELOCATION DETAIL

Not to Scale

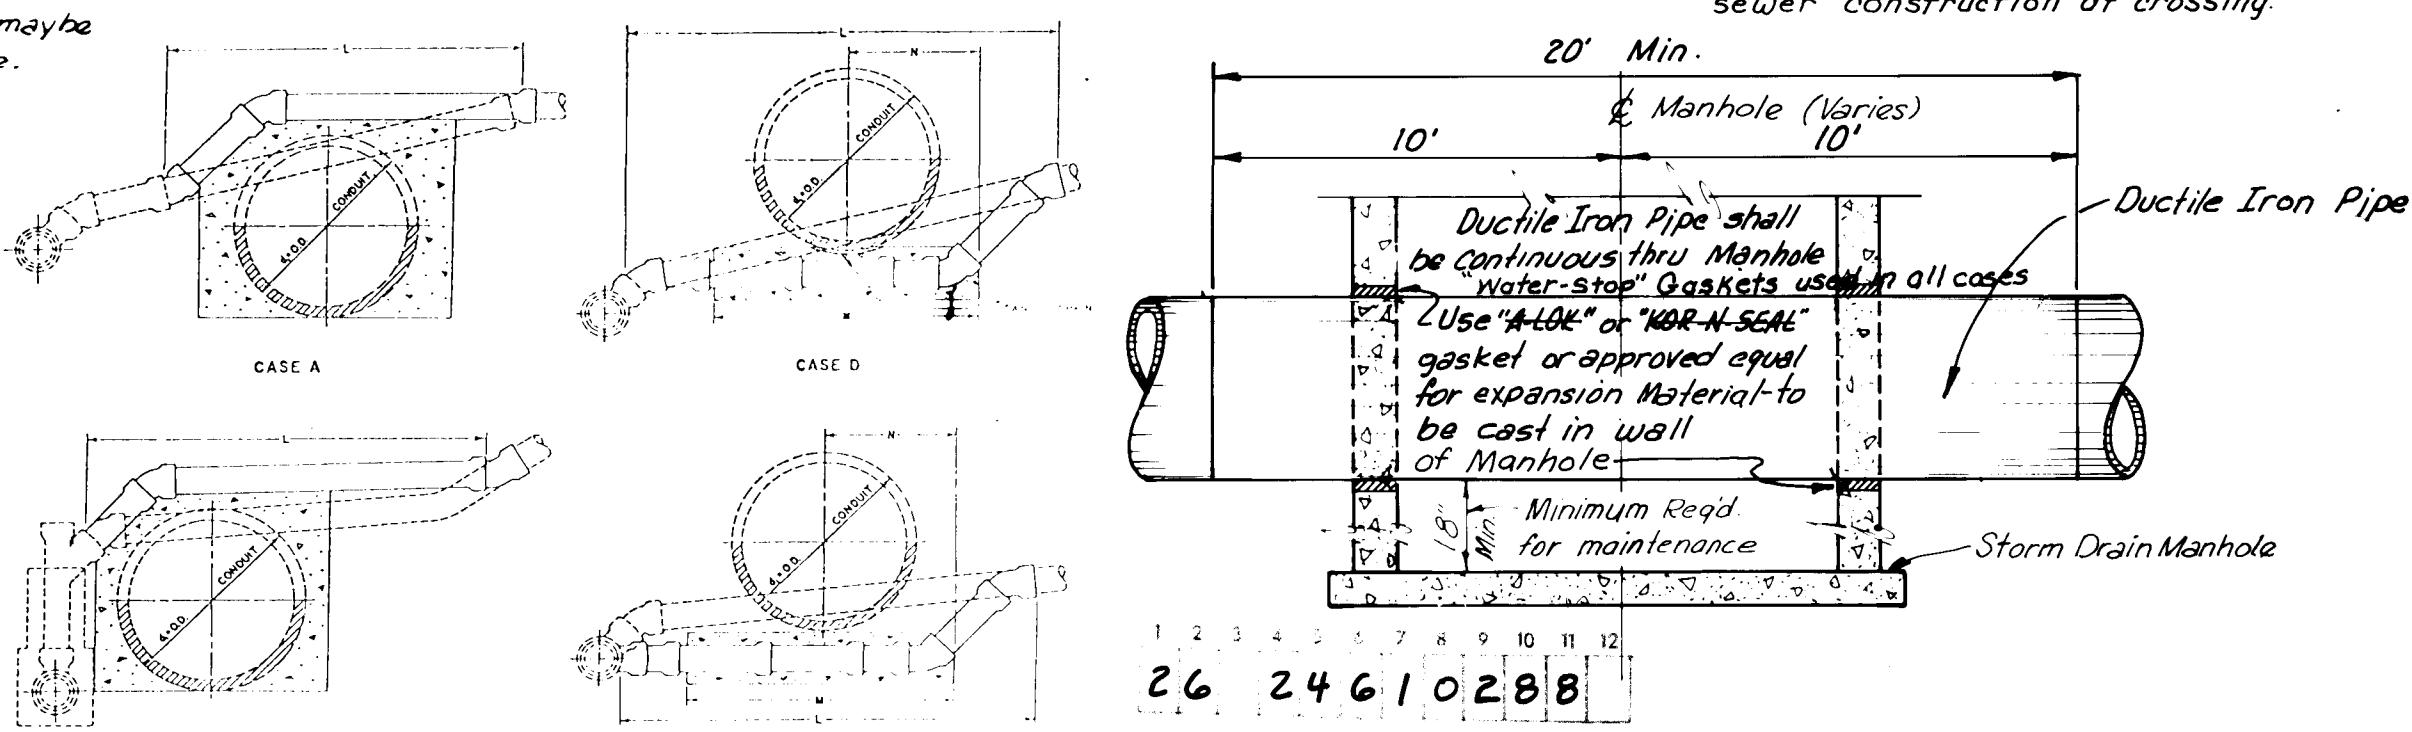

26 24610288

TYPICAL SAS LINE THRU STORM DRAIN MANHOLE

NTS

CITY OF ALBUQUERQUE
MUNICIPAL DEVELOPMENT DEPARTMENT
ENGINEERING DIVISION


TITLE: NORTH VALLEY DRAINAGE SYSTEM IMPROVEMENTS GENERAL NOTES AND DETAILS MONTANO ROAD SYSTEM (A)

APPROVALS	ENGINEER	DATE	APPROVALS	ENGINEER	DATE
City Engineer	John H. Scott	12/1/86	Liquid Waste	John H. Scott	12/1/86
ACE - Design	John H. Scott	12/1/86	Traffic	John H. Scott	12/1/86
ACE - Hydrology	John H. Scott	12/1/86	Water	John H. Scott	12/1/86

DRAWING NO.

2461


MAP NO. SHEET OF 2 19

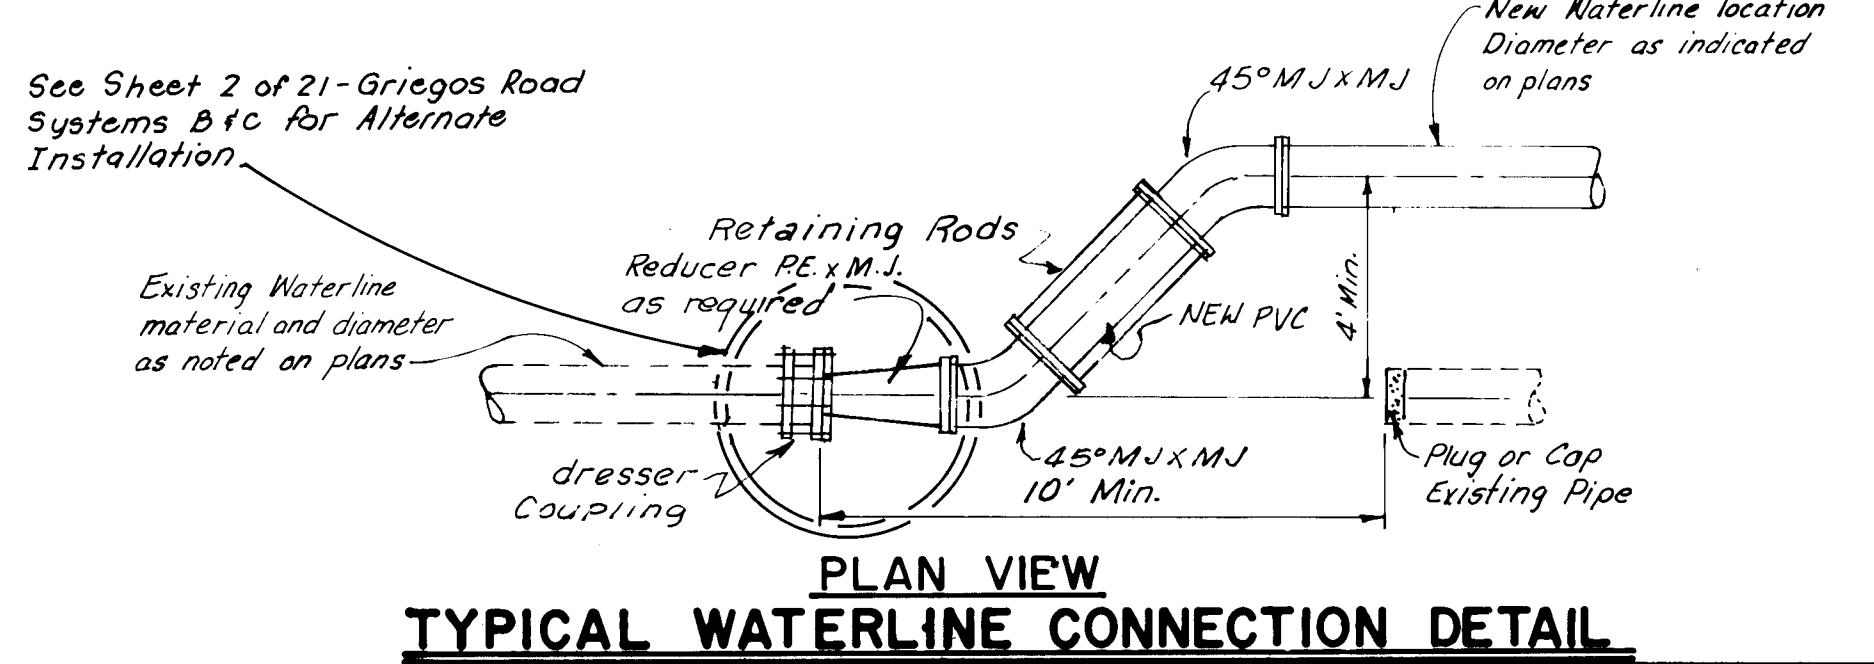


PLAN VIEW TYPICAL WATERLINE CONNECTION DETAIL

TYPICAL SAS SERVICE LINE RELOCATION DETAIL

WTS

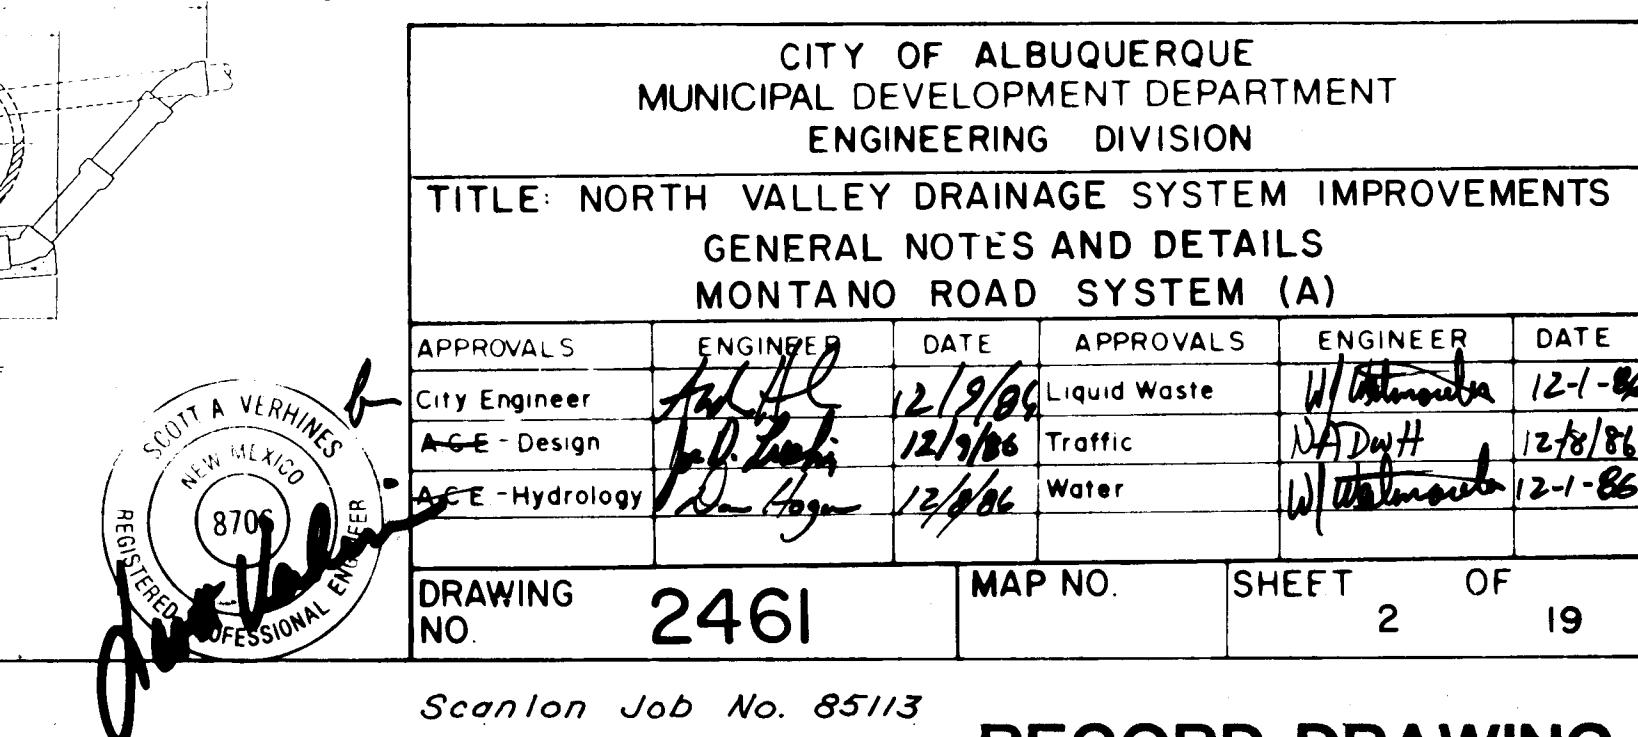

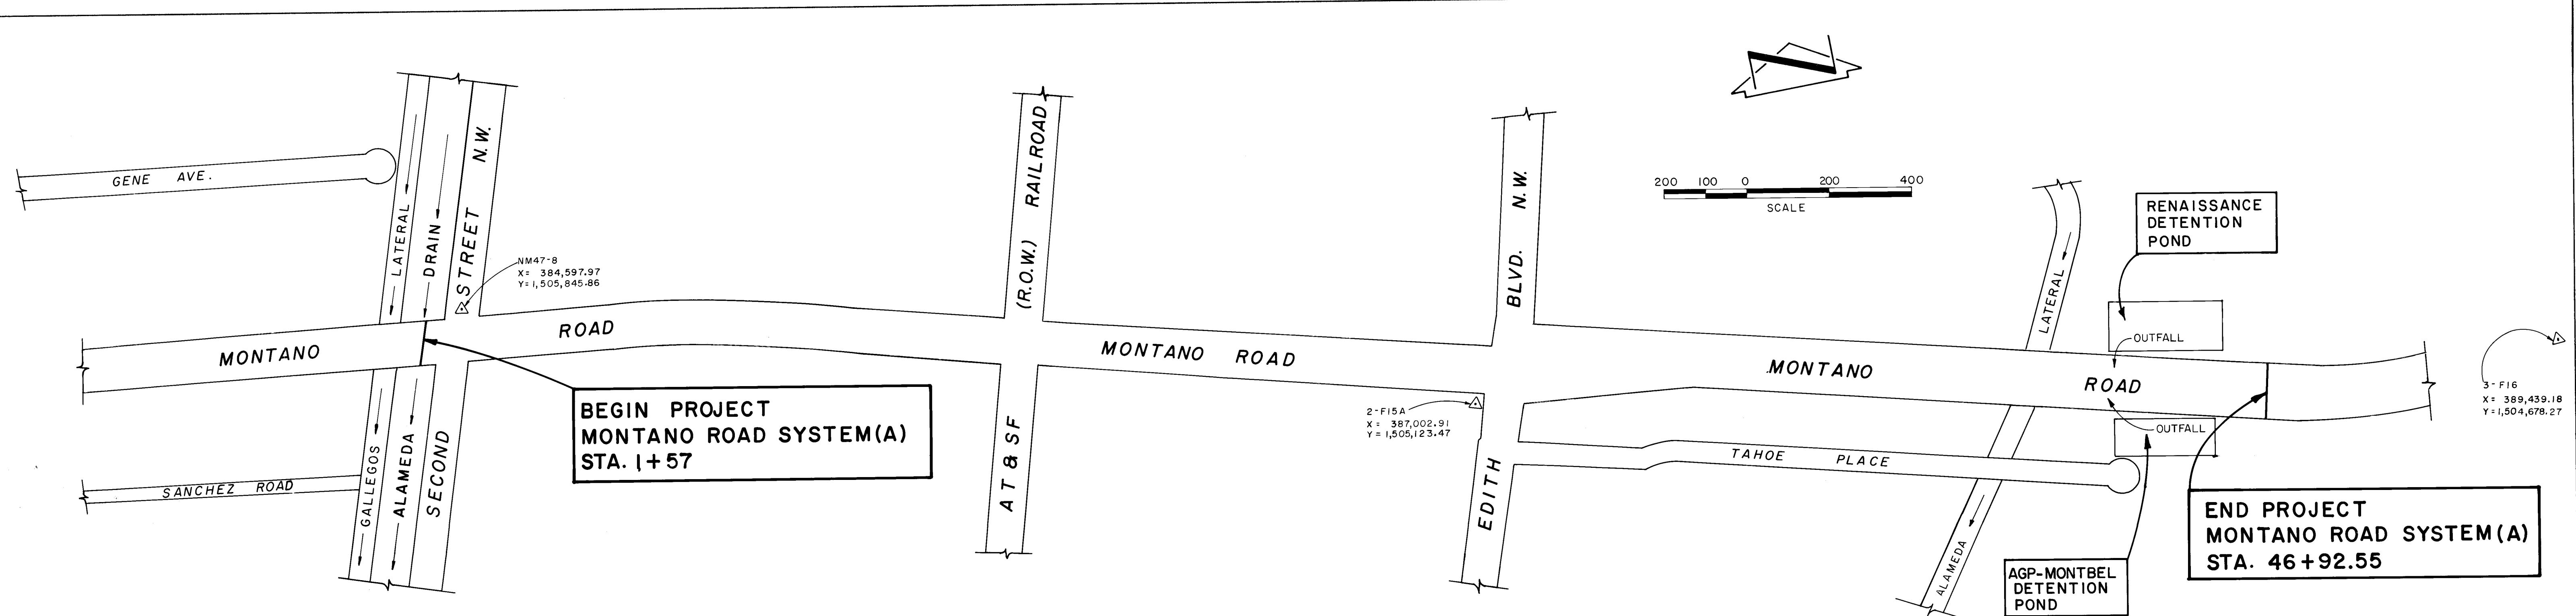

SITE PLAN
MONTANO ROAD SYSTEM (A)

LEGEND

=====	EXISTING CURB AND GUTTER	—SAS—	EXISTING SANITARY SEWER
=====	NEW STANDARD AND MEDIAN CURB AND GUTTER	—SD—	EXISTING STORM DRAIN
=====	NEW ASPHALT CURB	—W—	EXISTING WATER LINE
=====	EXISTING SIDEWALK	—G—	EXISTING GAS LINE
=====	NEW SIDEWALK PATCH	—SAS—	NEW SANITARY SEWER
=====	NEW MEDIAN PATCH	(○)	NEW SANITARY SEWER MANHOLE
=====	PAVEMENT REPLACEMENT PER C.O.A. STD. DWG P-25	—SD—	NEW STORM DRAIN
=====	EXISTING SIGN	(○)	NEW STORM DRAIN MANHOLE
○	EXISTING POLE	====	NEW CATCH BASIN
—○—	EXISTING CHAIN LINK FENCE	.12.8	EXISTING SPOT ELEVATION
=====	EXISTING BLOCK WALL	.72.8	NEW SPOT ELEVATION
—x—x—	EXISTING WIRE FENCE	—T—	EXISTING TELEPHONE LINE
—x—x—	EXISTING WOOD FENCE	—C—	EXISTING CABLE TELEVISION LINE
—●—●—	NEW CHAIN LINK FENCE	(○)	EXISTING WATER METER
△	PI OR CONTROL POINT	(○)	EXISTING WATER VALVE
——	CONSTRUCTION & SURVEY &	(○)	EXISTING FIRE HYDRANT
—R/W LINE		(○)	NEW FIRE HYDRANT
HGL 100.00	ELEVATION OF HYDRAULIC GRADE LINE		
Q ₁₀₀ = 10.0	FLOW RATE C.F.S. 100 YEAR-6 HOUR RUNOFF		
V ₁₀₀ = 5.0	VELOCITY (FT./SEC) 100 YEAR-6 HOUR RUNOFF		

TRAFFIC CONTROL NOTES

- All traffic control devices, and their placement, shall comply with Chapter VI of the 1978 Edition MANUAL FOR UNIFORM TRAFFIC CONTROL DEVICES.
- The Contractor shall prepare and submit to the Project Engineer a detailed detour plan, which must be approved by the City Traffic Engineer three (3) working days in advance of any required lane closures.
- All signs must be installed before construction begins as directed by the Project Engineer. Sign heights shall be 7 ft. from the bottom of the sign to the sidewalk level.
- All drums or barrels may have sand or water ballast limited to 100 lbs.
- All sign locations will be selected in the field and approved by the City Traffic Engineer or Project Engineer. Distances may be adjusted for local conditions.
- All signs will be ground mounted on single or double posts. Existing posts may be used at some locations, with the approval of the Project Engineer. Portable sign supports will be acceptable as an alternate.
- All signs will be moved forward as the construction progresses, as determined appropriate by the Project Engineer.
- Construction equipment and materials shall not be stored within the roadway or on the median during non-work hours.
- When barriers are required after dark, all advance warning signs and all barricades shall be equipped with flashing warning lights (Type A), except that all channelizing devices shall have steady burning warning lights (Type C).
- All existing regulatory signs and signals that need to be removed, relocated or reinstated shall be done by the City of Albuquerque Traffic Engineering Division. The Contractor shall notify the Traffic Engineering Division three (3) working days in advance of any required work.
- Exact locations of relocated traffic signal foundations shall be determined by the Traffic Engineering Division.
- The Contractor shall provide and maintain a safe and adequate means of channelizing pedestrian traffic around all work areas throughout the period of construction. All such channelization shall be arranged to prevent pedestrians from having to enter an open traffic lane in order to pass around the work areas.
- All construction signing shall be black on a reflectorized orange field unless otherwise specified. All construction barricades and channelization devices shall be orange on white, reflectorized, unless otherwise specified.
- The Contractor shall prepare and submit to the Project Engineer a detailed project phasing plan at the pre-construction conference for approval prior to beginning construction.

26 24610388

CITY OF ALBUQUERQUE
MUNICIPAL DEVELOPMENT DEPARTMENT
ENGINEERING DIVISION

TITLE: MONTANO ROAD SYSTEM (A)
SITE PLAN

LEGEND & TRAFFIC CONTROL NOTES


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City Engineer			Liquid Waste	W/J	(2-1-86)
ACE - Design	J.P. [Signature]	12/9/86	Traffic	NADW H	12/8/86
ACE - Hydrology	[Signature]	12/9/86	Water	W/J	12-1-86

DRAWING NO. 2461 MAP NO. F-15 SHEET 3 OF 19

Scanton Job No. 85113



RECORD DRAWING

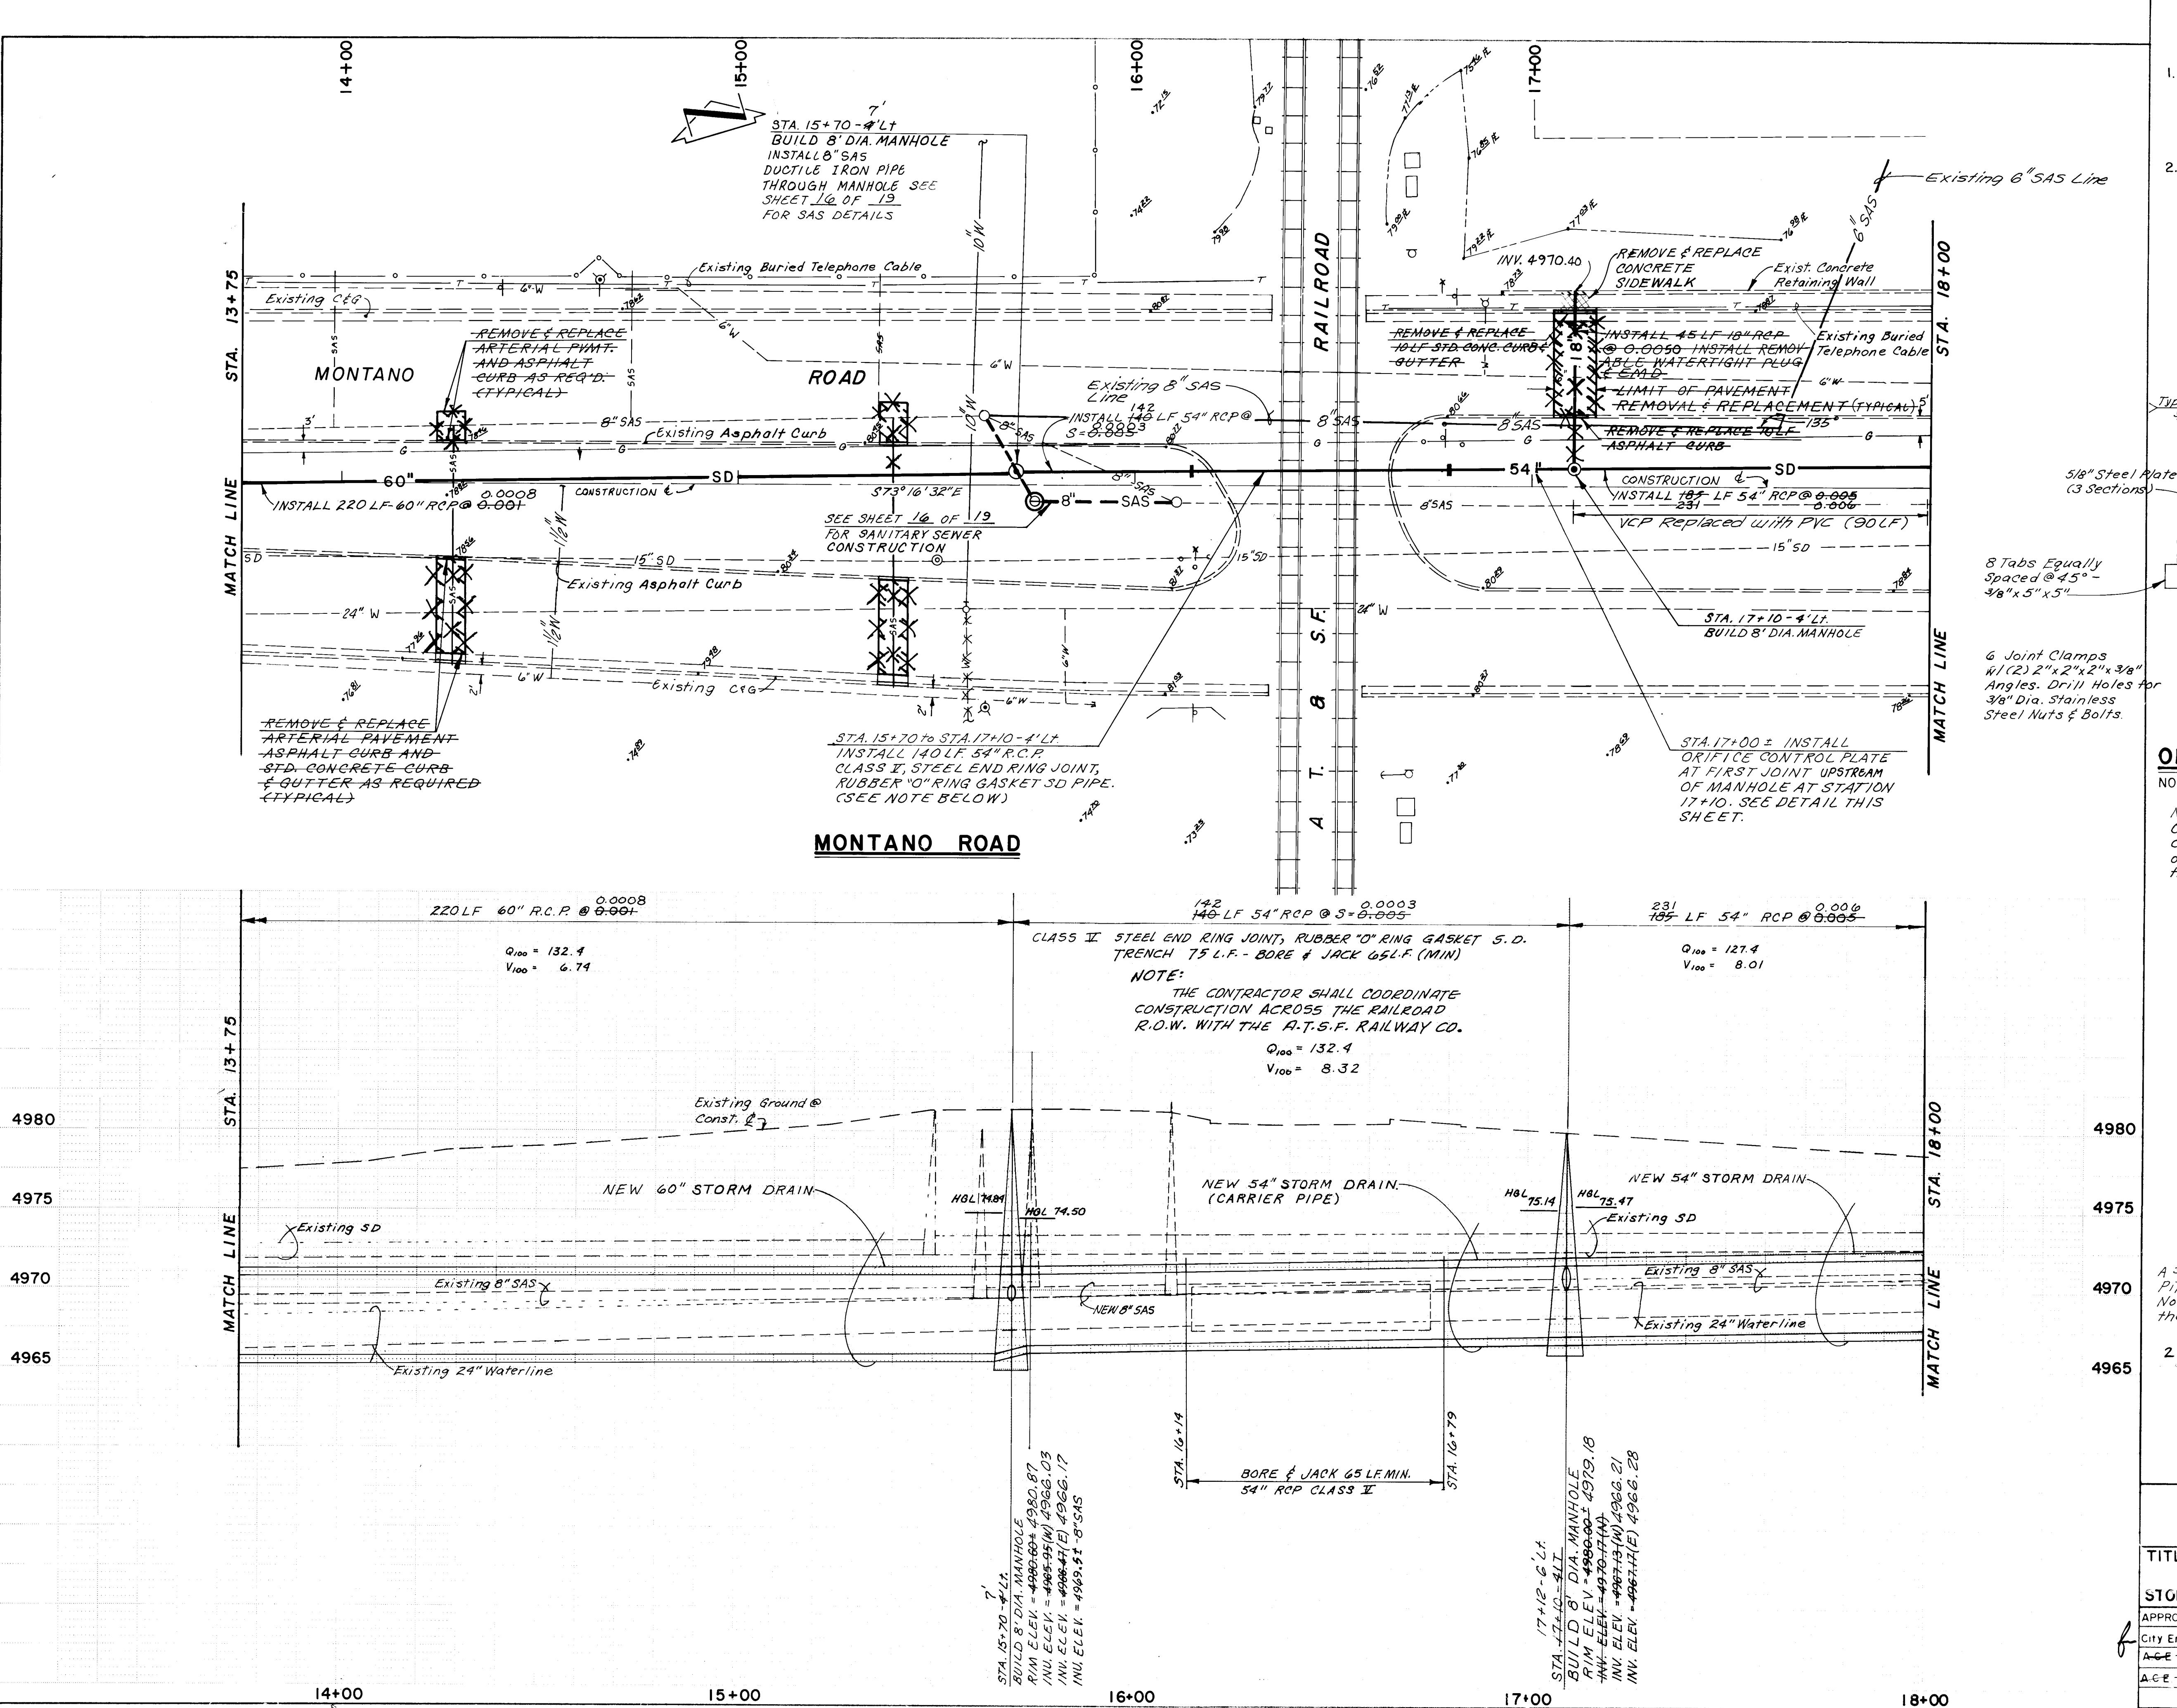


AS BUILT INFORMATION	
NOTE:	1. ALL SPOT ELEVATIONS SHOWN ARE EXISTING TOP OF CURB UNLESS OTHERWISE NOTED
2. STA. 14+28 & 15+39 SAS SERVICE LINES FROM SOUTH SIDE OF MONTANO ROAD SHALL BE ADJUSTED AND RECONNECTED TO EXISTING 8" SAS PER APPLICABLE DETAIL SEE SHEET 2. CONTRACTOR SHALL LIMIT LENGTH OF REQUIRED GRADE ADJUSTMENTS TO THAT REQUIRED FOR PROPER INSTALLATION.	
BENCH MARKS	
FIELD NOTES	ACS 2 - FISA - ACS BRASS TABLET ON CONCRETE POST SOUTHEAST CORNER MONTANO & EDITH ELEV. 4984.24
NO. BY DATE	NMSHC/ACS NM 47-8 BRASS TABLET IN ISLAND ON SECOND STREET NORTH OF MONTANO ELEV. 4974.569
SECTION A	
ENGINEER'S SEAL	
4980	4980
4975	4975
4970	4970
4965	4965
SECTION B	
4980	A 3/8" Spacer Shall be Provided at the Pipe Joint if the Orifice Plate is Not Installed Simultaneously with the Pipe Laying Operation.
4975	
4970	
4965	
SCALES	
HORIZONTAL	1" = 20'
VERTICAL	1" = 5'

CITY OF ALBUQUERQUE
MUNICIPAL DEVELOPMENT DEPARTMENT
ENGINEERING DIVISION


TITLE: NORTH VALLEY DRAINAGE SYSTEM IMPROVEMENTS
MONTANO ROAD SYSTEM (A)

APPROVALS	ENGINEER	DATE	APPROVALS	ENGINEER	DATE
City Engineer		12/1/86	Liquid Waste	W/W	12/1/86
A-C-E - Design		12/1/86	Traffic	N/A D/W	12/1/86
A-C-E - Hydrology		12/1/86	Water	W/W	12/1/86

DRAWING NO. 2461 MAP NO. F-15 SHEET 7 OF 19

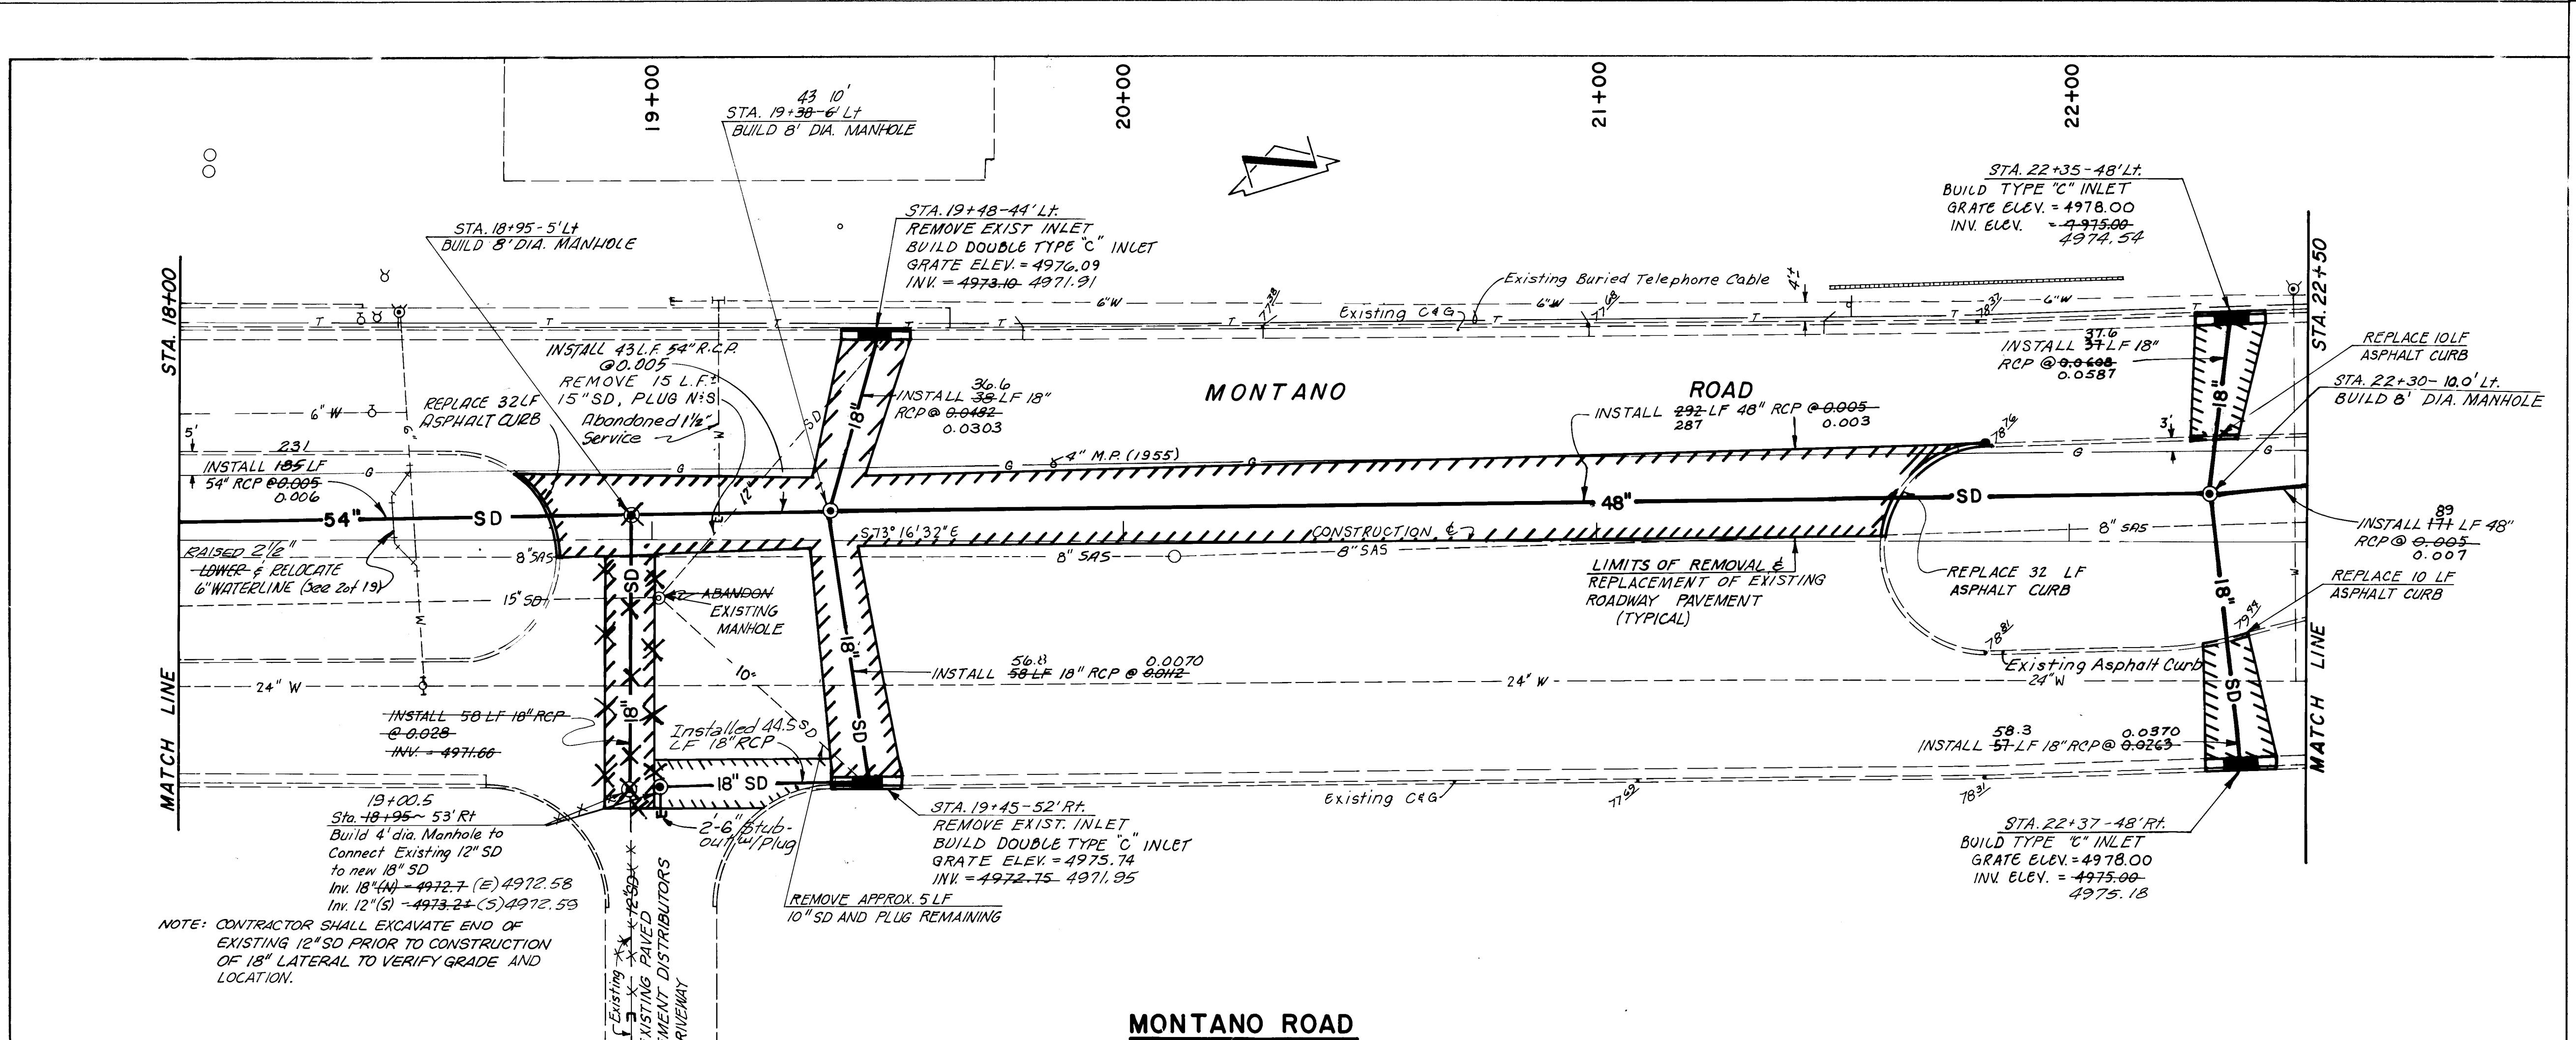


MONTANO ROAD

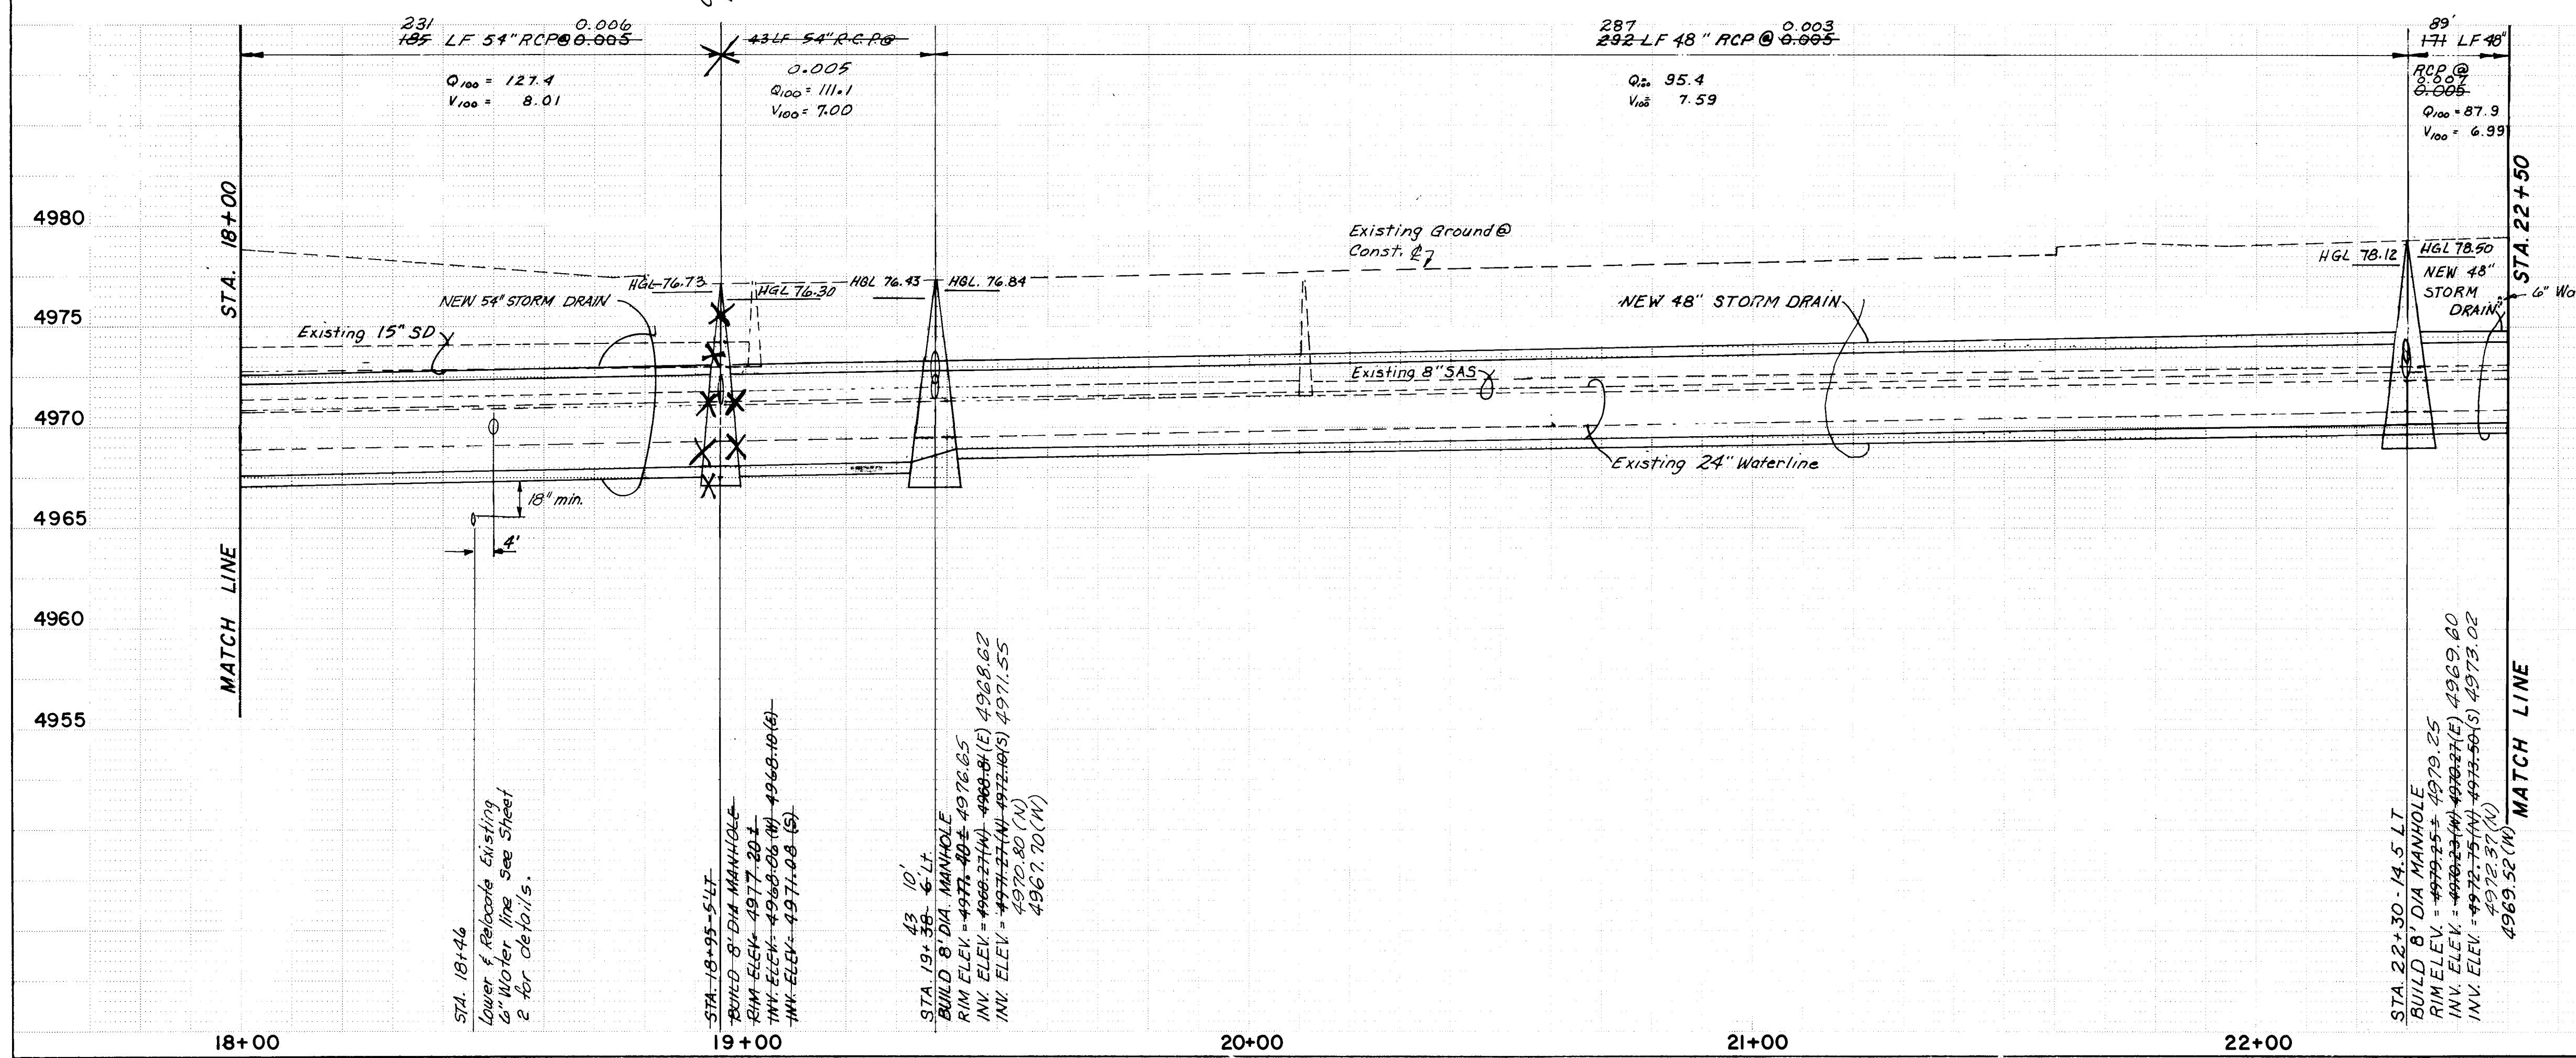


AS BUILT - NF INFORMATION		AS BUILT - NF INFORMATION	
New Concepts, Inc.		New Concepts, Inc.	
NO.	BY	NO.	BY
DATE	DATE	DATE	DATE
TABLET IN ISLAND ON SECOND STREET NORTH OF MONTANO ELEV. 4974.569	TABLET IN CONCRETE POST SOUTHWEST CORNER MONTANO & EDITH ELEV. 4984.24	TABLET IN CONCRETE POST SOUTHWEST CORNER MONTANO & EDITH ELEV. 4974.569	TABLET IN CONCRETE POST SOUTHWEST CORNER MONTANO & EDITH ELEV. 4974.569
NMSIC/ACS NM 47-8 BRASS			
NOTE: ALL SPOT ELEVATIONS SHOWN ARE EXISTING TOP OF CURB UNLESS OTHERWISE NOTED	NOTE: ALL SPOT ELEVATIONS SHOWN ARE EXISTING TOP OF CURB UNLESS OTHERWISE NOTED	NOTE: ALL SPOT ELEVATIONS SHOWN ARE EXISTING TOP OF CURB UNLESS OTHERWISE NOTED	NOTE: ALL SPOT ELEVATIONS SHOWN ARE EXISTING TOP OF CURB UNLESS OTHERWISE NOTED
APPROVALS APPROVALS	ENGINEER ENGINEER	DATE DATE	APPROVALS APPROVALS
City Engineer <i>[Signature]</i> 12-1-86	Liquid Waste <i>[Signature]</i> 12-1-86	12-1-86	City Engineer <i>[Signature]</i> 12-1-86
ACE - Design <i>[Signature]</i> 12-1-86	Traffic <i>[Signature]</i> 12-1-86	12-1-86	ACE - Design <i>[Signature]</i> 12-1-86
ACE - Hydrology <i>[Signature]</i> 12-1-86	Water <i>[Signature]</i> 12-1-86	12-1-86	ACE - Hydrology <i>[Signature]</i> 12-1-86
REVISIONS	REVISIONS	REVISIONS	REVISIONS
DESIGNED BY S.A.V. DATE 11/18/85	DRAWN BY C.L.W. DATE 11/18/85	REMARKS	REMARKS
CHECKED BY	DATE	REVISIONS	REVISIONS
26 24610888	SCALES	HORIZONTAL 1" = 20'	VERTICAL 1" = 5'

CITY OF ALBUQUERQUE MUNICIPAL DEVELOPMENT DEPARTMENT ENGINEERING DIVISION			
TITLE: NORTH VALLEY DRAINAGE SYSTEM IMPROVEMENTS MONTANO ROAD SYSTEM(A)			
STORM DRAIN STA. 18+00 TO STA. 22+50			
APPROVALS	ENGINEER	DATE	APPROVALS
City Engineer <i>[Signature]</i>	<i>[Signature]</i>	12-1-86	Liquid Waste <i>[Signature]</i> 12-1-86
ACE - Design <i>[Signature]</i>	<i>[Signature]</i>	12-1-86	Traffic <i>[Signature]</i> 12-1-86
ACE - Hydrology <i>[Signature]</i>	<i>[Signature]</i>	12-1-86	Water <i>[Signature]</i> 12-1-86
DRAWING NO. 2461	MAP NO. F-15	SHEET 8 OF 19	Scanlon Job No. 85113

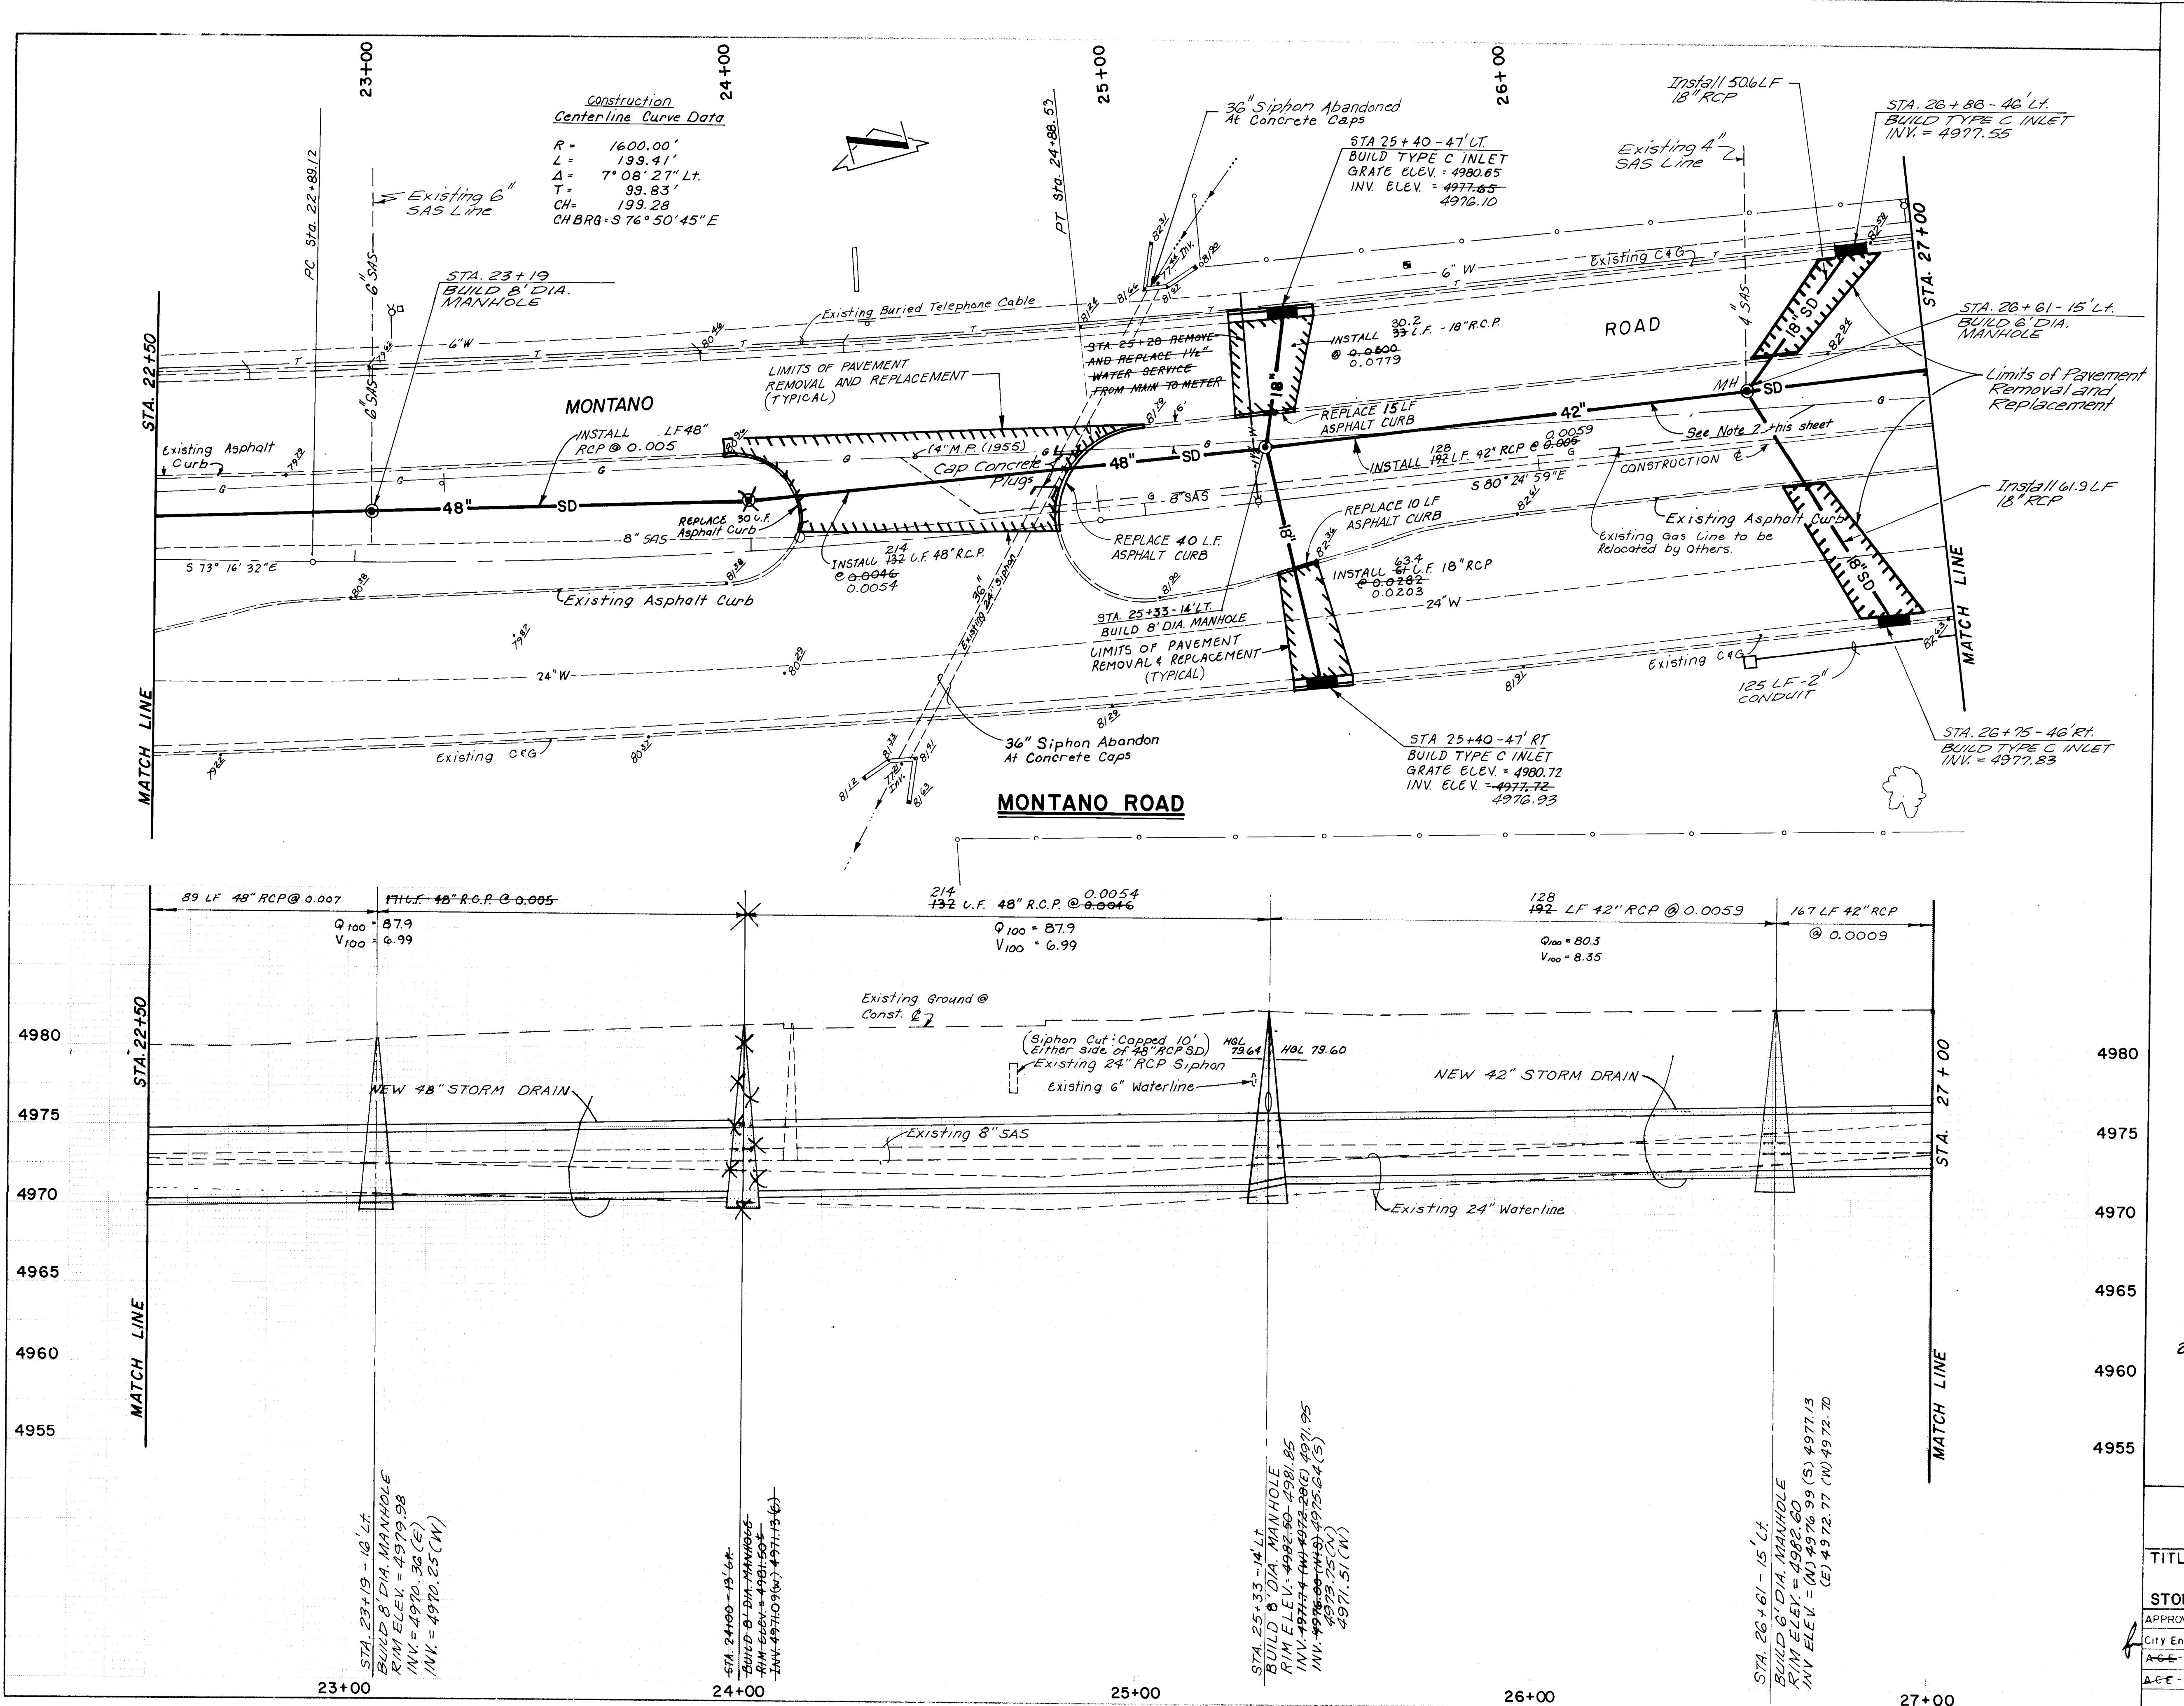

AS BUILT INFORMATION		BENCH MARKS	
CONTRACTOR	New Concepts, Inc.	WORK	ON CONCRETE POST SOUTHWEST
ASSOCIATES	Scanlon & Associates, Inc.	DATE	11-88
FIELD	Excavation by	VEHICLES	BY
VEHICLES	TRACTOR	DATE	11-88
DRAWN BY	Microfilm INFO.	DATE	11-88
RECORDED BY	NO	RECORD	11-88
NMSHC/ACS NM 47-8 BRASS TABLET	ACCS 2-F15A-ACS BRASS TABLET	NO.	FIELD NOTES
TABLET IN ISLAND ON SECOND STREET NORTH OF MONTANO	ON CONCRETE POST SOUTHWEST	BY	DATE
ELEV. 4984.24	CORNER MONTANO & EDITH	ELEV. 4984.24	ELEV. 4984.24
ELEV. 4974.569	STREET NORTH OF MONTANO	ELEV. 4974.569	ELEV. 4974.569

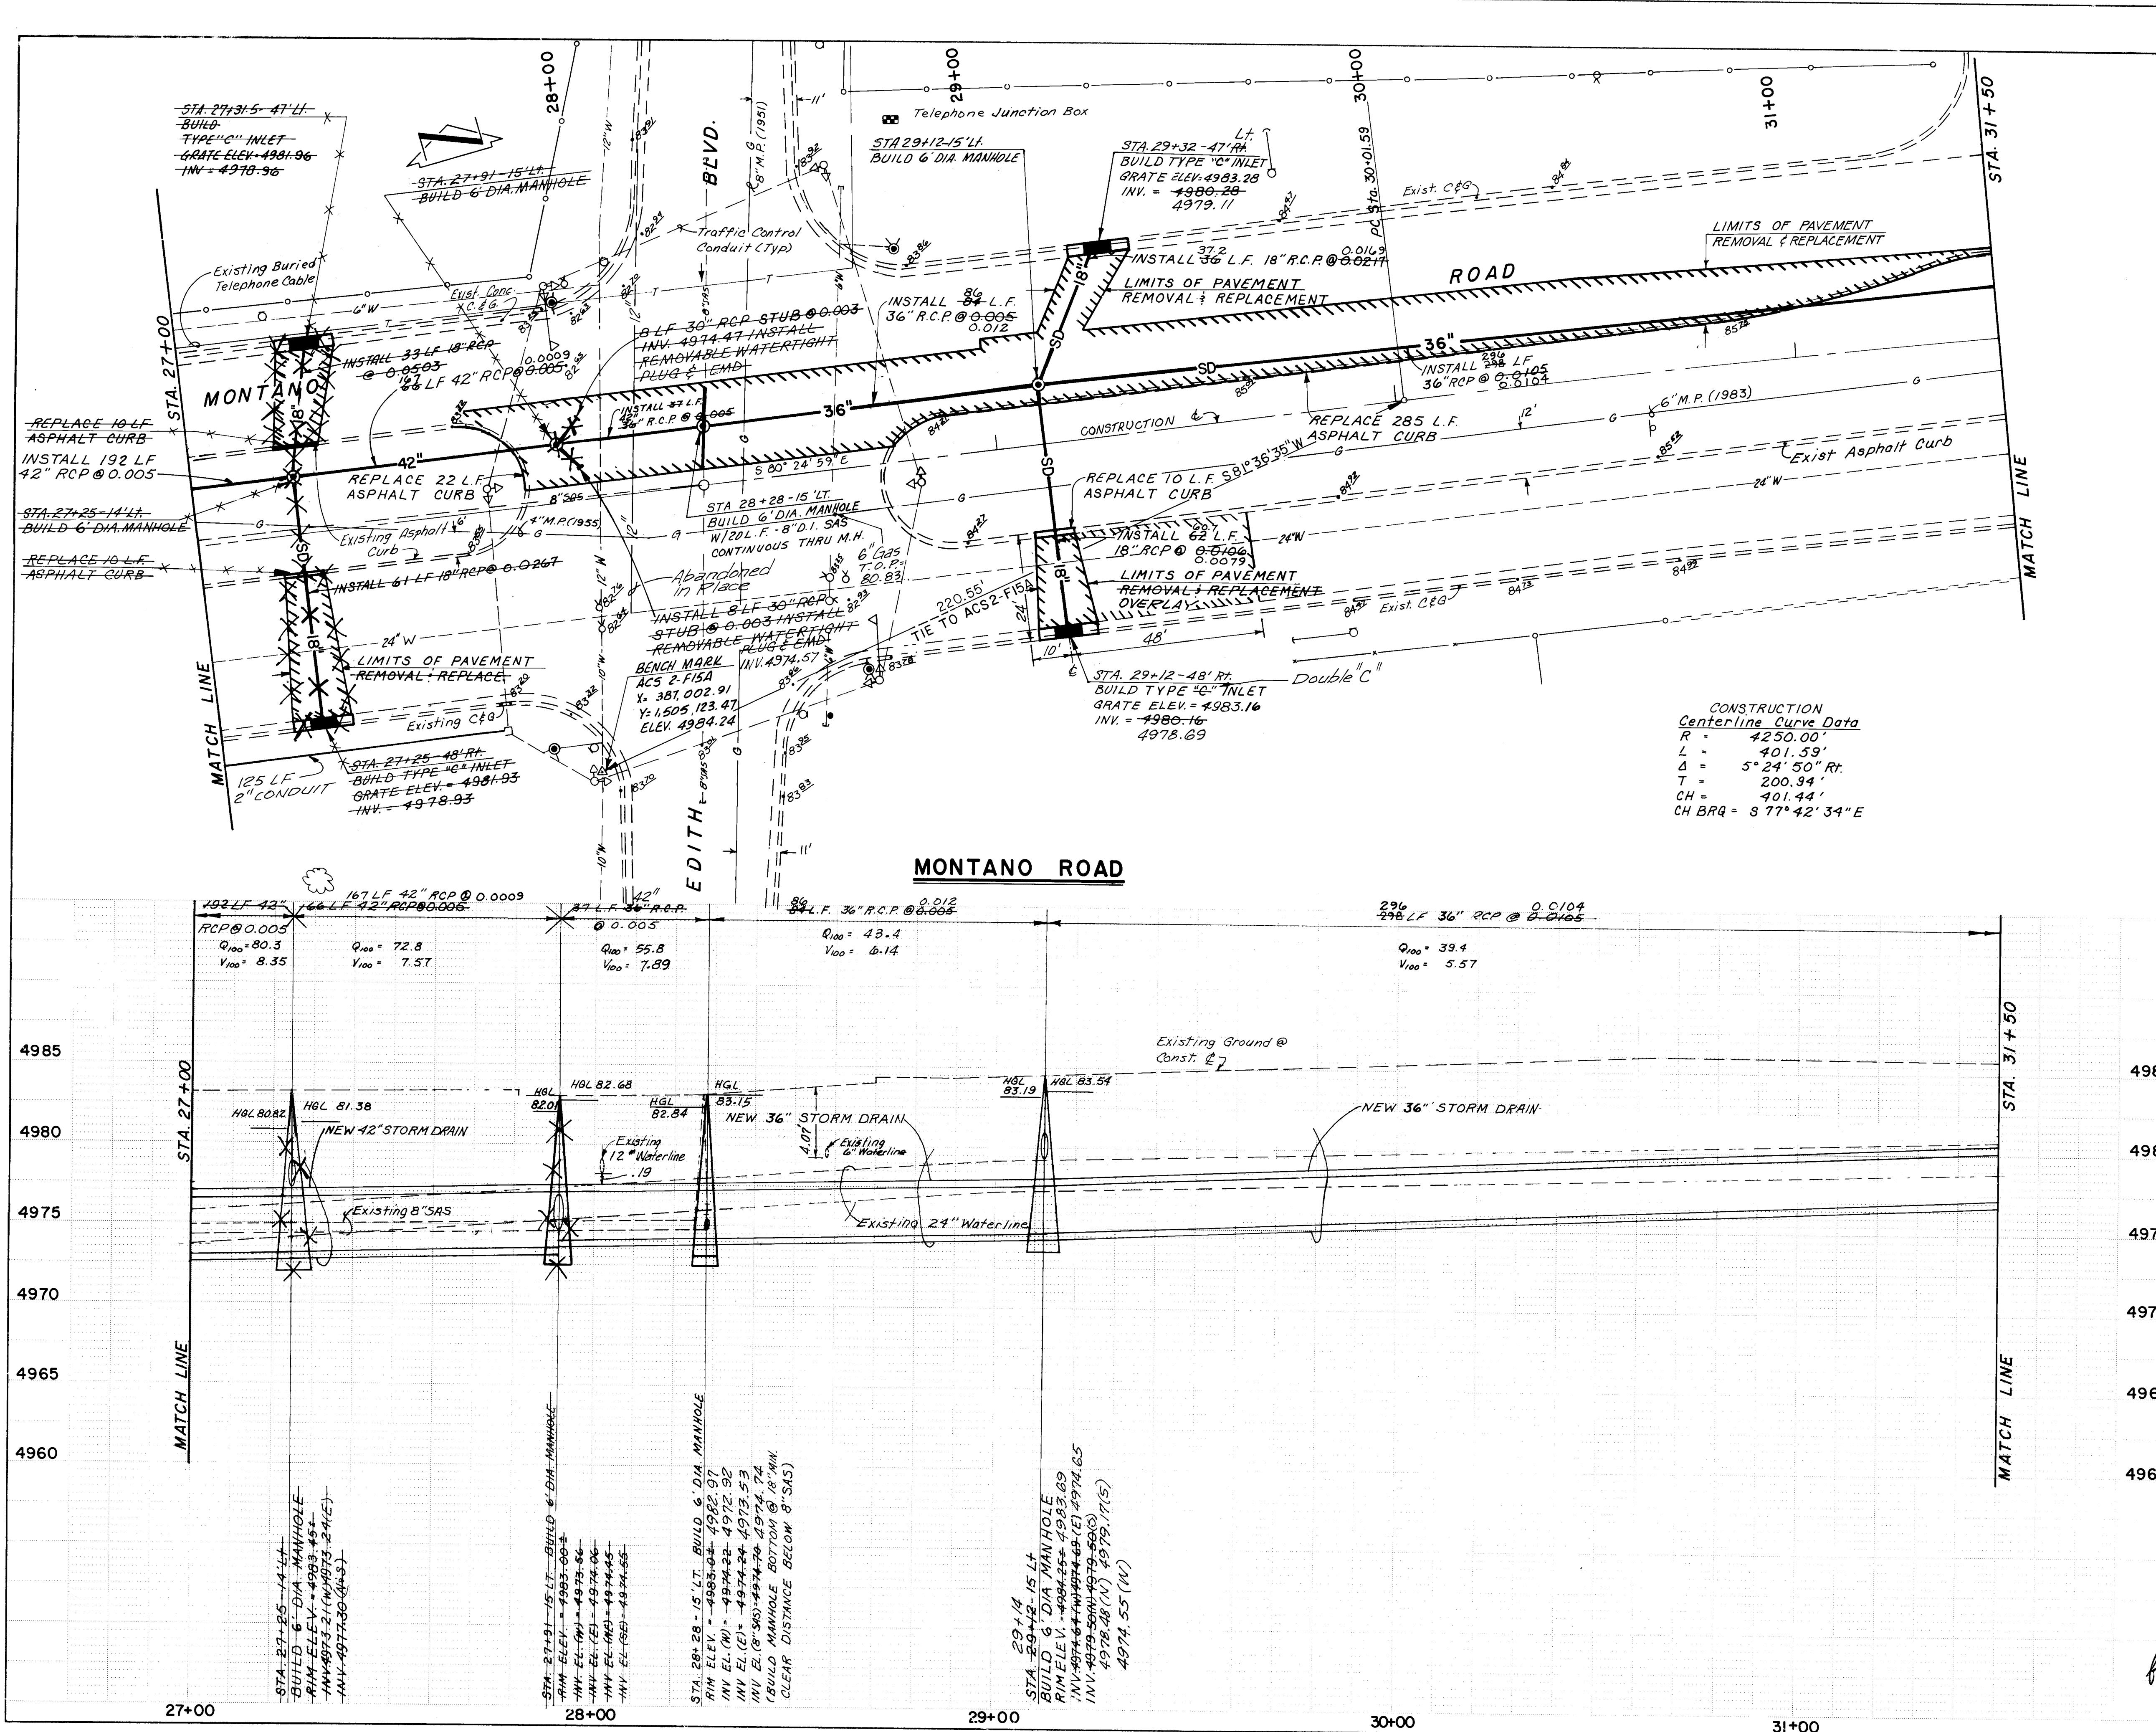

NOTE:
ALL SPOT ELEVATIONS
SHOWN ARE EXISTING
TOP OF CURB UNLESS
OTHERWISE NOTED

- WHEN CROSSING EXISTING
SIGNAL CONDUIT REPLACE
SIGNAL WIRE FROM TRAFFIC
FIXTURE TO TRAFFIC FIXTURE

"EMD" = ELECTRONIC MARKER
ISK INSTALLED PER C.O.A.
STANDARD DRAWING S-12.

**CITY OF ALBUQUERQUE
MUNICIPAL DEVELOPMENT DEPARTMENT
ENGINEERING DIVISION**


**CITY OF ALBUQUERQUE
MUNICIPAL DEVELOPMENT DEPARTMENT
ENGINEERING DIVISION**


S	ENGINEER	DATE	APPROVALS	ENGINEER	DATE
er	Judie Hark	12/9/86	Liquid Waste	W/W	12-1-86
ign	Joe D. Luehrs	12/9/86	Traffic	NADWH	12/8/86
rology	Don Hogan	12/9/86	Water	W/W	12-1-86

246	F-15	10	19
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NOTE:
ALL SPOT ELEVATIONS
SHOWN ARE EXISTING
TOP OF CURB UNLESS
OTHERWISE NOTED

AS BUILT INFORMATION		BENCH MARKS		SURVEY INFORMATION		FIELD NOTES		ACCS 2 - F15A - ACS BRASS TABLET	
CONTRACT NO.	DATE	WORK BY	SCANNON & ASSOCIATES	INSPECTOR	DATE	FIELD	MANUFACTURER	DATE	ACCS 2 - F15A - ACS BRASS TABLET
MICRO-FILM INFORMATION									
DATE	DATE	DATE	DATE	DATE	DATE	DATE	DATE	DATE	DATE
CORRECTED BY SCANNON & ASSOCIATES DATE 1-88									
RECORDED BY NO									
Scannon Job No. 85113									
RECORD DRAWING									



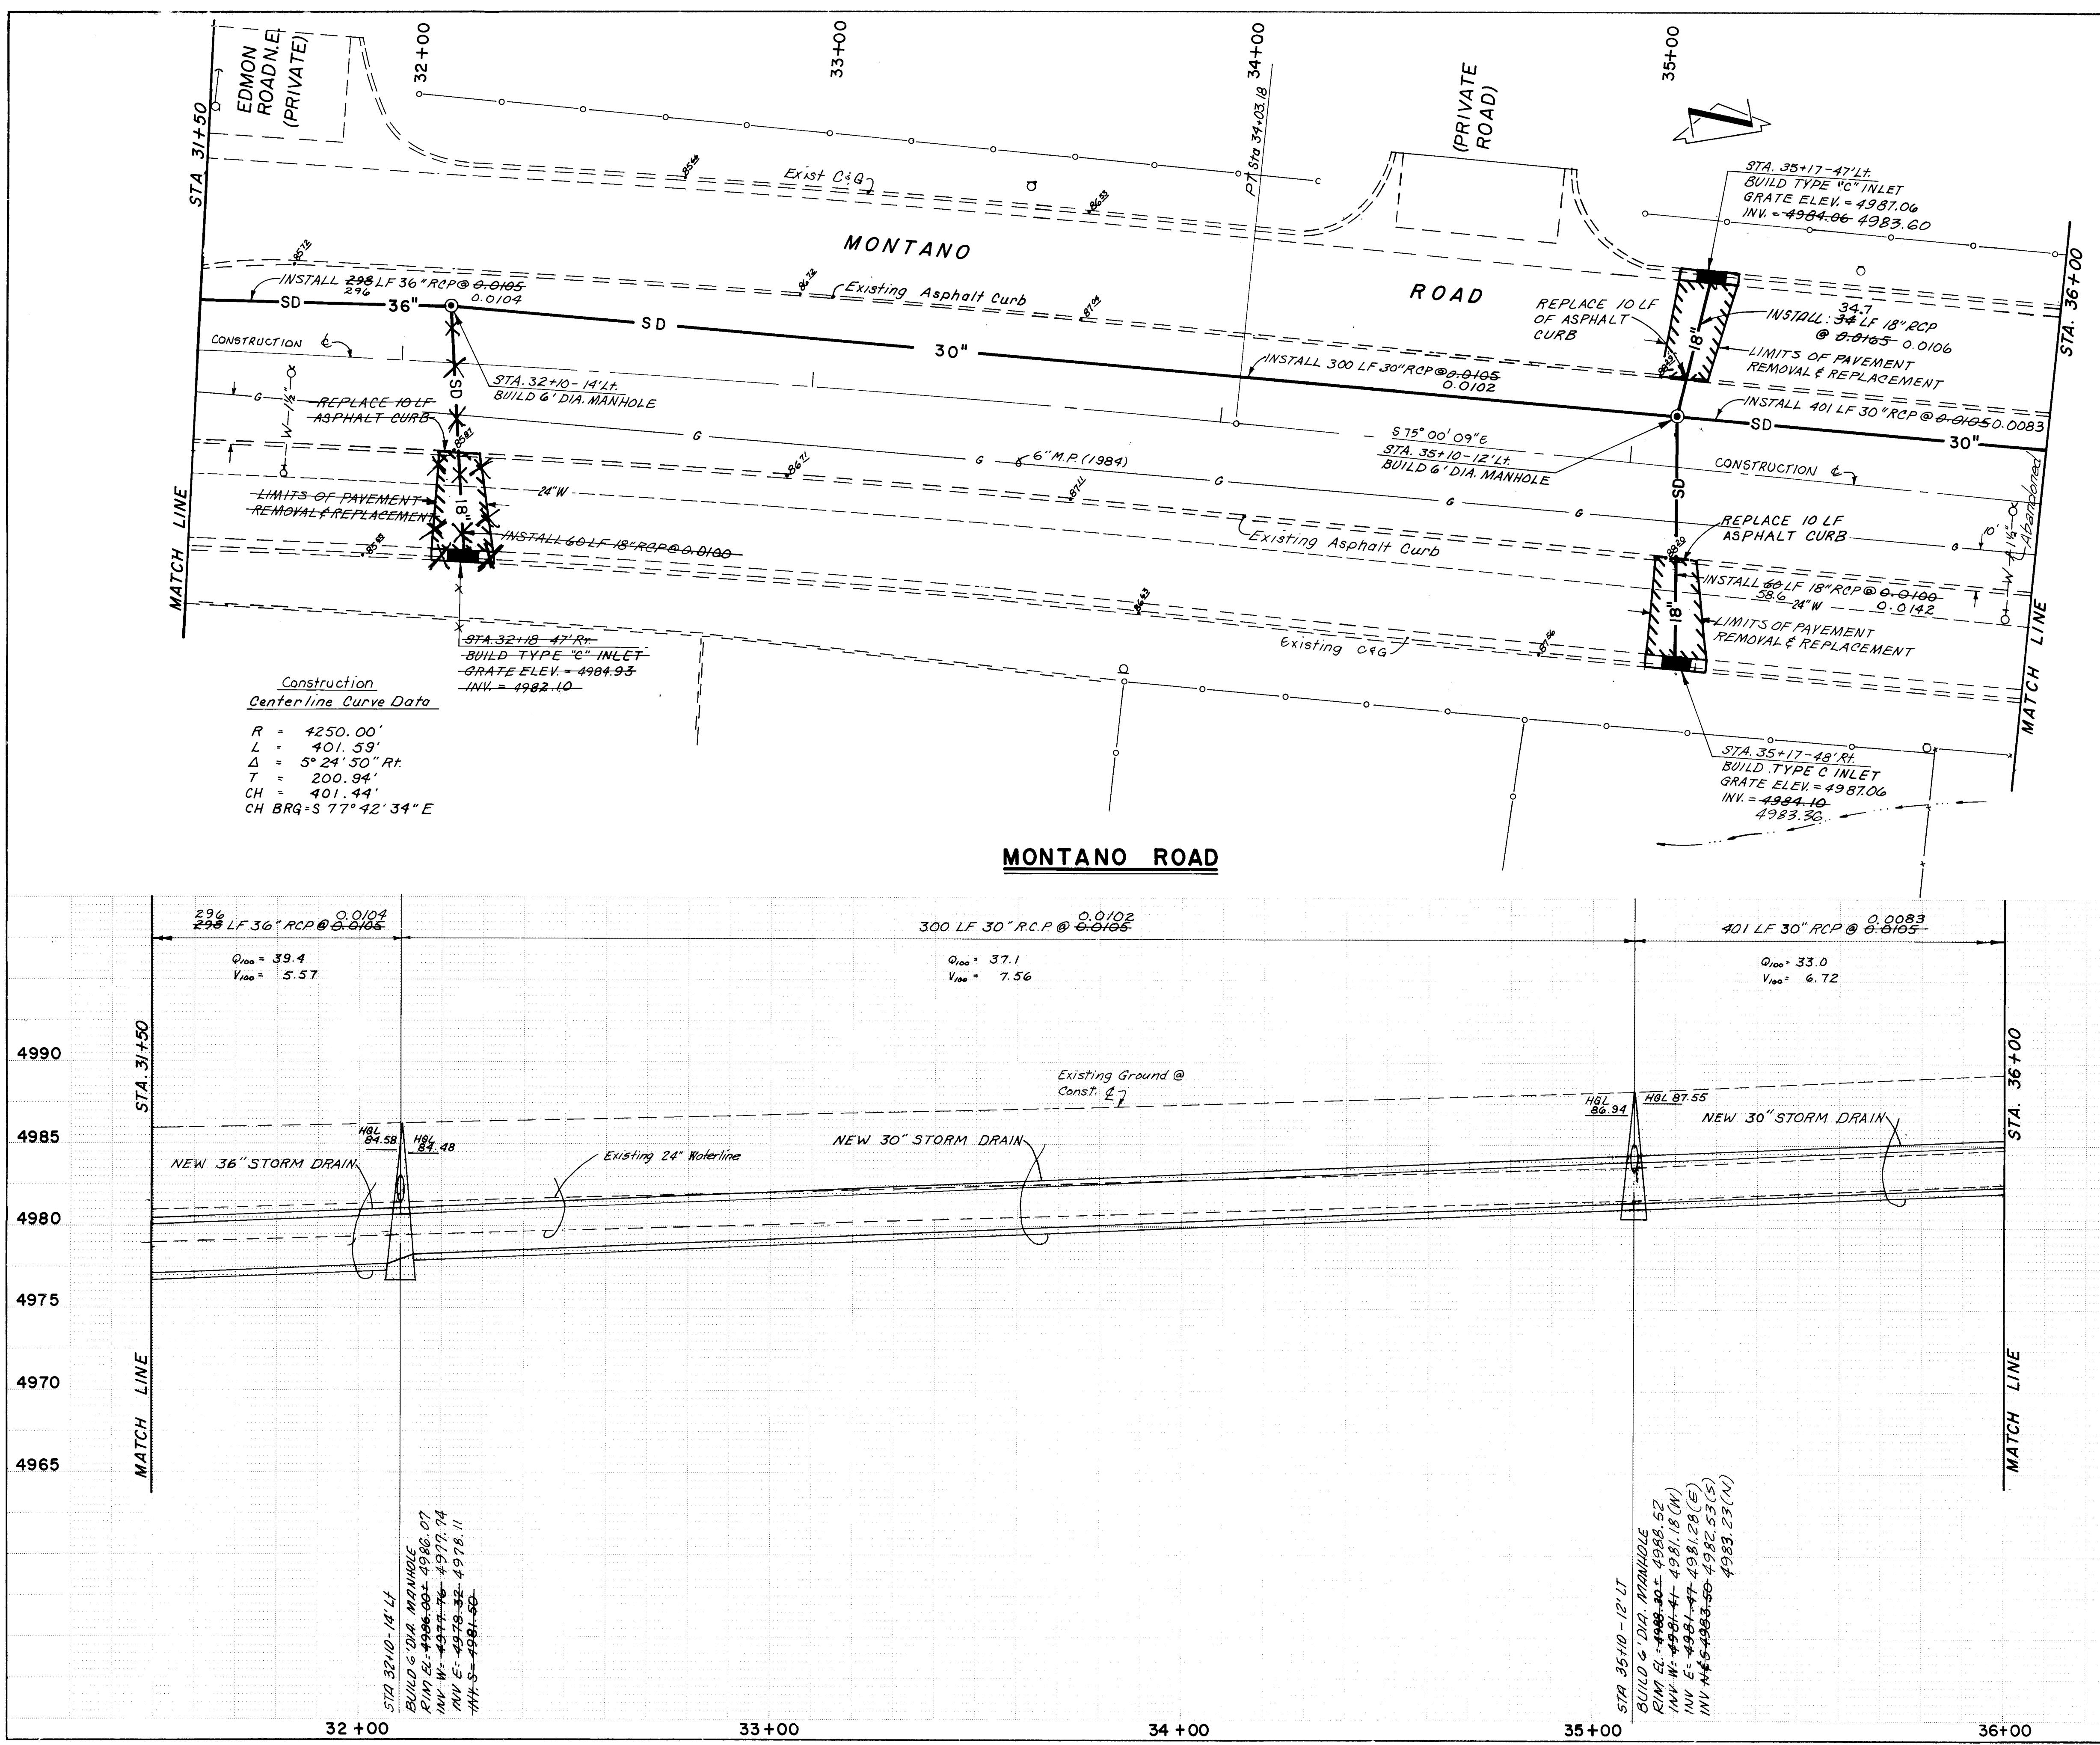

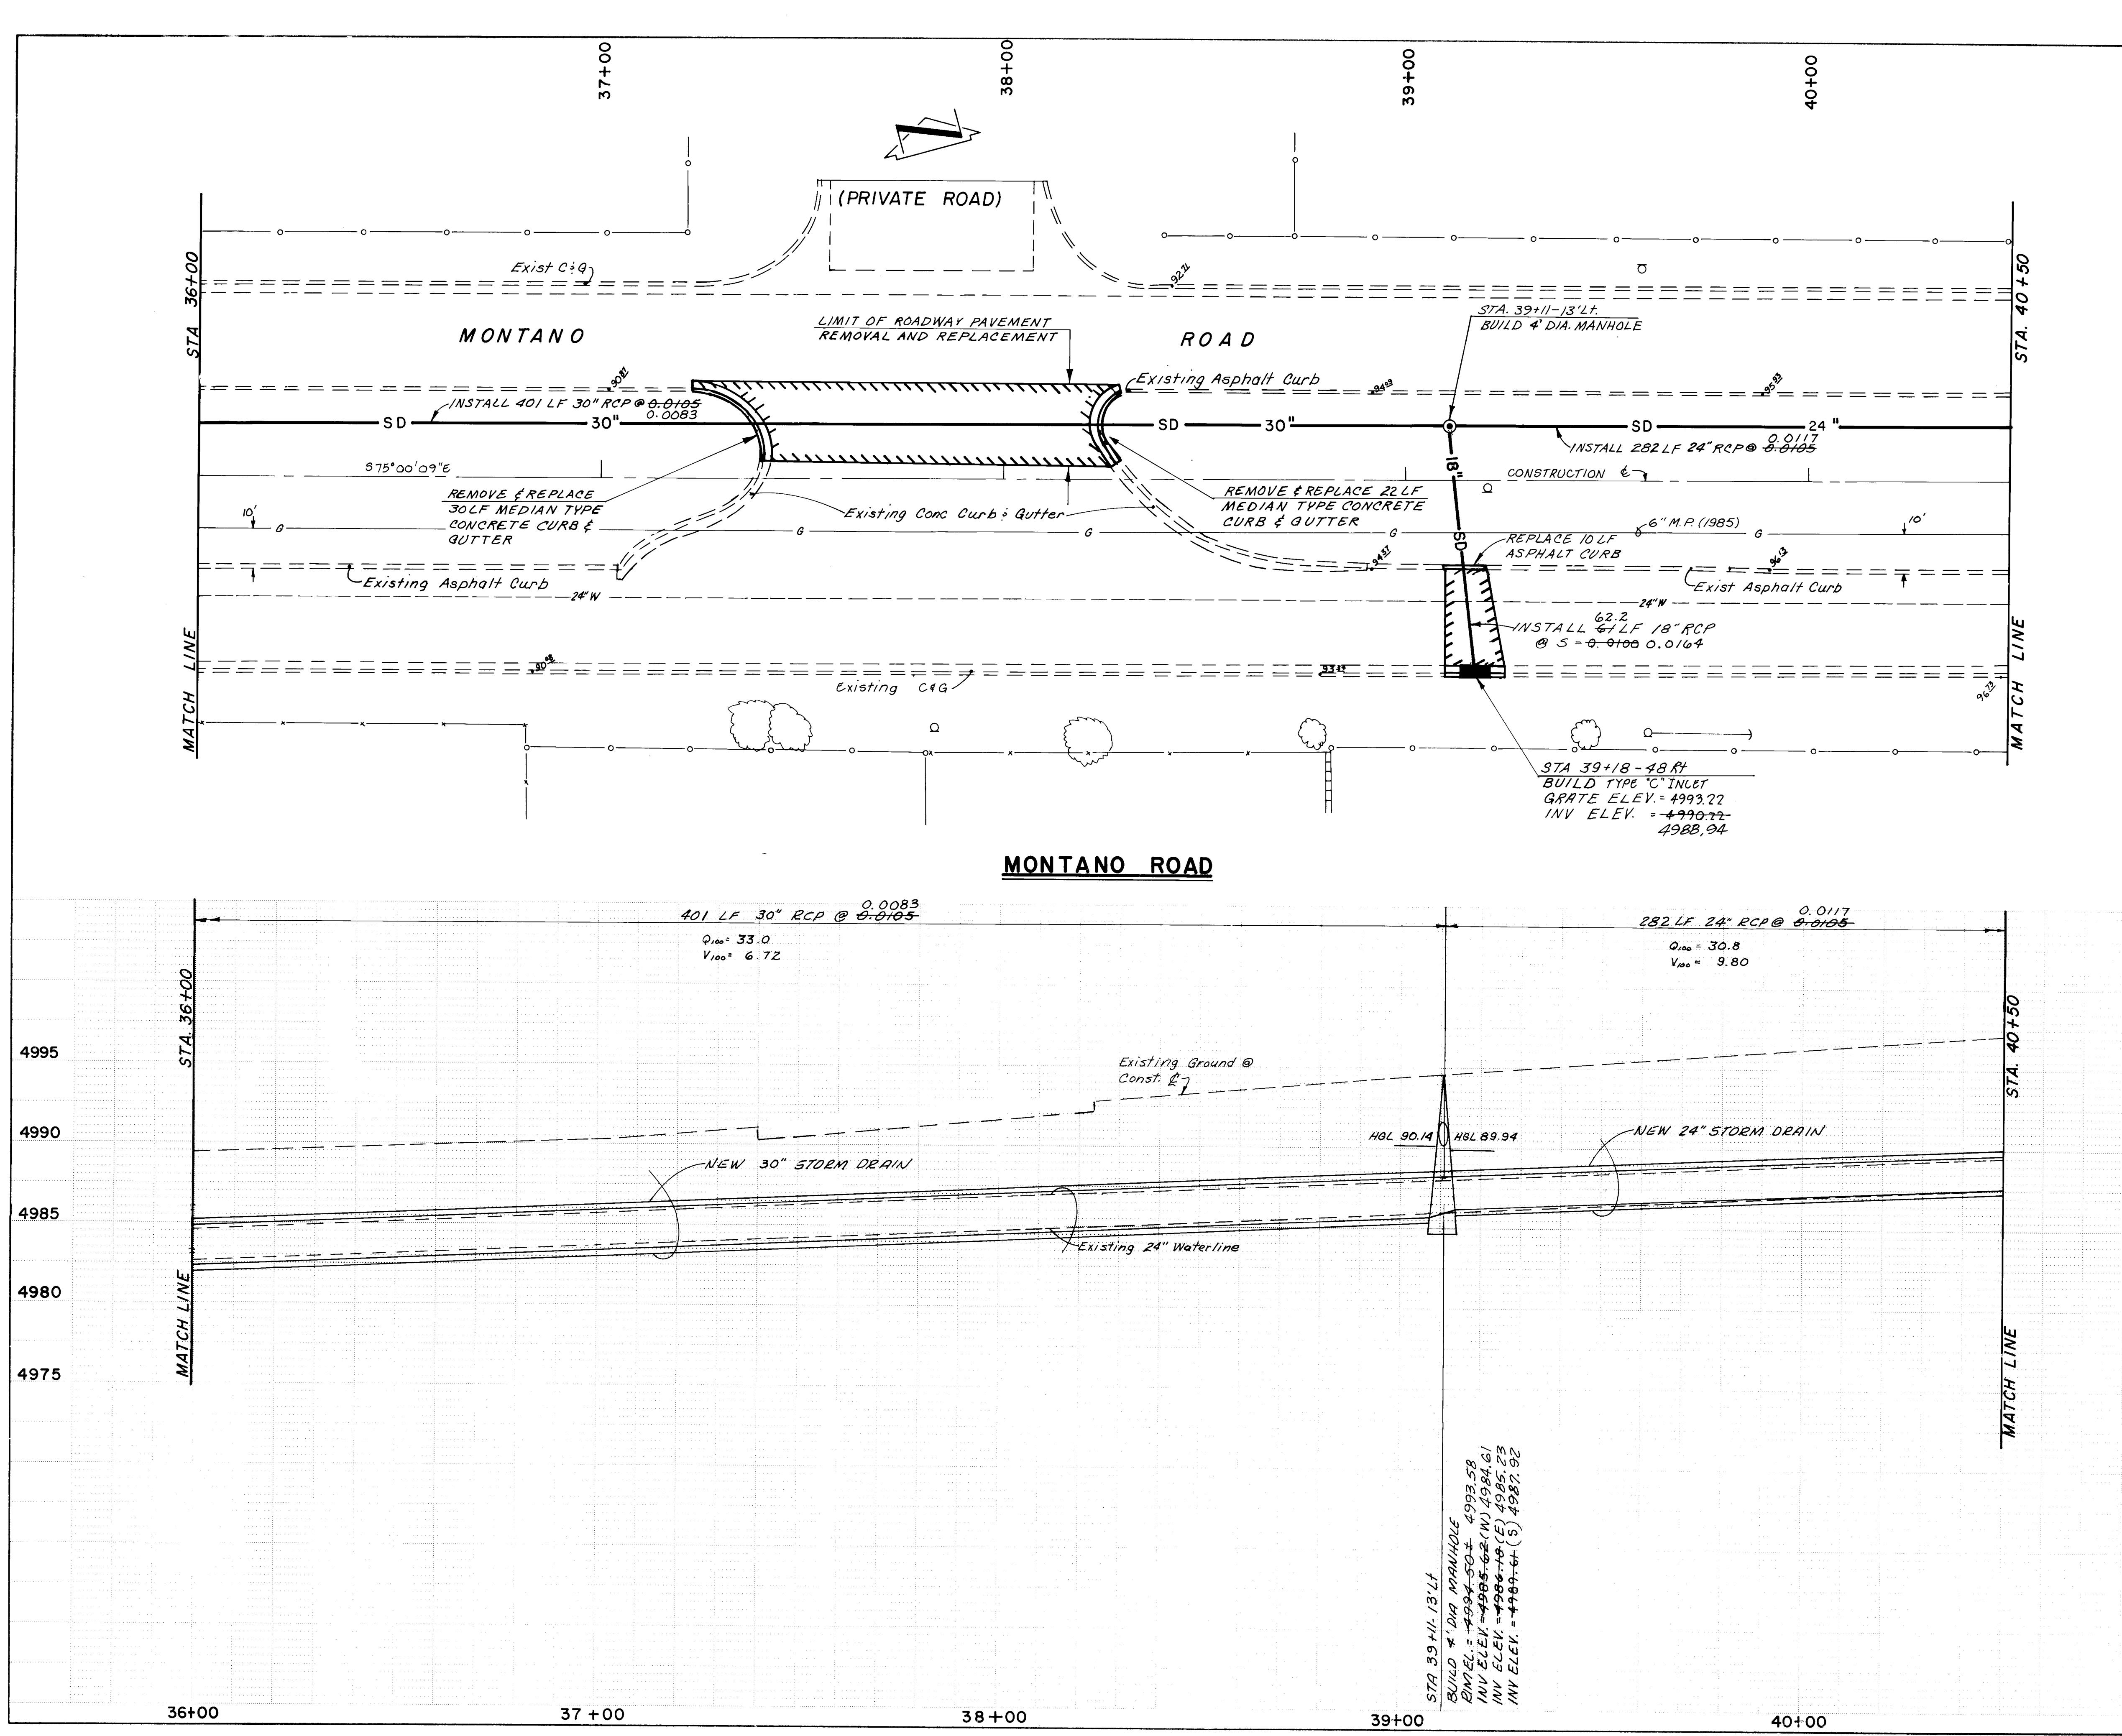OTE:
ALL SPOT ELEVATIONS
SHOWN ARE EXISTING
TOP OF CURB UNLESS
THERWISE NOTED


CITY OF ALBUQUERQUE
IPAL DEVELOPMENT DEPARTMENT
ENGINEERING DIVISION

**NORTH VALLEY DRAINAGE SYSTEM IMPROVEMENTS
MONTANO ROAD SYSTEM(A)
M DRAIN- STA 36+00 TO STA 40+50**

**NORTH VALLEY DRAINAGE SYSTEM IMPROVEMENTS
MONTANO ROAD SYSTEM(A)
M DRAIN-STA 36+00 TO STA 40+50**

S	ENGINEER	DATE	APPROVALS	ENGINEER	DATE
eer	John Hark	12/9/86	Liquid Waste	W/W	12-1-86
sign	Joe D. Loring	12/9/86	Traffic	NATDwH	12/8/86
irology	Don Hogan	12/8/86	Water	W/W	12-1-86

G 2461 MAP NO. F - 15 SHEET 12 OF 19

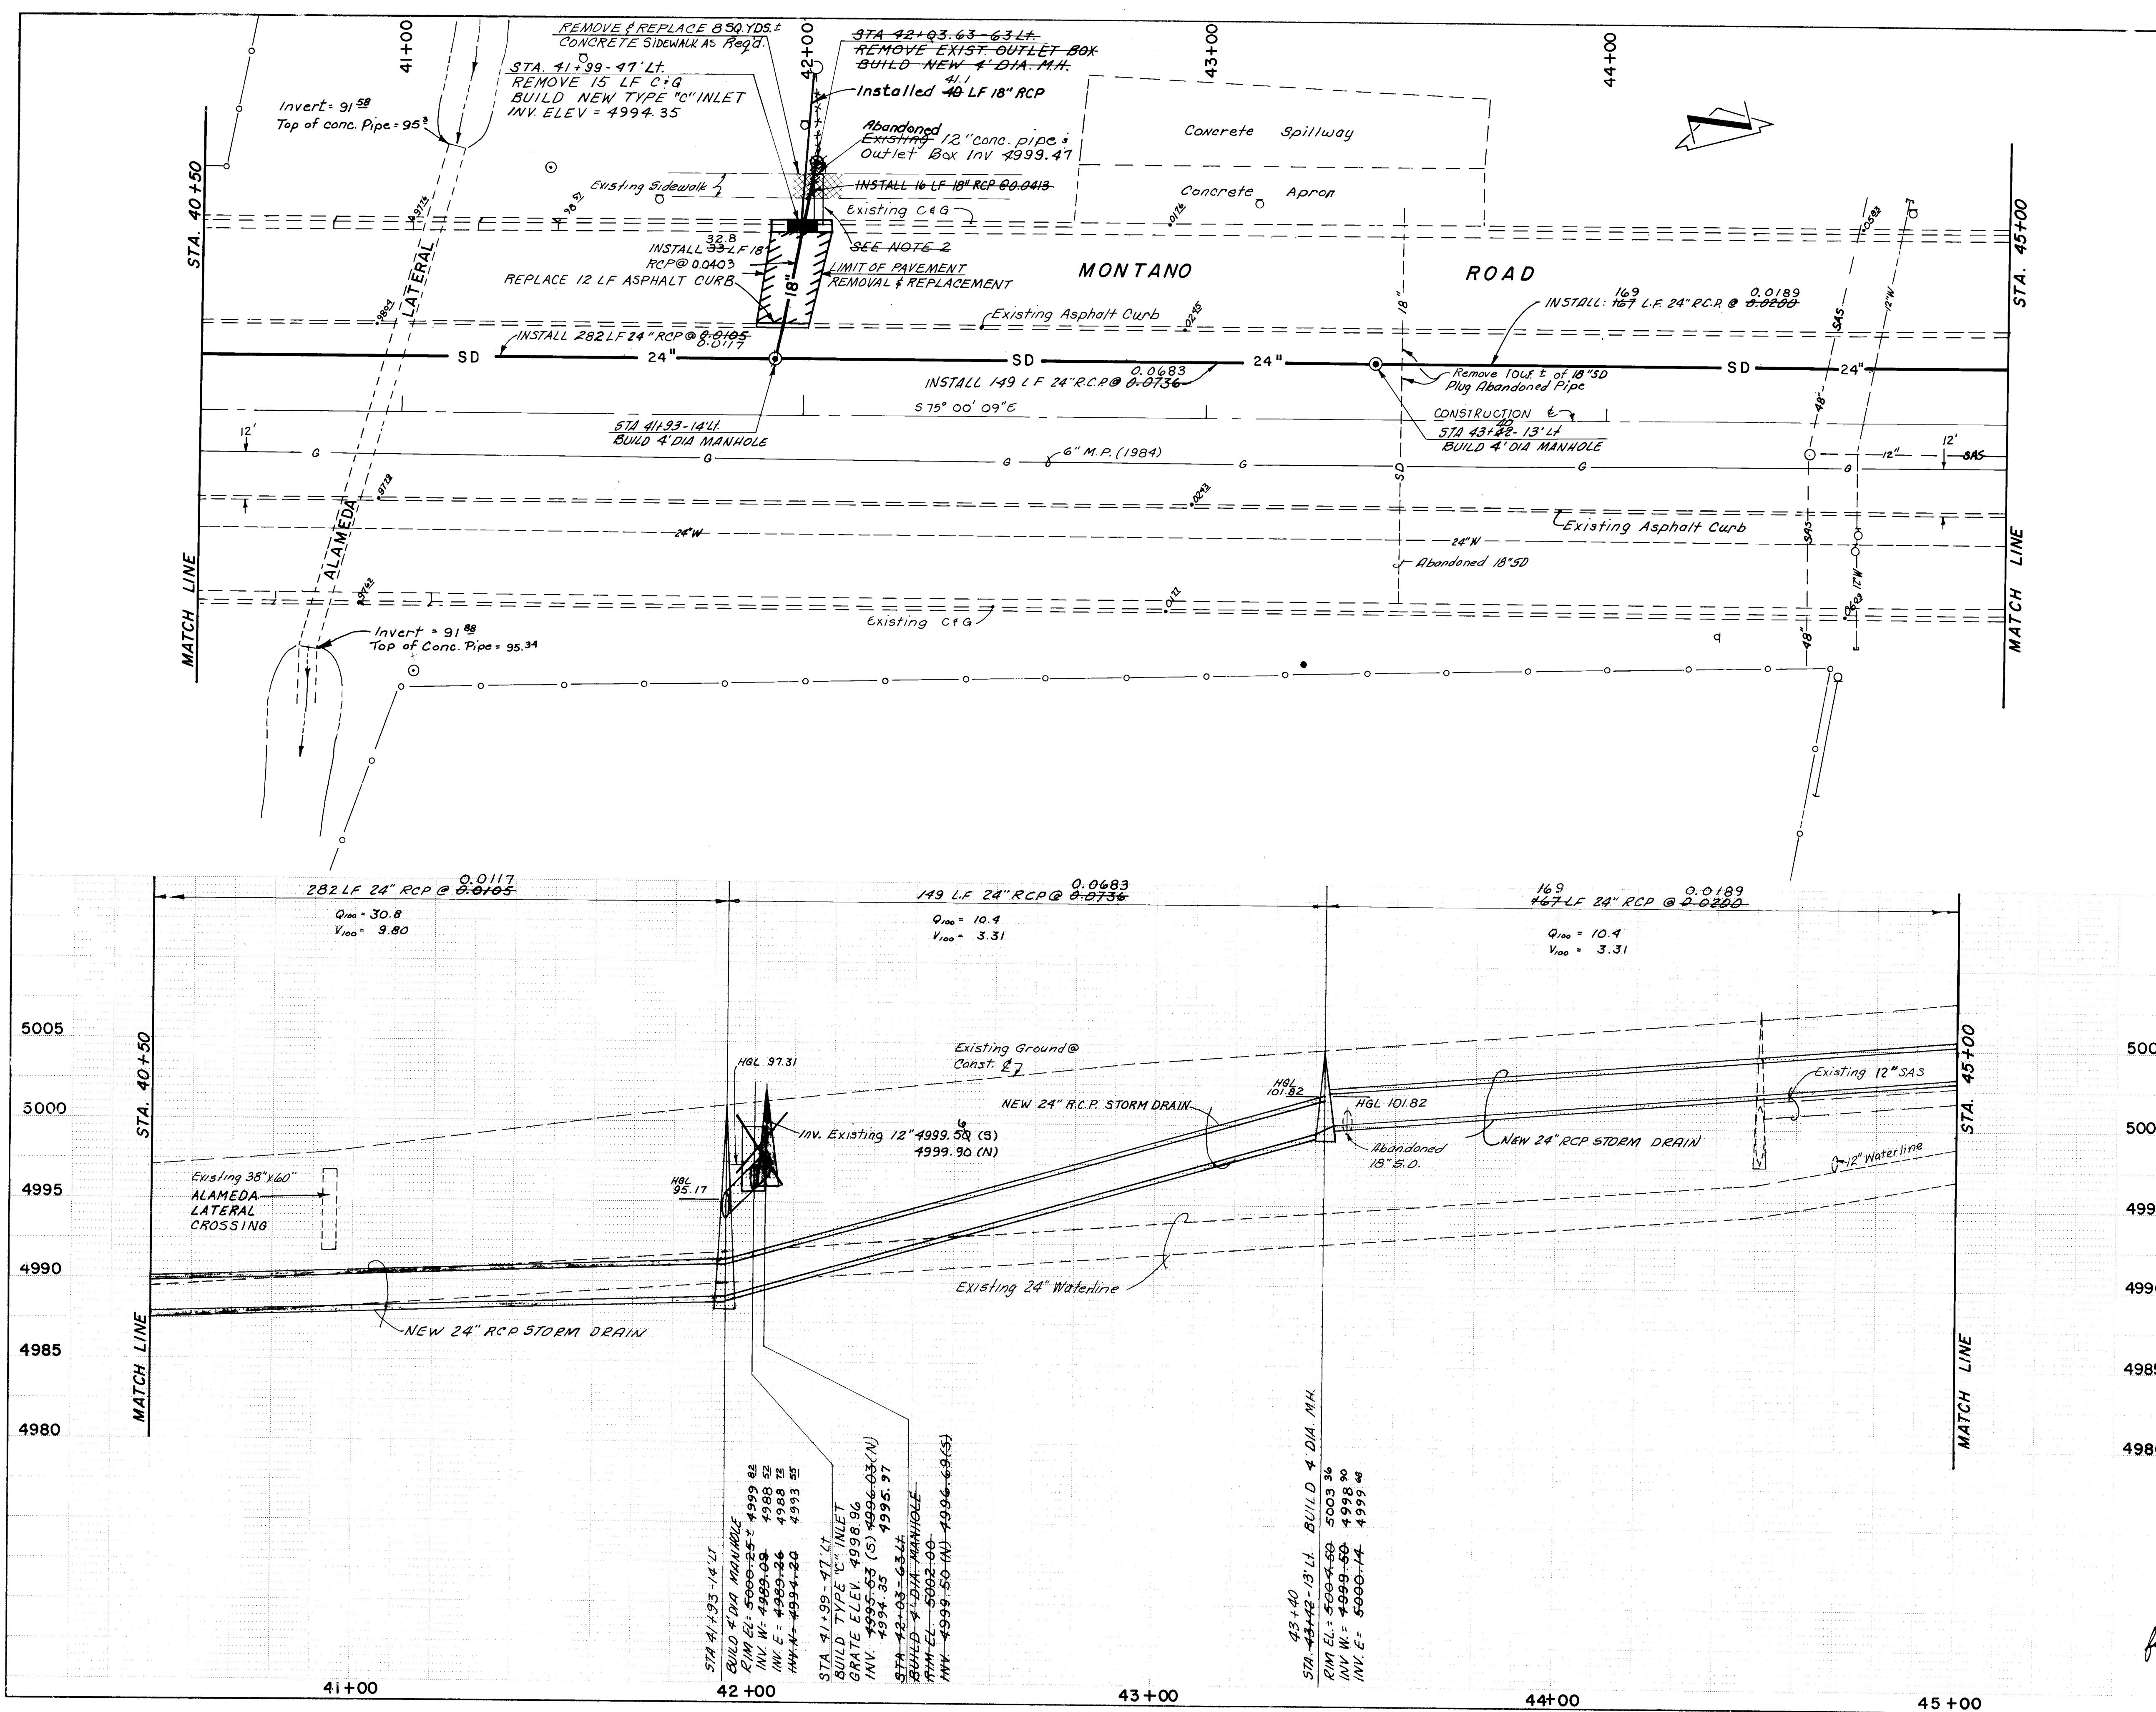

NOTE:


**2. REMOVE EXISTING DRAINLINE
UNDER SIDEWALK AND THROUGH
CURB.**

**CITY OF ALBUQUERQUE
MUNICIPAL DEVELOPMENT DEPARTMENT
ENGINEERING DIVISION**

**TITLE: NORTH VALLEY DRAINAGE SYSTEM IMPROVEMENTS
MONTANO ROAD SYSTEM (A)
FORM DRAIN - STA. 40+50 TO STA. 45+00**

APPROVALS	ENGINEER	DATE	APPROVALS	ENGINEER	DATE
Engineer	J. D. Lanning	12/9/86	Liquid Waste	W/W	12-1-86
Design	J. D. Lanning	12/9/86	Traffic	NADWH	12/8/86
Hydrology	John Hogan	12/8/86	Water	W/W	12-1-86

2461	F - 15	13	19
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NOTE:
ALL SPOT ELEVATIONS
SHOWN ARE EXISTING
TOP OF CURB UNLESS
OTHERWISE NOTED

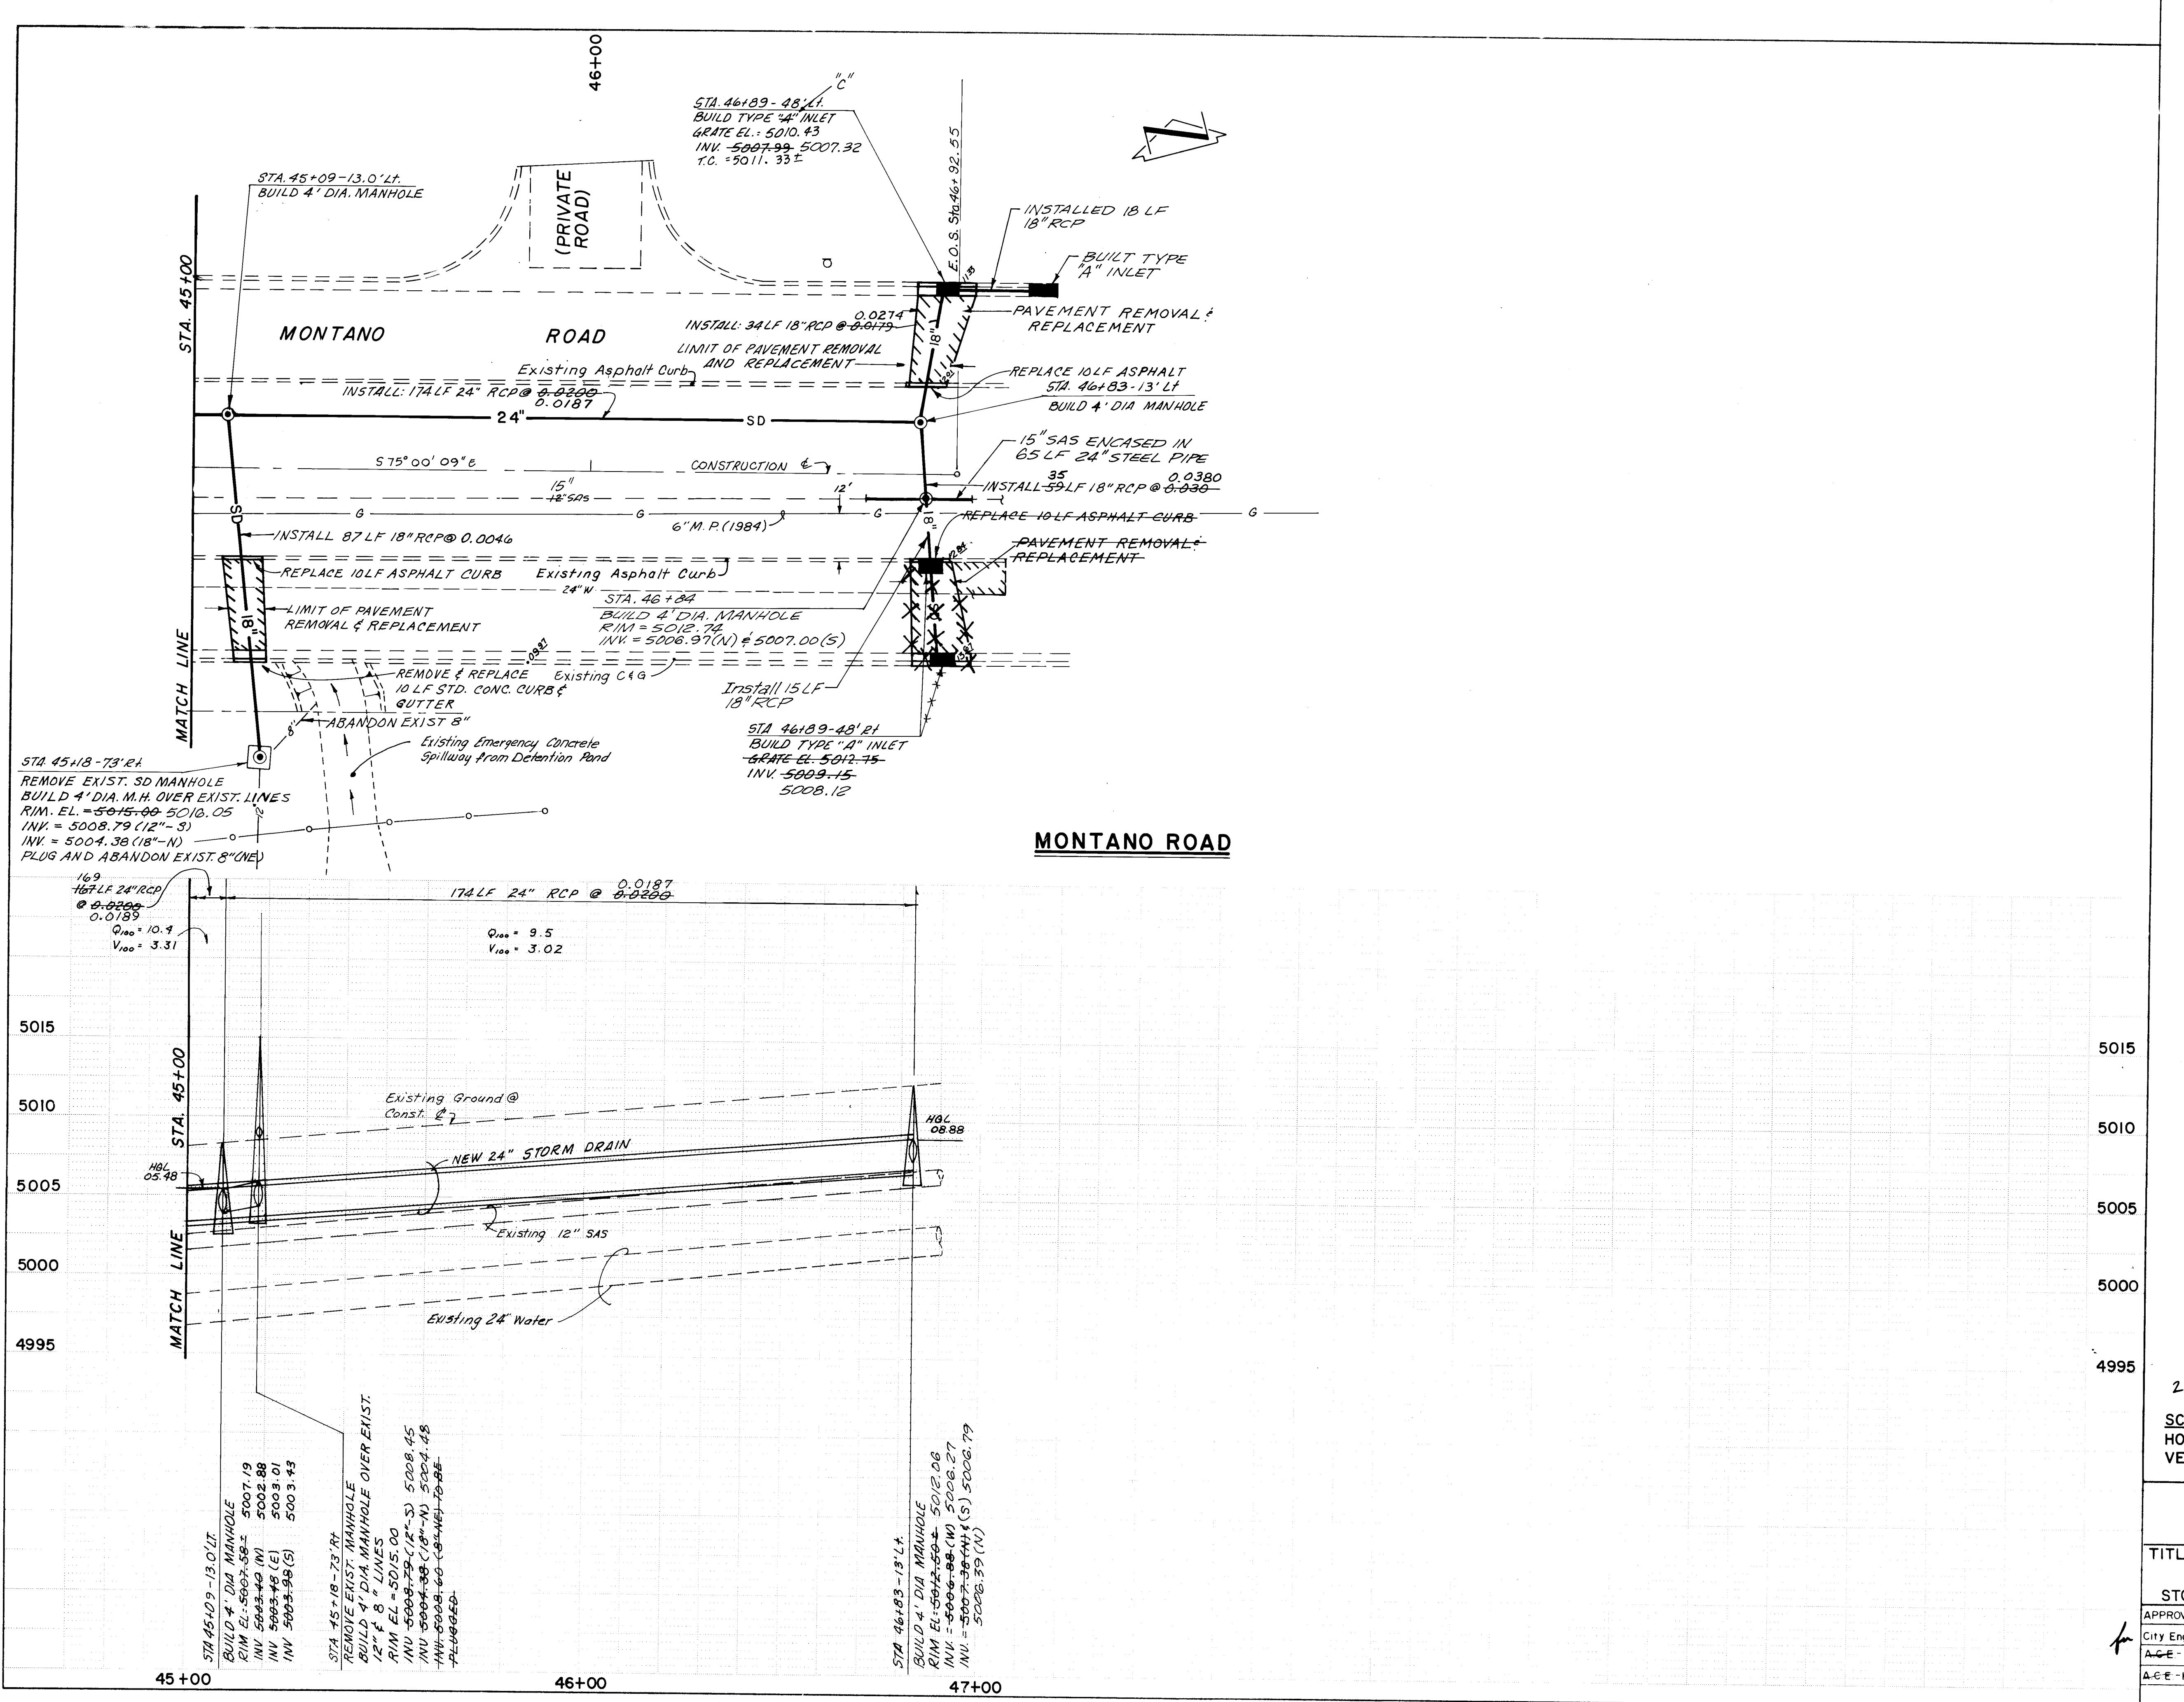AS BUILT INFORMATION		BENCH MARKS		AS BUILT NOTES	
CONTRACTOR	WORK	SCANDON & ASSOCIATES	DATE	CONTRACTOR	WORK
Scandon & Associates	SD	Scandon & Associates	DATE 11-86	Scandon & Associates	SD
ACCE - Design	SD	ACCE - Design	DATE 12/1/86	ACCE - Hydrology	SD
DRAWN BY Scanlon & Associates DATE 12/1/86		MICRO-FILM INFORMATION		RECORDED BY NO	
ELEV. 4984.24		ELEV. 4984.24		ELEV. 4974.569	
NM SHC/ACS NM 47-8 BRASS TABLET		TABLET IN ISLAND ON SECOND STREET NORTH OF MONTANO		ELEV. 4974.569	

26 24611488


SCALES:
HORIZONTAL 1" = 20'
VERTICAL 1" = 5'

CITY OF ALBUQUERQUE
MUNICIPAL DEVELOPMENT DEPARTMENT
ENGINEERING DIVISION


TITLE: NORTH VALLEY DRAINAGE SYSTEM IMPROVEMENTS
MONTANO ROAD SYSTEM (A)
STORM DRAIN-SHAFT STA. 45+00 TO STA. 46+92.55


APPROVALS	ENGINEER	DATE	APPROVALS	ENGINEER	DATE
City Engineer	J. D. Scandon	12/1/86	Liquid Waste	W.W.	12-1-86
ACCE - Design	J. D. Scandon	12/1/86	Traffic	NADW	12/1/86
ACCE - Hydrology	John Scandon	12/1/86	Water	W.W.	12-1-86

DRAWING NO **2461** MAP NO. **F - 15** SHEET **14** OF **19**

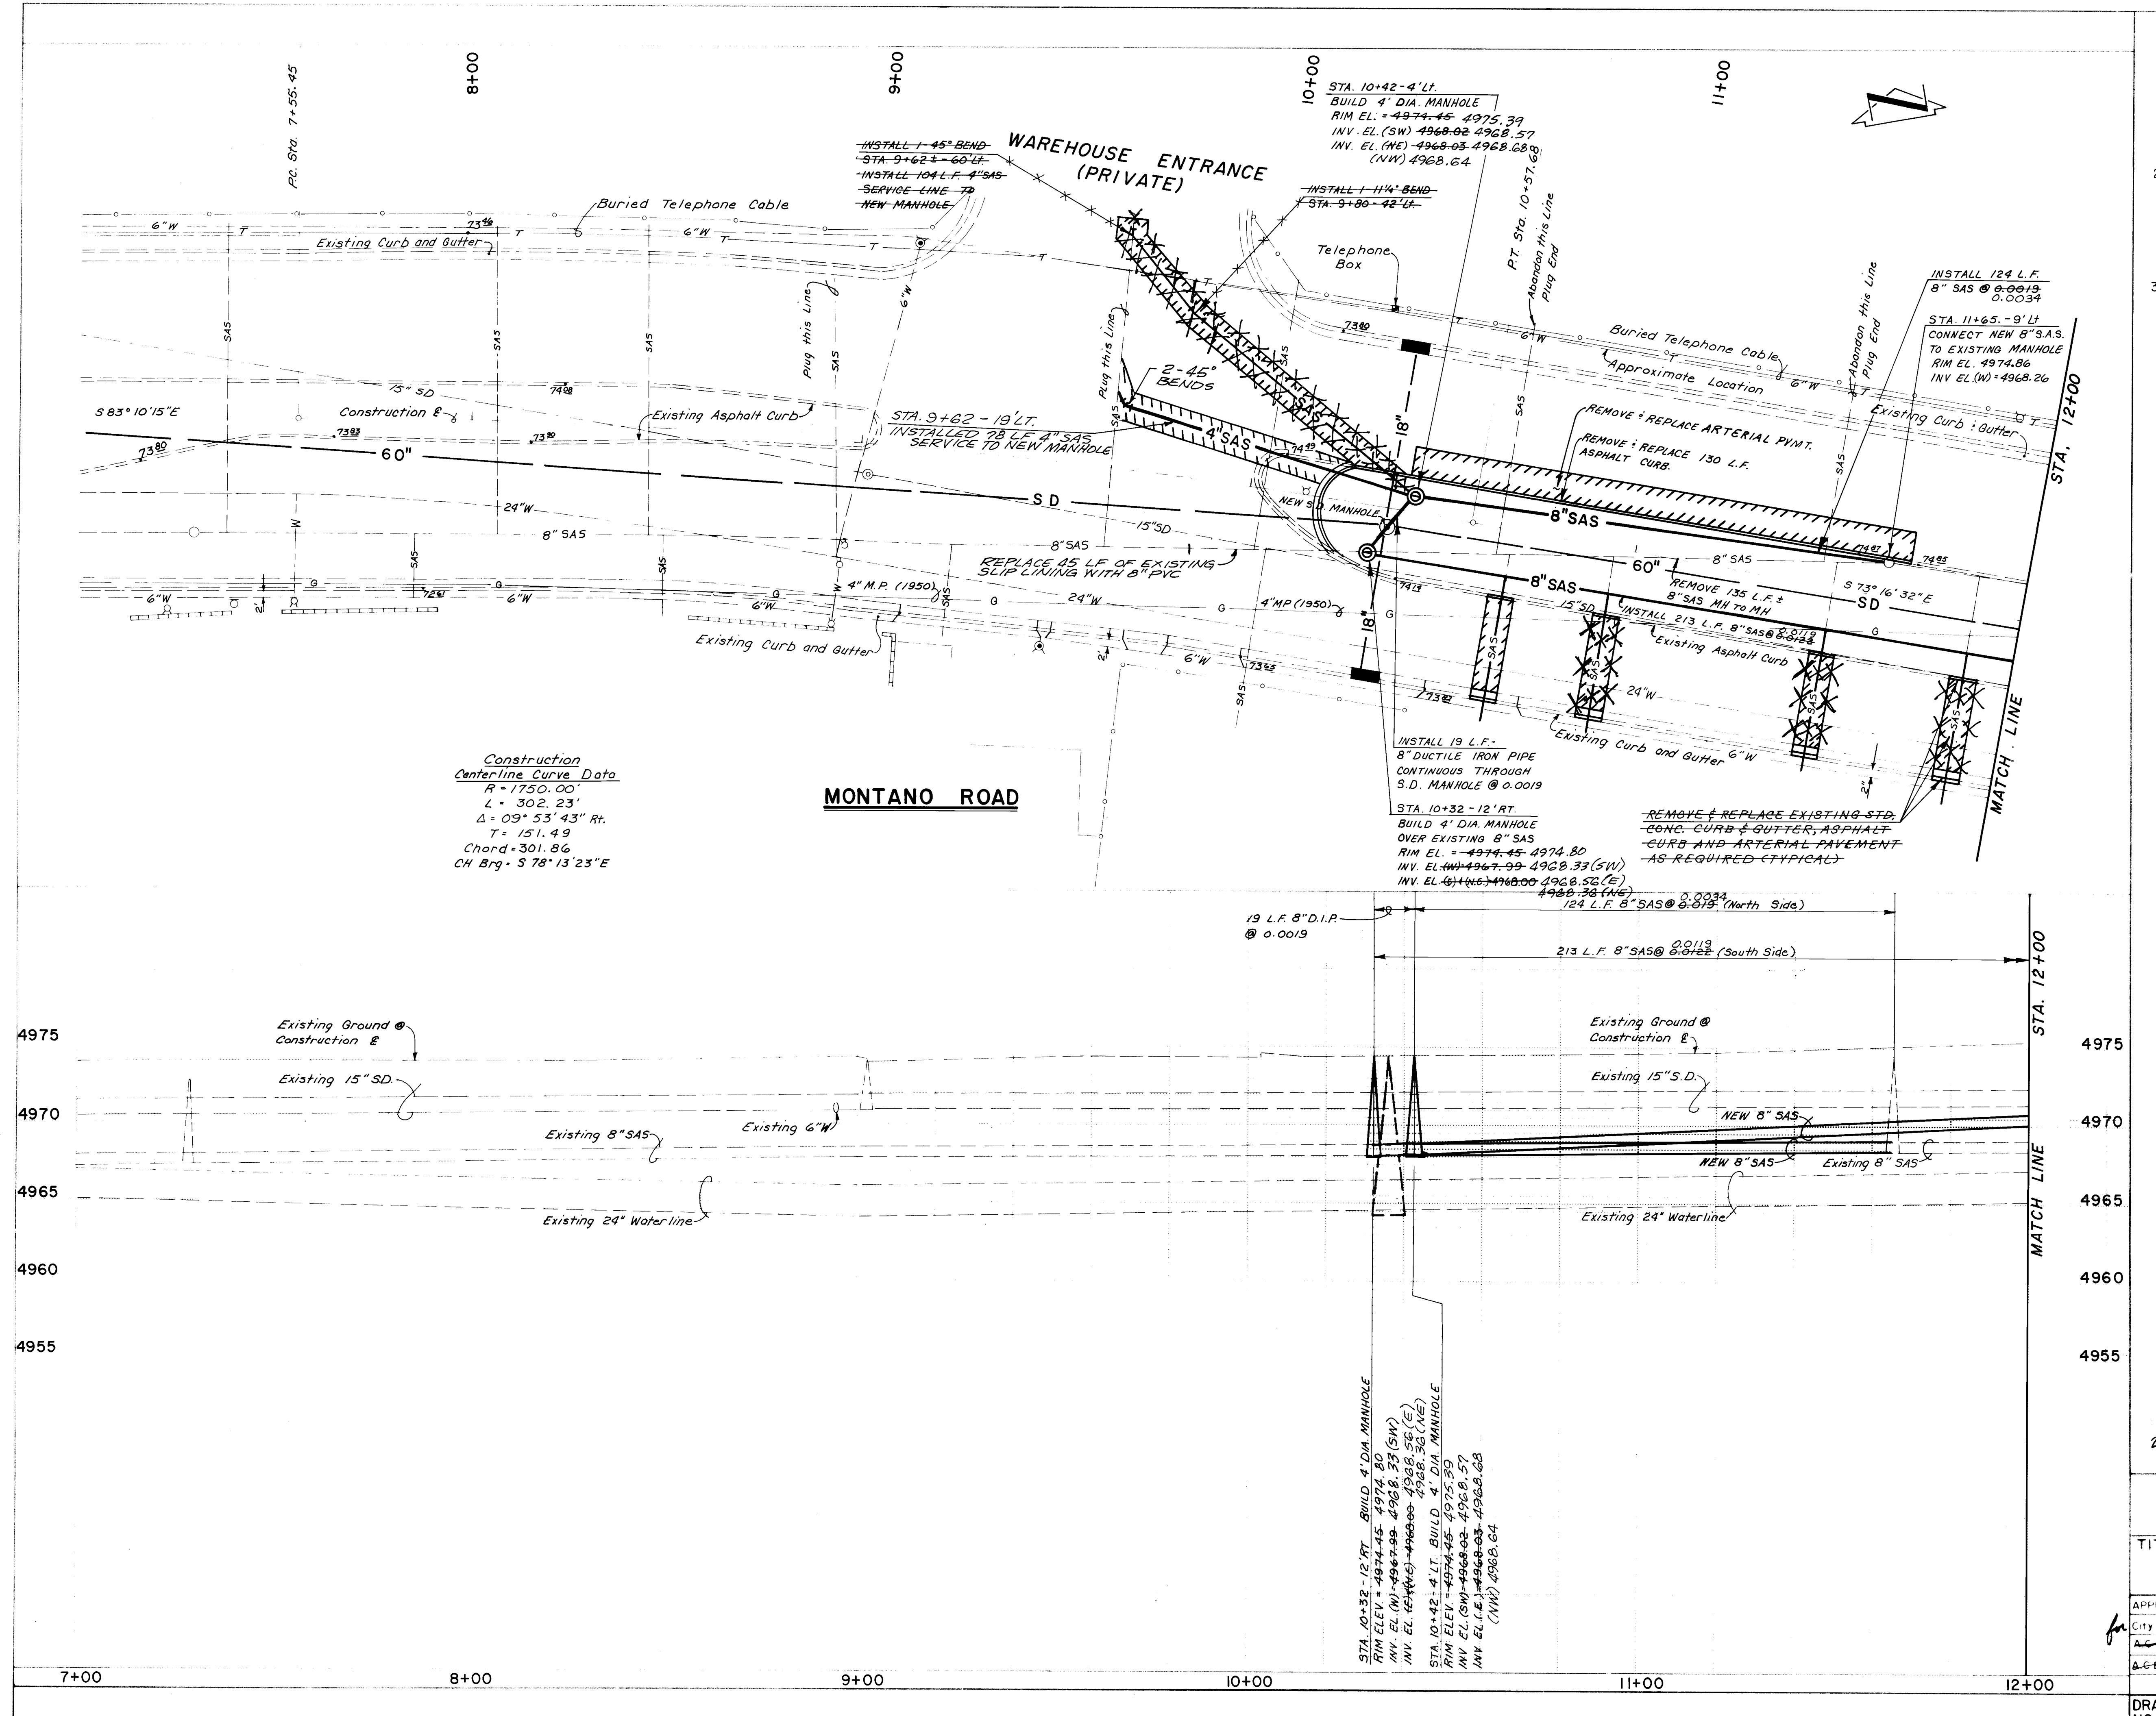

ENGINEER'S SEAL		SURVEY INFORMATION		BENCH MARKS		AS BUILT INFORMATION	
NO	BY	FIELD NOTES	DATE	ACS 2 - F15A - ACS BRASS TABLET ON CONCRETE POST SOUTHWEST CORNER MONTANO & EDITH ELEV. 4984.24	DATE	Scanton & Associates Inc.	11-88
REVISIONS	BY	REMARKS	DATE	REMARKS	DATE	REMARKS	DATE
4975				4975		4975	
4970				4970		4970	
4965				4965		4965	
4960				4960		4960	
4955				4955		4955	
4950				4950		4950	
4945				4945		4945	
4940				4940		4940	
4935				4935		4935	
4930				4930		4930	
4925				4925		4925	
4920				4920		4920	
4915				4915		4915	
4910				4910		4910	
4905				4905		4905	
4900				4900		4900	
4895				4895		4895	
4890				4890		4890	
4885				4885		4885	
4880				4880		4880	
4875				4875		4875	
4870				4870		4870	
4865				4865		4865	
4860				4860		4860	
4855				4855		4855	
4850				4850		4850	
4845				4845		4845	
4840				4840		4840	
4835				4835		4835	
4830				4830		4830	
4825				4825		4825	
4820				4820		4820	
4815				4815		4815	
4810				4810		4810	
4805				4805		4805	
4800				4800		4800	
4795				4795		4795	
4790				4790		4790	
4785				4785		4785	
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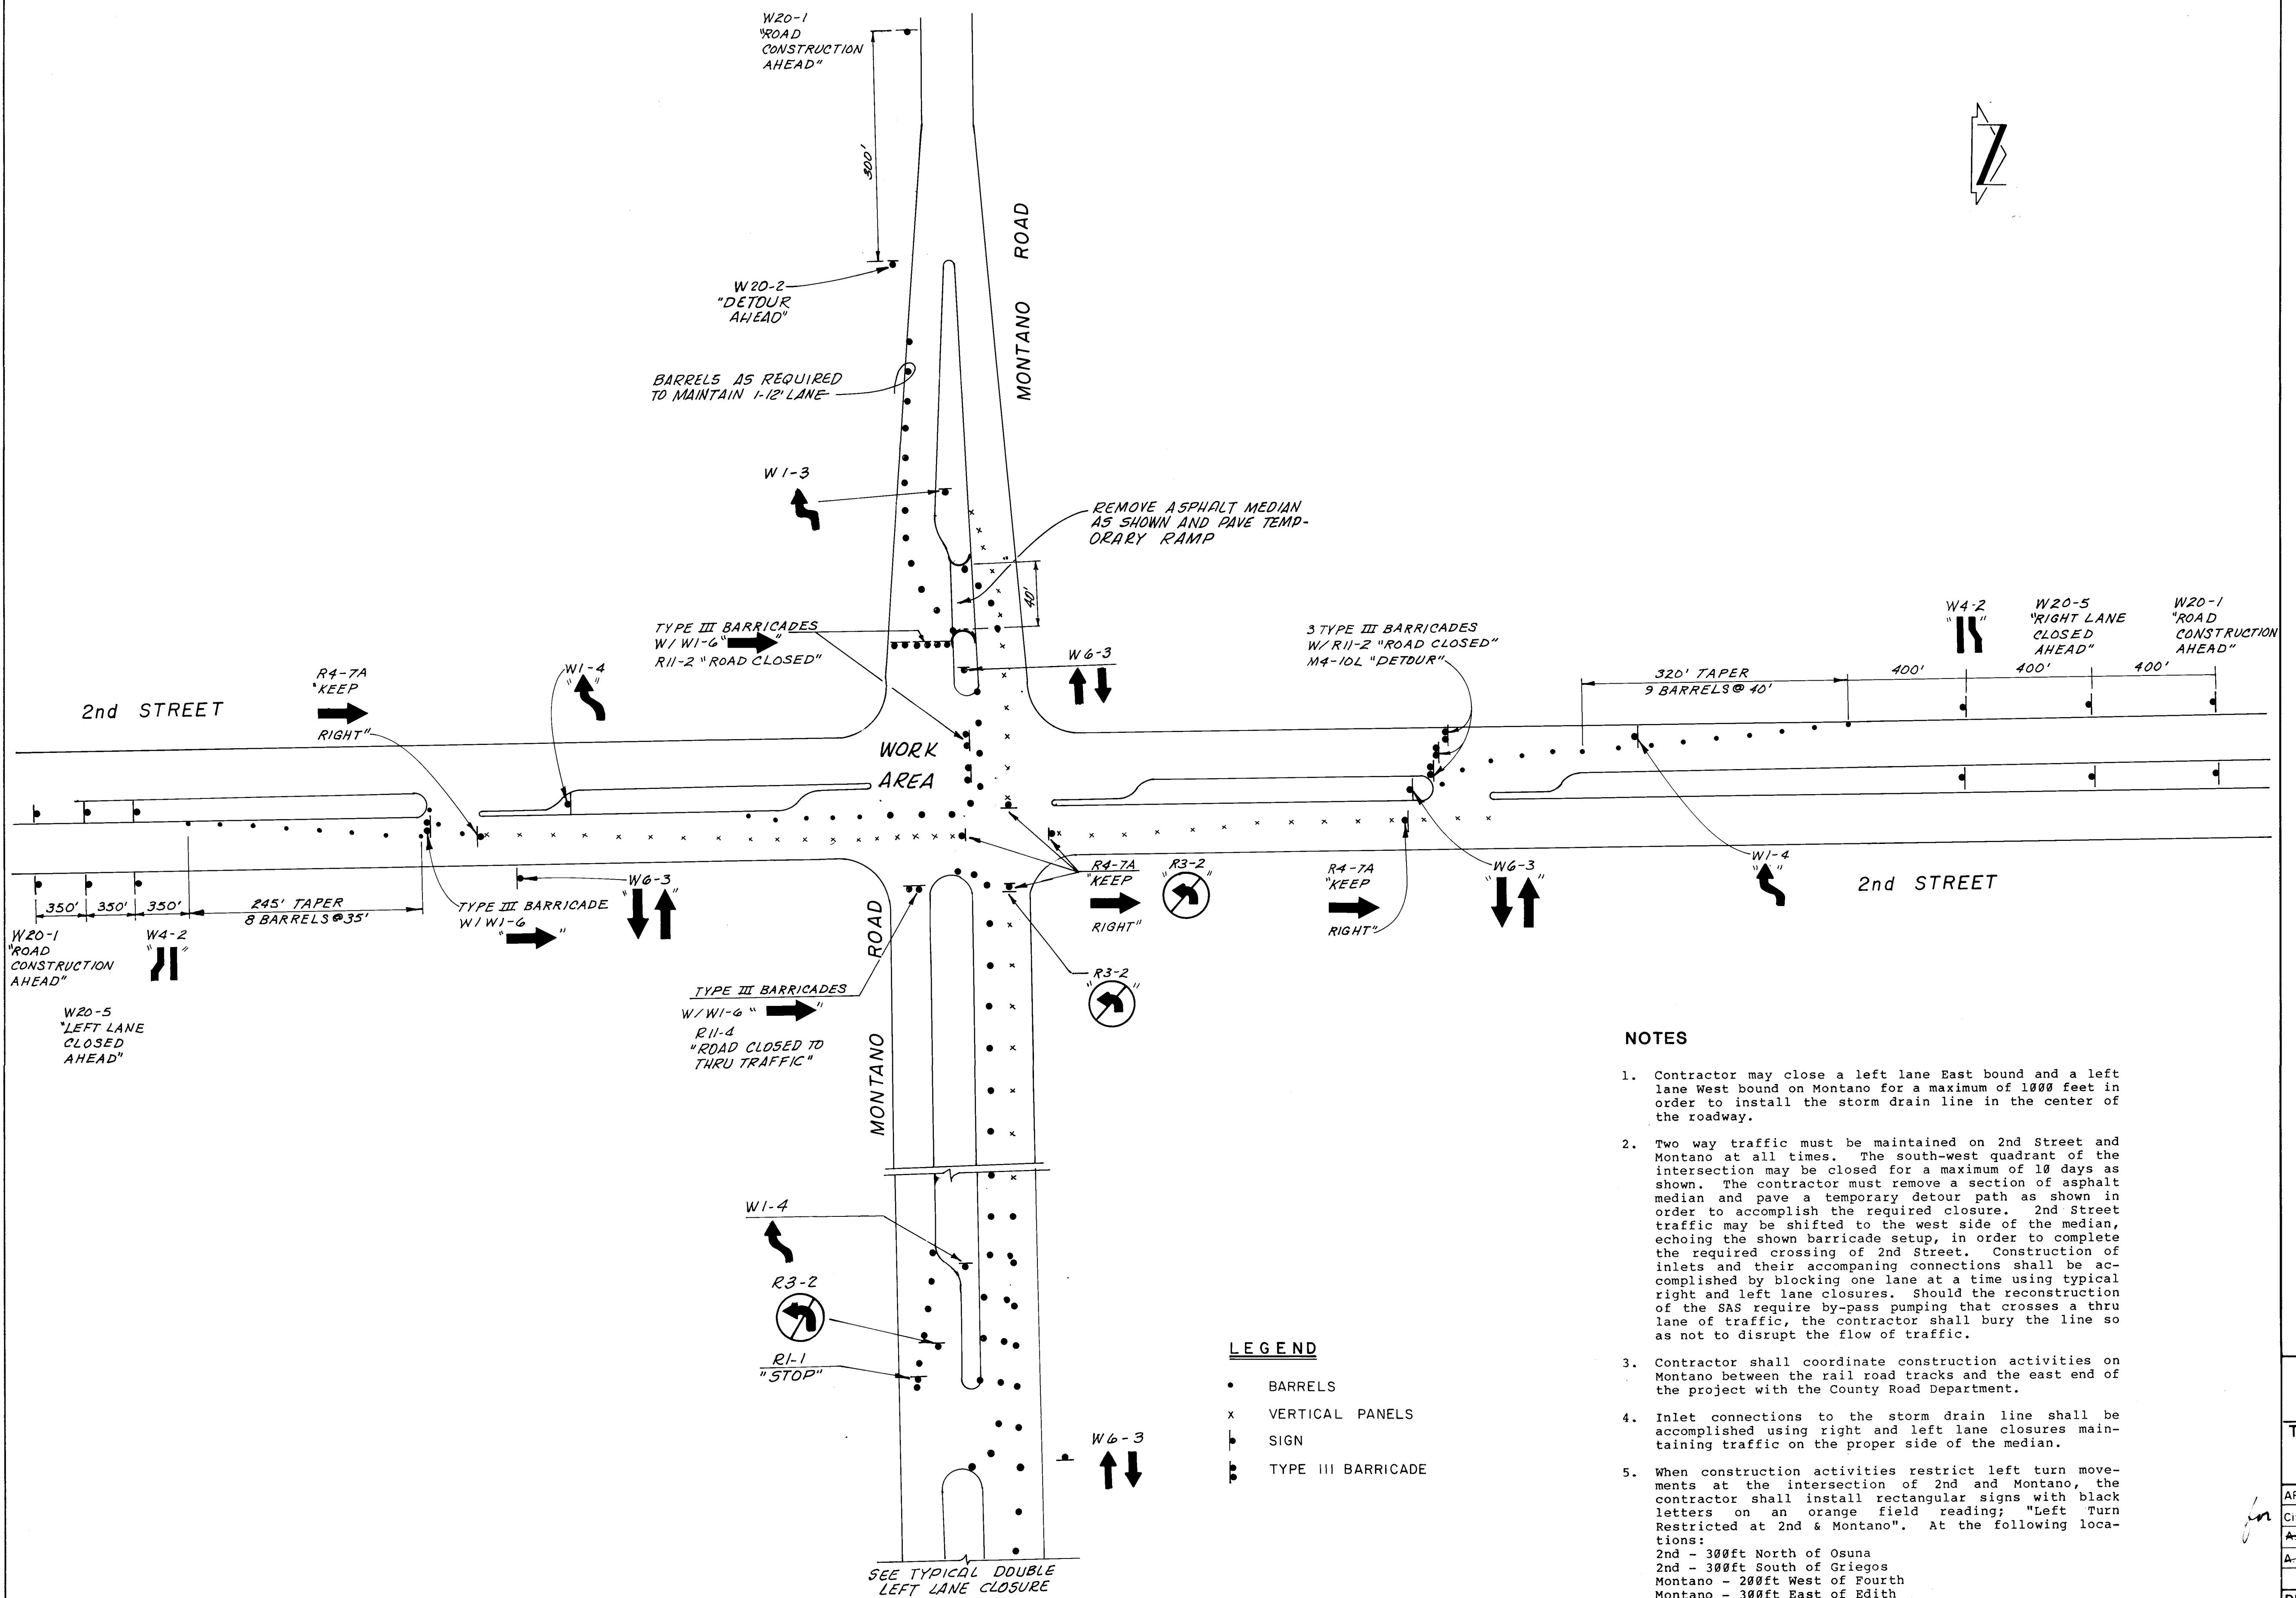


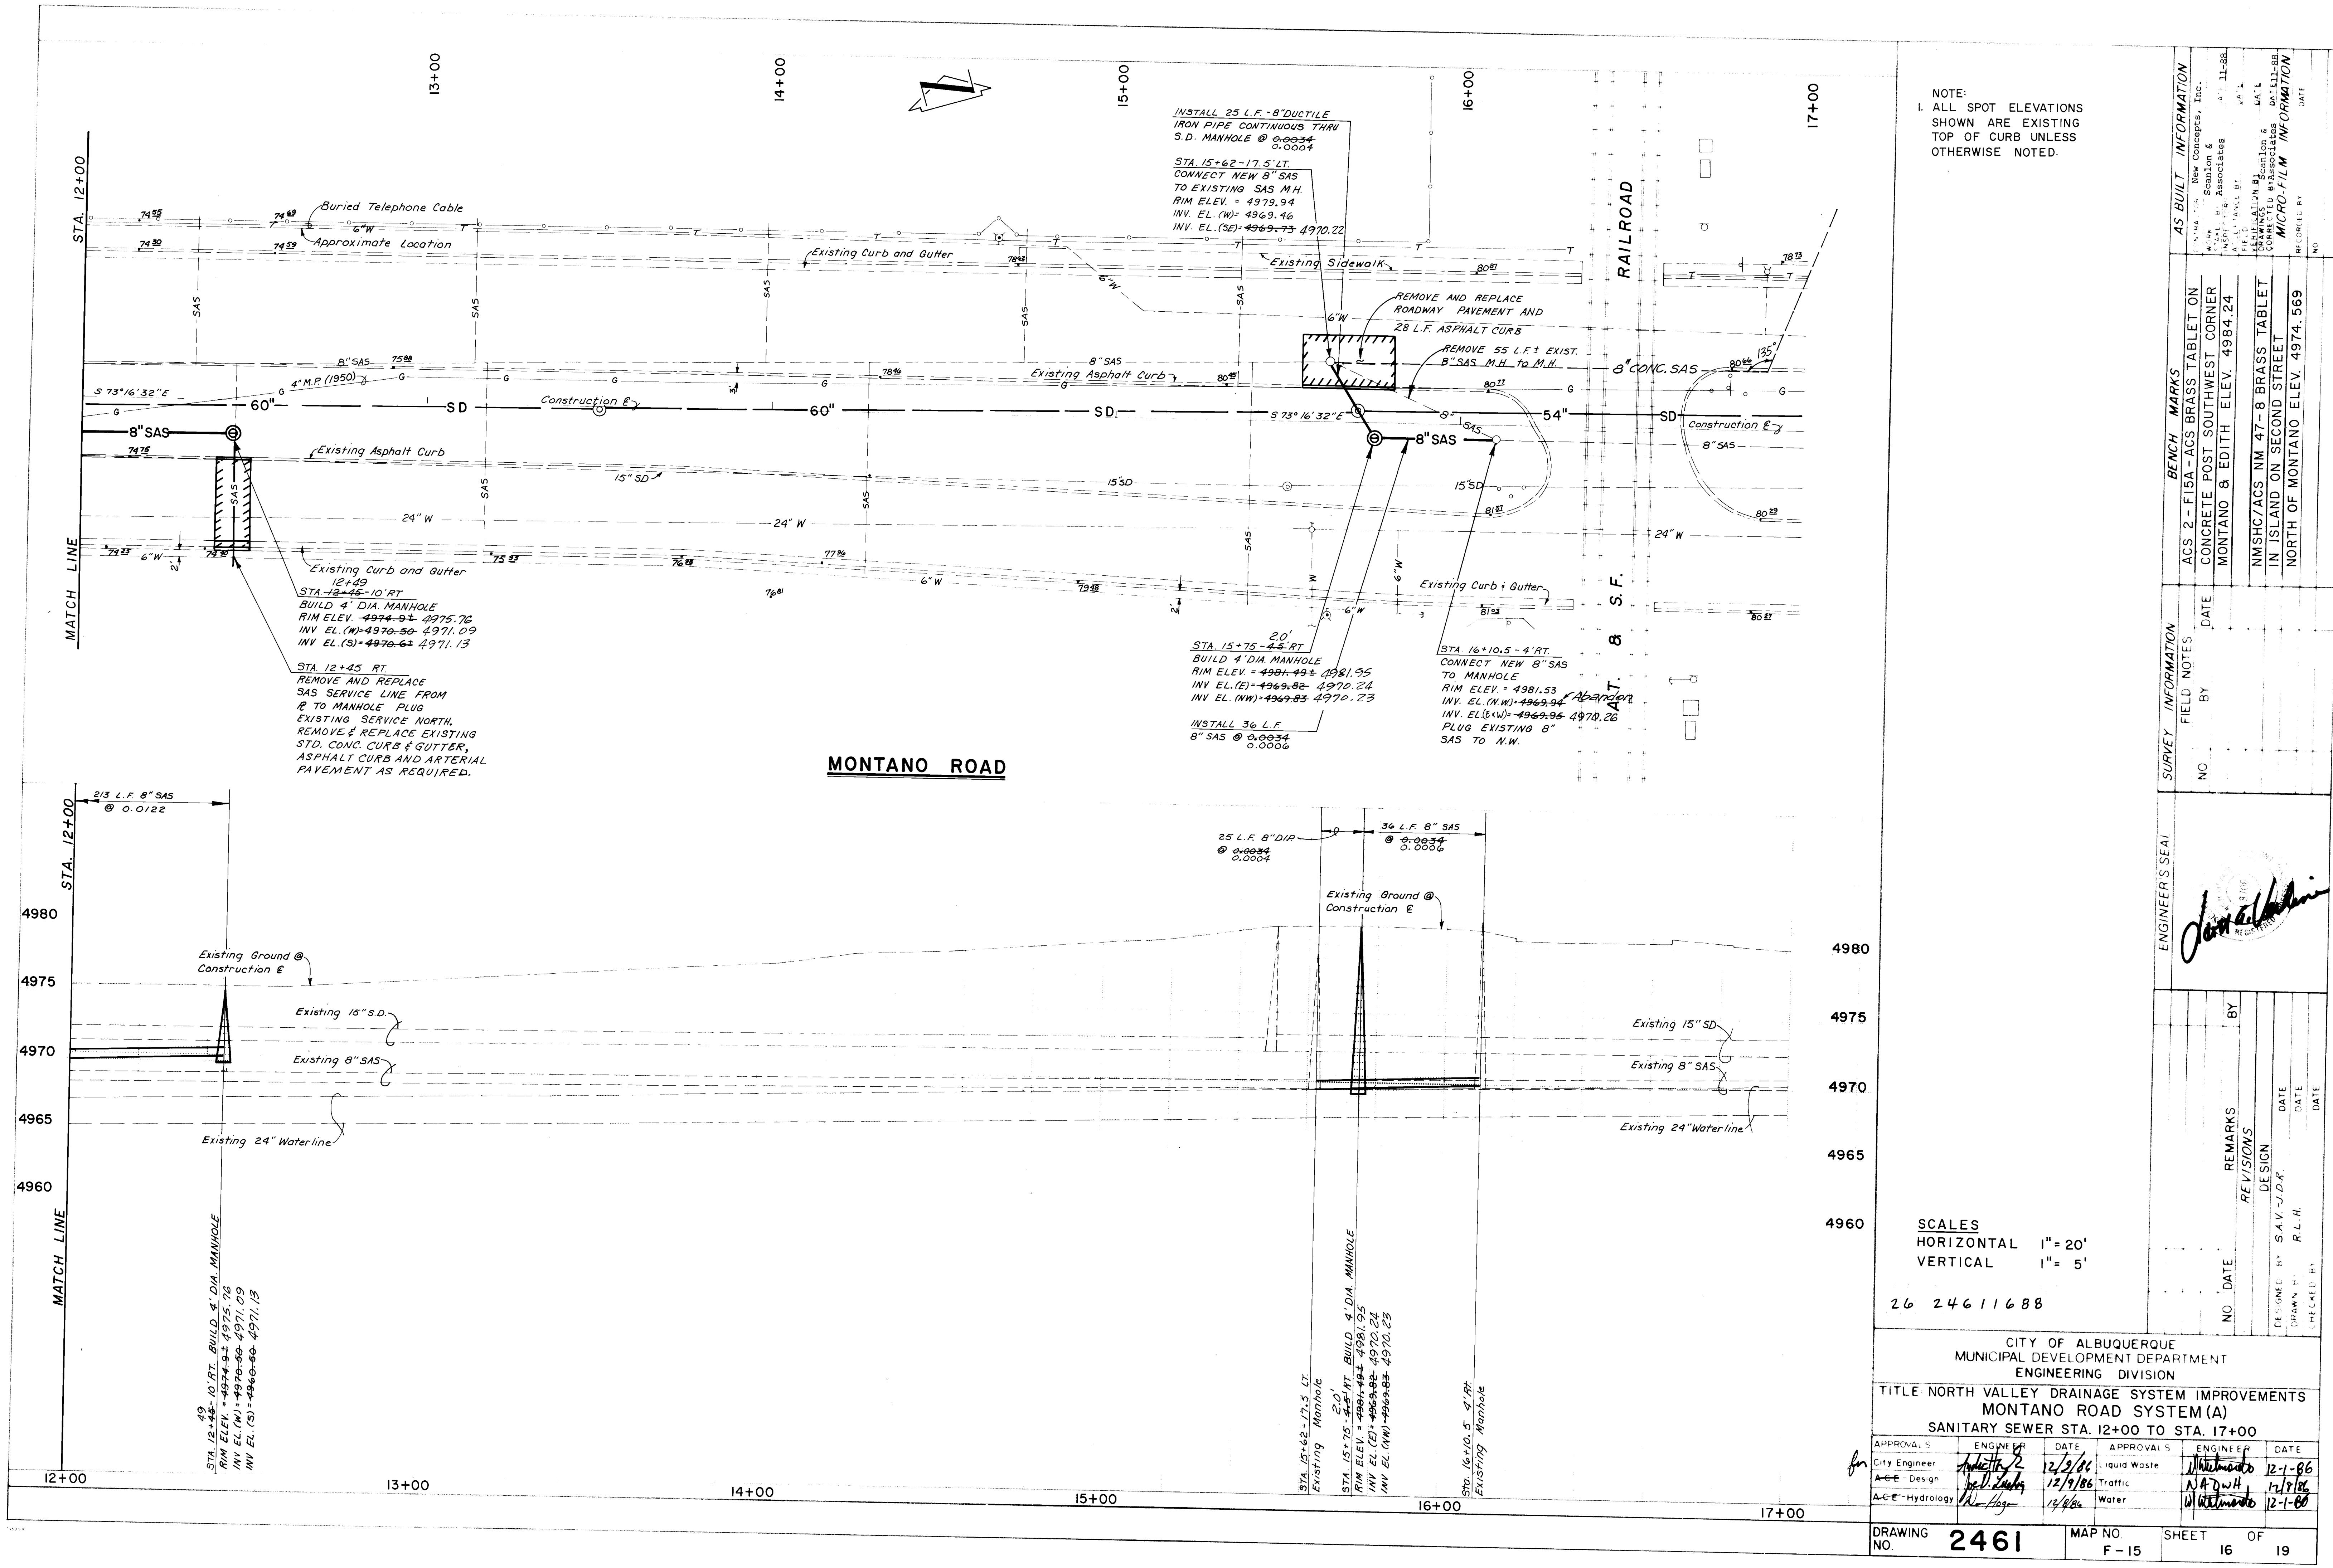ENGINEER'S SEAL		SURVEY INFORMATION		FIELD NOTES		BENCH MARKS		AS BUILT INFORMATION	
		ACCS 2 - F15A - ACS BRASS TABLET		ON CONCRETE POST SOUTHWEST		NASHC/ACS NM 47-8 BRASS		MICRO-FILM INFORMATION	
NO.	BY	DATE	DATE	NO.	BY	DATE	DATE		
NO. DATE	REMARKS BY	REVISIONS	DESIGN	NO. DATE	REMARKS BY	REVISIONS	DESIGN		
26 24611788	CITY OF ALBUQUERQUE MUNICIPAL DEVELOPMENT DEPARTMENT ENGINEERING DIVISION								
TITLE: NORTH VALLEY DRAINAGE SYSTEM IMPROVEMENTS MONTANO ROAD SYSTEM OUTLET STRUCTURE PLAN									
APPROVALS	ENGINEER	DATE	APPROVALS	ENGINEER	DATE				
City Engineer	<i>[Signature]</i>	12/1/86	Liquid Waste	<i>[Signature]</i>	12-1-86				
A.C.E. Design	<i>[Signature]</i>	12/19/86	Traffic	<i>[Signature]</i>	12/1/86				
A.C.E.-Hydrology	<i>[Signature]</i>	12/1/86	Water	<i>[Signature]</i>	12-1-86				
DRAWING NO.	MAP NO.	SHEET OF							
2461	F-15	17 19							

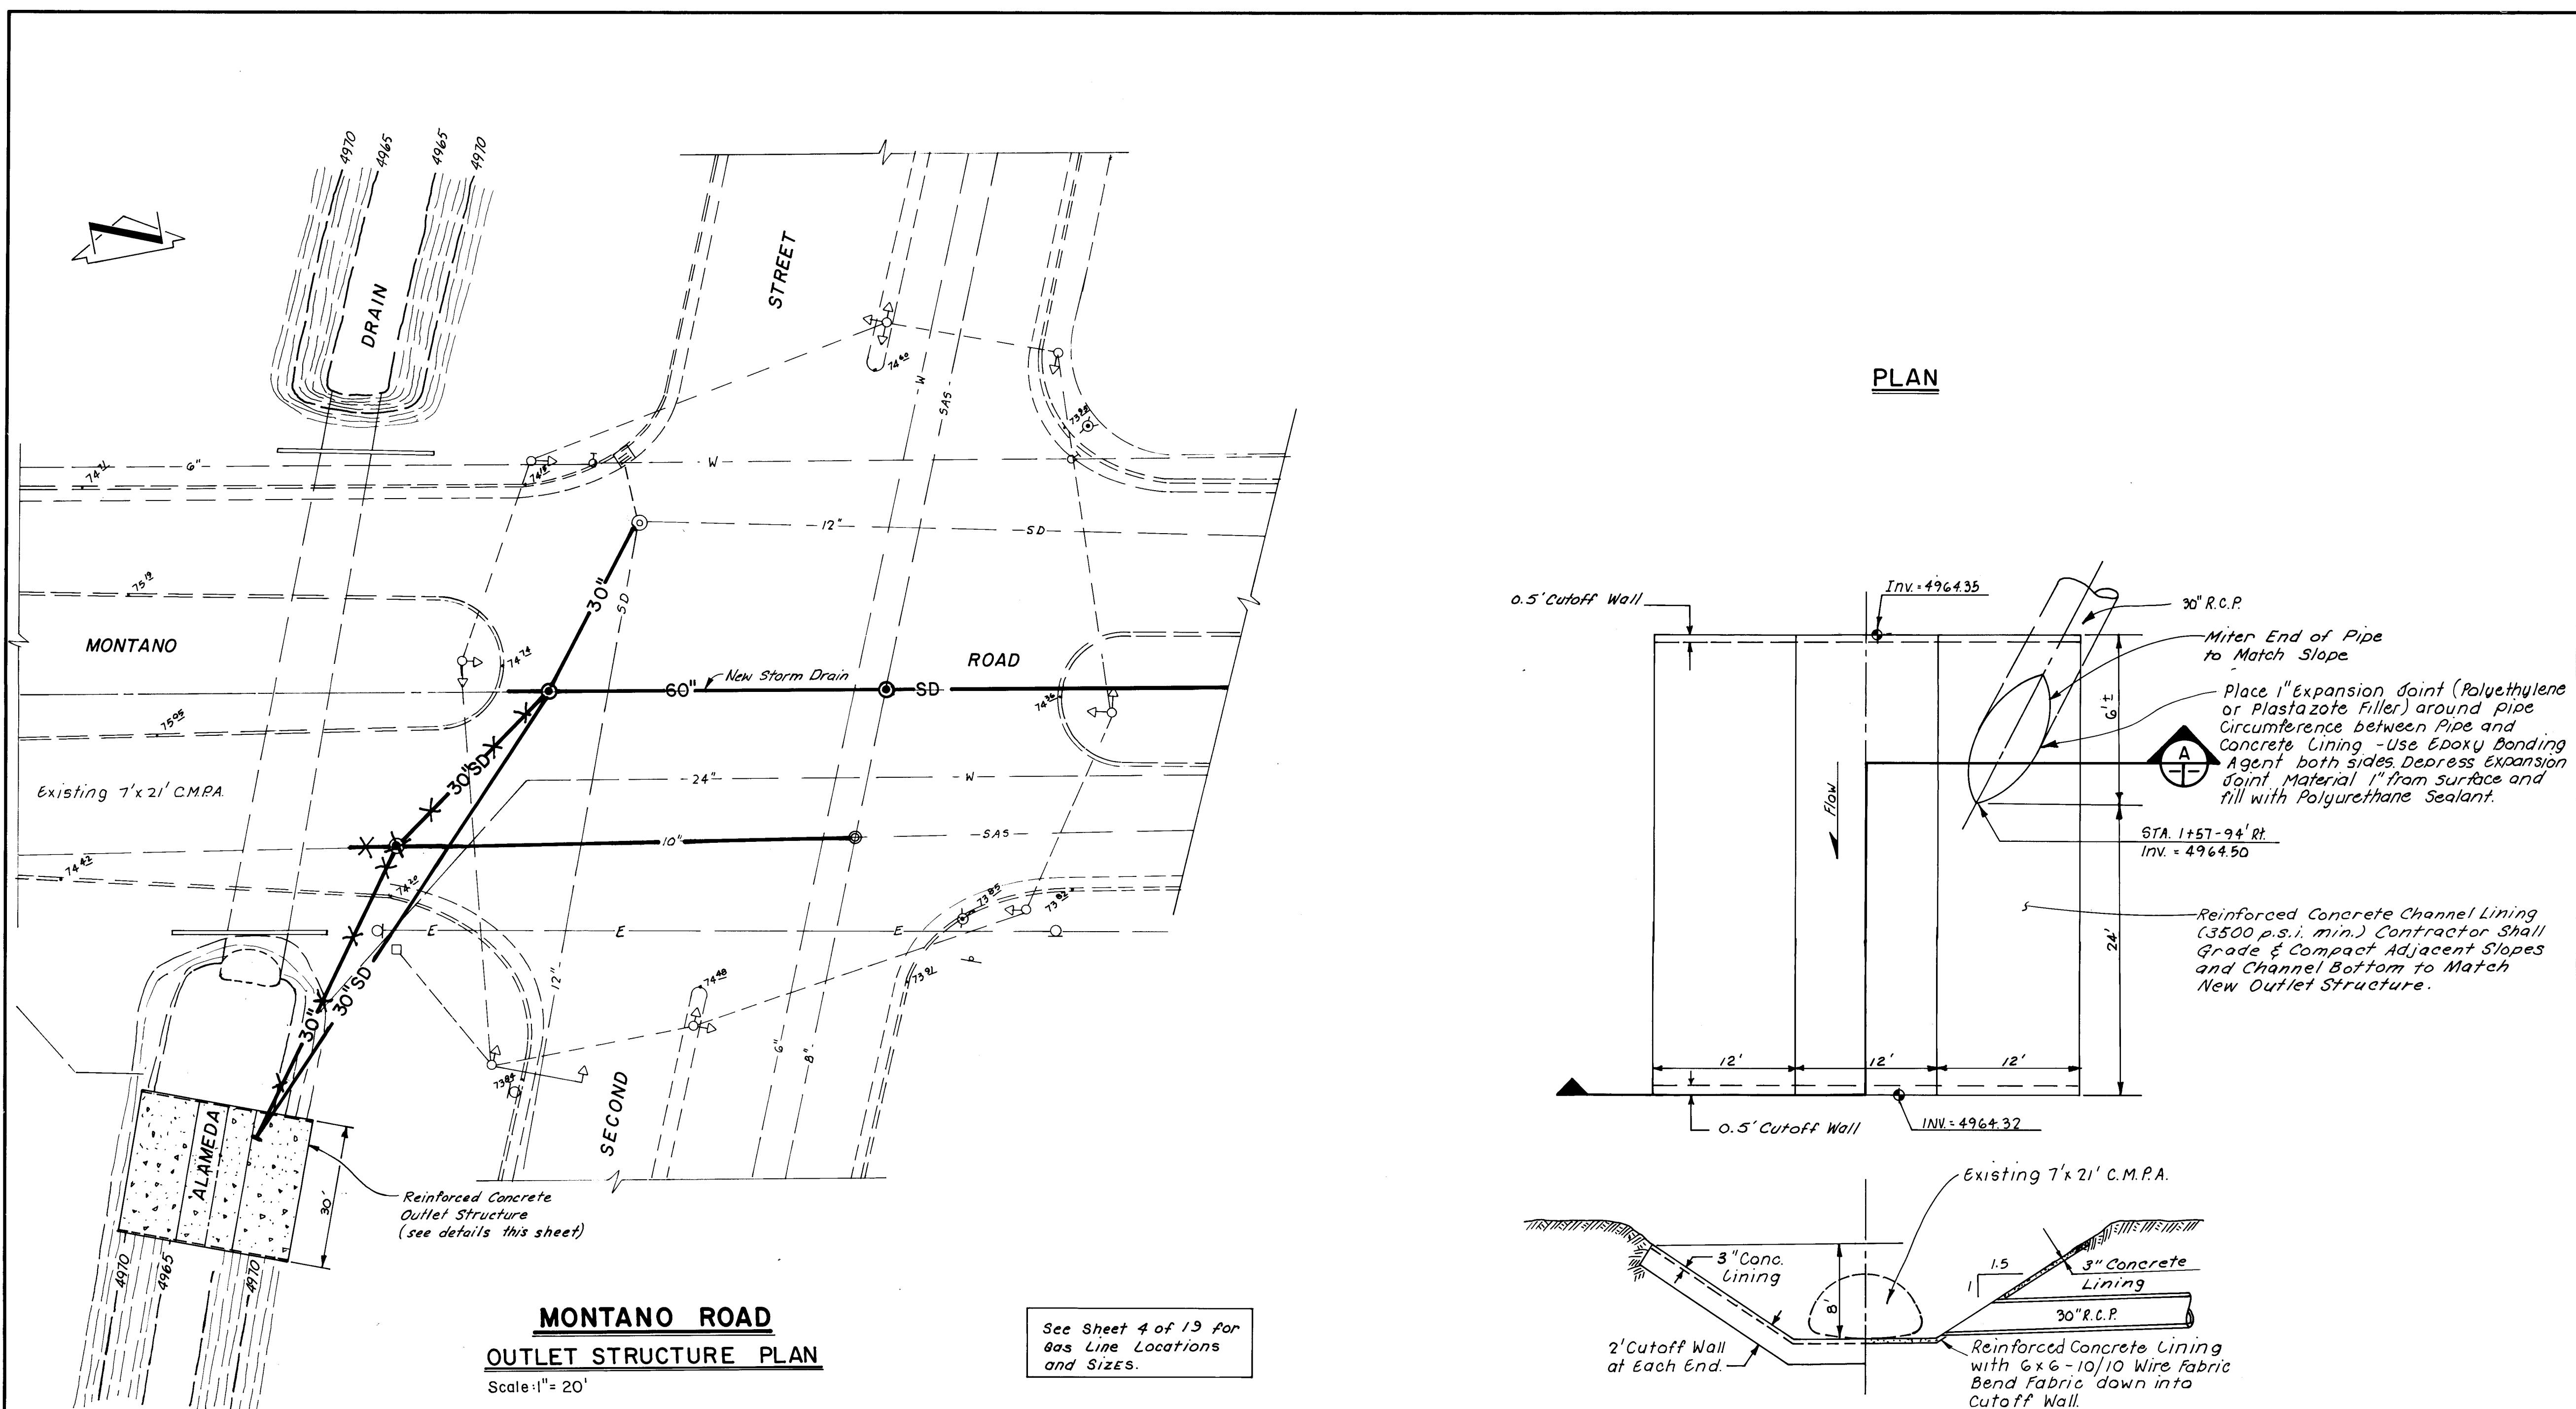for

Scanlon Job No. 85113

RECORD DRAWING




- NOTES**
1. Contractor may close a left lane East bound and a left lane West bound on Montano for a maximum of 1000 feet in order to install the storm drain line in the center of the roadway.
 2. Two way traffic must be maintained on 2nd Street and Montano at all times. The south-west quadrant of the intersection may be closed for a maximum of 10 days as shown. The contractor must remove a section of asphalt median and pave a temporary detour path as shown in order to accomplish the required closure. 2nd Street traffic may be shifted to the west side of the median, echoing the shown barricade setup, in order to complete the required crossing of 2nd Street. Construction of inlets and their accompanying connections shall be accomplished by blocking one lane at a time using typical right and left lane closures. Should the reconstruction of the SAS require by-pass pumping that crosses a thru lane of traffic, the contractor shall bury the line so as not to disrupt the flow of traffic.
 3. Contractor shall coordinate construction activities on Montano between the rail road tracks and the east end of the project with the County Road Department.
 4. Inlet connections to the storm drain line shall be accomplished using right and left lane closures maintaining traffic on the proper side of the median.
 5. When construction activities restrict left turn movements at the intersection of 2nd and Montano, the contractor shall install rectangular signs with black letters on an orange field reading; "Left Turn Restricted at 2nd & Montano". At the following locations:
2nd - 300ft North of Osuna
2nd - 300ft South of Griegos
Montano - 200ft West of Fourth
Montano - 300ft East of Edith


AS BUILT INFORMATION		BENCH MARKS		AS BUILT INFORMATION	
CONTRACTOR	FIELD NOTES	ACCS 2 - F15A - ACS BRASS TABLET	CONTRACTOR	FIELD NOTES	ACCS 2 - F15A - ACS BRASS TABLET
NEW CONCEPTS, INC.	NO. BY DATE	ON CONCRETE POST SOUTHWEST	NEW CONCEPTS, INC.	NO. BY DATE	ON CONCRETE POST SOUTHWEST
DATE 1-1-86		CORNER MONTANO & EDITH	DATE 1-1-86		CORNER MONTANO & EDITH
INSPECTORS ASSOCIATES		ELEV. 4984.24	INSPECTORS ASSOCIATES		ELEV. 4984.24
ACCEPTANCE BY		FIELD DRAWINGS	ACCEPTANCE BY		FIELD DRAWINGS
CONTRACTOR BY		SCANNED & CORRECTED BY ASSOCIATES	CONTRACTOR BY		SCANNED & CORRECTED BY ASSOCIATES
DATE		DATE 1-1-86	DATE		DATE 1-1-86
MICRO-FILM INFORMATION					
RECORDED BY		RECORDED BY		RECORDED BY	
NO	DATE	NO	DATE	NO	DATE
NMSHC/ACS NM 47-8 BRASS	TABLET IN ISLAND ON SECOND	NMSHC/ACS NM 47-8 BRASS	TABLET IN ISLAND ON SECOND	NMSHC/ACS NM 47-8 BRASS	TABLET IN ISLAND ON SECOND
STREET NORTH OF MONTANO	ELEV. 4974.569	STREET NORTH OF MONTANO	ELEV. 4974.569	STREET NORTH OF MONTANO	ELEV. 4974.569
<i>[Handwritten signatures and initials over the table]</i>					
DESIGN		REVISIONS		REVISIONS	
DESIGNED BY ALBUQUERQUE TRAFFIC ENGINEER DATE NOV. 28	DRAWN BY CLW - J. D. R. DATE NOV. 28	REMARKS	REMARKS	REMARKS	REMARKS
NO. DATE	NO. DATE	NO. DATE	NO. DATE	NO. DATE	NO. DATE
CITY OF ALBUQUERQUE MUNICIPAL DEVELOPMENT DEPARTMENT ENGINEERING DIVISION					
TITLE: NORTH VALLEY DRAINAGE SYSTEM IMPROVEMENTS MONTANO ROAD SYSTEM (A) TRAFFIC CONTROL PLAN					
APPROVALS	ENGINEER	DATE	APPROVALS	ENGINEER	DATE
City Engineer	<i>[Signature]</i>	12-1-86	Liquid Waste	<i>[Signature]</i>	12-1-86
A-E-E Design	<i>[Signature]</i>	12-1-86	Traffic	<i>[Signature]</i>	12-1-86
A-E-E-Hydrology	<i>[Signature]</i>	12-1-86	Water	<i>[Signature]</i>	12-1-86
TRAFFIC OPERATIONS					
DRAWING NO.	MAP NO.	SHEET OF			
2461	F-15	18	19		

NOTES:
1. See Traffic Control Notes
Sheet 3 of 19.


MATCH ADVANCE SIGNING
AND BARRICADES AS
SHOWN OPPOSITE DIRECTION

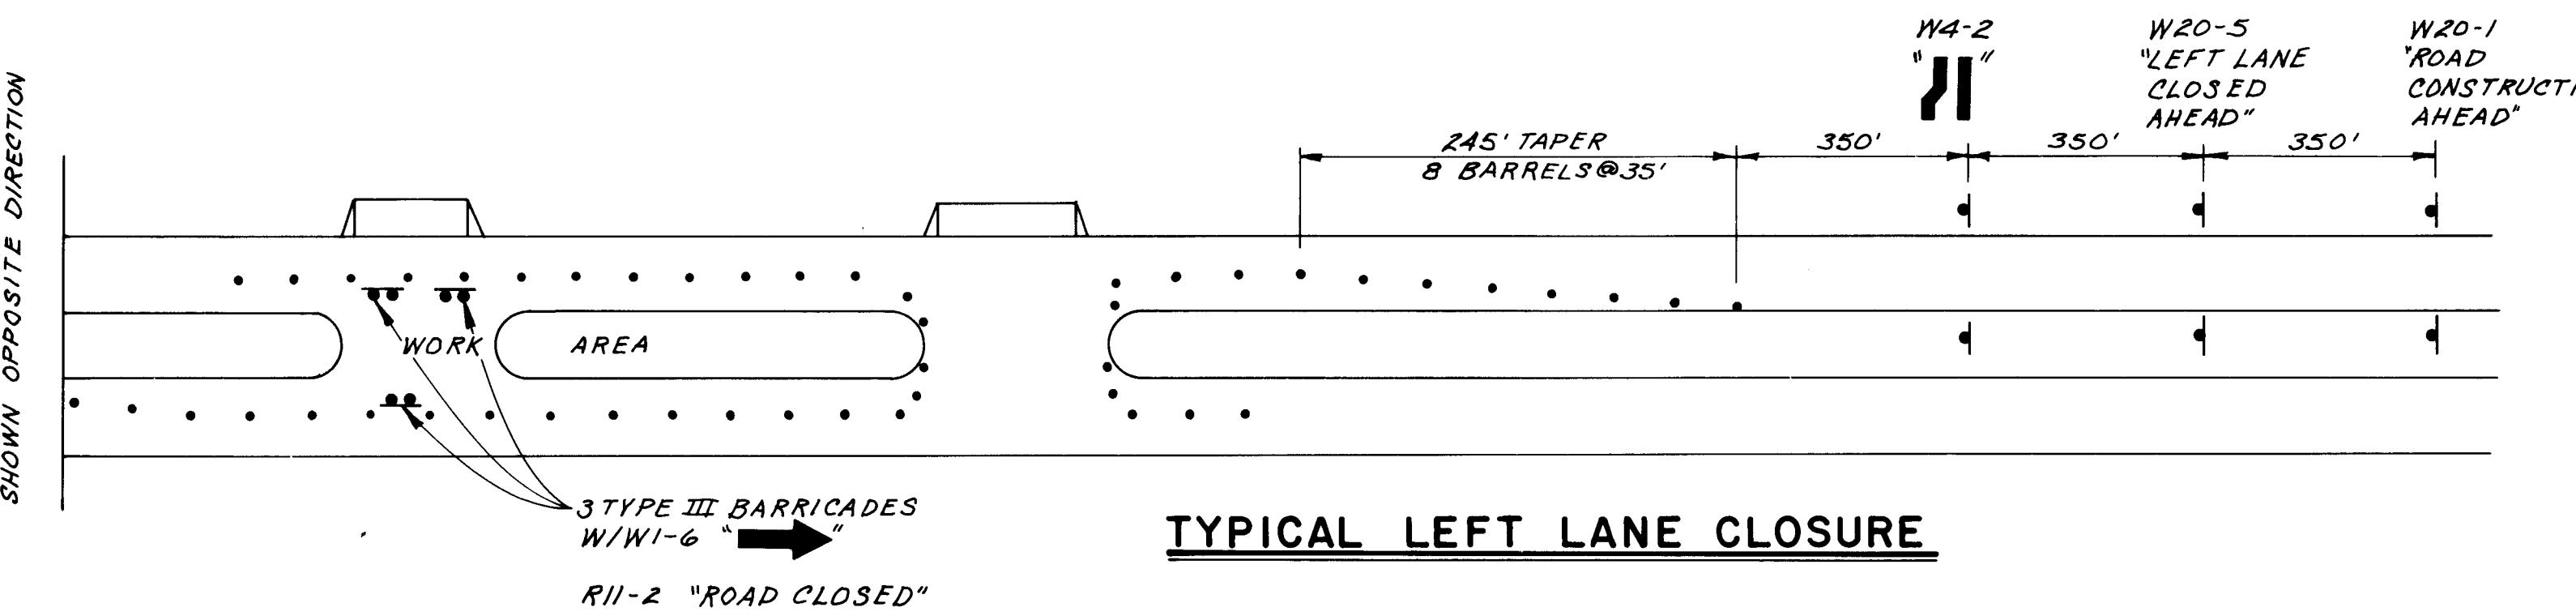

TYPICAL LEFT LANE CLOSURE

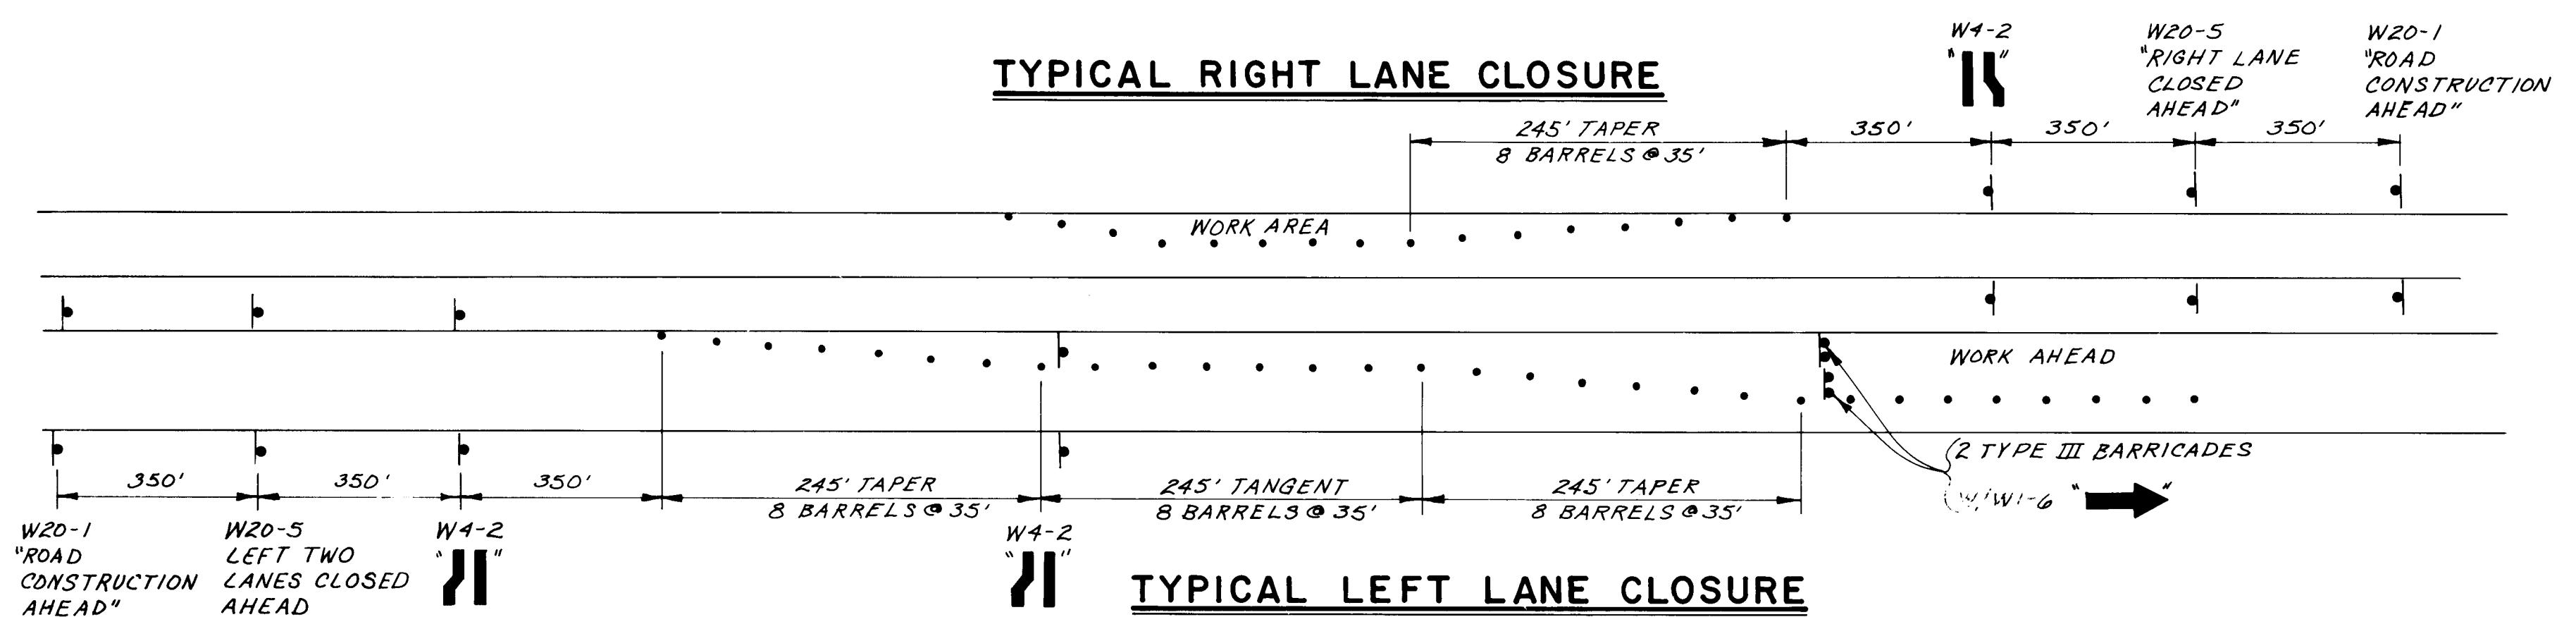

TYPICAL LEFT LANE CLOSURE

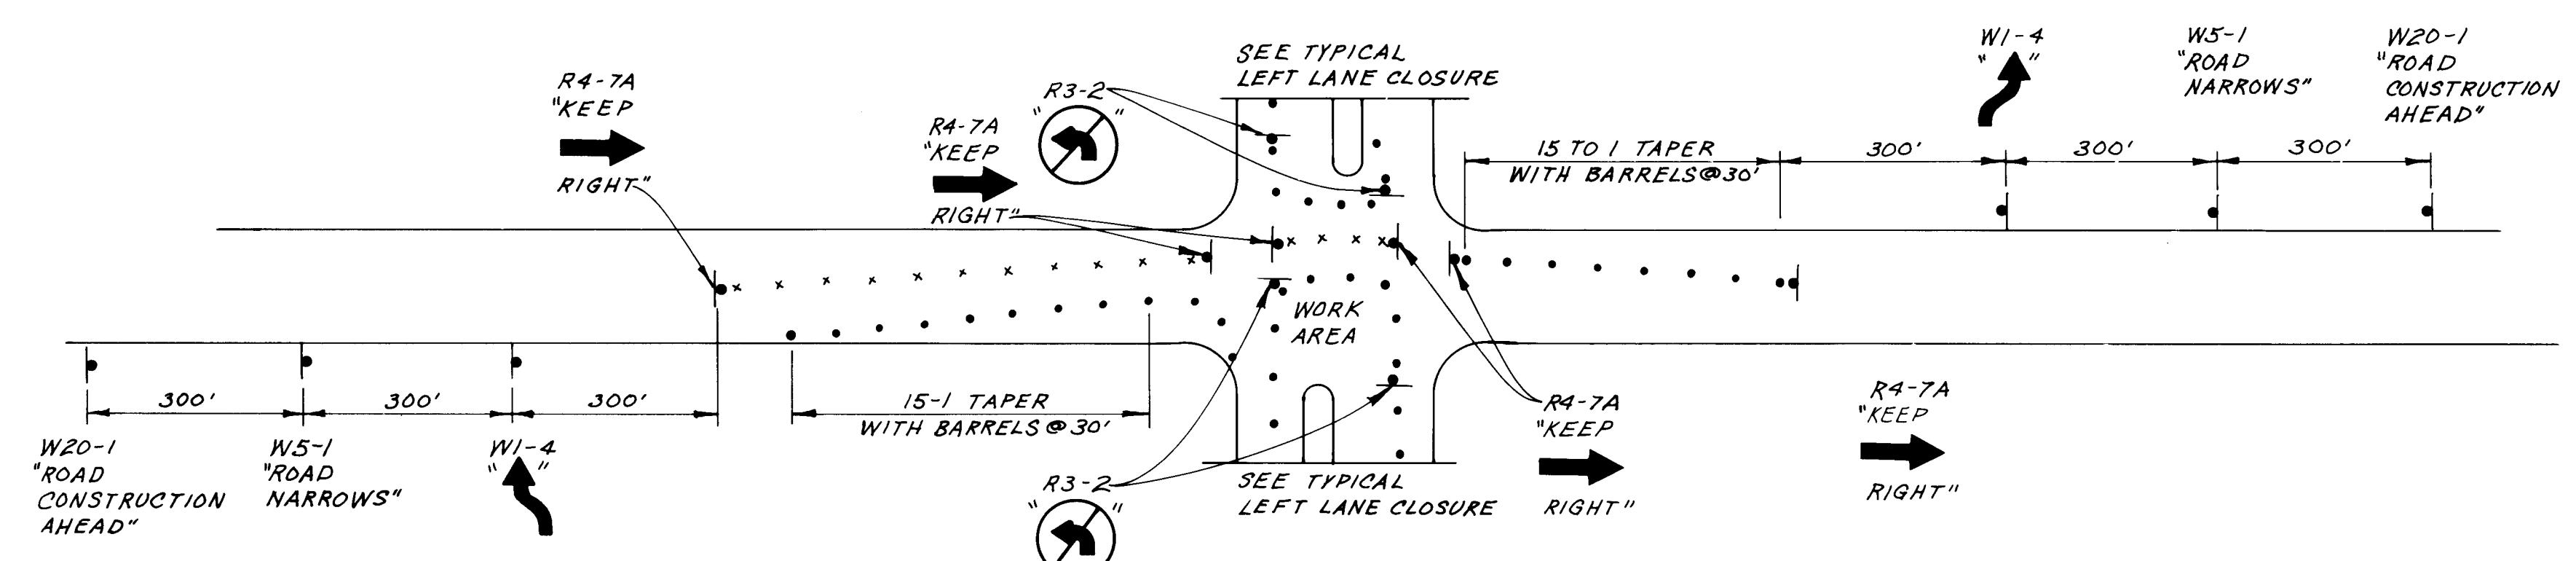

LEGEND

- BARRELS
- x VERTICAL PANELS
- SIGN
- TYPE III BARRICADE

26 24611988
CITY OF ALBUQUERQUE
MUNICIPAL DEVELOPMENT DEPARTMENT
ENGINEERING DIVISION

TITLE: NORTH VALLEY DRAINAGE SYSTEM IMPROVEMENTS
MONTANO ROAD SYSTEM (A)
TRAFFIC CONTROL PLAN (cont.)

APPROVALS	ENGINEER	DATE	APPROVALS	ENGINEER	DATE
City Engineer	[Signature]	12/1/86	Liquid Waste	[Initials]	12-1-86
A.O.E. Design	[Signature]	12/1/86	Traffic	[Initials]	12/1/86
A.C. E-Hydrology	[Signature]	12/1/86	Water	[Initials]	12-1-86
			TRAFFIC OPERATIONS		12-1-86
DRAWING NO.	2461	MAP NO.	F-15	SHEET OF	19 19

Scantec Job No. 85113

RECORD DRAWING

<u>BENCH MARKS</u>		<u>AS BUILT INFORMATION</u>
AC'S 2 - FISH - ACS BRASS TABLET	CONTRACTOR New Concepts, Inc.	DATE 1-86
ON CONCRETE POST SOUTHWEST	WORK STARTED BY Scantron & Associates	DATE 1-86
CORNER MONTANO & EDITH	INSPECTORS FIELD	DATE
EL-EV. 4984-24	GENERATED BY Scantron & Associates	DATE
NMSHCACS NM 47-8 BRASS	DRAWINGS BY Scantron & Associates	DATE
TABLET IN ISLAND ON SECOND STREET IN NORTH OF MONTANO	RECORDED BY MICRO-TLM INFORMATION	DATE
FILE EV. 4924-569	NO.	

[Handwritten Signature]