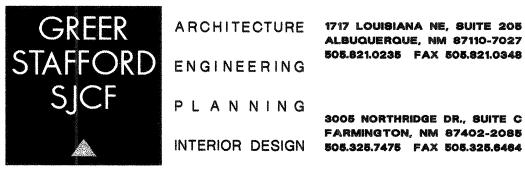
ALBUQUERQUE POLICE DEPARTMENT TRANSFER STATION LOCATED AT THE ALVARADO TRANSPORTATION CENTER CITY OF ALBUQUERQUE ALBUQUERQUE, NEW MEXICO

GRAPHIC LEGEND

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| A/D6.8 DETAIL AND PAGE NUMBER IN DETAIL MANUAL | 4 |
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| BUILDING SECTION SYMBOL | WALL SECTION SYMBOL |
| BUILDING SECTION LETTER | WALL SECTION NUMBER SHEET NUMBER |
| SHEET NUMBER | V SHEET NUMBER |

DESIGN TEAM ARCHITECT



ENGINEERING

PLANNING

ALBUQUERQUE, NM 87110-702 505.821.0235 FAX 505.821.0348

3005 NORTHRIDGE DR., SUITE C FARMINGTON, NM 87402-2085 INTERIOR DESIGN 505.325.7475 FAX 505.325.6464

MECHANICAL ENGINEER

4 SEASONS ENGINEERING LTD. 4320 PASEO DEL NORTE NE ALBUQUERQUE, NM (505) 798-0103

ELECTRICAL ENGINEER

eng group Ud OFFICE: 798-030 CELL: 350-6383 4320 PASEO DEL NORTE N.E.

ALBUQUERQUE, NEW MEXICO 87113

FAX: 798-0102

ARCHITECTURAL SHEETS:

| A100 | PARTIAL |
|------|------------|
| AIØI | EXISTING F |
| A102 | NEW FLOO |
| A103 | DIMENSION |
| A104 | REFLECTE |
| A2Ø1 | ENLARGE |
| A5Ø1 | WALL TYP |
| A5Ø2 | CASEWOR |
| A5Ø3 | CASEWOR |
| A504 | DOOR SCI |

MECH & PLUMBING SHEETS:

MIØI PIØI PIØ2 WATER PIPING

ELECTRICAL SHEETS:

LIGHTING PLAN ElØI E102 POWER PLAN E103 SPECIAL SYSTEMS PLAN

INDEX TO DRAWINGS

ODE INFORMATION IEDULE, CEILING SUPPORT MATERIALS AND SYSTEMS, PAINT NOTES AND H.C. SIGN HEIGHTS

SITE PLAN AND SITE DETAILS FLOOR PLAN / DEMOLITION PLAN & CONCRETE DETAILS

R PLAN AND FINISH LEGEND

NG FLOOR PLAN AND WALL TYPES PLAN

ED CEILING PLAN, SECURITY ELECTRICAL ROUGH-IN LOCATIONS

D PLANS AND INTERIOR ELEVATIONS ES, GLAZING ELEVATIONS, WALL STUD MATERIALS AND SYSTEMS

K DETAILS

K DETAILS HEDULE, DOOR TYPES, FRAME TYPES, DOOR DETAILS AND MISCELLANEOUS DETAILS

NEW MECHANICAL FLOOR PLAN NEW DRAIN & VENT PIPING MP001 SCHEDULES, CALCULATIONS & NOTES


(REFER TO ARCHITECTURAL SHEETS FOR FURTHER ELECTRICAL REQUIREMENTS)

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| | 1717 LOUISIANA NE, SUITE 205 Albuquerque, nm 87110-7027 605.821.0235 Fax 505.821.0348 | 3005 NORTHRIDGE DR., SUITE F FARMINGTON, NM 87402-2085 505.325.7475 FAX 505.325.6464 | |
| | ARCHITECTURE ENGINEERING | P L A N N I N G INTERIOR DESIGN | |
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DRAWING SHEE

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SCHEDULED 'A' MINERAL FIBER LAY-IN PANELS 24' × 48' × 5/8', SQUARE EDGED. 'CORTEGA' BY ARMSTRONG.

EXPOSED GRID-DIRECT HUNG - TEE SYSTEM SCHEDULED 'A SYSTEM CONSISTS OF MAIN AND CROSS TEES, WALL (PERIMETER) MOLDING, HANGERS, ANCHORS, AND ACCESSORIES.

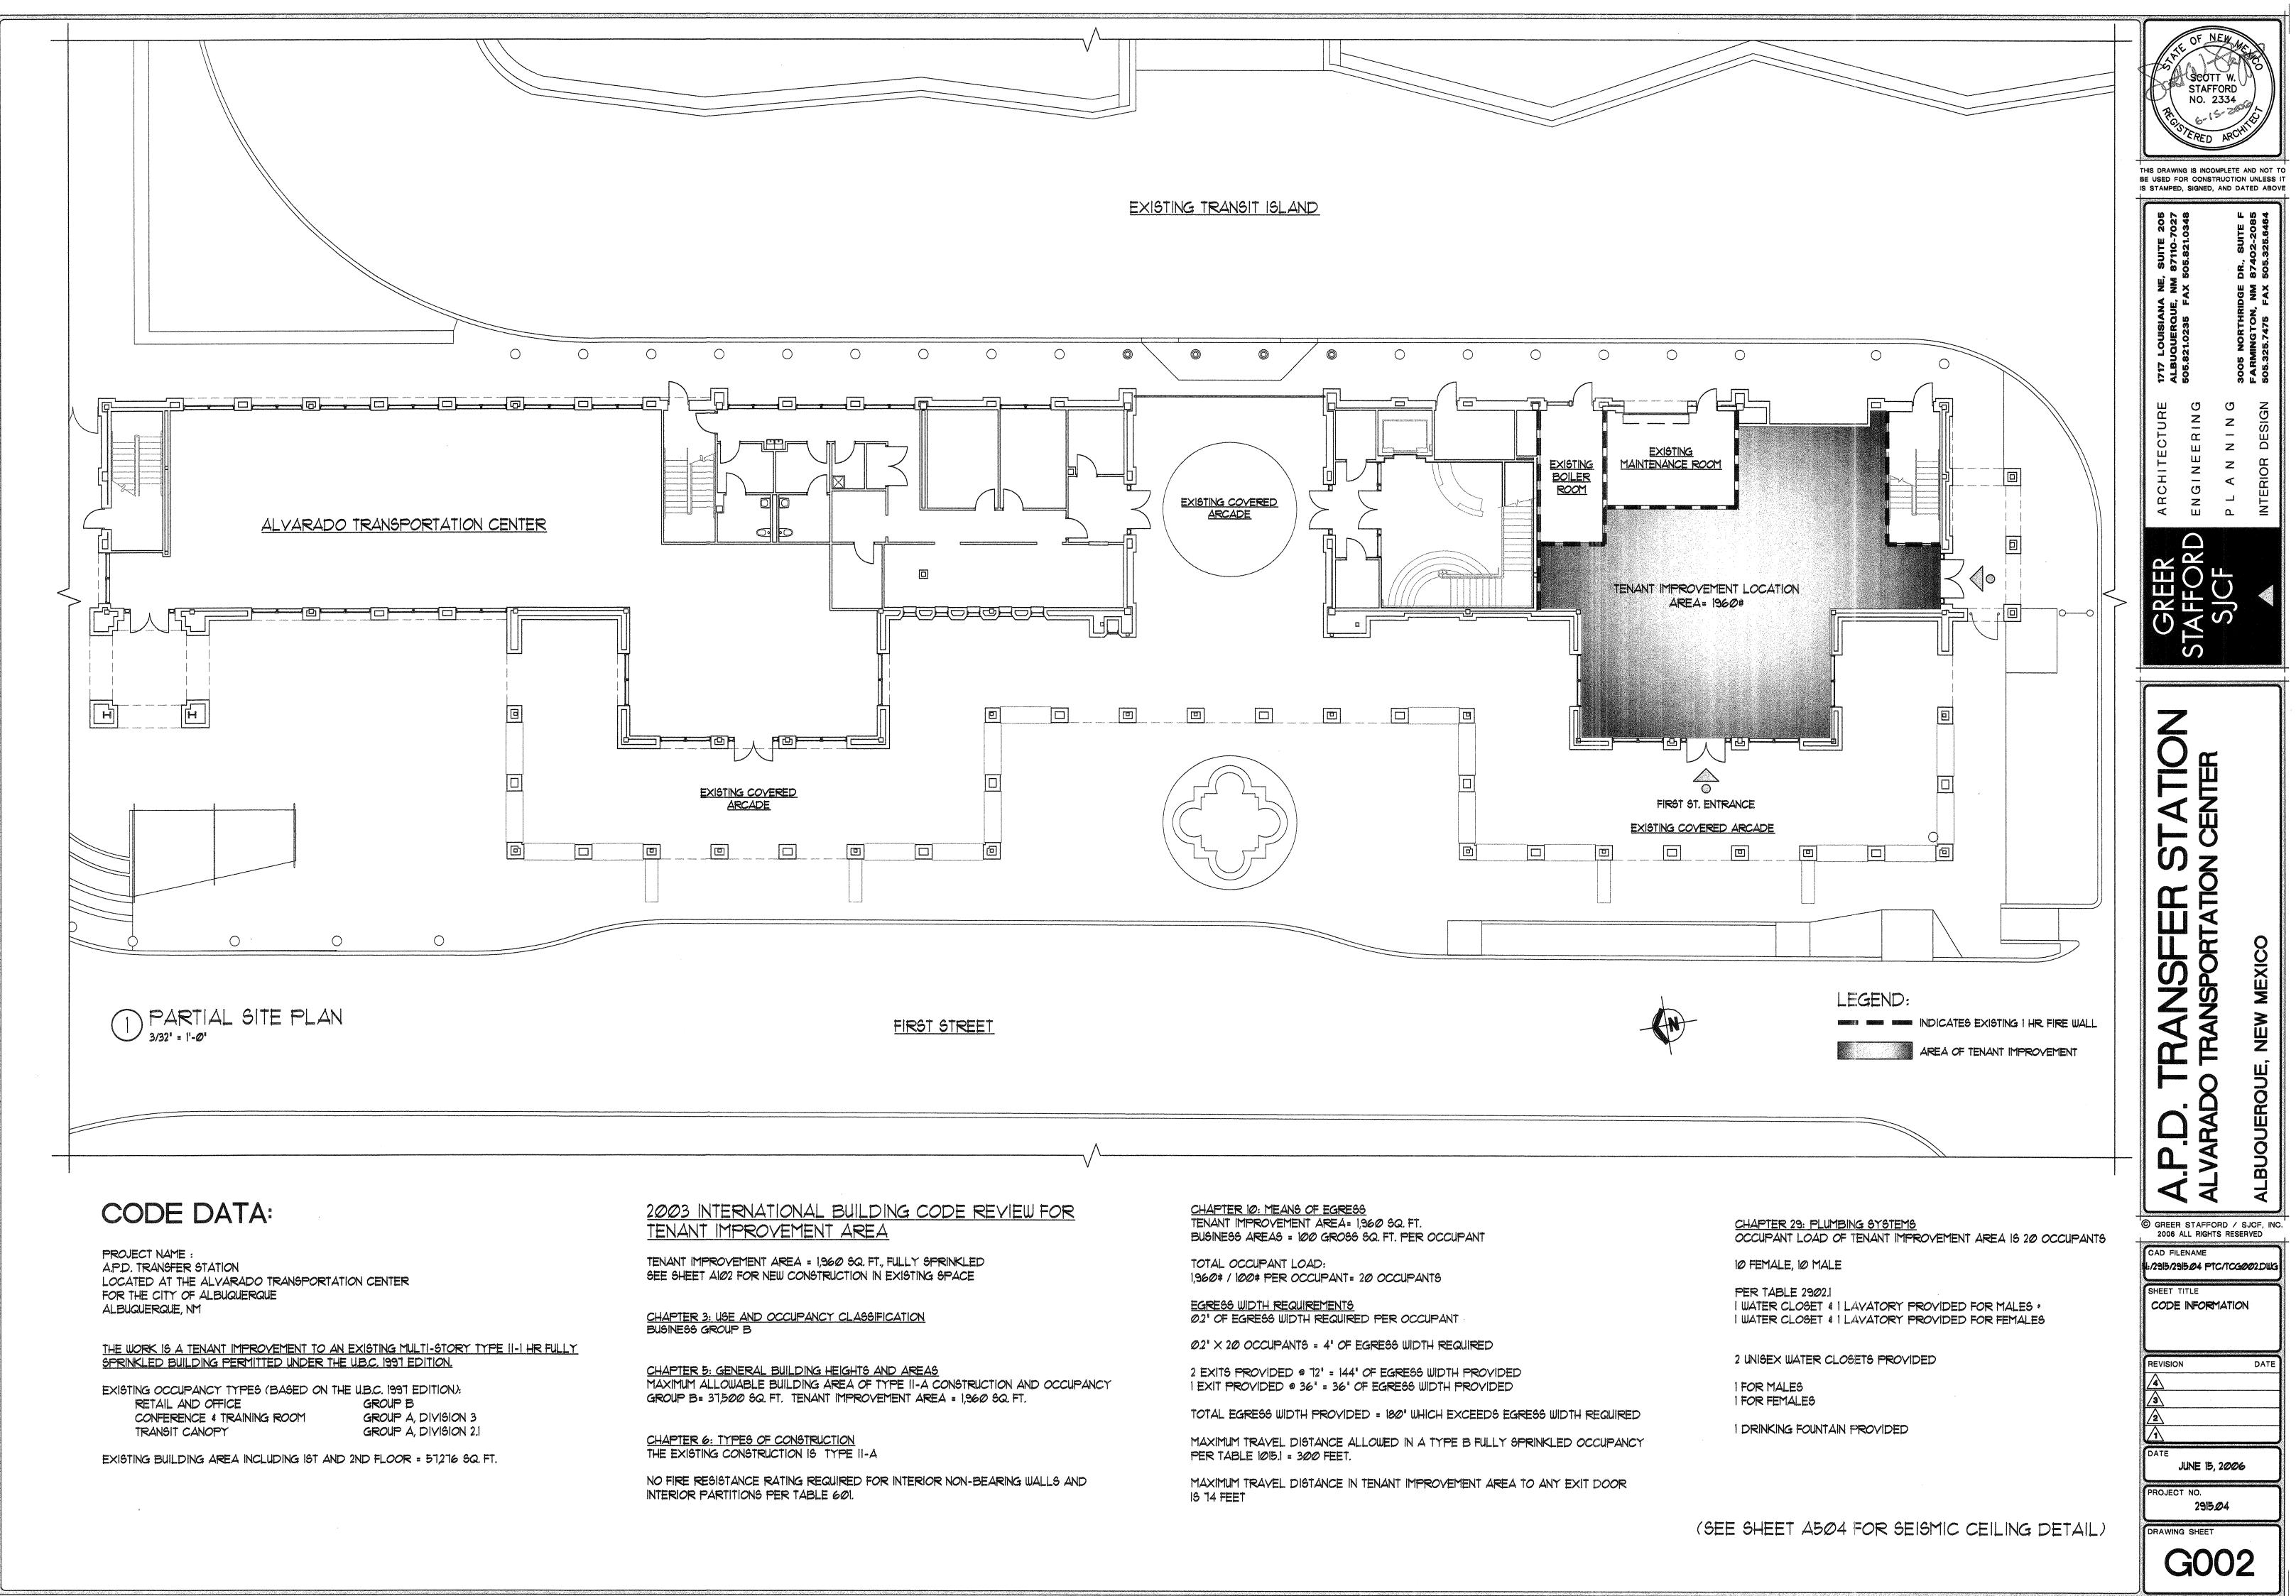TEES, DOUBLE WEB DESIGN WITH ROLLED CAP. USE ALUMINUM CAPPED MEMBERS WITH MOISTURE RESISTANT PANELS, WALL (PERIMETER) MOLDING SINGLE MEMBER DESIGN MATERIAL AND FINISH TO MATCH TEE MEMBERS. EXPOSED SURFACES FINISHED WHITE.

SCHEDULED 'G' GYPSUM BOARD CEILING GYPSUM BOARD CEILING CALLED OUT ON DRAWINGS TO BE SHEETROCK BRAND GYPSUM PANELS BY USG CORPORATION ON 3 5/8' ISGA. METAL STUDS @ 16' O.C.

FLEXIBLE EPOXY INTERIOR FINISH WALL & FLOOR SYSTEM SCHEDULED "F" 'SANIFLEX' INTERIOR WALL SYSTEM, CONSISTING OF A WATER BASED EPOXY WALL COATING AS PRIMER, TWO COATS OF EPO-FLEX FLEXIBLE WALL EPOXY AS A MEMBRANE, WATER BASED EPOXY WALL COATING AS THE FIRST FINISH COAT AND POLY-COTE WALL COATING AS FINAL FINISH COAT. PROVIDE SLIP RESISTANT FINISH ON FLOORS.

SCHEDULED 'C' CARPE1 MOHAWK STATI-TUFT III. COLOR BY ARCHITECT.

4' VINTL COVED BASE

ROPPE SERIES 100 1/8' VINYL. COLOR BY ARCHITECT.

RUBBER FLOORING SCHEDULED 'R'

FREUDENBERG BUILDING SYSTEMS, INC. (800) 332-NORA "NORAMENT 825" RUBBER FLOORING WITH CIRCULAR EMBOSSING, COLOR BY ARCHITECT

EXISTING CONCRETE SLAB

SCHEDULED 'X' TO RECEIVE EPOXY WATERPROOFING PAINT RATED FOR CONCRETE SLABS ON GRADE. COLOR BY ARCHITECT.

FIRE EXTINGUISHERS AND CABINTES:

FIRE EXTINGUISHER CABINETS

JL INDUSTRIES SEMI-RECESSED COMBINATION FLUGH METAL DOOR WITH VERTICAL GLASS PANEL. PROVIDE RED VERTICAL FIRE EXTINGUISHER LETTERING ON METAL SIDE OF DOOR MEETING ADA STANDARDS.

COSMOPOLITAN SERIES SATIN STAINLESS STEEL CABINET WITH 3' TRIM, 1/4" CLEAR ACRYLIC AND FULL PANEL WITH SAF-T-LOK OPTIONAL CYLINDER FOR INSTALLATIONS IN 3 5/8" METAL STUD WALL

FIRE EXTINGUISHERS DESIGNED, RATED AND LISTED BY UL.

PROVIDE COSMIC IDE EXTINGUISHERS BY JL. INDUSTRIES.

EQUAL EXTINGUISHERS BY LARSENS, OR PRIOR-APPROVED MANUFACTURERS ALGO PERMITTED.

FILL AND SERVICE ALL EXTINGUISHERS UPON INSTALLATION. UNITS SHALL BE RECHARGEABLE.

LABEL UNITS TO SHOW SERVICE DATE AND NEXT INSPECTION DATE

UNITS USED FOR TEMPORARY FIRE PROTECTION DURING CONSTRUCTION SHALL BE RE-INSPECTED AND CHARGED, IF NECESSARY, AT NO ADDED COST TO THE OWNER.

ROOM SIGNS:

PROVIDE & INSTALL SIX (6) SIGNS. FINAL COPY AND LOCATION PER OWNER.

PLASTIC SIGNS:

BEST MANUFACTURING CO. PRODUCT HC300 ADA: WWW.BESTSIGNS.COM

RAISED LETTER SIGNS

MATERIALS: OPAQUE, SOLID COLOR ACRYLIC PLASTIC BACK PLATE.

RAISED COPY, GRAPHICS, AND PICTOGRAMS: USE HEAT AND PRESSURE LAMINATED PHOTOPOLYMER FILM SYSTEM FORMED TO COMPLY WITH THE REQUIREMENTS INDICATED FOR SIZE, PROPORTIONS, SPACING, CONTENT, AND STYLE. APPLIED CHARACTERS OR BRAILLE PLATES ARE NOT ACCEPTABLE.

SIGNS FEATURING THE INTERNATIONAL SYMBOL OF ACCESSIBILITY MUST COMPLY WITH CHARACTER HEIGHT, PROPORTION, SYMBOLS, FINISH, BRAILLE, AND OTHER SIGNAGE REQUIREMENTS OF ANSI AIIT.I AND THE AMERICANS WITH DISABILITIES ACT. WHERE BRAILLE CHARACTERS ARE INDICATED, PROVIDE GRADE 2 BRAILLE TRANSLATION.

TOTAL THICKNESS: 1/8 INCH, MINIMUM.

SIGN SIZE: 8'x8' FACE COLOR FOR ACCESSIBLE TOILETS: BLUE, EQUAL TO COLOR NO. 15090 IN FEDERAL STANDARD 595B. FACE COLOR FOR OTHER INTERIOR SPACES: AS SELECTED BY ARCHITECT FROM MANUFACTURER'S STANDARDS.

EDGES: RADIUGED EDGE COLOR: SAME AS FACE COLOR

CORNERS: CORNERS ROUNDED TO 3/8-INCH RADIUS.

RAISED CHARACTER SIZE AND STYLE: CHARACTER COLOR: WHITE. CHARACTER THICKNESS: NOT LESS THAN 1/32 INCH. HEIGHT: 5/8' INCH, MINIMUM. EDGES: SQUARE. CHARACTER FONT: SANS SERIF OR SIMPLE SANS SERIF. CHARACTER CASE: UPPER CASE ONLY.

RAISED GRAPHICS AND PICTOGRAMS: COLOR: WHITE, RAISED THICKNESS: NOT LESS THAN 1/32 INCH. GRAPHIC AND PICTOGRAM HEIGHT: 6 INCHES, MINIMUM.

RAISED BRAILLE: COLOR: WHITE. RAISED THICKNESS: NOT LESS THAN 1/32 INCH. BRAILLE SYMBOLS: CONTRACTED GRADE II BRAILLE WITH DOTS IN CONFORMANCE WITH ANSI AIIT .!. CEILING SUPPORT MATERIALS AND SYSTEMS:

- SIZE CEILING SUPPORT COMPONENTS TO COMPLY WITH ASTM C 635 UNLESS OTHERWISE INDICATED. HANGERS AND FURRING MEMBERS SHALL CARRY LOAD OF ELECTRIC DEVICES, LIGHTS, SPEAKERS, ETC. ELECTRICIAN SHALL PROVIDE DEVICES NEEDED TO TRANSMIT WEIGHT TO FRAMING MEMBERS UNLESS DETAILED OTHERWISE. INSTALL SYSTEM IN ACCORDANCE WITH ASTM C 636 UNLESS EXCEEDED AND MODIFIED IN THIS SECTION.
- 2. HANGER WIRE ASTM A 641, SOFT, CLASS I GALVANIZED, 12 GA. AND HEAVIER AS REQUIRED TO PROVIDE CAPACITY OF AT LEAST 3 TIMES APPLIED LOAD. INSTALL FOR ESSENTIALLY VERTICAL SUPPORT OF THE FRAMING MEMBER. PROVIDE MINIMUM & GA. WIRE WHERE CEILING MEMBRANE WEIGHS 4 PSF OR MORE.
- 3. HANGER ANCHORAGE THE TO STRUCTURAL BEAM OR JOIST WHEREVER POSSIBLE.
- 4. PREPARE FOR HANGERS IN METAL ROOF DECK BY DRILLING HOLES (PUNCHING PROHIBITED) THROUGH SIDE FLANGES OF DECK RIBS + NOT GREATER THAN 3/16" DIA., AND 1/2" OR MORE FROM BOTTOM FLANGE. DRILL HOLES FOR EACH HANGER THROUGH BOTH SIDES OF RIB. ONLY ONE HANGER PERMITTED PER SET OF HOLES. SPACE HANGERS AT LEAST 12" APART ON ANY ONE RIB IF MULTIPLE HANGERS REQUIRED. MAXIMUM 100 LB. LOAD PER HANGER.
- 5. SUPPORT FRAMING COLD ROLLED STEEL WITH RUST INHIBITIVE FINISH. MINIMUM WEIGHT PER 1000 LINEAL FEET 1 1/2", 475 LBS. 2", 590 LBS.
- 6. FURRING MEMBERS ASTM C 645 0.0179' MIN. THICKNESS OF BASE METAL, CHANNEL, HAT-SHAPED, C-SHAPED STUDS, OR DIRECT SUSPENSION TEE SHAPED RUNNER AND CROSS TEES AND ACCESSORIES. MEMBERS DESIGNED FOR CONCEALED SUPPORT OF GYPSUM BOARD SUSPENDED AND FURRED SURFACES.
- 7. FURRING ANCHORAGES 16-GAUGE GALVANIZED WIRE TIES, MANUFACTURER'S STANDARD WIRE-TYPE CLIPS, BOLTS, NAILS OR SCREWS AS RECOMMENDED BY FURRING MANUFACTURER AND COMPLYING WITH C 754.
- 8. DIRECT SUSPENSION SYSTEMS MANUFACTURER'S STANDARD ZINC-COATED SYSTEM OF TEES, AND ACCESSORIES DESIGNED FOR CONCEALED SUPPORT OF GYPSUM DRYWALL CEILINGS FIRE RATED TYPE WHERE REQUIRED.
- 9. SYSTEMS EQUAL TO CHICAGO METALLIC CO., 1640 (STANDARD).

PAINT NOTES:

- PROVIDE FIRST QUALITY GRADE OF VARIOUS TYPES OF COATINGS AS REGULARLY MANUFACTURED BY ACCEPTABLE PAINT MATERIALS MANUFACTURERS. MATERIALS NOT DISPLAYING MANUFACTURER'S IDENTIFICATION AS A STANDARD, BEST GRADE PRODUCT WILL NOT BE ACCEPTABLE.
- PROVIDE UNDERCOAT PAINT PRODUCED BY SAME MANUFACTURER, AND USE ONLY WITHIN RECOMMENDED LIMITS.
- PROVIDE COATINGS MANUFACTURED BY ONE OF THE FOLLOWING: DUNN-EDWARDS/WELLBORN. BENJAMIN MOORE CORONADO PAINT. KWAL-HANLEY. PITTSBURG. SHERWIN-WILLIAMS DIAMOND VOGEL.
- THE APPLICATION OF ANY PAINT OR COATING SHALL CONSTITUTE ACCEPTANCE OF THAT SURFACE AS SUITABLE. CORRECT SURFACE DEFECTS AS REQUIRED. IN THE EVENT OF INCOMPATIBILITY OF MATERIALS, THE PROBLEM SHALL BE RESOLVED PRIOR TO ANY APPLICATION.
- MINIMAL COATING THICKNESS

APPLY EACH MATERIAL AT MANUFACTURER'S RECOMMENDED SPREADING RATE AND SUFFICIENT TO PROVIDE A TOTAL DRY FILM THICKNESS FOR THE COMPLETED SYSTEM OF PRIME AND FINISH COATS OF NOT LESS THAN 5.0 MIL FOR 3-COAT WORK AND/OR 3.5 MIL FOR 2-COAT WORK. ENAMEL SHALL BE AT LEAST ONE MIL THICKER THAN PRESCRIBED ABOVE.

NUMBER OF COATS SPECIFIED PRESUMES FULL HIDE WITH COATINGS APPLIED IN THICKNESSES RECOMMENDED BY MANUFACTURER FOR EACH COAT. IF MORE COATS ARE NEEDED TO PROVIDE PROPER COVER AND FINISH, THE CONTRACTOR SHALL PROVIDE NEEDED COATS AT NO EXTRA COST.

METHODS

USE ONLY PAINT METHODS APPROPRIATE FOR THE PARTICULAR PAINTING APPLICATION, USING CARE TO PROTECT ADJACENT FINISHES FROM OVERSPRAY, PAINT SMEARS OR OTHER DEFACEMENT. BACK PRIMING: REQUIRED ON ALL WOOD TRIM. BACK ROLLING: REQUIRED ON ALL SPRAYED APPLICATIONS.

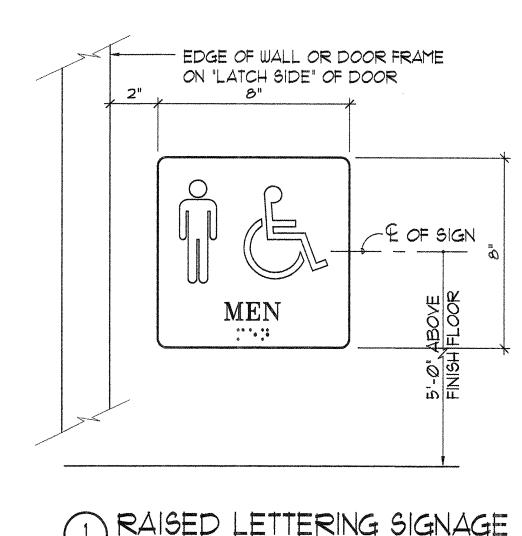
THE CODES AND REGULATIONS UNDER WHICH THE PROJECT'S DOCUMENTS HAVE BEEN PREPARED AND UNDER WHICH THIS CONTRACT'S WORK AND PROJECT SHALL BE CONSTRUCTED INCLUDE:

NEW MEXICO BUILDING CODES - 2003 INTERNATIONAL BUILDING CODE - 2003 UNIFORM PLUMBING CODE - 2003 UNIFORM MECHANICAL CODE - 2003 NATIONAL ELECTRICAL CODE - 2002 NATIONAL ELECTRICAL SAFETY CODE - 2002 INTERNATIONAL ENERGY CONSERVATION CODE - 2003 INTERNATIONAL EXISTING BUILDING CODE - 2003 NFPA LIFE SAFETY CODE 101 - 1997 NFPA FIRE PREVENTION CODE 1 - 1997 OTHER FEDERAL AND LOCAL REQUIREMENTS APPLICABLE AND/OR REFERENCED.

HANDICAP ACCESSIBILITY STANDARDS WHERE APPLICABLE AND WHERE INDICATED ON THE DRAWINGS AND SPECIFICATIONS, ALL MATERIALS, PRODUCTS, WORKMANSHIP AND INSTALLATIONS SHALL CONFORM TO CURRENT REQUIREMENTS OF THE FEDERAL 'AMERICANS WITH DISABILITIES ACT' (ADA) AND ALL OTHER STATE AND LOCAL AGENCIES AND REGULATIONS HAVING JURISDICTION.

GENERAL NOTES:

- INC. AT (505) 998-1150



CODES & REGULATIONS:

1. GENERAL NOTES ON THIS SHEET APPLY TO ALL SHEETS.

2. CONTRACTOR TO COORDINATE HEIGHTS & LOCATIONS OF MECHANICAL UNITS, DUCT WORK, PIPES AND CONDUIT WITH FINISHED CEILING HEIGHTS PRIOR TO ANY INSTALLATION. IF ANY CONFLICT IS NOTED, THE CONTRACTOR IS TO NOTIFY ARCHITECT/ENGINEER IMMEDIATELY PRIOR TO COMMENCING THE WORK.

3. CONTRACTOR TO COORDINATE LOCATION OF CONSTRUCTION STAGING AREA W/ ARCHITECT & OWNER.

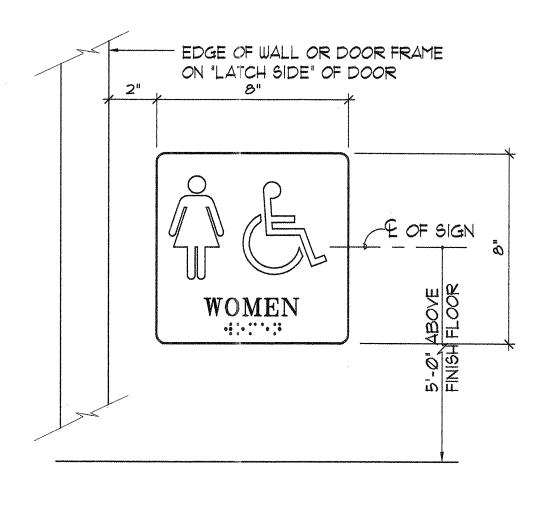
4. CONTRACTOR TO PROVIDE ELECTRICAL ROUGH-IN FOR SECURITY SYSTEM TO BE PROVIDED BY THE OUNER UNDER A SEPARATE CONTRACT. COORDINATE FINAL LOCATIONS WITH ROBERT WARD FROM SCI,

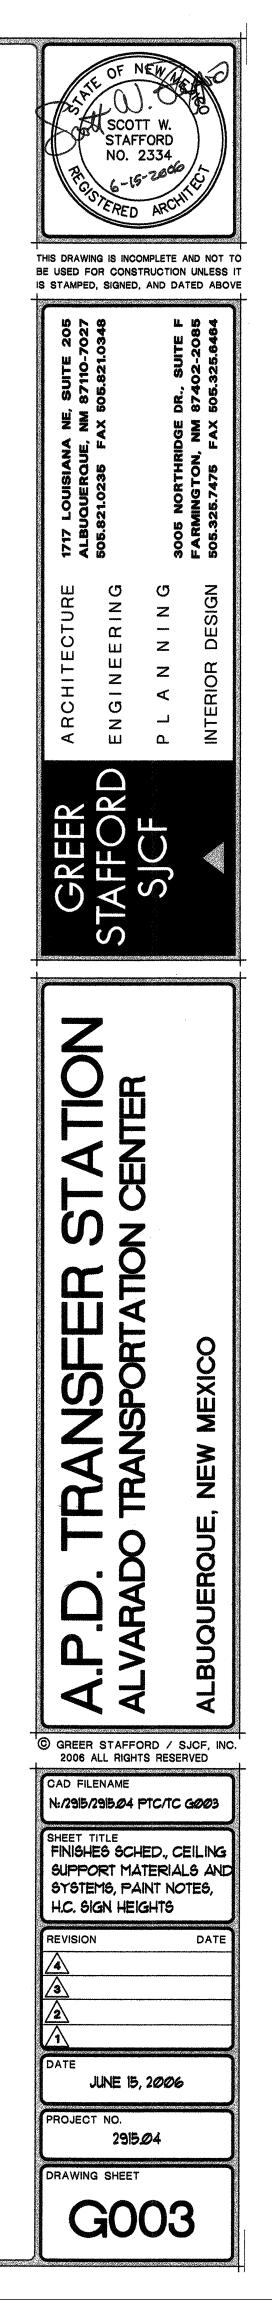
5. THE EXISTING STRUCTURE AND BUILDING ELEMENTS ARE SHOWN IN THEIR APPROXIMATE LOCATION. THE CONTRACTOR SHALL FIELD VERIFY EXISTING ELEMENTS AND NOTIFY THE ARCHITECT/ENGINEER OF ANY DISCREPANCIES BETWEEN ACTUAL CONDITIONS AND THOSE SHOWN ON PLANS PRIOR TO COMMENCING WORK. NO ALLOWANCES WILL BE MADE FOR ADDITIONAL MATERIALS AND OR LABOR AS A CONSEQUENCE OF FAILURE TO VERIFY EXISTING CONDITIONS.

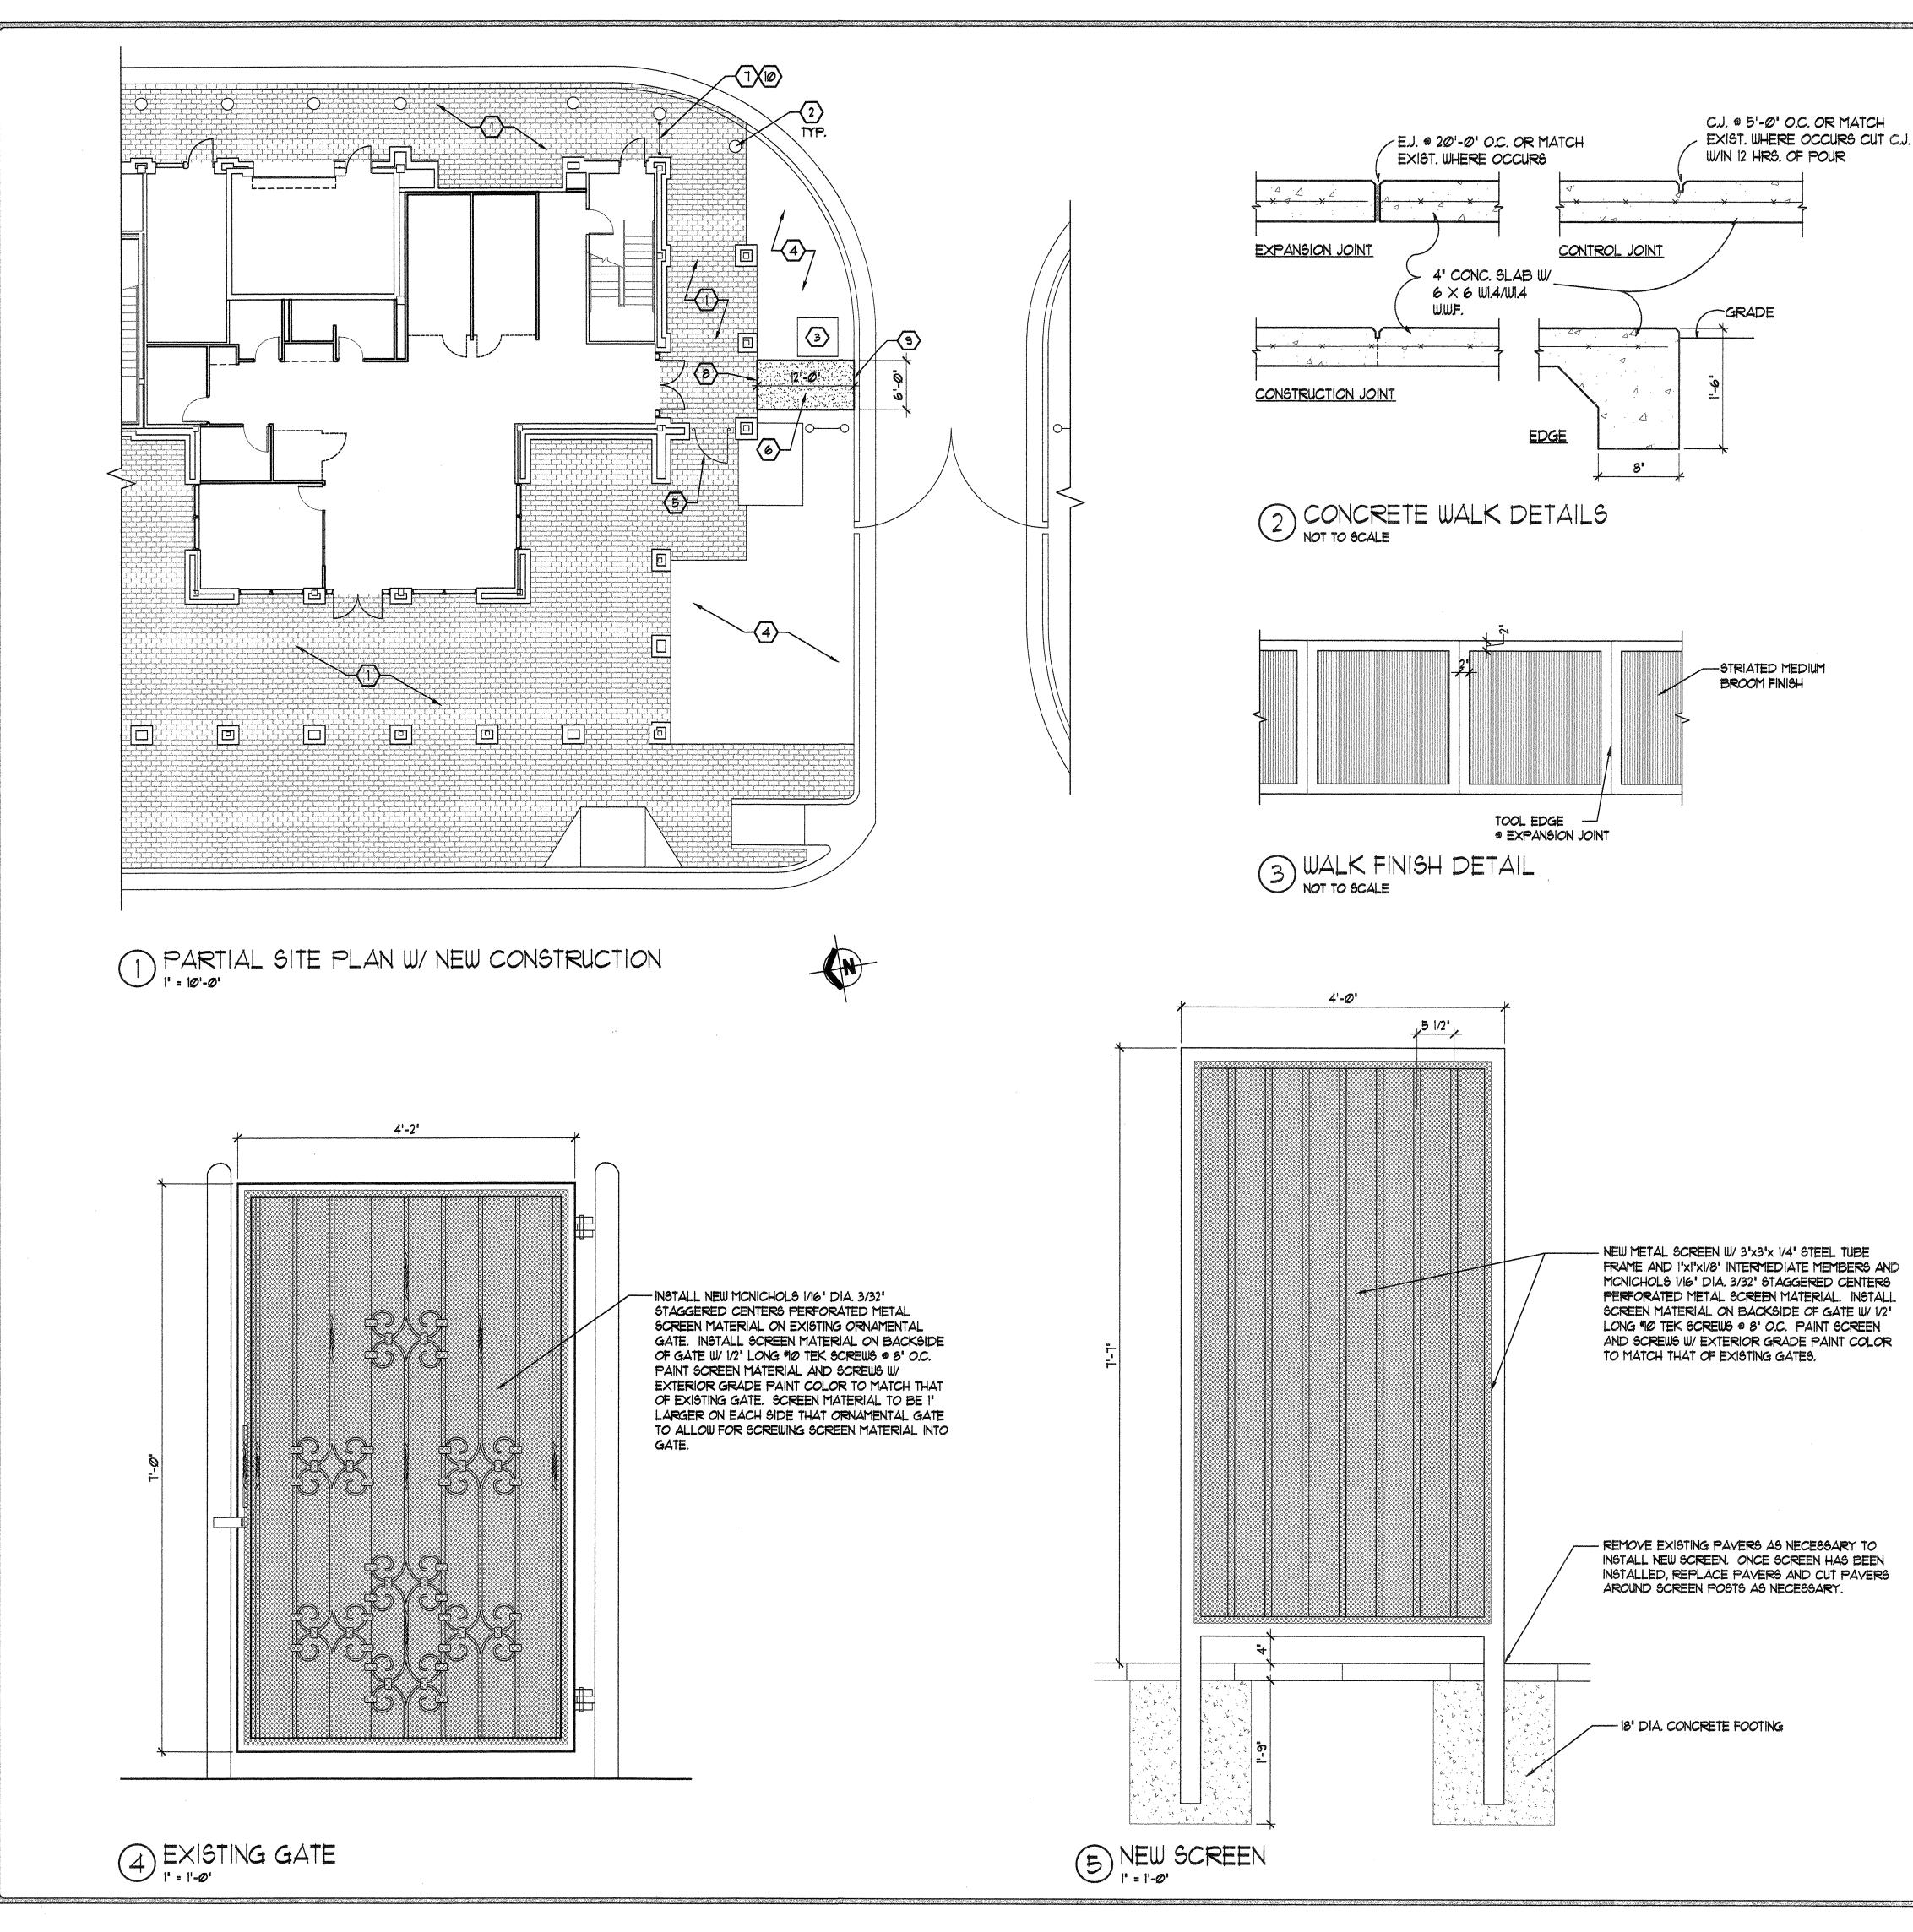
6. CONSTRUCTION WORK SHALL BE CARRIED OUT USING PROCEDURES AND TECHNIQUES WHICH WILL ASSURE FULL PROTECTION FOR PERSONS WITHIN THE BUILDING AND ON SITE WHETHER PART OF THE CONTRACTOR'S FORCES OR OTHER PERSONS.

1. ALL EXISTING EQUIPMENT AND OR BUILDING ELEMENTS WHICH ARE TO REMAIN SHALL BE PROTECTED FROM DAMAGE DURING CONSTRUCTION. ANY ITEM DAMAGED DURING CONSTRUCTION SHALL BE REPLACED OR REPAIRED AT THE CONTRACTOR'S EXPENSE.

9. PATCH AND REPAIR ANY SURFACE AS NECESSARY WHERE DEMOLITION OR RELATED WORK WAS ACCOMPLISHED, MATCH ADJACENT MATERIALS AND FINISHES.







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GENERAL NOTES:

REFER TO SHEET GOO3 FOR GENERAL NOTES THAT APPLY TO ALL SHEETS.


2. CAST-IN-PLACE CONCRETE: ALL INTERIOR SLABS ON GRADE F'C = 3000 PSI © 28 DAYS. USE CITY OF ALBUQUERQUE STANDARD MIX DESIGNATED 'INTERIOR STRUCTURES'.



- 1. EXISTING PAVERS TO REMAIN. PROTECT DURING CONSTRUCTION.
- 2. EXISTING PIPE BOLLARDS TO REMAIN. PROTECT DURING CONSTRUCTION.
- 3. EXISTING EQUIPMENT ENCLOSURE TO REMAIN. PROTECT DURING CONSTRUCTION.
- 4. EXISTING LANDSCAPED AREA TO REMAIN. PROTECT DURING CONSTRUCTION.
- 5. INSTALL NEW MCNICHOLS 1/16' DIA. 3/32' STAGGERED CENTERS PERFORATED METAL SCREEN MATERIAL ON EXISTING ORNAMENTAL GATE. INSTALL SCREEN MATERIAL ON BACKSIDE OF GATE W/ 1/2" LONG #10 TEK SCREWS @ 8" O.C. PAINT SCREEN MATERIAL AND SCREWS W/ EXTERIOR GRADE PAINT COLOR TO MATCH THAT OF EXISTING GATE. SCREEN MATERIAL TO BE I' LARGER ON EACH SIDE THAT ORNAMENTAL PATTERN TO ALLOW FOR SCREWING SCREEN MATERIAL INTO GATE. TOUCH UP PAINT OF EXISTING GATE IF ANY DAMAGE OCCURS AS A RESULT OF INSTALLING NEW SCREEN. REFER TO DETAIL 4/A100.
- 6. NEW 4' THICK CONCRETE WALK. REFER TO DETAILS 243/AIOO. REMOVE EXISTING LANDSCAPING FROM AREA WHERE NEW WALK WILL BE INSTALLED AND VERIFY NO UTILITIES WILL BE DAMAGED AS A RESULT OF INSTALLING NEW WALK PRIOR TO WALK WORK STARTING.
- 1. NEW METAL SCREEN W/ 3"x3'x 1/4" STEEL TUBE FRAME AND 1'x1'x1/8" INTERMEDIATE MEMBERS AND MCNICHOLS 1/16' DIA. 3/32' STAGGERED CENTERS PERFORATED METAL SCREEN MATERIAL. INSTALL SCREEN MATERIAL ON BACKSIDE OF GATE W/ 1/2' LONG MO TEK SCREWS @ 8' O.C. PAINT SCREEN AND SCREWS W/ EXTERIOR GRADE PAINT COLOR TO MATCH THAT OF EXISTING GATES. REFER TO DETAIL 6/A100.
- 8. MATCH TOP EXISTING OF SIDEWALK.
- 9. MATCH TOP OF EXISTING CURB.
- 10. REMOVE EXISTING PAVERS AS NECESSARY TO INSTALL NEW SCREEN. ONCE SCREEN HAS BEEN INSTALLED, REPLACE PAYERS AND CUT PAYERS AROUND SCREEN POSTS AS NECESSARY.


SCOTT W. STAFFORD NO. 2334 R. 6-15-2008 THIS DRAWING IS INCOMPLETE AND NOT TO BE USED FOR CONSTRUCTION UNLESS IT IS STAMPED, SIGNED, AND DATED ABOVE 205 7027 NE, SUITE NM 87110-7 1717 LOUISIANA ALBUQUERQUE, I ECTURE U U Z Z ш u Z Z Ī ARC C Z ۵. ш RD S. NOF TATIC CENTER U ່ທ_z ANSPORTATIO XICO Ш Х NEW $\hat{\mathbf{C}}$ E ALBUQUERQUE \mathbf{O} A **VA** Ω A

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FINISH LEGEND:

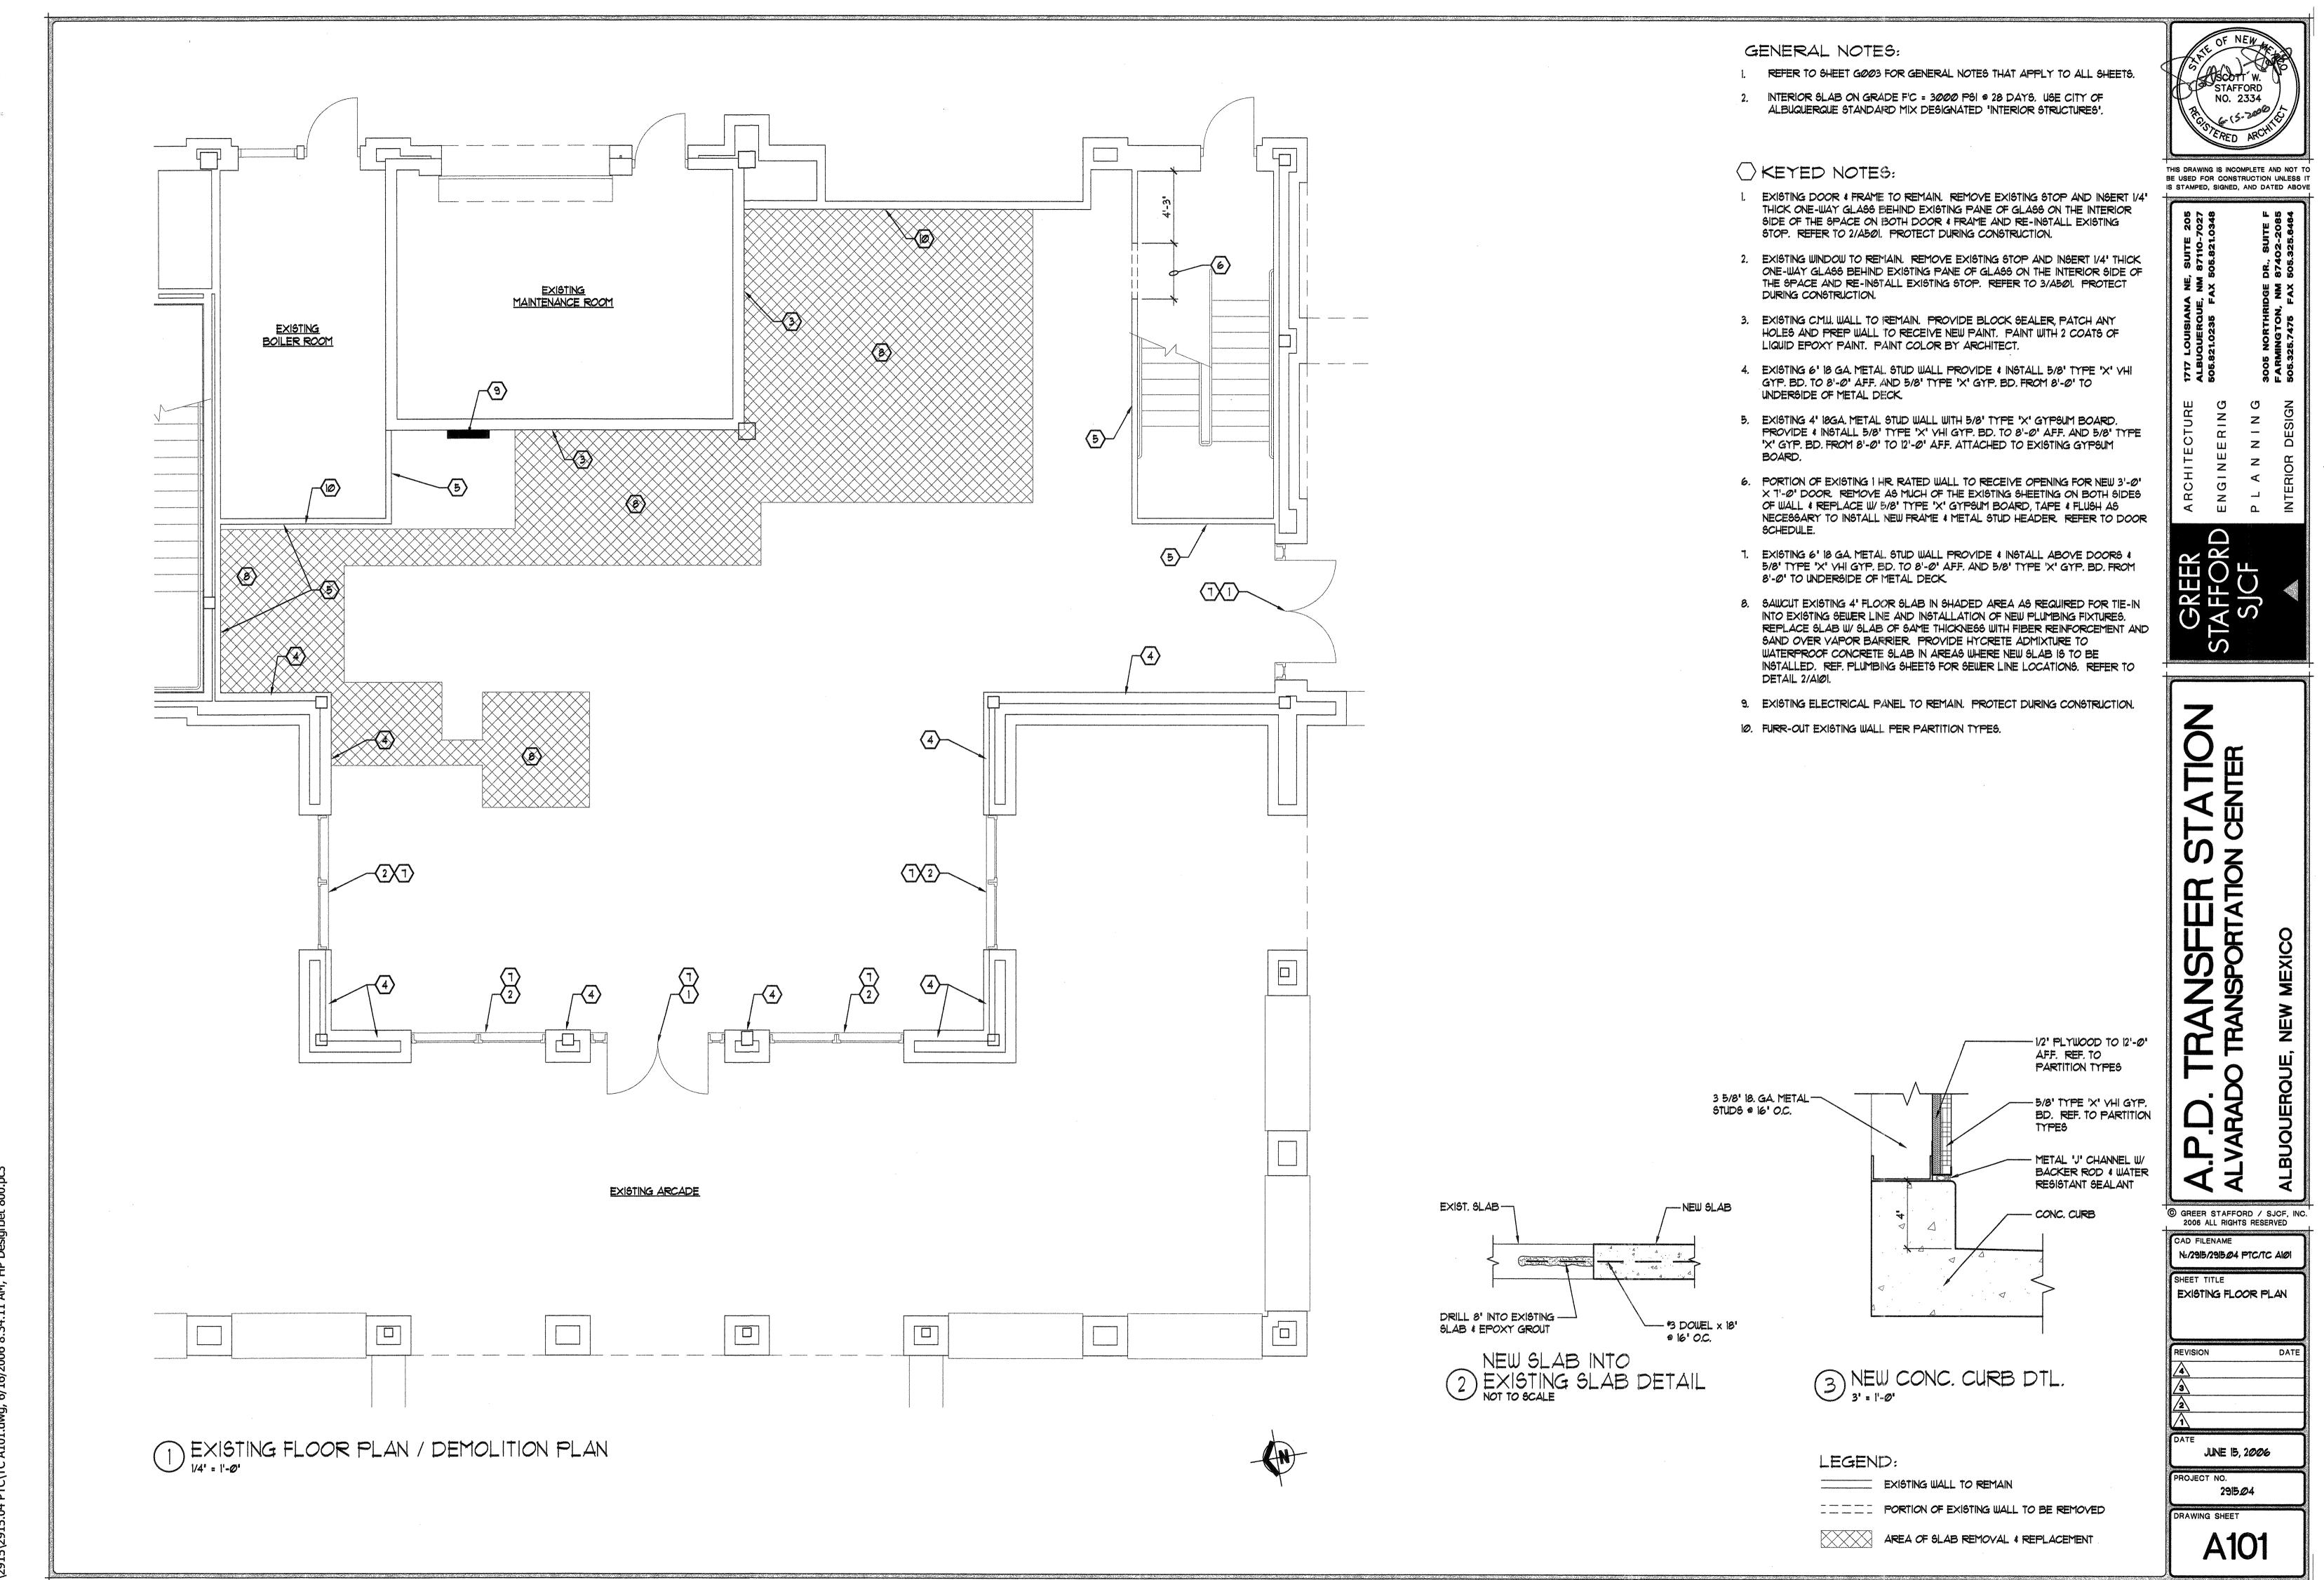ROOM NUMBER WALL FINISH P 8-0 C CEILING HEIGHT

- CEILING FINISH

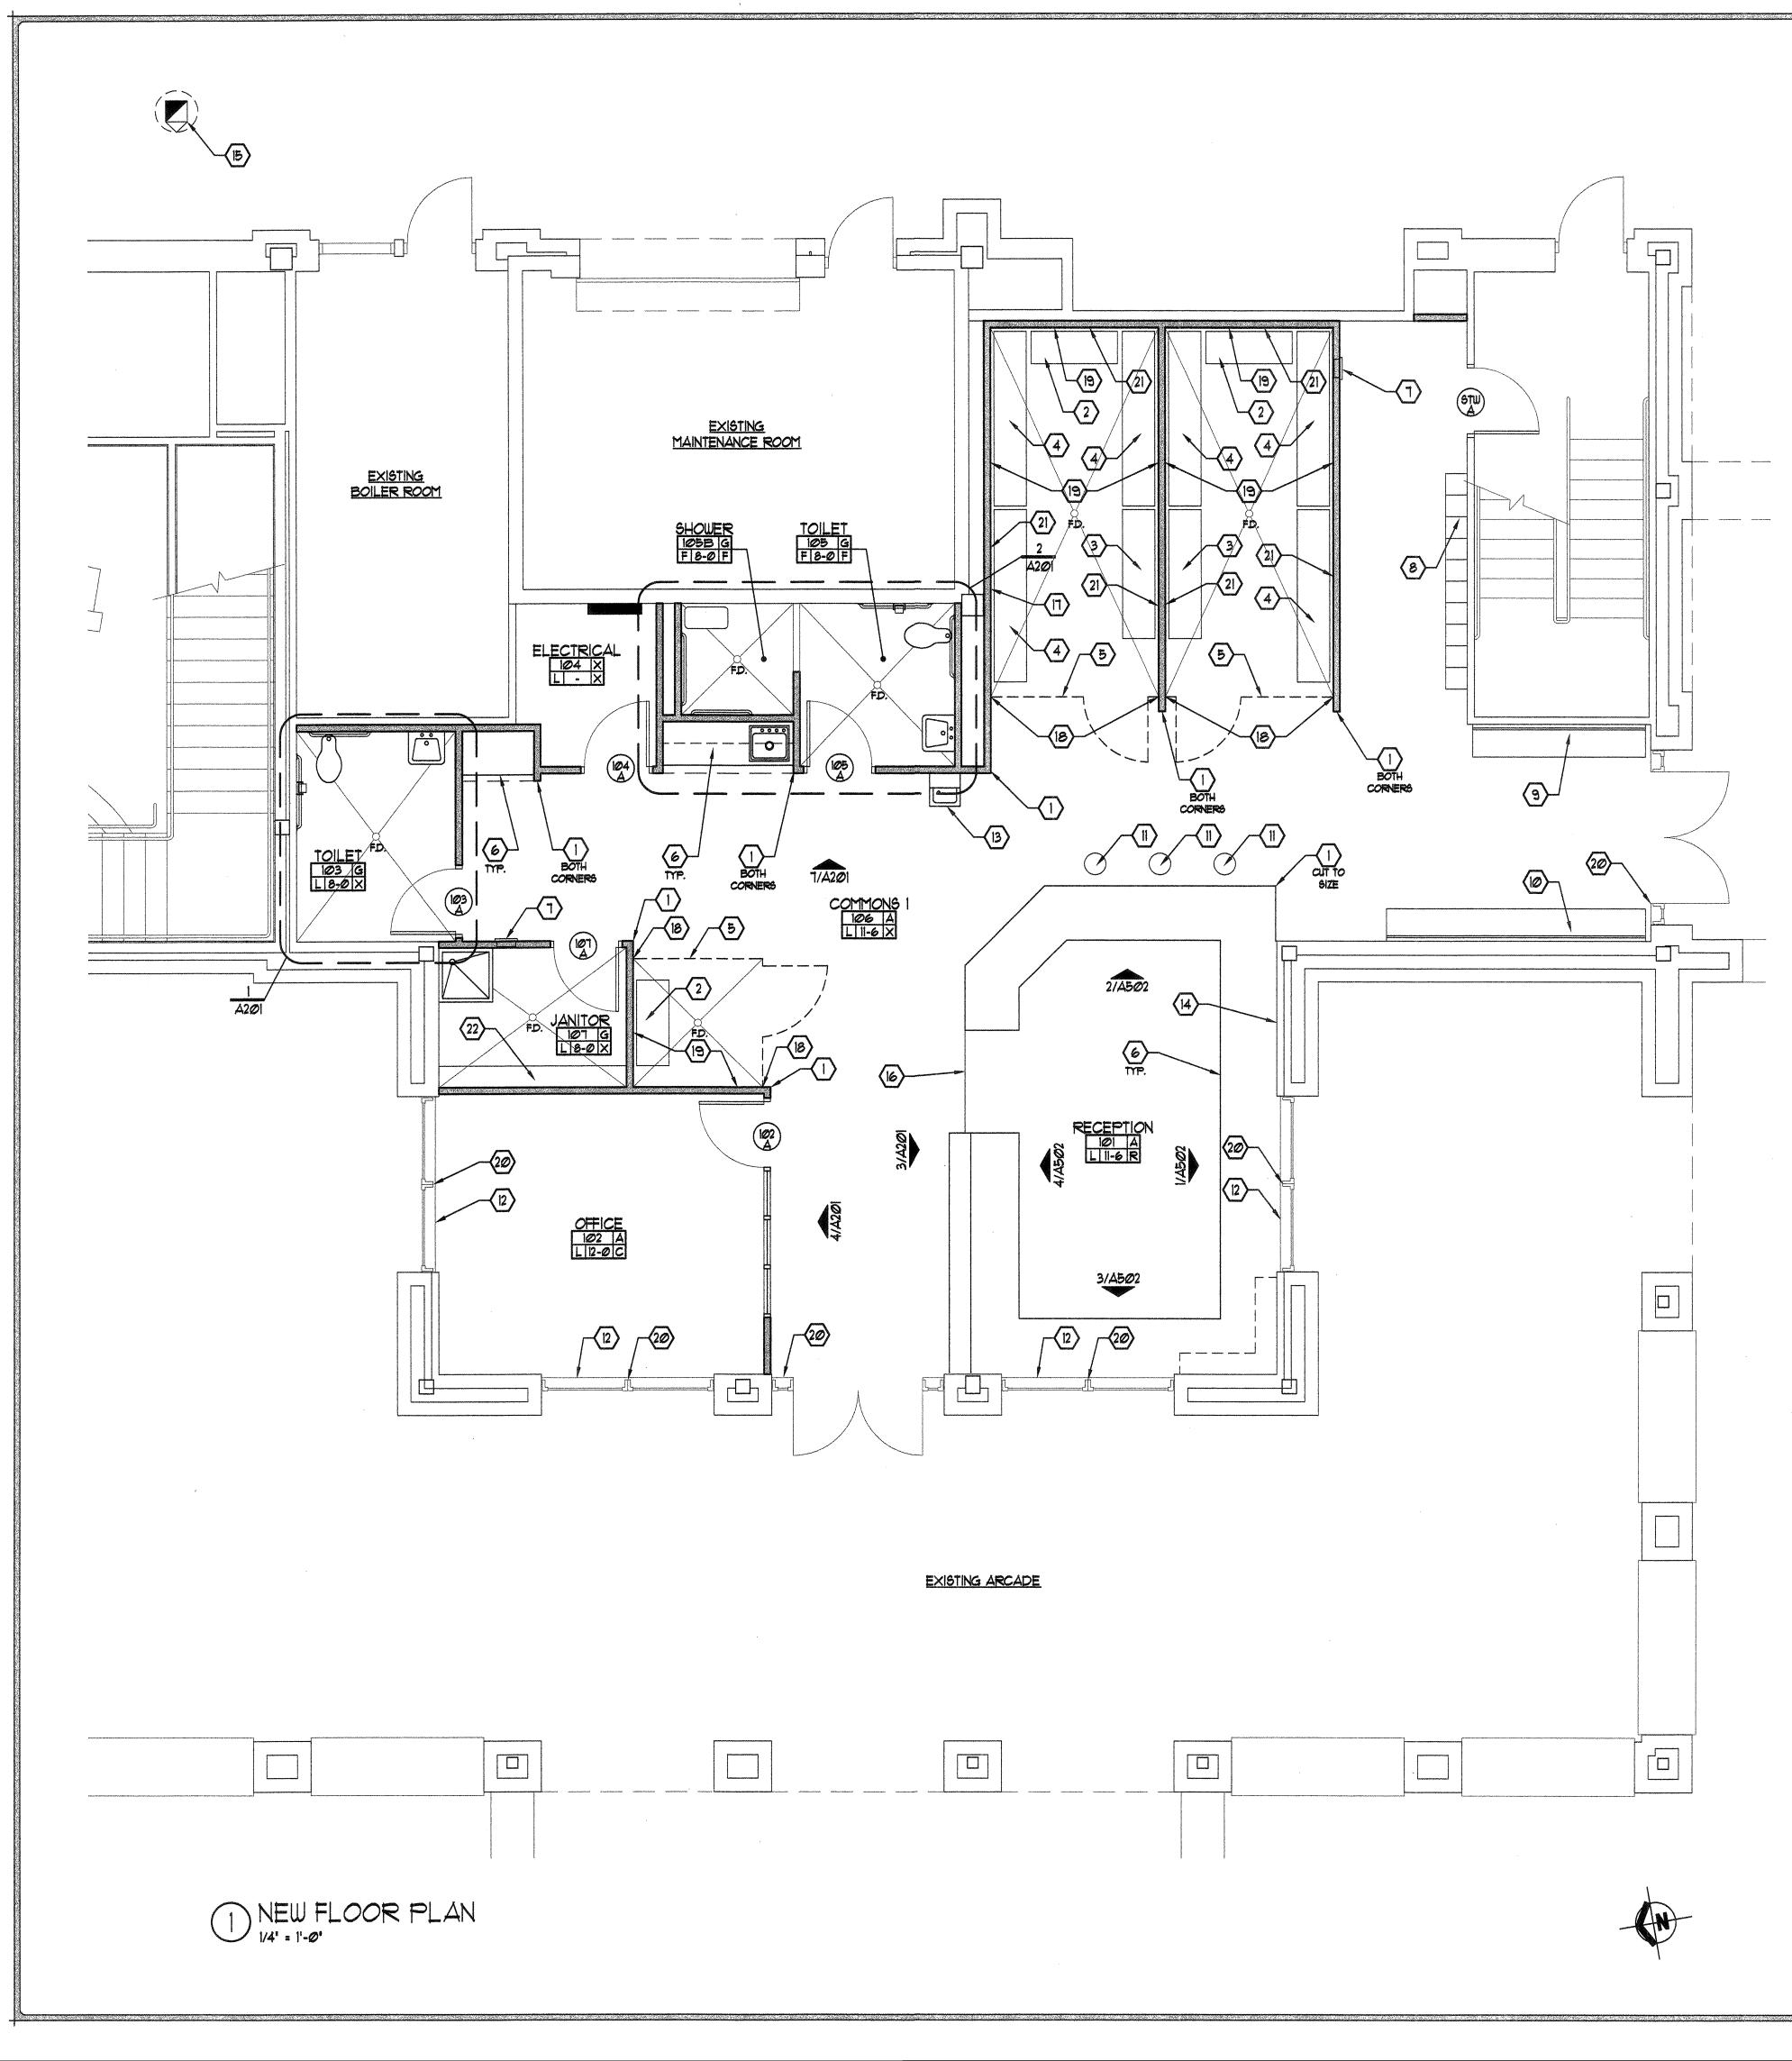FLOOR FINISH

<u>FLOOR FINISH</u> C- CARPET

F - FLEXIBLE EPOXY FINISH R- RUBBER FLOORING X- EXISTING TO RECEIVE NEW PAINT

<u>CEILING FINISH</u> A- 2'x2' ACOUSTICAL LAY-IN G- GYPSUM BOARD W/ EPOXY PAINT X-EXPOSED STRUCTURE TO REMAIN

WALL FINISH F- FLEXIBLE EPOXY FINISH L- EPOXY PAINT

BASE PROVIDE NEW 4' REGILIENT BASE AS NOTED AT FLOOR FINISH 'C', 'R' 4 'X'.

LEGEND:

EXISTING WALL TO REMAIN

GENERAL NOTES:


- 1. REFER TO SHEET A100 FOR GENERAL NOTES THAT APPLY TO ALL SHEETS.
- 2. REFER TO SHEET A103 FOR DIMENSIONS AND WALL TYPE MARKERS.
- 3. REFER TO SHEET GOO3 FOR FINISHES SCHEDULE.
- 4. ALL PLUMBING FIXTURES AND FLOOR DRAINS WITH CONCRETE SLAB SLOPING TO DRAINS SHOWN ON THIS SHEET ARE NEW INSTALLATIONS. REFER TO PLUMBING SHEETS AND SHEET AIRI FOR EXTENTS OF CONCRETE SLAB TO BE REMOVED AND REPLACED.
- 5. GYPSUM BOARD CALLED OUT ON DRAWINGS TO BE SHEETROCK BRAND TYPE 'X' GYPSUM PANELS BY USG CORPORATION.
- 6. VHI GYPSUM BOARD CALLED OUT ON DRAWINGS TO BE FIBEROCK BRAND TYPE 'X' VHI ABUSE-RESISTANT GYPSUM INTERIOR PANELS BY USG CORPORATION.
- 7. WATER RESISTANT GYPSUM BOARD CALLED OUT ON DRAWINGS TO BE FIBEROCK BRAND AQUA-TOUGH GYPSUM INTERIOR PANELS BY USG CORPORATION.
- 8. REFER TO A201 FOR ADDITIONAL TOILET ACCESSORIES.
- 9. KEYSTONE RIDGE DESIGNS (800) 284-8208.
- 10. PROVIDE & INSTALL ROOM SIGNS PER SHEET GOO3.
- 11. IT IS THE CONTRACTOR RESPONSIBILITY TO LOWER OR RELOCATE EXISTING FIRE ALARM DEVICES IF THEY INTERFERE WITH NEW CONSTRUCTION. PROVIDE ALL MATERIALS NECESSARY TO COMPLETE RELOCATION'S.

KEYED NOTES:

- NEW STAINLESS STEEL 48' HIGH CORNER GUARD. BOBRICK MODEL #B-633x48.
- 2. NEW 48' LONG FLAT BENCH. KEYSTONE RIDGE DESIGNS TORQUE SERIES. ANCHOR INTO CONCRETE SLAB W/ (4) 3/8' DIA \times 3' LONG EXPANSION ANCHORS AT EACH LEG.
- 3. NEW 72' LONG FLAT BENCH. KEYSTONE RIDGE DESIGNS TORQUE SERIES. ANCHOR INTO CONCRETE SLAB W/ (4) 3/8' DIA x 3' LONG EXPANSION ANCHORS AT EACH LEG.
- 4. NEW 96' LONG FLAT BENCH. KEYSTONE RIDGE DESIGNS TORQUE SERIES. ANCHOR INTO CONCRETE SLAB W/ (4) 3/8' DIA x 3' LONG EXPANSION ANCHORS AT EACH LEG.
- 5. NEW 10 GA. ROUNDED EDGES WIREWAYHUSKY DETENTION CELL FRONT, CEILING & GATE. TYPICAL. INCLUDE DOOR HARDWARE CAPABLE OF BEING REMOTELY RELEASED. FIELD VERIFY FINAL FINISHED DIMENSIONS PRIOR TO ORDERING DETENTION CELL MATERIALS.
- 6. NEW PLASTIC LAMINATE CASEWORK, TYPICAL. REF. TO SHEET A201.
- 1. PROVIDE AND INSTALL NEW FIRE EXTINGUISHER & CABINET. REFER TO SHEET GOO3. MOUNTING HEIGHT PER MANUFACTURERS RECOMMENDATIONS.
- 8. NEW (20) 12'X12' METAL LOCKERS. MANUFACTURED BY LYONG CORPORATION. COLOR BY ARCHITECT.
- 9. NEW 8'-0' LONG, 14GA. STAINLESS STEEL BENCH (SIMILAR TO THOSE AT OTHER A.P.D. SUBSTATIONS). ATTACH TO EXISTING METAL STUD WALL @ 16' O.C. WITH SECURITY FASTENERS. PROVIDE & INSTALL STAINLESS STEEL BRACKET @ ENDS AND AT 4'-0' O.C. REF. TO DETAIL 4/A503.
- 10. NEW 12'-0' LONG, 14GA. STAINLESS STEEL BENCH (SIMILAR TO THOSE AT OTHER A.P.D. SUBSTATIONS). ATTACH TO EXISTING METAL STUD WALL @ 16' O.C. WITH SECURITY FASTENERS. PROVIDE & INSTALL STAINLESS STEEL BRACKET @ ENDS AND AT 4'-0' O.C. REF. TO DETAIL 4/A503.
- 11. PROVIDE AND INSTALL 18' HIGH 14 GA. STAINLESS STEEL SEAT TOP STOOL W/ SCHEDULE 40 PIPE SAND AND 8'X8'X1/4' BASE MOUNTING PLATE. ATTACH TO CONCRETE SLAB W/ (4) 3/8' DIA x 3' LONG EXPANSION ANCHORS FINAL LOCATION PER OWNER
- 12. PROVIDE & INSTALL NEW 1" LEVELOR MINI-BLINDS TO FIT INSIDE WINDOW FRAME. COLOR BY ARCHITECT.
- 13. NEW DRINKING FOUNTAIN. TOP OF SPOUT TO BE 3'-0' AFF. REFER TO PLUMBING PLANS.
- 14. PROVIDE & INSTALL TWO (2) LAYERS OF 1/2" PLYWOOD BLOCKING BETWEEN STUDS FROM 3'-0" AFF. TO 11'-0" AFF. X LENGTH OF PORTION OF WALL.
- 15. PROVIDE NEW OPENING IN EXISTING CLAY ROOF TO INSTALL NEW EXHAUST FAN. REFER TO MECHANICAL PLANS. INSTALL NEW CURB PER MECHANICAL PLANS & FLASH CURB INTO EXISTING ROOF SO THAT NEW CURB AND FLASHING DOES NOT VOID EXISTING ROOF WARRANTY.
- 16. PROVIDE RESILIENT REDUCER JOHNGONITE SGR-XX-B OR EQUAL WHERE RUBBER FLOORING TRANSITIONS TO CONCRETE FLOOR.
- 17. PROVIDE NEW 18'X18' HIGH SECURITY ACCESS PANEL IN NEW WALL CENTERED ON EXISTING WALL CLEANOUT. REF. TO PLUMBING PLANS FOR LOCATION OF EXISTING CLEANOUT.
- 18. PROVIDE & INSTALL 2'X12' WOOD BLOCKING @ 24' O.C. TO 8'-0' AFF. BETWEEN STUDS AT LOCATION OF WIRE DETENTION CELL ATTACHMENT TO NEW WALL. VERIFY FINAL ANCHORING LOCATION WITH DETENTION CELL MANUFACTURER PRIOR TO INSTALLING WOOD BLOCKING.
- 19. PROVIDE & INSTALL CONTINUOS 2'X12' @ 8'-0' O.C. AFF. WOOD BLOCKING BETWEEN STUDS AND 3'X5'X1/4' CONTINUOS STEEL ANGLE AT LOCATION OF WIRE DETENTION CELL CEILING ATTACHMENT TO NEW WALL. VERIFY FINAL ANCHORING LOCATION WITH DETENTION CELL MANUFACTURER PRIOR TO INSTALLING WOOD BLOCKING AND ANGLE. ATTACH ANGLE TO WALL W/ 3/8' DIA. X 3' LONG LAG BOLTS AT 16' O.C. REFER TO DETAIL 10/A504.
- 20. PREP AND PAINT INTERIOR SIDE OF EXISTING H.M. DOOR & WINDOW FRAMES. COLOR BY ARCHITECT.
- 21. INSTALL NEW CONCRETE CURB. REFER TO DETAIL 3/A101.
- 22. PROVIDE & INSTALL TWO (2) LYONG MANUFACTURING, 8000 SERIES INDUSTRIAL SHELVING UNITS. FIVE SHELF, 48' WIDE OPEN SHELVING.



| N:/2915/2915/04 PTC/TC A102 |
|-------------------------------|
| SHEET TITLE NEW FLOOR PLAN |
| REVISION DATE |
| |
| <u>3</u> |
| 2 |
| |
| DATE JUNE 15, 2006 |
| PROJECT NO. 2915.04 |
| DRAWING SHEET |
| A102 |

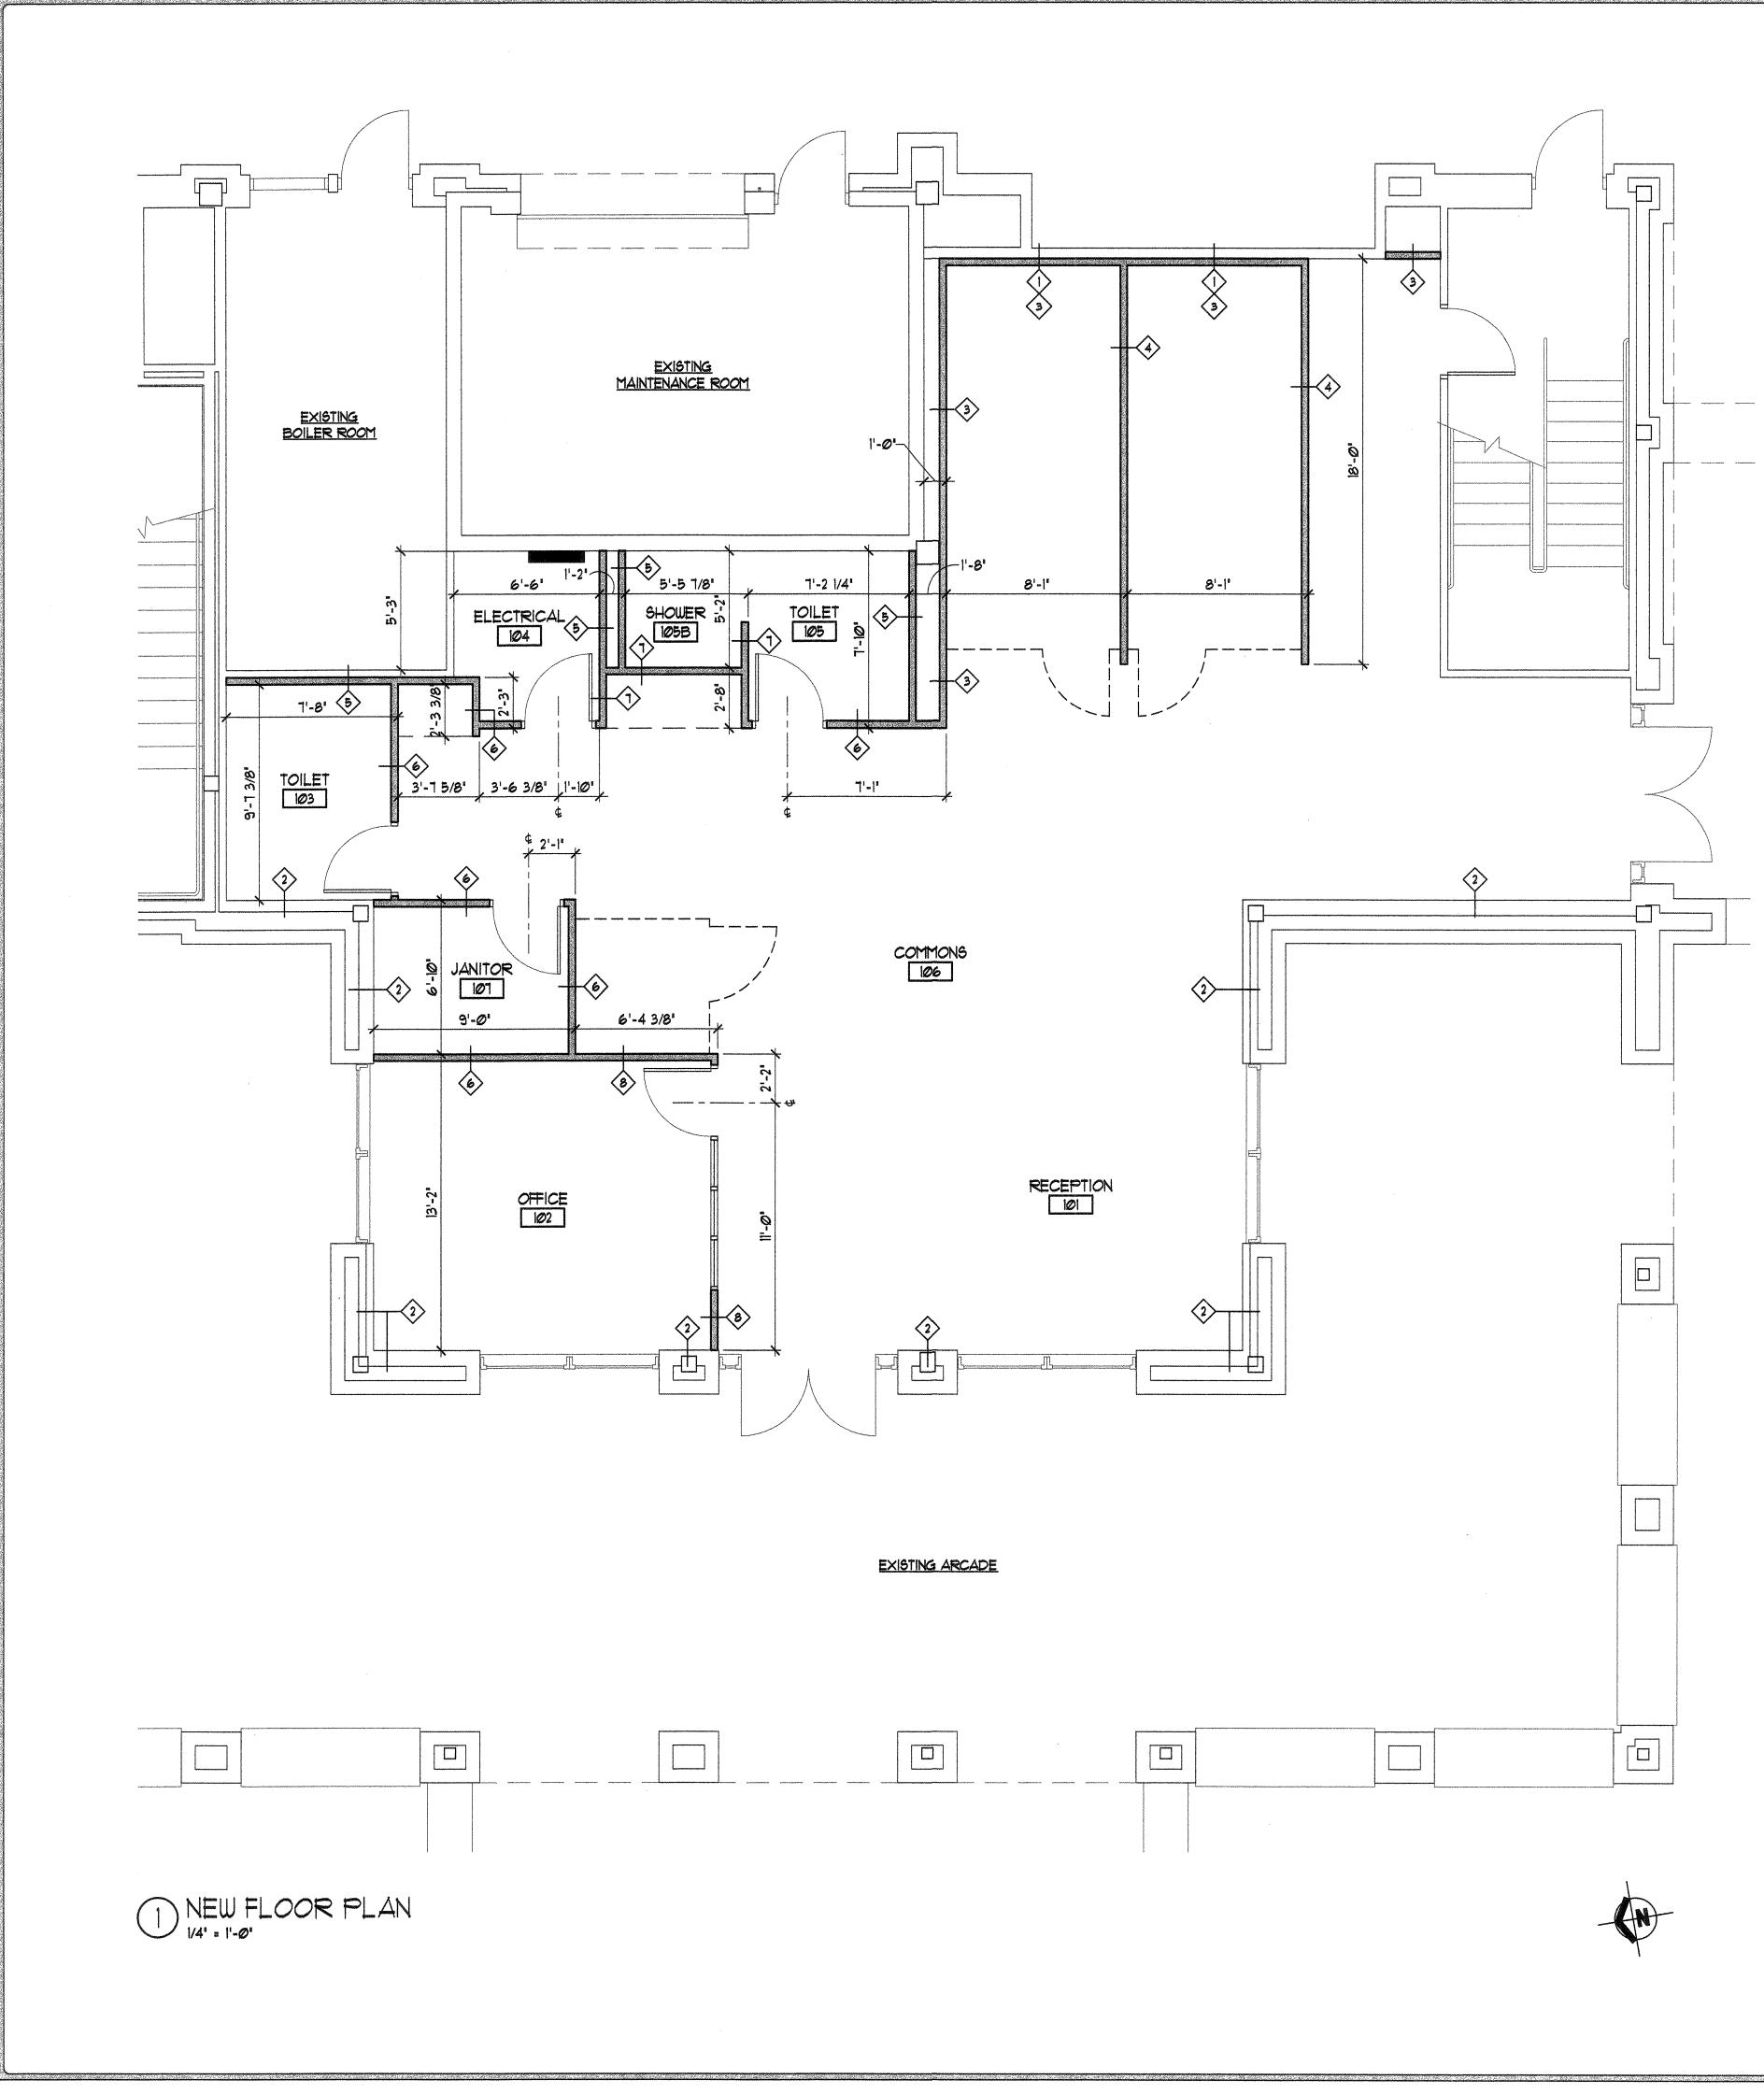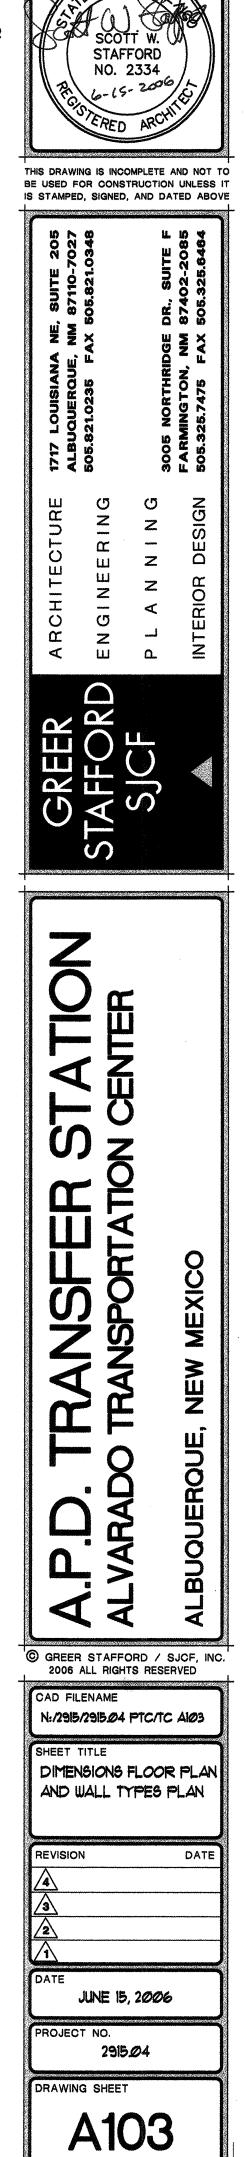


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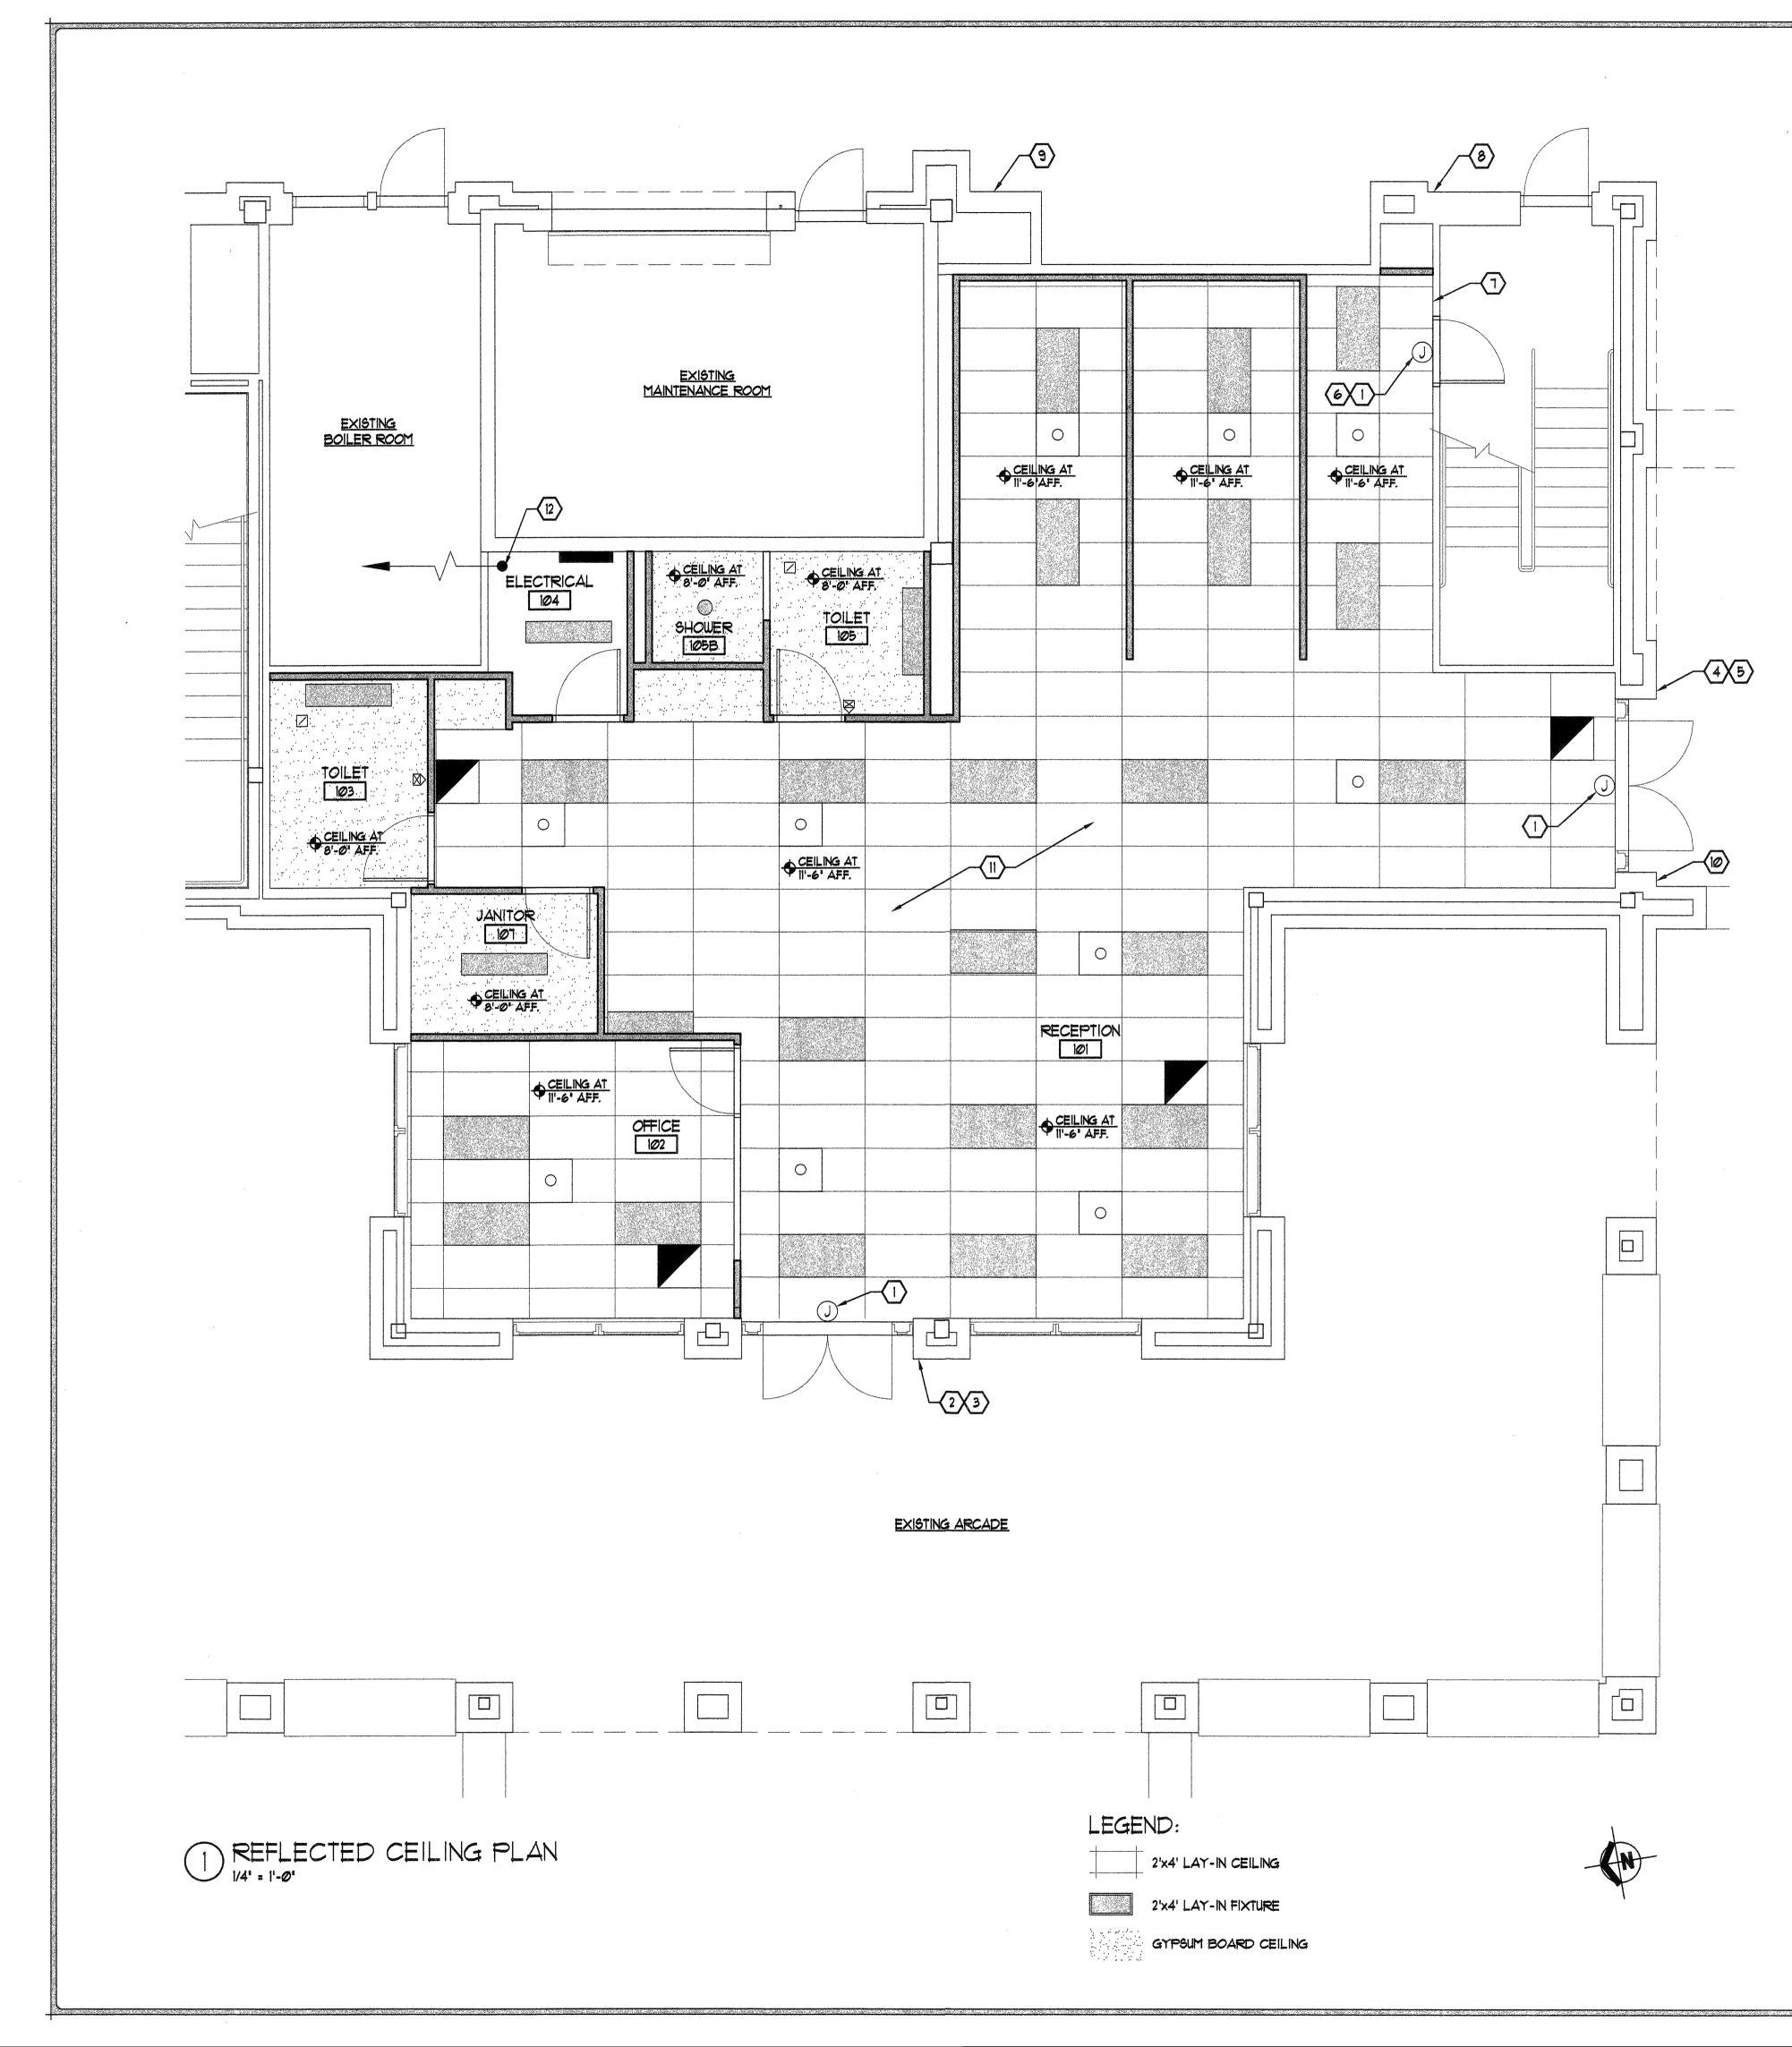
- SOME ITEMS LEFT OUT OF THIS PLAN FOR CLARITY PURPOSES. REFER TO A102 FOR ALL EXISTING AND NEW CONSTRUCTION. 1
- REFER TO SHEET GOOJ FOR GENERAL NOTES THAT APPLY TO THIS SHEET. 2.
- 3. GYPSUM BOARD CALLED OUT ON DRAWINGS TO BE SHEETROCK BRAND TYPE 'X' GYPSUM PANELS BY USG CORPORATION.
- 4. VHI GYPSUM BOARD CALLED OUT ON DRAWINGS TO BE FIBEROCK BRAND TYPE 'X' VHI ABUSE-RESISTANT GYPSUM INTERIOR PANELS BY USG CORPORATION.
- 5. WATER RESISTANT GYPSUM BOARD CALLED OUT ON DRAWINGS TO BE FIBEROCK BRAND AQUA-TOUGH GYPSUM INTERIOR PANELS BY USG CORPORATION.



LEGEND:



EXISTING WALL TO REMAIN NEW CONSTRUCTION



2

GENERAL NOTES:

- THIS SHEET.
- 2. REFER TO SHEET GOOS FOR FINISHES SCHEDULE.
- 3. REFER TO SHEET AIO2 FOR FINISH LEGEND.
- IMPROVEMENT WORK

KEYED NOTES:

- 2. PROVIDE & INSTALL ON SOUTH INTERIOR SIDE OF DOOR:
- 3. PROVIDE & INSTALL ON SOUTH EXTERIOR SIDE OF DOOR:
- 4. PROVIDE & INSTALL ON EAGT INTERIOR SIDE OF DOOR:
- 5. PROVIDE & INSTALL ON EAST EXTERIOR SIDE OF DOOR:
- 7. PROVIDE & INSTALL ON EAST INTERIOR SIDE OF DOOR:
- 8. PROVIDE & INSTALL ON EAST EXTERIOR WALL:
- 9. PROVIDE & INSTALL ON EAST EXTERIOR WALL:
- 10. PROVIDE & INSTALL ON SOUTH EXTERIOR WALL:
- OUNER.

DOUBLE GANG BOX-

SINGLE GANG BOX-

LINE OF BUILDING -EXTERIOR WALL

REFER TO ELECTRICAL LIGHTING SHEETS FOR OTHER ITEMS NOT SHOWN ON

4. ELECTRICAL ROUGH-IN SHOUN ON THIS SHEET TO BE PROVIDED UNDER THE CONTRACT FOR THE TENANT

PROVIDE & INSTALL SINGLE GANG OUTLET CENTERED ON DOOR @ 12'-6" AFF. W/ (2) #12 & (1) #12 GROUND - IN 1/2" CONDUIT TO NEAREST RECEPTACLE CIRCUIT. PROVIDE 3'-0' LONG FLEX WHIP W/ (2) #12 \$ (1) #12 GROUND FOR SECURITY SYSTEM CONTROLLER.

A. ONE SINGLE GANG BOX MOUNTED FLUSH WITH THE WALL FINISH 45" ON CENTER OFF THE FLOOR

B. 3/4" CONDUIT RUN FROM THE SINGLE GANG BOX TO THE EXISTING JUNCTION BOX LOCATED ABOVE THE DOOR.

A. ONE SINGLE GANG BOX MOUNTED FLUSH WITH THE WALL FINISH 45' ON CENTER OFF THE FLOOR. B. ONE 3/4' CONDUIT CONNECTING THE INTERIOR BOX WITH THIS BOX.

C. ONE DOUBLE GANG BOX MOUNTED FLUSH WITH THE WALL FINISH 55' ON CENTER OFF THE FLOOR D. ONE 3/4" CONDUIT CONNECTING THE DOUBLE BOX WITH THE SINGLE BOX.

A. ONE SINGLE GANG BOX MOUNTED FLUSH WITH THE WALL FINISH 45" ON CENTER OFF THE FLOOR. B. 3/4" CONDUIT RUN FROM THE SINGLE GANG BOX TO THE EXISTING JUNCTION BOX LOCATED ABOVE THE DOOR.

A. ONE SINGLE GANG BOX MOUNTED FLUSH WITH THE WALL FINISH 45' ON CENTER OFF THE FLOOR

B. ONE 3/4" CONDUIT CONNECTING THE INTERIOR BOX WITH THIS BOX.

C. ONE DOUBLE GANG BOX MOUNTED FLUSH WITH THE WALL FINISH 55' ON CENTER OFF THE FLOOR.

D. ONE 3/4" CONDUIT CONNECTING THE DOUBLE BOX WITH THE SINGLE BOX.

6. PROVIDE & INSTALL ONE & X & X & JUNCTION BOX # 12'-6" AFF. 18" OFF CENTER OF DOOR.

A. ONE SINGLE GANG BOX MOUNTED FLUSH WITH THE WALL FINISH 45" ON CENTER OFF THE FLOOR B. 3/4" CONDUIT RUN FROM THE SINGLE GANG BOX TO THE JUNCTION BOX LOCATED ABOVE THE DOOR. C. 1/2" CONDUIT RUN FROM THE JUNCTION BOX 3" INTO DOOR FRAME ON THE STRIKE SIDE OF THE DOOR. D. 3/4" CONDUIT RUN FROM THE JUNCTION BOX 3" INTO DOOR FRAME ON THE HINGE SIDE OF THE DOOR.

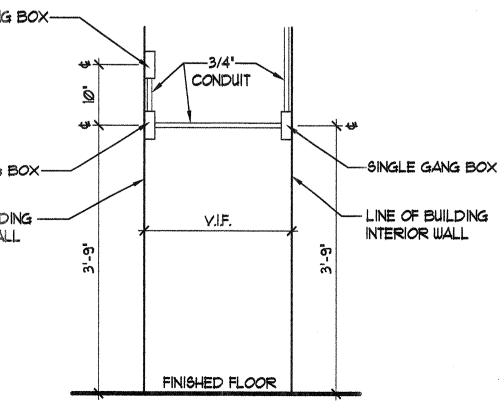
A. ONE DOUBLE GANG BOX MOUNTED FLUSH WITH THE WALL FINISH 55' ON CENTER OFF THE FLOOR. B. 1/2" CONDUIT RUN FROM THE DOUBLE GANG BOX TO THE JUNCTION BOX LOCATED ABOVE DOOR STW A.

A. ONE SINGLE GANG BOX MOUNTED FLUSH WITH THE WALL FINISH 12'-O' ON CENTER OFF THE GROUND B. 3/4" CONDUIT STUBBED INTO AND ABOVE THE CEILING INTO NEW SPACE.

A. ONE SINGLE GANG BOX MOUNTED FLUSH WITH THE WALL FINISH 12'-O' ON CENTER OFF THE GROUND. B. 3/4" CONDUIT STUBBED INTO AND ABOVE THE CEILING INTO NEW SPACE.


11. REMOVE EXISTING LIGHT FIXTURES AND CONDUCTORS IN TENANT IMPROVEMENT AREA TO NEAREST JUNCTION BOX AND RETURN TO

12. PROVIDE & INSTALL 190 L.F. OF 1' DIA. CONDUIT FROM ELECTRICAL ROOM #104 TO EXISTING SECOND FLOOR COMPUTER HUB ROOM. PROVIDE ALL NECESSARY MATERIALS TO PROVIDE A FINISHED INSTALLATION.






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|---|--|---|
| E | 1717 LOUISIANA NE, SUITE 205 ALBUQUERQUE, NM 87110-7027 505.821.0235 FAX 505.821.0348 | |
| | ARCHITECTURE ENGINEERING | P L A N N I N G INTERIOR DESIGN |
| | GREER STAFFORD | |
| | A.P.D. TRANSFER STATION ALVARADO TRANSPORTATION CENTER | ALBUOUEROUE, NEW MEXICO |
| | CAD FILENAME N:/2915/2915/24 P SHEET TITLE REFLECTED CE SECURITY ELEC ROUGH-IN LOCA REVISION | TC/TC A104 EILING PLAN C. ATIONS |

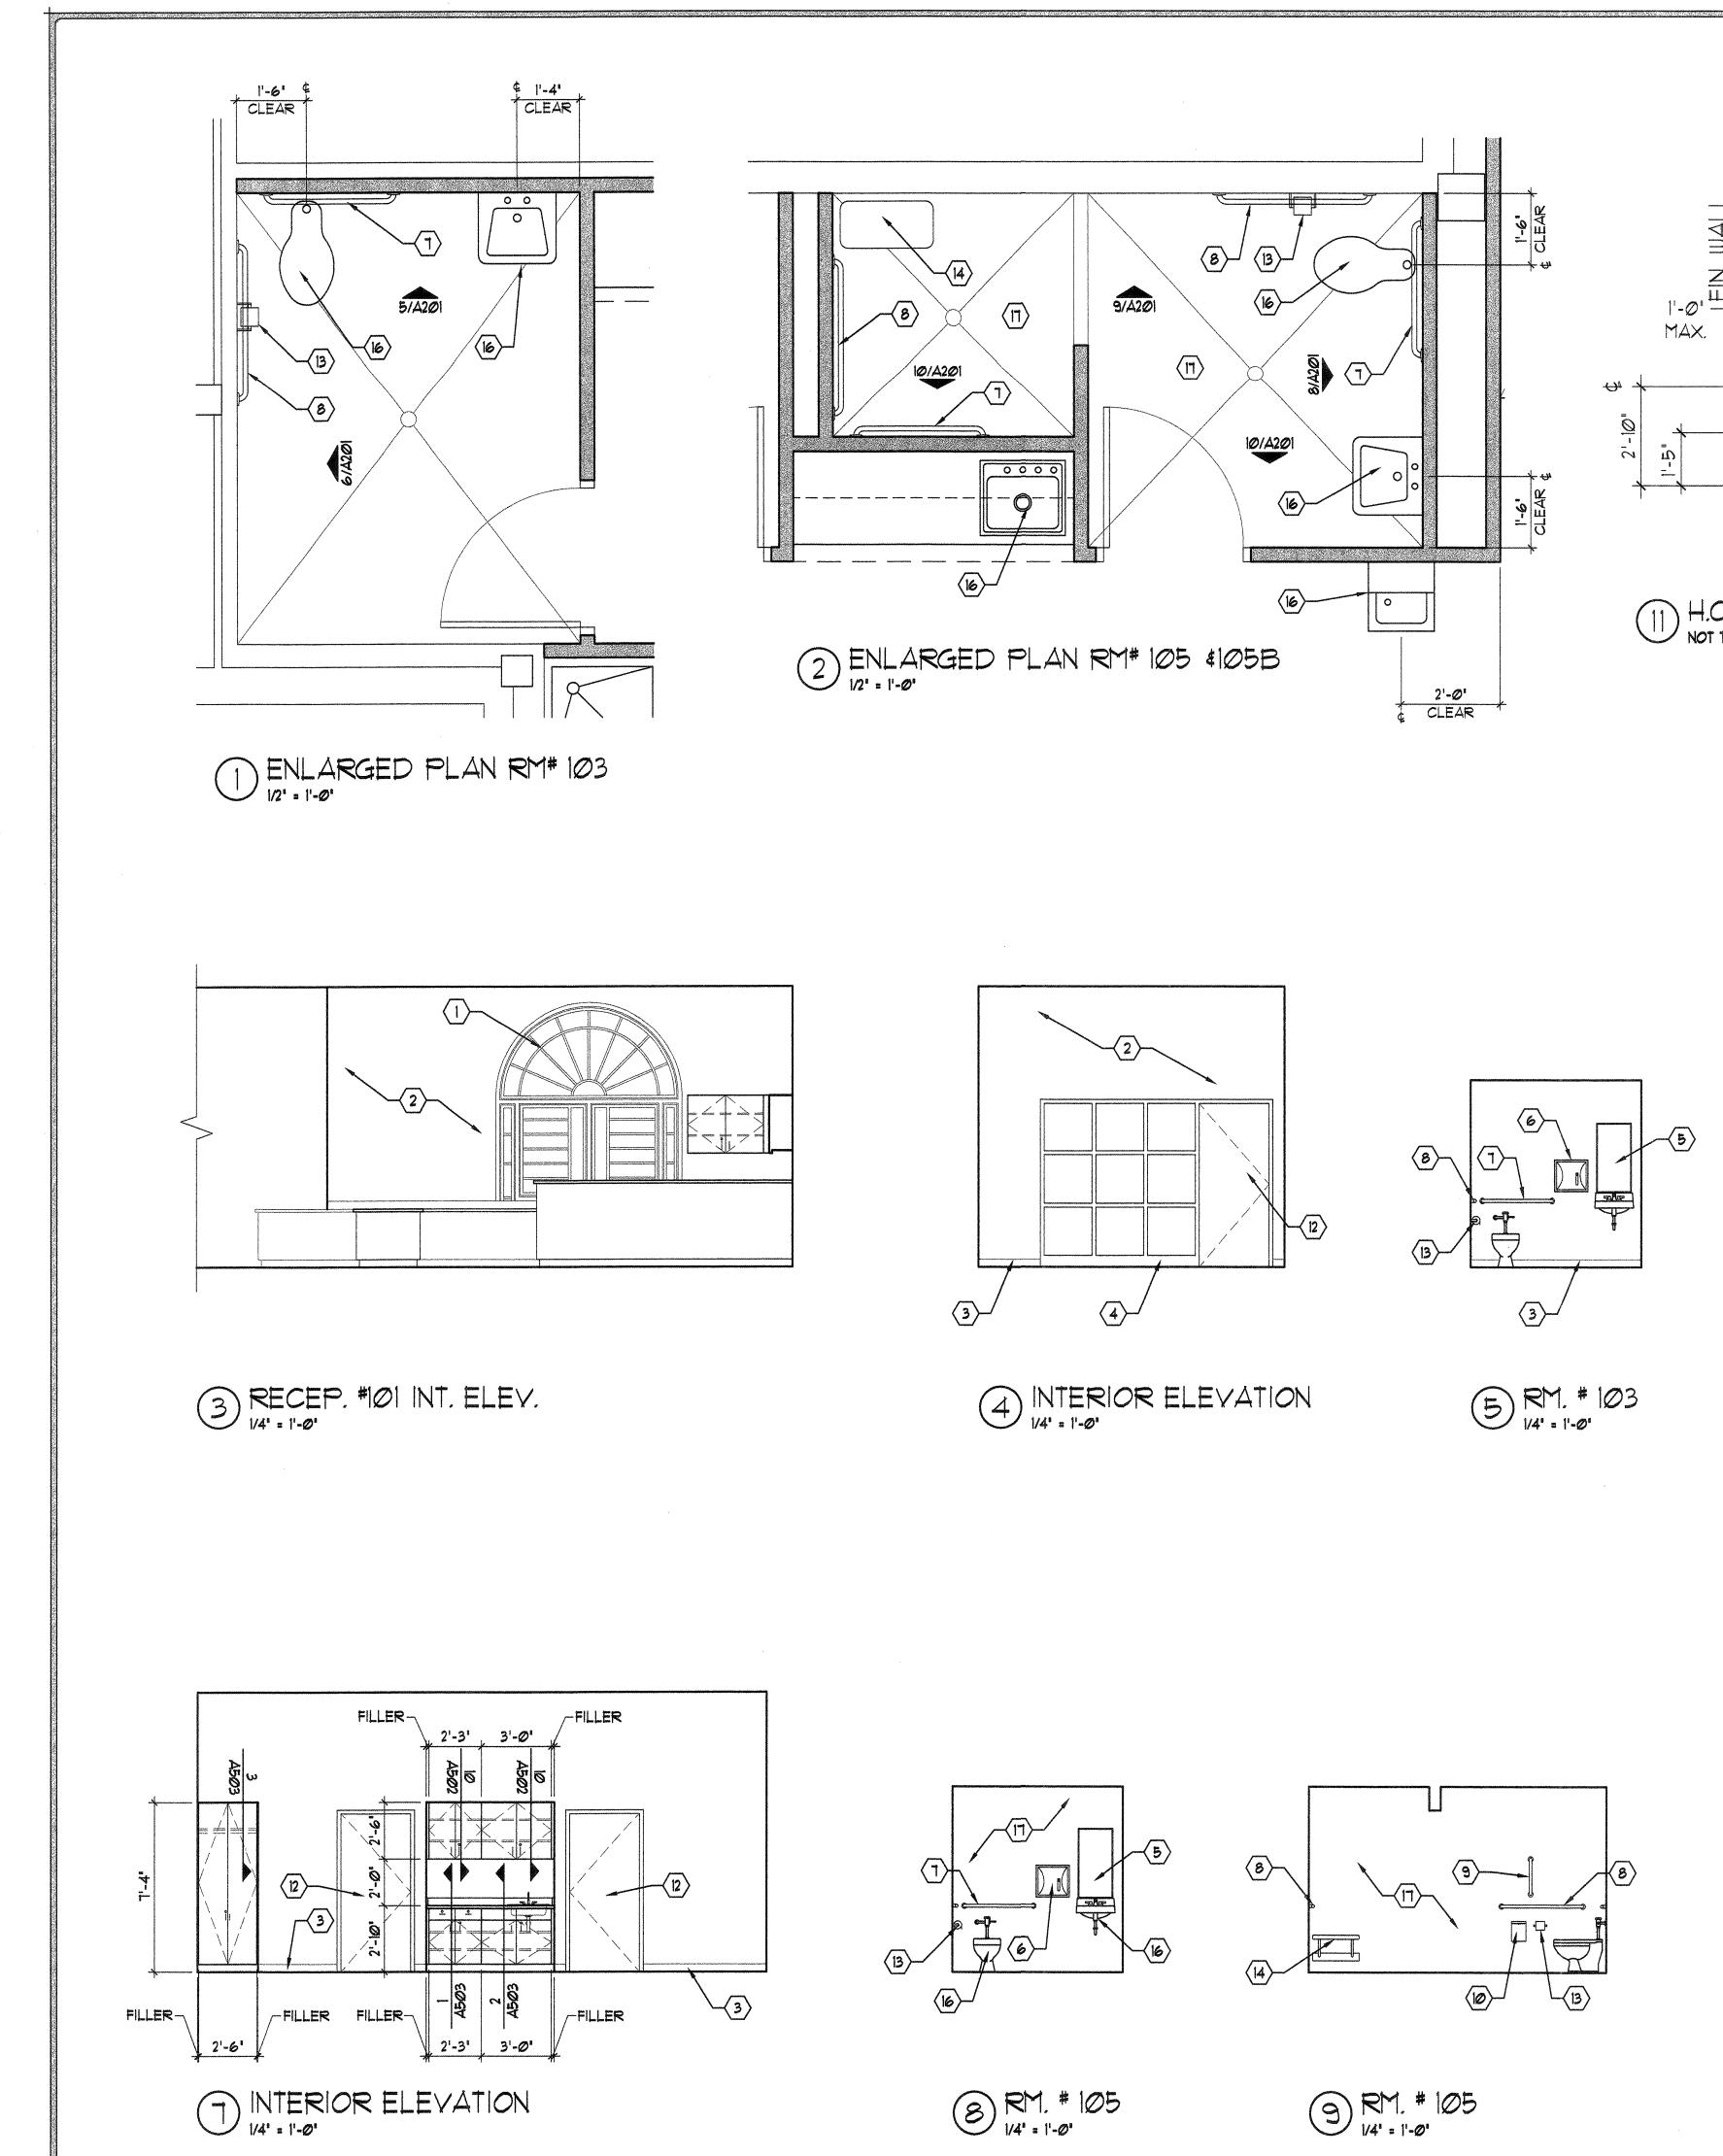


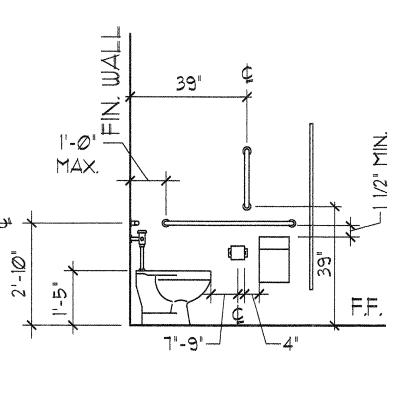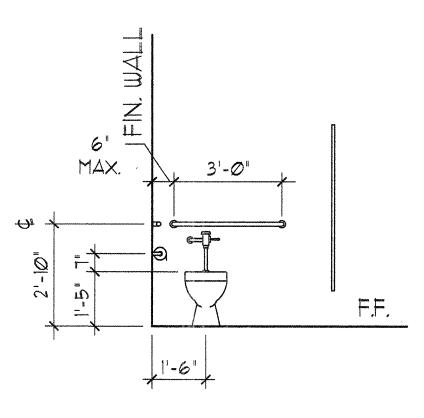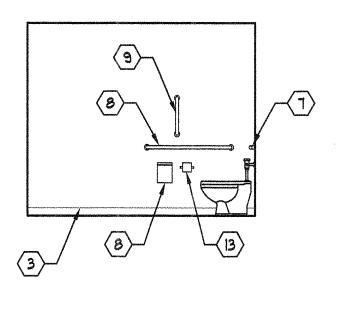
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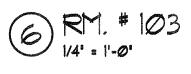
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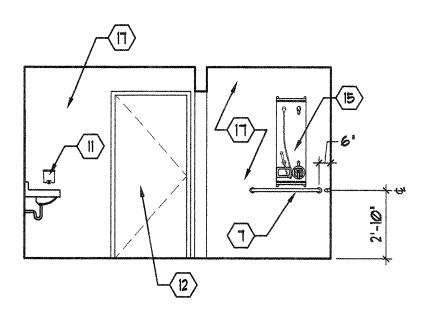













10 RM. # 105

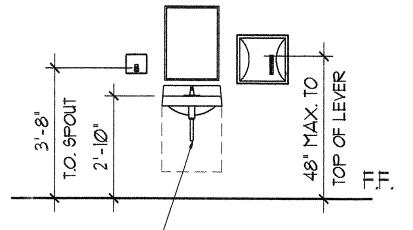


WRAP HOT & WASTE WATER PIPING WITH INSULATION


GENERAL NOTES:


- I. DOORS ON ALL CASEWORK STORAGE CABINETS TO RECEIVE LOCKS.
- 2. ALL EXPOSED CASEWORK SURFACES TO RECEIVE PLASTIC LAMINATE.
- 3. REFER TO H.C. MOUNTING HEIGHTS ON SHEET GOOS PRIOR TO INSTALLING FIXTURES & TOILET ACCESSORIES.

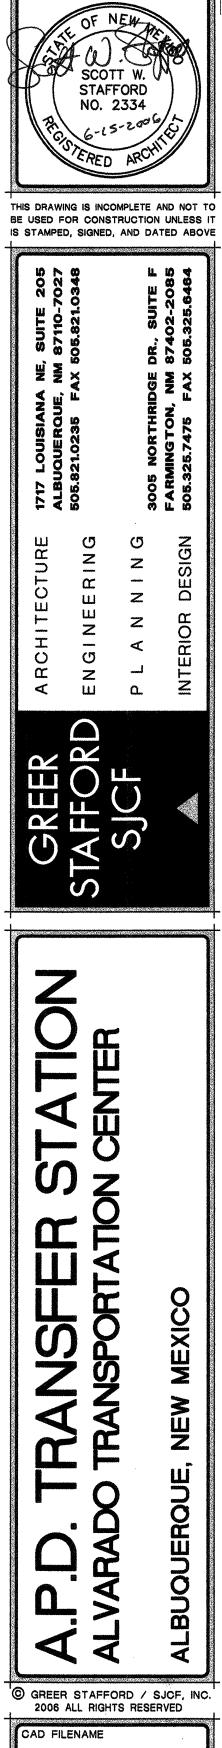
- \bigcirc KEYED NOTES:
- EXISTING WINDOW TO REMAIN. INSTALL NEW ONE-WAY GLASS, REF. TO 3/A5Ø1.
- 2. NEW FIBEROCK TYPE 'X' V.H.I. GYPSUM BOARD, PAINTED. REF. TO PARTITION TYPES.
- 3. NEW 1/8' THICK RUBBER COVED BASE, MANUFACTURED BY ROPPE.
- 4. NEW H.M. FRAME, PAINT.
- 5. NEW MIRROR 18'x36". BOBRICK MODEL "B-165 1836.
- 6. NEW SURFACE MOUNTED PAPER TOWEL DISPENSER. BOBRICK MODEL ***B-2860**
- 7. NEW 36', 1-1/2' DIA. S.S. GRAB BAR. BOBRICK MODEL "B-6206.
- 8. NEW 42', 1-1/2' DIA. S.S. GRAB BAR. BOBRICK MODEL *B-6206.
- 9. NEW 1-1/2" DIA. S.S. GRAB BAR, 18" LONG, MOUNT @ 39" AFF TO BOTTOM OF BAR AND 39' TO THE CENTERLINE OF BAR FROM REAR WALL. BOBRICK MODEL "B-6206.
- 10. NEW SURFACE MOUNTED SANITARY NAPKIN DISPOSAL, BOBRICK MODEL **B-270**.
- 11. NEW SURFACE MOUNTED SOAP DISPENSER. BOBRICK MODEL *B-4112.
- 12. NEW H.M. DOOR & FRAME, PAINT. REFER TO DOOR SCHEDULE.
- 13. NEW SURFACE MOUNTED TOILET TISSUE DISPENSER. BOBRICK MODEL **B-2730**.
- 14. NEW FOLDING SHOWER SEAT. BOBRICK MODEL *B-5191.
- 15. NEW SURFACE MOUNTED STAINLESS STEEL SHOWER & SHOWER WAND UNIT. REF. TO PLUMBING SHEETS.
- 16. NEW PLUMBING FIXTURE, REFER TO PLUMBING SHEETS.
- 17. FLEXIBLE EPOXY INTERIOR FINISH WALL & FLOOR SYSTEM SHALL BE "SANIFLEX" INTERIOR WALL SYSTEM, CONSISTING OF A WATER BASED EPOXY WALL COATING AS PRIMER, TWO COATS OF EPO-FLEX FLEXIBLE WALL EPOXY AS A MEMBRANE, WATER BASED EPOXY WALL COATING AS THE FIRST FINISH COAT AND POLY-COTE WALL COATING AS FINAL FINISH COAT. PROVIDE SLIP RESISTANT FINISH ON FLOORS.





| N:/2915/2915/24 PTC/TC A201 |
|--|
| SHEET TITLE ENLARGED PLANS AND INTERIOR ELEVATIONS |
| REVISION DATE |
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| DATE JUNE 15, 2006 |
| PROJECT NO. 2915,04 |
| DRAWING SHEET |
| A201 |

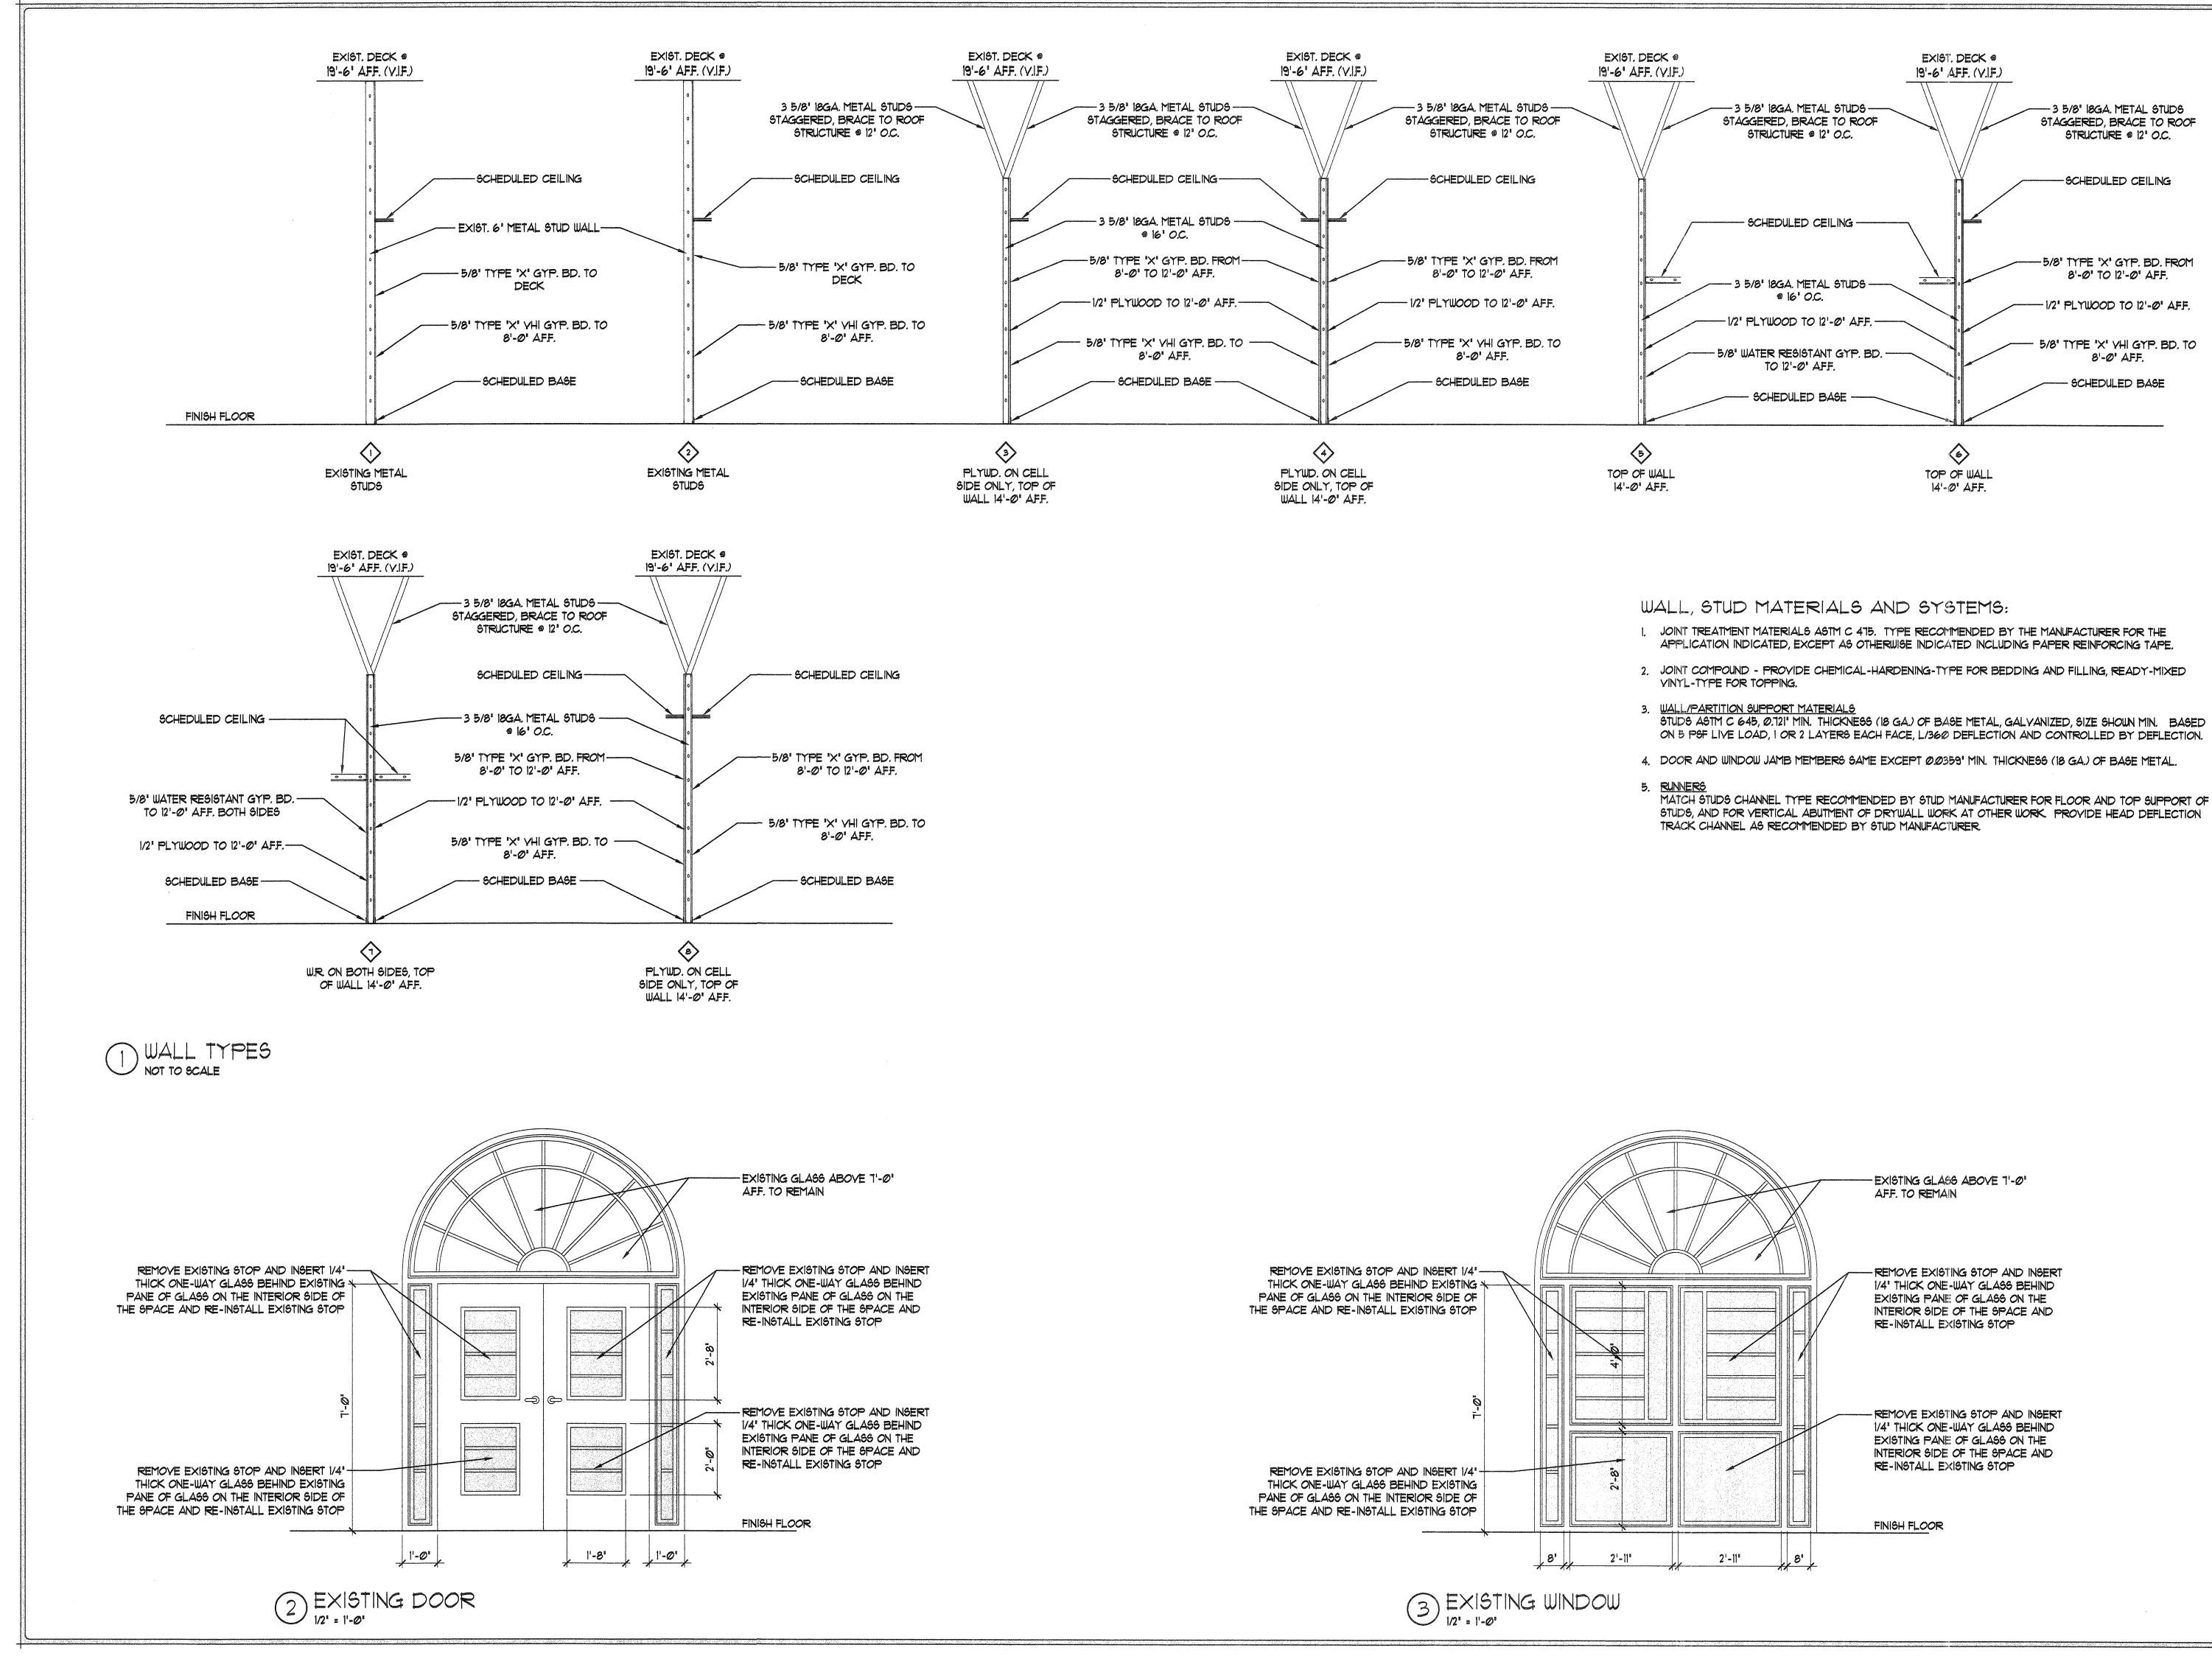

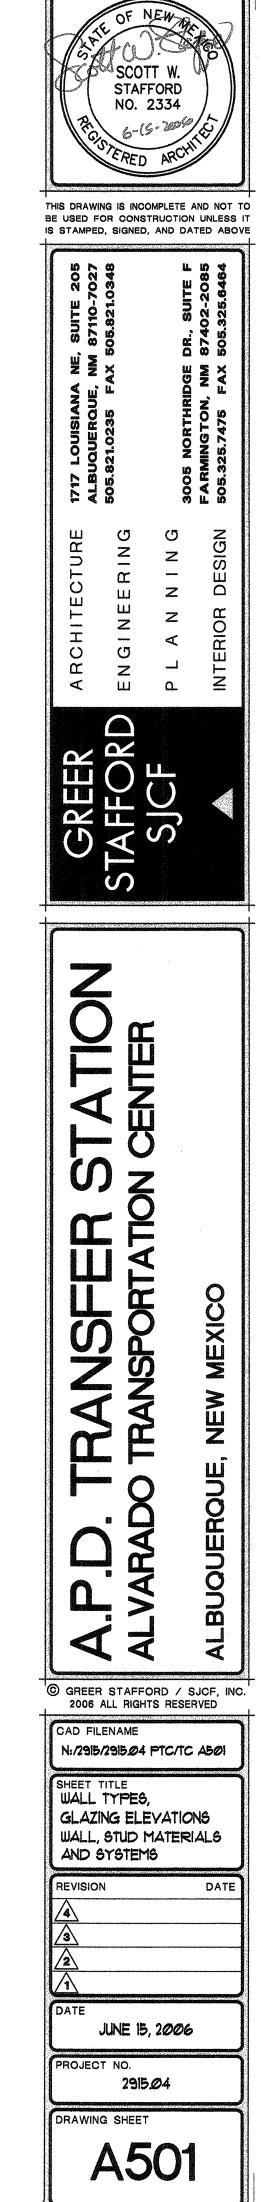

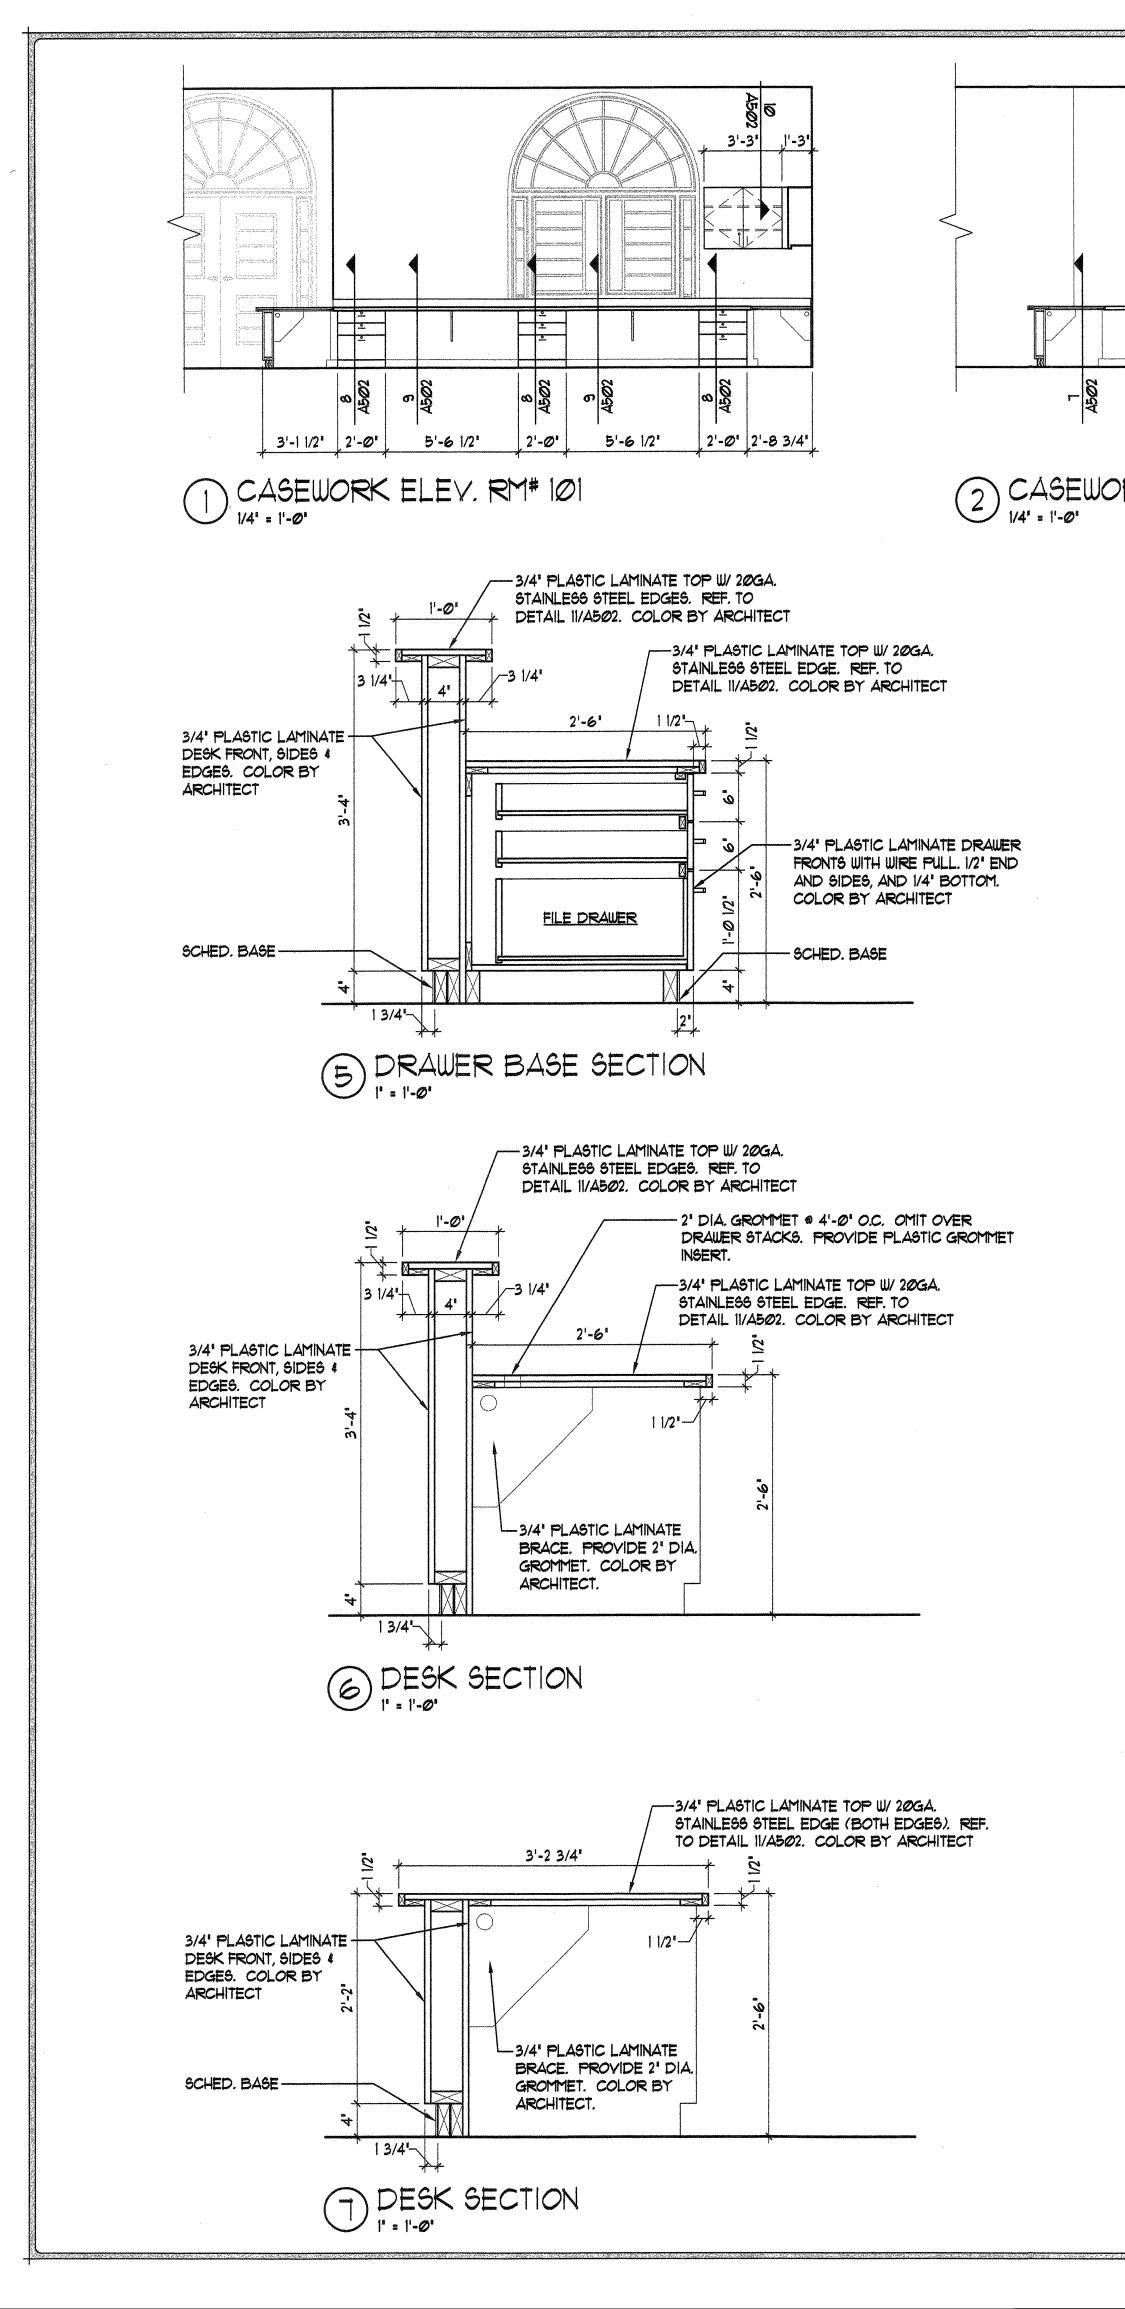

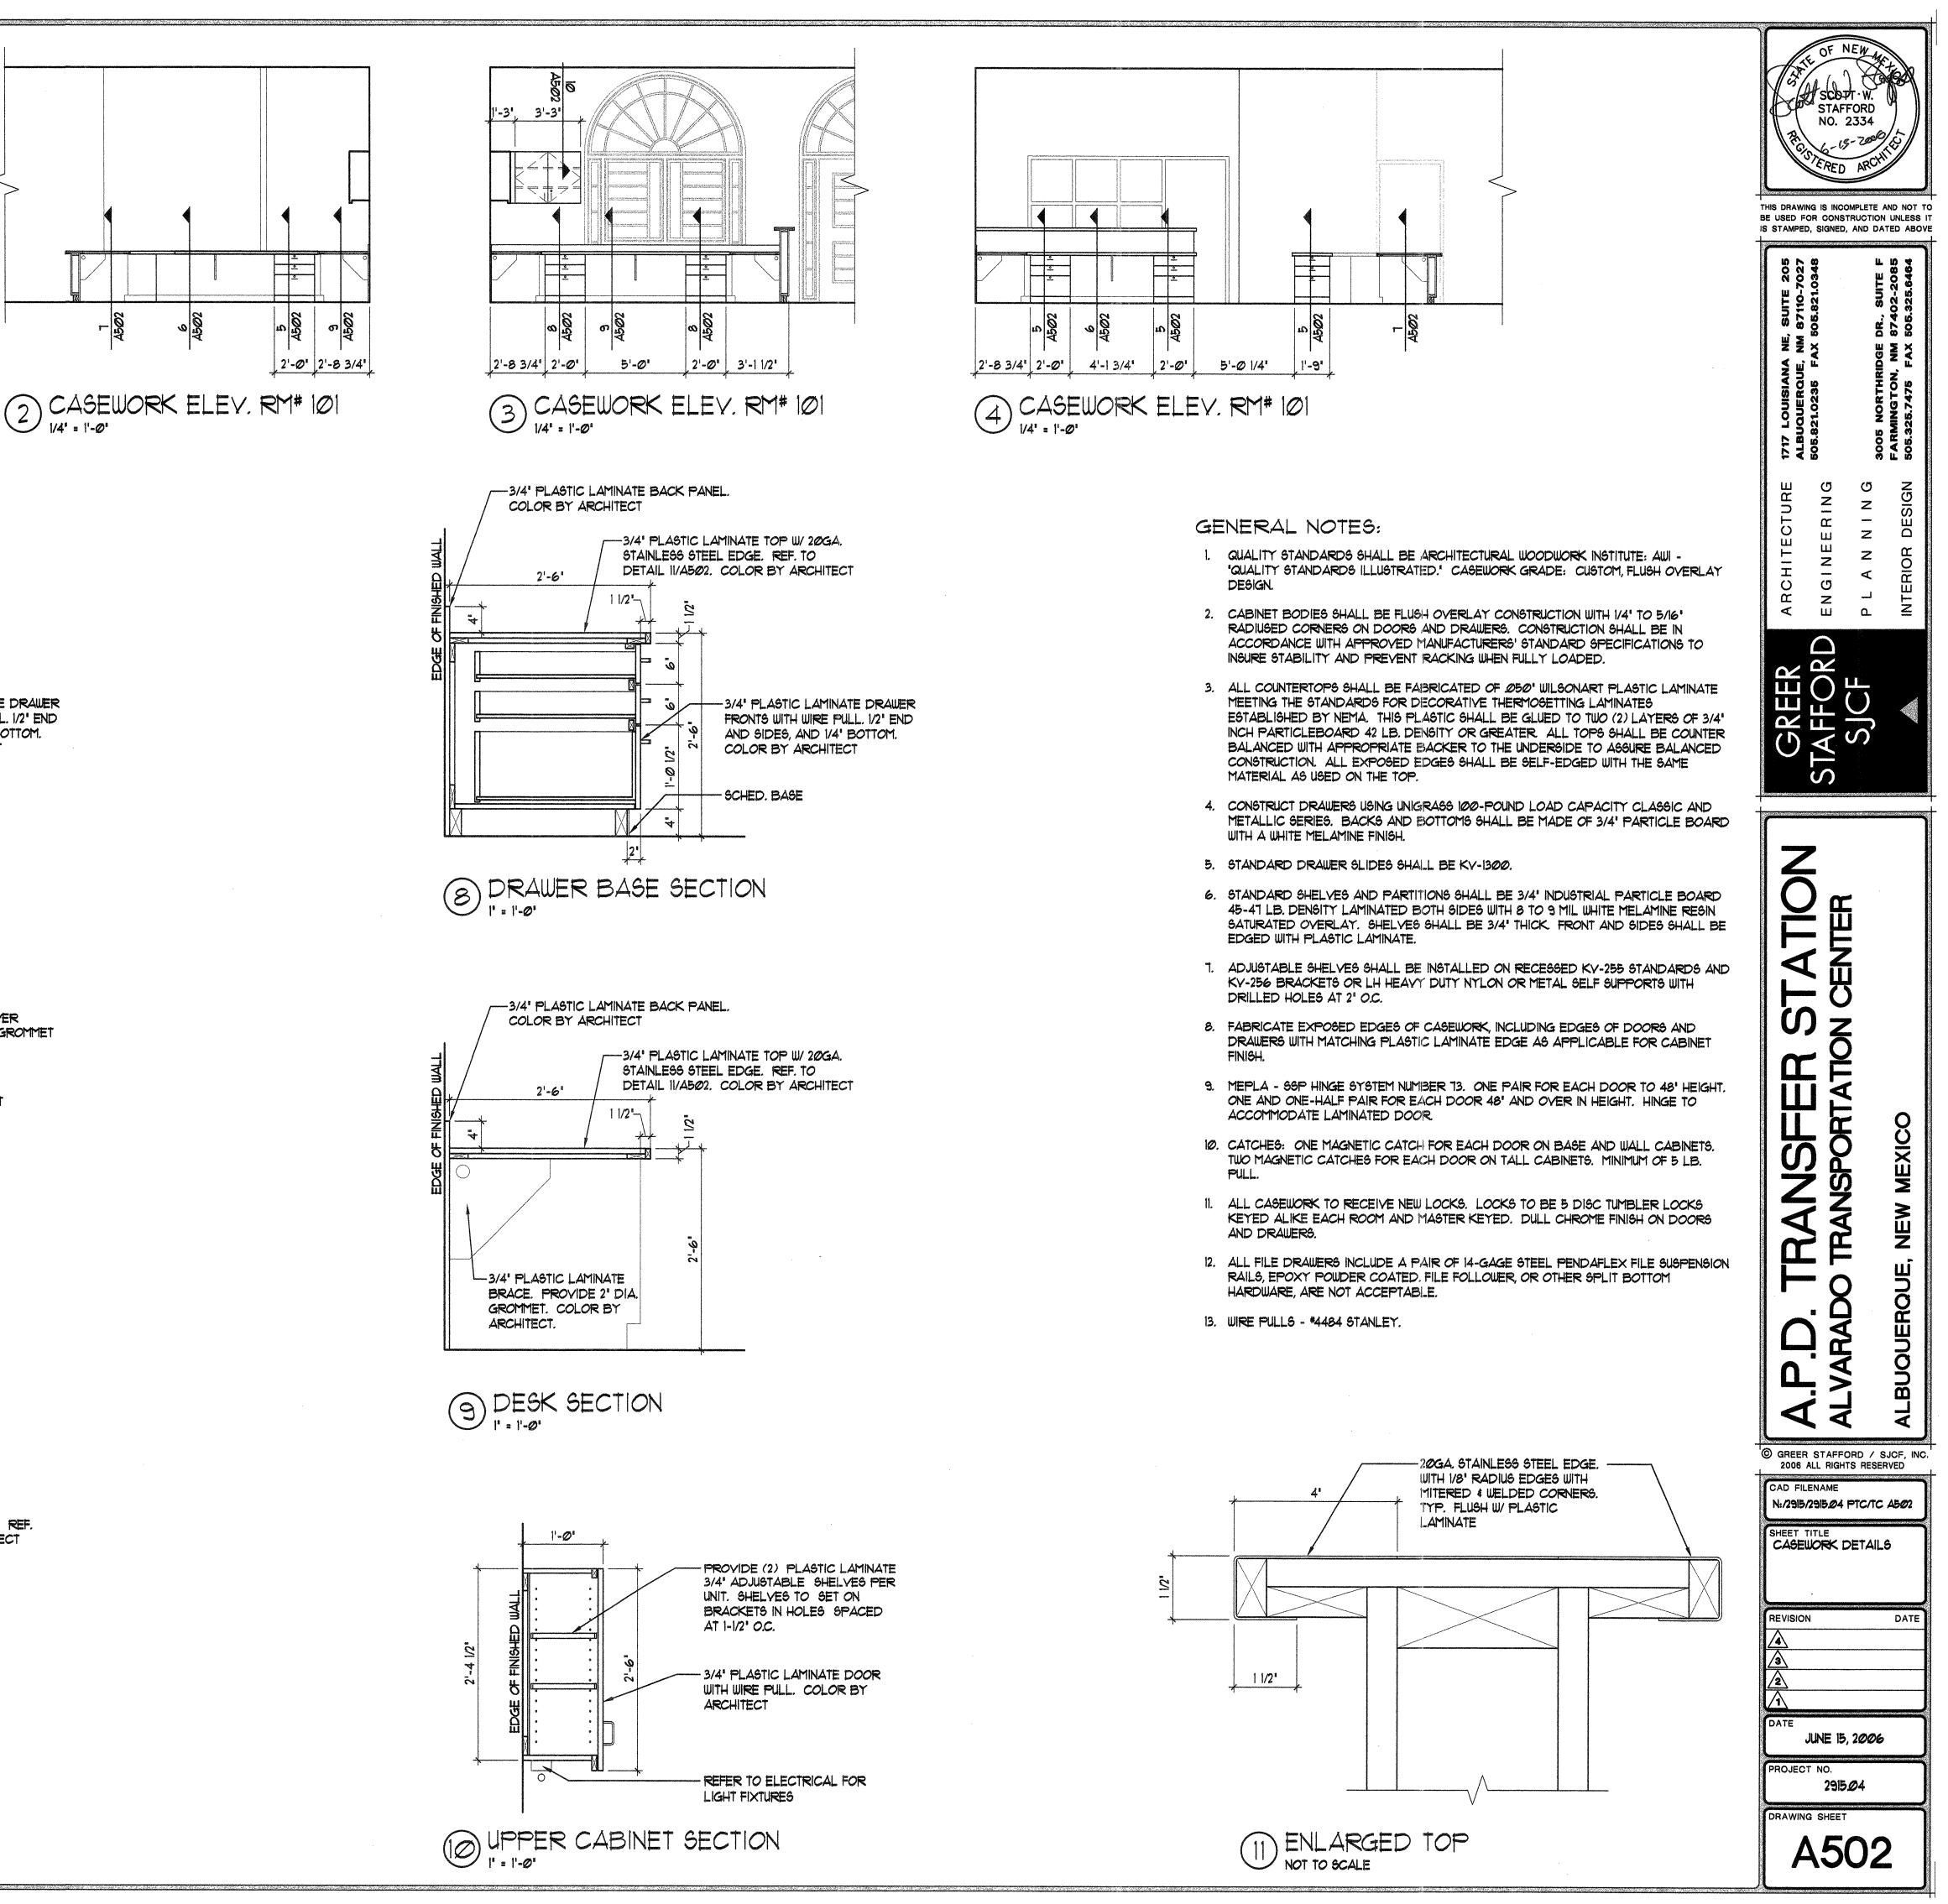


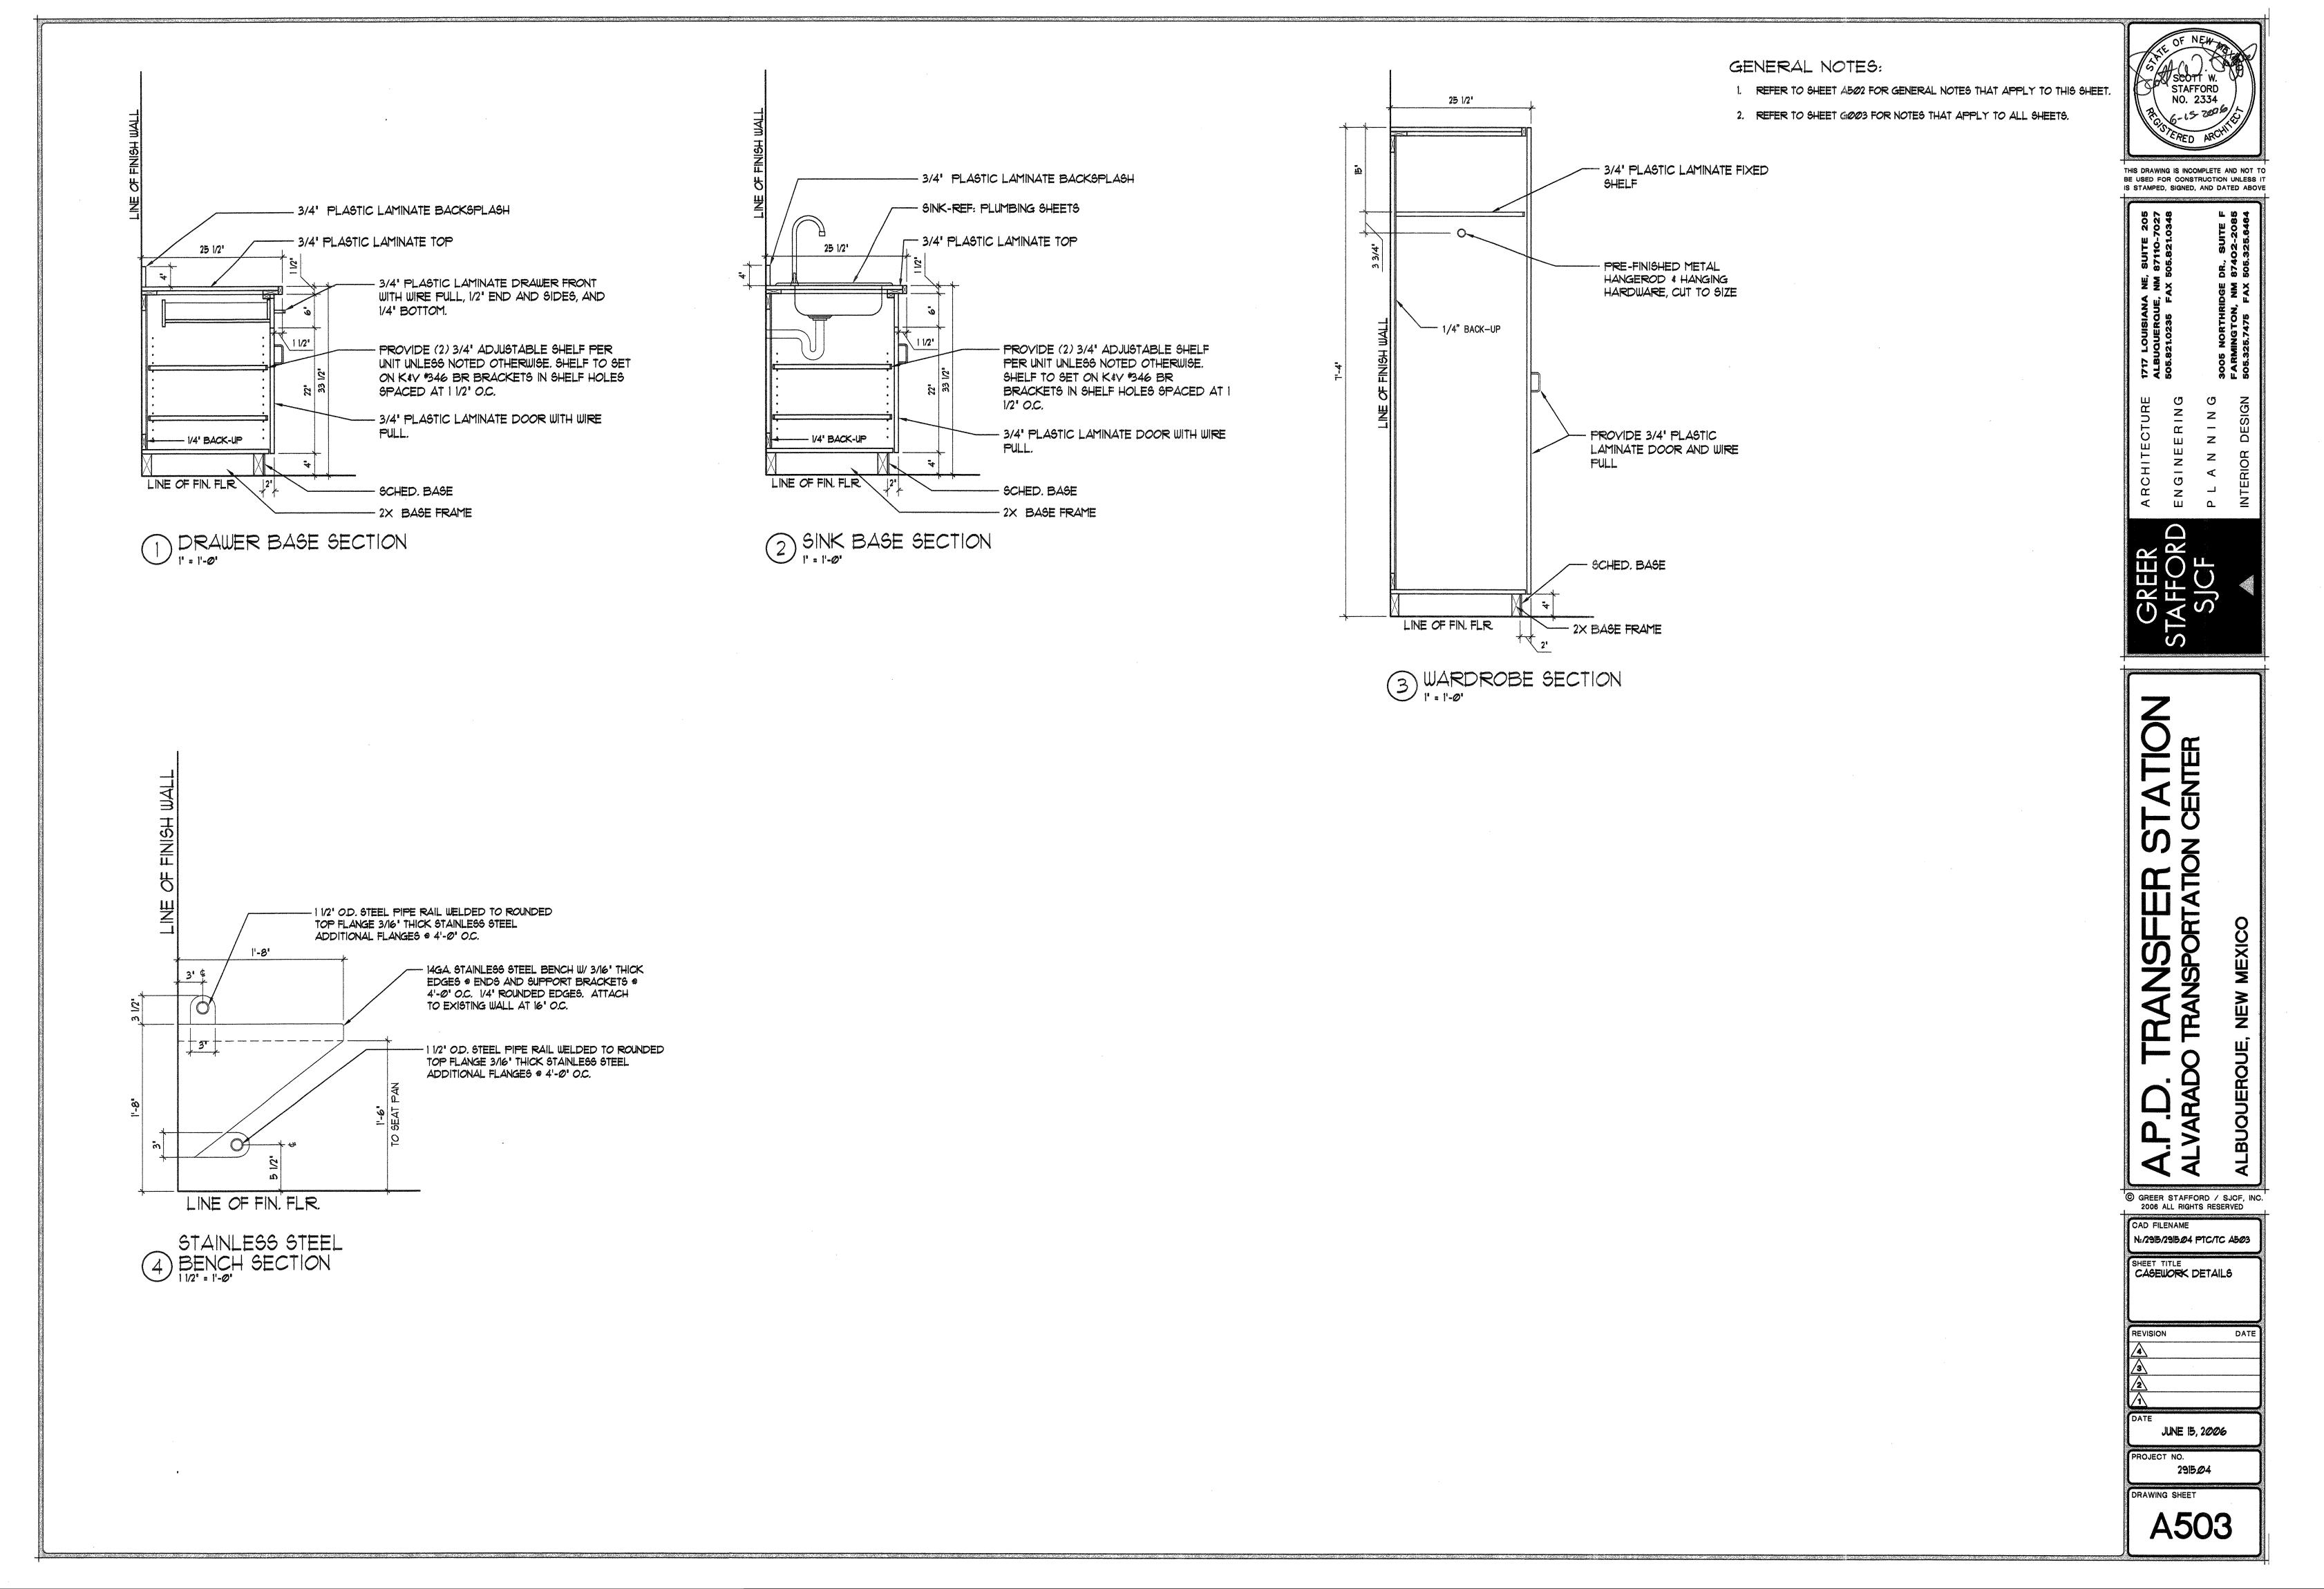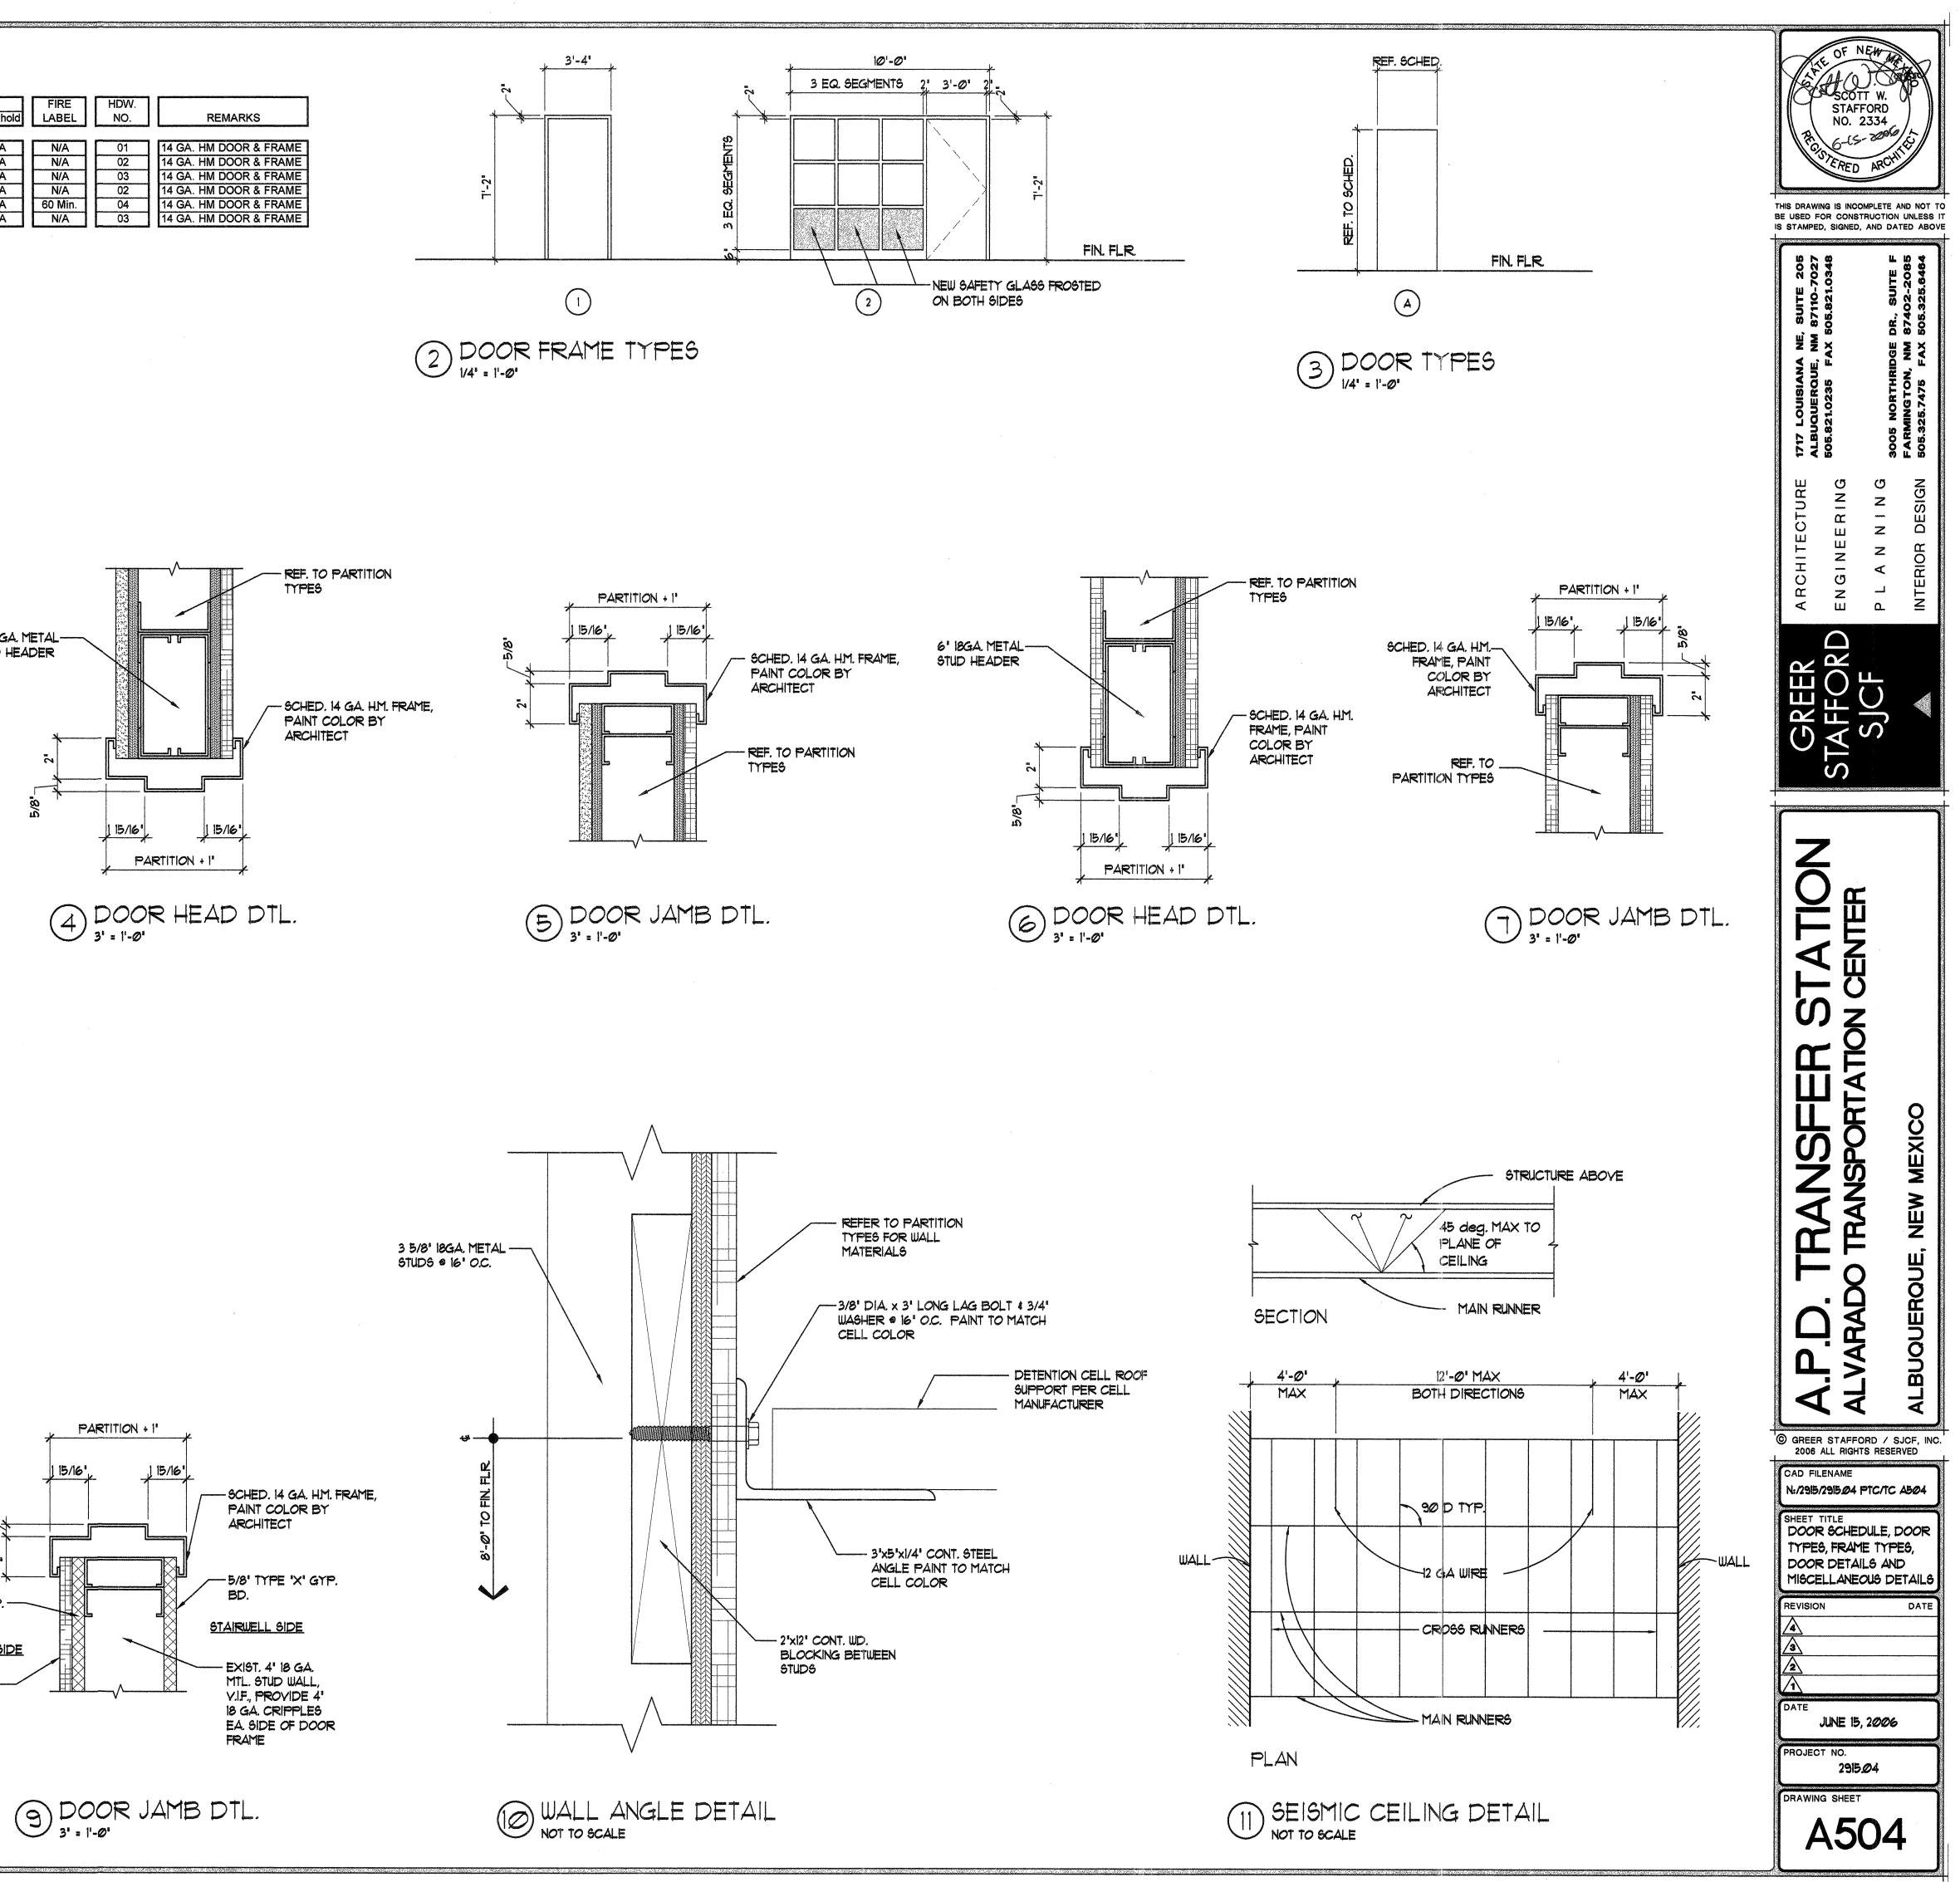

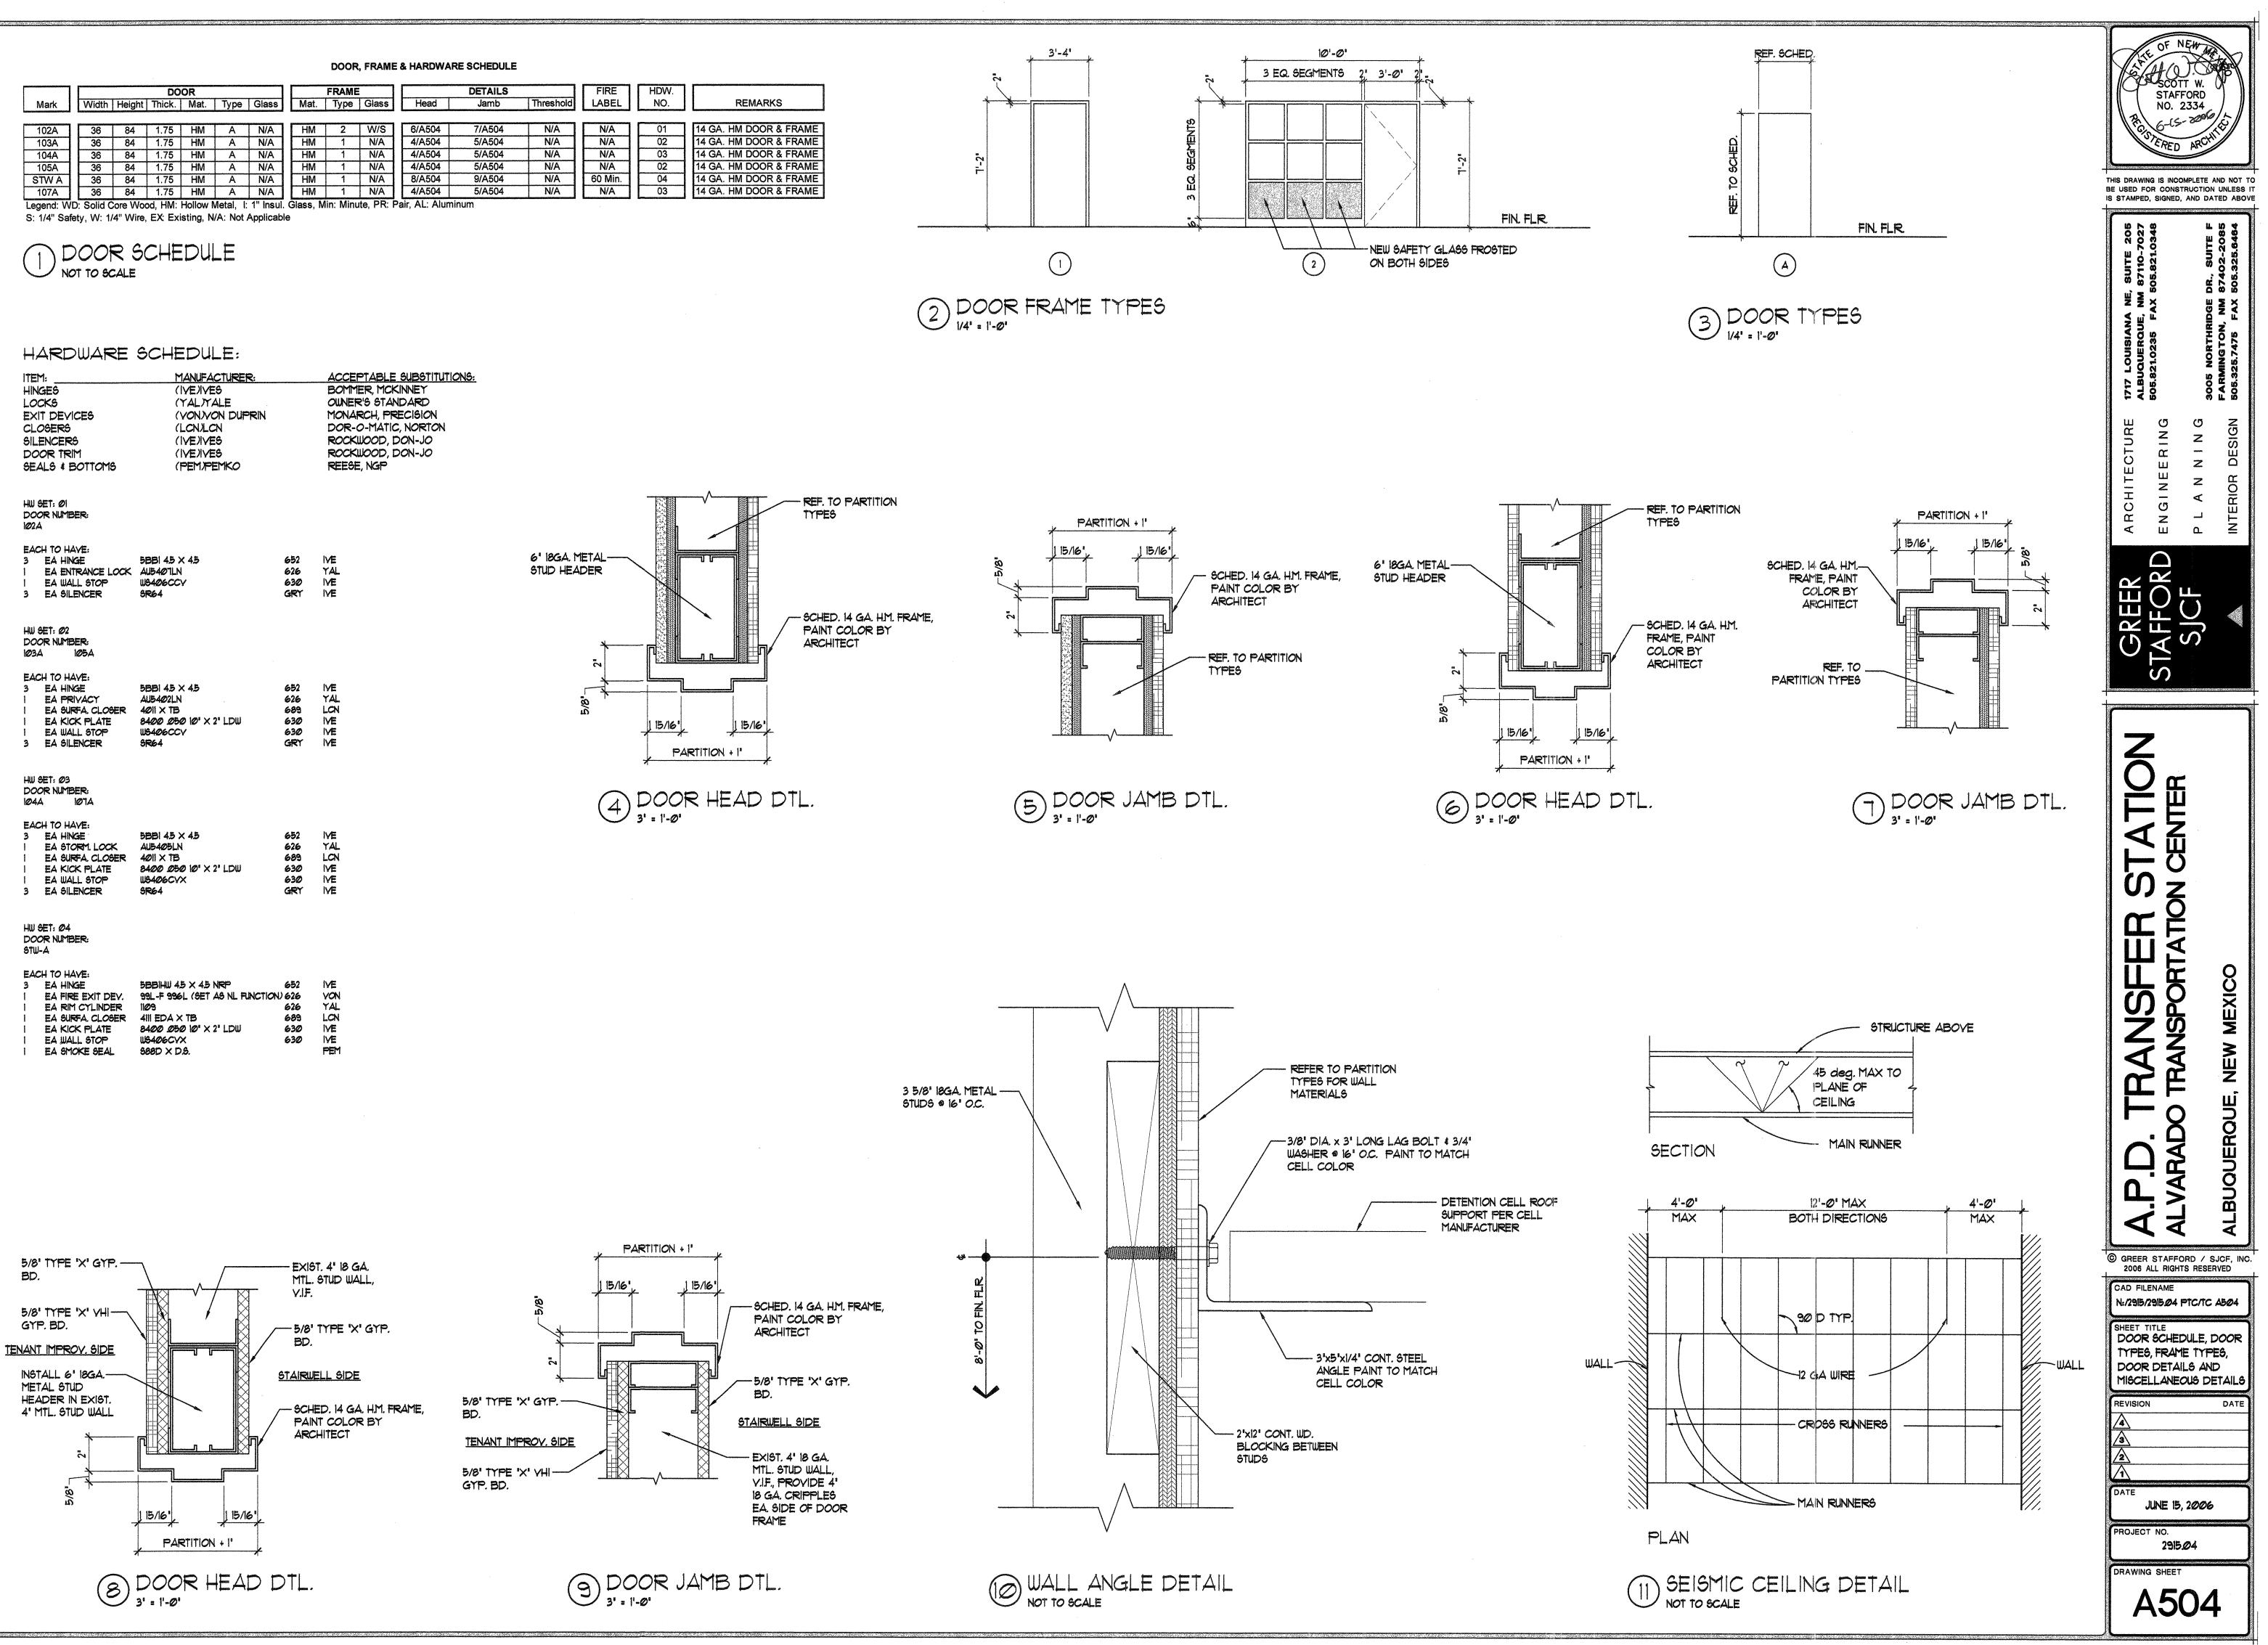
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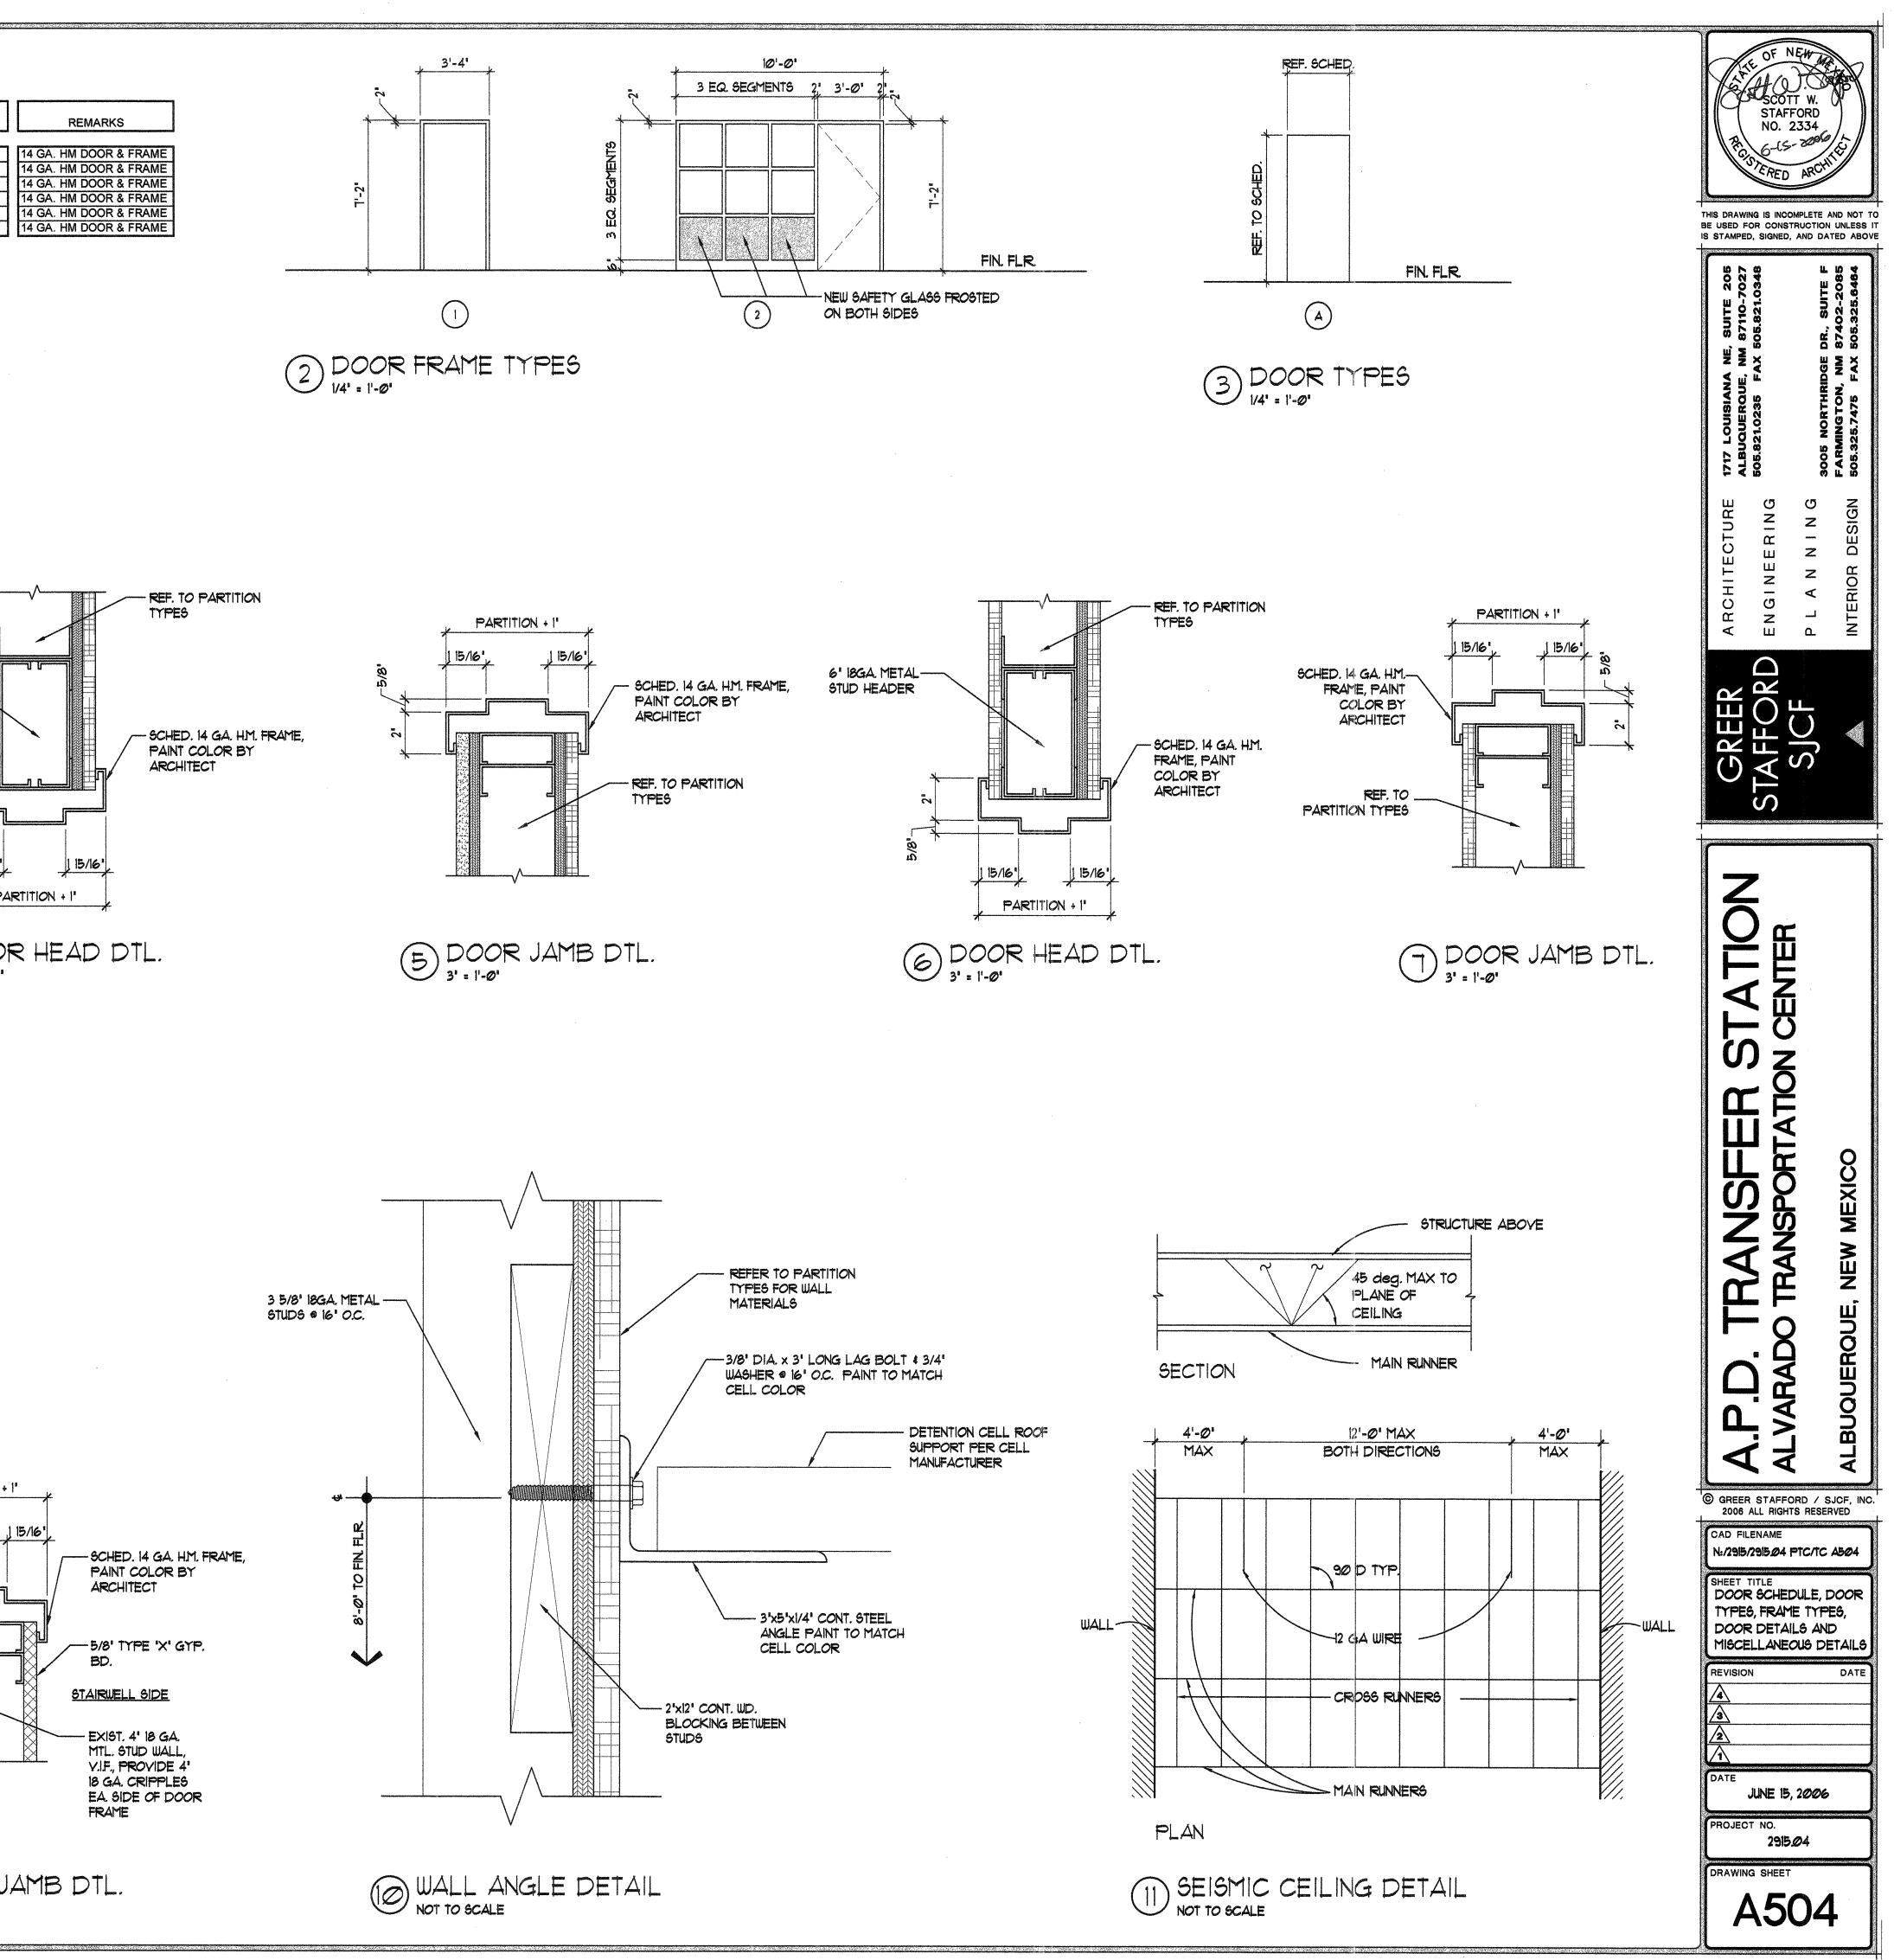
| | | | DO | OR | | | | FRAME | | | | DETAILS | | FIRE | HDW. |
|-------|-------|--------|--------|------|------|-------|------|-------|-------|------|----|---------|-----------|---------|------|
| Mark | Width | Height | Thick. | Mat. | Туре | Glass | Mat. | Туре | Glass | Hea | id | Jamb | Threshold | LABEL | NO. |
| 102A | 36 | 84 | 1.75 | HM | A | N/A | HM | 2 | W/S | 6/A5 | 04 | 7/A504 | N/A | N/A | 01 |
| 103A | 36 | 84 | 1.75 | HM | A | N/A | HM | 1 | N/A | 4/A5 | 04 | 5/A504 | N/A | N/A | 02 |
| 104A | 36 | 84 | 1.75 | HM | A | N/A | HM | 1 | N/A | 4/A5 | 04 | 5/A504 | N/A | N/A | 03 |
| 105A | 36 | 84 | 1.75 | HM | A | N/A | HM | 1 | N/A | 4/A5 | 04 | 5/A504 | N/A | N/A | 02 |
| STW A | 36 | 84 | 1.75 | HM | A | N/A | HM | 1 | N/A | 8/A5 | 04 | 9/A504 | N/A | 60 Min. | 04 |
| 107A | 36 | 84 | 1.75 | HM | A | N/A | HM | 1 | N/A | 4/A5 | 04 | 5/A504 | N/A | N/A | 03 |


| ITEM: | | MANUFACTURER: | | ACCEPTABLE SUBSTITUTIONS |
|-----------------|---------------------------------|---|---------|--------------------------|
| HINGE | 9 | (IVE)VES | | BOMMER, MCKINNEY |
| LOCK | 6 | (YAL)YALE | | OUNER'S STANDARD |
| • | DEVICES | (VON) VON DUPRIN | | MONARCH, PRECISION |
| CLOS | | (LCN)LCN | | DOR-O-MATIC, NORTON |
| | | · · · · · · · · · · · · · · · · · · · | | • |
| | CERS | (IVE)VES | | ROCKWOOD, DON-JO |
| DOOF | r trim | (IVE)IVES | | ROCKWOOD, DON-JO |
| SEALS | 3 & BOTTOMS | (PEM)PEMKO | | REESE, NGP |
| HW SET | : Ø1 | | | |
| DOOR | NUMBER: | | | |
| 102A | | | | |
| | TO HAVE: | | | |
| | A HINGE | 5881 4.5 × 4.5 | 652 | IVE |
| | A ENTRANCE LOCK | | 626 | YAL |
| | A WALL STOP | WS406CCV | 630 | |
| 3 E | 4 SILENCER | 9R64 | GRY | IVE |
| طەمەتتىكى ئىزۇر | . @2 | | | |
| HW SET | | | | |
| | NUMBER: 105A | | | |
| 105A | IUSA | | | |
| EACH . | TO HAVE: | | | |
| 3 E | A HINGE | 5881 45 × 45 | 652 | IVE |
| I E | A PRIVACY | AU5402LN | 626 | YAL |
| | A SURFA. CLOSER | 4011 × TB | 689 | Lan |
| | A KICK PLATE | 84 <i>00 .0</i> 50 10' x 2' LDW | 630 | IVE |
| | A WALL STOP | WS406CCY | 630 | IVE |
| | A SILENCER | 9R64 | GRY | IVE |
| | | | | |
| HW SET | | | | |
| | NUMBER: | | | |
| 1044 | IOTA | | | |
| EACH . | | | | |
| | 4 HINGE | 5881 45 × 45 | 652 | I∕E |
| | A STORM. LOCK | | 626 | YAL |
| | 4 SURFA CLOSER | | 689 | LCN |
| | A KICK PLATE | 8400 050 10' X 2' LDW | 630 | |
| | A WALL STOP | | 630 | |
| - | A SILENCER | SR64 | GRY | |
| اشار می | | ي همه الم | and 1.4 | ··· ,# |
| HW SET | : Ø4 | | | |
| | NUMBER: | | | |
| STW-A | Ignergang Tr | | | |
| EVU | TO HAVE: | | | |
| | A HINGE | 5881HW 45 × 45 NRP | 652 | I∕∕E |
| | A FIRE EXIT DEV. | | | VON |
| | | | 626 | YAL |
| | A RIM CYLINDER | | 689 | LON |
| ۱ ۲ | 4 SURFA. CLOSER 4 KICK PLATE | 4111 EDA X TB 84 <i>00_0</i> 50 10' X 2' LDW | 630 | IVE |
| 4 daw | A 16 IF 16 1997 A 1997 | | 6220 | IYE |
| | | | | |
| I E | A WALL STOP A SMOKE SEAL | W3406CVX S88D X D.9. | 630 | IVE PEM |










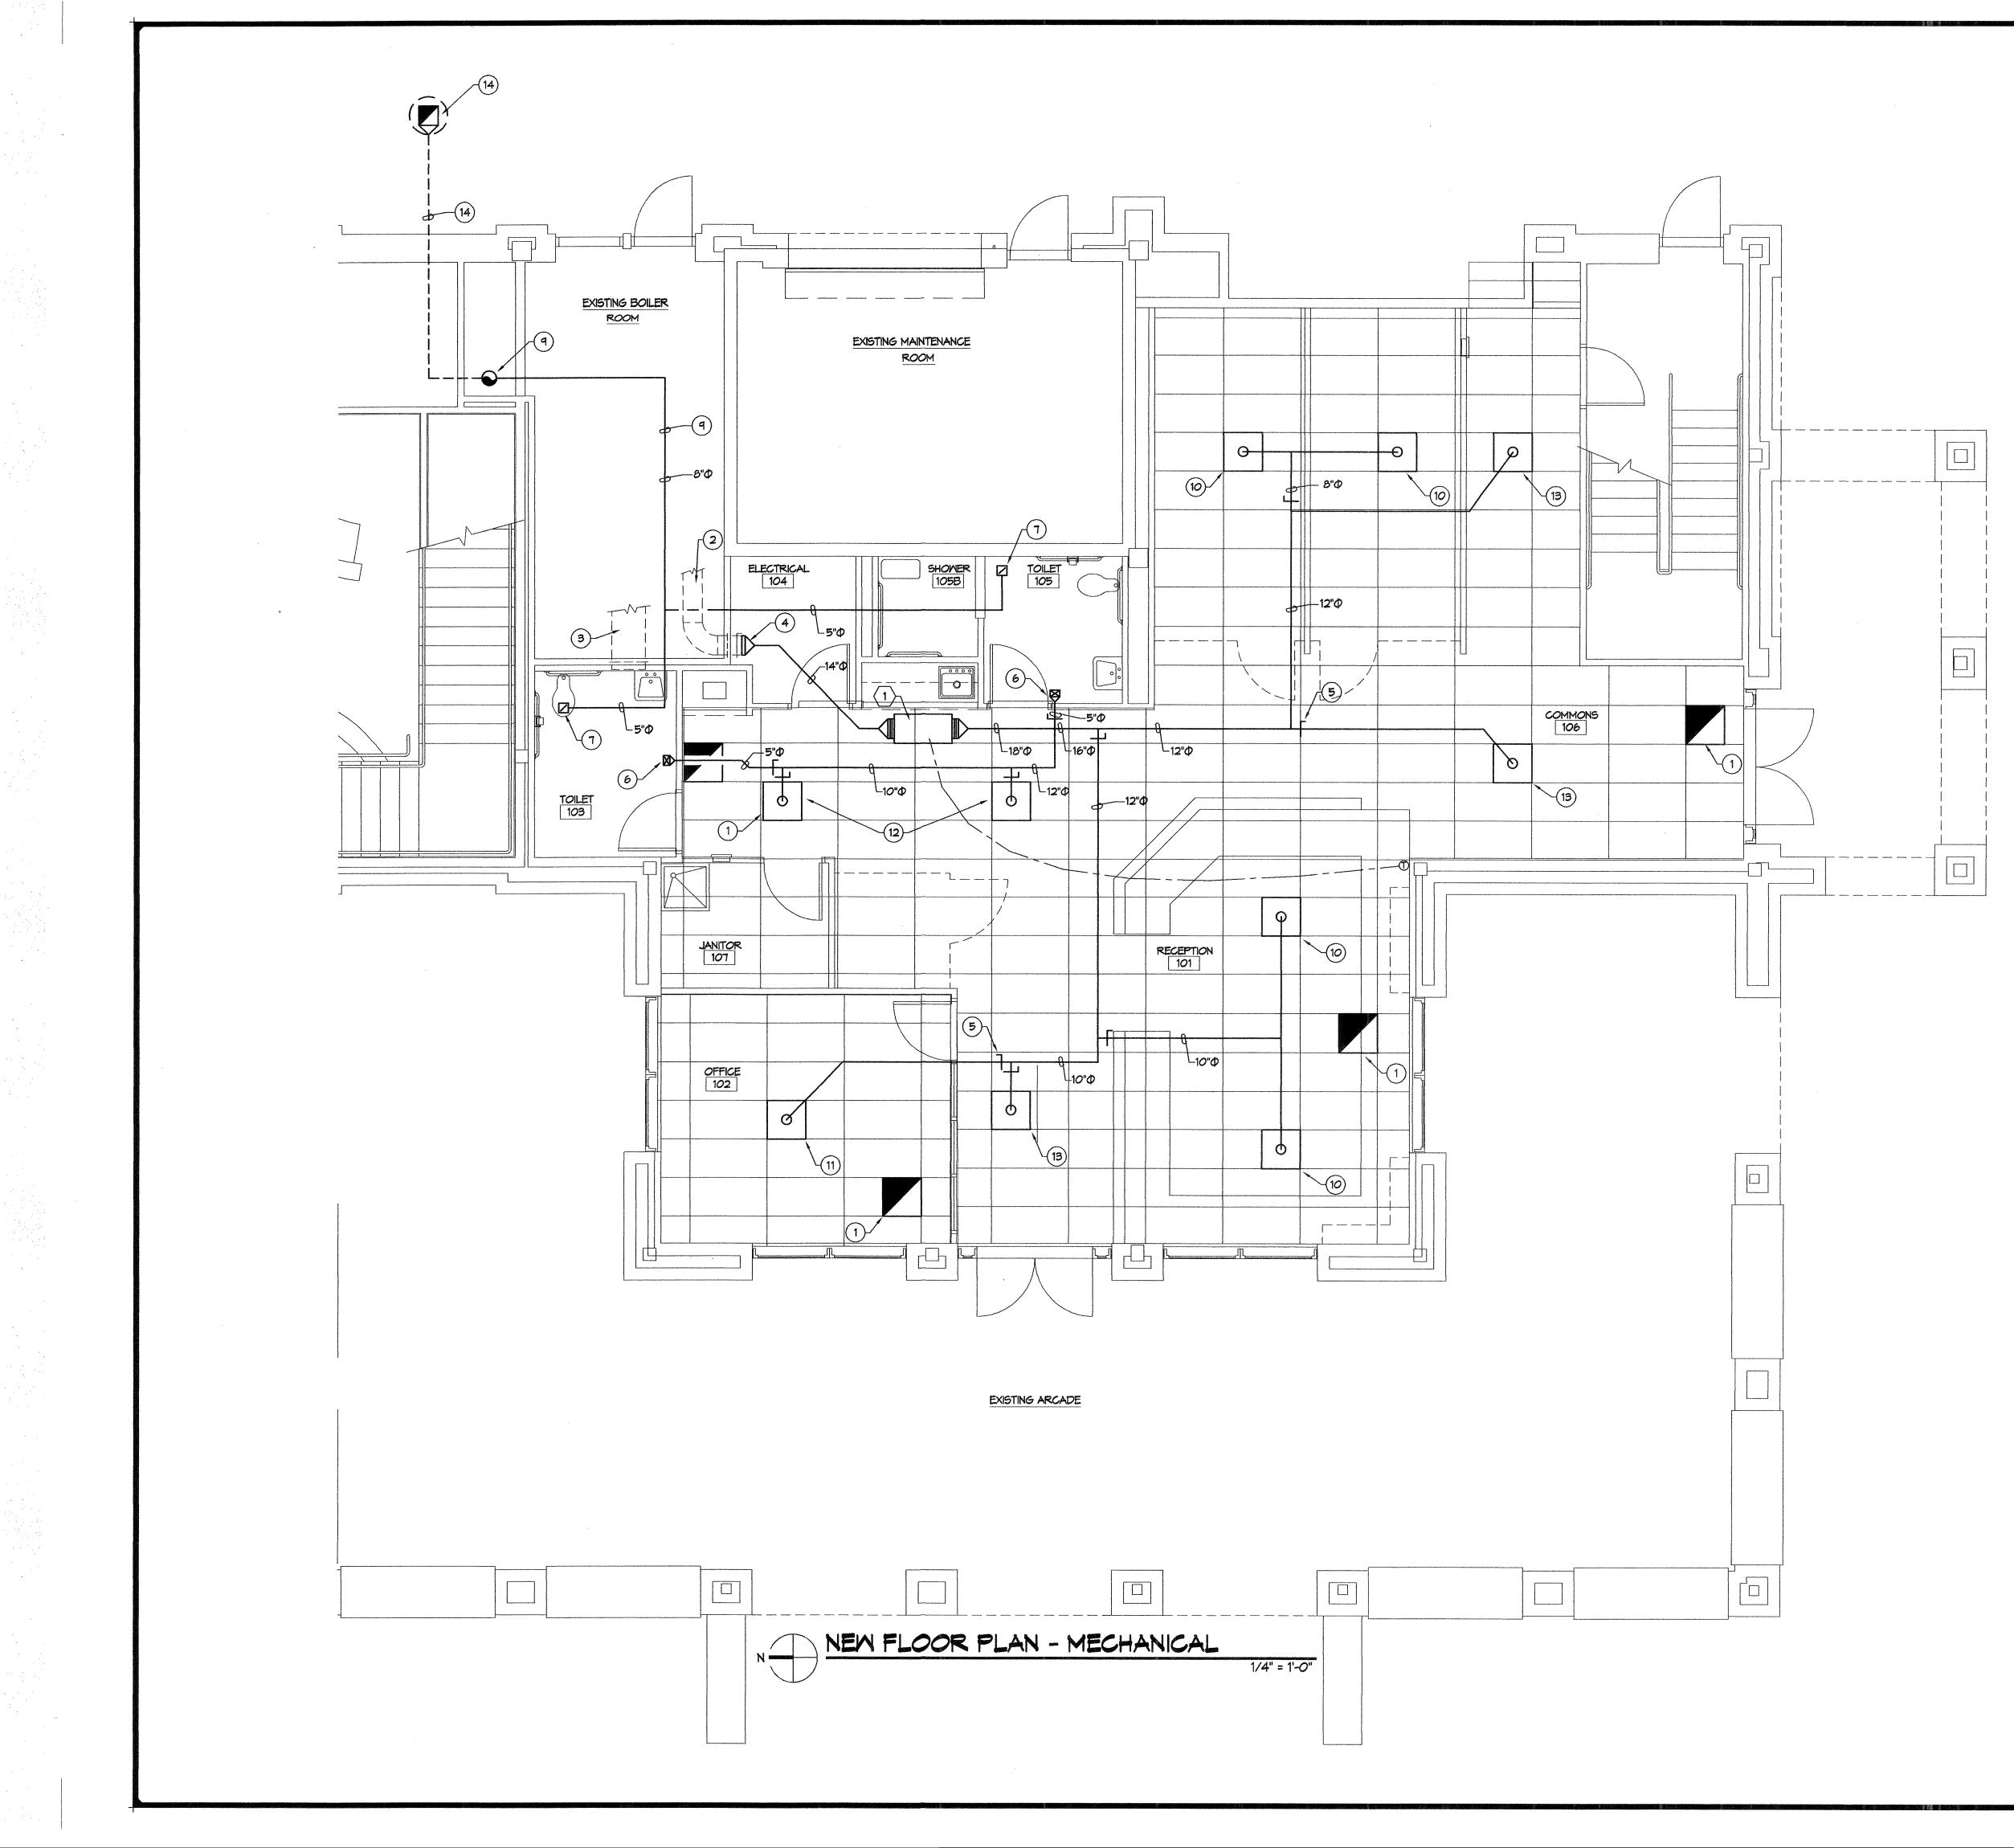

KEYED NOTES:

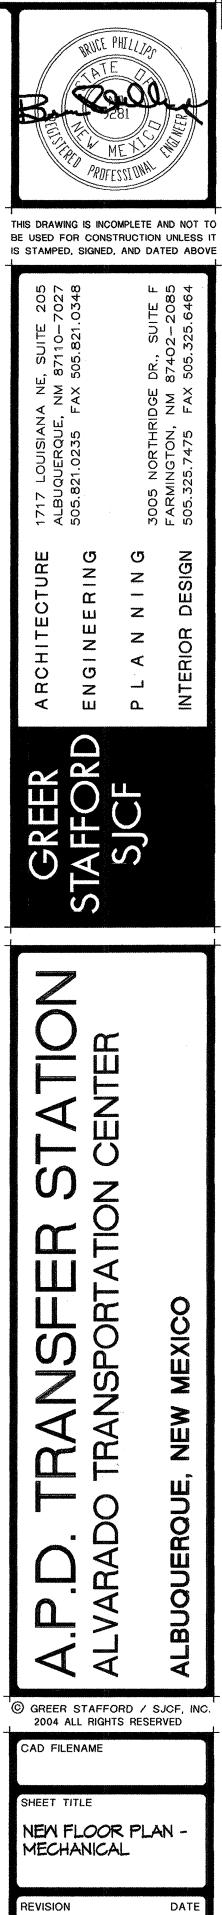- 1 (RAR) 24"x24".
- (2) EXISTING 14" ϕ SUPPLY DUCT STUB THRU WALL WITH FIRE/SMOKE DAMPER.
- (3) EXISTING 20"X20" RETURN AIR DUCT STUB THRU WALL WITH FIRE/SMOKE DAMPER.
- (4) CONNECT NEW 14" ϕ duct to existing 14" ϕ duct. Verify exact size in Field. It is possible it is 16" ϕ , if so run 16" ϕ to $\langle 1 \rangle$.
- 5 VOLUME DAMPER, TYPICAL.
- 6 (SR) 6"X4", 75 CFM.
- (7) (ER) 6"x6", 100 CFM, 5" (0 BRANCH DUCT.
- 8 NOT USED.
- (9) 8"O EXHAUST DUCT RISE UP IN EXISTING CHASE TO SECOND FLOOR. CONTRACTOR TO VERIFY BEST DUCT ROUTING FROM REGISTERS, THRU MECH. ROOM AND UP IN CHASE IN FIELD.
- (10) (CD) 24"х24", 8"Ф NECK, 200 CFM.
- (1) (CD) 24"X24", 8"(D) NECK, 225 CFM.
- (12) (CD) 24"x24", 10"Φ NECK, 325 CFM.
- (13) (CD) 24"X24", 8"O NECK, 100 CFM.
- (14) DASHED LINES INDICATE 8" ϕ EXHAUST DUCT OFFSETTING IN SECOND FLOOR CEILING, AND RISE UP THRU ROOF WITH 8"X8" TO EXHAUST FAN $\langle 2 \rangle$. CONTRACTOR TO VERIFY BEST ROUTE IN FIELD.





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| ROJECT NO | • | |

2915.04

DRAWING SHEET

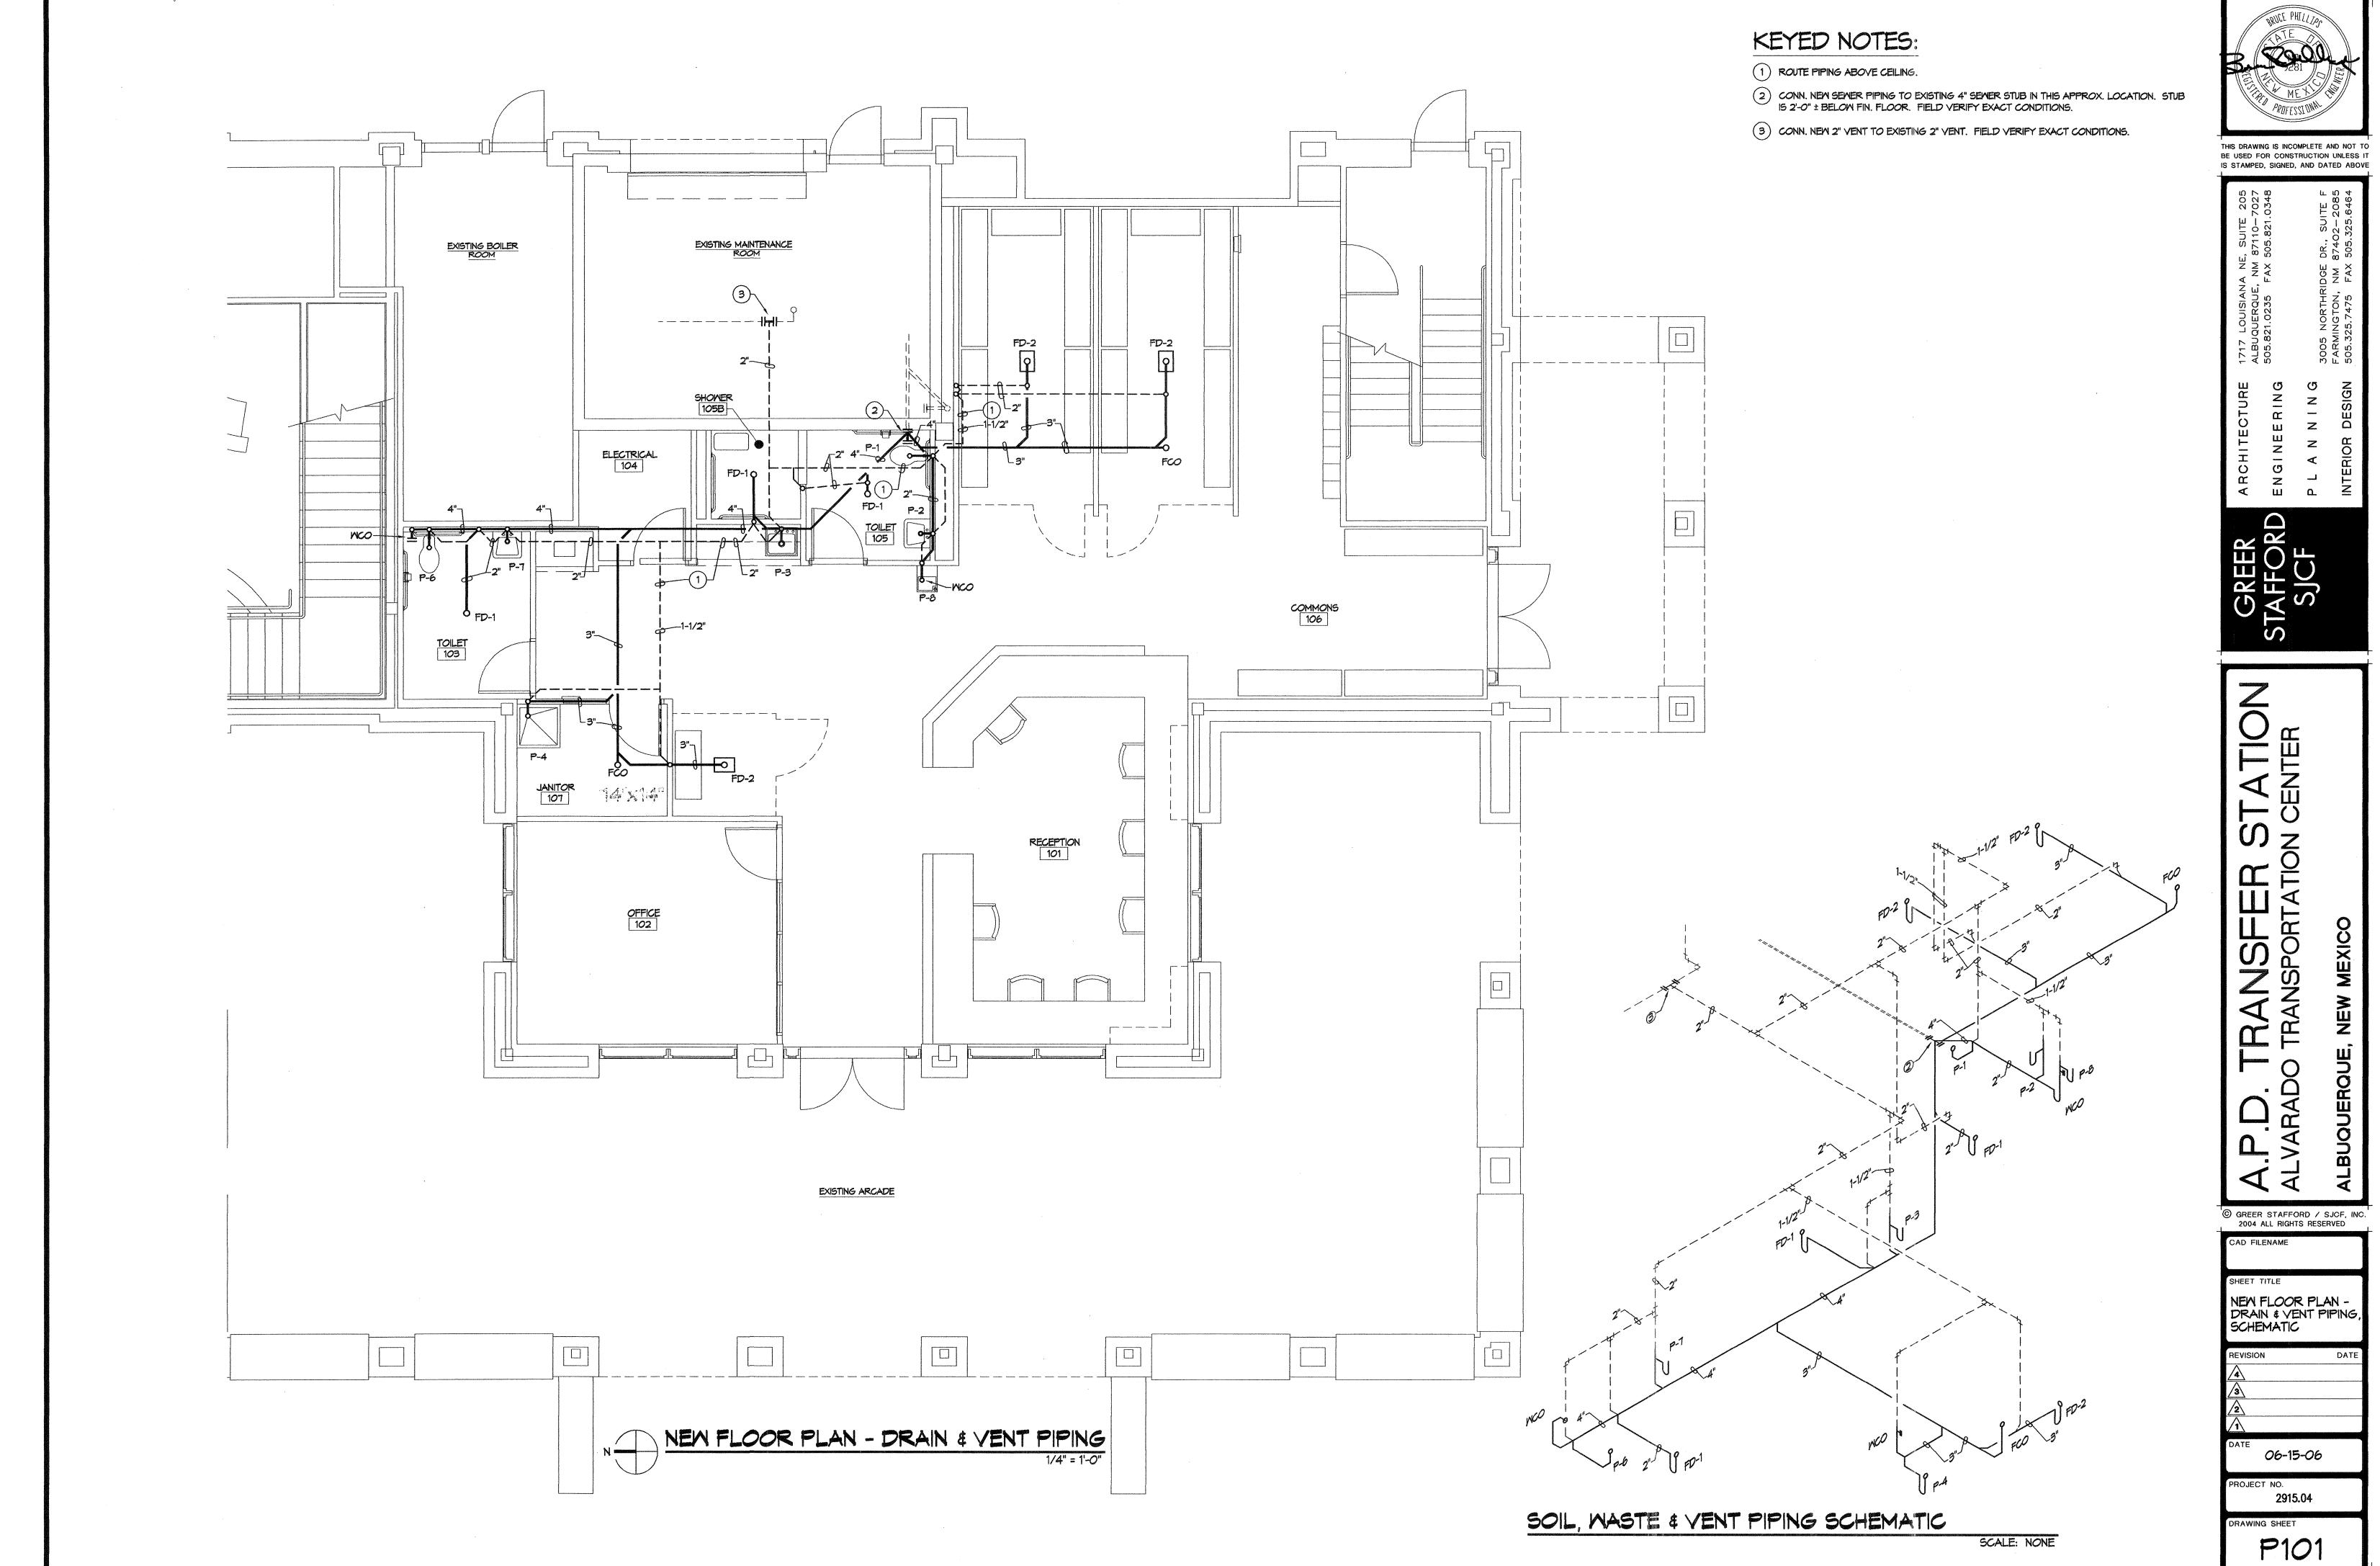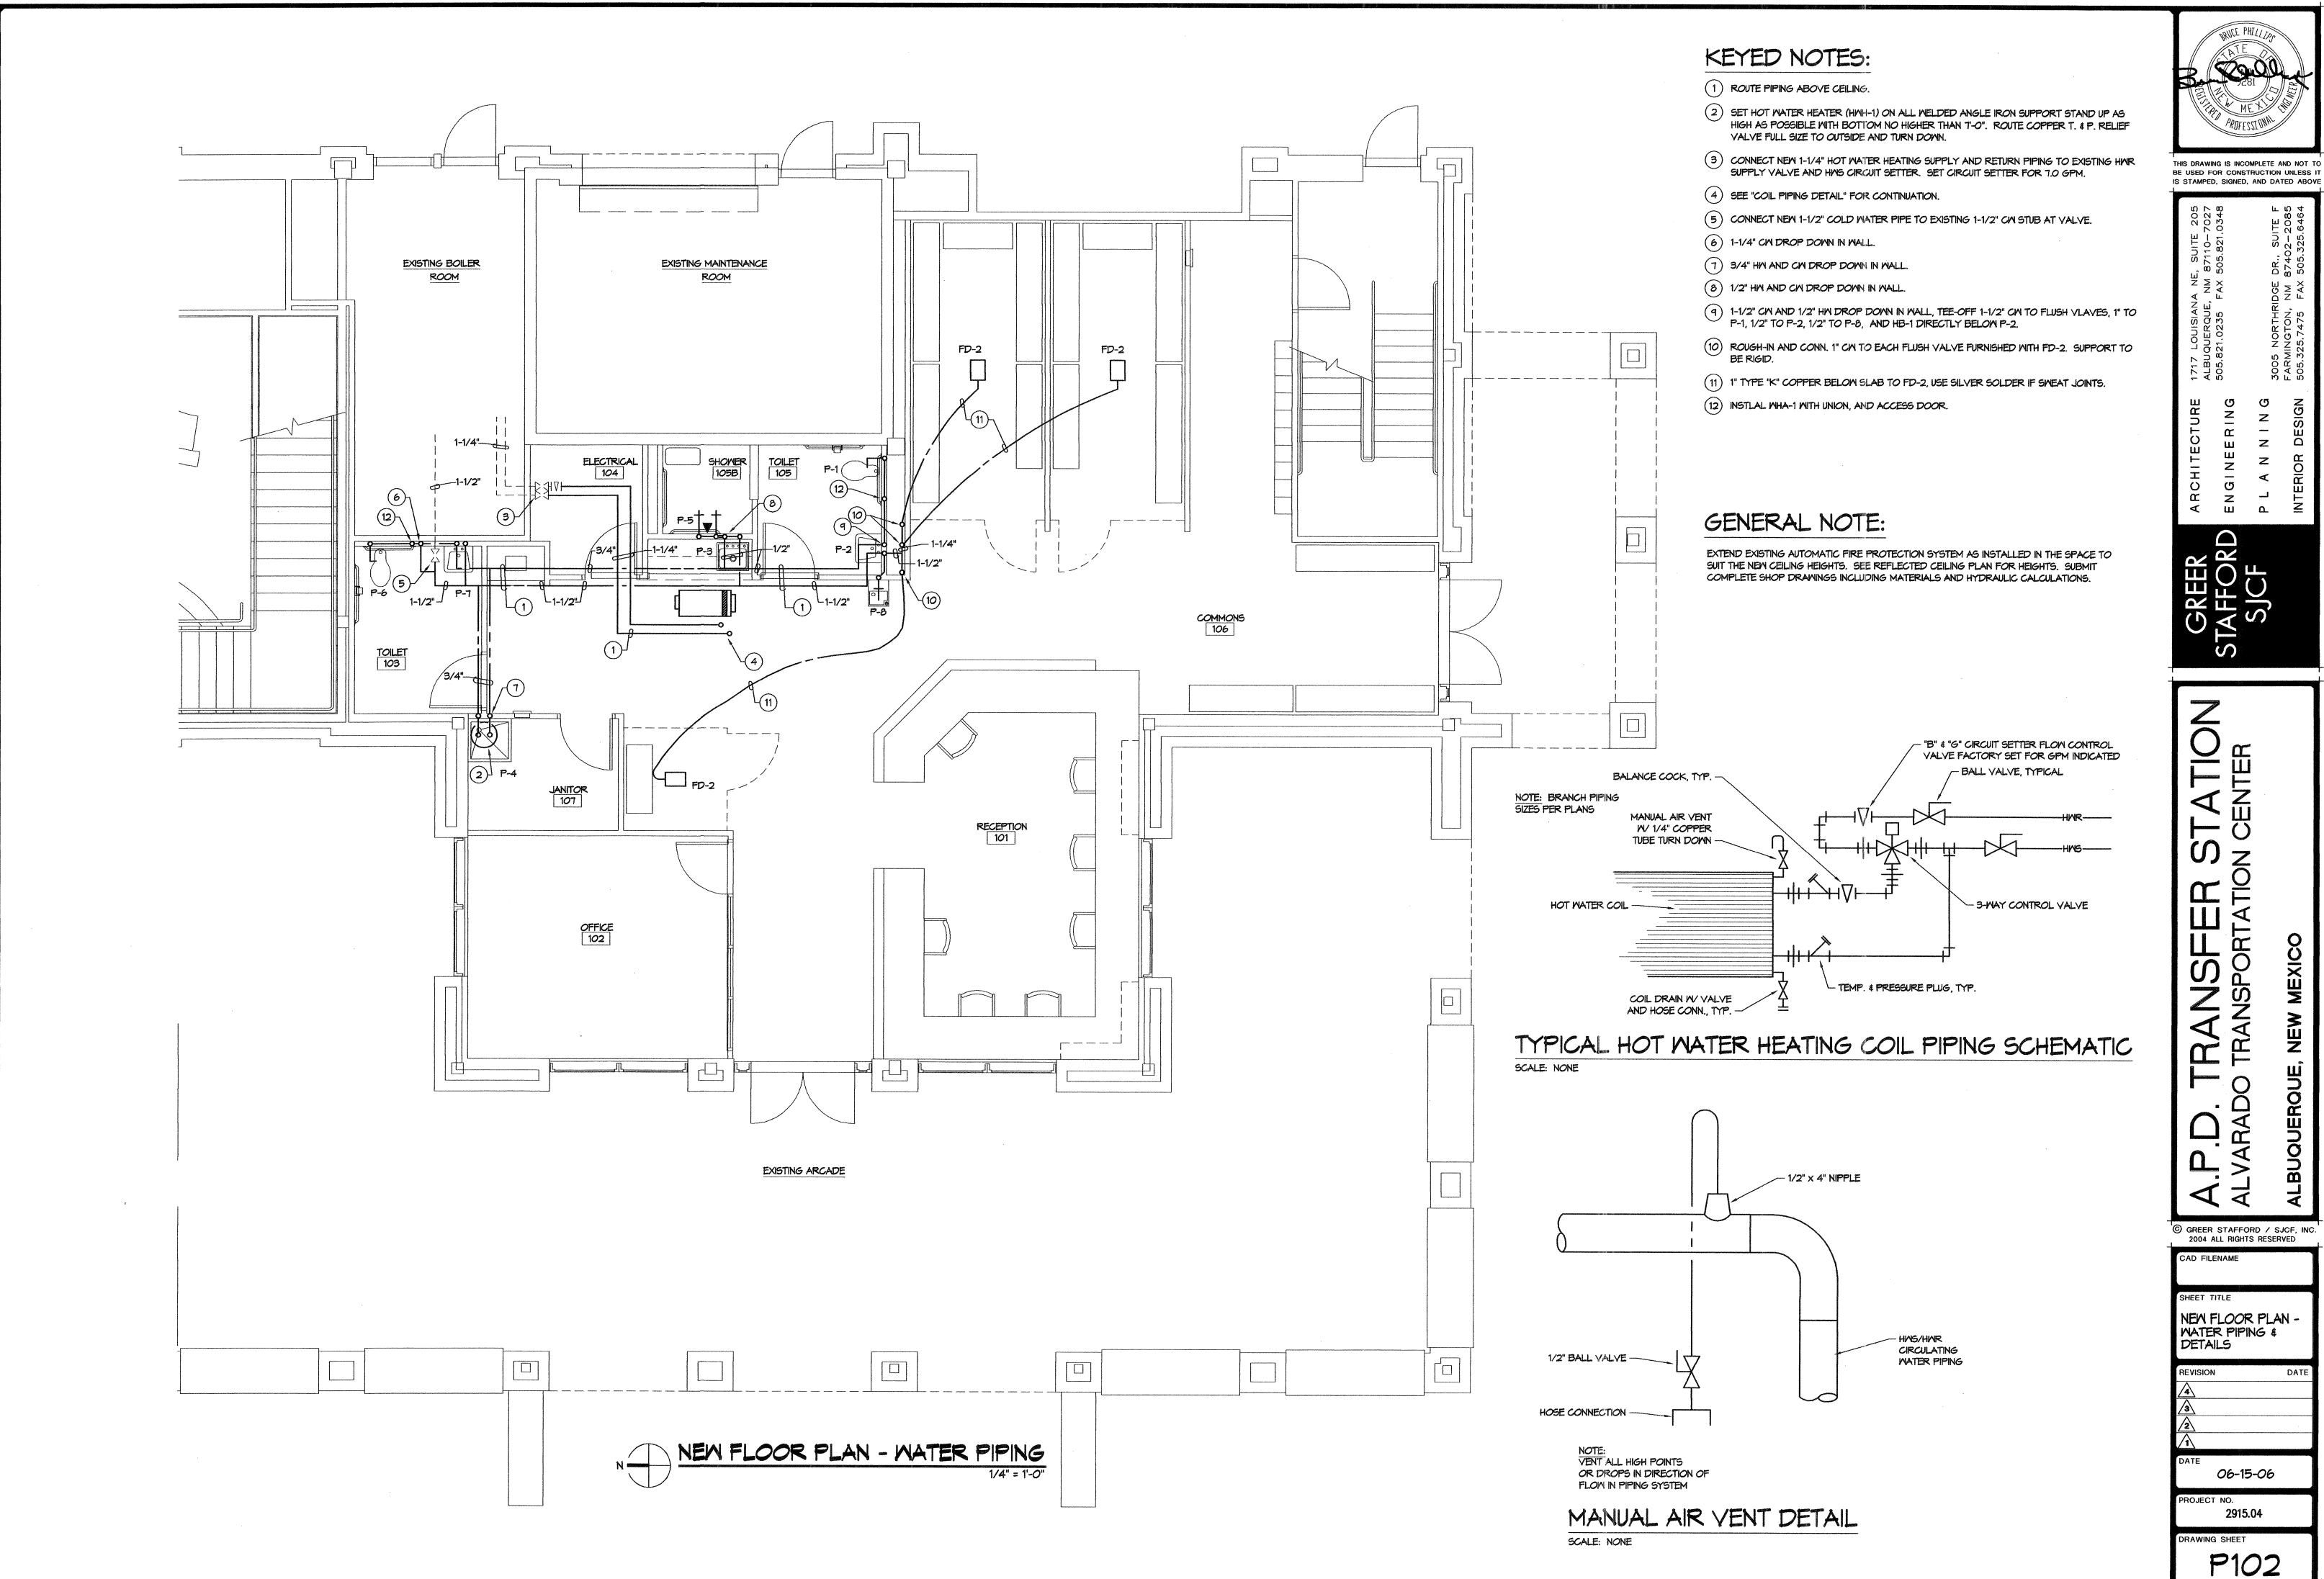M101





| 1 | PLUMBING EQUIPMENT SCHEDULE |
|------|--|
| MBOL | DESCRIPTION |
| P-1 | A.D.A. TOILET: EQUAL TO ACORN PENAL-WARE 18", MODEL 1695, FLOOR MTD., FIXTURE SHALL BE FABRICATED FROM 14 GAGE, TYPE 304 STAINLESS STEEL, CONSTRUCTION SHALL BE SEAMLESS WELDED AND EXPOSED SURFACES SHALL HAVE A SATIN FINISH, SLOAN ROYAL FLUSH VALVE, 1.6 GPF, ELONGATED BOWL, A SELF DRAINING FLUSH RIM, AND AN INTEGRAL CONTOURED SEAT WITH A SANITARY HIGH POLISH FINISH, TOILET SHALL MEET ANSI 112.19.2M REQUIREMENTS, USING AN AVERAGE WATER CONSUMPTION OF 1.6 GALLONS PER FLUSH OR LESS, TOILET TRAP SHALL HAVE A MINIMUM 3-1/2" SEAL THAT SHALL PASS A 2-1/8" DIAMTER BALL AND BE FULLY ENCLOSED, FIXTURE SHALL WITHSTAND LOADINGS OF 5,000 POUNDS WITHOUT PERMANENT DAMAGE, FIXTURE SHALL BE FURNISHED WITH NECESSARY FASTENERS FOR PROPER INSTALLATION, WALL SLEEVE, PAPER HOLDER. |
| P-2 | A.D.A. LAVATORY: EQUAL TO ACORN PENAL-WARE, 18" WIDE ADA COMPLIANT LAVATORY WITH OVAL BOWL, FRONT ACCESS, MODEL 1652, WALL MTD., H. & C. AIR CONTROL VALVES, PENAL BUBBLER, UNIT SHALL CONFORM WITH ANSI, UFAS AND ADA REQUIREMENTS FOR ACCESSIBILITY, FIXTURE SHALL BE FABRICATED FROM 14 GAGE, TYPE 304 STAINLESS STEEL, CONSTRUCTION SHALL BE SEAMLESS WELDED AND EXPOSED SURFACES SHALL HAVE A SATIN FINISH, COUNTERTOP SHALL HAVE AN AIR-CIRCULATING, SELF-DRAINING SOAP DISH, VALVE TO CONFORM WITH NSF61, SECTION 9-1997 LEAD FREE REQUIREMENTS, CABINET BOTTOM SHALL BE REMOVABLE AND SECURED WITH TAMPER RESISTANT SCREWS, CABINET INTERIOR SHALL BE SOUND DEADENED WITH FIRE-RESISTANT MATERIAL, FIXTURE SHALL BE FURNISHED WITH NECESSARY FASTENERS FOR PROPER INSTALLATION. |
| P-3 | A.D.A. COUNTER SINK: ELKAY GECR-2521-L OR R, 20 GAUGE TYPE 302 STAINLESS STEEL, SELF-RIMMING, SINGLE COMPARTMENT, UNDERCOATED, SINGLE FAUCET HOLE, LK-4100 SINGLE LEVER FAUCET WITH SWING SPOUT AND AERATOR, LK-35 DUO STRAINER WITH 1-1/2" TAILPIECE, 2" WASTE, 1-1/2" VENT, 1/2" CW AND 1/2" HW. C.P. P-TRAP WITH WASTE TO WALL, SINK SIZE 25"X21"X5-1/4" DEEP. HW RISER AND P-TRAP TO BE INSULATED WITH "SKAL-GARD", OR APPROVED EQUAL, PROVIDE OFFSET DRAIN. |
| P-4 | SERVICE SINK: FIAT MODEL MSB-2424, MOLDED STONE, 24"X24"X10" HIGH, INTEGRAL DRAIN, RIM GUARD, MODEL #830-AA FAUCET WITH VACUUM BREAKER, HOSE WITH BRACKET, 3" P-TRAP, 3" WASTE, 2" VENT, 1/2" CM AND 1/2" HW OR FLORSTONE. |
| P-5 | A.D.A. SHOWER: EQUAL TO ACORN APEX SURFACE-MOUNTED, ADA COMPLIANT WALL SHOWER WITH WIDE HOUSING, MODEL 450, SHOWER HOUSING SHALL BE FABRICATED FROM 16 GAGE, TYPE 304 STAINLESS STEEL AND SHALL HAVE A SATIN FINISH, HOUSING TOP AND BOTTOM SHALL HAVE A 30 DEGREE SLOPE, EXPOSED TRIM SHALL BE CHROME-PLATED BRASS, FIXTURE SHALL BE FURNISHED WITH AN ADA COMPLIANT CONTROL VALVE WITH LEVER HANDLE, A FIXED UPPER SHOWER HEAD, A LEVER HANDLE DIVERTER VALVE, A QUICK DISCONNECT HAND SHOWER WITH VACUUM BREAKER AND FLOW CONTROL, VALVE SUPPLY FLEXIBLE HOSE CONNECTOR, A RECESED SOAP DISH, UNITS TO CONFORM WITH ANSI, UFAS AND ADA REQUIREMENTS FOR ACCESSIBLITY. |
| P-6 | A.D.A. WATER CLOSET: AMERICAN STANDARD MODEL NO. 9468.018, SIPHON JET ACTION ELONGATED BOWL, FLOOR MOUNTED 1-1/2" TOP SPUD, VITREVOUS CHINA, SLOAN "ROYAL" 110 FLUSH VALVE (WATER SAVING), WHITE OPEN FRONT SEAT WITH STAINLESS STEEL CHECK HINGES, 4" WASTE, 2" VENT, 1" CW, 17-1/4" HIGH TO RIM OR APPROVED EQUAL. CUT FLUSH VALVE RISER 2" TO CLEAR GRAB BAR (IF APPLICABLE). |
| P-7 | A.D.A. LAVATORY: KOHLER MODEL K-2005, CONCEALED ARM CARRIER, VITREOUS CHINA LAVATORY WITH RECTANGULAR BASIN, SPLASH LIP, FRONT OVERFLOW, K-15592 SINGLE LEVER FAUCET, FLOW RESTRICTOR, AERATOR, GRID STRAINER, K-7606 SUPPLIES WITH STOPS, C.P. P-TRAP, LAVATORY SIZE 21"X18", 1-1/2" WASTE, 1-1/2" VENT, 1/2" CM AND 1/2" HW. MOUNT AT HEIGHT AS INDICATED BY ARCHITECT. INSULATE HW RISER AND P-TRAP WITH 1" THICK INSULATION WITH PROTECTIVE COVER EQUAL TO "SKAL GARD", PROVIDE OFFSET DRAIN, PROVIDE APPLICABLE CARRIER. |
| P-8 | ELECTRIC WATER HEATER: ELKAY MODEL NO. EZS-8, STAINLESS STEEL BASIN, SELF CONTAINED WALL MOUNTED, EASY TOUCH CONTROLS ON FRONT AND EACH SIDE, NO LEAD, CAPACITY 8 GPH OF 50°F DRINKING WATER BASED UPON 80°F INLET WATER AND 90°F AMBIENT. 3/8" SUPPLY WITH WHEEL HANDLE STOP AND 1-1/4"X1-1/2" CHROME PLATED P-TRAP. 1-1/2" WASTE, 1-1/2" VENT, AND 1/2" CW. 1/6 HP, 115-60-10. MOUNT AT HEIGHT AS DIRECTED BY ARCHITECT, PROVIDE APPLICABLE CARRIER. |
| MH-1 | HOT WATER HEATER: NO'S ARE A.O. SMITH, ELECTRIC, GLASS LINED TANK, WITH A.S.M.E. TEMPERATURE AND PRESSURE RELIEF VALVE, HEAVY DUTY SCREM IN ANODES. THERMOSTAT/HI-LIMIT, THICK FOAM INSULATION, 4.6 GPH RECOVERY AT 90°F RISE PER 1000 WATTS, OR STATE EQUAL. SET AT 110°F. INSTALL THERMOMETER ON H.M. OUTLET. |
| | ELEMENT SYMBOL MODEL GAL. CAP. WATTS ELECTRICAL |
| | HWH-1 ECS-30 30 6000 208-60-10 |
| B-1 | HOSE BIBB: NIBCO NO. 72, 1/2" SIZE, WITH VACUUM BREAKER, KEY OPERATED, TURN (2) KEYS OVER TO OWNER. |
| 00 | FLOOR CLEANOUT (INSIDE BUILDING FOR APPLICABLE FINISH): CONCRETE, CERAMIC TILE, OR Q.T ZURN NO. Z-1400-3, VINYL TILE - ZURN NO. Z-1400-7, RECESSED TILE, CARPET - ZURN NO 1400-15 WITH CARPET MARKER, VANDALPROOF NICKEL BRONZE TOP, OR SMITH SERIES 4000. |
| ĸo | MALL CLEANOUT: LOCATE WHERE SHOWN OR REQUIRED BY CODE. SMITH NO. 4472 EXTRA HEAVY BRONZE PLUG WITH STAINLESS STEEL WALL COVER, V.P. SCREW, OR APPROVED EQUAL. |
| D-1 | FLOOR DRAIN: SMITH FIGURE 2010-A-U, WITH 5" DIAMETER ADJUSTABLE TOP AND VANDALPROOF SCREWS, OUTLET WITH VENTED P-TRAP BELOW FLOOR WITH TRAP PRIMER CONNECTION, ROUTE 1/2" TYPE "K" COPPER PIPE BELOW SLAB FROM TRAP PRIMER WITH VALVE, UNION AND ACCESS DOOR TO FD-1. |
| HA-1 | WATER HAMMER ARRESTOR: SMITH FIGURE NO. 5050, 1" SIZE, 1808 STAINLESS STEEL, LOCATE WHERE SHOWN. |
| D-2 | DETOX FLOOR DRAIN: EQUAL TO ACORN 1699-W-3-FV-1.6, FIXTURE SHALL BE FABRICATED FROM 14 GAGE, TYPE 304 STAINLESS STEEL AND SHALL HAVE A CONTINUOUS 360 DEGREE WASHDOWN FLUSHING RIM, BAR GRATE SHALL BE 3/8" DIAMETER BARS WELDED IN PLACE, EXCEPT BAR OVER WASTE OUTLET, WHICH SHALL BE REMOVABLE AND SECURED IN PLACE WITH TWO TAMPER-RESISTANT SCREWS, RECEPTOR SHALL HAVE COVED CORNERS AND THE BOTTOM AREA SHALL MAINTAIN A MINIMUM WATER SURFACE OF 8"X12"X2" DEEP, TOILET WASTE OUTLET SHALL BE 2-3/8" OD PLAIN END AND TRAP SHALL PASS A 2-1/8" BALL, PROVIDE SLOAN ROYAL FLUSH VALVE, 1.6 GPF, PUSH BUTTON, INSTALL ELDOR ACCESS DOOR, MODEL 5010, 13"X17" SIZE, 14 GA. TYPE 304 STAINLESS STEEL POLISHED TO A SATIN FINISH, FLUSH VALVE PUSH BUTTON TO BE INSTALLED THRU FACE OF PANEL. |

MECHANICAL EQUIPMENT SCHEDULE SYMBOL DESCRIPTION ļ----- $\langle 1 \rangle$ SINGLE DUCT VAV TERMINAL UNITS: WELDED 22 GA. GALV. STEEL CASING, PROVIDED WITH HANGER HOLES AT THE FOUR CORNERS DIE CAST ALUMINUM AIR FLOW INLET IS TAPERED TO FIT STANDARD ROUND FLEXIBLE DUCTWORK, INCLUDES EIGHT POINT FLOW APPROVED EQUAL. HOT WATER CAPACITIES ARE BASED UPON 180°F EWT, AND 55°F EAT, 20°F DROP. CONTROLS BY SOUTHWEST TRANE CO. - NO EXCEPTIONS. SYMBOL MODEL CFM RANG $\langle 1 \rangle$ VCWE-24 2000 1350- $\langle 2 \rangle$ EXHAUST FANS: V-BELT DRIVEN CENT CENTRIFUGAL WHEEL, SPUN ALUMINUM JENN AIRE ARE EQUAL. SYMBOL MODEL CFM @ "E.S.P. HP ELECTRICAL OP. WT. 2 GB-071-4 200 @ 1/2" 1/4 115-60-10 75# $\langle D \rangle$ CEILING DIFFUSER: TITUS TMSA WITH O.B. VOLUME DAMPER, STEEL CONTSTRUCTION, FOR APPLICABLE TYPE CEILING, OFF-WHITE COLOR, 4-WAY THROW, OR EQUAL. RAR RETURN AIR REGISTER (CEILING): TITUS MODEL 50-R, STEEL CONSTRUCTION, FLANGED FRAME, WITH O.B. VOLUME DAMPERS, OFF-WHITE COLOR, OR APPROVED EQUAL.

OUTSIDE AIR CALCULATIONS:

PER TABLE 4-1 OR THE 2003 NEW MECHANICAL CODES, UNDER GROUP "I" (INSTITUTIONAL/CORRECTIONAL FACILITY). THE FOLLOWING IS CFM PER PERSON REQUREMENTS. VAV UNIT 1 :

CELLS/HOLDING - .10 CFM/PERSON = 5 THEREFORE 5 CFM/PERSON × 50 = 250 CFM

GENERAL NOTES (TYPICAL ALL SHEETS): PROVIDE TURNING VANES IN ALL SQUARE ELBOWS.

ROUND DUCT BRANCH RUNOUTS TO $\langle CD \rangle$ DIFFUSER SHALL BE OF EQUAL TO NECK SIZE.

SEE REFLECTED CEILING PLAN ON ARCHITECTURAL DRAWINGS FOR EXACT LOCATION OF ALL GRILLES, REGISTERS, AND DIFFUSERS.

COORDINATE DUCTWORK WITH STRUCTURAL, MECHANICAL, PLUMBING, FIRE PROTECTION AND ELECTRICAL CONDITIONS. IN THE EVENT THAT ANY DUCT CANNOT BE ROUTED AS SHOWN ON THE CONTRACT DRAWINGS, THE CONTRACTOR SHALL MODIFY THE DUCT AS REQUIRED TO MAINTAIN THE SAME NET FREE AREA AS THE DESIGNED DUCT. CONTRACTOR SHALL SUBMIT SHOP DRAWINGS TO THE ARCHITECT SHOWING THE PROPOSED CHANGE FOR APPROVAL AND SHALL BE DONE AT NO ADDITIONAL COST TO THE OWNER.

BEFORE CONTRACTOR ORDERS ANY GRILLES, REGISTERS, OR DIFFUSERS, HE SHALL VERIFY THE CEILING CONSTRUCTION IN ALL AREAS OF THE PROJECT. IF GRILLES, REGISTERS OR DIFFUSERS SPECIFIED ARE NOT COMPATIBLE WITH THE TYPE OF CEILING CONSTRUCTION, THE CONTRACTOR SHALL ORDER THE PROPER TYPE OF GRILLE, REGISTER, OR DIFFUSER TO BE COMPATIBLE WITH THE CEILING.

ALL PIPING SHALL BE CONCEALED WHERE POSSIBLE. ALL EXPOSED PIPING WHERE CONCEALMENT IS NOT POSSIBLE SHALL BE PAINTED AS DIRECTED BY ARCHITECT.

SEE SPECIFICATIONS FOR PIPING INSULATION.

CAULK ALL PIPE PENETRATIONS THRU FIRE WALLS WITH DOW-CORNING NO. 365-48, SEMCO. NO. PR855 OR EQUAL TO MEET PROPER FIRE RATING.

TAKE SPECIAL CARE TO KEEP VENTS THROUGH ROOF AWAY FROM ALL FRESH AIR INLETS ON ROOFTOP UNITS (MINIMUM OF 10'-O").

ALL EQUIPMENT.

FOR INSTALLATION. LEAK RATE IS 1% AT 4.0' WG., DOUBLEWALL CONSTRUCTION TO ISOLATE THE FIBERGLASS INSULATION FROM THE AIRSTREAM, 1" THICK INSULATION, R=4.21, 1.9LB/CU. FT. WITH HIGH DENSITY FACING, INSULATION IS UL LISTED AND MEETS NFPA-90A AND UL 181. FACTORY MOUNTED TWO ROW COILS, 3/8" O.D. SEAMLESS COPPER TUBES ARE MECHANICALLY EXPANDED INTO THE FIN COLLARS, FACTORY MOUNTED, REMOVABLE PANEL ON BOTTOM OF UNIT PROVIDING ACCESS TO AIR VALVE AND ENTERING AIR SIDE OF COIL. STRAIGHT FLANGE OR SLIP AND DRIVE RECTANGULAR DISCHARGE DUCT CONNECTION, AIR VALVE SHALL BE CYLINDRICAL SENSING RING TO PROVIDE FLOW MEASUREMENT TO WITHIN 5% OF RATED UNIT AIR FLOW WITH 1-1/2 DIAMETERS OF STRAIGHT DUCT UPSTREAM OF UNIT, INTEGRAL FLOW TAPS AND CALIBRATION CHART PROVIDED ON EACH UNIT. THE VAV TERMINAL UNITS SHALL BE INDIVIDUALLY CONTROLLED BY A UNIT MOUNTED DDC VAY CONTROLLER PER VAY TERMINAL UNIT. THE DDC CONTROLLER, DAMPER MOTOR, TRANSDUCER AND TRANSFORMER SHALL BE SUPPLIED BY THE UNIT MANUFACTURER. FACTORY MOUNTED AND RUN TESTED. THE COST TO FACTORY MOUNT, CALIBRATE AND TEST THE CONTROLLER, TRANSDUCER, TRANSFORMER, AND ACTUATOR SHALL BE INCLUDED IN THE TERMINAL UNIT SUPPLIERS PRICE. TERMINAL UNITS ARE TO BE PRESSURE INDEPENDENT, NUMBERS ARE TRANE, OR

| NGE | BTUH | GPM | <u>P.D.</u> | DUCT | MIN. CFM OUTSIDE AIR | |
|-------|-------|-----|-------------|------|-------------------------|---|
| -2200 | 65000 | 7.0 | 2.6 | 12"Ф | 250 | |
| | | | | | • | T DAMPER, BACKWARD INCLINED 5 ARE GREENHECK, ACME, PENN, |

ACCESS PANELS AND/OR DOORS SHALL BE FURNISHED FOR ACCESS TO VALVES AND ACCESSORIES AT ALL RIGID CEILINGS AND WALLS.

TRENCHING AND BACKFILL FOR PIPING SHALL BE THE RESPONSIBILITY OF THIS CONTRACTOR.

ALL PLUMBING AND MECHANICAL SYSTEMS SHALL COMPLY WITH ALL APPLICABLE CODES, ORDINANCES, AND O.S.H.A. STANDARDS.

MECHANICAL CONTRACTOR SHALL FURNISH AND INSTALL ALL TRAPS, TAILPIECES, AND SUPPLIES WITH STOPS FOR FINAL CONNECTION OF

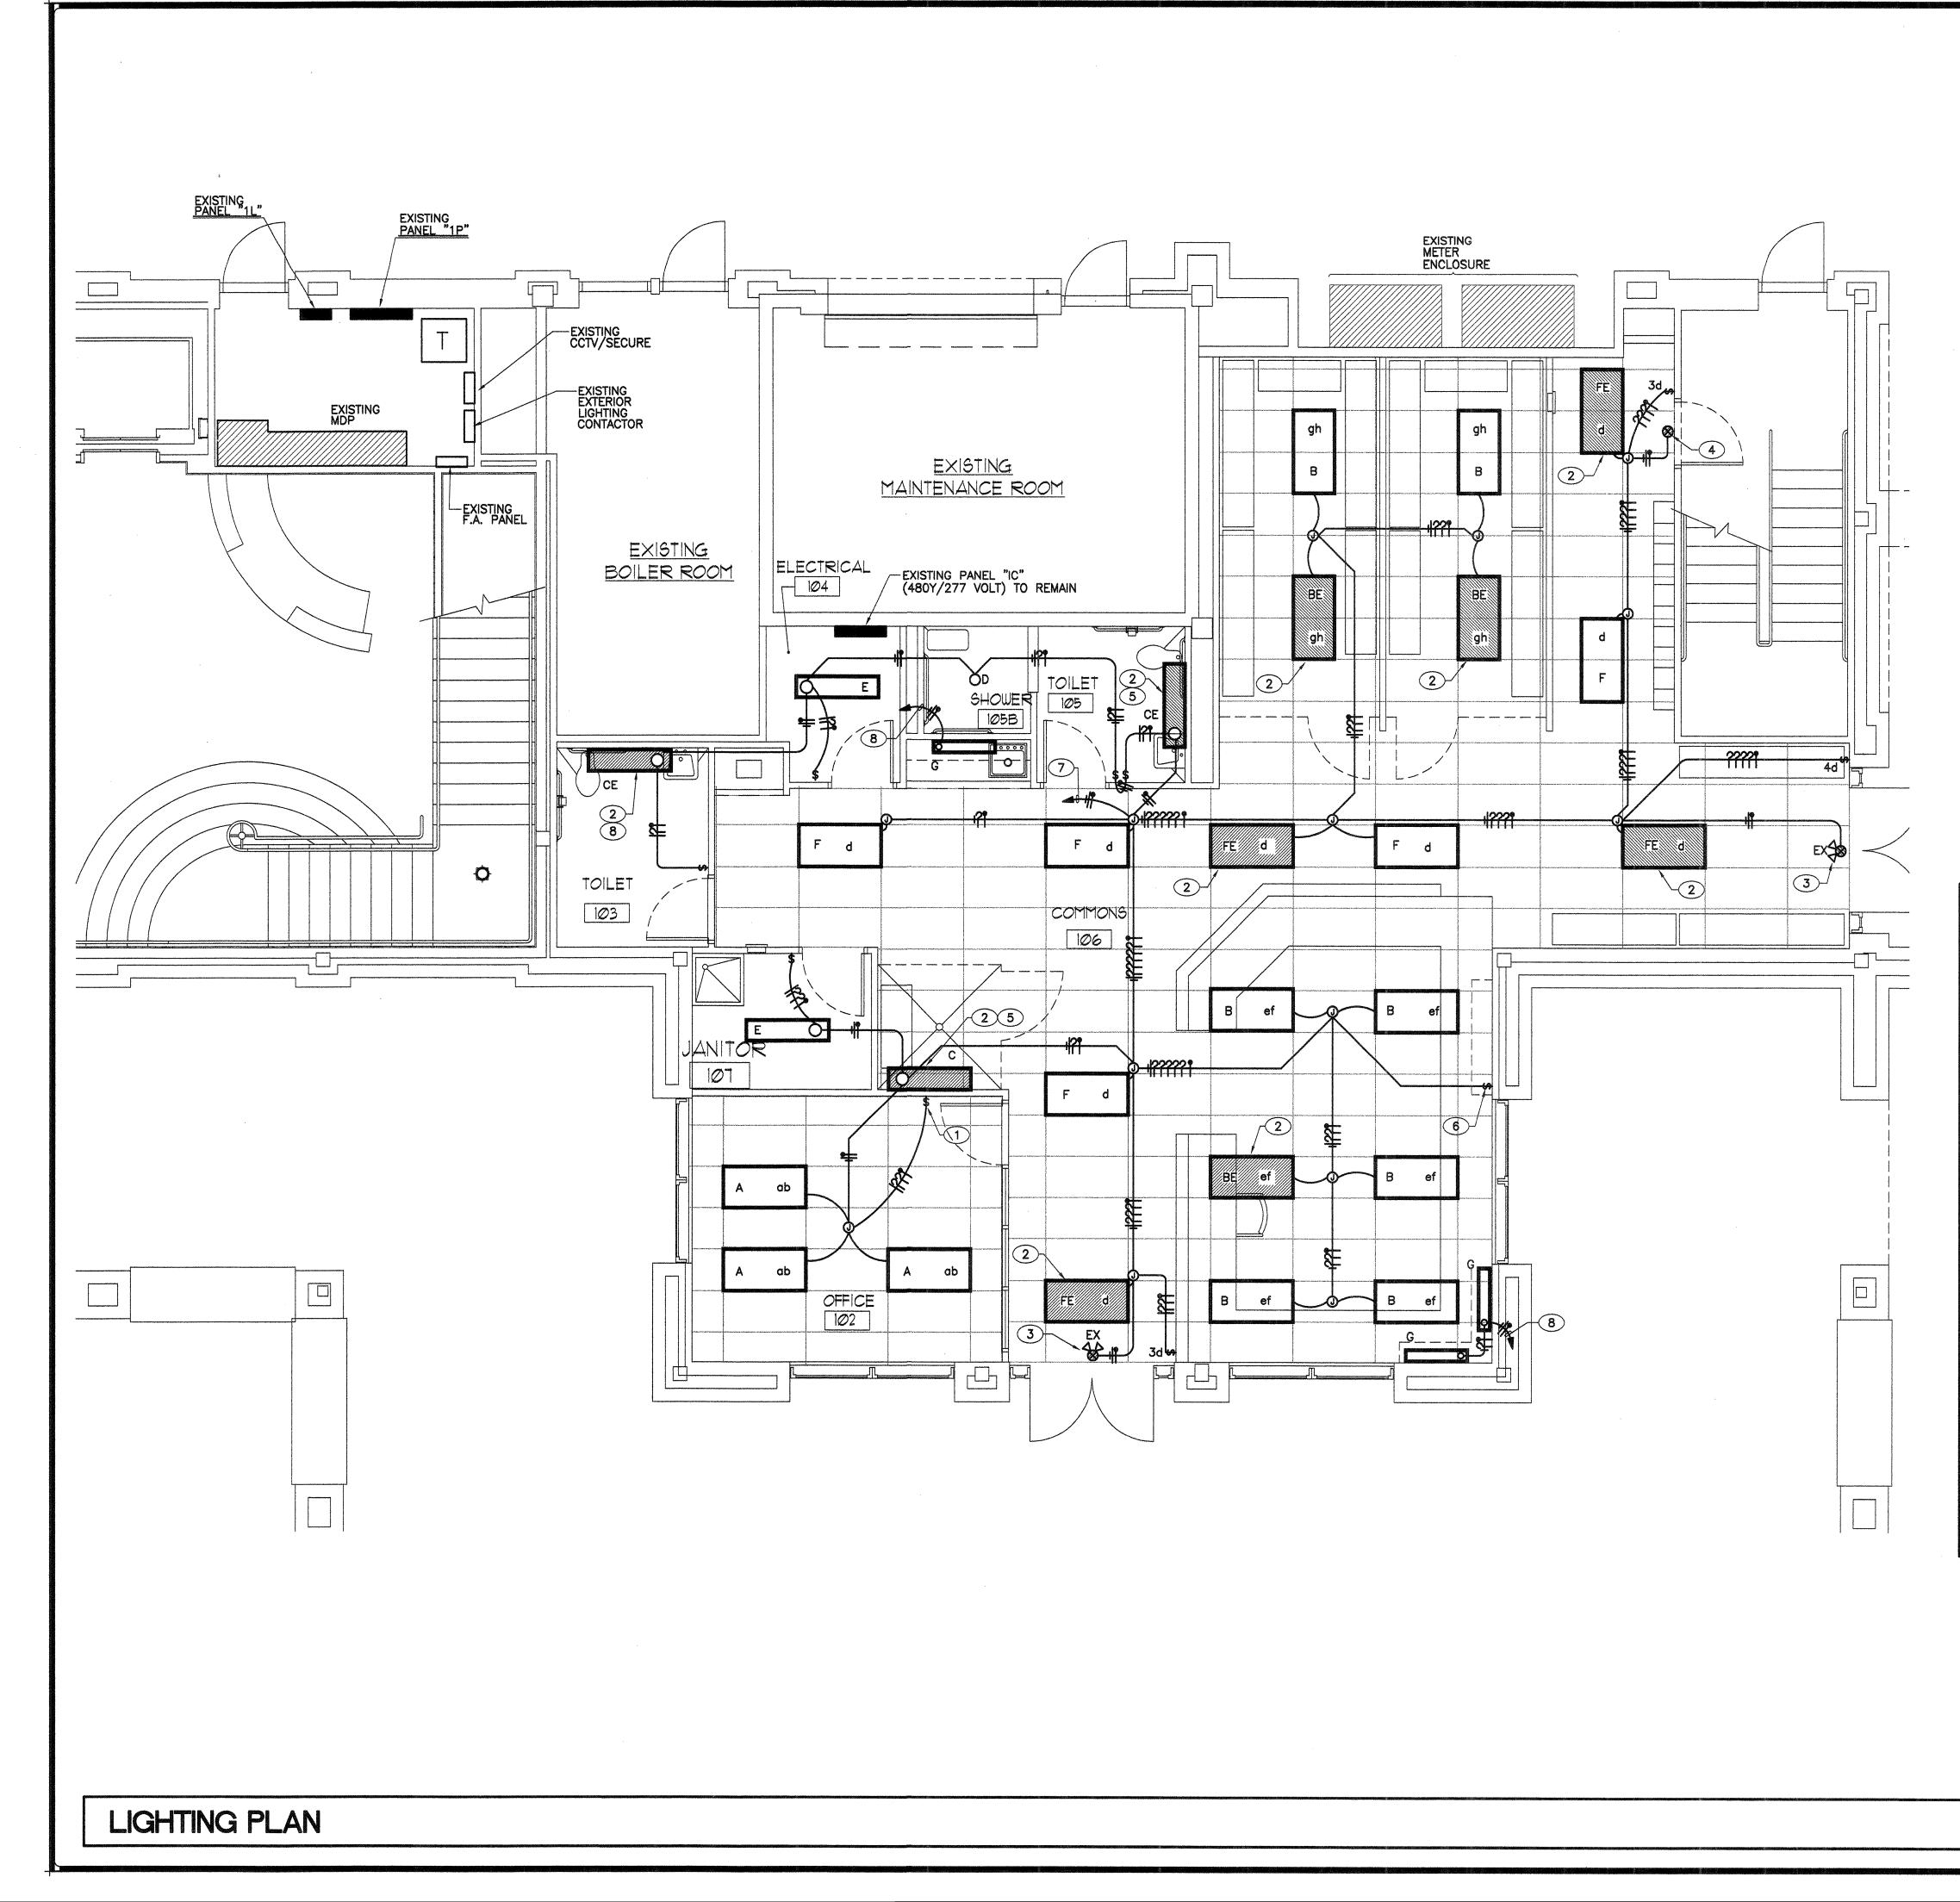
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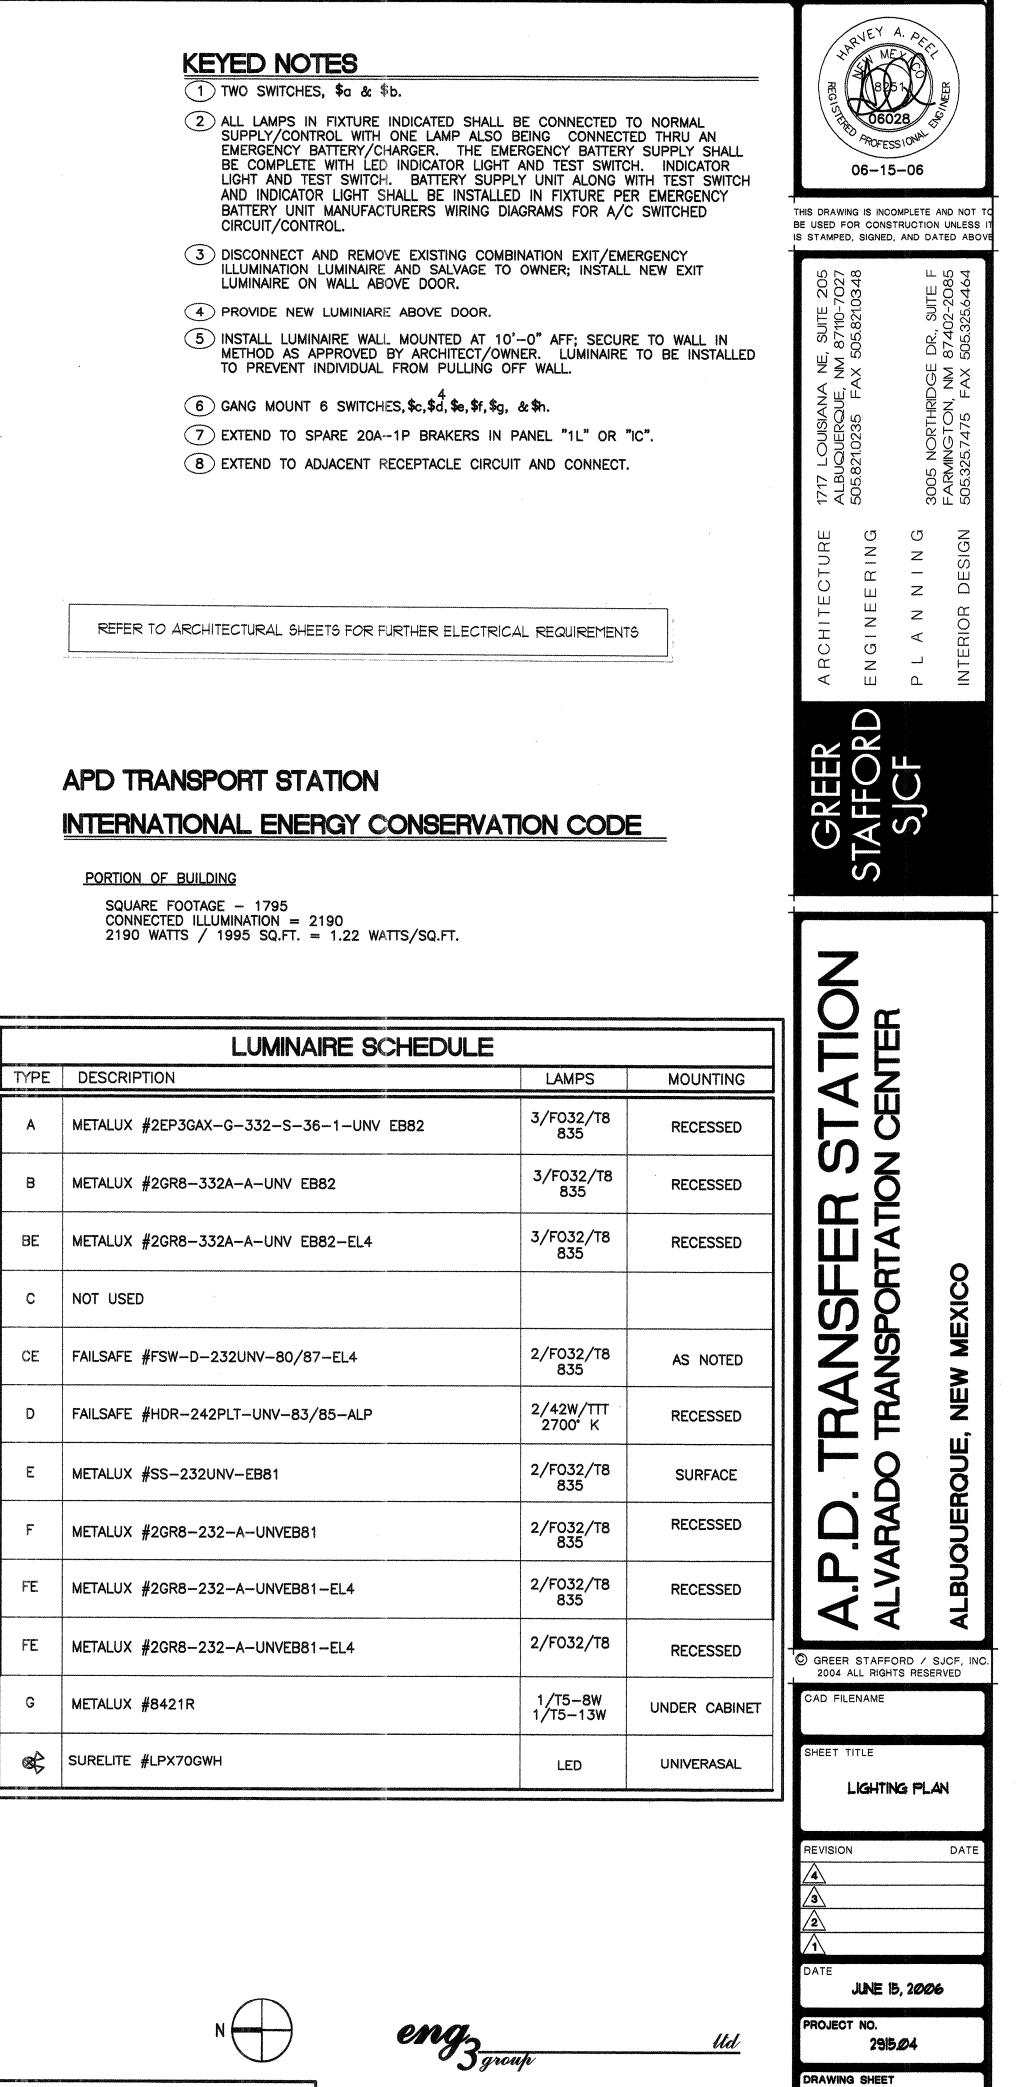
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DRAWING SHEET




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SCALE: 1/4" = 1'-0"4320 PASEO DEL NORTE N.E. ALBUQUERQUE, NEW MEXICO 87113

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KEYED NOTES

- 1 INSTALL DEVICE(S) BELOW COUNTERTOP.
- 2 INSTALL DEVICE 6" ABOVE COUNTERTOP BACKSPLASH.
- 3 PROVIDE SINGLE RECEPTACLE UP 7'-4" TO CENTER FOR OWNER CLOCK INSTALLATION.
- 4 SWITCH FOR CONTROL OF EXHAUST FAN, LABEL "RESTROOM EXHAUST FAN".
- 5 PROVIDE GFCI PROTECTED RECEPTACLE.
- 6 INSTALL DEVICE UP 42".
- 7 PROVIDE (2) 20 AMP, 120 VOLT, TRANSIENT VOLTAGE SURGE SUPPRESSION DUPLEX RECEPTACLES. (DOUBLE DUPLEX WHERE INDICATED). DEVICES SHALL MEET U.L. STANDARD 1449-2ND EDITION (1998), SIMILAR TO LEVITION 5380 SERIES.
- 8 APPROXIMATE LOCATION OF NEW EXHAUST FAN; REFERENCE "M" SHEETS FOR EXACT LOCATION.
- 9 EXISTING POWER PANEL "IC", TO REMAIN.
- (10) EXTEND TO SPARE 20A-1P BRANCH CIRCUITS IN EXISTING PANEL "IP".
- 11 LABEL SWITCH "EXHAUST FAN".
- (12) EXTEND CONTROLS TO NEW EXHAUST FAN.
- 13 EXTEND 120 VOLT TO HVAC EQUIPMENT CONTROL VALVE.
- 14 PROVIDE JUNCTION BOX FOR CONNECTION OF ELECTRIC WATER HEATER; REFERENCE "P" SHEET(S) FOR EXACT HEIGHT AND LOCATION.
- 15 EXTEND TO NEW 40A-2P CIRCUIT BREAKER IN PANEL "IP".
- 16 THIS CIRCUIT SHALL BE DEDICATED AND ISOLATED GROUND.
 (17) GANG (4) QUADRAPLEX DEVICES AT 40" ABOVE FINISH FLOOR; INSTALL (2) QUADRAPLEX ON EACH CIRCUIT.

REFER TO ARCHITECTURAL SHEETS FOR FURTHER ELECTRICAL REQUIREMENTS


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SCALE: 1/4" = 1'-0"
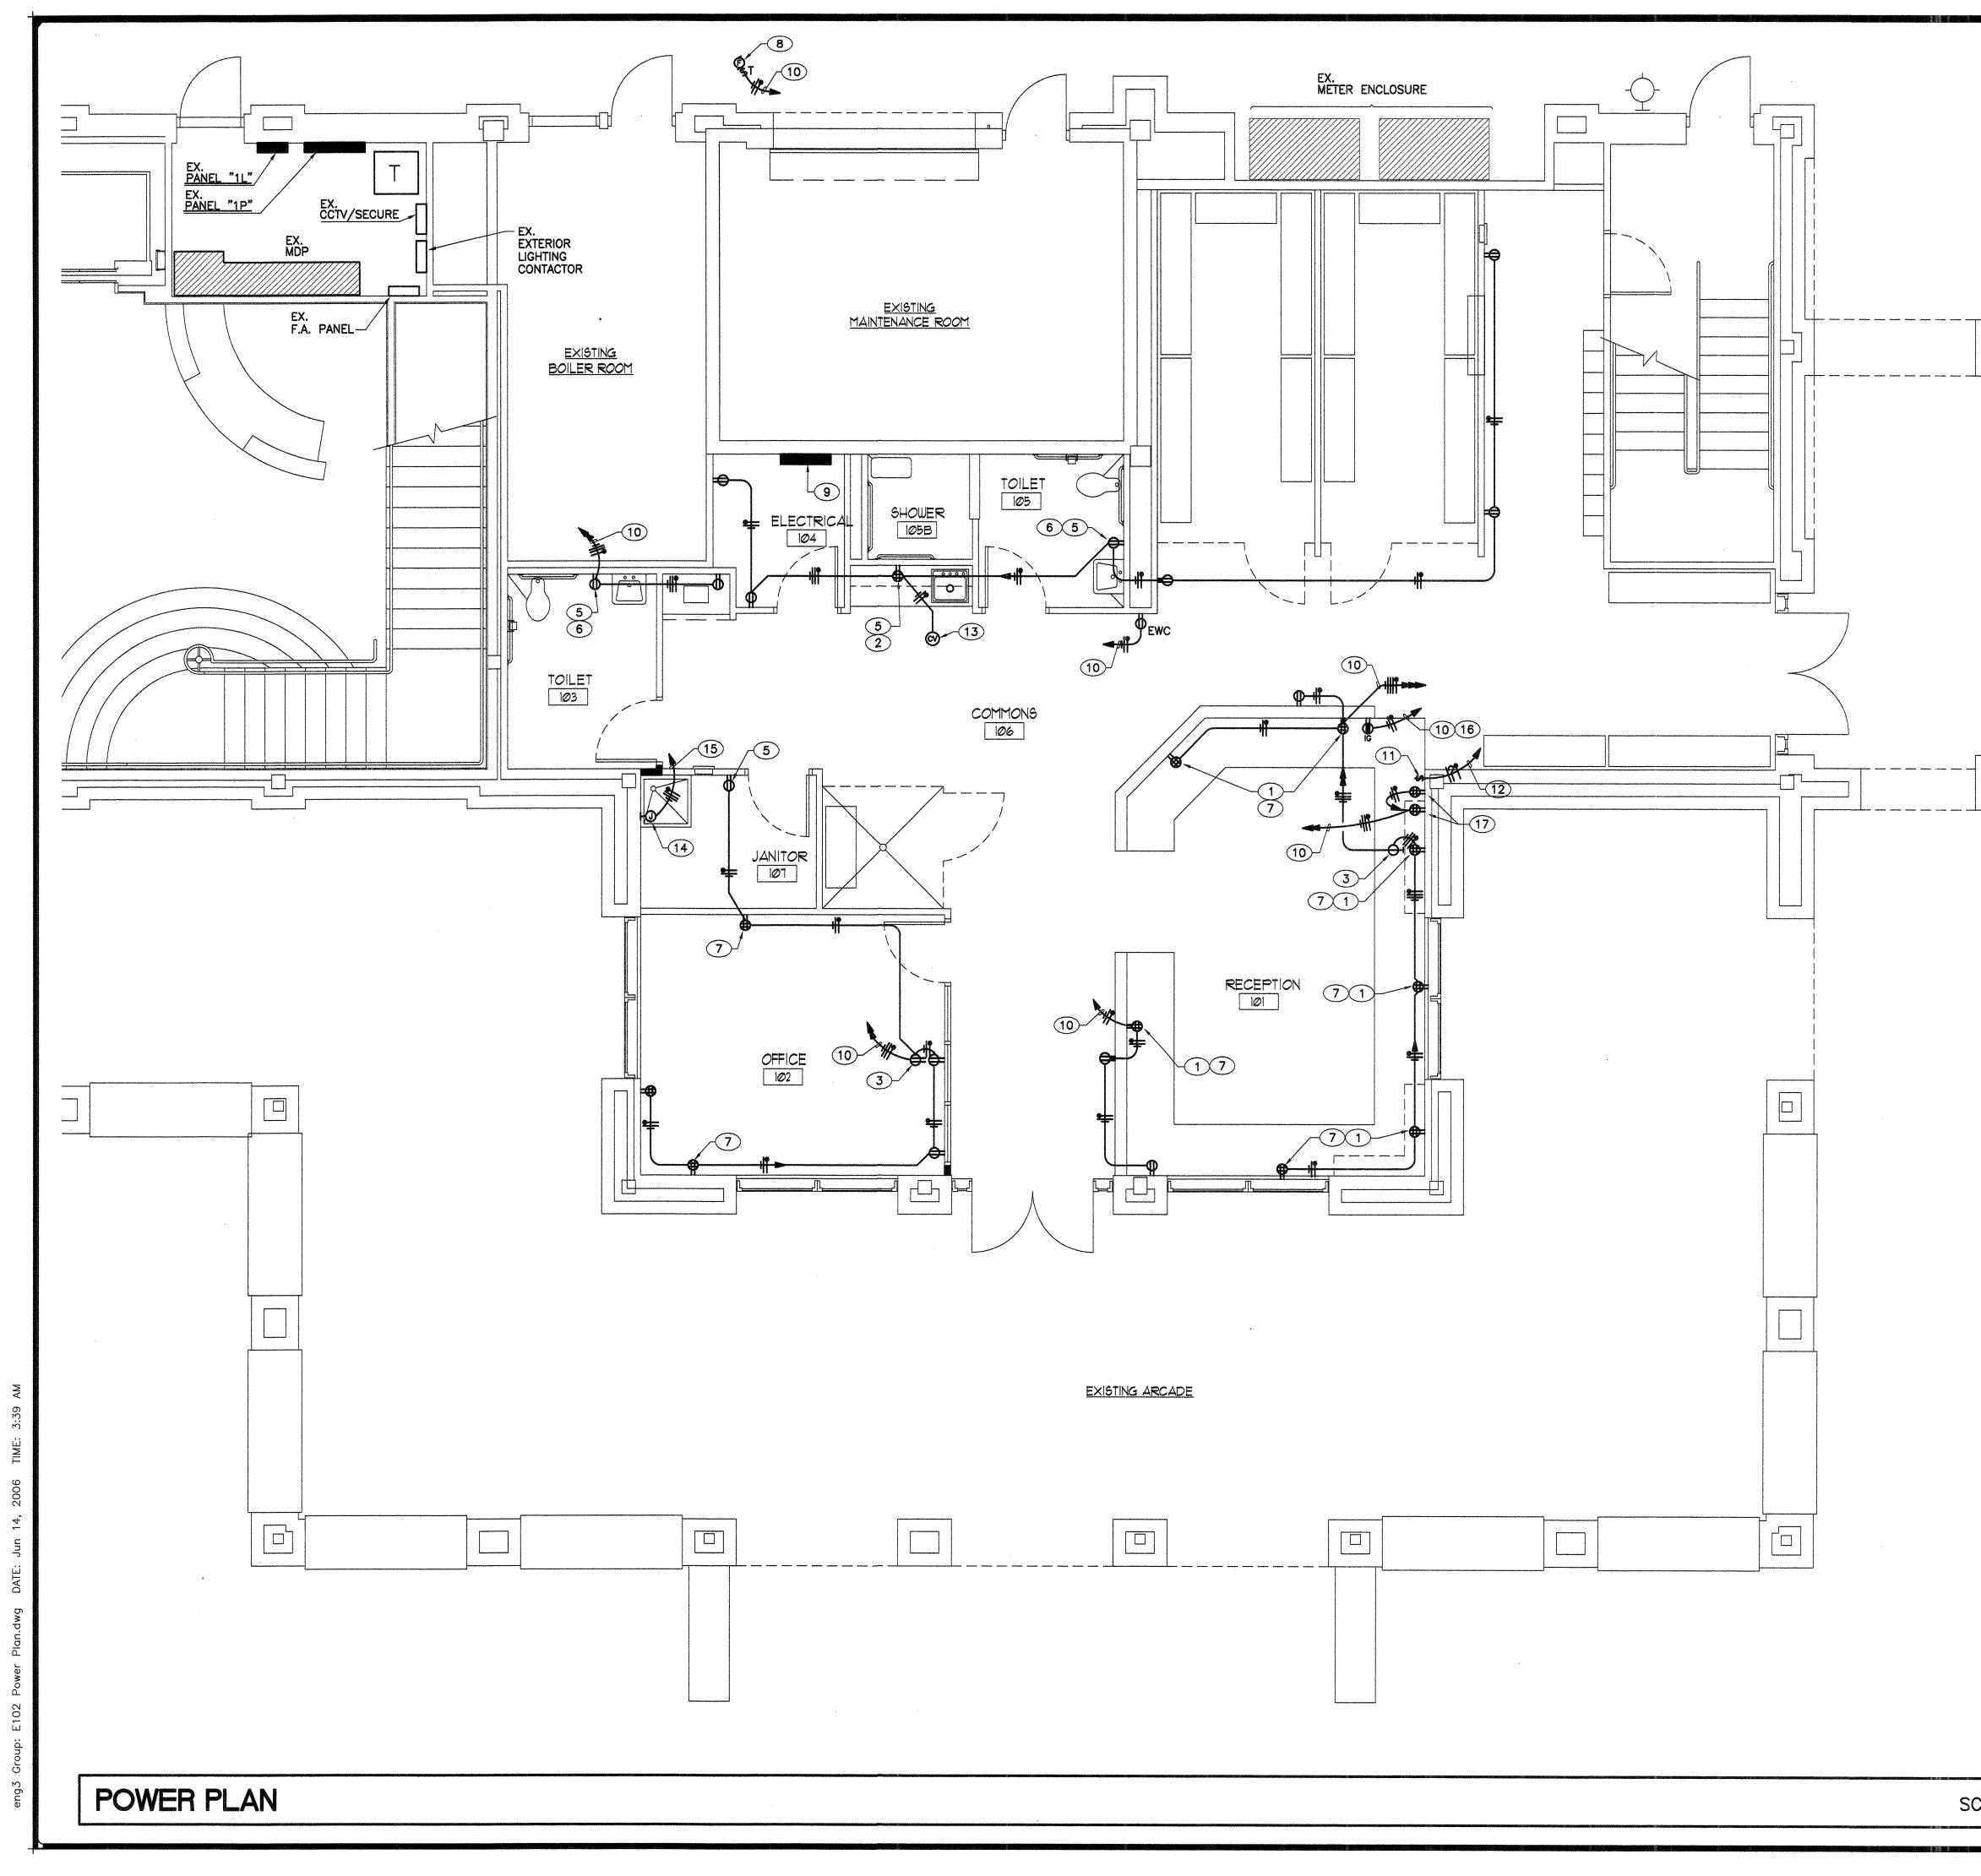
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4320 PASEO DEL NORTE N.E. ALBUQUERQUE, NEW MEXICO 87113 OFFICE: 798-0301 CELL: 350-6383 FAX: 798-0102 DRAWING SHEET
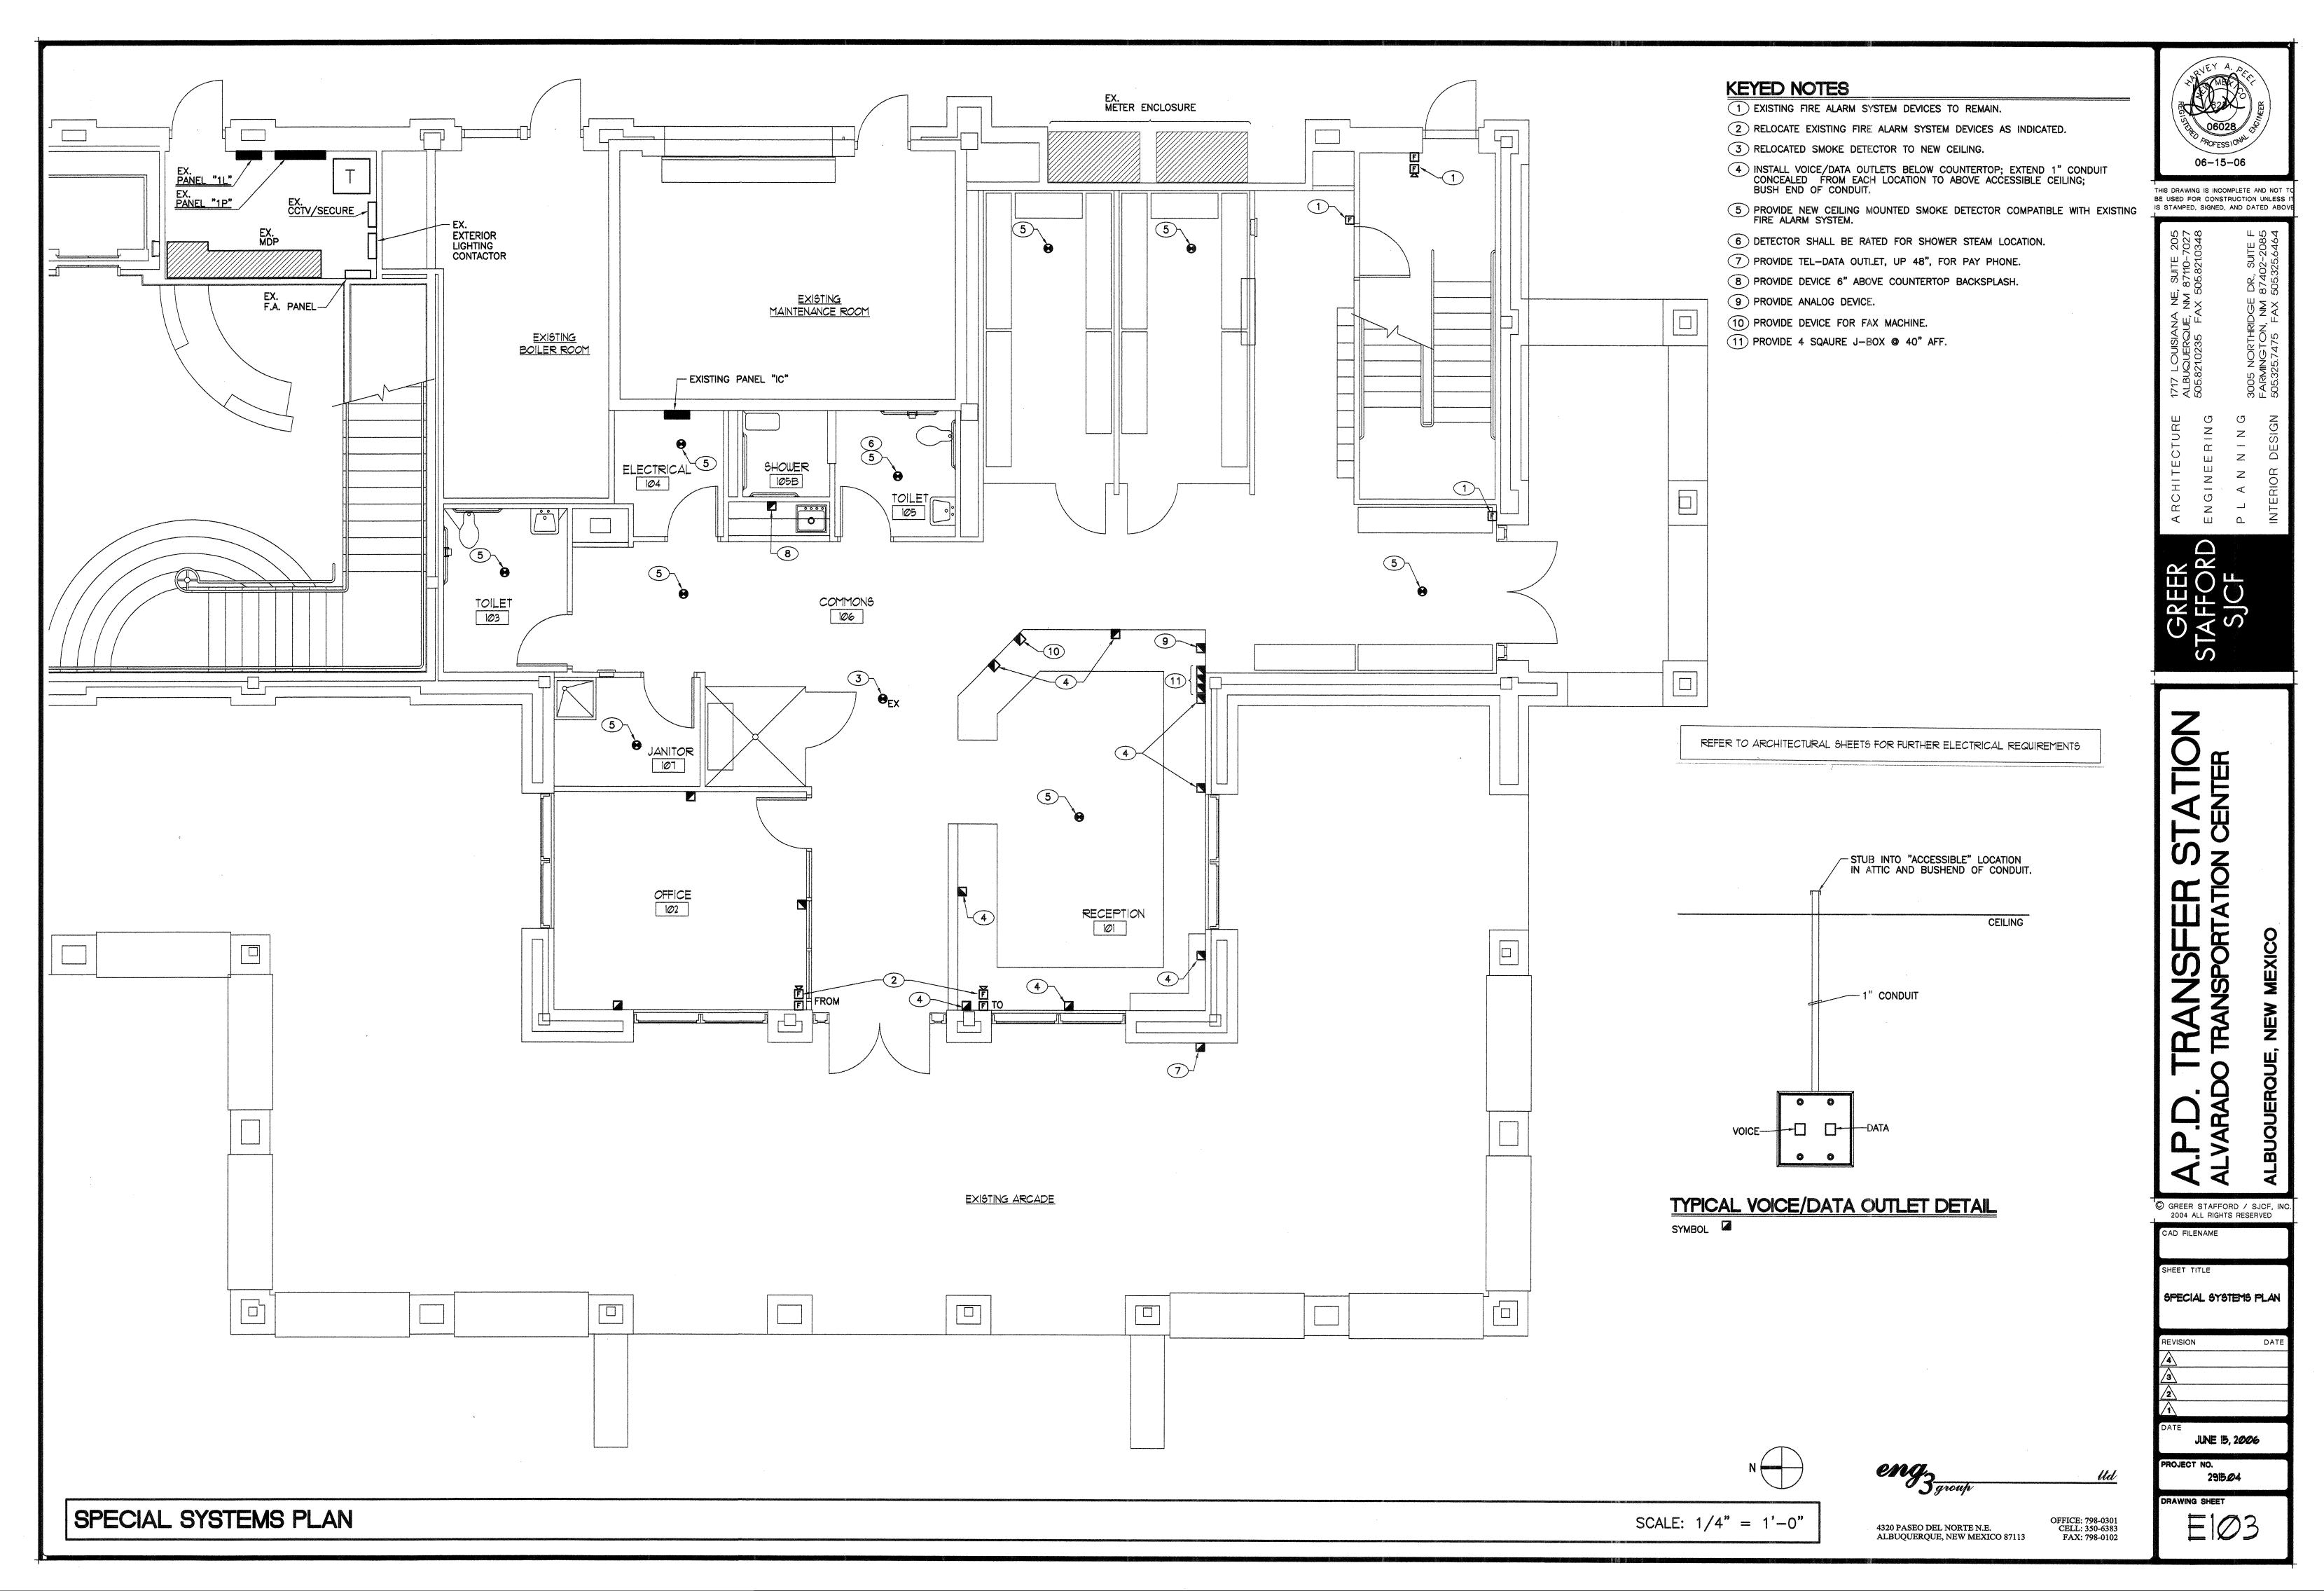
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