


GENERAL NOTES

1. ALL WORK DETAILED ON THESE PLANS TO BE PERFORMED UNDER CONTRACT SHALL, EXCEPT AS OTHERWISE STATED OR PROVIDED FOR HEREON, BE CONSTRUCTED IN ACCORDANCE WITH THE CITY OF ALBUQUERQUE STANDARD SPECIFICATIONS FOR PUBLIC WORKS CONSTRUCTION 1986.
 2. PRIOR TO CONSTRUCTION, THE CONTRACTOR SHALL EXCAVATE & VERIFY THE HORIZONTAL AND VERTICAL LOCATIONS OF ALL OBSTRUCTIONS. SHOULD A CONFLICT EXIST, THE CONTRACTOR SHALL NOTIFY THE ENGINEER SO THAT THE CONFLICT CAN BE RESOLVED WITH MINIMUM DELAY.
 3. TWO (2) WORKING DAYS PRIOR TO ANY EXCAVATION, CONTRACTOR MUST CONTACT LINE LOCATING SERVICE @ 765-1234 FOR LOCATION OF EXISTING UTILITIES.
 4. CONTRACTOR SHALL PROVIDE CONTINUOUS WATER SERVICE TO AFFECTED RESIDENCES & BUSINESSES DURING CONSTRUCTION PERIOD BY INSTALLING A SURFACE "SHOE-FLY" LINE OR SOME OTHER APPROPRIATE MEANS TO MINIMIZE SERVICE DISRUPTION.
 5. WATER SYSTEMS SHALL BE CONTACTED @ 823-4200, 3 WORKING DAYS PRIOR TO ANY SHUT-OFFS. ALL SYSTEM SHUT-OFFS SHALL BE AS PER SECTION 18.3 OF THE GENERAL CONDITIONS.
 6. ALL UTILITIES AND UTILITY SERVICE LINES SHALL BE INSTALLED PRIOR TO PAVING. THE SURFACE COURSE SHALL BE INSTALLED AFTER FULL APPROVAL AND ACCEPTANCE OF THE UTILITY LINES.
 7. PAVEMENT REPLACEMENT AND BACKFILL SHALL BE PER CITY OF ALBUQUERQUE STANDARD DRAWING 2465, CURB AND GUTTER, SIDEWALKS, DRIVEPADS AND CURB RETURNS DAMAGED BY THE CONTRACTOR SHALL BE REPLACED PER CITY STANDARD DRAWINGS 2415, 2430, 2425 AND 2440.
 8. THE CONTRACTOR SHALL PROVIDE FOUR PROJECT CONSTRUCTION SIGNS WHICH ARE TO BE MOVED DURING THE PROJECT AT THE DIRECTION OF THE ENGINEER.
 9. EXISTING WATER LINES TO BE REPLACED SHALL BE REMOVED & DISPOSED OF EXCEPT WHERE OTHERWISE NOTED ON THE PLANS. THE ENDS OF ABANDONED LINES SHALL BE PLUGGED, VALVES SHALL HAVE THE OPERATING NUT & VALVE CAN REMOVED.
 10. ALL WATER LINE REPLACEMENT CONNECTIONS SHALL BE PER CITY OF ALBUQUERQUE STANDARD DRAWING NO. 2301.
 11. WATER SERVICE LINES, METERS, & BOXES SHALL BE REPLACED, TRANSFERRED, RELOCATED & REHABILITATED AS PER SECTION 802 OF THE TECHNICAL SPECIFICATIONS AND THE PLANS. METER BOX RELOCATIONS SHALL BE AS NOTED ON THE PLANS AS PER STANDARD DRAWINGS 2360 AND 2363.
 12. WATER SERVICE LINES SHALL BE REPLACED WHEN THE EXISTING SERVICE LINE IS EITHER GALVANIZED OR LEAD, OR WHEN THE SERVICE LINE MUST BE LENGTHENED TO CONNECT TO THE NEW WATER MAIN PER SECTION 802.4.2 OF THE SPECIFICATIONS.
 13. TACK COAT REQUIREMENTS SHALL BE DETERMINED BY THE CITY ENGINEER.
 14. IT IS THE CONTRACTOR'S RESPONSIBILITY TO LOCATE AND RECONNECT ALL EXISTING SEWER SERVICE CONNECTIONS PER SECTION 905.6. RECONNECTIONS AND TRANSFERS SHALL BE PAID FOR IN ACCORDANCE WITH THE UNIT PRICE LISTED ON THE BID PROPOSAL. HOWEVER, THOSE CONNECTIONS DAMAGED WHILE PERFORMING THE WORK UNDER THIS PROJECT SHALL BE REPLACED AT NO ADDITIONAL COST TO THE CITY.
 15. ALL SANITARY SEWER MANHOLES SHALL BE BUILT IN ACCORDANCE WITH THE CITY OF ALBUQUERQUE STANDARD DRAWING 2102. ALL SANITARY SEWER MANHOLES SHALL BE 4 FEET IN DIAMETER UNLESS OTHERWISE NOTED.
 16. ON EXISTING SEWER MANHOLES THAT ARE TO BE ABANDONED IN PLACE, REMOVE AND RETURN THE EXISTING RING AND COVER AND ABANDON THE MANHOLE AS PER SECTION 920.6.
 17. CONTRACTOR SHALL SUPPORT ALL EXISTING, UNDERGROUND UTILITY LINES WHICH BECOME EXPOSED DURING CONSTRUCTION. PAYMENT FOR SUPPORTING WORK SHALL BE INCIDENTAL TO WATERLINE AND/OR SEWERLINE COSTS.
 18. ALL EXISTING SANITARY SEWER LINES ARE CONCRETE PIPE EXCEPT WHERE NOTED OTHERWISE ON THE PLANS.
 19. THE CONTRACTOR IS HEREBY NOTIFIED OF THE POSSIBILITY OF ELECTRICAL SHOCK WHEN WORKING NEAR EXISTING STEEL LINES. PRECAUTIONS SHALL BE TAKEN TO GROUND ANY STRAY CURRENTS BEFORE SEPARATING STEEL PIPES.
 20. NO SEPARATE PAYMENT WILL BE MADE FOR EXPANSION JOINT MATERIAL NOTED ON THE PLANS. THIS WILL BE CONSIDERED INCIDENTAL TO WATERLINE CONSTRUCTION.
- WARNING - EXISTING UTILITY LINE LOCATIONS ARE SHOWN IN AN APPROXIMATE MANNER ONLY, AND SUCH LINES MAY EXIST WHERE NONE ARE SHOWN. THE LOCATION OF ANY SUCH EXISTING LINES IS BASED UPON INFORMATION PROVIDED BY THE UTILITY COMPANY, THE OWNER, OR BY OTHERS, AND THE INFORMATION MAY BE INCOMPLETE OR MAY BE OBSOLETE BY THE TIME CONSTRUCTION COMMENCES.**
- THE ENGINEER HAS UNDERTAKEN NO FIELD VERIFICATION OF THE LOCATION, DEPTH, SIZE, OR TYPE OF EXISTING UNDERGROUND UTILITY LINES, MAKES NO REPRESENTATION PERTAINING THERETO, AND ASSUMES NO RESPONSIBILITY OR LIABILITY THEREFOR. THE CONTRACTOR SHALL INFORM ITSELF OF THE LOCATION OF ANY UTILITY LINE IN OR NEAR THE AREA OF THE WORK IN ADVANCE OF AND DURING EXCAVATION WORK. THE CONTRACTOR IS FULLY RESPONSIBLE FOR ANY AND ALL DAMAGE CAUSED BY ITS FAILURE TO LOCATE, IDENTIFY, AND PRESERVE ANY AND ALL EXISTING UTILITIES. THE CONTRACTOR SHALL COMPLY WITH STATE STATUTES, MUNICIPAL AND LOCAL ORDINANCES, RULES AND REGULATIONS PERTAINING TO THE LOCATION OF THESE LINES AND FACILITIES, IN PLANNING AND CONDUCTING EXCAVATION, WHETHER BY CALLING OR NOTIFYING THE UTILITIES, COMPLYING WITH "BLUE STAKES" PROCEDURES, OR OTHERWISE.**

FY 1988-1989

WATER & SEWER LINE RENEWAL PROGRAM

AREA II CONSTRUCTION PLANS FOR PUBLIC WORKS DEPARTMENT CITY OF ALBUQUERQUE

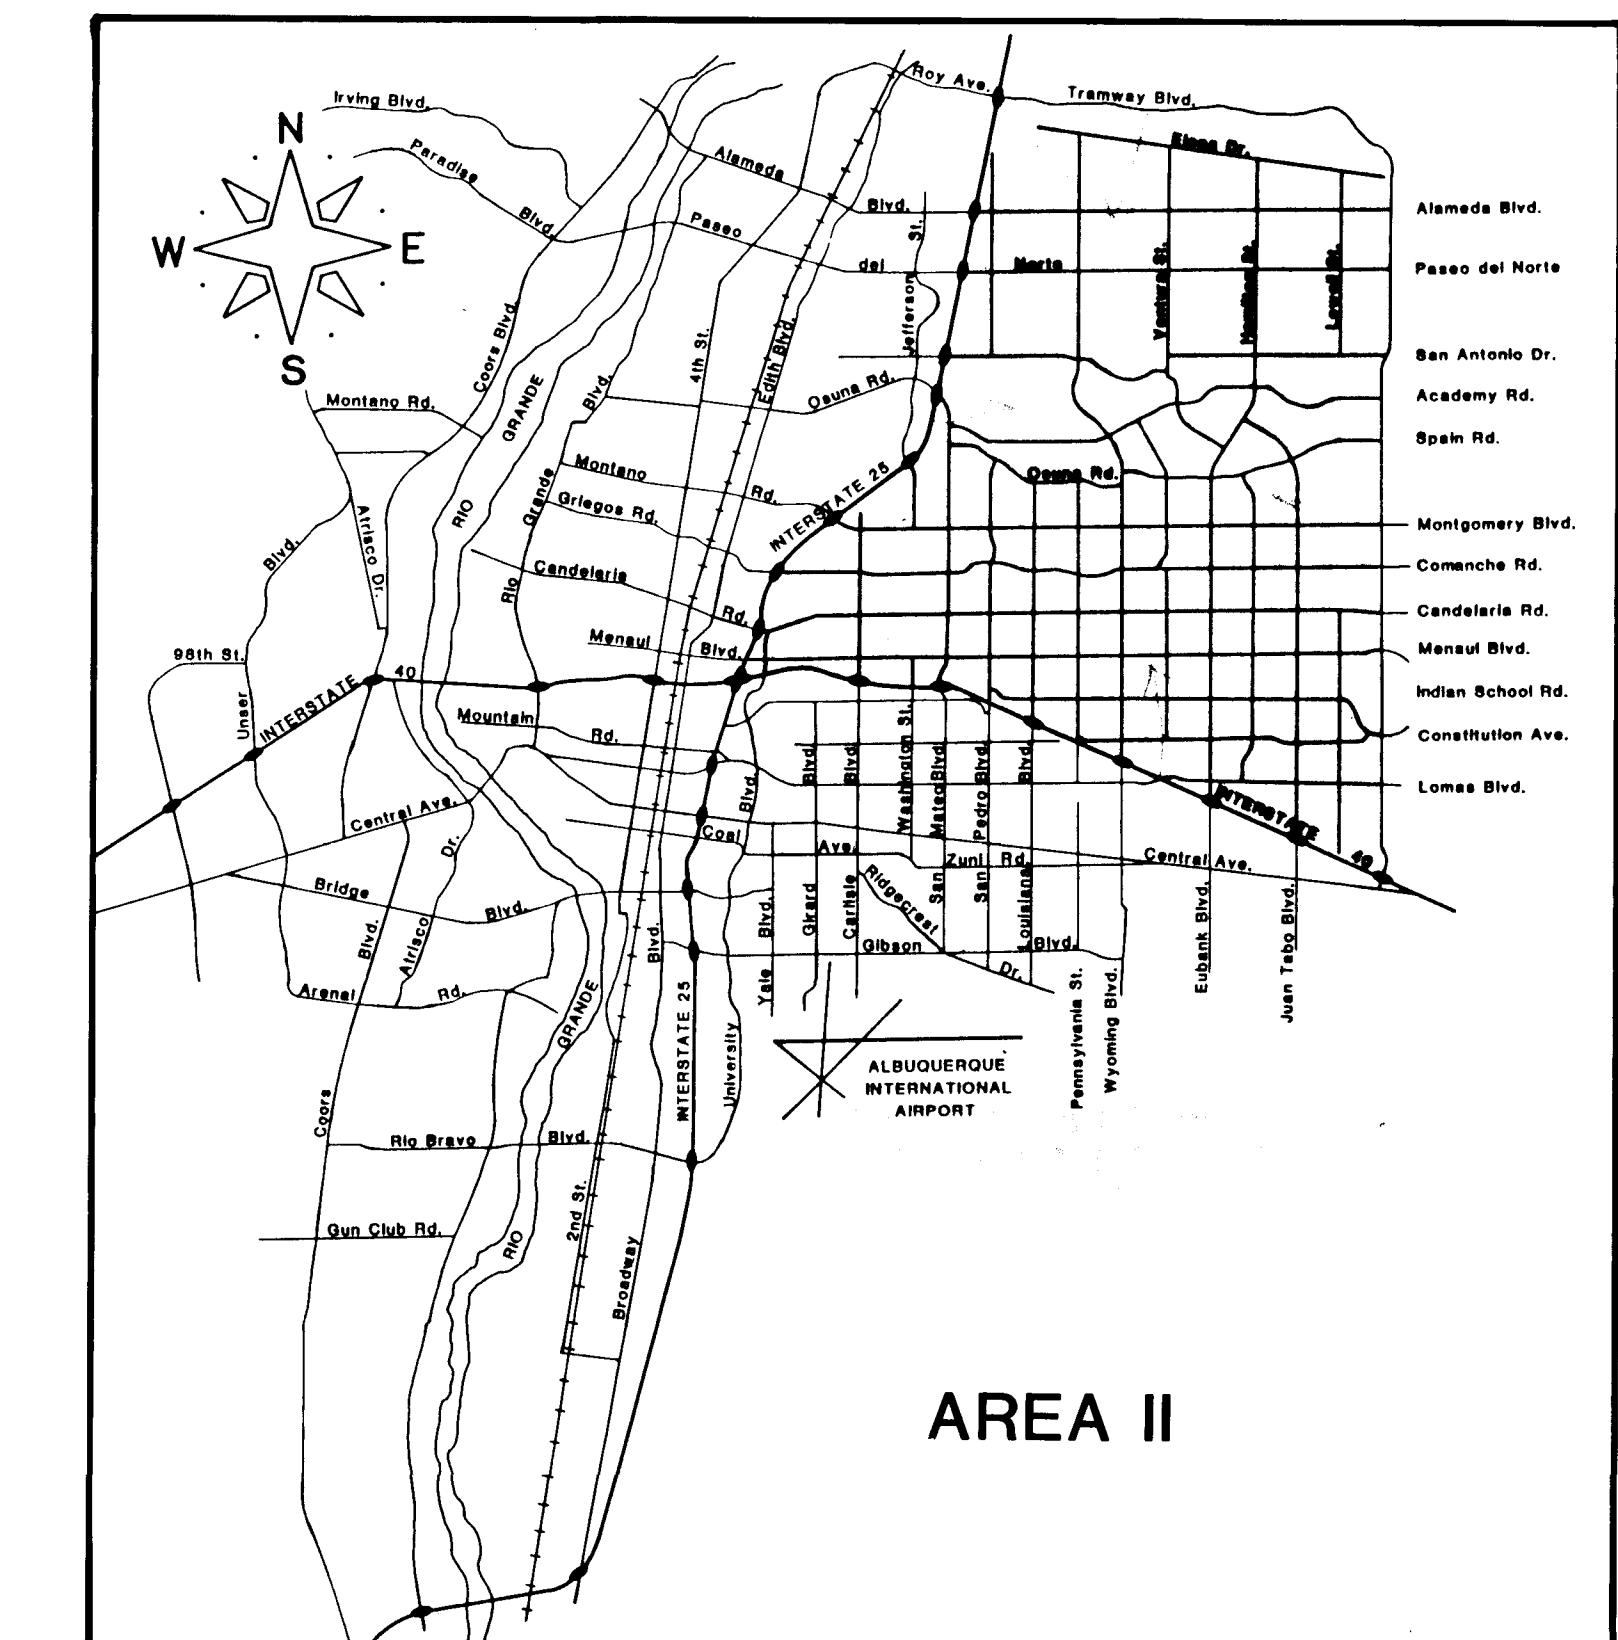**AREA II****TABLE OF CONTENTS**

DESCRIPTION	SHEET NO.
TITLE SHEET & VICINITY MAP	1
LOCATION MAP	2
WATER & SEWER PLAN AND PROFILE SHEETS	3 - 21
WATER VALVE SHUT-OFF PLANS	22
DETAIL SHEET	23
TRAFFIC CONTROL	24

LEGEND

CI	CAST IRON
S,ST	STEEL
PVC	POLYVINYL CHLORIDE
SAS	SANITARY SEWER
SD	STORM DRAIN
OPP	POWER POLE
OHE	OVERHEAD ELECTRIC
HPG	HIGH PRESSURE GAS
EXT	EXISTING
2513	STREET ADDRESS
R&D	REMOVE & DISPOSE
R&R	REMOVE & REPLACE
FL EL	FLANGE ELEVATION
□	WATER METER BOX


→ INDICATES VALVE TO BE CLOSED

COPIED FROM & RECORDS
1 2 3 4 5 6 7 8 9 10 11 12
26 35030193

APPROVAL OF AS PUBL DRAWINGS
CHIEF CONSTRUCTION ENGINEER,
James D. Isaacson
DATE 7-15-83

RECORD DRAWING
WARNING
This is part of a record document. Record documents are based on reports submitted by the contractor. They are not to be used for any other purpose. Users of this document are advised to obtain independent verification of actual conditions.

REV	SHEETS	CITY ENGR	DATE	USER DEPT	DATE	USER DEPT	DATE
APPROVAL OF REVISIONS							

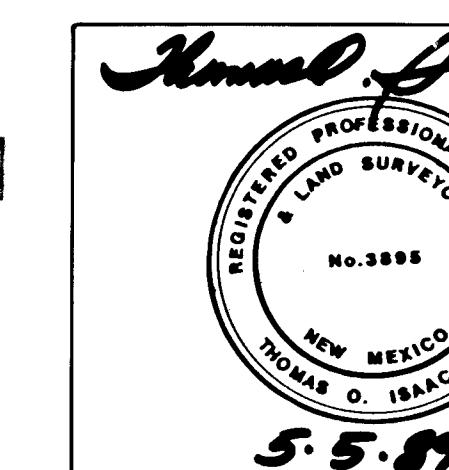

Isaacson & Arfman, P.A.
CONSULTING ENGINEERING ASSOCIATES
Albuquerque, New Mexico

APPROVED FOR CONSTRUCTION
DATE: 12/12/89

DRAWING NO. 3503**SHEET 1 OF 24**


5

G

H

J

K

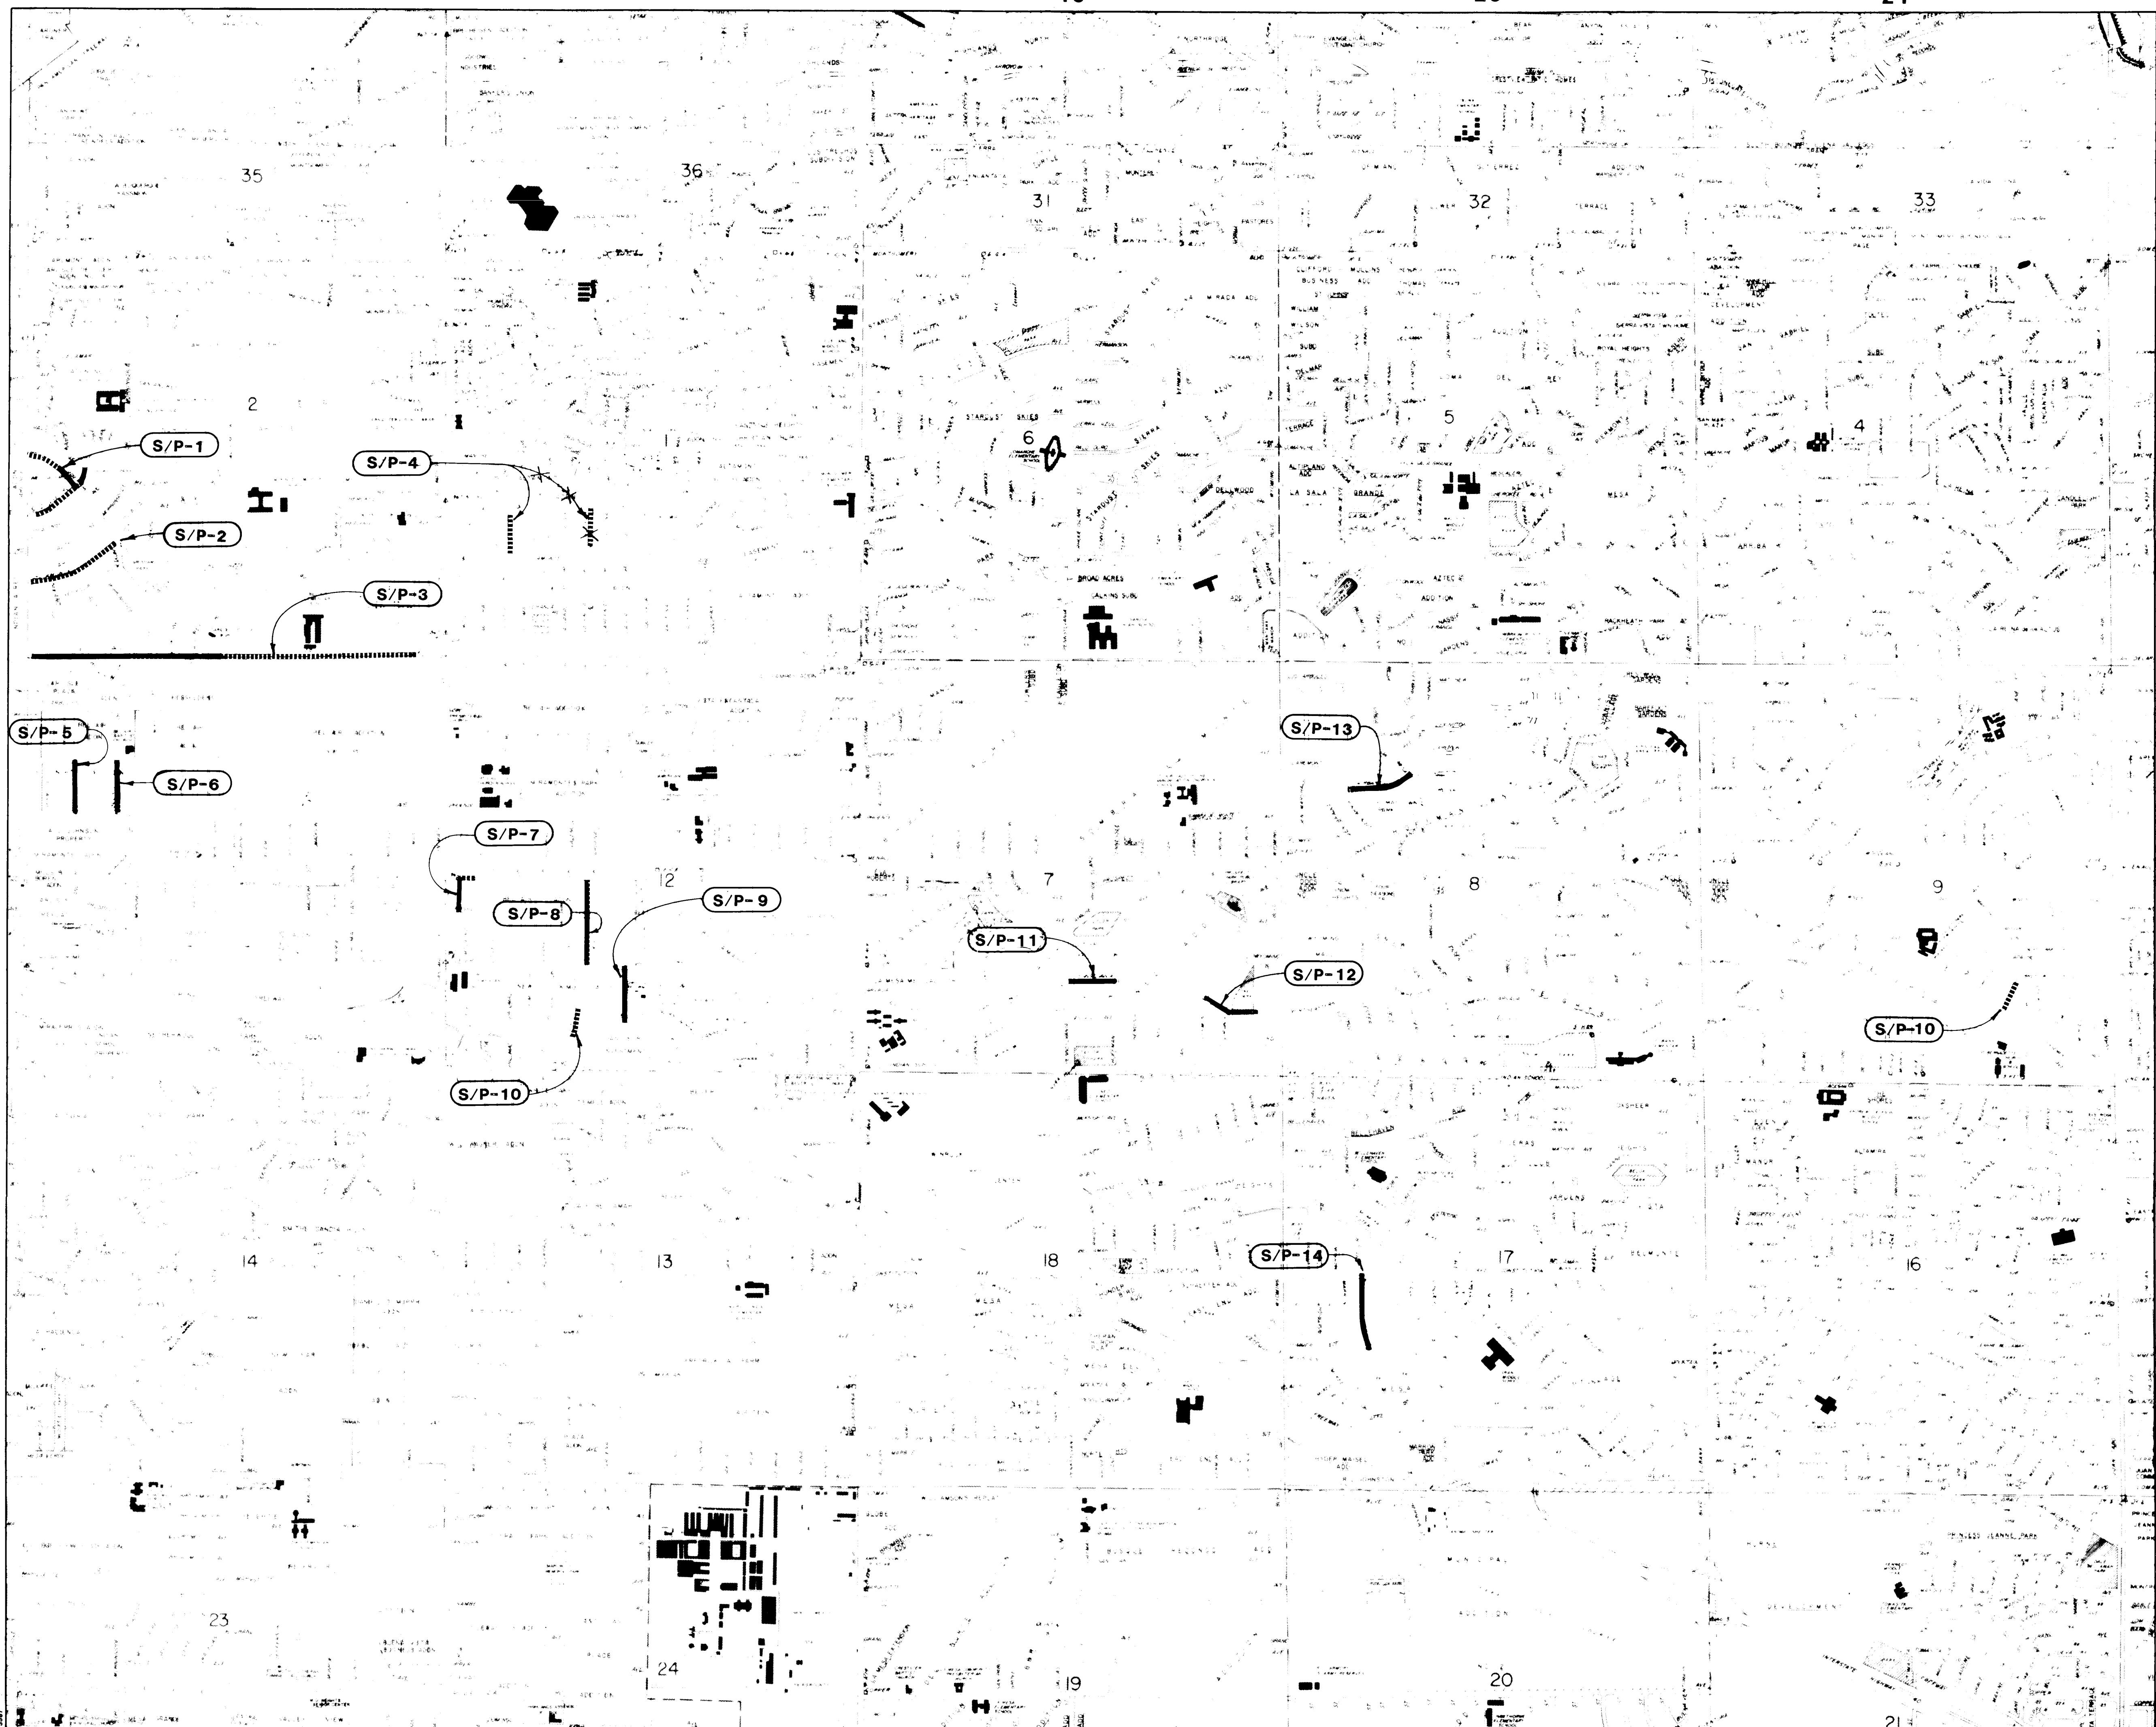

SHEET INDEX

/P O.	SHEET No(s).	STREET NAME
1	3	SHEPARD
1	4	CHEROKEE
2	5&6	ALTA MONTE
3	7-10	CANDELARIA
4	11	LA VETA & VALENCI DELETED
5	12	SOLANO
6	13	BEL AIR
7	14	SAN MATEO E. ALLEY
8	15	VALENCIA E. ALLEY
9	16	CAGUA
10	17	VALENCIA & MARTHA
11	18	PENNSYLVANIA PL.
12	19	CUTLER
13	20	FAIRBANKS
14	21	LUTHY

SCALE:

C of A PWD Maps & Records

LEGEND

- WATERLINE REPLACEMENT
 - SEWERLINE REHABILITATION
 - WATERLINE & SEWERLINE
REPLACEMENT/REHAB.
 - 2 SUBPROJECT WITH NUMBER
 - Z ZONE ATLAS INDEXES

WARNING
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**CITY OF ALBUQUERQUE
PUBLIC WORKS DEPARTMENT
ENGINEERING GROUP**

TITLE: FY 88/89 Waterline & Sewerline Renewal Program, Area II

LOCATION MAP



TES

- SEE SHEET 4 FOR CONTINUATION OF
REHABILITATION WORK ON CHEROKEE RD.

SUPPORT EXISTING GAS LINES IN THE
VICINITY OF STATION 0+50 AND 2+75
IS REQUIRED FOR CONSTRUCTION.

THE EXISTING 4" WATERLINE SHALL BE
MOVED AND DISPOSED OF FROM
APPROXIMATELY STA. 4+15 TO STA.
+65.


ANY PARK FACILITIES DAMAGED BY THE
CONTRACTOR SHALL BE RESTORED AT NO
EXPENSE TO THE CITY.

RECORD DRAWING

WARNING

6-617" SET IN THE FRONTAGE ROAD CONTRACTOR SUNDANCE MECHANICAL
CARLISLE BLVD. OPPOSITE AZTEC WORK STAKES BY G. MARQUEZ DATE 199

WATER VALVE SHUT-OFF PLAN

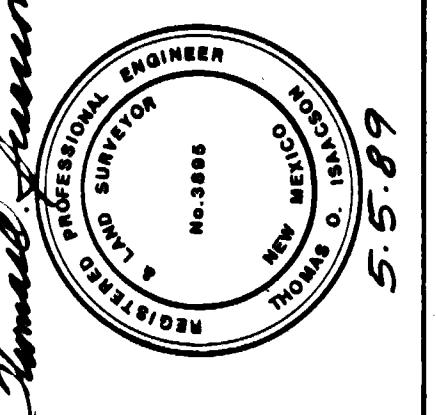

SCALE:
HORIZ. 1" = 50'
VERT 1" = 5'

C of A PWD Maps & Records


The logo consists of a large, solid black right-pointing arrow icon positioned to the left of the company name. To the right of the arrow, the words "CONSULTING ENGINEERING ASSOCIATES" are written in a bold, sans-serif font. Below this, the word "Albuquerque," is centered, and to its right, the words "New Mexico" are also centered.

CITY OF ALBUQUERQUE
PUBLIC WORKS DEPARTMENT
ENGINEERING GROUP

**WATERLINE & SEWERLINE RENEWAL PROGRAM, AREA II
SHEPARD ROAD**

APPROVALS	ENGINEER	DATE	APPROVALS	ENGINEER	DATE
D.R.C. Chair	<i>[Signature]</i>	"	Liquid Waste		
Trans. Dev.	<i>[Signature]</i>	"	Traffic		
Utility Dev.	<i>[Signature]</i>	"	Water		

RAWING O.	3503	MAP NO. G-17	SHEET 3	OF 24
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NOTES

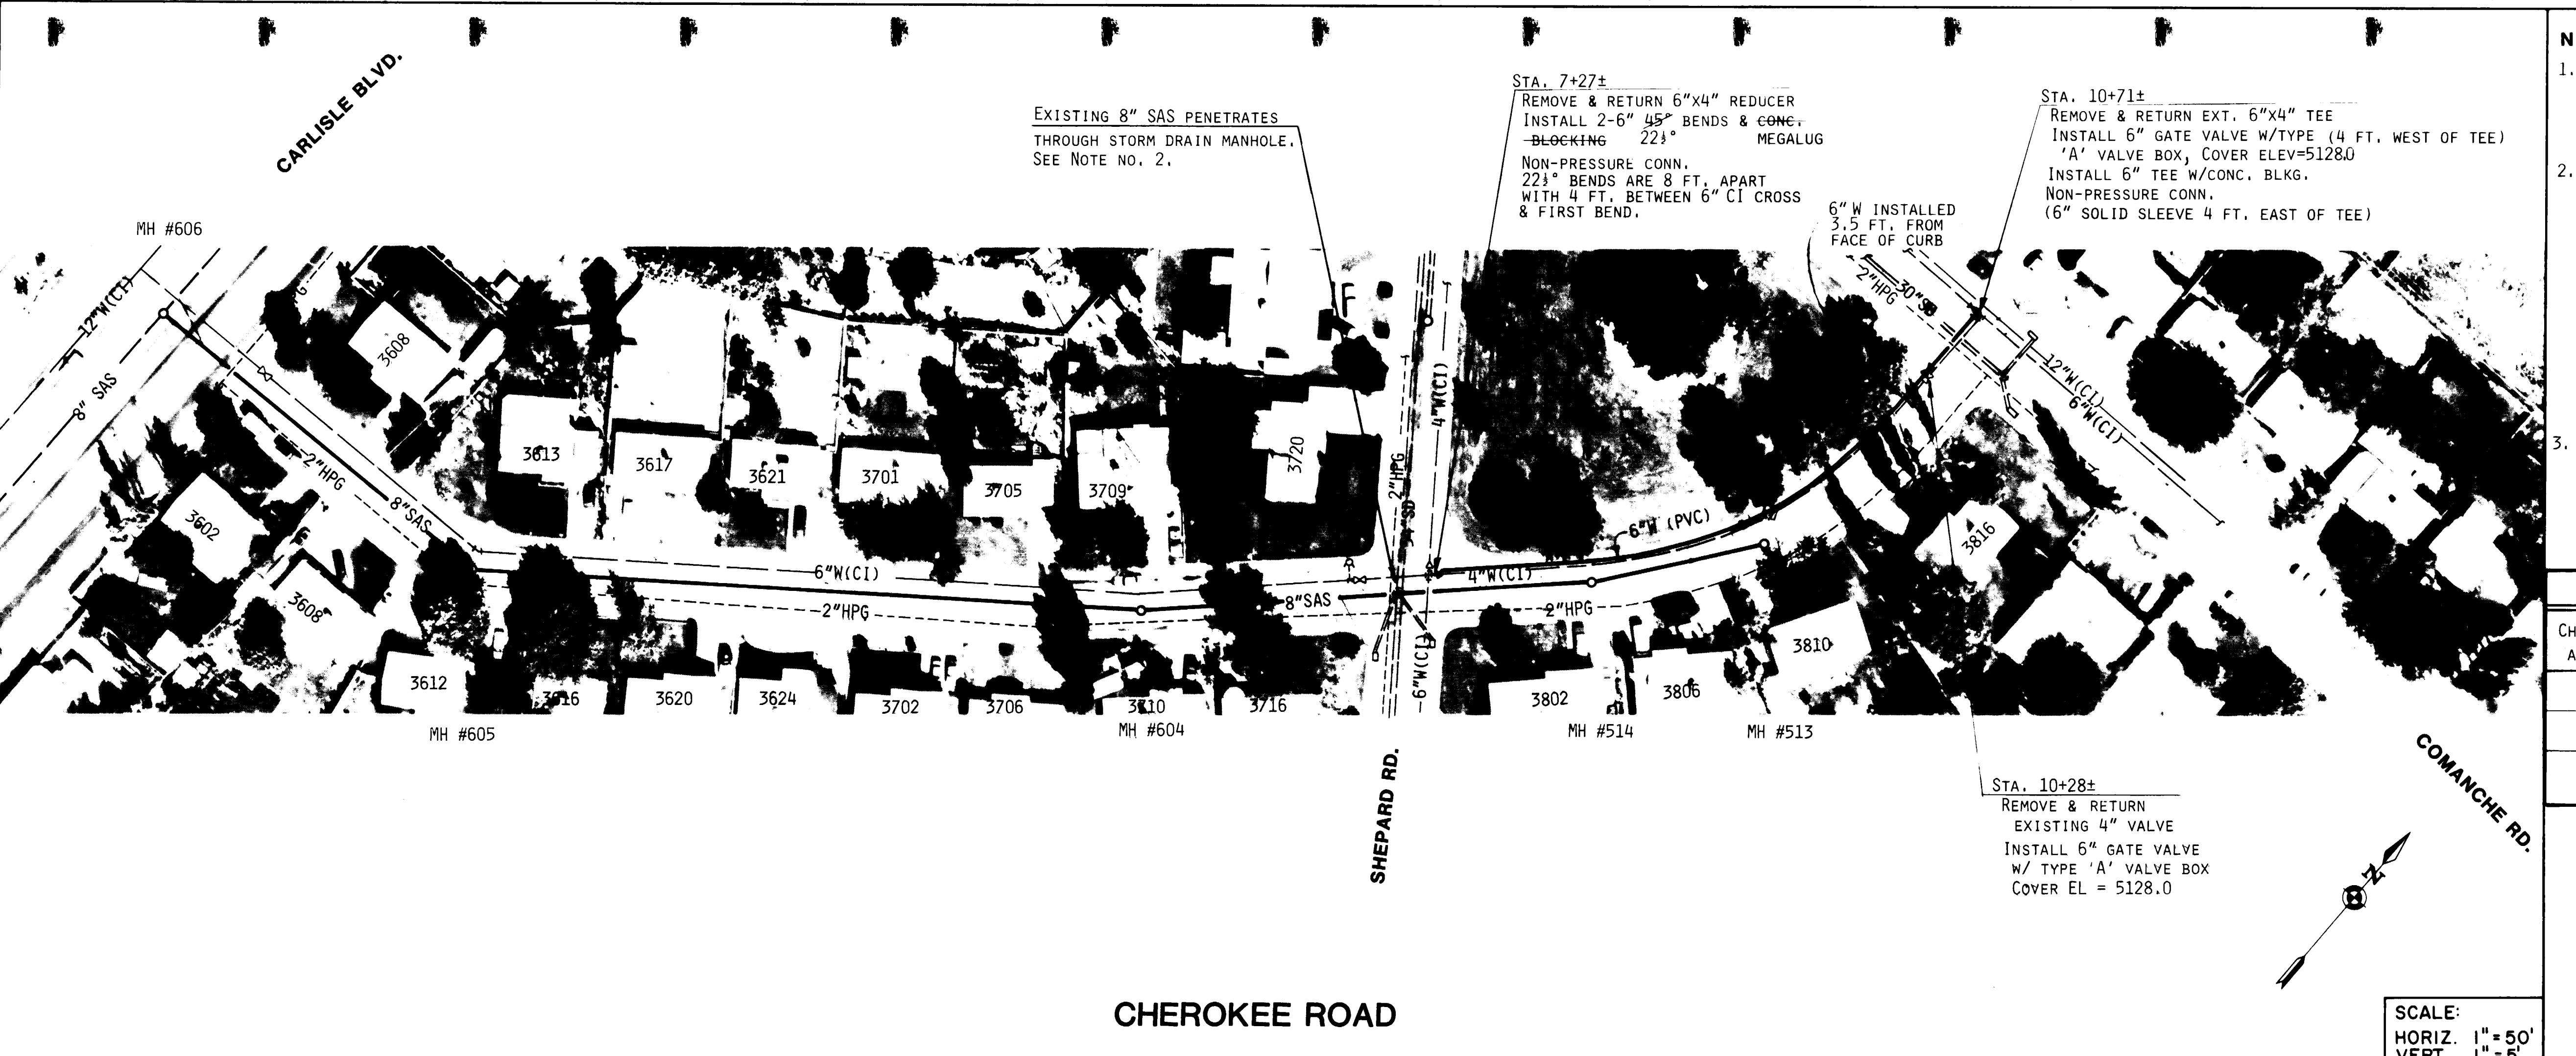- SEE SHEET 3 FOR CONTINUATION OF REHABILITATION WORK ON SHEPARD RD. & WATER VALVE SHUT-OFF PLAN FOR THIS WORK.
- EXISTING SLEEVE USED
THE CONTRACTOR SHALL REMOVE & DISPOSE OF THE DI SANITARY SEWER LINE RUNNING THROUGH THE MANHOLE & REPLACE IT WITH A 10 INCH DIAMETER STEEL CASING. MANHOLE WALLS SHALL BE REPAIRED WITH GROUT. THE BELL END OF THE ADJACENT DOWNGRADE SECTION OF NEW 8" SAS SHALL BE LOCATED WITHIN 5' OF THE STEEL CASTING. THE NEXT LENGTH OF 8" SAS SHALL BE INSERTED THROUGH THE CASING, WITH INSTALLATION THEN PROCEEDING NORMALLY UPGRADE.
- THE EXISTING 4" WATER SHALL BE REMOVED & DISPOSED OF FROM STA. 7+27± TO STA. 10+71±.

WATER SERVICE REHABILITATION					
CHEROKEE ADDRESS	METER SIZE	(1)	(2)	(3)	
3802	3/4"			X	
3806	"			X	
3810	"			X	

- KEY:
- (1) SERVICE LINE TRANSFER
 - (2) METER BOX RELOCATION & REPLACEMENT
 - (3) SERVICE LINE REPLACEMENT


AS BUILT INFORMATION		BENCH MARKS	
NO.	FIELD NOTES	NO.	DATE
S.U.G.	BY	7/88	ROAD TO THE WEST
			ELEVATION: 5136.46
			DRAWINGS BY ALAN O. DATE 4/1991
			CORRECTED BY J. A. DATE 8/91
			RECORDED BY NO


RECORD DRAWING



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Isaacson & Arfman, P.A.
CONSULTING ENGINEERING ASSOCIATES
Albuquerque, New Mexico

CITY OF ALBUQUERQUE PUBLIC WORKS DEPARTMENT ENGINEERING GROUP											
TITLE: FY88-89 WATERLINE & SEWERLINE RENEWAL PROGRAM, AREA II											
APPROVALS		ENGINEER		DATE		APPROVALS		ENGINEER		DATE	
D.R.C. Chair	1	1	1	1	1	1	1	1	1	1	1
Trans. Dev.											
Utility Dev.											
<i>[Handwritten signatures]</i>											
DRAWING NO.	3503	MAP NO.	G-17	SHEET	4	OF	24				



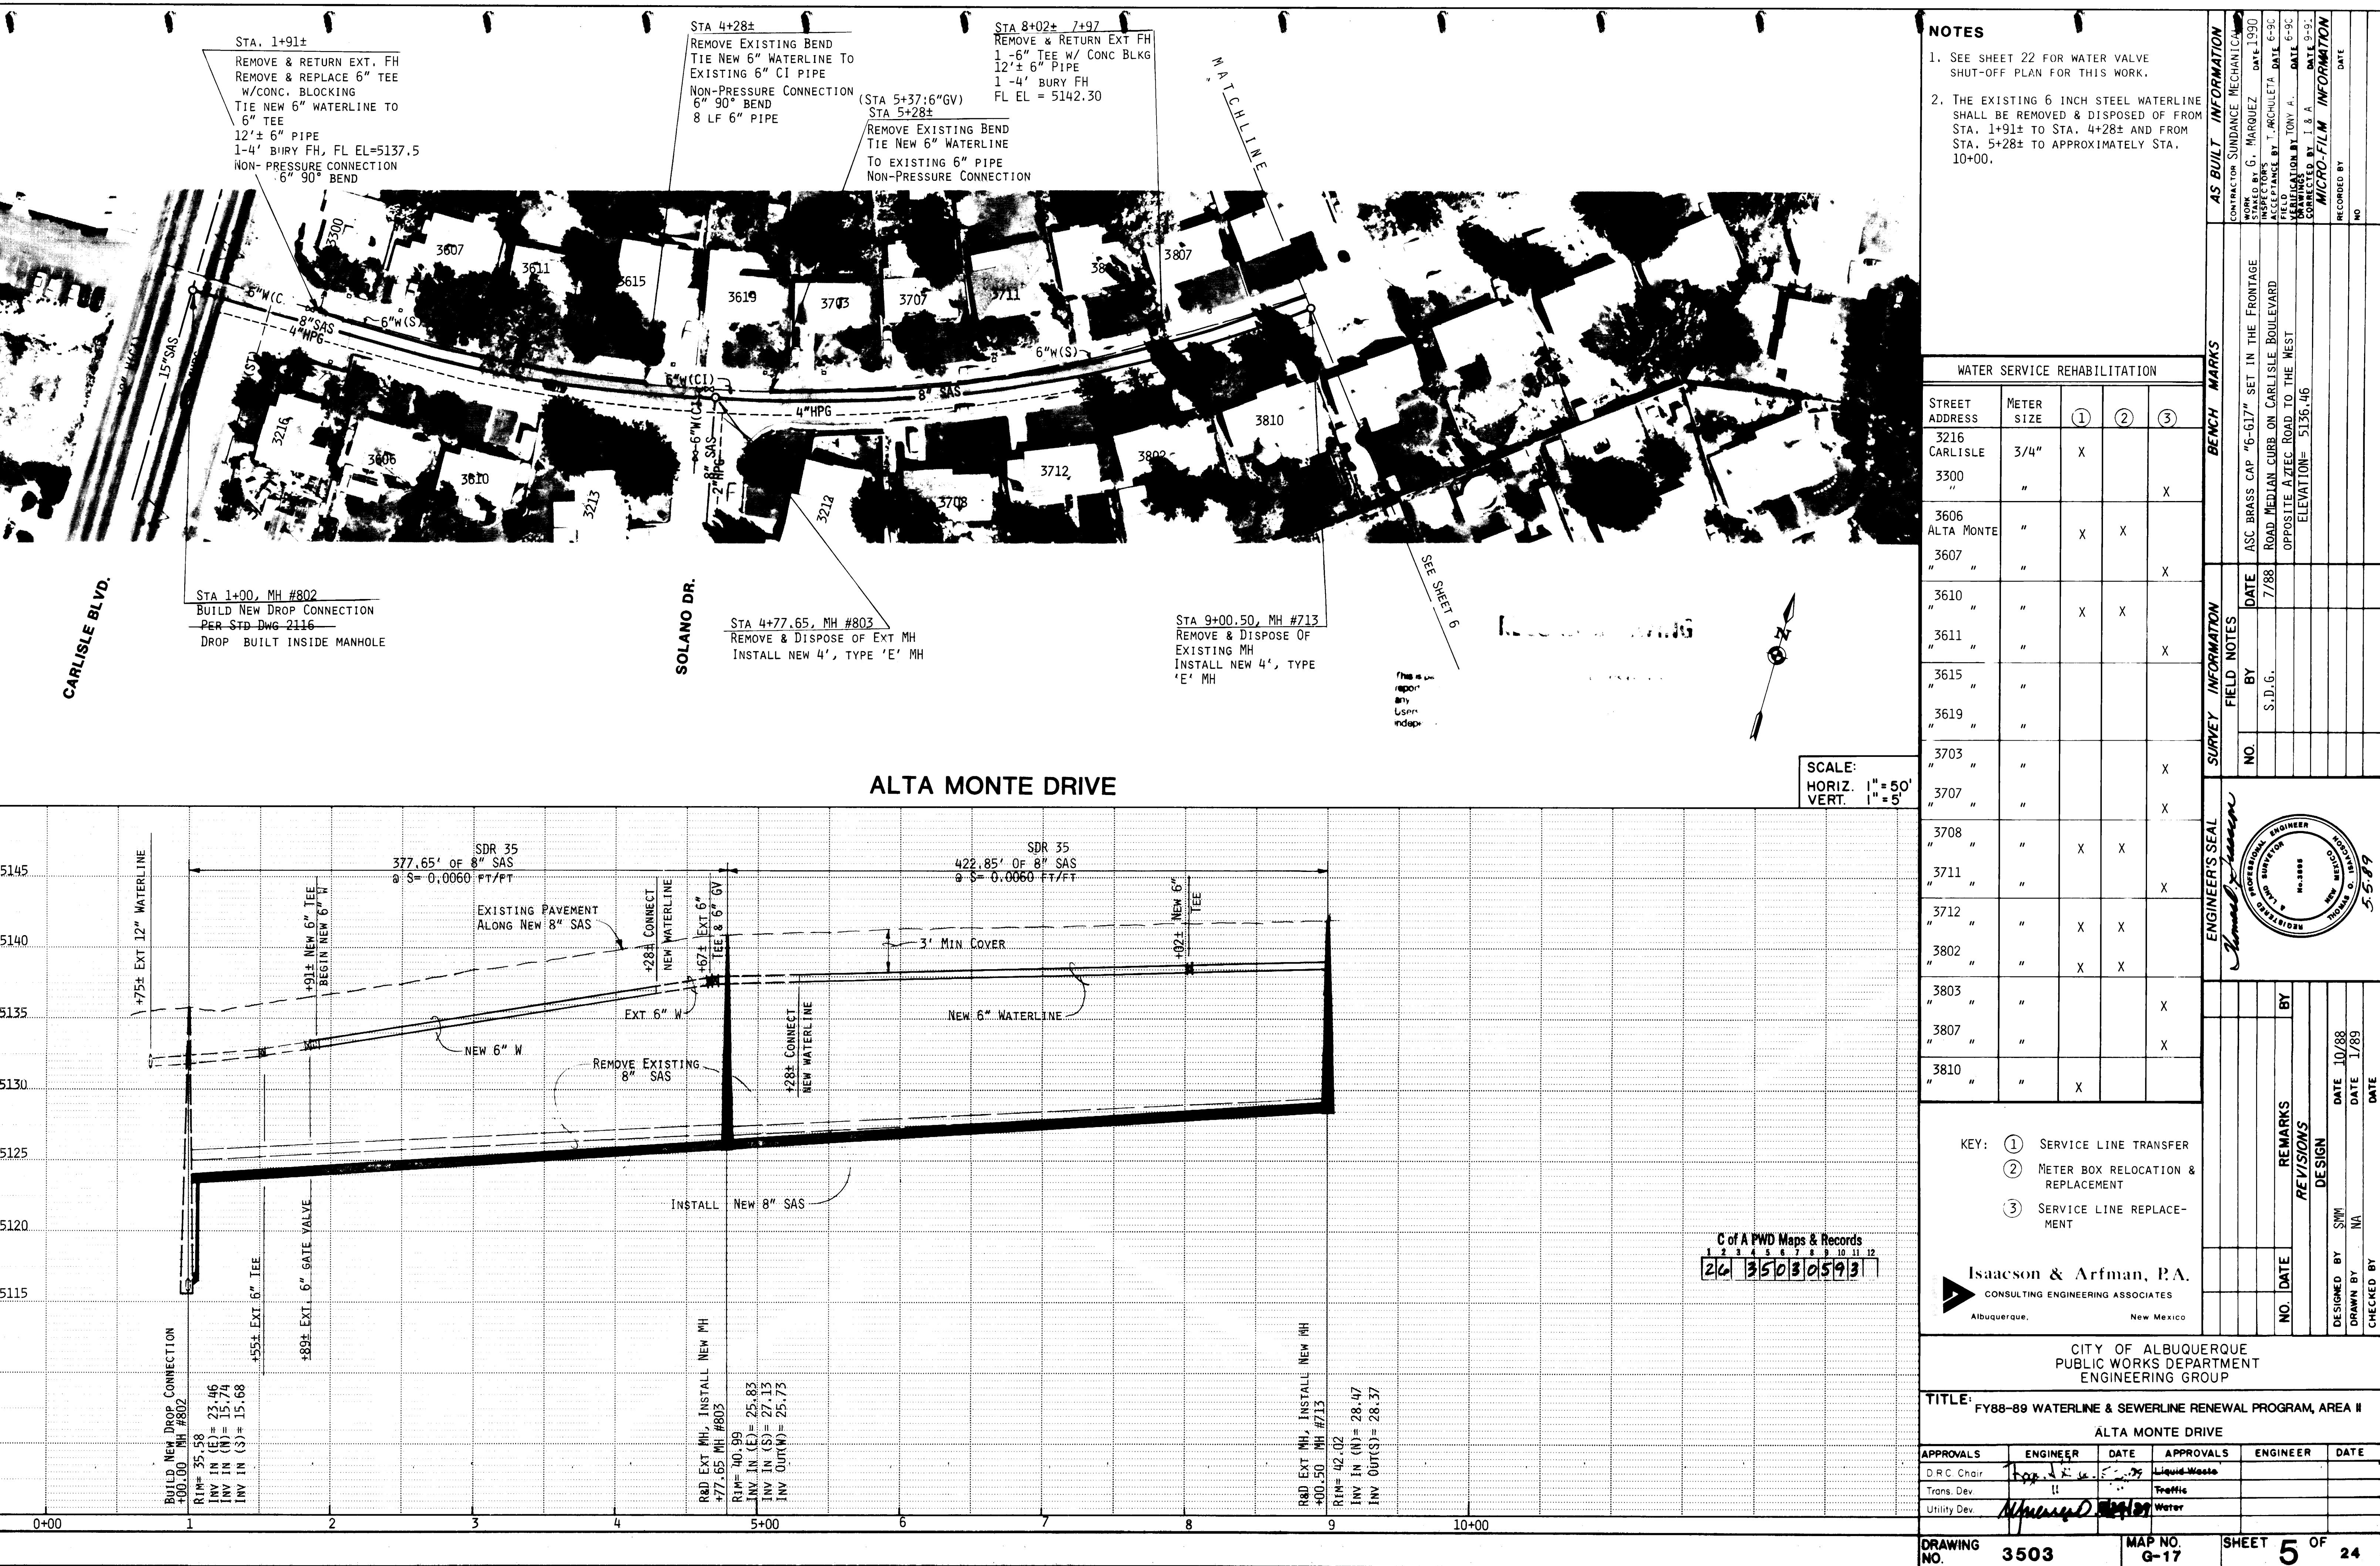

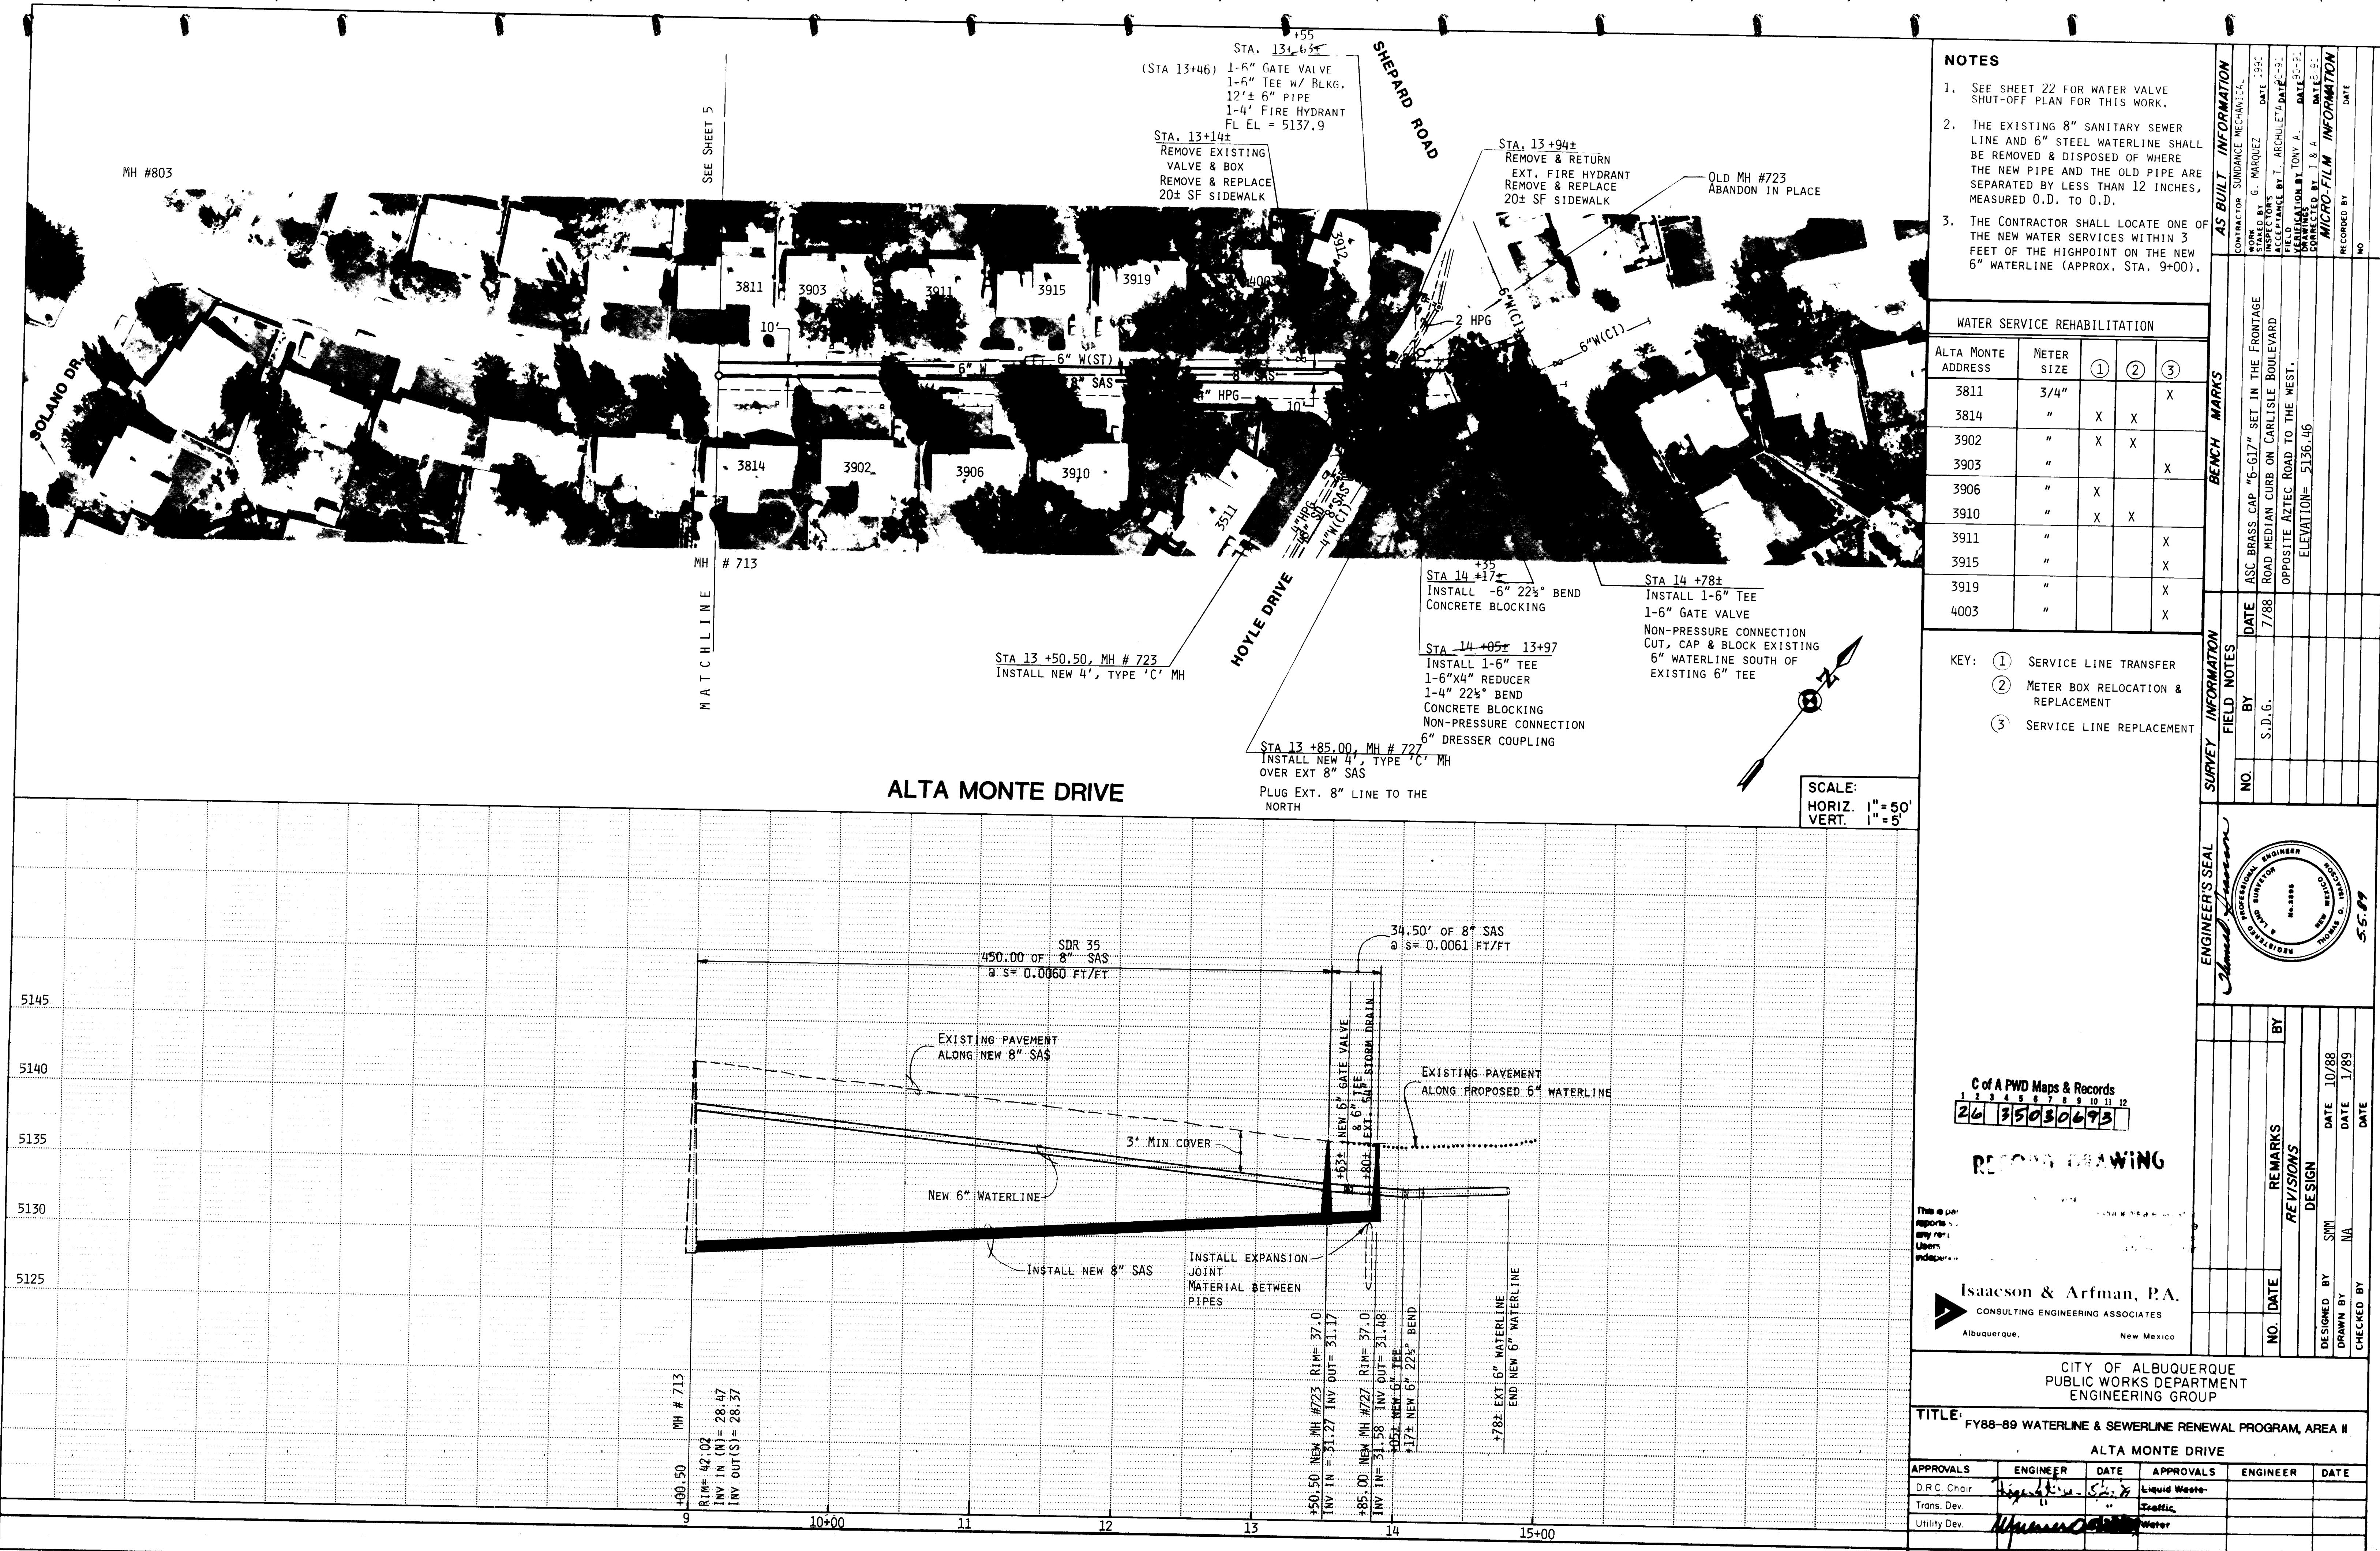

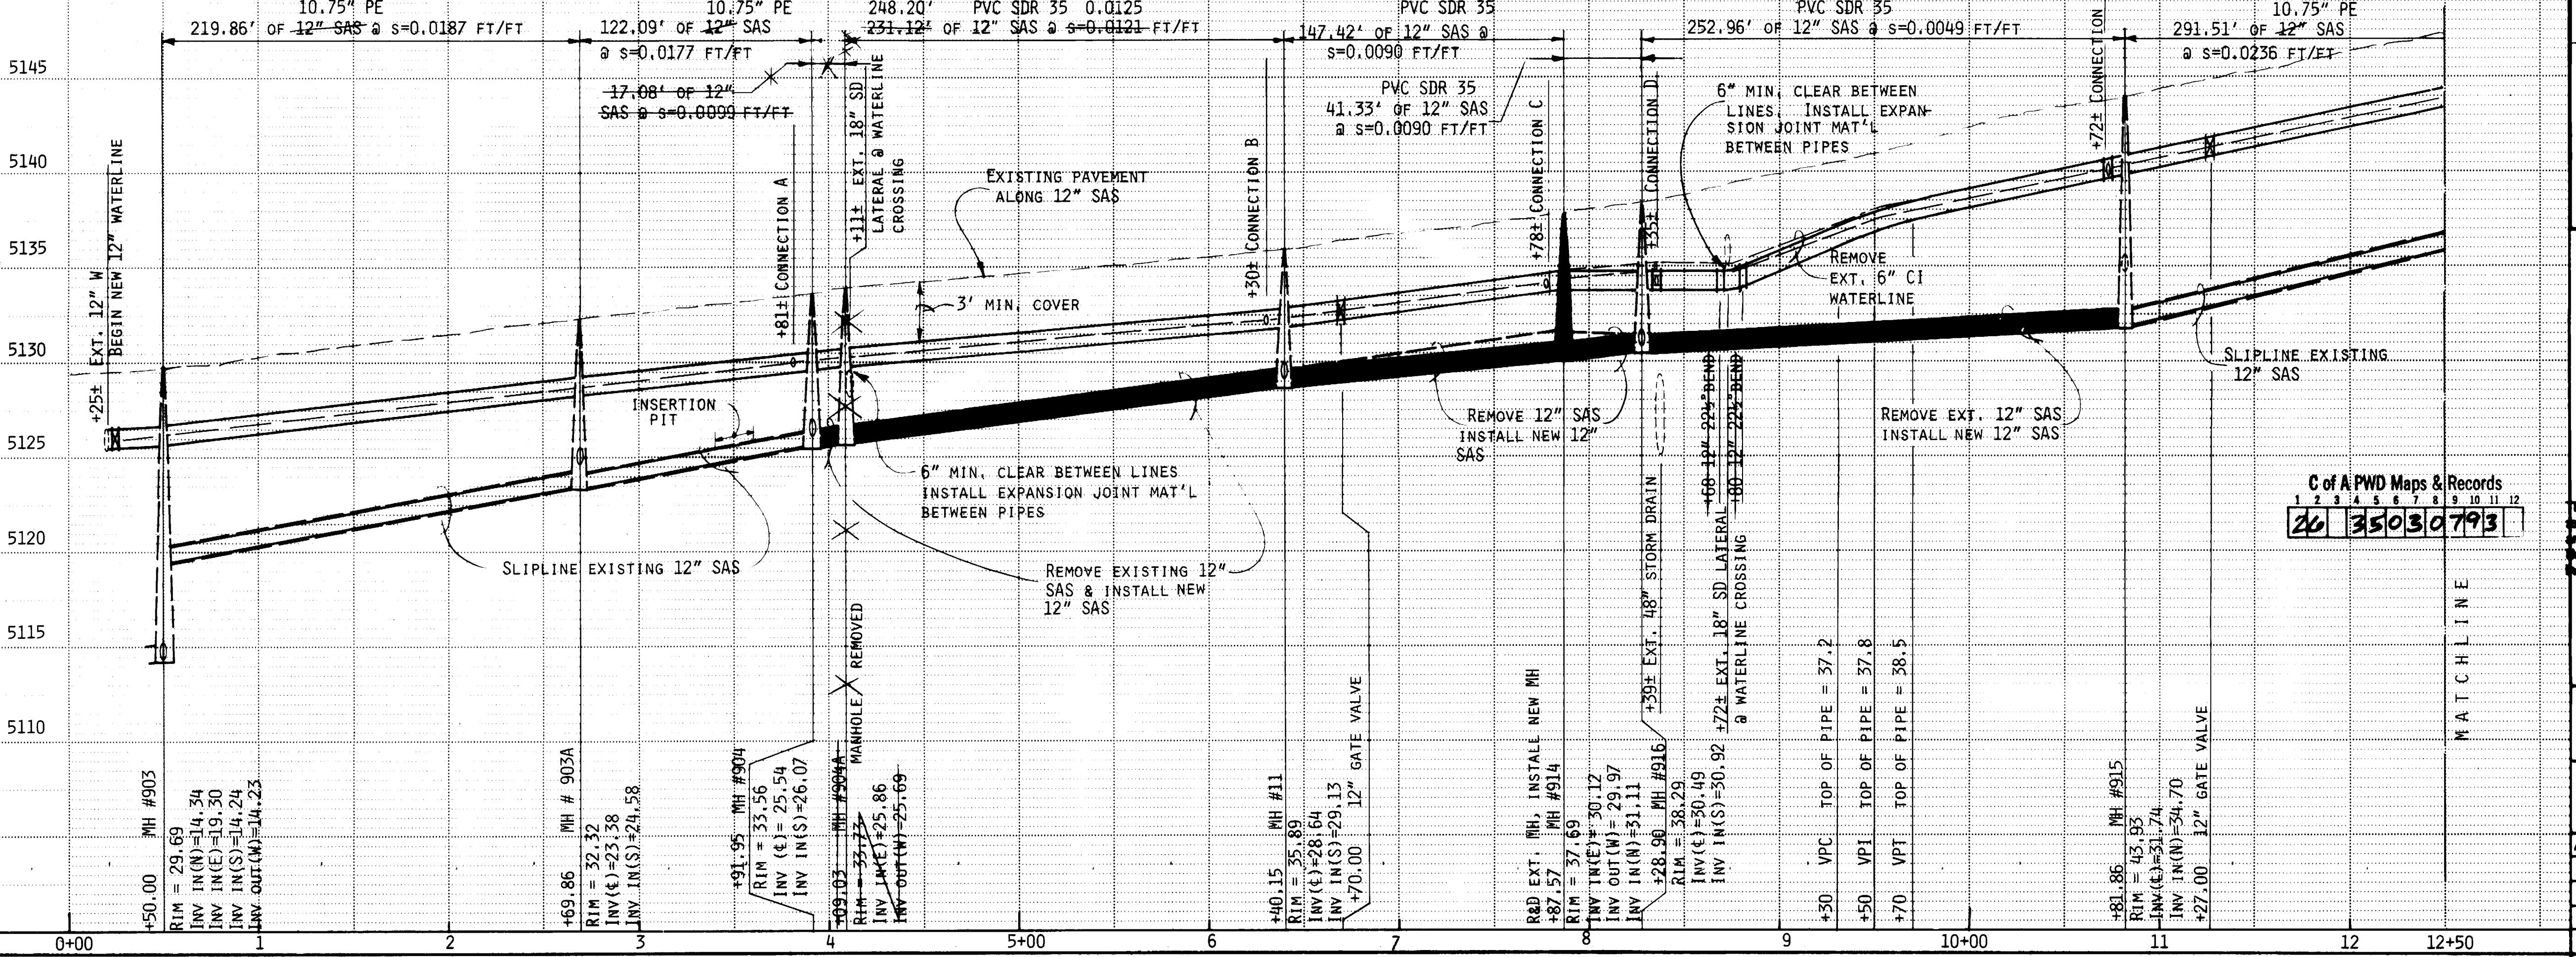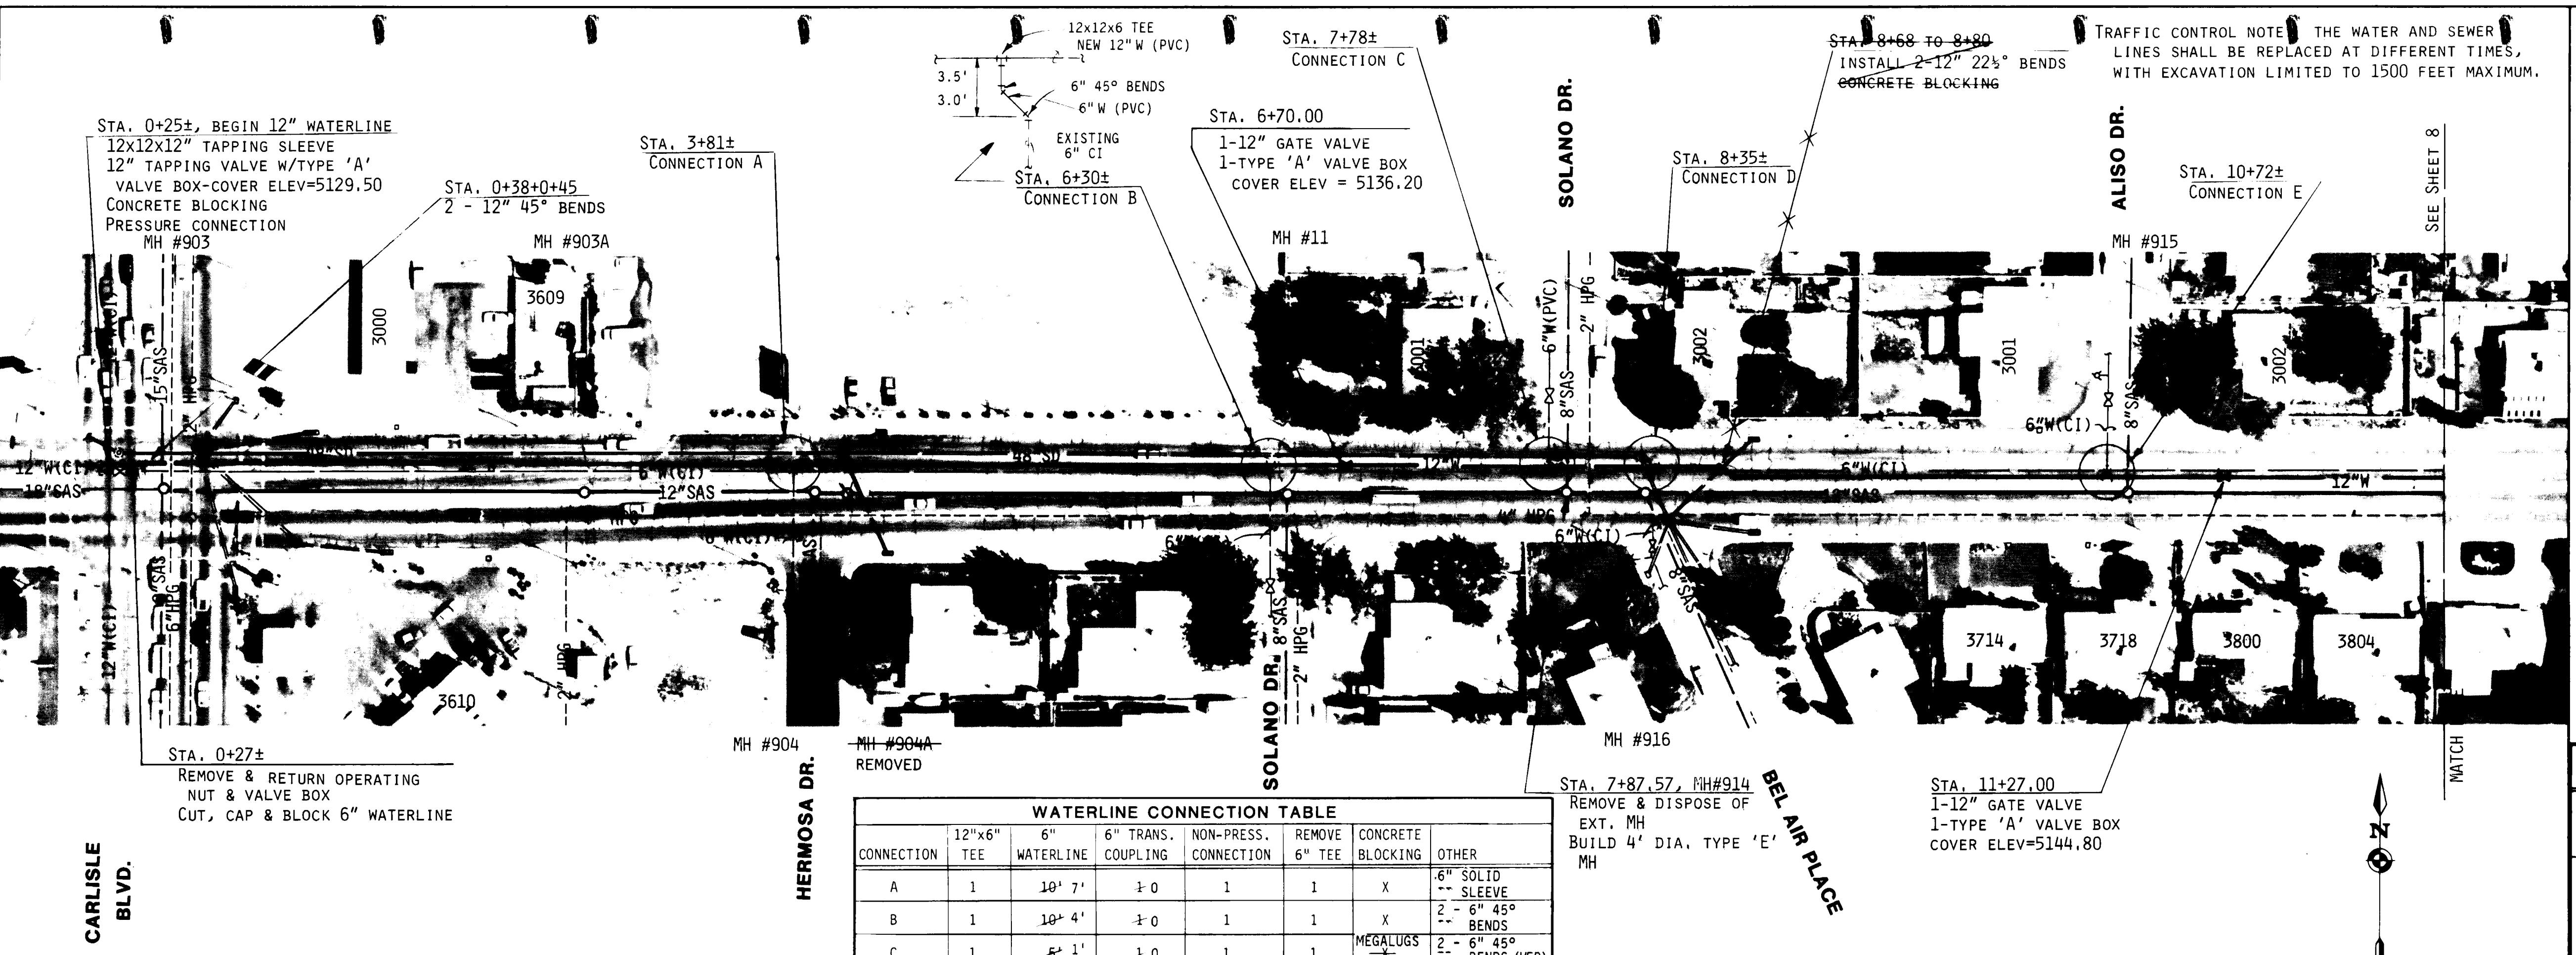- NOTES**
- CONTRACTOR SHALL UNCOVER THE EXISTING 12" WATERLINE IN CARLISLE BLVD. TO VERIFY THE HORIZONTAL POSITION FOR THE PROPOSED TAPPING SLEEVE. IF THE CONNECTION POINT SHIFTS NORTH OR SOUTH, THEN THE 12" WATERLINE SHALL BE DEFLECTED A MAXIMUM OF 3° PER JOINT TO BRING IT TO THE DESIGN ALIGNMENT.
 - CONTRACTOR TO VERIFY EXISTING DEPTH OF 18" STORM DRAIN LATERAL, 6" CAST IRON & 6" STEEL (ABANDONED) WATERLINES AT STA. 8+70. THE PROPOSED 12" WATERLINE SHALL BE INSTALLED DEEPER, BEGINNING AT STA. 7+80, TO AVOID ANY GRADE CONFLICT AT THE PROPOSED CROSSING. NO PAYMENT WILL BE MADE FOR EXPANSION JOINT MATERIAL.
 - THE 12" TAPPING VALVE AT STA. 0+22± WILL BE CONSIDERED AS A 12" GATE VALVE FOR PAYMENT PURPOSES.
 - SEE WATER VALVE SHUT-OFF PLAN ON SHEET 22.
 - THE CONTRACTOR SHALL REMOVE & DISPOSE OF THE 6-INCH WATERLINE FROM STA. 0+27± TO STA. 24+99±.

WATER SERVICE REHABILITATION			BENCH MARKS		
STREET ADDRESS	METER SIZE	(1)	(2)	(3)	AC'S BRASS CAP "I-617" LOCATED IN THE MEDIAN
3001 SOLANO	3/4"			X	ON CARLISLE BLVD, 42 FEET NORTH OF THE CENTER
3002 SOLANO	"	X			LINE OF CANDELARIA RD, NE
3001 ALISO	"			X	HEAD OF CANDELARIA RD, NE
3002 ALISO	"			X	ELEVATION: 5130.11
3000 CARLISLE	"	X	X		
CANDELARIA 3609	"		X	X	
3610	"	X			
3714	"	X		X	
3718	"			X	
3800	"	X		X	
3804	"	X	X		

SCALE:
HORIZ. 1" = 50'
VERT. 1" = 5'

KEY:

- (1) SERVICE LINE TRANSFER
- (2) METER BOX RELOCATION & REPLACEMENT
- (3) SERVICE LINE REPLACEMENT

RECORD DRAWING

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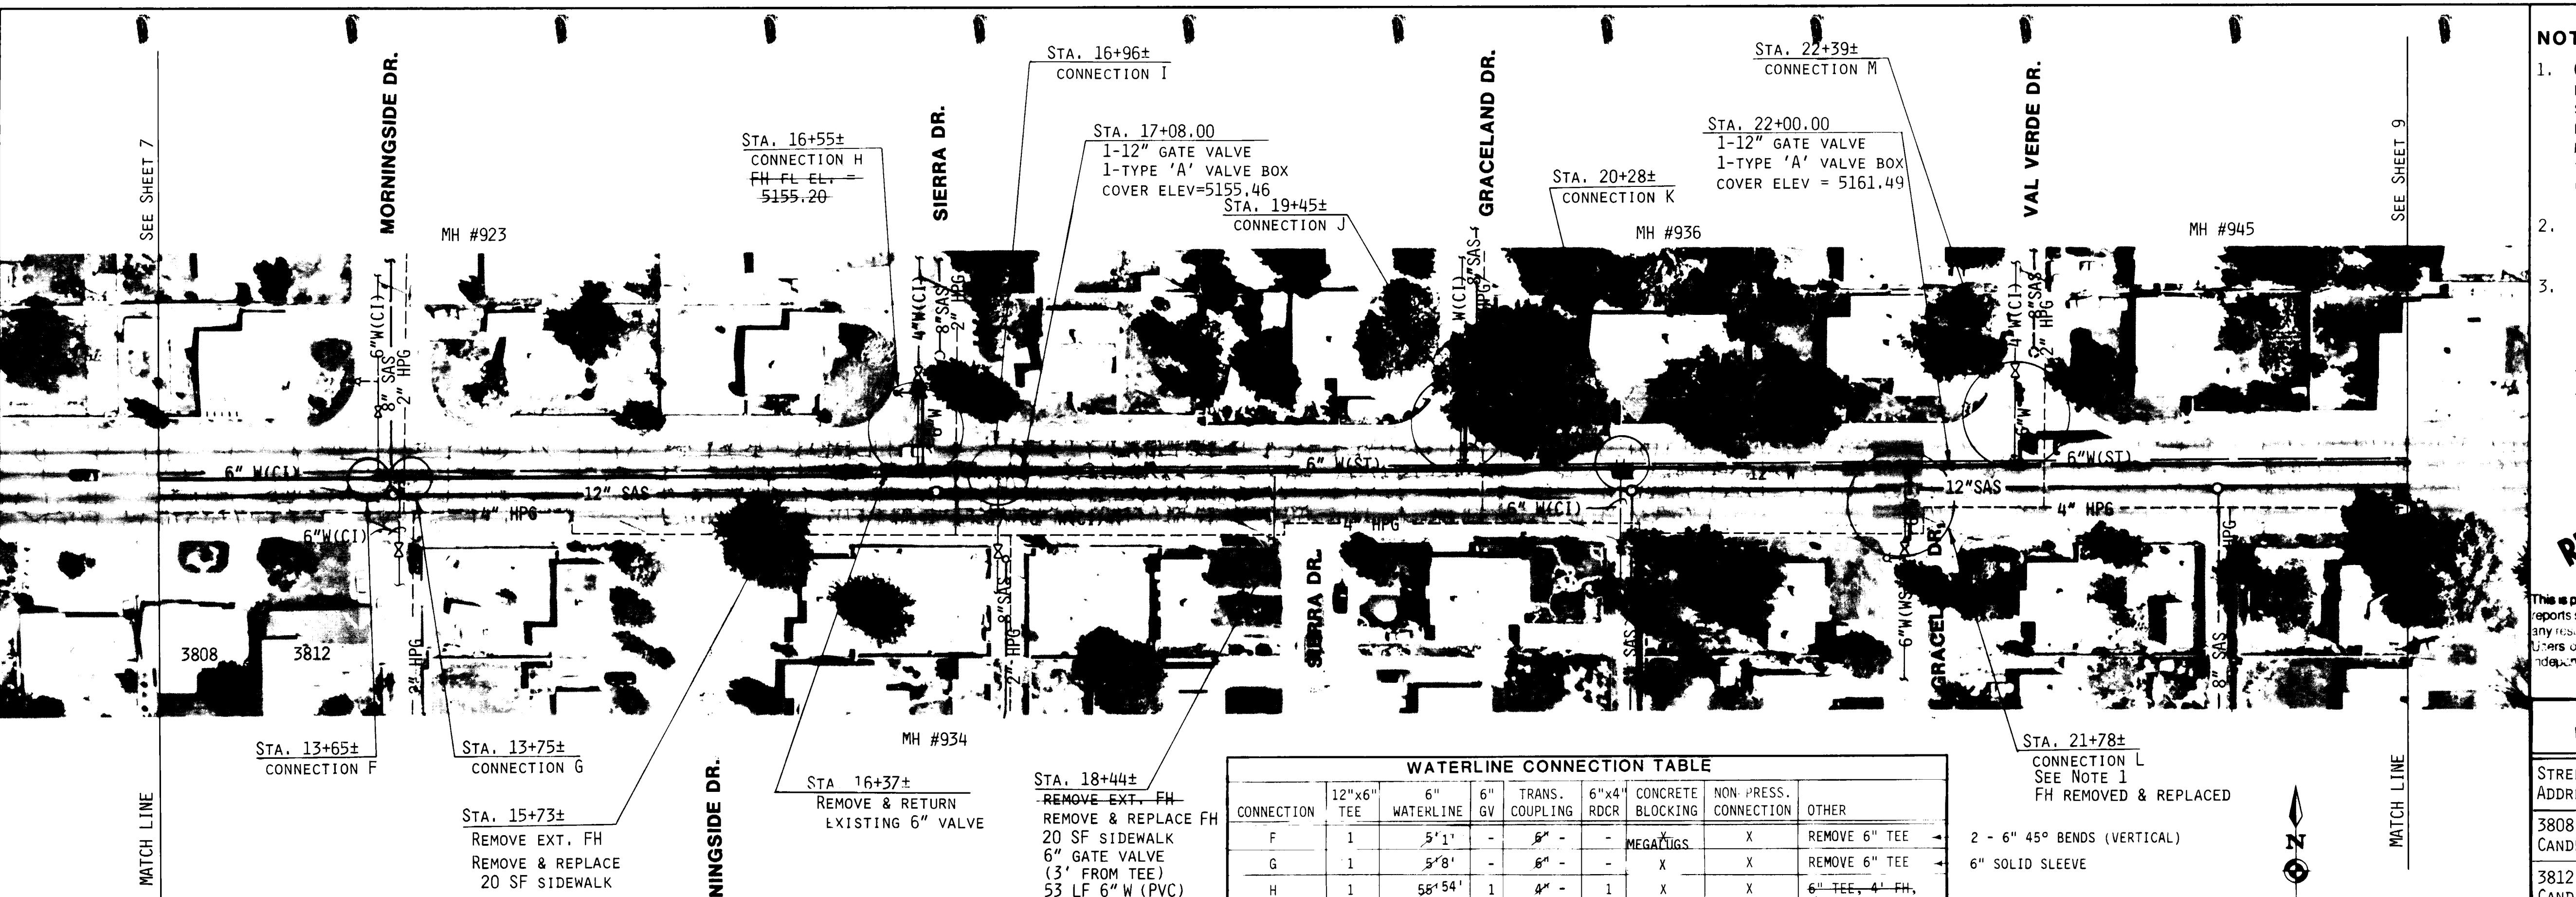
Isaacson & Arfman, P.A.
CONSULTING ENGINEERING ASSOCIATES
Albuquerque, New Mexico

CITY OF ALBUQUERQUE
PUBLIC WORKS DEPARTMENT
ENGINEERING GROUP

TITLE: FY88-89 WATERLINE & SEWERLINE RENEWAL PROGRAM, AREA II
CANDELARIA ROAD STA. 0+00 to 12+50


APPROVALS	ENGINEER	DATE	APPROVALS	ENGINEER	DATE
O.R.C. Chair	John [Signature]	10/88	Land Waste		
Trans. Dev.	Mike [Signature]	10/88	TRAFFIC		
Utility Dev.	Alfredo [Signature]	10/88	Water		

DESIGNED BY: SMM **DRAWN BY:** NA **CHECKED BY:** DATE 10/88
DATE 1/89



CANDELARIA ROAD

*SEE NOTE STRIP AT RIGHT

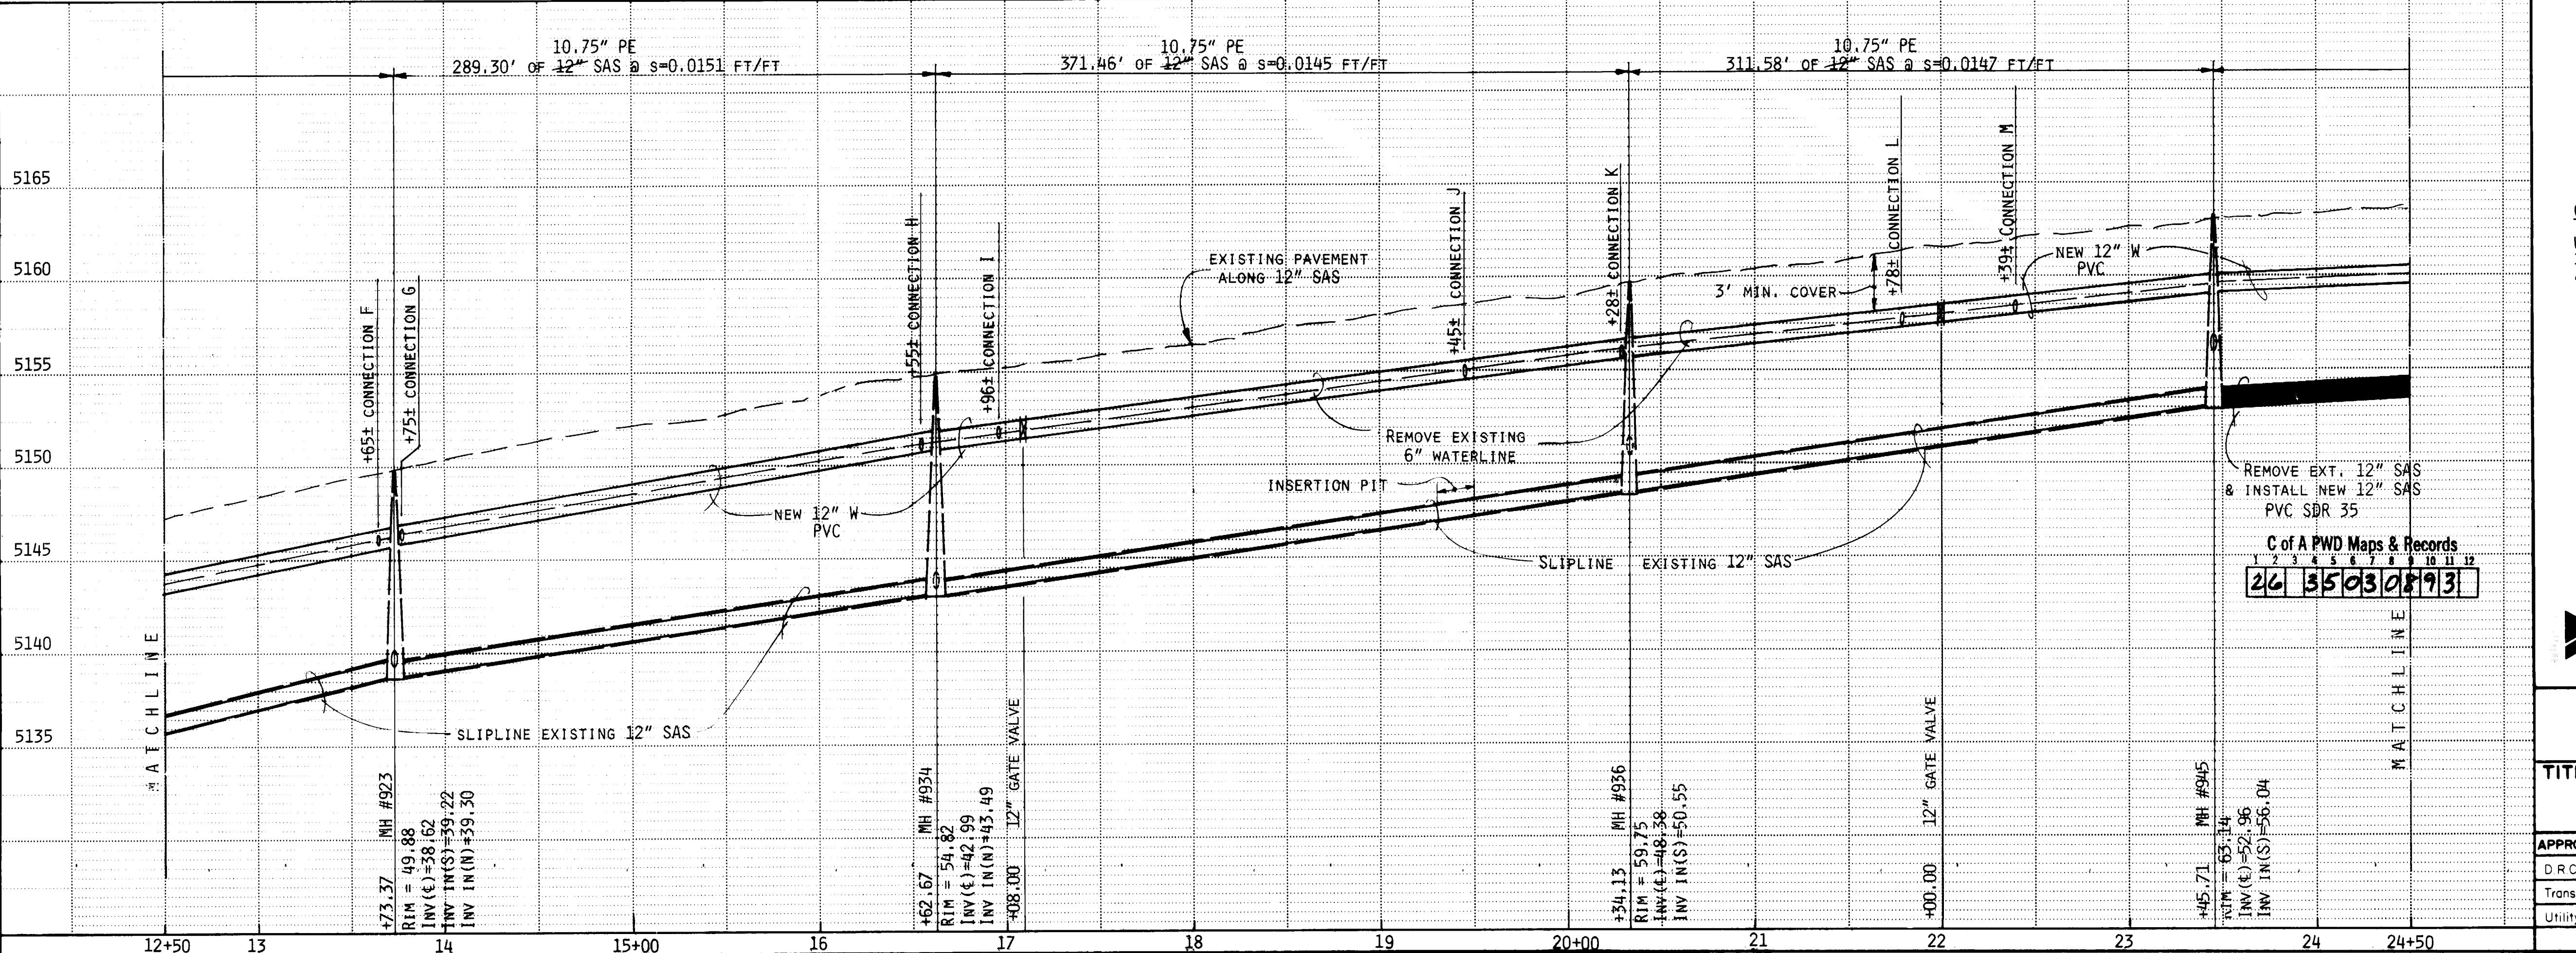


NOTES					
1.	CONTRACTOR SHALL VERIFY WATERLINE PIPE MATERIAL TYPE IN GRACELAND DR. SOUTH OF CANDELARIA. IF A PREVIOUS REPLACEMENT TO CI PIPE HAS BEEN MADE, THEN CONNECTION L REQUIRES THE SAME TYPE TIE-IN DETAILED FOR CONNECTION K.				
2.	SEE WATER VALVE SHUT-OFF PLAN ON SHEET 22.				
3.	THE EXISTING FIRE HYDRANTS ON THE SOUTH SIDE OF CANDELARIA AT MORNINGSIDE AND SIERRA SHALL BE REMOVED AND REPLACED WITH ONE HYDRANT ON THE NORTH SIDE OF CANDELARIA AT SIERRA DRIVE.				
RECORD DRAWING					
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WATER SERVICE REHABILITATION					
STREET ADDRESS	METER SIZE	(1)	(2)	(3)	
3808 CANDELARIA	3/4"	X	X		
3812 CANDELARIA	"			X	


ENGINEER'S SEAL	SURVEY INFORMATION	FIELD NOTES	DATE
	NO. S.D.G.	BY 7/88	IN THE SW QUADRANT OF THE CURB SET FLUSH WITH THE Curb
			GRACELAND DR. AND CANDELARIA RD. NE
			ELEVATION = 5161.13
REVISIONS	BY	REMARKS	DATE
DESIGNED BY SMITH	DATE 10/88		DATE 1/89
DRAWN BY NA			
CHECKED BY			


TITLE: FY88-89 WATERLINE & SEWERLINE RENEWAL PROGRAM, AREA II											
CANDELARIA ROAD STA. 12+50 TO STA. 24+50											
APPROVALS	ENGINEER	DATE	APPROVALS	ENGINEER	DATE						
D.R.C. Chair		10/19	Liquid Waste								
Trans. Dev.		10/19	Traffic								
Utility Dev.		10/19	Water								
DRAWING NO. 3503						MAP NO. G-17					
SHEET 8 OF 24											

AS BUILT INFORMATION					
CONTRACTOR	SUNDANCE MECHANICAL	WORK DO.	G. MARQUEZ	DATE	1990
INSPECTORS	B.M., TENORIO	ACCEPTANCE	DATE	6/90	
FIELD	MIKE T.	RECALL	DATE	9/90	
CONNECTED BY	I & A	DATE	8/91		
MICRO-FILM INFORMATION					
RECORDED BY	NO				

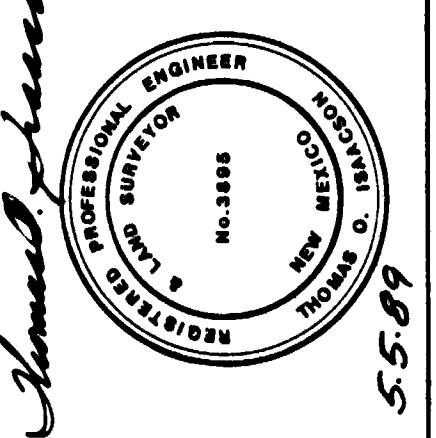


5589

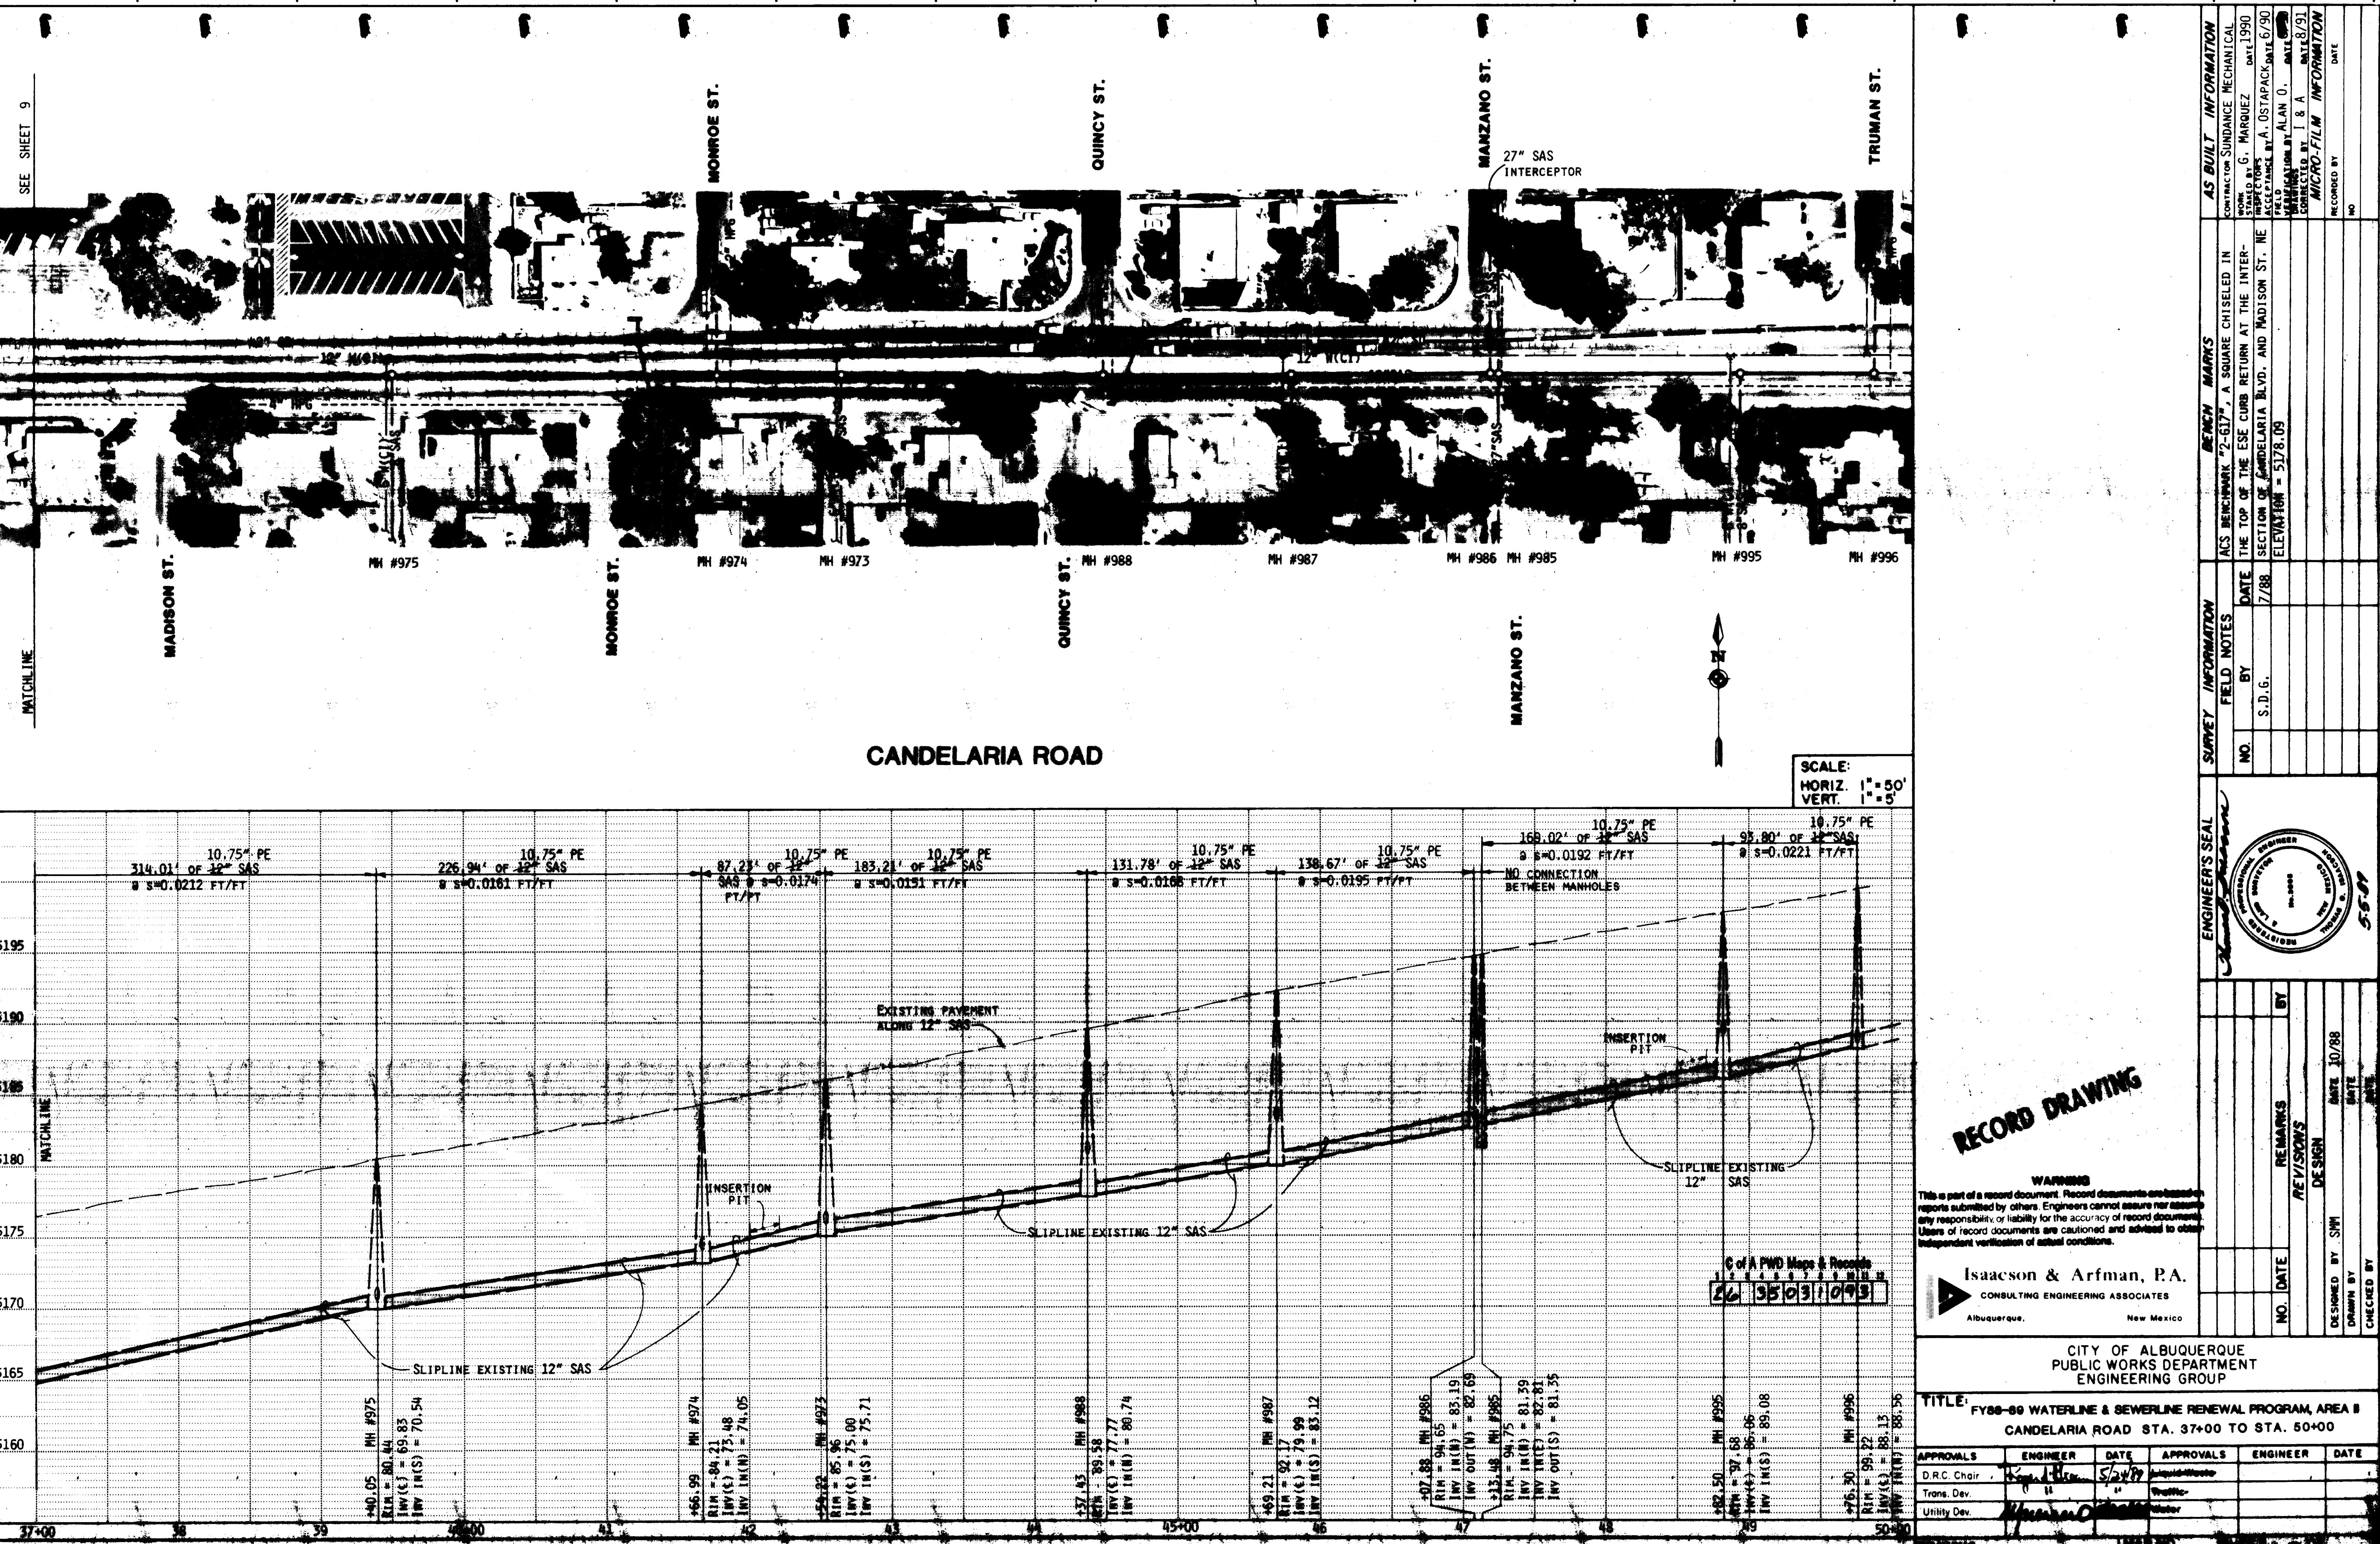

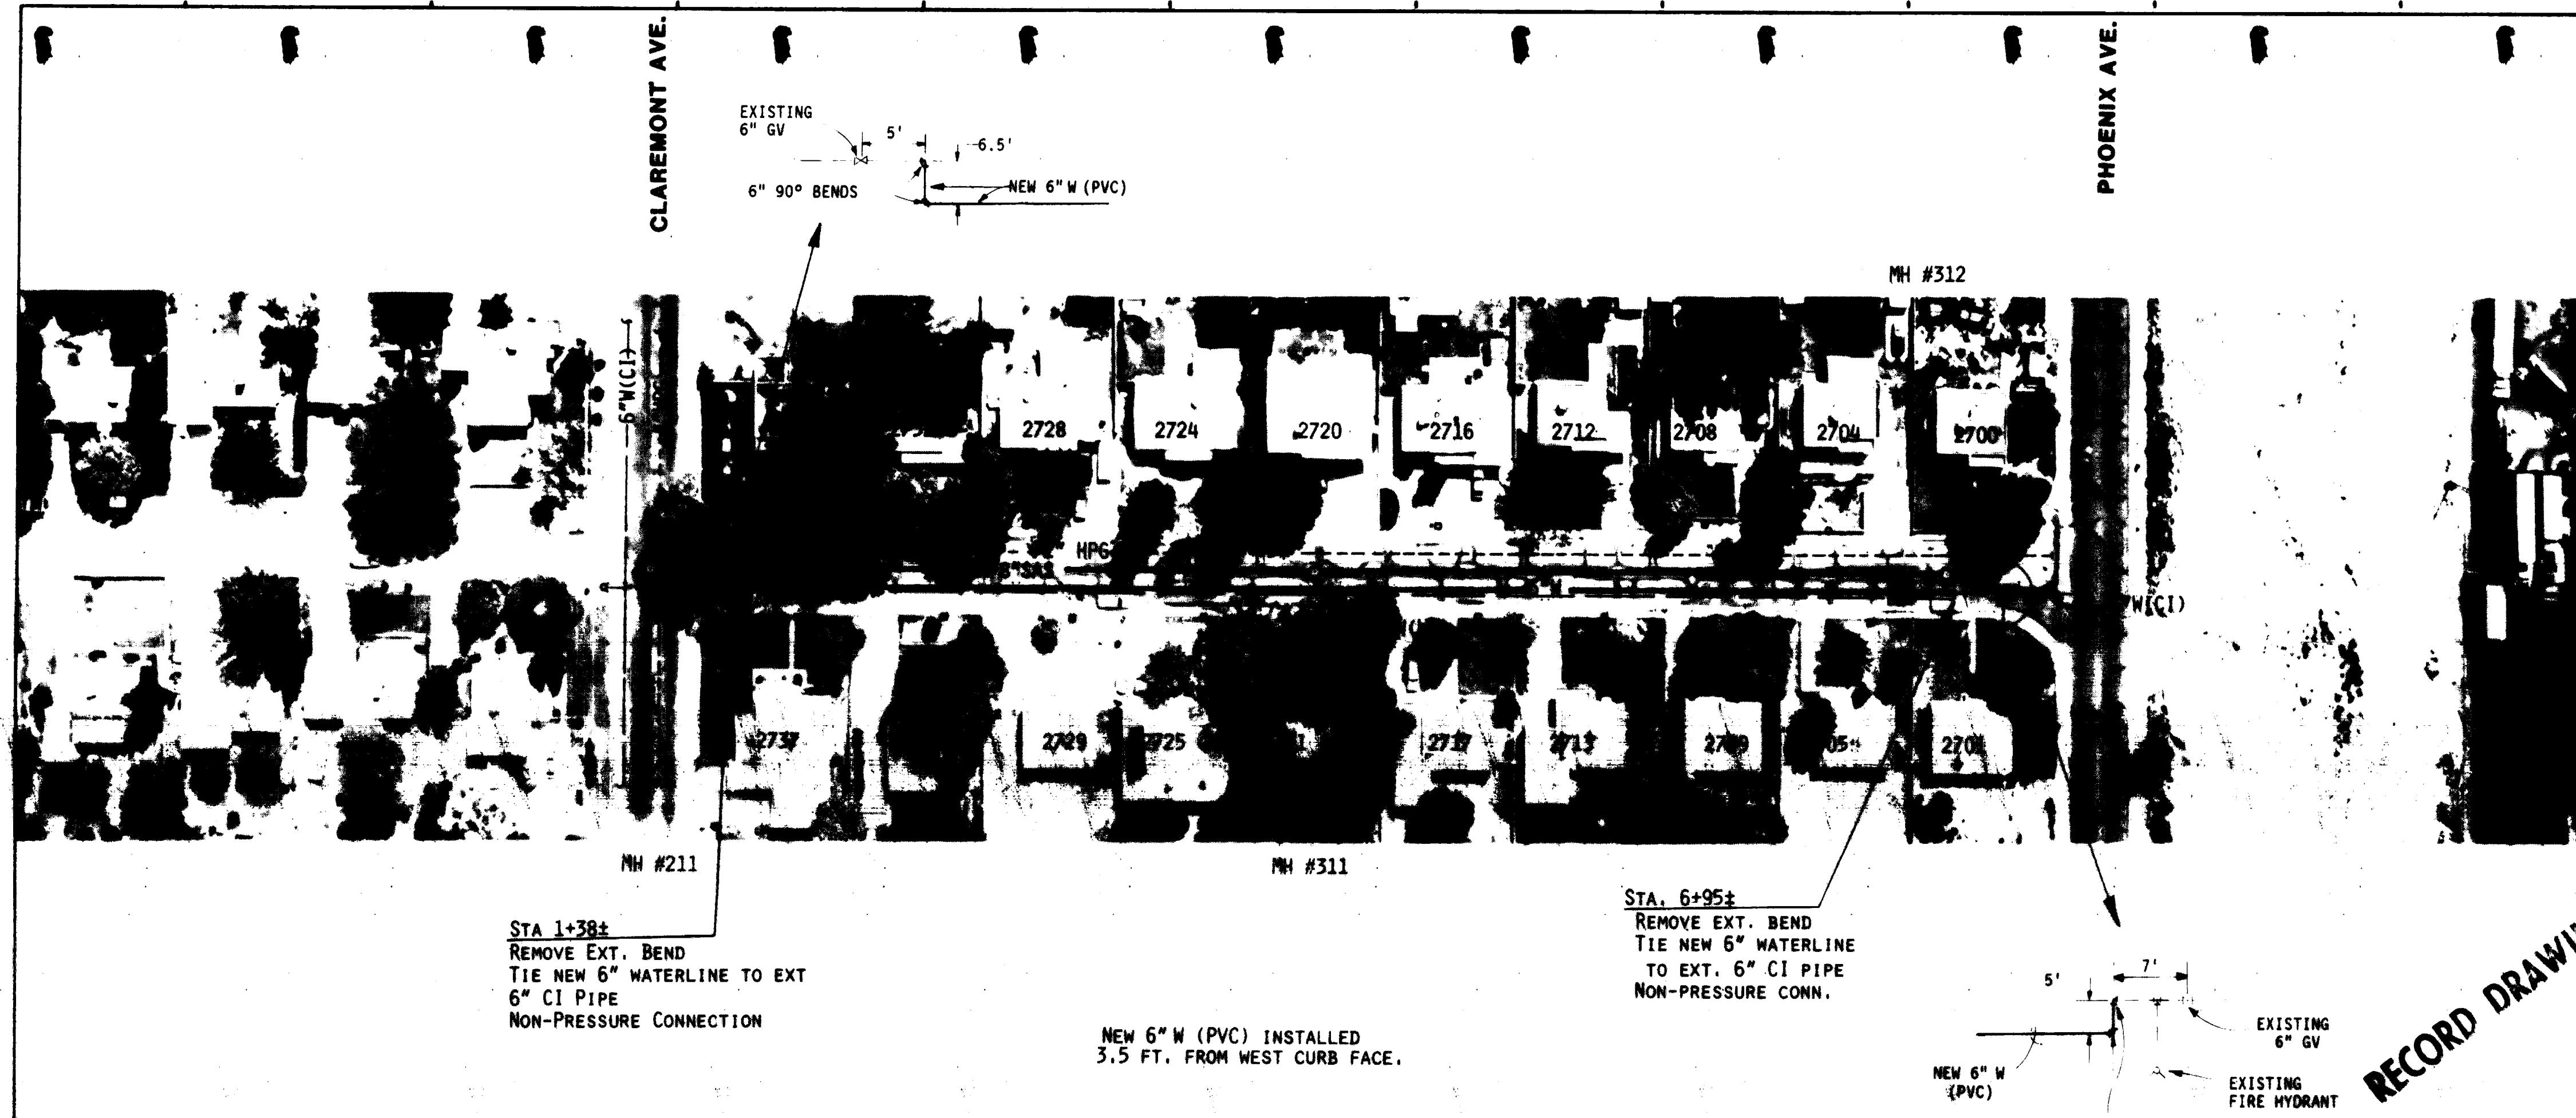

SOLANO DRIVE

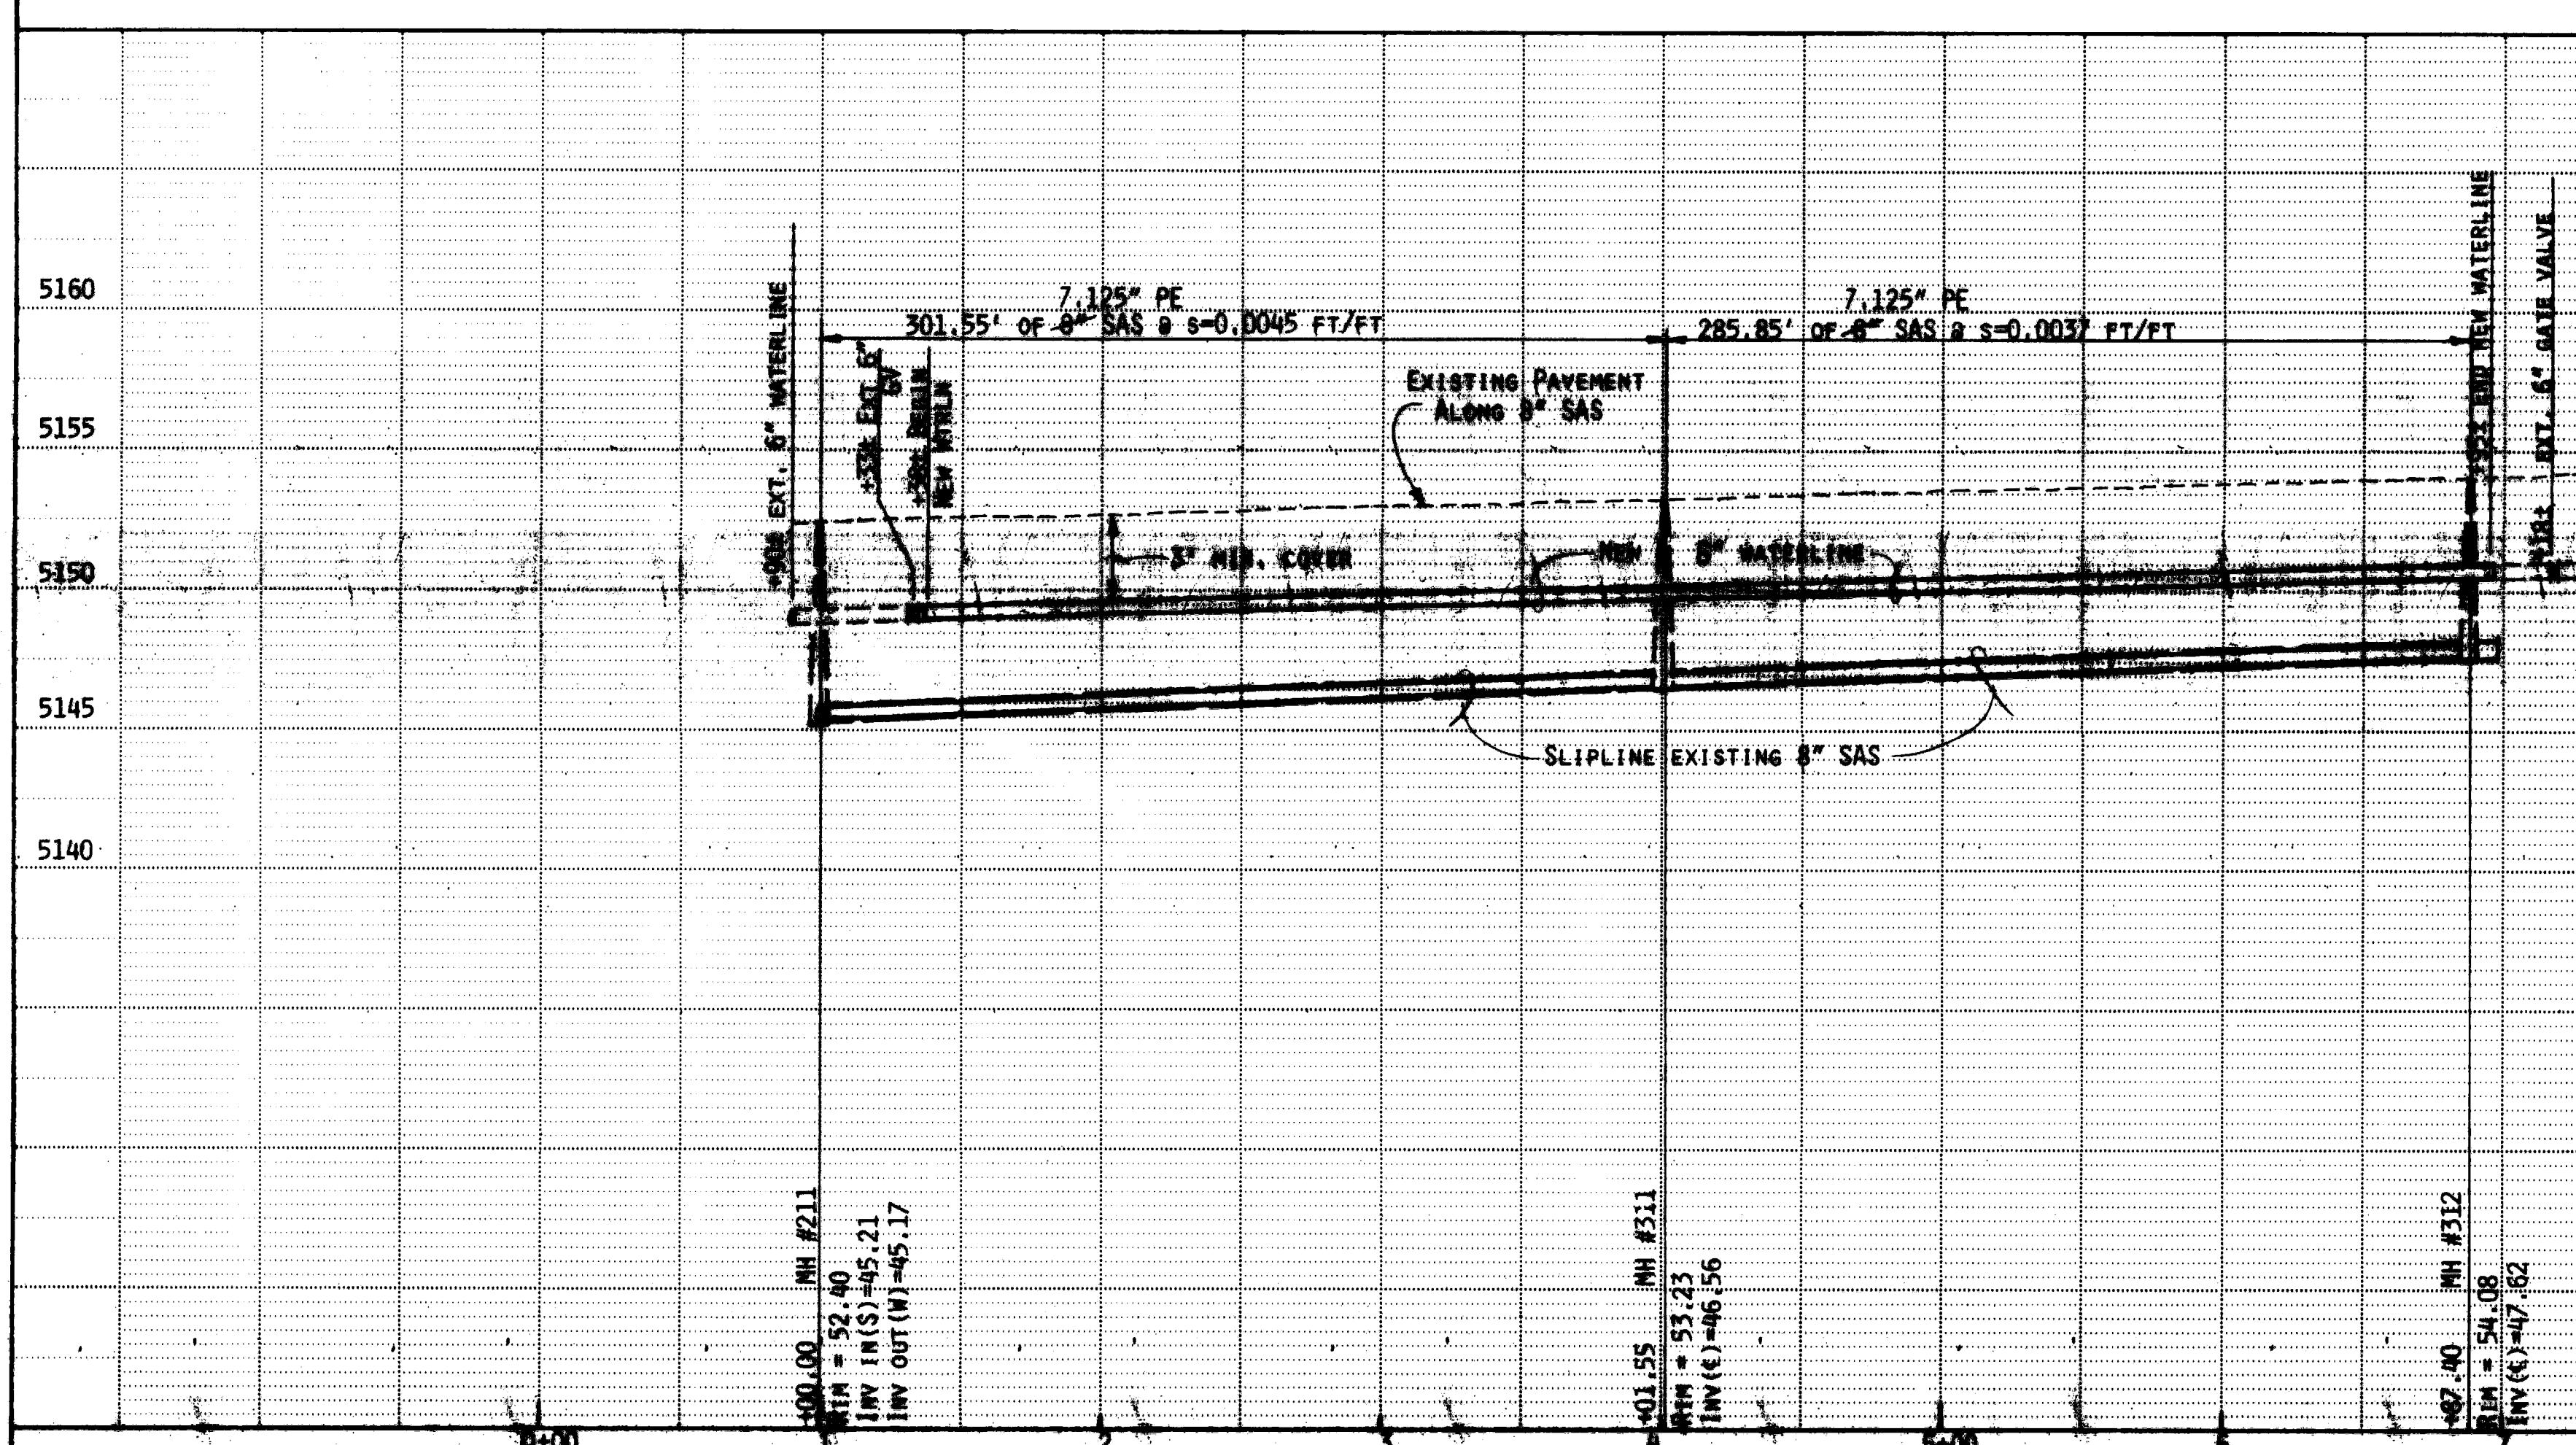

RECORD DRAWING



WATER VALVE SHUT-OFF PLAN

KEY TO WATER SERVICE REHAB. TABLE

- ① SERVICE LINE TRANSFER
- ② METER BOX RELOCATION & REPLACEMENT
- ③ SERVICE LINE REPLACEMENT

WARNING
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repeal or modification by the City. Record documents do not assume
any responsibility for rehabilitation work. Record documents are not
Users of record documents are responsible for their own independent verification of actual conditions.

WATER SERVICE REHABILITATION

SOLANO ADDRESS	METER SIZE	SCALE:		
		1	2	3
2700	3/4"			
2701	"			
2704	"	X	X	
2705	"			X
2708	"	X	X	
2709				
2712	"	X	X	
2713	"			X
2716	"	X	X	
2717	"			X
2720	"	X	X	
2721	"			
2724	"	X	X	
2725	1-1/4"			X
2728	3/4"	X	X	
2729	"			X
2732	"	X	X	
2733	"			X
2736	"	X	X	
2737	"			X


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Albuquerque, New Mexico


CITY OF ALBUQUERQUE
PUBLIC WORKS DEPARTMENT
ENGINEERING GROUP


TITLE: FY88-89 WATERLINE & SEWERLINE RENEWAL PROGRAM, AREA II
SOLANO DRIVE

APPROVALS	ENGINEER	DATE	APPROVALS	ENGINEER	DATE
D.R.C. Chair	[Signature]	[Date]			
Trans. Dev.	[Signature]	[Date]			
Utility Dev.	[Signature]	[Date]			


AS BUILT INFORMATION		
CONTRACTOR: SUNDANCE MECHANICAL WORK: 6" STEEL WATERLINE STATED BY: G. MARQUEZ DATE: 1/90 ACCEPTED BY: A. OSTAPACK DATE: 4/90 FIELD CHECKED BY: ALAN O. DATE: 4/90 RECORDED BY: MICRO-FILM INFORMATION DATE: NO		
BENCH MARKS		
AC'S BEAMS CAP "6-H17-A" LOCATED IN THE MEDIAN OF CARLISLE BLVD. NE 191 FEET NORTH OF THE CENTERLINE OF PHOENIX AVE. NE ELEVATION: 5148.74		
FIELD NOTES		
NO.	BY	
S.D.G.	7/88	
SURVEY INFORMATION		
NO.	REMARKS	BY
REVISIONS	DESIGN	DATE: 12/88
REVISIONS	DRAWN BY	DATE: 1/89
REVISIONS	CHECKED BY	

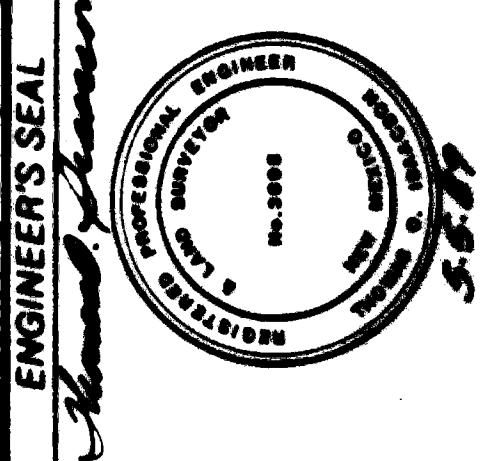

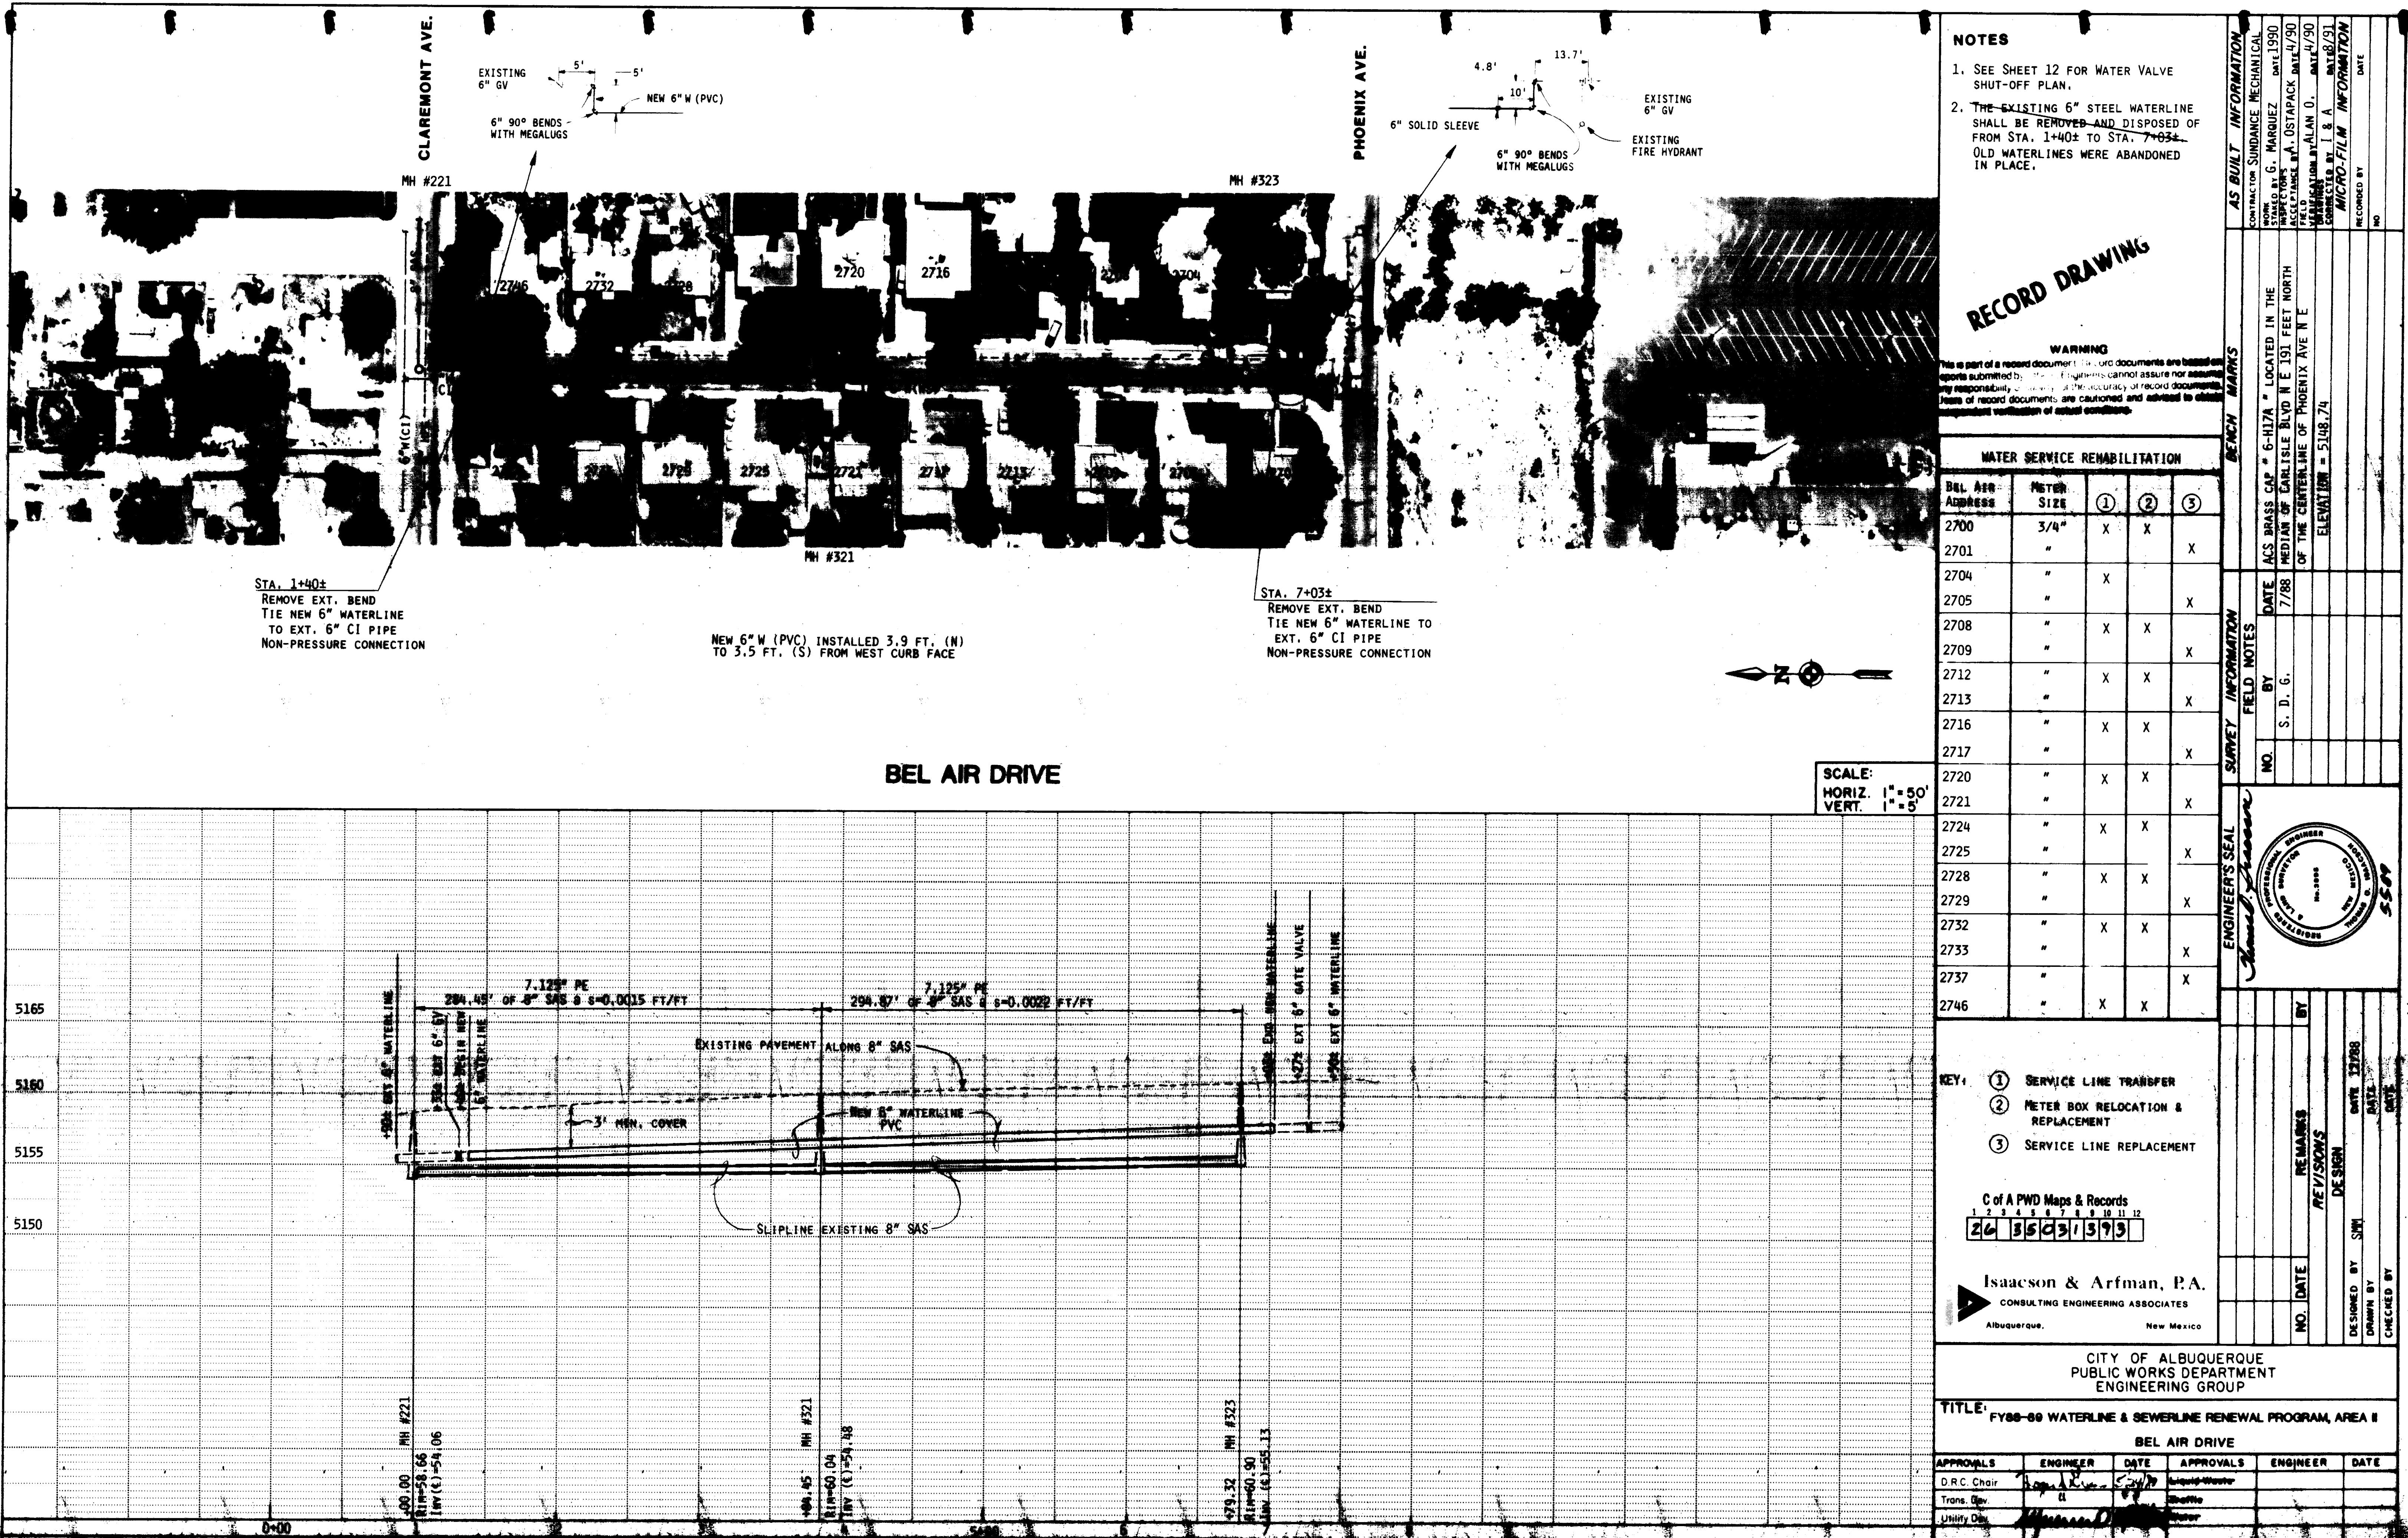

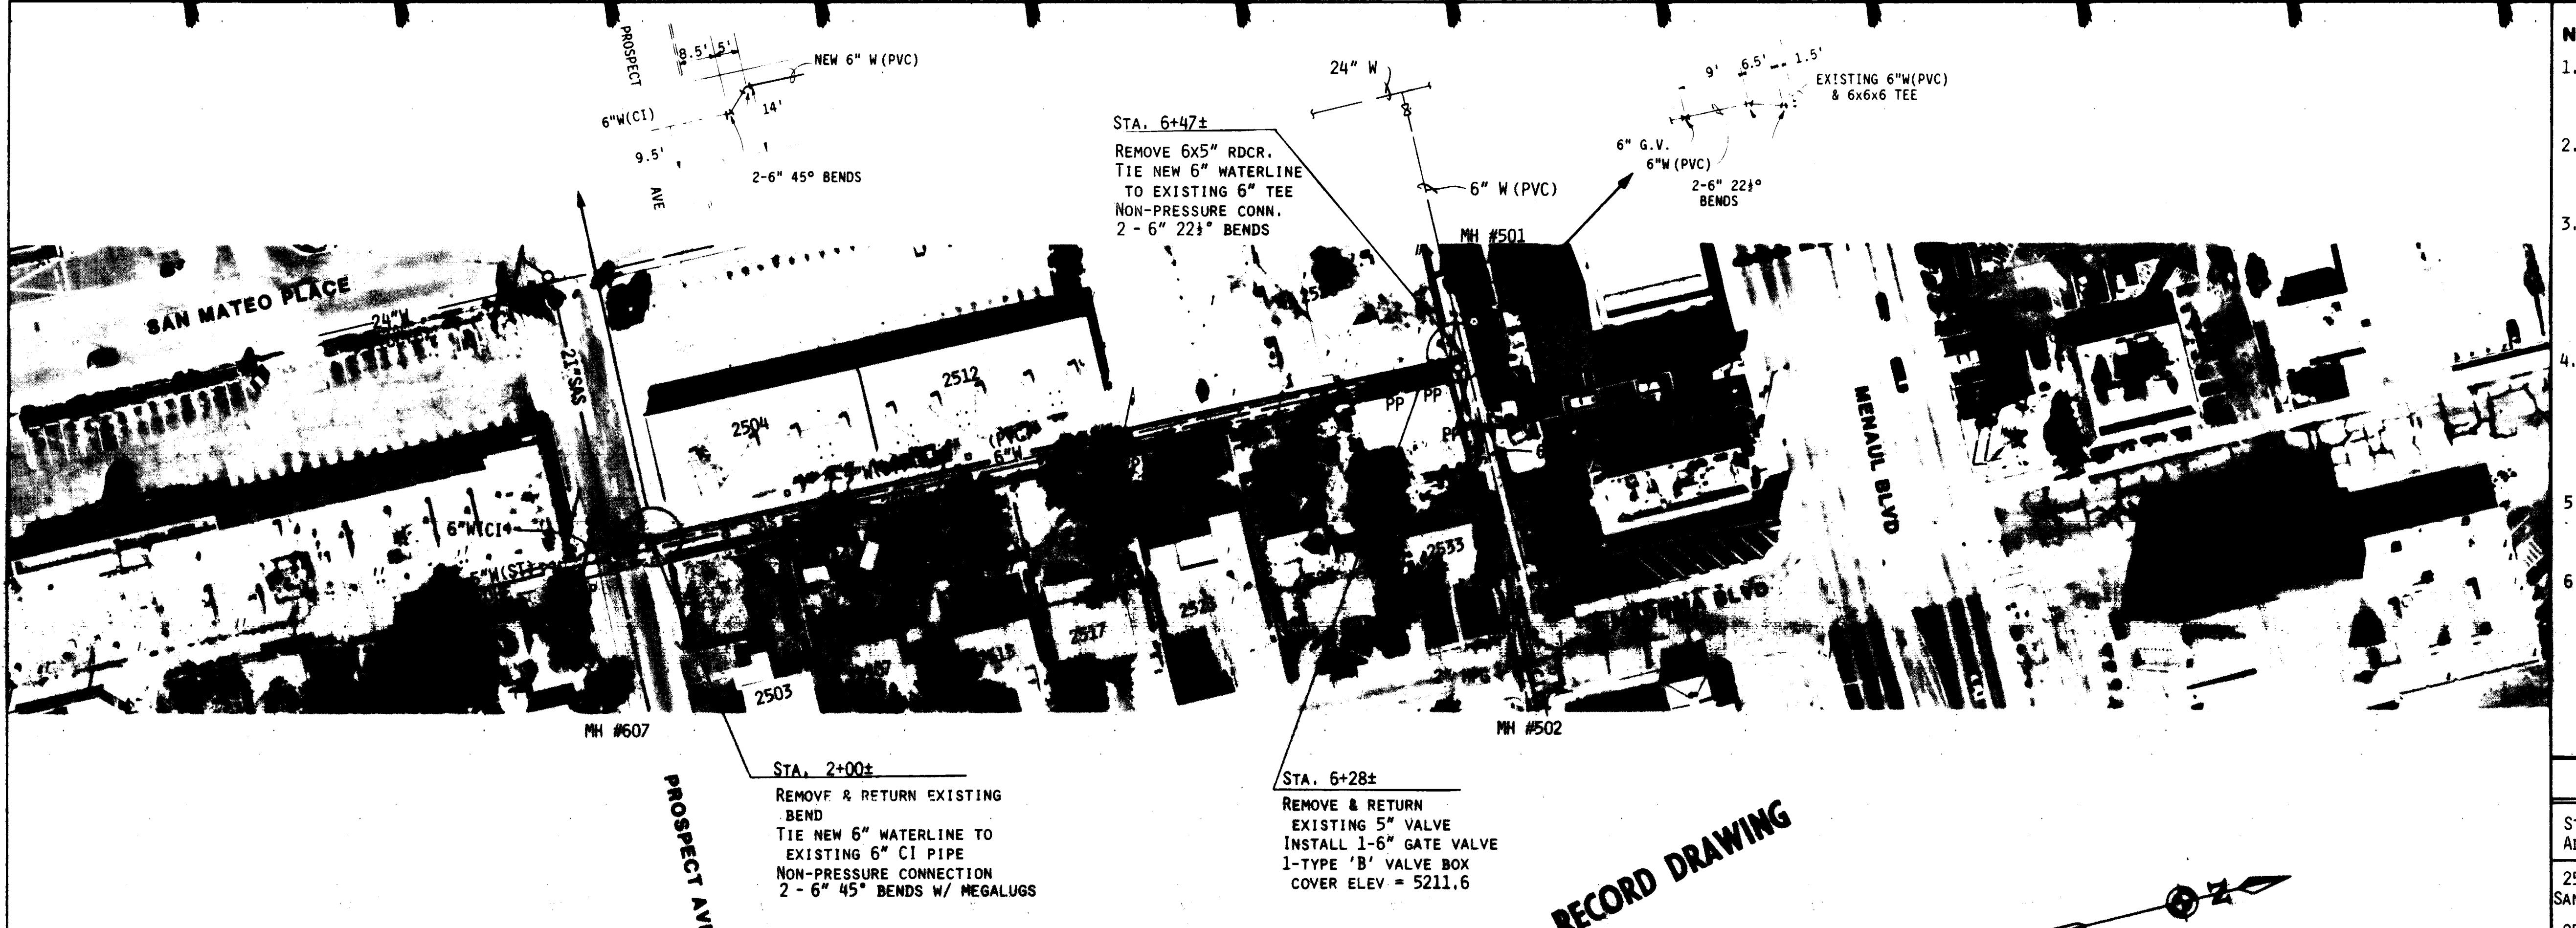


SAN MATEO EAST ALLEY

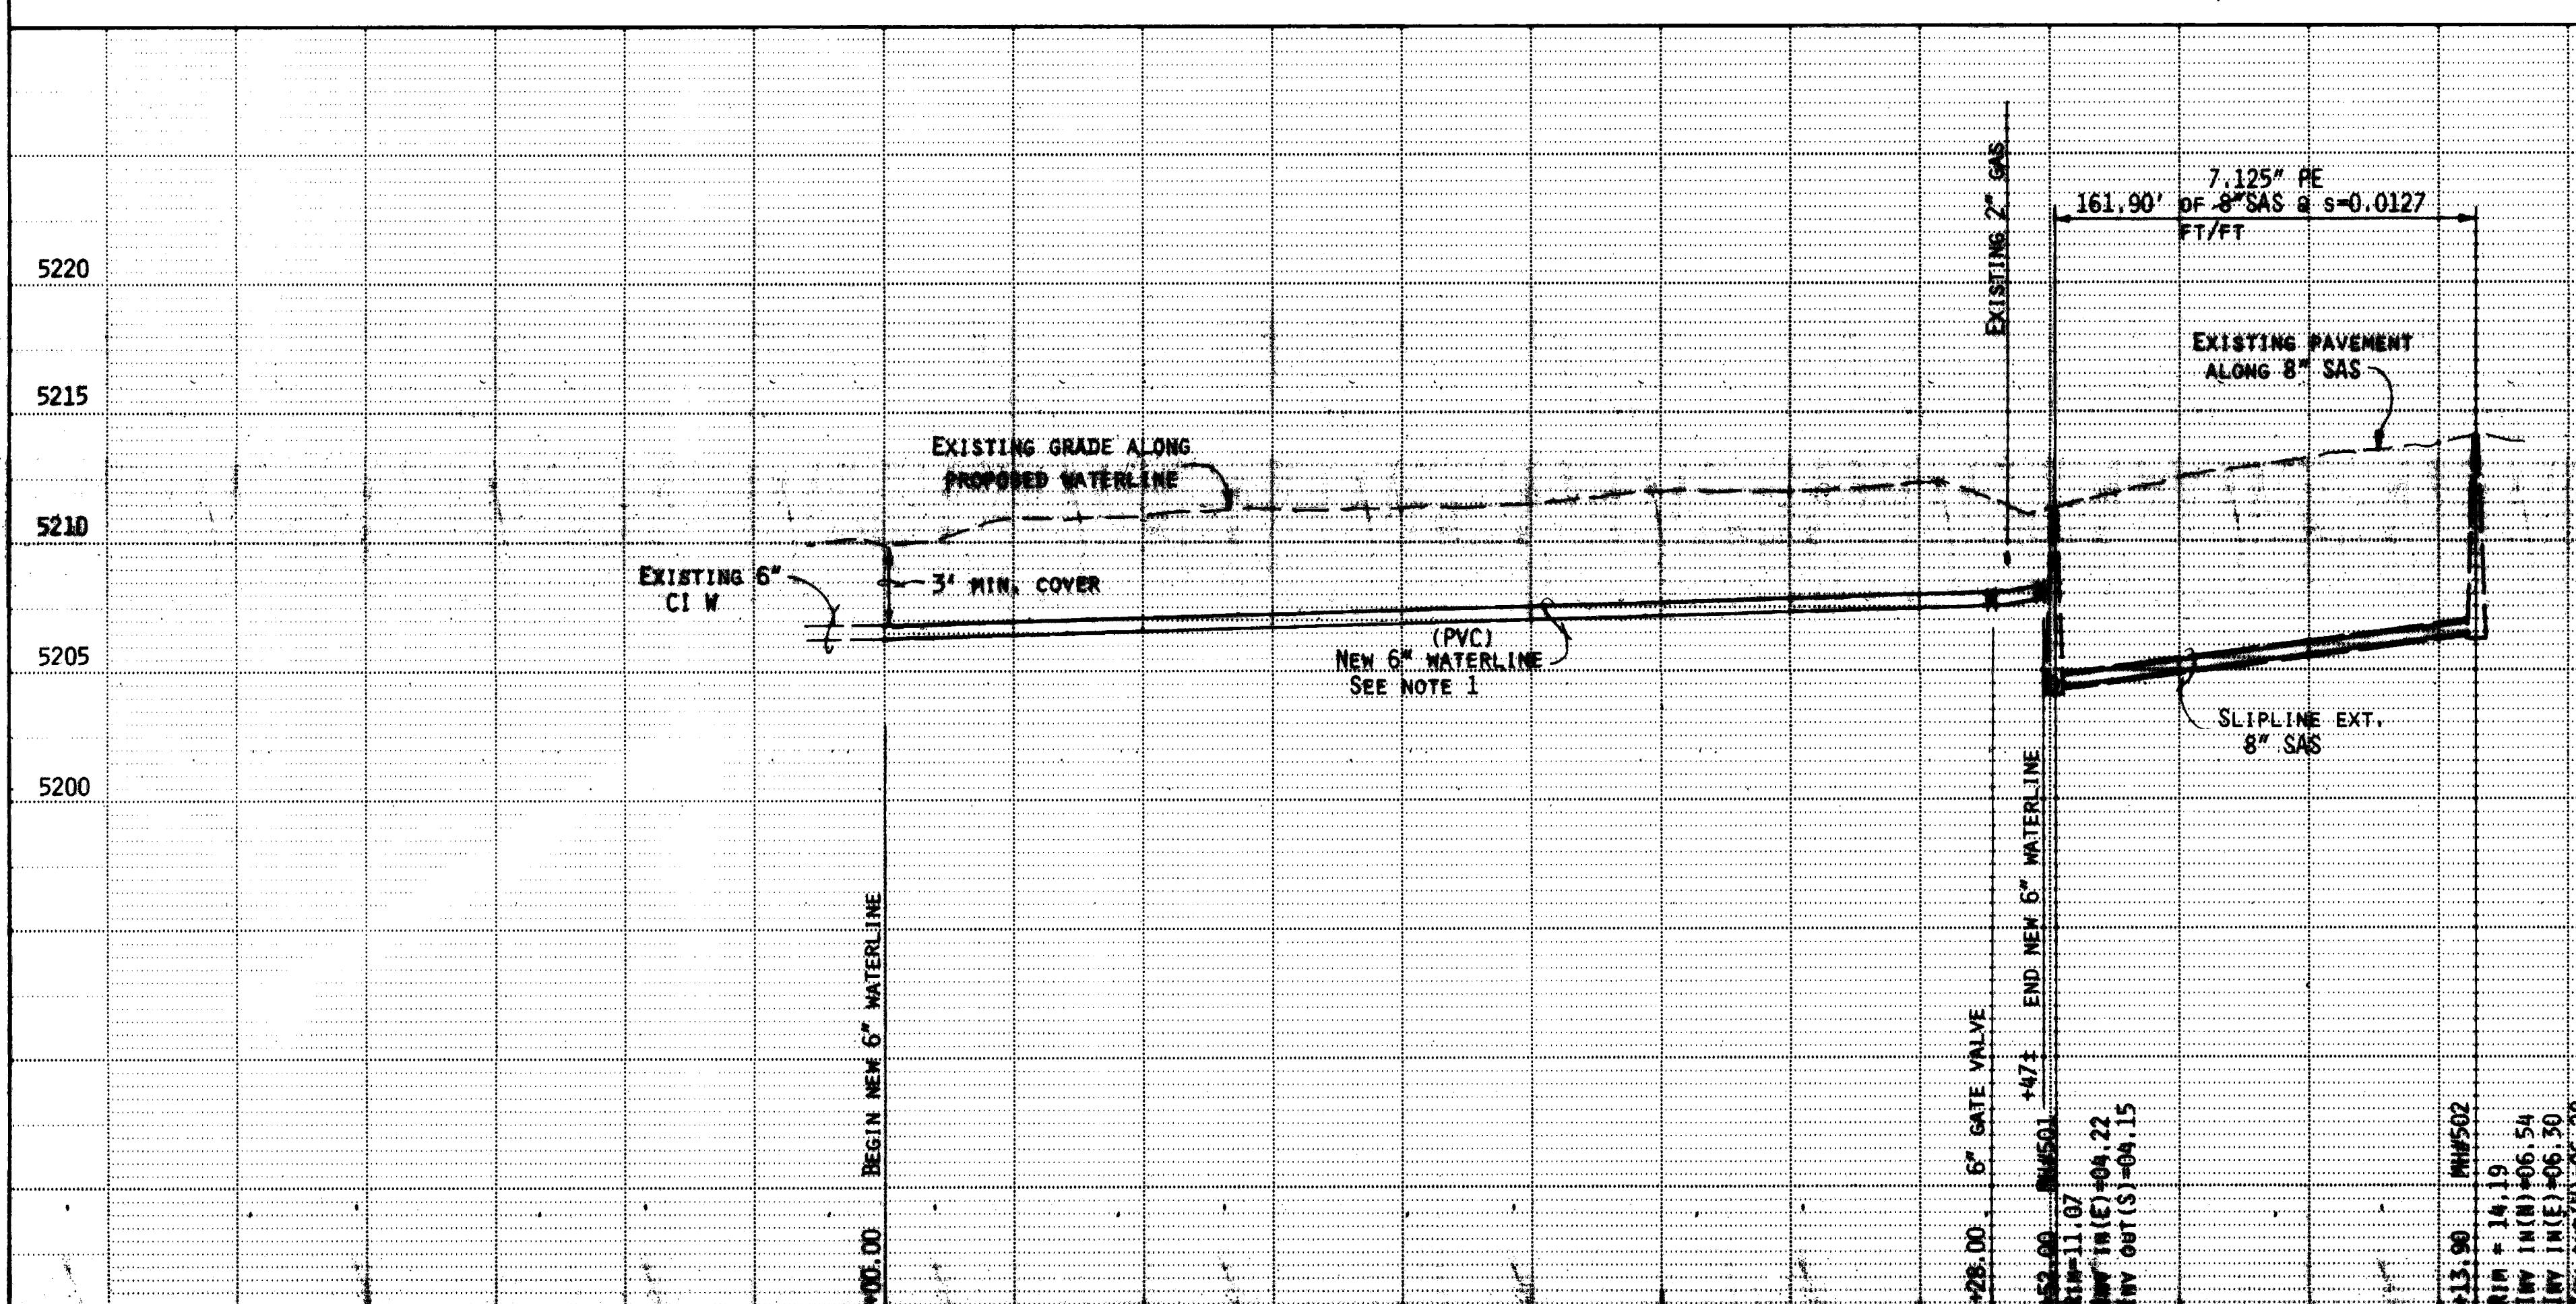




RECORD DRAWING

WARNING
This is part of a record document. Record documents are based on reports submitted by contractors and are not assuring any responsibility on the part of the City of Albuquerque for the documents. Users of record documents are advised and advised to obtain independent verification of actual conditions.

NOTES					
1. CONTRACTOR SHALL PROVIDE A CONTINUOUS POSITIVE GRADE FOR THE WATERLINE INSTALLATION SHOWN.					
2. THE WATER VALVE SHUT-OFF PLAN FOR THIS WORK IS SHOWN ON SHEET 22.					
3. CONTRACTOR SHALL REPLACE APPROX. 150 FEET OF PAVING AT THE SOUTH END OF ALLEY EAST OF SAN MATEO PLACE AS PER DRAWING NO. 2415 FOR TEMPORARY PAVEMENT.					
4. CONTRACTOR SHALL NOTIFY PUBLIC SERVICE CO. OF NM WHEN LIP OF TRENCH IS LESS THAN 5' FROM POWER POLE. COSTS ASSOCIATED WITH SUPPORTING EXISTING POLES SHALL BE INCIDENTAL TO THE PROJECT.					
5. THE EXISTING 5" STEEL WATERLINE SHALL BE REMOVED & DISPOSED OF FROM STA. 2+00± TO STA. 6+47±.					
6. CONTRACTOR SHALL VERIFY WATER LINE PIPE MATERIAL IN EAST-WEST ALLEY SOUTH OF MAEDEIRA, WHEN MAKING THE CONNECTION AT STA. 6+47±.					
AS BUILT INFORMATION					
BENCH MARKS					
WATER SERVICE REHABILITATION					
STREET ADDRESS	METER SIZE	(1)	(2)	(3)	
2504 SAN MATEO PL	3/4"	X	X		
2512 "	"	X	X		
2520 "	"	X			
2503 MAEDEIRA	"				X
2507 "	"				X
2513 "	"				X
2517 "	"				X
2523 "	"				X
2529 "	"				X
2533 "	"				X
ENGINEER'S SEAL	SURVEY INFORMATION	FIELD NOTES	NO.	BY	DATE
C of A PWD Maps & Records 1 2 3 4 5 6 7 8 9 10 11 12 26 35031 4993					
KEY: (1) SERVICE LINE TRANSFER (2) METER BOX RELOCATION & REPLACEMENT (3) SERVICE LINE REPLACEMENT					
Isaacson & Arfman, P.A. CONSULTING ENGINEERING ASSOCIATES Albuquerque, New Mexico					
CITY OF ALBUQUERQUE PUBLIC WORKS DEPARTMENT ENGINEERING GROUP					
TITLE: FY88-89 WATERLINE & SEWERLINE RENEWAL PROGRAM, AREA II SAN MATEO EAST ALLEY					
APPROVALS	ENGINEER	DATE	APPROVALS	ENGINEER	DATE
D.R.C. Chair			Manager		
Trans. Dev.			Public Works		
Utility Dir.			Engineering		

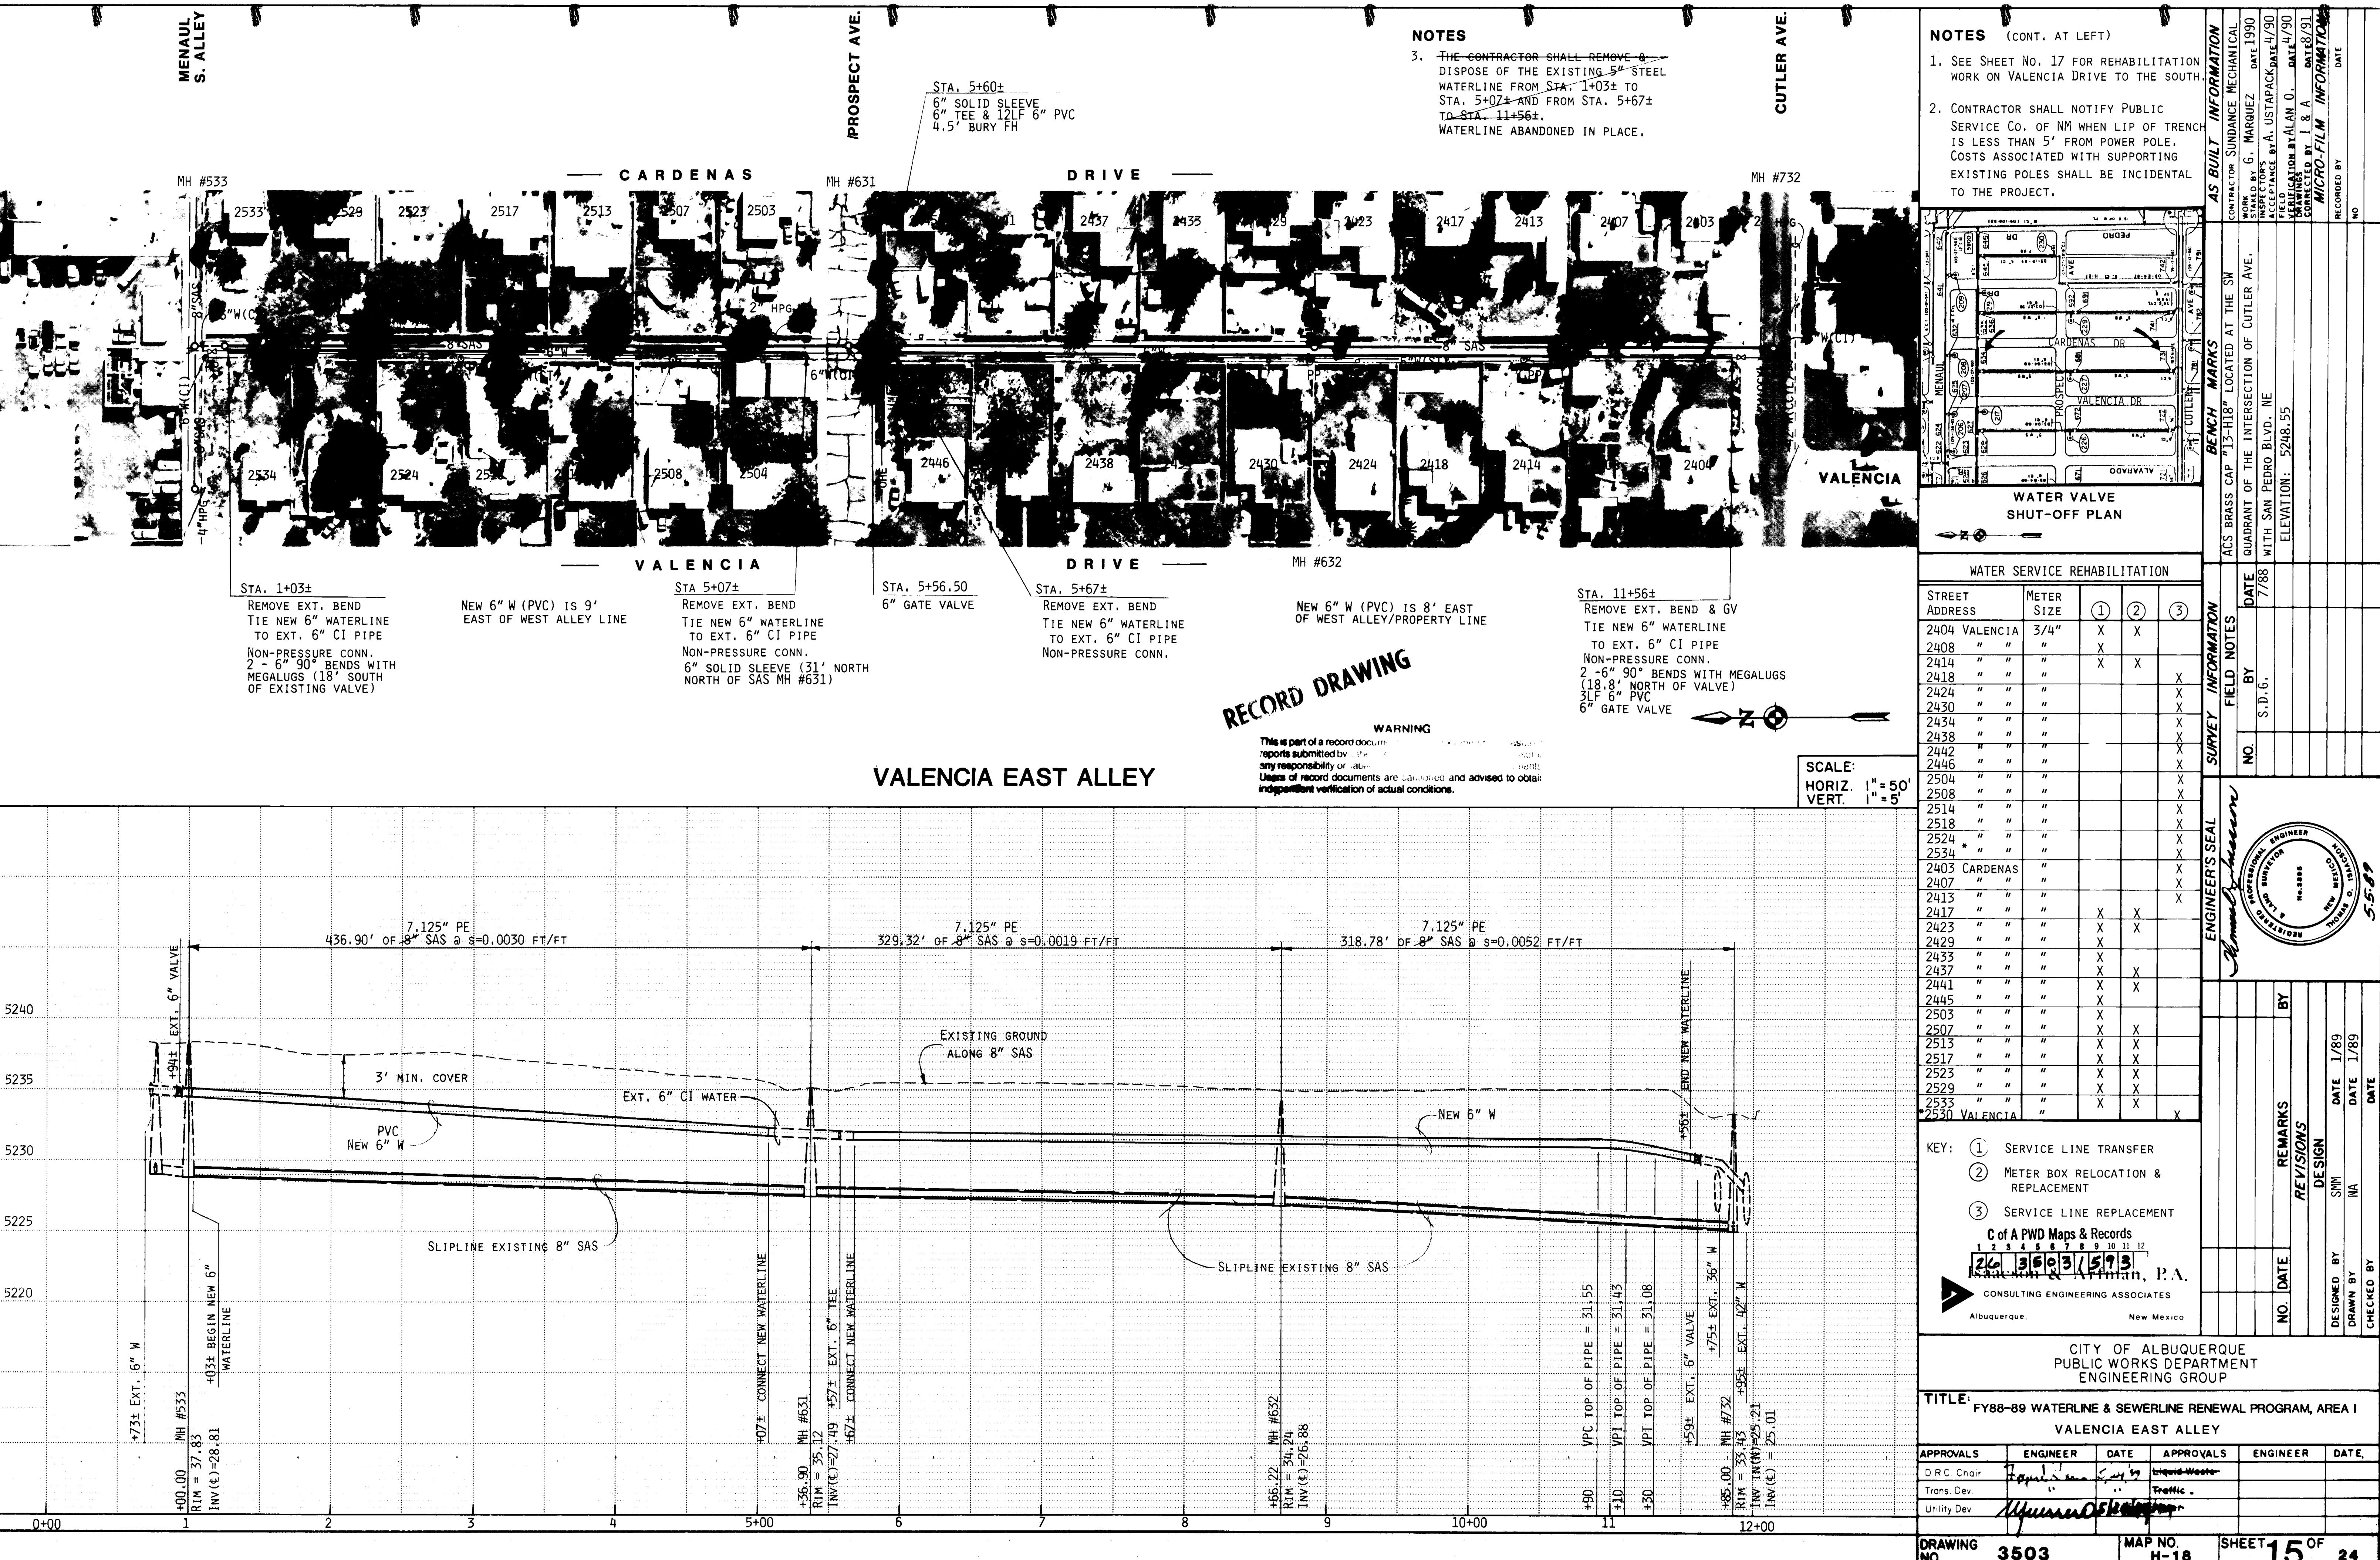

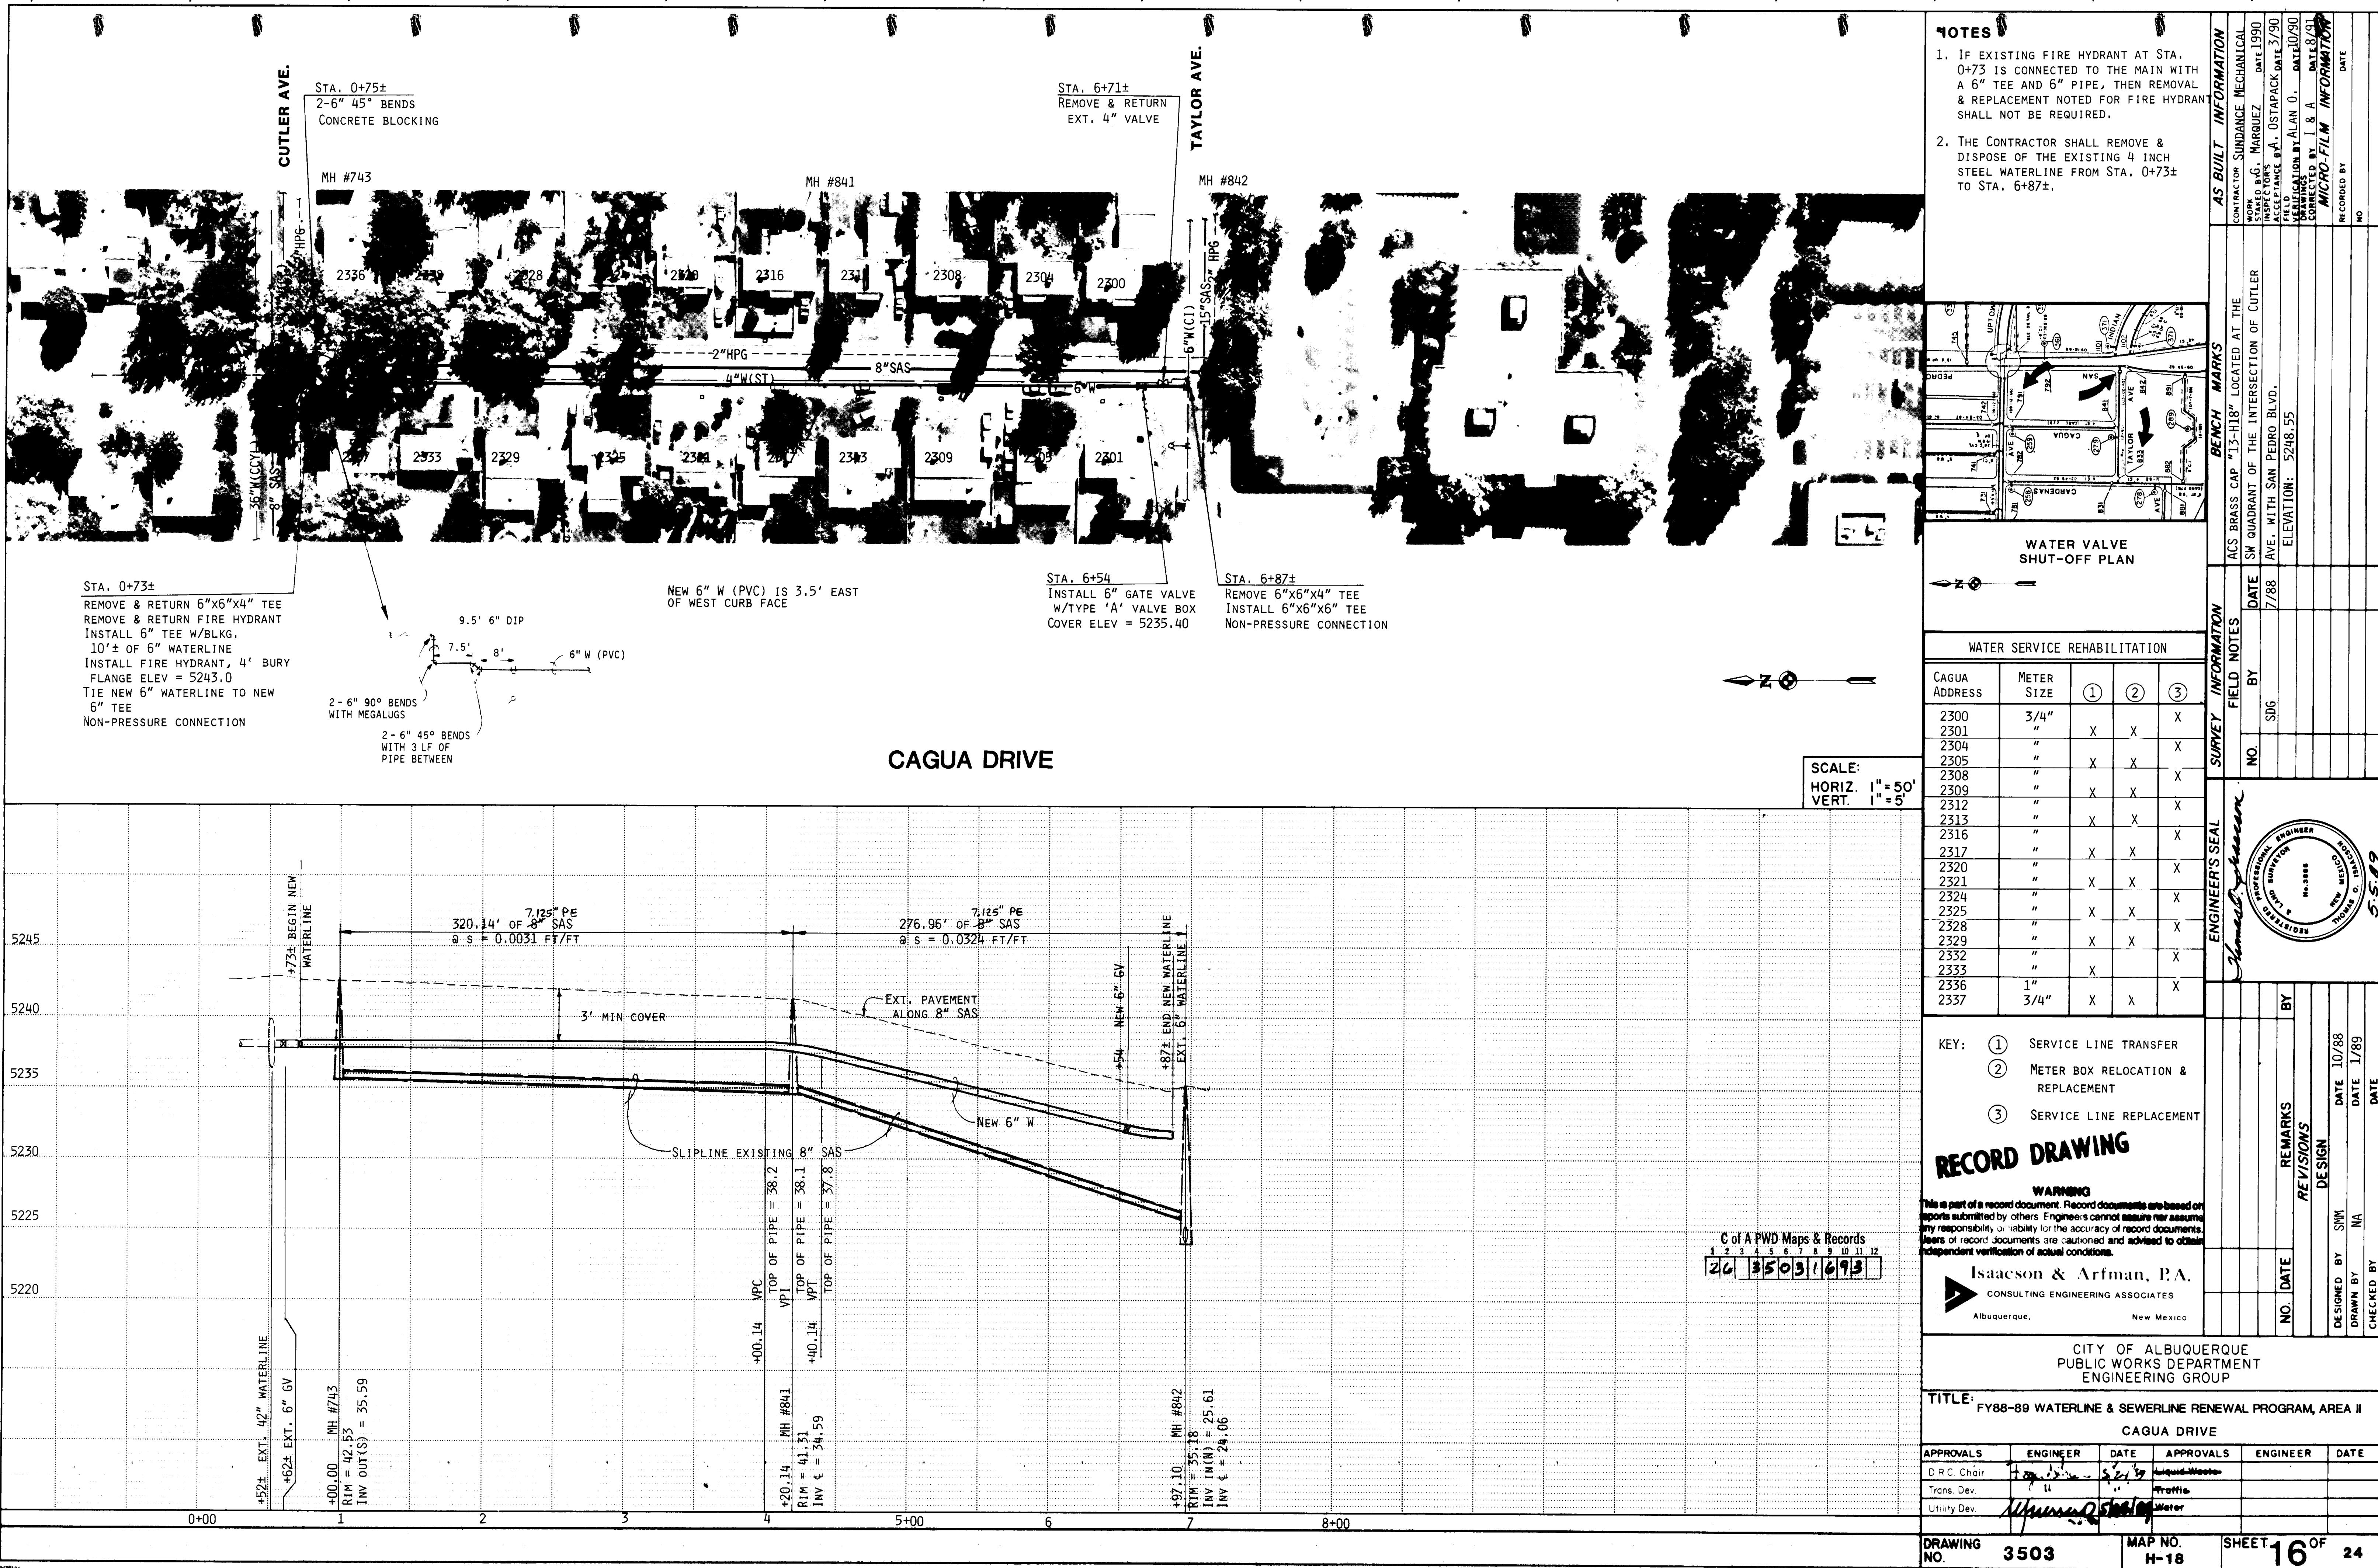

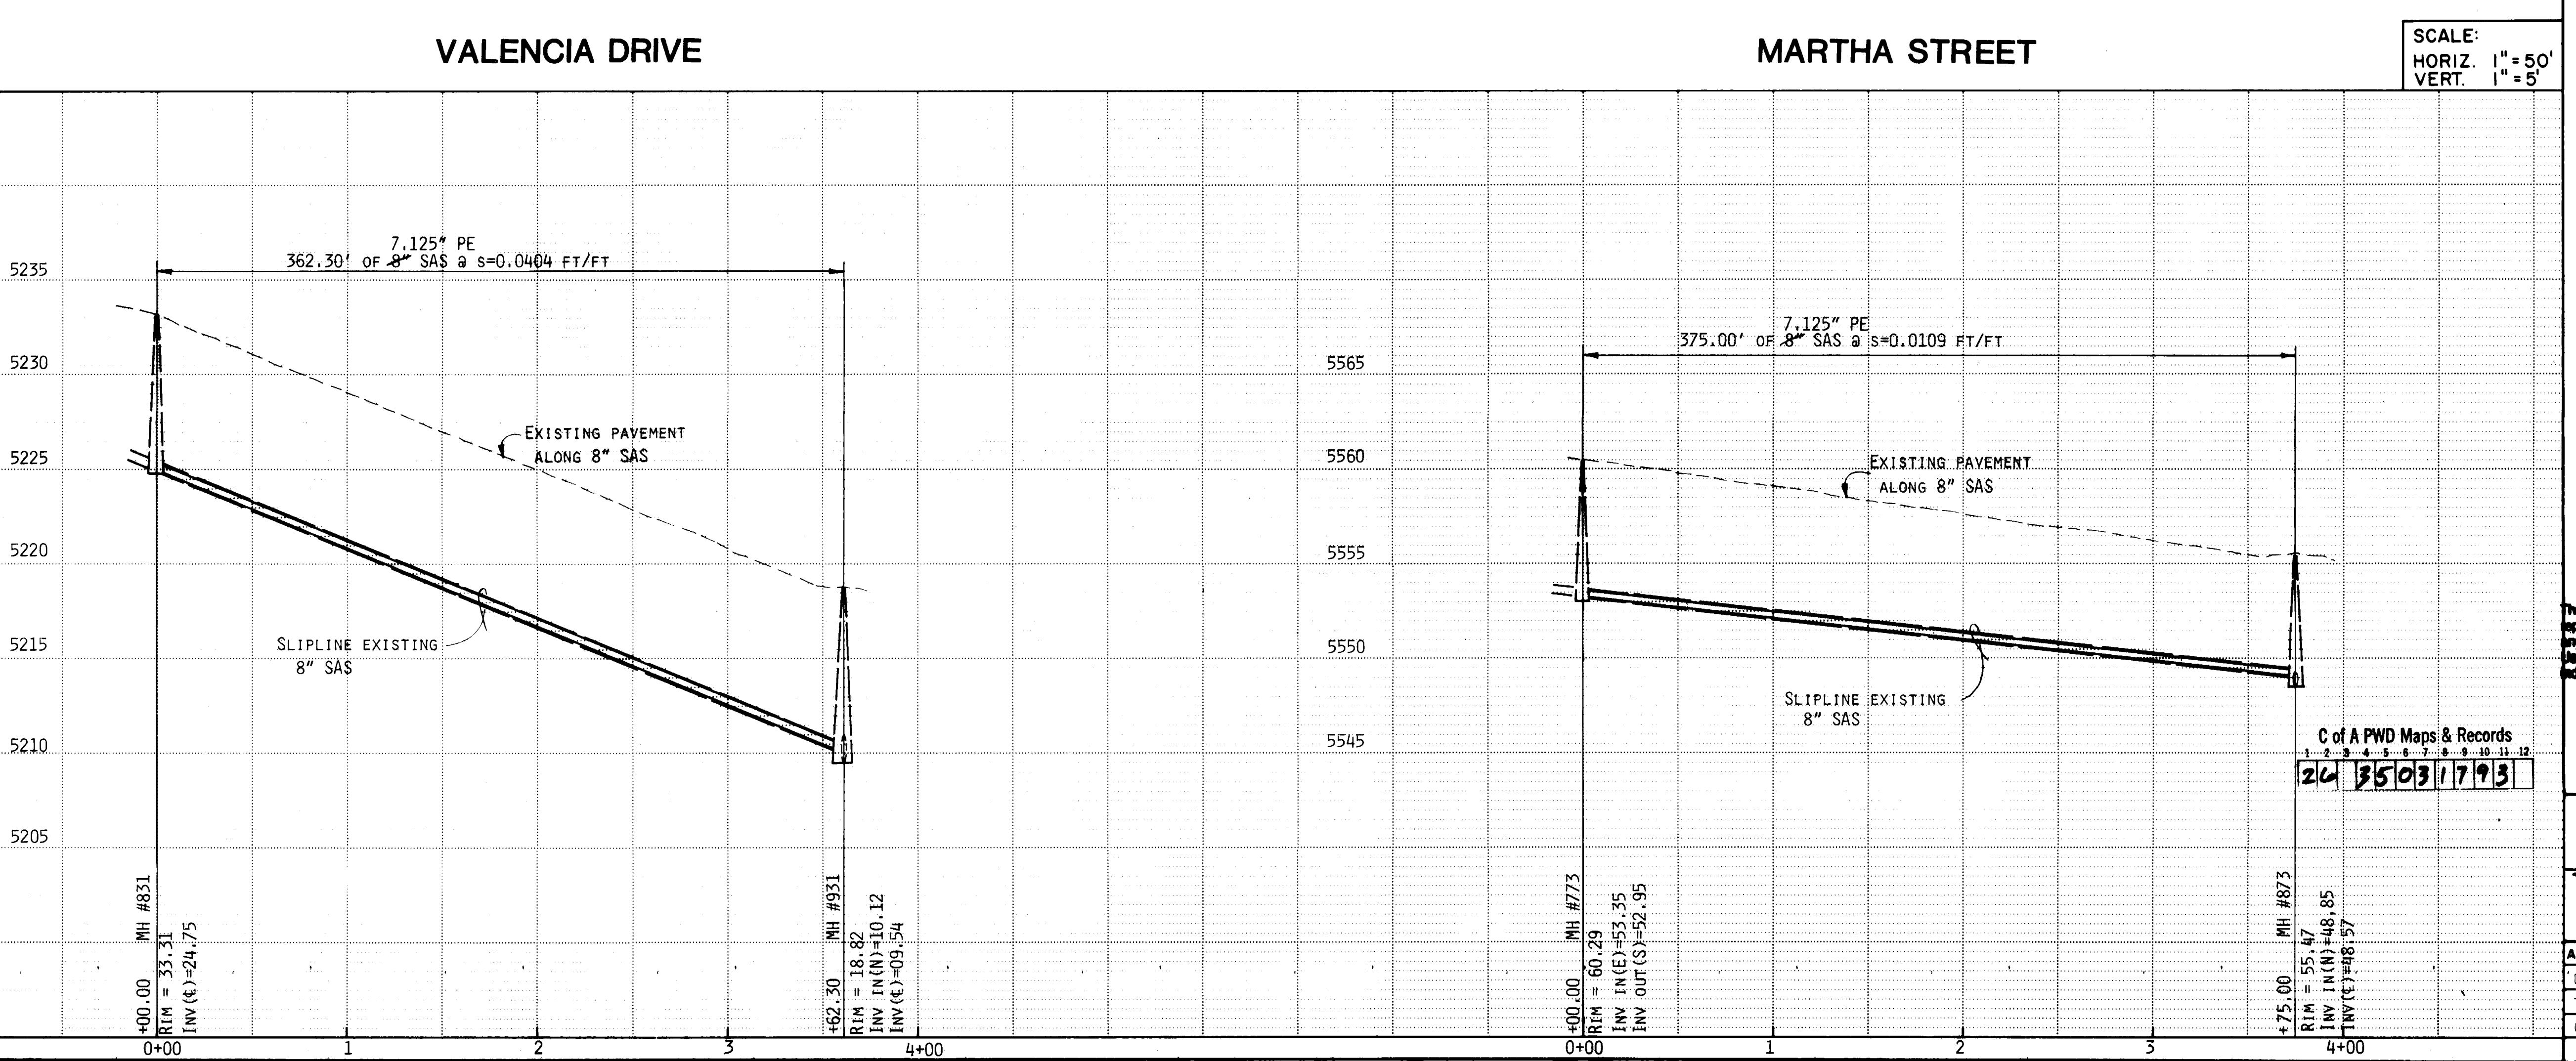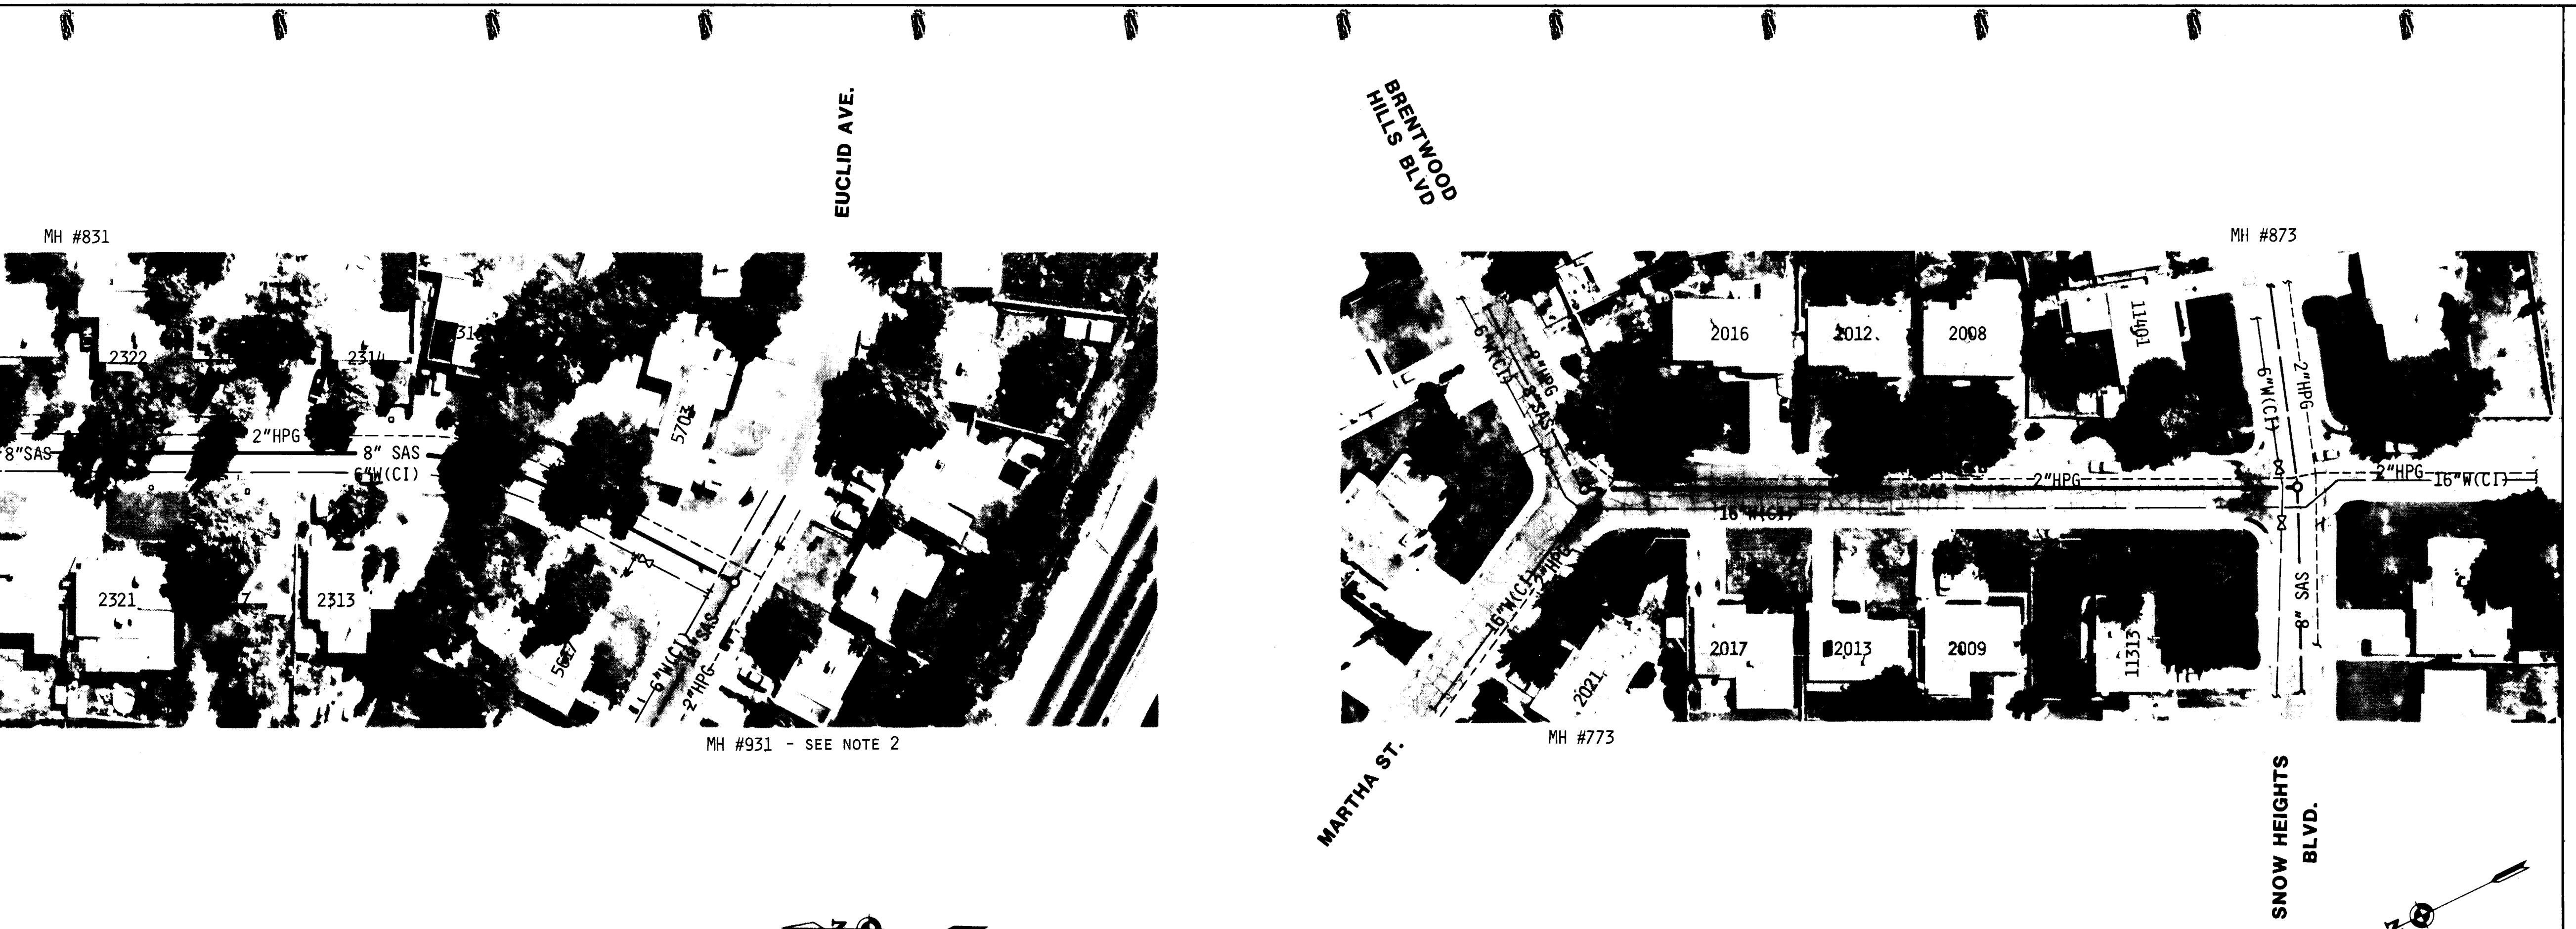

NOTES		AS BUILT INFORMATION	
1. NO WATERLINE REPLACEMENT WORK IS SCHEDULED FOR EITHER OF THE TWO AREAS SHOWN ON THIS SHEET.		CONTRACTOR SUNDANCE MECHANICAL	
2. THE MANHOLE LOCATED AT EUCLID AVE. AND VALENCIA DRIVE (MH #931) SHALL BE PLASTERED AT THE DIRECTION OF THE CITY INSPECTOR - 100± SF.		WORK BY G. MARQUEZ DATE 1/90	
		ACCEPTED BY A. OSTAPACKA DATE 1/90	
		FIELD CHECKED BY ALAN O. DATE 1/90	
		SUBMISSION BY I & A DATE 1/91	
		MICRO-FILM INFORMATION	
		RECORDED BY DATE	
		NO	

RECORD DRAWING

ENGINEER'S SEAL		SURVEY INFORMATION		BENCH MARKS	
<i>Isaacson, Arfman</i>		ACB BRASS CAP "13-H18" LOCATED AT THE SW QUADRANT OF THE INTERSECTION OF CUTLER AVE. WITH SAN PEDRO BLVD. NE ELEVATION: 5218.55		ACB BRASS CAP "13-H18" LOCATED AT THE SW QUADRANT OF THE INTERSECTION OF CUTLER AVE. WITH SAN PEDRO BLVD. NE ELEVATION: 5218.55	
NO.	BY	DATE	NO.	BY	DATE
S.D.G.		7/88	S.D.G.		7/88
REMARKS	BY	REVISIONS	DESIGN	DATE	DATE
				1/89	1/89
NO.	DATE	NO.	DATE	NO.	DATE
DESIGNED BY	SIGN	DRAWN BY	NAME	DRAWN BY	NAME
APPROVEDS	ENGINEER	APPROVALS	ENGINEER	APPROVALS	ENGINEER
D.R.C. Chair		Trans. Dev.		Traffic	
Utility Dev.					

WARNING: This is part of a record document. Record documents are based on reports submitted by others. Engineers cannot assure nor assume any responsibility or liability for the accuracy of record documents. These record documents are cautioned and advised to obtain independent verification of actual conditions.


Isaacson & Arfman, P.A.
CONSULTING ENGINEERING ASSOCIATES
Albuquerque, New Mexico


CITY OF ALBUQUERQUE
PUBLIC WORKS DEPARTMENT
ENGINEERING GROUP

TITLE: FY88-89 WATERLINE & SEWERLINE RENEWAL PROGRAM, AREA I
VALENCIA DRIVE & MARTHA STREET

APPROVALS	ENGINEER	DATE	APPROVALS	ENGINEER	DATE
D.R.C. Chair			Trans. Dev.		
Utility Dev.			Traffic		

DRAWING NO. 3503 MAP NO. H-18&21 SHEET 17 OF 24

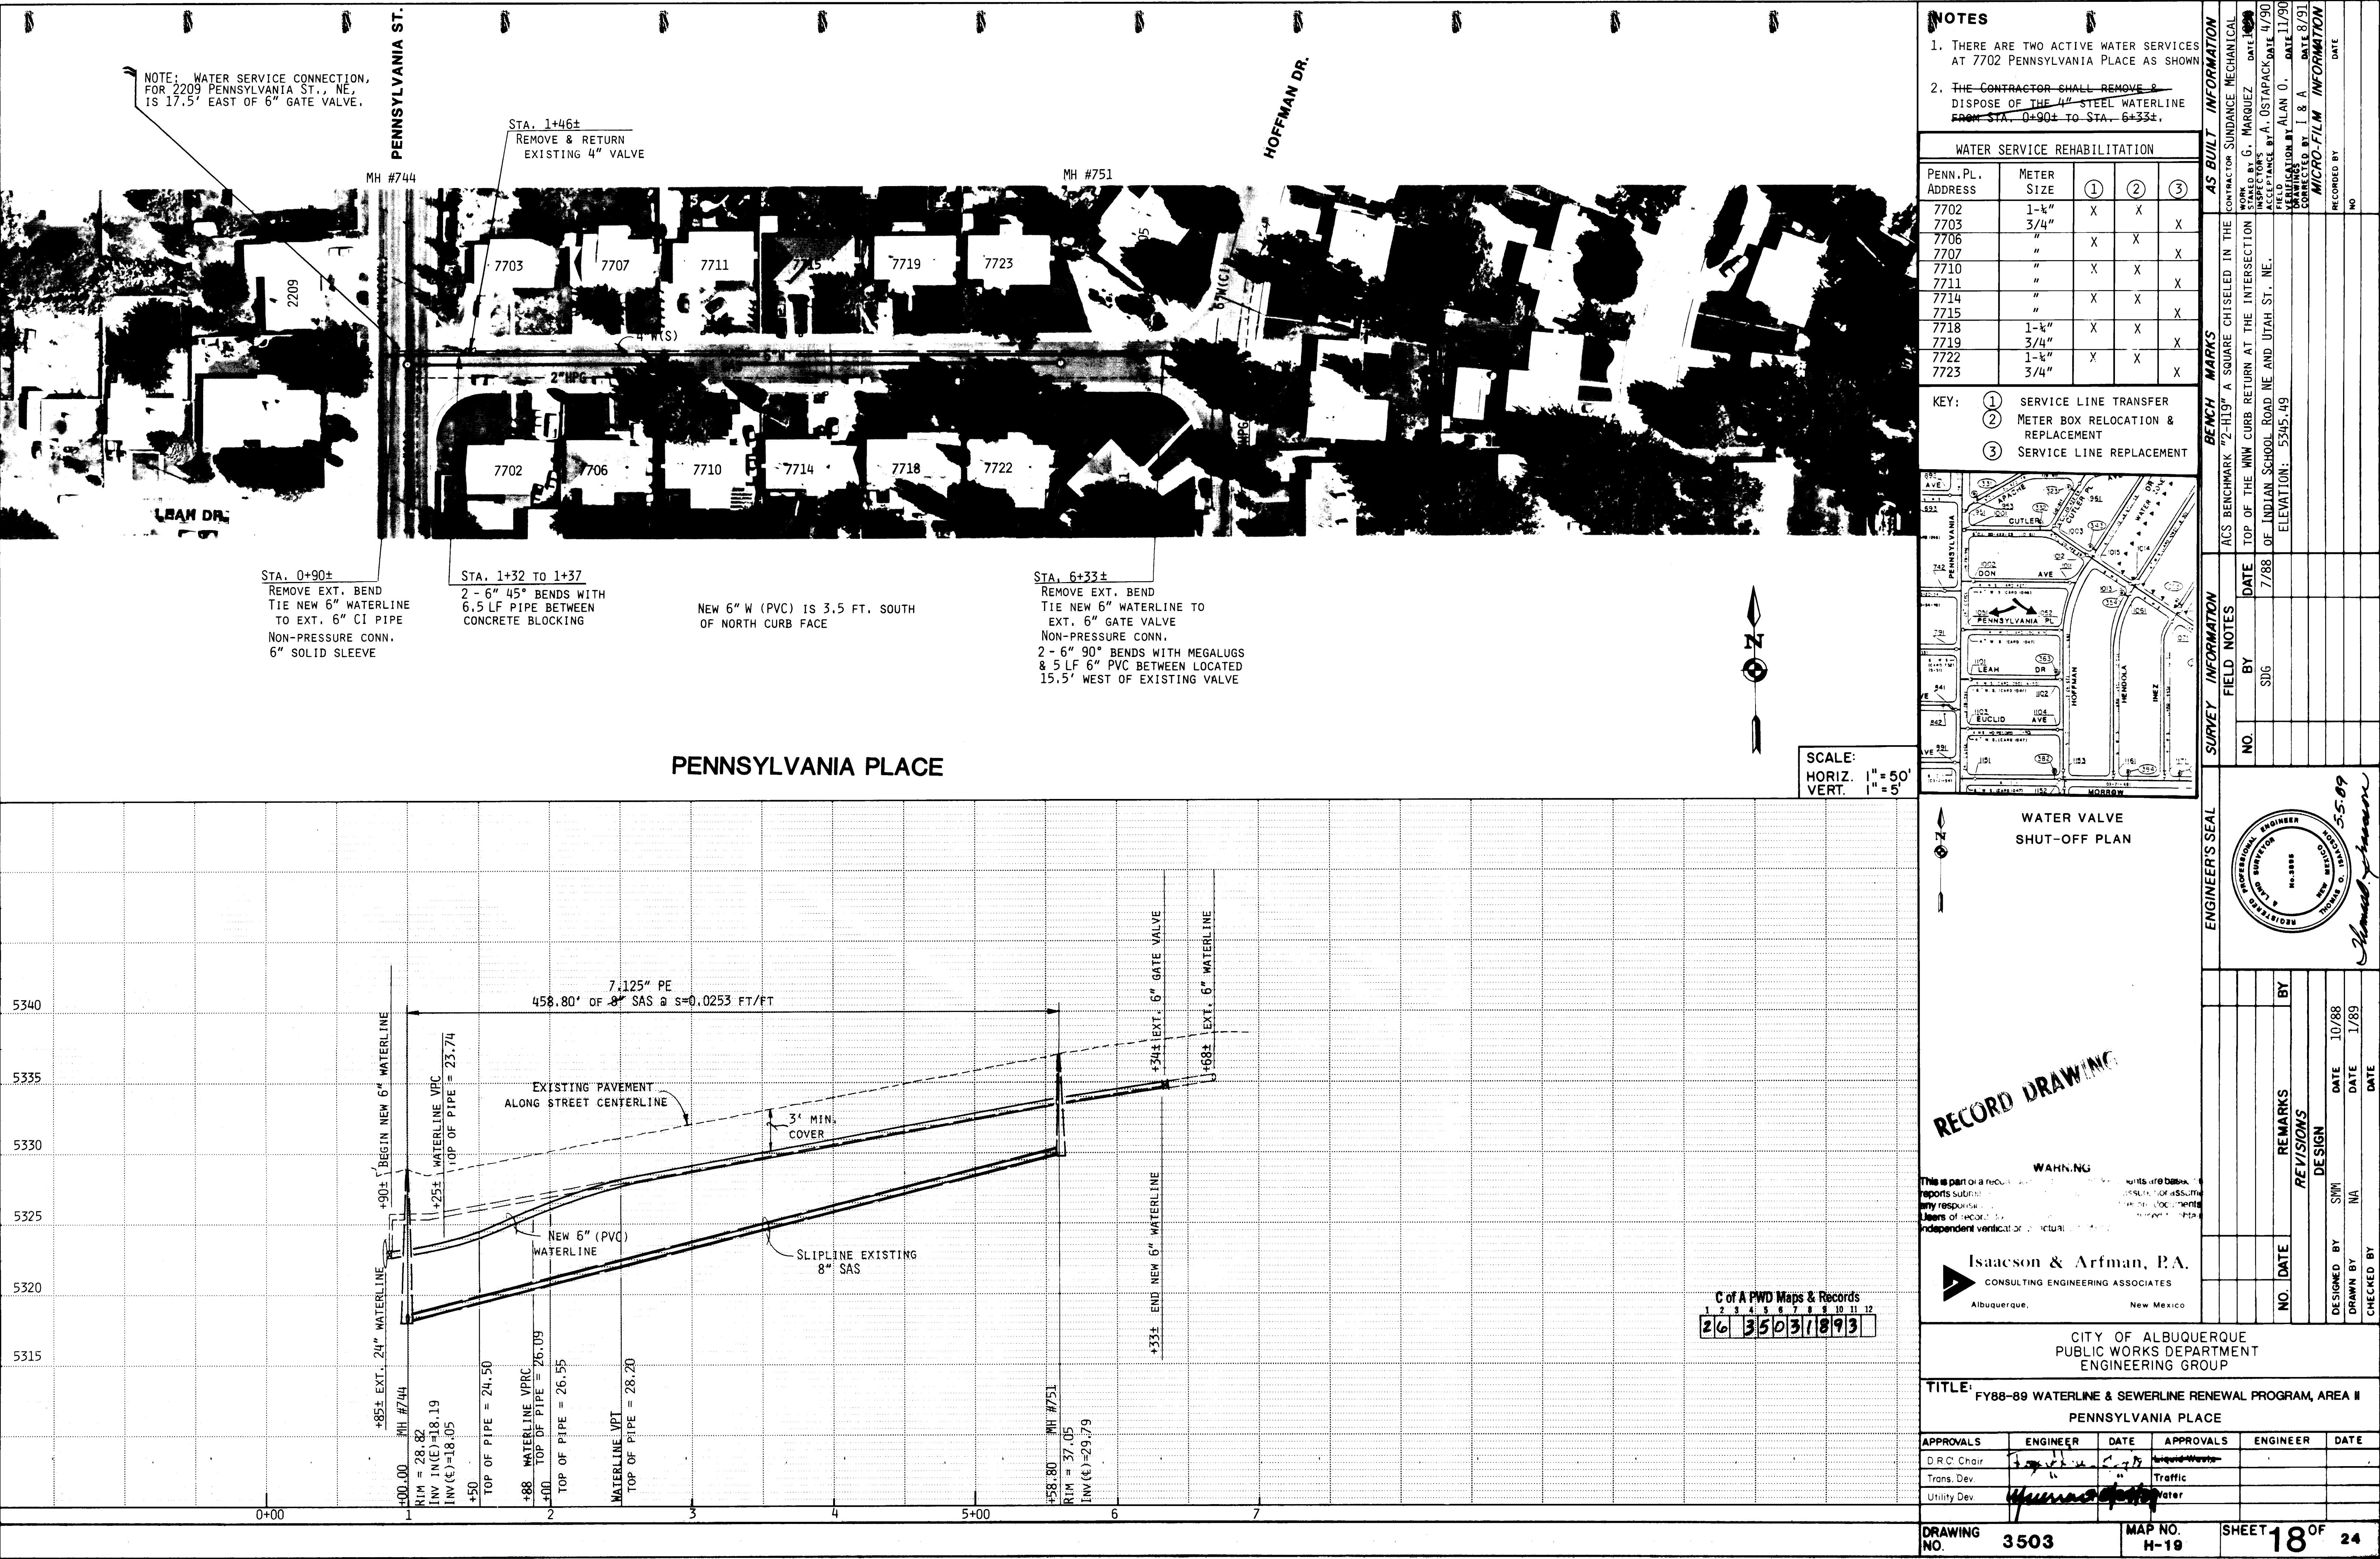

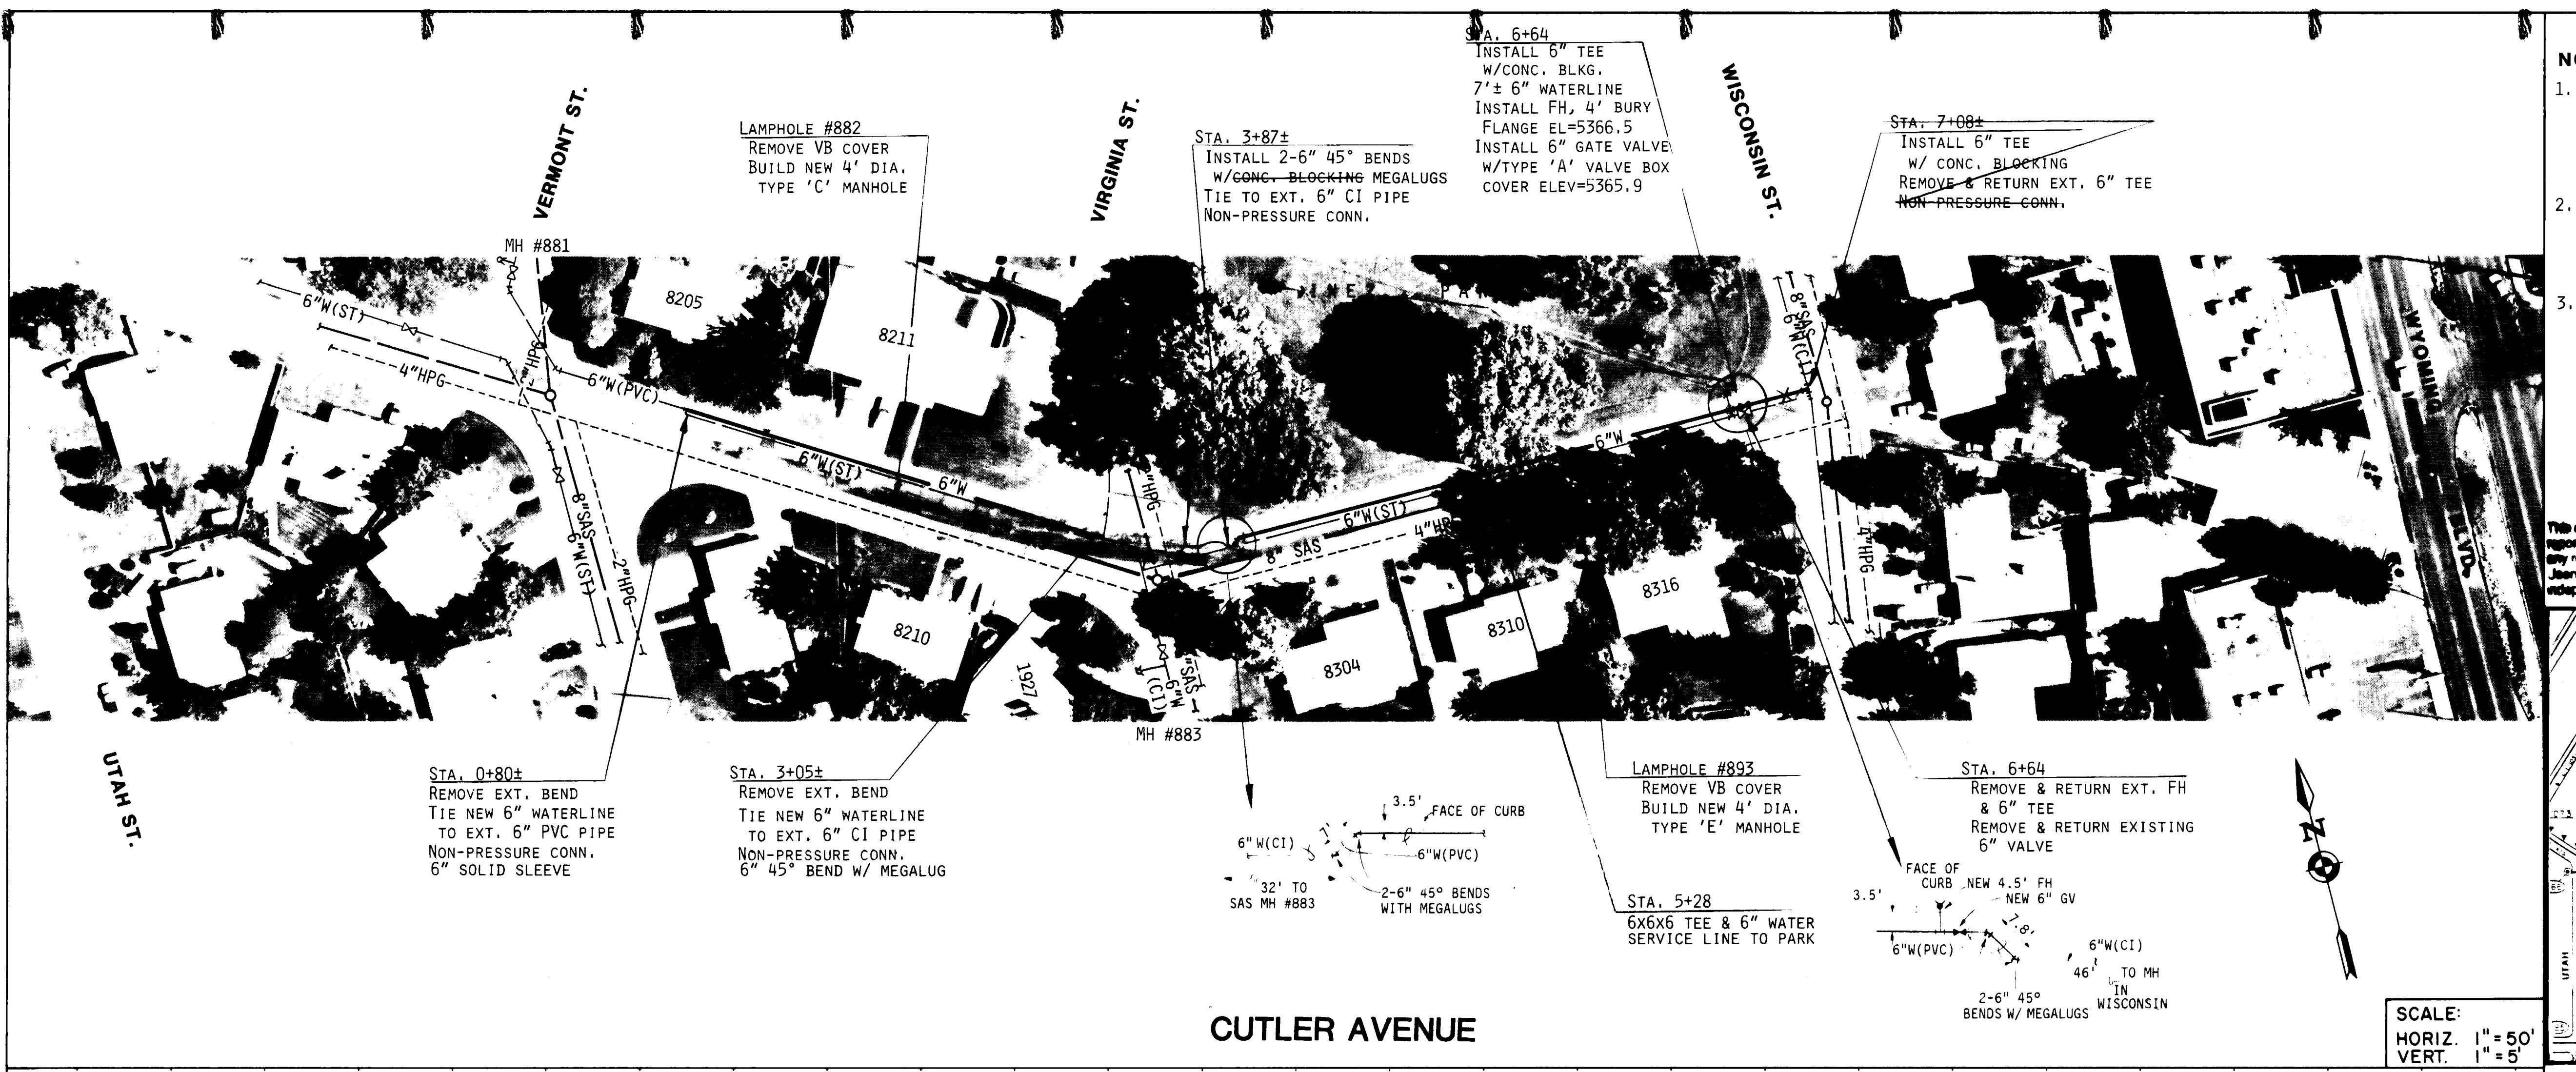



AS BUILT INFORMATION		BENCH MARKS	
		ACS BENCHMARK 2-HL97, A SQUARE CHISELED IN FIELD DURING MECHANICAL WORK ON THE TOP OF THE NEW CURB RETURN AT THE INTERSECTION OF INDIAN SCHOOL RD & UTAH ST. NE DRAWINGS BY ALAN O. DIAZ 8/91 VERIFICATION BY L.S.A. OSTAPACK DATE 1/91 MICRO-FILM INFORMATION	CONTRACTOR SUNDANCE MECHANICAL STAKED BY G. MARQUEZ DATE 1/90 INSPECTORS A. OSTAPACK DATE 1/91 RECORDED BY NO
NO.	FIELD NOTES BY S.D.G.	DATE 7/88	ELEVATION: 5345.49


SCALE:
HORIZ. 1" = 50'
VERT. 1" = 5'


WATER VALVE SHUT-OFF PLAN

ENGINEER'S SEAL
Isaacson & Arfman, P.A.
CONSULTING ENGINEERING ASSOCIATES
Albuquerque, New Mexico
55-07

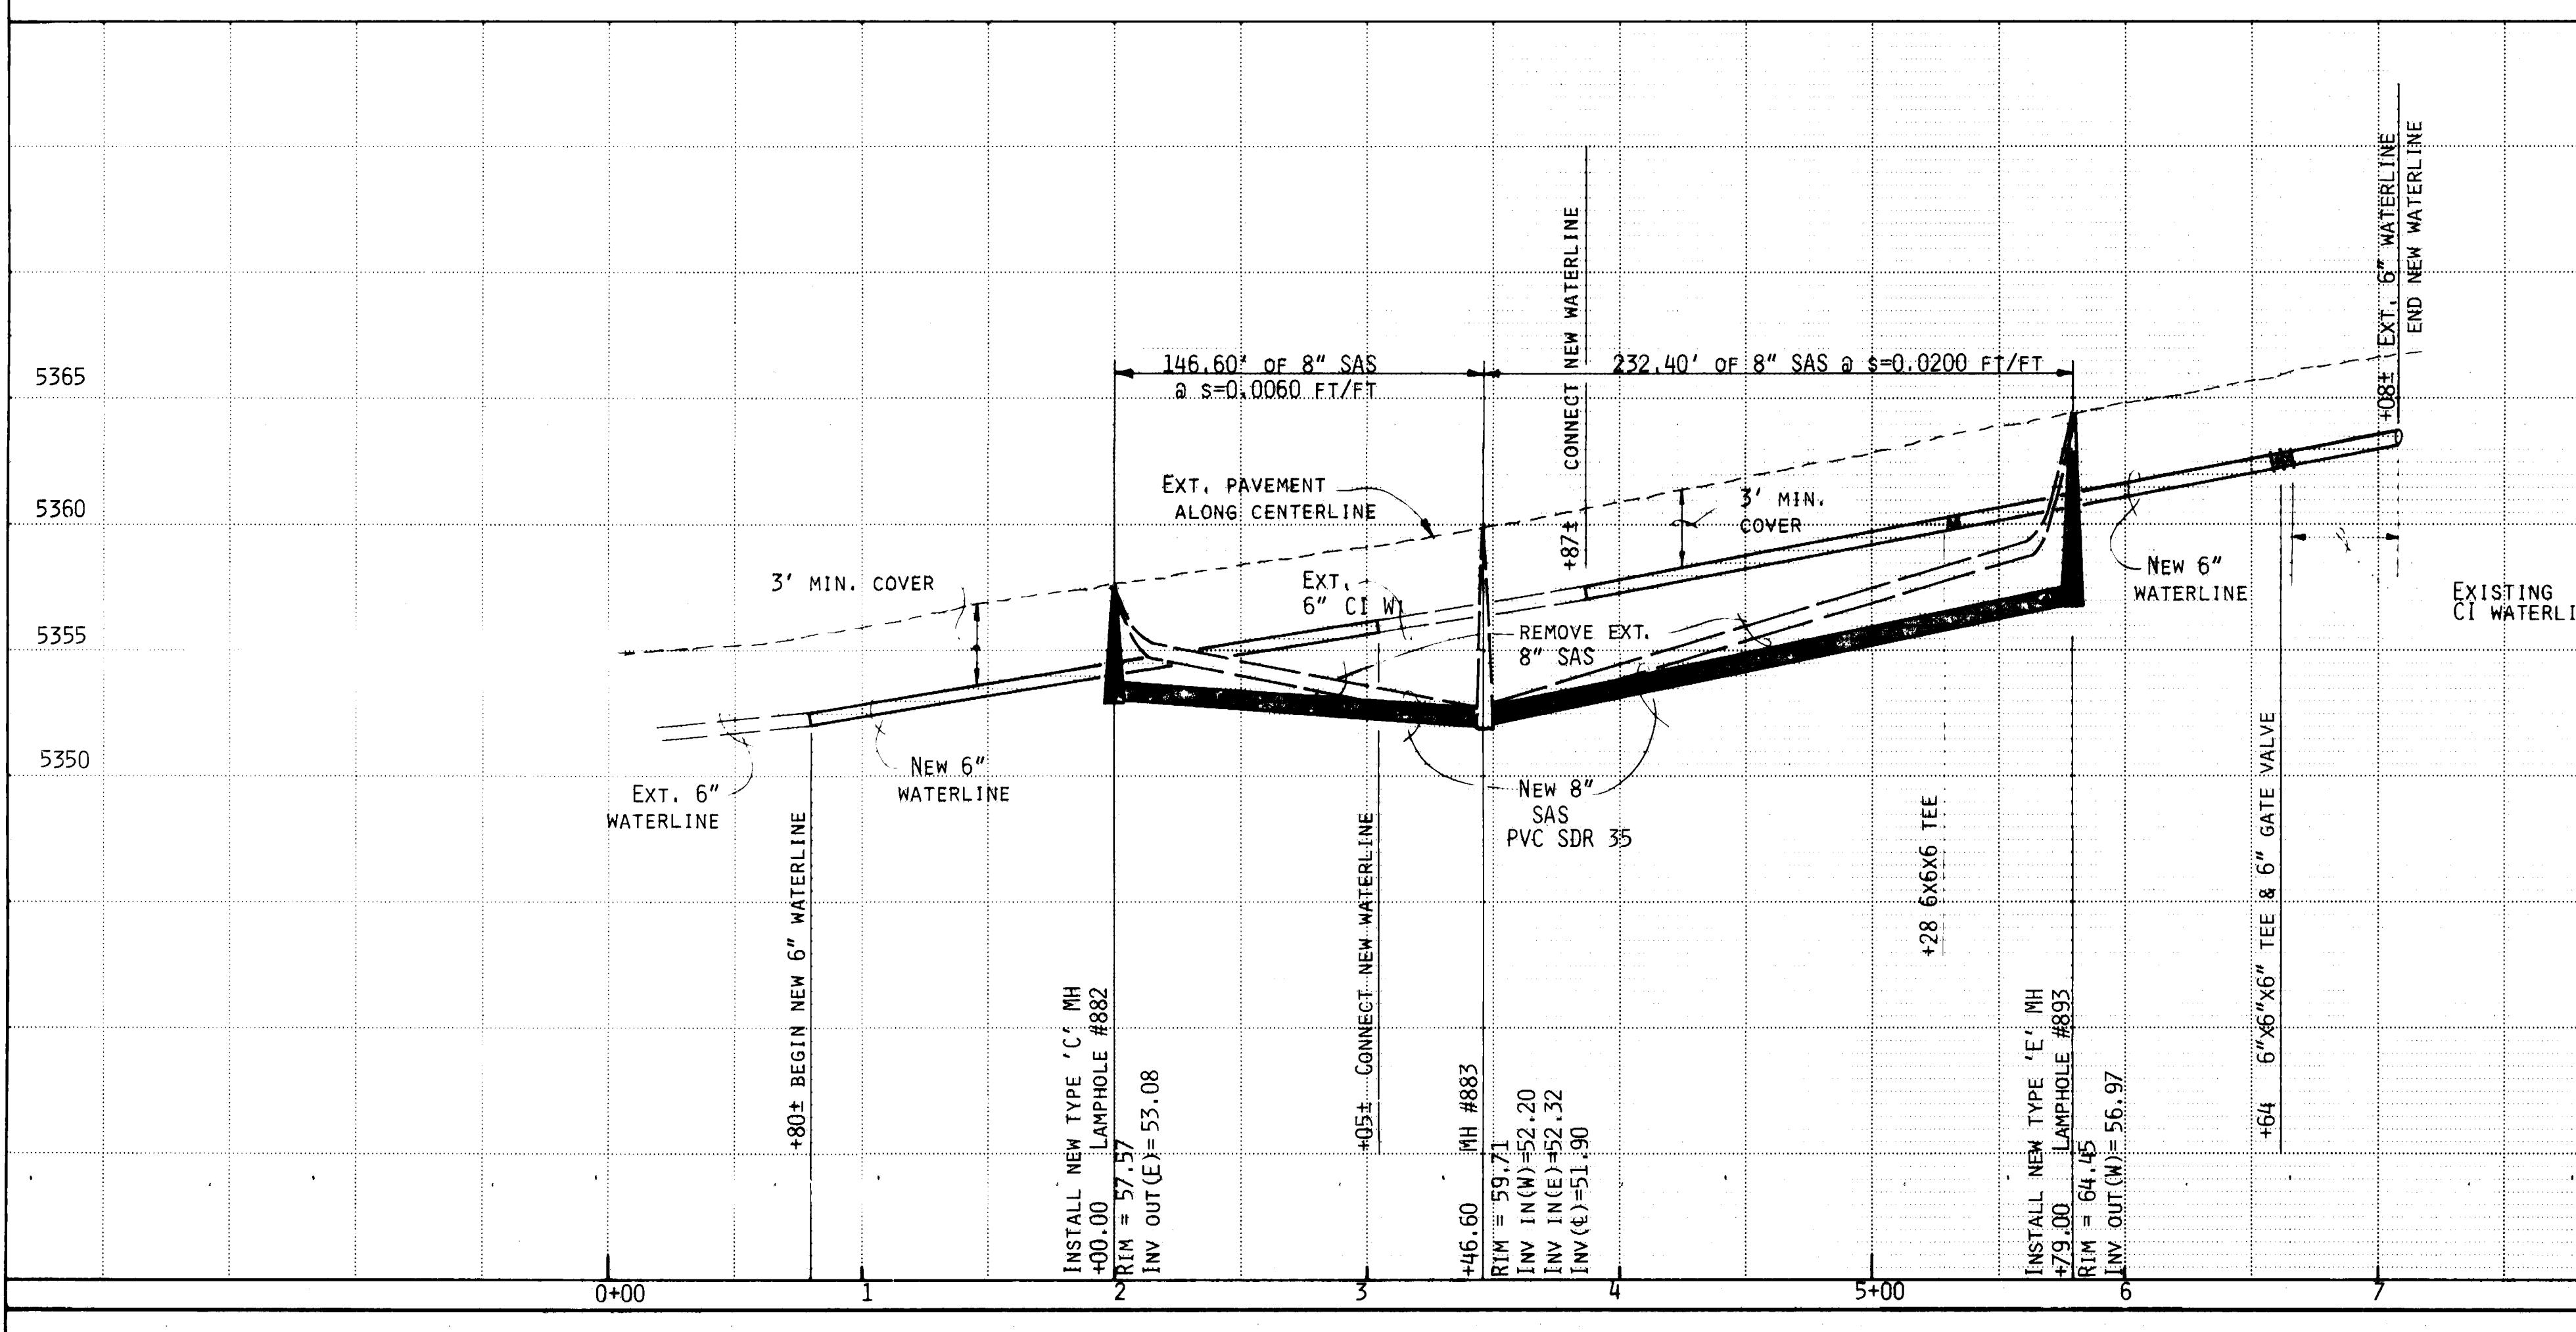

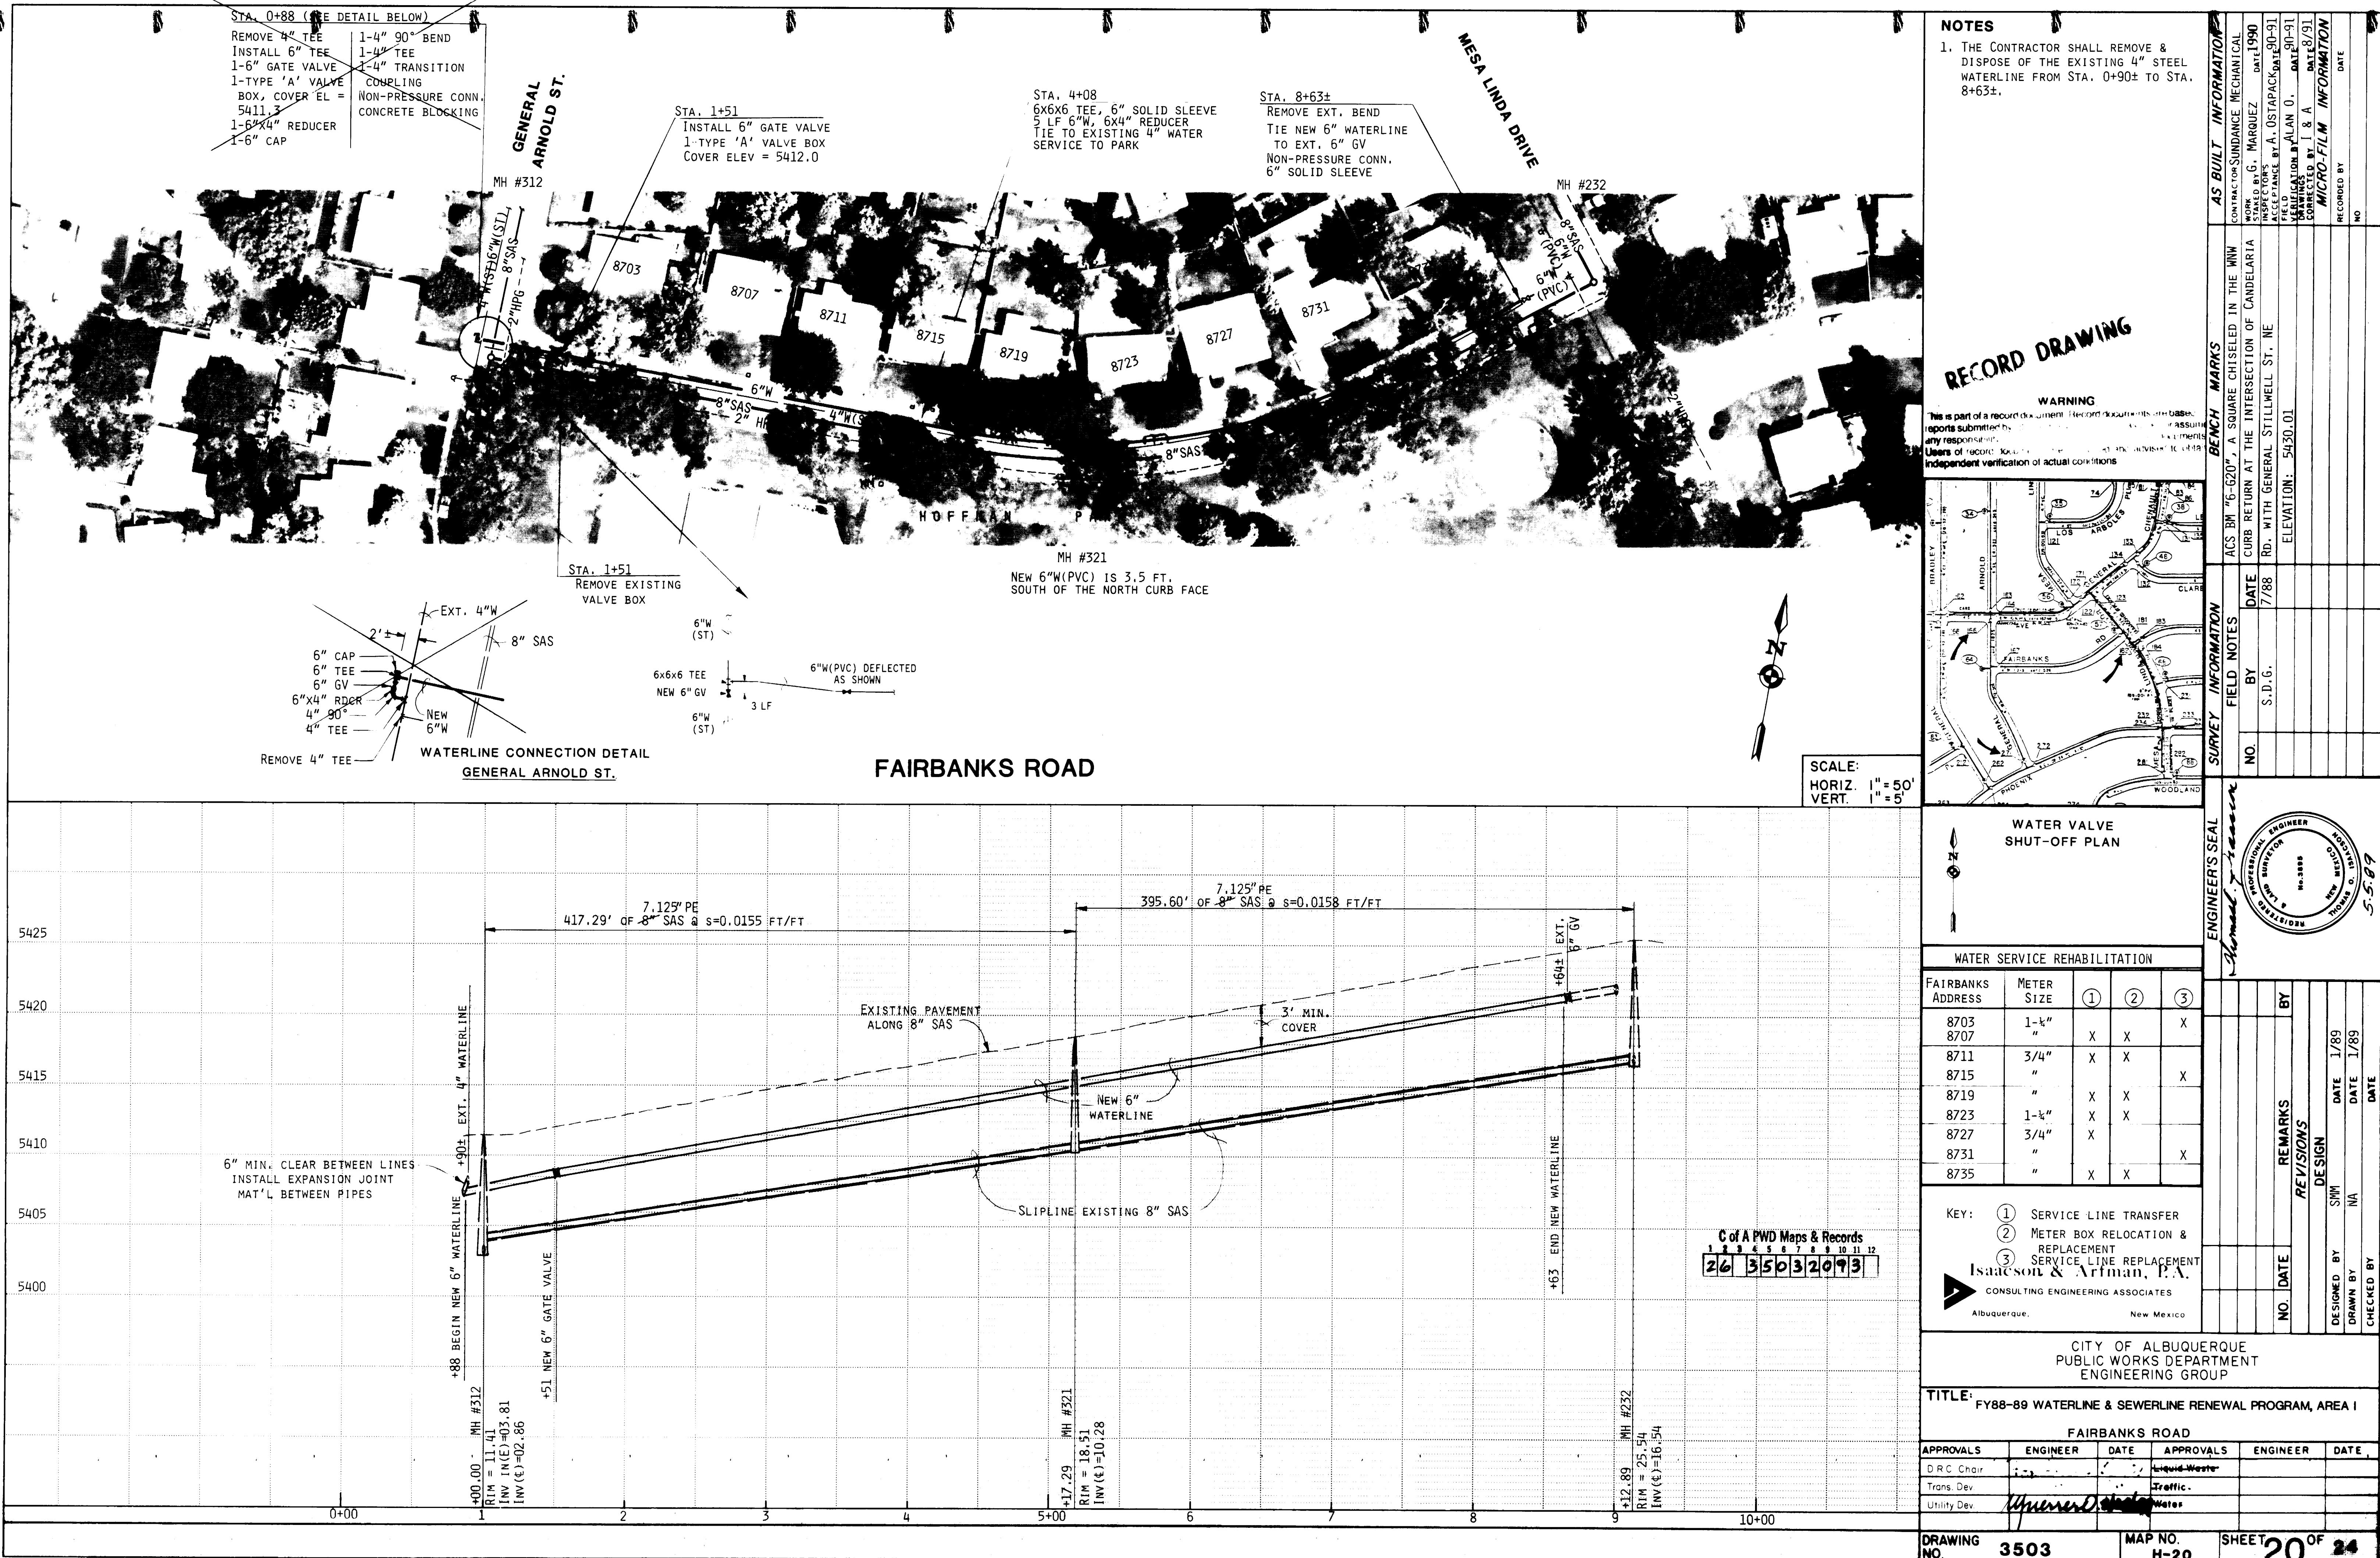


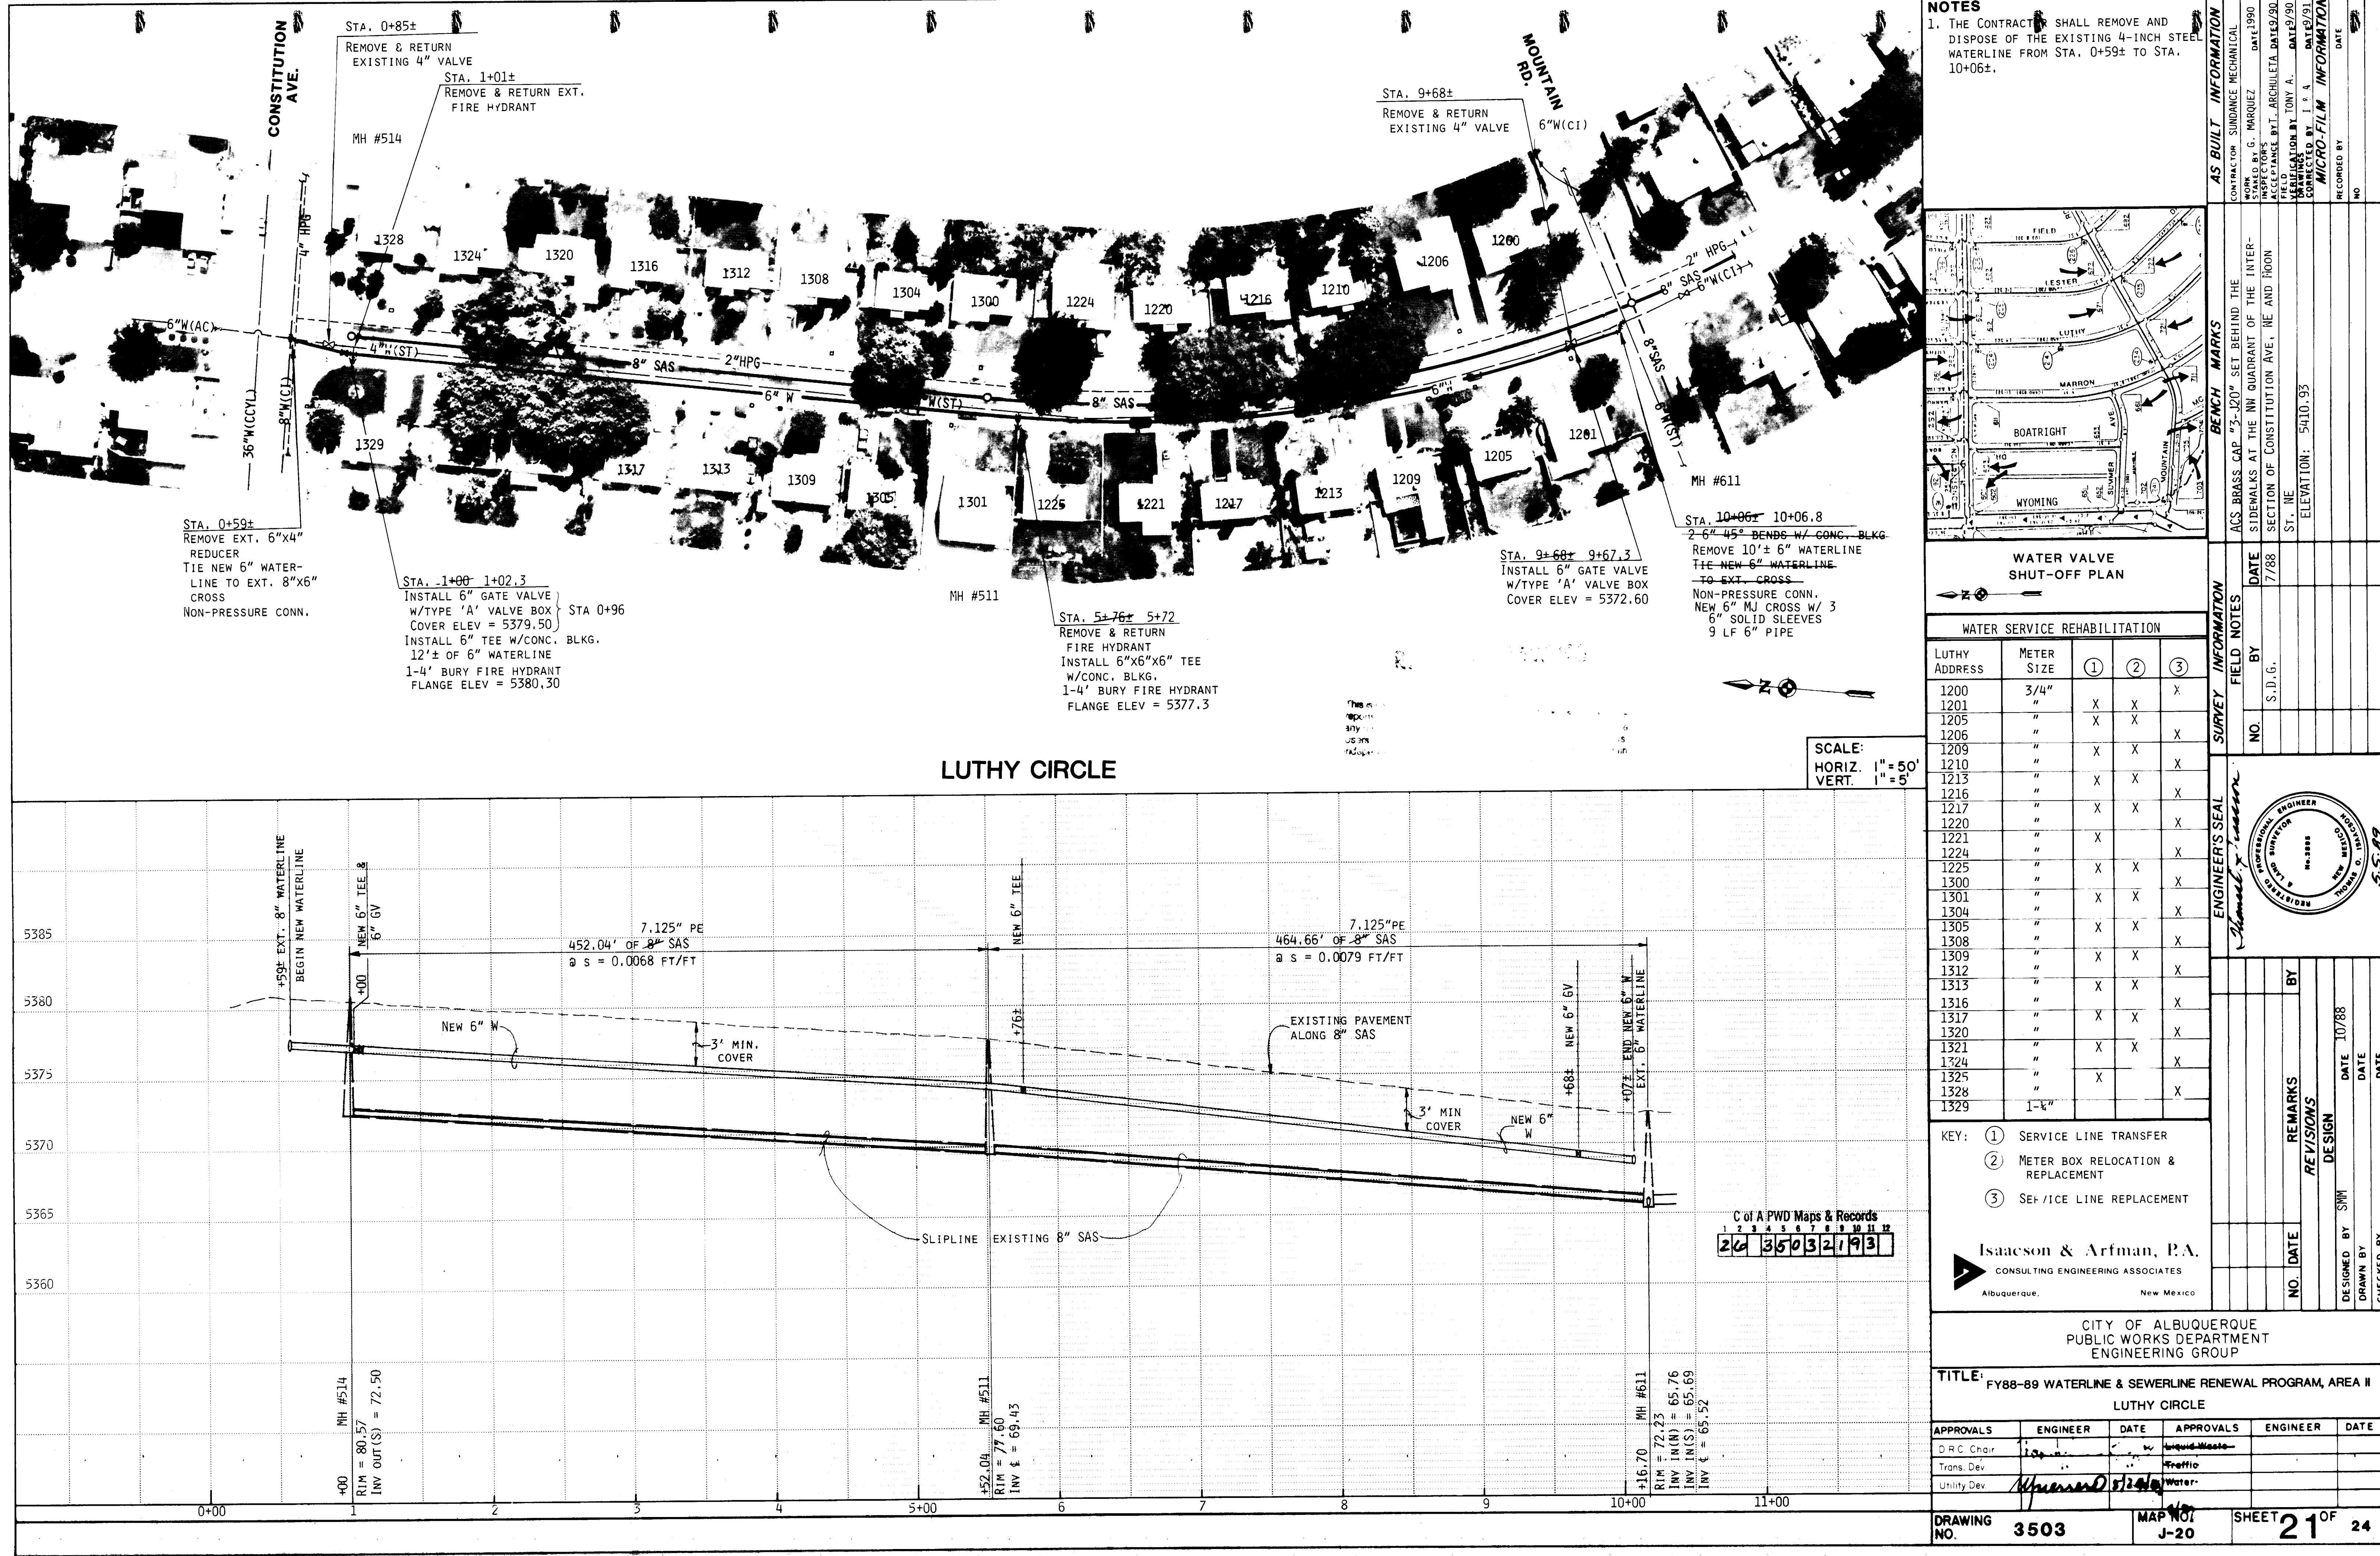

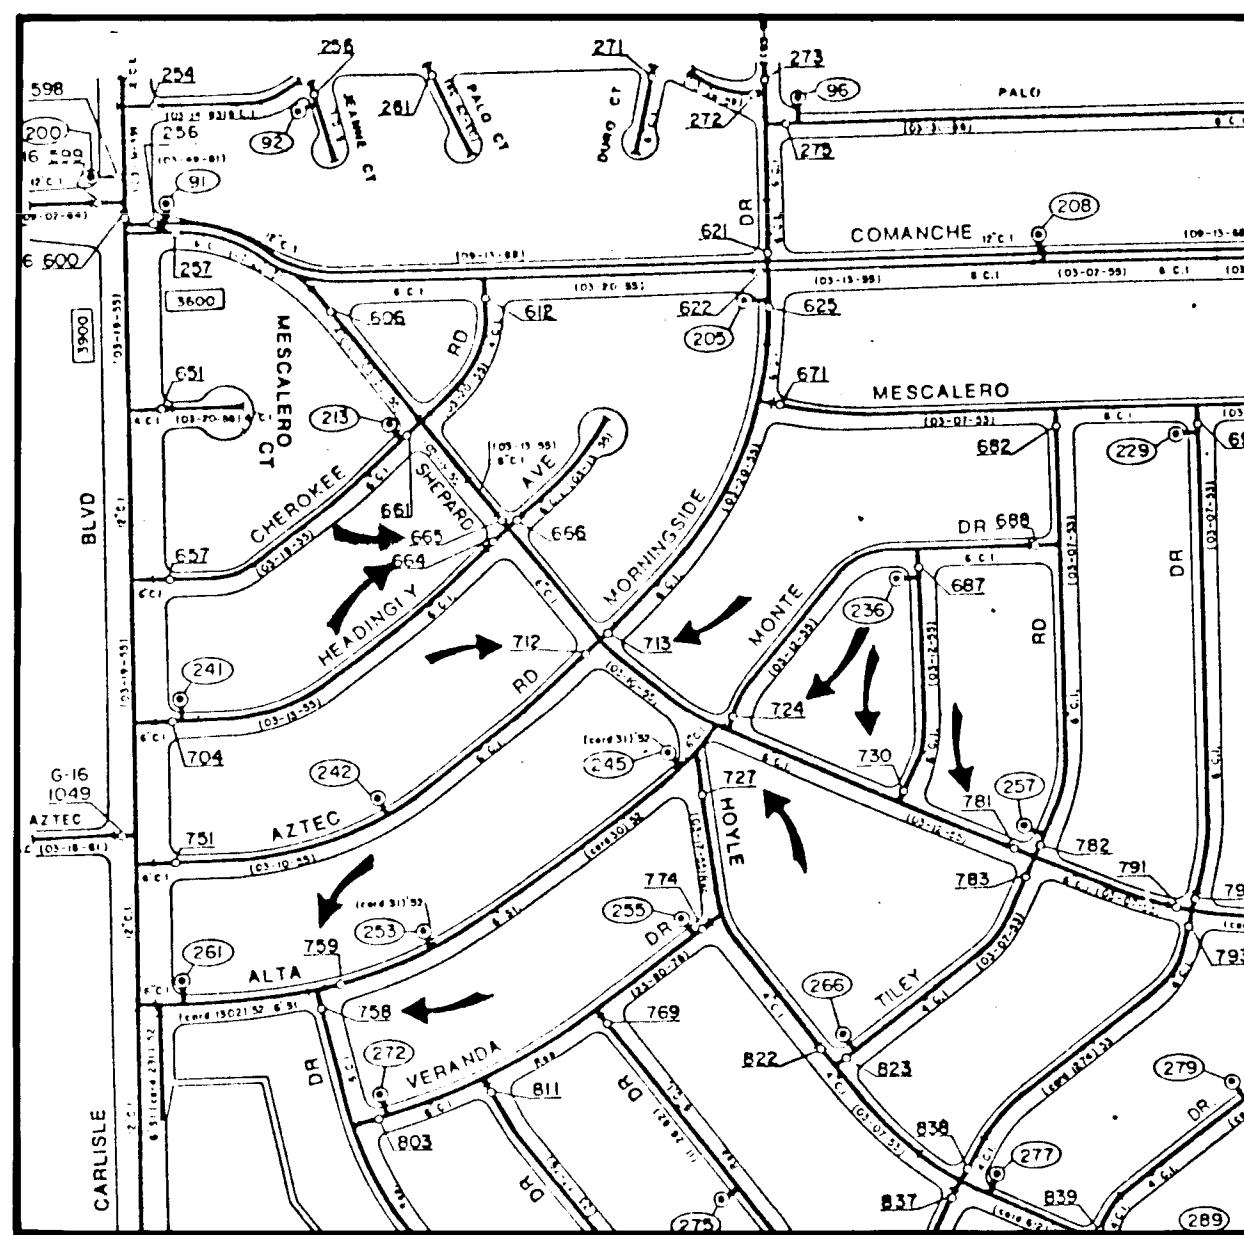


ALTA MONTE DRIVE
WATER VALVE SHUT-OFF PLAN

NOTE: 6" PRESSURE CONNECTION REQUIRED TO
12 CI PIPE IN CARLISLE.

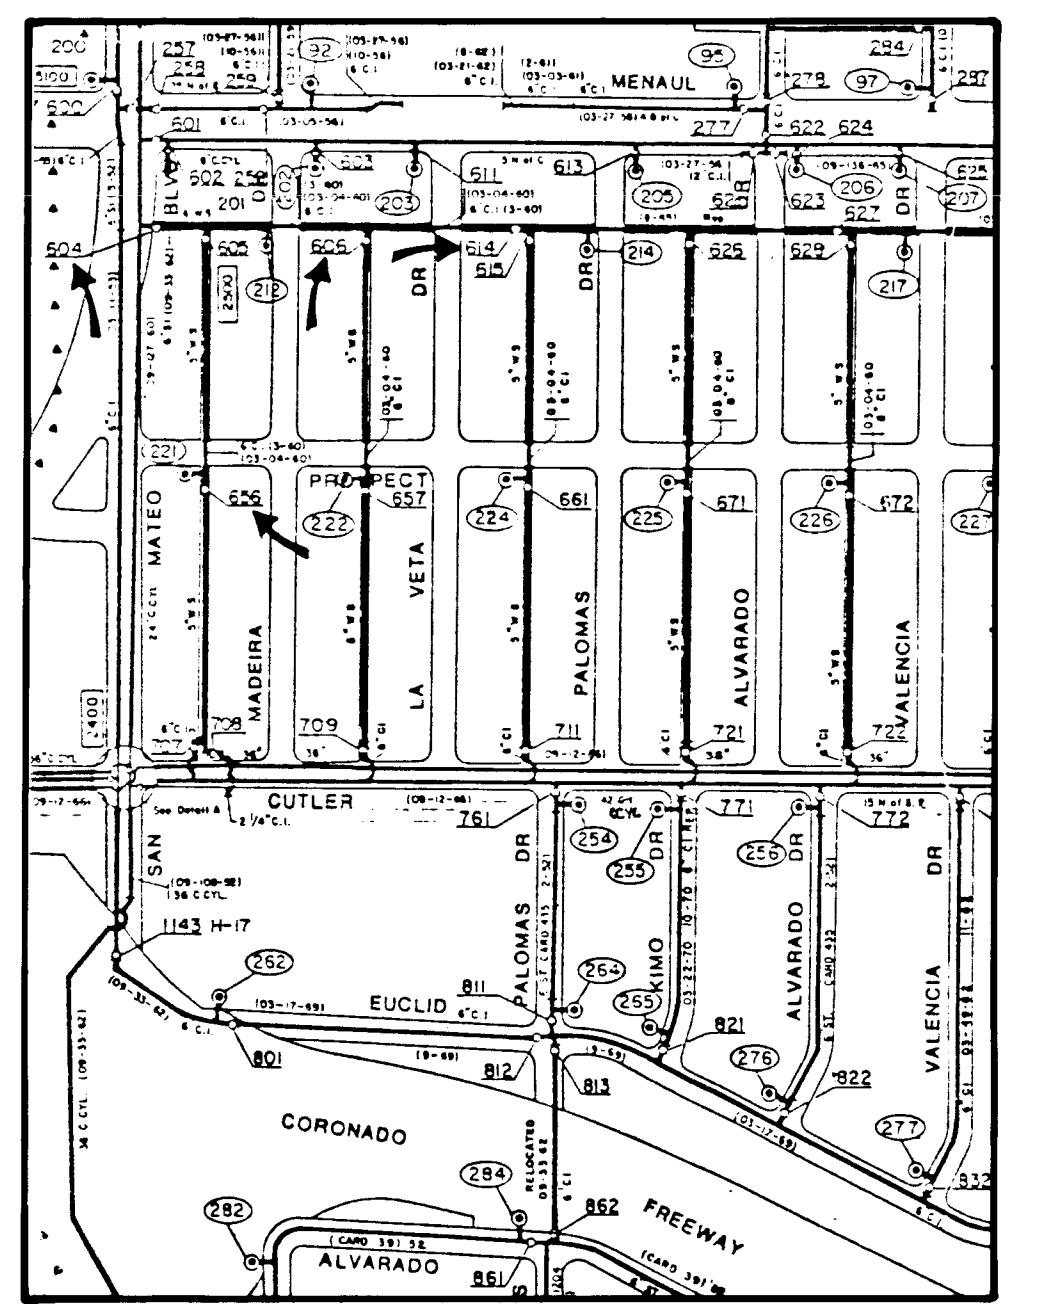

SAN MATEO EAST ALLEY
WATER VALVE SHUT-OFF PLAN

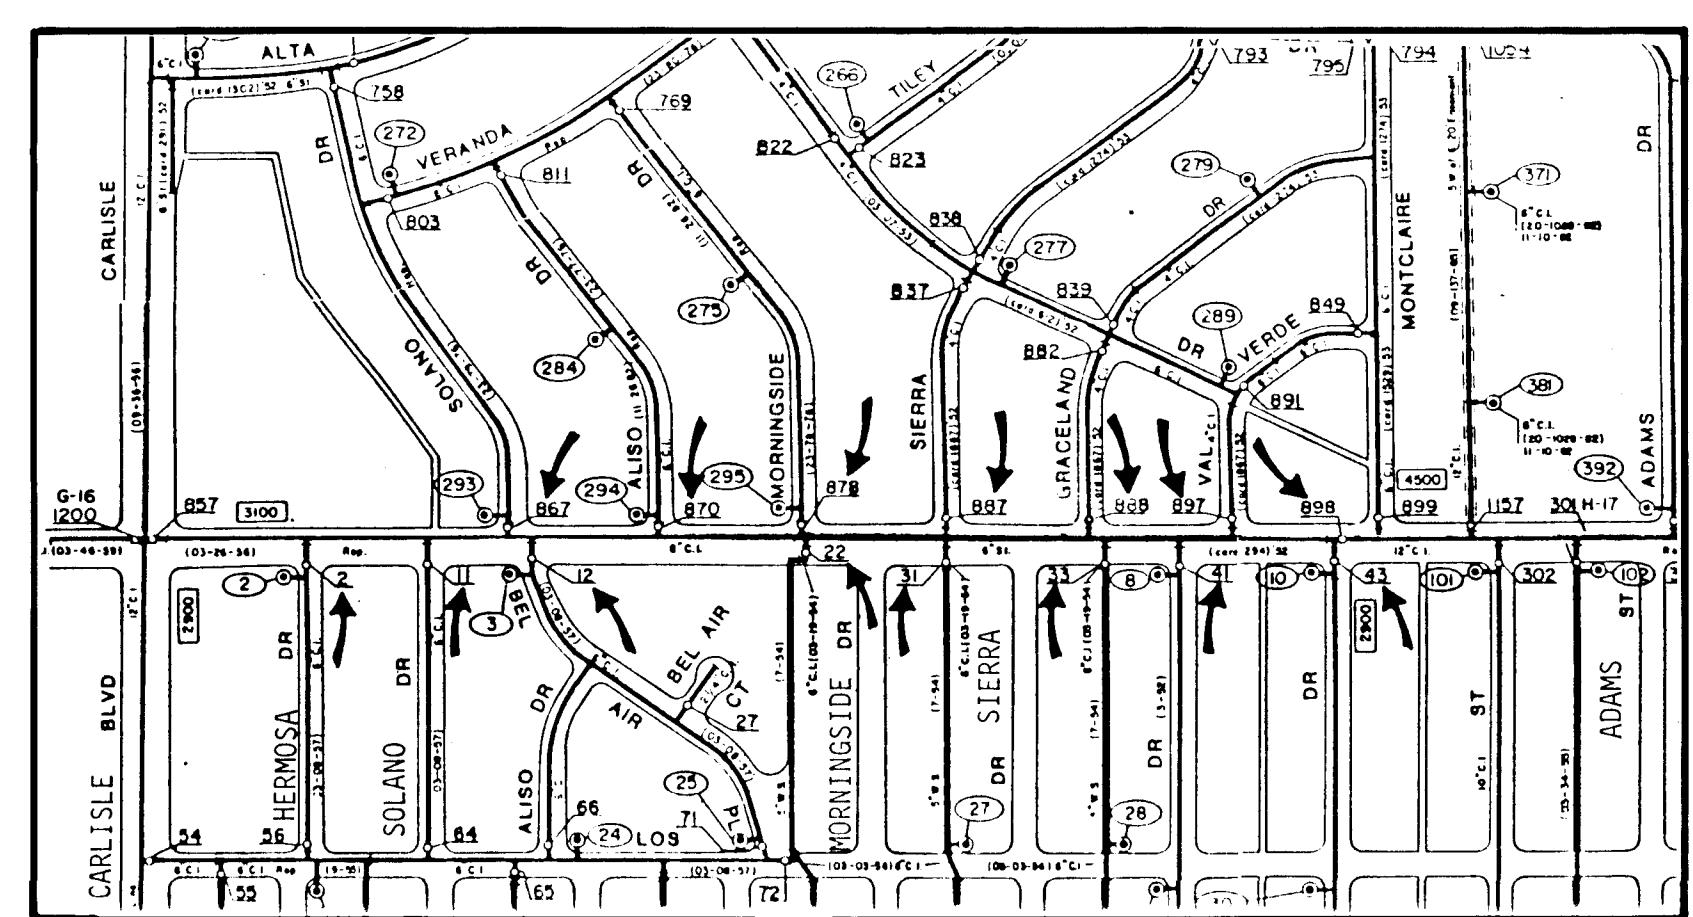

CANDELARIA ROAD
WATER VALVE SHUT-OFF PLAN

NOTE: 12" PRESSURE CONNECTION REQUIRED TO
12" CI PIPE IN CARLISLE.

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26 3503 2293

RECORD DRAWING

WARNING

This is part of a record document. Record documents are used to report submitted by the City of Albuquerque to assure for accurate any responsibility for the accuracy of record documents. Users of record documents are cautioned and advised to obtain independent verification of actual conditions.


CITY OF ALBUQUERQUE
PUBLIC WORKS DEPARTMENT
ENGINEERING GROUP

TITLE: FY 88-89 WATERLINE & SEWERLINE RENEWAL PROGRAM, AREA II
WATER VALVE SHUT-OFF PLANS
FOR SP-2,3, & 7


APPROVALS	ENGINEER	DATE	APPROVALS	ENGINEER	DATE
DRC Chair	<i>Ronald B. ...</i>	5/24/89			
Trans. Dev	"	"			
Utility Dev	<i>Munoz, 5/24/89</i>	5/24/89			

DRAWING NO. 3503 MAP NO. SHEET 22 OF 24

AS BUILT INFORMATION	
CONTRACTOR'S SUNDANCE MECHANICAL	WORK DATE 1990
INSPECTOR'S G. MARQUEZ	INSPECTED BY G. MARQUEZ
FIELD SURVEY DATE 9-0-91	FIELD SURVEY DATE 9-0-91
VERIFICATION DATE 9-0-91	VERIFICATION DATE 9-0-91
CORRECTED BY A. OSTAPACK	CORRECTED BY A. OSTAPACK
RECORDED BY	RECORDED BY
MICRO-FILM INFORMATION	
DATE NO.	

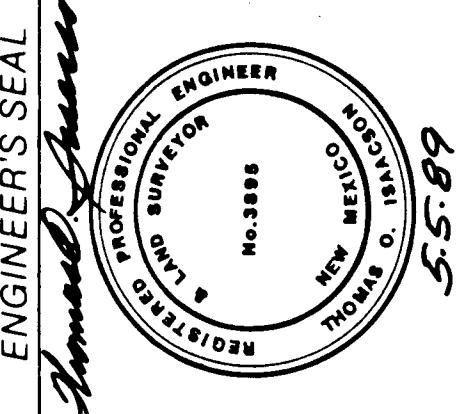


<p>SEE DETAIL 'A'</p> <p>SEE DETAIL 'B'</p>		<p>LINER TRANSITION: PRECO PLUG OR C. TY APPROVED EQUAL TO BE INSTALLED AT UPSTREAM END OF HDPE LINER. DOWNSTREAM END & LINER PULLED THROUGH MANHOLE WILL NOT REQUIRE LINER TRANSITION.</p> <p>HDPE LINER</p> <p>PLAN</p>																																					
<p>TYPICAL MID-LINE INSERTION SECTION</p> <p>NO SCALE</p> <p>TRANSVERSE SECTION</p> <p>LONGITUDINAL SECTION</p>		<p>LINER TRANSITION AT UPSTREAM MANHOLE</p> <p>NO SCALE</p> <p>CONCRETE POINT REPAIR</p> <p>NO SCALE</p>																																					
<p>TYPICAL MANHOLE INSERTION SECTION</p> <p>NO SCALE</p> <p>RECORD DRAWING</p> <p>WARNING</p> <p>This part of a record drawing contains information concerning the design, construction, and operation of public works facilities. It is the responsibility of the user to determine if the information contained herein is still valid and applicable. Users of record documents are cautioned and advised to obtain independent verification of actual conditions.</p> <p>NOTE: PULL LINER PIPE TO CENTER OF MANHOLE AND ALLOW 12 HOURS FOR CONTRACTION PRIOR TO TRIMMING.</p> <p>RESHAPE INVERT & BENCHES AS REQUIRED TO PROVIDE SMOOTH FLOWING CHARACTERISTICS</p> <p>TRIM LINER 2" FROM MANHOLE WALL SEE DETAIL 'A'</p>		<p>LONGITUDINAL SECTION</p>																																					
<p>DETAIL 'A'-MANHOLE WALL CONNECTION</p> <p>NO SCALE</p> <p>MANHOLE INVERT REHABILITATION</p> <p>NO SCALE</p> <p>PLAN VIEW OF MANHOLE W/CONCRETE INVERT</p> <p>NO SCALE</p> <p>SEE DETAIL 'A'</p> <p>NOTE: THIS TYPE INVERT TO BE USED EXCLUSIVELY IN MANHOLES w/3 OR MORE LINES & AT DOWNSTREAM ENDS OF LINER INSTALLATIONS.</p>		<p>TRANSVERSE SECTION</p> <p>SERVICE CONNECTION</p> <p>NO SCALE</p> <p>CITY OF ALBUQUERQUE PUBLIC WORKS DEPARTMENT ENGINEERING GROUP</p> <p>TITLE: FY88-89 WATERLINE & SEWERLINE RENEWAL PROGRAM, AREA II</p> <p>DETAIL SHEET</p> <table border="1"> <tr> <td>APPROVALS</td> <td>ENGINEER</td> <td>DATE</td> <td>APPROVALS</td> <td>ENGINEER</td> <td>DATE</td> </tr> <tr> <td>City Engr.</td> <td>Jay D. [Signature]</td> <td>5/24/91</td> <td>Liquid Waste</td> <td></td> <td></td> </tr> <tr> <td>ACE Design</td> <td>"</td> <td>"</td> <td>Traffic</td> <td>Roger [Signature]</td> <td>5/24/91</td> </tr> <tr> <td>ACE Hydrology</td> <td>"</td> <td>"</td> <td>Water</td> <td>[Signature]</td> <td></td> </tr> <tr> <td colspan="3">DRAFTED BY: [Signature] DATE: 5/24/91</td> <td colspan="3">CHECKED BY: [Signature] DATE: 5/24/91</td> </tr> <tr> <td>DRAWING NO.</td> <td>MAP NO.</td> <td>SHEET NO.</td> <td colspan="3">23 OF 24</td> </tr> </table>		APPROVALS	ENGINEER	DATE	APPROVALS	ENGINEER	DATE	City Engr.	Jay D. [Signature]	5/24/91	Liquid Waste			ACE Design	"	"	Traffic	Roger [Signature]	5/24/91	ACE Hydrology	"	"	Water	[Signature]		DRAFTED BY: [Signature] DATE: 5/24/91			CHECKED BY: [Signature] DATE: 5/24/91			DRAWING NO.	MAP NO.	SHEET NO.	23 OF 24		
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DRAWING NO.	MAP NO.	SHEET NO.	23 OF 24																																				

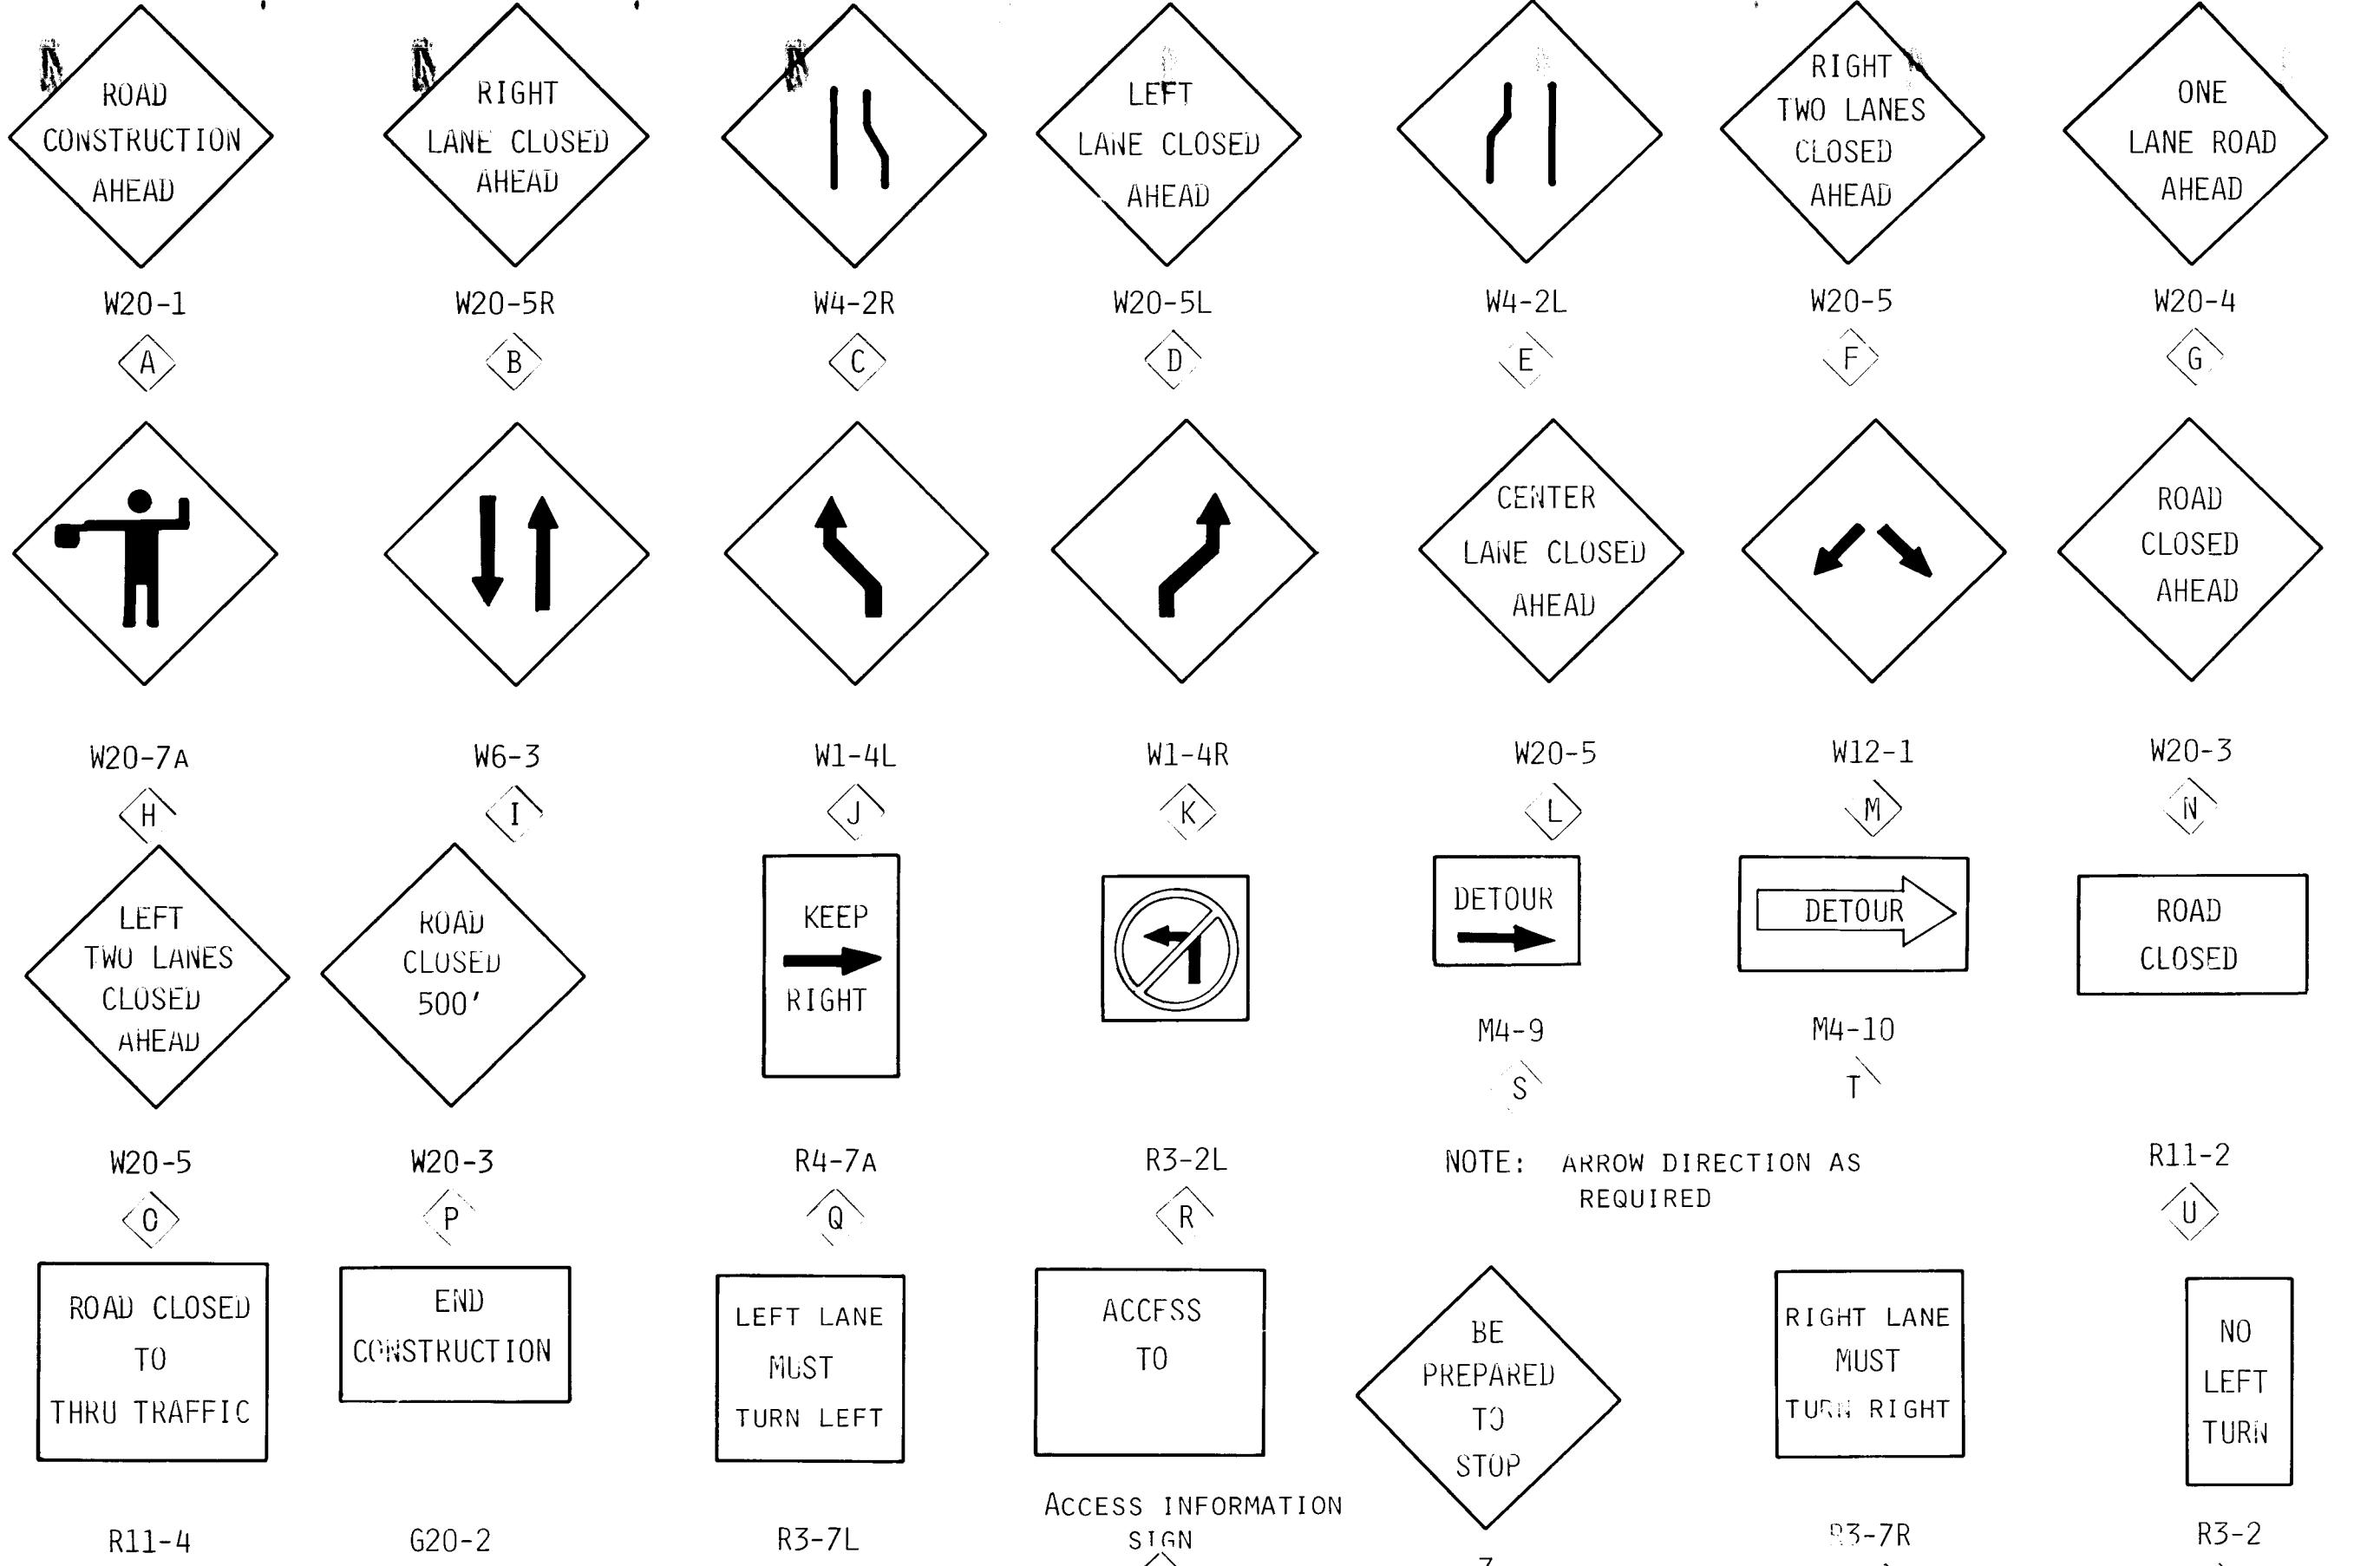


STANDARD SIGNS

NO SCALE

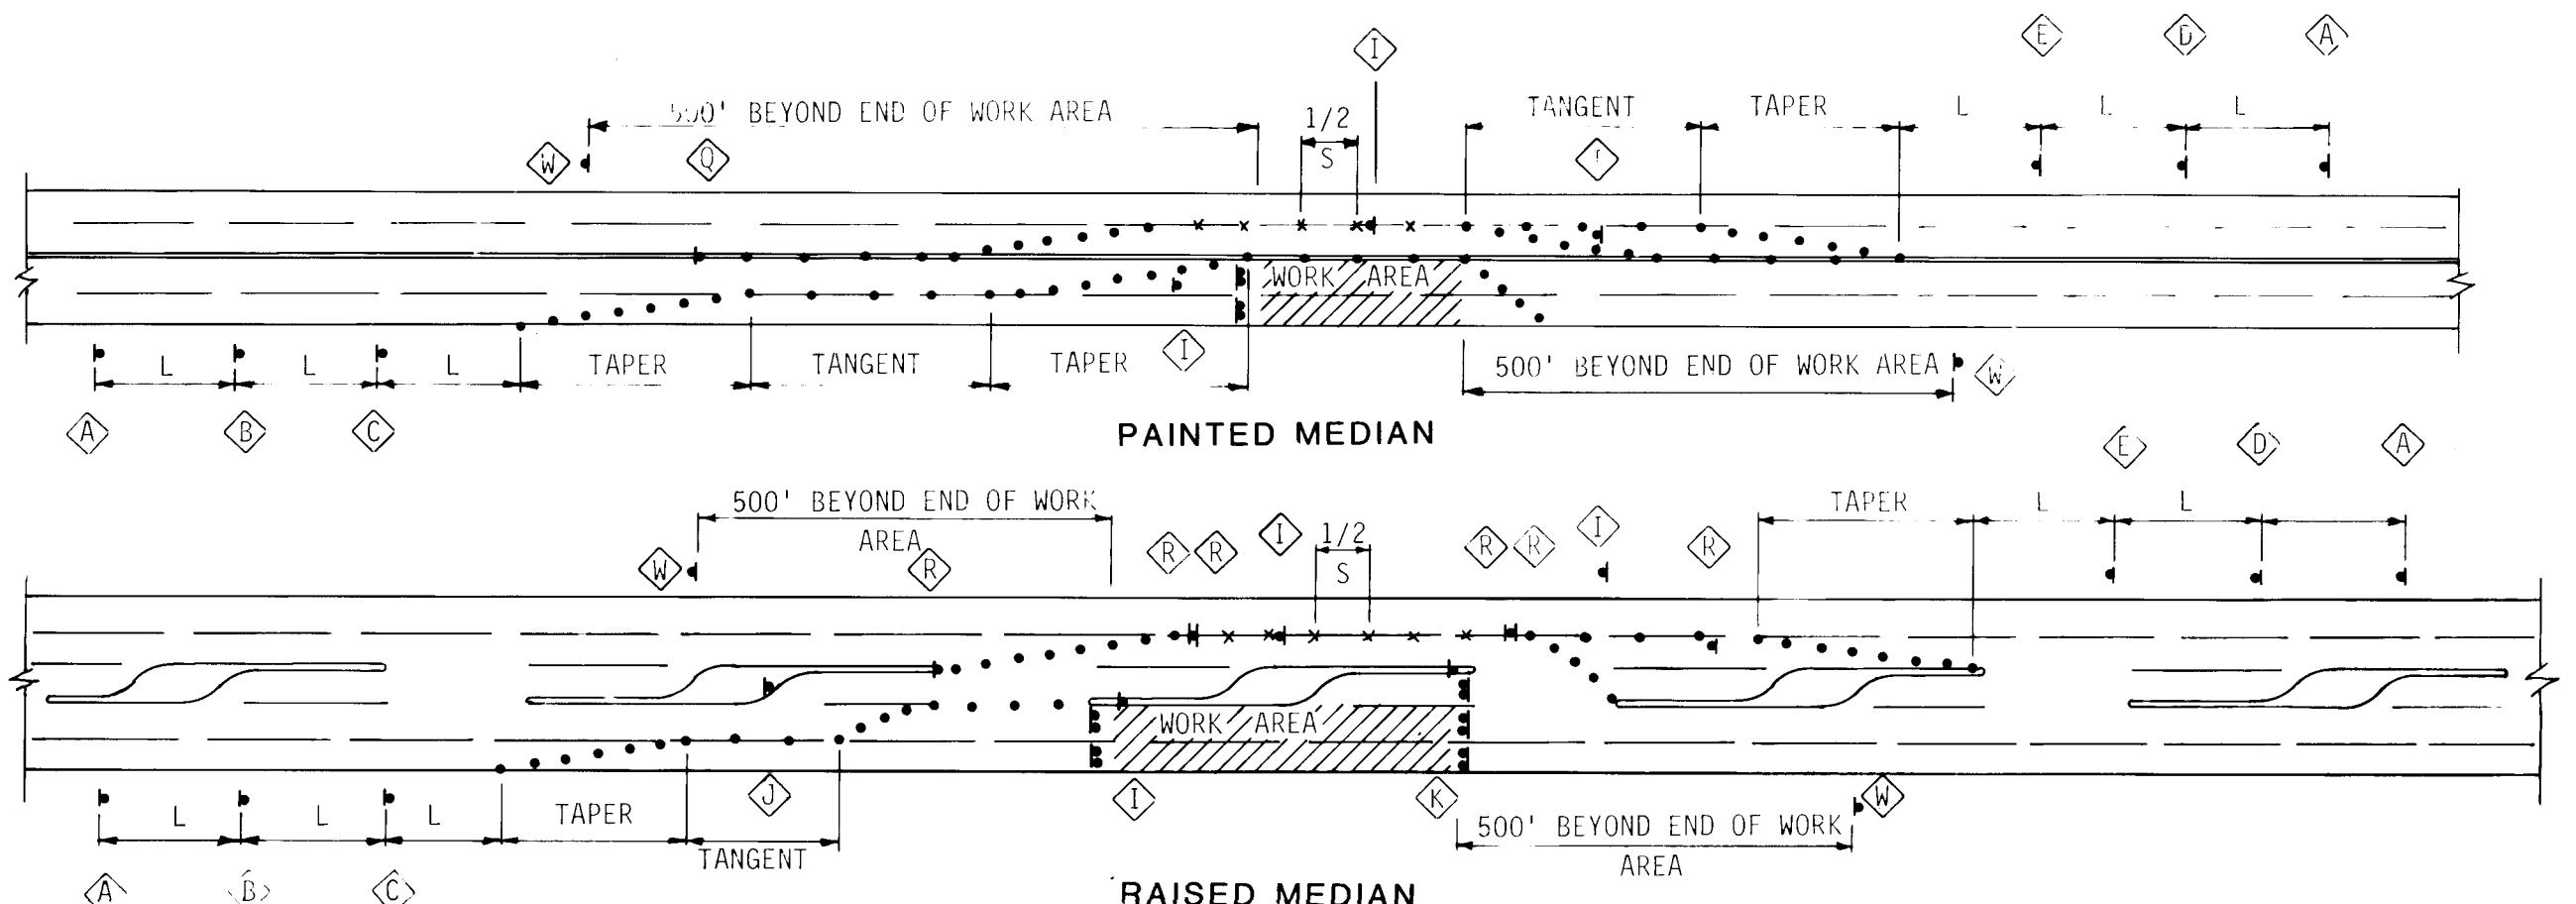

TYPICAL TRAFFIC SPLIT

NO SCALE

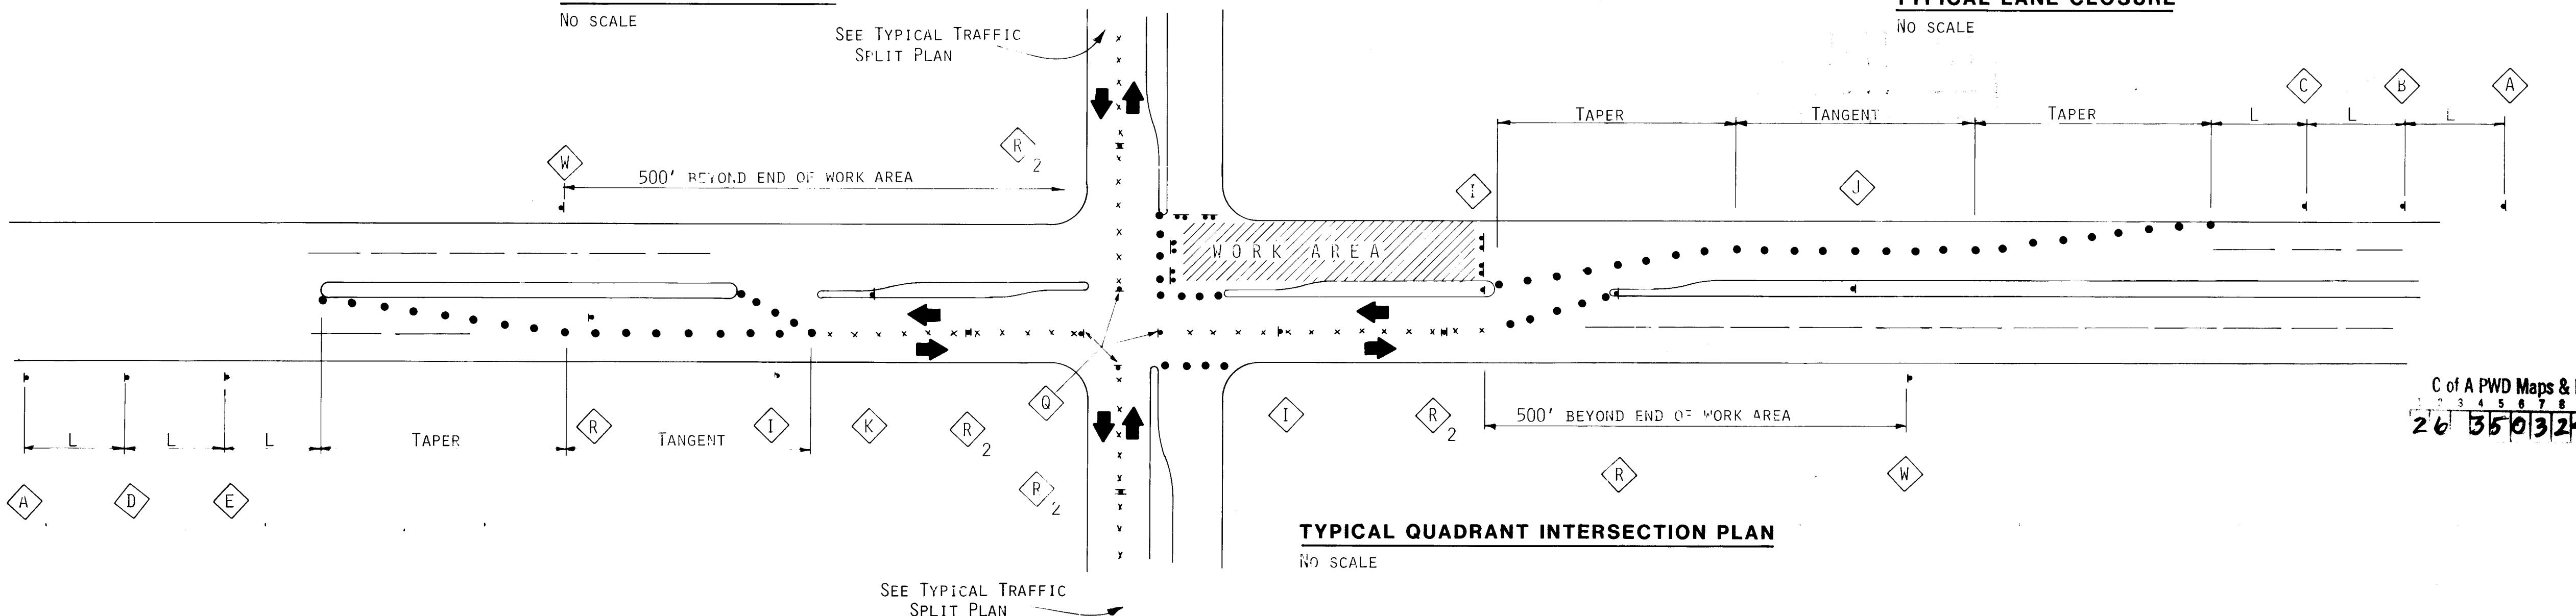


TAPER REQUIREMENTS			
SPEED LIMIT (MPH)	TAPER LENGTH (FEET)		
	10' LANE	11' LANE	12' LANE
25	104	115	125
30	150	165	185
35	204	225	245
40	267	293	320
45	450	495	540
50	500	550	600
55	550	605	660
			55
			13

LEGEND

	WORK AREA
	TRAFFIC SIGN & QUANTITY (SEE THIS SHEET FOR DESIGNATION)
	BARRICADE-TYPE I, TYPE II, OR BARREL
	BARRICADE-TYPE III
	VERTICAL PANEL
	WARNING SIGN
	DISTANCE BETWEEN SIGNS-A DISTANCE MEASURED IN FEET EQUAL TO A VALUE OF TEN TIMES THE SPEED LIMIT OF THE STREET
	SPACING BETWEEN BARRICADES-A DISTANCE MEASURED IN FEET EQUAL TO THE SPEED LIMIT OF THE STREET


TAPER LENGTH-SEE CHART ABOVE

TANGENT LENGTH-IS EQUAL TO 1.5X TAPER LENGTH FOR GIVEN STREET

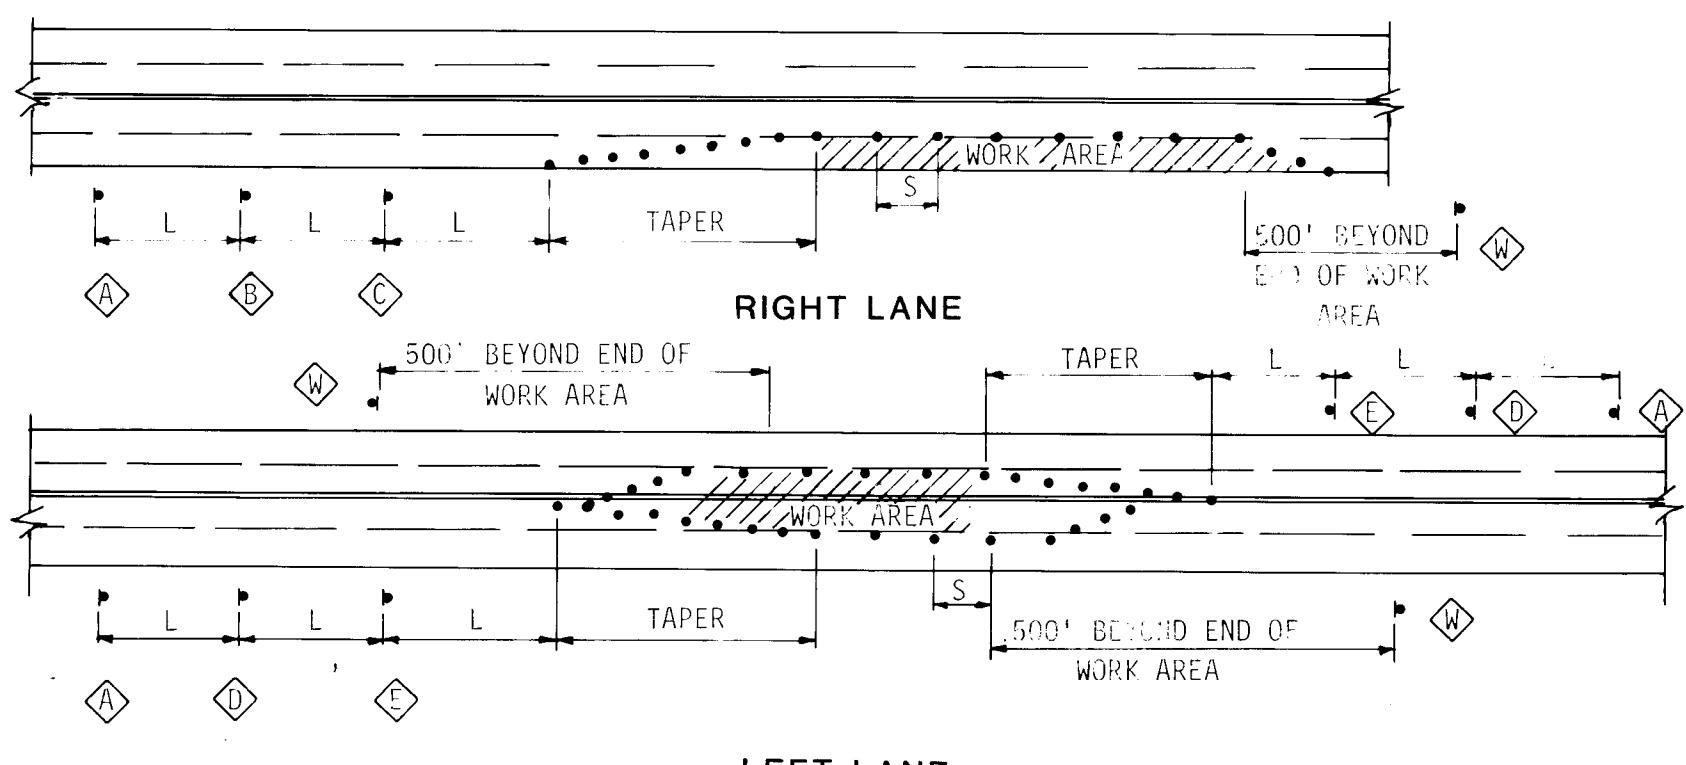

TYPICAL LANE CLOSURE

NO SCALE

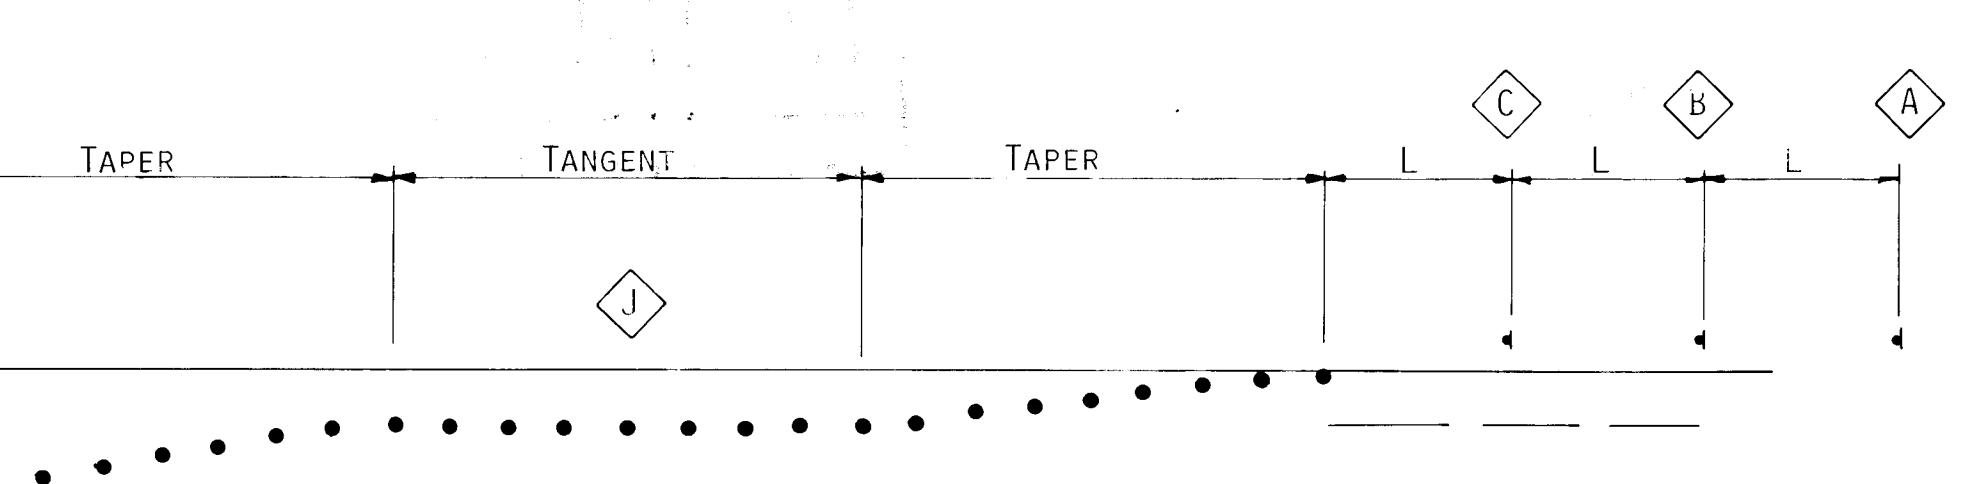

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26 3503 2493

GENERAL NOTES

- CONTRACTOR SHALL ADHERE TO SECTION 19 OF THE GENERAL CONDITIONS OF THE CITY OF ALBUQUERQUE STANDARD SPECIFICATIONS FOR PUBLIC WORKS CONSTRUCTION, 1986.
- ACCESS TO EACH PRIVATE RESIDENCE OR BUSINESS Affected BY THE CONSTRUCTION OF THIS PROJECT SHALL BE MAINTAINED AT ALL TIMES.
- CONTRACTOR'S HOURS OF OPERATION SHALL BE BETWEEN THE HOURS OF 8:30 AM AND 4:00 PM, SEVEN (7) DAYS A WEEK ON ALL COLLECTOR AND ARTERIAL STREETS.
- CONTRACTOR MUST MAINTAIN TWO WAY TRAFFIC ON COLLECTOR AND ARTERIAL STREETS.
- LANE CHANGES SHALL NOT BE MADE WHILE PASSING THROUGH AN INTERSECTION.
- IF A TRAFFIC SPLIT IS REQUIRED, CONTRACTOR SHALL NOTIFY A TRAFFIC ENGINEER.
- AT A SIGNALIZED INTERSECTION, ALL LEFT TURNS SHALL BE PROHIBITED, CONTRACTOR SHALL BE LIMITED TO TWO (2) WORKING DAYS IN A SIGNALIZED INTERSECTION.
- IF CONTRACTOR PLACES VEHICLE IN ROADWAY, VEHICLE WILL ONLY OCCUPY ONE LANE, BETWEEN THE HOURS OF 8:30 AM AND 4:00 PM FOR A MAXIMUM OF TWO (2) DAYS.
- CONTRACTOR SHALL NOT OCCUPY ANY NON-SIGNALIZED INTERSECTION FOR MORE THAN THREE (3) DAYS.
- AT NO TIME SHALL ANY RESIDENTIAL STREET OR COLLECTOR STREET BE CLOSED.
- ON ALL RESIDENTIAL STREETS, ONE LINE OF TRAFFIC MUST BE MAINTAINED AT ALL TIMES.
- TYPICAL TRAFFIC CONTROL PLANS SHOWN ON THIS SHEET ARE SCHEMATIC. IT IS THE CONTRACTOR'S RESPONSIBILITY TO HAVE DETAILED PLANS PREPARED FOR EACH SITE IN ACCORDANCE WITH THE FIELD CONDITIONS PRESENT AT THE PROJECT SITES & SECTION 19 OF THE SPECIFICATIONS REFERENCED ABOVE.
- ALL WORK ON CARLISLE AND PENNSYLVANIA SHALL BE ACCOMPLISHED DURING SATURDAYS AND SUNDAYS.
- CONTRACTOR SHALL COMPLY WITH SECTION SP-3 OF THE SPECIFICATIONS REGARDING CONSTRUCTION WORK AFFECTING CANDLESTICK, CARLISLE, PENNSYLVANIA, CONSTITUTION, AND COMANCHE STREETS.
- CONTRACTOR SHALL CONTACT CITY BARRICADE ENGINEER @ 768-2551 TO OBTAIN A BARRICADE PERMIT PRIOR TO OCCUPYING AN INTERSECTION OR STARTING CONSTRUCTION AT A NEW SITE.

RECORD DRAWING

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CITY OF ALBUQUERQUE
PUBLIC WORKS DEPARTMENT
ENGINEERING GROUP

TITLE: FY 88-89 WATERLINE & SEWERLINE RENEWAL PROGRAM, AREA II
TRAFFIC CONTROL PLAN

APPROVALS	ENGINEER	DATE	APPROVALS	ENGINEER	DATE
DRC Chair	Fernando J. Sanchez	5/24/89	Trans Dev	"	"
Utility Dev	PECO	5/24/89			

DRAWING NO. 3503 MAP NO. SHEET 24 OF 24

CONTRACTOR'S SUNDAY MECHANICAL
WORK
STATE OF NEW MEXICO
INSPECTOR'S DATE 5/24/89
FIELD INSPECTOR'S DATE 5/24/89
FIELD DRAWINGS BY G. MARQUEZ
MICRO-FILM INFORMATION DATE 5/24/89

RECORDED BY NO