


CITY OF ALBUQUERQUE FIRE DEPARTMENT

FIRE STATION NO. 10 MODIFICATIONS

WARNING/DISCLAIMER

ARCHITECTS, CONTRACTORS AND BUILDING OWNERS MUST COMPLY WITH THE AMERICANS WITH DISABILITIES ACT (ADA) AND THE AMERICANS WITH DISABILITIES ARCHITECTURAL GUIDELINES (ADAAG). THE CODE

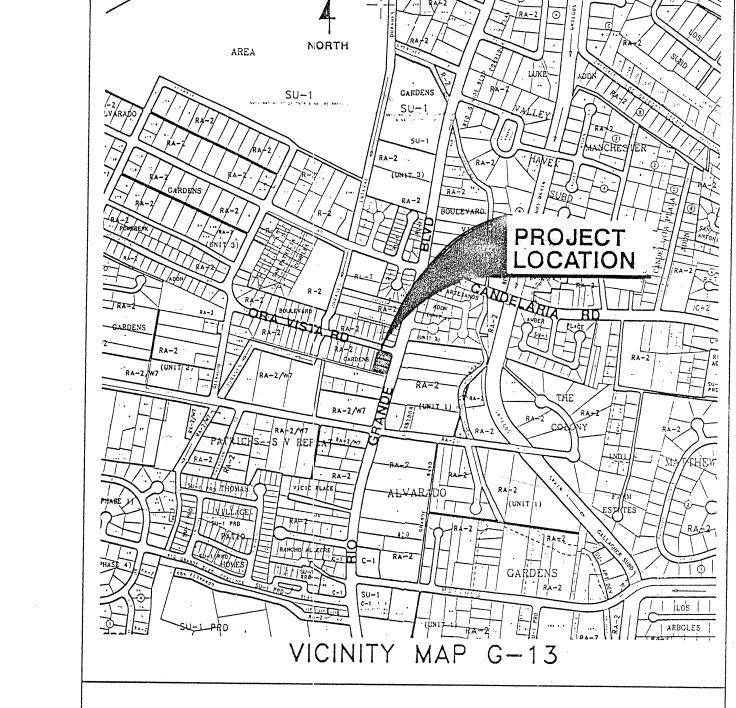

CODE DESIGN DATA

OCCUPANCY GROUP

B-2

TYPE OF CONSTRUCTION AREA OF EACH FLOOR

TYPE V-N (EXISTING)

N/A

OCCUPANT LOAD

SEISMIC ZONE

2B

SOIL BEARING CAPACITY. 1000 PSF

CONCRETE STRENGTH 3000 PSI (28 DAY)

STRESS VALUES:

STEEL

ASTM A500 GRADE B - TUBES ASTM A36 - ALL OTHER

WIND DESIGN LOAD 80 MPH, EXP C

ROOF DESIGN LOAD FLOOR DESIGN LOAD

150 PSF OVER EXISTING MECHANICAL ROOM

20 PSF

CORRIDOR DESIGN LOAD N/A

ALBUQUERQUE BUILDING CODE 301 (d)

INDEX OF DRAWINGS

TITLE SHEET

DEMOLITION PLANS

D-1

T-1

E-1

ARCHITECTURAL FLOOR PLAN AND DETAILS ARCHITECTURAL DOOR AND ROOM FINISH SCHED. A-2

STRUCTURAL PLANS AND GENERAL NOTES S-1 STRUCTURAL DETAILS AND SECTIONS S-2

MECHANICAL PLANS AND DETAILS M-1

ELECTRICAL FLOOR PLANS AND SCHEDULES


2841 Rio Grande NW REV. SHEETS CITY ENGR. USER DEPT. DATE DATE USER DEPT. APPROVAL OF REVISIONS APPROVED FOR CONSTRUCTION


6501 AMERICAS PARKWAY, SUITE 700 ALBUQUERQUE, NEW MEXICO 87110 PHONE (505) 889-4100


PROJECT NO. 4670.90

SHEET T-1 OF 8

34H 17 1994

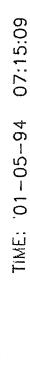

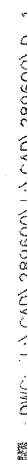

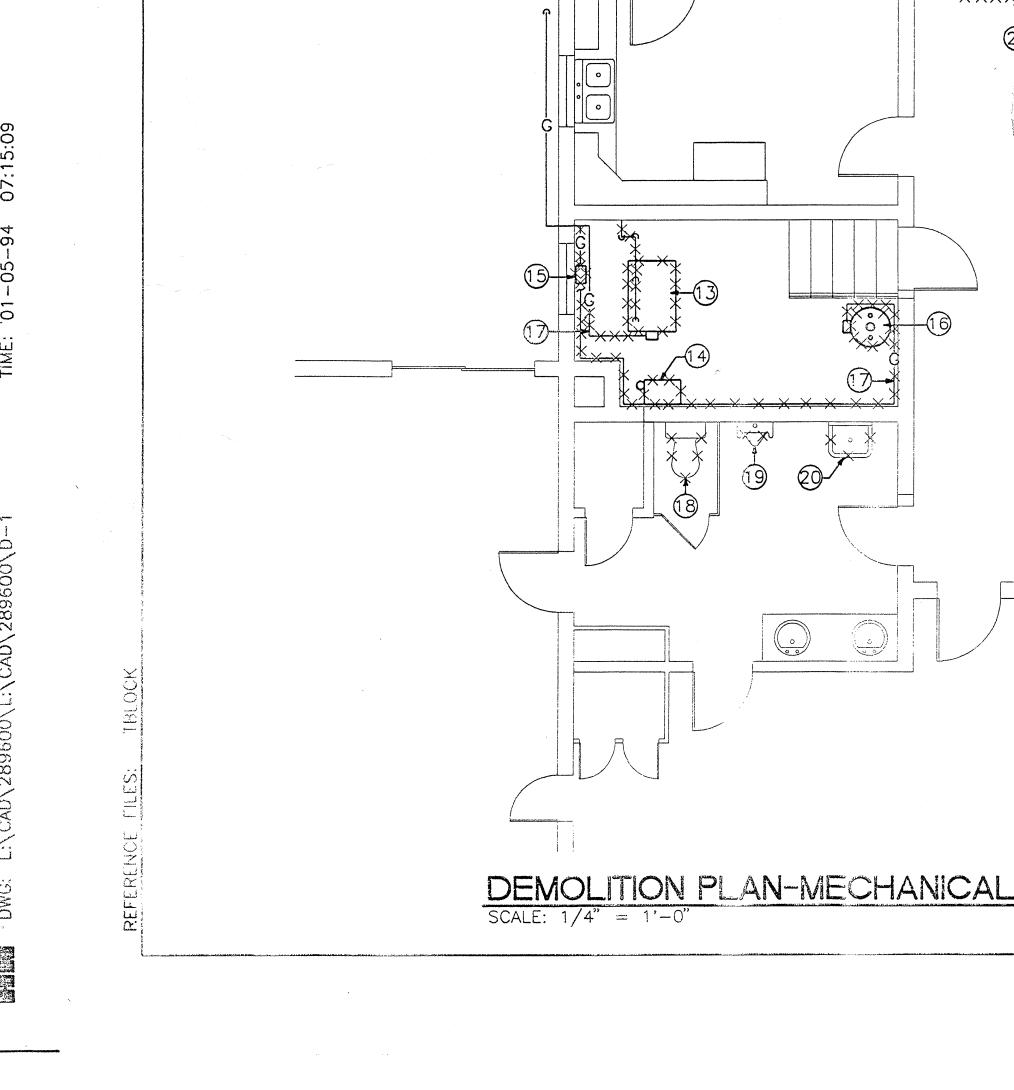


7'-6"

/×-×-×-×-×-×-×-×**/**


MECH.

RESTROOM


SCALE: 1/4" = 1'-0"

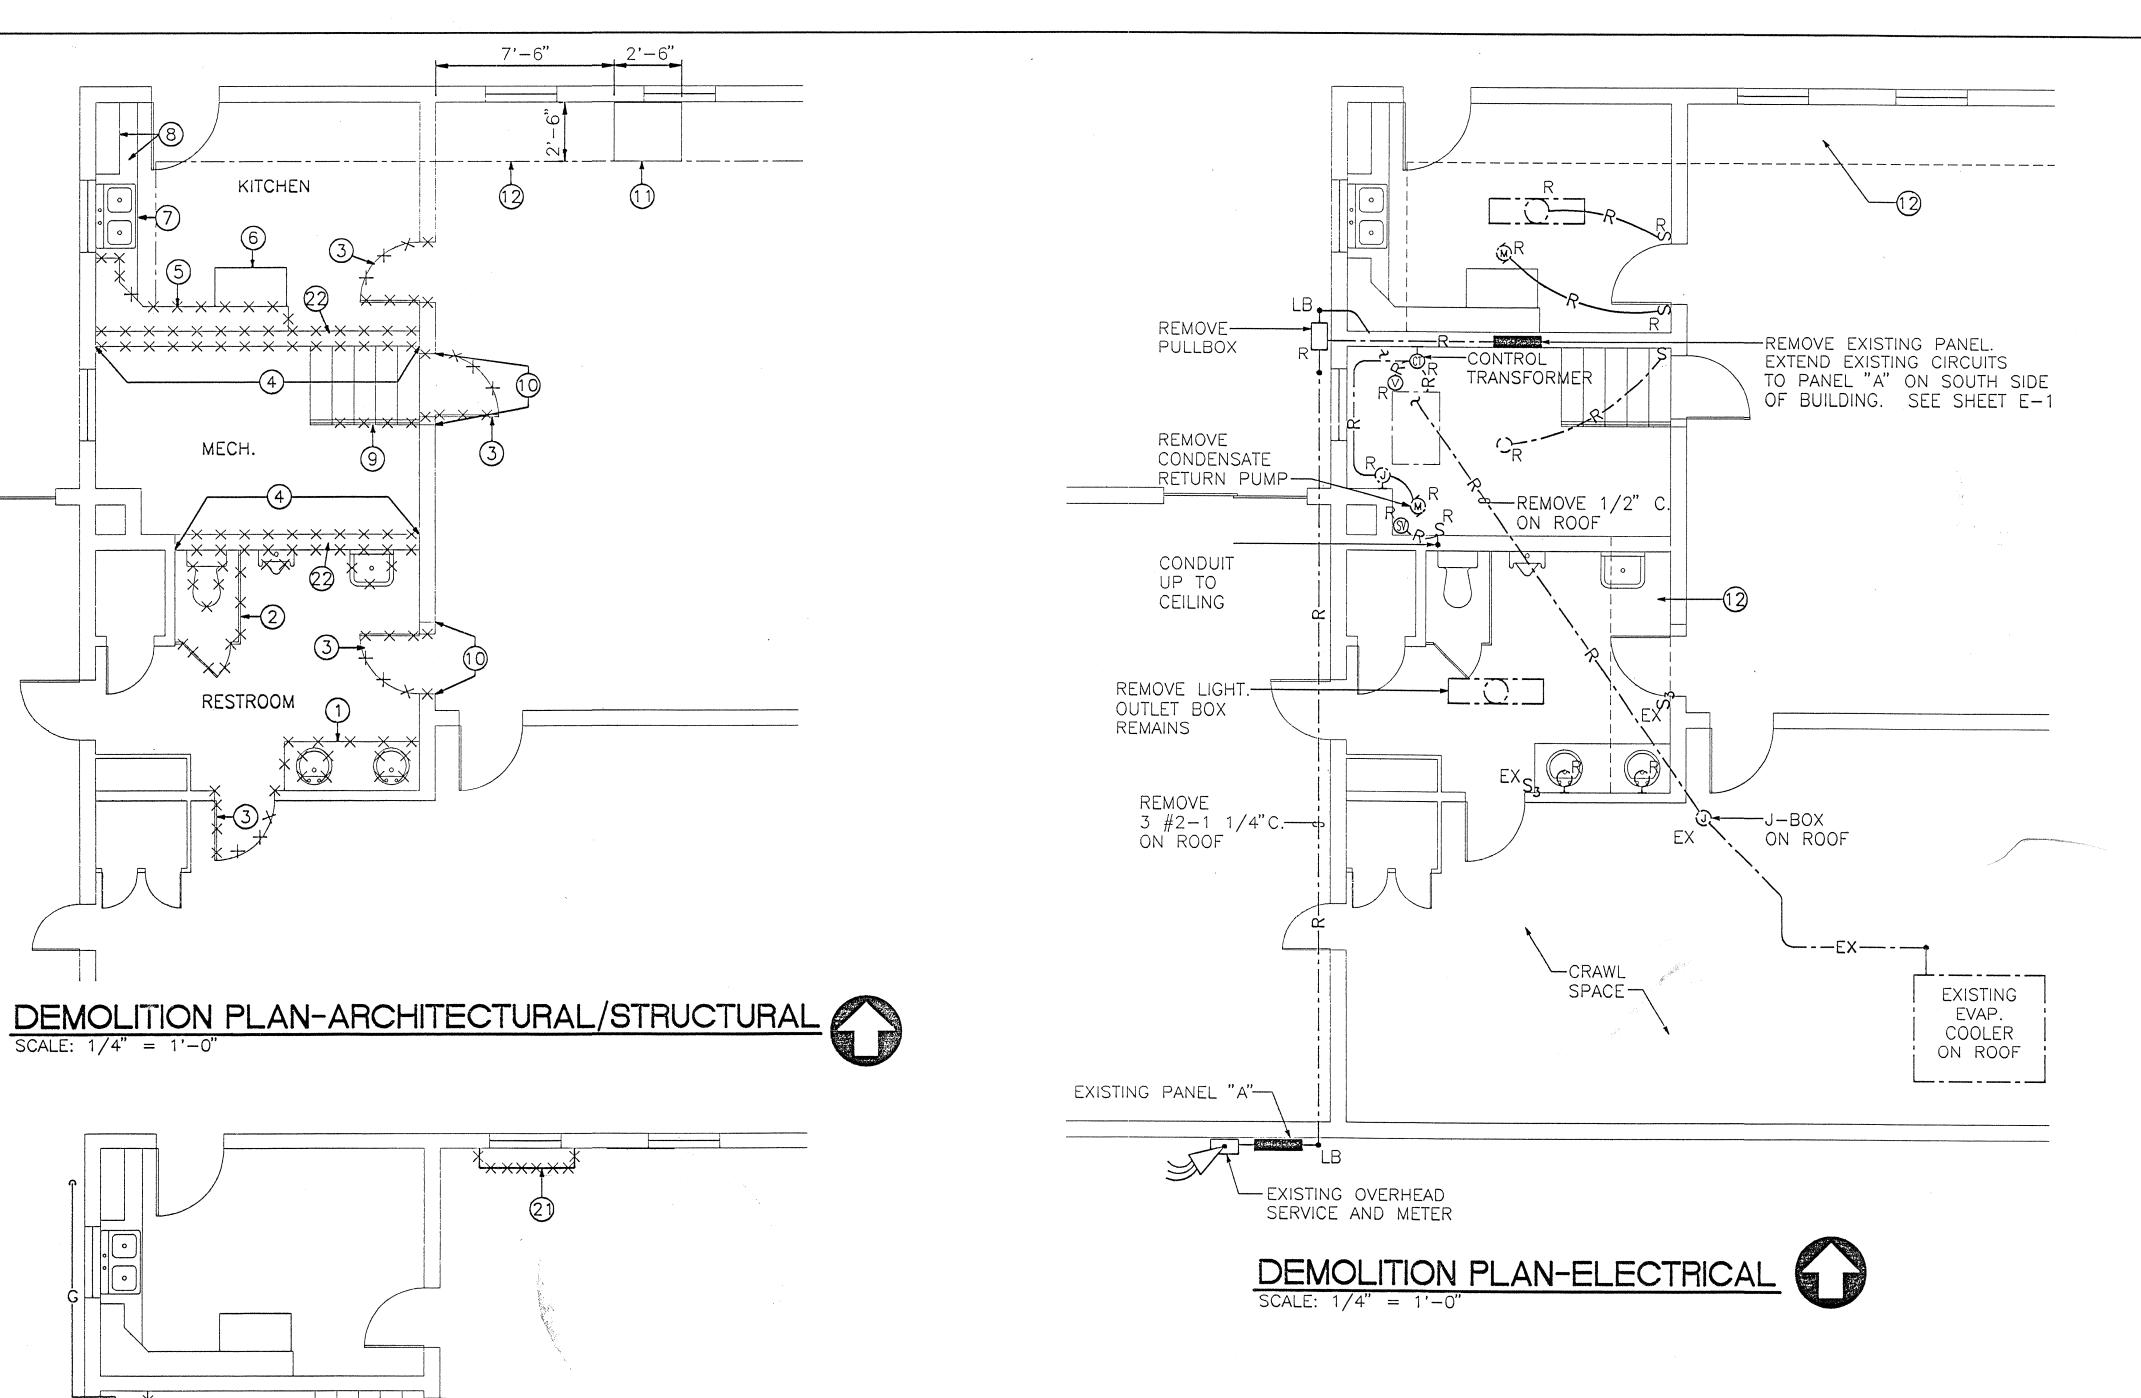

NOTE: 'X' DENOTES REMOVAL. FOR

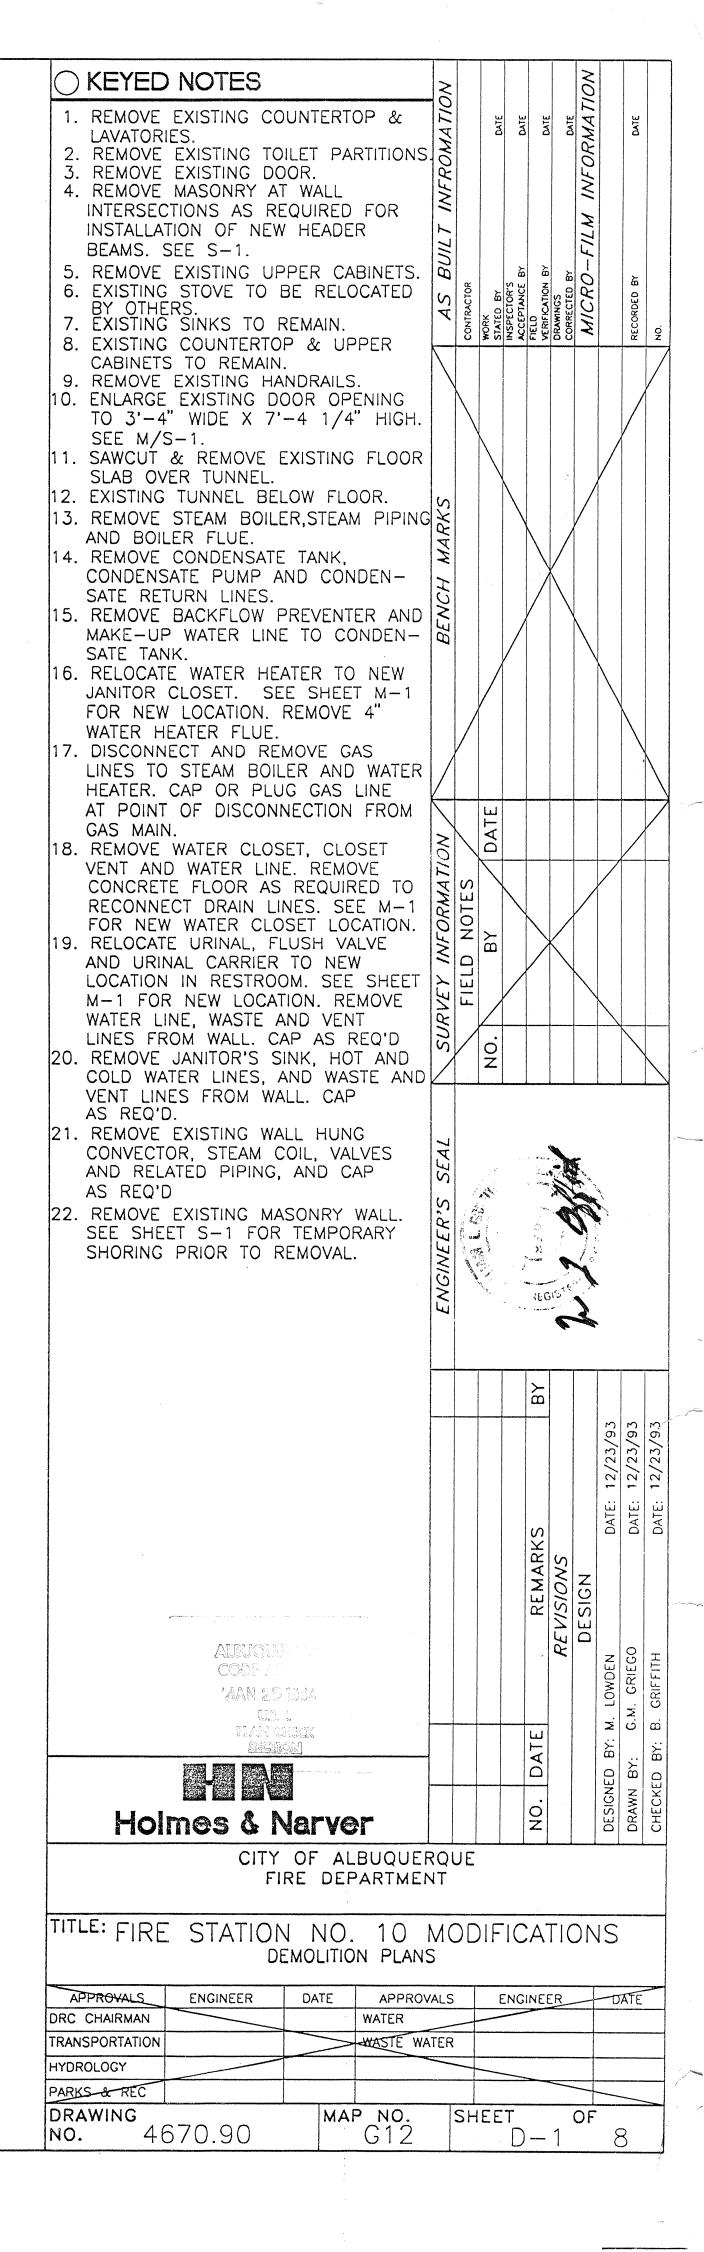

ELECTRICAL LEGEND SEE SHEET E-1

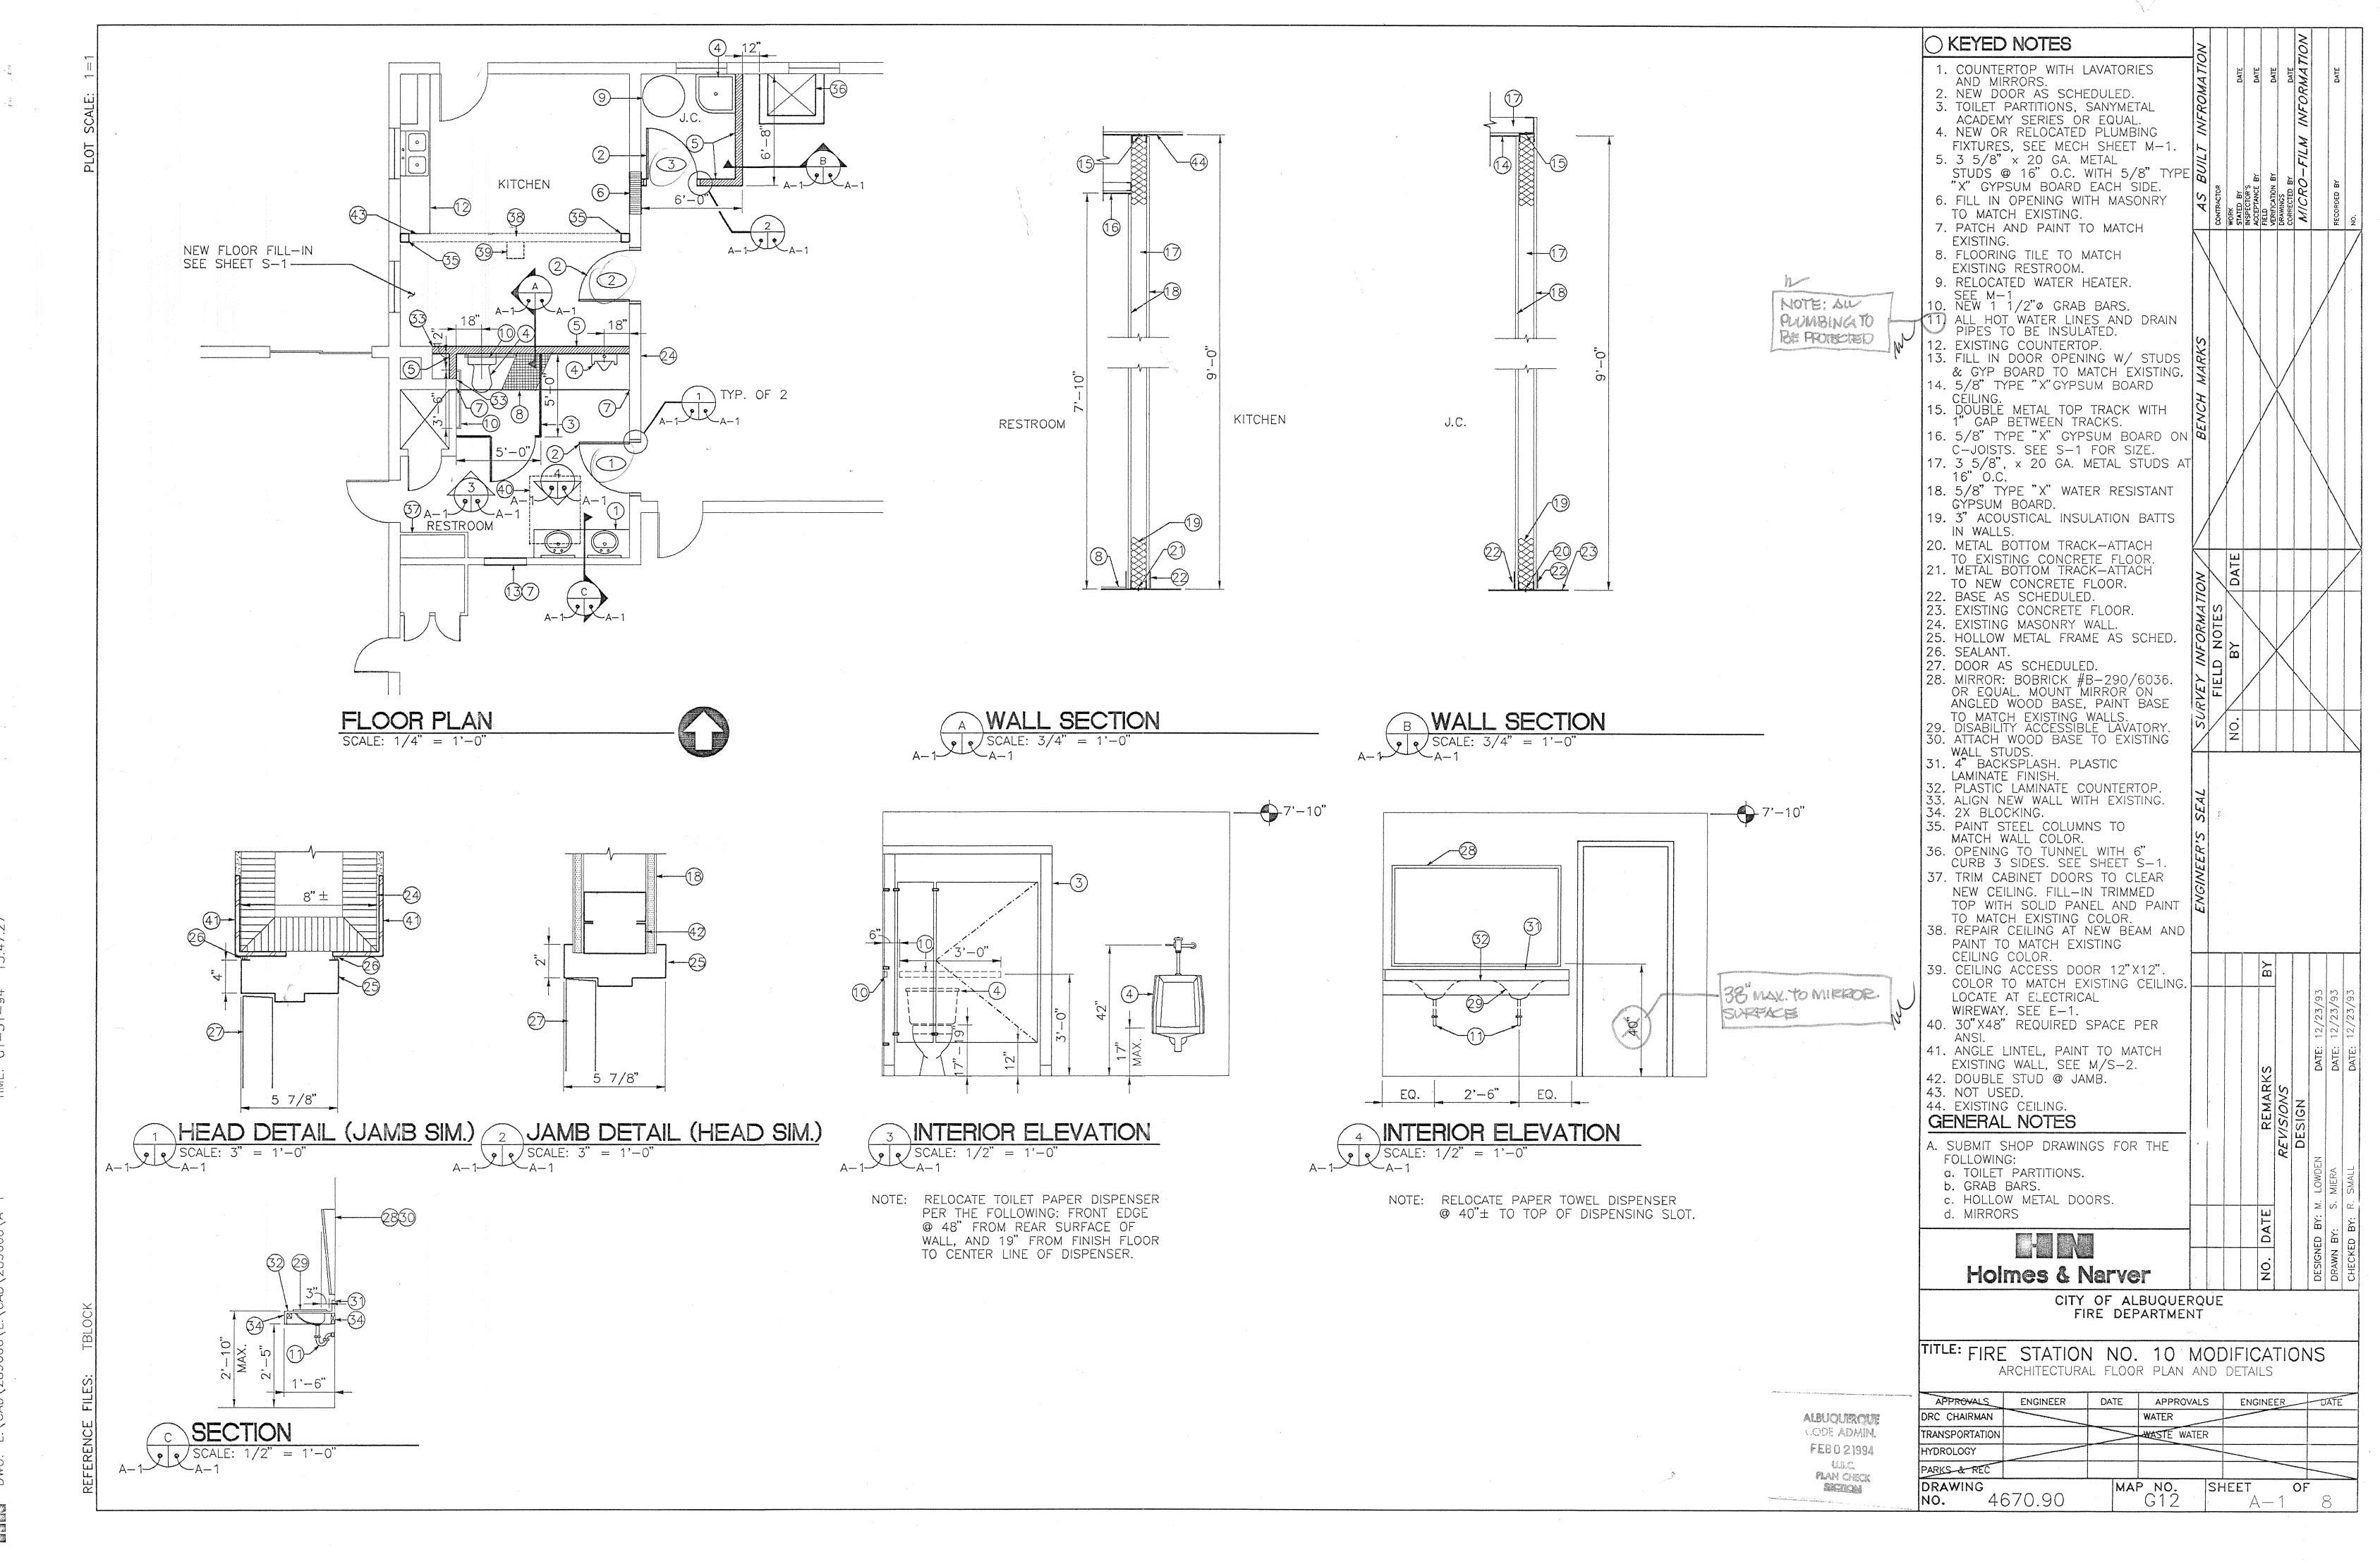

TIME: 01 21 01 12.

	DOOR SCHEDULE										
DOOR NUMBER		DOOR TYPE	DOOR MATERIAL	FRAME TYPE	FRAME MATERIAL	LABEL	HARDWARE SET NO.	DET/ HEAD JAMB		NAME PLAT	REMARKS
1	3'-0"X 7'-0"X 1 3/4"	В	НМ	1	НМ	20MIN	HW 2	1/A1 1/A1	1/A1 -		
2	3'-0"X 7'-0"X 1 3/4"	В	НМ	1	НМ	20MIN	HW 1	1/A1 1/A1	1/A1 -	_	_
3	3'-0"X 7'-0"X 1 3/4"	Α	НМ	1	НМ	20MIN	HW 3	2/A1 2/A1	2/A1 -		LOUVER W/FUSIBLE LINK

ROOM FINISH SCHEDULE													
ROOM	FLOO	RE	BASE			V	VAL	LS			CEII	_ING	REMARKS
	CERAMIC TILE - THIN SET	NCRETE SLAB	CERAMIC TILE STRAIGHT VINYL BASE	GYPSUN TILE WA	EXISTING SURFACE \Box	CERAMIC TILE WAINSCOT		CERAMIC TILE WAINSCOT			SUSPENDED GYP. BD. PAINTED EXISTING CEILING PAINTED	HEIGHT	
RESTROOM	0		0	0	0	0 (0 6		0	0	7'-10"	
KITCHEN	•		0		0	•		0		0	0	9'-0"	
JANITOR'S CLOSET)	0	0		(3)	4	0	0		o	9'-0"	

HARDWARE SCHEDULE

HARDWARE SET #1

1 1/2 PR. BUTTS BB1168 4 1/2" × 4 1/2" × US26

1 EA. LOCKSET 8115 LNL US26 LH

1 EA. CLOSER DC3200

1 EA. THRESHOLD 613A × DOOR WIDTH

1 EA. DOOR SWEEP 201 NA × DOOR WIDTH

1-SET PERIMETER SEALS 110 NA

HARDWARE SET #2

1 1/2 PR. BUTTS BB1168 4 1/2" × 4 1/2" × US26

1 EA. LOCKSET 8115 LNL US26 RH

1 EA. THRESHOLD 613A × DOOR WIDTH

1 EA. DOOR SWEEP 201 NA × DOOR WIDTH

1 SET PERIMETER SEALS 110 NA 2 EA. KICK PLATES 10" x 32"

HARDWARE SET #3
1 1/2 PR. BUTTS BB1168 4 1/2" x 4 1/2" x US26
1 EA. LOCKSET 8136 LNL US26 LH
1 EA. THRESHOLD 613A x DOOR WIDTH

1 EA. DOOR SWEEP 201 NA x DOOR WIDTH 1 SET PERIMETER SEALS 110 NA 2 EA. KICK PLATES 10" x 32"

1 EA. WALL STOP 1273CCS

NOTE:


MANUFACTURES PRODUCT NUMBERS IN HARDWARE SCHEDULE SHALL SERVE AS A LEVEL OF QUALITY


1. BUTTS - HAGER


2. LOCKSET - SARGENT 3. CLOSER - CORBIN/RUSSWIN


4. THRESHOLD - NATIONAL GUARD PRODUCTS

5. DOOR SWEEP — NATIONAL GUARD PRODUCTS
6. PERIMETER SEALS — NATIONAL GUARD PRODUCTS
7. KICKPLATE — TRIMCO
8. WALL STOP — TRIMCO

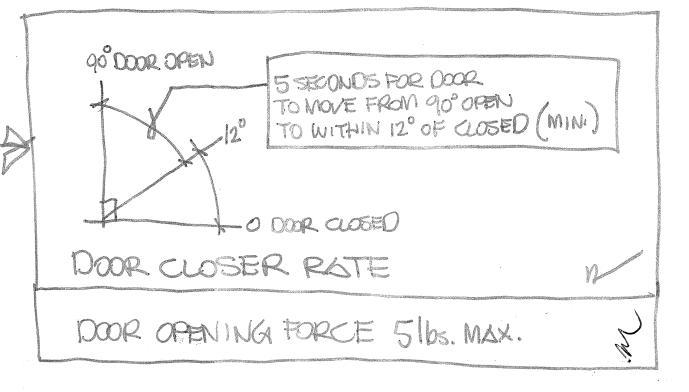

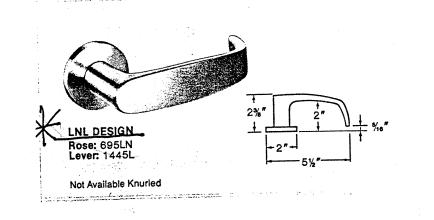

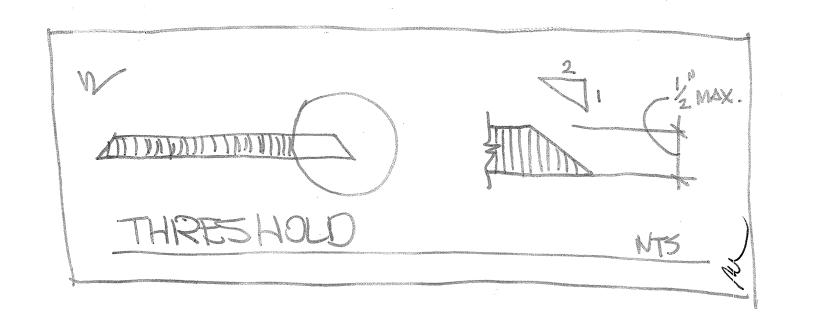

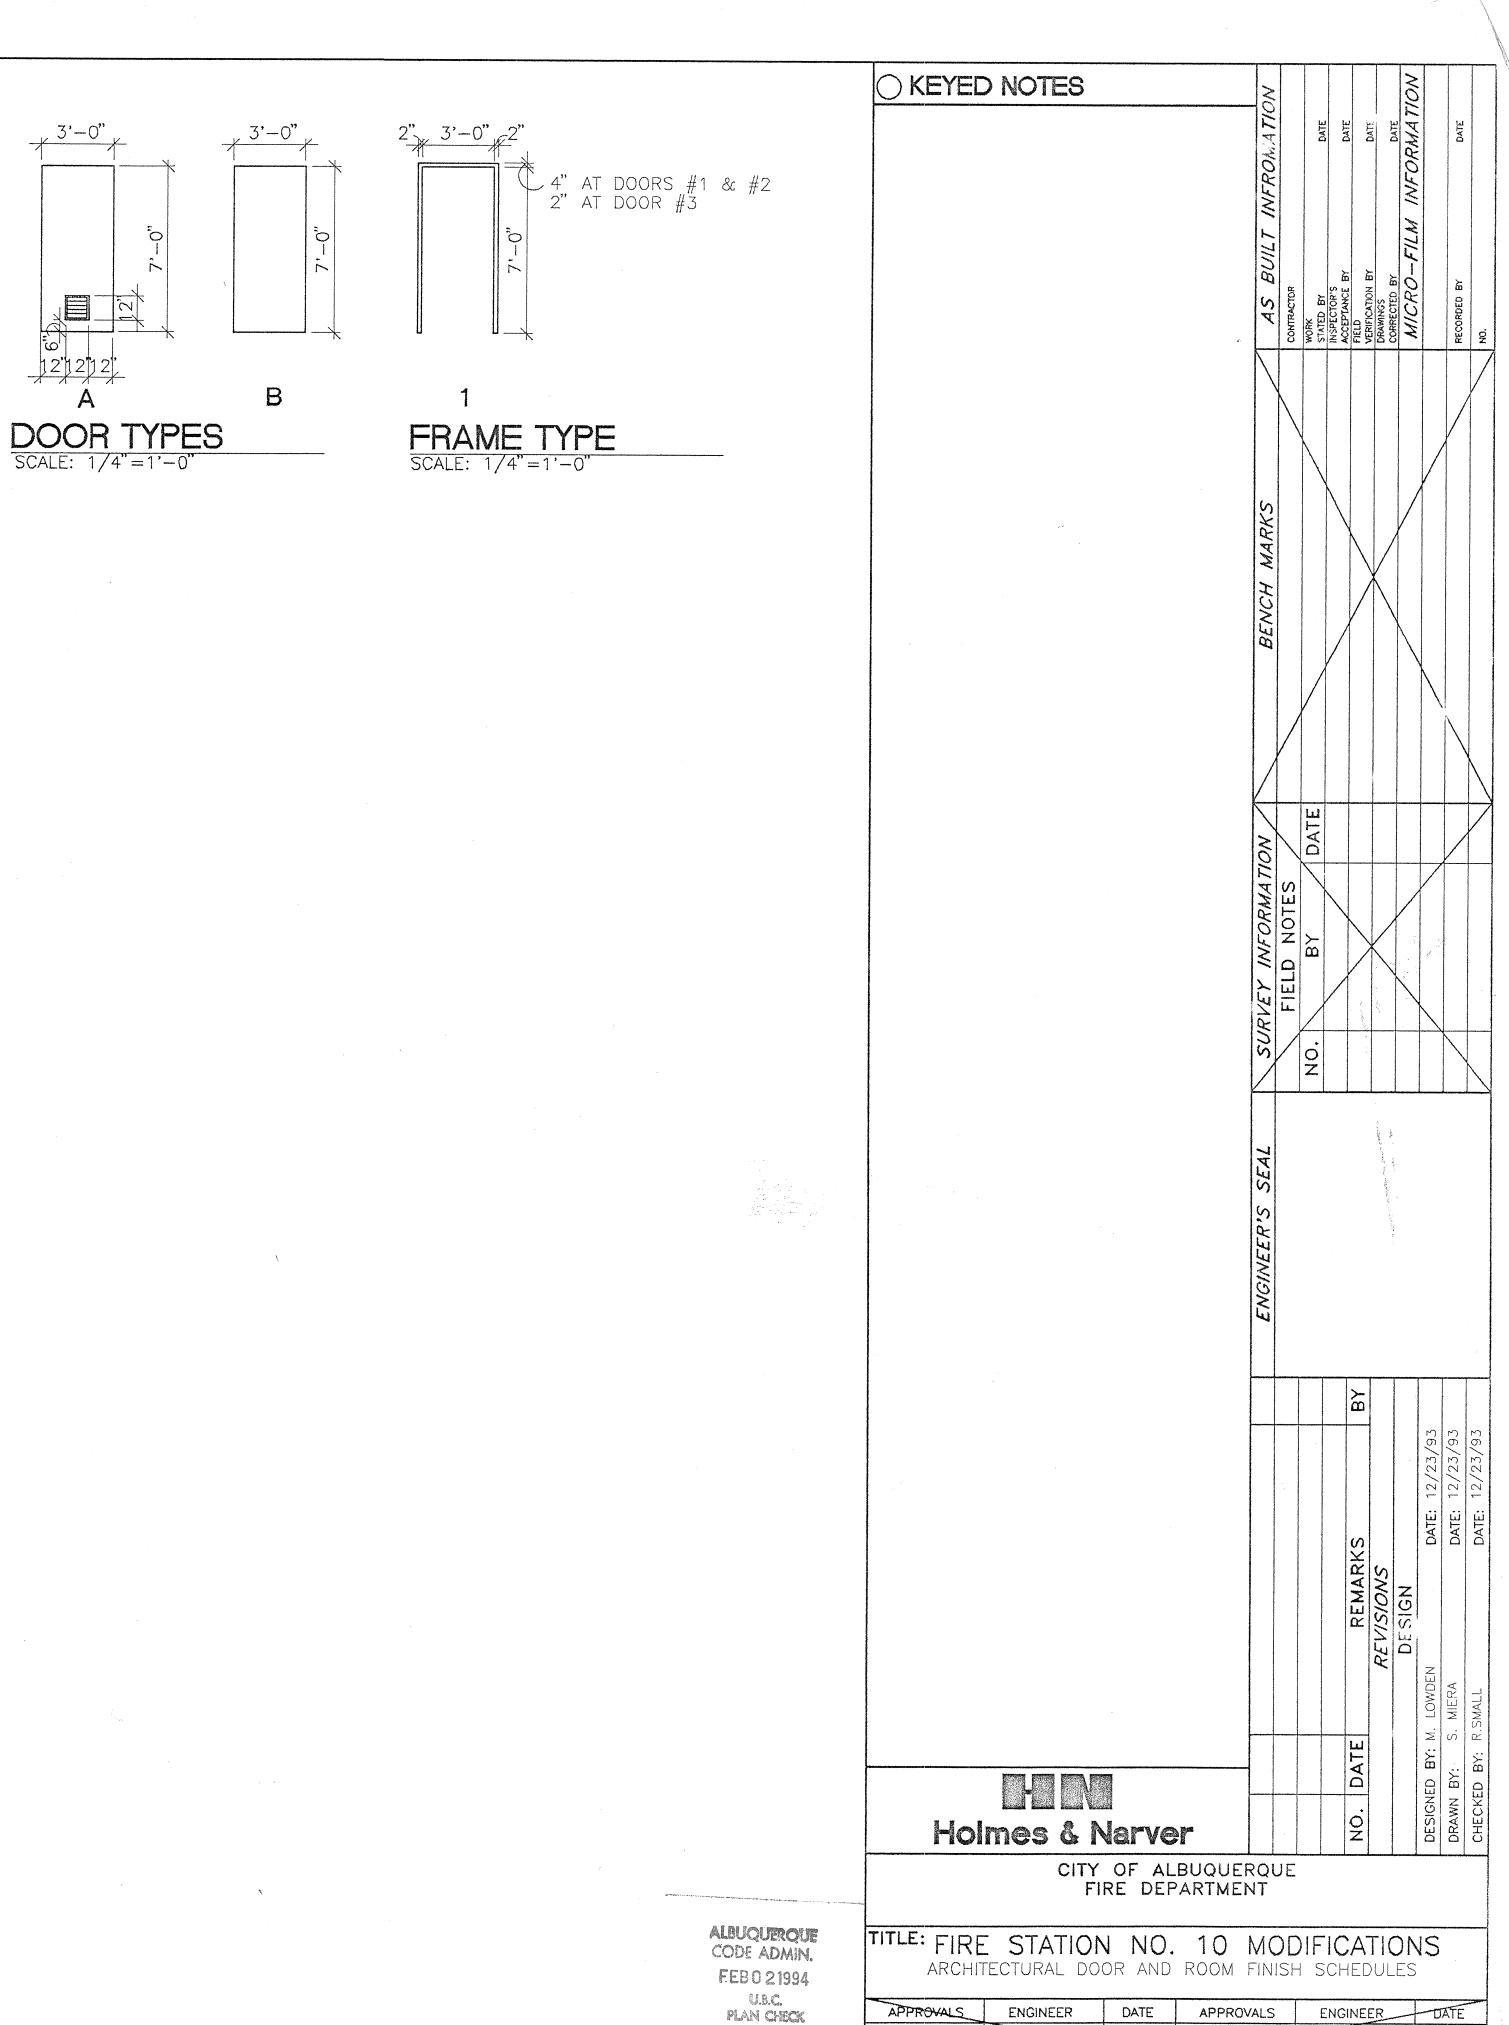

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APPROVALS	ENGINEER	DATE	APPROVAL	.S	ENGINEER	DATE
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TRANSPORTATION			WASTE WATE	R	-	
HYDROLOGY						
PARKS & REC						1
DRAWING NO. 46	570.90	MAI	P NO. G12	SH	IEET OI	F 8

GENERAL NOTES

- 1. GENERAL REQUIREMENTS
- PROVIDE NECESSARY SHORING TO SUPPORT EXISTING STRUCTURE DURING DEMOLITION AND CONSTRUCTION. SUPPORT UNTIL FINISHED STRUCTURE IS IN PLACE AND GROUT HAS CURED FOR MINIMUM OF 7 DAYS. DO NOT SUPPORT SHORING ON NEW CONCRETE SLAB UNTIL CONCRETE HAS REACHED FULL STRENGTH AS VERIFIED BY TESTS. CEASE OPERATIONS AND NOTIFY ENGINEER IMMEDIATELY IF THE SAFETY OF THE STRUCTURE APPEARS TO BE ENDANGERED. TAKE PRECAUTIONS TO SUPPORT THE STRUCTURE UNTIL DETERMINATION IS MADE TO CONTINUE CONSTRUCTION.
- 1.2 FIELD VERIFY EXISTING DIMENSIONS THAT AFFECT WORK BEFORE FABRICATION OF NEW COMPONENTS.
- 1.3 SUBMIT TO ENGINEER SHOP DRAWINGS FOR STRUCTURAL STEEL BEAMS, COLUMNS, LINTELS, AND CONNECTIONS. DO NOT BEGIN FABRICATION UNTIL SHOP DRAWINGS ARE APPROVED.
- 2. (NOT USED)
- CONCRETE
- 3.1 CAST-IN-PLACE CONCRETE
 - A. WORK SHALL CONFORM TO ACI 301 AND ACI 318 EXCEPT AS NOTED BELOW.
- B. MATERIALS
 - 1. REINFORCING: ASTM A615, GRADE 60.
 - 2. PORTLAND CEMENT: ASTM C150, TYPE I.
 - 3. AGGREGATE: ASTM C33.
 - 4. WATER: DRINKABLE.
 - 5. ADMIXTURES: AS APPROVED BY ENGINEER. DO NOT USE CALCIUM CHLORIDE OR ADMIXTURES CONTAINING MORE THAN 0.1 PERCENT CHLORIDE IONS.
- C. MIX DESIGN
 - 1. COMPRESSIVE STRENGTH 3000 PSI MINIMUM AT 28 DAYS.
 - 2. SLUMP: 1 TO 3 INCHES.
- D. READY-MIX CONCRETE SHALL CONFORM TO ASTM C94.
- E. ACCURATELY POSITION, SUPPORT, AND SECURE REENFORCEMENT.

- F. FINISH OF SLABS PER ACI 301:
 - INTERIOR SLABS: TROWEL FINISH.
 TOLERANCE: 3/16" FROM PLANE WHEN TESTED WITH 10-FOOT STRAIGHT EDGE.
- G. CURE CONCRETE PER ACI 301.
- . CONCRETE TESTING WILL BE BY CITY.
- 3.2 GROUT
 - PRE-MIXED, NONMETALLIC, NONSHRINK, CONFORMING TO CORPS OF ENGINEERS CRD-C 621. SIKAGROUT 212 FROM SMALLEY & CO. (884-6553)OR APPROVED EQUAL.
 - B. MIX AND INSTALL GROUT IN ACCORDANCE WITH MANUFACTURER'S INSTRUCTIONS.
- 3.3 BONDING AGENT AND EPOXY GROUT
 - A. EPOXY ADHESIVE, SIKADUR 32, HI-MOD FROM SMALLEY & CO. OR APPROVED EQUAL.
 - B. APPLY IN ACCORDANCE WITH MANUFACTURER'S RECOMMENDATIONS.
- 4. MASONRY
 - A. CLAY TILE INFILL AT EXISTING DOOR: 8" WIDE CLAY TILE UNITS, ASTM C-56.
- 5. METALS
- 5.1 STRUCTURAL STEEL
 - A. PLATES, SHAPES: ASTM A36.
 - B. STEEL TUBE: ASTM A500, GRADE B.
 - C. FABRICATE PER AISC SPECIFICATION FOR STRUCTURAL STEEL BUILDINGS.
- 5.2 FASTENERS
 - A. BOLTS: ASTM A307.
 - EXPANSION ANCHORS: HILTI KWIK BOLTS OR APPROVED EQUAL. 1/2" DIAMETER WITH 3 1/2" EMBEDMENT UNLESS NOTED OTHERWISE.
 - MASONRY ANCHORS: HILTI HIT C-20 SYSTEM OR APPROVED EQUAL, RESIN ADHESIVE USED WITH GALVANIZED METAL SCREEN AND ALL THREAD ROD. RODS SHALL BE 1/2" DIAMETER X 8" LONG.
 - D. INSTALL FASTENERS IN ACCORDANCE WITH MANUFACTURER'S INSTRUCTIONS.

- 5.3 WELDING
 - A. CONFORM TO AWS D1.1
 - B. WELDING SHALL BE BY CERTIFIED WELDERS.
 - C. ALL WELDS SHALL BE VISUALLY INSPECTED BY EXPERIENCED INSPECTOR. DEFECTIVE WELDS SHALL BE REMOVED AND REPLACED.
- D. ELECTRODES: E70XX, LOW HYDROGEN.
- 5.4 LIGHT-GAGE STEEL JOISTS AND STUDS
 - A. ASTM A611, MINIMUM YIELD STRENGTH 33 KSI.
 - B. FINISH: PRIME PAINT.
 - SECTION: DEPTH AS NOTED WITH 1-5/8" FLANGE AND 1/2" FLANGE RETURN

○ KEYED NOTES 2" 18 GAGE COMPOSITE DECK GALV, VULCRAFT 2VLI OR EQUAL FASTEN TO SUPPORTING ANGLES W/ #12 TEK SCREWS @ 12" OC. 2. LEDGËR L 5x3 1/2x1/4 LLV. 3. 6" CONCRETE CURB @ 3 SIDES OF NEW TUNNEL ACCESS OPENING W/ 3/16" SAFETY PLATE COVER. SEE DET 3/S-2. 4. W12x26 HEADER BEAM. TOP OF STEEL = BOTTOM OF EXISTING ROOF TRUSSES. SEE DET 1/S-2. 5. C3 5/8" × 20 GAGE CEILING JOISTS @ 16" OC MAX. 6. STEEL STUD PARTITION. SEE DWG A-1. 7. DOUBLE STEEL ANGLE LINTEL L 4x3 1/2x1/4 LLV. 8. C3 5/8" x 20 GA JOIST HEADER, FASTEN TO EXISTING WALL W/ CLIP ANGLE & 1/2"ø MASONRY ANCHOR. FASTEN CLIP ANGLES TO C4 JOISTS W/ 2 - #12 TEK SCREWS TYP. 9. PROVIDE TEMPORARY SHORING FOR EXISTING ROOF BEFORE REMOVING MASONRY WALLS. SEE GENERAL NOTE 1.1. 10. PATCH CONCRETE FLOOR AT NEW DRAIN LINE. SEE SHEET M-1. REMARKS
REVISIONS
DESIGN ALBUOUROUR CODE ADMAR JAN 25 1994 U.S.C. Plan Check SECHON Holmes & Narver CITY OF ALBUQUERQUE FIRE DEPARTMENT TITLE: FIRE STATION NO. 10 MODIFICATIONS STRUCTURAL PLANS :AND GENERAL NOTES

APPROVALS ENGINEER DATE APPROVALS ENGINEER DATE

WATER

MAP NO.

G12

WASTE WATER

SHEET


DRC CHAIRMAN


HYDROLOGY

TRANSPORTATION

PARKS & REC DRAWING

4670.90

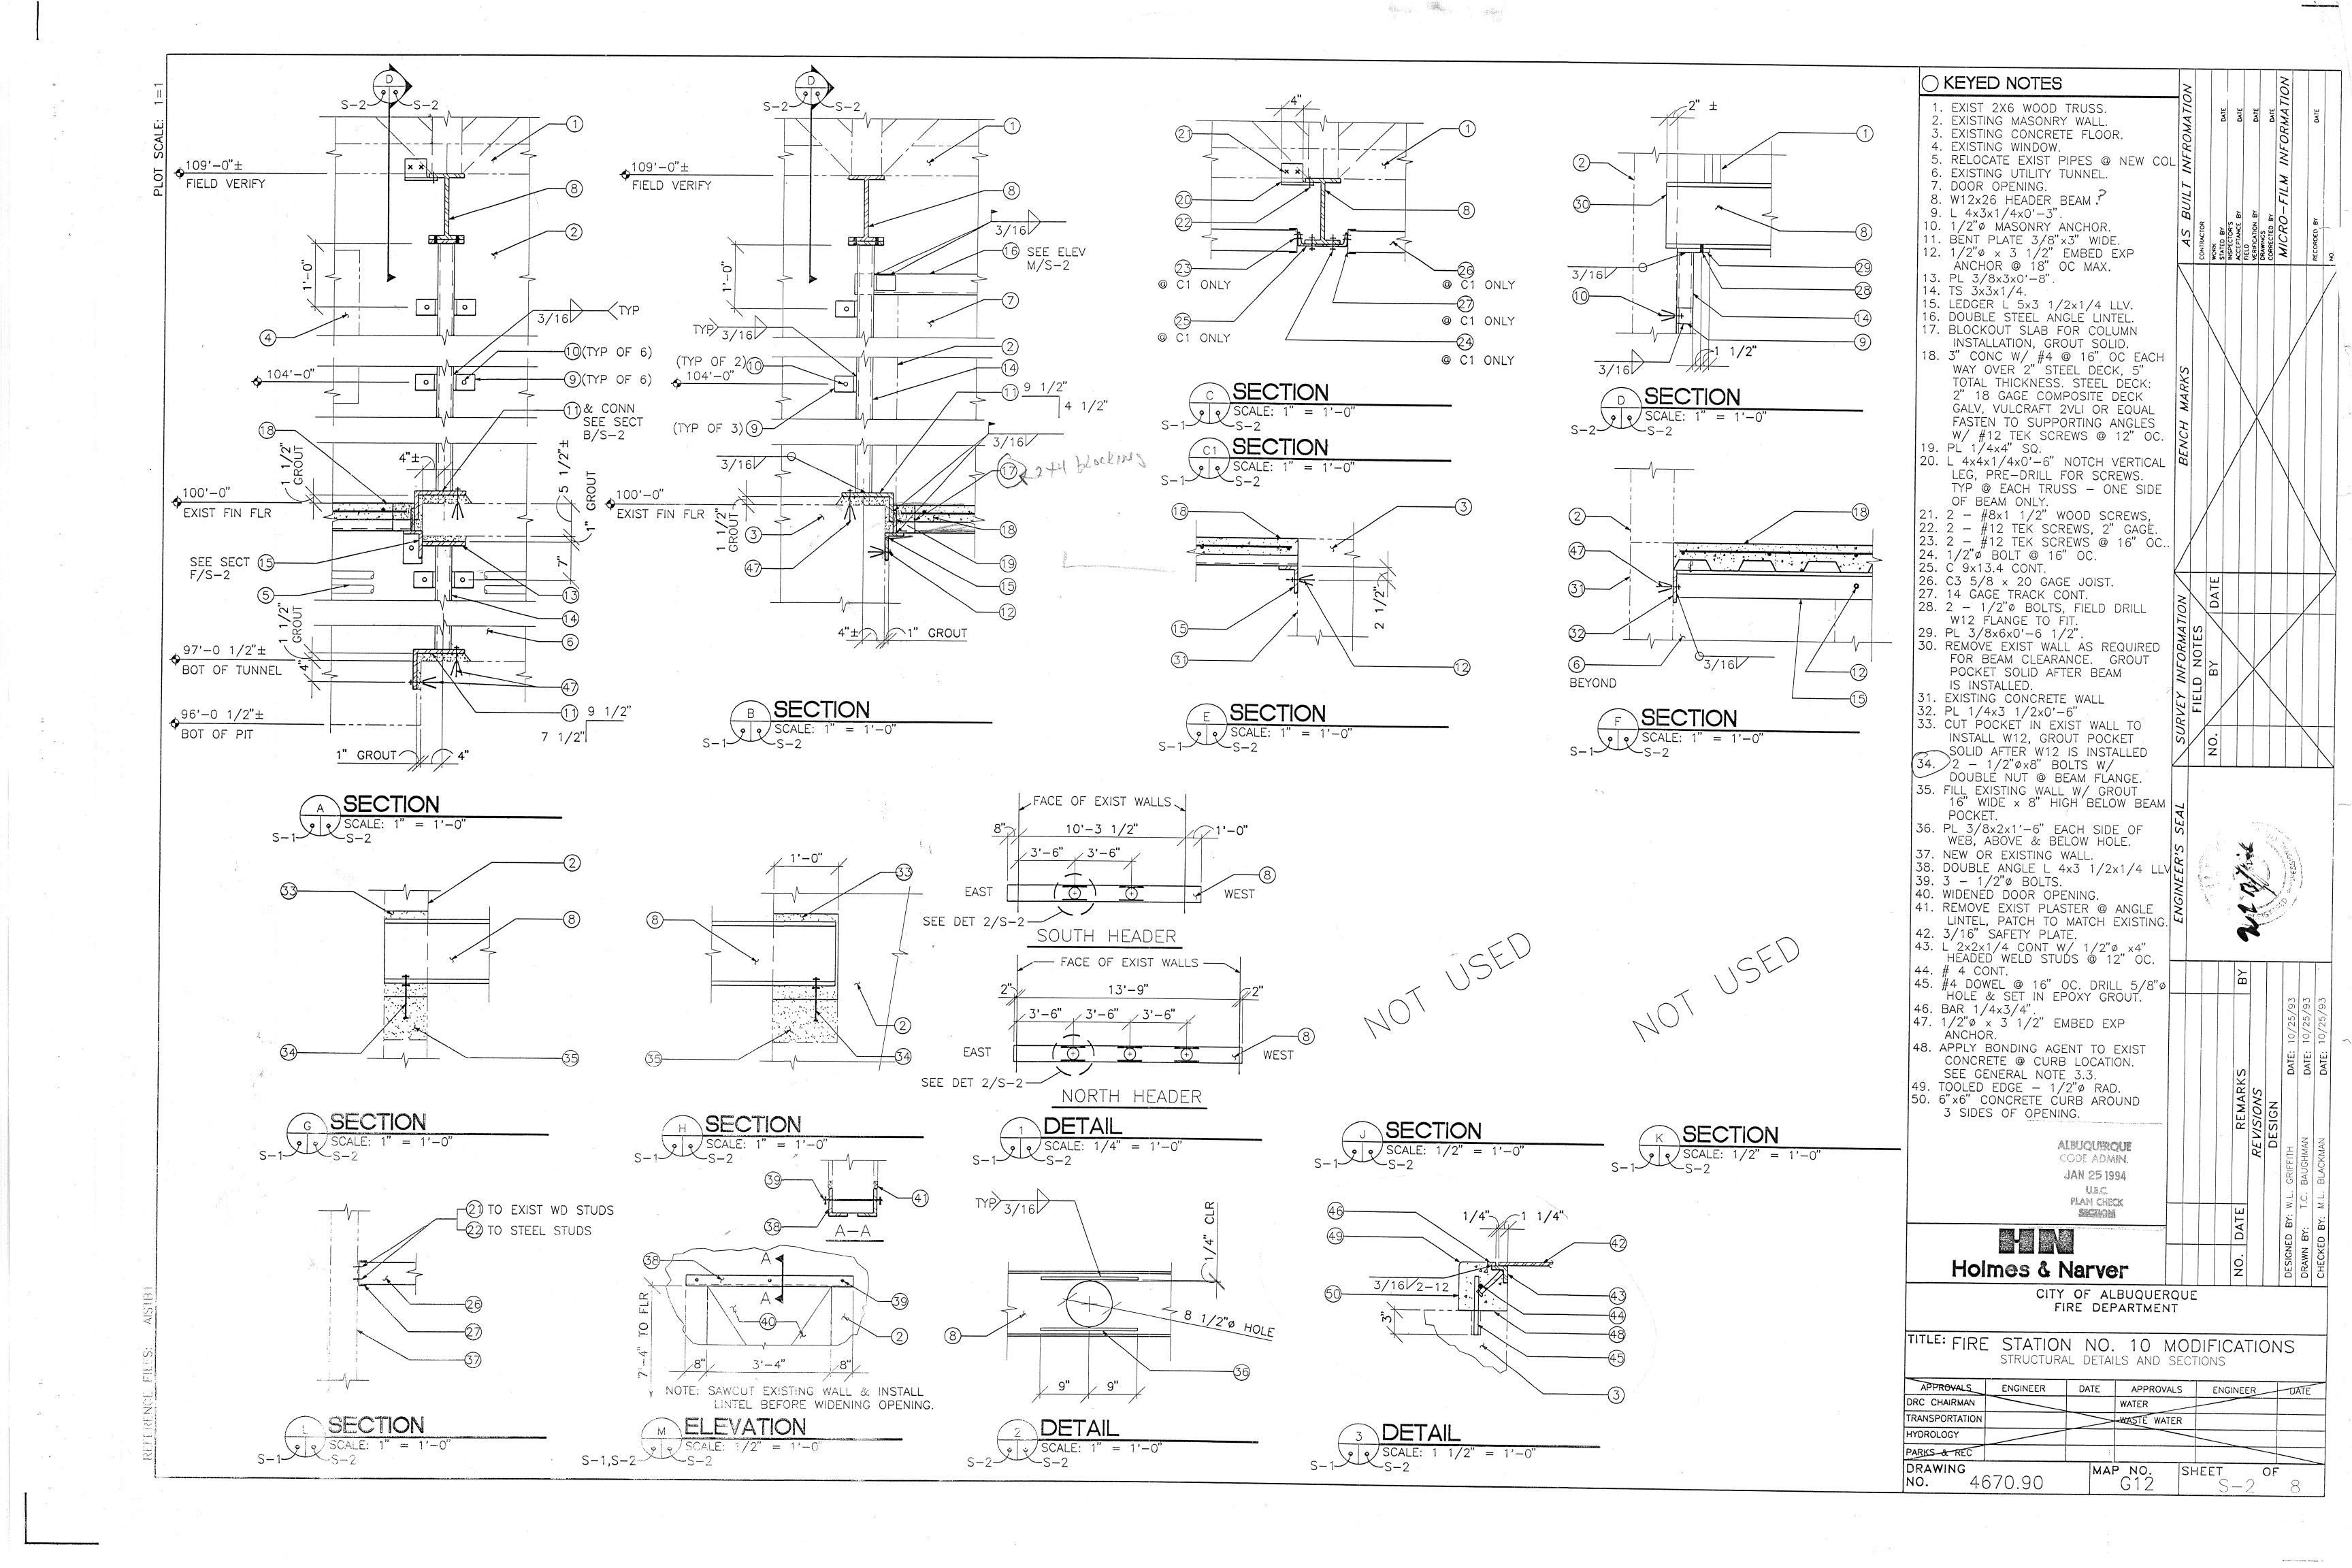

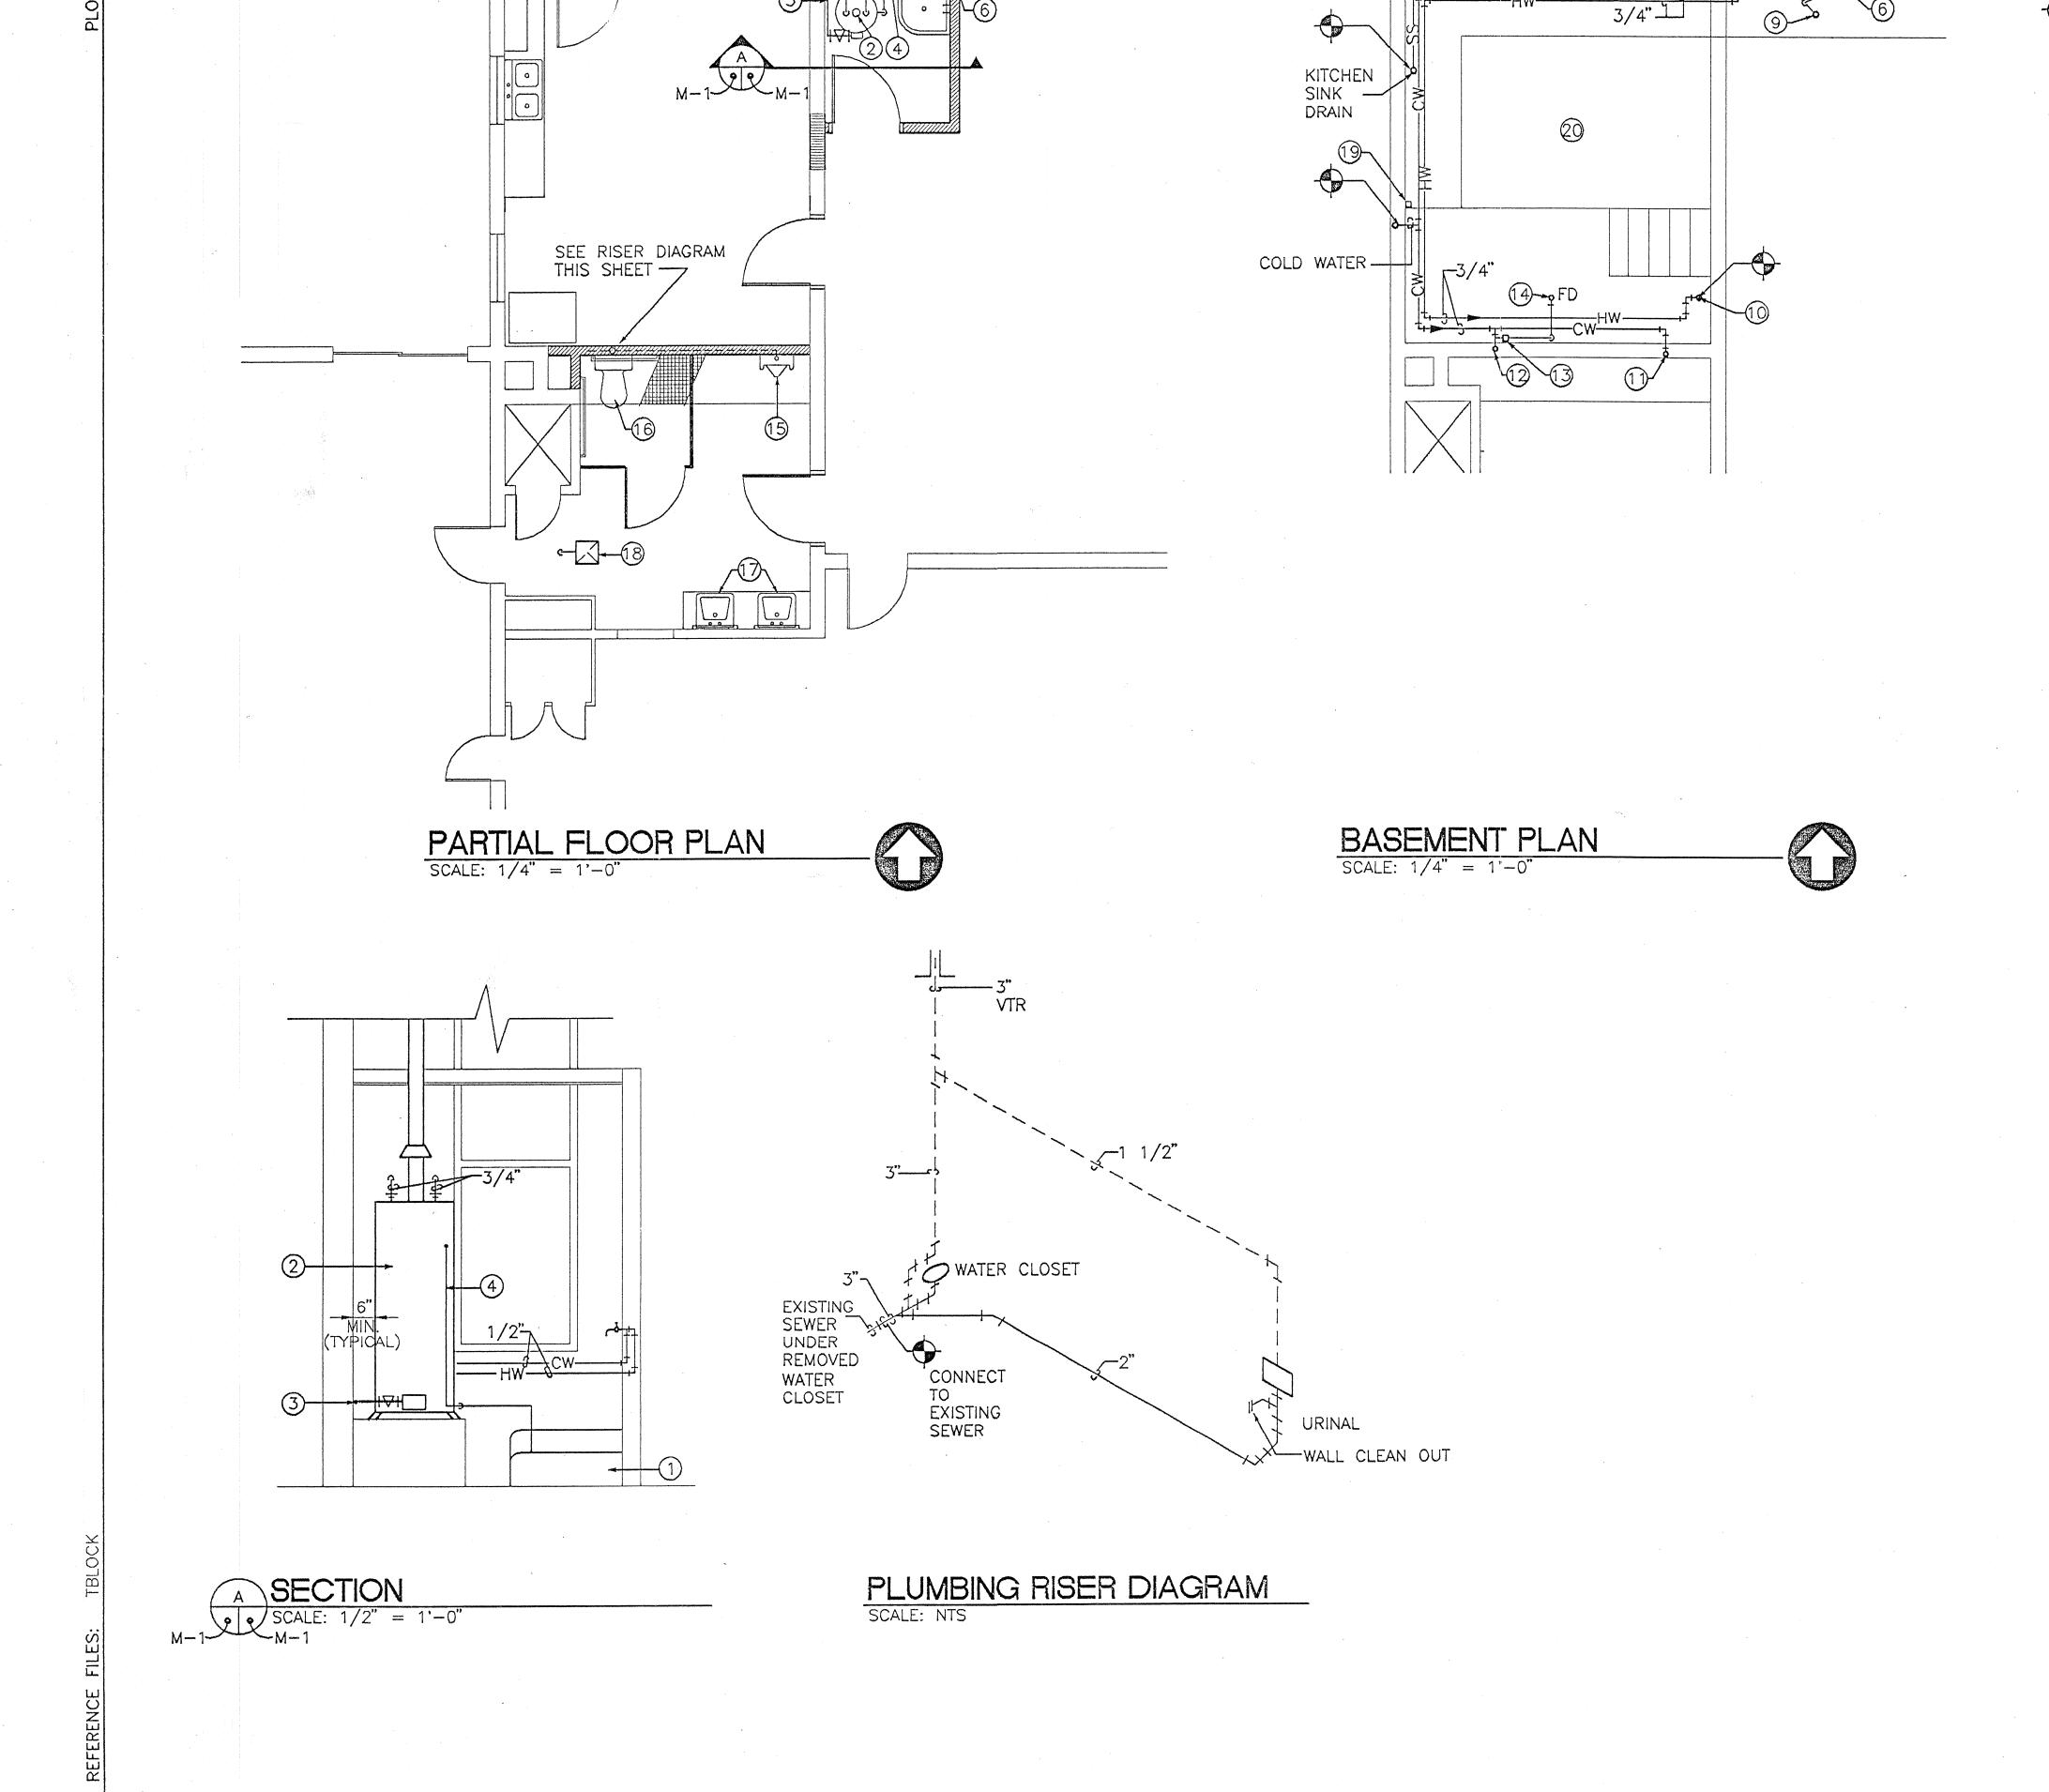

EXISTING GAS METER

LEGEND

- POINT OF CONNECTION SS SANITARY SEWER CW COLD WATER LINE HW HOT WATER LINE VTR VENT THRU ROOF


○ KEYED NOTES . NEW ENAMELED CAST IRON CORNER FLOOR MOUNTED SERVICE SINK. EQUAL TO KOHLER NUMBER K-6710 WITH CHROME PLATED FAUCET KOHLER NUMBER K-8928 2. RELOCATED HOT WATER HEATER. MOUNT HEATER ON 18" HIGH PLATFORM. RUN 4" HEATER FLUE THRU ROOF. INSTALL FLUE FLASHING WHERE FLUE PENETRATES ROOF. SEAL WEATHER 3. 1/2" GAS LINE FOR HOT WATER HEATER. CONNECT TO GAS LINE AT GAS METER. SEAL PIPE PENETRATING WALL WEATHER TIGHT. 4. RUN LINE FROM RELIEF VALVE TO SERVICE SINK (FULL SIZE FROM T & P). 5. 2" DRAIN LINE FROM SERVICE SINK. SLOPE LINE 1/4" PER FOOT. CONNECT TO DRAIN LINE FROM KITCHEN SINK (UNDER FLOOR). 6. 1 1/2" VENT LINE FROM SERVICE SINK THRU ROOF. INSTALL PIPE FLASHING WHERE VENT PIPE PENETRATES ROOF. SEAL PIPE PENETRATION WEATHER TIGHT. HOT AND COLD WATER LINES FROM UTILITY TUNNEL, SEE BASEMENT PLAN FOR CONTINUATION. 8. 3/4" HOT AND COLD WATER LINES TO JANITOR CLOSET, SEE FLOOR PLAN ON THIS SHEET FOR CONTINUATION. 9. 2" DRAIN LINE FROM SERVICE SINK W/P-TRAP.10. CONNECT 3/4" HOT WATER LINE INTO HOT WATER SYSTEM WHERE HOT WATER HEATER WAS REMOVED. 11. 3/4" COLD WATER LINE TO RE-LÓCATED URINAL IN BATHROOM. 12. 1/2" COLD WATER LINE TO NEW WÁTER CLOSET IN BATHROOM. 13. INSTALL TRAP PRIMER IN 1/2" COLD WATER LINE TO WATER CLOSET. TRAP PRIMER: SMITH FIGURE 2699 OR APPROVED EQUAL. 14. RUN 1/2" LINE FROM TRAP PRIMER 5 TO EXISTING FLOOR DRAIN. 15. RELOCATED URINAL. 16. NEW HANDICAPPED WATER CLOSET. 1.5 GAL. PER FLUSH. COMPLETE WITH OPEN FRONT PLASTIC SEAT EQUAL TO KOHLER NUMBER K-3544 WITH K-4650 SEAT AND COVER. 17. NEW HANDICAPPED LAVATORY, BARRIER FREE, SELF RIMMING. EQUAL TO KOHLER NUMBER K-2093 WITH K-13361 FAUCETS, K-8998 P-TRAP AND K-7605 ANGLE SUPPLIES WITH STOPS. 18. CEILING EXHAUST FAN. 100 CFM AT 1/8" STATIC PRESSURE EQUAL TO ACME ENGINEERING CEILING EX-HAUSTER MODEL V-100 WITH MODEL VC-8 VENT CAP.
19. RELOCATE EXISTING PIPES TO CLEAR NEW COLUMN. 20. ALL PIPING AND PLUMBING UNDERFLOOR. CODE ADVA AN 251994 SECTION

Holmes & Narver

CITY OF ALBUQUERQUE FIRE DEPARTMENT

TITLE: FIRE STATION NO. 10 MODIFICATIONS MECHANICAL PLANS AND DETAILS

APPROVALS ENGINEER DATE APPROVALS ENGINEER DATE DRC CHAIRMAN TRANSPORTATION WASTE WATER HYDROLOGY PARKS & REC DRAWING MAP NO. SHEET 4670.90

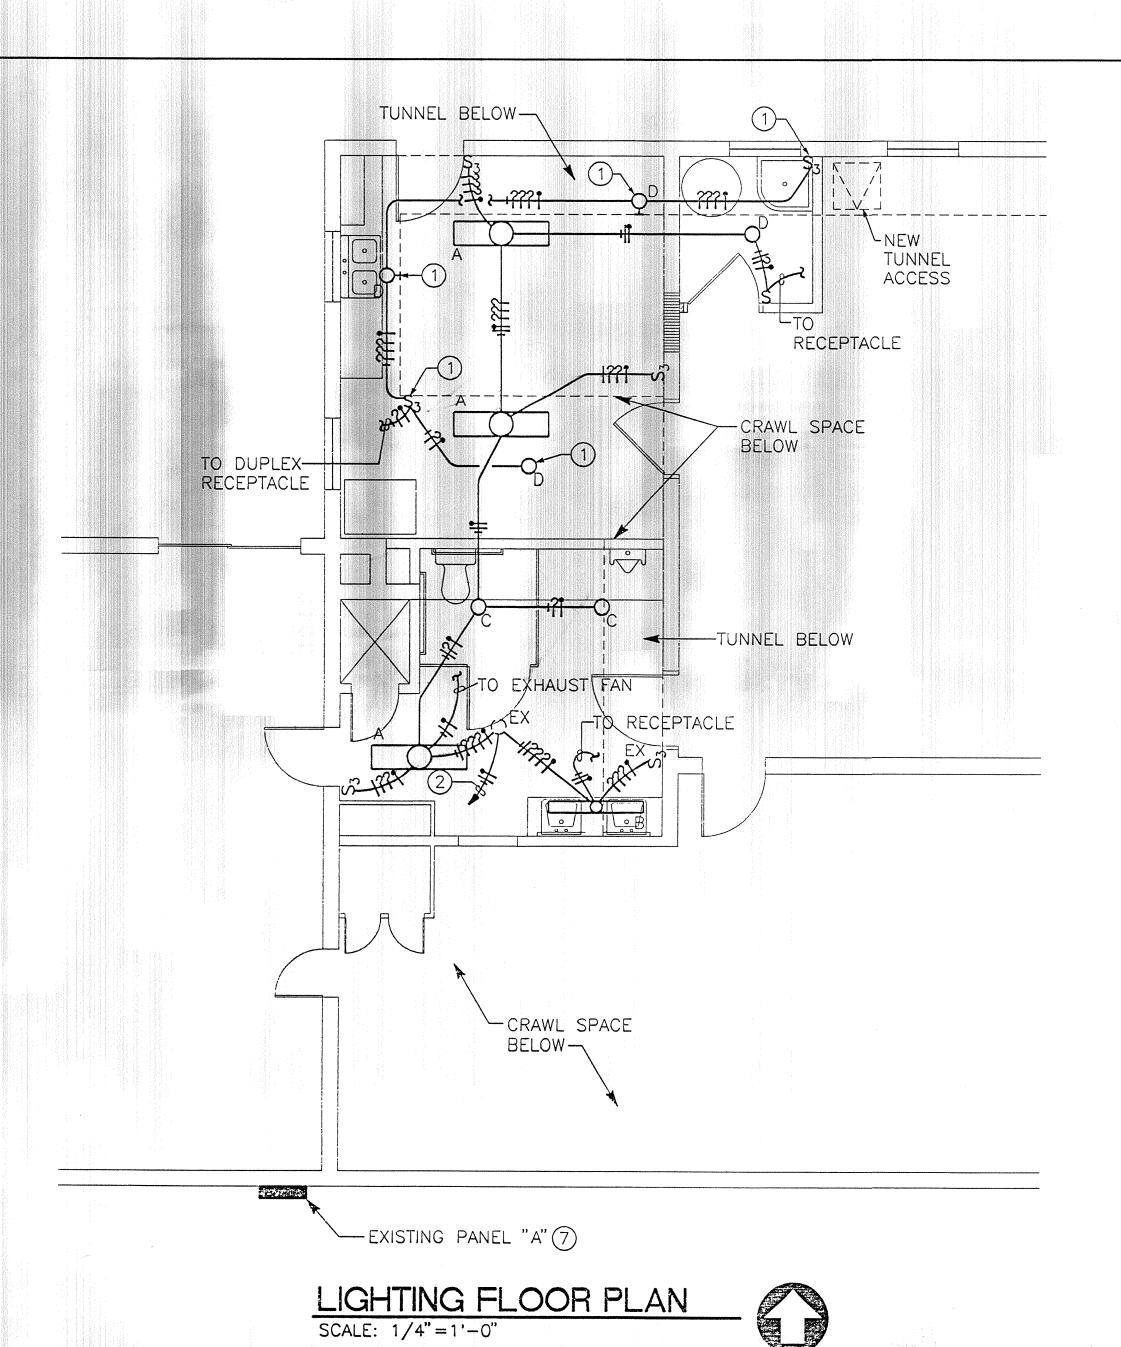

SYMBOL **DESCRIPTION** LIGHT SWITCH SURFACE FLUORESCENT DRUM FIXTURE 0 0 1x4 SURFACE FLUORESCENT LIGHT FIXTURE Ю WALL MOUNTED INCANDESCENT FIXTURE 3-WAY LIGHT SWITCH DUPLEX CONVENIENCE OUTLET DUPLEX CONVENIENCE OUTLET W/ GROUND FAULT CIRCUIT INTERRUPTER 120/240V - 10 - 3W PANELBOARD الشهارات فالمحاج TELEPHONE OUTLET EXISTING TO REMAIN ΕX EXISTING TO BE REMOVED CONDUIT RUN CONCEALED WITH NEUTRAL,

--+124--


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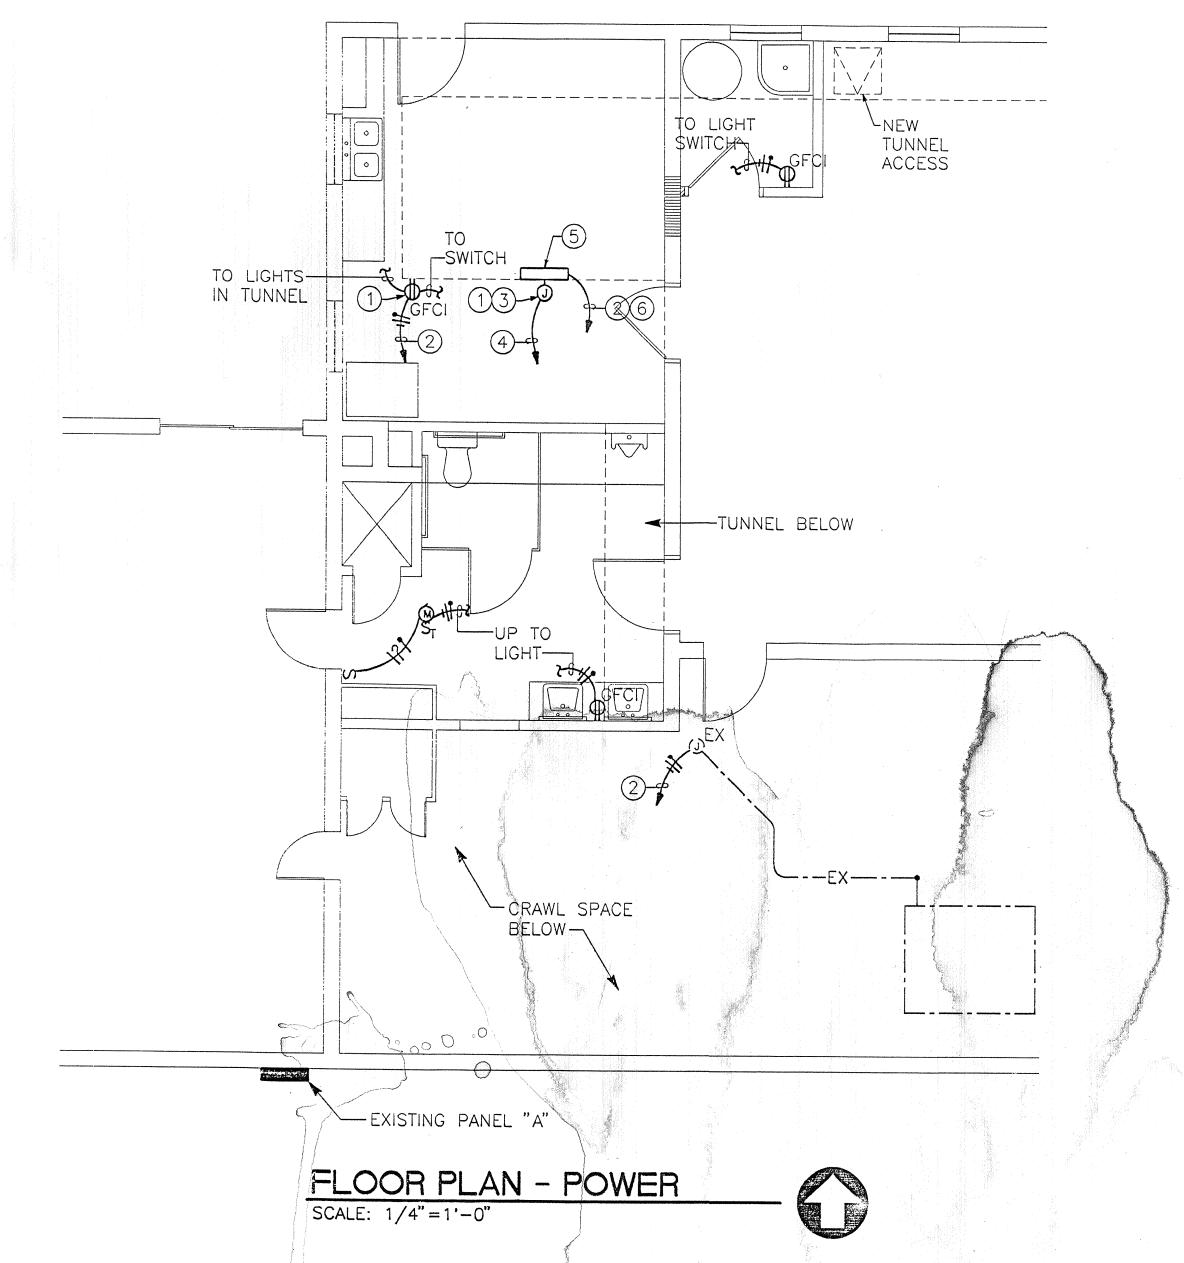
HOT, SWITCH LEG, AND GROUND RESPECTIVELY

CONDUIT RUN BELOW FLOOR OR IN WALL

CONDUIT RUN EXPOSED

ELECTRICAL LEGEND



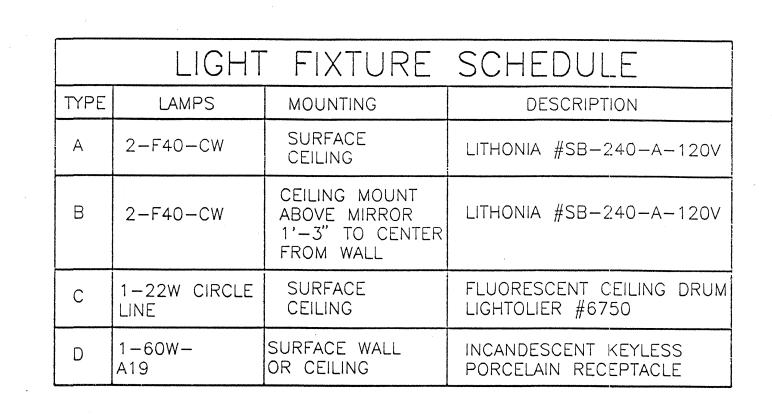

GENERAL NOTES - CONT'D

- 13 ALL COVERPLATES SHALL BE CODE GA. AND MEET THE MINIMUM SIZES AS RECOMMENDED BY N.E.C.
- 14 IT IS INTENDED FOR THE CONTRACTOR TO REUSE EXISTING CONDUIT SYSTEMS WITHIN THE BUILDING WHERE POSSIBLE OR FEASIBLE. WIRING SHALL BE REPLACED WHERE NEW WORK IS BEING PERFORMED.
- 15 IN ALL LOCATIONS WHERE EXISTING LIGHTING OR POWER CIRCUITS ARE AFFECTED BY THE REMOVAL OF CONDUIT WIRING, THE BLOCKING OUT OF EXISTING OUTLET BOXES, ETC., AND THE CIRCUIT IS STILL ? REQUIRED TO FEED OTHER ITEMS OF EQUIPMENT WHICH ARE TO REMAIN AFTER THE REMODEL, THE CONTRACTOR SHALL REFEED AS REQUIRED, THE ITEMS OF EQUIPMENT WHICH ARE TO REMAIN IN SERVICE AFTER THE COMPLETION OF THE REMODEL AT NO ADDITIONAL COST.

GENERAL NOTES - CONT'D

- 8 INTERRUPTION OF ANY "ELECTRICAL SERVICES SHALL BE COORDINATED WITH THE FIRE STATION AT LEAST 7 DAYS PRIOR TO THE INTENDED OUTAGE AND SHALL BE REQUESTED IN WRITING WITH A COPY TO THE OWNER.
- 9 ALL CONDUCTORS TO BE #12 AWG (POWER) #14 AWG (CONTROL/SIGNAL) EXCEPT WHERE OTHERWISE SHOWN, NOTED, OR RECOMMENDED BY EQUIPMENT/SYSTEM MANUFACTURER.
- 10 PROVIDE SEPARATE COLOR CODING FOR POWER AND CONTROL/SIGNAL CIRCUITS. MAINTAIN SAME COLOR AS THAT WHICH PRESENTLY EXISTS IN BUILDING.
- 11 CONDUIT SHALL BE ROUTED CONCEALED WHERE POSSIBLE BELOW FLOOR, IN WALLS OR CEILINGS IN A NEAT WORKMANLIKE MANNER.
- 12 ALL COVERPLATES SHALL BE PAINTED STEEL.

WAR SORTA

MOUNTED IN TUNNEL OR CRAWL

KEYED NOTES

- 2 HOMERUN TO EXISTING PANEL "A". FIELD COORDINATE ROUTING.
- 3 INSTALL J-BOX IN CRAWL SPACE TO INTERCEPT EXISTING CIRCUITS FEEDING INTO SIDE AND BOTTOM OF OLD PANELBOARD. EXTEND FOUR (4) EXISTING CIRCUITS TO EXISTING PANEL "A".
- 4 8 #12-3/4" C. MINIMUM.
- 5 INSTALL 4"x4"x1'-0" LONG SCREW COVER WIREWAY ABOVE CEILING TO INTERCEPT EXISTING CIRCUITS FEEDING INTO TOP OF OLD PANEL-BOARD. EXTEND FIVE (5) EXISTING , CIRCUITS TO EXISTING PANEL "A".
- 6 11 #12-1" C. MINIMUM.
- 7 INSTALL UP TO 10 20A-1P CIRCUIT BREAKERS IN EXISTING SPACES. FIELD COORDINATE.

GENERAL NOTES

THE CONTRACTOR SHALL PROVIDE AND INSTALL ALL ELECTRICAL FACILITIES IN ACCORDANCE WITH THE FOLLOWING: SPECIFICATIONS, PLANS AND ASSOCIATED NOTES, A NATIONAL ELECTRICAL CODE, STATE AND LOCAL CODES, AND IN A WORKMANLIKE MANNER.

DATE

DATE: 12/23/93 DATE: 12/23/93 DATE: 12/23/93

REMARKS
REVISIONS
DESIGN

VEY INFORMATE FIELD NOTES BY


- CONTRACTOR SHALL BECOME FAMILIAR WITH EXISTING CONDITIONS AT JOB SITE.
- THE CONTRACTOR SHALL INSTALL ALL CONTROLS AND MAKE REQUIRED CONNECTIONS TO EQUIPMENT FURNISHED BY OTHERS
- THE CONTRACTOR SHALL INCLUDE, IN HIS BID, THE COSTS OF ALL PERMITS, TEST AND INSPECTIONS, AND VISIT THE SITE OF WORK BEFORE SUBMITTING
- THE CONTRACTOR SHALL COORDINATE HIS WORK WITH OTHER TRADES AND REFER TO ARCHITECTURAL PLANS TO DETERMINE THE EXACT LOCATION OF EQUIPMENT.
- THE CONTRACTOR SHALL GUARANTEE ALL WORK AND MATERIAL FOR A PERIOD OF ONE YEAR AFTER DATE OF ACCEPTANCE.
- A SET OF MARKED UP PRINTS SHALL BE PREPARED SHOWING ALL CHANGES MADE DURING CONSTRUCTION AND TURN IT OVER TO THE OWNER AT THE END OF THE PROJECT. ALL CHANGES MUST HAVE THE OWNER'S APPROVAL.


Holmes & Narver

CITY OF ALBUQUERQUE FIRE DEPARTMENT

TITLE: FIRE STATION NO. 10 MODIFICATIONS ELECTRICAL FLOOR PLANS AND SCHEDULES


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DRC CHAIRMAN			WATER			
TRANSPORTATION			WASTE WATE	R		
HYDROLOGY		ì				
PARKS & REC						
DRAWING NO. 46	570.90	MAI	NO. G12	SHE	EET 0	F 8

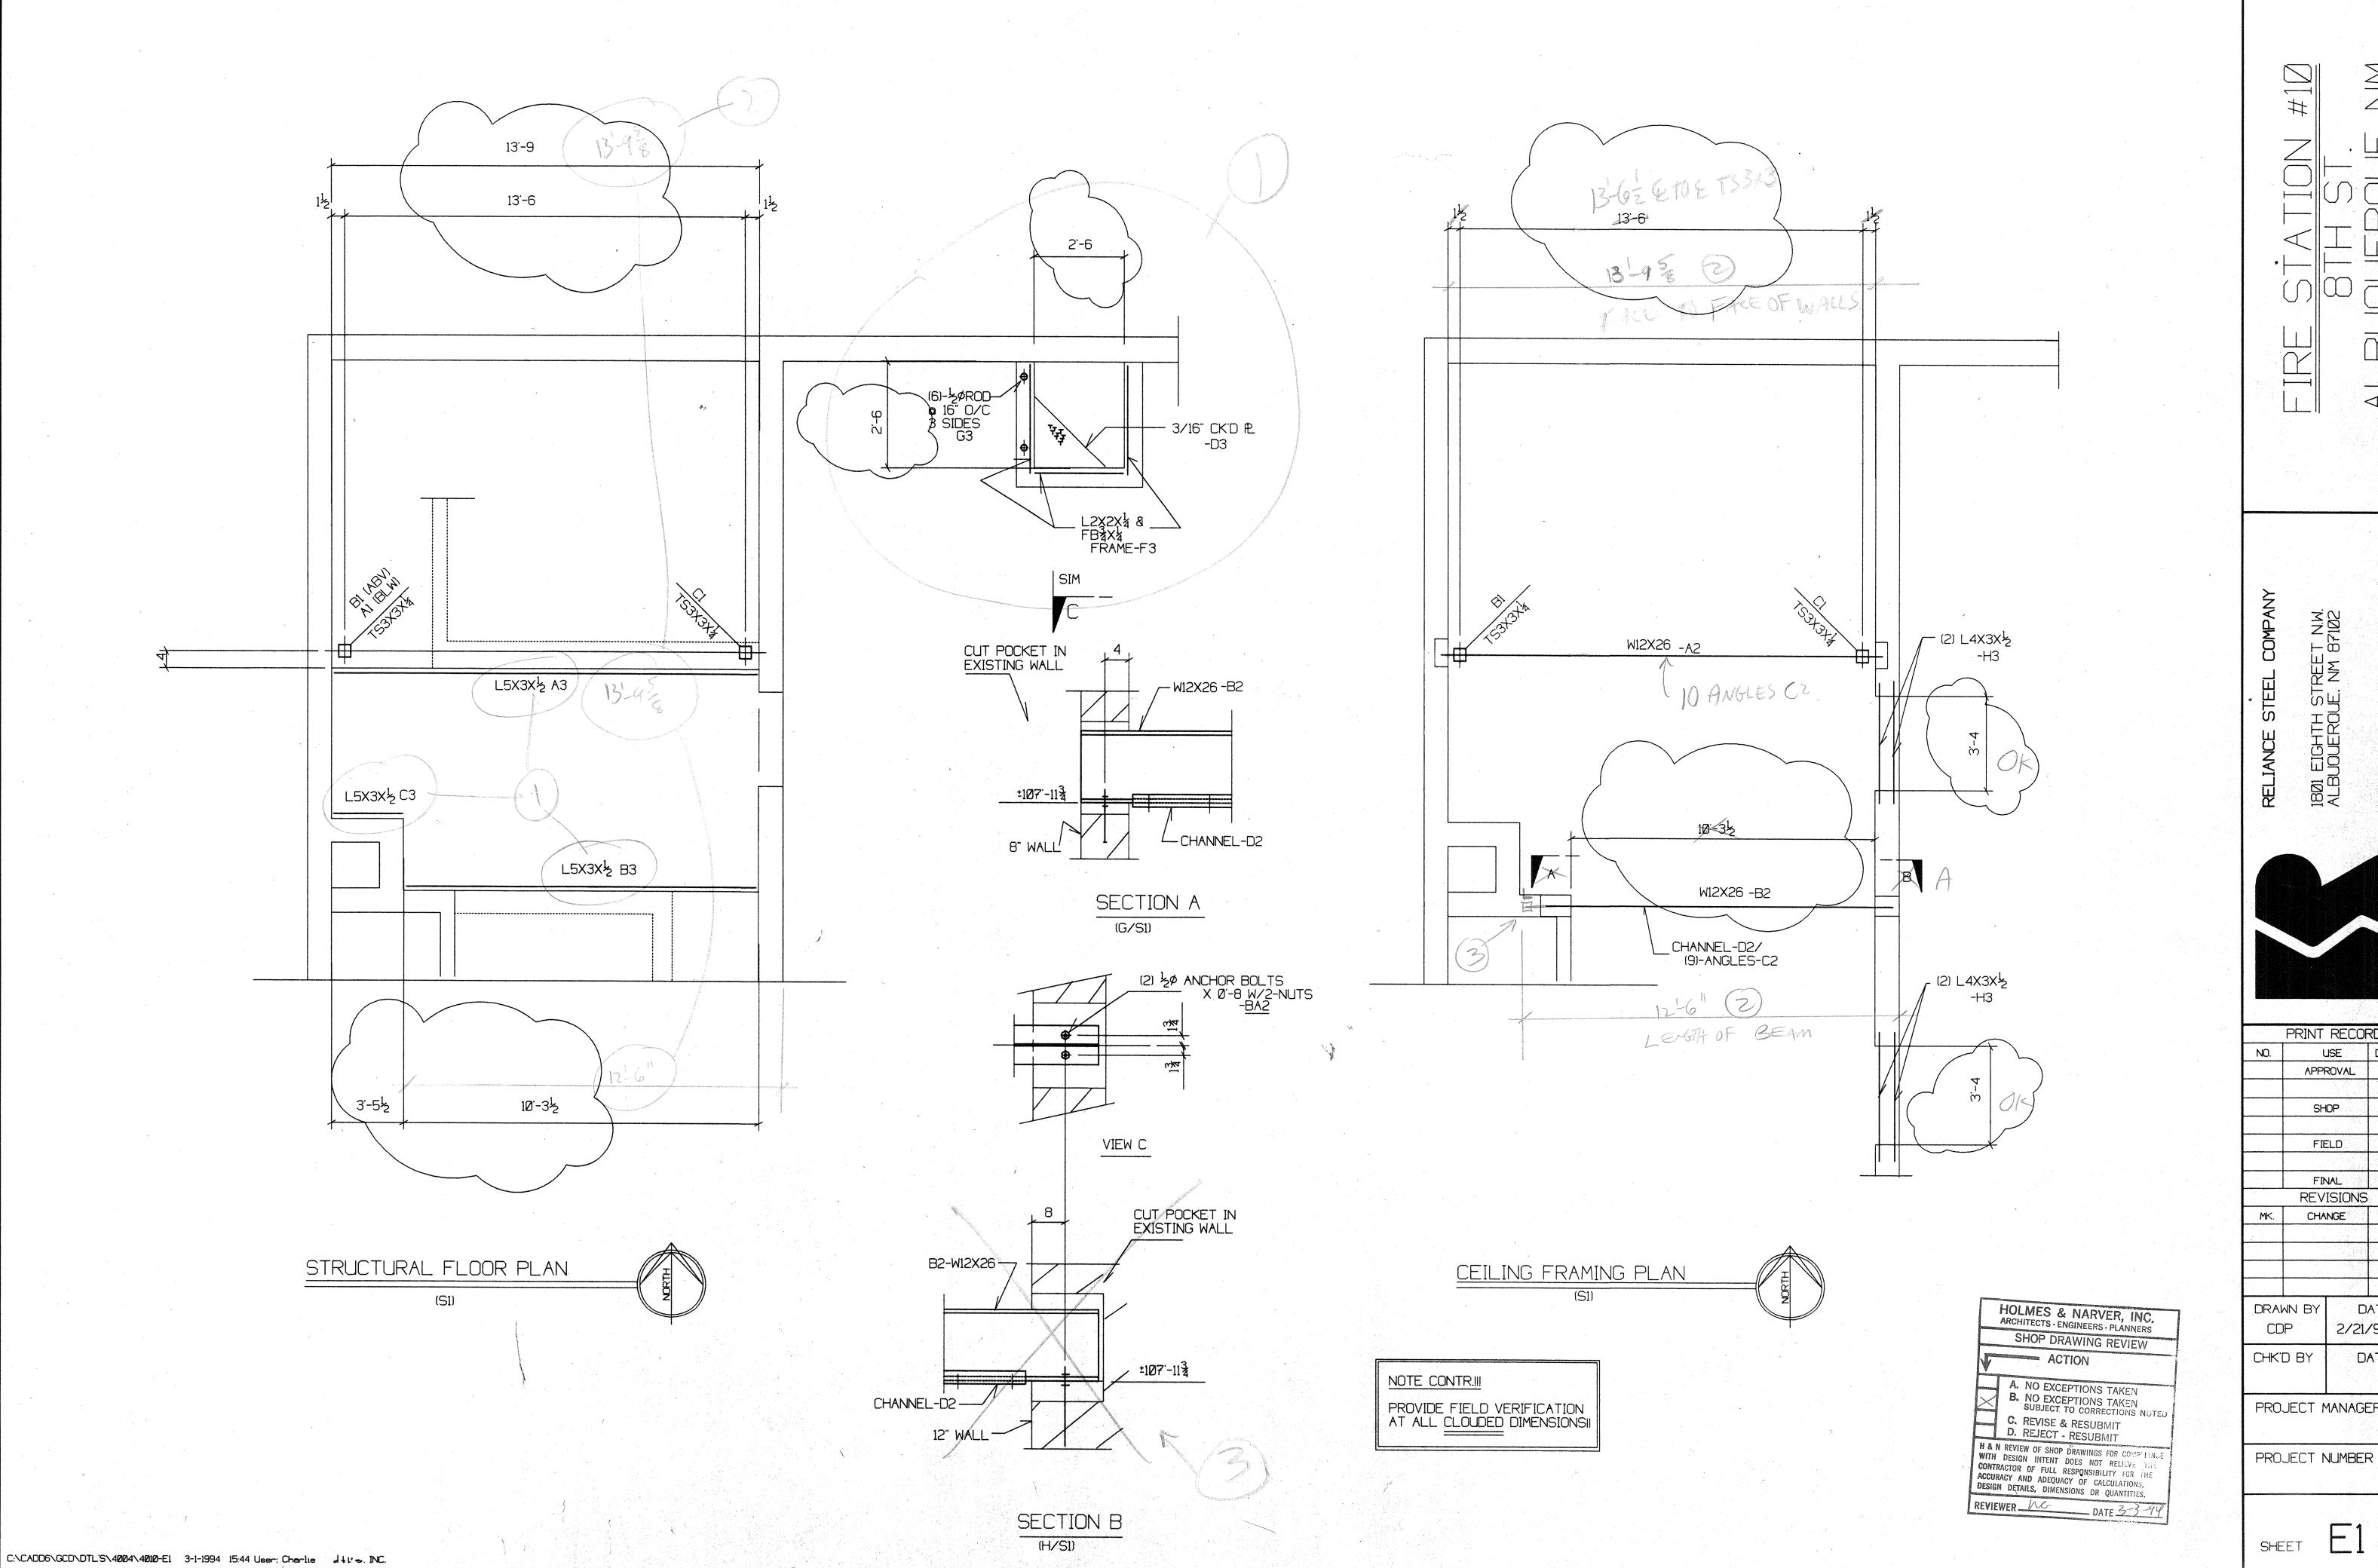


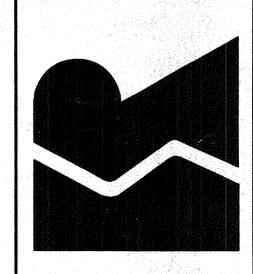


PRINT RECORD USE DATE REVISIONS CHANGE DATE DATE 2/21/94 DATE


PROJECT MANAGER

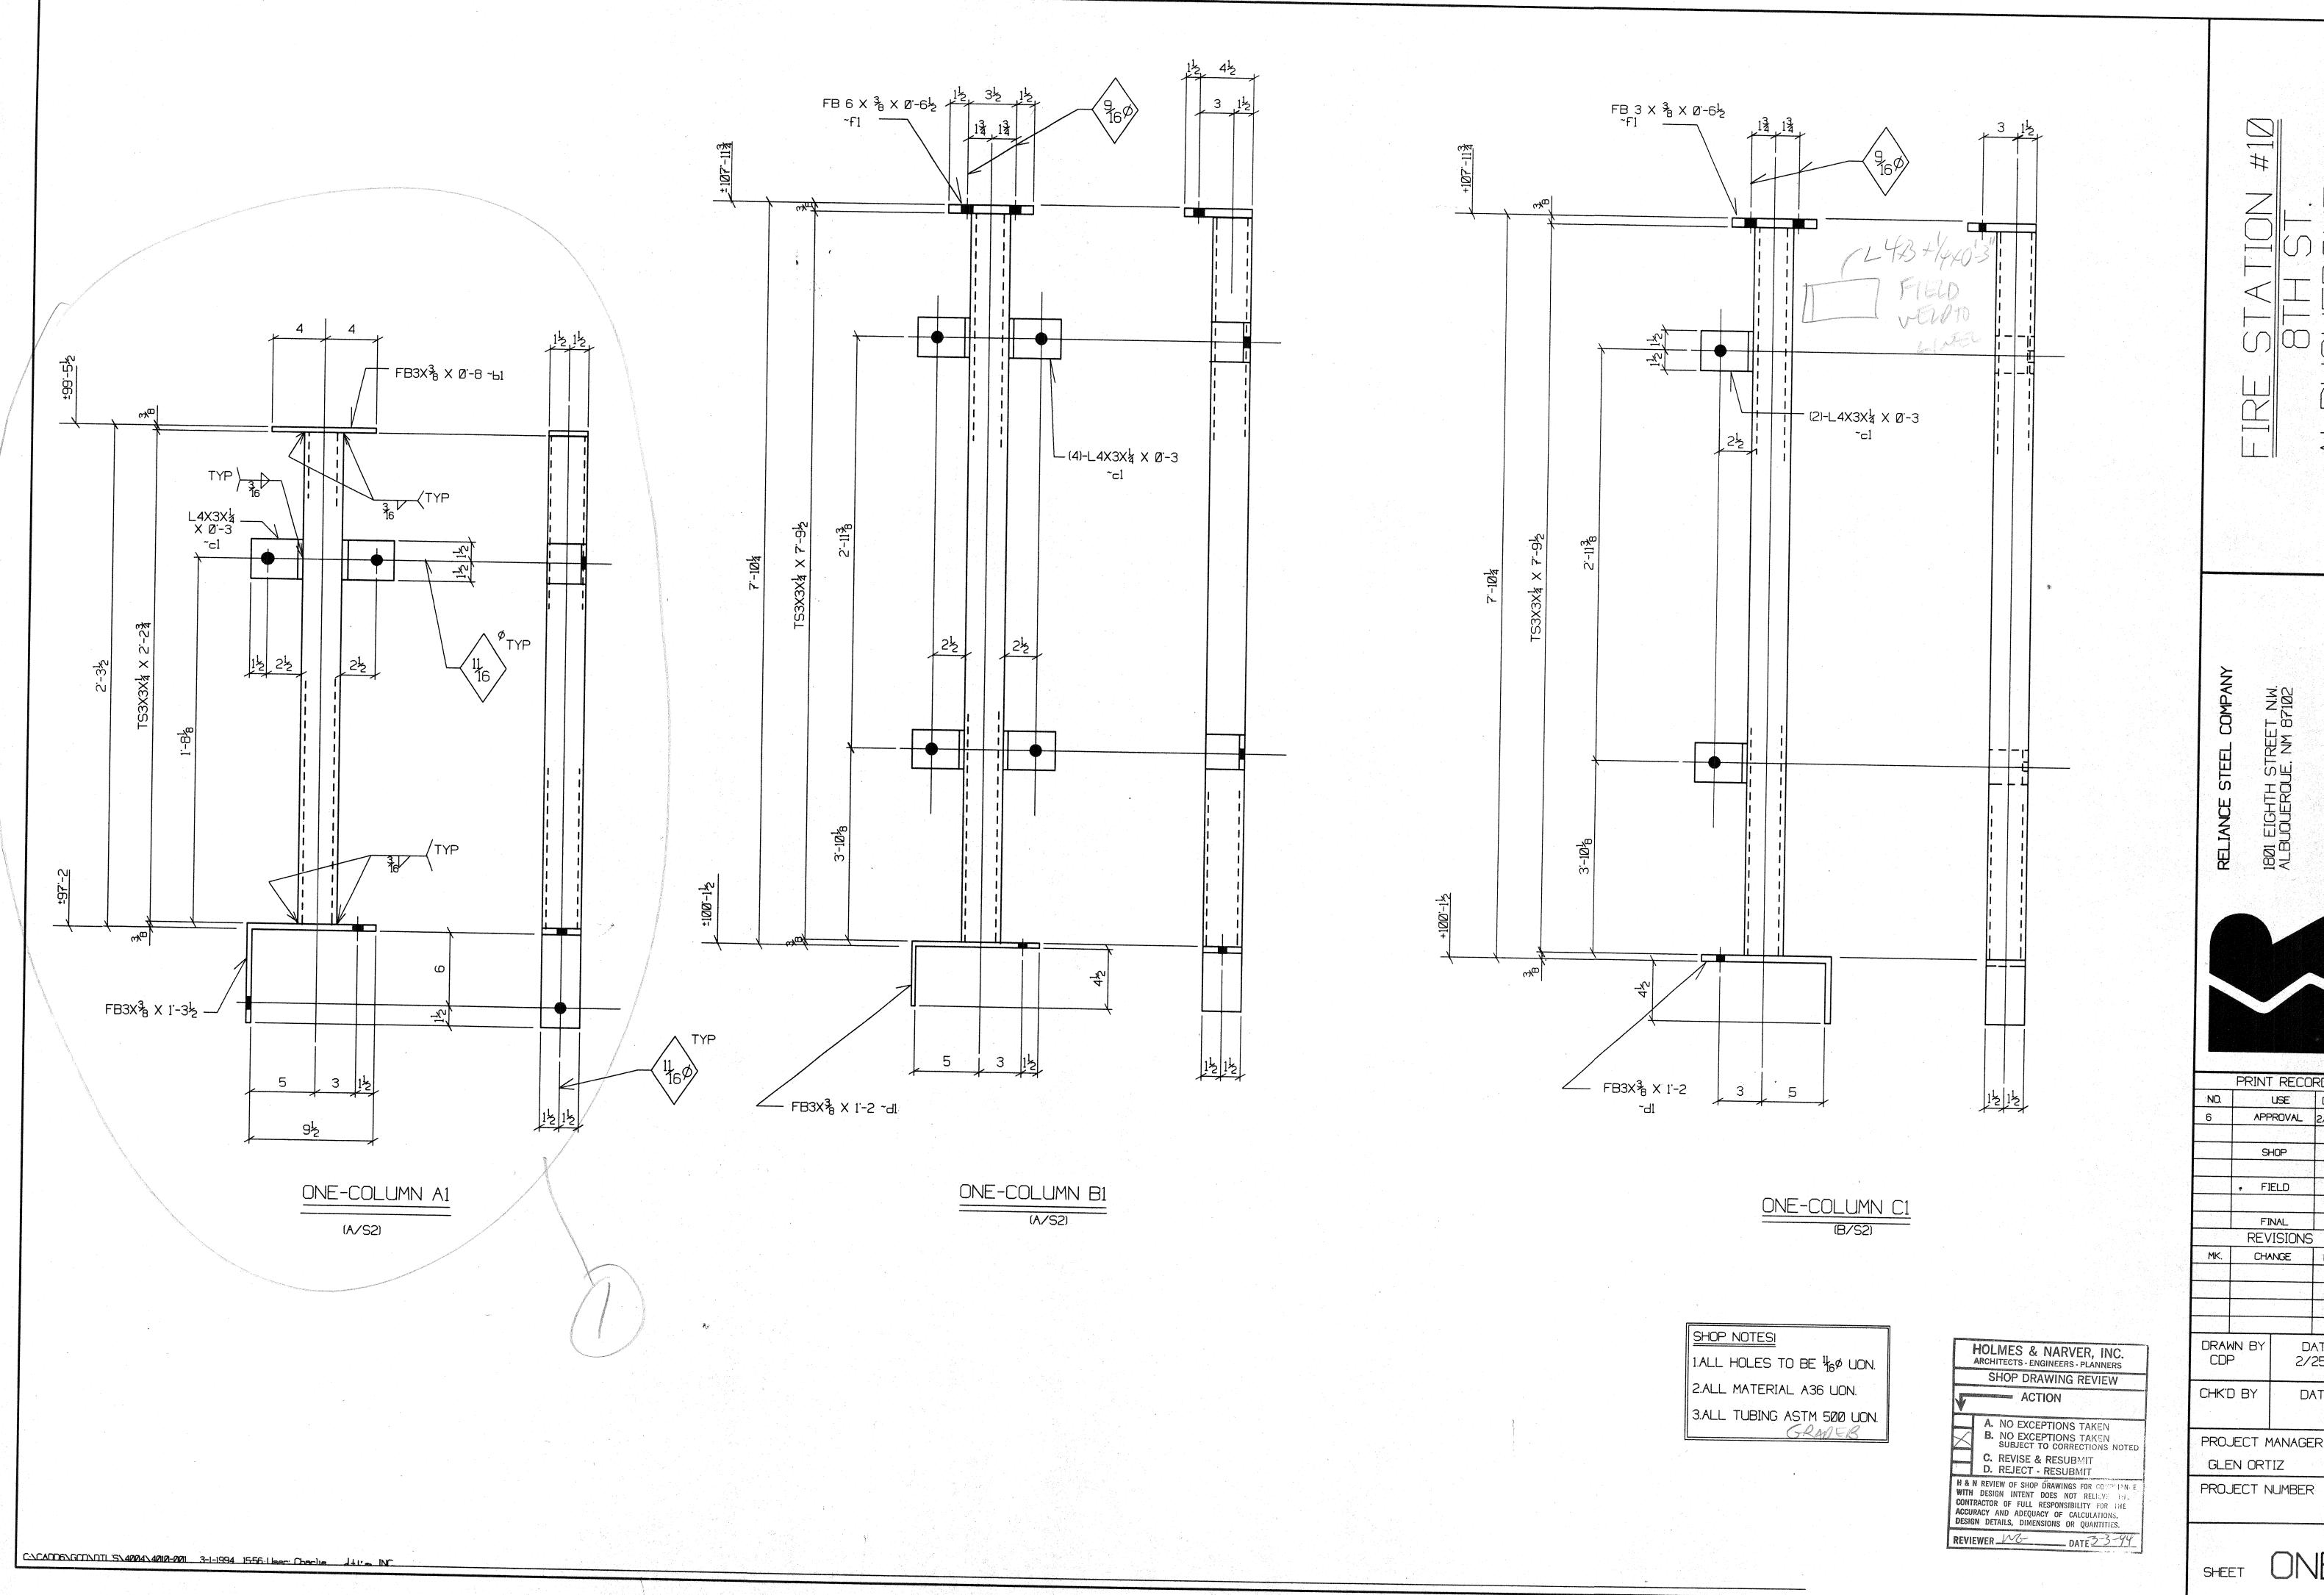

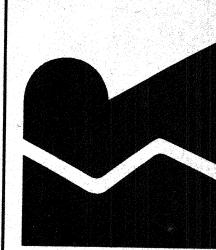

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CHK.[D BY	DATE					
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GLE	GLEN ORTIZ						
PROJECT NUMBER							

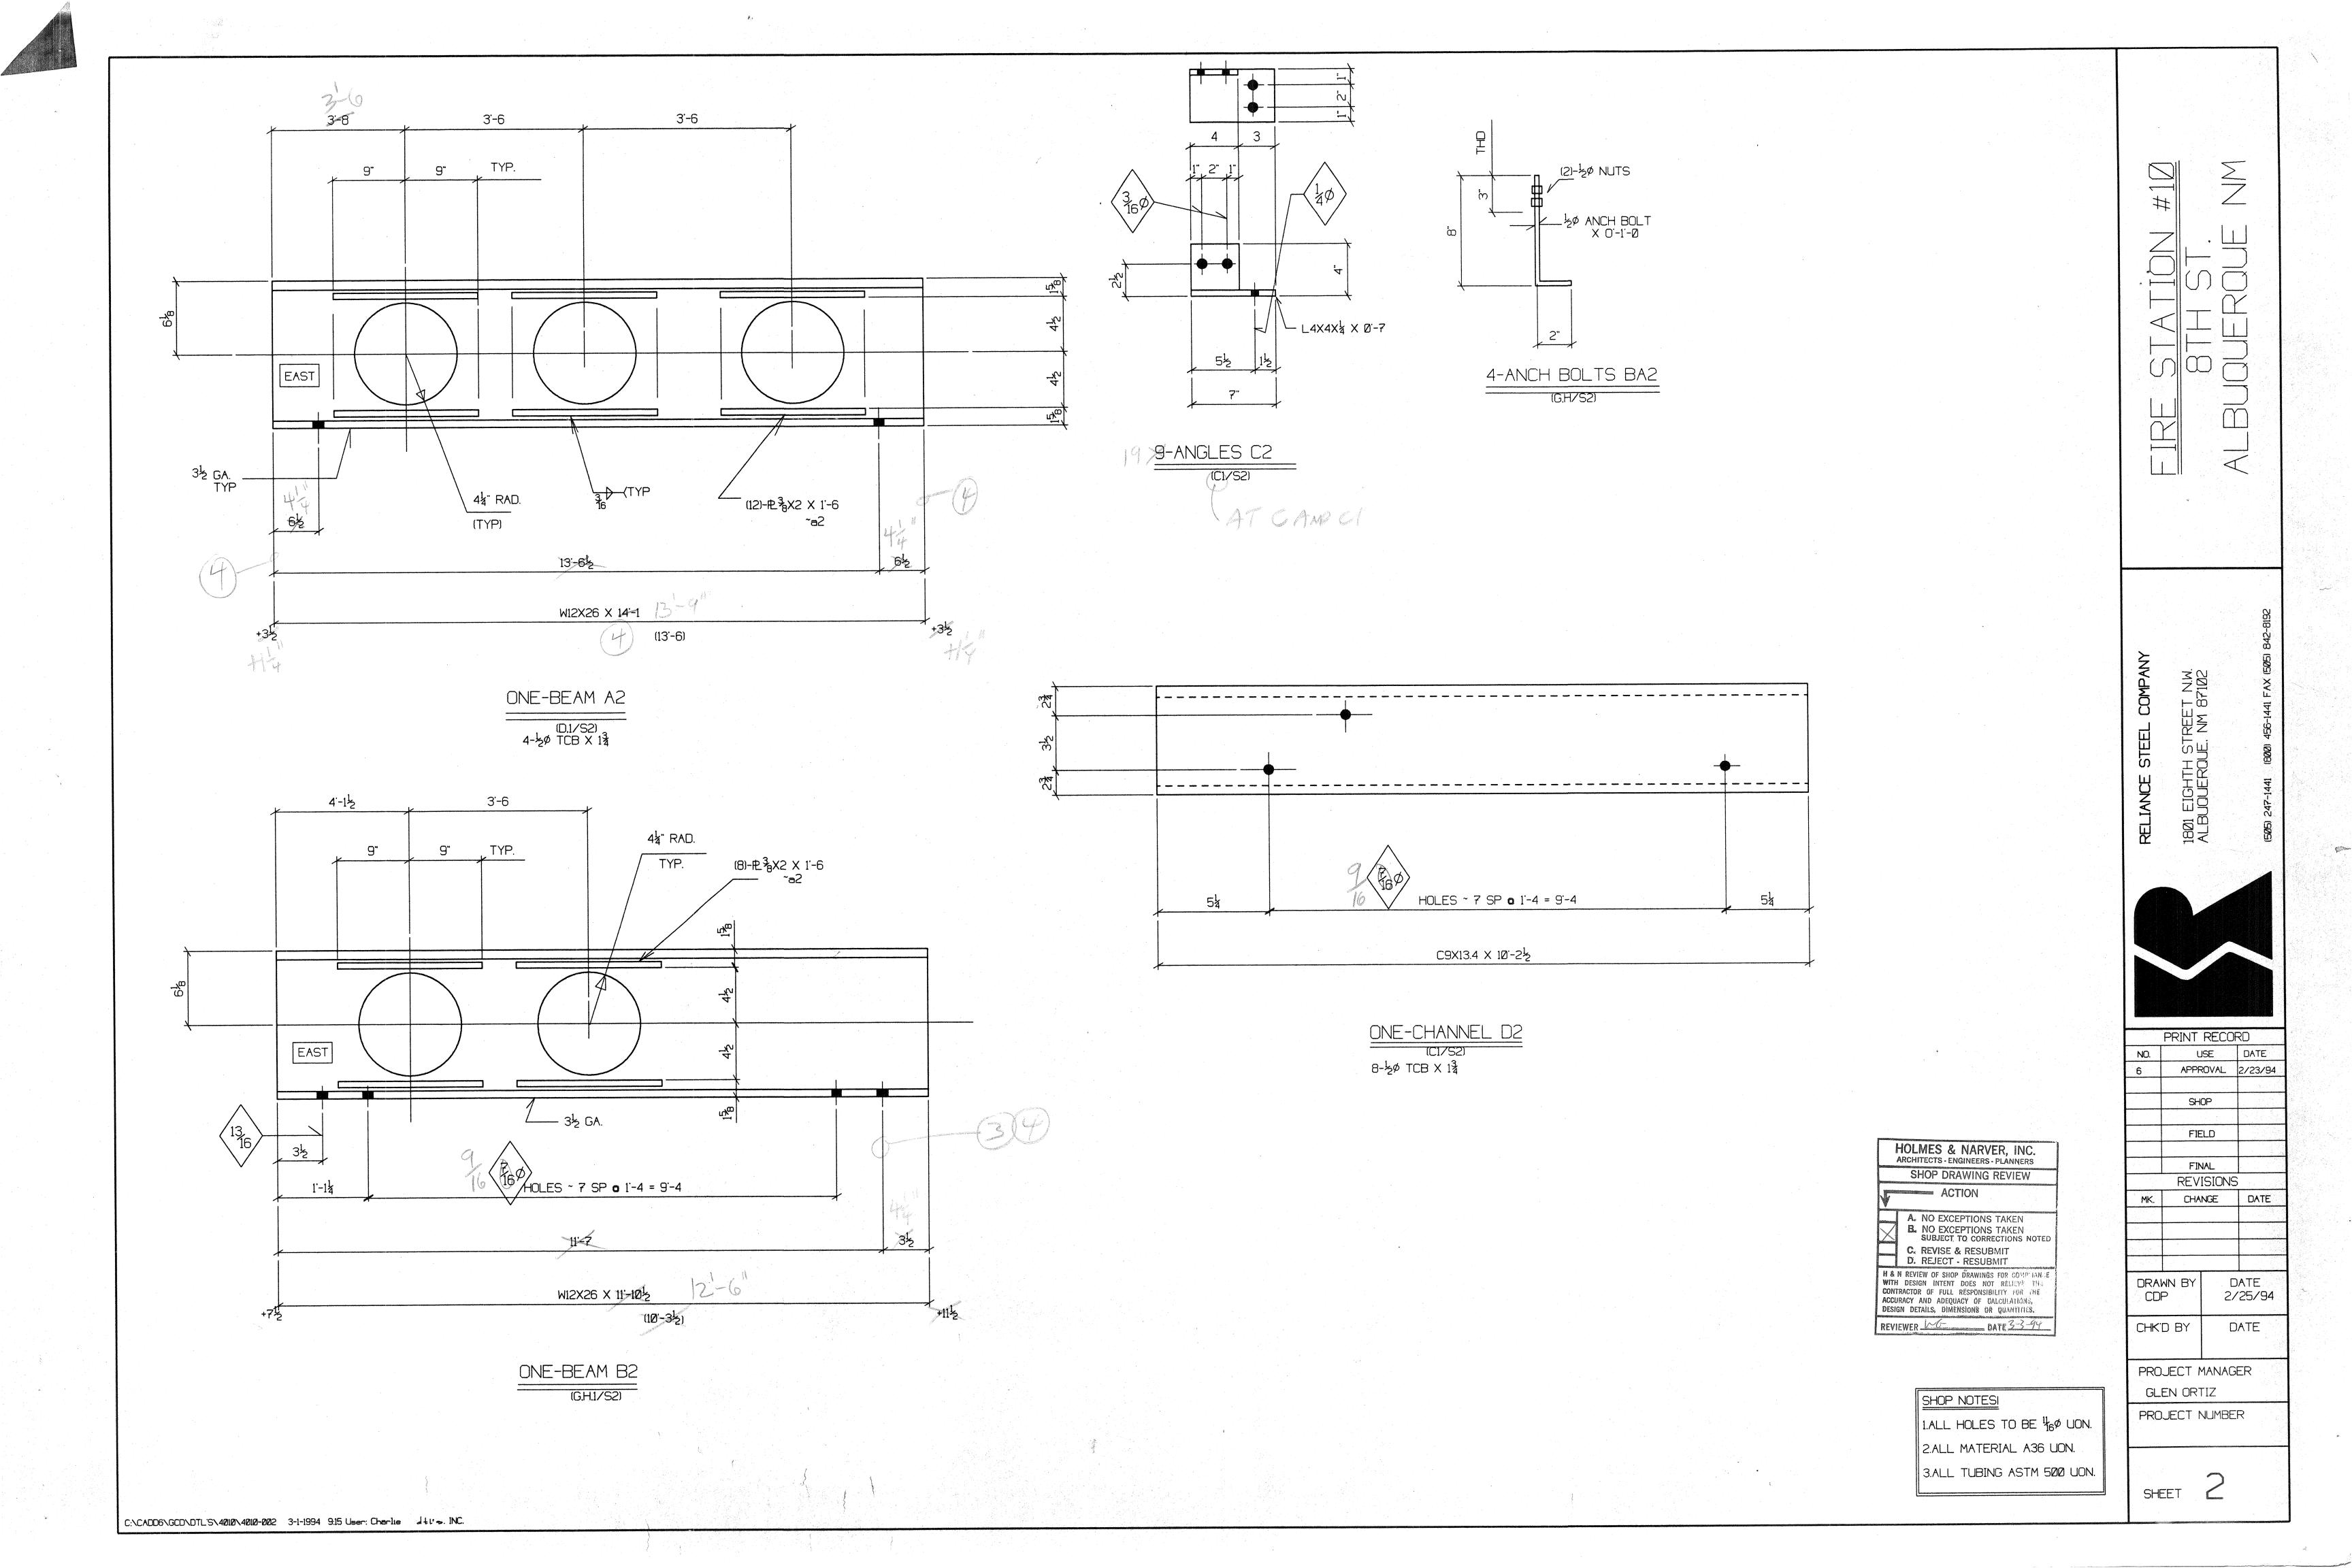

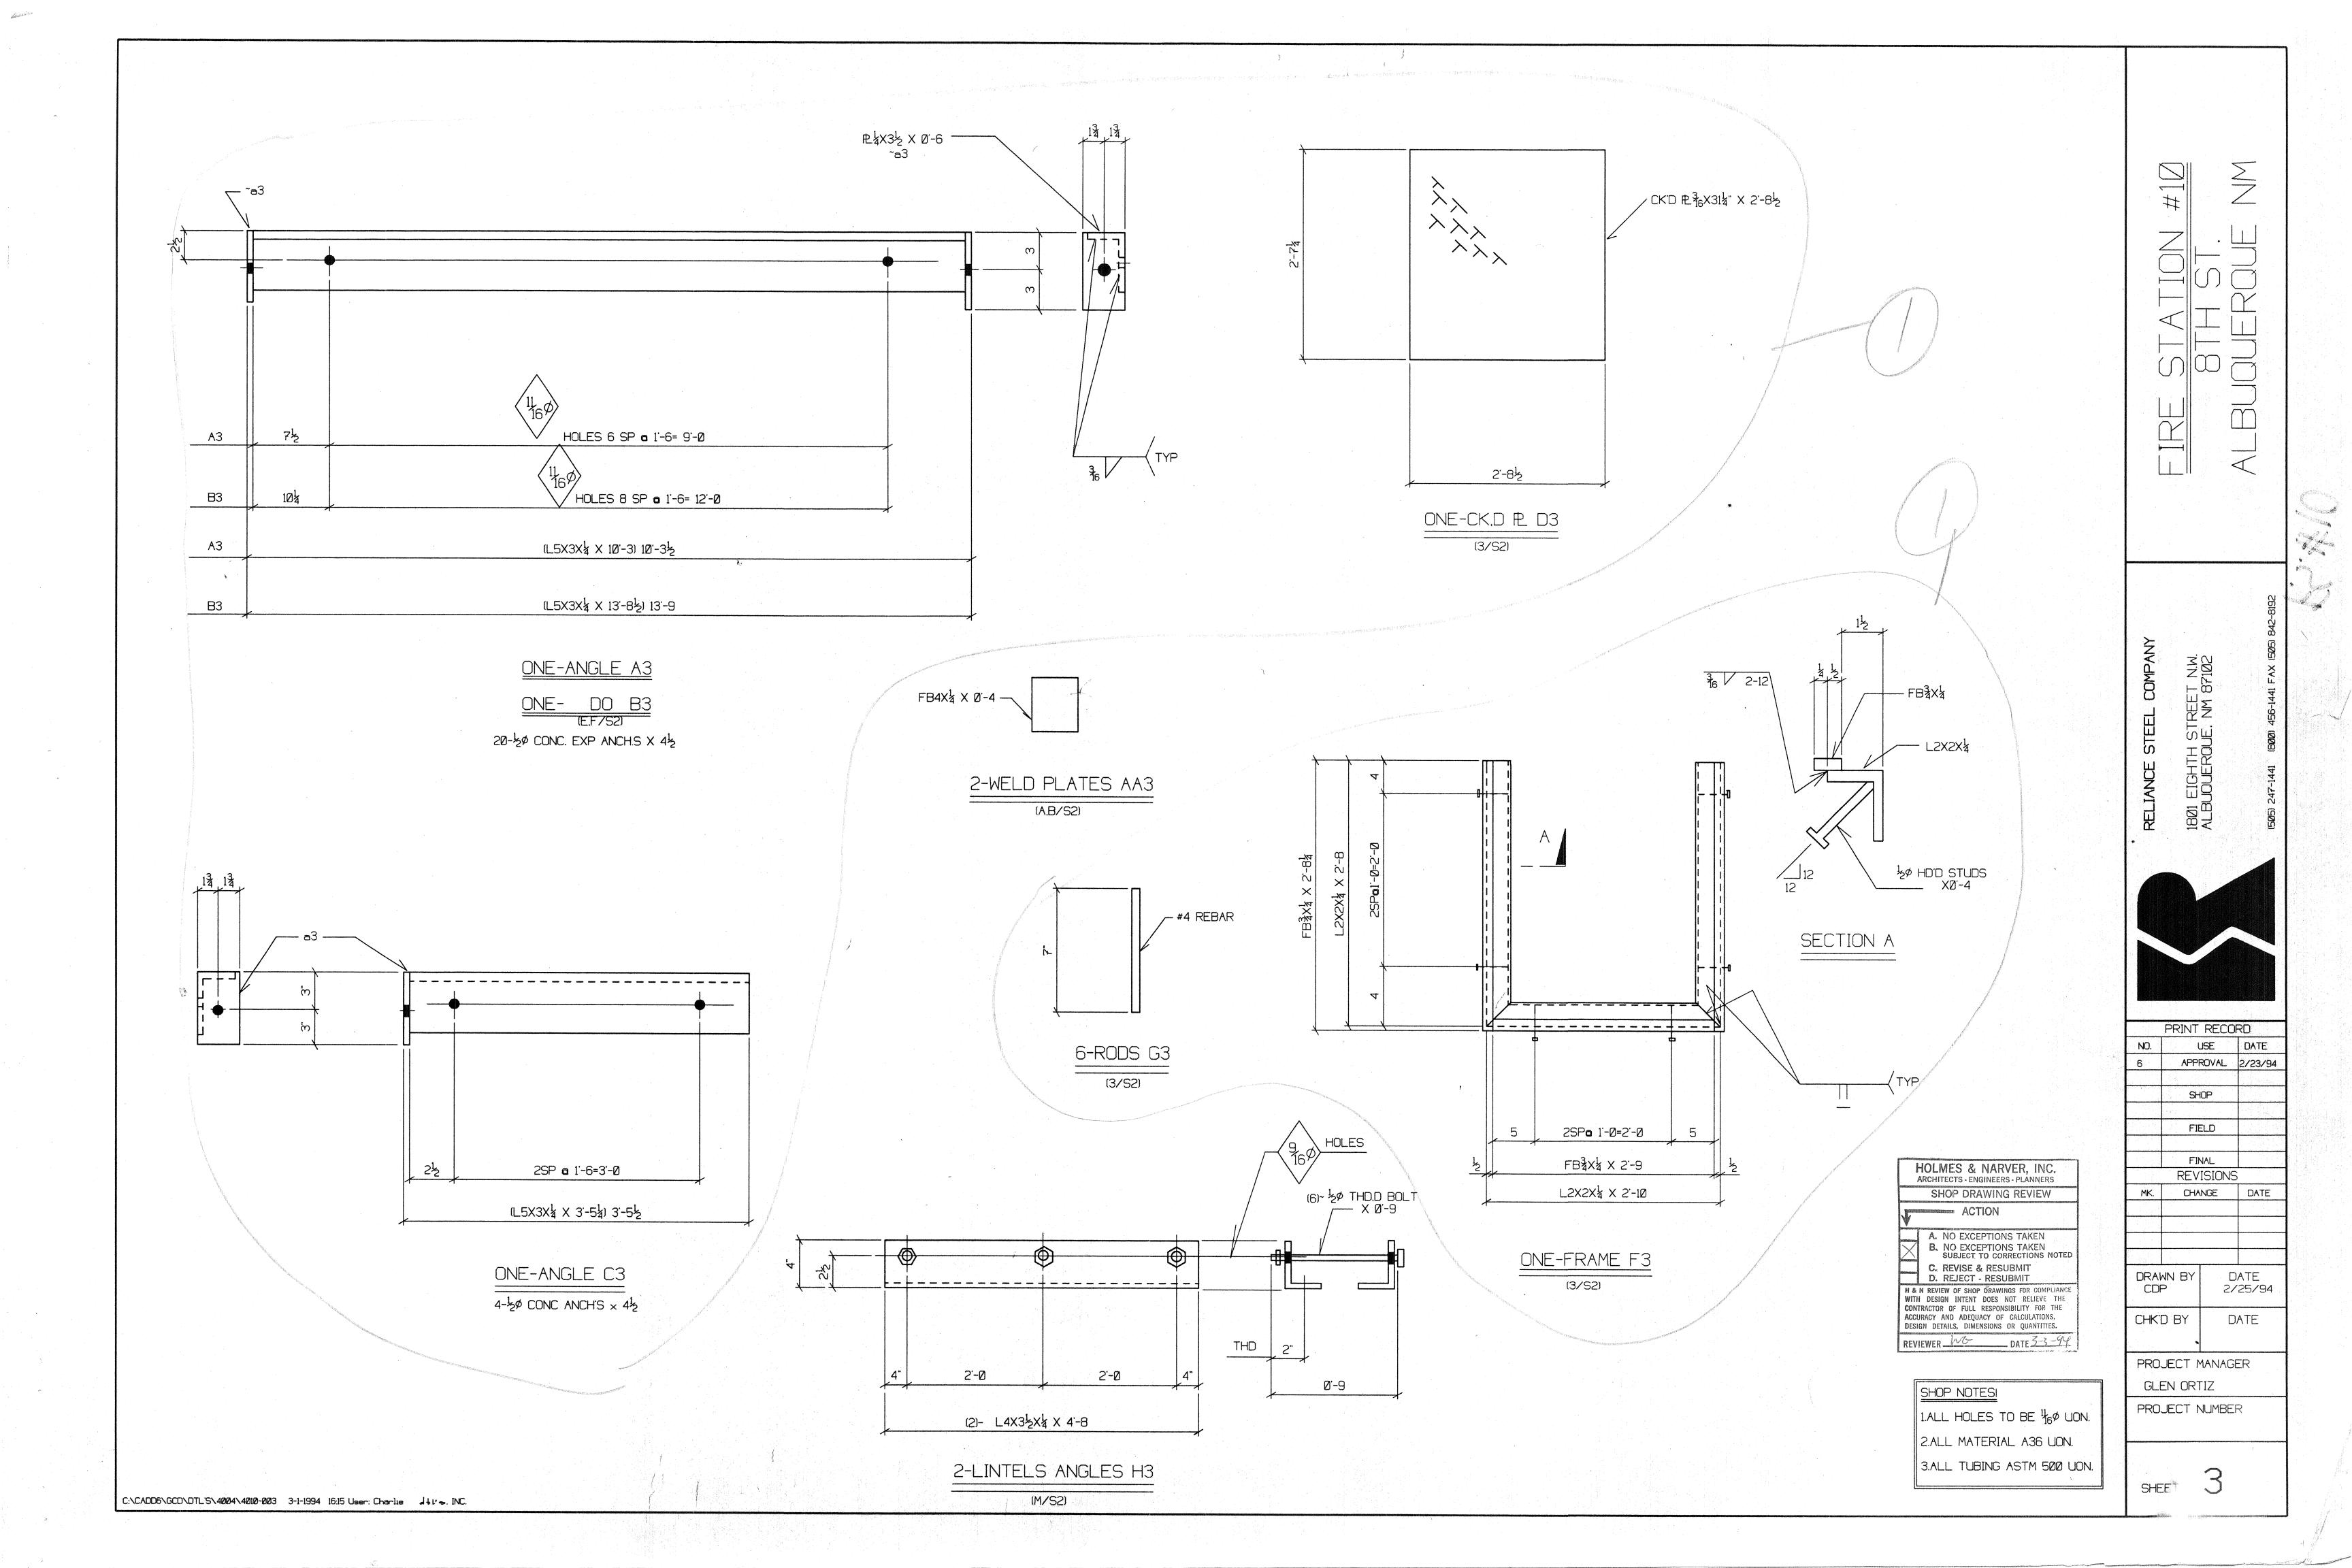

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