CITY OF ALBUQUERQUE, NEW MEXICO CONSTRUCTION PLANS

SEP PROJECT AT PINO MAINTENANCE YARD CITY PROJECT No. 528002

5501 Pino Avenue N.E. Albuquerque, New Mexico 87109 **SEPTEMBER 12, 2014**



GENERAL NOTES

- ALL WORK DETAILED ON THESE PLANS TO BE PERFORMED UNDER CONTRACT SHALL, EXCEPT AS OTHERWISE STATED OR PROVIDED FOR HEREON. BE CONSTRUCTED IN ACCORDANCE WITH THE CITY OF ALBUQUERQUE STANDARD SPECIFICATIONS FOR PUBLIC WORKS CONSTRUCTION 1986 EDITION AS AMENDED WITH UPDATE NO. 8.
- PRIOR TO CONSTRUCTION, THE CONTRACTOR SHALL EXCAVATE AND VERIFY THE HORIZONTAL AND VERTICAL LOCATIONS OF ALL OBSTRUCTIONS. SHOULD A CONFLICT EXIST, THE CONTRACTOR SHALL NOTIFY THE ENGINEER SO THAT THE CONFLICT CAN BE RESOLVED WITH MINIMUM DELAY.
- TWO (2) WORKING DAYS PRIOR TO ANY EXCAVATION, CONTRACTOR MUST CONTACT NEW MEXICO ONE CALL SYSTEM, INC. @ 260-1990 FOR LOCATION OF EXISTING UTILITIES.
- TRAFFIC CONTROL: SEVEN (7) WORKING DAYS PRIOR TO BEGINNING CONSTRUCTION THE CONTRACTOR SHALL SUBMIT TO THE CONSTRUCTION COORDINATION DIVISION A DETAILED CONSTRUCTION SCHEDULE. TWO (2) WORKING DAYS PRIOR TO CONSTRUCTION, THE CONTRACTOR SHALL OBTAIN A BARRICADING PERMIT FROM THE CONSTRUCTION COORDINATION DIVISION. THE CONTRACTOR SHALL NOTIFY THE BARRICADING ENGINEER (924-3400) PRIOR TO OCCUPYING AN INTERSECTION. SEE SECTION 19 FOR THE SPECIFICATIONS.
- ALL PAVEMENT STRIPING ALTERED OR DESTROYED SHALL BE REPLACED WITH PAINTED REFLECTORIZED PAVEMENT MARKINGS BY THE CONTRACTOR TO THE SAME LOCATION AS WAS EXISTING, OR AS SHOWN ON THESE PLANS.
- THE CONTRACTOR SHALL PROMPTLY CLEAN UP ANY MATERIAL EXCAVATED WITHIN THE PUBLIC RIGHT-OF-WAY OR PRIVATE ROADWAY EASEMENTS SO THAT THE EXCAVATED MATERIAL IS NOT SUSCEPTIBLE TO BEING WASHED DOWN THE STREET OR INTO ANY PUBLIC DRAINAGE FACILITY.
- THE CONTRACTOR SHALL RECORD DATA ON ALL UTILITY LINES AND ACCESSORIES AS REQUIRED BY THE CITY OF ALBUQUERQUE FOR THE PREPARATION OF "AS CONSTRUCTED" DRAWINGS. THE CONTRACTOR SHALL NOT COVER UTILITY LINES AND ACCESSORIES UNTIL ALL DATA HAS BEEN RECORDED.
- THE CONTRACTOR SHALL NOTIFY ALL AFFECTED UTILITY COMPANIES OF ANY ADJUSTMENT OR RELOCATION OF EXISTING UTILITIES REQUIRED DUE TO THE CONSTRUCTION OPERATIONS THE CONTRACTOR MAY BE REQUIRED TO RESCHEDULE HIS ACTIVITIES TO ALLOW UTILITY CREWS TO PERFORM THEIR WORK. NO ADDITIONAL COSTS WILL BE ALLOWED FOR DELAYS OR INCONVENIENCES CAUSED BY UTILITY COMPANY CREWS.
- EXISTING UTILITY LINE LOCATIONS ARE SHOWN IN AN APPROXIMATE MANNER ONLY, AND SUCH LINES MAY EXIST WHERE NONE ARE SHOWN. THE LOCATION OF ANY SUCH EXISTING LINE IS BASED UPON INFORMATION PROVIDED BY THE UTILITY COMPANY, THE OWNER, OR BY OTHERS AND THE INFORMATION MAY BE INCOMPLETE OR MAY BE OBSOLETE BY THE TIME CONSTRUCTION COMMENCES.


- 10. WARNING THE ENGINEER HAS UNDERTAKEN A LIMITED SCOPE OF THE EXISTENCE, LOCATION, SIZE, DEPTH, OR TYPE OF UNDERGROUND UTILITY LINES, MAKES NO REPRESENTATION PERTAINING THERETO, AND ASSUMES NO RESPONSIBILITY OR LIABILITY THEREFOR. THE CONTRACTOR SHALL BECOME INFORMED OF THE LOCATION OF ANY UTILITY LINE IN OR NEAR THE AREA OF THE WORK IN ADVANCE OF AND DURING EXCAVATION WORK. THE CONTRACTOR IS FULLY RESPONSIBLE FOR ANY AND ALL DAMAGE CAUSED BY THE FAILURE TO LOCATE, IDENTIFY, AND PRESERVE ANY AND ALL EXISTING UTILITIES. THE CONTRACTOR SHALL COMPLY WITH STATE STATUTES, MUNICIPAL AND LOCAL ORDINANCE, RULES AND REGULATIONS PERTAINING TO THE LOCATION OF THESE LINES AND FACILITATES IN PLANNING AND CONDUCTING EXCAVATION OPERATIONS, WHETHER BY CALLING OR NOTIFYING THE UTILITIES COMPLYING WITH "NEW MEXICO ONE CALL SYSTEM, INC." PROCEDURES OR OTHERWISE.
- 11. THE CONTRACTOR SHALL CONFINE HIS WORK AS SHOWN ON THE ATTACHED PLANS. OVERNIGHT PARKING OF THE CONTRACTOR'S EQUIPMENT SHALL NOT OBSTRUCT ACCESS ROADS, TRAFFIC LANES OR PEDESTRIAN PATHWAYS.
- 12. THE CONTRACTOR SHALL MAINTAIN A GRAFFITI-FREE WORK SITE. THE CONTRACTOR SHALL PROMPTLY REMOVE ANY AND ALL GRAFFITI FROM EQUIPMENT, WHETHER PERMANENT OR TEMPORARY.
- 13. ALL BORROW AND SURFACING MATERIALS SHALL BE OBTAINED FROM CITY APPROVED COMMERCIAL SOURCES.
- 14. AN EXCAVATION/CONSTRUCTION PERMIT MAY BE REQUIRED BEFORE BEGINNING ANY WORK WITHIN THE CITY RIGHT-OF-WAY.
- 15. CONTRACTOR SHALL COORDINATE WITH THE WATER AUTHORITY SEVEN (7) DAYS IN ADVANCE OF PERFORMING WORK THAT WILL AFFECT THE PUBLIC WATER OR SANITARY SEWER INFRASTRUCTURE. WORK REQUIRING SHUTOFF OF FACILITIES DESIGNATED AS MASTER PLAN FACILITIES MUST BE COORDINATED WITH THE WATER AUTHORITY 14 DAYS IN ADVANCE OF PERFORMING SUCH WORK. ONLY WATER AUTHORITY CREWS ARE AUTHORIZED TO OPERATE PUBLIC VALVES. SHUTOFF REQUESTS MUST BE MADE ONLINE AT HTTP://ABCWUA.ORG/CONTENT/VIEW/463/729/.
- 16. AT HIS OWN EXPENSE, CONTRACTOR SHALL ASSUME RESPONSIBILITY FOR ANY DAMAGE TO EXISTING PAVEMENT, PAVEMENT MARKINGS, CURB AND GUTTER, HANDICAP RAMPS, AND SIDEWALK DURING CONSTRUCTION APART FROM THOSE SECTIONS INDICATED FOR REMOVAL ON THE PLANS AND SHALL REPAIR OR REPLACE, PER STANDARD SPECIFICATIONS.
- 17. REMOVALS SHALL BE DISPOSED OF OFF-SITE AND SHALL BE THE RESPONSIBILITY OF THE CONTRACTOR.
- 18. CONTRACTOR SHALL DISPOSE OF ALL UNSUITABLE MATERIAL IN AN ENVIRONMENTALLY ACCEPTABLE MANNER AT A LOCATION ACCEPTABLE TO THE PROJECT MANAGER. THERE WILL BE NO DIRECT COMPENSATION FOR
- 19. ALL EXCAVATION, TRENCHING AND SHORING ACTIVITIES MUST BE CARRIED OUT IN ACCORDANCE WITH OSHA 29 CFR 1926.650 SUBPART P.

UTILITY COMPANIES

- NEW MEXICO GAS COMPANY (GAS SERVICES & GAS LINES) CONTACT: EARL HOSKINS, 697-3140
- PUBLIC SERVICE COMPANY OF NM (ELECTRICAL SERVICES & ELECTRIC LINES) CONTACT: ROLAND BLAUWKAMP, 241-3581 CONTACT: MIKE ADAMS, 241-3316
- CenturyLink (TELEPHONE SERVICES) CONTACT: RITA JARAMILLO, 245-8706
- AT&T (TELEPHONE SERVICES) CONTACT: DAVID CROWEL, 842-2911
- VERIZON-BROOKS FIBER COMM. (TELEPHONE SERVICES)
- CONTACT: ANDY DARNELL, 346-4470
- COMCAST (CABLE TELEVISION) CONTACT: MIKE MORTUS, 761-6235
- TIME WARNER TELECOM (CABLE TELEVISION) CONTACT: ROYAL HARRISON, 938-7339
- ALBUQUERQUE BERNALILLO COUNTY WATER UTILITY AUTHORITY CONTACT: JON ERTSGAARD, 768-2598
- McLEOD USA
 - CONTACT: RICK MUELLER, 244-3161
- BCG ASSETS
 - CONTACT: JOHN BROWN, 877-500-3427

TRAFFIC NOTES

- 1. THE CONTRACTOR SHALL MAINTAIN ONE LANE OPEN ON THE NORTH ACCESS ROAD AT ALL TIMES.
- 2. THE CONTRACTOR SHALL PROVIDE PEDESTRIAN CIRCULATION THROUGH OR AROUND THE WORK SITE AT ALL TIMES.
- 3. THE CONTRACTOR SHALL ACCOMPLISH AS MUCH WORK AS POSSIBLE PRIOR TO STARTING CONSTRUCTION OPERATIONS THAT WILL AFFECT TRAFFIC . THE CONTRACTOR SHALL PROVIDE A LISTING OF SUCH WORK TO THE CITY PROJECT MANAGER AND ENGINEER FOR APPROVAL PRIOR TO STARTING CONSTRUCTION OPERATIONS.
- 4. CONTRACTOR SHALL BE RESPONSIBLE FOR PROVIDING AND MAINTAINING ALL TRAFFIC AND CONSTRUCTION SIGNAGE UNTIL THE PROJECT HAS BEEN ACCEPTED BY THE CITY OF ALBUQUERQUE.

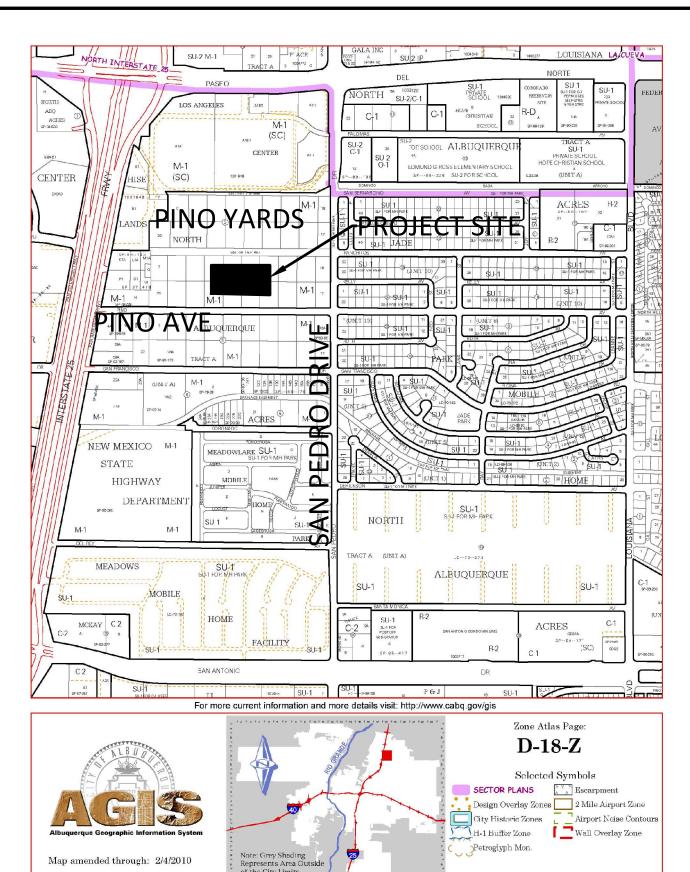


VICINITY MAP ZONE ATLAS MAP D-18-Z

	SHEET INDEX
SHT#	SHEET TITLE
1	TITLE SHEET
2	DEMOLITION PLAN
3	DRAINAGE PLAN
4	PAVING AND MARKING PLAN
5	PERMEABLE ASPHALT SECTION AND DETAILS
6	PERMEABLE PAVER SECTION AND DETAILS
7	WORK ZONE EXHIBIT



CITY OF ALBUQUERQUE DEPARTMENT OF MUNICIPAL DEVELOPMENT

REV. SHEETS CITY ENGINEER DATE USER DEPARTMENT DATE USER DEPARTMENT ENGINEERS STAMP & SIGNATUR APPROVALS FNGINFFR ROVED FOR CONSTRUCTION

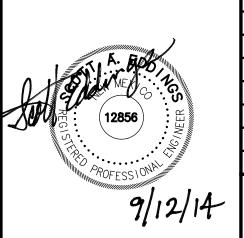


TROVALS	LINOINLLIN	DAIL	
C Chairman			APPF
ansportation	NA	-	
iter/Wastewater	-	_	
drology	_	_	
.P.	_	-	
nstr. Mngmt.	-	-	
nstr. Coord.	-	_	City En
:HD	-	_	
tu Draigat N			Shaa

City Project No. Sheet 528002


SCOTT A. EDDINGS, REGISTERED IN NEW MEXICO AS A PROFESSIONAL ENGINEER NO. 12856, HERBY CERTIFY THAT THIS PROJECT WAS BUILT IN SUBSTANTIAL COMPLIANCE WITH THESE PLANS.

RECORD DRAWINGS

DATE DECEMBER 26, 2014.

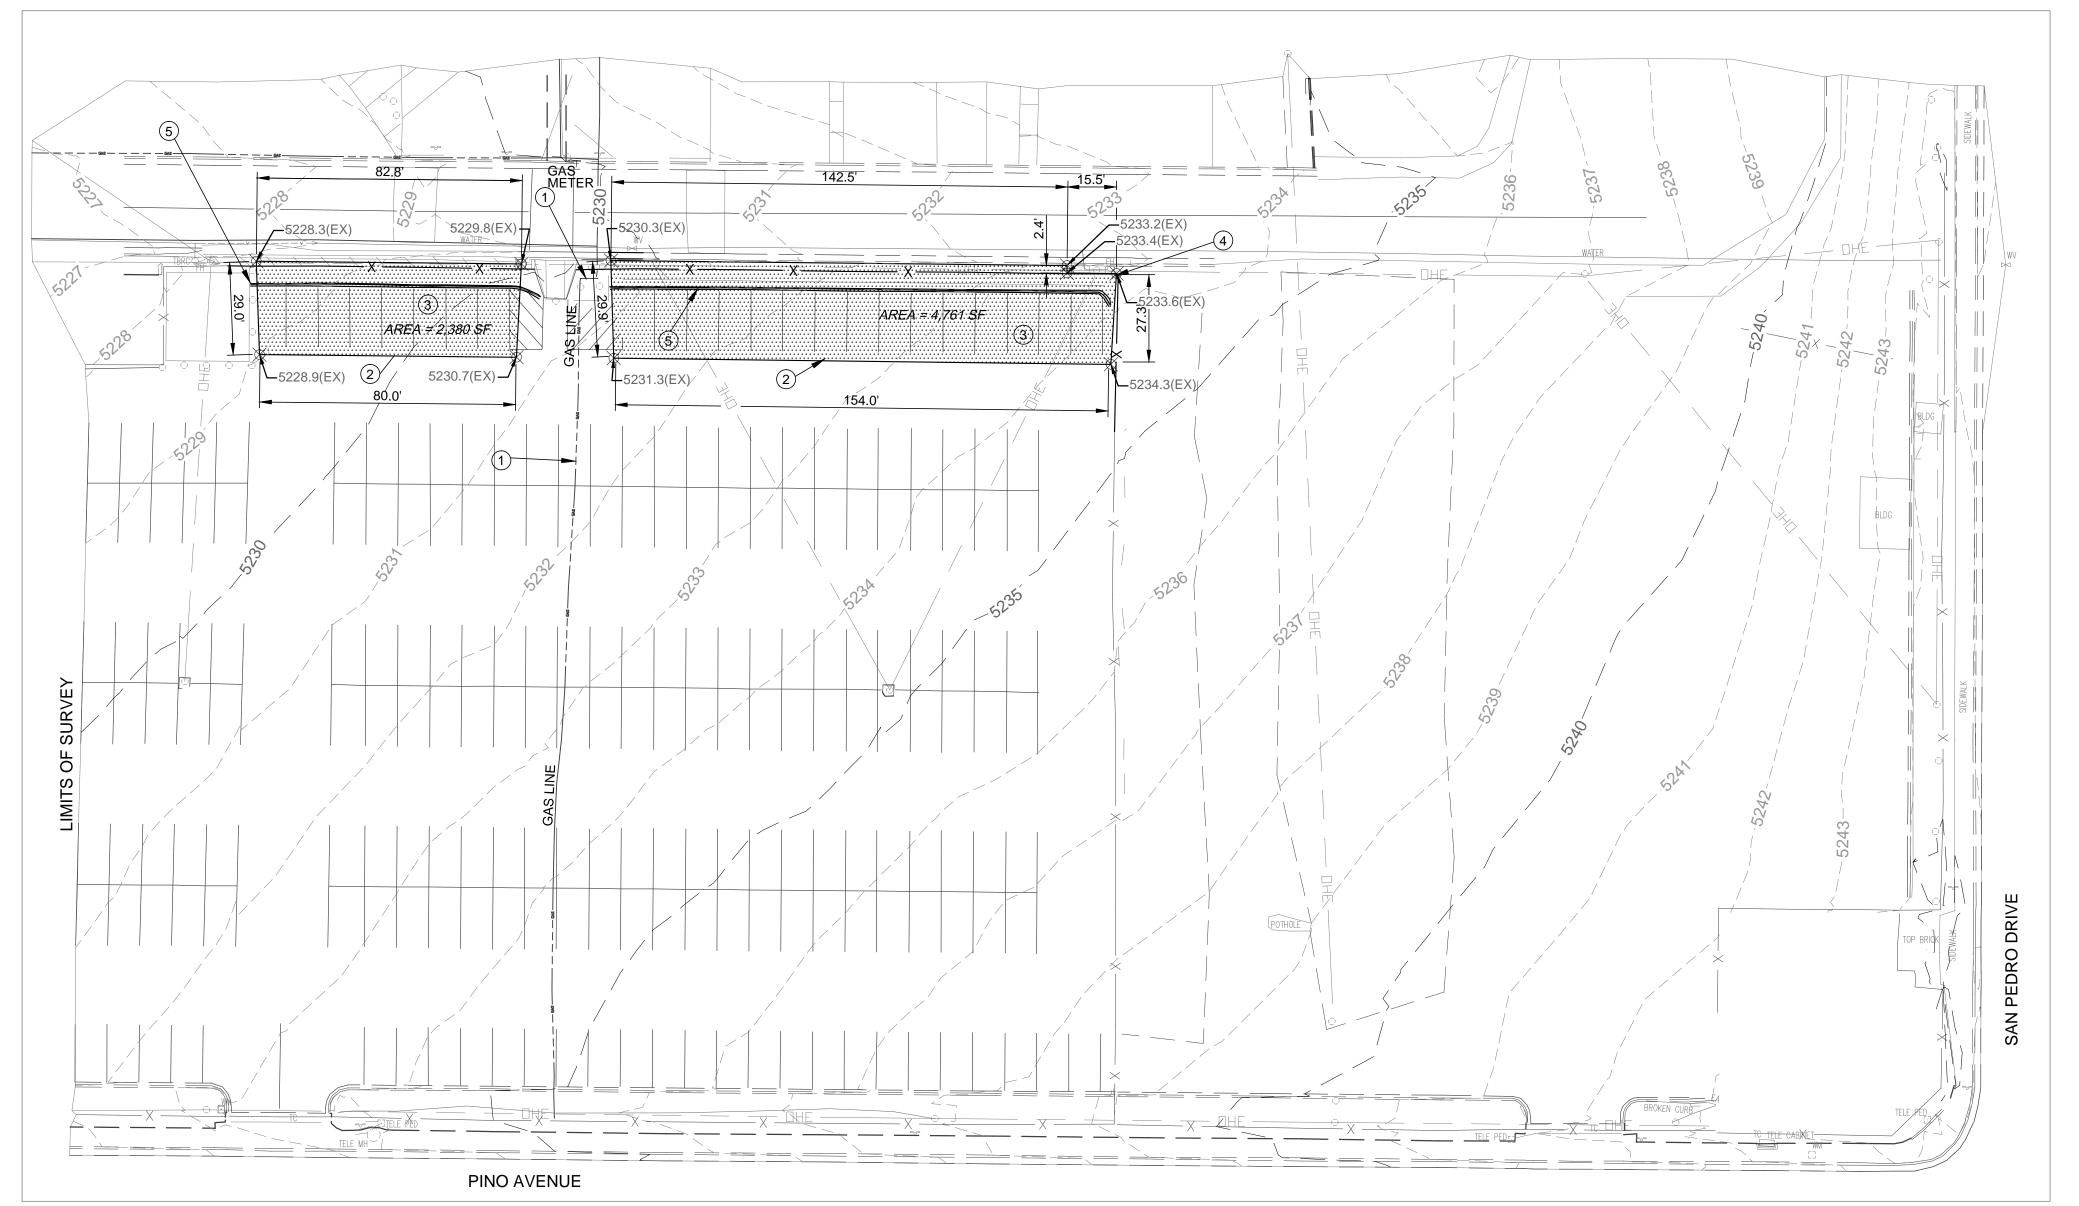

DEMOLITION PLAN

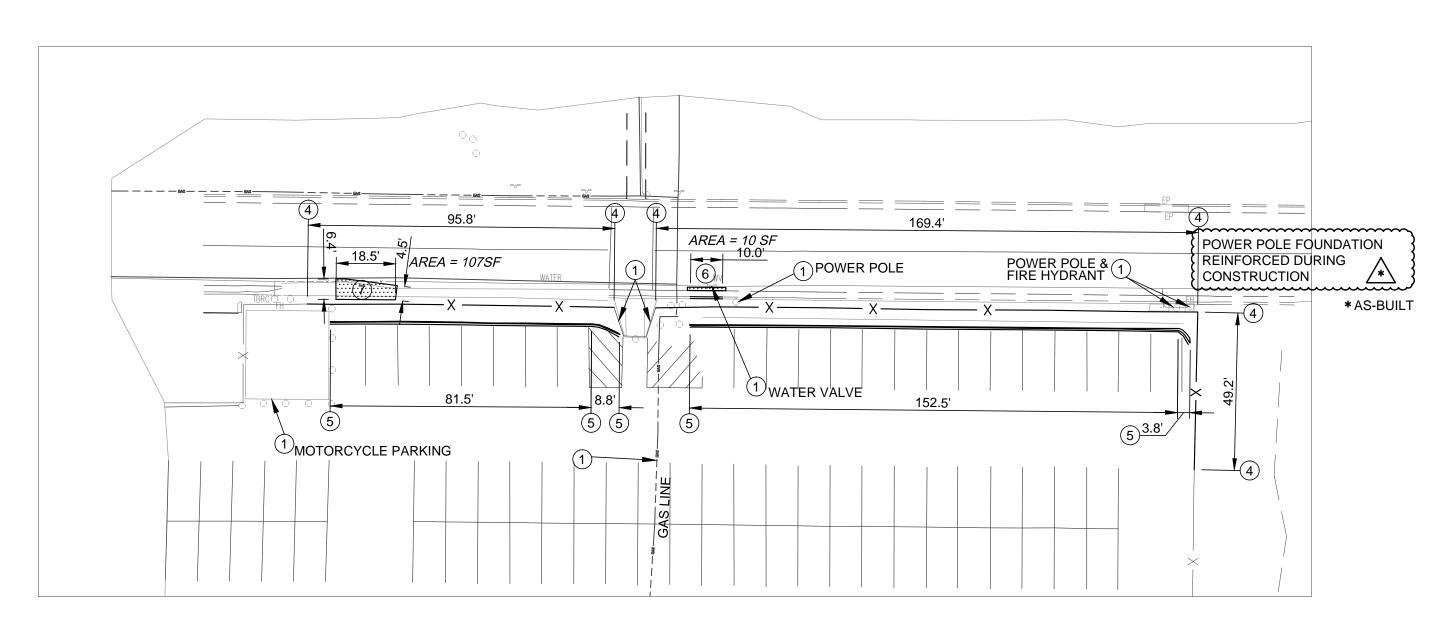

DEMOLITION PLAN -	ADDITIONAL	INFORMATION

EXISTING FEATURE LEGEND —— —— 5228— — EXISTING CONTOUR × 5228.3 (EX) EXISTING SPOT ELEVATION EXISTING FIRE HYDRANT EXISTING WATER VALVE \bowtie WV **EXISTING MANHOLE** EXISTING LIGHT EXISTING ELECTRICAL **EQUIPMENT** EXISTING OVERHEAD ______ ELECTRIC EXISTING GAS LINE EXISTING FENCE AND GATE EXISTING BOLLARD EXISTING POWER POLE EXISTING CONCRETE **CURB AND GUTTER**

EXISTING ASPHALT ROLL

CURB

ASPHALT CURB CONCRETE CURB AND GUTTER ASPHALT PARKING

ASPHALT ROLL CURB

AND ROAD

City Project No.

528002


RECORD DRAWINGS

I, <u>SCOTT A. EDDINGS</u>, REGISTERED IN NEW MEXICO AS A PROFESSIONAL ENGINEER NO. <u>12856</u>, HERBY CERTIFY THAT THIS PROJECT WAS BUILT IN SUBSTANTIAL COMPLIANCE WITH THESE PLANS.

DATE <u>DECEMBER 26</u>, 2014.

DEMOVE 5 400 OF OF EVICTING ACRUAL T		DATE	DATE	DATE 12	DATE 12	DATE 12	X C	DATE		
REMOVE 5,400 SF OF EXISTING ASPHALT PAVEMENT AND REPLACE WITH PERMEABLE PAVEMENTS (ASPHALT AND CLAY PAVERS)	MATION						INFORMATION			
LEVED NOTES	INFORMATION	ᄓ	TLC	00 00	COA	HZI				
(1) PROTECT IN PLACE EXISTING (INCIDENTAL)	BUILT I	CTOR		i's SE BY	 N	Ι Ψ)—FILM	β		
2 NEATCUT EXISTING ASPHALT PAVEMENT REMOVE AND DISPOSE EXISTING ASPHALT	AS B	CONTRACTOR	WORK STAKED BY		ELD ERIFICATION	DRAWINGS CORRECTED	MICRO	RECORDED	NO.	
REMOVE AND DISPOSE EXISTING FENCE (6'		0	1/2" W	≚₹	⊏⋝	ΩΟ		₩.	Ž	П
(4) HEIGHT W/ BARB WIRE) AND REUSE TO EXTENT POSSIBLE REMOVE AND DISPOSE EXISTING ASPHALT			TH A 5							
CURB - INCIDENTAL TO ASPHALT REMOVAL			BENEATH							
AND 1-FOOT OVERCUT			ROD SET	4".						
ROLL CURB AND 1-FOOT ROAD OVERCUT	MARKS		STEEL	_B, 1994".						
GENERAL NOTES SEE SHEET 4 FOR BENCHMARK AND			STAINLESS	D "ZAB_			1988)			
COORDINATE INFORMATION	BENCH	"ZAB_B"	uerque st	STAMPED			O (NAVD			
	8	l —	BUQUEF	COVER,	0.370	8.103	5195.90			
		FOUND MONUMEN	A CITY OF ALBUQ	NGS ACCESS COV	1540960.370	Y = 1519518.103	ELEVATION IS			
		FOUN		NGS	∥ ×	- ∀	ELEV/			Щ
	 ≥		DATE							
	SURVEY INFORMATION	S								
	INFO	FIELD NOTES	ВУ							
	IRVEY	FIELD								
	7S		_							
			9 8							
									١	
	7								4	
	S SEAL				70°2	EER .	annunun AV/OA	**************************************	9/12/14	1.12.11
	INEER'S SEAL			NE POST	NGS.	.:		Por Colonial Colonia	9/12/14	
	ENGINEER'S SEAL					(12856) EER	AN / SA	AND LOCATION AND AND AND AND AND AND AND AND AND AN	9/12/14	1.1.1.
	ENGINEER'S SEAL			A STATE OF THE STA	West of the second seco	(12856)	AN/24	AND ADECO	41/21/6	
	ENGINEER'S SEAL			E	West of the second seco	(12856)				
	ENGINEER'S SEAL		SAE	BY		(12856)				
	ENGINEER'S SEAL		SAE	BY	West State of the	(12856) :EE	JULY 21, 2014	JULY 21, 2014	#: R30-2309-01	JULY 21, 2014
HZ	ENGINEER'S SEAL				CS:	(12856) :EE			: R30-2309-01	
	ENGINEER'S SEAL		COMMENT		SI SI	(12856) :EE	JULY 21, 2014	JULY 21, 2014	#: R30-2309-01	JULY 21, 2014
0 30' 60'	ENGINEER'S SEAL			REMARKS BY SEPARATE STATES OF THE SEPARATE ST	SNOISIN		JULY 21, 2014	JULY 21, 2014	#: R30-2309-01	JULY 21, 2014
0 30' 60' SCALE: 1" = 30'	ENGINEER'S SEAL		/14 CITY COMMENT	REMARKS	REVISIONS	DESIGN : E	JULY 21, 2014	JULY 21, 2014	#: R30-2309-01	JULY 21, 2014
	ENGINEER'S SEAL		CITY COMMENT		REVISIONS		DATE: JULY 21, 2014	JULY 21, 2014	#: R30-2309-01	SAE DATE: JULY 21, 2014
SCALE: 1" = 30' Designed By: Huitt-Zollars, Inc. Albuquerque	ENGINEER'S SEAL		/24/14 CITY COMMENT	REMARKS	REVISIONS		BY: DATE: JULY 21, 2014	BY: DATE: JULY 21, 2014	PROJ #: R30-2309-01	BY: SAE DATE: JULY 21, 2014
SCALE: 1" = 30' Designed By: HUTT-ZOLARS	ENGINEER'S SEAL		/24/14 CITY COMMENT	REMARKS	REVISIONS		DATE: JULY 21, 2014	DATE: JULY 21, 2014	#: R30-2309-01	SAE DATE: JULY 21, 2014
Designed By: Huitt-Zollars, Inc. 6501 Americas Parkway, Suite 550 Albuquerque, New Mexico 87t10 Phone (505) 883-8t14 Fax (505) 883-5022 CITY OF ALBUC	QU QU	EI	2 1 9/24/14 CITY COMMENT	ON DATE REMARKS	E	DESIGN	DESIGNED BY: DATE: JULY 21, 2014	DRAWN BY: DATE: JULY 21, 2014	DWG NAME: PROJ #: R30-2309-01	CHECKED BY: SAE DATE: JULY 21, 2014
Designed By: Huitt-Zollars, Inc. 6501 Americas Parkway, Suite 550 Albuquerque, New Mexico 87t10 Phone (505) 883-8114 CITY OF ALBUC DEPARTMENT OF MUNICI TITLE:	QU	L	U S 1 9/24/14 CITY COMMENT	NO. DATE REMARKS	E /E	DESIGN	DESIGNED BY: DESIGNED BY: DESIGNED BY:	DRAWN BY: DATE: JULY 21, 2014	DWG NAME: PROJ #: R30-2309-01	CHECKED BY: SAE DATE: JULY 21, 2014
Designed By: Huitt-Zollars, Inc. 6501 Americas Parkway, Suite 550 Albuquerque, New Mexico 87110 Phone (505) 883-8114 CITY OF ALBUC DEPARTMENT OF MUNICI	QU PA	L E	C S 1 9/24/14 CITY COMMENT	NO. DATE REMARKS	E /E	DESIGN	DESIGNED BY: DESIGNED BY: DESIGNED BY:	DRAWN BY: DATE: JULY 21, 2014	DWG NAME: PROJ #: R30-2309-01	CHECKED BY: SAE DATE: JULY 21, 2014
Designed By: Huitt-Zollars, Inc. 6501 Americas Parkway, Suite 550 Albuquerque, New Mexico 87110 Phone (505) 883-8114 Fax (505) 883-5022 CITY OF ALBUCATION OF MUNICITIE: SEP PROJECT AT PINO MAIN DEMOLITION PLANT OF MUNICITION	QU PA	L E	U S 1 9/24/14 CITY COMMENT	NO. DATE REMARKS	E /E	DESIGN	DESIGNED BY: DESIGNED BY: DESIGNED BY:	DRAWN BY: DATE: JULY 21, 2014	DWG NAME: PROJ #: R30-2309-01	CHECKED BY: SAE DATE: JULY 21, 2014
Designed By: Huitt-Zollars, Inc. 6501 Americas Parkway, Suite 550 Albuquerque, New Mexico 87t10 Phone (505) 883-8t14 CITY OF ALBUC DEPARTMENT OF MUNICI TITLE: SEP PROJECT AT PINO MAIN DEMOLITION PLA	QU PA	L E	C S 1 9/24/14 CITY COMMENT	NO. DATE REMARKS	E /E	DESIGN	DESIGNED BY: DESIGNED BY: DESIGNED BY:	DRAWN BY: DATE: JULY 21, 2014	DWG NAME: PROJ #: R30-2309-01	CHECKED BY: SAE DATE: JULY 21, 2014

Zone Map No.

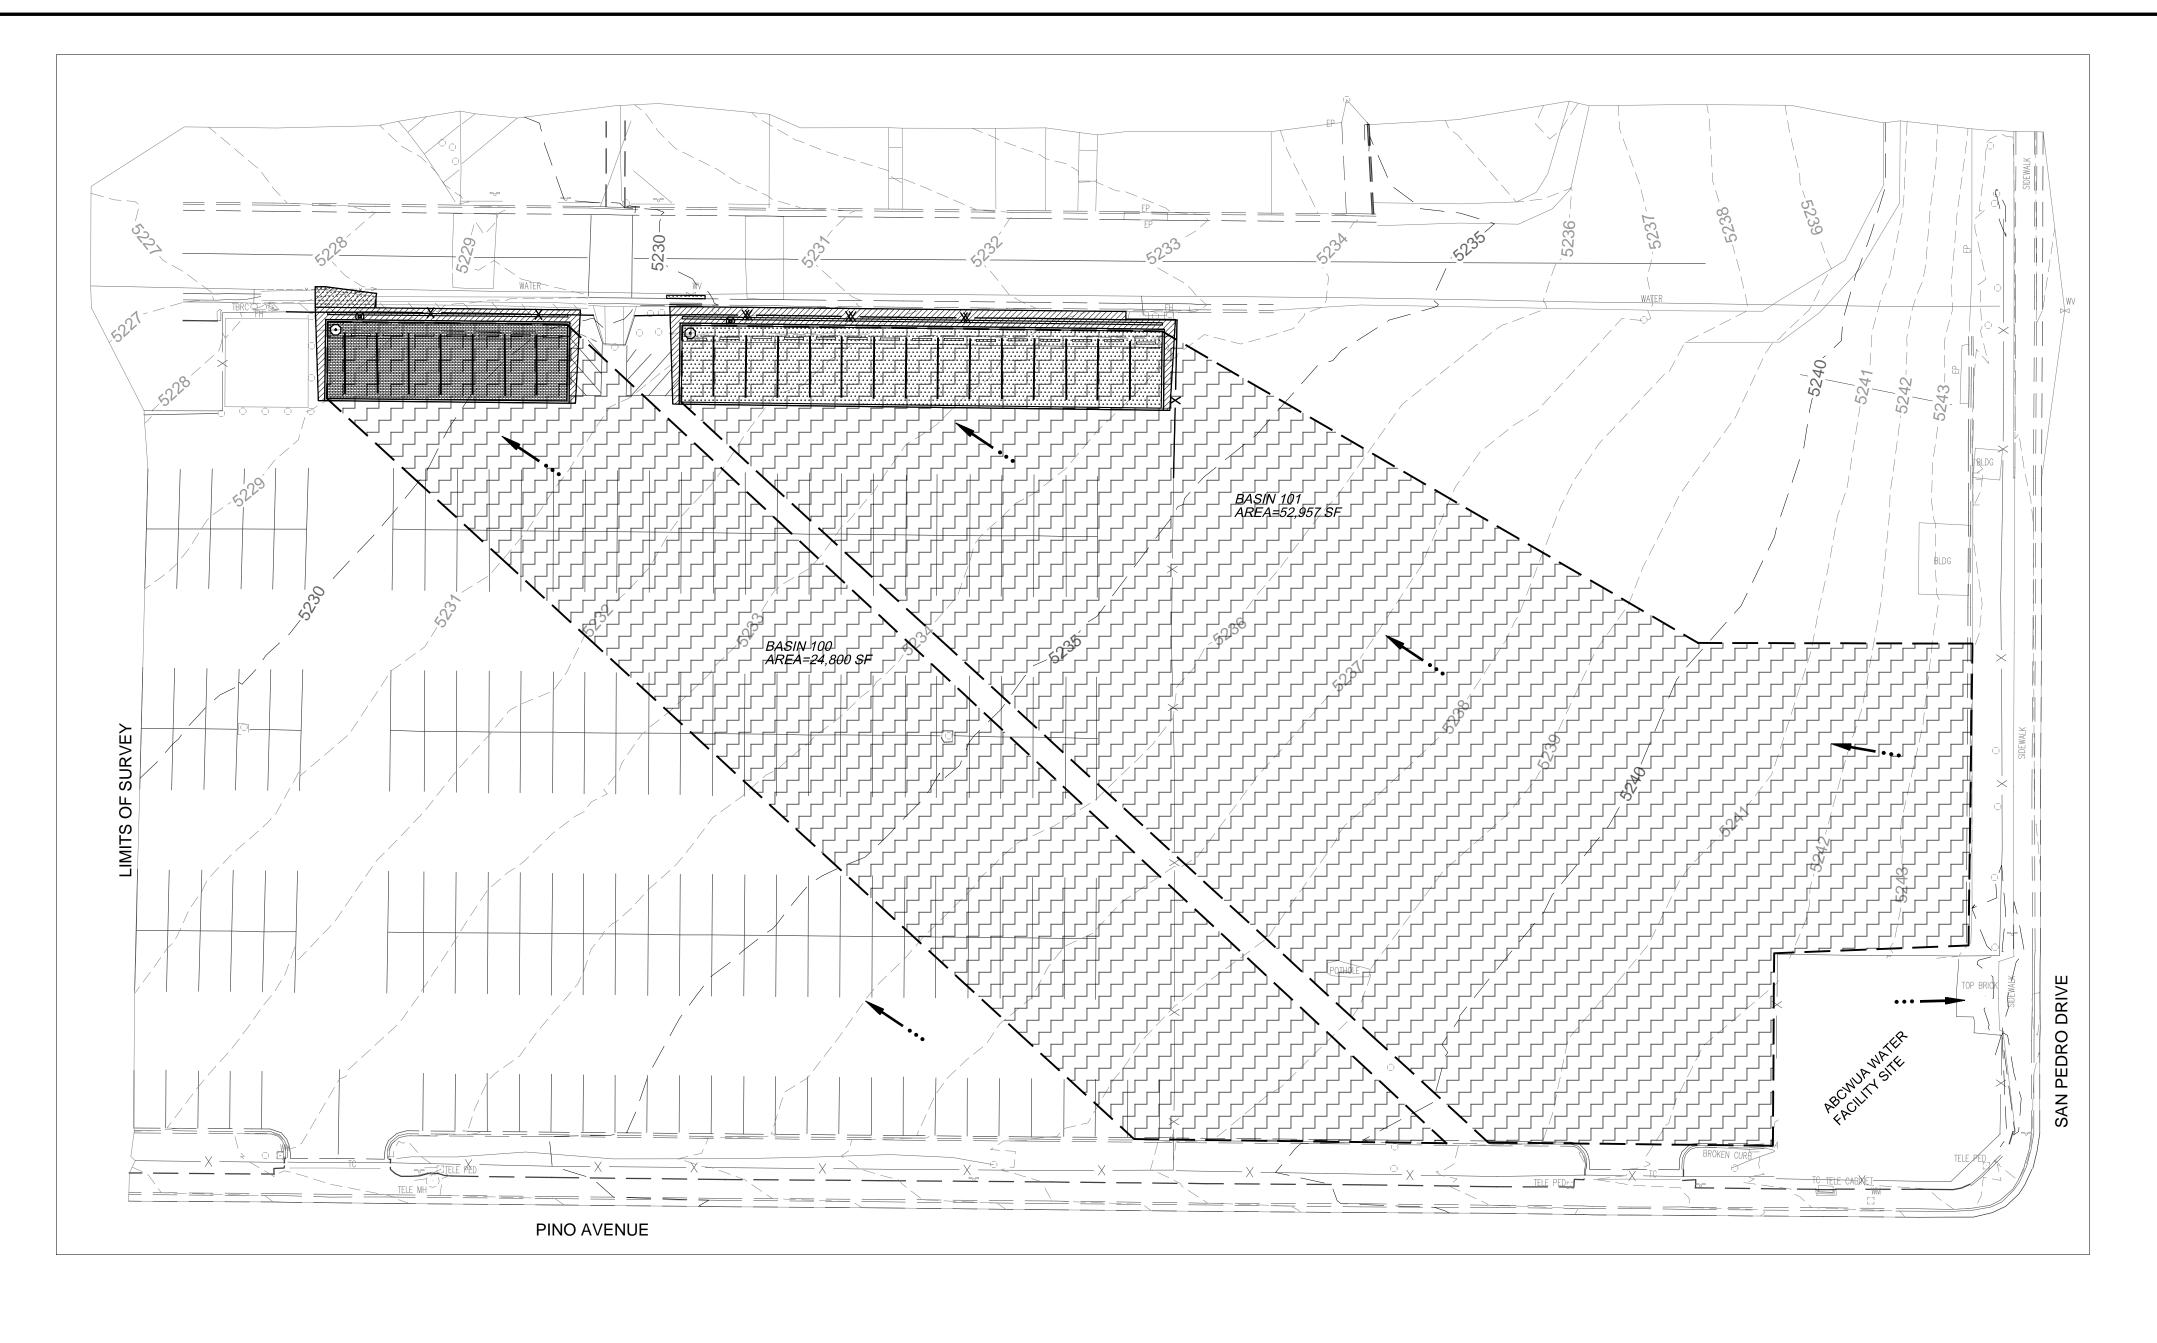

DRAINAGE MAP

GENERAL LEGEND

FLOW DIRECTION ARROW
DRAINAGE BASIN

••• ——

 DRAINAGE AREA BASIN 100
 24,800 sf

 AREA = 0.57 ac.

 FIRST FLUSH

 = 0.44 in.

 V(first flush)
 (0.44)x(0.57)/ 12.0 = 0.020875 ac-ft = 909 cf

BASIN 100

 DRAINAGE AREA BASIN 101
 52957 sf

 AREA = 1.22 ac.

 FIRST FLUSH = 0.44 in.

 V(first flush)
 (0.44)x(1.22)/ 12.0 = 0.044577 ac-ft = 1942 cf

BASIN 101


RECORD DRAWINGS


I, <u>SCOTT A. EDDINGS</u>, REGISTERED IN NEW MEXICO AS A PROFESSIONAL ENGINEER NO. <u>12856</u>, HERBY CERTIFY THAT THIS PROJECT WAS BUILT IN SUBSTANTIAL COMPLIANCE WITH THESE PLANS.

DATE <u>DECEMBER 26, 2014.</u>


EPA SEP REMOVE 5,400 S PAVEMENT AND	REPLACE WITH	PERMEABLE		NO/	DATE	DATE	DATE 12/23/14	DATE 12/23/14	DATE 12/26/14	IATION	DATE		
PAVEMENTS (AS	PHALT AND CLA	AY PAVERS)		AS BUILT INFORMATION	CONTRACTOR _{TLC}	WORK STAKED BY TLC	INSPECTOR'S ACCEPTANCE BY COA	FIELD VERIFICATION BY COA	_	MICRO-FILM INFORMATION	RECORDED BY	NO.	
				BENCH MARKS	FOUND MONUMENT "ZAB_B"	DATE A CITY OF ALBUQUERQUE STAINLESS STEEL ROD SET BENEATH A 5 1/2"	NGS ACCESS COVER, STAMPED "ZAB_B, 1994".	X = 1540960.370	Y = 1519518.103	ELEVATION IS 5195.90 (NAVD 1988)			
				SURVEY INFORMATION	FIELD NOTES	NO. BY DA							
			•	ENGINEER'S SEAL		N				AN A	And the second of the second o	4/12/14	11.7.11
Designed By:	2 0' 60' 1" = 30'	? ? \$				9/24/14 CITY COMMENT SAE	DATE REMARKS BY	REVISIONS	DESIGN) BY: DATE: JULY 21, 2014	Y: DATE: JULY 21, 2014	IE: PROJ #: R30-2309-01	BY: SAE DATE: JULY 21, 2014
Huitt-Zollars, Inc. 6501 Americas Par Albuquerque, Ner Phone (505) 883-8114 DEPARTI	W Mexico 87110 Fax (505) 883 CITY O MENT OF CT AT PII	-5022 F ALBU MUNIC	CIF	PA IT	L Ei	D	EV	E.					
Design Review Committee City Project No.	City Eng		Last Update		Mo./	'Day,	Yr.			Mo./	'Day/	Yr.	

Flowed: 12/20/2014 7.31.17 Am, By Eddings, 300tt H:\proj\R302309.01 Pino Yards\CAD\Sheets\100% SUBMITTAL\3_DRAINAGE PL

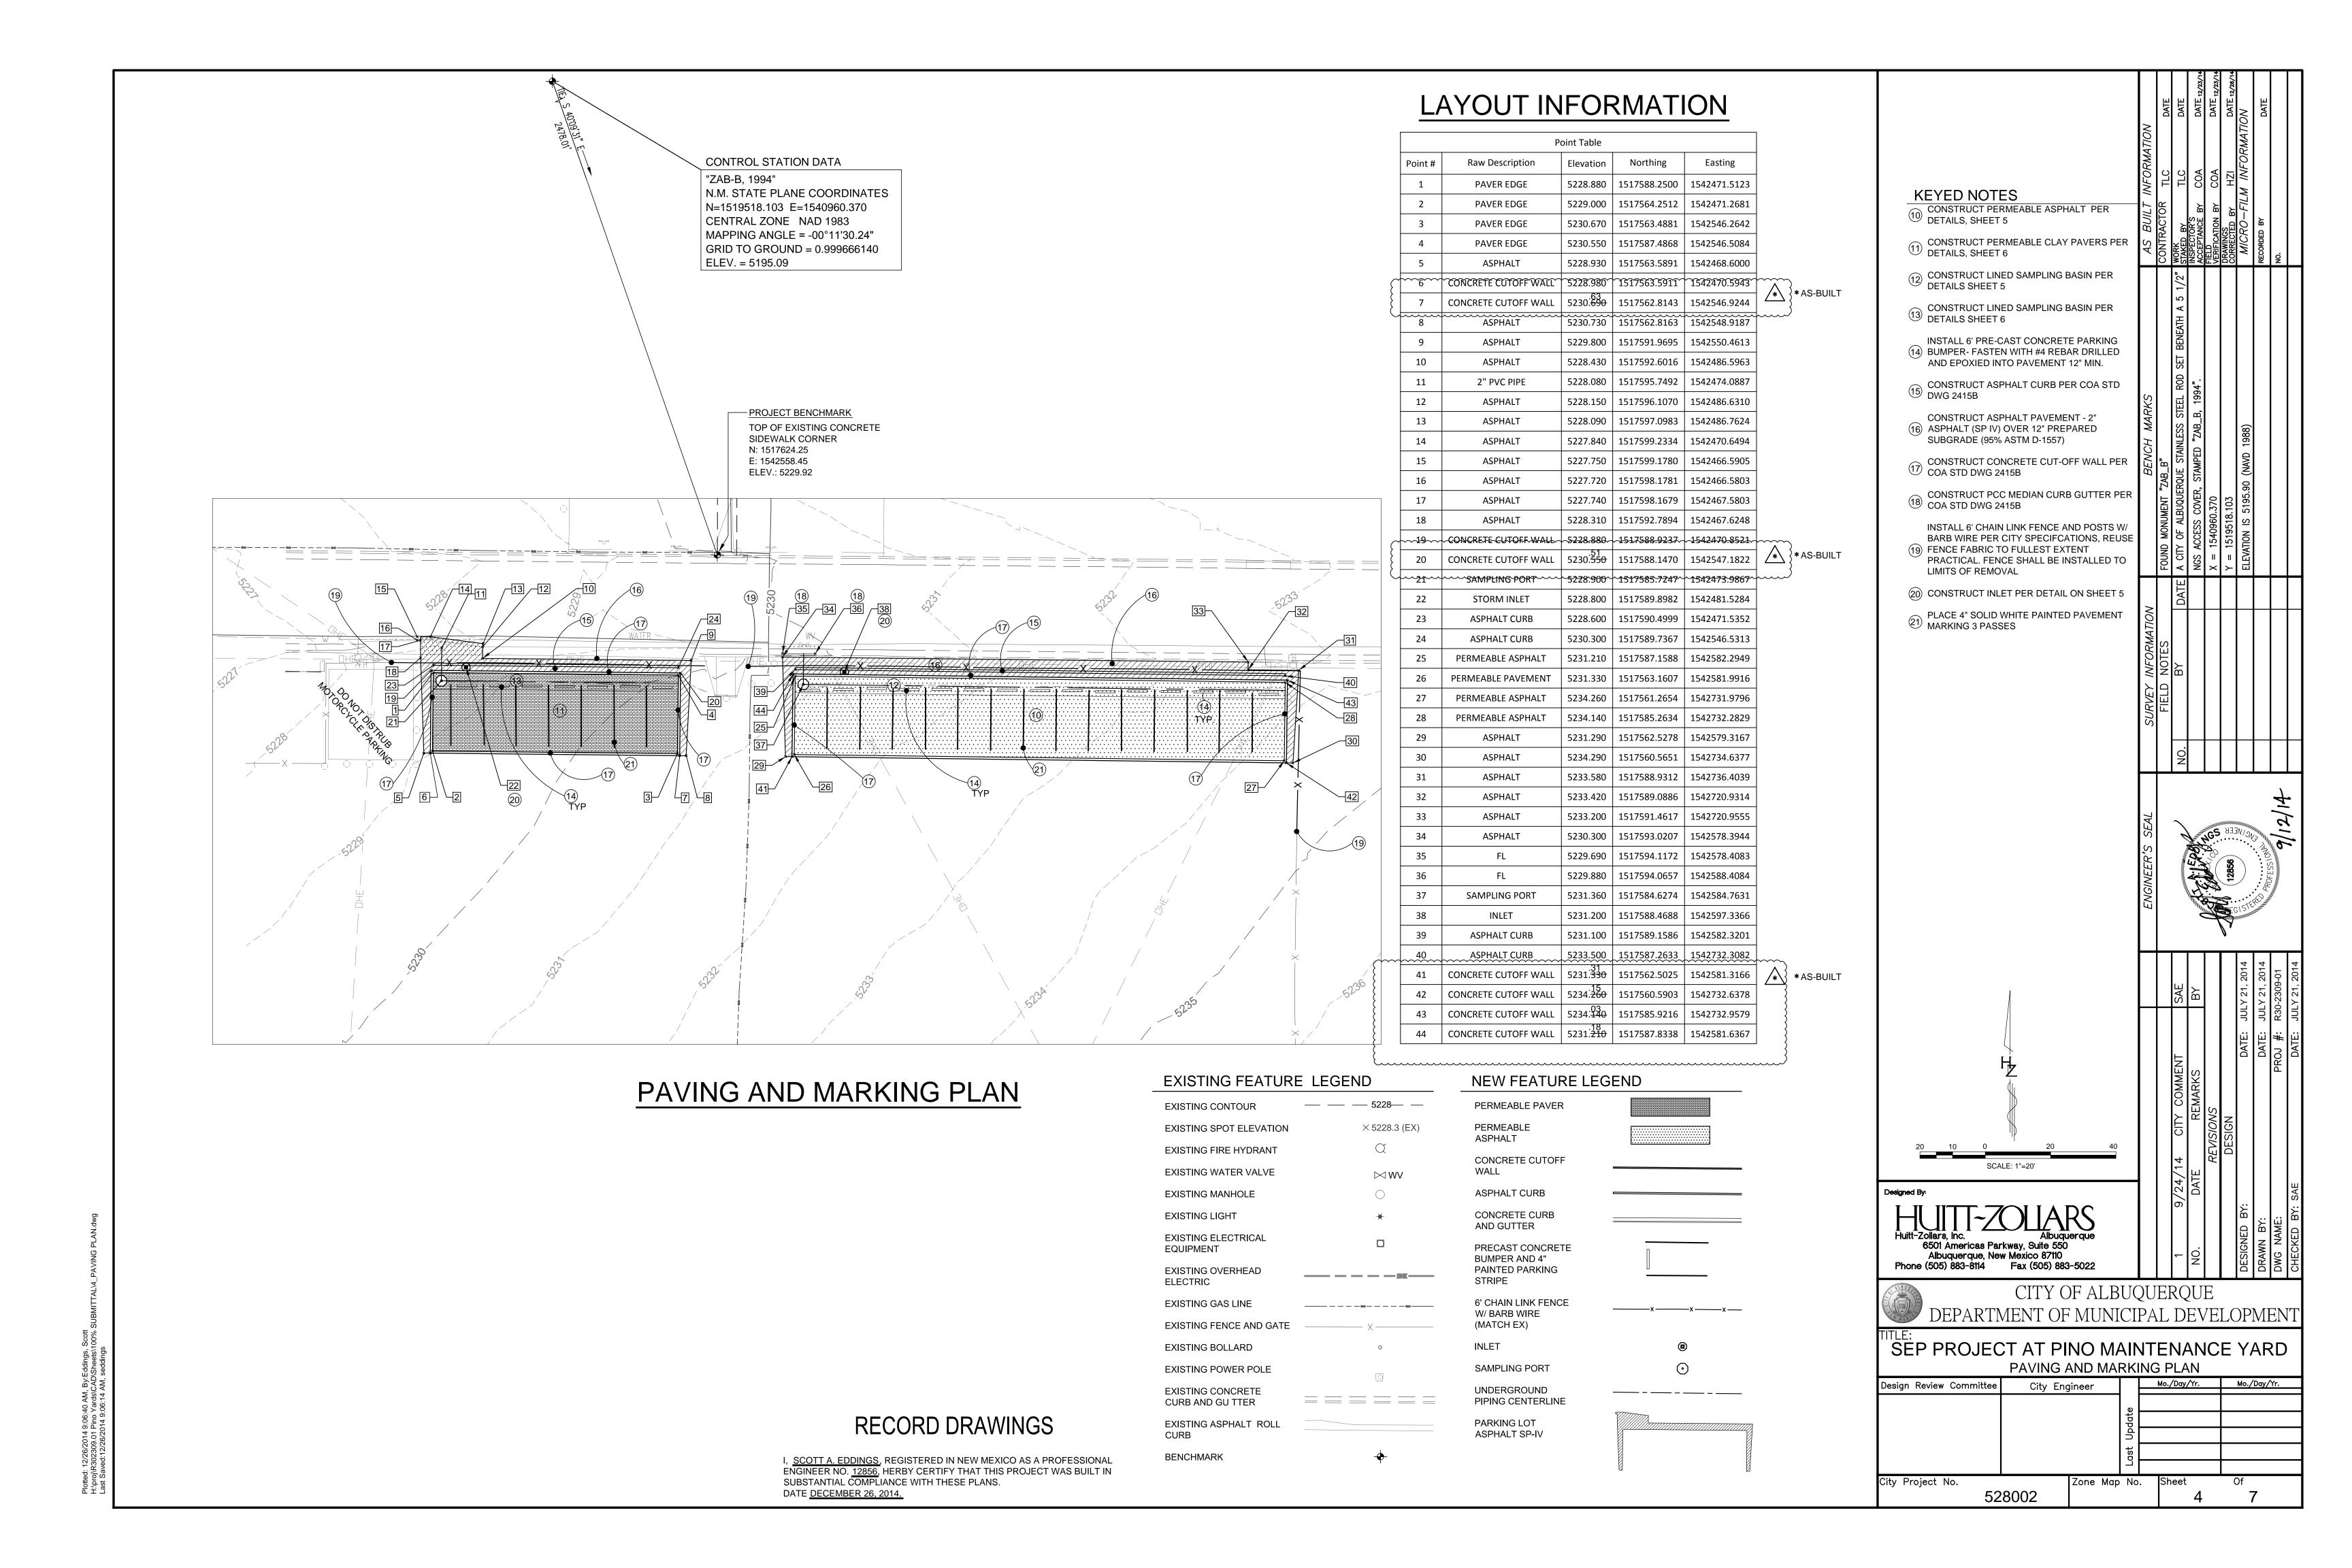

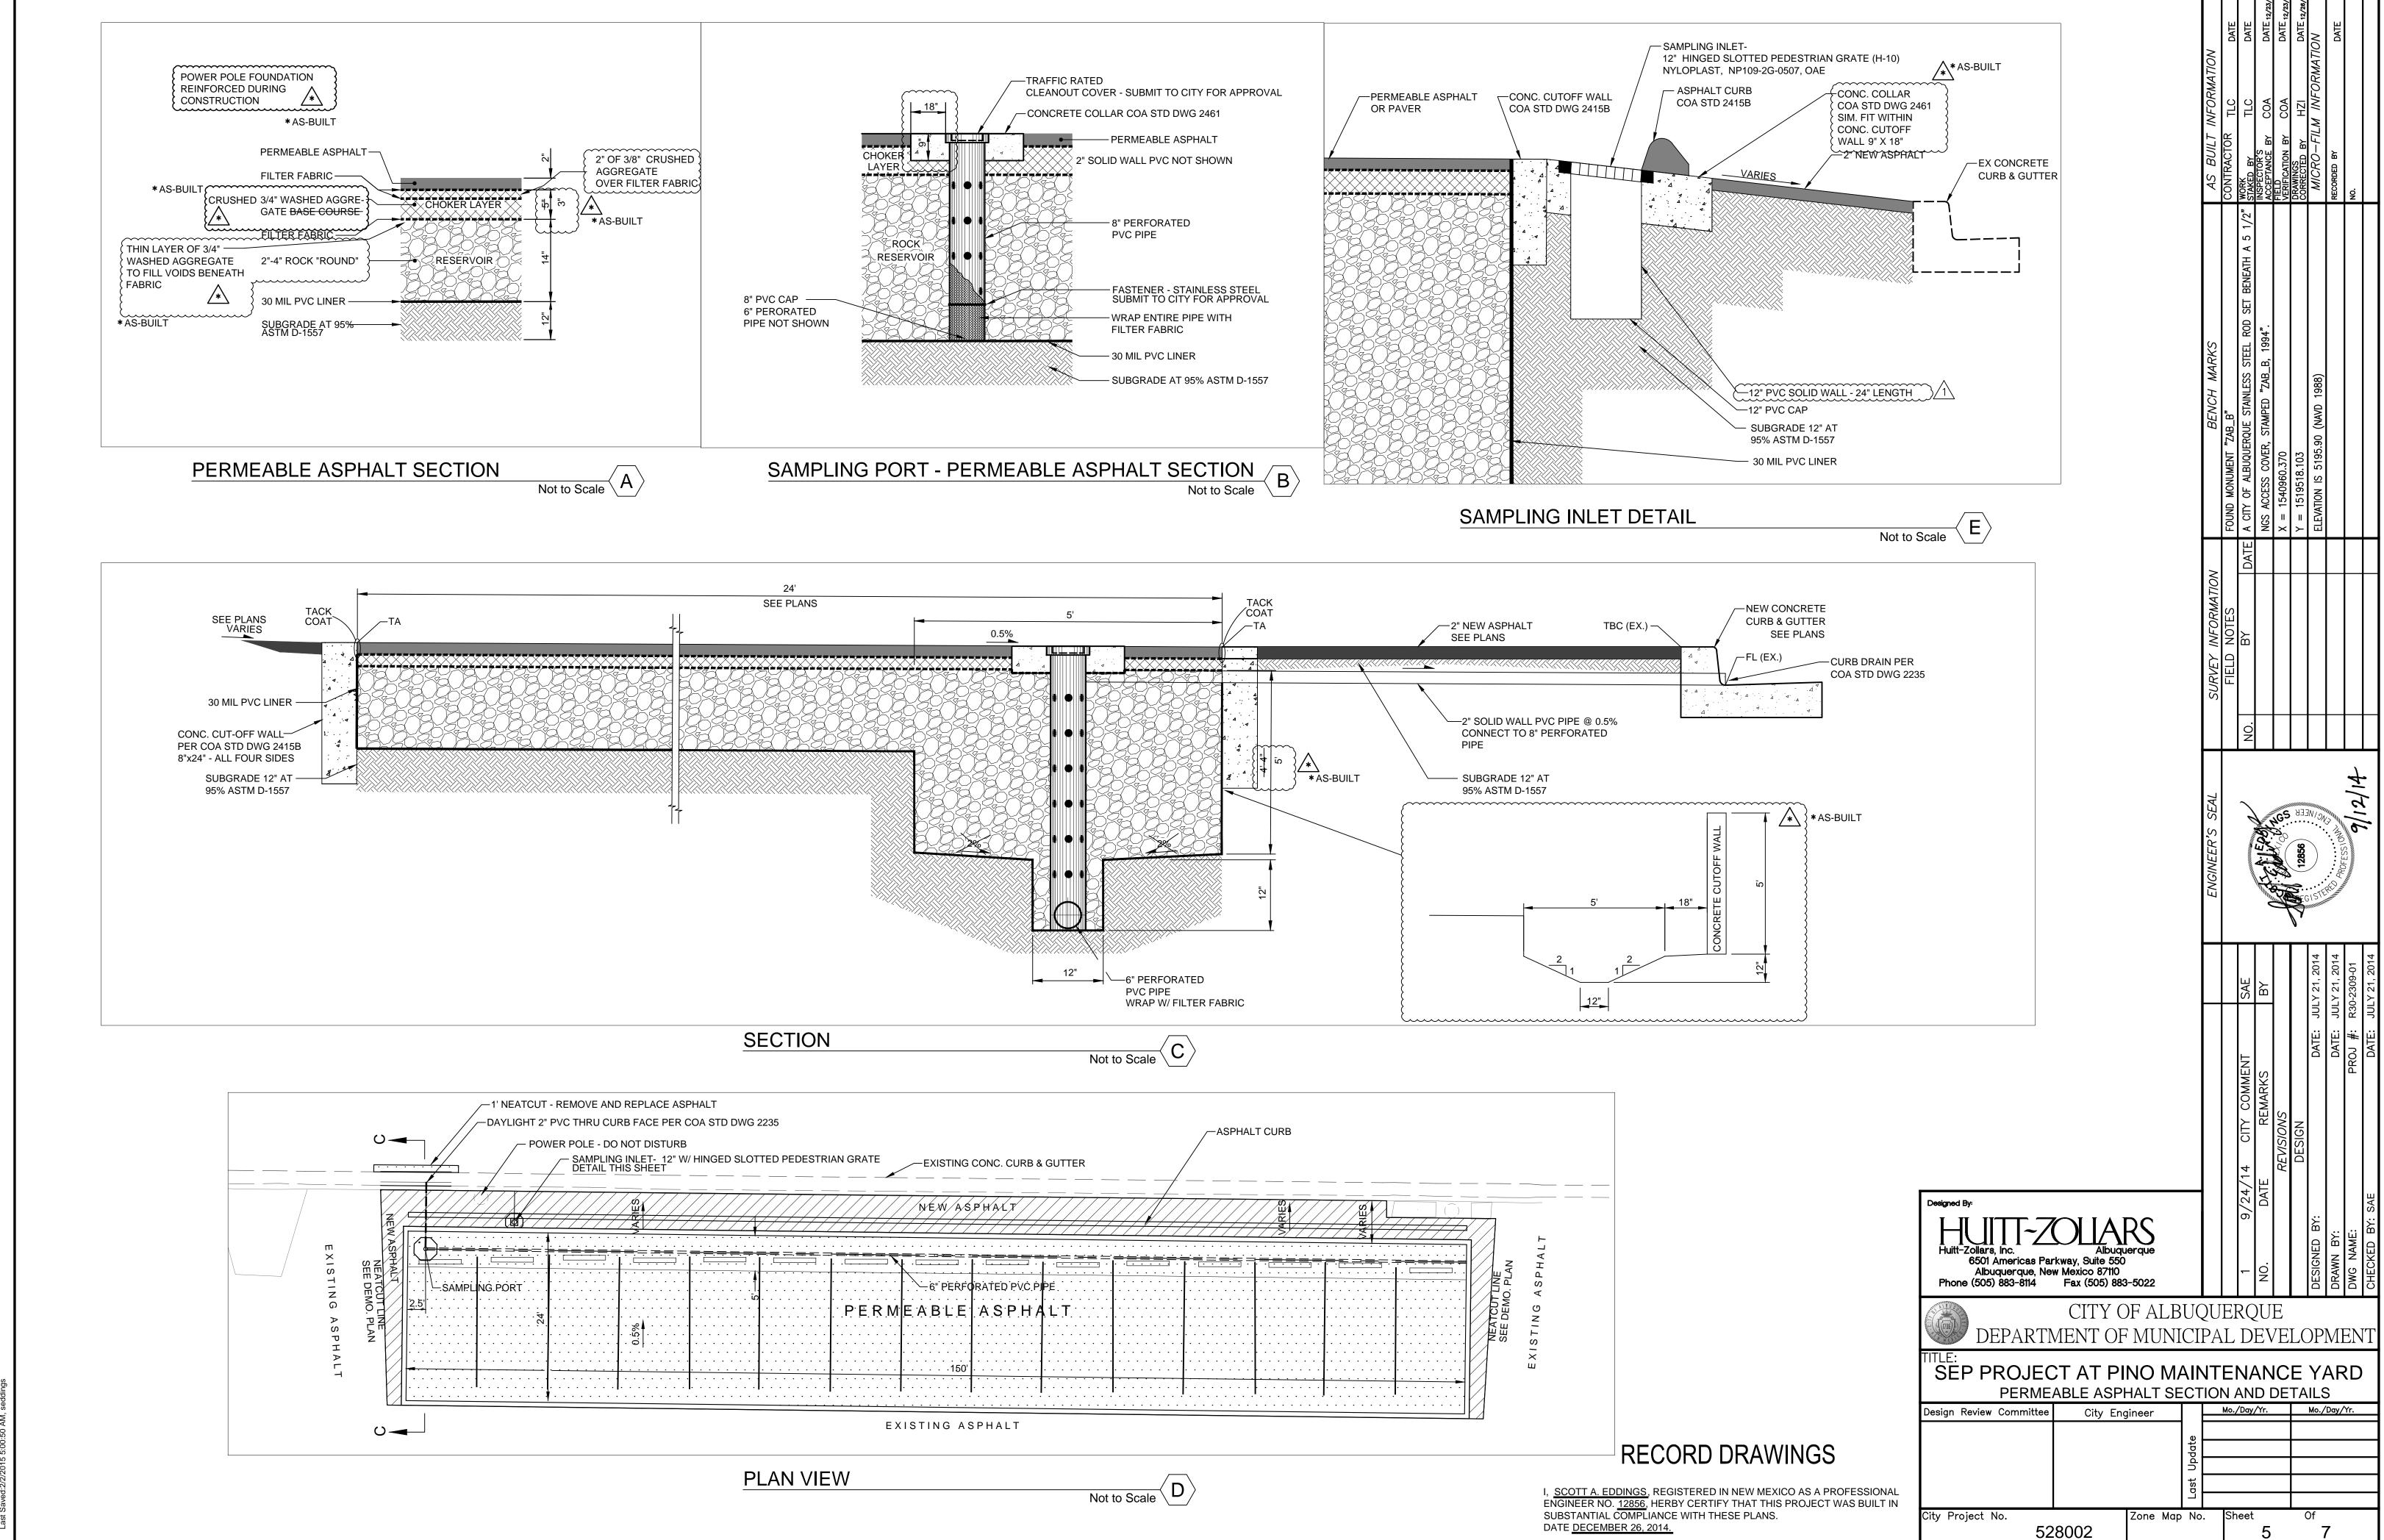

Plotted: Z/Z/Z015 5:01:24 AM/, BY:Eddings, Scott H:\proj/R302309.01 Pino Yards\CAD\Sheets\100% SUBMITTAL\5_DETAILS.

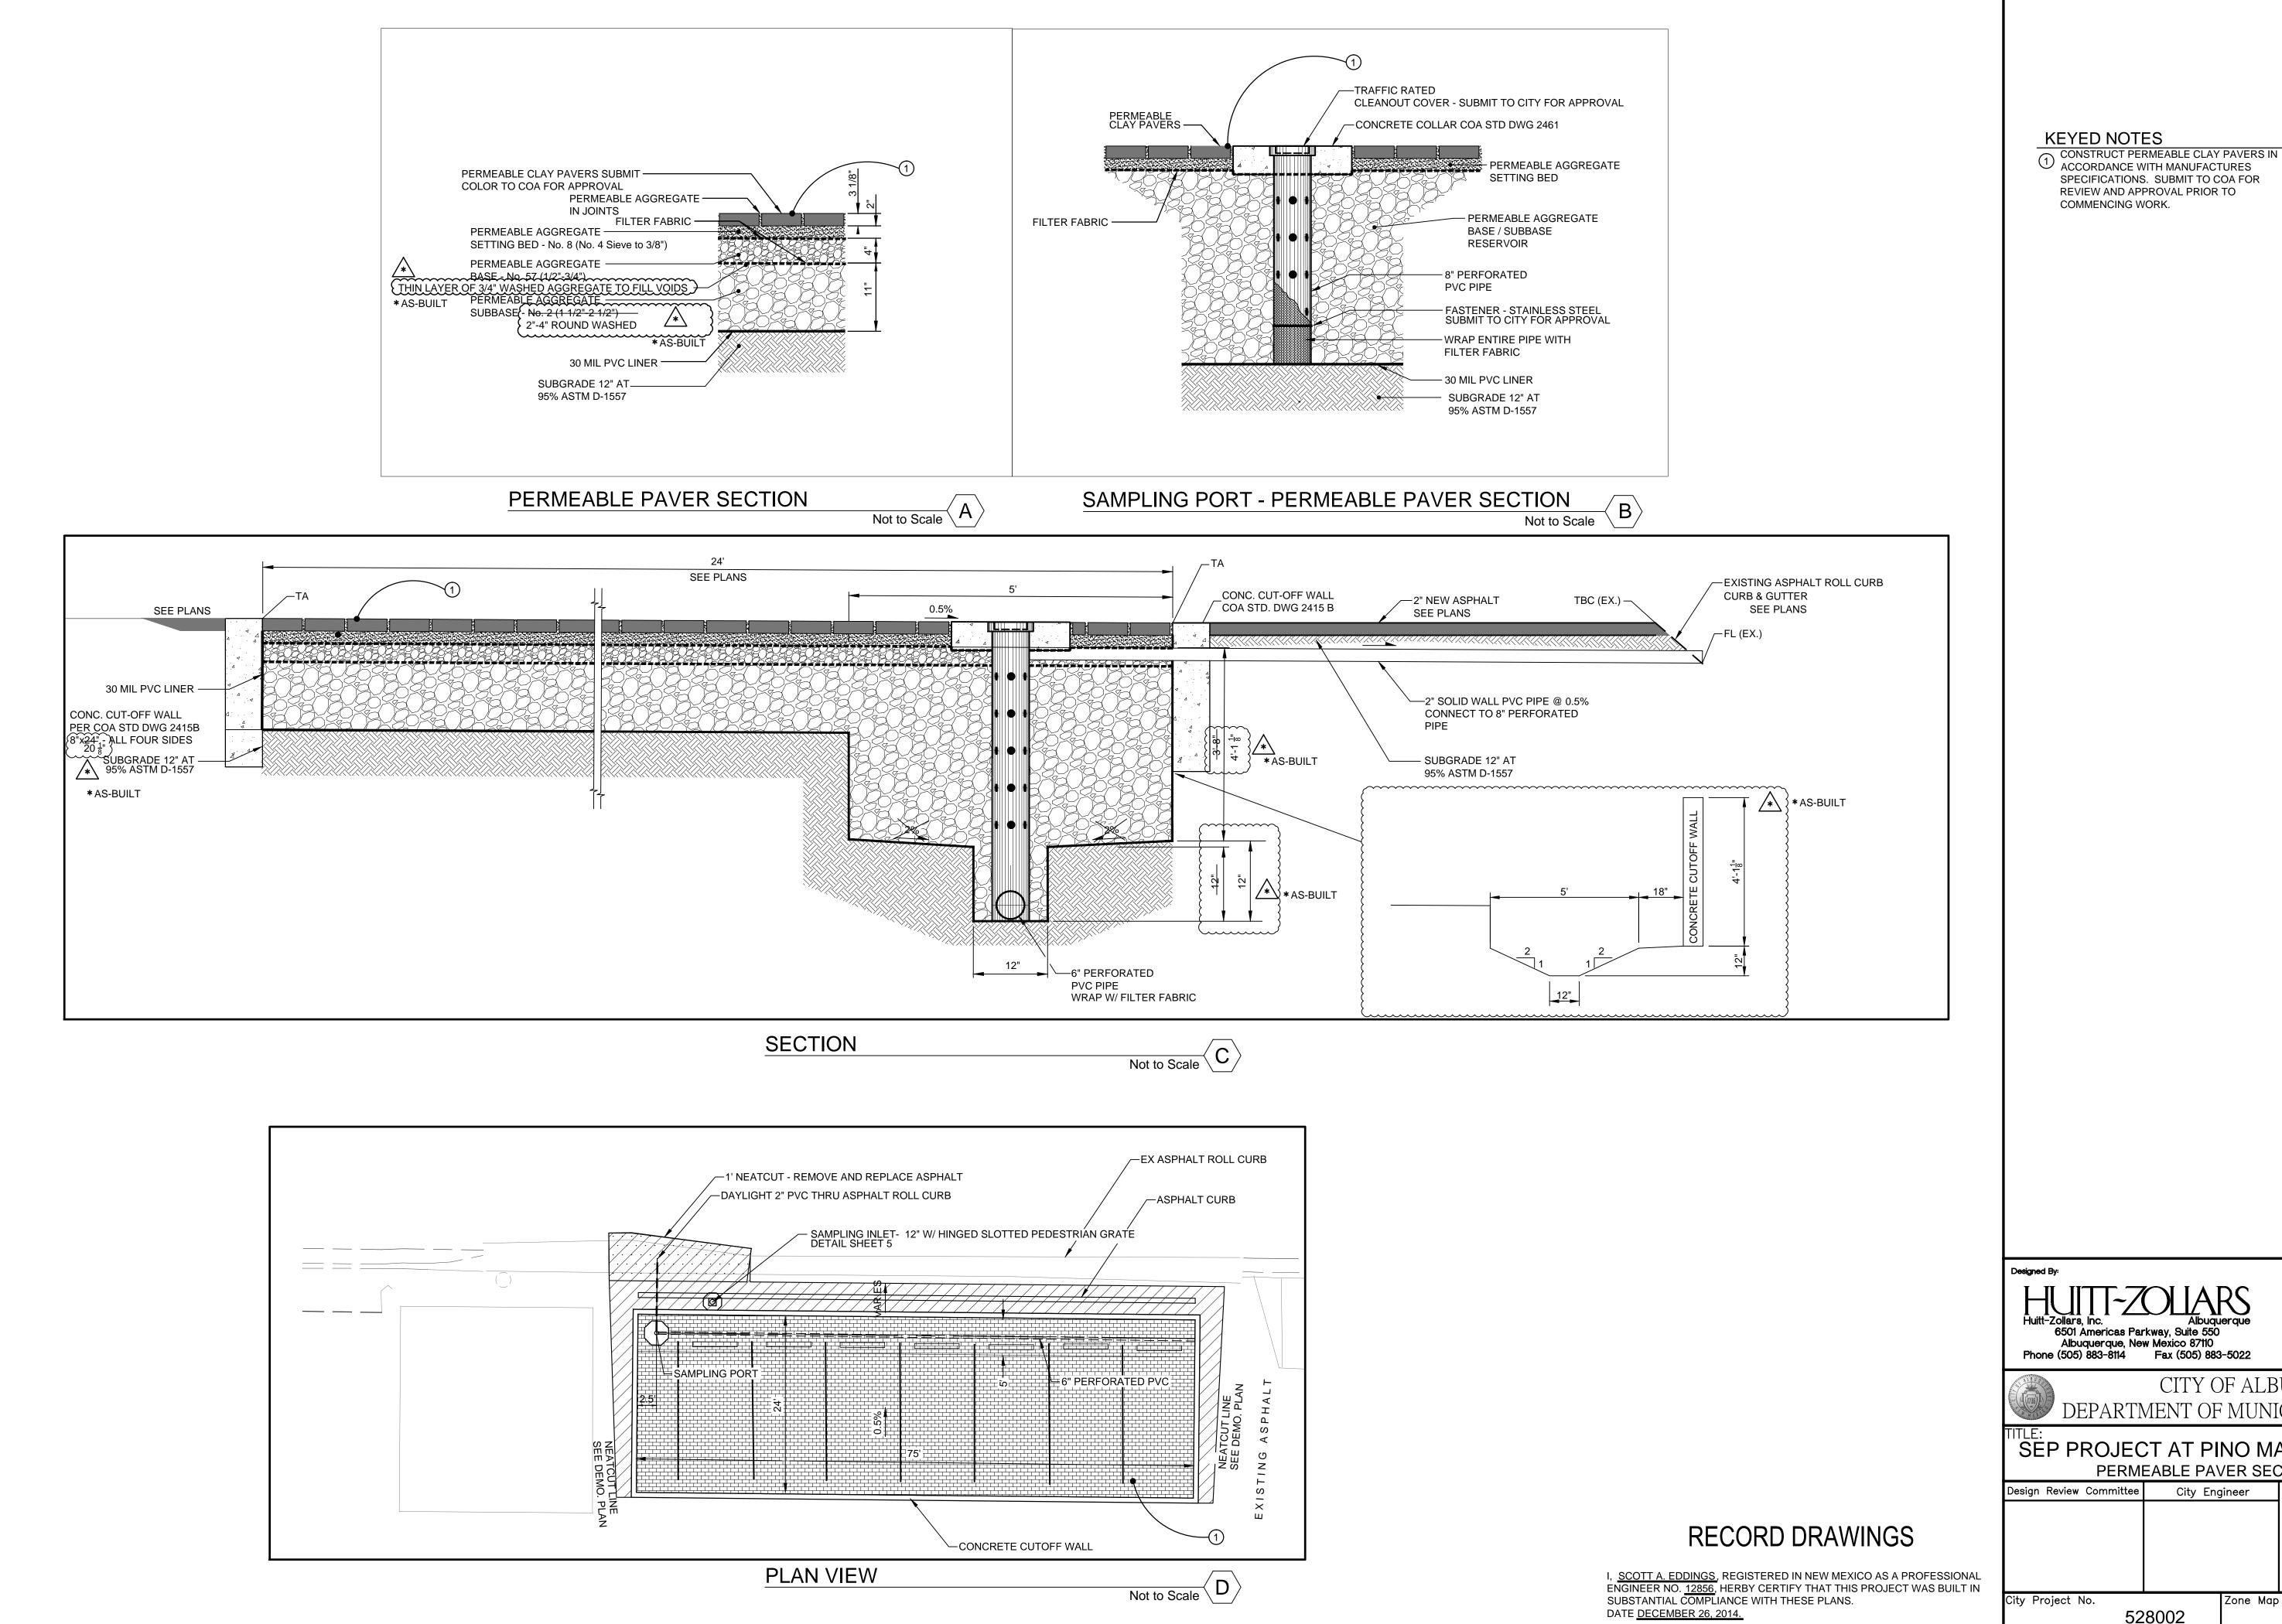

Plotted: 2/2/2015 5:08:47 AM, By:Eddings, Scott
H:\proj\R302309.01 Pino Yards\CAD\Sheets\100% SUBMITTAL\6_DETAILS.dwg

Designed By:

Huitt-Zollars, Inc.
6501 Americas Parkway, Suite 57100
Phone (505) 883-8114

Fax (505) 883-5022

CITY OF ALBUQUERQUE
DEPARTMENT OF MUNICIPAL DEVELOPMENT

TITLE:
SEP PROJECT AT PINO MAINTENANCE YARD
PERMEABLE PAVER SECTION AND DETAILS

Design Review Committee

City Engineer

Total Project No.

City Project No.

Sheet

Total Project No.

Zone Map No.

Sheet

Total Project No.

Sheet

Total Project No.

Total Project

WORK ZONE EXHIBIT

LEGEND

WORK ZONE

•

ORANGE BARREL



PEDESTRIAN ACCESS ROUTE



PERMEABLE PAVEMENT

PROJECT WAS COMPLETED WITHIN ONE WORK ZONE AND ONE PHASE

FOR INFORMATION ONLY

RECORD DRAWINGS

I, SCOTT A. EDDINGS, REGISTERED IN NEW MEXICO AS A PROFESSIONAL ENGINEER NO. 12856, HERBY CERTIFY THAT THIS PROJECT WAS BUILT IN SUBSTANTIAL COMPLIANCE WITH THESE PLANS.

DATE DECEMBER 26, 2014

		AS BUILT INFORMATION	CONTRACTOR DATE		INSPECTOR'S ACCEPTANCE BY DATE	FIELD BY DATE	DRAWINGS CORRECTED BY DATE	MICRO-FILM INFORMATION	RECORDED BY DATE	NO.	
		BENCH MARKS	XXXXXX	XXXXX	XXXXXX	NORTHING = XXXXXXXX	EASTING = XXXXXXXX	ELEVATION IS XXXXXXX (NAVD 1988)			
		SURVEY INFORMATION	FIELD NOTES	NO. BY DATE							
		ENGINEER'S SEAL			1 × 600;	NO CONTRACTOR OF THE POST OF T	95921 REC	ON 1	CONTRACTOR OF THE PARTY OF THE	0.537	
SCALE: 1" = 50"					REMARKS BY	REVISIONS	DESIGN	DATE: JULY 21, 2014	DATE: JULY 21, 2014	PROJ #: R30-2309-01	DATE: JULY 21, 2014
Huitt-Zollars, Inc. 6501 Americas Parkway, Suite 550 Albuquerque, New Mexico 87110 Phone (505) 883-8114 Fax (505) 883-5022		\1 I			NO. DATE			DESIGNED BY:	DRAWN BY:	DWG NAME:	CHECKED BY: SAE
CITY OF ALI DEPARTMENT OF MUN PPROJECT AT PINO M WORK ZONE E Review Committee City Engineer	IAIX IHXE Indoore	PA NT	L E		EV AN		Έ	Y		RD	
Project No. Zone Mo	Lost	•	Sh	eet			(Of			

Potect. —, Dy. Louings, 200tt H.yproj/R302309.01 Pino Yands/CAD\Sheets\60% SUBMITTAL\2309-2SHEETBASE_CC 1 ast Sayord-8/6/2014 3-00-15 PM seddings