

PUBLIC IMPROVEMENT PLANS

FOR

DISNEY PLACE N.E.

NOR ESTE MANOR

ALBUQUERQUE, NEW MEXICO

MAY 1997

PREPARED FOR:
THE GARRETT GROUP
P.O. BOX 10285
ALBUQUERQUE, NM 87184-0285

PREPARED BY:
ISAACSON & ARFMAN, P.A.
128 MONROE ST. NE
ALBUQUERQUE, NM 87108
(505) 268-8828


INDEX TO DRAWINGS

SHEET NO.	TITLE
1	COVER SHEET
2	PRELIMINARY PLAT
3	GRADING AND DRAINAGE PLAN
4	DISNEY PLACE PAVING PLAN
5	DISNEY PLACE UTILITY PLAN
5A	HELEN HARDIN UTILITY PLAN

SURVEYOR'S CERTIFICATION

"I, Timothy Aldrich, a duly qualified Registered Professional Land Surveyor under the laws of the State of New Mexico, do hereby certify that the 'as-built' information shown on these drawings was obtained from field construction and 'as-built' surveys performed by me or under my supervision, that the 'as-built' information shown on these drawings was added by me or under my supervision, and that this 'as-built' information is true and correct to the best of my knowledge and belief." Aldrich Land Surveying is not responsible for any of the design concepts, calculations, engineering, or interpretation of the record drawings."

Timothy Aldrich, P.S. No. 7719
 Date: **02-03-98**

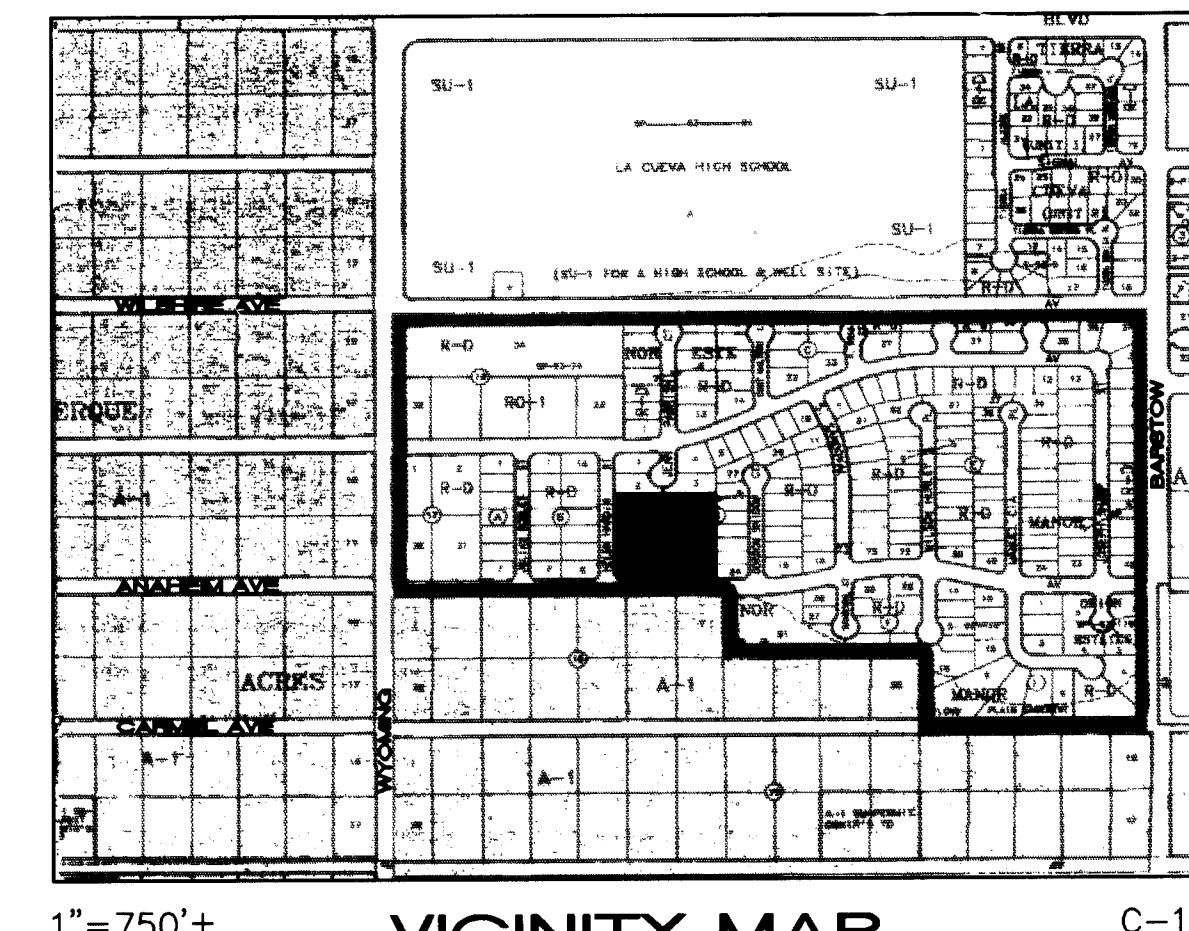


GENERAL NOTES

1. All work detailed on these plans to be performed under contract shall, except as otherwise stated or provided for hereon, be constructed in accordance with the City of Albuquerque Standard Specifications for Public Works Construction 1986 Edition as amended with Update No. 6.
2. All work on this project shall be performed in accordance with applicable federal, state, and local laws, rules, and regulations concerning construction safety and health.
3. Prior to construction, the Contractor shall excavate & verify the horizontal and vertical locations of all obstructions. Should a conflict exist, the Contractor shall notify the Engineer so that the conflict can be resolved with minimum delay.
4. Two (2) working days prior to any excavation, Contractor must contact Line Locating Service @ 260-1990 for location of existing utilities.
5. Contractor shall conduct his operations in a manner which will minimize interference with local traffic. Contractor shall comply with all applicable laws, ordinances, rules, regulations, and orders of any public body having jurisdiction for the safety of persons or property, and to protect them from damage, injury, or loss. Contractor shall erect and maintain, as required by the conditions and progress of the work, all necessary safeguards for safety continuously and not limited to normal working hours, throughout the duration of the project. Contractor shall adhere to Section 19 of the General Conditions of the City of Albuquerque Standard Specifications for Public Works Construction, 1986, as amended with Update No. 6.
6. The Contractor agrees that he shall assume the sole and complete responsibility for the job site conditions during the course of construction of this project, including safety of all persons and property, that this requirement shall apply continuously and not be limited to normal working hours; and that the Contractor shall defend, indemnify, and hold harmless the Owner & Engineer from any and all liability real or alleged, in connection with the performance of work on this project, excepting liability arising from the sole negligence of the Owner or Engineer.
7. TRAFFIC CONTROL: Three (3) working days prior to beginning construction the Contractor shall submit to the Construction Coordination Division a detailed construction schedule. Two (2) working days prior to construction, the Contractor shall obtain a barricading permit from the Construction Coordination Division. Contractor shall notify Barricade Engineer (768-2551) prior to occupying an intersection. See section 19 of the specifications. All street striping altered or destroyed shall be replaced with plastic reflectorized pavement markings by Contractor to location as existing or as shown in this plan set at no additional cost to the Owner.
8. When abutting existing pavement to new, sawcut existing pavement to a straight edge and at a right angle, or as approved by the field Engineer. Removal of broken or cracked pavement will also be required.
9. Existing curb and gutter not to be removed under the contract which is damaged or displaced by the Contractor shall be removed and replaced by the Contractor at his expense.
21. The Contractor shall assume responsibility for any damage to existing pavement, pavement markings, C & G, driveways, wheelchair ramps & sidewalks during construction apart from those sections indicated for removal on plans & shall repair or replace per COA std at his own expense.


DRB NO. 96-250

REV.	Sheets	CITY ENGINEER	DATE	USER DEPARTMENT	DATE	USER DEPARTMENT	DATE
ENGINEERS STAMP & SIGNATURE APPROVALS ENGINEER DATE *****							
DRC Chairman	<i>Billy J. Hembly</i>	6-3-97					
Transportation	<i>R. W. Kline</i>	6-3-97					
Water/Wastewater	<i>R. W. Kline</i>	6-3-97					
Hydrology	<i>John Calzona</i>	6-3-97					
CIP							
Constr. Mngmt.	<i>Dave Lates</i>	6-3-97					
APPROVED FOR CONSTRUCTION							
<i>City Engineer</i> 11/15/97 Date							
City Project No.				Sheet 1 Of 5			

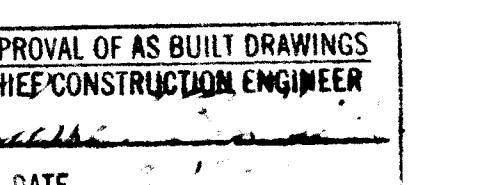

ISAACSON & ARFMAN, P.A.
 Consulting Engineering Associates
 128 Monroe Street N.E.
 Albuquerque, New Mexico
 5/20/97



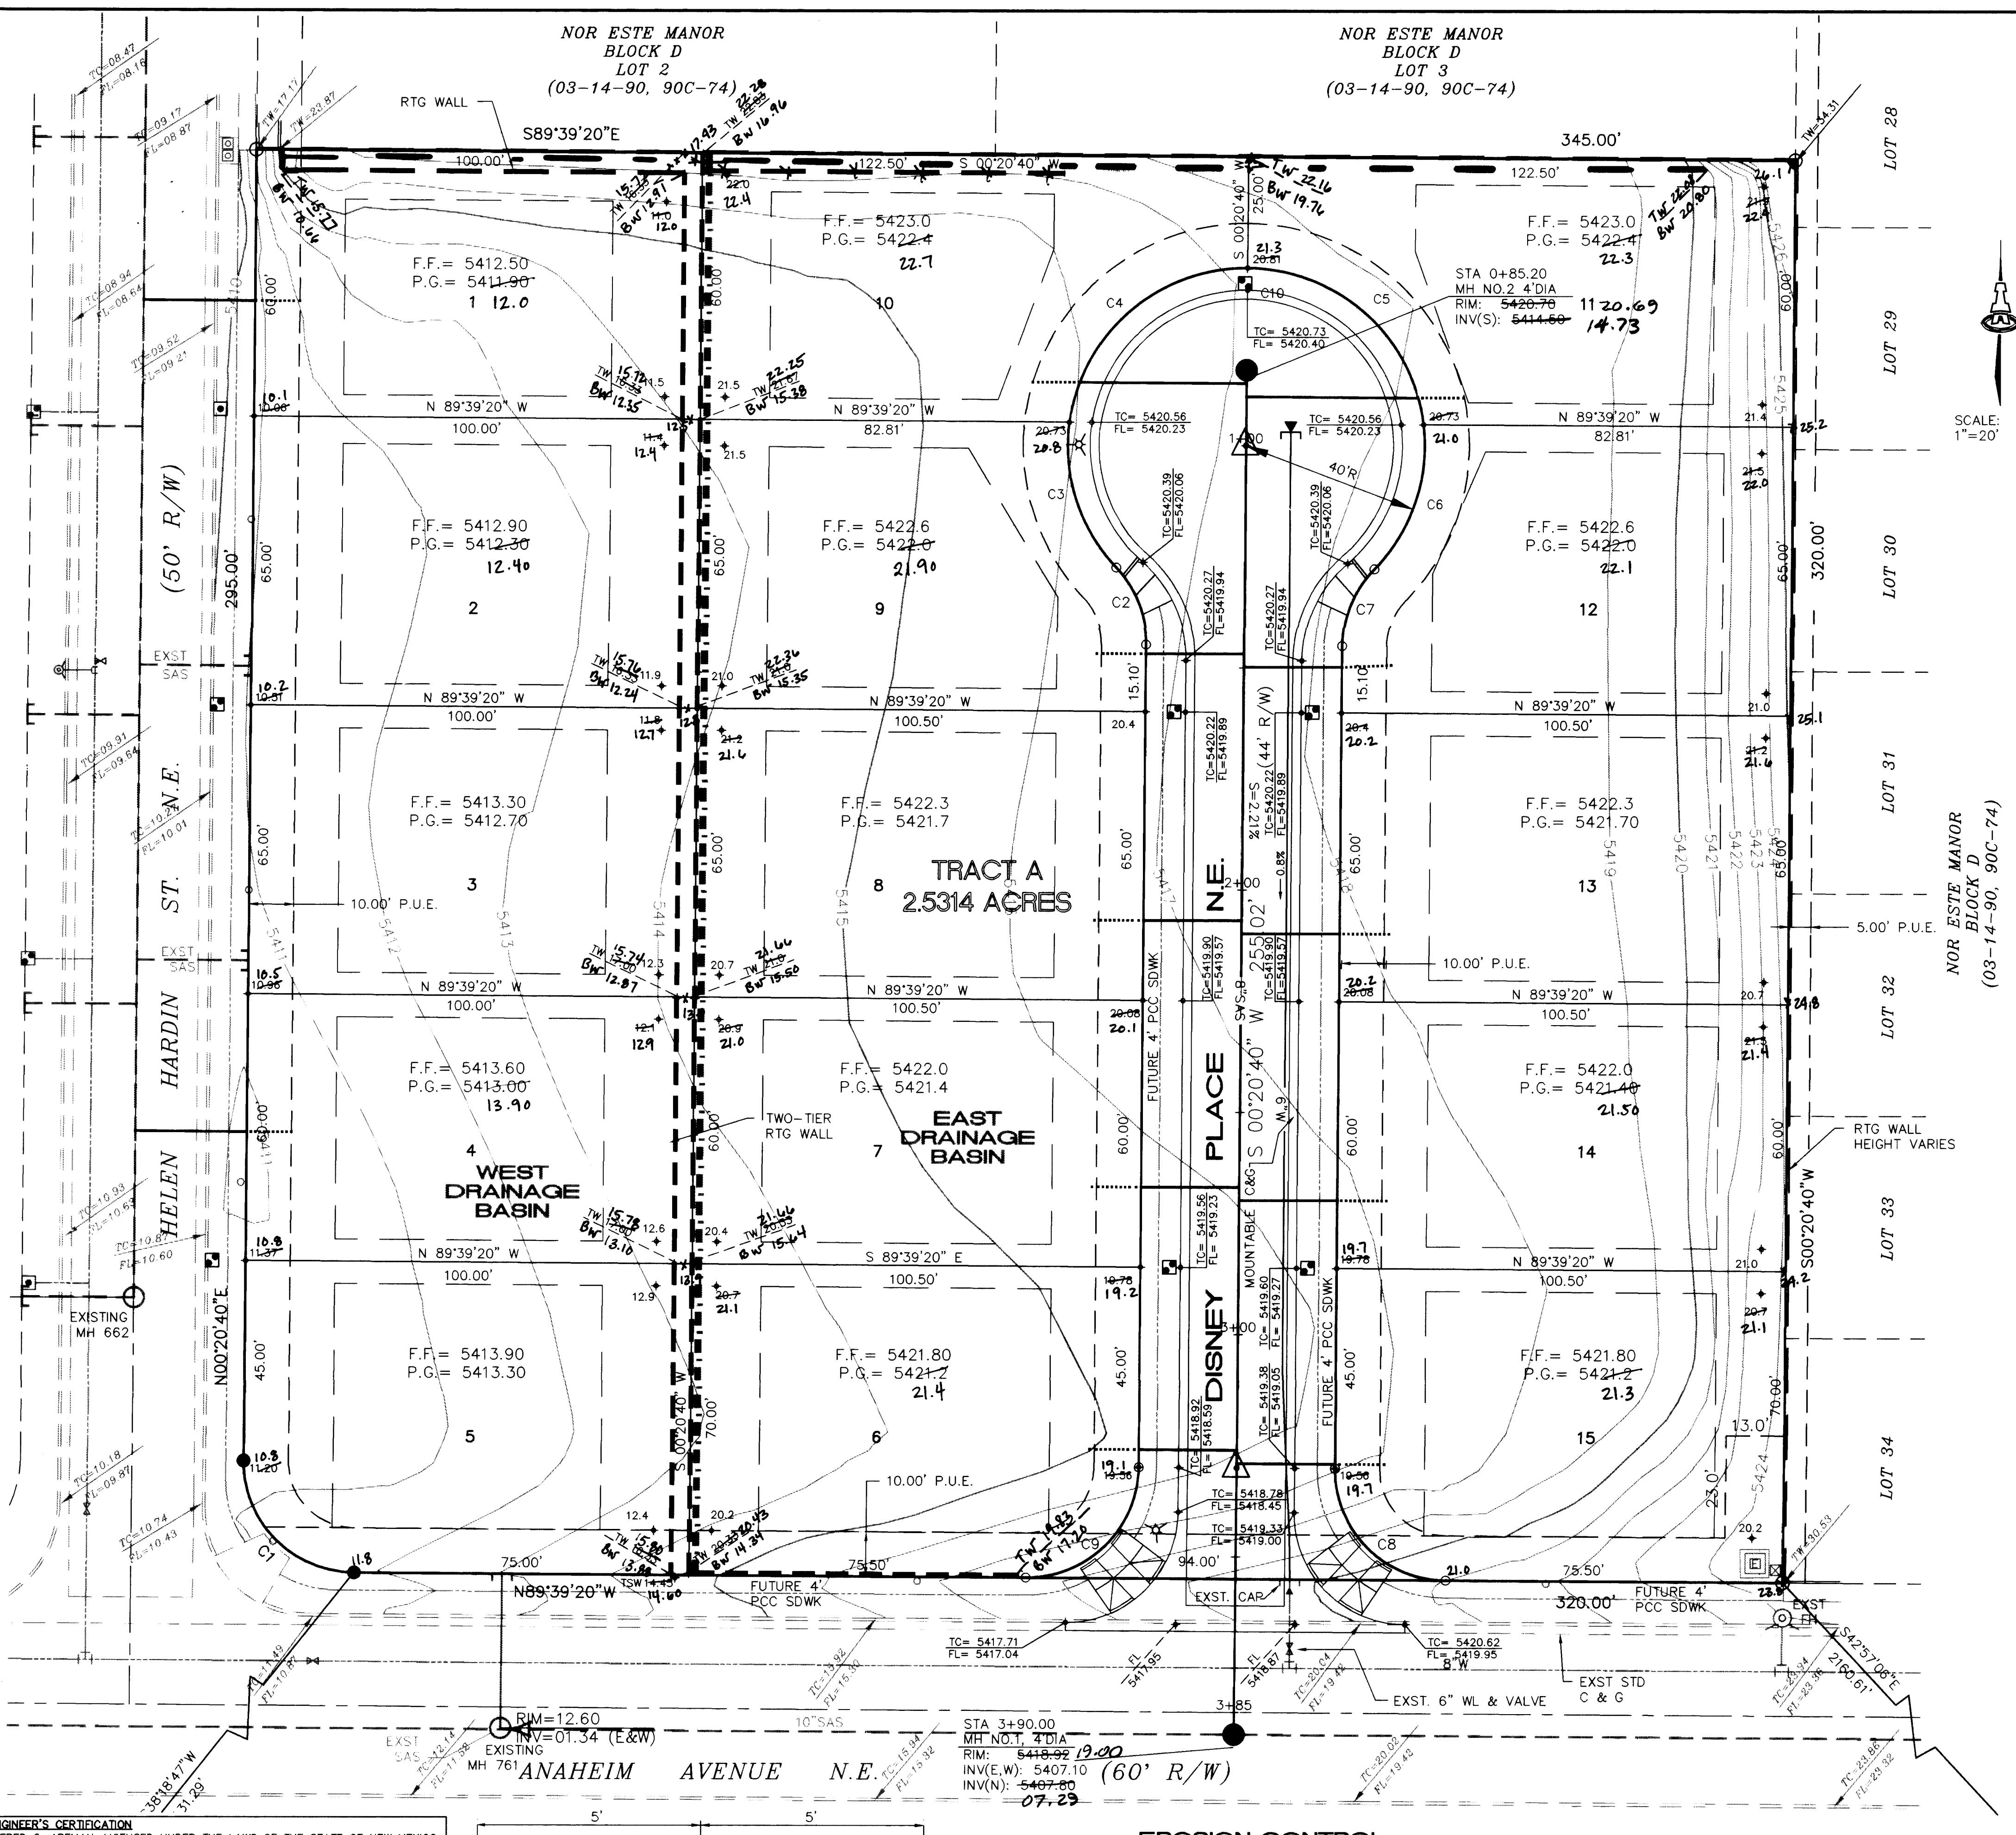

ENGINEER'S CERTIFICATION
I, FRED C. ARFMAN, LICENSED UNDER THE LAWS OF THE STATE OF NEW MEXICO,
DO HEREBY CERTIFY THAT THIS PROJECT WAS CONSTRUCTED IN SUBSTANTIAL
COMPLIANCE WITH THOSE GRADES AND IMPROVEMENTS SHOWN AS FIELD
VERIFIED BY ALDRICH LAND SURVEYING, NMLS NO. 7719 ON NOV. 10, 1997, IN
ACCORDANCE WITH THE "NEW MEXICO ENGINEERING AND SURVEYING ACT"
SECTION 61-23-1 THROUGH 61-23-32 NMSD (1978).

RETAINING WALLS WERE REQUIRED AT DESIGNATED LOCATIONS ALONG
DESIGNATED INTERIOR LOT LINES AS SHOWN ON THE APPROVED FINAL GRADING
AND DRAINAGE PLAN, DATED MARCH 12, 1997, FOR DISNEY PLACE ON FILE WITH
THE HYDROLOGY DIVISION, PUBLIC WORKS DEPARTMENT, ALBUQUERQUE (C19/D6B). SAID
SURVEYOR FIELD VERIFIED WALL IMPROVEMENTS ON JAN. 23, 1998.

Fred C. Arfman, P.E., NMPE No. 2332
State of New Mexico


EROSION CONTROL BERMS

SCALE: 1"=2'

EROSION CONTROL

1. THE CONTRACTOR SHALL ENSURE THAT NO SOIL ERODES FROM THE SITE INTO THE PUBLIC RIGHT-OF-WAY OR ONTO PRIVATE PROPERTY. THIS CAN BE ACHIEVED BY CONSTRUCTING EROSION CONTROL BERMS (AS DETAILED AT RIGHT) AS SHOWN ON THE PLAN AND WETTING THE SOIL TO KEEP IT FROM BLOWING.
2. THE CONTRACTOR SHALL SECURE "TOPSOIL DISTURBANCE PERMIT" FROM THE CITY ENVIRONMENTAL HEALTH DEPARTMENT PRIOR TO BEGINNING CONSTRUCTION. AN EXCAVATION PERMIT IS REQUIRED FOR ALL WORK WITHIN PUBLIC RIGHT-OF-WAY.

SCANNED BY
BY LASON

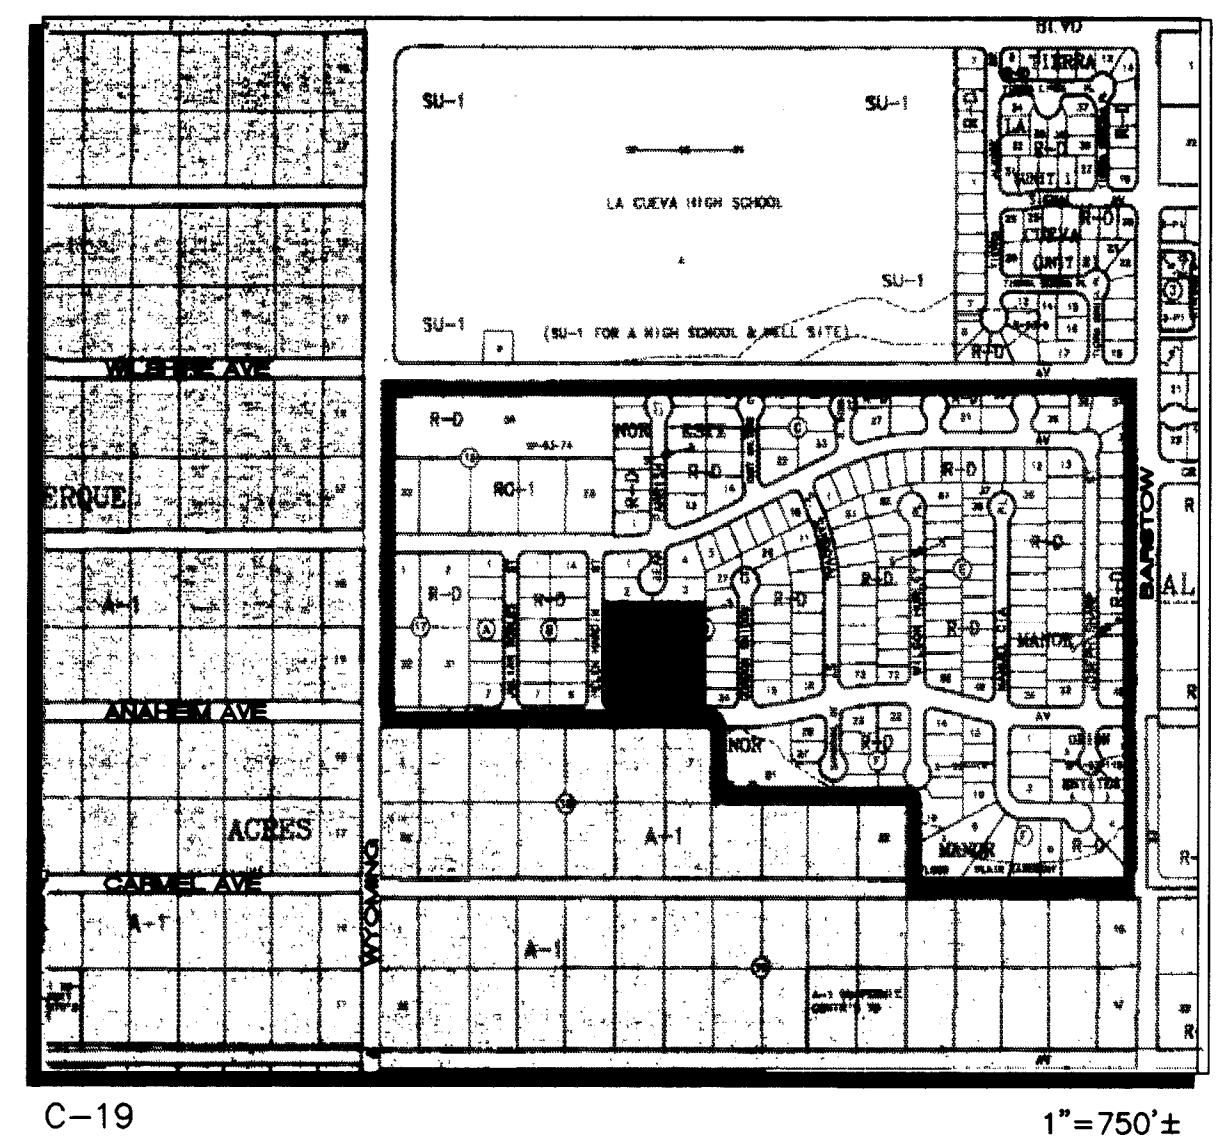

VICINITY MAP
LEGAL DESCRIPTION: TRACT A, BLOCK D, NOR ESTE MANOR, (03-14-90, 90C-74)
AREA: 2.50 ACRES (108,900 SF)
BENCHMARK: ACS MONUMENT "6-C19"
ELEVATION: 5476.7

FLOOD ZONE DESIGNATION: ZONE C (AREAS OF MINIMAL FLOODING), PANEL 10 OF 50, FLOOD INSURANCE RATE MAP, CITY OF ALBUQUERQUE, BERNALILLO COUNTY, NEW MEXICO, OCTOBER 14, 1983.

EXISTING DRAINAGE PLAN: THE SUBJECT SITE WAS INCLUDED IN THE OVERALL DRAINAGE ANALYSIS OF NOR ESTE MANOR AND GRADING AND COMPACTED IN ACCORDANCE WITH THE ASSOCIATED GRADING PLAN AS FOUND ON SHEET 6 OF 52 OF NOR ESTE MANOR (C.O.A. PROJ. NO 3355).

DRAINAGE REPORT IS ON FILE AT THE CITY'S HYDROLOGY DIVISION IN FILE (C19/D006B).

EXISTING CONDITIONS: TRACT A WAS ANALYZED IN THE NOR ESTE DRAINAGE ANALYSIS AS A NON-RESIDENTIAL SITE (FUTURE CHURCH). CURRENTLY, THE SITE IS AN UNDEVELOPED TRACT WITH COMPACTED MASS GRADING ACCORDANCE TO THE NOR ESTE MANOR GRADING PLAN.

THE SITE DOES NOT ACCEPT ANY OFF-SITE FLOWS FROM THE FULLY DEVELOPED SINGLE FAMILY RESIDENTIAL NEIGHBORHOOD TO THE NORTH AND EAST. THE TRACT FRONTS ON FULLY DEVELOPED CITY STREETS BEING ANAHEIM AVENUE ON THE SOUTH AND HELEN HARDIN STREET ON THE WEST.

PROPOSED IMPROVEMENTS AND CONDITIONS: THE TRACT IS SCHEDULED FOR DEVELOPMENT AS 15 SINGLE FAMILY LOTS, 5 LOTS FRONTING ON HELEN HARDIN STREET (BASIN A) AND 10 LOTS WITHIN A CUL-DE-SAC OFF OF ANAHEIM AVENUE (BASIN B). THEREFORE, THE DEVELOPED FLOWS SHALL BE SPLIT WITH ONE-THIRD OF THE DEVELOPED STORM WATER FLOWS ENTERING ONTO HELEN HARDIN STREET AND THEN BEING CONVEYED TO THE NORTH. THE REMAINING 10 LOTS WITHIN THE CUL-DE-SAC WILL HAVE 100% OF THE DISCHARGING STORM WATERS Routed SOUTH TO ANAHEIM AVENUE WHERE THEY WILL THEN BE CONVEYED TO THE WEST IN ACCORDANCE TO THE ORIGINAL STUDY.

PROPOSED HYDROLOGY:

PRECIPITATION ZONE 3
DESIGN STORM: 100 YR-6HR, D = 2.60 IN.
LAND TREATMENTS

$$\begin{aligned} D &= 7\sqrt{(6X6) + (5X6)} \\ &= 7\sqrt{66} = 7X8.12 = 57\% \\ B &= 23\% \\ C &= 20\% \end{aligned}$$

3	4	5	6	7	8	9	10	11	12	13	14	15
✓	✓	✓	✓	✓	✓	✓	✓	✓	✓	✓	✓	✓

EXCESS PRECIPITATION
TREATMENT

	INCHES
B	0.92
C	1.29
D	2.36

PEAK DISCHARGE

$$\begin{aligned} \text{BASIN A (0.833 AC)} \\ \text{TOTAL } Q_p &= (0.92)(0.23)(0.833) + (1.29)(0.20)(0.833) + (2.36)(0.57)(0.833) \\ &= 0.18 + 0.21 + 1.12 \\ &= 1.5 \text{ CFS} \end{aligned}$$

$$\begin{aligned} \text{BASIN B (1.67 AC)} \\ \text{TOTAL } Q &= (0.92)(0.23)(1.67) + (1.29)(0.20)(1.67) + (2.36)(0.57)(1.67) \\ p &= 0.36 + 0.42 + 2.24 \\ &= 3.0 \text{ CFS} \end{aligned}$$

LEGEND

- EXST. CONTOUR
- TW— EXST. TOP OF WALL
- TC— EXST. TOP OF CURB ELEV.
- FL— EXST. CURB AND GUTTER
- EXST. RETAINING WALL
- PROPOSED RETAINING WALL
- PROPOSED CURB & GUTTER
- P.G. PAD GRADE ELEVATION
- F.F. FINISH FLOOR ELEVATION
- FLOW DIRECTIONAL ARROW
- TC= TOP OF CURB ELEVATION
- FL= FLOWLINE
- EROSION CONTROL BERM
- LIMITS OF DRAINAGE BASIN

ISAACSON & ARFMAN, P.A.
Consulting Engineering Associates
128 Monroe Street N.E.
Albuquerque
New Mexico
918CRD.DWGmtd
3/4/97

CITY OF ALBUQUERQUE
PUBLIC WORKS DEPARTMENT
ENGINEERING GROUP

TITLE:


DISNEY PLACE GRADING & DRAINAGE PLAN


Design Review Committee	City Engineer Approval	No./Day/Yr.	No./Day/Yr.
Approved	Approved	3-18-97	3-18-97
REVISIONS	REVISIONS	DATE	DATE
DESIGNED BY	DESIGNED BY	DATE	DATE
DRAWN BY	DRAWN BY	DATE	DATE
CHECKED BY	CHECKED BY	DATE	DATE

Last Design Update _____

City Project No. 570081 Zone Map No. C-19 Sheet 3 Of 5

CONTRACTOR	AS-BUILT INFORMATION
WORK STAGED BY	AS-BUILT MEETING
INSTRUCTIONS BY	DATE 9/27/97
FIELD SURVEY BY	AS-BUILT DATE 5/7/98
VERIFICATION BY	AS-BUILT DATE 7/1/98
REMARKS	REMARKS BY AS-BUILT DATE 7/1/98
RECORDED BY	RECORDED BY AS-BUILT DATE 7/1/98
MICRO-FILM INFORMATION	
RECORDED BY NO.	

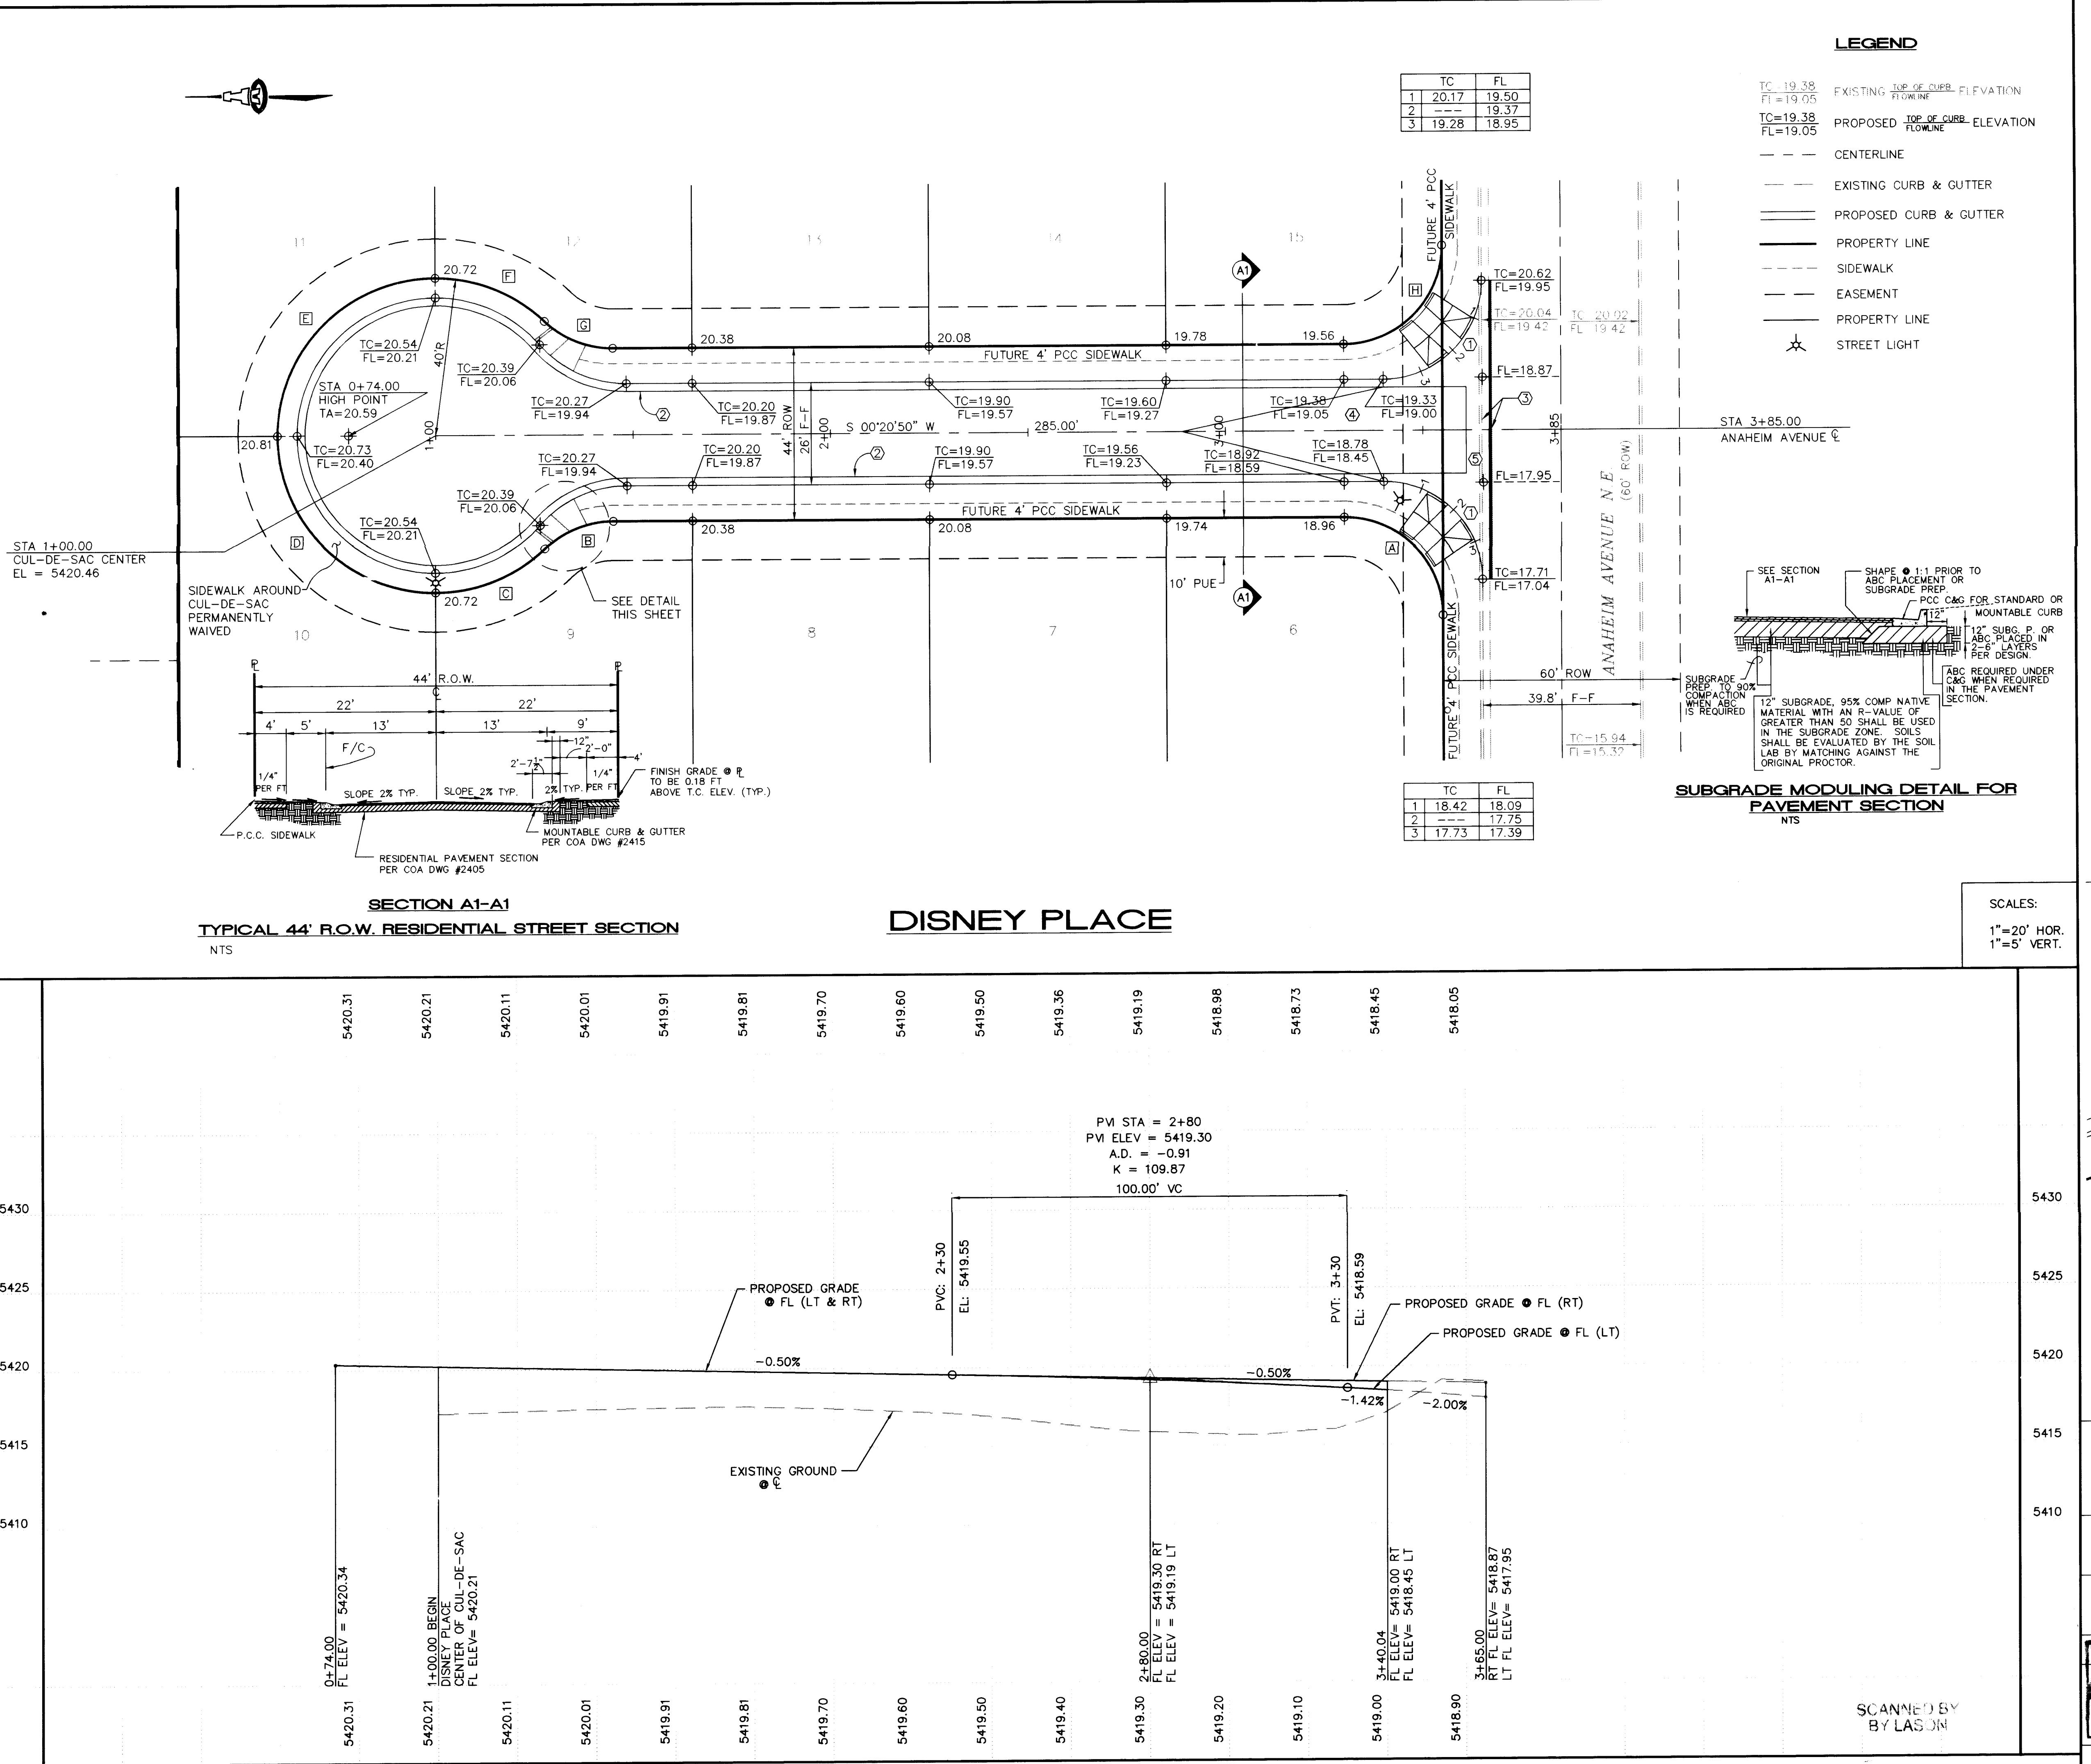

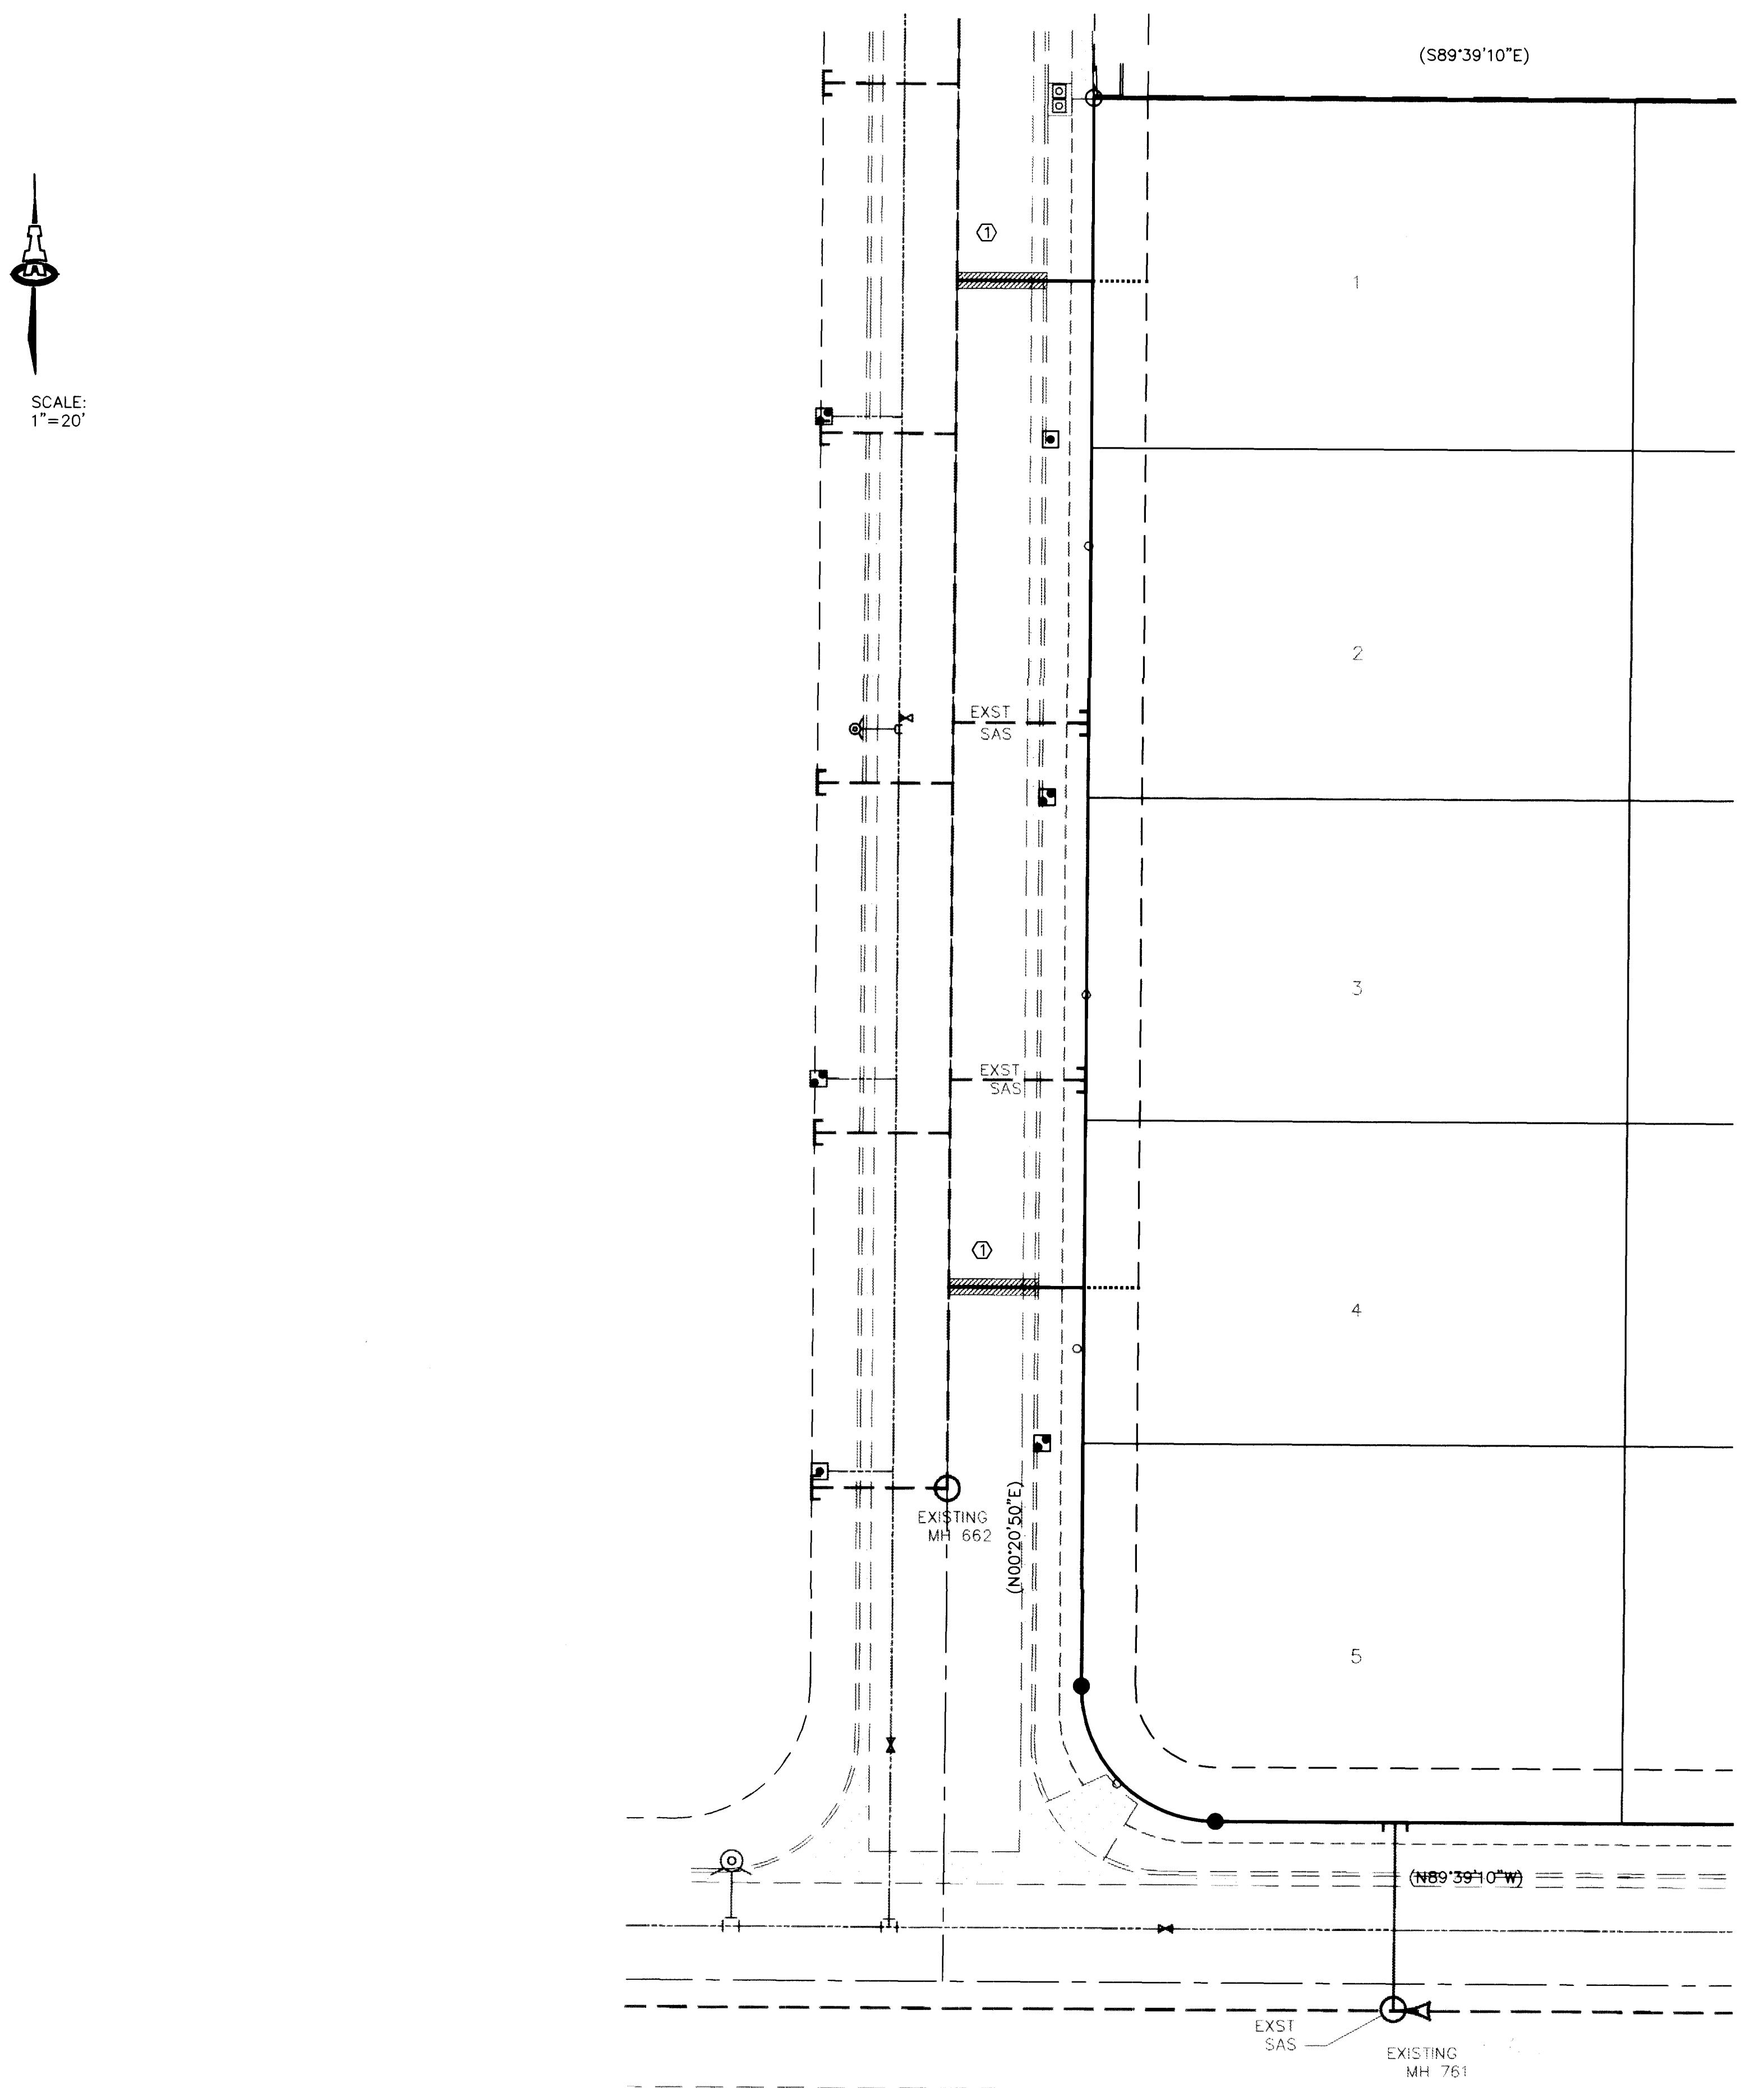

HELEN HARDIN STREET

SCALE:
1"=20'

卷之三

- GATE VALVE WITH TYPE A VALVE BOX
 - DOUBLE WATER METER AND BOX
 - ★ PROPOSED STREET LIGHT
 - | WATERLINE WITH FITTING
 - 14.37 SAS SERVICE LINE INVERT @ P

SAS SERVICE TABLE

LOT NO.	STA.	INV. @ R/W
1	34' S OF N E	4.7
2	*	*
3	*	*
4	37' N OF MH 662	6.00
5	*	*

* EXISTING SAS SERVICE



ISAACSON & ARFMAN, P.A.
Consulting Engineering Associates
128 Monroe Street N.E.
Albuquerque New Mexico

5/30/97

HELEN HARDIN STREET

SCANNED BY
BY LASON