

CITY OF ALBUQUERQUE, NEW MEXICO  
MUNICIPAL DEVELOPMENT DEPARTMENT

INDEX

DESCRIPTION	SHEET No.
TITLE SHEET	1
QUANTITIES & GENERAL NOTES	2
LOCATION MAP & LEGEND	3
PLAN & PROFILE SHEETS	4-19
DETAIL SHEETS	20-22
PREFABRICATED BRIDGE DETAIL	23-24
RETAINING WALL ELEVATIONS	25
CROSS SECTIONS	26-30

# EMBUDO / PIEDRA LISA RECREATIONAL TRAIL

1 2 3 4 5 6 7 8 9 10 11 12  
06 00 11 01 18 4

APPROVAL OF AS BUILT DRAWINGS
ASST. CITY ENGINEER-FIELD
W.J. McNamara
DATE 3/1/84



AS BUILT

GARDNER, MASON & ASSOC. INC.  
ALBUQUERQUE, NEW MEXICO

SET No. \_\_\_\_\_  
DATE \_\_\_\_\_

# SUMMARY OF QUANTITIES

ITEM NO.	DESCRIPTION	UNIT OF MEASURE	GRAND TOTAL	
			ESTIMATE	FINAL
1	Clearing & Grubbing	L.S.	100%	
2	Grading	S.Y.	55517	55705
3	Removal of Trees 4" to 10" dia.	Ea.	12	12
4	Removal of Trees greater than 10" dia.	Ea.	10	10
5	Trimming of Trees	Ea.	8	26
6	Removal of Asphalt Pavement	S.Y.	85	155
7	Removal of Curb & Gutter	L.F.	190	126
8	Removal of Sidewalk	S.Y.	75	155
9	Removal of Chain Link Fence	L.F.	253	253
10	Relocate Exist. 12' Chain Link Gates	Ea.	5	Deleted
11	Remove Exist. Bike Gates	Ea.	14	22
12	Remove 4"x4" Guard Posts	Ea.	48	28
13	Removal of Concrete Channel Lining	C.V.	20	10
14	Reinforced Concrete Retaining Wall	C.Y.	90	90
15	Unreinforced, Pneumatically applied Concrete	S.F.	1500	1529
16	Process & Compact Exist. Material	S.Y.	19265	20212
17	Remove & Replace any "in place" material	S.Y.	2000	2000
18	Prime Coat	S.Y.	-0-	20467
19	Asphaltic Concrete Surface Course	S.Y.	19265	18243
20	Concrete Drivepad - 6" thick	S.F.	691	1512
21	Concrete Curb & Gutter	L.F.	160	333
22	Concrete Median Curb & Gutter	L.F.	360	55
23	Adjust Manhole Frame to Grade	Ea.	1	2
24	Reconstruct Manhole	Ea.	1	Deleted
25	4", 1800 lb. Hot Mix for Patch Paving	S.Y.	50	28
26	Mast Arm Foundation, Type I	Ea.	10	10
27	Mast Arm Pedestal, 25'	Ea.	7	7
28	Mast Arm Pedestal, 20'	Ea.	2	2
29	Installation of Standard Traffic Signs	S.F.	519	5275
30	Steel Posts for Traffic Signs	L.F.	256	286
31	Thermoplastic Pavement Marking	L.F.	625	630
32	4" Thermoplastic Pavement Marking	L.F.	1867	1967
33	Installation of Bollards (Removable)	Ea.	26	28
34	Installation of Bollards (Stationary)	Ea.	26	27
35	Prefabricated Steel Bridge (8'x50')	L.S.	1	1
36	Installation of Hand Rail	L.F.	460	460
37	Reconstruction of Exist. Planter	L.S.	1	1
38	Reflectors	Ea.	7	7
39	Installation of 12" C.M.P.	L.S.	-0-	1
40	6" Concrete w/ Reinforcing Steel	S.F.	-0-	1389
41	Replace Sign Post Location	Ea.	-0-	11
42	Trash & Dirt Removal (Juan Tabo/Mesa)	L.S.	-0-	100%
43	Concrete Safety Anchors	Ea.	-0-	69
AA-1-1	Grading to any Depth	S.Y.	1389	1389
AA-1-2	Remove Exist. Bike Gates	Ea.	1	1
AA-1-3	Reinforced Concrete Retaining Wall	C.Y.	63	88
AA-1-4	Process & Compact Exist. Material	S.Y.	337	583
AA-1-5	Asphaltic Concrete Surface Course	S.Y.	337	550
AA-1-6	Thermoplastic Pavement Marking	L.F.	28	40
AA-1-7	Installations of Bollards (Removable)	Ea.	1	2
AA-1-8	6" Concrete w/ Reinforced Wire Mesh	S.F.	1100	1166
AA-1-9	Prime Coat	S.Y.	-0-	583
AA-2-1	4' high Chain Link Fence	L.F.	510	533
AA-2-2	6' high Chain Link Fence	L.F.	694	454
AA-2-3	5' high Chain Link Fence	L.F.	2564	2549
AA-2-4	10' Special Gate	Ea.	1	1
AA-2-5	12' Special Gates	Ea.	6	19
AA-2-6	4" Gate Posts	Ea.	-0-	23
AA-3-1	Standard Traffic Signs	S.F.	520	60
AA-3-2	Steel Posts for Traffic Signs	L.F.	624	680
AA-4-1	Prefabricated Steel Bridge (6'x80')	L.S.	1	1

## NOTICE TO CONTRACTORS:

- New Mexico Standard Specifications for Public Works Construction - 1979 Edition will be referred to hereon as the "Standard Specification".
- All work detailed on these plans to be performed under contract shall be constructed in accordance with the contract documents of which these are a part.
- Three (3) working days prior to any excavation, Contractor must contact Line Locating Service, 765-1234, for location of existing utilities.
- Prior to construction, the Contractor shall excavate and verify the horizontal and vertical locations of all obstructions. Should a conflict exist, the Contractor shall notify the Engineer so that the conflict can be resolved with a minimum amount of delay.
- A disposal site for all excess excavation material, asphaltic paving, concrete, etc. shall be provided by the Contractor. All costs incurred in obtaining a disposal site and haul thereto shall be considered incidental to construction and no direct payment will be made therefore.
- All clearing and grubbing, removal of stumps, or shrubs, removal of minor underground structures, pipe, service lines, etc. shall be considered part of clearing and grubbing.
- The Contractor shall maintain access to adjacent properties during construction except during paving operations..
- Testing, Right-of-Way surveys and construction staking shall be provided by the Engineer.
- Gas, sewer and underground telephone utilities shall remain in existing locations and necessary adjustments made by others. Utility poles to be relocated by owners. It shall be the contractors responsibility to request the relocation of poles and/or risers.
- All ties to existing pavements on cross-streets and connections shall be a neat line saw cut joint. This work shall be considered incidental to construction and no direct payment will be made therefore.
- Fifty (50) ton roller operation shall not be used on this project where underground utilities are present. The required compaction at these locations shall be effected by means of other types of rolling available.
- When directed by the Engineer, existing sidewalks and concrete driveways, asphaltic driveways, shall be sawed in a neat line to match new construction. This work shall be considered as a part of the unit bid price for sidewalks and or driveways.
- The City of Albuquerque's Traffic Engineering Department shall remove all existing above ground traffic signs deemed salvagable by the City.
- All radii of curb returns and dimensions are shown to Back of Curb.
- The Contractor shall plan his daily surfacing operations on a schedule which will result in a minimum length of exposed longitudinal joints at the end of each day's operations. All transverse joints and all longitudinal joints left exposed to traffic at the end of each day's overlay operation shall be tapered a minimum of one foot.
- Grading Operations shall be confined to within the limits of construction as shown on the Typical Sections except as directed by the Engineer.
- Construction operation through landscaped areas of the parks shall be confined to the width of the bikeway plus four feet on one side and ten feet on the other side. Upon completion of each section through the parks, the contractor shall fine grade the construction area and leave it in a condition suitable for the placement of sod.
- The Contractor will be required to confine his work within the construction limits and or ROW to preserve existing vegetation and private property. Overnight parking of construction equipment shall not obstruct driveway openings onto private property.

## EROSION CONTROL NOTES:

### A. ERODIBLE SURFACE AREA


- The contractor shall open this project in accordance with the requirements of construction.

### B. TEMPORARY MEASURES

- Top of subgrade, bottom of excavation, or top of embankment shall be watered or otherwise kept dust free. The Contractor, at the direction of the Engineer, shall use his watering equipment for dust pollution abatement. This operation shall be given priority over any other operation where the water equipment might be required. Watering as required shall be considered incidental to construction and no measurement or payment will be made therefore.
- As directed by the Engineer, roadway slopes which are exposed during construction and will be subject to erosion are to be treated by watering to prevent erosion. Watering shall be considered incidental, and no measurement or payment will be made therefore.
- If construction operations need to be suspended for a period of time longer than two weeks, the Engineer shall request the Contractor to treat all exposed areas with a temporary soil stabilant. No measurement or payment will be made therefore.
- All areas occupied by the Contractor in connection with the work, shall be kept free of dust. This work shall be considered incidental, and no measurement or payment will be made therefore.

## TRAFFIC CONTROL AND SAFETY:

- The Contractor is cautioned that traffic must be carried through construction. This shall conform with the Sequence of Work as provided in the Sequence of Construction and Detour Plan to be provided by the Contractor in accordance with the specifications. The safe and efficient movement of this traffic is a prime responsibility of the Contractor. Preparation of the Construction Signing and Detour Plan by the Contractor shall be considered incidental to construction.
- All construction signing for all roadways, premissible detours, open excavations and other incidental work for the completion of this project shall be in accordance with the Manual on Uniform Traffic Control Devices for Streets and Highways, 1978 Edition.
- Signing and barricading shall include adequate protection against excavation and other hazards to pedestrian traffic.
- The Contractor shall be required to keep the public apprised through the local news media for the life of this project, of the various construction operations involving street or lane closures or any other pertinent information relating to traffic movement.

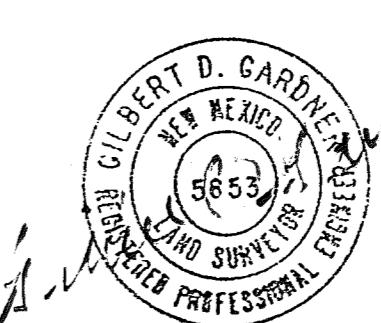

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06 00 11 02 84

CITY OF ALBUQUERQUE					
MUNICIPAL DEVELOPMENT DEPARTMENT					
ENGINEERING DIVISION					
TITLE EMBUDO / PIEDRA LISA RECREATIONAL TRAIL					
QUANTITIES & GENERAL NOTES					
APPROVALS	ENGINEER	DATE	APPROVALS	ENGINEER	DATE
City Engineer			Liquid Waste		
A.C.E. Design			Traffic		
A.C.E. Hydrology			Water		
DRAWING NO.	SHEET 2 OF 25				



STREET MAP OF  
**ALBUQUERQUE**

**SCALE OF MILES**  
ONE INCH EQUALS APPROXIMATELY 0.45 MILES

**Constrained Access Dual Hwy**

**Principal Through Routes**

**Secondary Thoroughfares**

**Undeveloped Parks**

**Schools**

**Community Centers**

**Swimming Pool**

**Tennis Courts**

**House Numbers**

**One way Streets**


**HIGHWAY NUMBERS**

40 Interstate 66 United States 98 State

## LEGEND

TOP OF PAVEMENT	T.P.	SIGN	•	POST
RIGHT OF WAY	R/W	SPRINKLER HEAD	○	RETAINING WALL w/HAND RAIL
SIDEWALK	S.W.			
END OF PROJECT	E.O.P.	BOLLARD	•	
BEGINNING OF PROJECT	B.O.P.	GRASS	▼▼	
BACK OF CURB	B.C.	CONCRETE	▲▲	
BACK TO BACK	B-B	TYPICAL BIKE PAVING		_____
CURB	Cb.			
GUTTER	Gtr.			
CENTER LINE	C			
POWER POLE	P.P. •	WIRE MESH BARRIER FENCE	• X • X •	
GUY WIRE	G.W. →	NEW CHAIN LINK FENCE	X X X X	
TREE		EXIST. CHAIN LINK FENCE	— X — X — X —	

DNER, MASON & ASSOC. INC.  
BUQUERQUE, NEW MEXICO

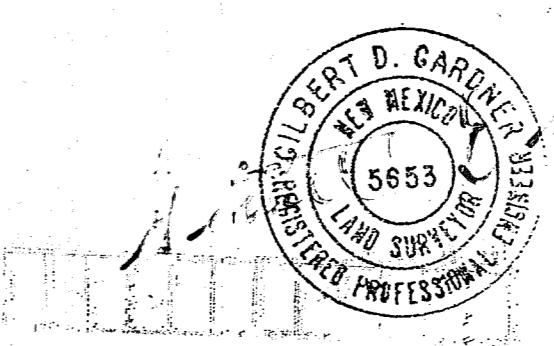


CITY OF ALBUQUERQUE  
MUNICIPAL DEVELOPMENT DEPARTMENT  
ENGINEERING DIVISION

#### **EMBUDO/PIEDRA LISA RECREATIONAL TRAIL**

## LOCATION MAP & LEGEND


APPROVALS	ENGINEER	DATE	APPROVALS	ENGINEER	DATE
City Engineer			Liquid Waste		
A.C.E. Design			Traffic		
A.C.E. Hydrology			Water		
DRAWING NO.					

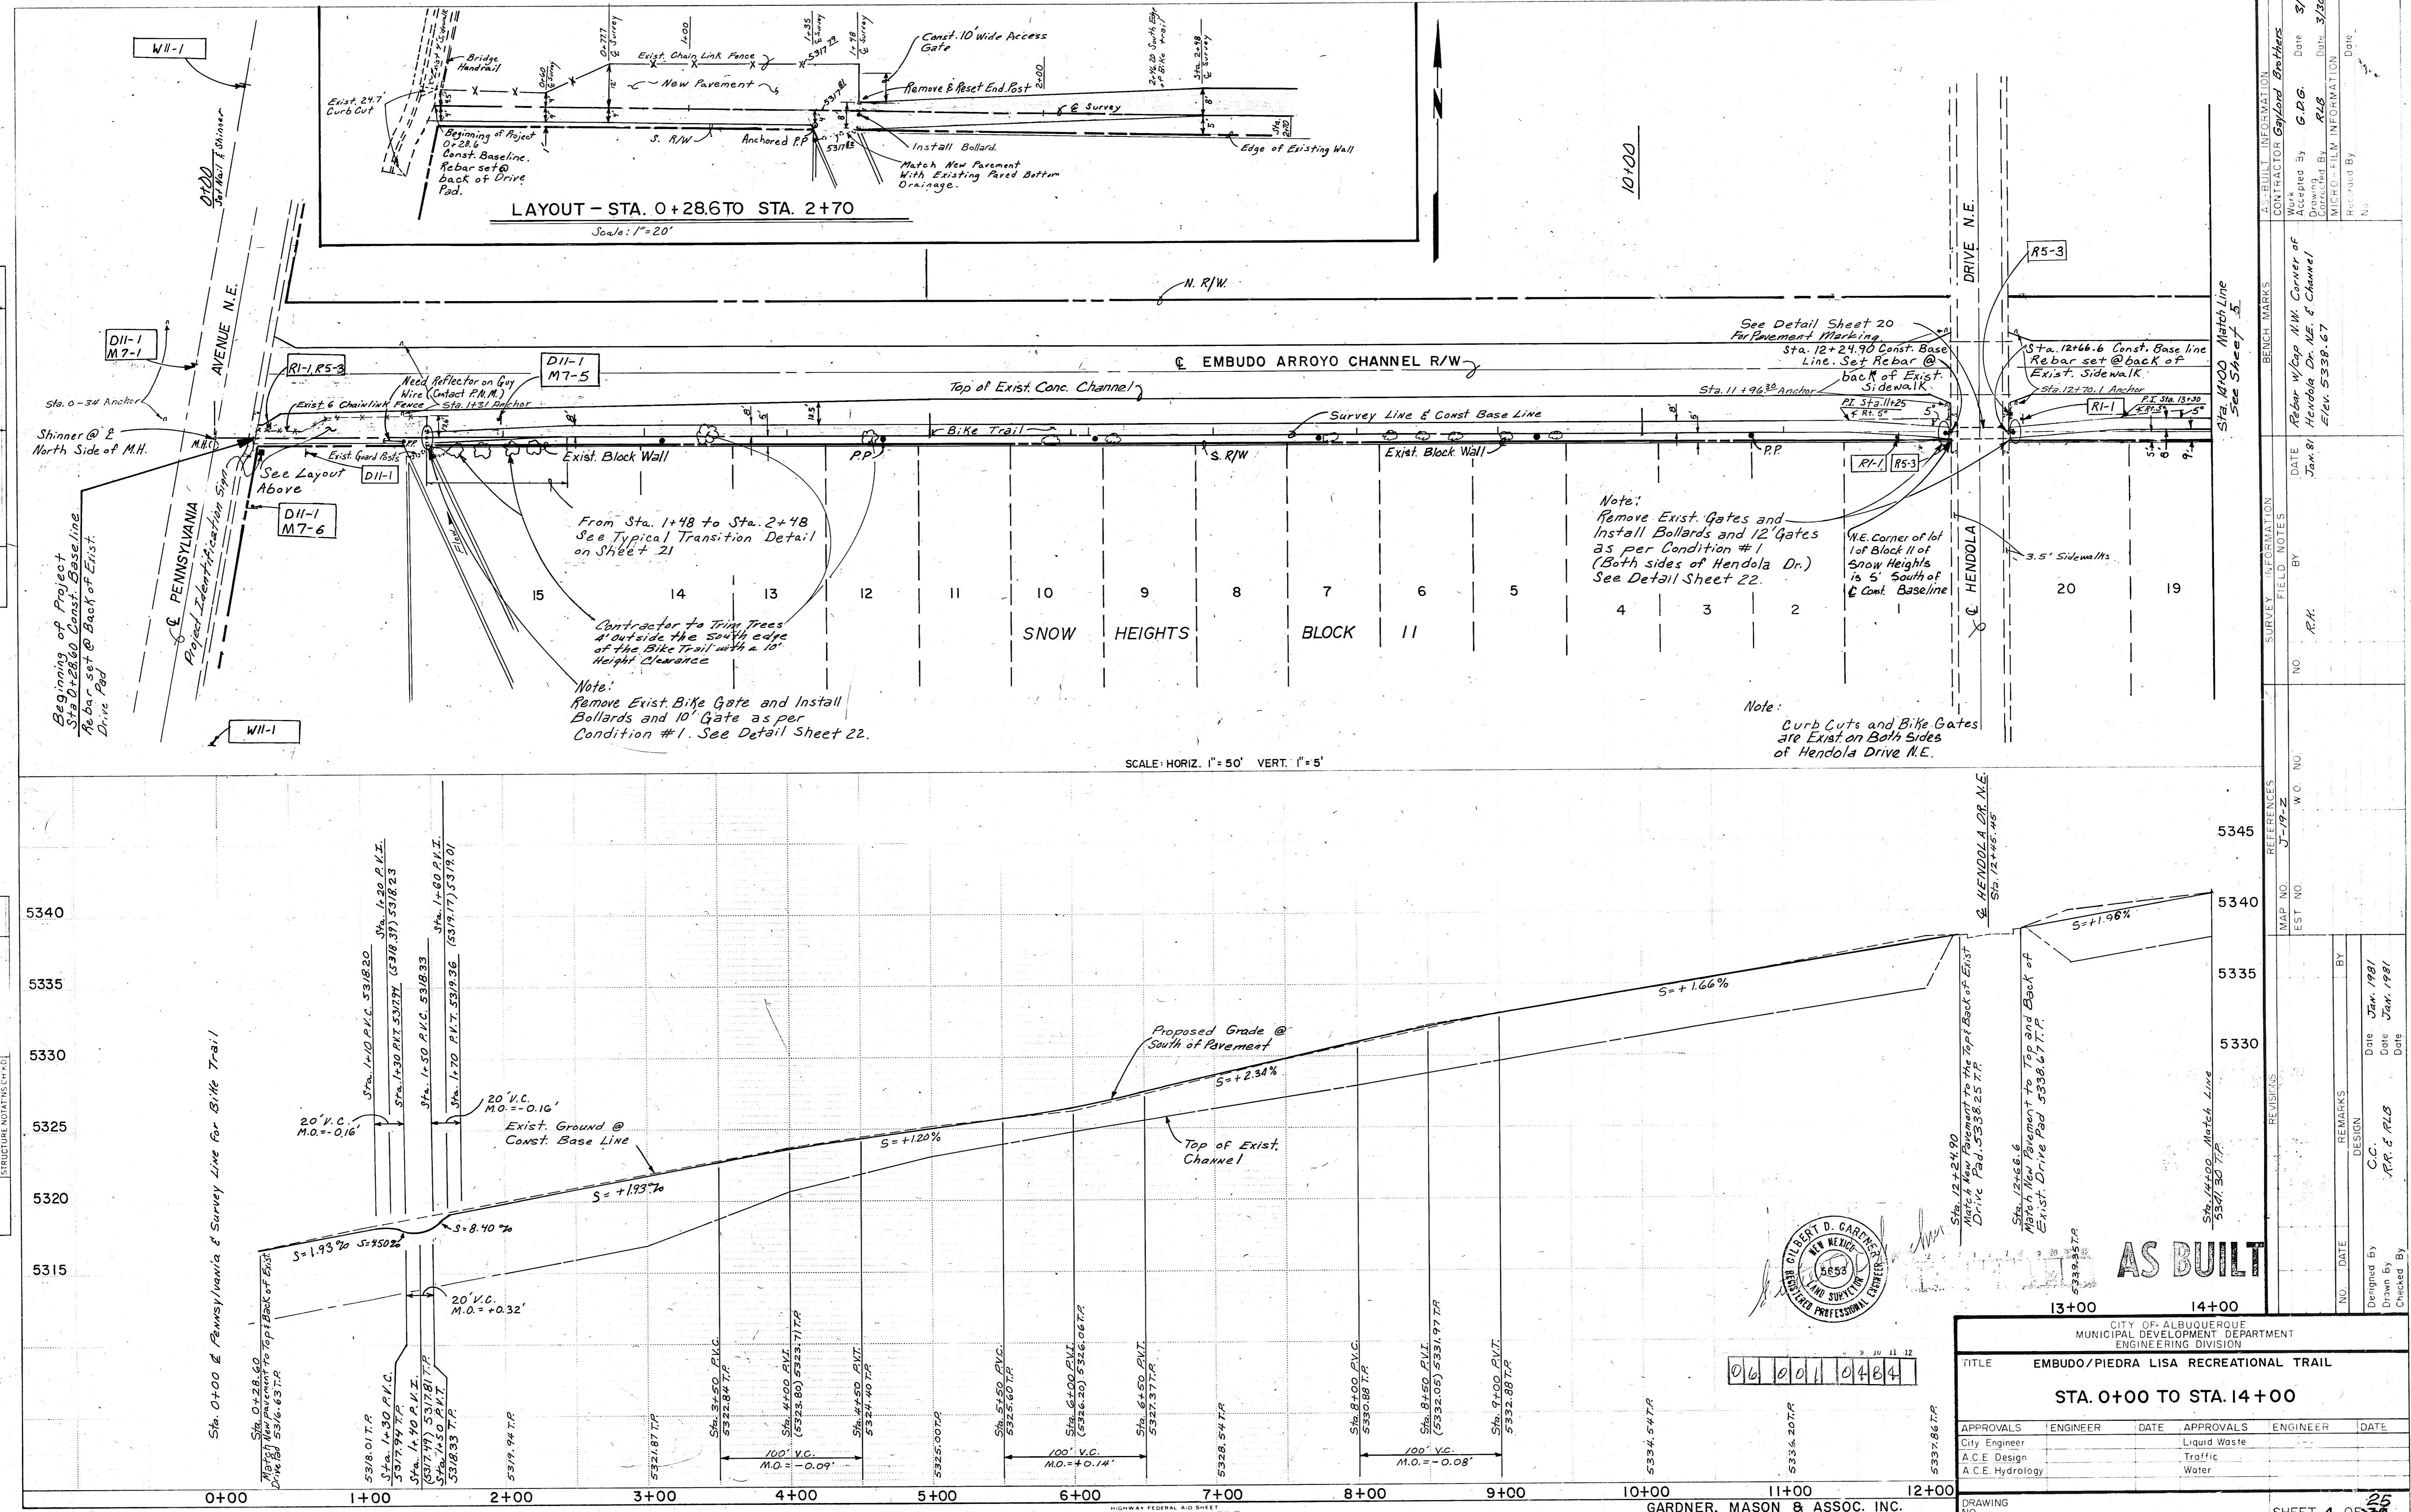



SHEET 4 OF 30

PLAN	SURVEYED	BY	DATE
PLOTTED			
NOTE BOOK	GRADES CHECKED		
STRUCTURE NOTATIONS CHECKED			
NO.			

PROFILE	SURVEYED	BY	DATE
PLOTTED			
NOTE BOOK	GRADES CHECKED		
STRUCTURE NOTATIONS CHECKED			

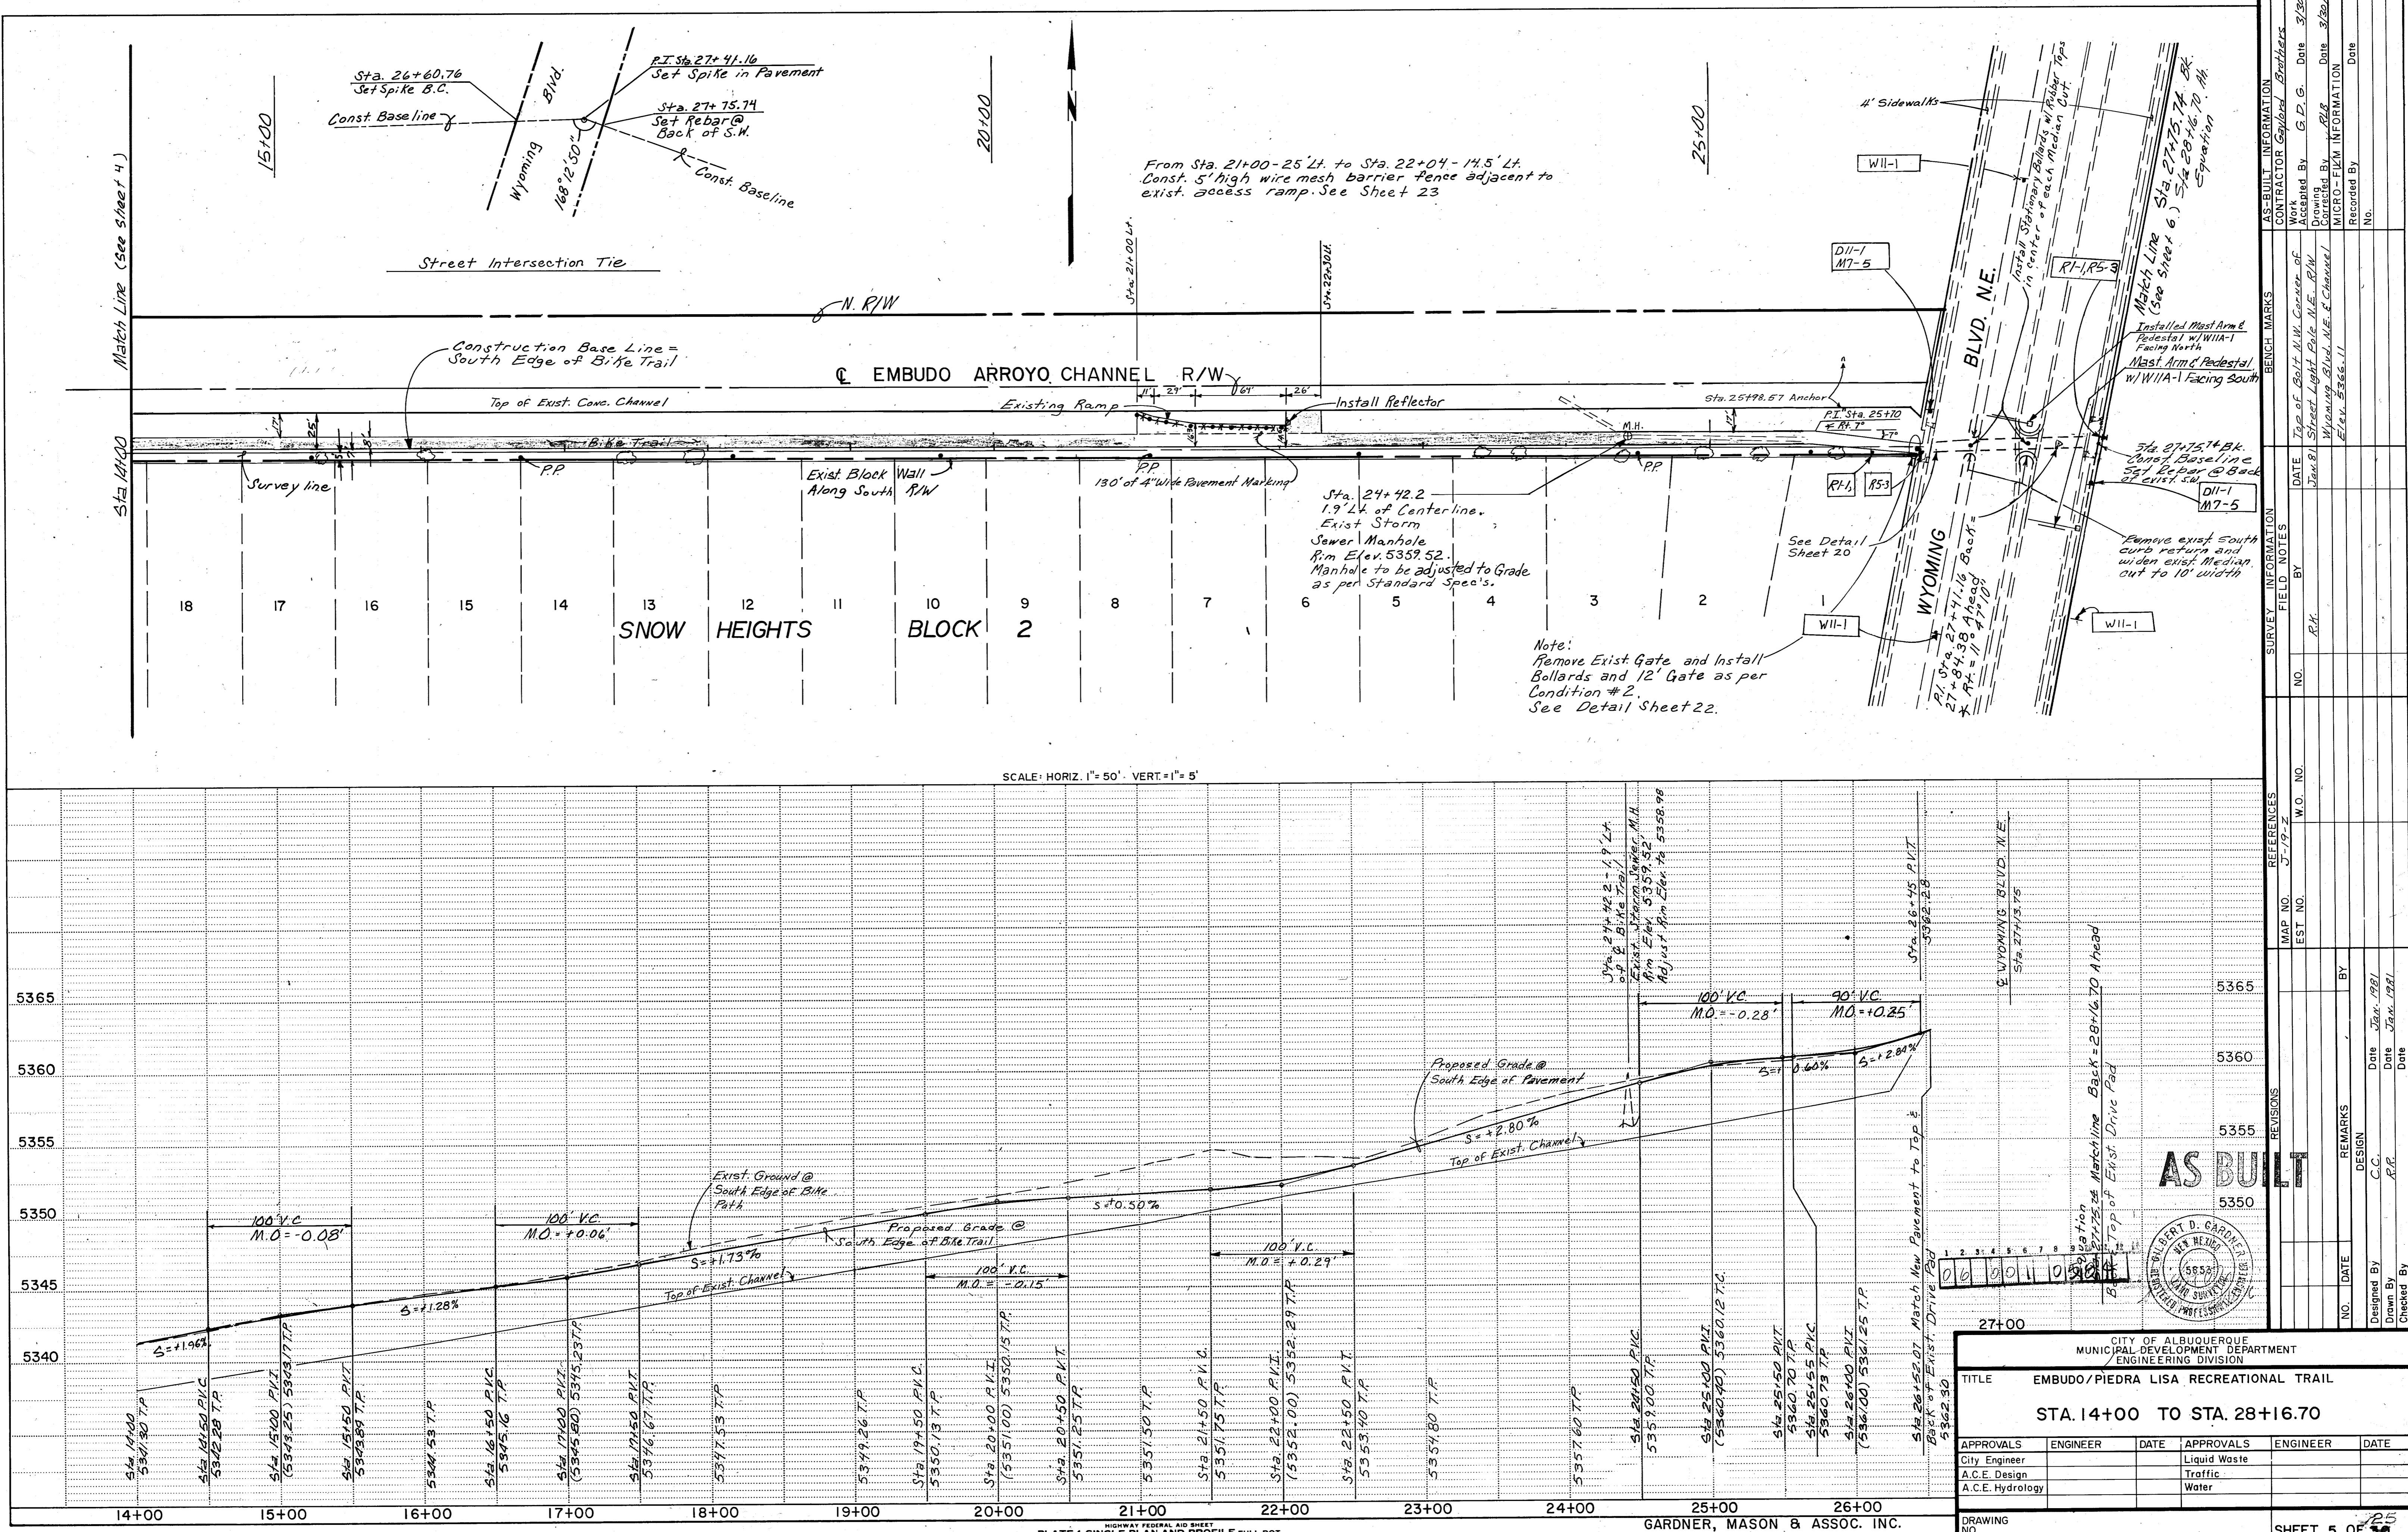

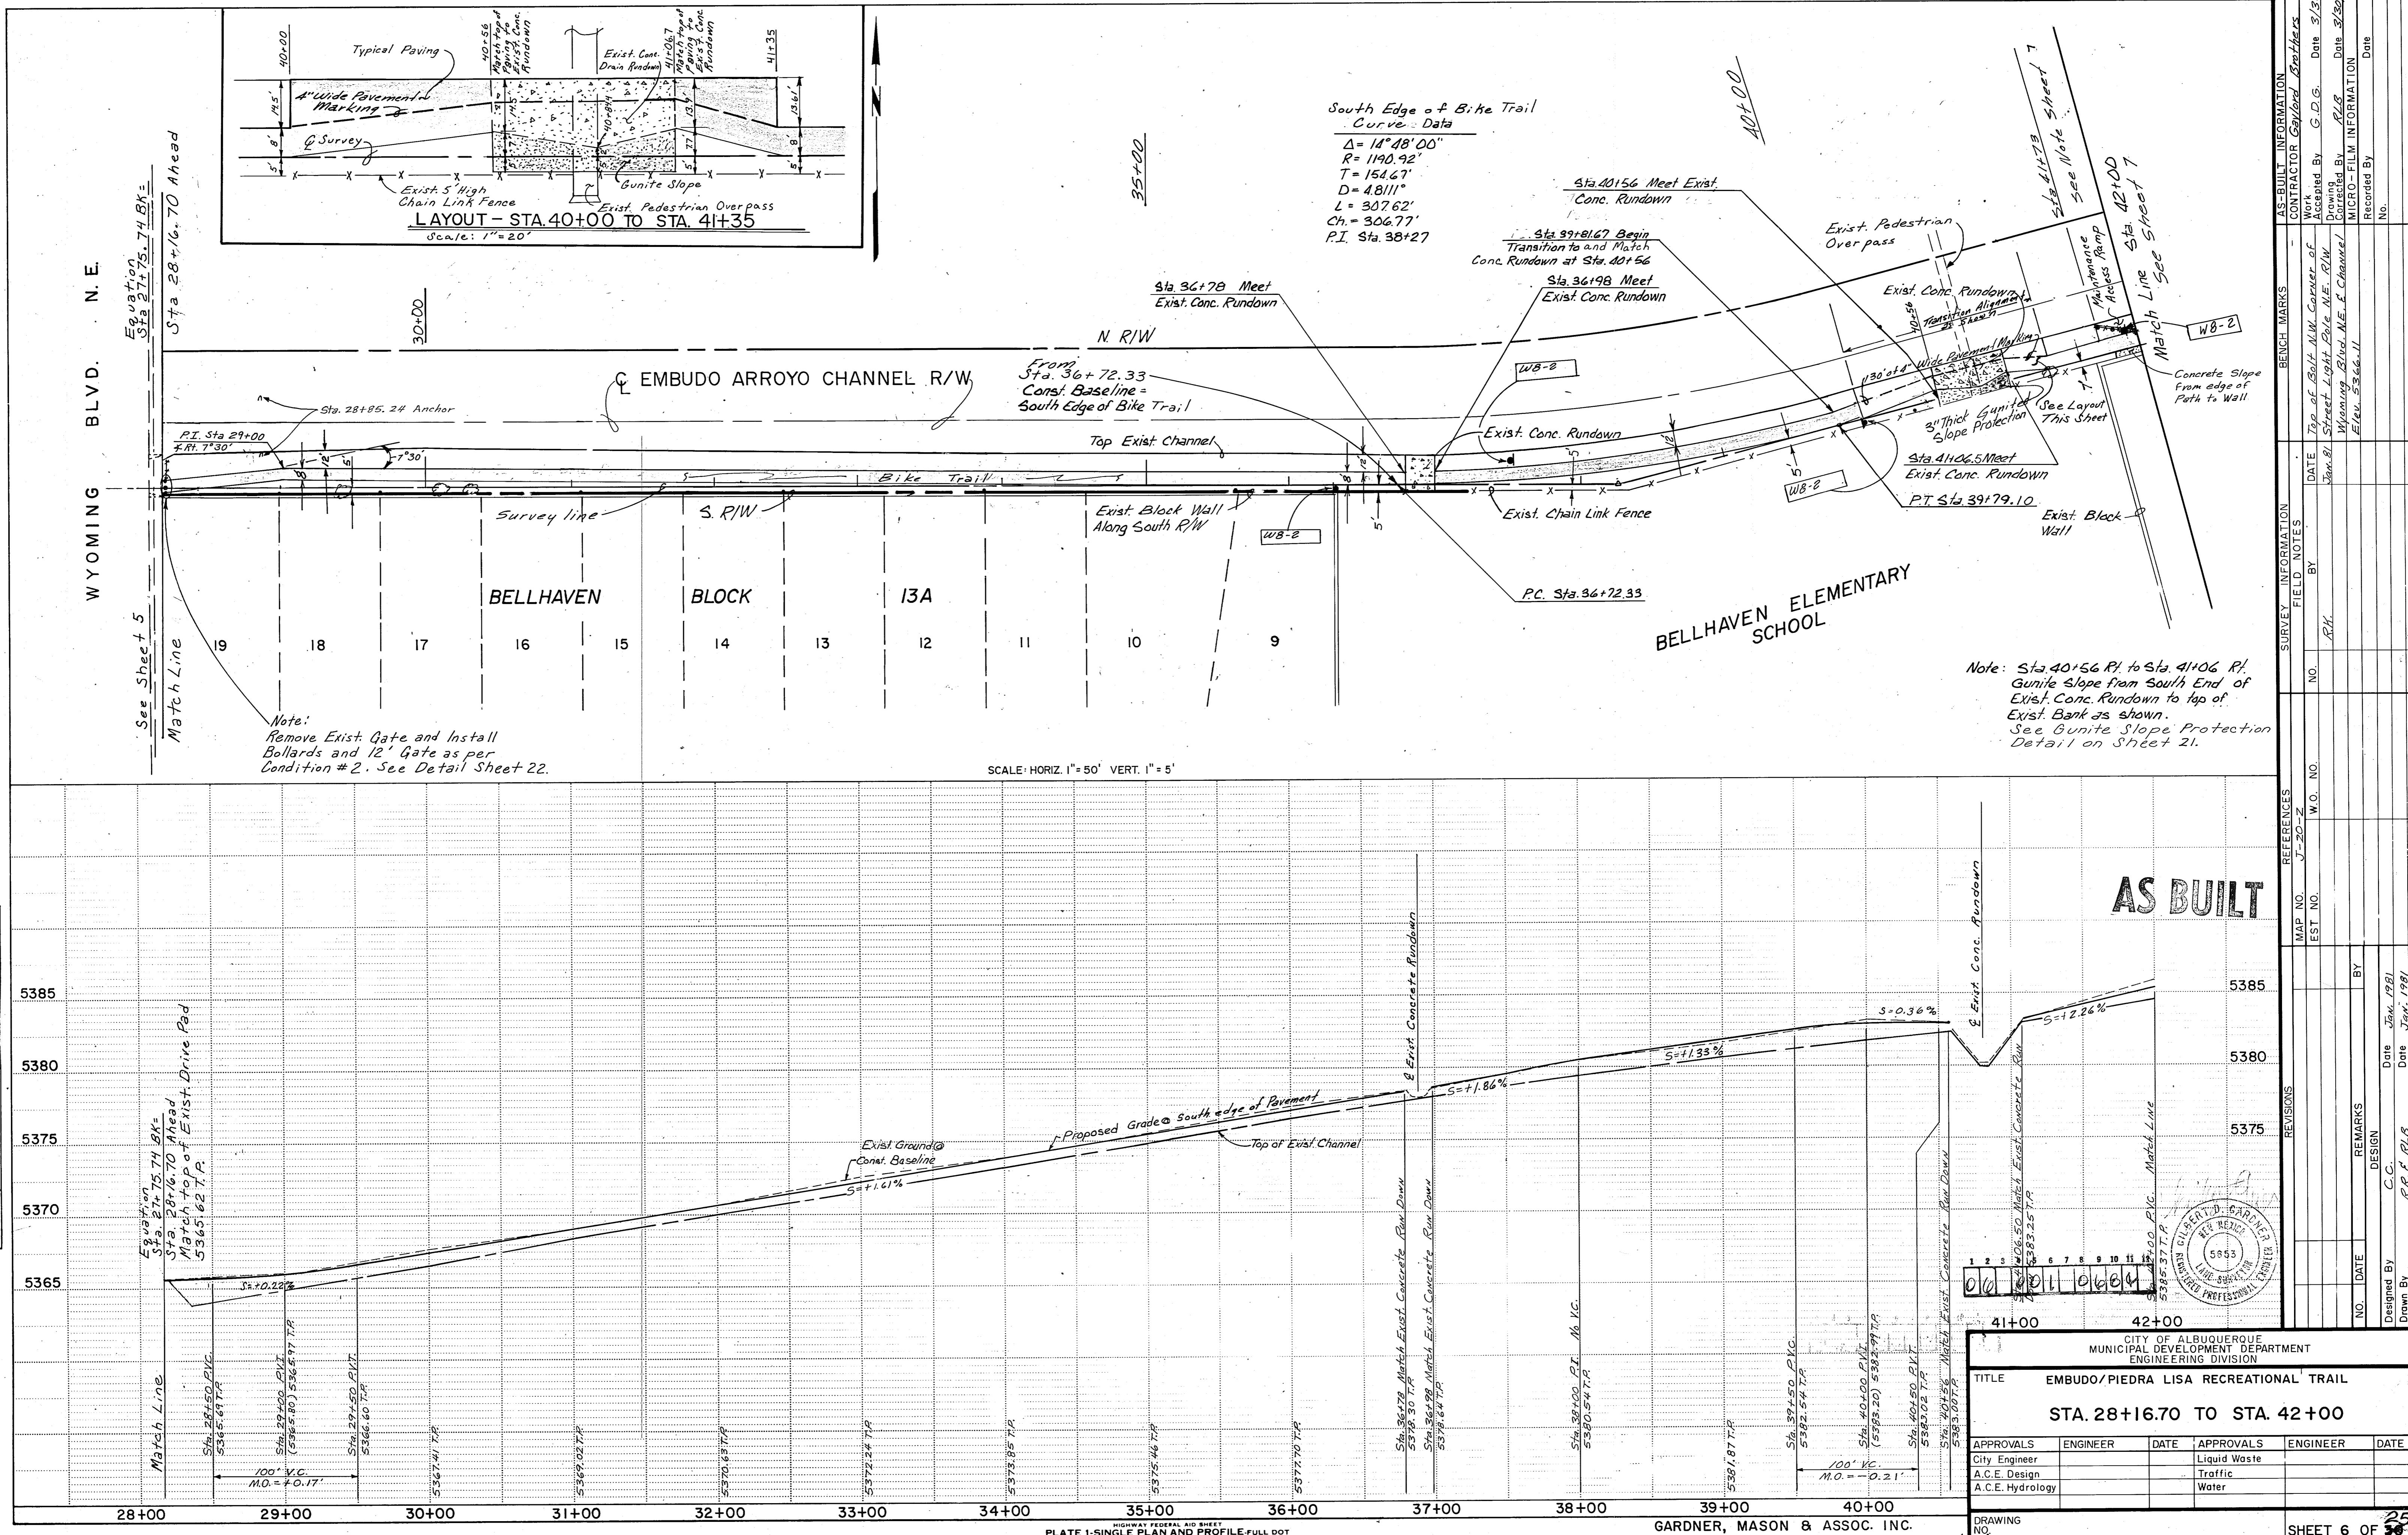

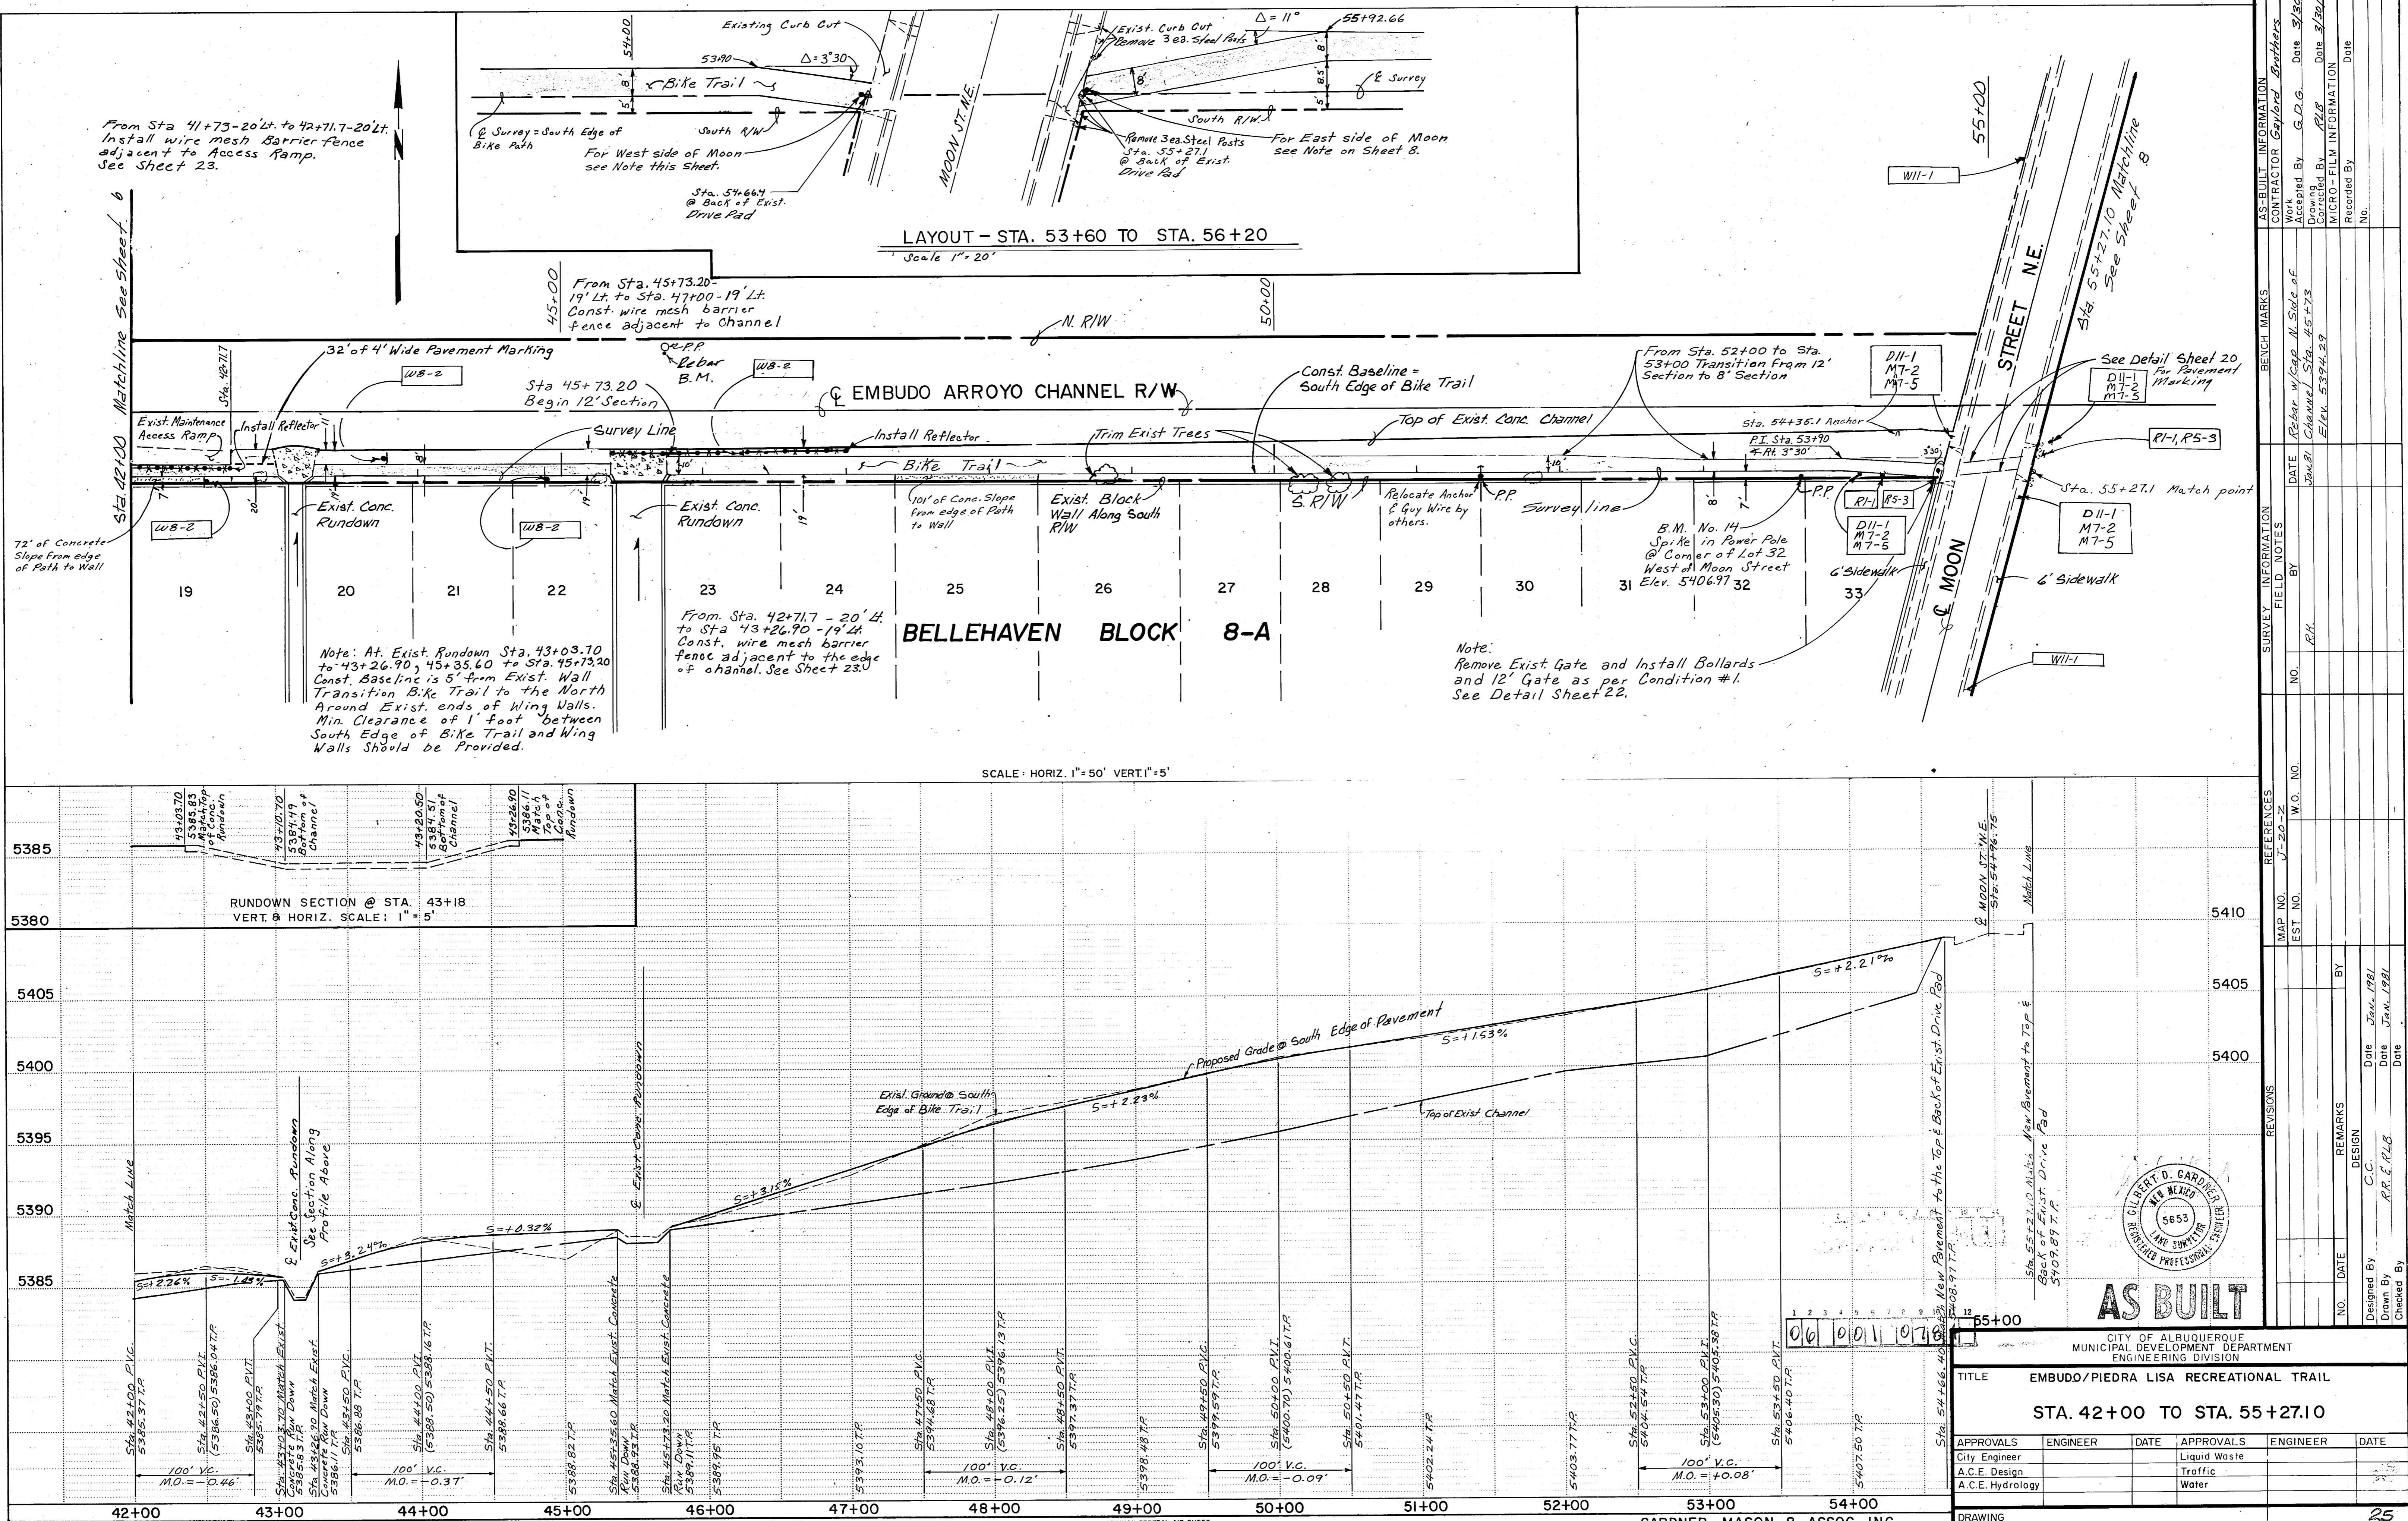

HIGHWAY FEDERAL AID SHEET  
PLATE 1-SINGLE PLAN AND PROFILE-FULL DO  
TELEDYNE  
PRINTED IN U.S.A.

**GARDNER, MASON & ASSOC. INC.**  
**ALBUQUERQUE, NEW MEXICO**

**CITY OF ALBUQUERQUE  
MUNICIPAL DEVELOPMENT DEPARTMENT  
ENGINEERING DIVISION**

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**DO/PIEDRA LISA RECREATIONAL TRAIL**

CITY OF ALBUQUERQUE  
MUNICIPAL DEVELOPMENT DEPARTMENT

MONTE VIEJA RECREATIONAL TRAIL  
ENGINEERING DIVISION

# DO/PIEDRA LISA RECREATIONAL TRAIL

. 42+00 TO STA. 55+27.10

INER DATE APPROVALS ENGINEER

	<b>Liquid Waste</b>	
	<b>Traffic</b>	

	<b>Traffic</b>	
	<b>Water</b>	


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SHEET 7


10. The following table shows the number of hours worked by each employee in a company.

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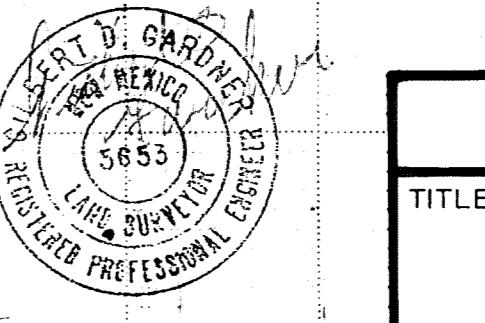
PLAN	SURVEYED	BY	DATE
PLOTTED	GRADE CHECKED		
NOTE BOOK NO. B.M. INDEXED STRUCTURE COUNTS CHKO			



PROFILE	SURVEYED	BY	DATE
PLOTTED	GRADES CHECKED		
NOTE BOOK NO. B.M. INDEXED STRUCTURE COUNTS CHKO			


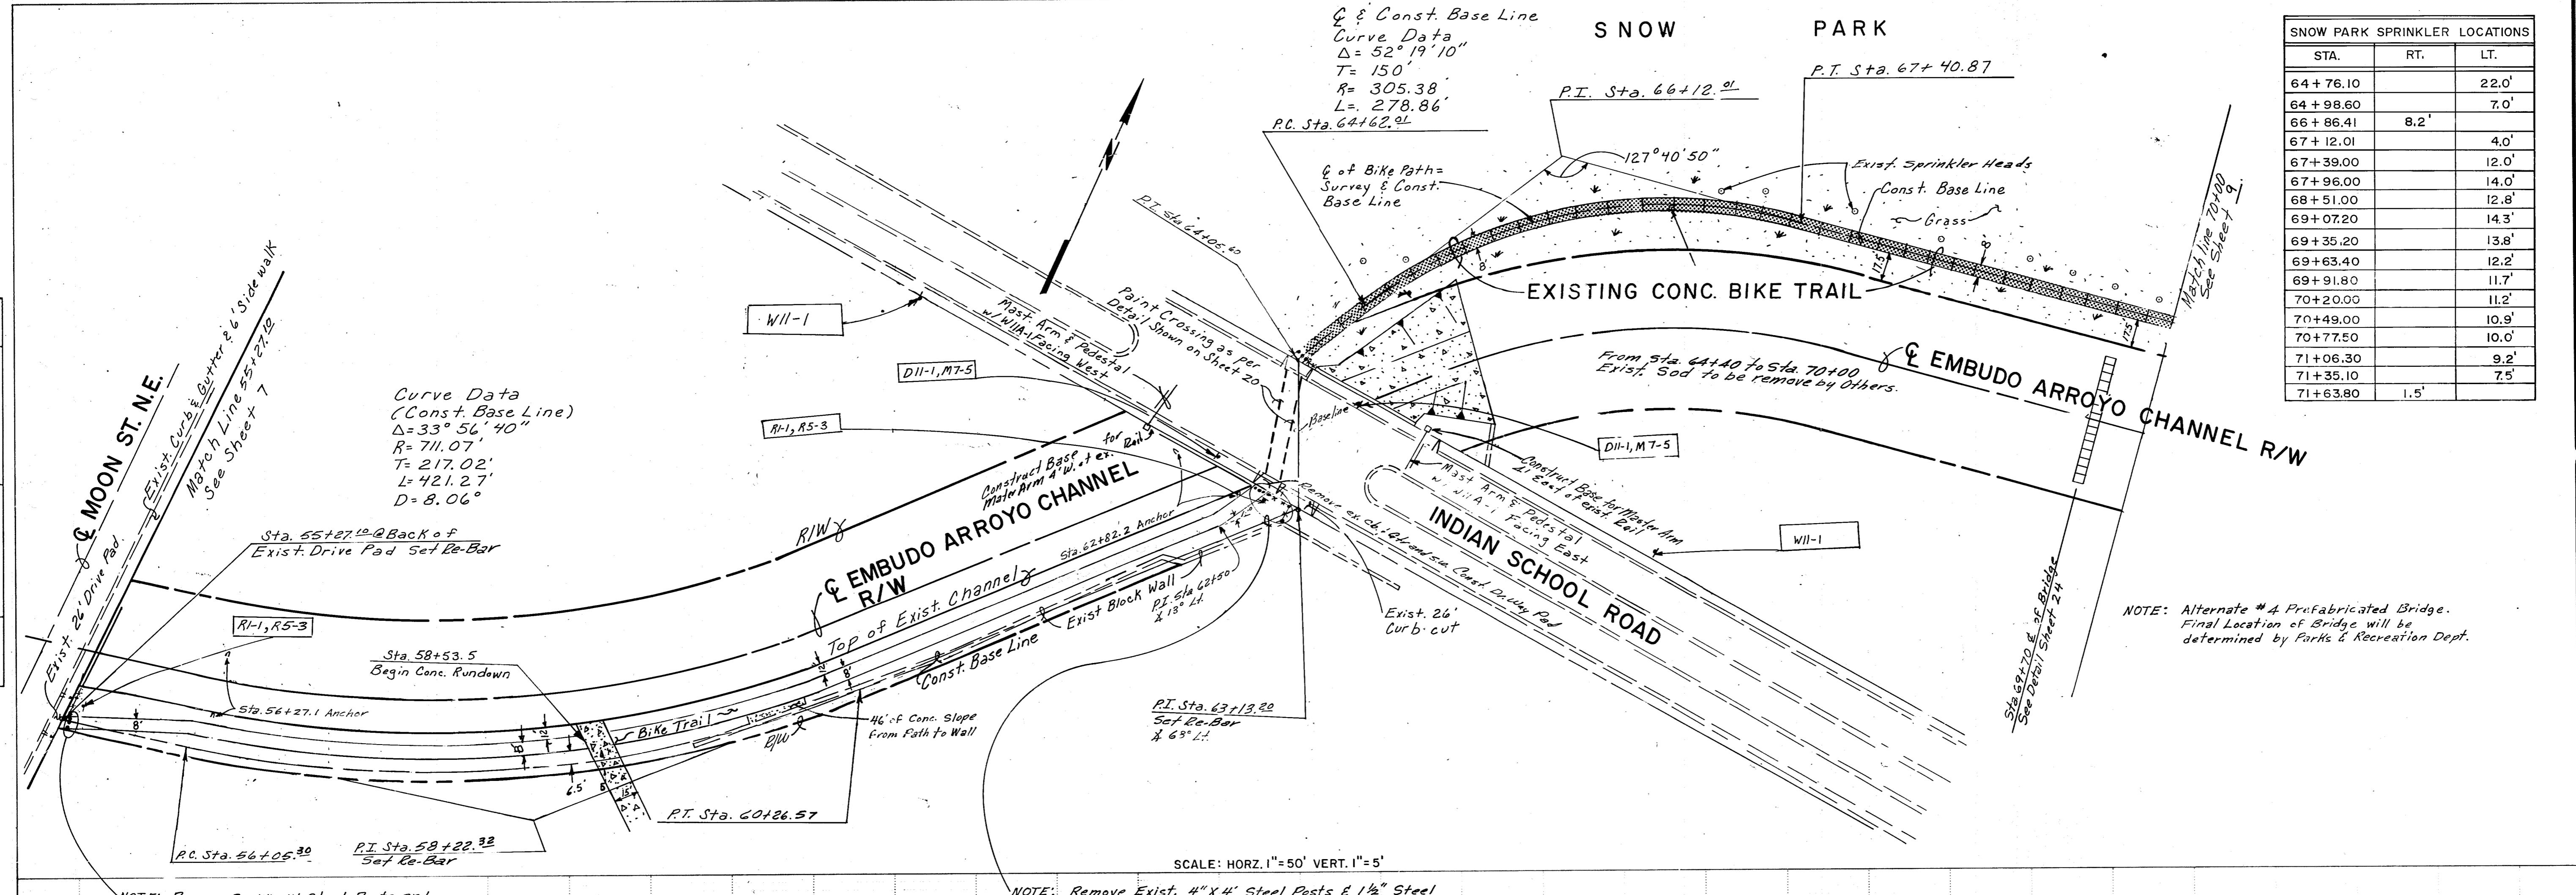


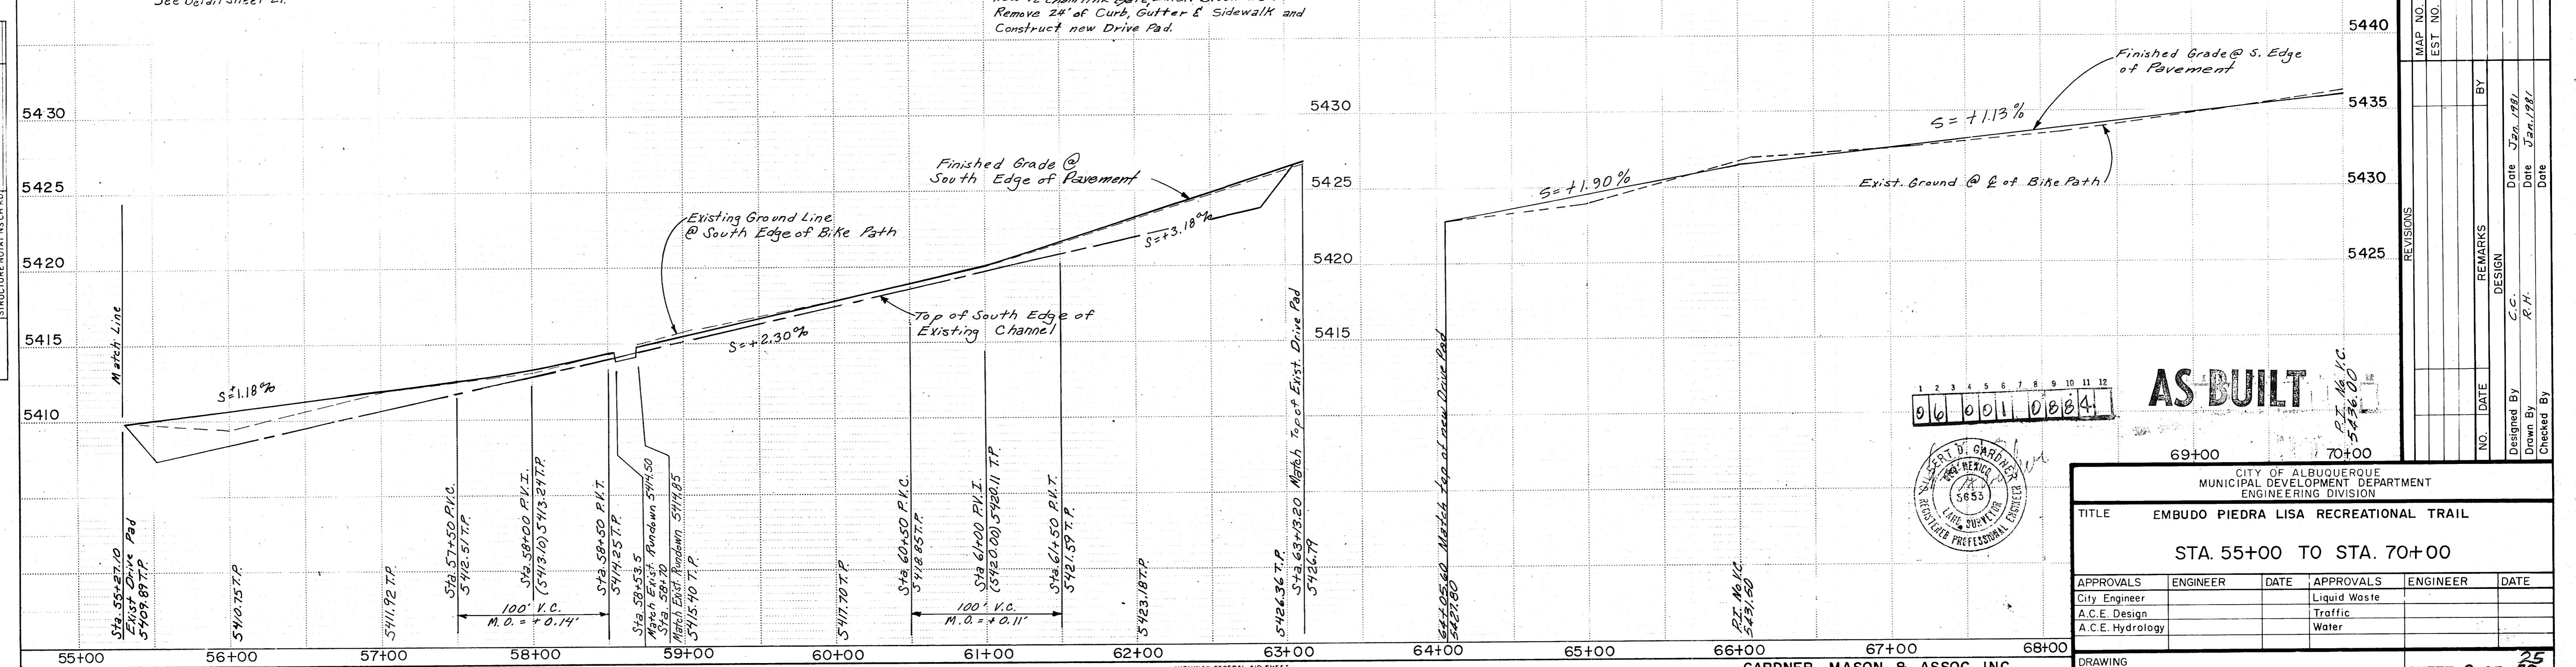AS-BUILT INFORMATION		
CONTRACTOR	GARDNER Brothers	
Work Accepted By	G.D.G.	Date 3/30/83
Drawing Checked By	Z.L.B.	Date 3/20/83
MICR - FILM INFORMATION		
Recorded By		Date
No.		




PLAN	SURVEYED	BY	DATE
PLotted	COMPONENT CHECKED		
NOTE BOOK NO.	RT OF WAY CHECKED		

PROFILE SURVEYED	BY	DATE
NOTE BOOK NO.	GRAVES CHECKED	
STRUCTURE NOTATNS CHCKD		

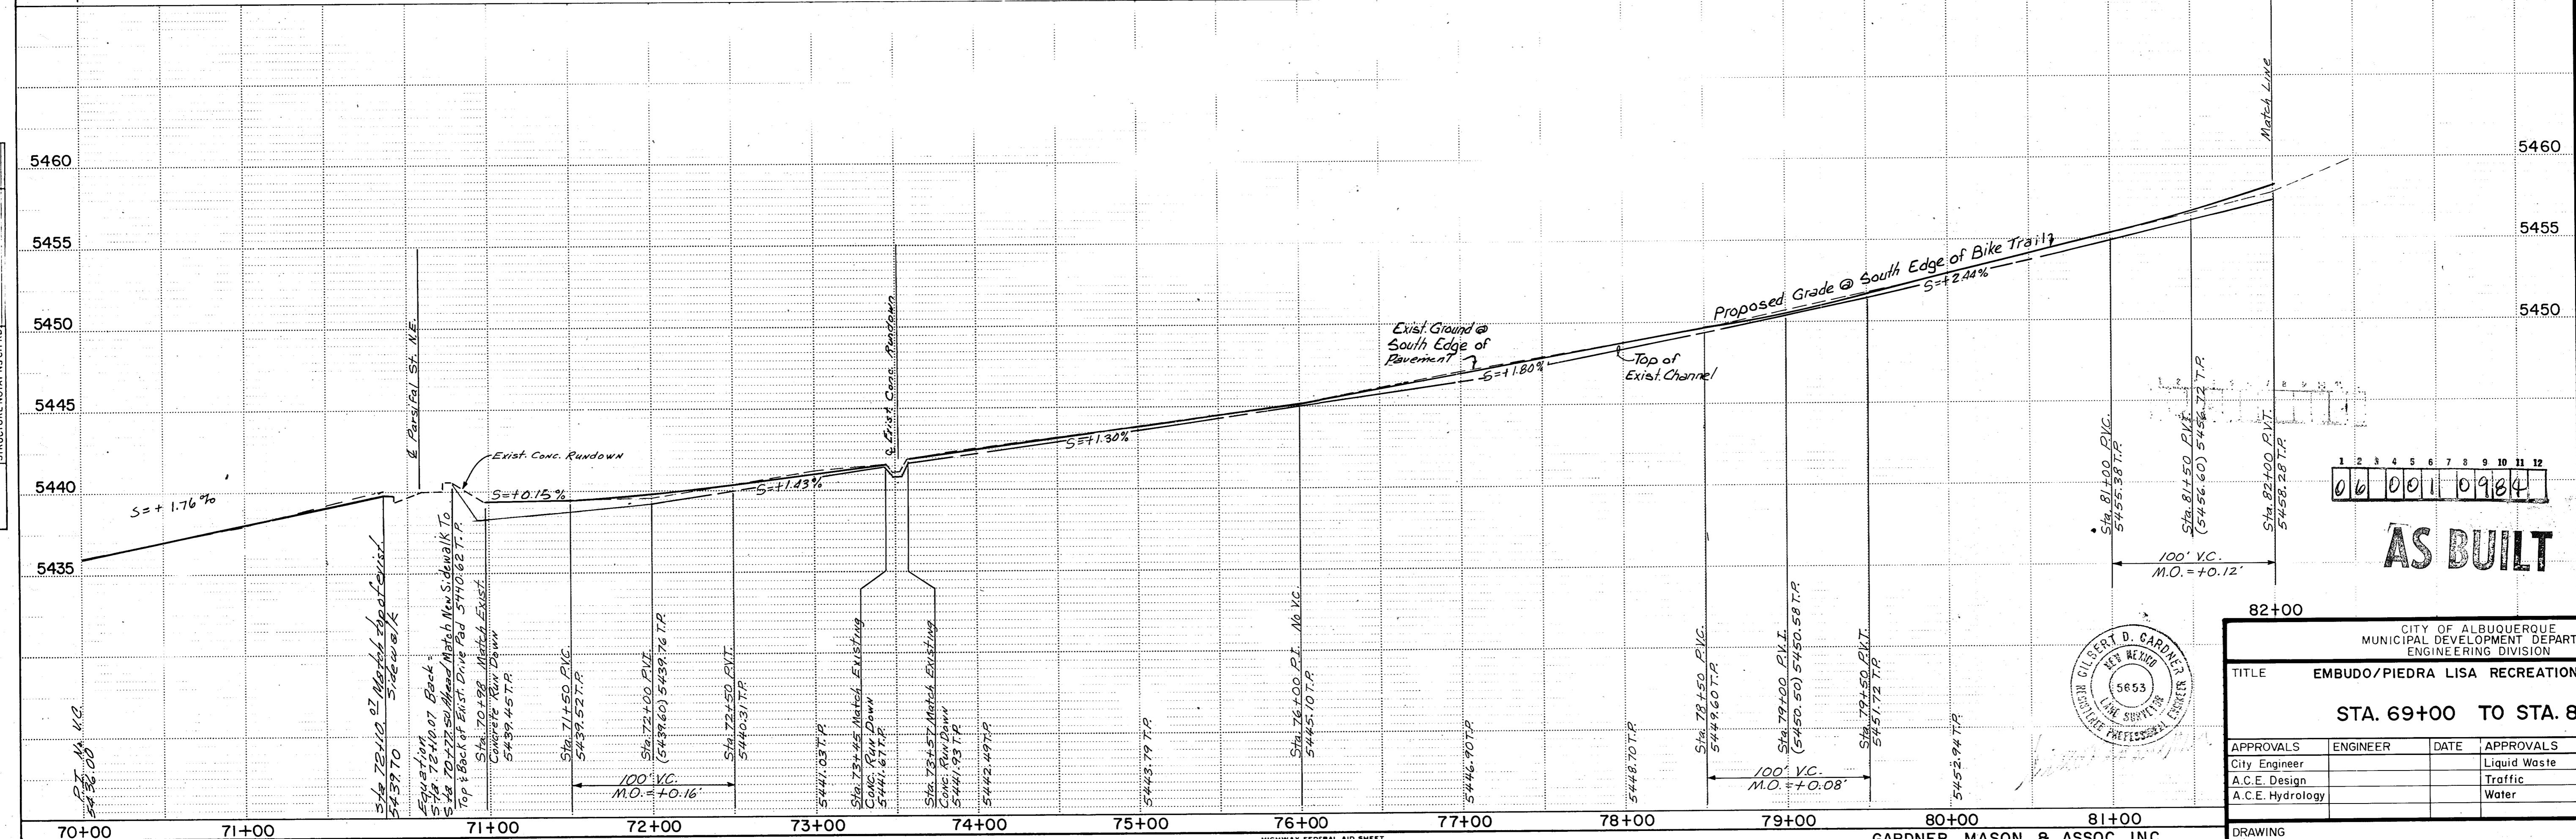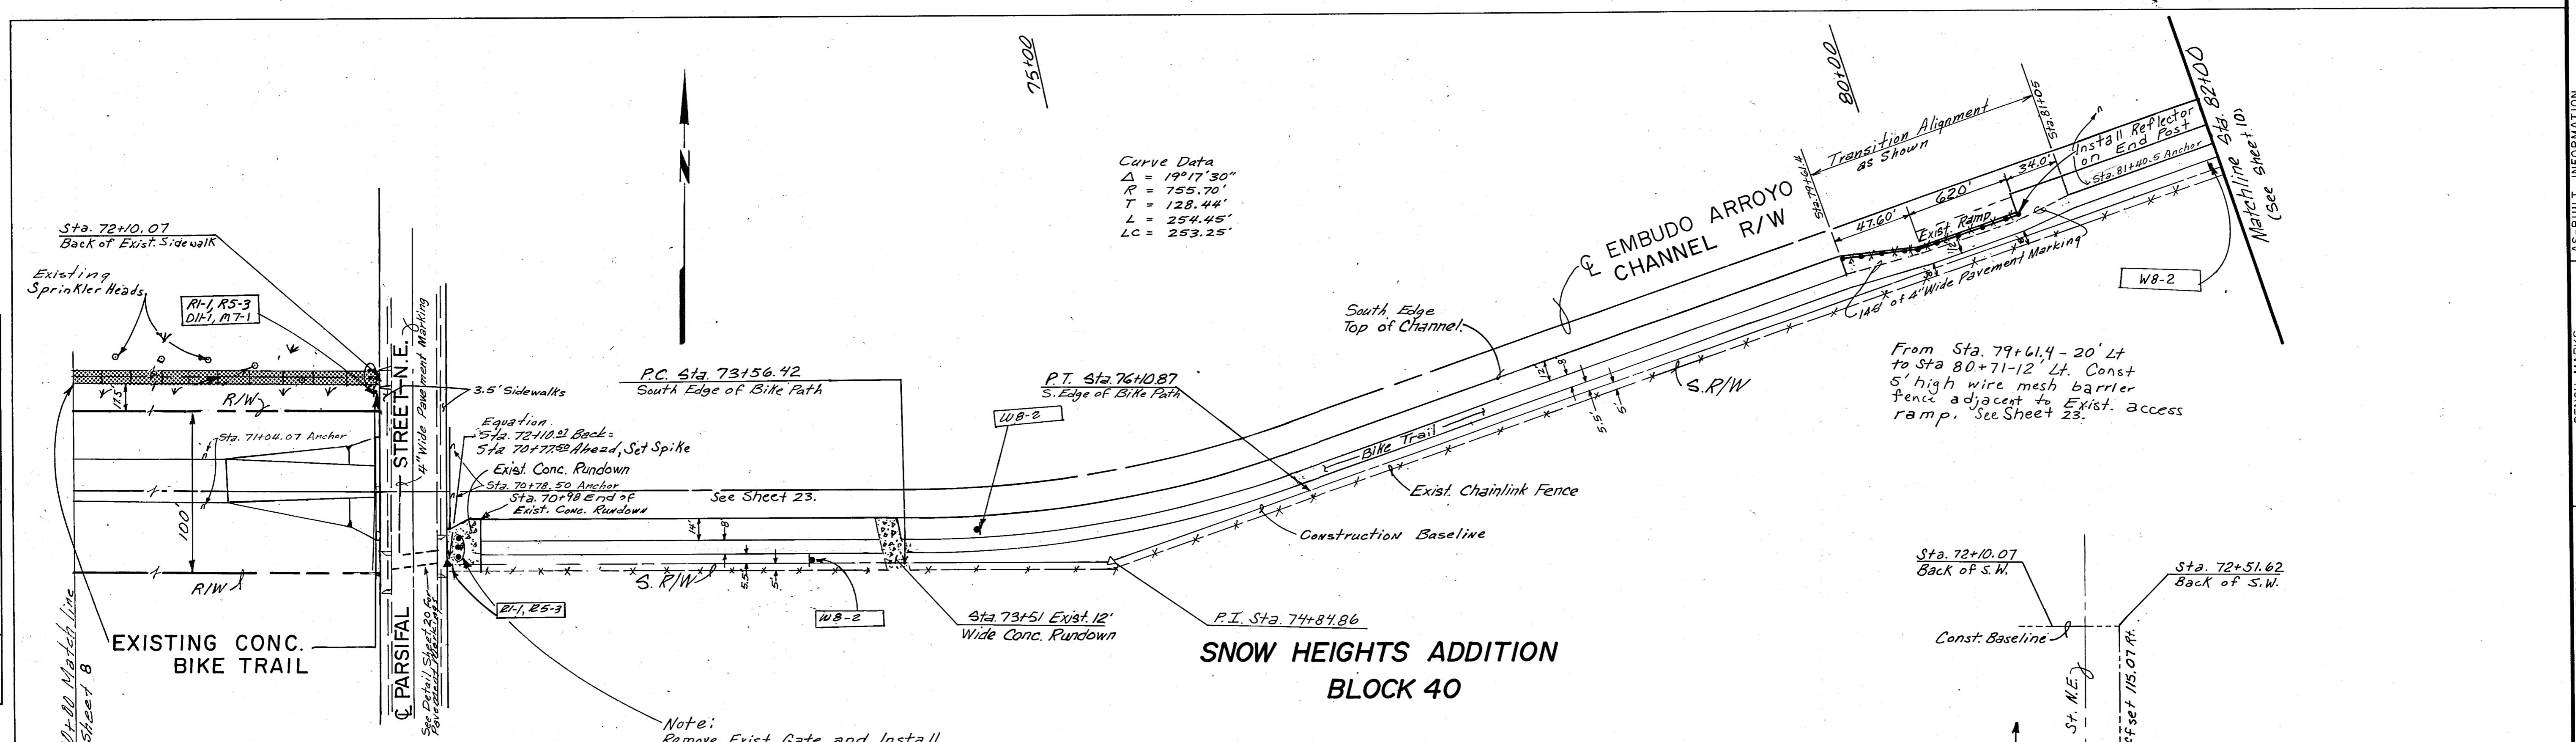

AS-BUILT INFORMATION			
CONTRACTOR	Gardner Brothers	BY	
Work Accurred By	G.P.G.	DATE	3/30/03
Drawing Corrected By	P.L.B.	DATE	3/30/03
MICRO-FILM INFORMATION			
Recorded By	No.		

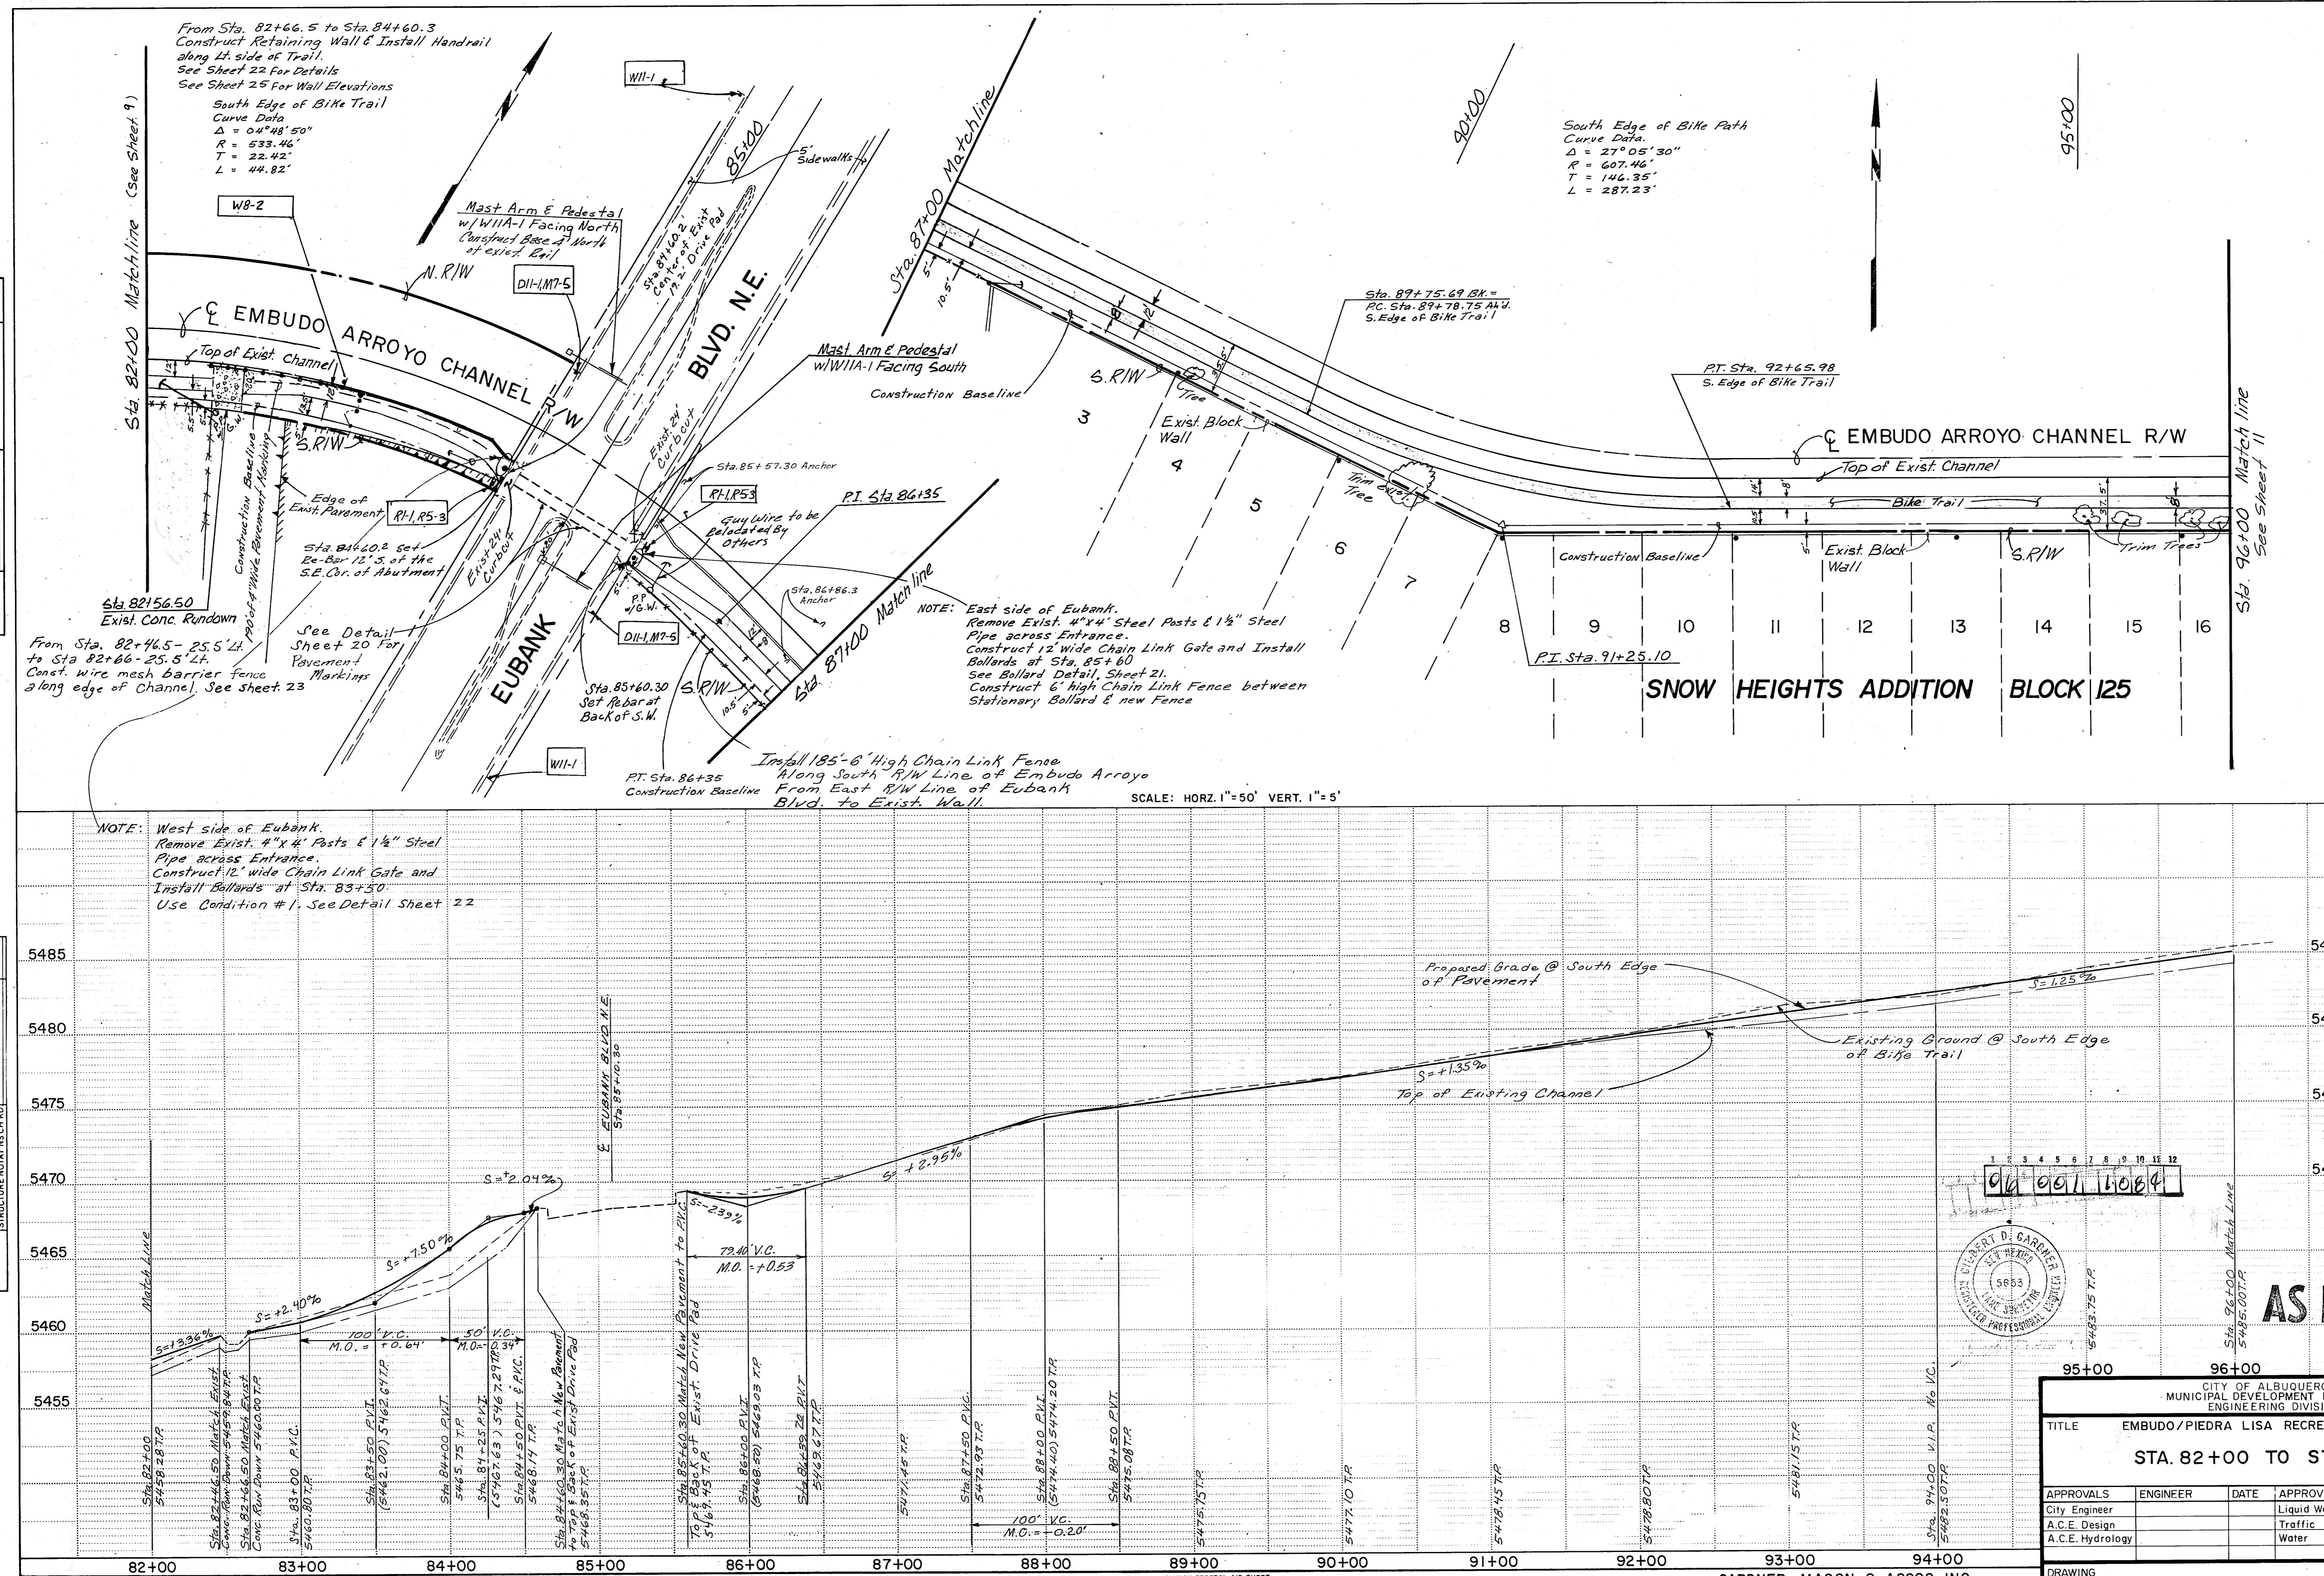


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NAL TRAIL  
96 + 00

	ENGINEER	D

SHEET 10 OF 2

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HIGHWAY FEDERAL AID SHEET  
PLATE 1-SINGLE PLAN AND PROFILE-FULL DOT  
  
TELEDYNE  
PRINTED IN U.S.A.


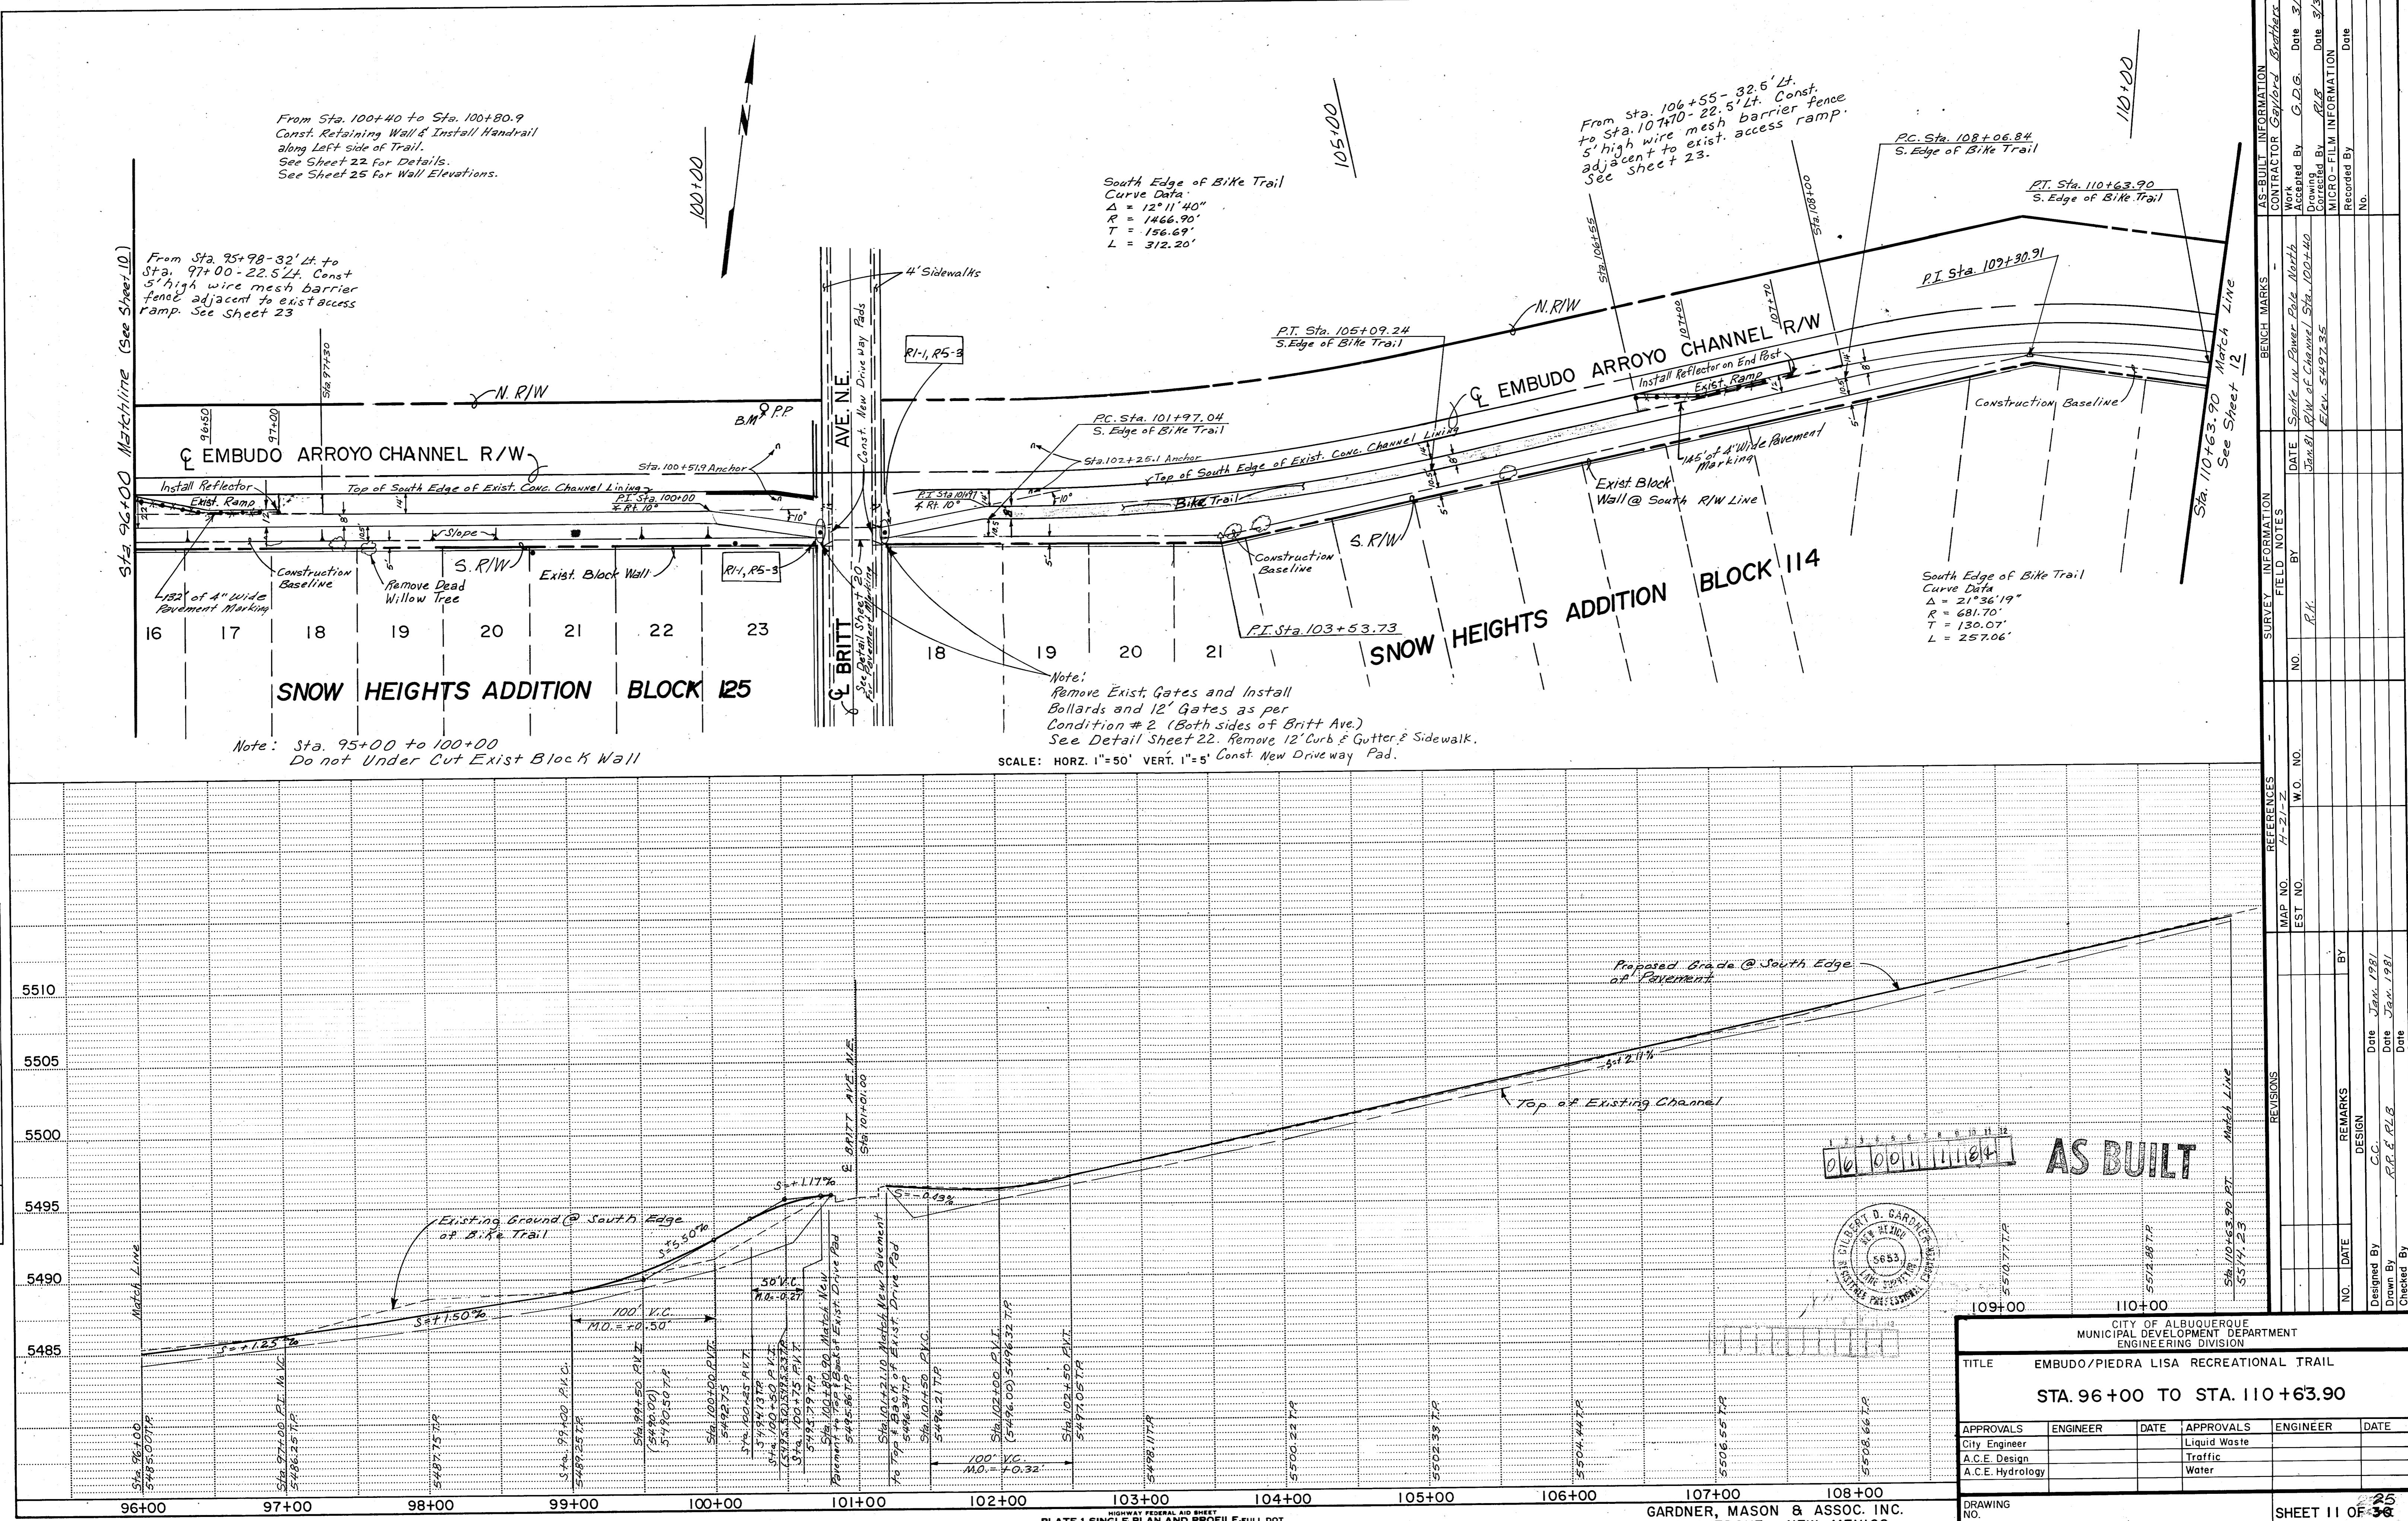
GARDNER, MASON & ASSOC. INC.  
ALBUQUERQUE, NEW MEXICO



**CITY OF ALBUQUERQUE  
MUNICIPAL DEVELOPMENT DEPARTMENT  
ENGINEERING DIVISION**

## EMBUDO/PIEDRA LISA RECREATIONAL TRAIL

# STA. 96+00 TO STA. 110+63.90

NG SHEET 11 OF 30 25

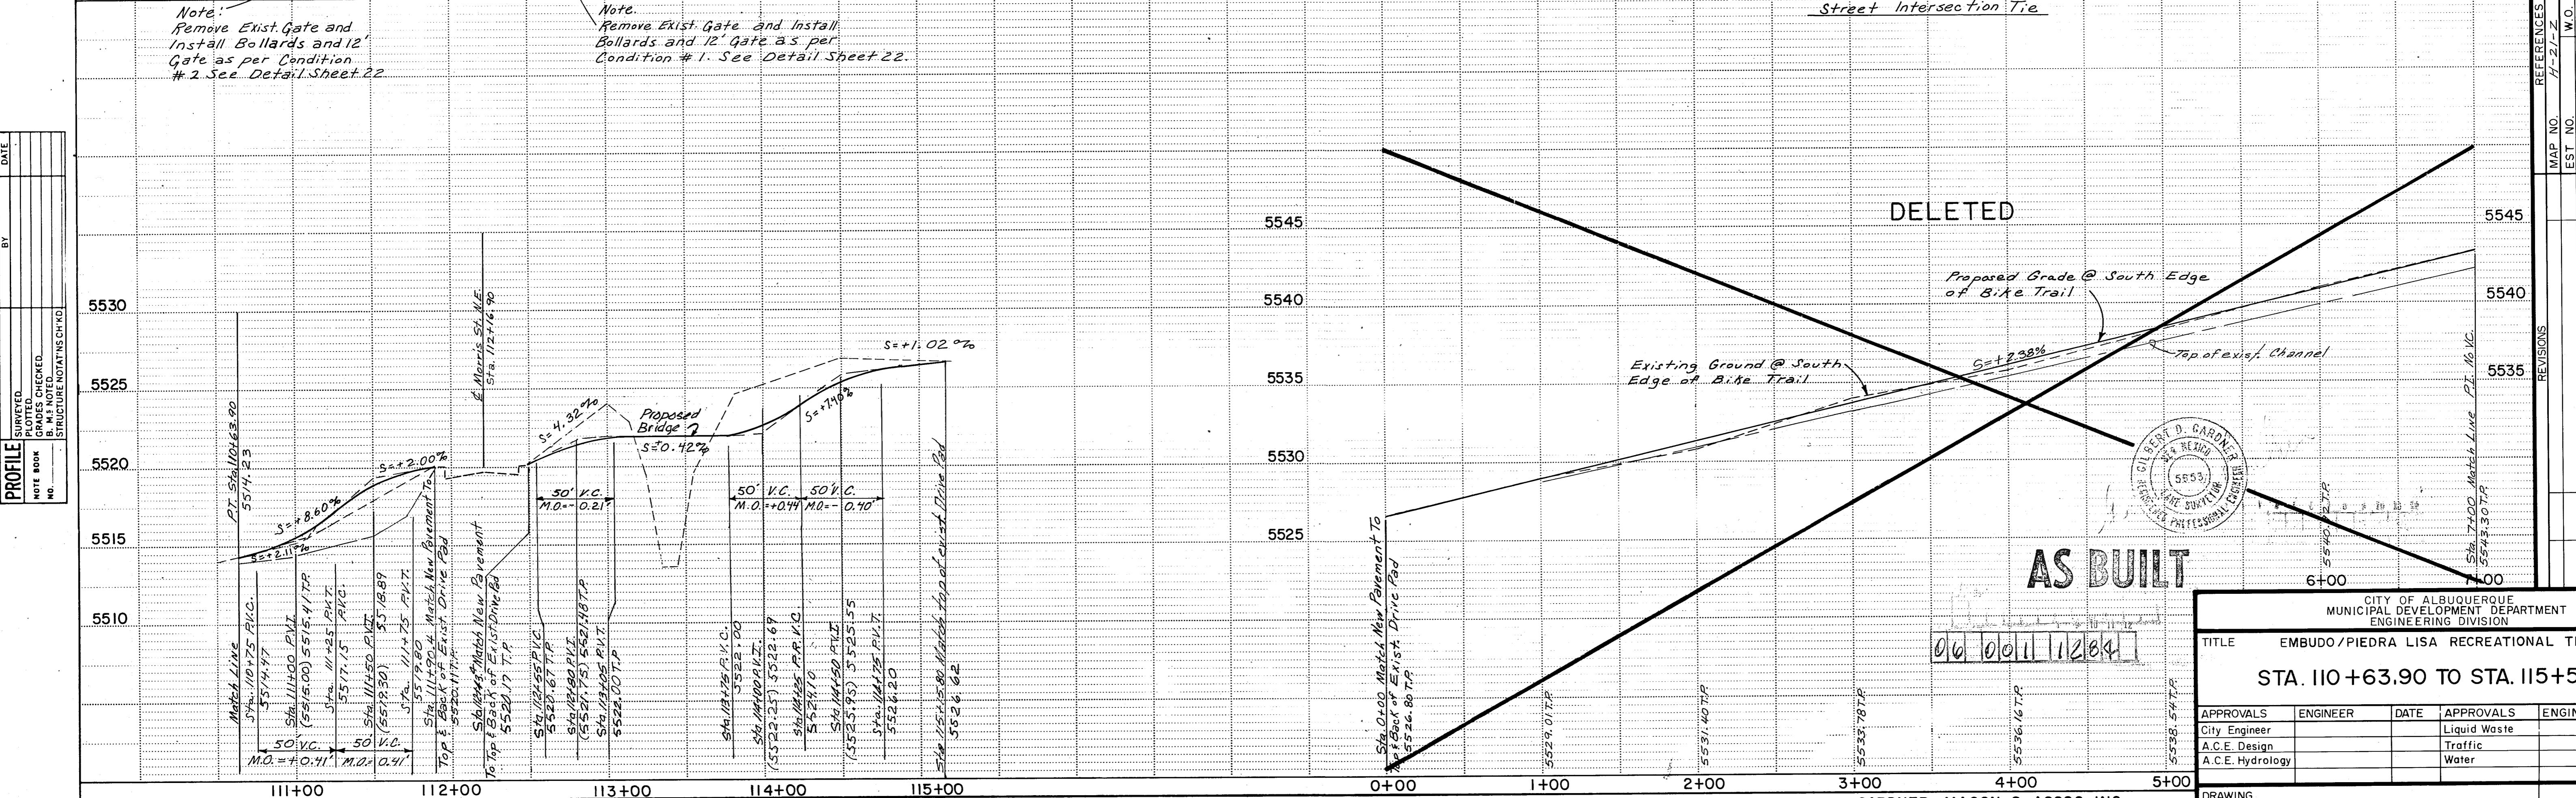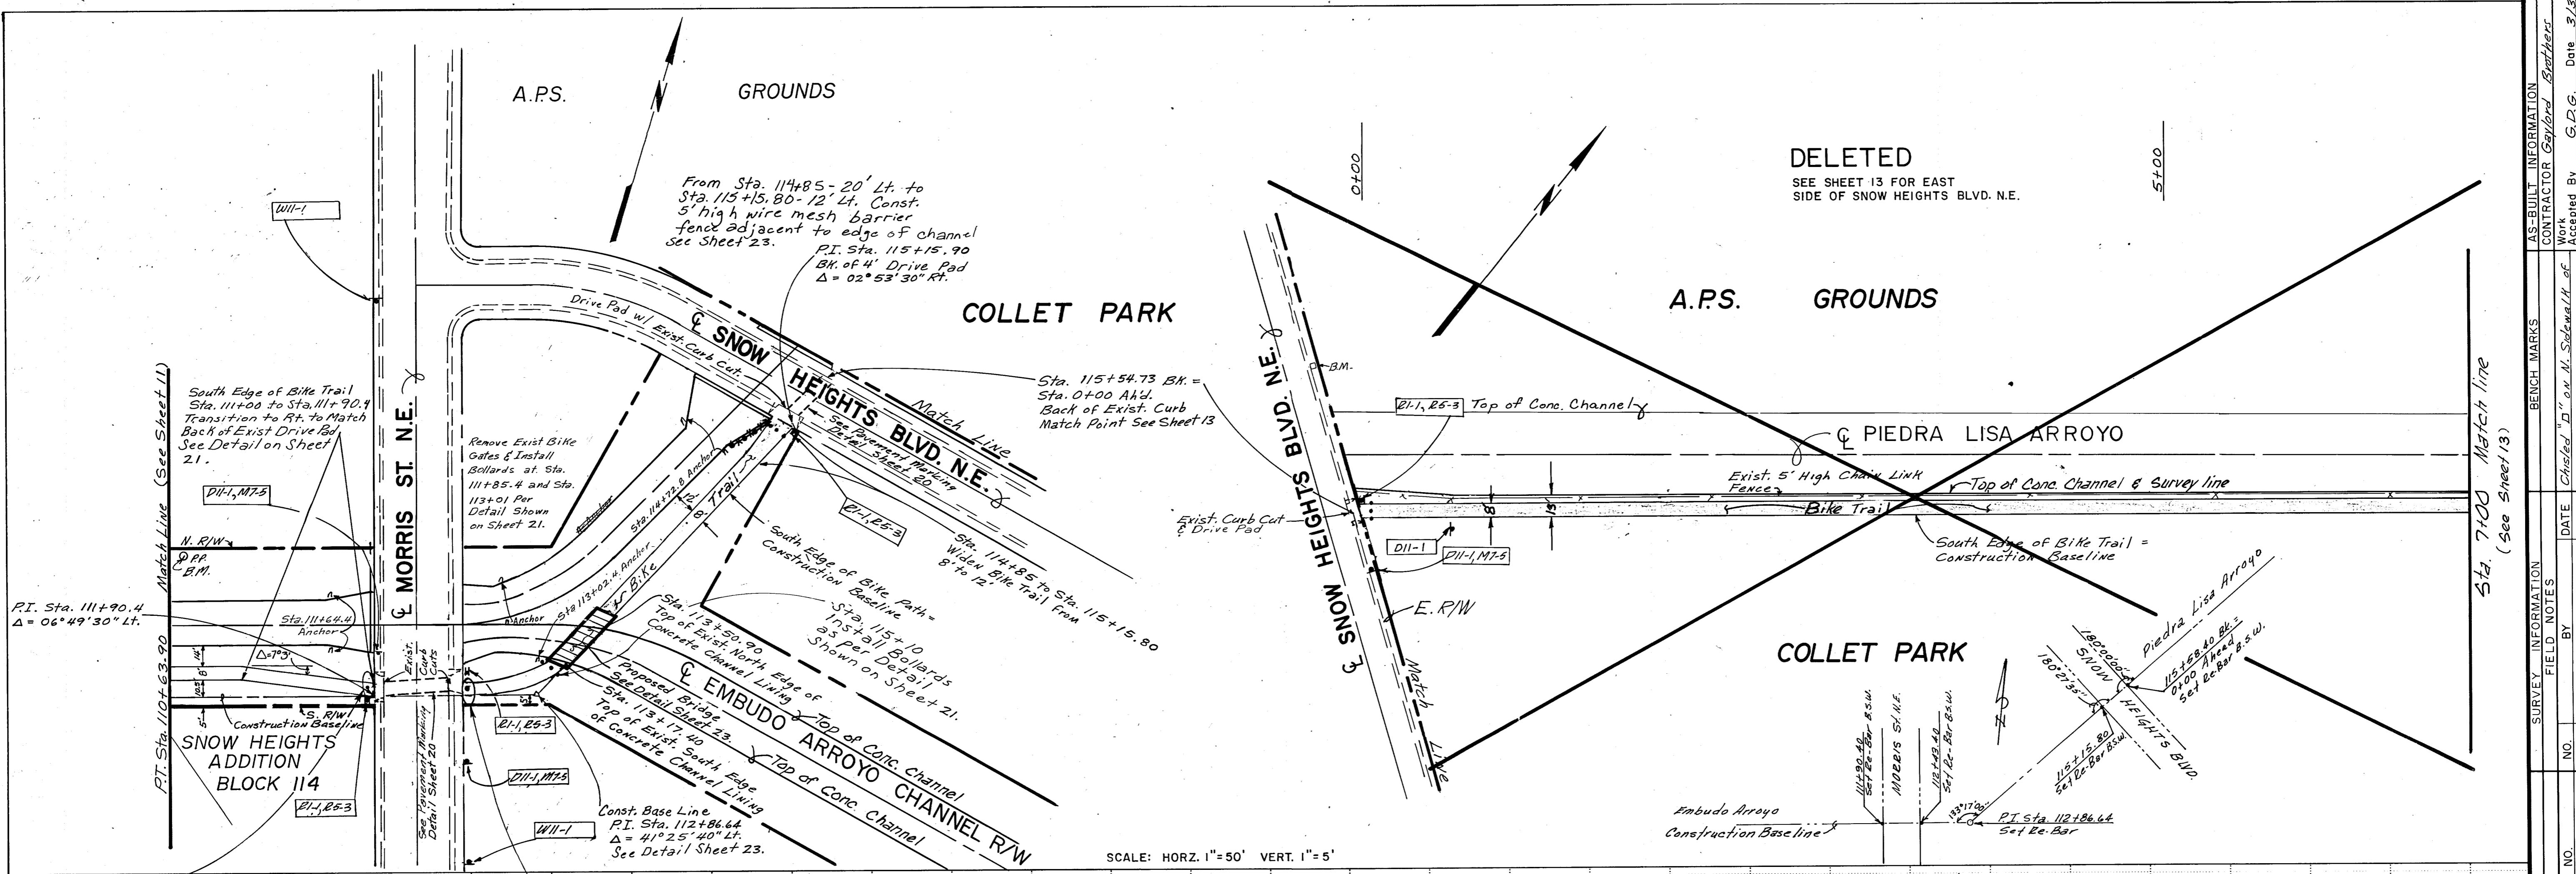

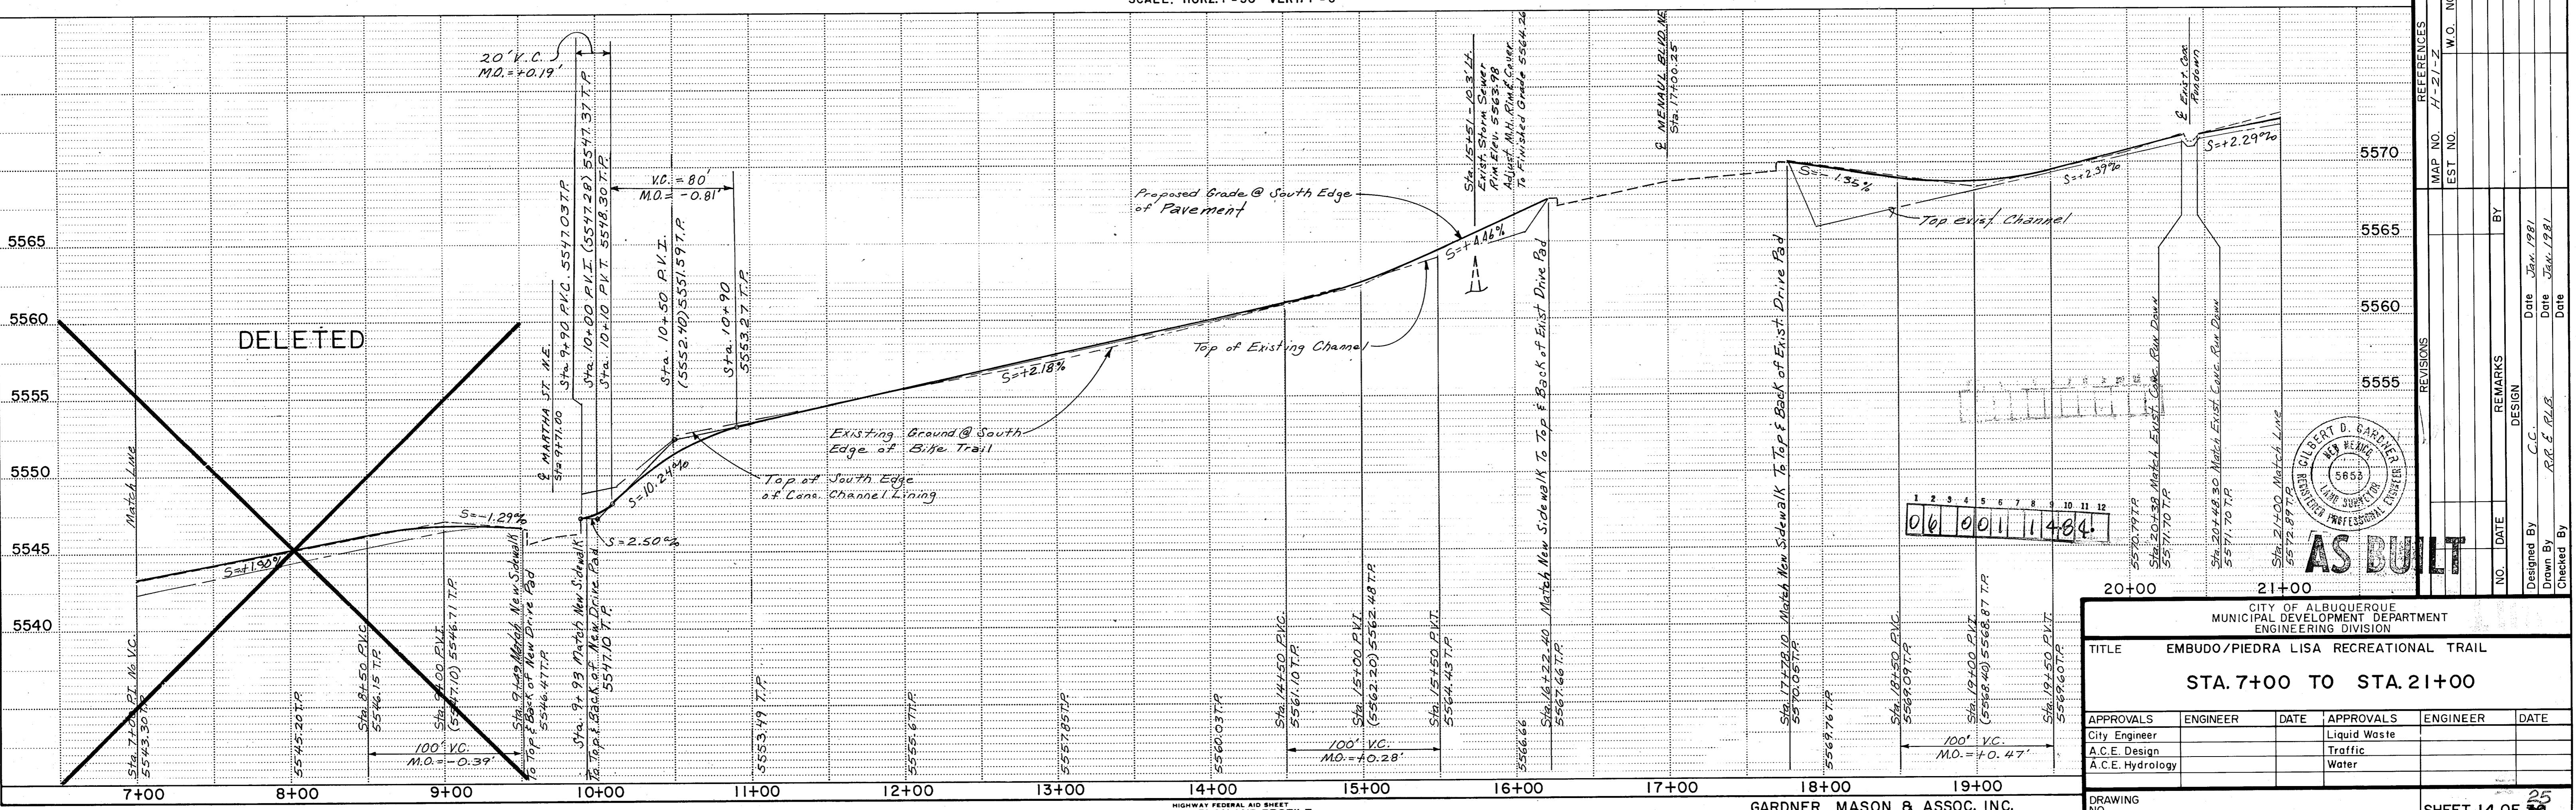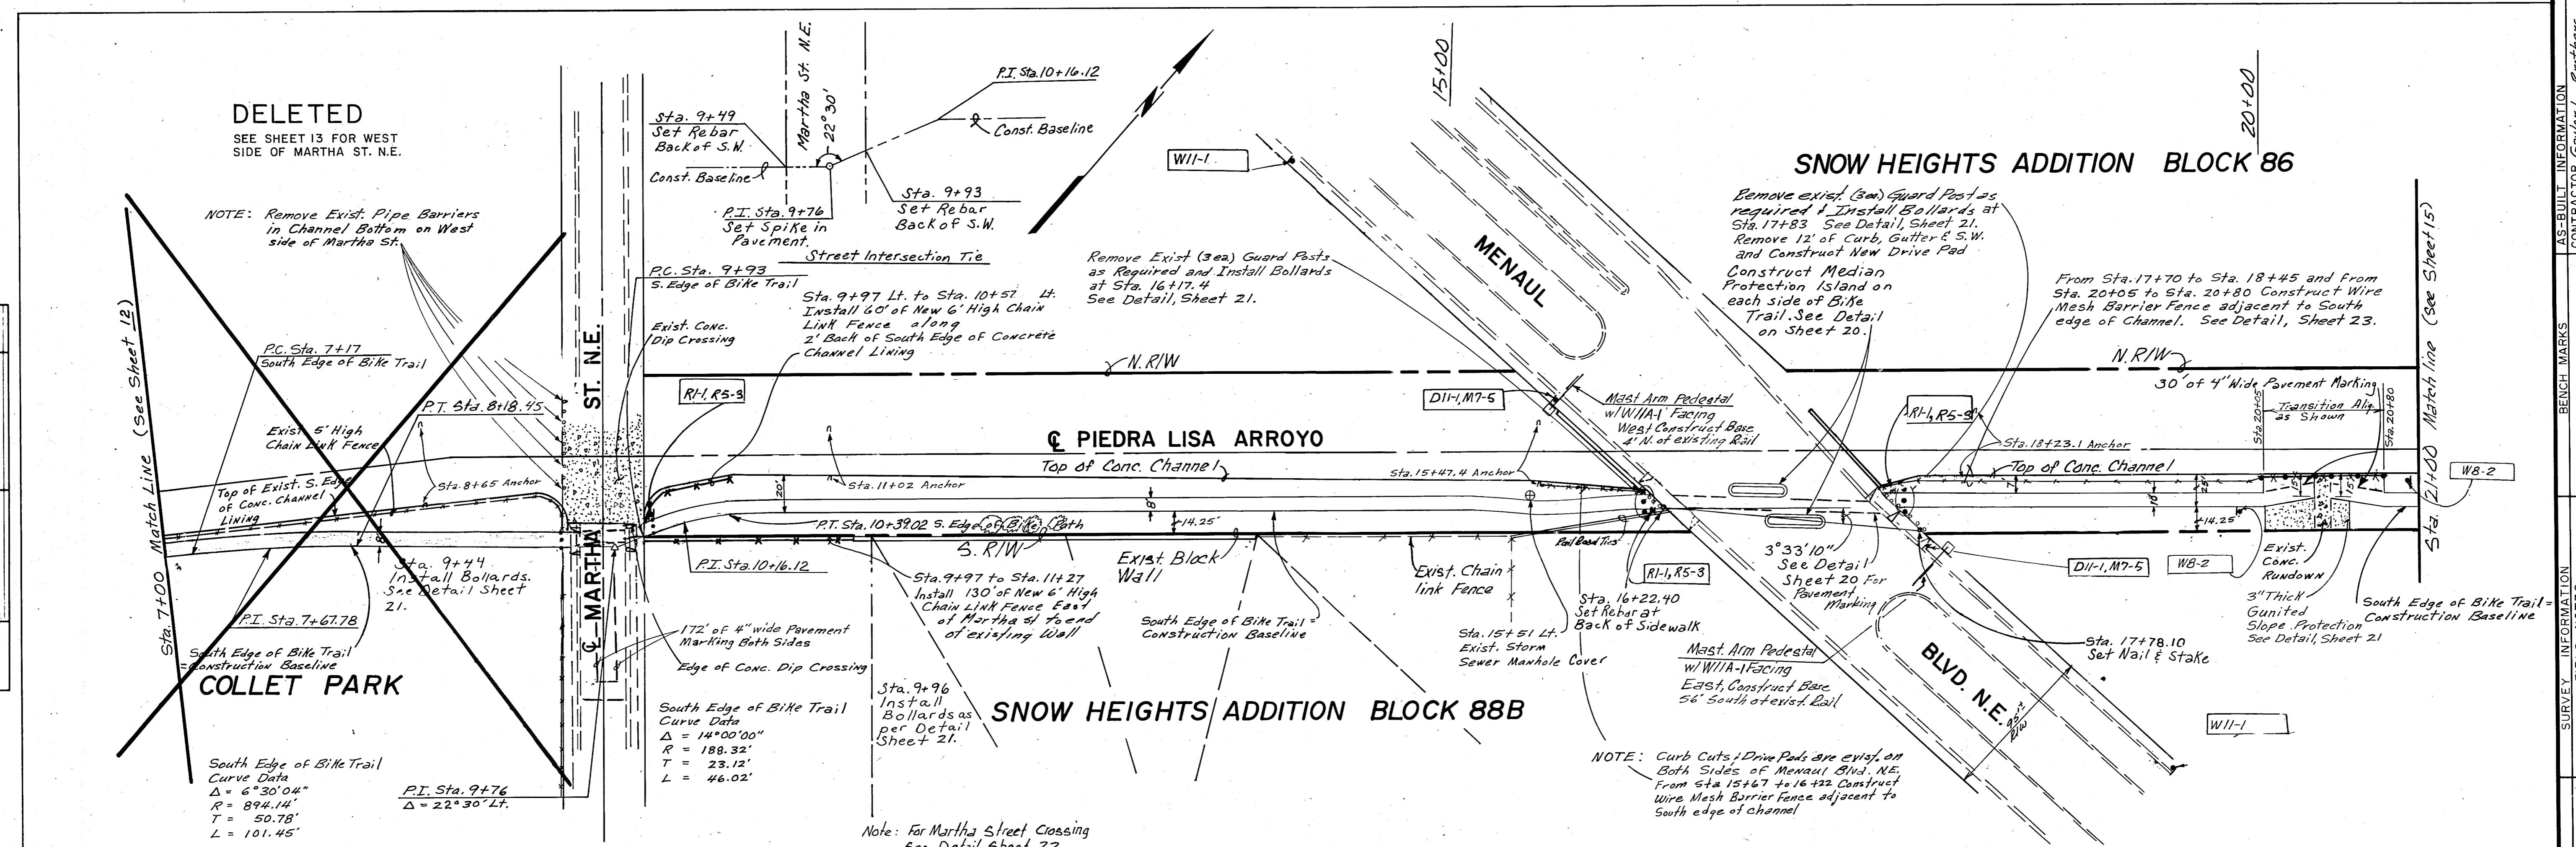

Remove 16' of Exist Curb, Gutter, & Sidewalk  
and Construct Curb Cut & Drive Pad  
on East Side Only.

**C PIEDRA LISA ARROYO**

Construction Baseline

Match Point Sta. 115+54.73 BK =  
Sta. 0+00 Abd.  
See Sheet 12

Top of Conc. Channel  
Anchor & 6" Structure  
Sta. 0-10 Begin 8' wide  
Asphalt Bike Trail

R9-6

DII-1 M7-1

333' B.T.B.

8'

Back of Curb = Construction Baseline

Exist. Chain Link Fence relocated  
by Parks & Recreation Dept.

Sta. 2+13.42 PC.

Sta. 2+34.00 PT.

2-9R-6

8'

Back of Curb = Construction Baseline

Exist. Chain Link Fence relocated  
by Parks & Recreation Dept.

Sta. 9+85.01 PC.

R9-6

8'

Back of Curb = Construction Baseline

Sta. 10+71.81 PC.  
Begin Exist. 3.8' S.W.

Sta. 10+14.96 PT.

Sta. 10+94.36 P.O.C.

12° 48' 25"

Construction Baseline


7' From Back of Curb Both Sides  
172' of 4" wide Pavement Marking

See Detail Sheet 20 For Pavement Marking

N. 37° 24' 00"E.

Curve Data Back of Curb

COLLET PARK

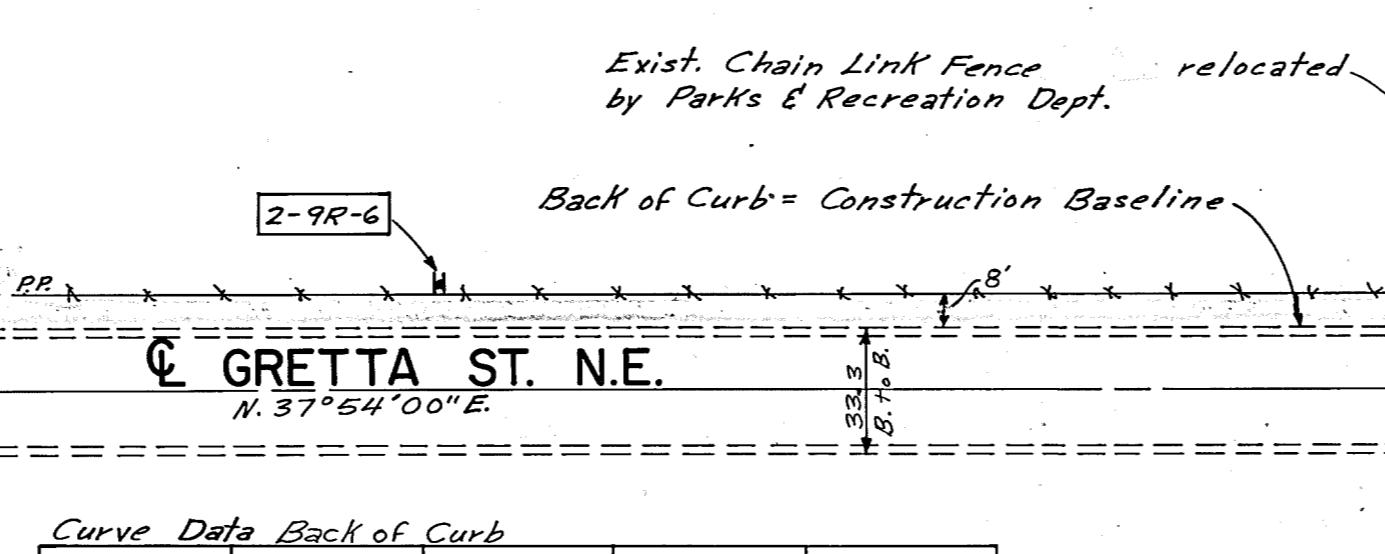

SCALE: HORZ. 1"=50' VERT. 1"=5'

**C MARTHA ST. N.E.**  
N. 14° 51' 10"W.

Match Point Pt. Sta. 9+76 Abd =  
Sta. 12+58.97 BK.  
See Sheet 14

Sta. 11+59.67 End Bike Trail  
on Collet Park

Sta. 11+41.07 PT.

Sta. 10+14.96 PT.

Sta. 9+85.01 PC.

R9-6

8'

Back of Curb = Construction Baseline

Sta. 10+71.81 PC.  
Begin Exist. 3.8' S.W.

Sta. 10+14.96 PT.

Sta. 10+94.36 P.O.C.

12° 48' 25"

Construction Baseline

7' From Back of Curb Both Sides  
172' of 4" wide Pavement Marking

See Detail Sheet 20 For Pavement Marking

N. 63° 29' 00"E.

Curve Data Back of Curb

Curve No. 1 2 3 4

Delta 78° 50' 00" 25° 35' 00" 96° 00' 10" 18° 40' 00"

Radius 14.96' 67.07' 13.46' 143.36'

Tangent 12.30' 15.23' 14.95' 23.56'

Length 20.58' 29.95' 22.55' 46.71'

12° 48' 25"

Construction Baseline

7' From Back of Curb Both Sides  
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Construction Baseline

7' From Back of Curb Both Sides  
172' of 4" wide Pavement Marking

See Detail Sheet 20 For Pavement Marking

N. 63° 29' 00"E.

Curve Data Back of Curb

Curve No. 1 2 3 4


Delta 78° 50' 00" 25° 35' 00" 96° 00' 10" 18° 40' 00"

Radius 14.96' 67.07' 13.46' 143.36'

Tangent 12.30' 15.23' 14.95'


PLAN	SURVEYED	BY	DATE
PLOTTED			
NOTE BOOK			
GRADES CHECKED			
STRUCTURE ROTATING CHK'D			
NO.			



PROFILE	SURVEYED	BY	DATE
PLOTTED			
NOTE BOOK			
GRADES CHECKED			
STRUCTURE ROTATING CHK'D			
NO.			

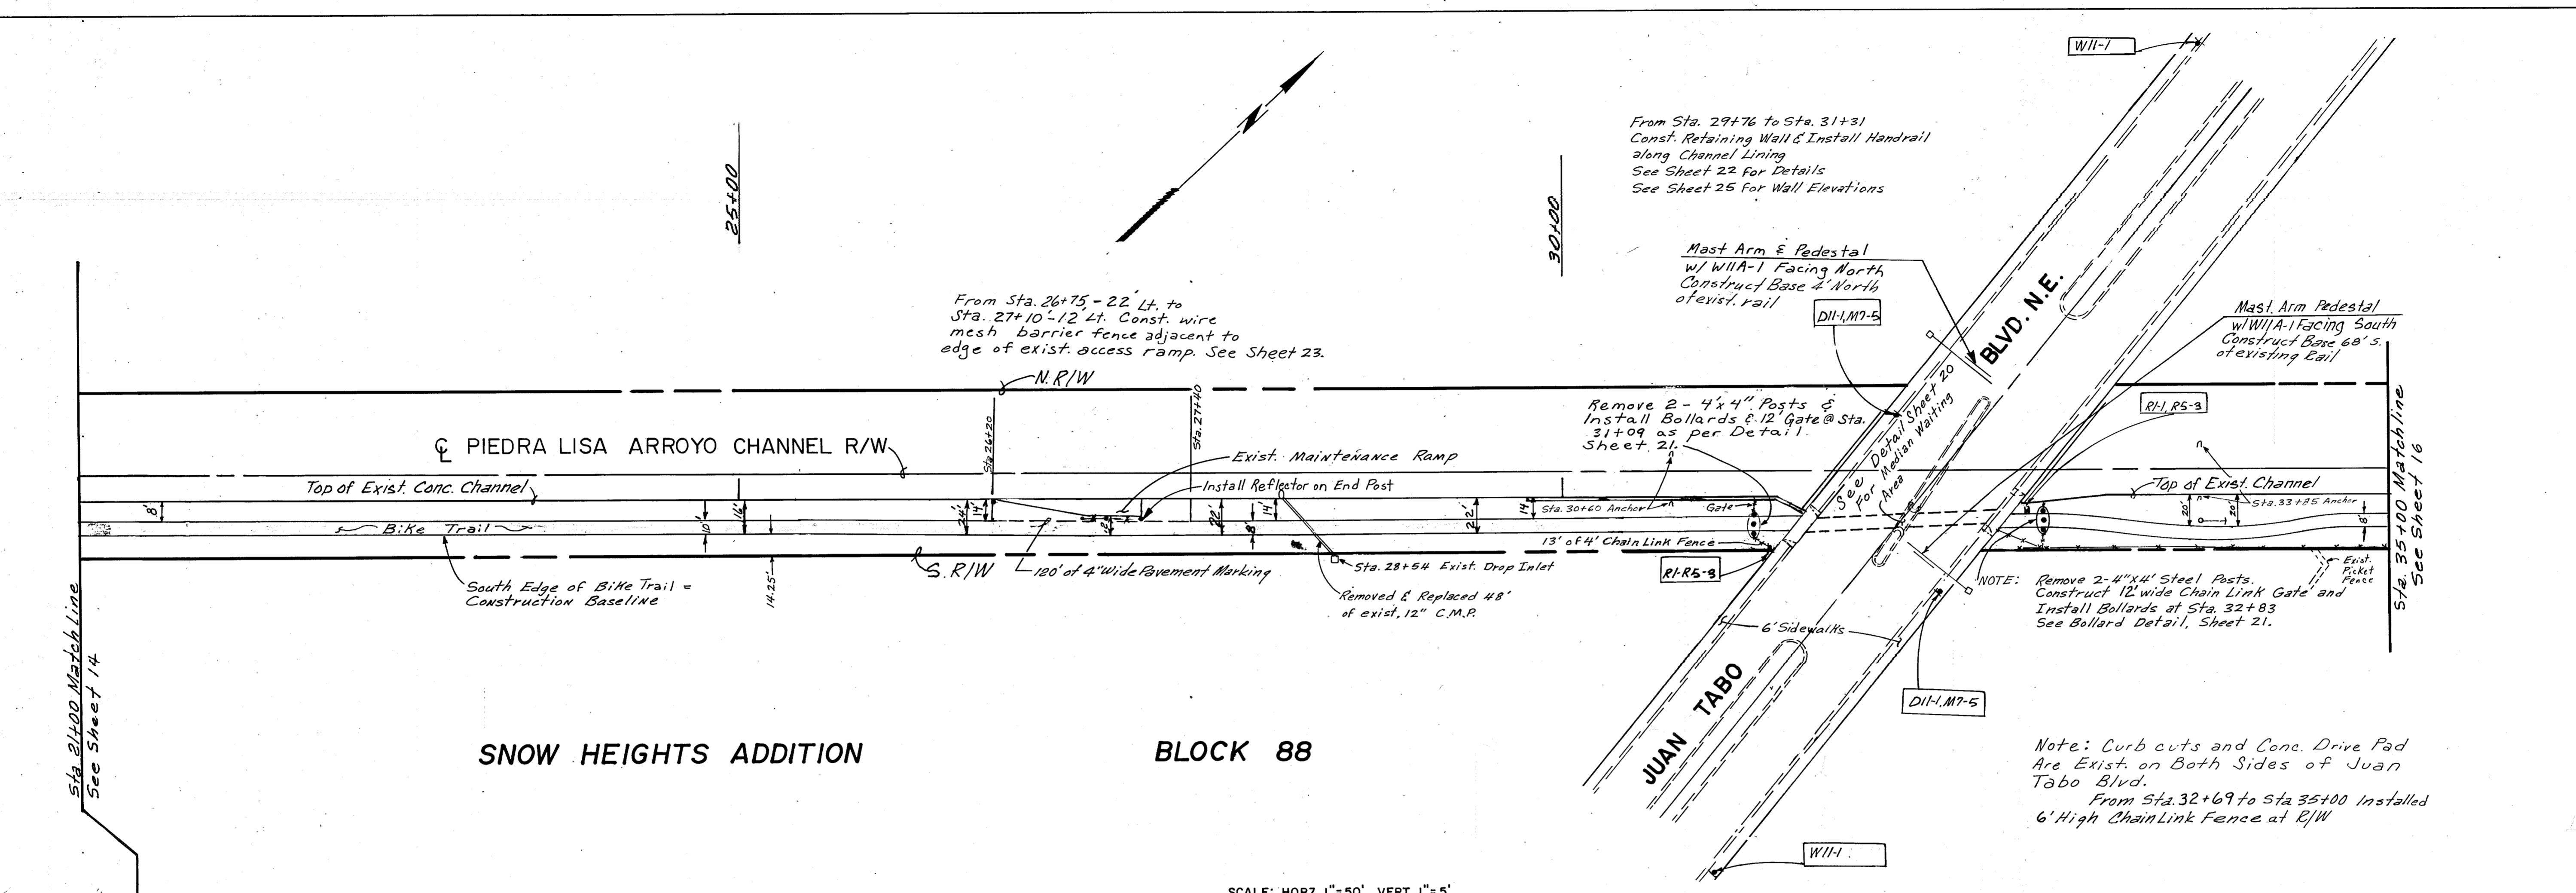

### SNOW HEIGHTS ADDITION


### BLOCK 88

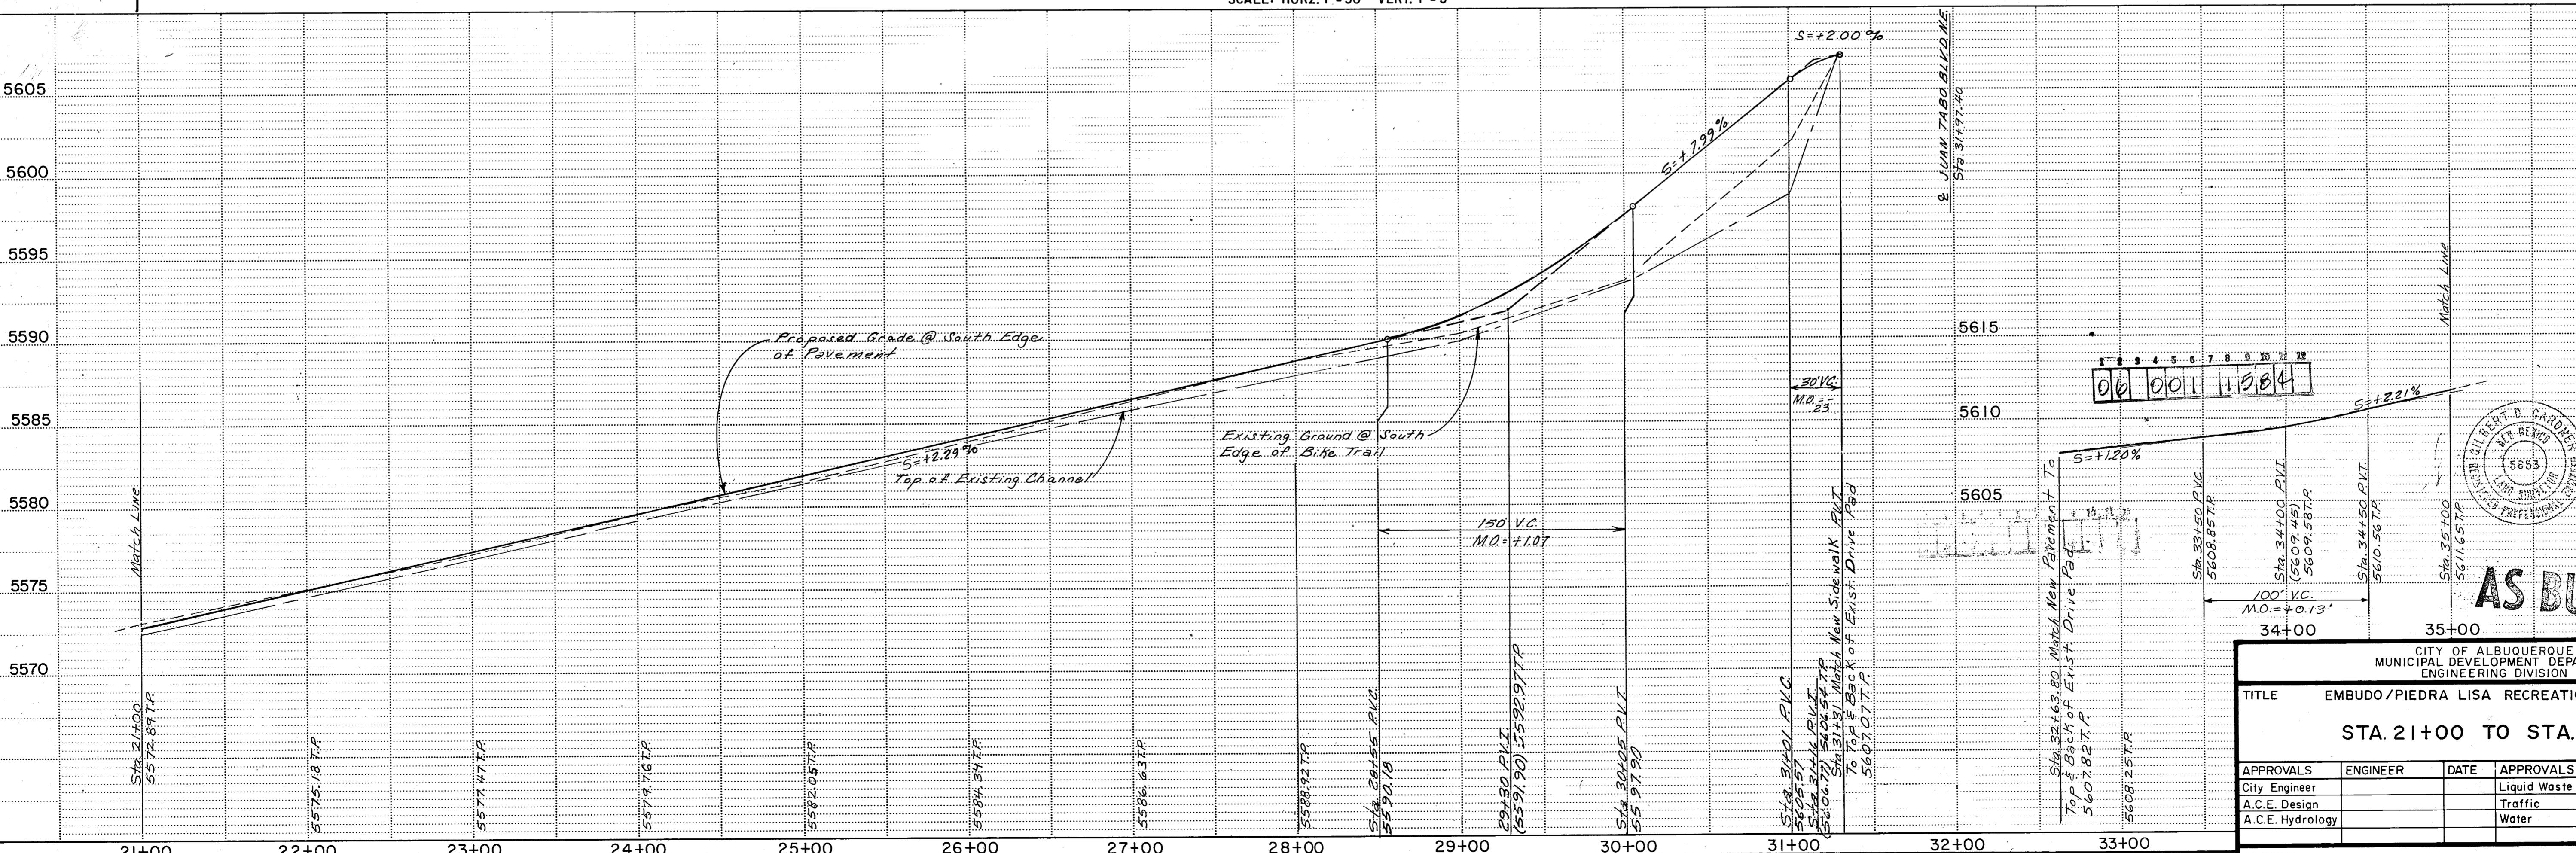

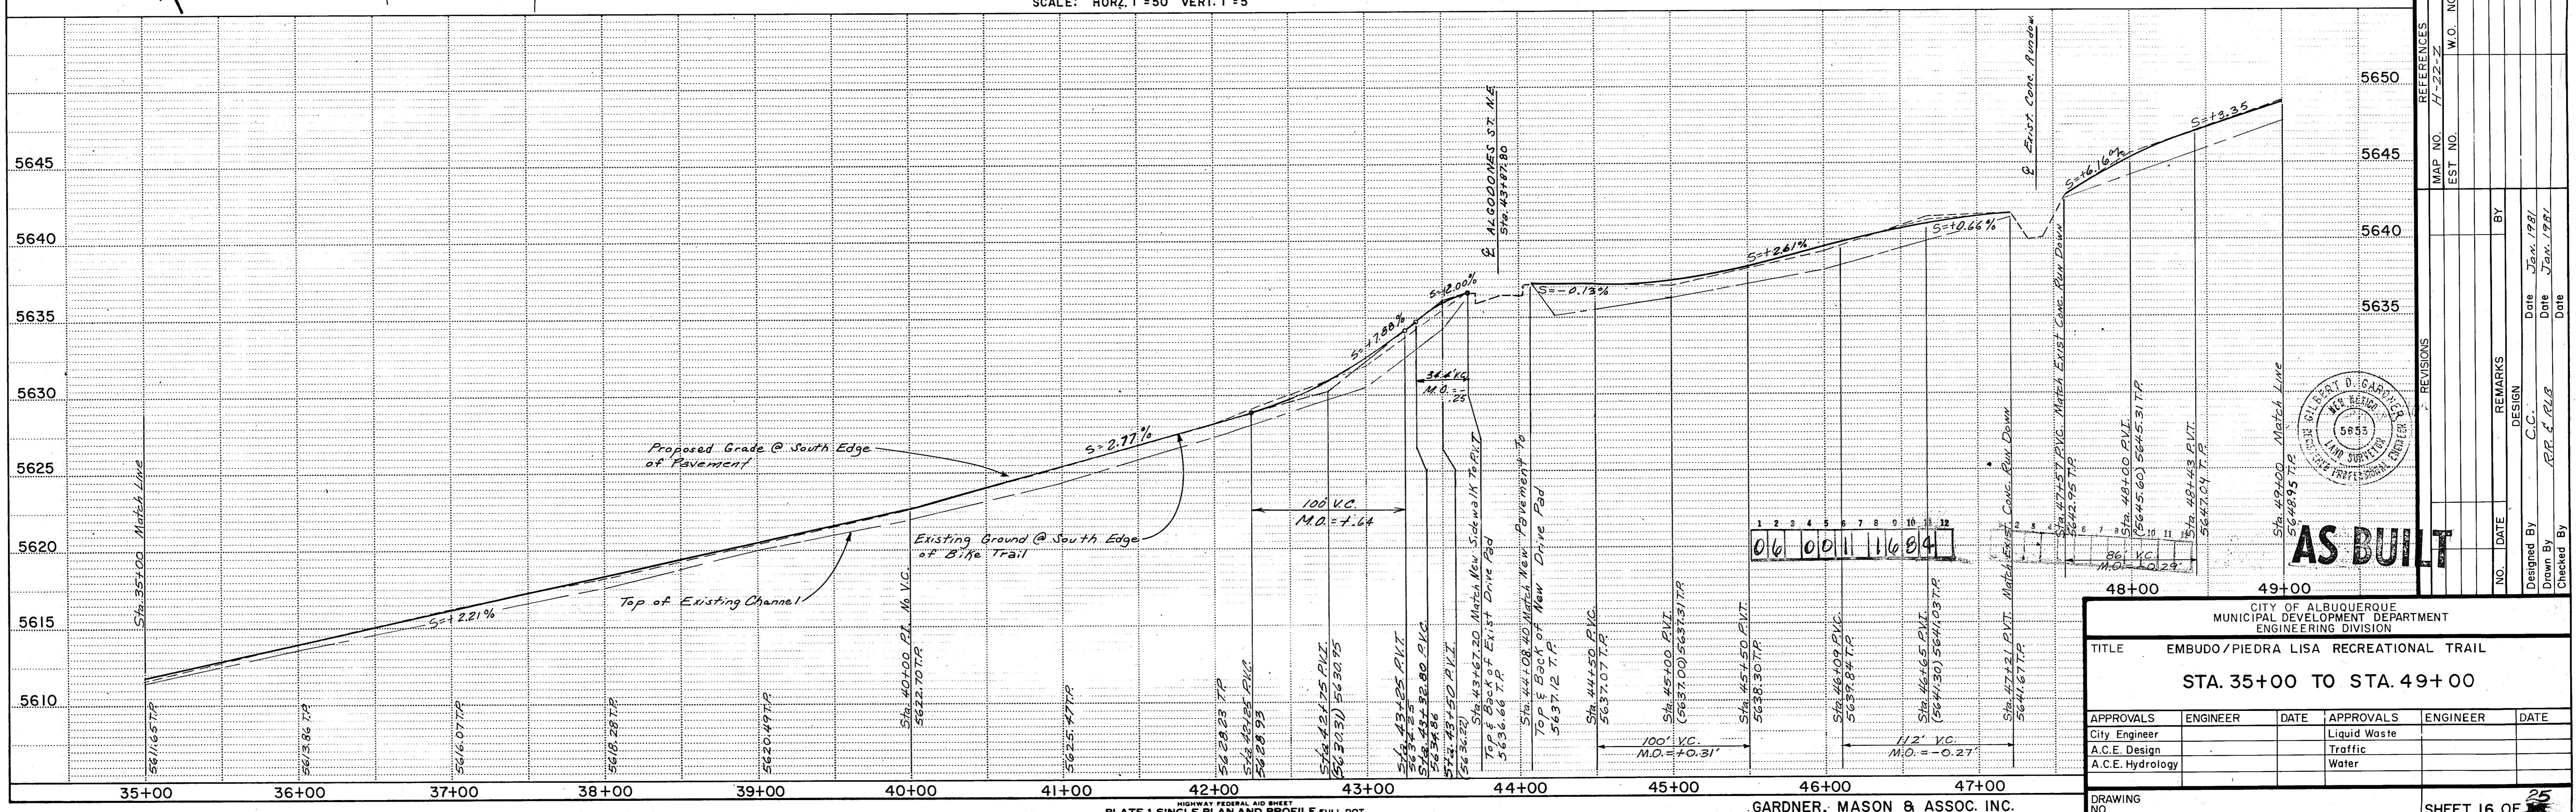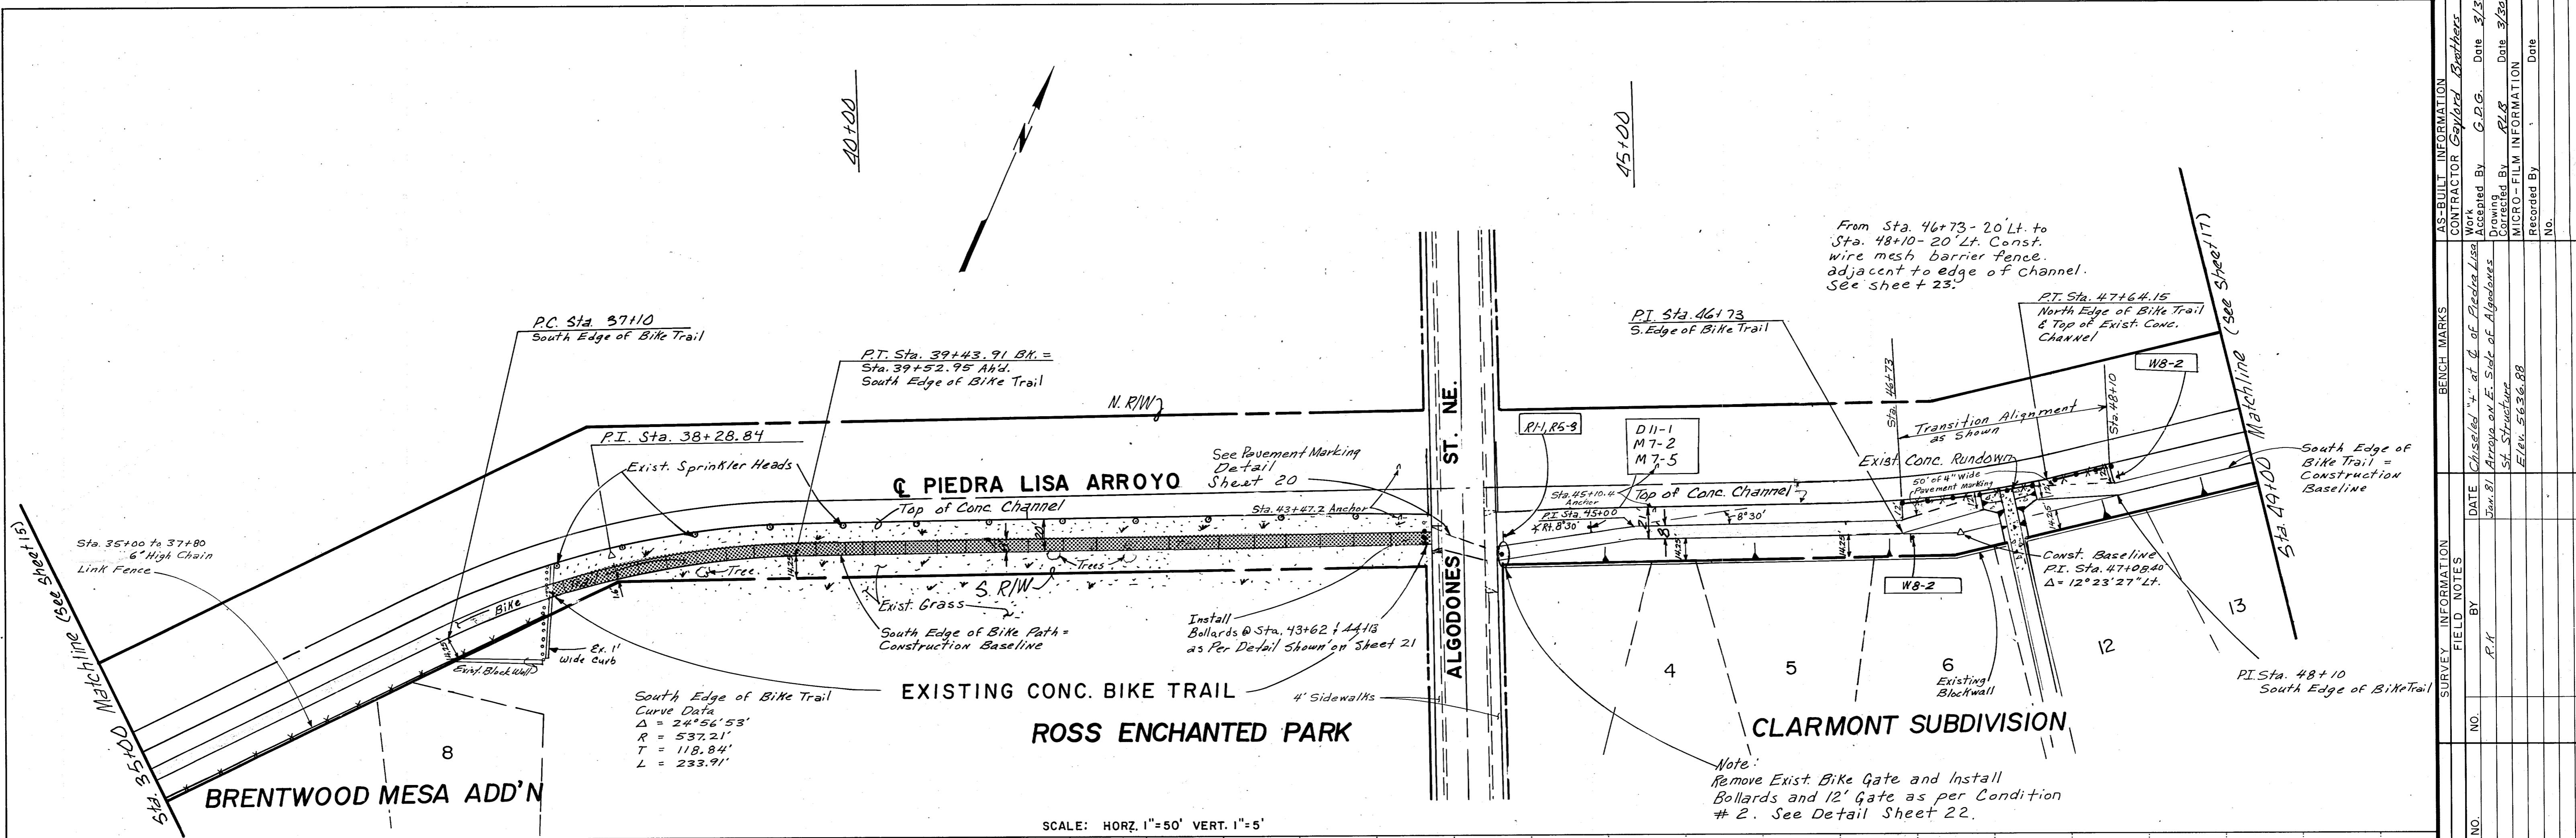

Sta. 49+00 Matchline (see sheet 16)

PLAN	SURVEYED	BY	DATE
PILOTTED			
GRADES CHECKED			
G.M. NO.			
STRUCTURE ROTATNS CHCKD			

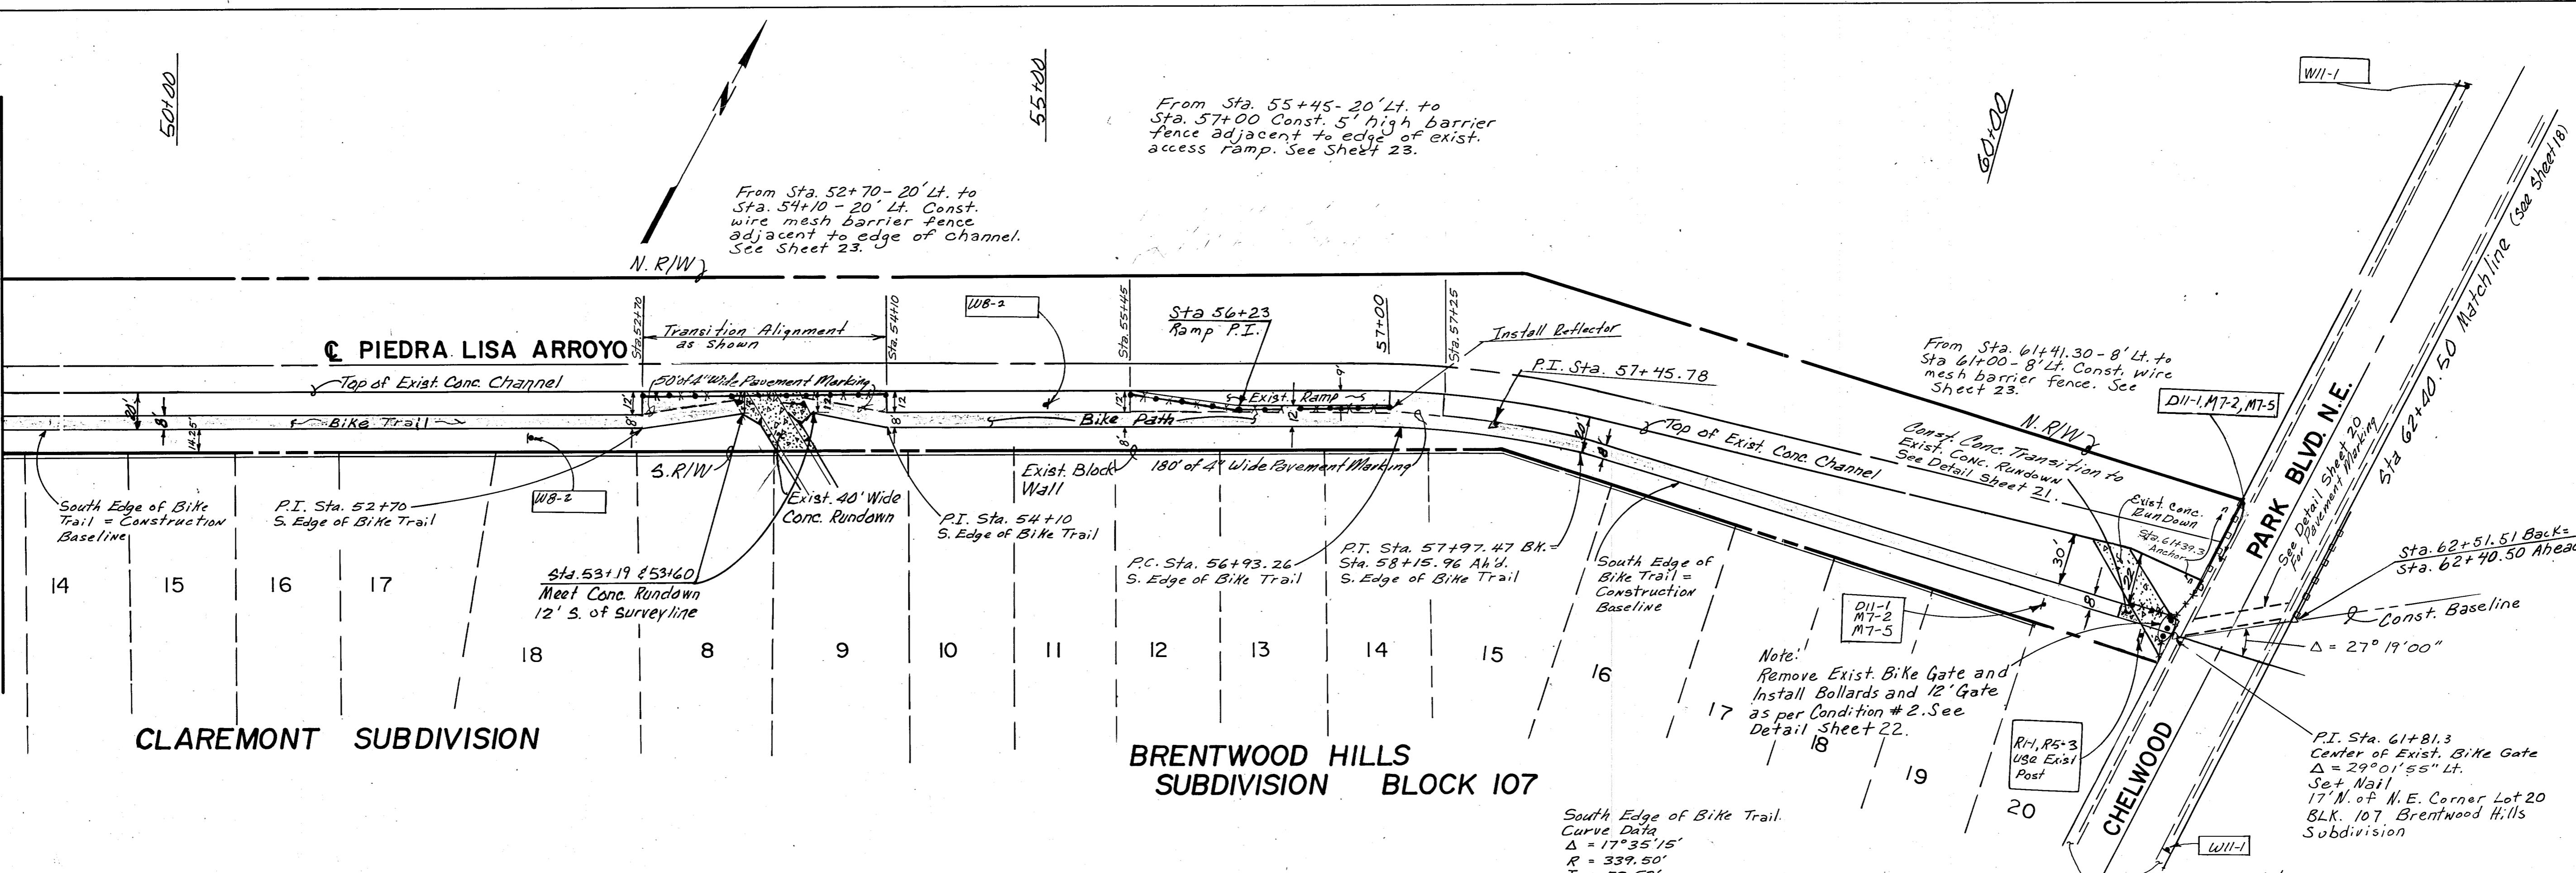

AS-BUILT INFORMATION	CONTRACTOR	DATE
Work Performed By	G.D.G.	Date 3/20/88
Drawn By	R.B.	Date 3/20/88
Checked By		
Microfilm Information		
Recorded By	No.	

REVISIONS	REFERENCES
	MAP NO. H-22-Z EST. NO. W.O. NO. BY DATE
	Set Nail
	17' N. of N.E. Corner Lot 20 BLK. 107 Brentwood Hills Subdivision

APPROVALS	ENGINEER	DATE	APPROVALS	ENGINEER	DATE
City Engineer	Liquid Waste		A.C.E. Design	Traffic	
A.C.E. Hydrology	Water				

DRAWING NO. SHEET 17 OF 25


REMARKS	BY
DESIGN	C.C.
Drawn By	R.P.E.R.B.
Checked By	Date Jan. 1981


AS BUILT

CITY OF ALBUQUERQUE  
MUNICIPAL DEVELOPMENT DEPARTMENT  
ENGINEERING DIVISION  
TITLE EMBUDO / PIEDRA LISA RECREATIONAL TRAIL  
STA. 49+00 TO STA. 61+61.30

APPROVALS	ENGINEER	DATE	APPROVALS	ENGINEER	DATE
City Engineer	Liquid Waste		A.C.E. Design	Traffic	
A.C.E. Hydrology	Water				

DRAWING NO. SHEET 17 OF 25

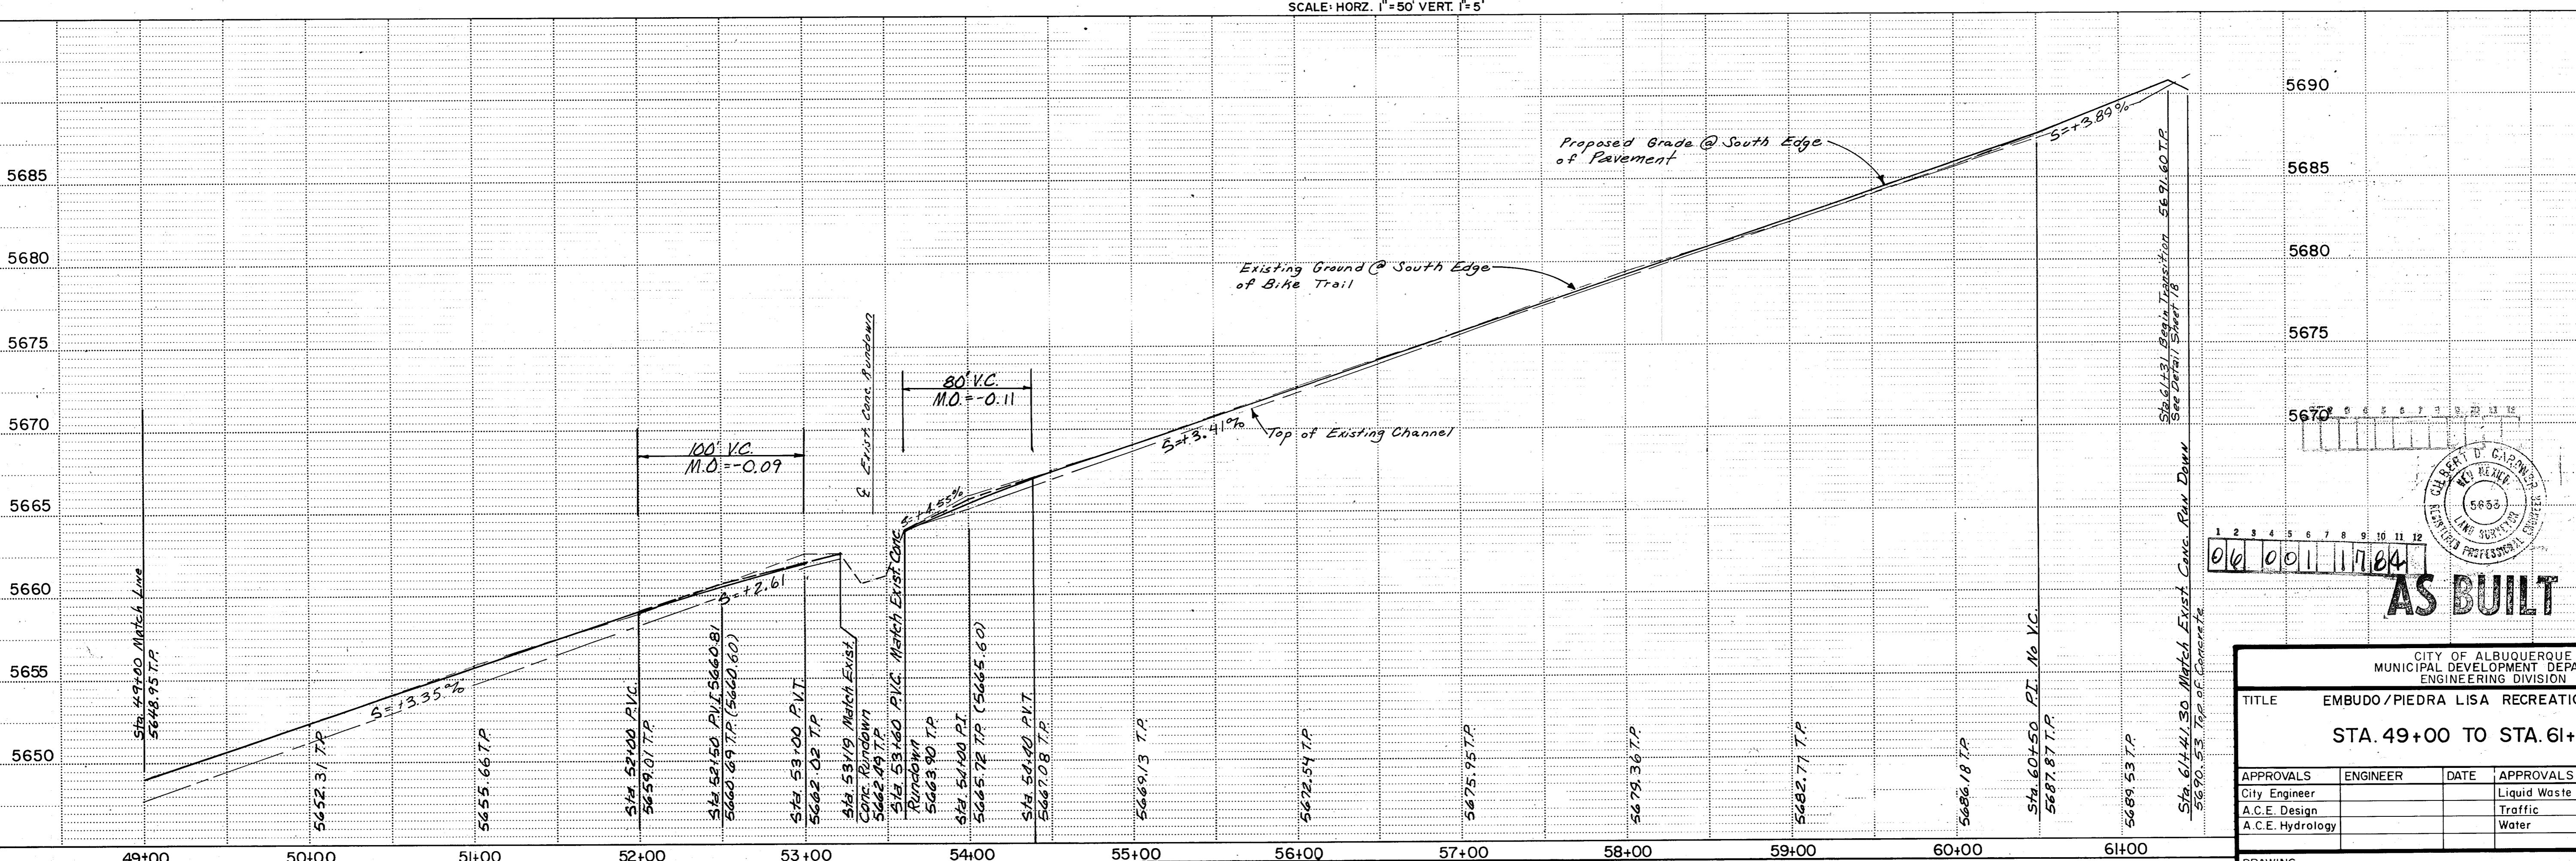

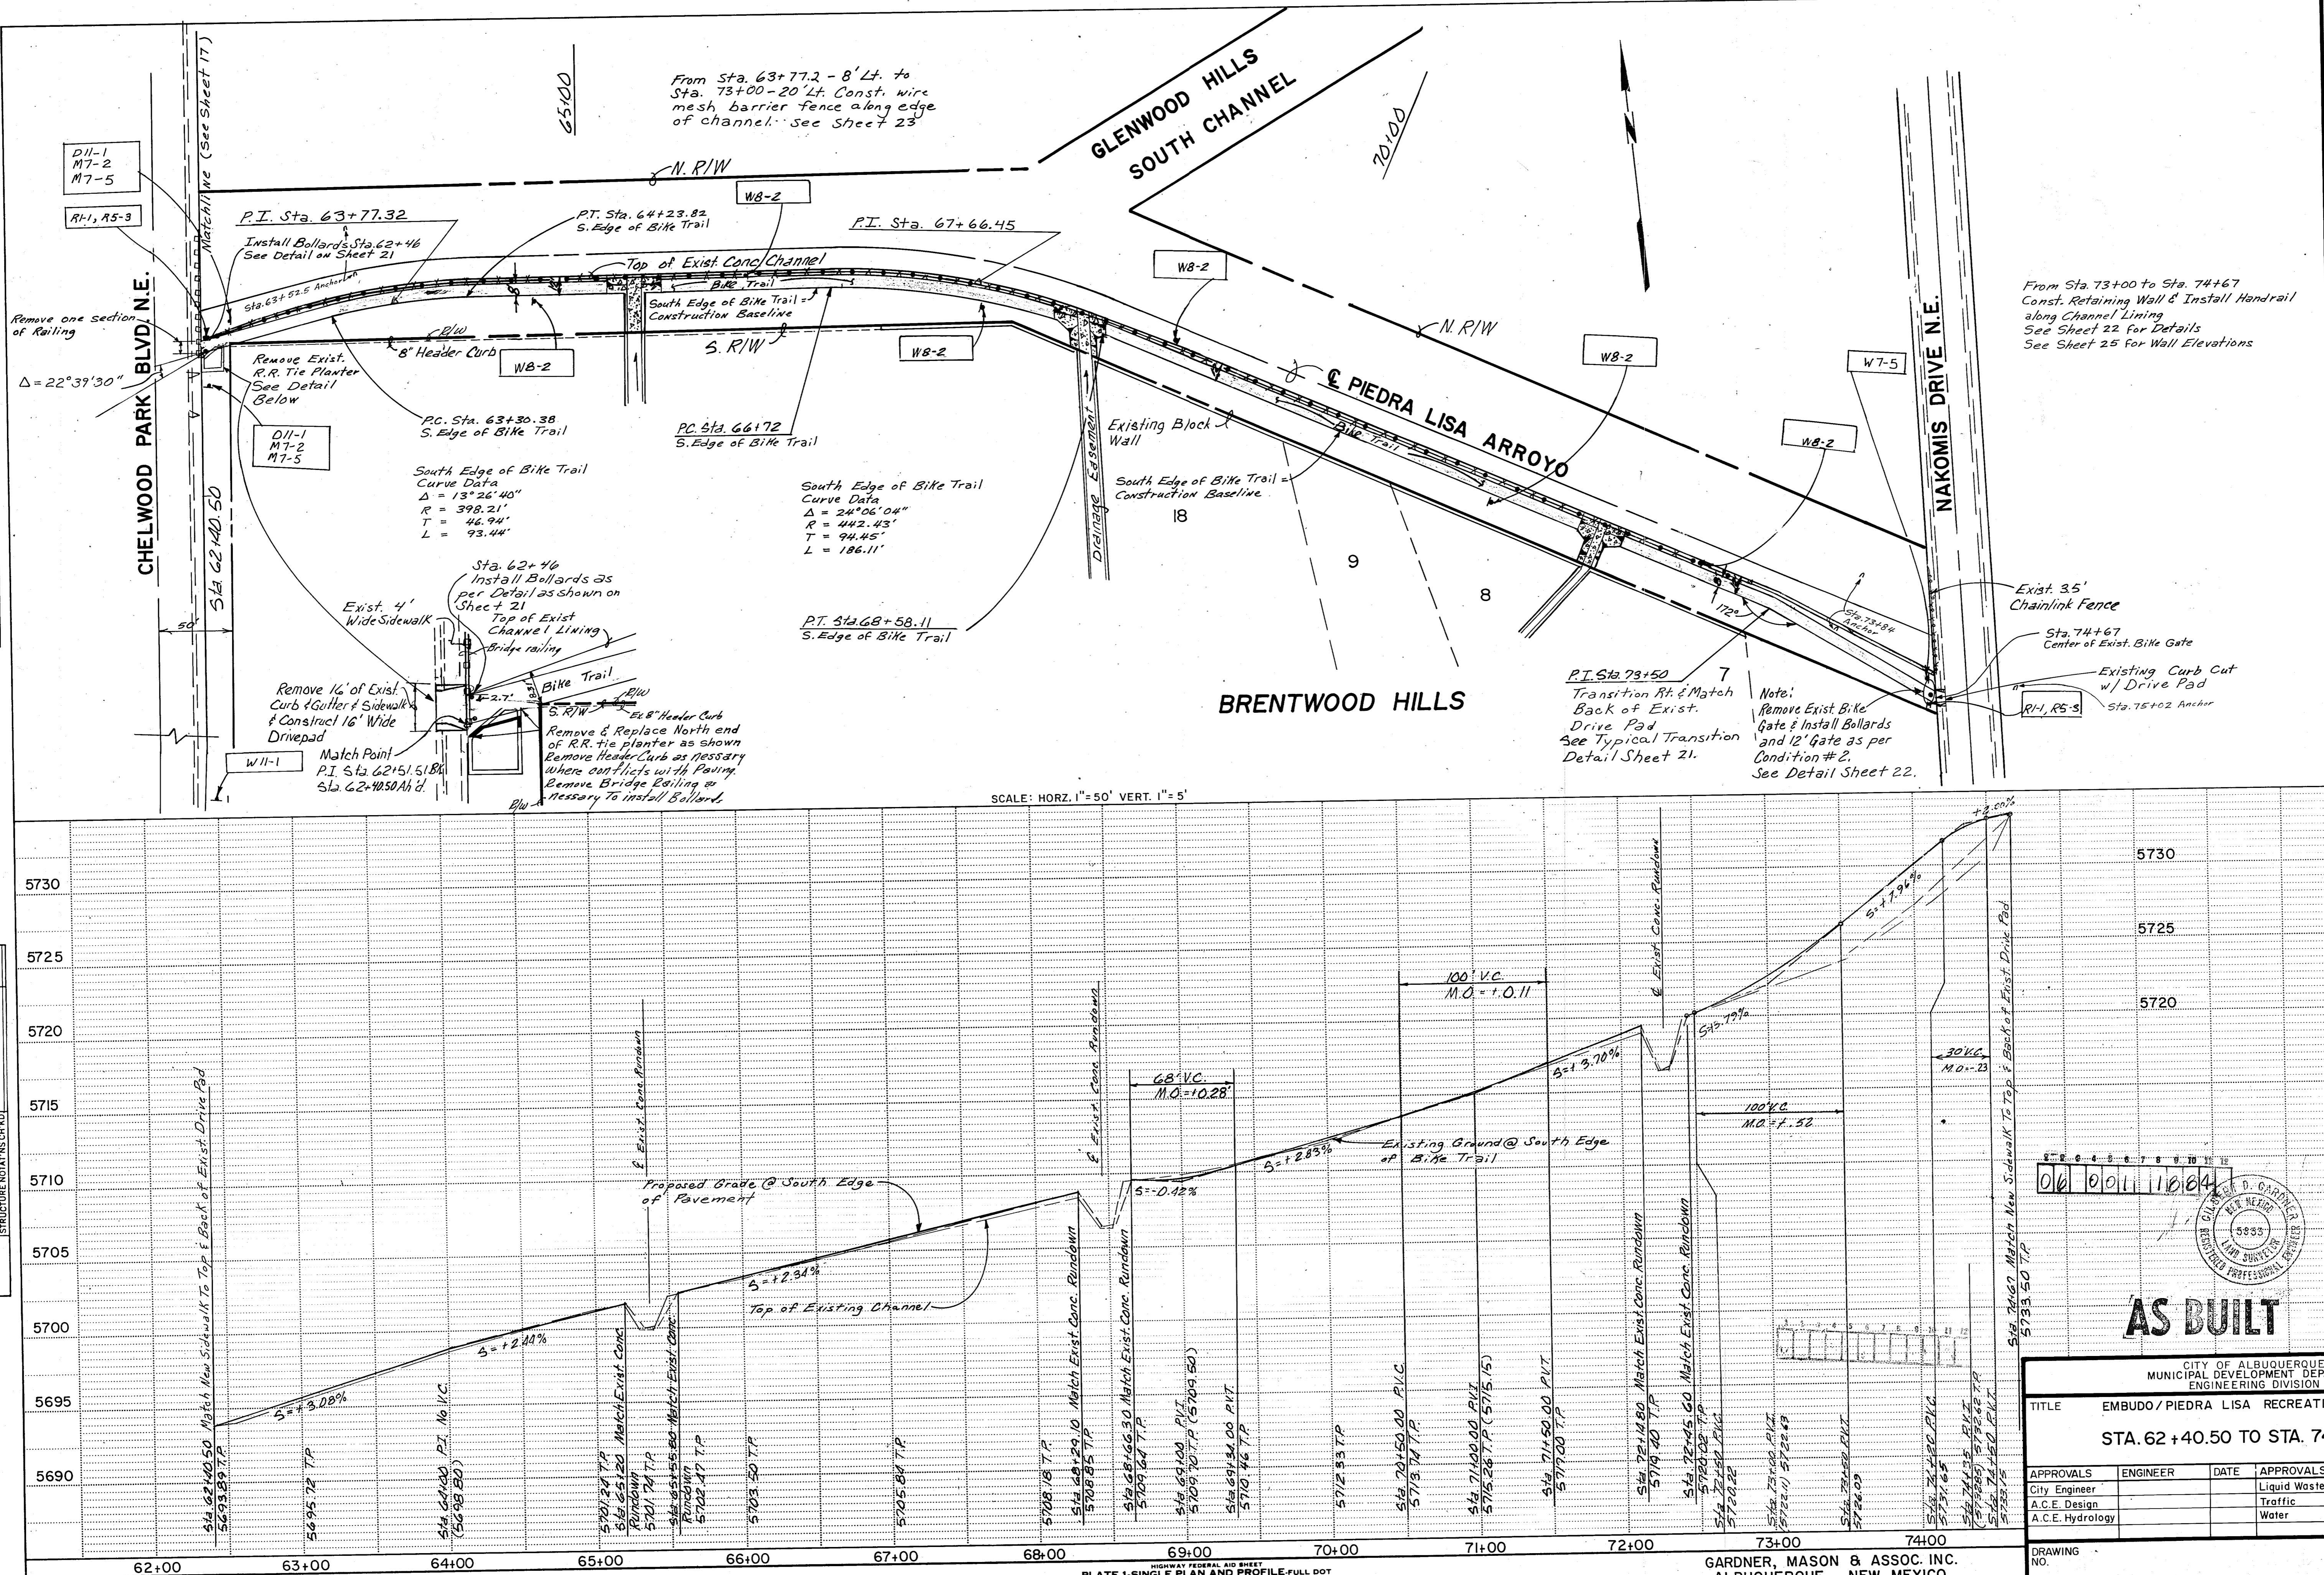


AS BUILT

CITY OF ALBUQUERQUE MUNICIPAL DEVELOPMENT DEPARTMENT ENGINEERING DIVISION						
TITLE EMBUDO / PIEDRA LISA RECREATIONAL TRAIL						
STA. 62 +40.50 TO STA. 74 + 67						
APPROVALS	ENGINEER	DATE	APPROVALS	ENGINEER	DATE	
City Engineer			Liquid Waste			
A.C.E. Design			Traffic			
A.C.E. Hydrology			Water			
DRAWING NO.						SHEET 18 OF 3


PLAN	SURVEYED	DATE
NOTE BOOK	PLOTTED	BY
	ALIGNMENT CHECKED	
	RT OF WAY CHECKED	

PROFILE	SURVEYED	BY	DATE
NOTE BOOK	PLOTTED		
	GRADES CHECKED		
	B. M.s NOTED		STRUCTURE OR NOTATIONS CHVD

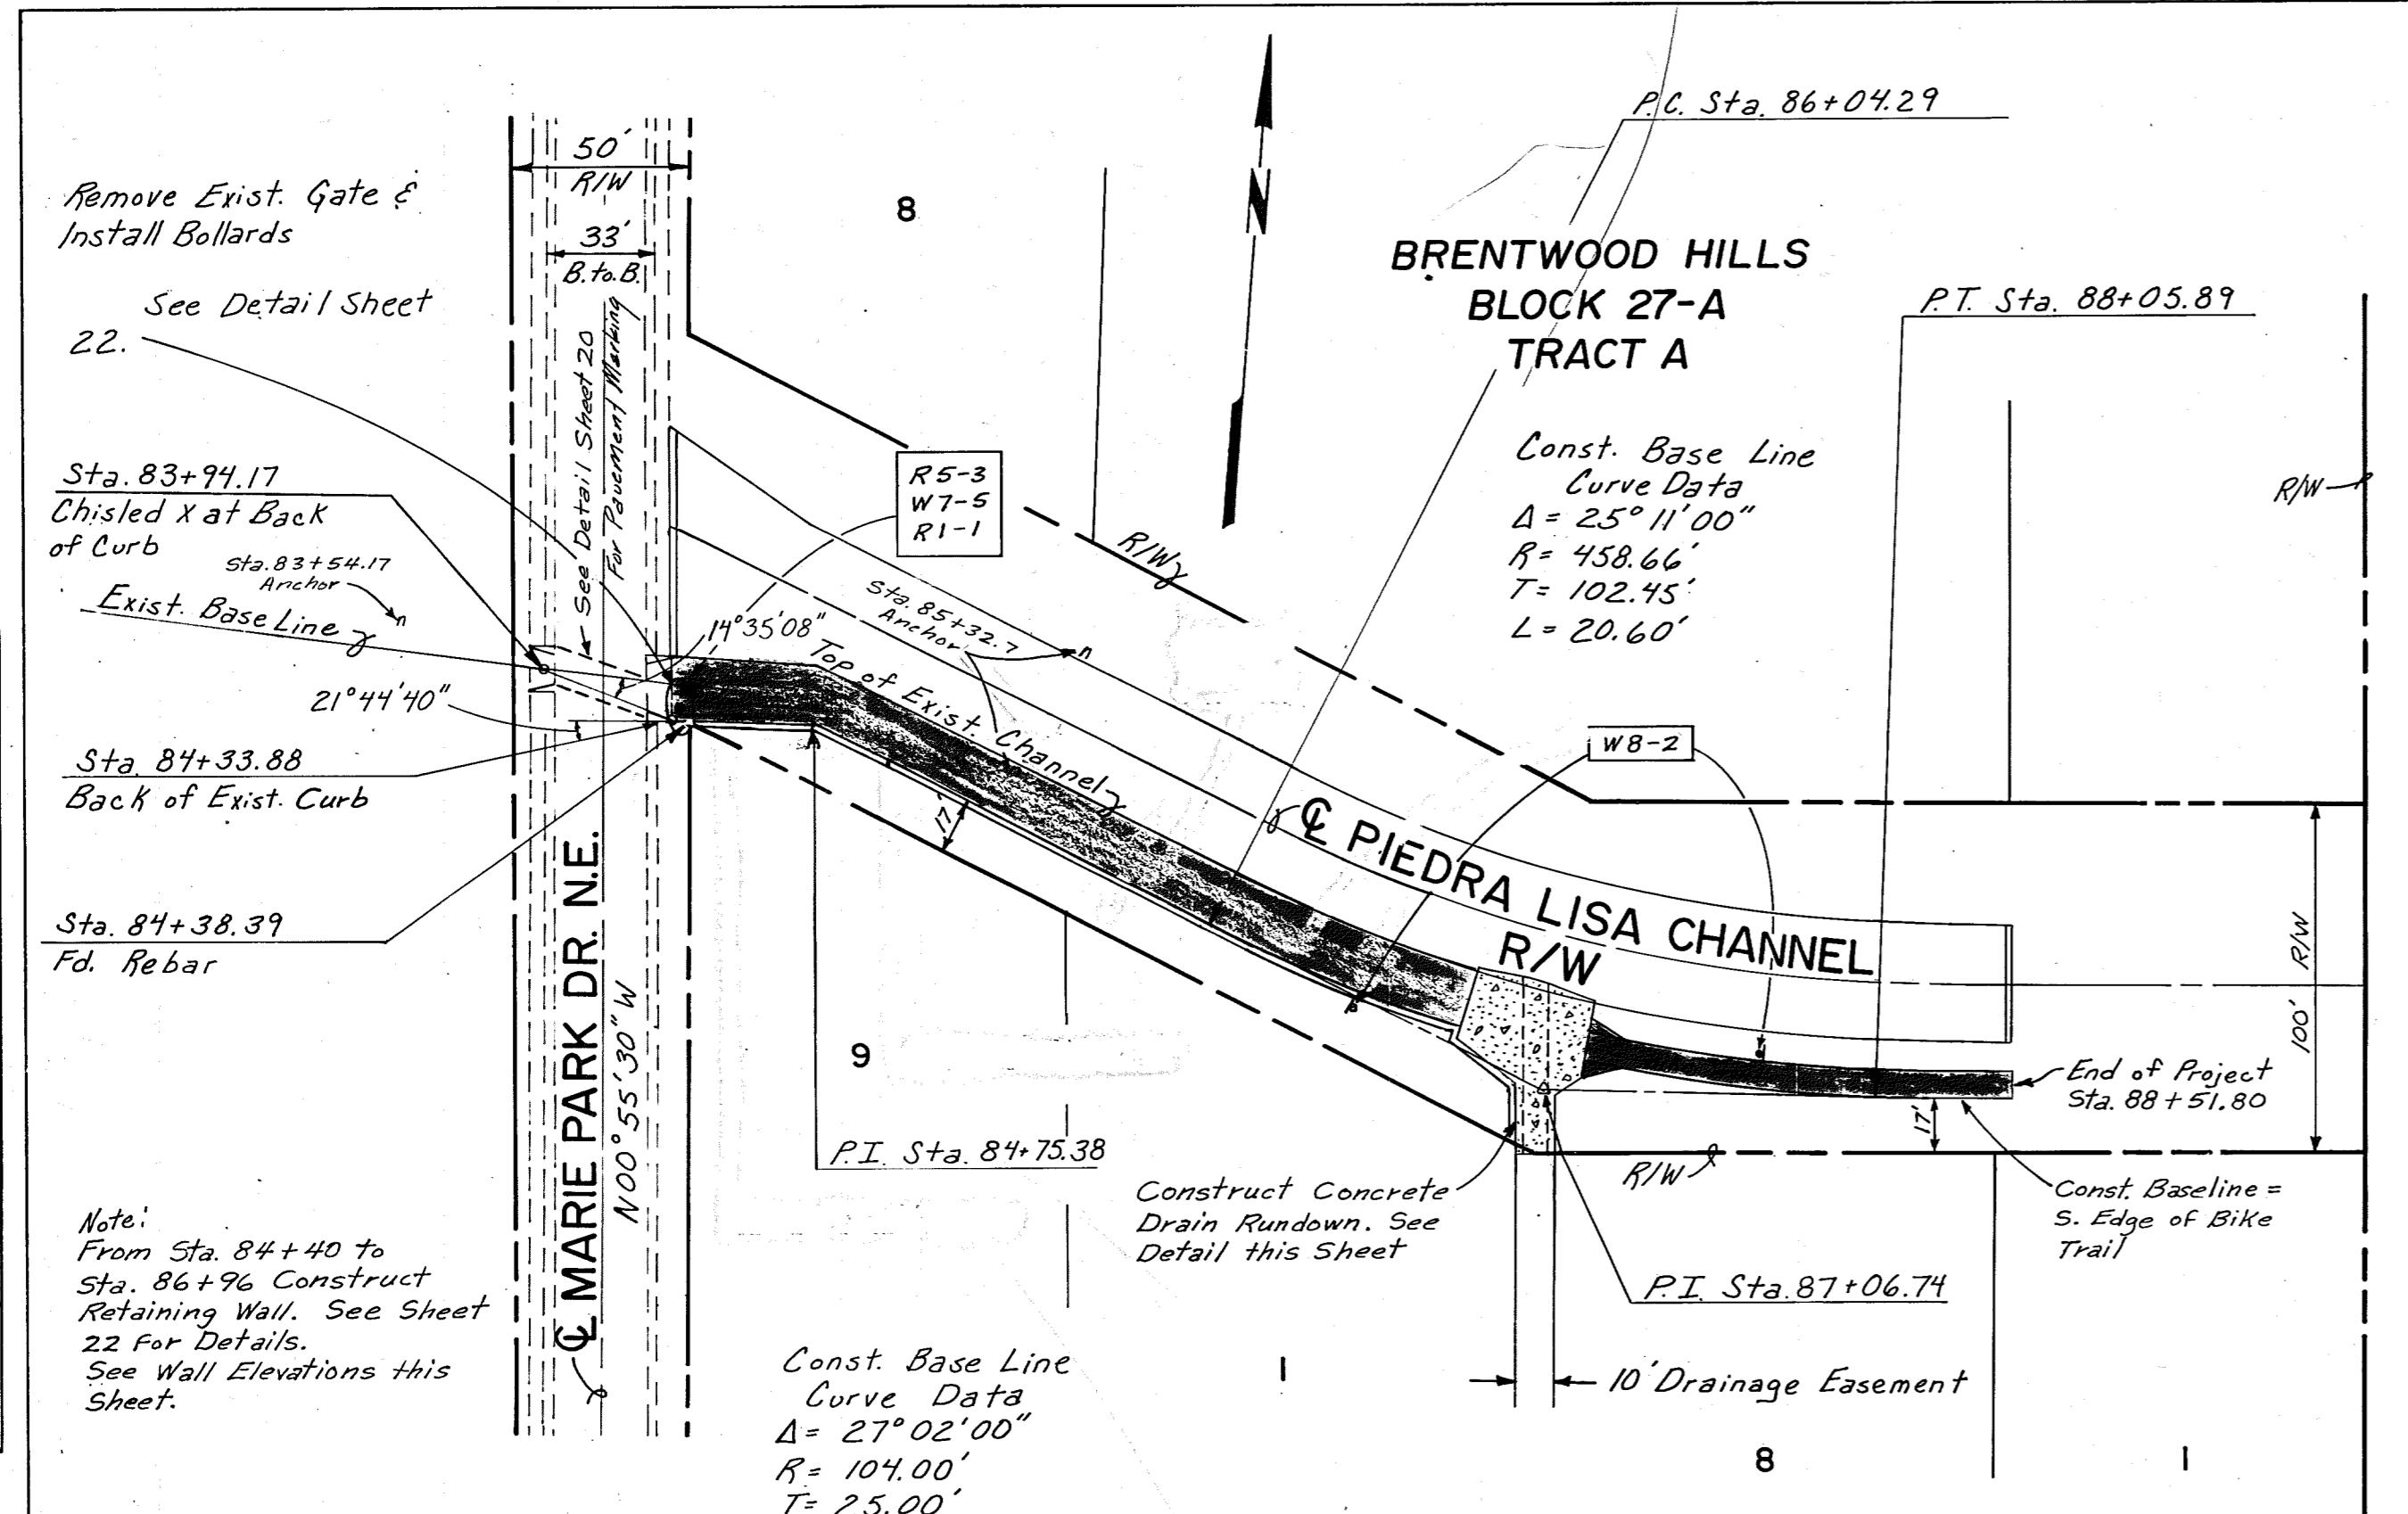


## BRENTWOOD HILLS

SCALE: HORIZ. 1" = 50' VERT. 1" = 5'

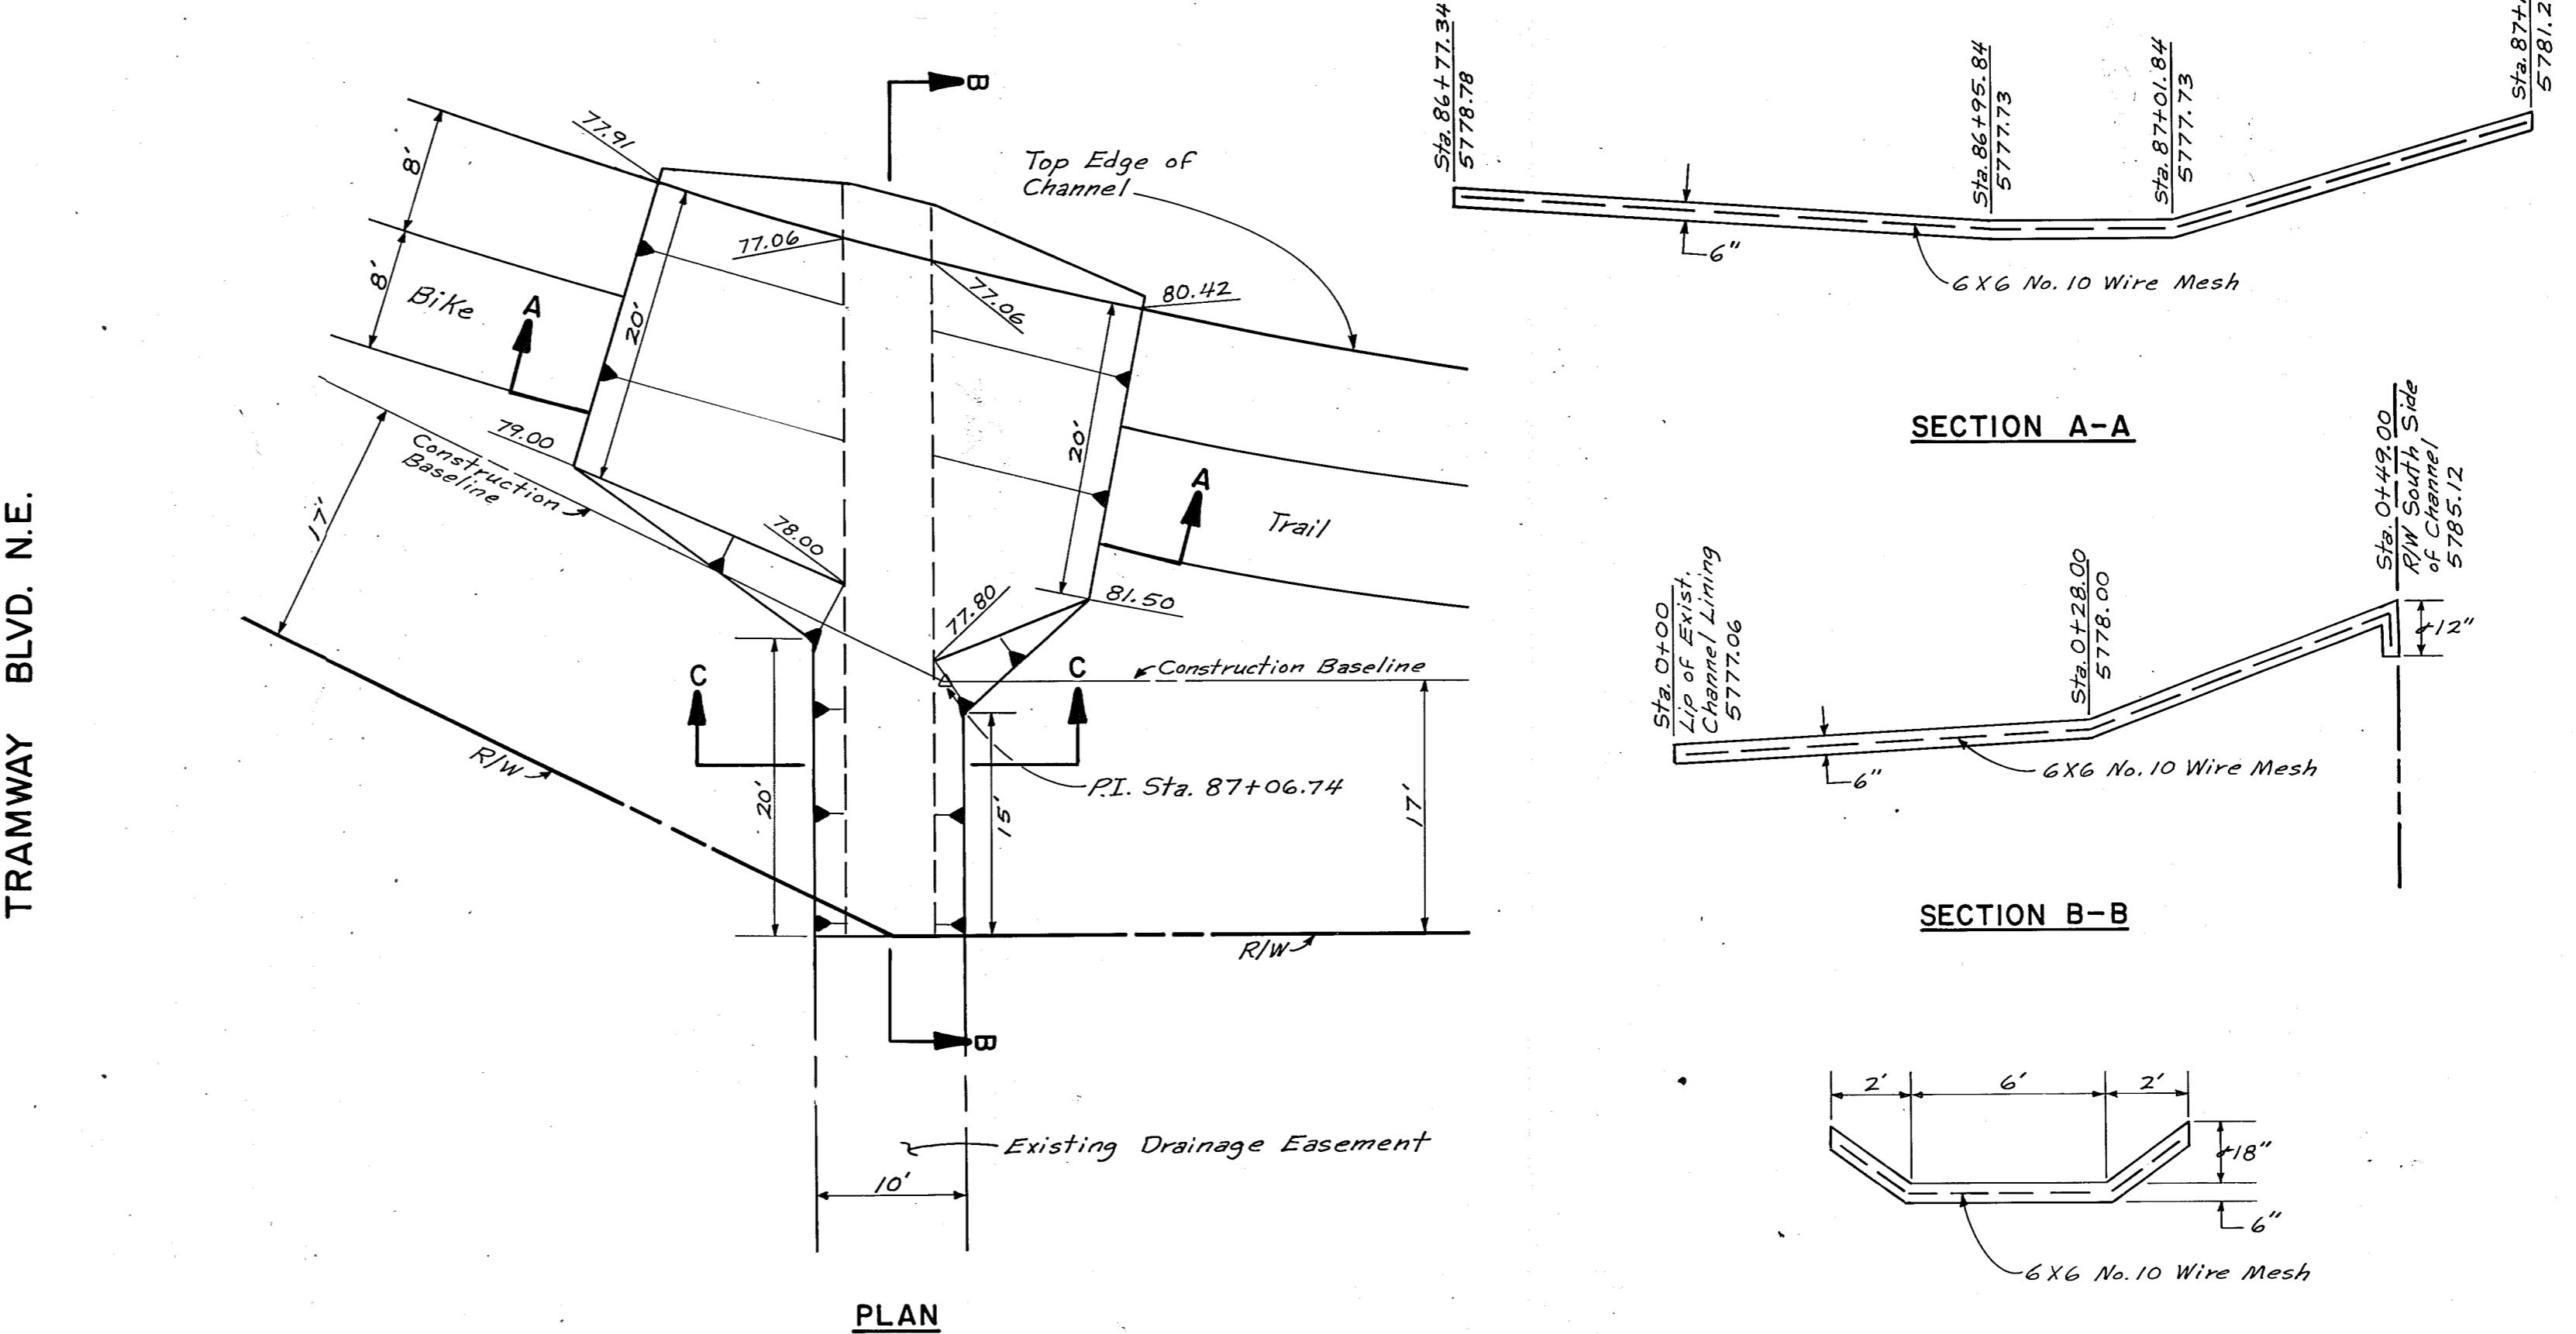


# CONCRETE DRAIN RUNDOWN

**NOT TO SCALE**

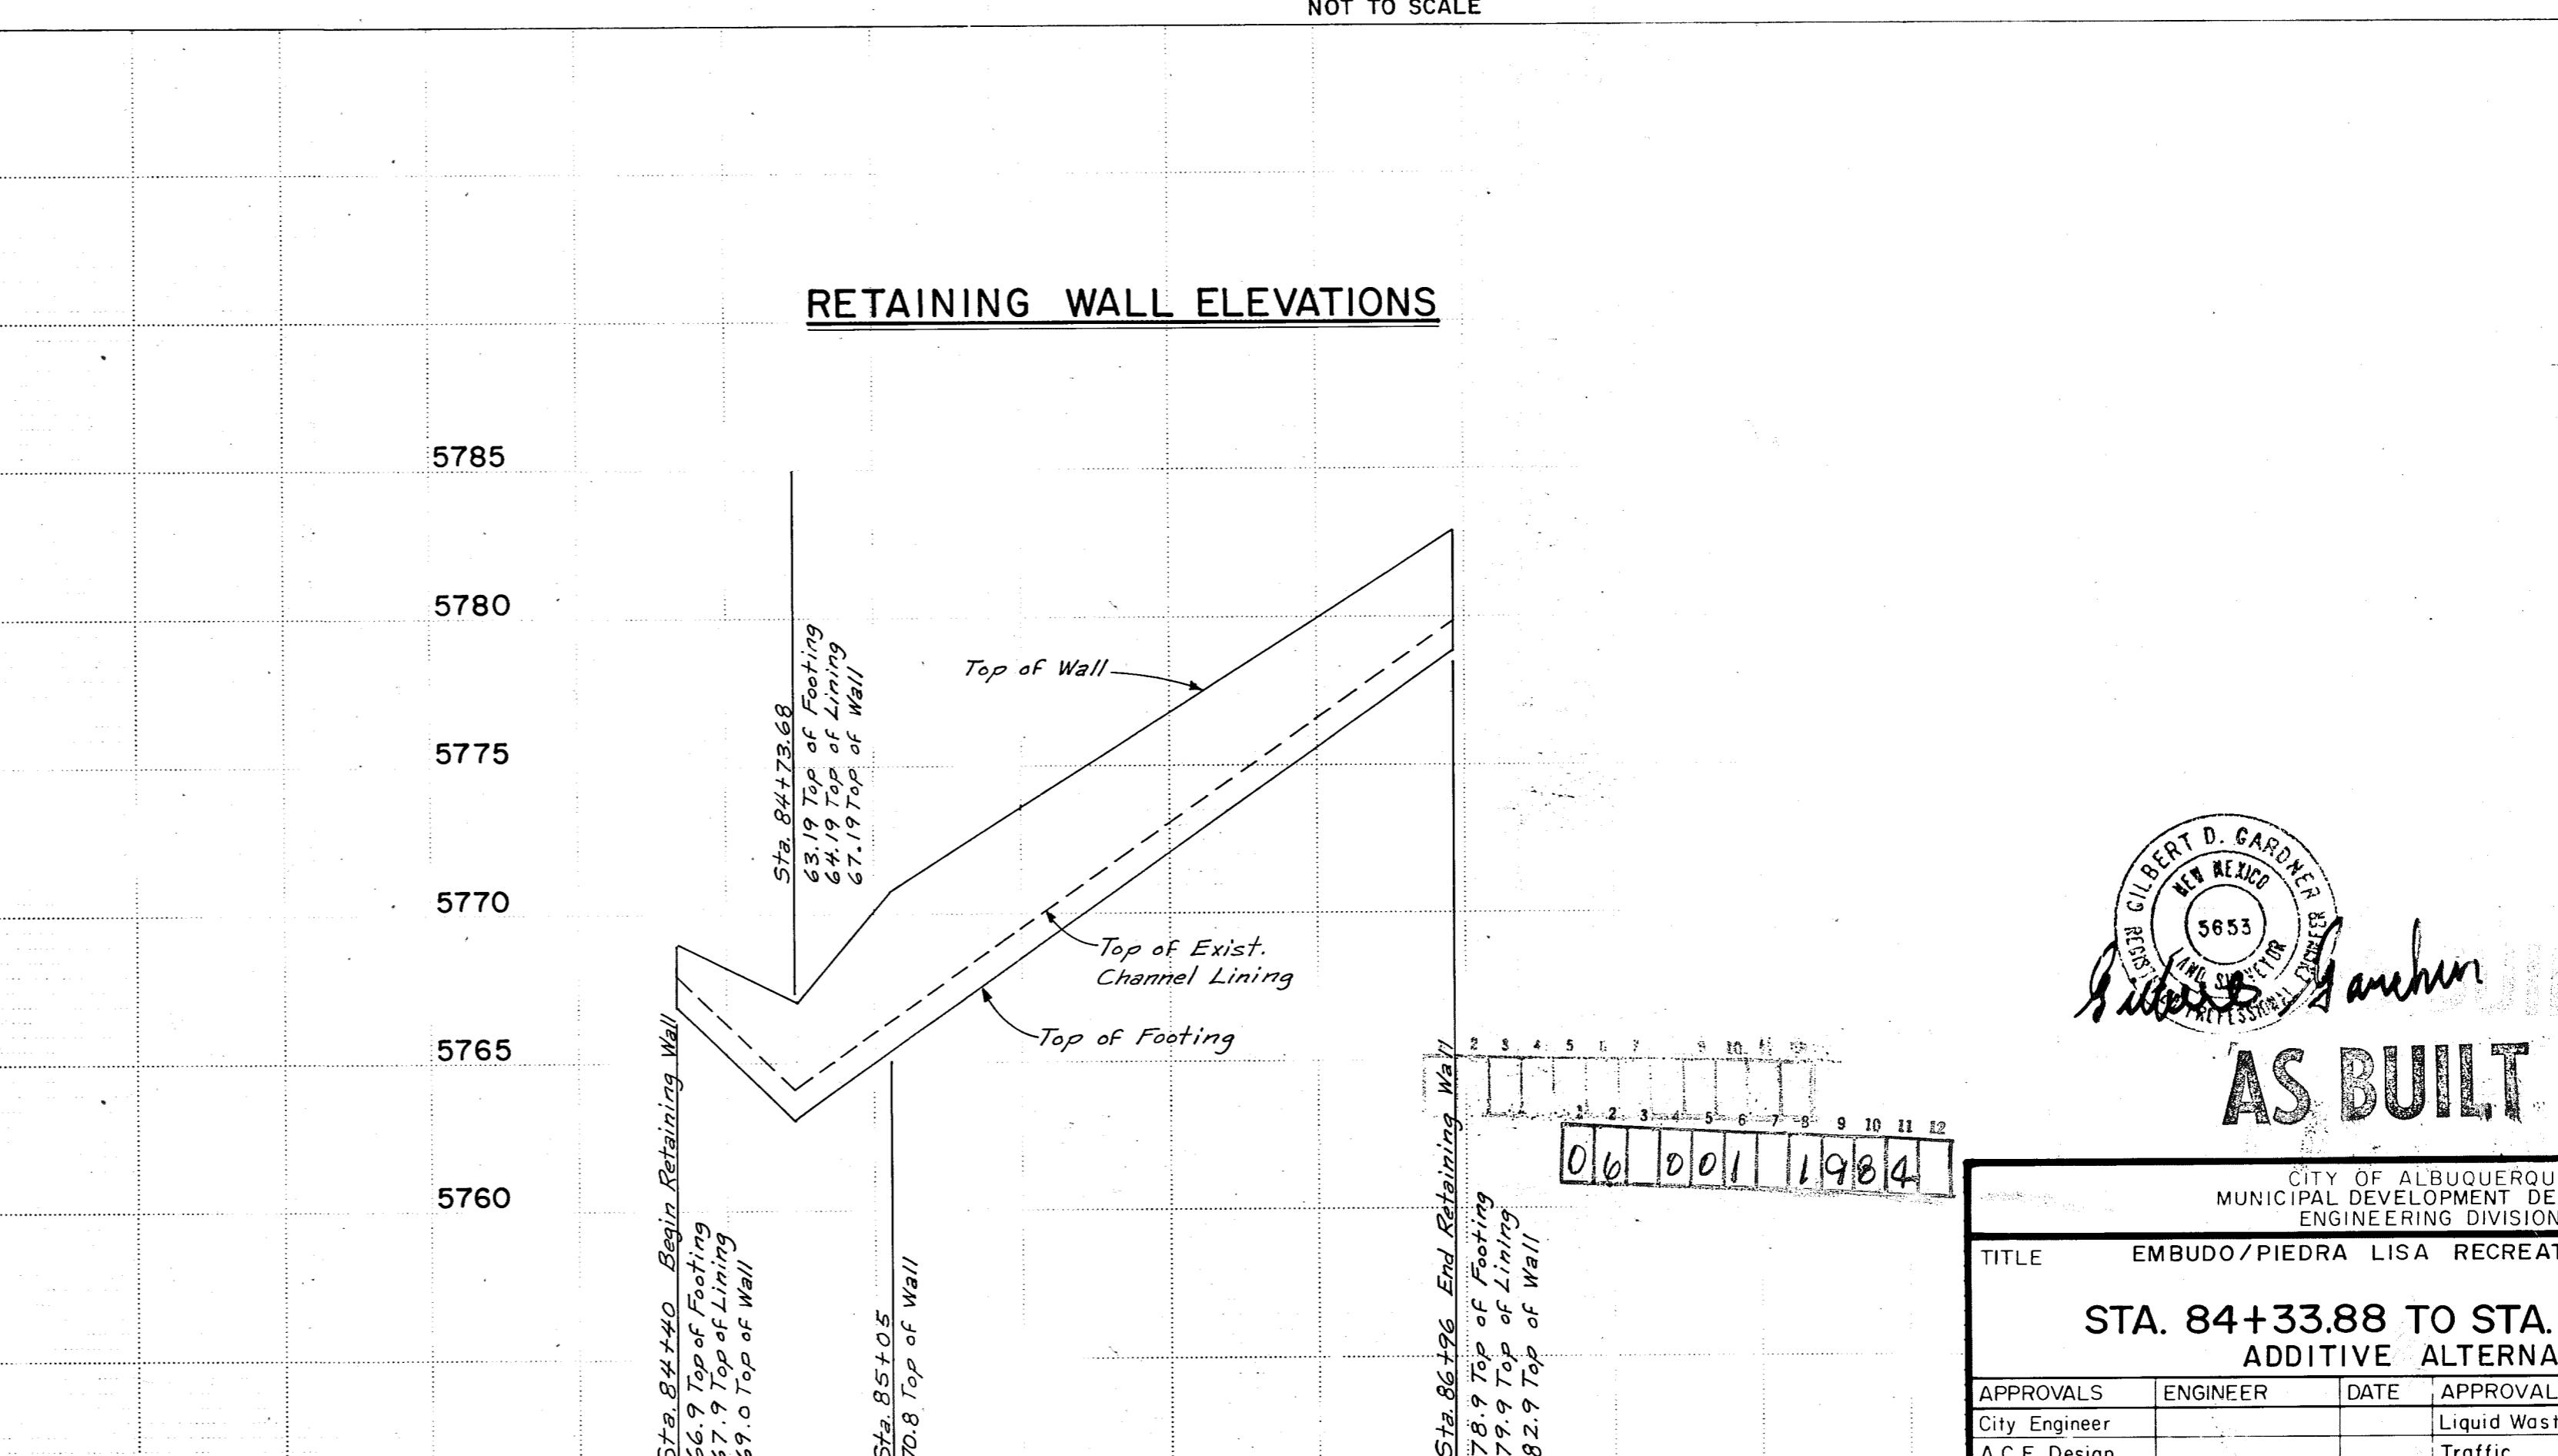

## RETAINING WALL ELEVATIONS

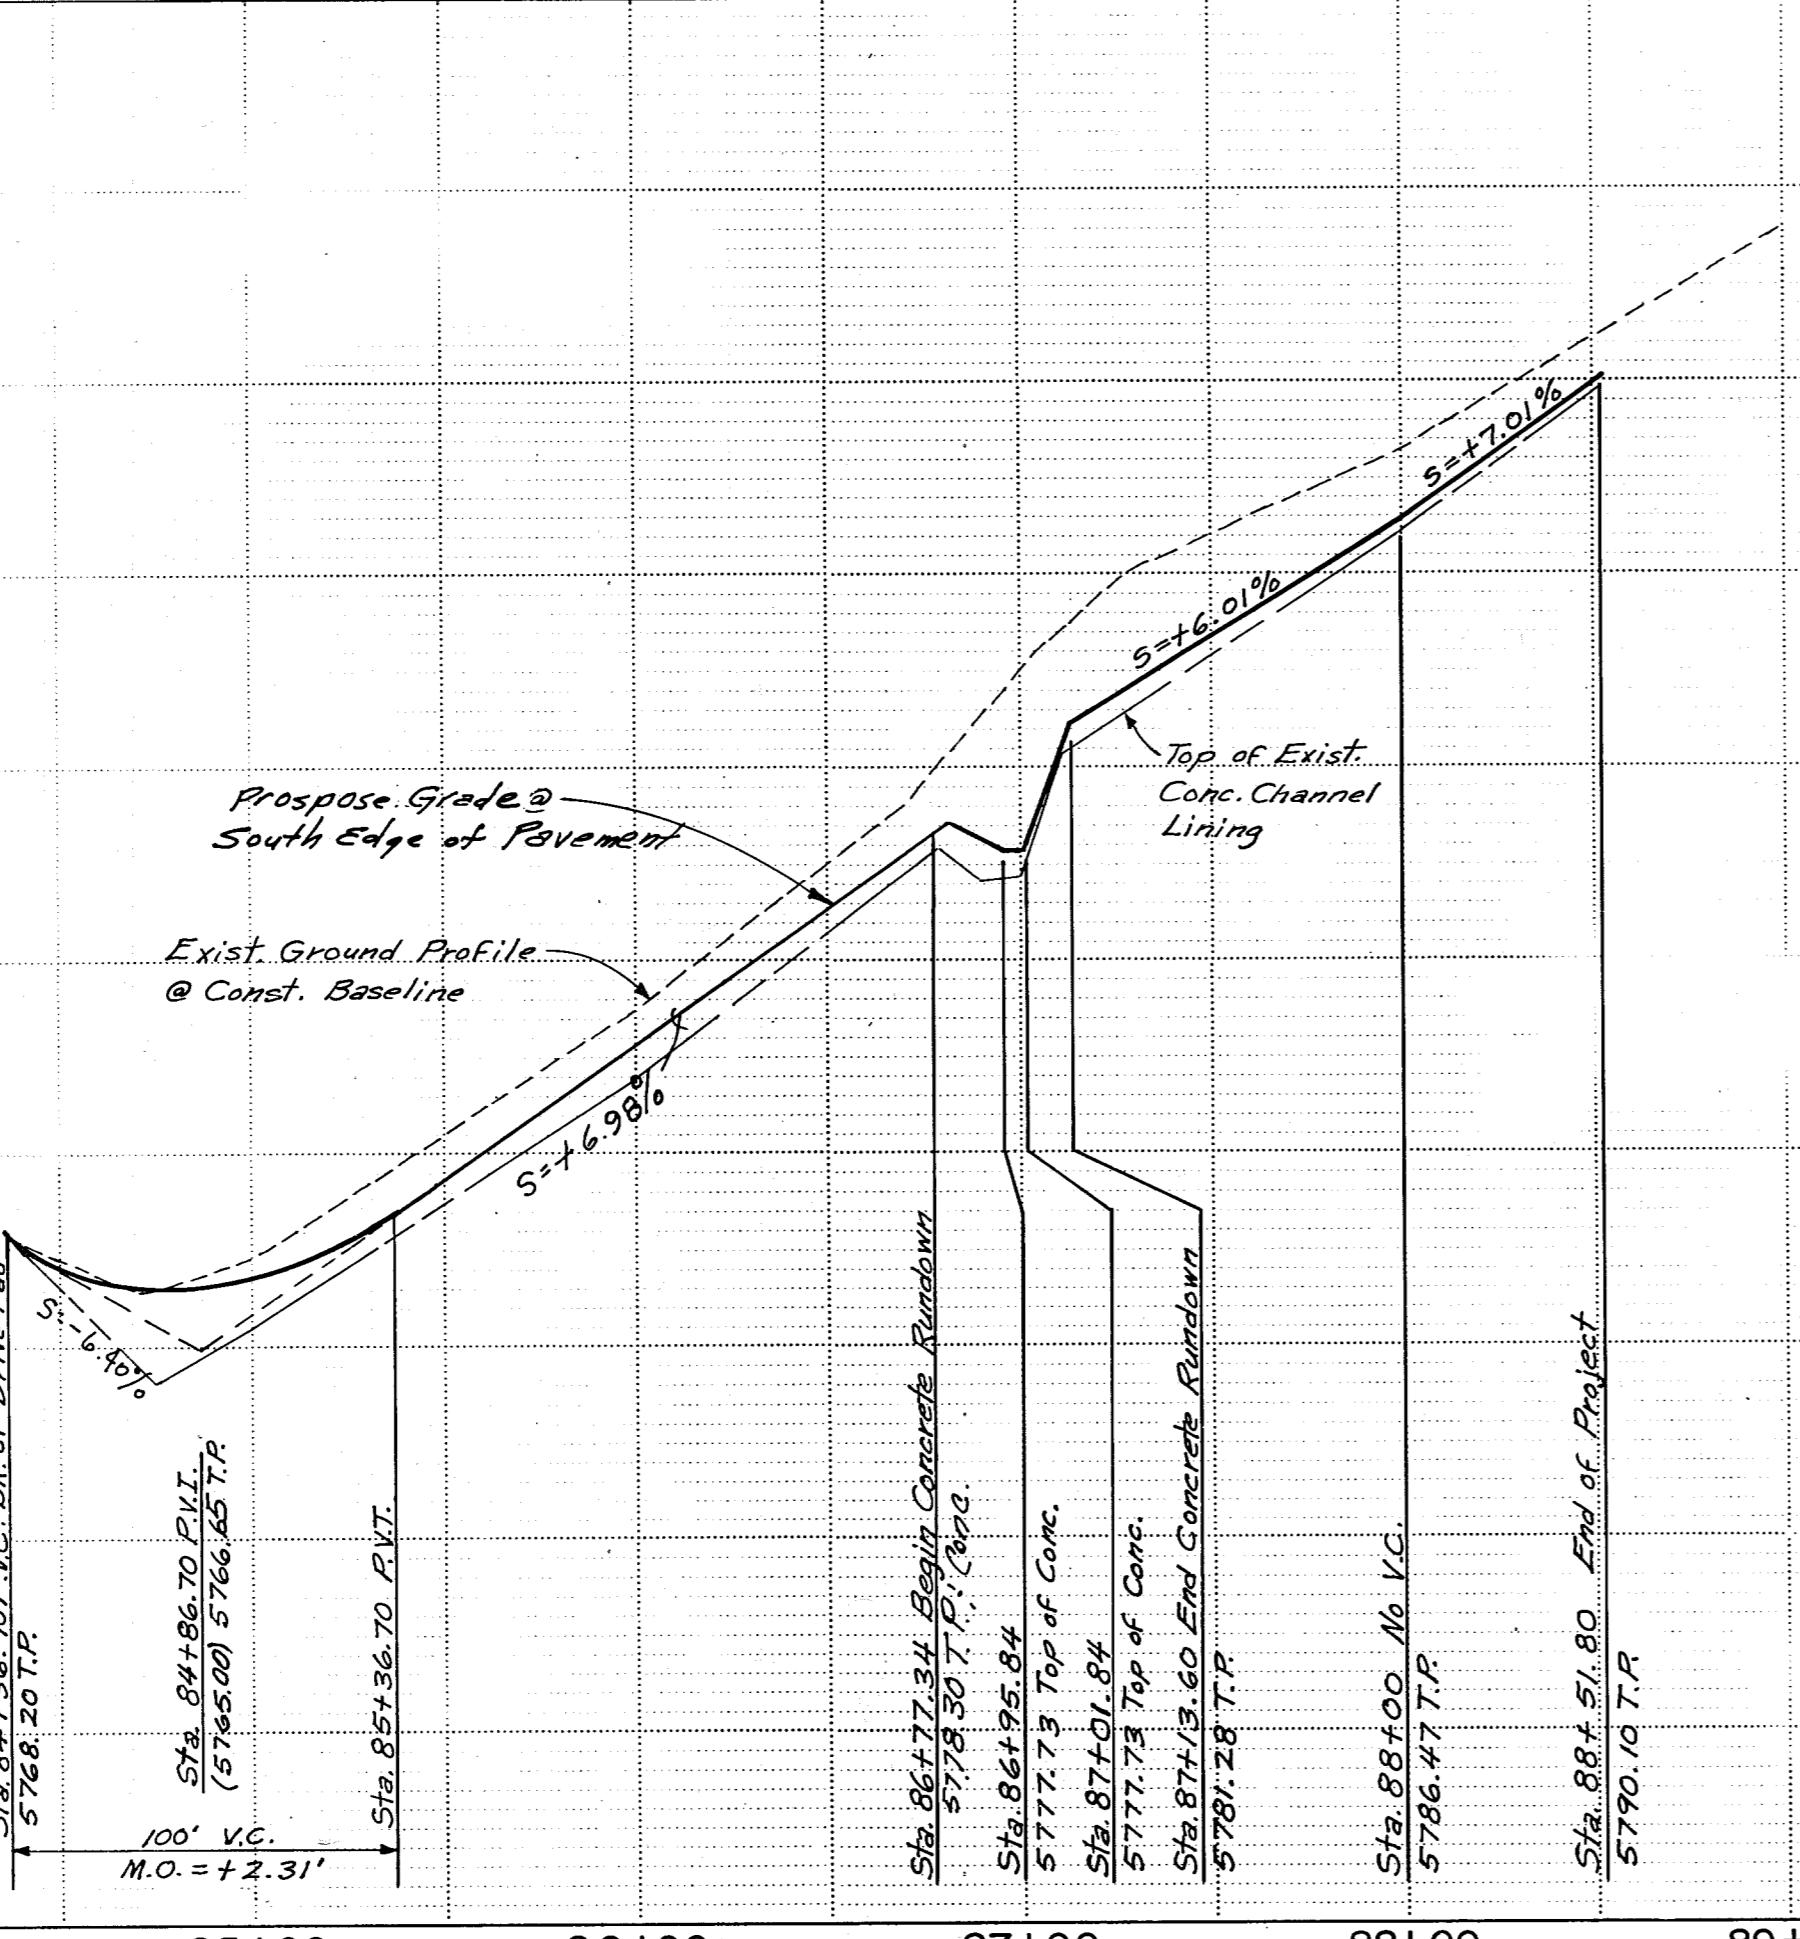


HIGHWAY FEDERAL AID SHEET  
PLATE 1-SINGLE PLAN AND PROFILE-FULL DOT  
 TELEDYNE  
PRINTED IN U.S.A.


GARDNER, MASON & ASSOC., INC.  
ALBUQUERQUE, NEW MEXICO

CITY OF ALBUQUERQUE MUNICIPAL DEVELOPMENT DEPARTMENT ENGINEERING DIVISION					
TITLE	EMBUDO/PIEDRA LISA RECREATIONAL TRAIL				
<b>STA. 84+33.88 TO STA. 88+51.80</b>					
<b>ADDITIVE ALTERNATE #4</b>					
APPROVALS	ENGINEER	DATE	APPROVALS	ENGINEER	DATE
City Engineer			Liquid Waste		
C.E. Design			Traffic		
C.E. Hydrology			Water		
DRAWING NO.					
SHEET 19 OF 30 <span style="float: right;">25</span>					

FEDERAL HWY. ADMINISTRATION SIGN NUMBER	SIZE	COLOR	APPEARANCE
LOCATION			
RI-1 @ All Street Crossings with Limited Sight Distance	18" x 18"	Red with White Letters	
RI-2 At Crossings where Sight Distance Permits Visibility of Vehicular Traffic	24" x 24" x 24"	Red with White Letters	
R5-3 @ All Locations where Motor Vehicles have Ready Access to Bike Trail	24" x 24"	White with Black Letters	
WI-1 No Less than 50' Prior to Change in Alignment	18" x 18"	Yellow w/ Black Letters	
WI-2	"	"	
WI-4	"	"	
W2-1 150'-200' Before Each Street Crossing	"	"	
W2-4	"	"	
W3-1 100' Before Any Intersection where Stop Signs are not Clearly Visible	"	"	
WS-4 50' Before Gates	"	"	
W7-5 At Locations where Grades are excessive	"	"	
W8-10 Where Conditions Exist that are Likely to cause Loss of Control	"	"	
WII-1 On Roadways	36" x 36" Arterials	"	
WIIA-1 On Mast Arm	30" x 30" Collector & Residential	"	
W8-2 50' in Advance of any Dip	18" x 18"	"	
R9-6 Off the Edge of Sidewalk, where Bicycles are Required to Cross or Share Pedestrian Facilities	12" x 18"	White with Black Letters	
R7-9 Where Necessary to Restrict Parking in a Designated Bicycle Crossing	6" x 18"	Red w/ White	
WII-1	30" x 30"	Yellow w/ Black	

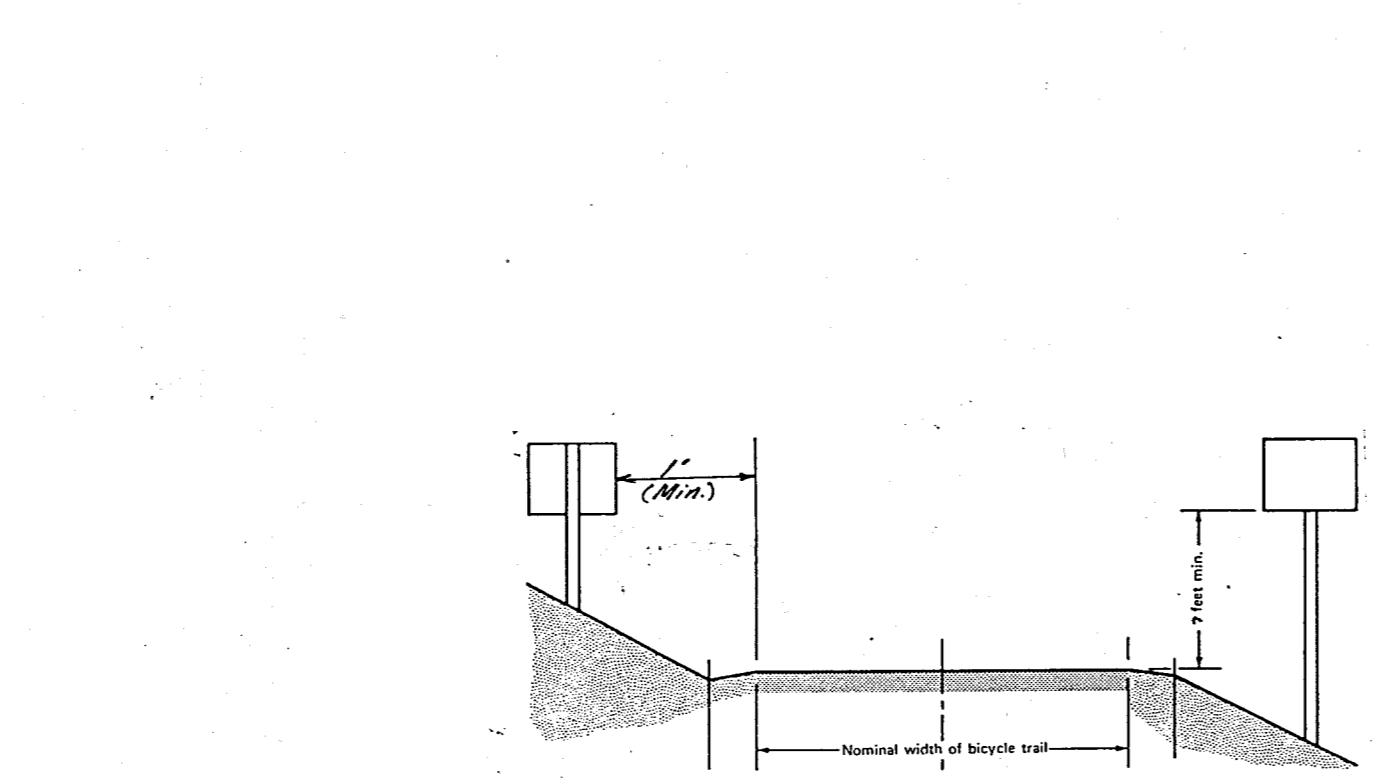


SIGN PLACEMENT DETAIL  
NOT TO SCALE

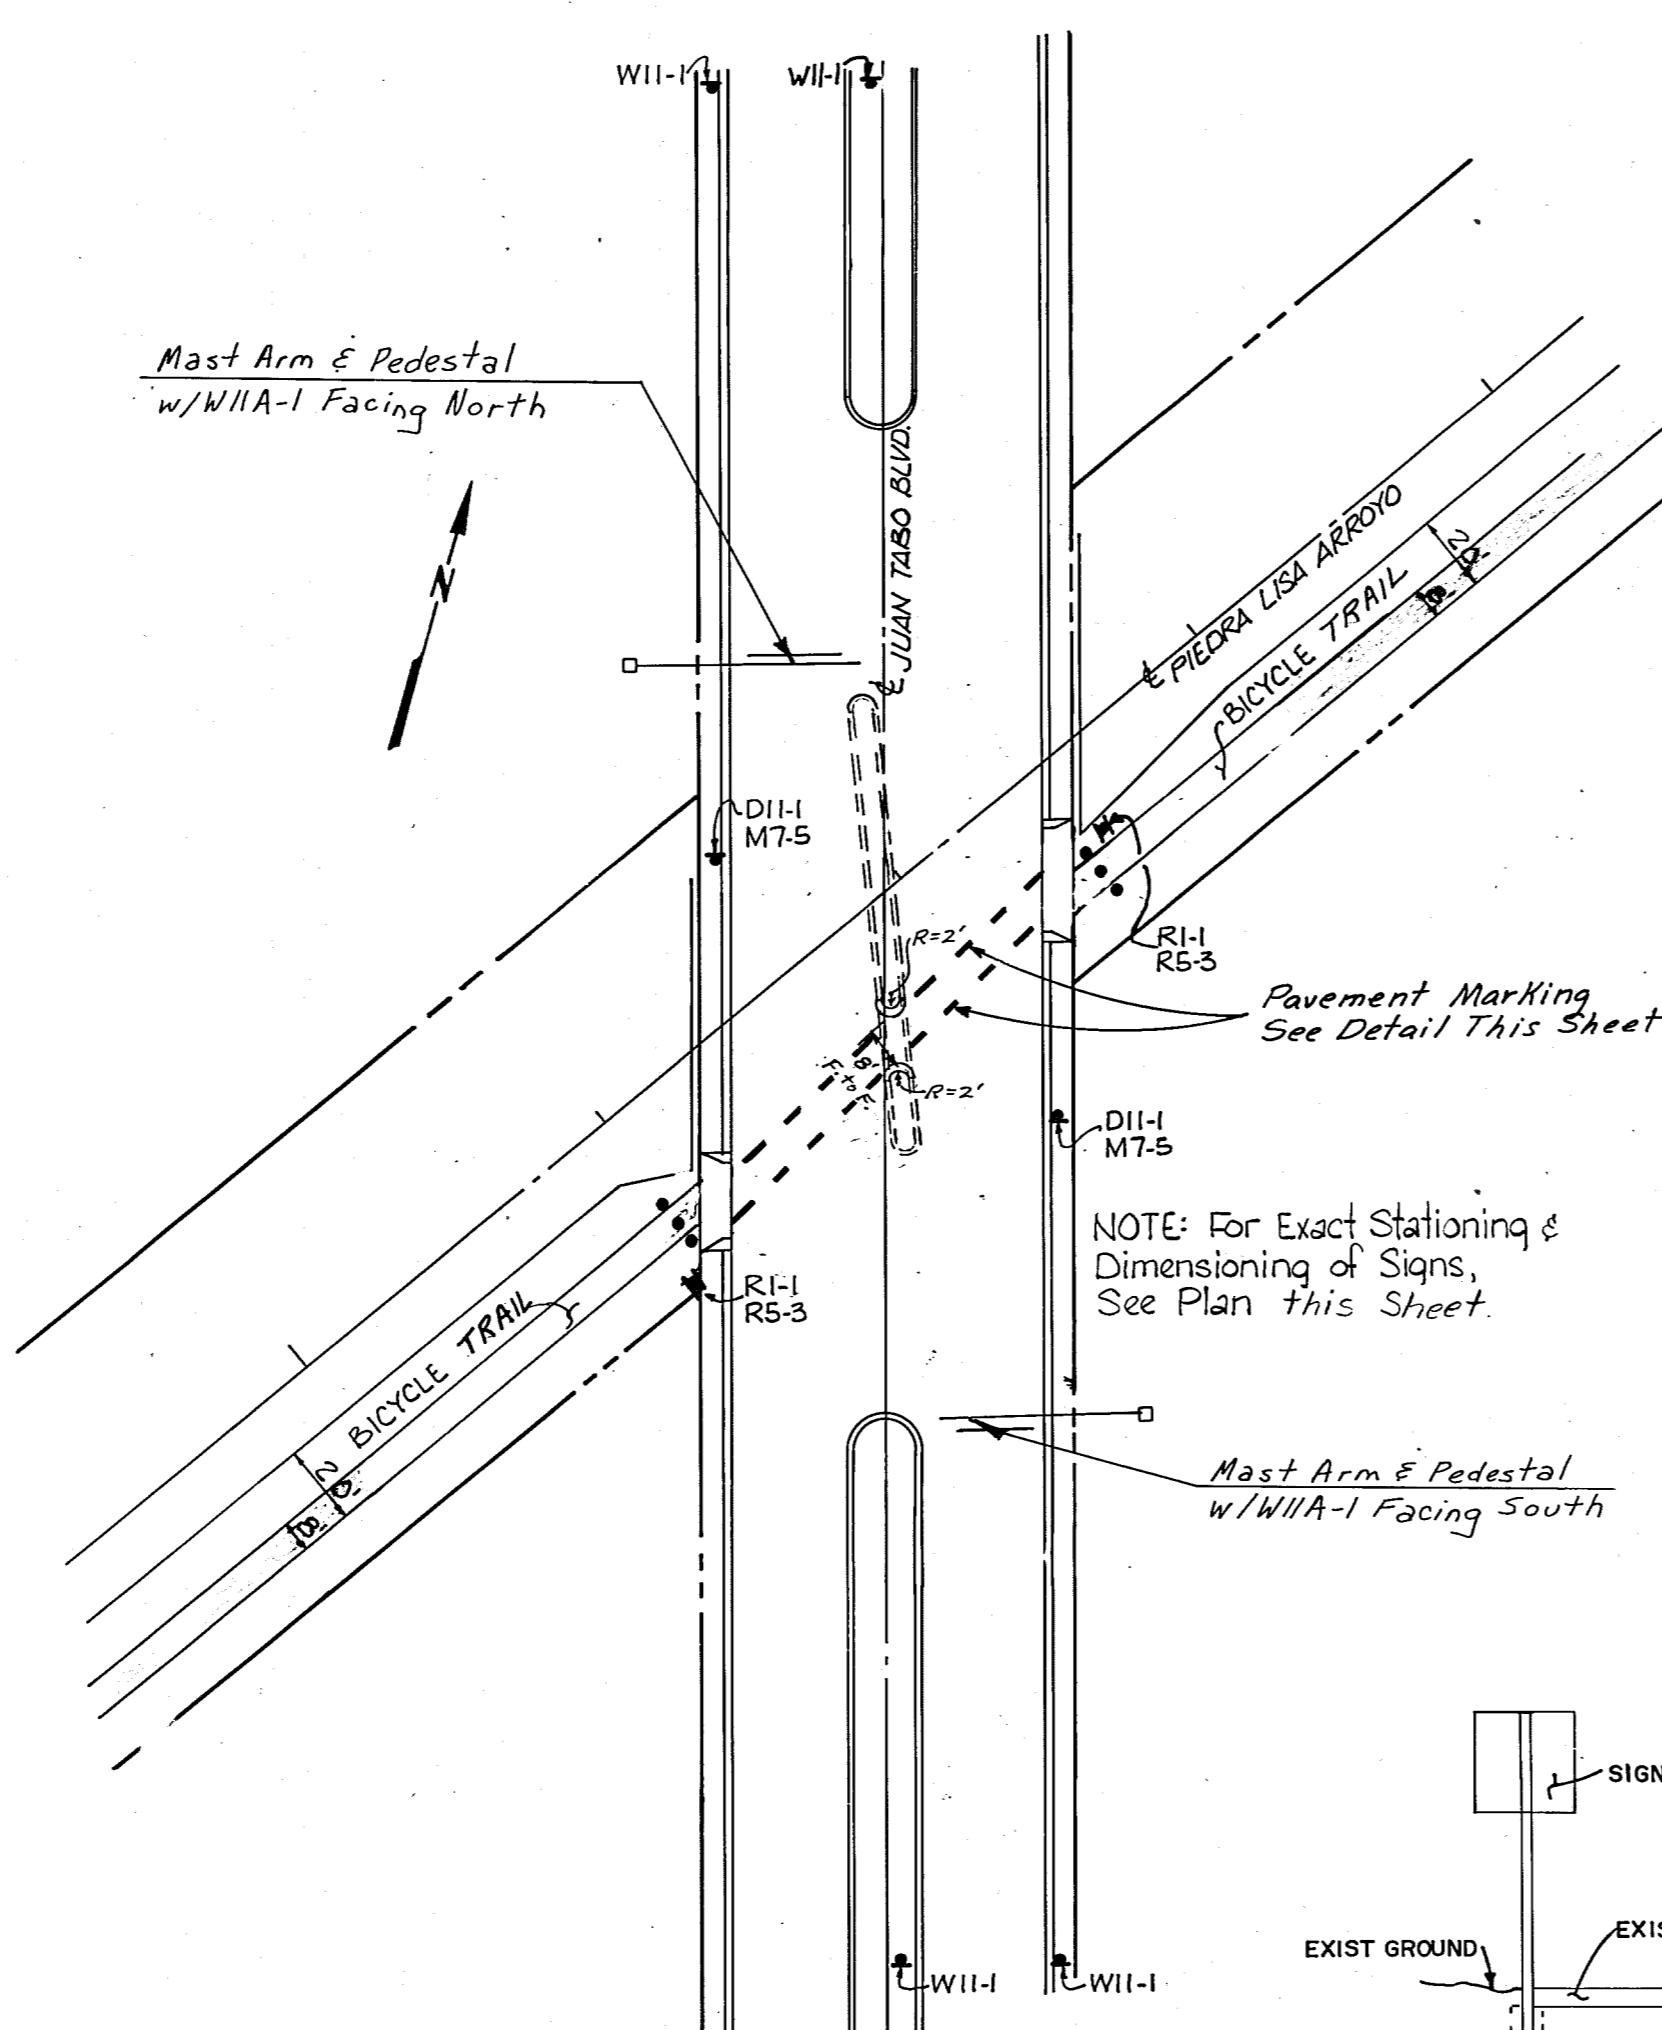


INTERSECTION AT JUAN TABO BLVD.  
NOT TO SCALE

MOUNTING OF BIKE TRAIL SIGNS  
ADJACENT TO MAJOR & MINOR STREETS  
NOT TO SCALE


FHWA. SIGN NO.	SIZE	COLOR	APPEARANCE
DI-1	24" x 18"	Green w/ White	
To be placed at Intervals and Changes of Route	12" x 9"	Green w/ White	
M7-5	12" x 9"	Green w/ White	
M7-2 In advance of Bike Routes Crossing	12" x 9"	Green w/ White	
M7-6 In advance of Change in Route Direction	12" x 9"	Green w/ White	
M7-1 To be used w/ Route Marker	12" x 9"	Green w/ White	

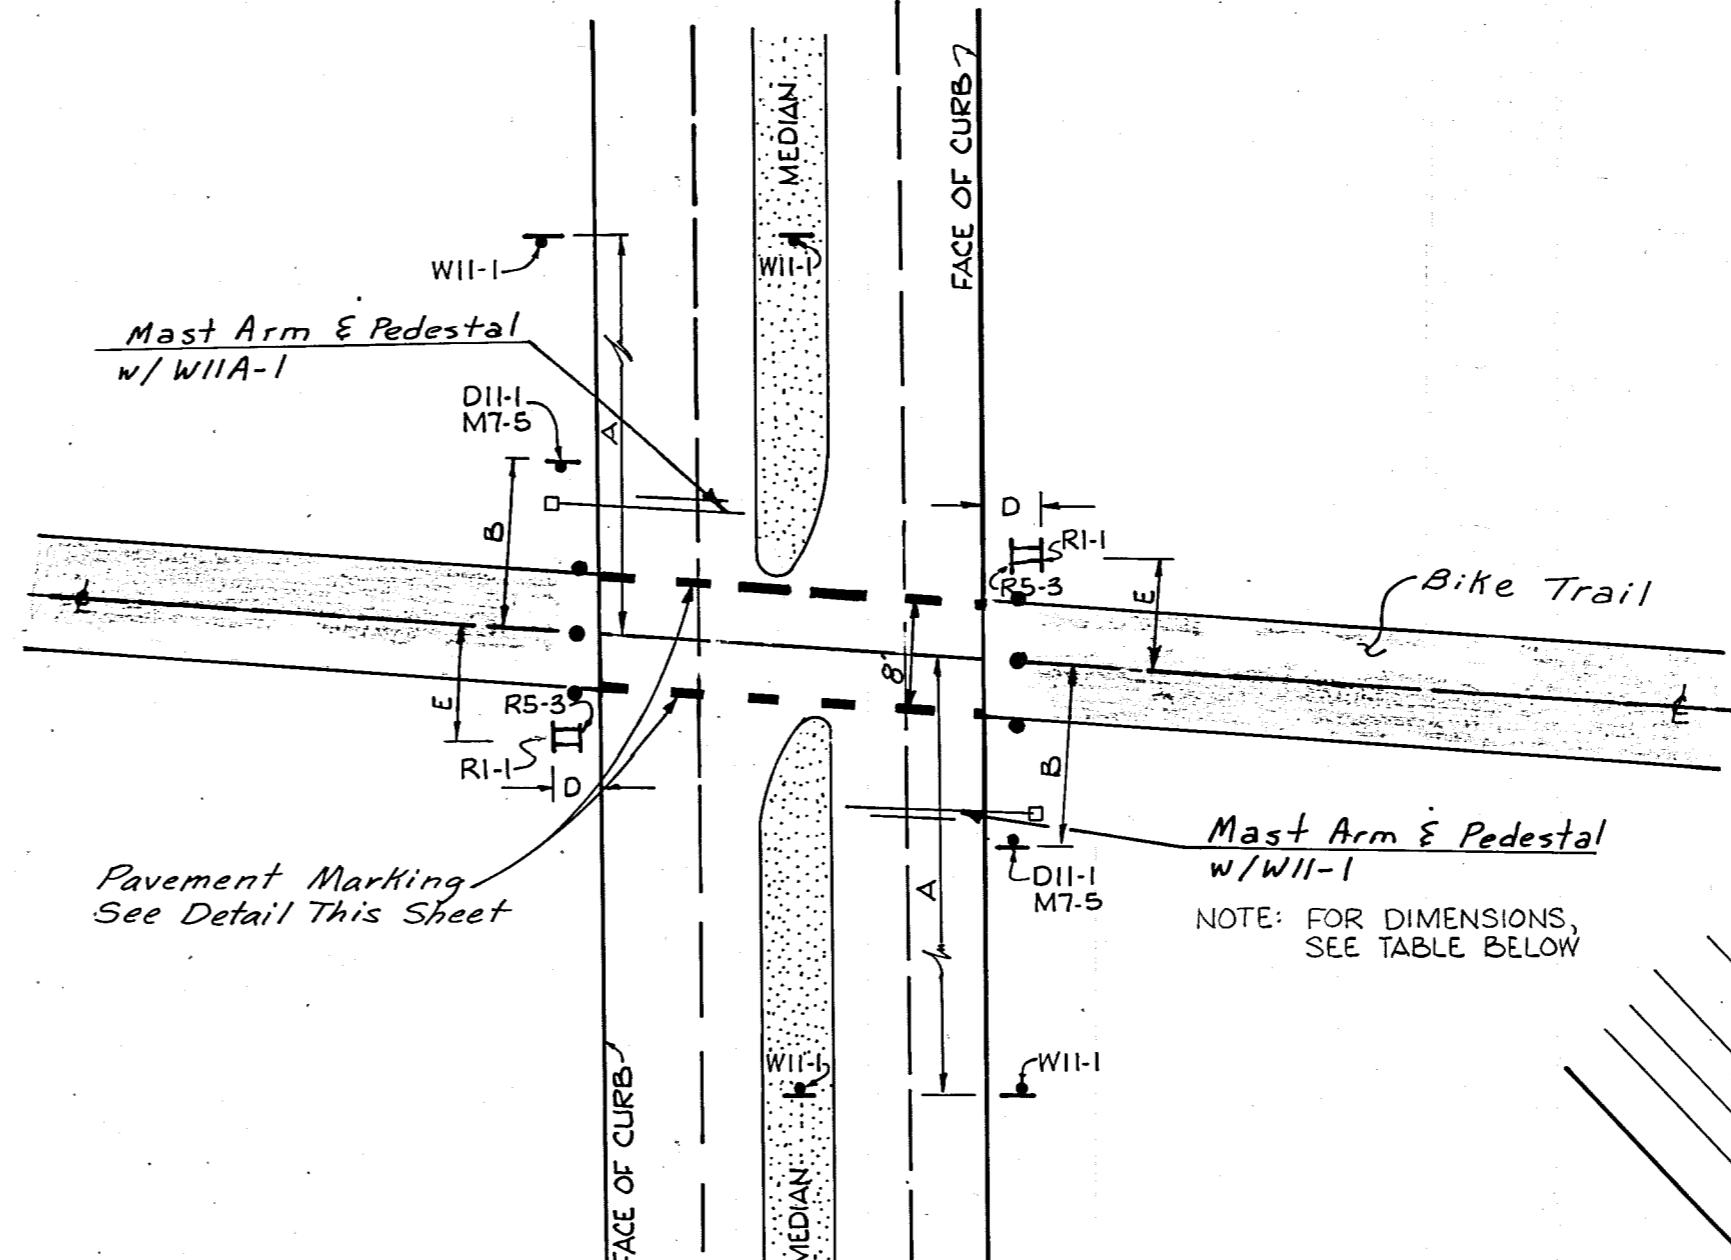


MAJOR STREET INTERSECTION  
NOT TO SCALE

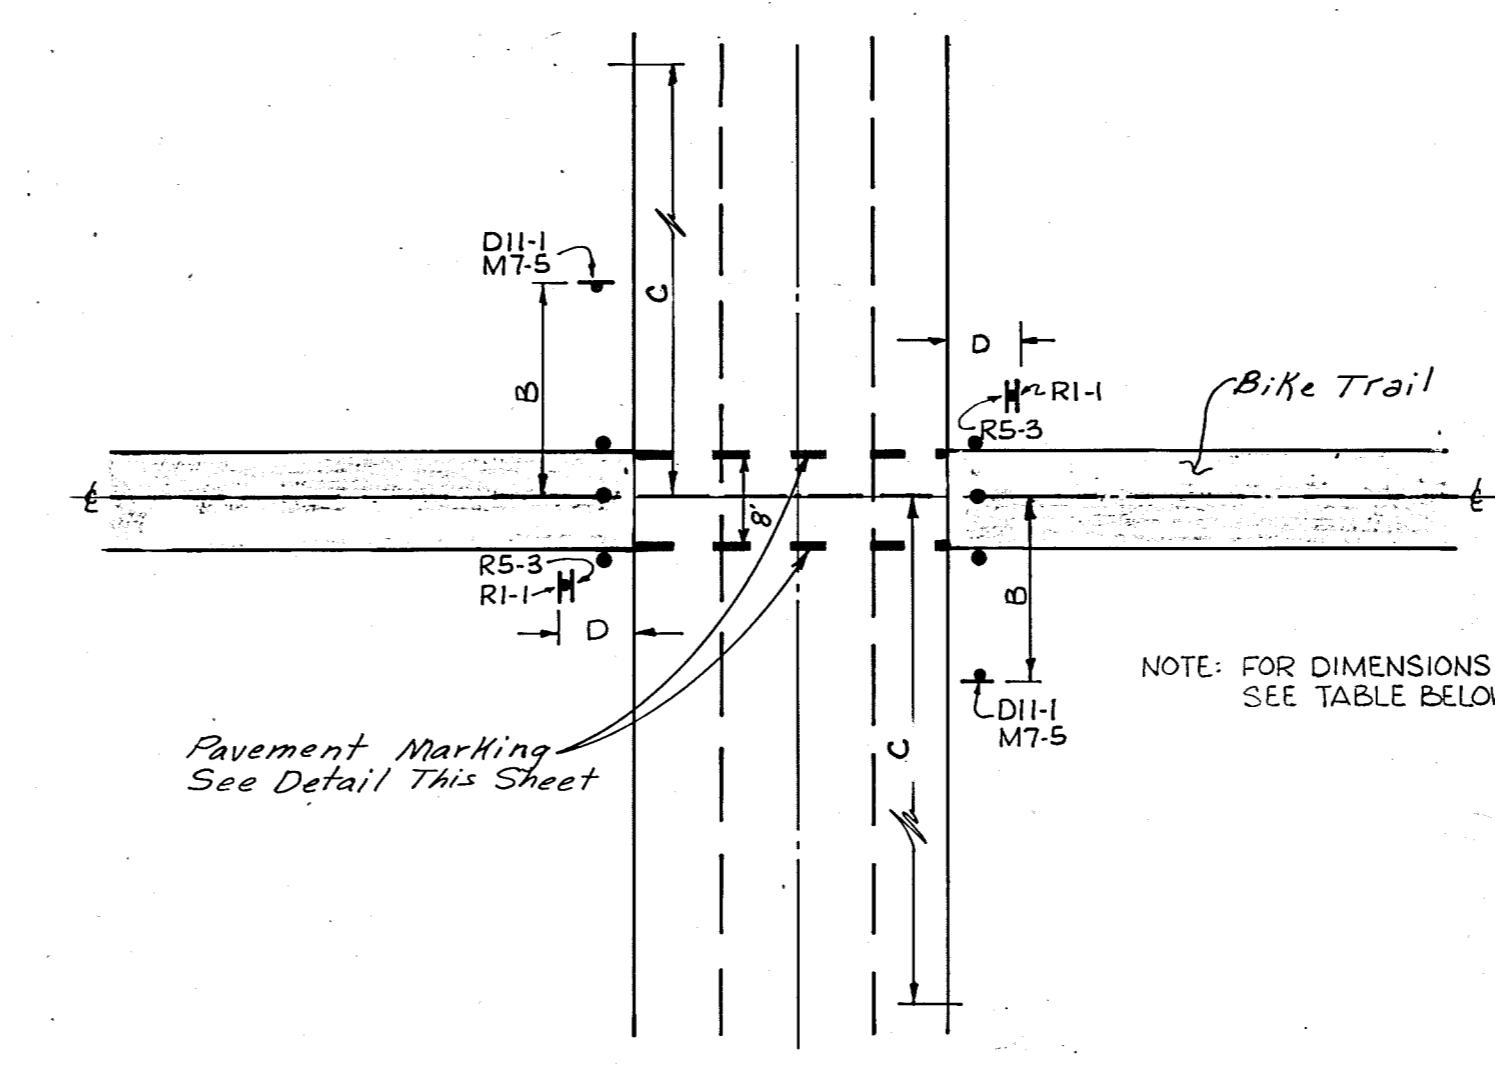


MINOR STREET INTERSECTION  
NOT TO SCALE

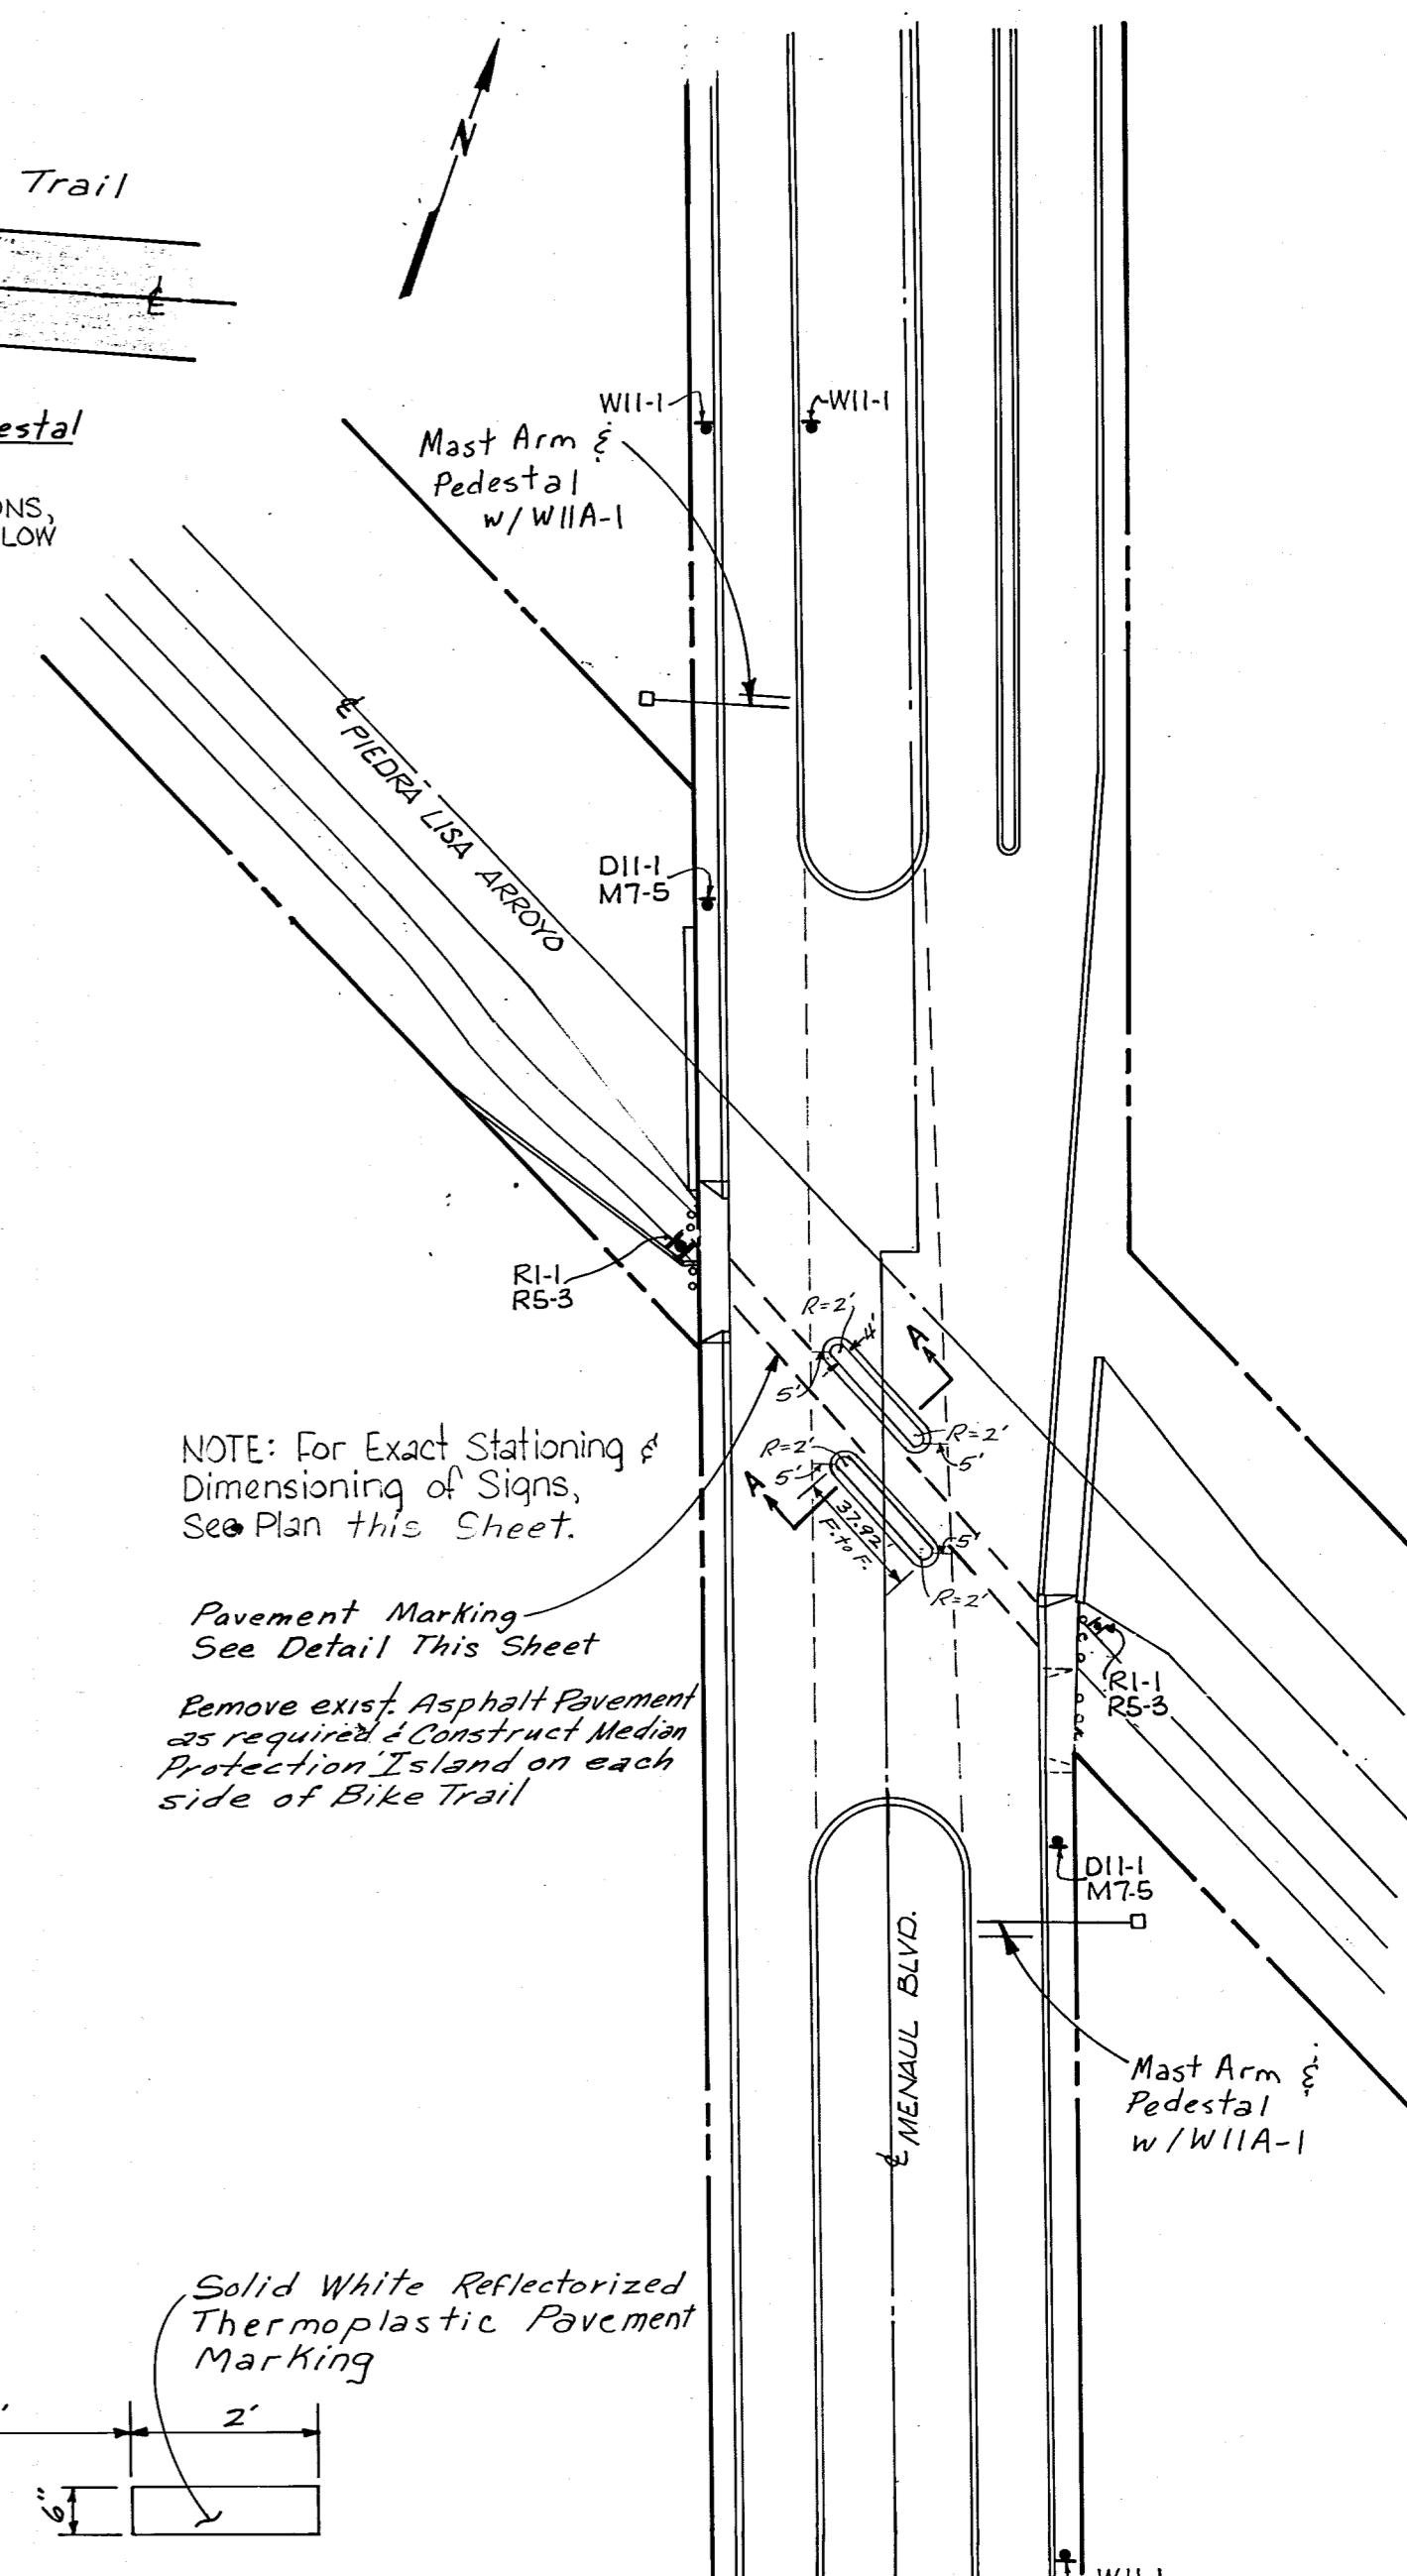

PAVEMENT MARKING DETAIL  
AT STREET CROSSINGS  
NOT TO SCALE

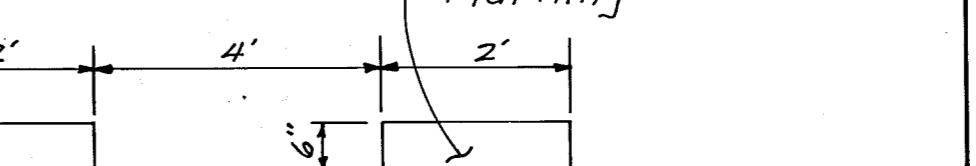


INTERSECTION AT MENAUL BLVD.  
NOT TO SCALE

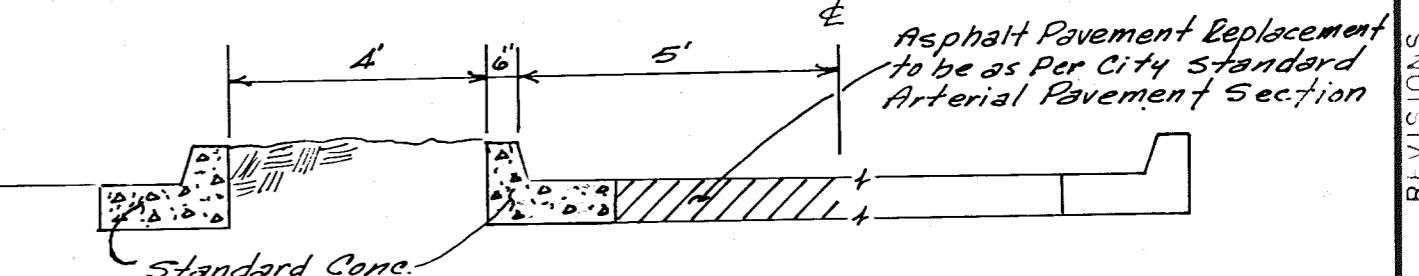

SECTION A-A  
NOT TO SCALE

AS BUILT

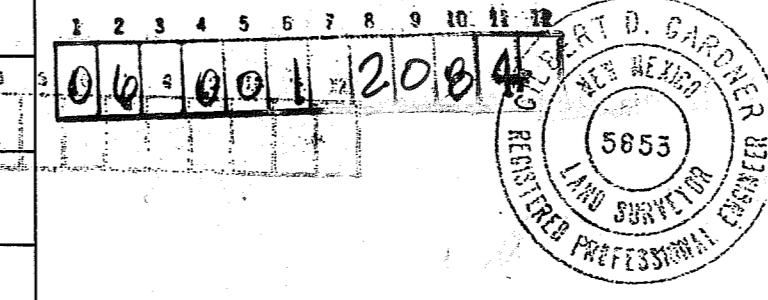

CITY OF ALBUQUERQUE  
MUNICIPAL DEVELOPMENT DEPARTMENT  
ENGINEERING DIVISION

TITLE EMBUDO/PIEDRA LISA RECREATIONAL TRAIL

DETAILS

APPROVALS	ENGINEER	DATE	APPROVALS	ENGINEER	DATE
City Engineer A.C.E. Design A.C.E. Hydrology			Liquid Waste Traffic Water		
DRAWING N.C.					

NOTE:  
Traffic Signs to be placed along the Streets are included  
in the Base Bid. Traffic Signs along the Bike Trail are  
included in the Additive Alternate No. 2.

GARDNER, MASON & ASSOC. INC.  
ALBUQUERQUE, NEW MEXICO



AS BUILT INFORMATION  
CONTRACTOR Gaylord Brothers  
Work Accepted By G.G.  
Drawn Corrected by X2B  
Information Date 3/23/03  
Recorded By No.

REVISIONS  
MAP NO. W.O. NO. FIELD NOTES  
EST. NO. NO. NO. NO. NO.  
BY


REMARKS DESIGN DATE  
NO. NO. NO. NO. NO. NO.  
BY

SECTION A-A  
NOT TO SCALE


AS BUILT  
Drawn By Date  
Checked By Date

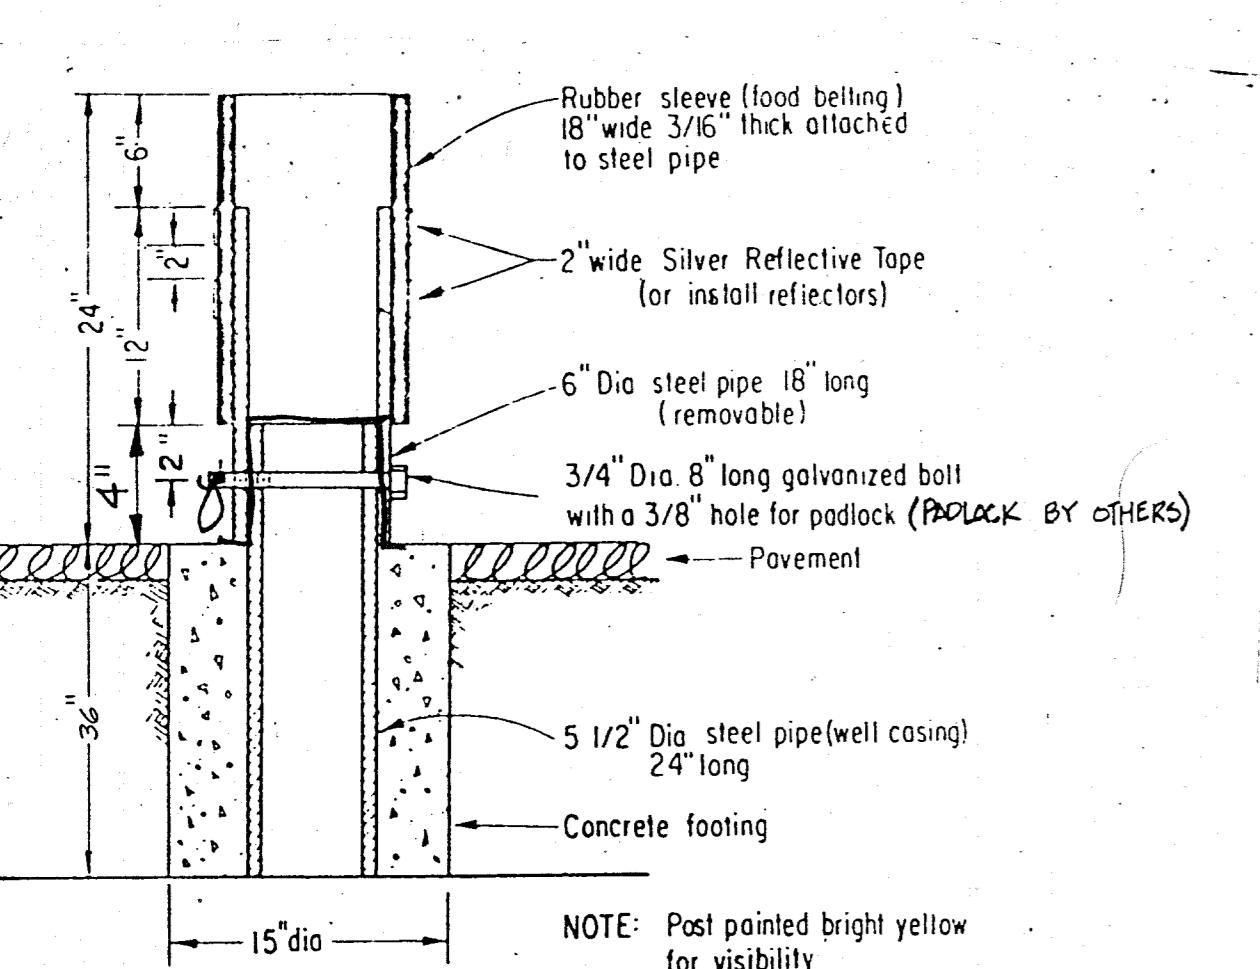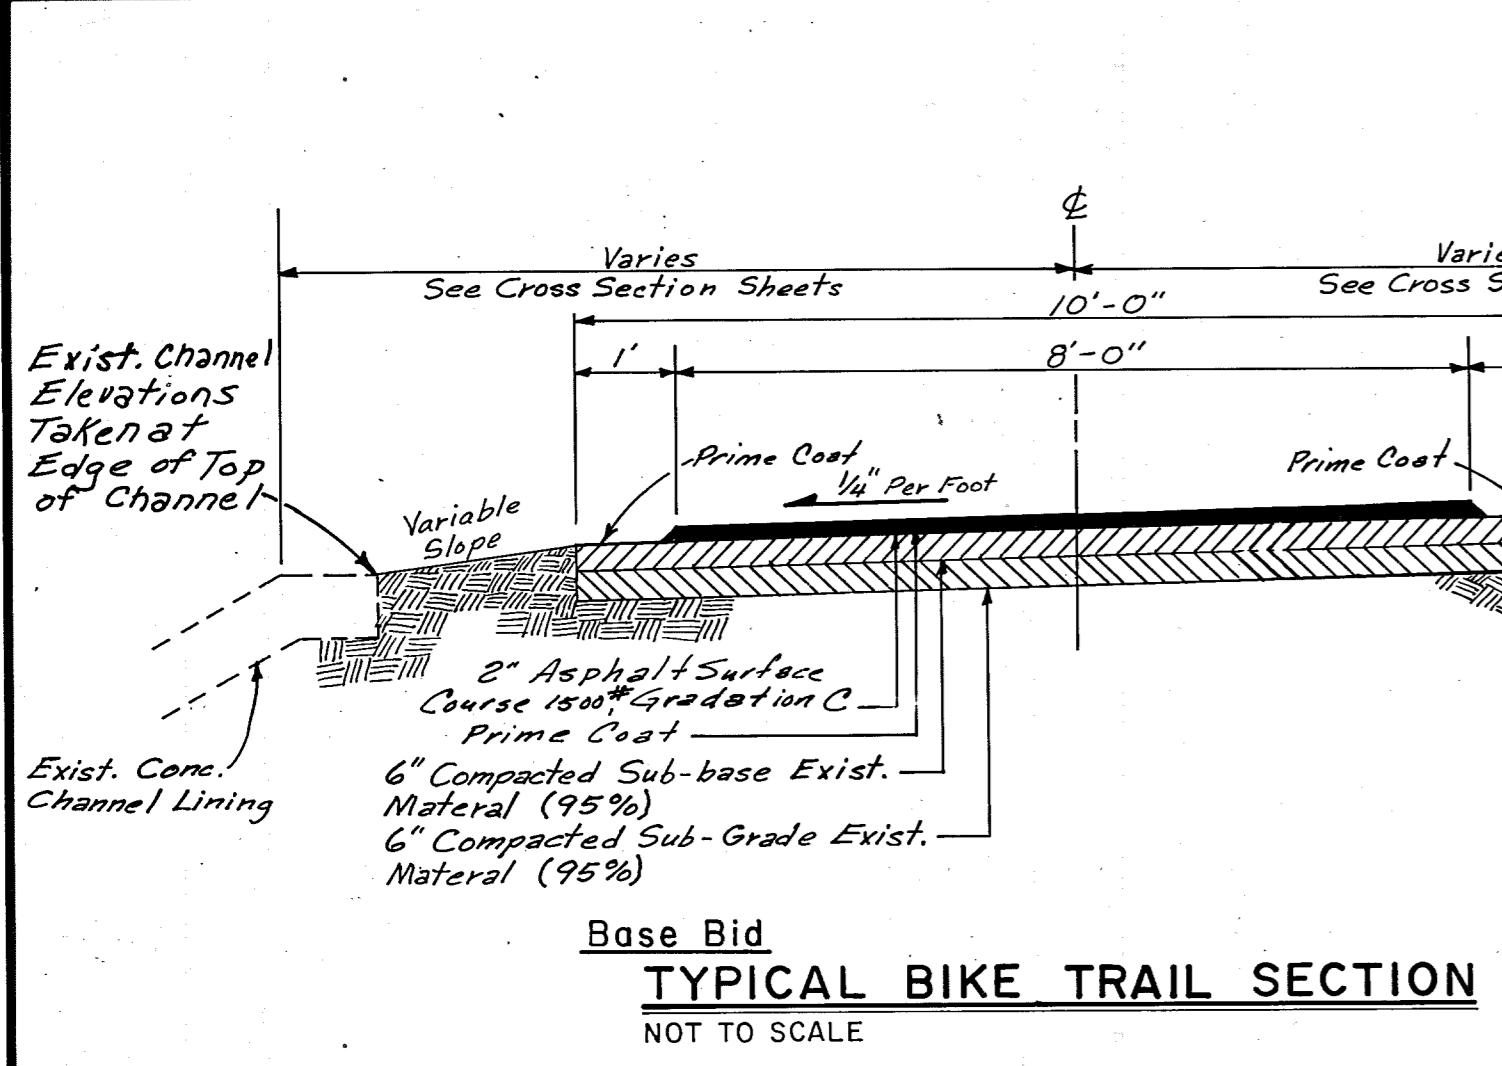


# SECTION REMOVABLE BOILLARD DETAIL

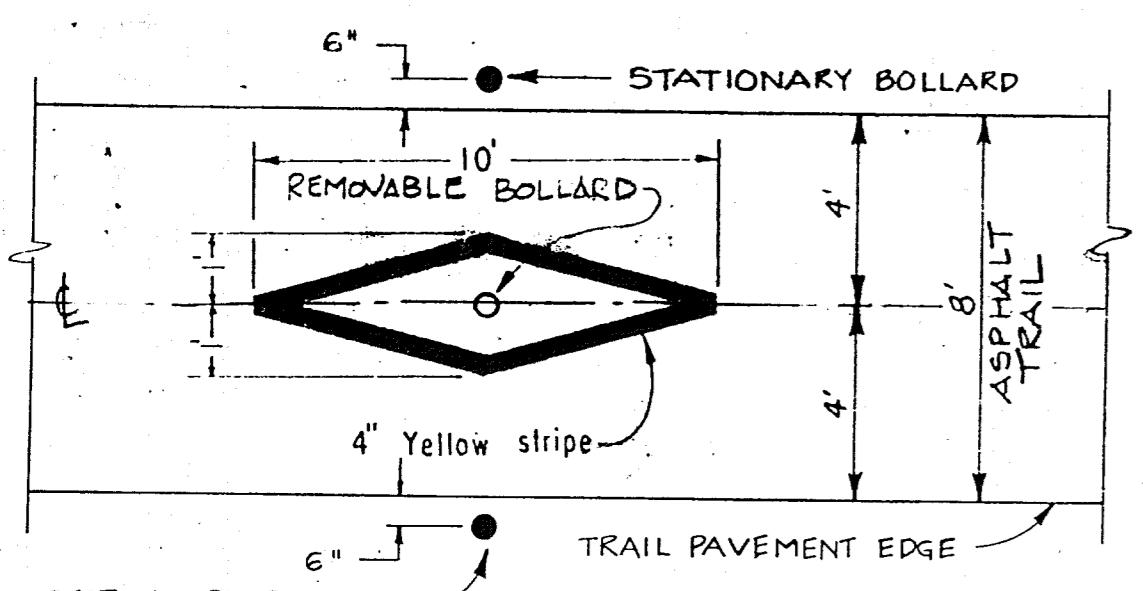

PLAN VIEW  
TYPICAL BOLLARD LOCATION

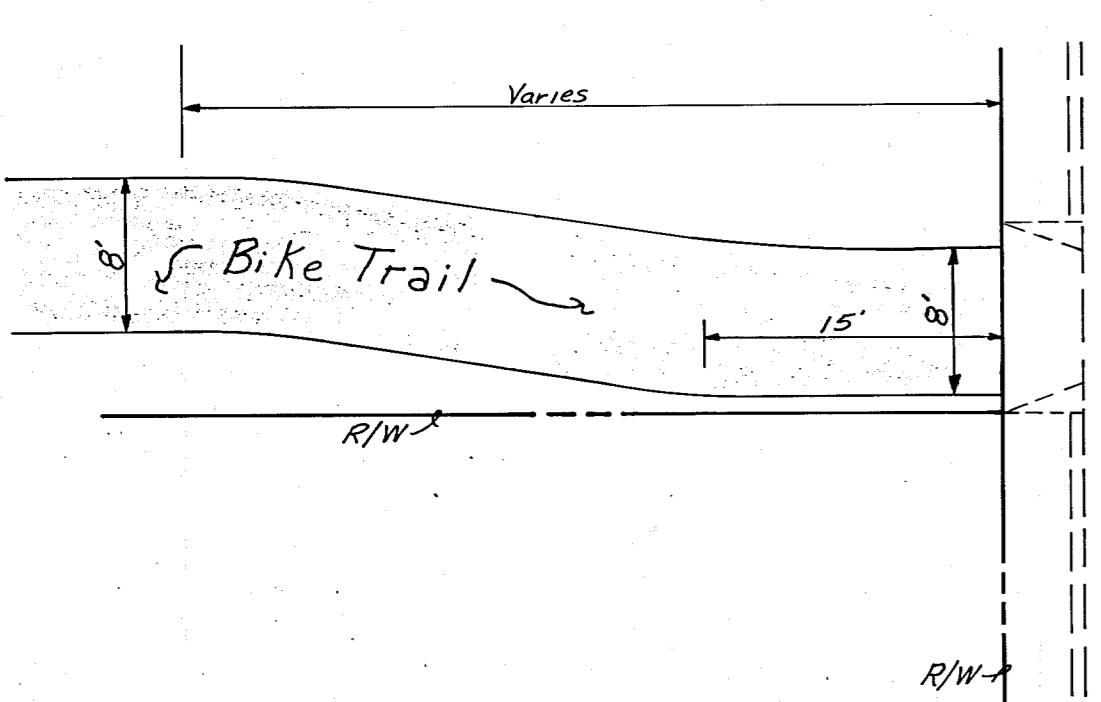

# TYPICAL TRANSITION DETAIL

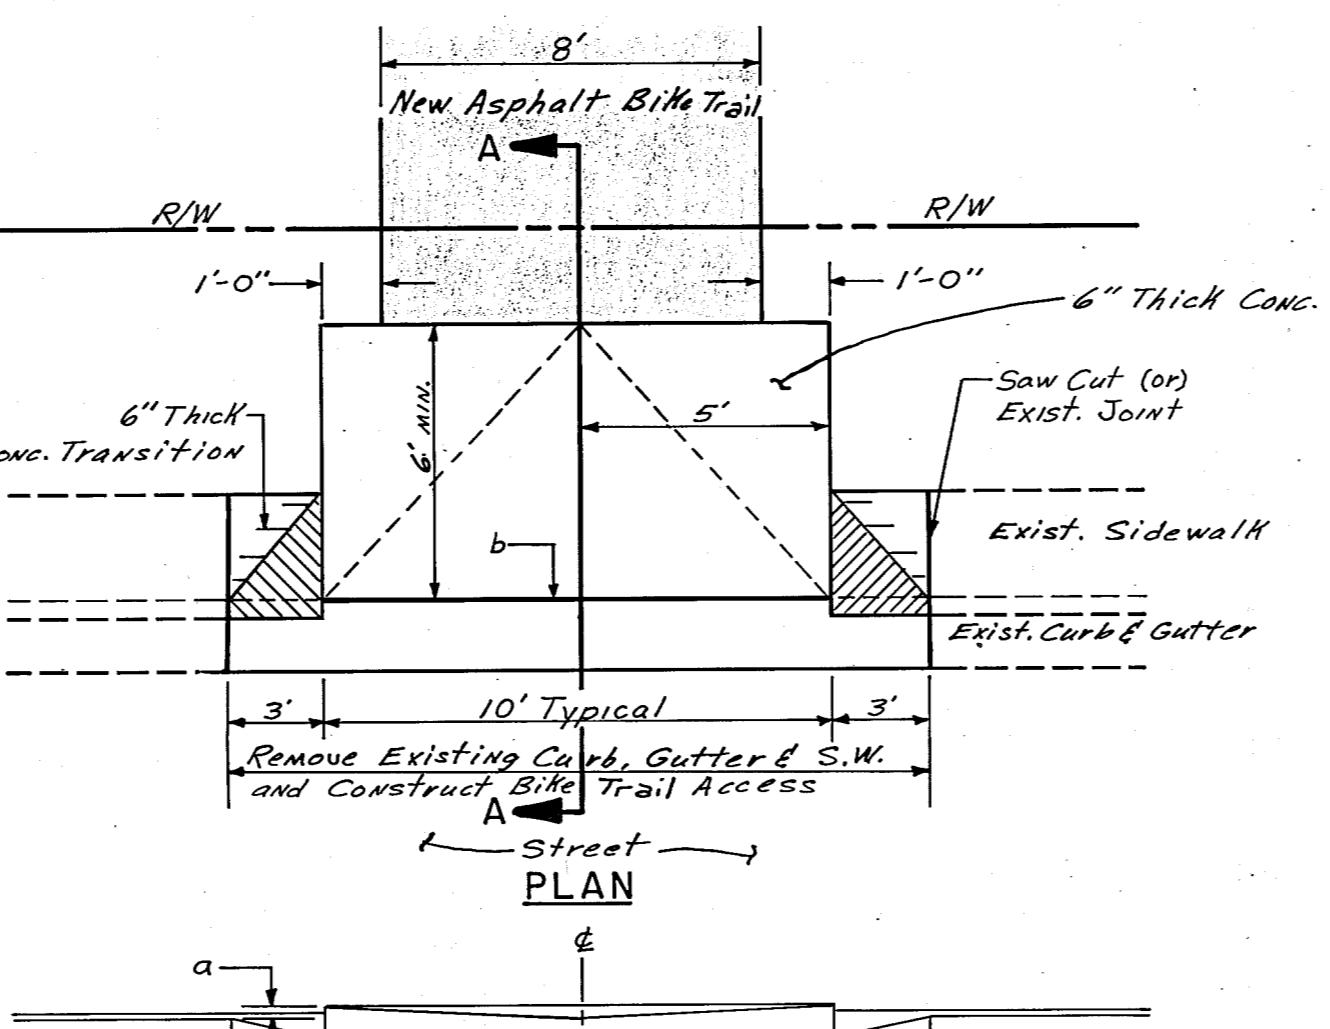

FRONT VIEW

NOTES:  
a Finished Grade to be 0.33'  
above Top of Curb at  
Property Line.

b Expansion  
Joint. Material


3"

6"


6 X 6 - W1.4 X W1.4  
Welded Wire Fabric

SECTION A-A


**CURB CUT AT BIKE TRAIL CROSSING**  
NOT TO SCALE

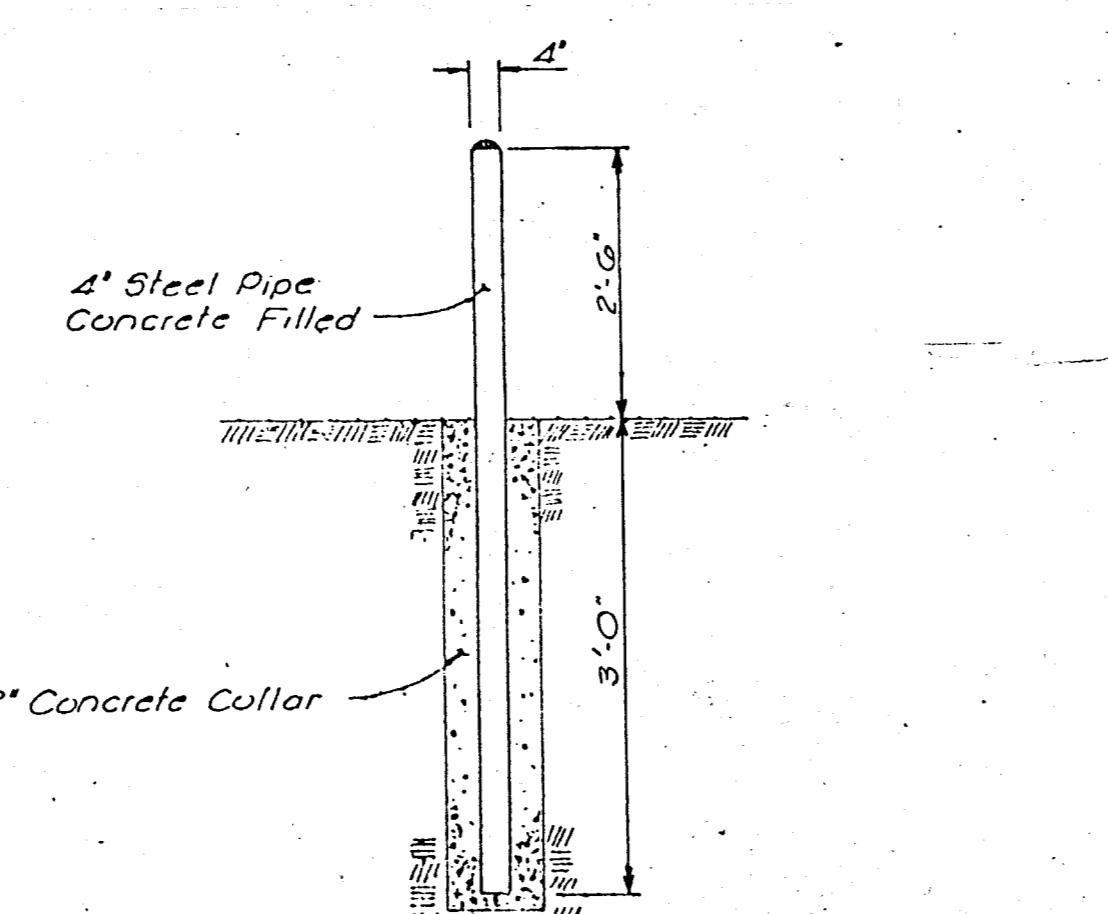

SECTION  
STATIONARY BOLLARD DETAIL

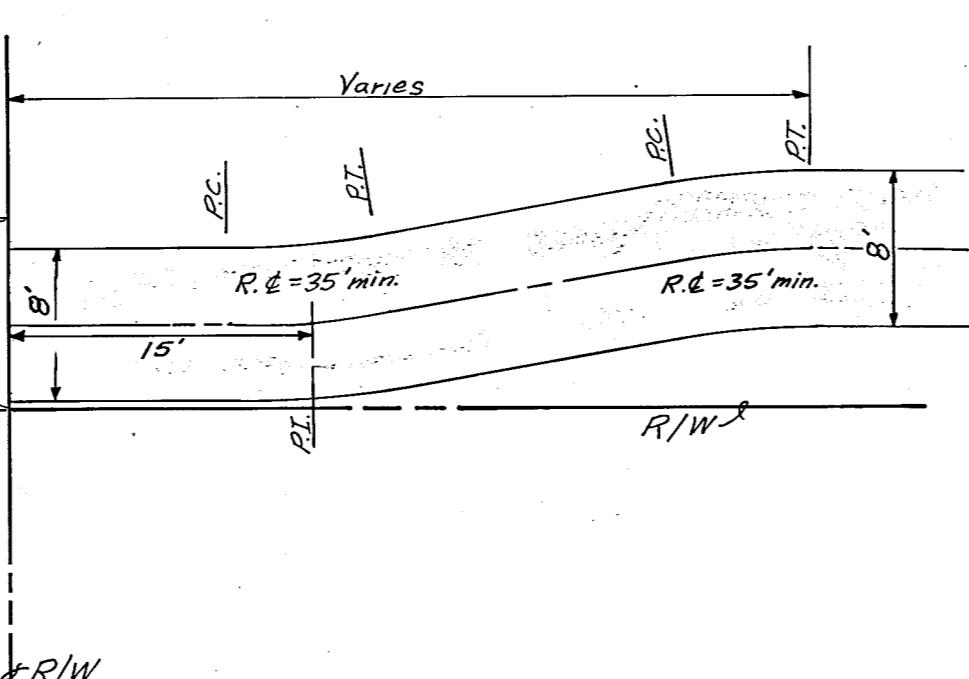

**TRANSITION DETAIL AT CHELWOOD PARK BLVD.**

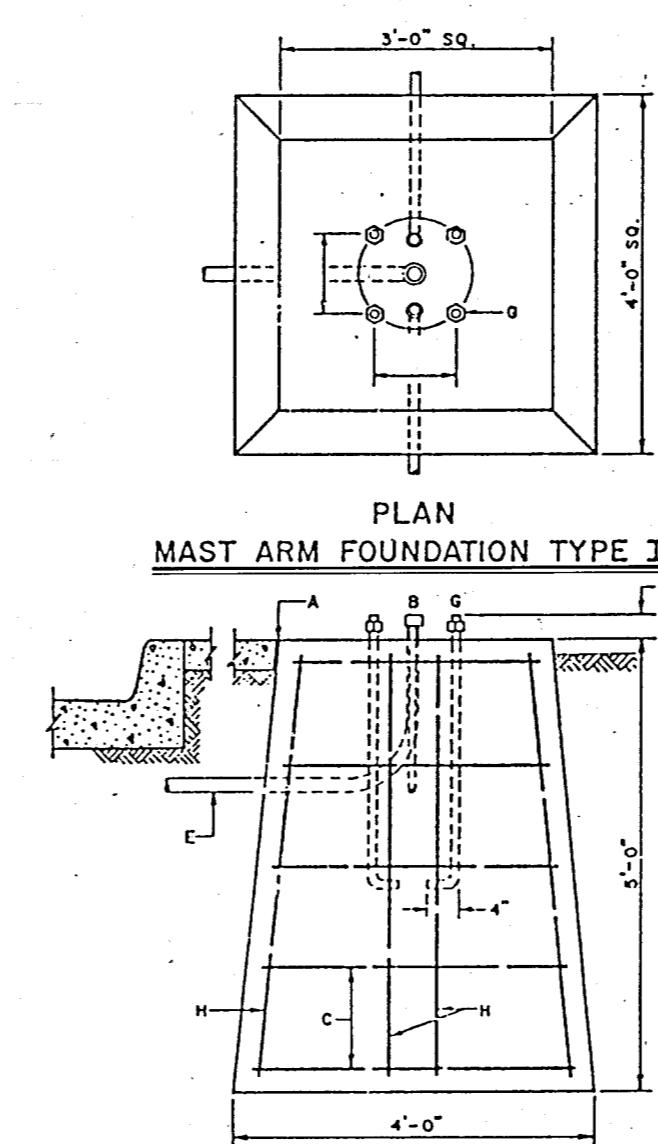

#### SECTION


#### GENERAL NOTES:

- GENERAL NOTES.


  - I. THE TOP OF THE MAST ARM AND PEDESTAL FOUNDATIONS SHALL BE LEVEL. WHEN PLACED IN MEDIAN WHERE MEDIAN IS CONC., THE TOP OF THE FOUNDATION SHALL BE FLUSH WITH THE TOP OF THE CONC. SURFACE. WHERE THE MEDIAN IS ASPHALT, THE TOP OF THE FOUNDATION SHALL BE FLUSH WITH THE FUTURE CONC. SURFACE, AS CALCULATED BY THE CITY ENGINEERING DIVISION. WHEN LOCATED ON OR ADJACENT TO SIDEWALKS, THE TOP OF THE FOUNDATION SHALL BE LEVEL WITH SIDEWALK ALONG THE PROPERTY SIDE OF THE FOUNDATION.

CONSTRUCTION NOTES:

  - A. EXPANSION JOINT MATERIAL (TYPICAL).
  - B. WEATHER CAP.
  - C. NO. 4 TIES.
  - D. NO. 6 AT EACH CORNER.
  - E. RIGID CONDUIT.
  - F. 4- 1" X 3'-0" ANCHOR BOLTS, WITH NUTS AND LOCKWASHERS ON 15" DIA. BOLT CIRCLE.
  - G. SEE TRAFFIC ENGINEERING DIVISION FOR EXACT BOLT CIRCLE DIAMETER AND BOLT DIMENSIONS.
  - H. NO. 6 - 12 REQUIRED.
  - I. MAST ARM TO BE 25' EXCEPT AT INDIAN SCHOOL ROAD WHICH IS TO BE 20'.
  - J. MAST ARM & PEDESTAL WITH WIIA-1(2) SHOULD HAVE BREAK AWAY POLES.

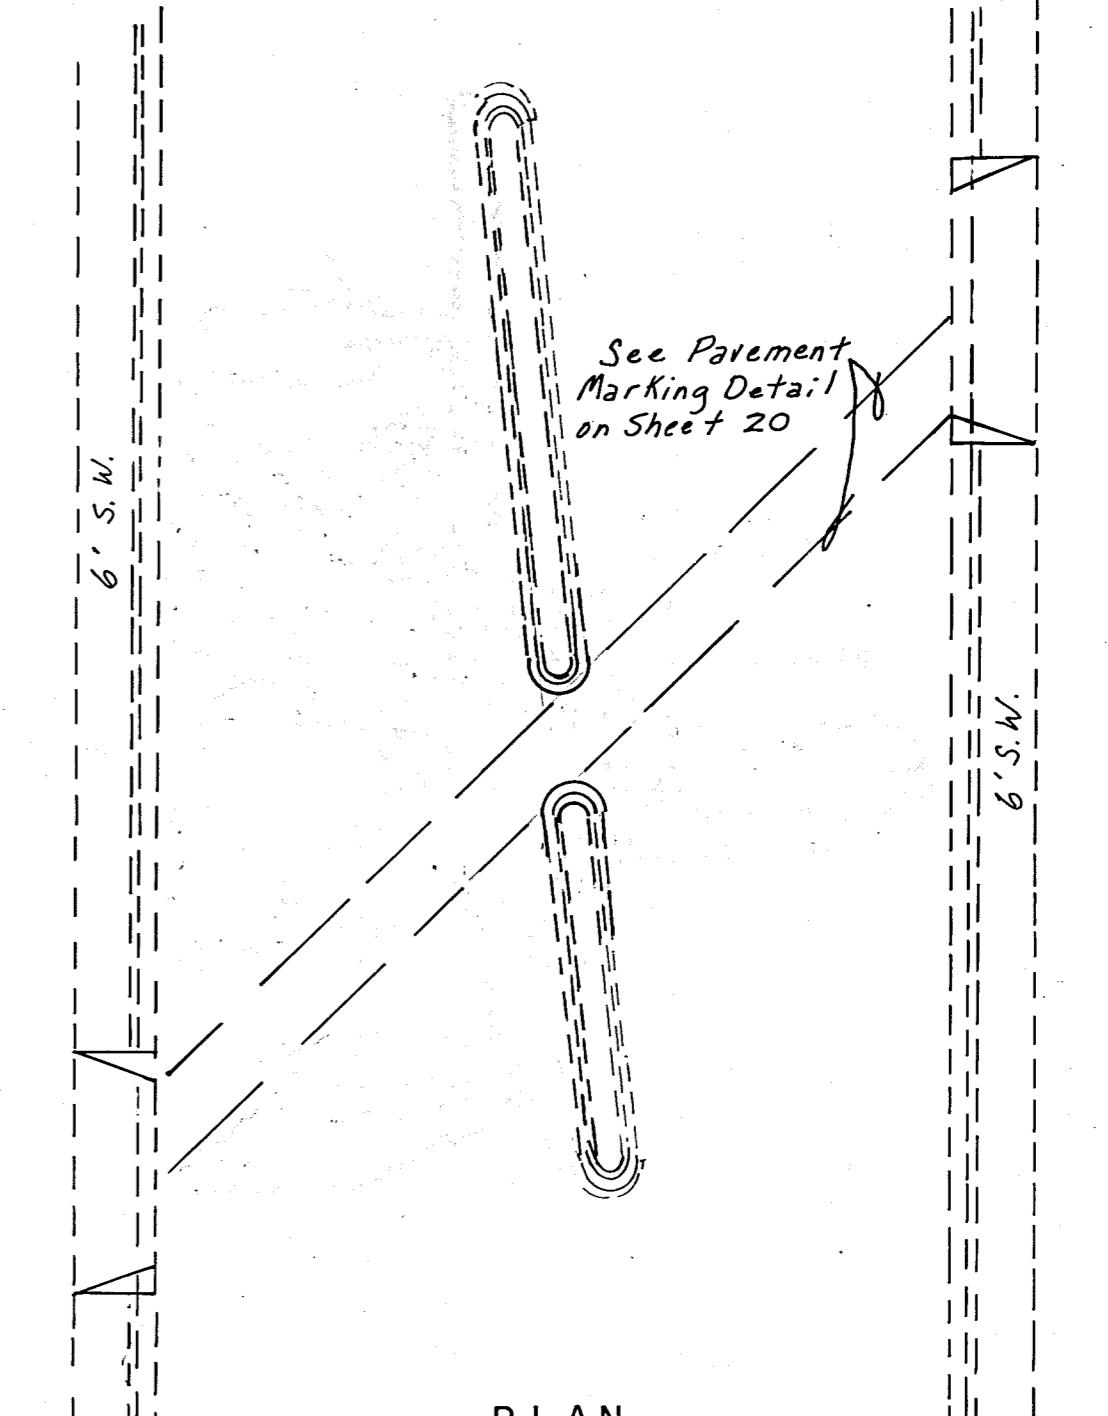


— PLAN

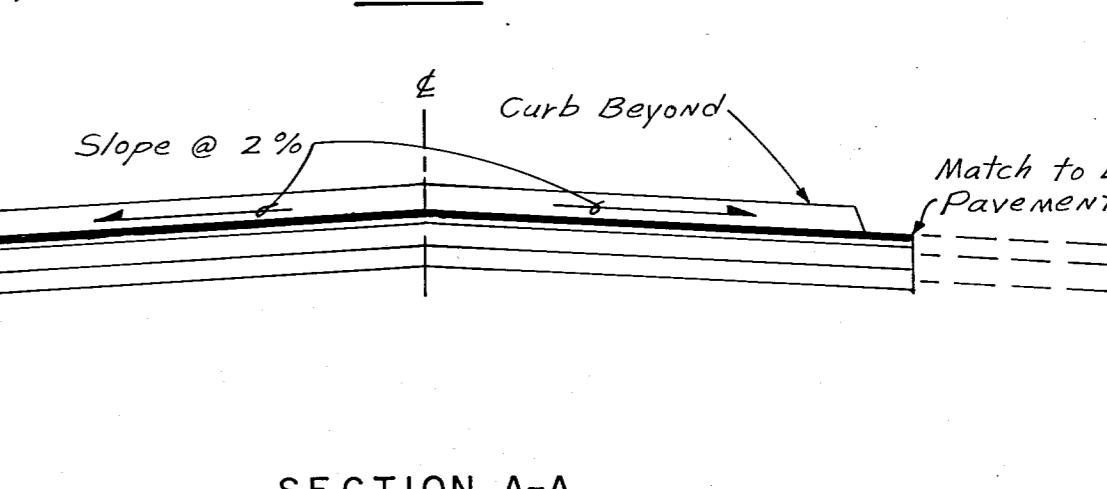

**UAN TABO BLVD. MEDIAN WAITING AREA**


CITY OF ALBUQUERQUE MUNICIPAL DEVELOPMENT DEPARTMENT ENGINEERING DIVISION					
TITLE EMBUDO/PIEDRA LISA RECREATIONAL TRAIL					
DETAILS					
APPROVALS	ENGINEER	DATE	APPROVALS	ENGINEER	DATE
City Engineer			Liquid Waste		
C.E. Design			Traffic		
C.E. Hydrology			Water		
DRAWING NO.				SHEET 21 OF 2	

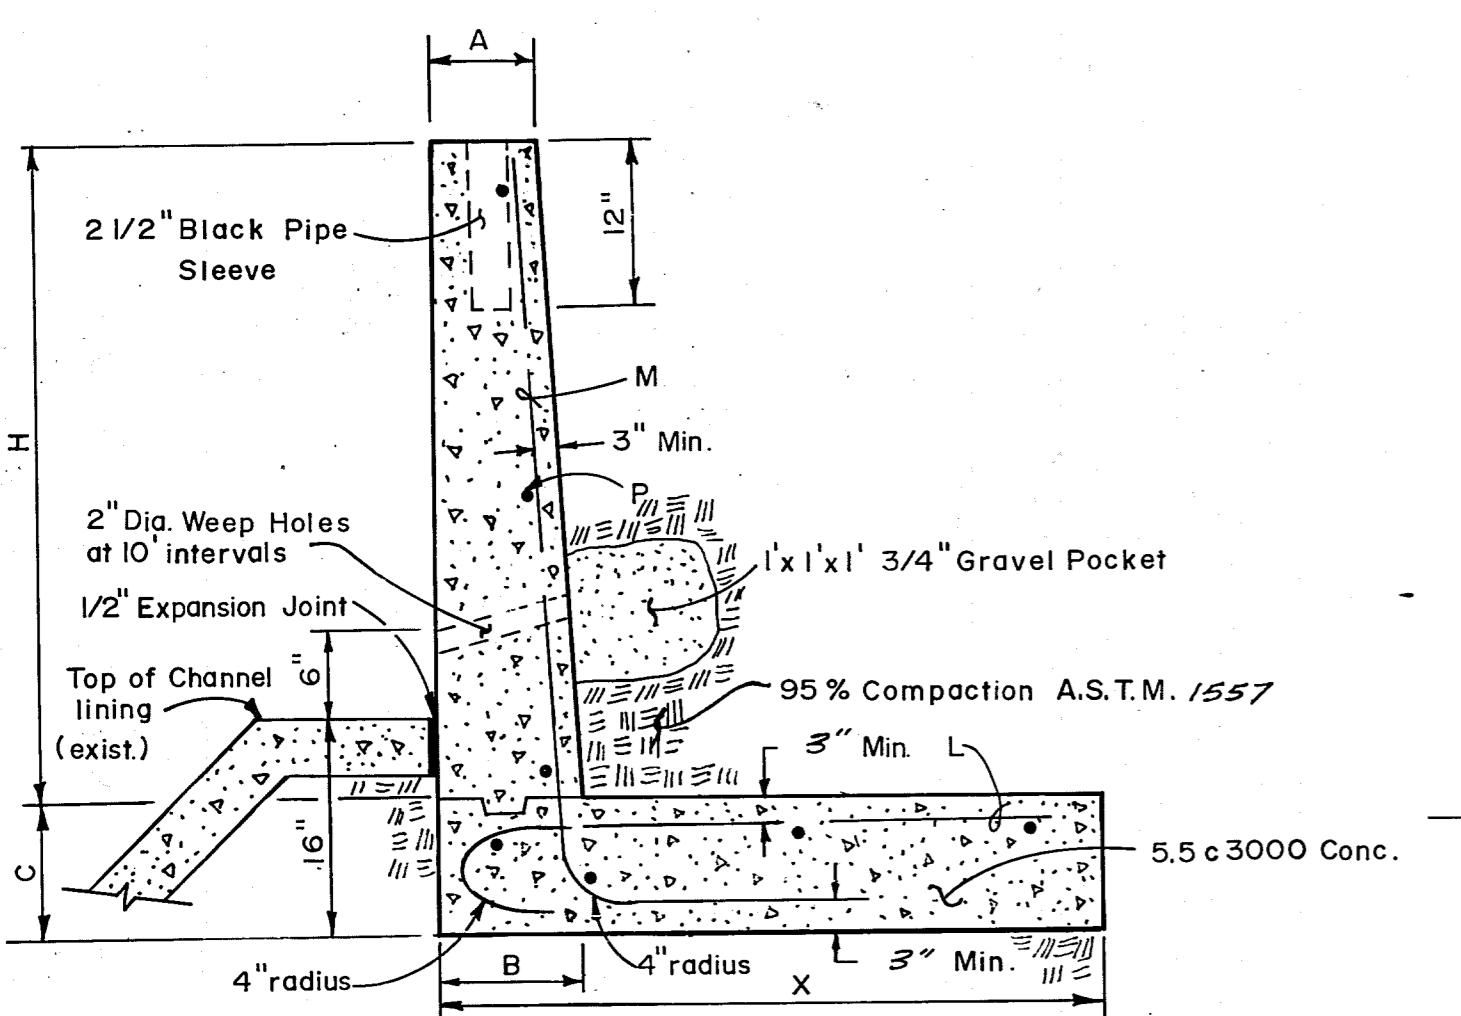

### RETAINING WALL DETAIL

NOT TO SCALE See Sheets 10 & 15


H	A	B	C	REINFORCING			X
				M	P	L	
1'	6"	8"	10"	#5@18" O.C. 3'-0" long	#5@18" O.C. 5'-0" long	3'-2"	
2'	8"	8"	10"	#5@18" O.C. 4'-0" long	#5@18" O.C. 5'-0" long	3'-2"	
3'	8"	10'	10'	#5@18" O.C. 5'-6" long	#5@18" O.C. 5'-0" long	3'-2"	
4'	8"	10"	10"	#5@18" O.C. 6'-6" long	#5@18" O.C. 6'-0" long	3'-10"	
5'	8"	10"	10"	#5@18" O.C. 7'-6" long	#5@18" O.C. 7'-0" long	4'-6"	

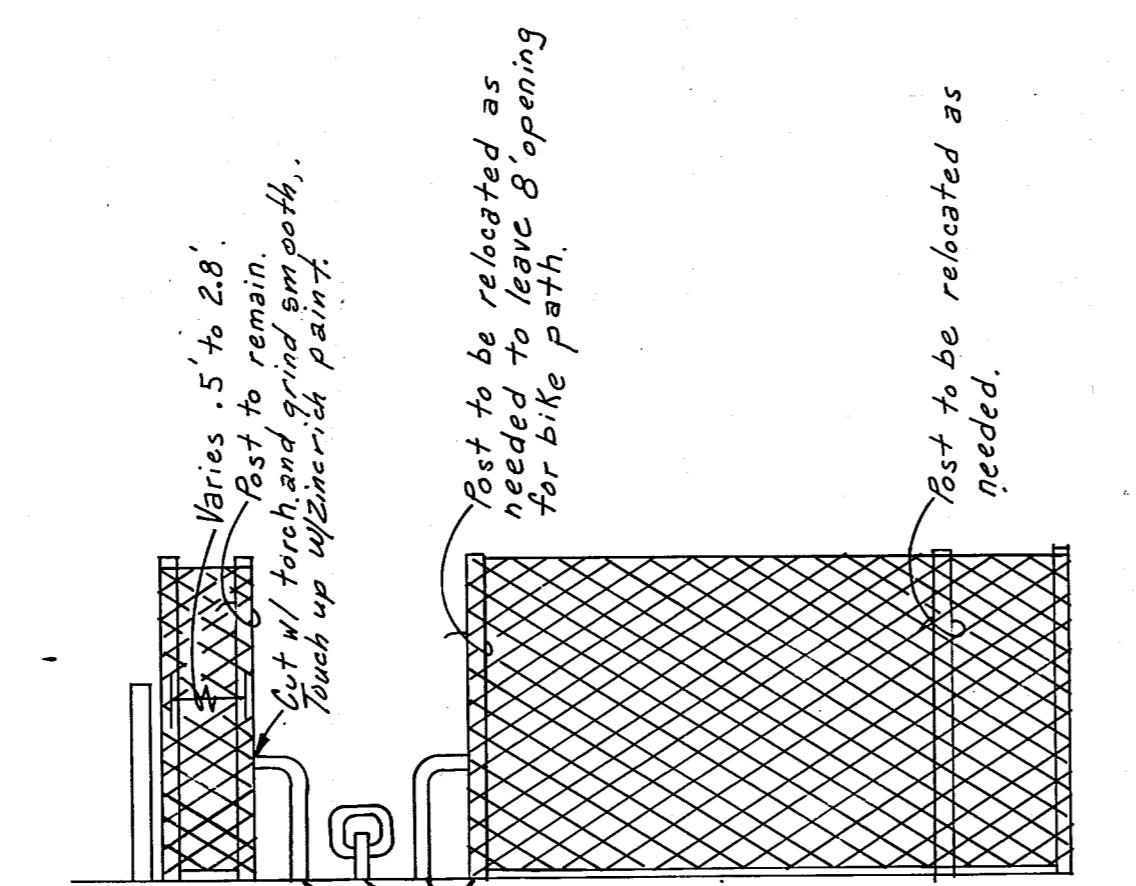


### EXISTING BIKE GATE & 12' MAINTENANCE GATE

### PROPOSED BIKE OPENING

#### CONDITION #1

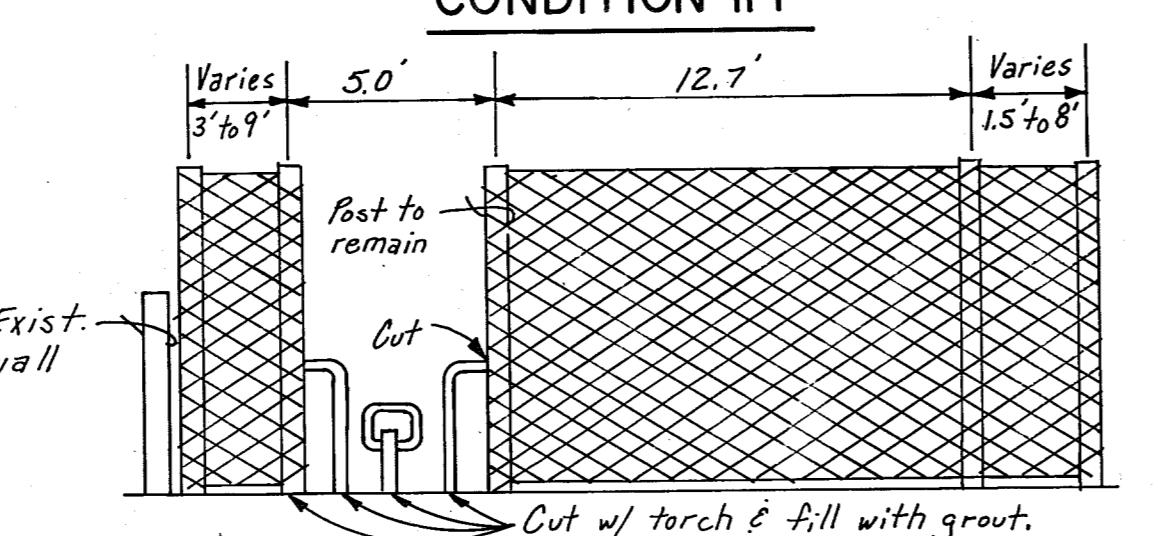


### EXISTING BIKE GATE & 12' MAINTENANCE GATE

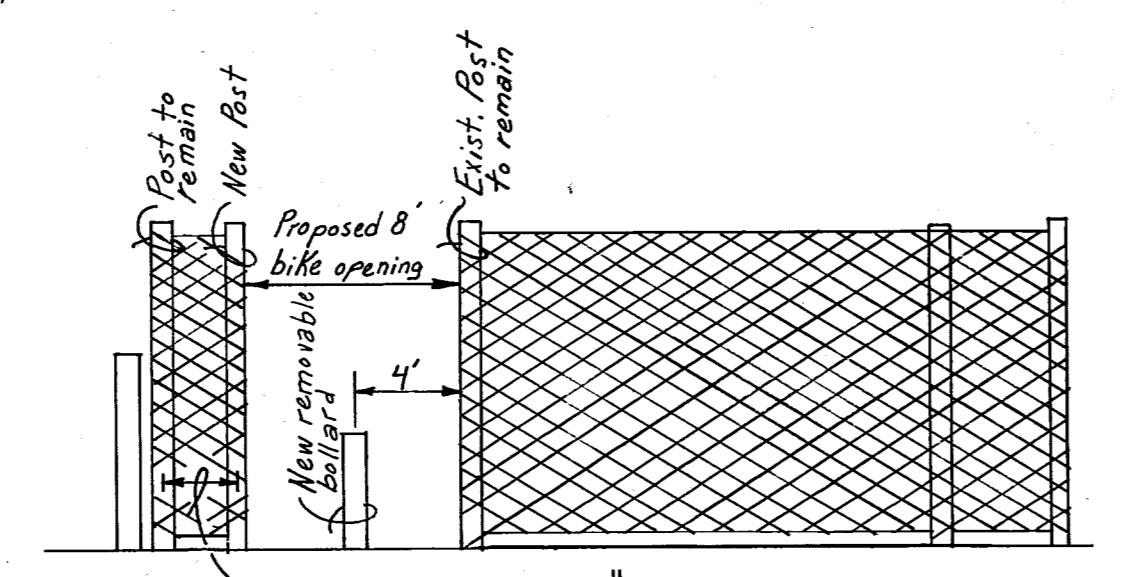

### HANDRAIL INSTALLATION DETAIL

NOT TO SCALE

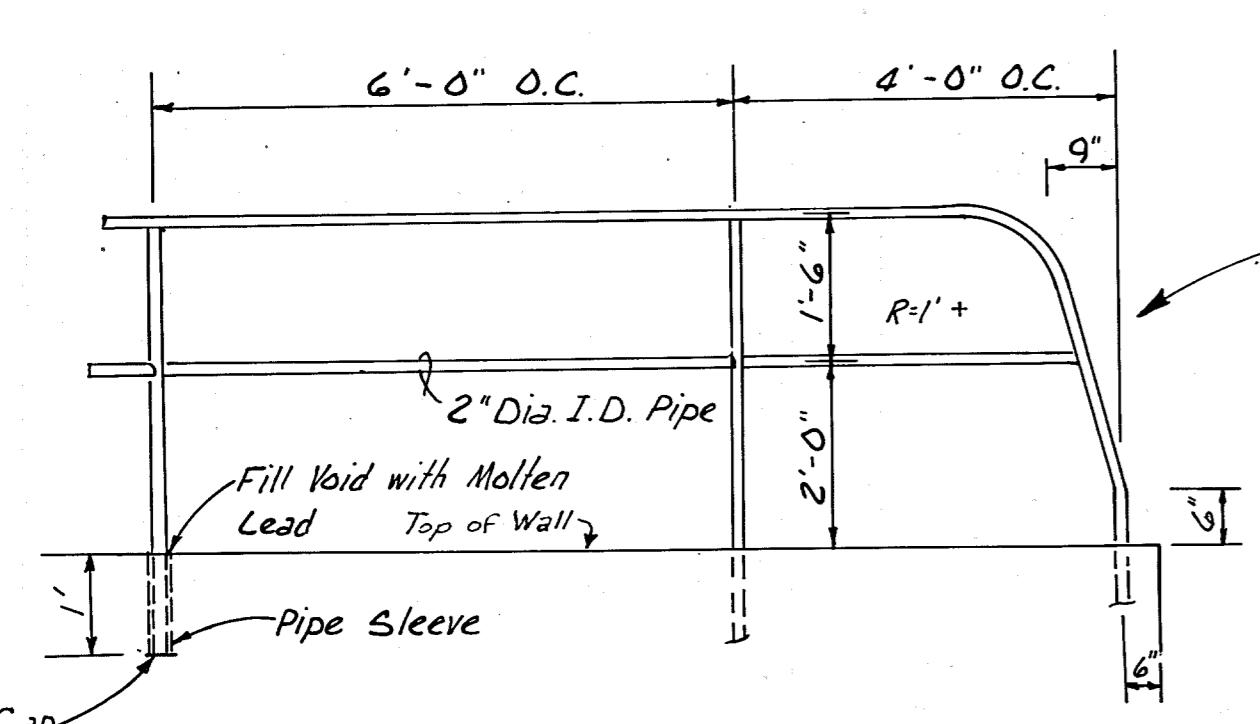

### STEEL HANDRAIL DETAIL


NOT TO SCALE

### PROPOSED BIKE OPENING

#### CONDITION #2


NOT TO SCALE

- Note:
- All 2" I.D. Pipes for Handrail to be Standard Weight, Seamless Steel Pipe, ASTM Designation A53-SST.
  - One Coat of Prime Coat and One of Red Lead Paint and One of Far Finished field Coat of Aluminum Paint should be applied to all Steel Handrails.

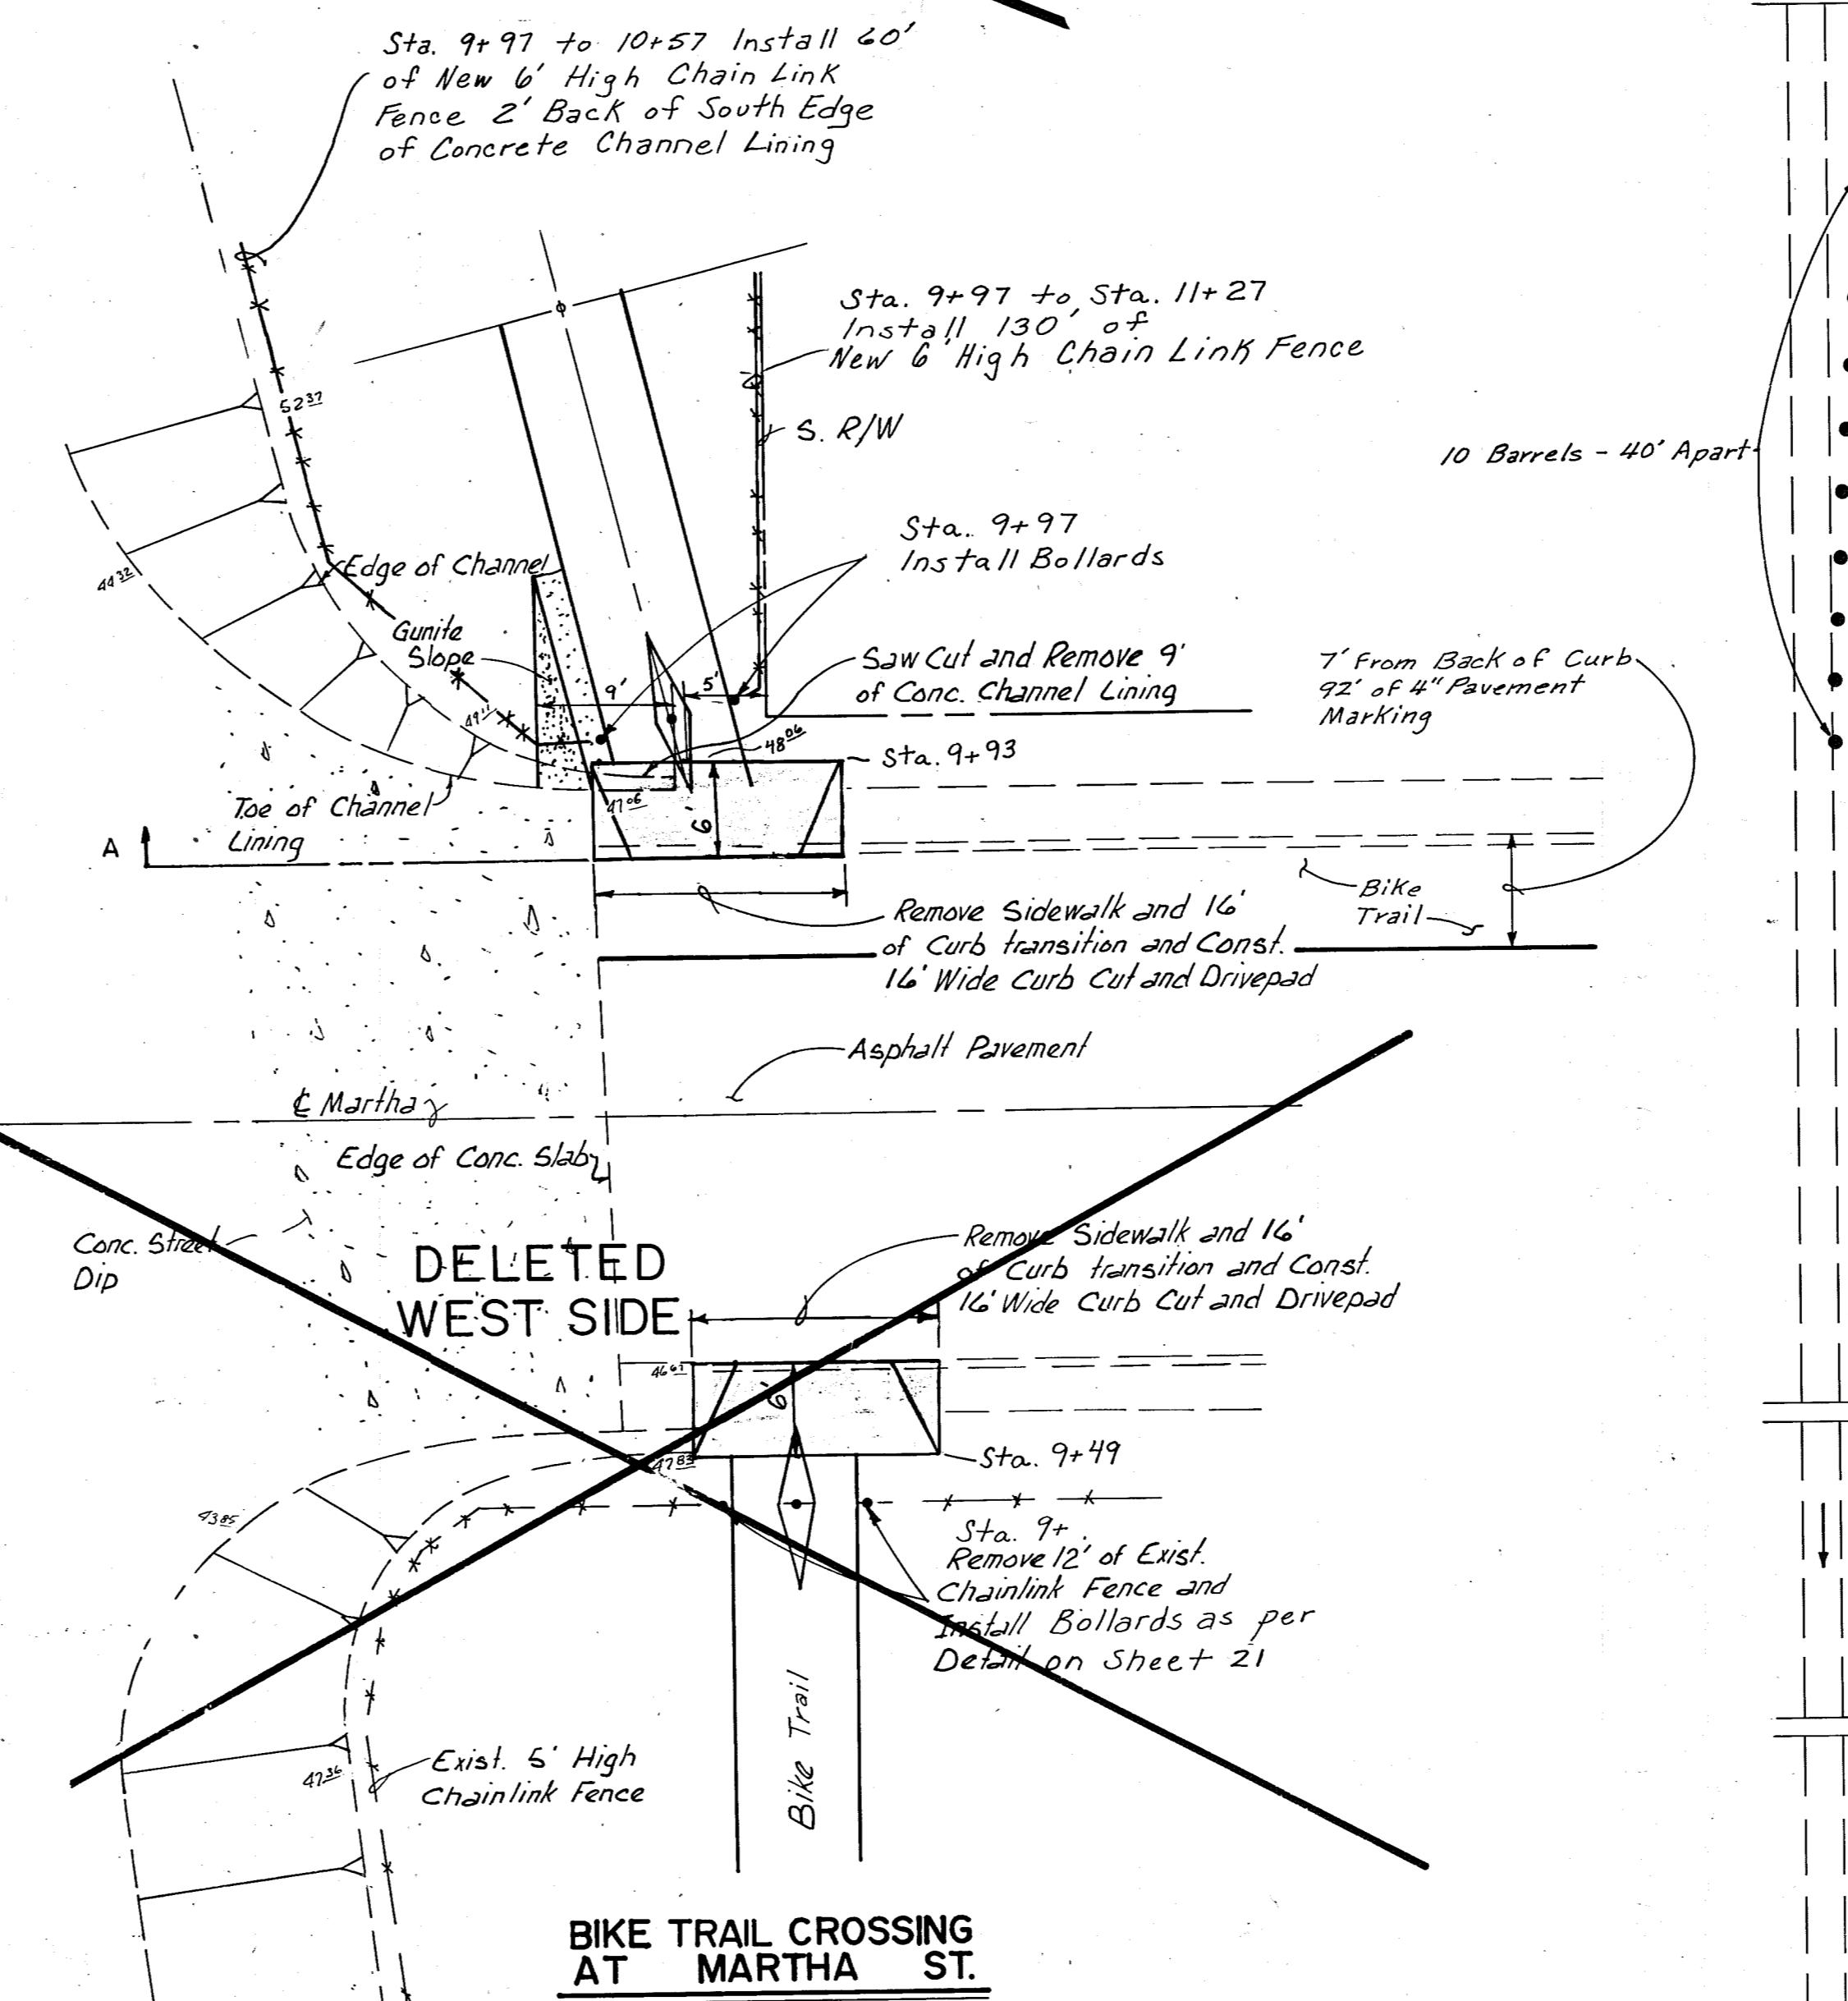
















### BIKE TRAIL CROSSING AT MARTHA ST.

SCALE: 1"=10' See Sheet 14

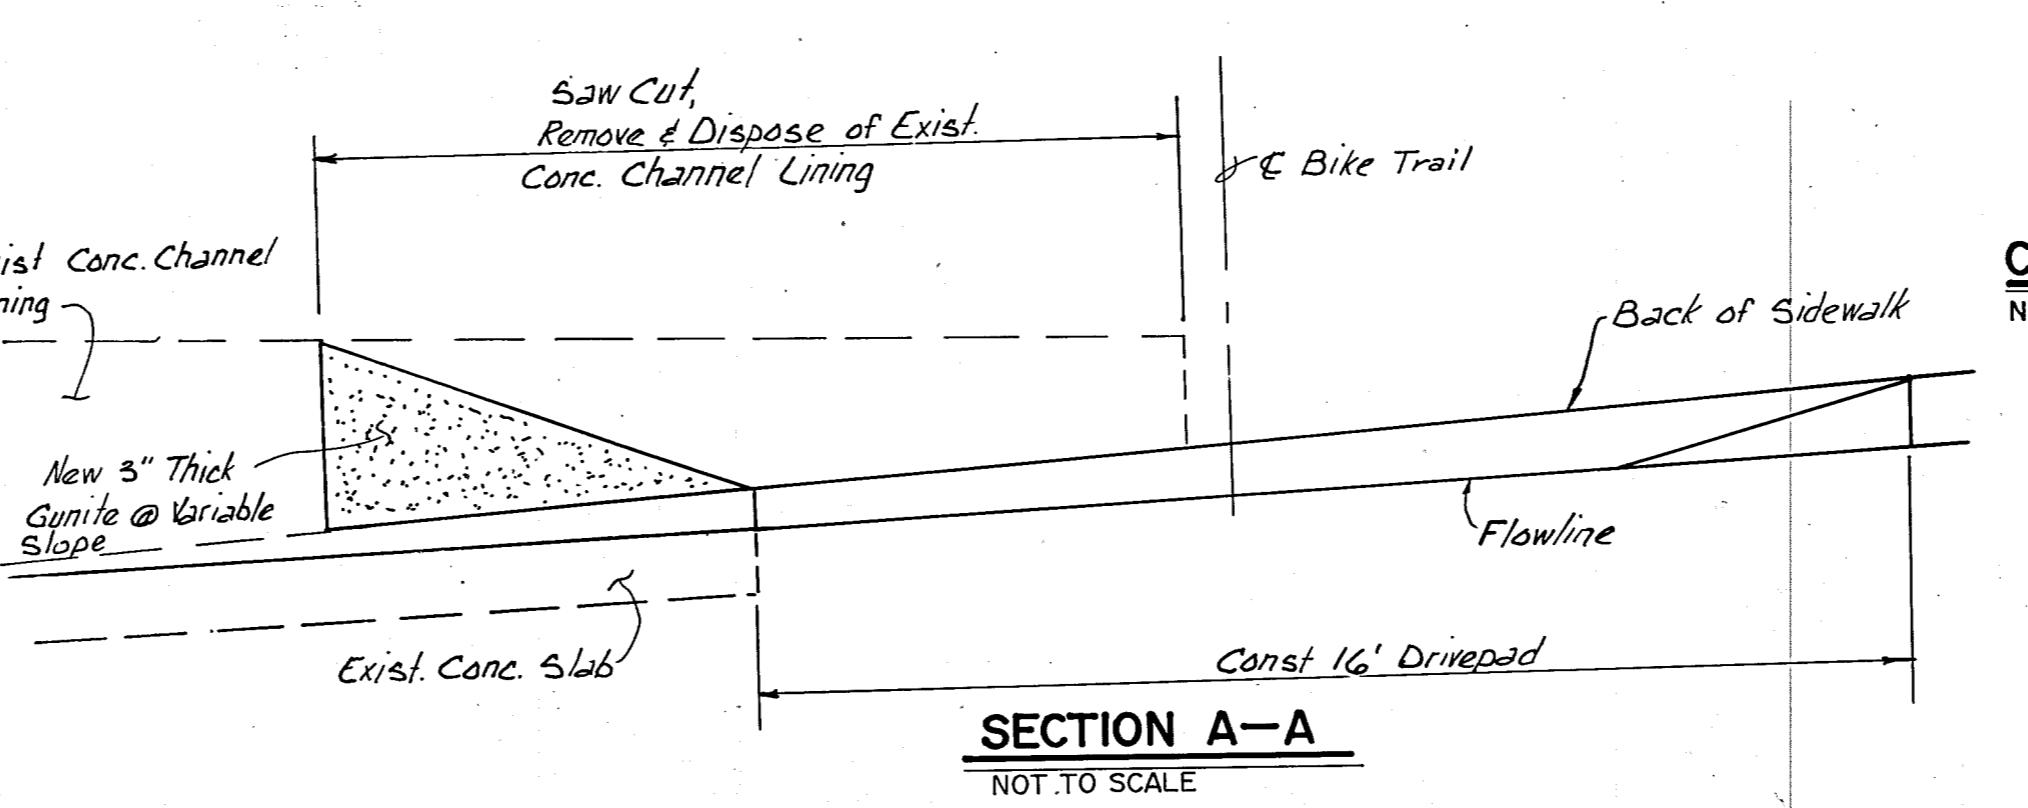

### SECTION A-A

NOT TO SCALE

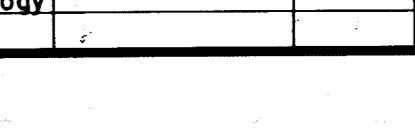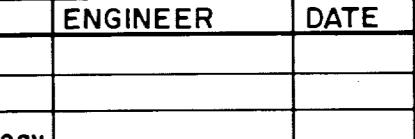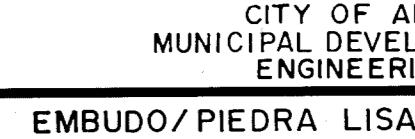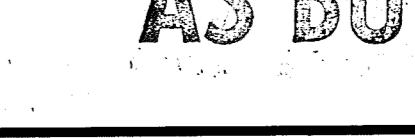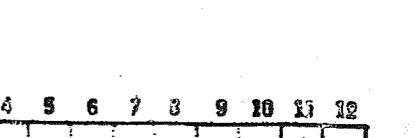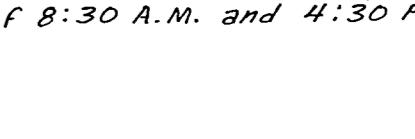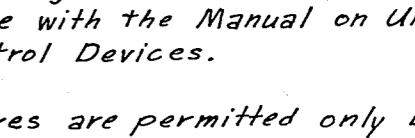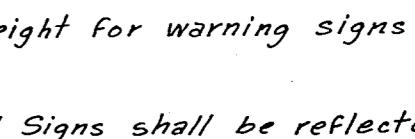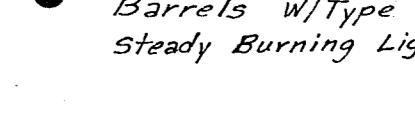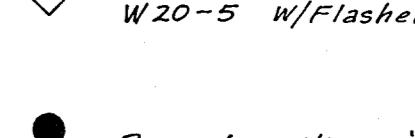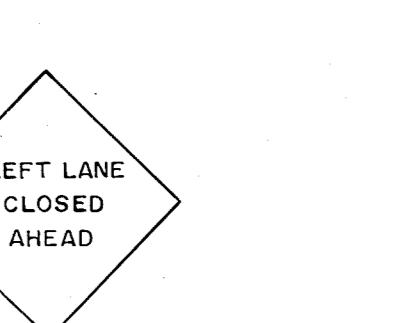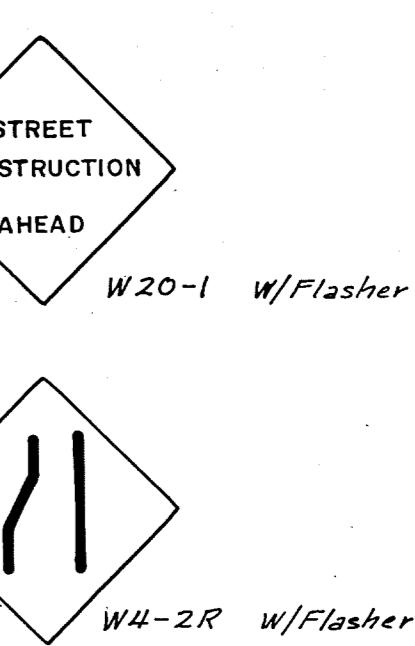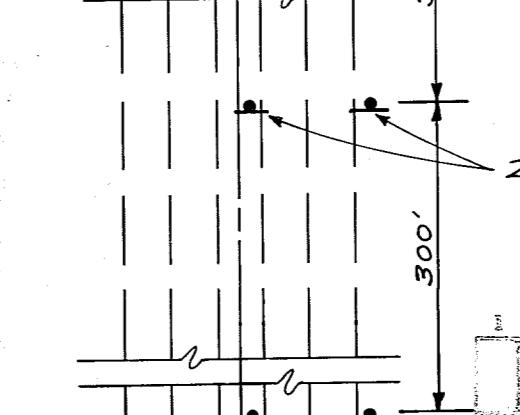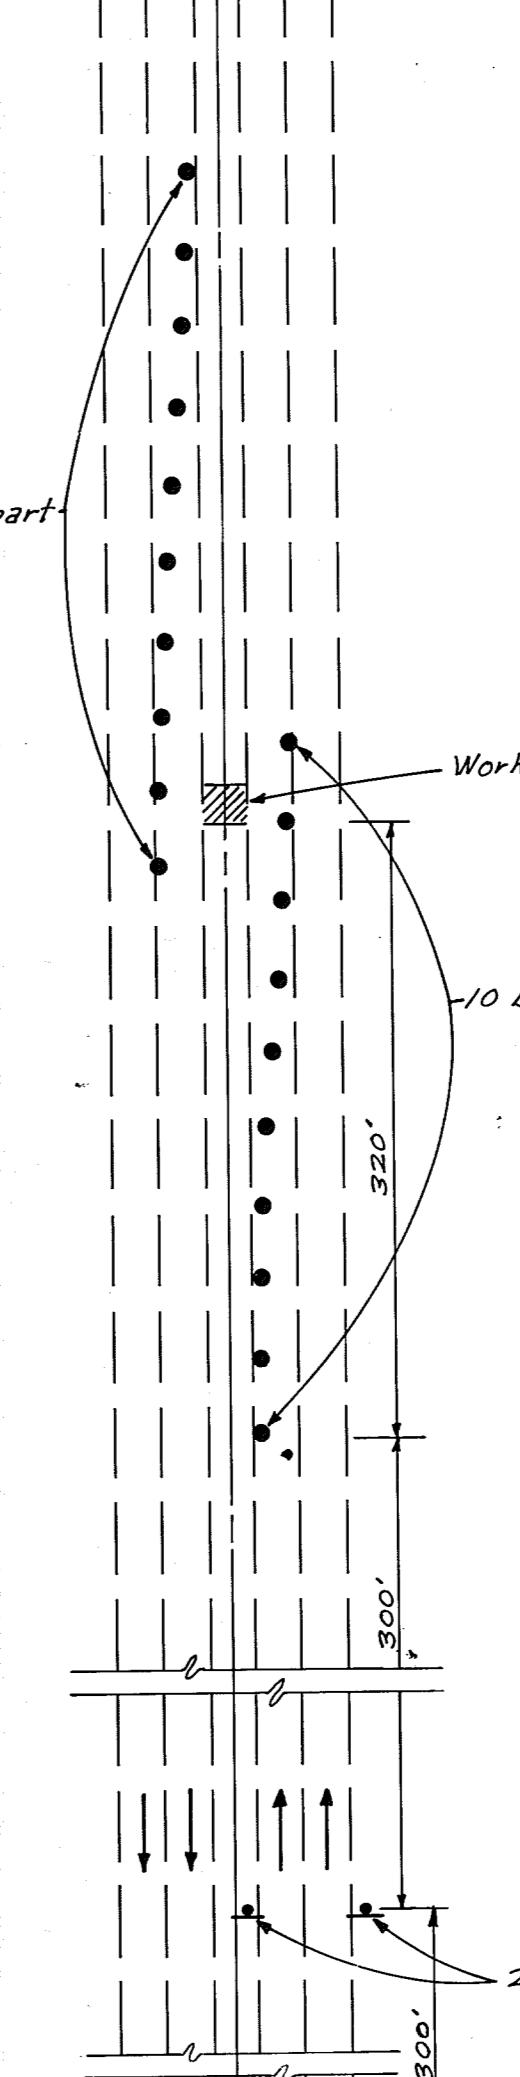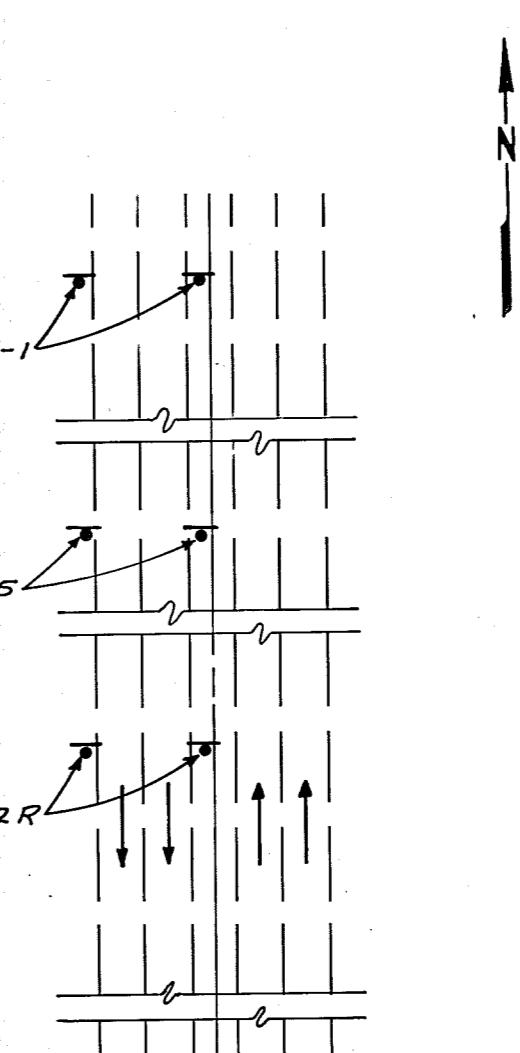

AS-BUILT INFORMATION	
CONTRACTOR	GARDNER Brothers
Accepted By	G.P.G.
Date	3/30/03
Drawn By	G.P.G.
Recorded By	G.P.G.
Date	3/30/03
MICRO-FILM INFORMATION	
No.	

BENCH MARKS

SURVEY INFORMATION

FIELD NOTES

BY DATE

MAP NO. NO. BY DATE

EST. NO. NO. BY DATE

REMARKS

DESIGN BY DATE

DRAWN BY DATE

CHECKED BY DATE

AS BUILT

CITY OF ALBUQUERQUE MUNICIPAL DEVELOPMENT DEPARTMENT ENGINEERING DIVISION					
TITLE EMBUDO / PIEDRA LISA RECREATIONAL TRAIL					
DETAILS					
APPROVALS	ENGINEER	DATE	APPROVALS	ENGINEER	DATE
City Engineer			Liquid Waste		
A.C.E. Design			Traffic		
A.C.E. Hydrology			Water		
DRAWING NO.	SHEET 22 OF 30				




SHEET 22 OF 30

### GENERAL NOTES

- I. Line posts within existing concrete rundowns shall be of sufficient length to maintain the top of the fence in a straight line.
- II. Line posts set in concrete with 2 braces shall be located a maximum of 60 feet apart.
3. Woven wire to be V-mesh fence wire-galvanized. Min. 223# per 20 rod (320') roll. 14 1/2 gauge horizontal wire w/ 4" max. between wires; 16 gauge cross wires w/ 4" max. between wires at widest point.
4. Metal posts & braces shall be rolled from coil steel or new billet steel conforming with any of the following ASTM designations, A-1, A-7, A-16, A107, or A120, and shall be galvanized or painted with one coat of aluminum paint of a type approved by the Engineer. Galvanized shall conform to ASTM designation A123 in lieu of tubular brace posts, angle brace posts may be used.
5. Line posts — 11.30# each min.
6. End posts — min. 66# with one brace.
7. Corner post — min. 94# with two braces.
8. All footings and bases shall consist of 3000 Lb. concrete with crown tops and of the dimensions indicated.
9. Fence wire may be placed on the trail side of the posts except on the inside of curves.
10. Unless otherwise provided, all posts shall be of the same type of material throughout the project.
- II. The furnishing and installing of all braces will be considered incidental to the completion of the work and no measurement will be made therefor.
12. End and corner braces to be of the length recommended by the manufacturer.


## WOVEN WIRE FENCE WITH METAL POSTS

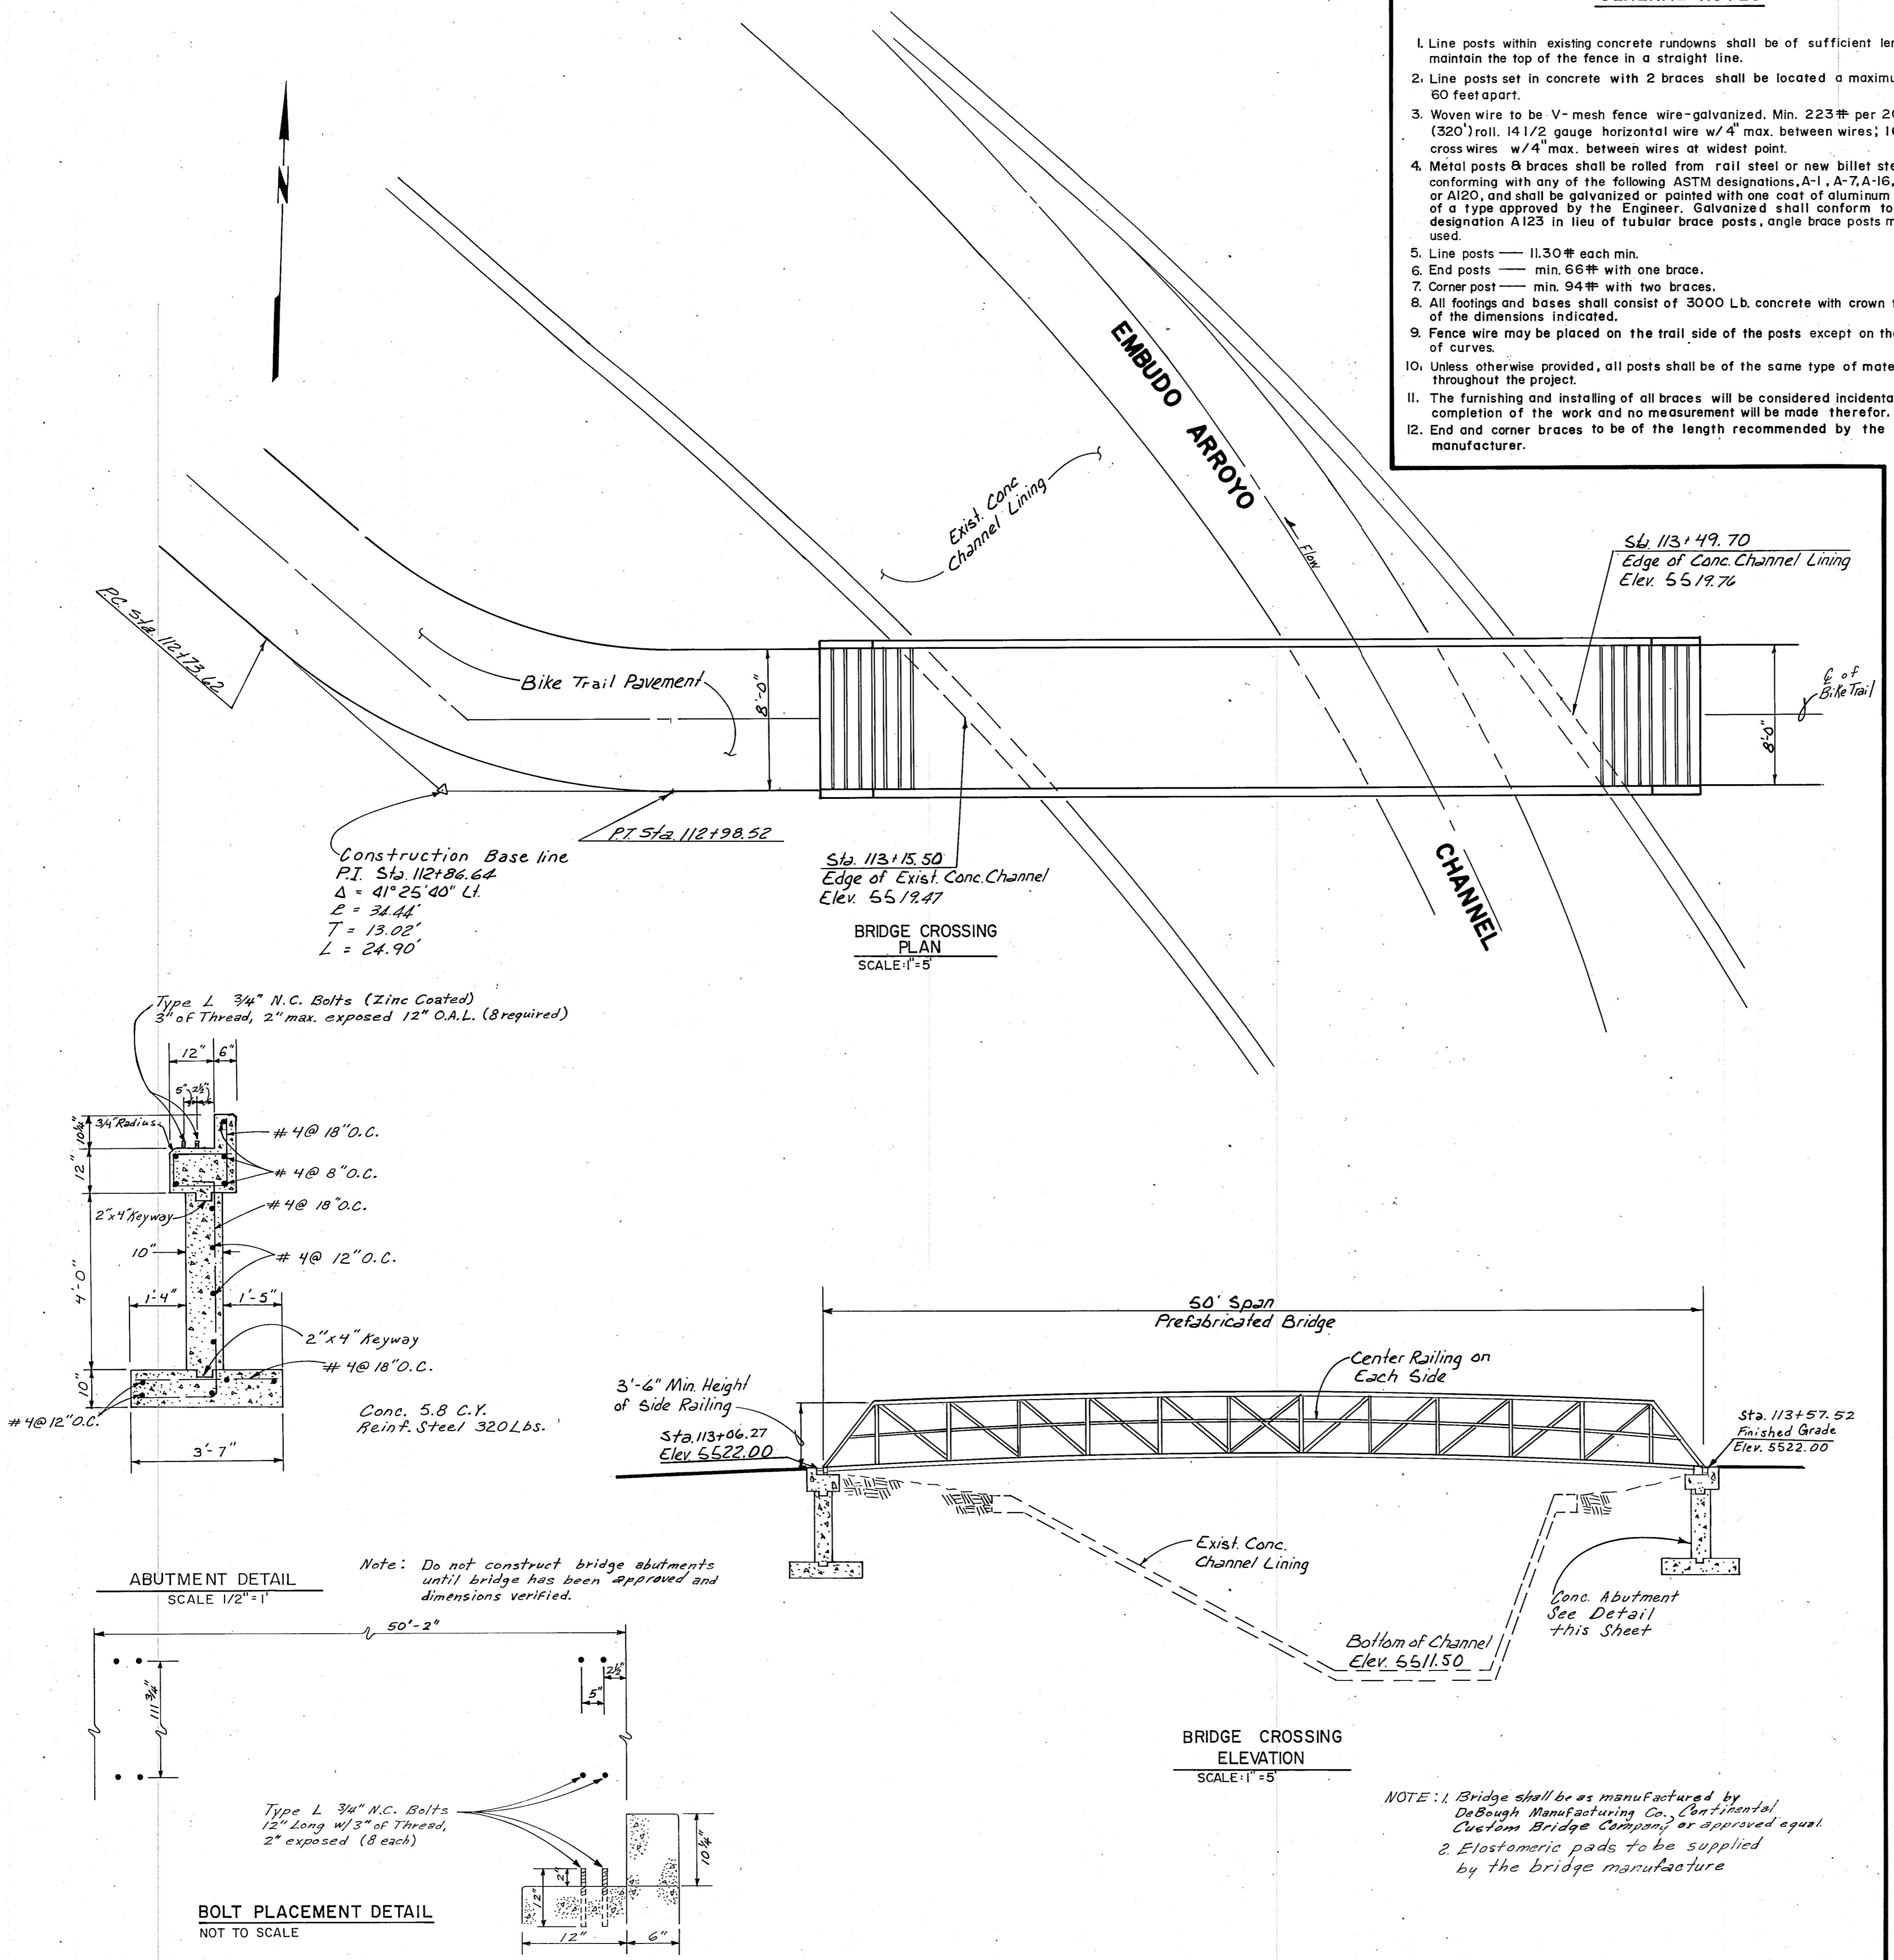


AS-BUILT INFORMATION		BENCH MARKS		SURVEY INFORMATION		FIELD NOTES		REVISIONS		REFERENCES	
CONTRACTOR	Gillard Brothers	Work Accepted By	G.D.G.	Drawing No.	DATE	No.	BY	DATE	MAP NO.	EST. NO.	W.O. NO.

CITY OF ALBUQUERQUE  
MUNICIPAL DEVELOPMENT DEPARTMENT  
ENGINEERING DIVISION


<b>PREFABRICATED BRIDGE DETAILS</b>											
APPROVALS	ENGINEER	DATE	APPROVALS	ENGINEER	DATE	APPROVALS	ENGINEER	DATE	APPROVALS	ENGINEER	DATE
City Engineer			Liquid Waste			Traffic			Water		
A.C.E. Design											
A.C.E. Hydrology											
DRAWING NO. SHEET 23 OF 36											

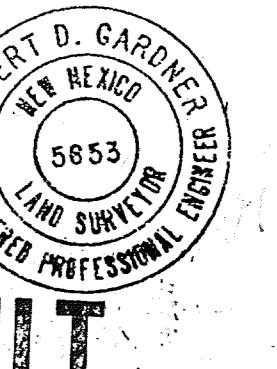

**AS BUILT**

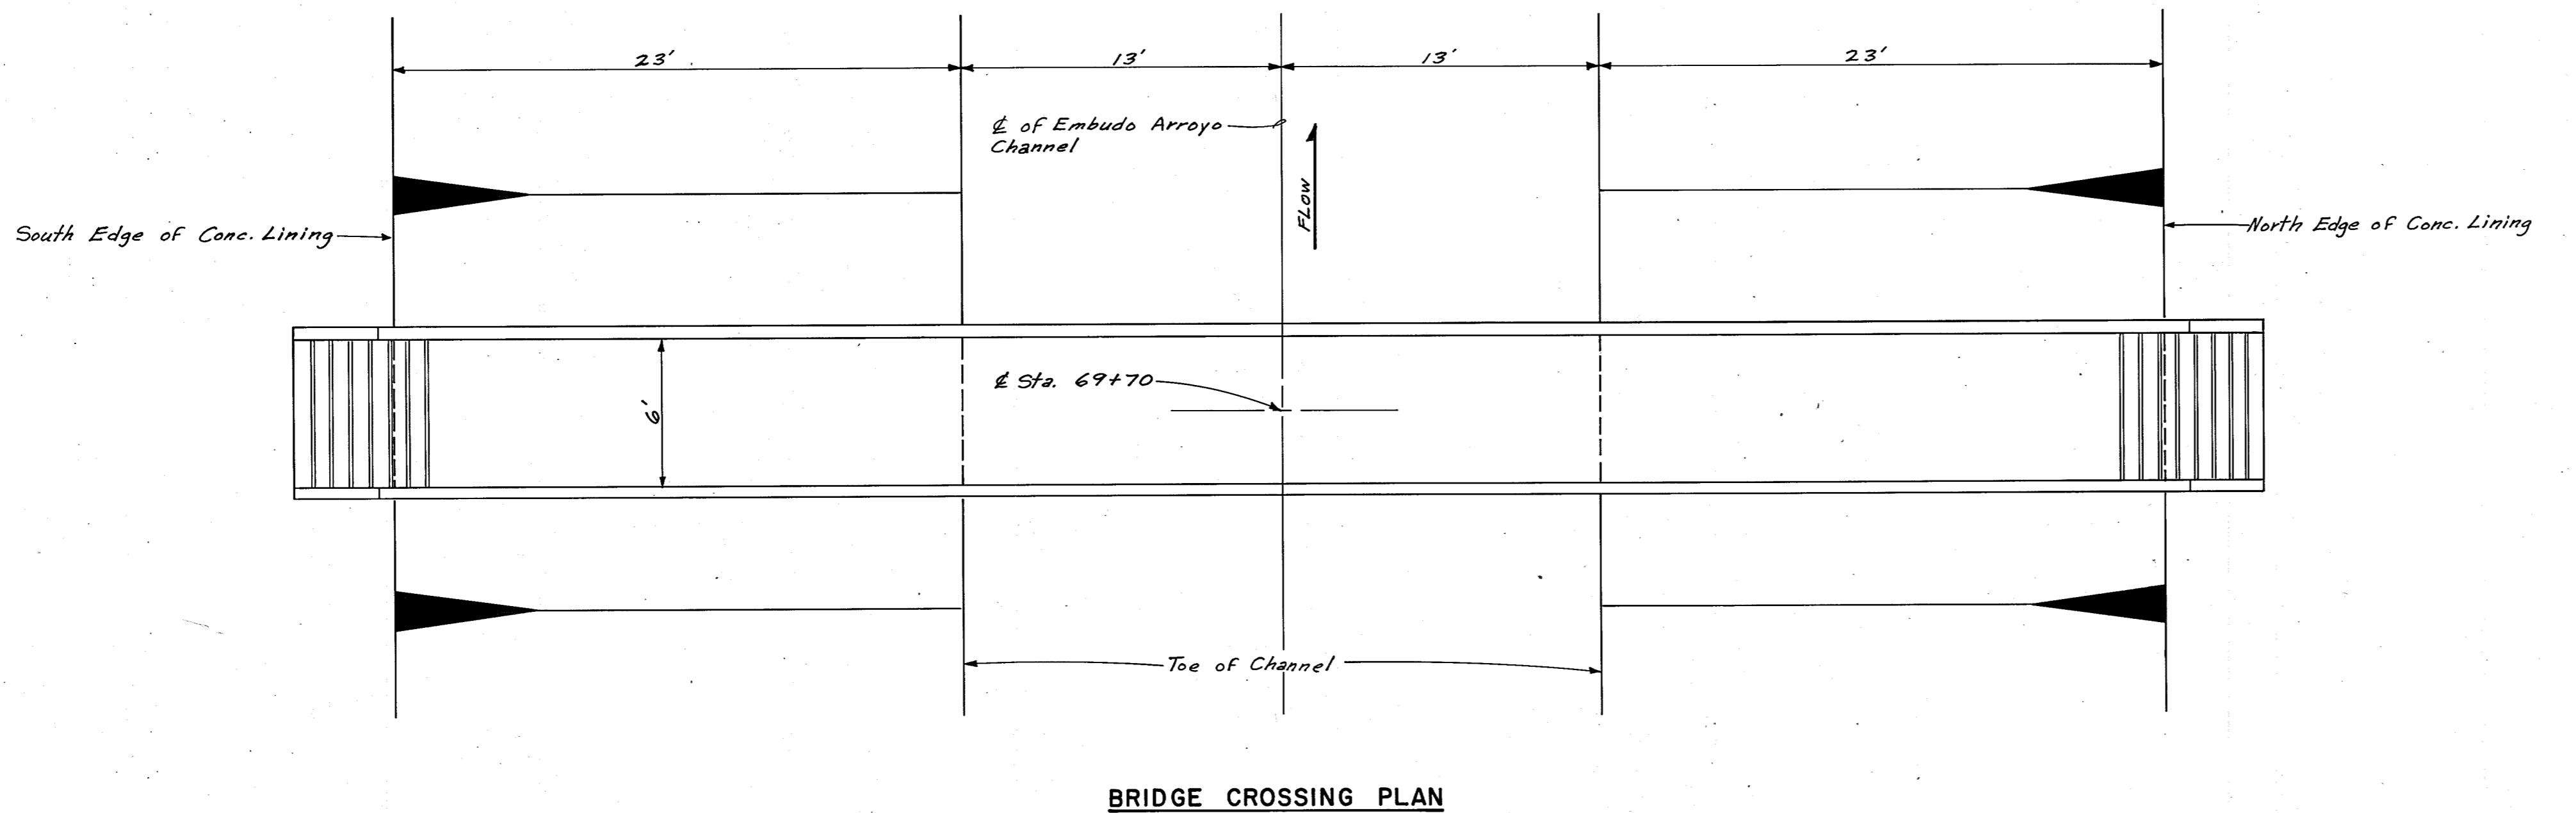

## BRIDGE CROSSING PLAN

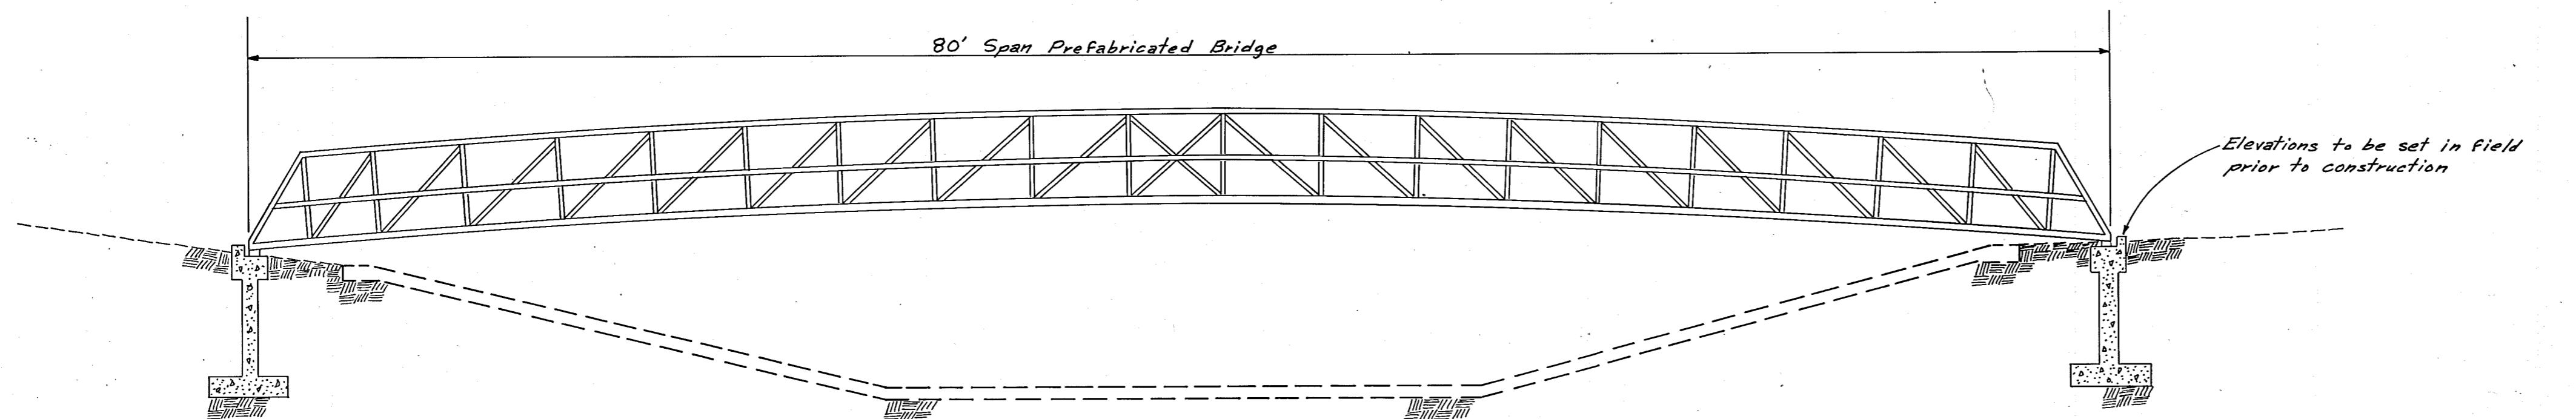


## BRIDGE CROSSING ELEVATION

NOTE: 1. Bridge shall be as manufactured by  
DeBourgh Manufacturing Co., Continental  
Custom Bridge Co. or approved equal.  
2. Elastomeric Pads to be supplied  
by the manufacturer

## PREFABRICATED BRIDGE DETAIL

SCALE: 1"=5'


**NOTE:**  
Actual location to be determined in the  
field by the Engineer.

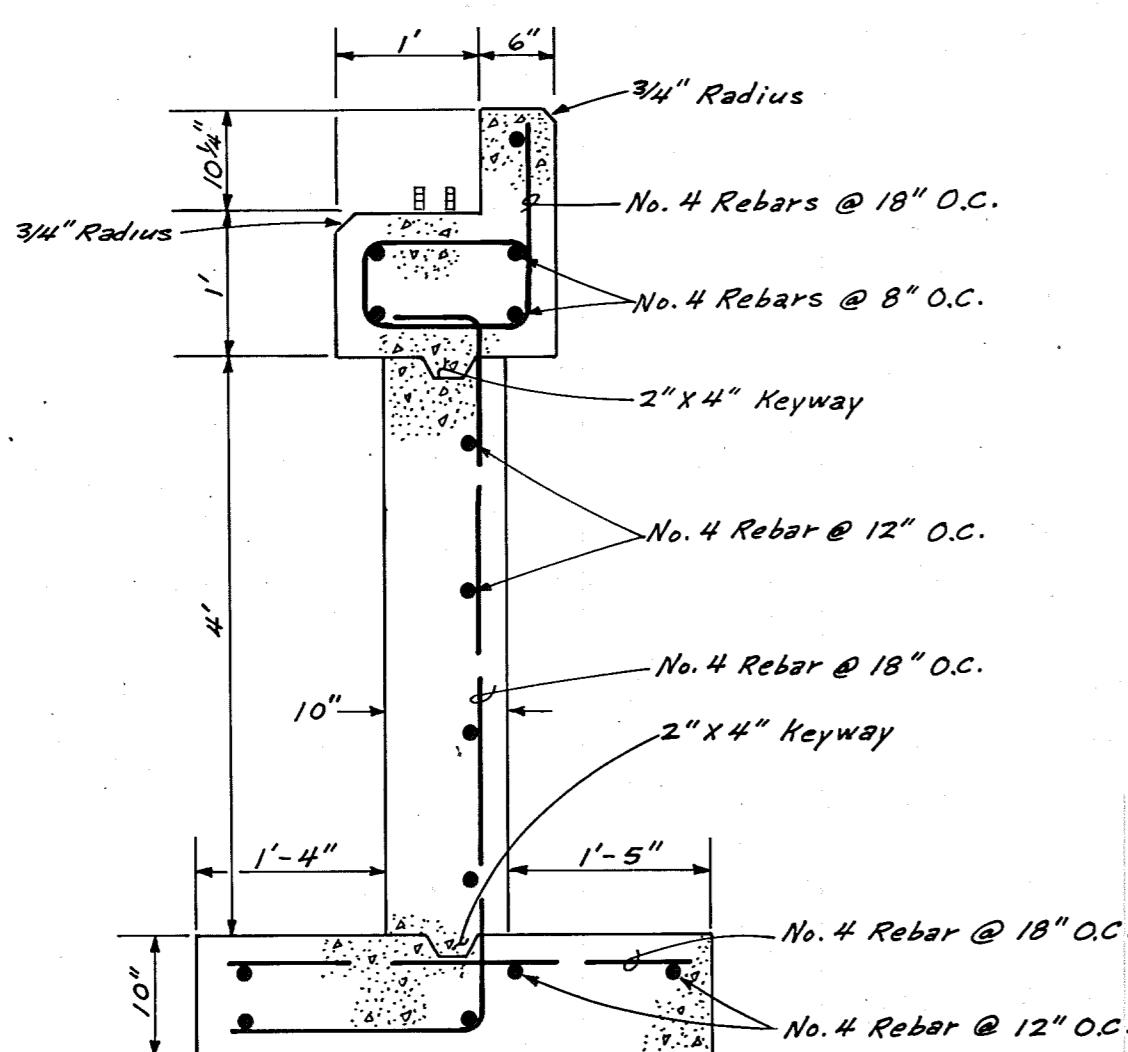

SECTION A-A

## ABUTMENT DETAILS

**SCALE: 3A**

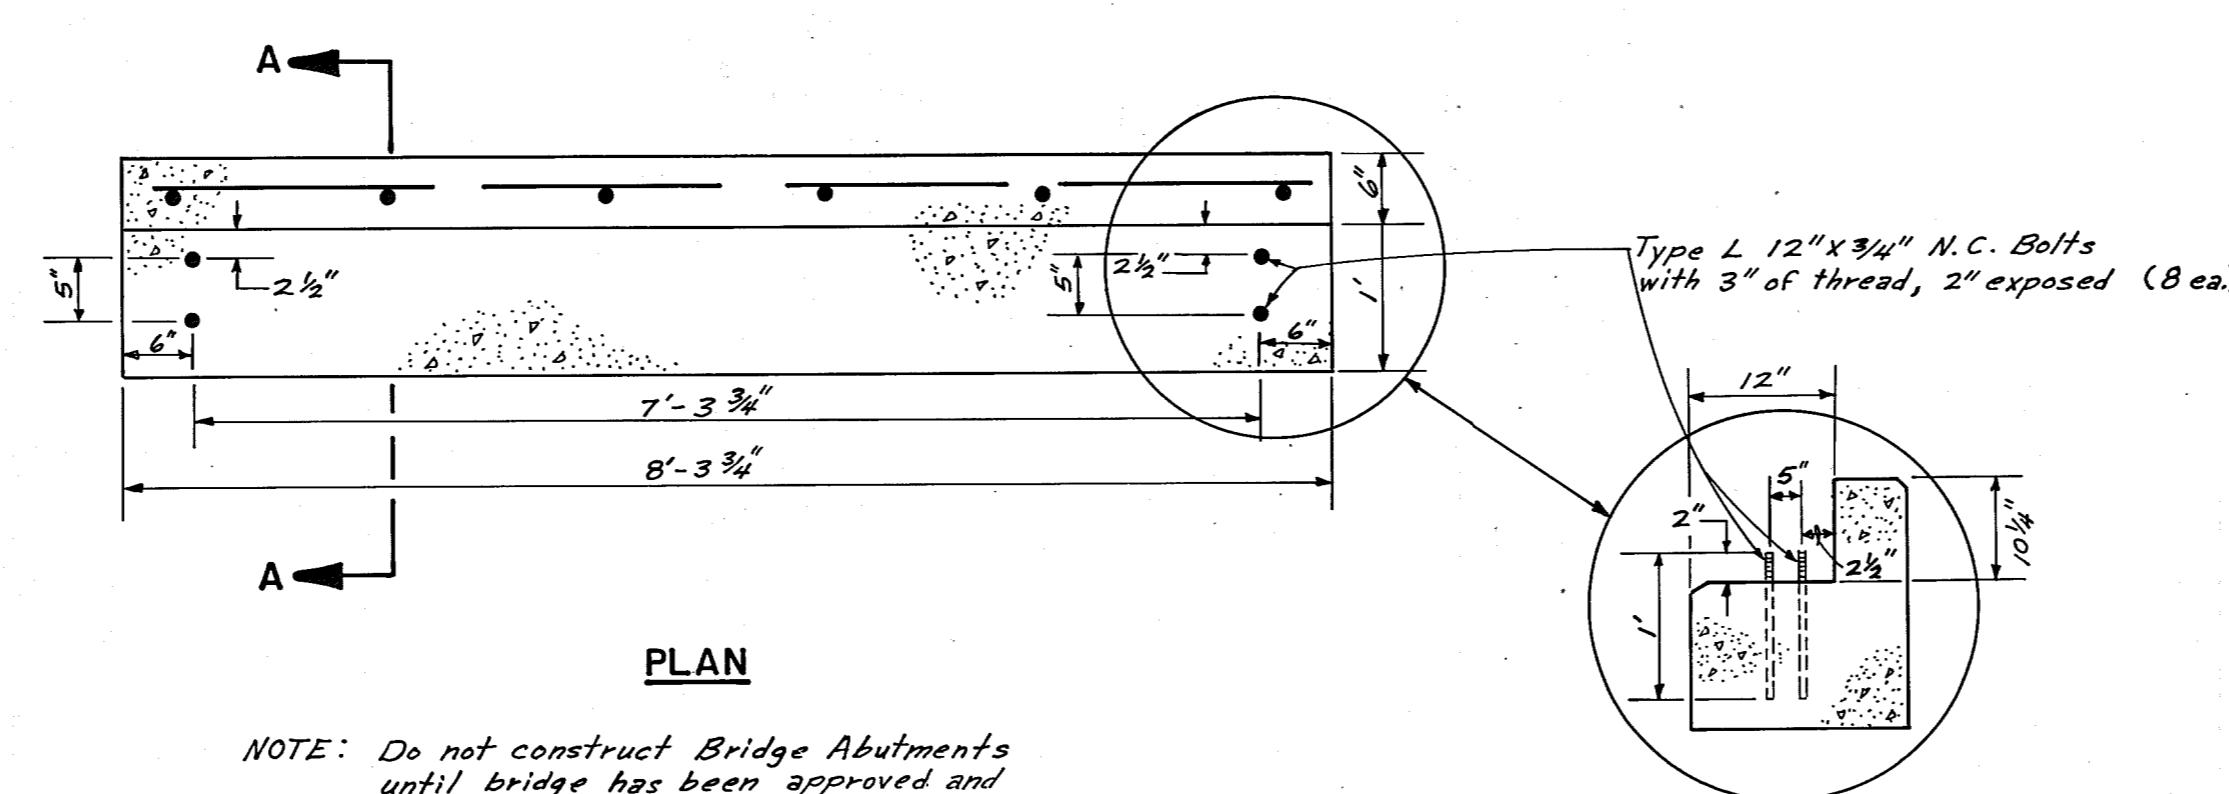

## **BOLT PLACEMENT DETAIL**

**NOTE:** Do not construct Bridge Abutments until bridge has been approved and dimensions verified.

**AS BUILT**

**CITY OF ALBUQUERQUE  
MUNICIPAL DEVELOPMENT DEPARTMENT  
ENGINEERING DIVISION**


N D C

**CITY OF ALBUQUERQUE  
MUNICIPAL DEVELOPMENT DEPARTMENT  
ENGINEERING DIVISION**

**ITLE EMBUDO/PIEDRA LISA RECREATIONAL TRAIL  
ALTERNAE # 4-PREFABRICATED BRIDGE  
DETAILS FOR SNOW PARK**

ORIGINAL SURVEY	ADJUSTED SURVEY	BY	DATE
5468	5464		

FINAL SURVEY	ADJUSTED SURVEY	BY	DATE
5466	5462		

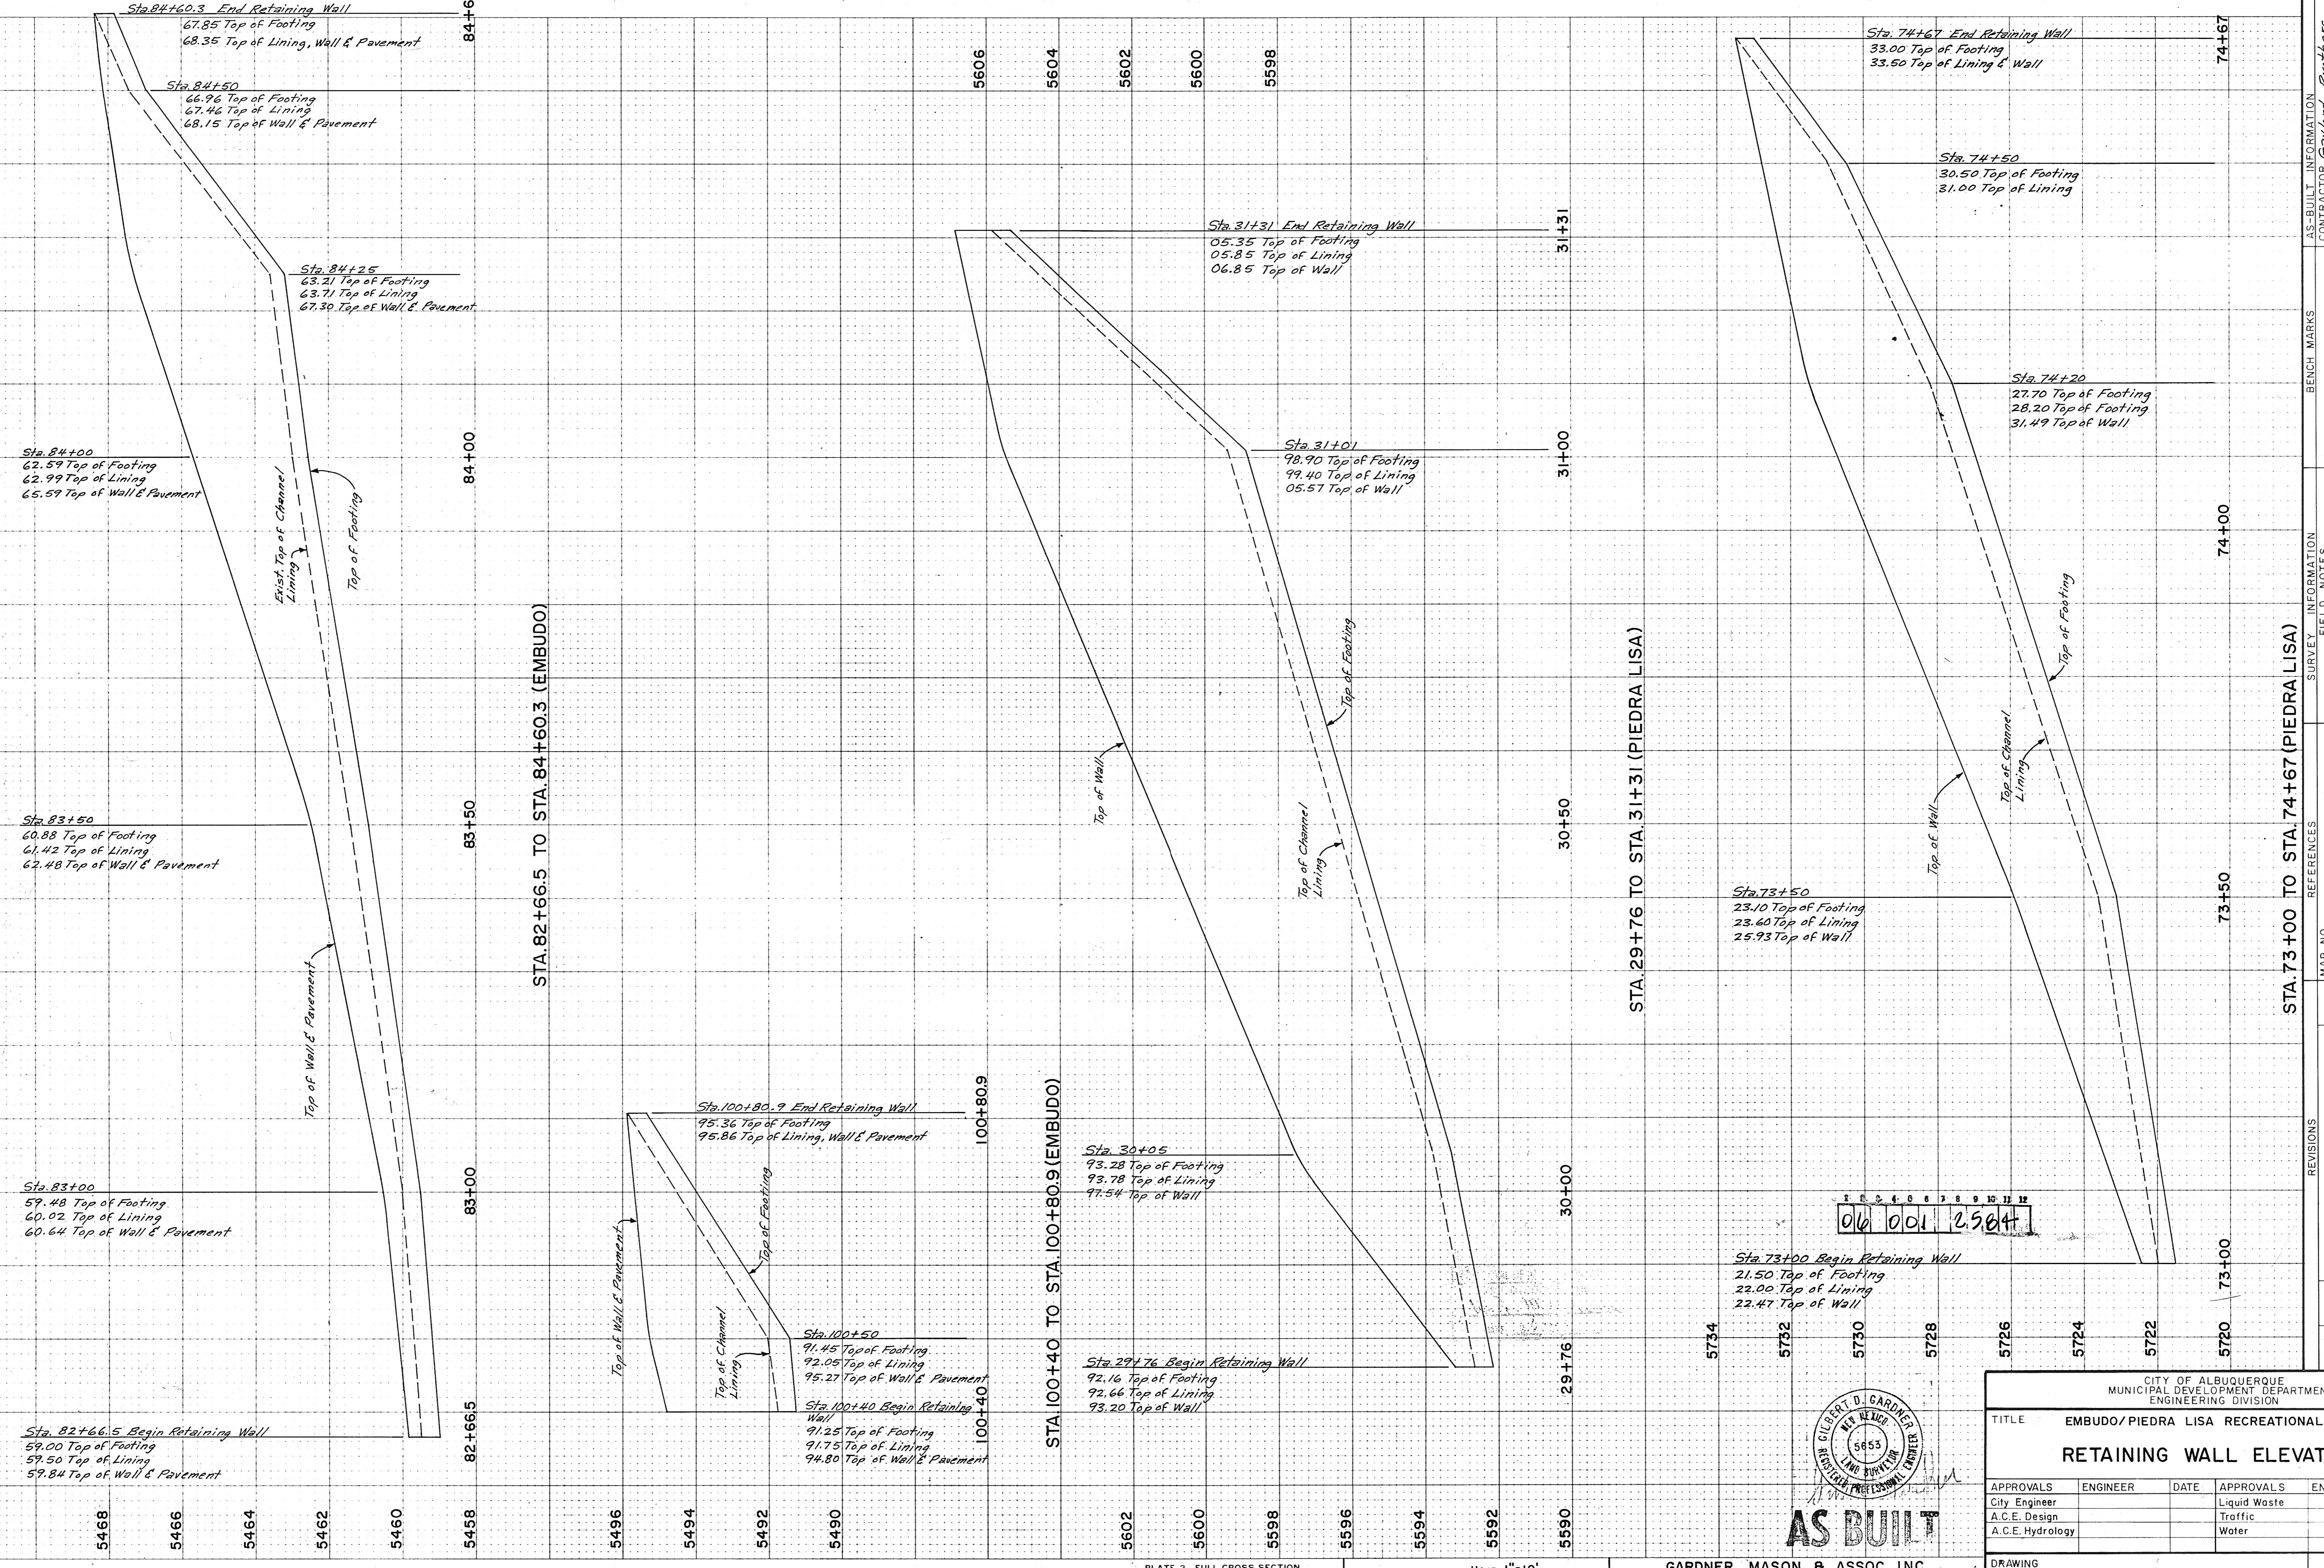

AS-BUILT INFORMATION  
CONTRACTOR: GARDNER Brothers  
WORK DRAWN BY: G.D.G.  
Accepted By: G.D.G.  
Date 3/30/83  
CORRECTED BY: R.B.  
Date 3/30/83  
MICRO-FILM INFORMATION  
Recorded by: R.B.  
No.: 5653  
Date: