


AFD FIRE STATION 20 + APD COMMUNITY POLICE SUBSTATION
CITY OF ALBUQUERQUE FIRE DEPARTMENT
NORTH DOMINGO BACA PARK
ALBUQUERQUE, NEW MEXICO

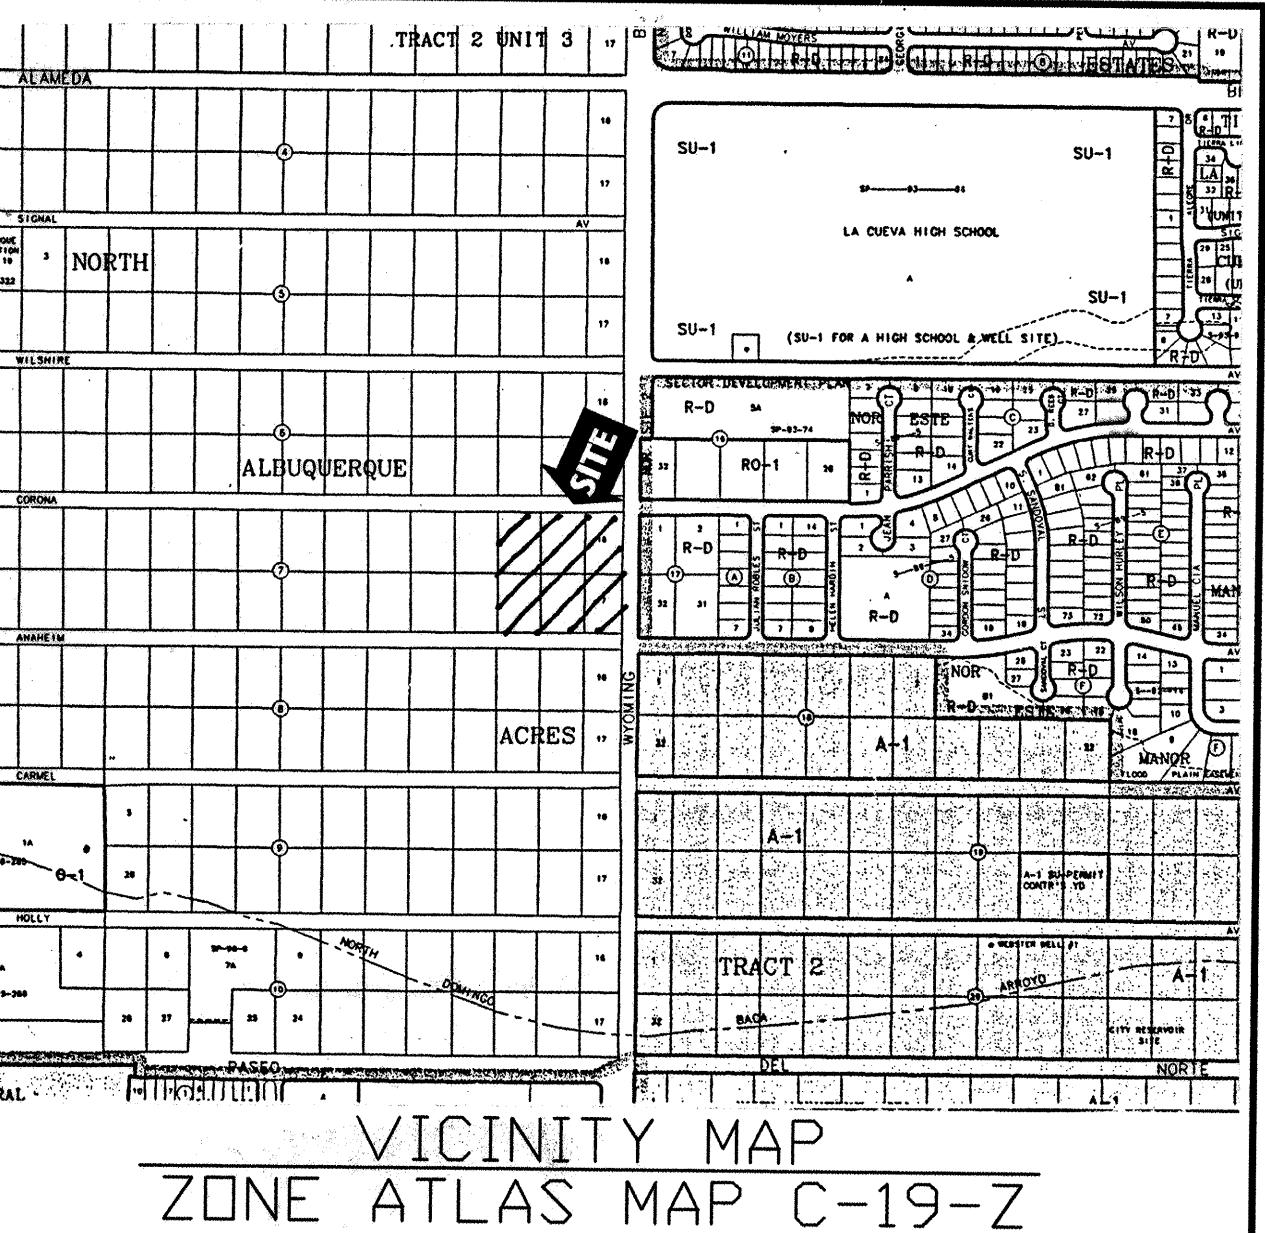

OFF-SITE IMPROVEMENTS

CORONA AVE and WYOMING BLVD, NE

INDEX OF DRAWINGS

<u>SEQUENCE NO.</u>	<u>SHEET NO.</u>	<u>DESCRIPTION</u>	<u>FOR INFORMATION</u>
1	1	TITLE SHEET	
2	2	WYOMING PLAN and PROFILE	
3	3	CORONA PLAN and PROFILE	
4	4	CORONA SANITARY SEWER PLAN and PROFILE	
5	5	TYPICAL SECTIONS	
6	6	TRAFFIC , TELEPHONE, and GAS EXTENSIONS	
7	7	PERMANENT TRAFFIC CONTROL	
8	8	TYPICAL TRAFFIC CONTROL & SIGNING EXAMPLES	
9	9	SIGNING AND CONSTRUCTION TRAFFIC CONTROL STANDARDS	
10	TS-16	FOUNDATION DETAILS TYPE II AND TYPE III STANDARDS	
11	TS-20	PULL BOX DETAILS	
12	TS-34	HAZARD IDENTIFICATION BEACON DETAILS	
13	TS-36	MASTARM BEACON DETAILS	

R INFORMATION ONLY

- ALL WORK DETAILED ON THESE PLANS TO BE PERFORMED UNDER CONTRACT SHALL, EXCEPT AS OTHERWISE STATED OR PROVIDED FOR HEREON, BE CONSTRUCTED IN ACCORDANCE WITH THE CITY OF ALBUQUERQUE STANDARD SPECIFICATIONS FOR PUBLIC WORKS CONSTRUCTION 1986 EDITION AS AMENDED WITH UPDATE NO. 6.

PRIOR TO CONSTRUCTION, THE CONTRACTOR SHALL EXCAVATE AND VERIFY THE HORIZONTAL AND VERTICAL LOCATIONS OF ALL OBSTRUCTIONS. SHOULD A CONFLICT EXIST, THE CONTRACTOR SHALL NOTIFY THE ENGINEER SO THAT THE CONFLICT CAN BE RESOLVED WITH MINIMUM DELAY.

TWO (2) WORKING DAYS PRIOR TO ANY EXCAVATION, CONTRACTOR MUST CONTACT LINE LOCATING SERVICE @ 260-1990 FOR LOCATION OF EXISTING UTILITIES.

WARNING - THE ENGINEER HAS UNDERTAKEN NO VERIFICATION OF THE EXISTENCE, LOCATION, SIZE, DEPTH, OR TYPE OF UNDERGROUND UTILITY WITHIN THE CONSTRUCTION AREA AND MAKES NO REPRESENTATION PERTAINING TO THESE UTILITIES. THE UTILITIES THAT HAVE BEEN SHOWN ARE BASED ON AVAILABLE INFORMATION FROM THE OWNER, UTILITY COMPANIES, GOVERNING AGENCY, OR OTHERS. THIS INFORMATION MAY BE INCOMPLETE, INACCURATE, OR OBSOLETE. THE CONTRACTOR SHALL, CONTACT THE LINE LOCATION SERVICE AT 260-1990 AT LEAST TWO (2) FULL WORKING DAYS PRIOR TO START OF CONSTRUCTION TO HAVE THE UTILITIES SPOTTED. THE CONTRACTOR SHALL BE SOLELY RESPONSIBLE FOR MAINTAINING THE EXISTING UTILITIES THROUGHOUT THE CONSTRUCTION OF THIS PROJECT. THE CONTRACTOR SHALL BE SOLELY RESPONSIBLE FOR REPAIR OR REPLACEMENT OF ANY UTILITIES DAMAGED DURING CONSTRUCTION TO THE SATISFACTION OF THE GOVERNING AUTHORITIES HAVING JURISDICTION OVER THE UTILITY THAT HAS BEEN DAMAGED.

TRAFFIC CONTROL: FIVE (5) WORKING DAYS PRIOR TO BEGINNING CONSTRUCTION, THE CONTRACTOR SHALL SUBMIT TO THE CONSTRUCTION COORDINATION DIVISION A DETAILED CONSTRUCTION SCHEDULE. TWO (2) WORKING DAYS PRIOR TO CONSTRUCTION, THE CONTRACTOR SHALL OBTAIN A BARRICADING PERMIT FROM THE CONSTRUCTION COORDINATION DIVISION. CONTRACTOR SHALL NOTIFY BARRICADE ENGINEER (768-2551) PRIOR TO OCCUPYING AN INTERSECTION. SEE SECTION 19 OF THE SPECIFICATIONS. ALL STREET STRIPING ALTERED OR DESTROYED SHALL BE REPLACED BY CONTRACTOR TO LOCATION AND IN KIND AS EXISTING AT NO ADDITIONAL COST TO THE OWNER.


THE CONTRACTOR SHALL PROMPTLY CLEAN UP ANY MATERIAL EXCAVATED WITHIN THE PUBLIC RIGHT-OF-WAY SO THAT THE EXCAVATED MATERIAL IS NOT SUSCEPTIBLE TO BEING WASHED DOWN THE STREET.

THE CONTRACTOR IS RESPONSIBLE FOR PROTECTING AND MAINTAINING ALL EXISTING MONUMENTATION CONTROLS. IN THE EVENT OF INADVERTENT DESTRUCTION OR ALTERATION THE CONTRACTOR MUST IMMEDIATELY NOTIFY THE CITY CHIEF SURVEYOR.


ALL EXCAVATION, TRENCHING, AND SHORING ACTIVITIES MUST BE CARRIED-OUT IN ACCORDANCE WITH OSHA 29 CFR 1926.650.

LARRY READ & ASSOCIATES
Civil Engineers

REV.	SHEETS	CITY ENGINEER	DATE	USER DEPARTMENT	DATE	USER DEPARTMENT	DATE
ENGINEERS STAMP & SIGNATURE		APPROVALS		ENGINEER	DATE	* * * * *	*
		DRC Chairman		<i>Ken Brinkley</i>	10-22-99	APPROVED FOR CONSTRUCTION	
		Transportation		<i>Richard J. Goetz</i>	10-12-99		
		Water/Wastewater		<i>Billy G. Goosby</i>	9-30-99		
		Hydrology		<i>Mark Caloyne</i>	9-30-99		
		C.I.P.					
		Constr. Mngmt.					
		Constr. Coord.		<i>Jell. Lushy</i>	10-4-99		
City Project No. (OFFSITE)				6042.91		Sheet	Of
						1	13

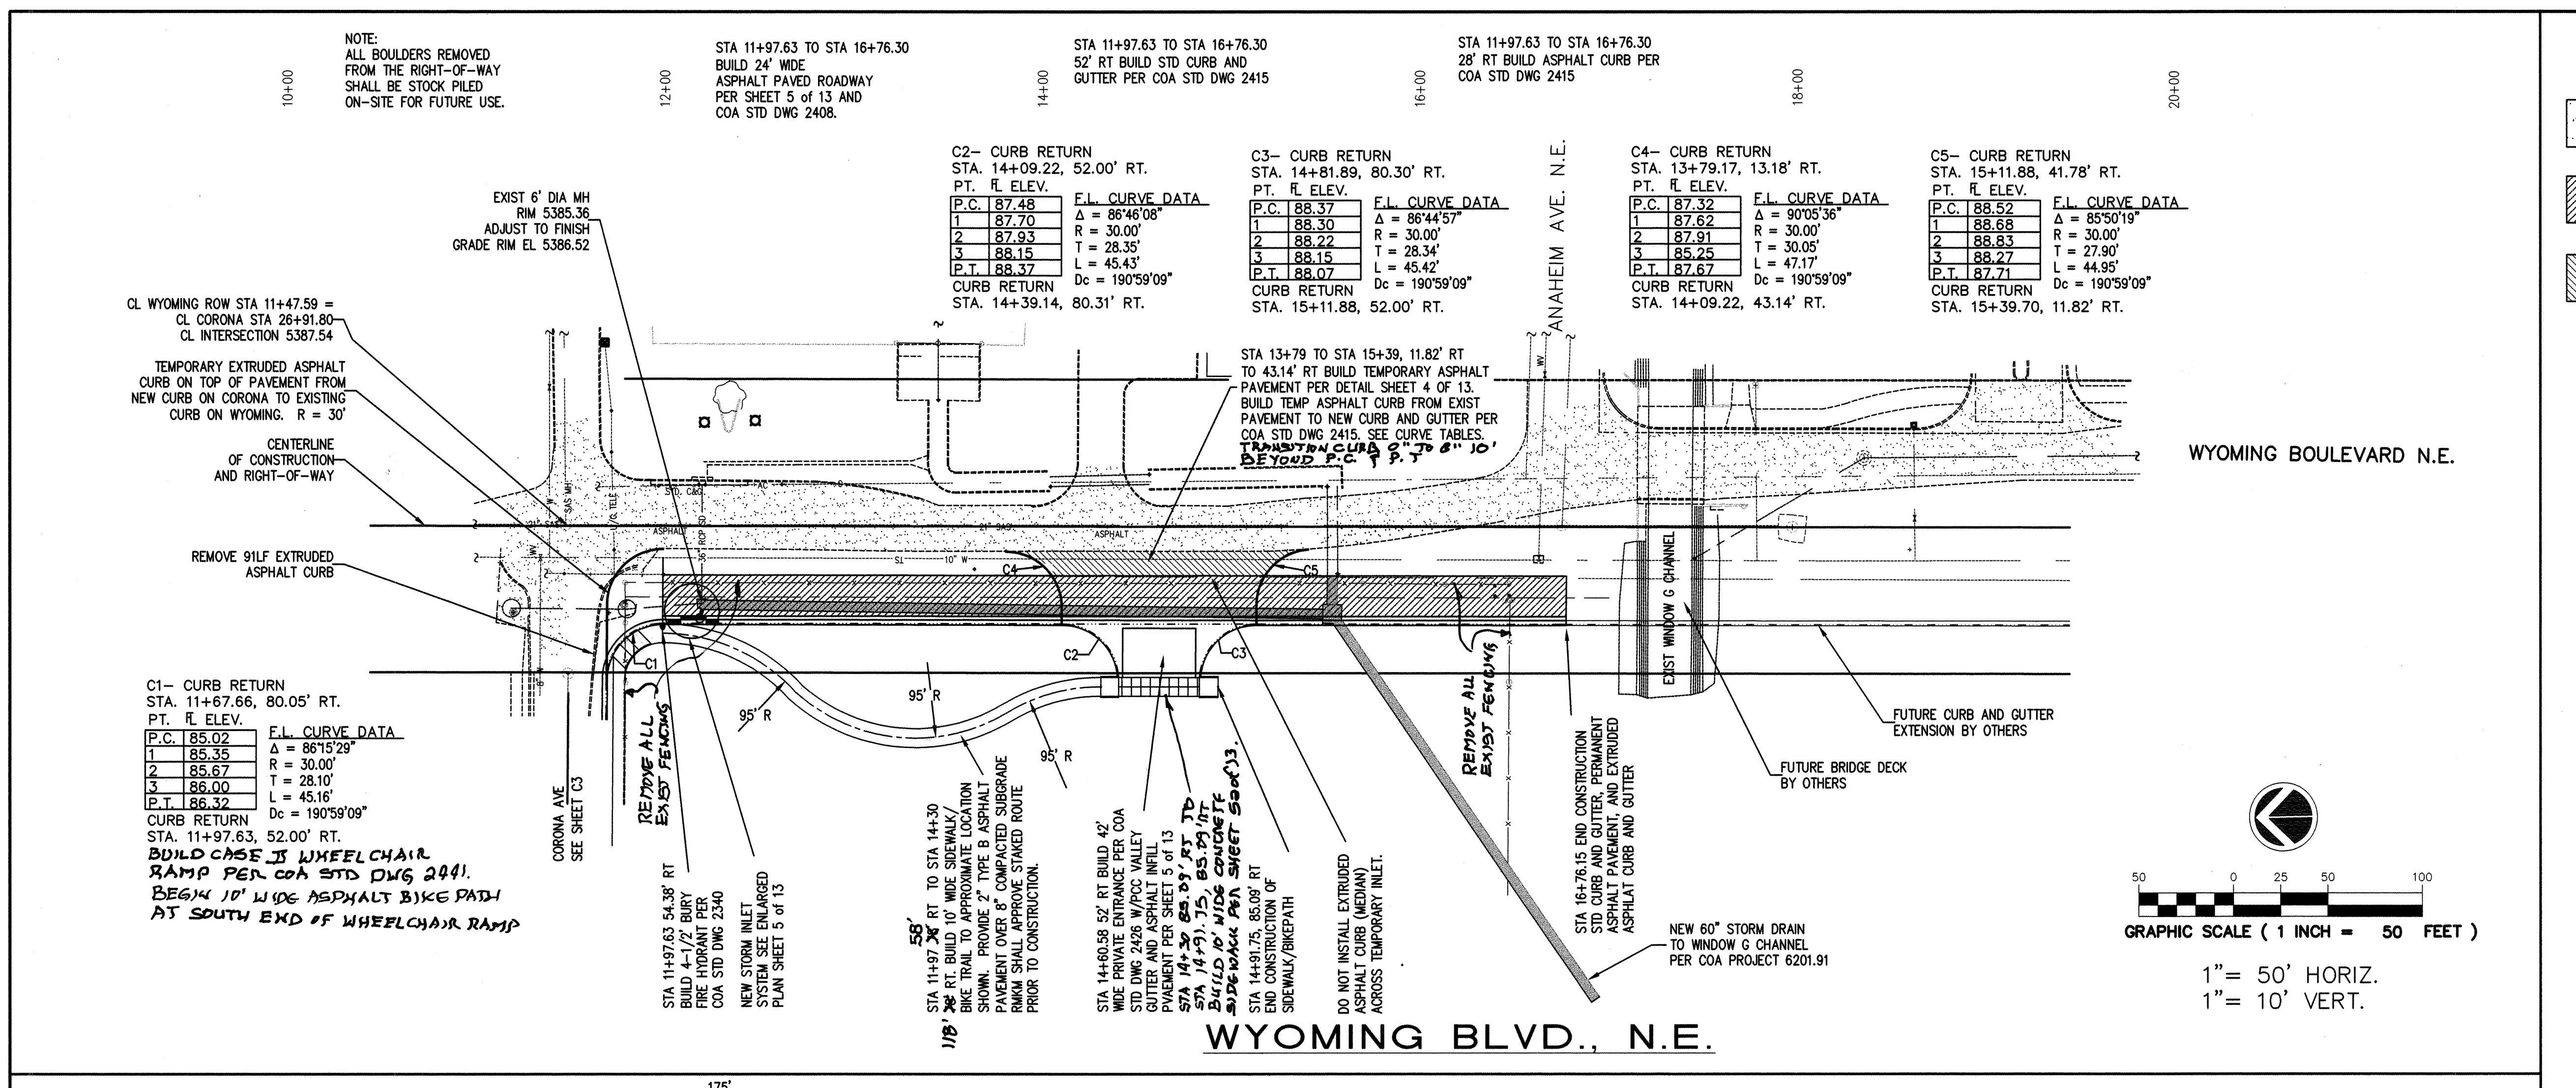

LEGEND

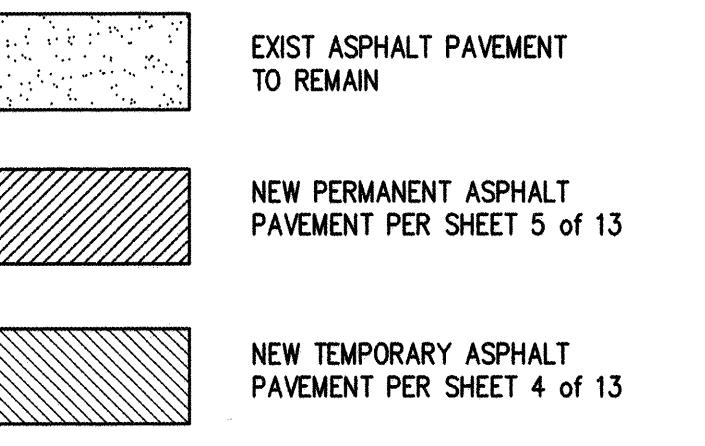


ASPHALT PAVEMENT

MANENT ASPHALT
T PER SHEET 5 of 13

Temporary Asphalt
T PER SHEET 4 of 13

SURVEY INFORMATION				BENCH MARKS		AS BUILT INFORMATION	
FIELD NOTES						CONTRACTOR	
BY	DATE	CITY OF ALBUQUERQUE BENCH MARK "HEAVEN", A STANDARD USGS BRASS TABLET STAMPED "HEAVEN 1969", SET IN TOP OF A CONCRETE POST FLUSH WITH THE GROUND. LOCATED AT THE ENTRANCE TO THE "GATE OF HEAVEN" CEMETERY 0.15 MILES WEST OF THE INTERSECTION OF PASEO DEL NORTE N.E. AND WYOMING BLVD. N.E. STATION IS ON THE SOUTH SIDE OF PASEO DEL NORTE N.E.		WORK STAKED BY INSPECTORS ACCEPTANCE BY FIELD VERIFICATION BY DRAWINGS CORRECTED BY		DATE DATE DATE DATE DATE DATE DATE	
		ELEV.=5378.78 feet (M.S.L.D.)					

FOR INFORMATION ONLY

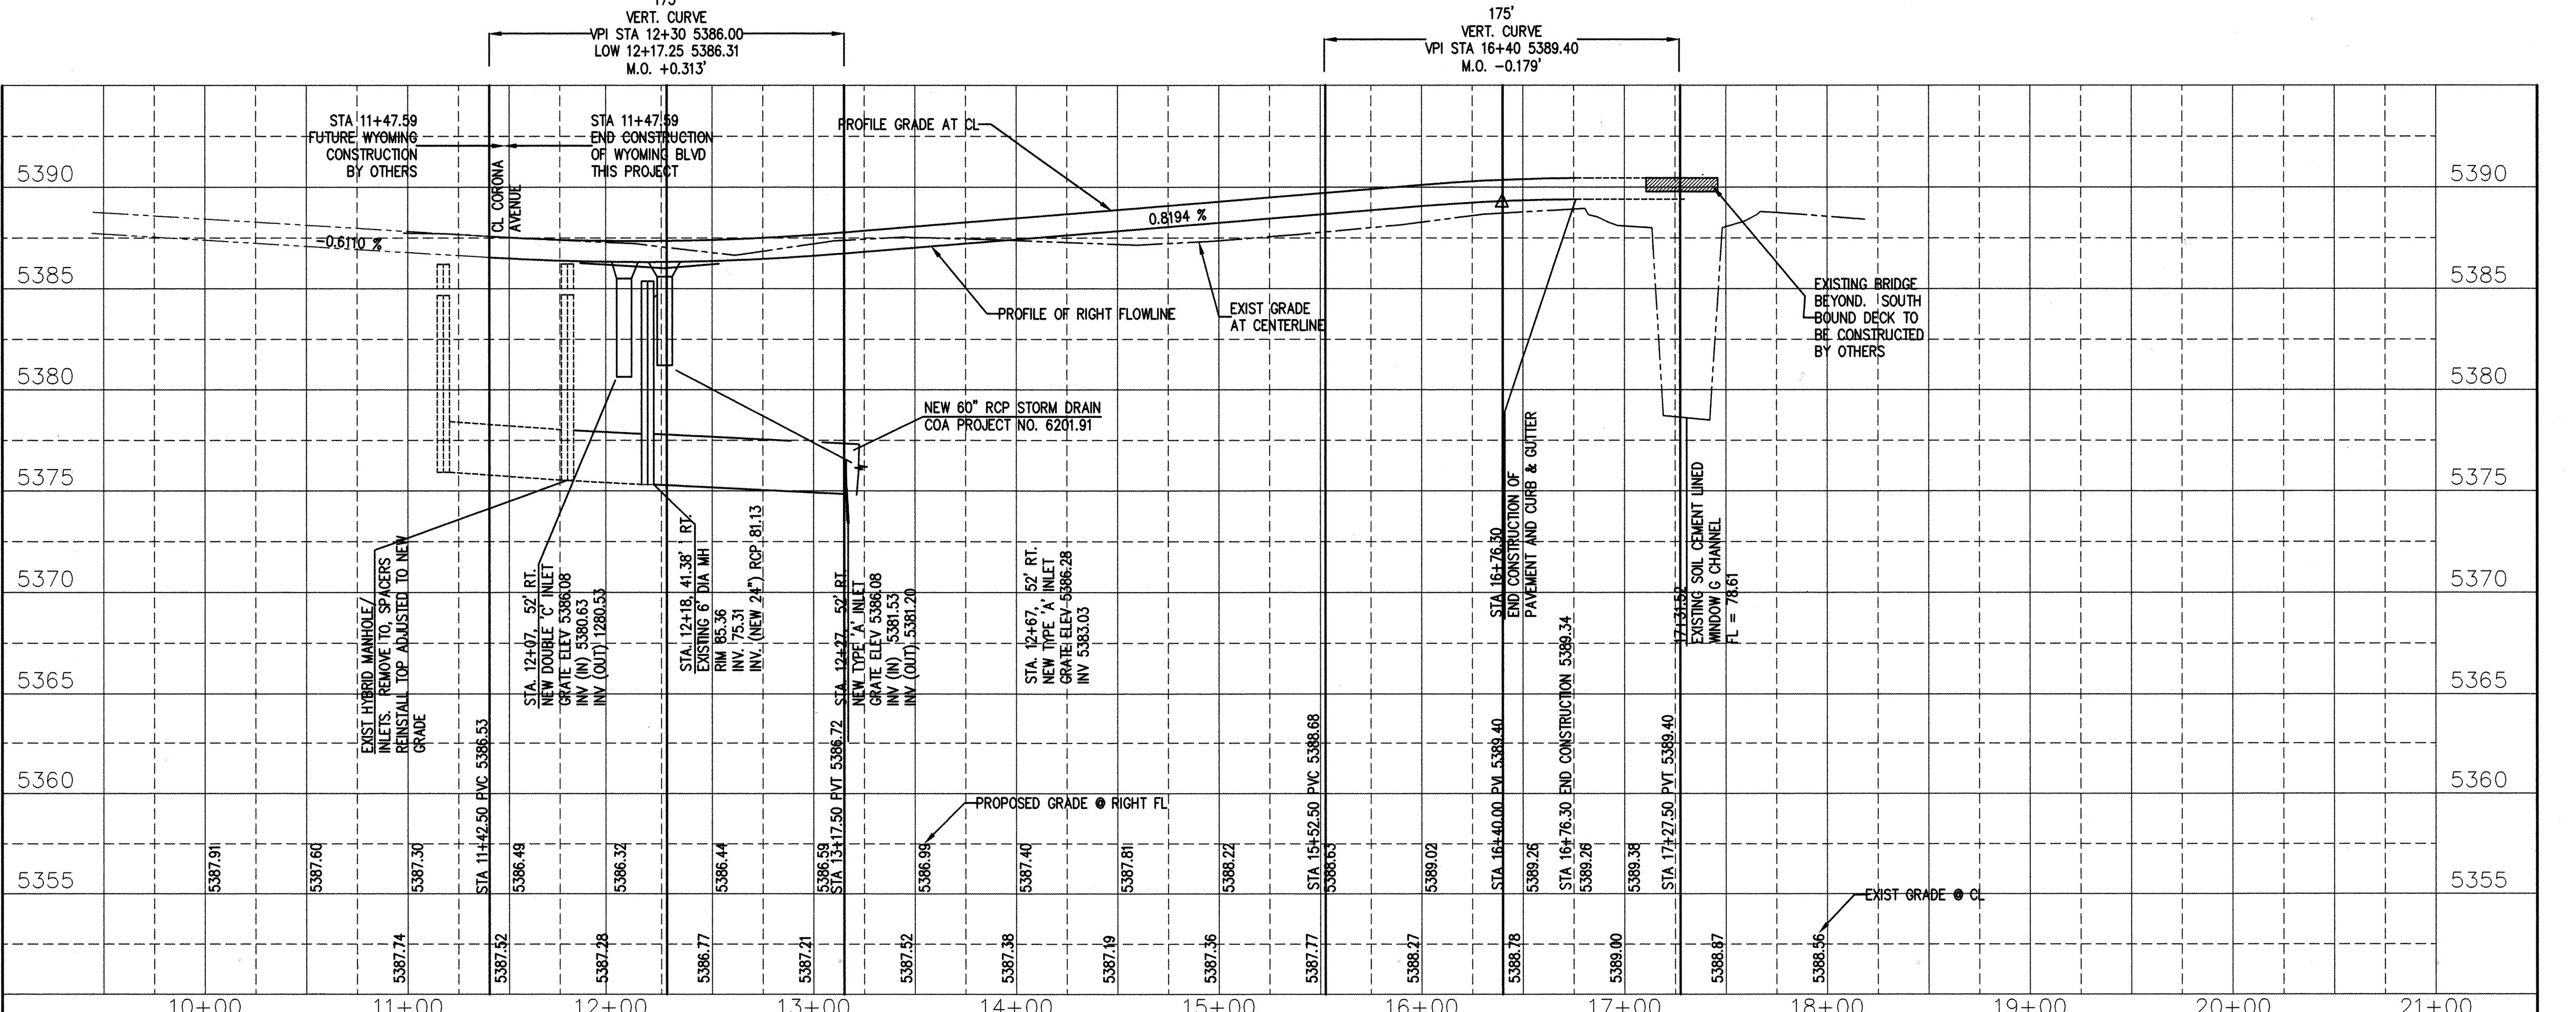

LARRY READ & ASSOCIATES
Civil Engineers
12836 - B Lomas Blvd., N.E.
Albuquerque, New Mexico 87112
(505) 227-8421

CITY OF ALBUQUERQUE
PUBLIC WORKS DEPARTMENT
PLANNING & DEVELOPMENT GROUP

ALBUQUERQUE FIRE DEPT. STATION # 20
WYOMING BLVD. CONSTRUCTION

16+00

18+00

20+00

22+00

24+00

26+00

28+00

NOTE:
ALL BOULDERS REMOVED
FROM THE RIGHT-OF-WAY
SHALL BE STOCK PILED
ON-SITE FOR FUTURE USE.

CENTERLINE OF CONSTRUCTION
CENTERLINE OF EXISTING RIGHT-OF-WAY

STA 21+16, CL TO STA 21+97.47 20' RT
BUILD TEMP ASPHALTIC CONCRETE
PAVEMENT SECTION PER DETAIL
SHEET 4 OF 13.

STA 21+97.47 20' RT TO
STA 26+11.94 20' RT PLUS
FILLET, BUILD ASPHALTIC CONCRETE
PAVEMENT SECTION PER DETAIL
SHEET 5 OF 13.

STA 22+48' LT
CONNECT NEW 6"
PVC FIRE HYDRANT
TO EXIST 8" PVC MAIN

EXISTING
ROW
60'

STA 24+77 BUILD 4"
SANITARY SEWER SERVICE
LINE TO PROPERTY LINE
PER COA STD DWG 2125.

STA 24+82 INSTALL
4" FIRE LINE, 45 LF
4" AWWA C-900 PRESS
CL 150, 4" TAPPING SADDLE,
4" TAPPING VALVE, PER COA
STD DWG 2301.

STA 24+86 INSTALL 1/2" 2"
LF PIPE, METER
BASE AND BOX PER COA STD
DWG 2363.

STA 26+11.94 TO 26+91.80
CL TO 49.10' RT, BUILD TEMPORARY
ASPHALT PAVEMENT FILLED AND
EXTRUDED ASPHALT CURB.
CL CORONA STA 26+91.80 =
CL WYOMING STA 11+47.59

20'
R

C1 - CURB RETURN
STA. 11+67.66, 80.05' RT.
PT. RL ELEV.
P.C. 72.11 F.L. CURVE DATA
1 72.77 Δ = 62.31' 13"
2 73.45 R = 30.00'
T = 18.21'
3 74.11 L = 32.74'
P.T. 74.78 Dc = 190'59"09"
CURB RETURN
STA. 11+97.63, 52.00' RT.

C2 - CURB RETURN
STA. 11+67.66, 80.05' RT.
PT. RL ELEV.
P.C. 75.20 F.L. CURVE DATA
1 75.38 Δ = 63'38"30"
2 75.55 R = 30.00'
3 75.73 T = 18.62'
P.T. 75.90 L = 33.32'
CURB RETURN Dc = 190'59"09"
STA. 11+97.63, 52.00' RT.

NEW 6' PCC
CONCRETE
SIDEWALK

STA 22+48, 22.68' RT
BUILD 4-1/2" BURY
FIRE HYDRANT PER
COA STD DWG 2340

STA 22+96.86 BUILD
24' PRIVATE ACCESS
DRIVEWAY PER COA
STD DWG 2426

STA 24+14.83 FUTURE
50' PRIVATE ACCESS
DRIVEWAY PER COA
STD DWG 2426

COORDINATE
DRIVE PAD
LOCATION W/
60x24 (ON-SITE)
SITE PLAN TYPICAL


STA 26+47.42, 30.92' RT
EXISTING 8" DIA MANHOLE
REMOVE TOP, SPACER BLOCKS
REPLACE TOP TO GRADE PER
COA STD DWG 2101

STA 22+16.33 4' RT
BEGIN TEMP ASPH CURB
FL 536.79
TC 5368.65

STA 21+91.47 20.00' RT
BEGIN NEW STP CURB
FL 536.79
TC 5370.34


NEW 60" STORM DRAIN
TO WINDOW G CHANNEL
PER COA PROJECT 6201.91

WYOMING BLVD.
SEE SHEET C2

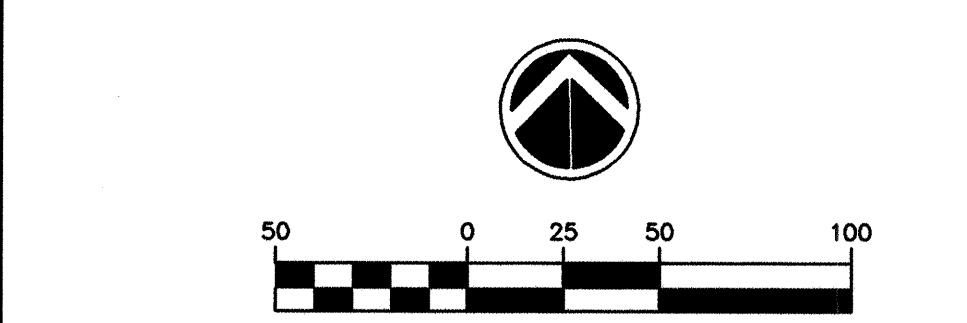

1" = 50' HORIZ.
1" = 5' VERT.

CORONA AVENUE, N.E.

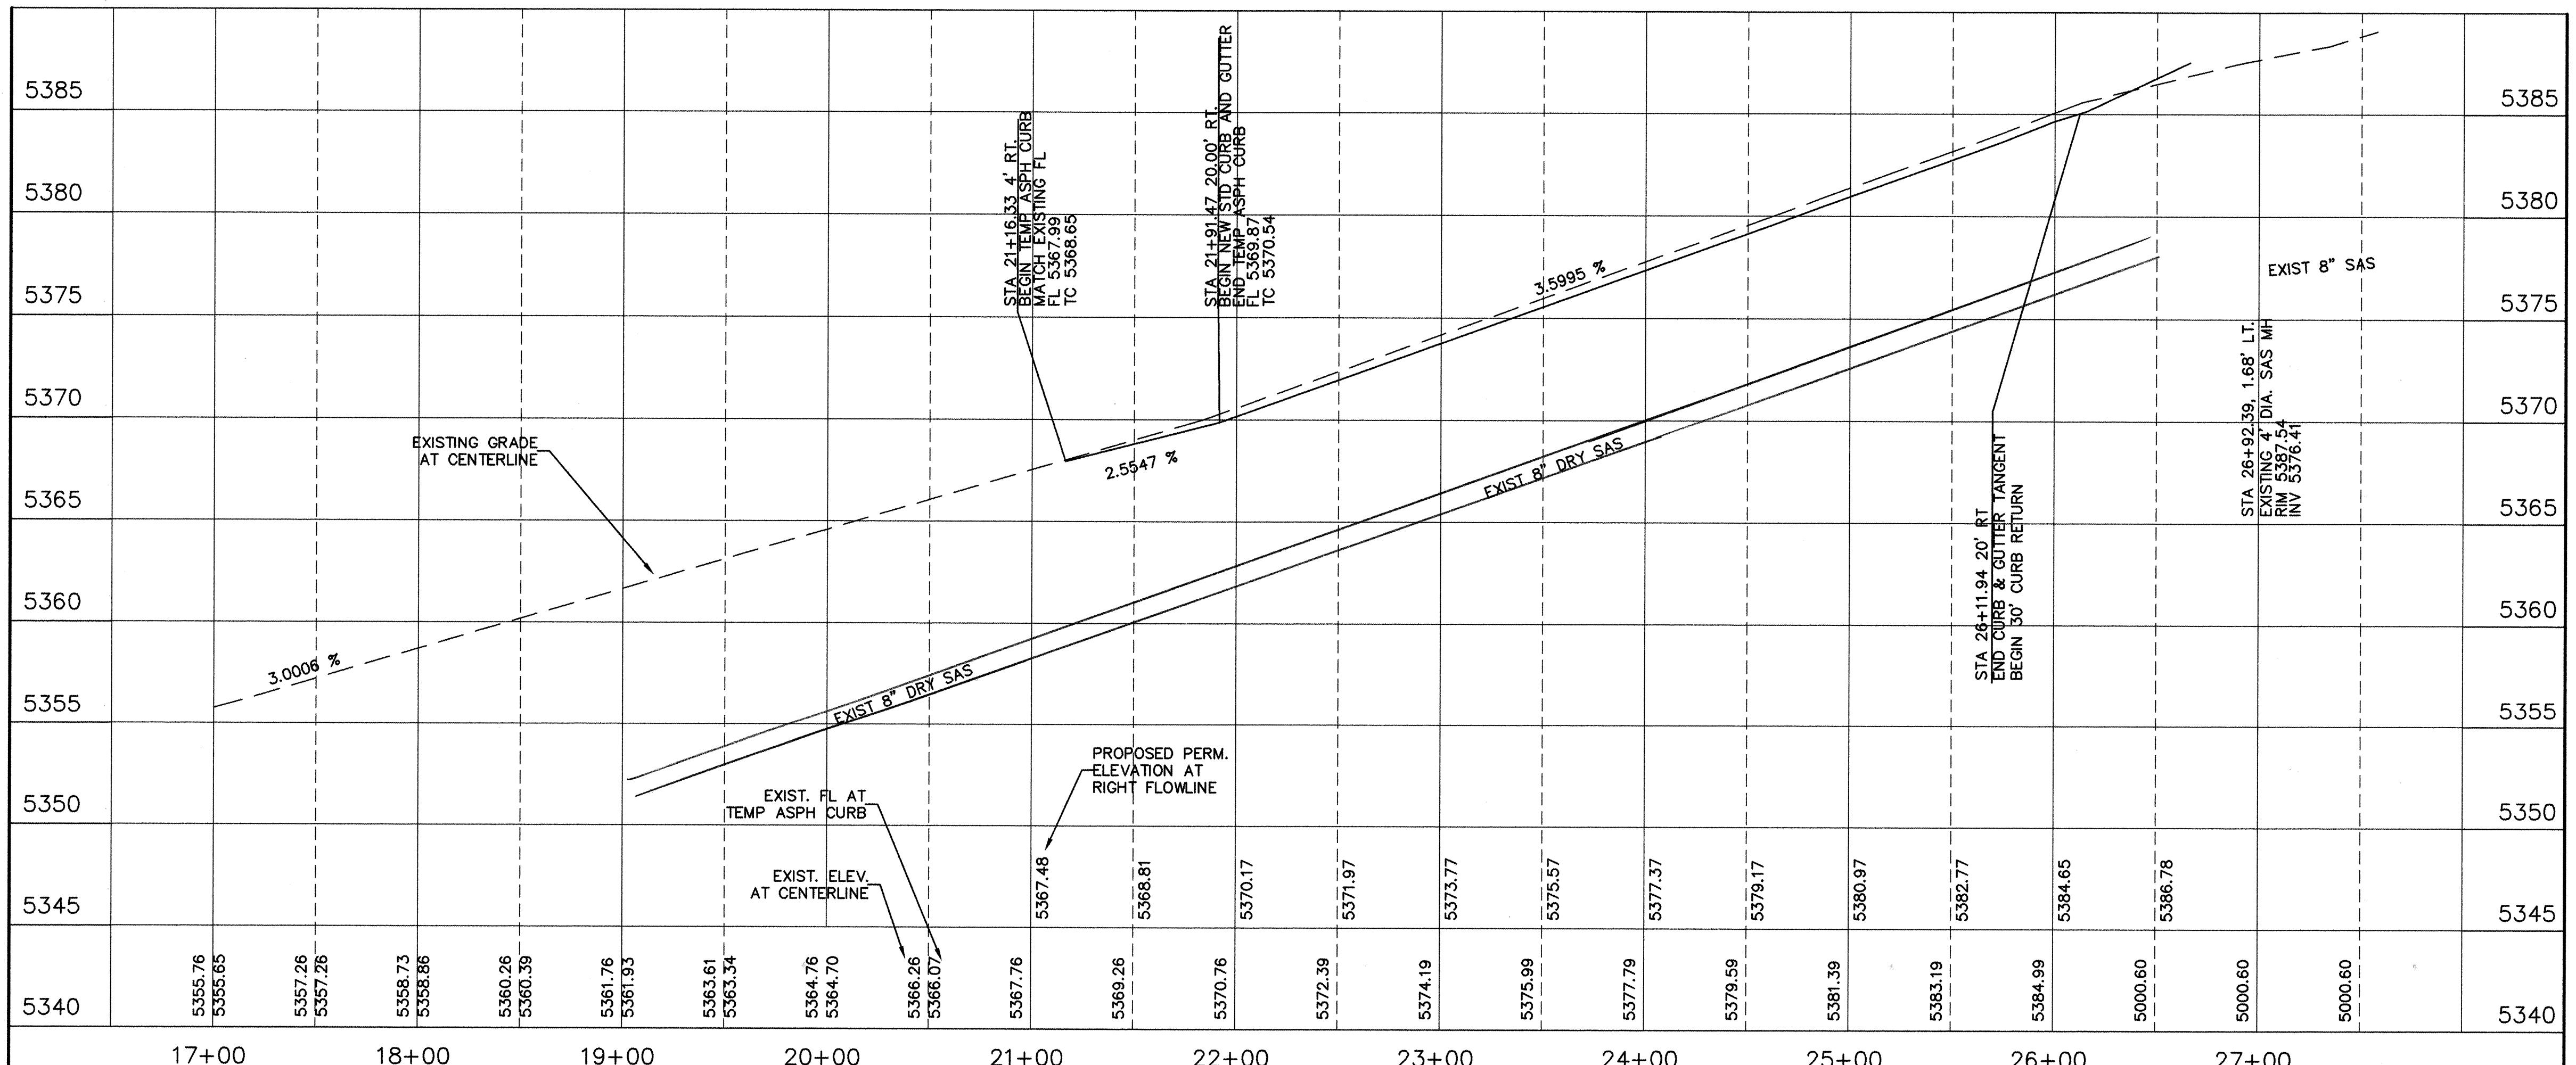

FOR INFORMATION ONLY

LARRY READ & ASSOCIATES
Civil Engineers
12836 - B Lomas Blvd., N.E.
Albuquerque, New Mexico 87112
(305) 237-8421

CITY OF ALBUQUERQUE
PUBLIC WORKS DEPARTMENT
ENGINEERING DEVELOPMENT GROUP

TITLE: ALBUQUERQUE FIRE DEPT. STATION # 20
CORONA AVENUE CONSTRUCTION


Design Review Committee APPROVED	City Engineer Approval APPROVED	Last Design Update Mo./Day/Yr.	Last Design Update Mo./Day/Yr.
OCT 22 1999	OCT 22 1999		
DESIGN REVIEW COMMITTEE	CITY ENGINEER		
DATE DRAWN BY	DATE CHECKED BY		




City Project No. 6042.91 Zone Map No. C-19 Sheet 3 of 13

LEGEND

- EXIST ASPHALT PAVEMENT TO REMAIN
- NEW PERMANENT ASPHALT PAVEMENT PER SHEET 5 of 13
- NEW TEMPORARY ASPHALT PAVEMENT PER SHEET 4 of 13

AS BUILT INFORMATION	
CONTRACTOR	WORK STAGED BY DATE
INSPECTORS BY DATE	ACCEPTANCE BY DATE
DRAWINGS BY DATE	DEFECTS BY DATE
RECTIFIED BY DATE	RECORDED BY DATE
MICRO-FILM INFORMATION	
STATION 11+67.66, 80.05' RT.	
P.C. 75.60 F.L. CURVE DATA	
1 76.05 Δ = 50'05"45"	R = 29.50'
2 76.50 T = 16.72'	L = 30.43'
3 76.94 P.T. 77.39 Dc = 190'13"23"	CL CORONA STA 26+91.80 = CL WYOMING STA 11+47.59
CURB RETURN STA. 11+97.63, 52.00' RT.	
C4 - CURB RETURN STA. 11+67.66, 80.05' RT.	
P.C. 80.00 F.L. CURVE DATA	
1 80.05 Δ = 82'14"34"	R = 30.00'
2 80.10 T = 26.19'	L = 43.06'
3 80.05 P.T. 80.00 Dc = 190'59"09"	CURB RETURN STA. 11+97.63, 52.00' RT.
WYOMING BLVD. Station is on the south side of Paseo del Norte N.E.	
ELEV = 5378.78 feet (M.S.L.D.)	

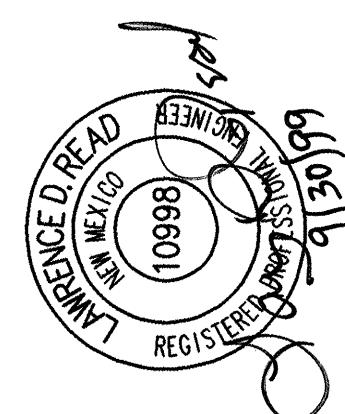

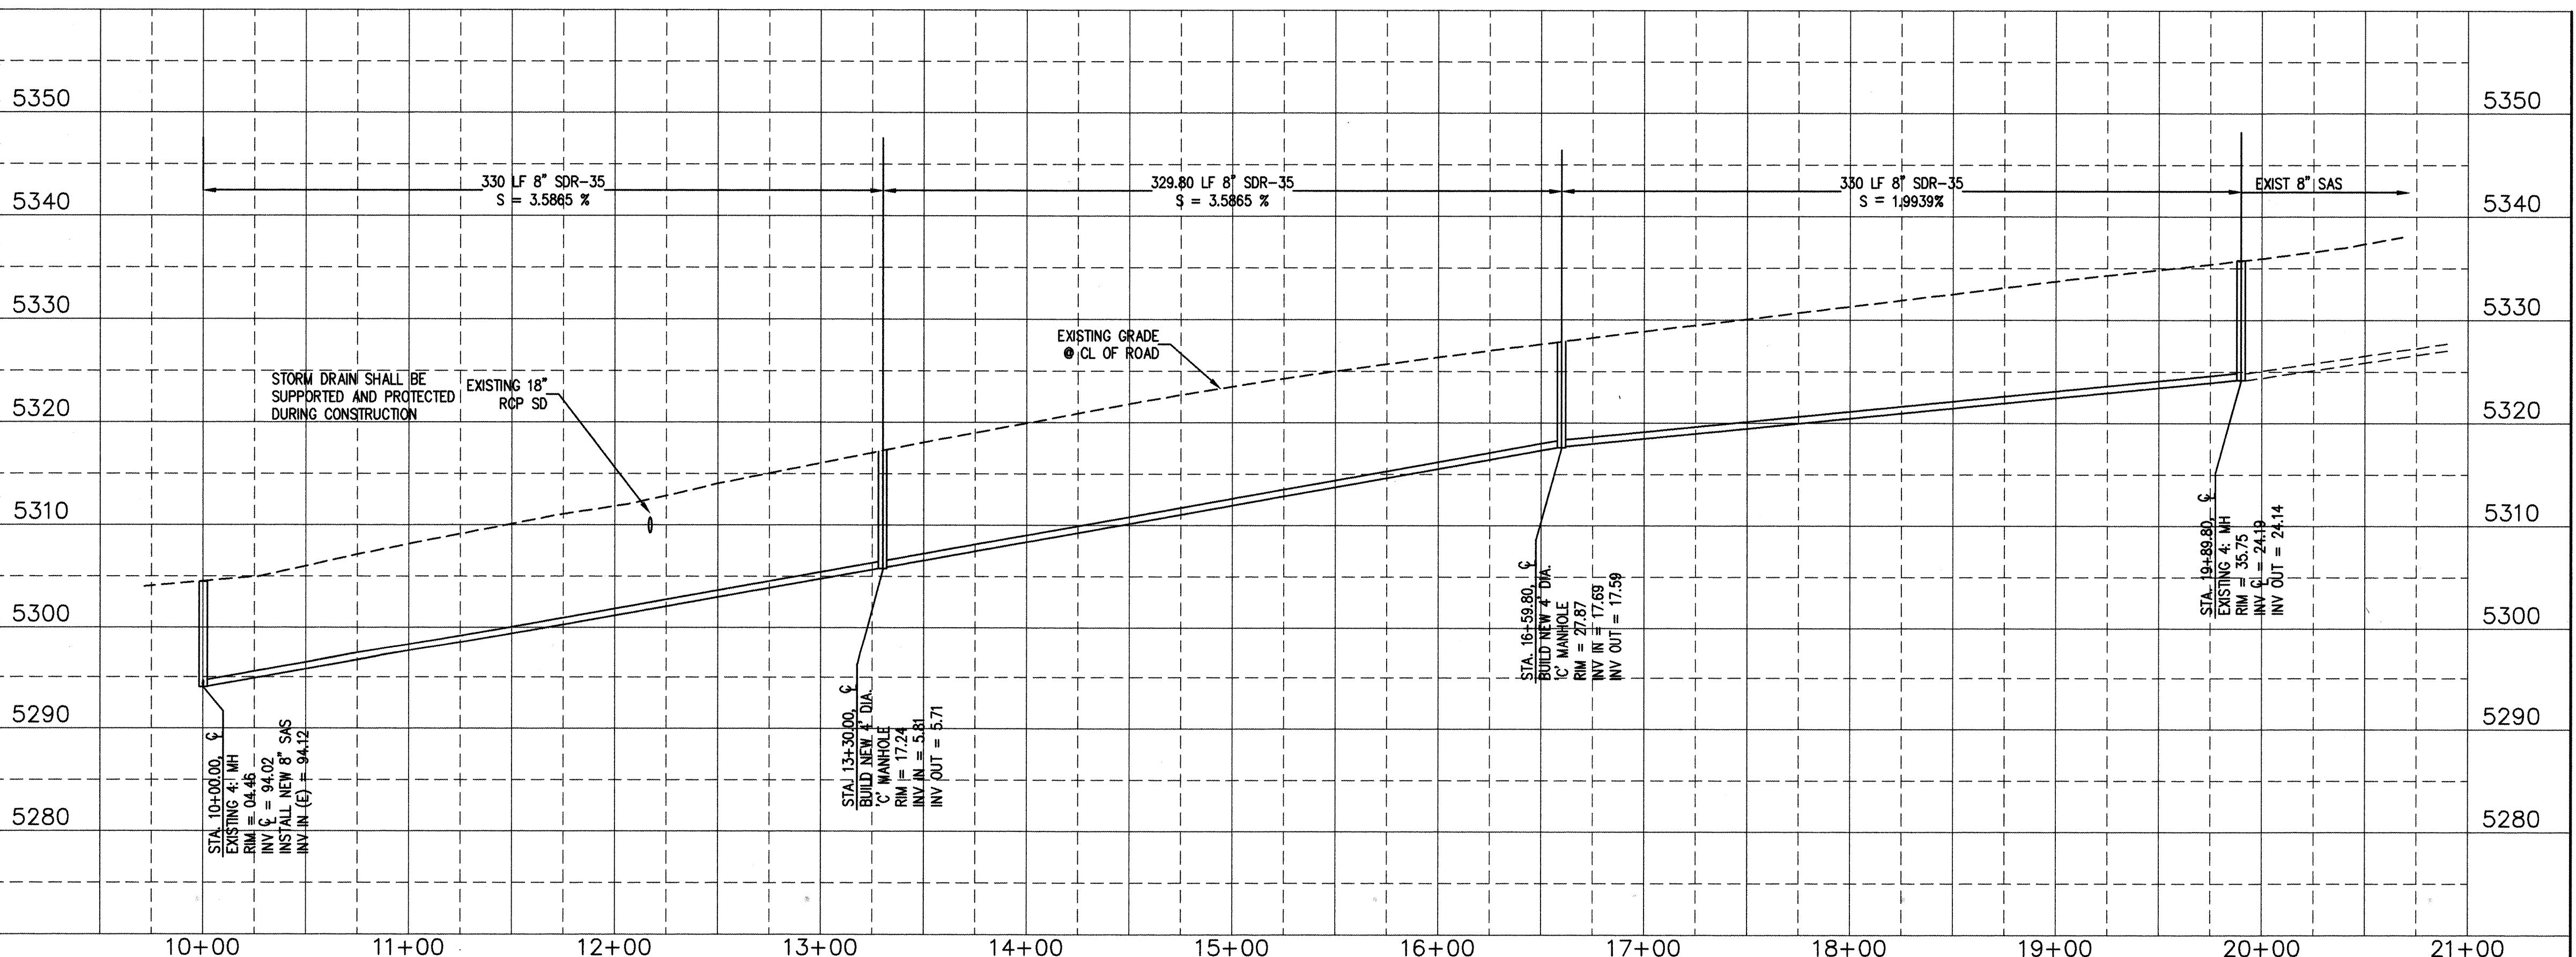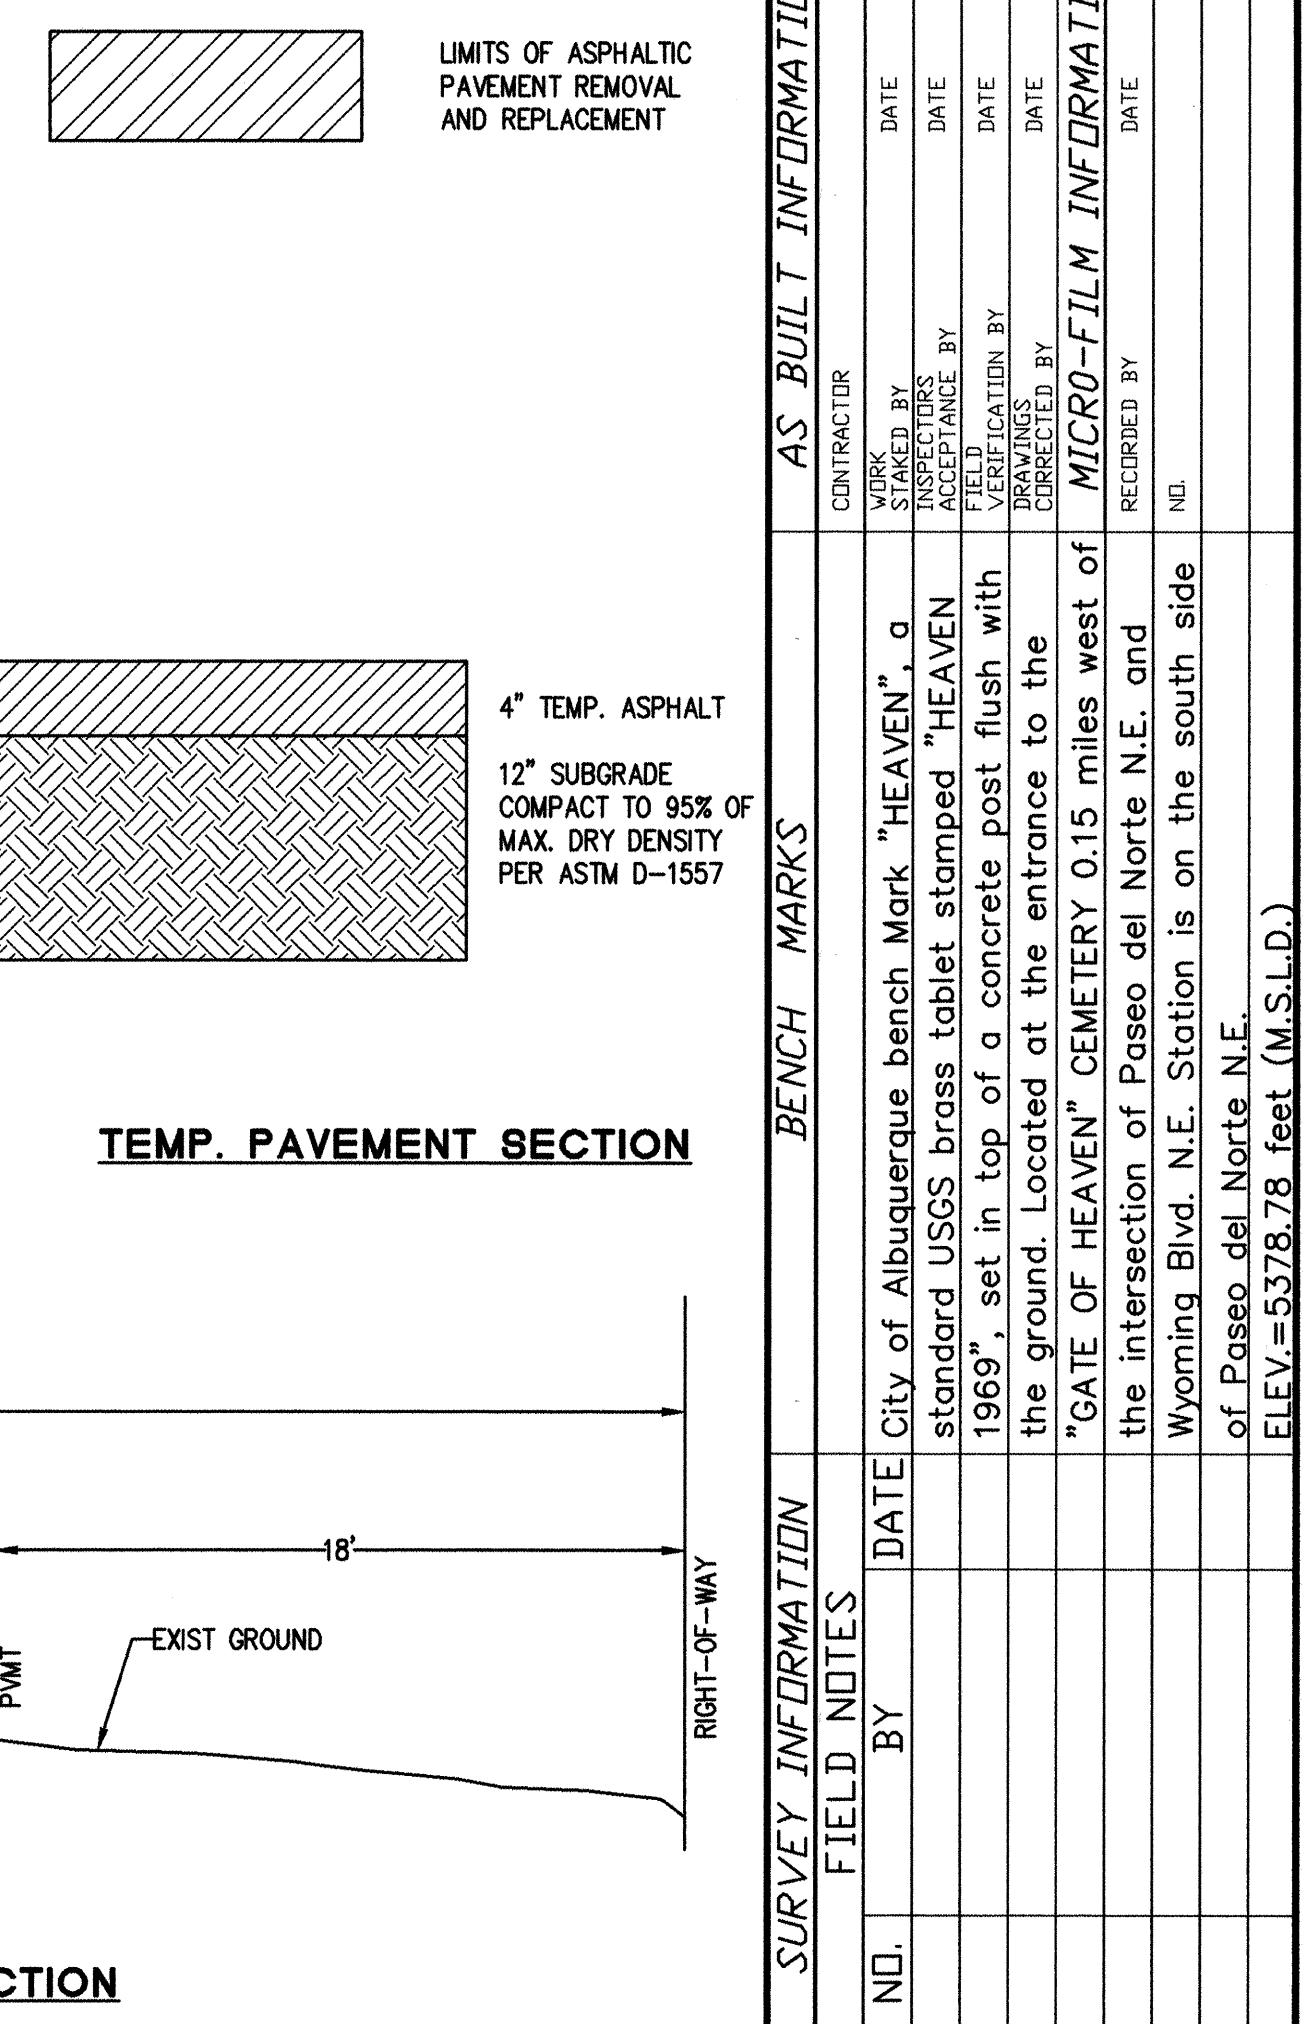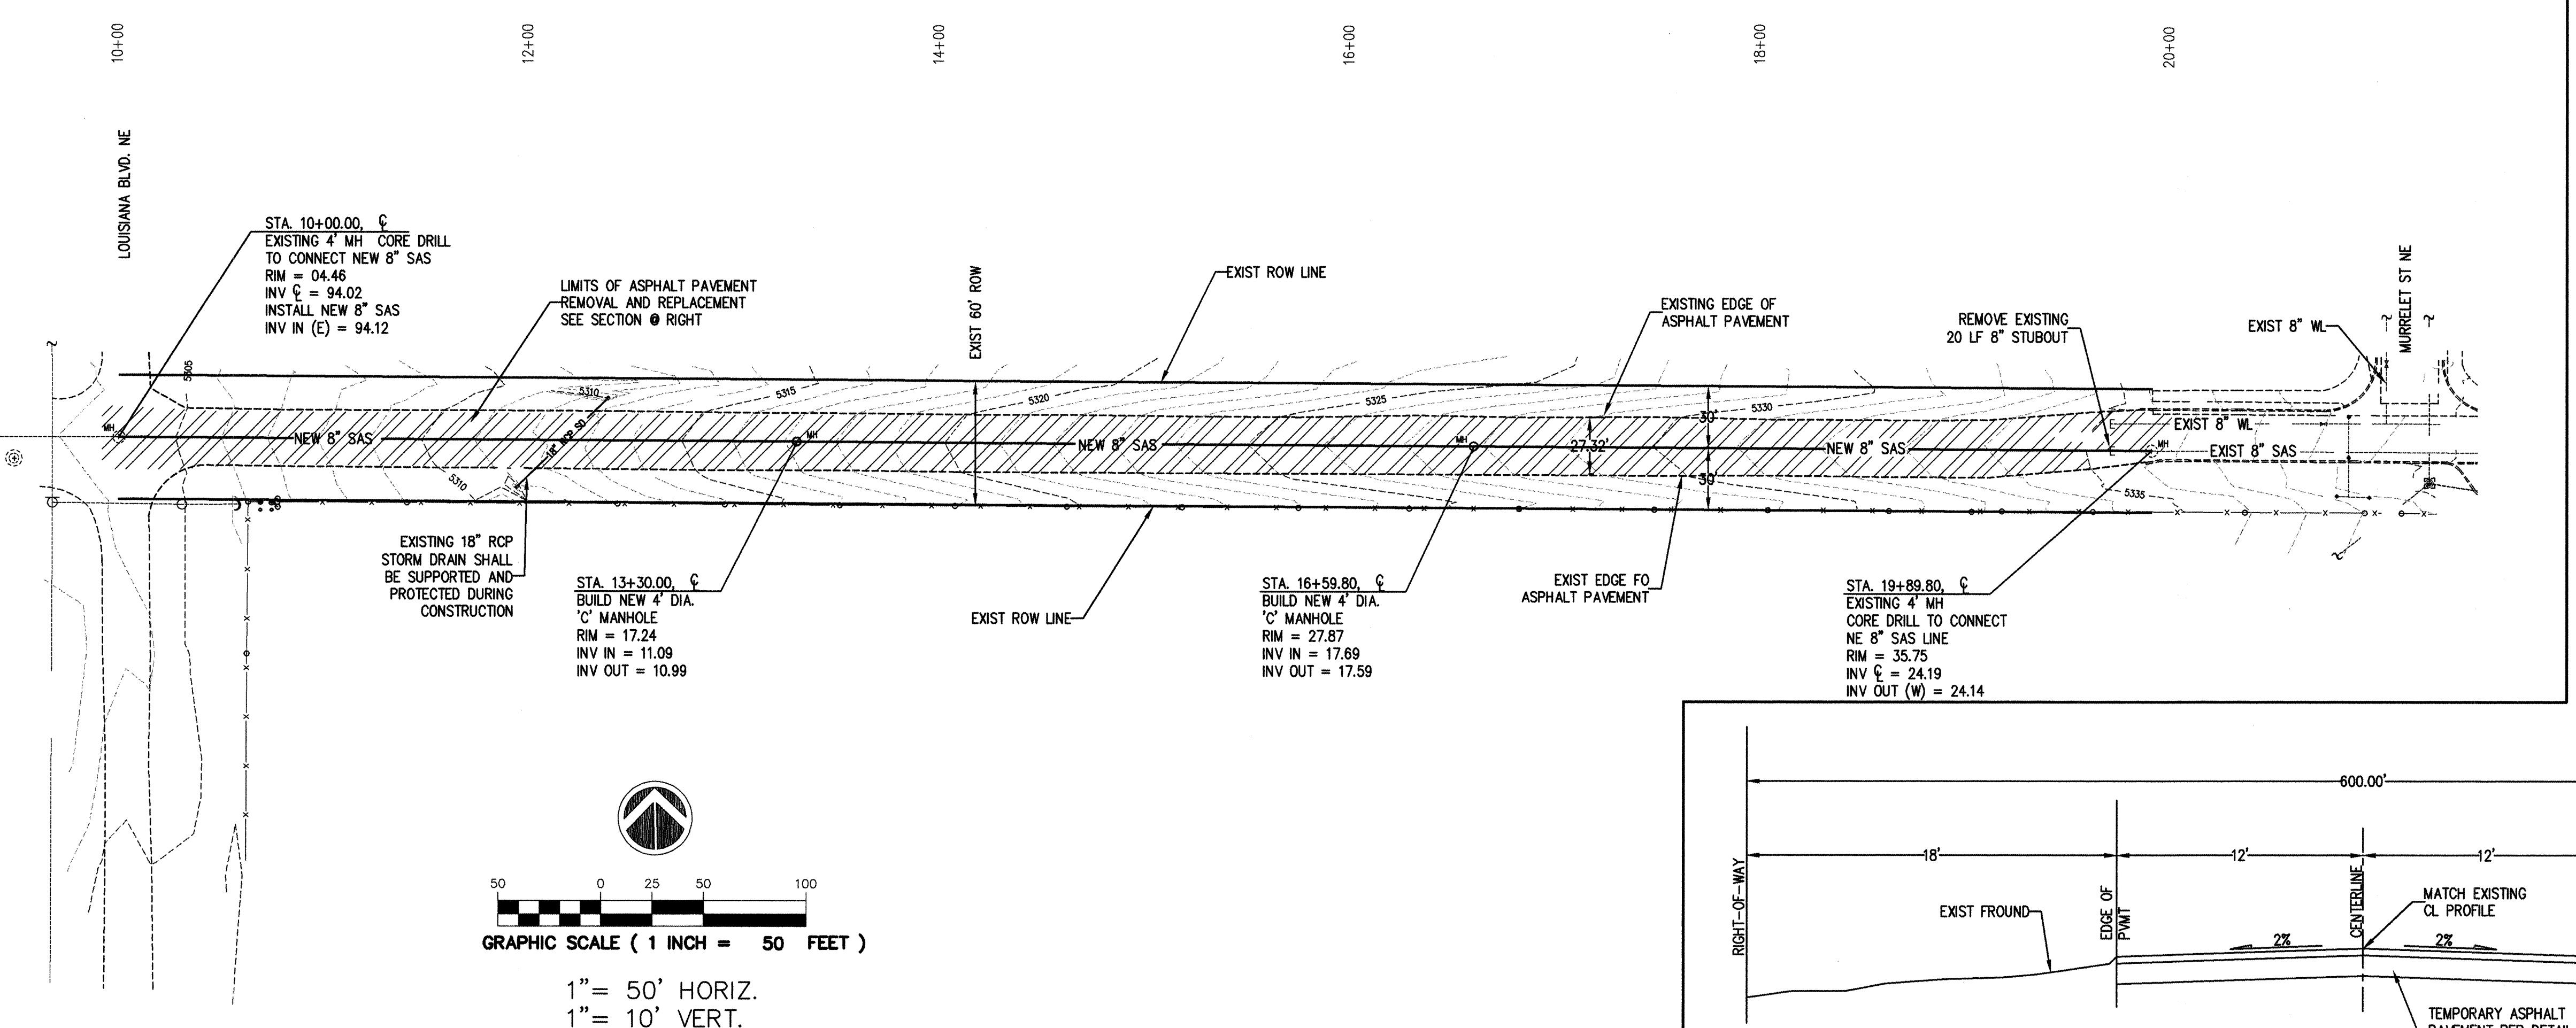

ENGINEER'S SEAL	SURVEY INFORMATION	BENCH MARKS	AS BUILT INFORMATION
	NO. FIELD NOTES	DATE	CONTRACTOR
	BY	city of Albuquerque bench Mark "HEAVEN", a standard USGS brass tablet stamped "HEAVEN" 1969, set in top of a concrete post flush with the ground. Located at the entrance to the "GATE OF HEAVEN" CEMETERY 0.15 miles west of the intersection of Paseo del Norte N.E. and Wyoming Blvd. N.E. Station is on the south side of Paseo del Norte N.E.	STAKED BY INSPECTOR BY DATE
	REVISIONS	VERIFICATION BY DRAWINGS CORRECTED BY DATE	RECORDED BY MICRO-FILM INFORMATION DATE
DESIGNED	DATE	DATE	DATE
DRAWN BY	DATE	DATE	DATE
CHECKED BY	DATE	DATE	DATE

LARRY READ & ASSOCIATES
Civil Engineers
12836-B Lomas Blvd., N.E.
Albuquerque, New Mexico 87112
(505) 237-8421

CITY OF ALBUQUERQUE
PUBLIC WORKS DEPARTMENT
ENGINEERING DEVELOPMENT GROUP


TITLE: CORONA AVENUE NE SANITARY SEWER EXTENSION

Design Review Committee OCT 22 1999 City Engineer Approval OCT 22 1999
DESIGN REVIEW COMMITTEE CITY ENGINEER


LAST DESIGN UPDATE Mo./Day/Yr. Mo./Day/Yr.
OCT 22 1999 OCT 22 1999

OFFSITE


City Project No. 6042.91 Zone Map No. C-19 Sheet 4 of 13

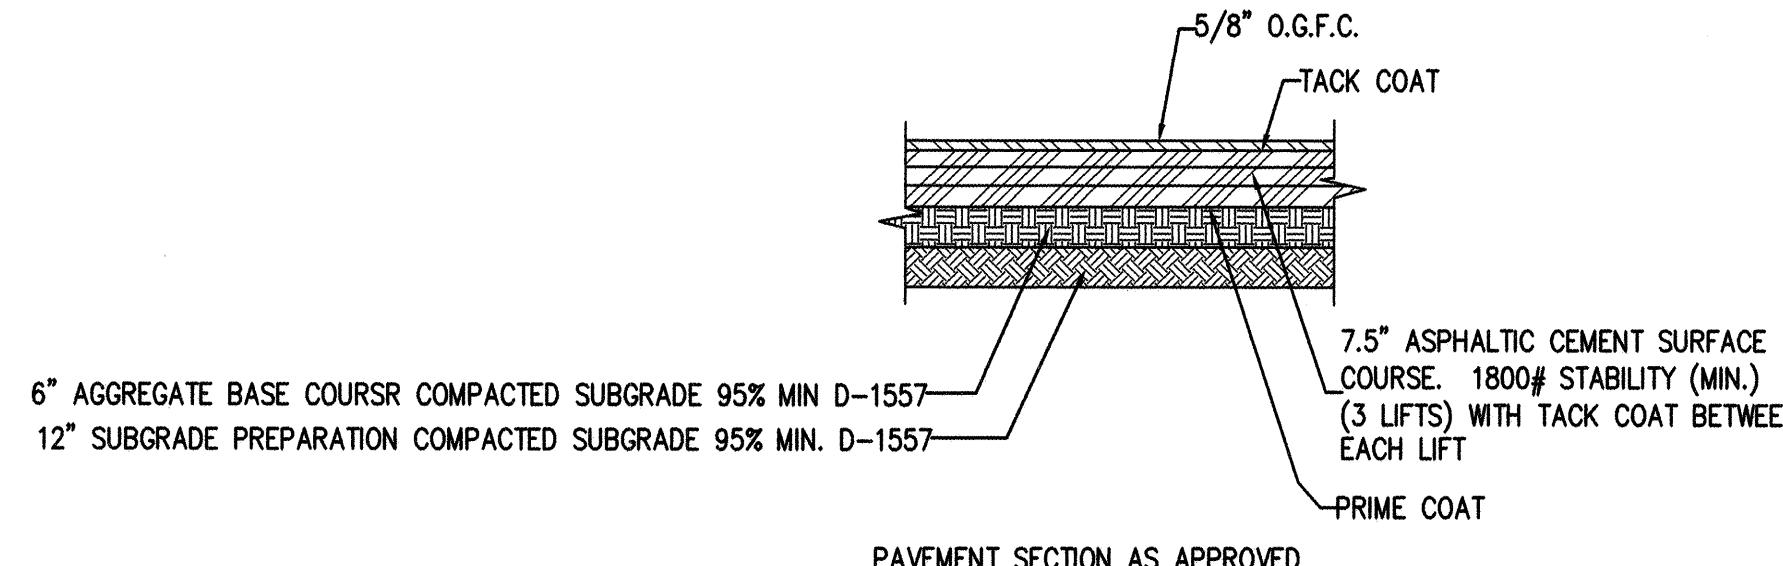


**WYOMING BOULVARD
PROPOSED PAVEMENT SECTION**

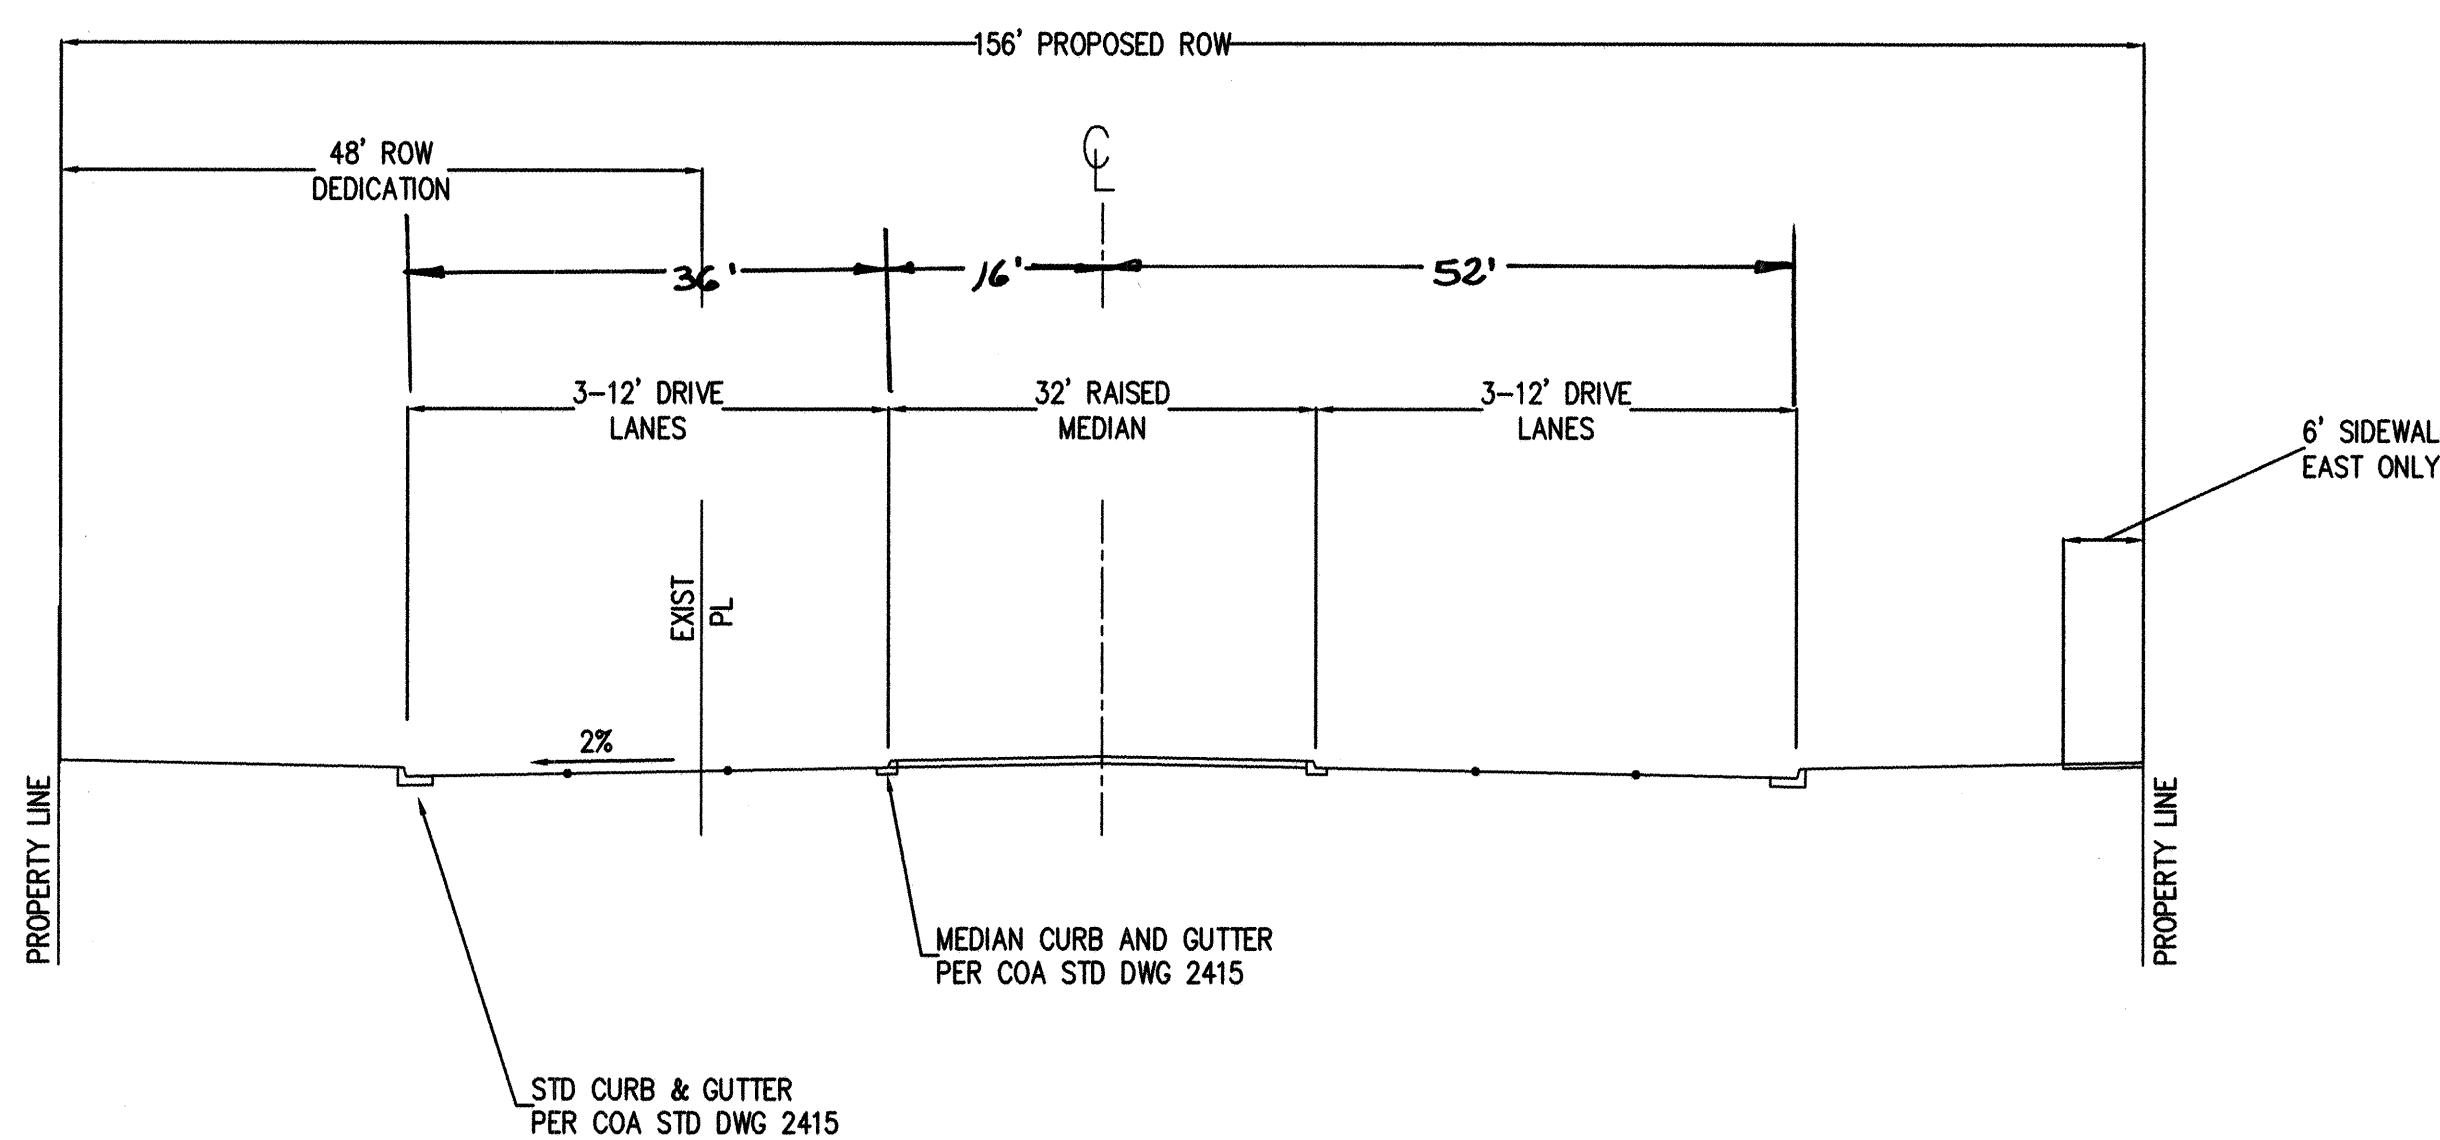


**WYOMING BOULVARD
FUTURE TYPICAL SECTION**

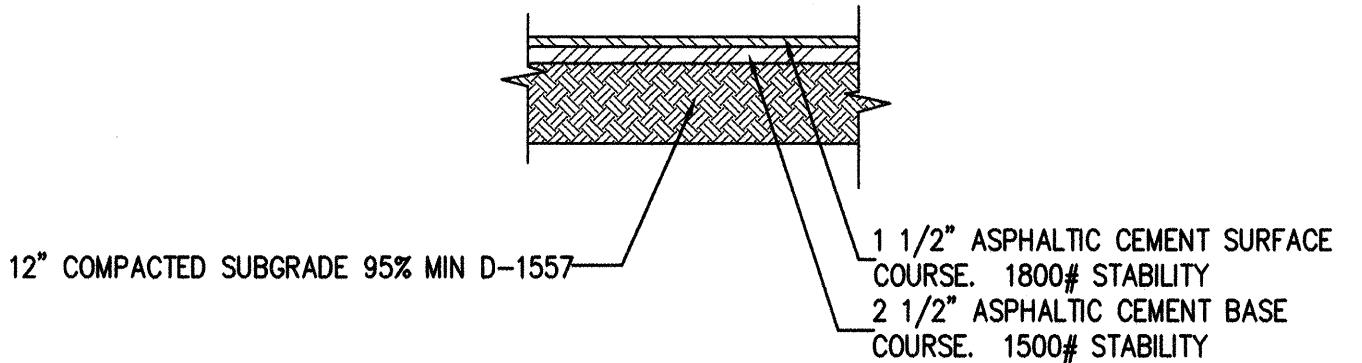


**CORONA AVENUE
PROPOSED PAVEMENT SECTION**

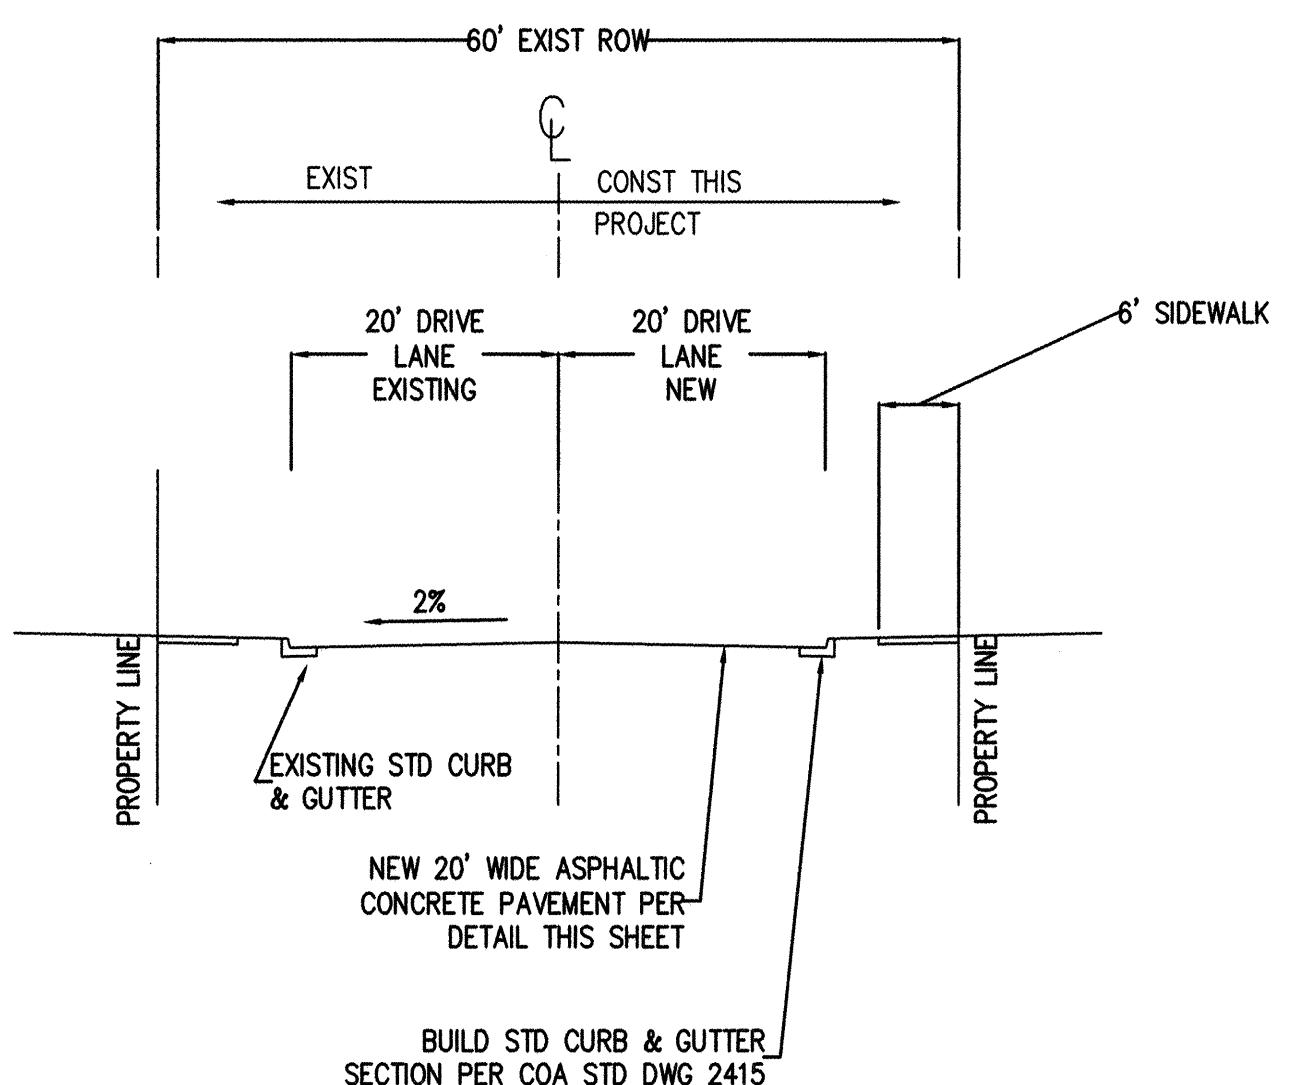


**CORONA AVENUE
PROPOSED TYPICAL SECTION**

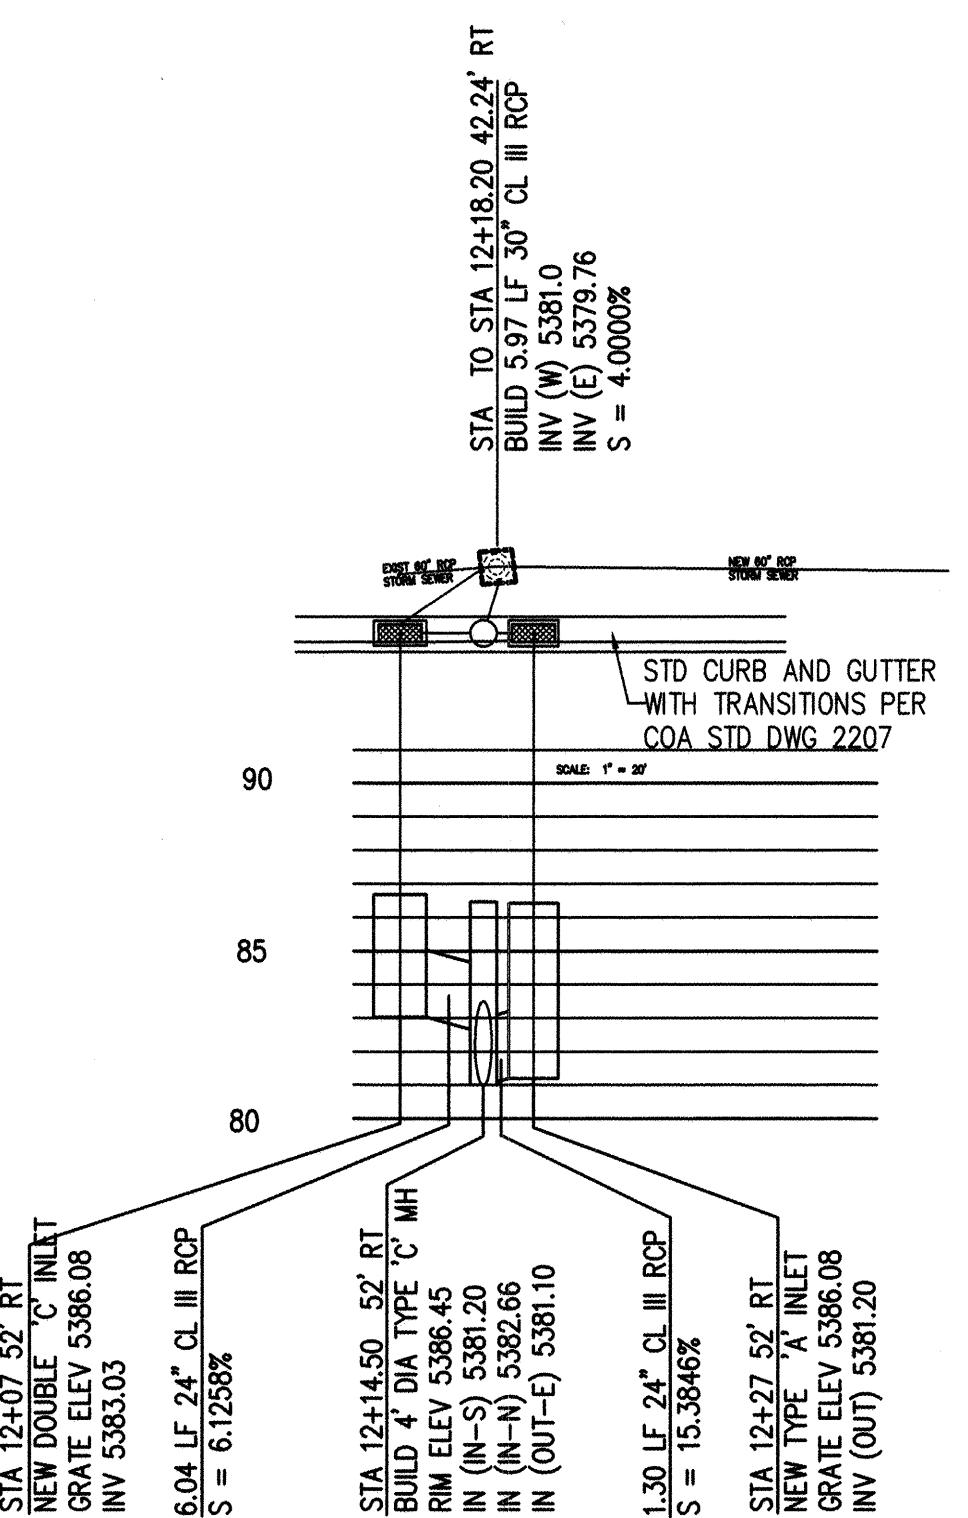

**WYOMING BLVD.
STORM INLET DETAIL**

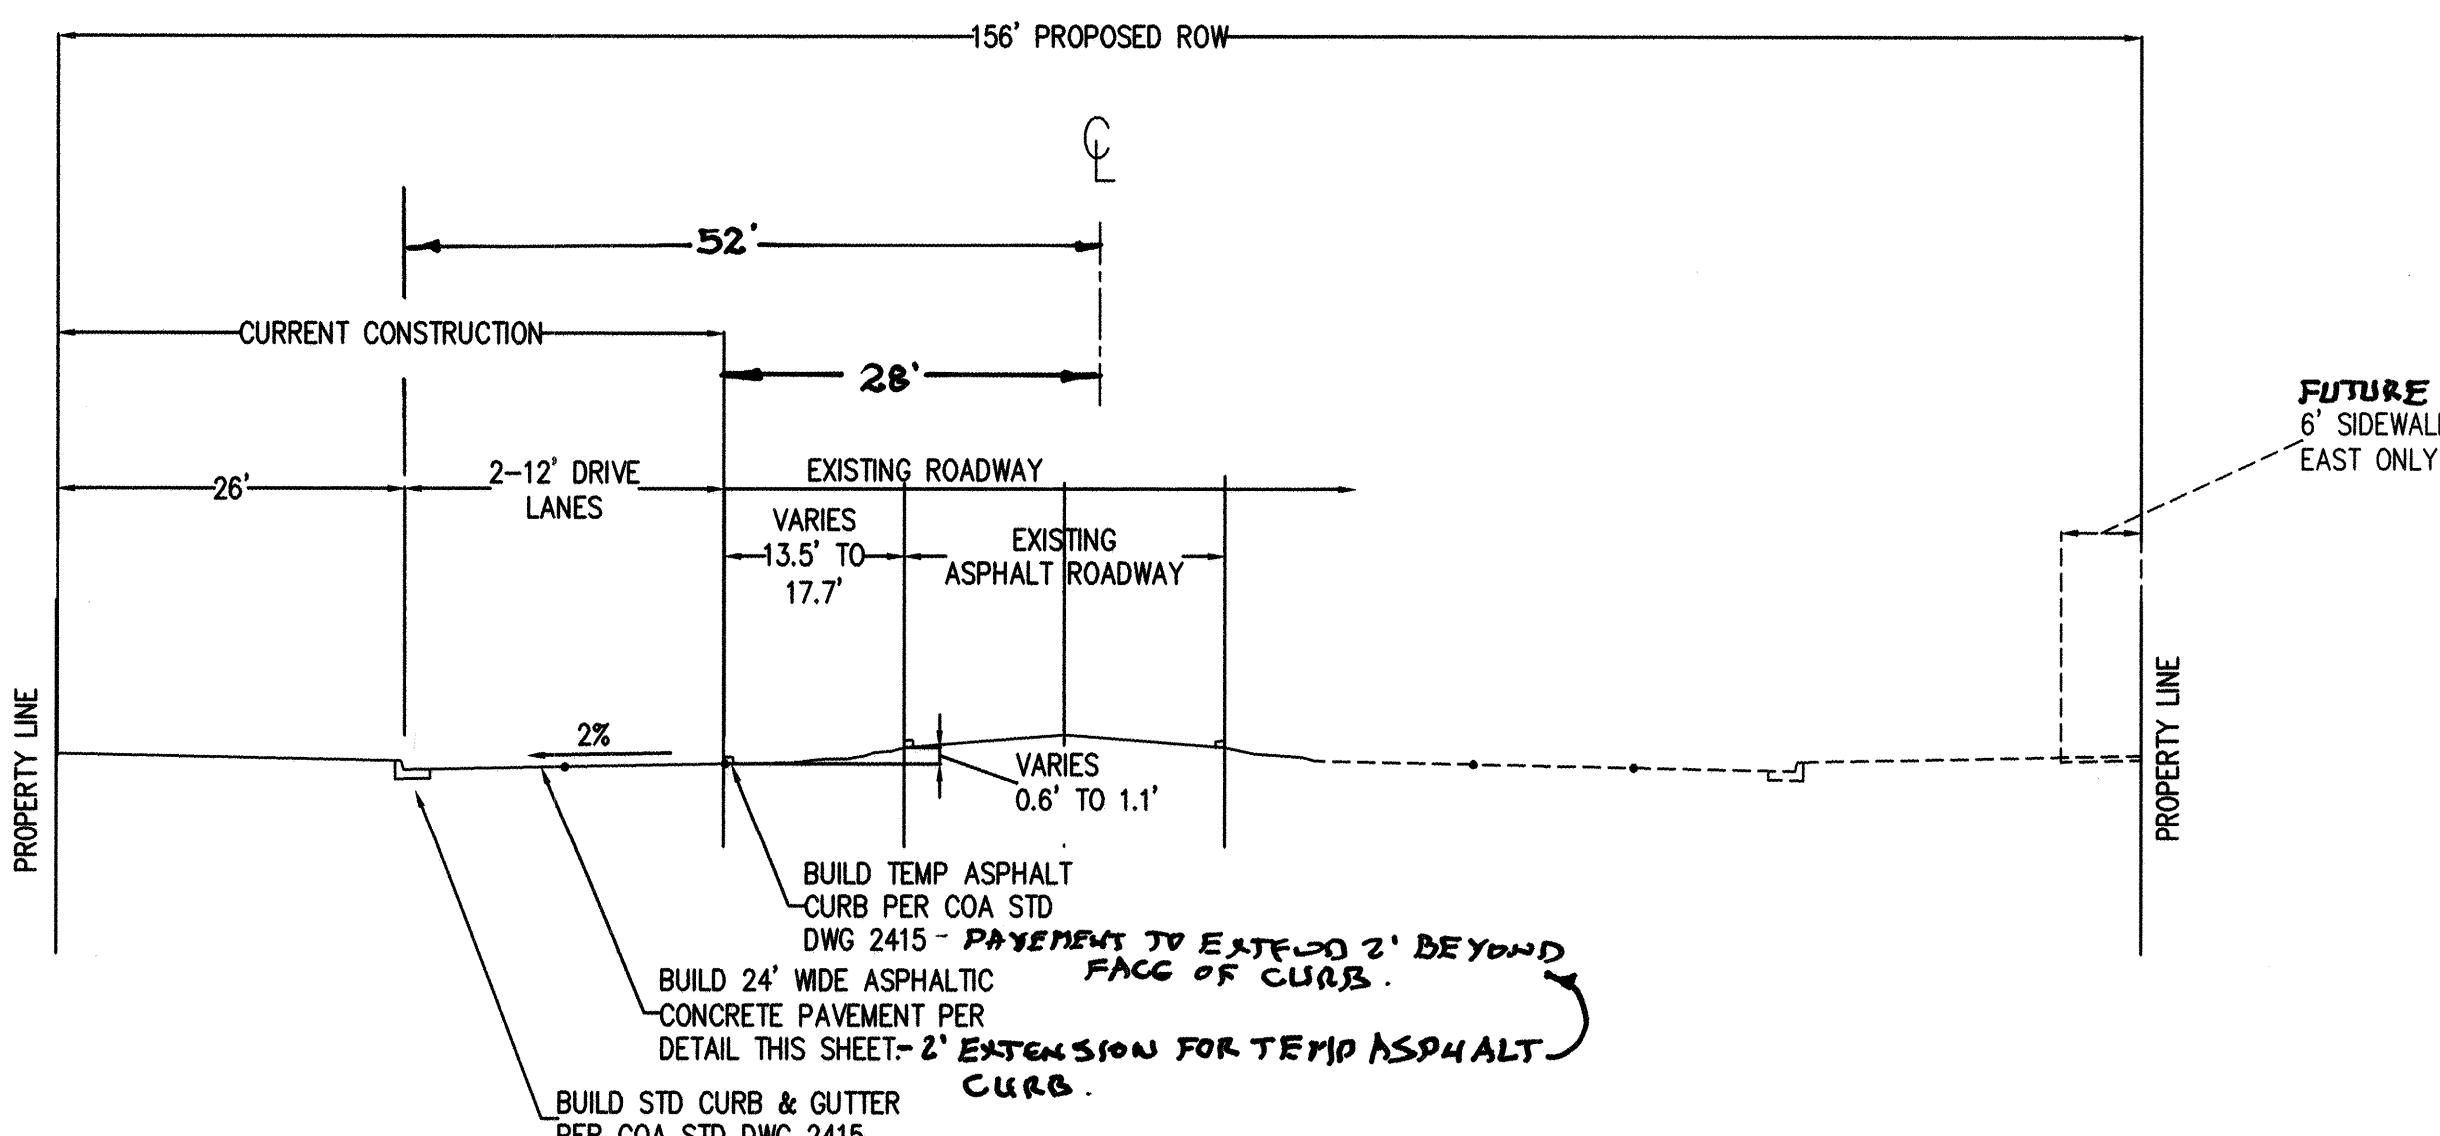


**WYOMING BOULVARD
CURRENT CONST. SECTION**

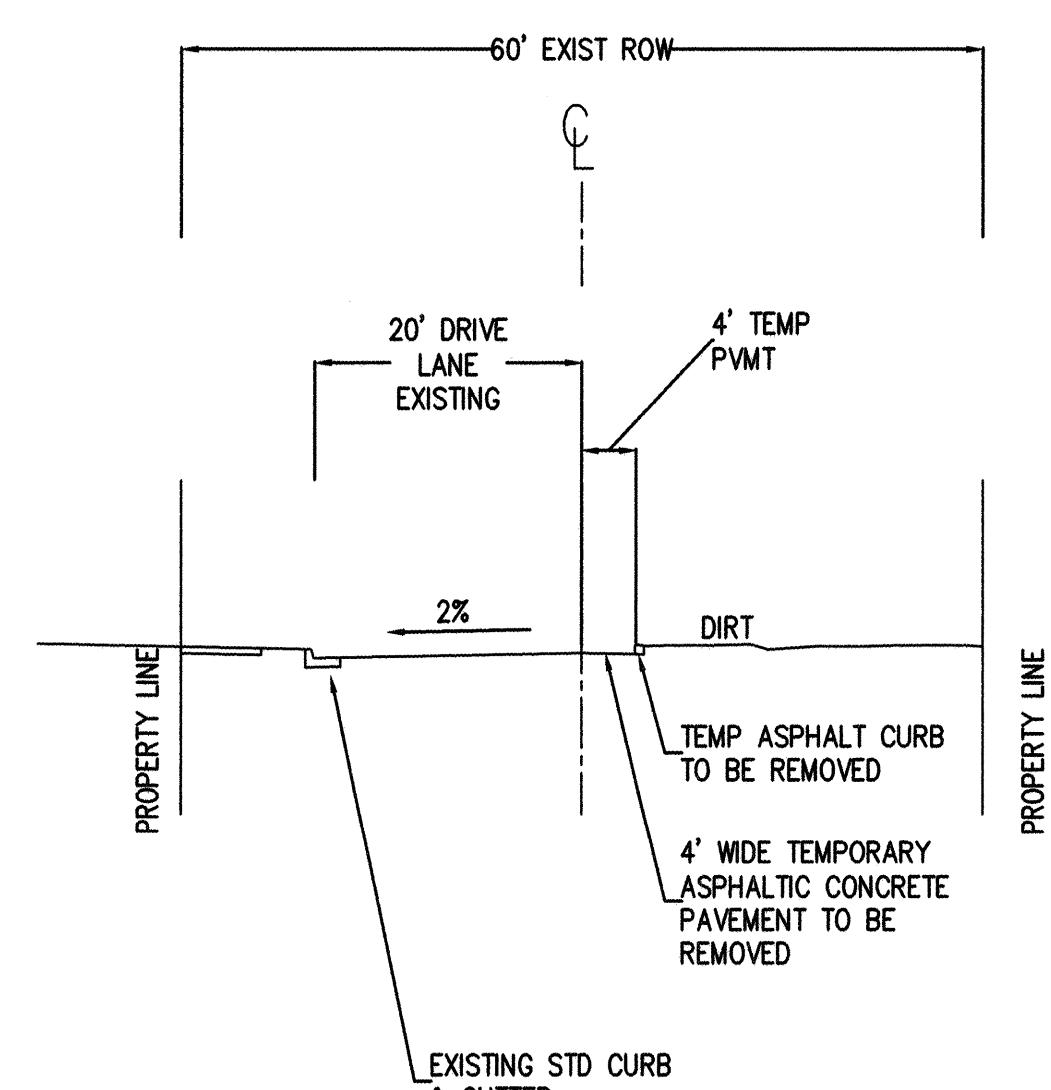


**CORONA AVENUE
EXISTING SECTION**

AS BUILT INFORMATION	
CONTRACTOR	DATE
WORK INSPECTED BY	DATE
FIELD NOTES	DATE
INVESTIGATOR	DATE
FIELD LOCATION	DATE
DRAWINGS	DATE
CORRECTED BY	DATE
MICRO-FILM INFORMATION	
RECORDED BY	DATE
10998	
LAWRENCE D. READ REGISTERED ENGINEER 1930	
FOR INFORMATION ONLY	
LARRY READ & ASSOCIATES Civil Engineers 12836 - B Lomas Blvd., N.E. Albuquerque, New Mexico 87112 (505) 237-8421	
CITY OF ALBUQUERQUE PUBLIC WORKS DEPARTMENT ENGINEERING DEVELOPMENT GROUP	
TITLE: ALBUQUERQUE FIRE DEPT. STATION # 20 TYPICAL SECTIONS	
Design Review Committee APPROVED OCT 22 1999	City Engineer Approved OCT 22 1999
DESIGN REVIEW COMMITTEE	
CITY ENGINEER	
LAST DESIGN UPDATE	Mo./Day/Yr.
Project Phase	OFFSITE
City Project No.	6042.91
Zone Map No.	C-19
Sheet	5 Of 13

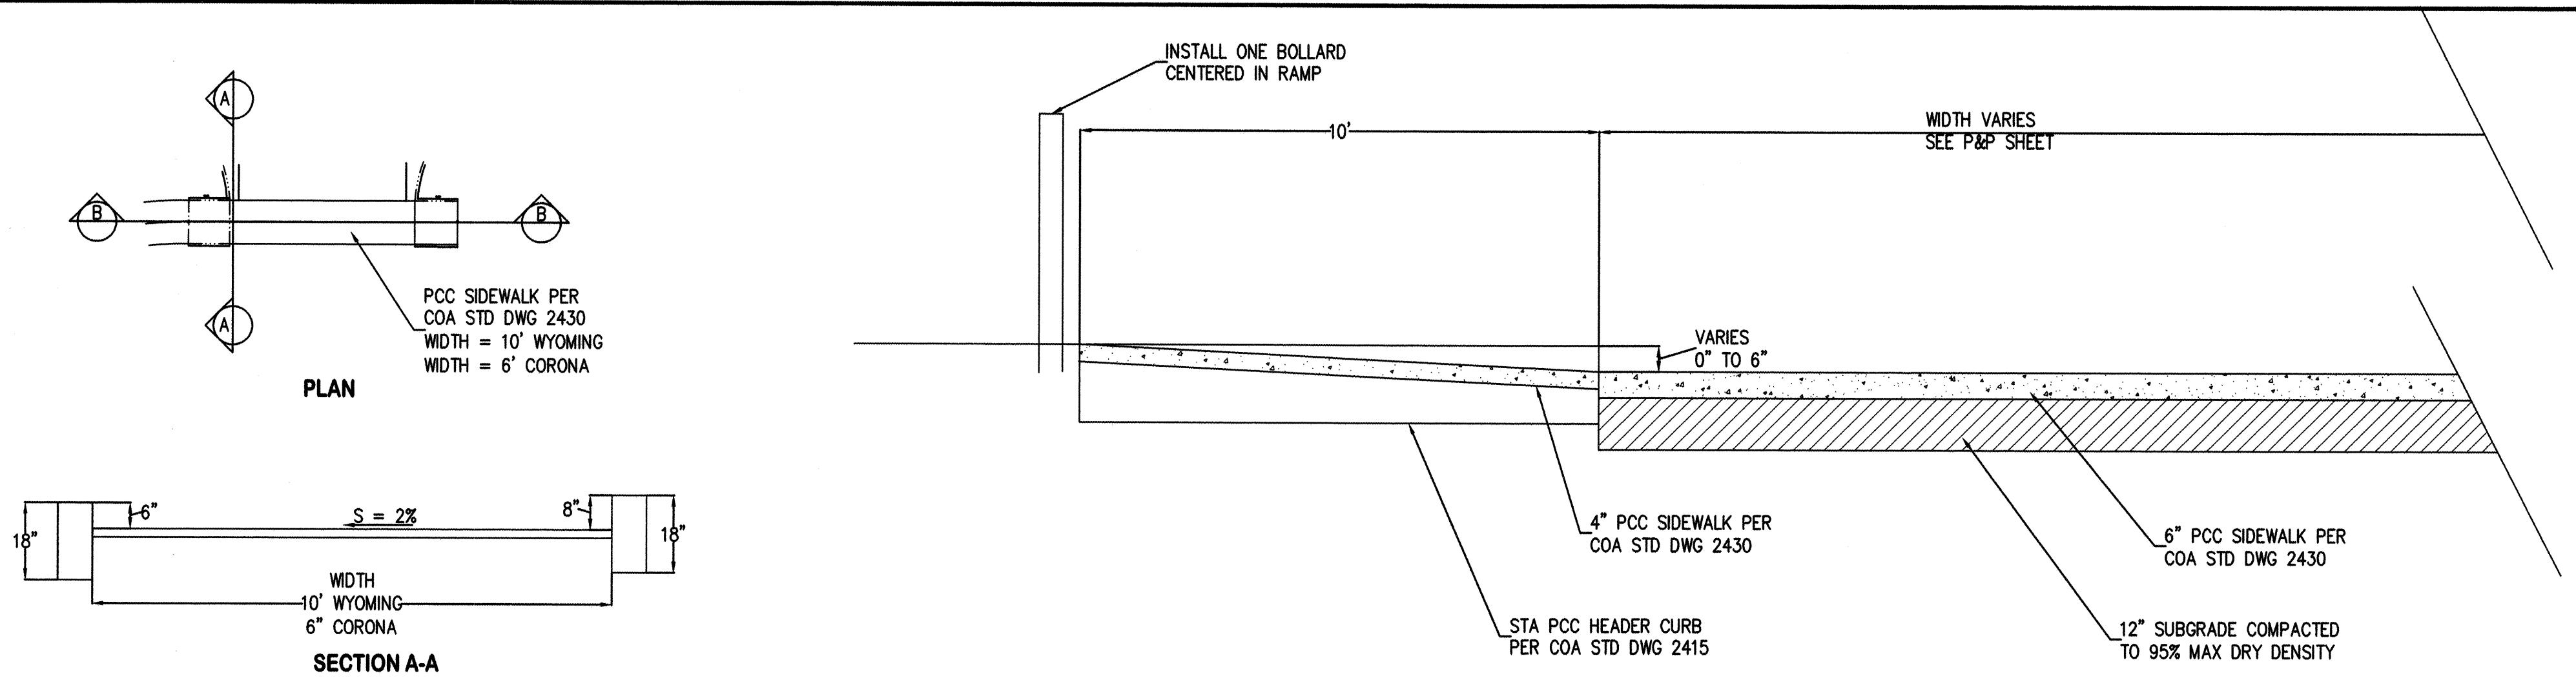

NOTE: REFERENCE COA STD DWG 2425 FOR ADDITIONAL DETAIL


UNIDIRECTIONAL WHEELCHAIR RAMP DETAILS

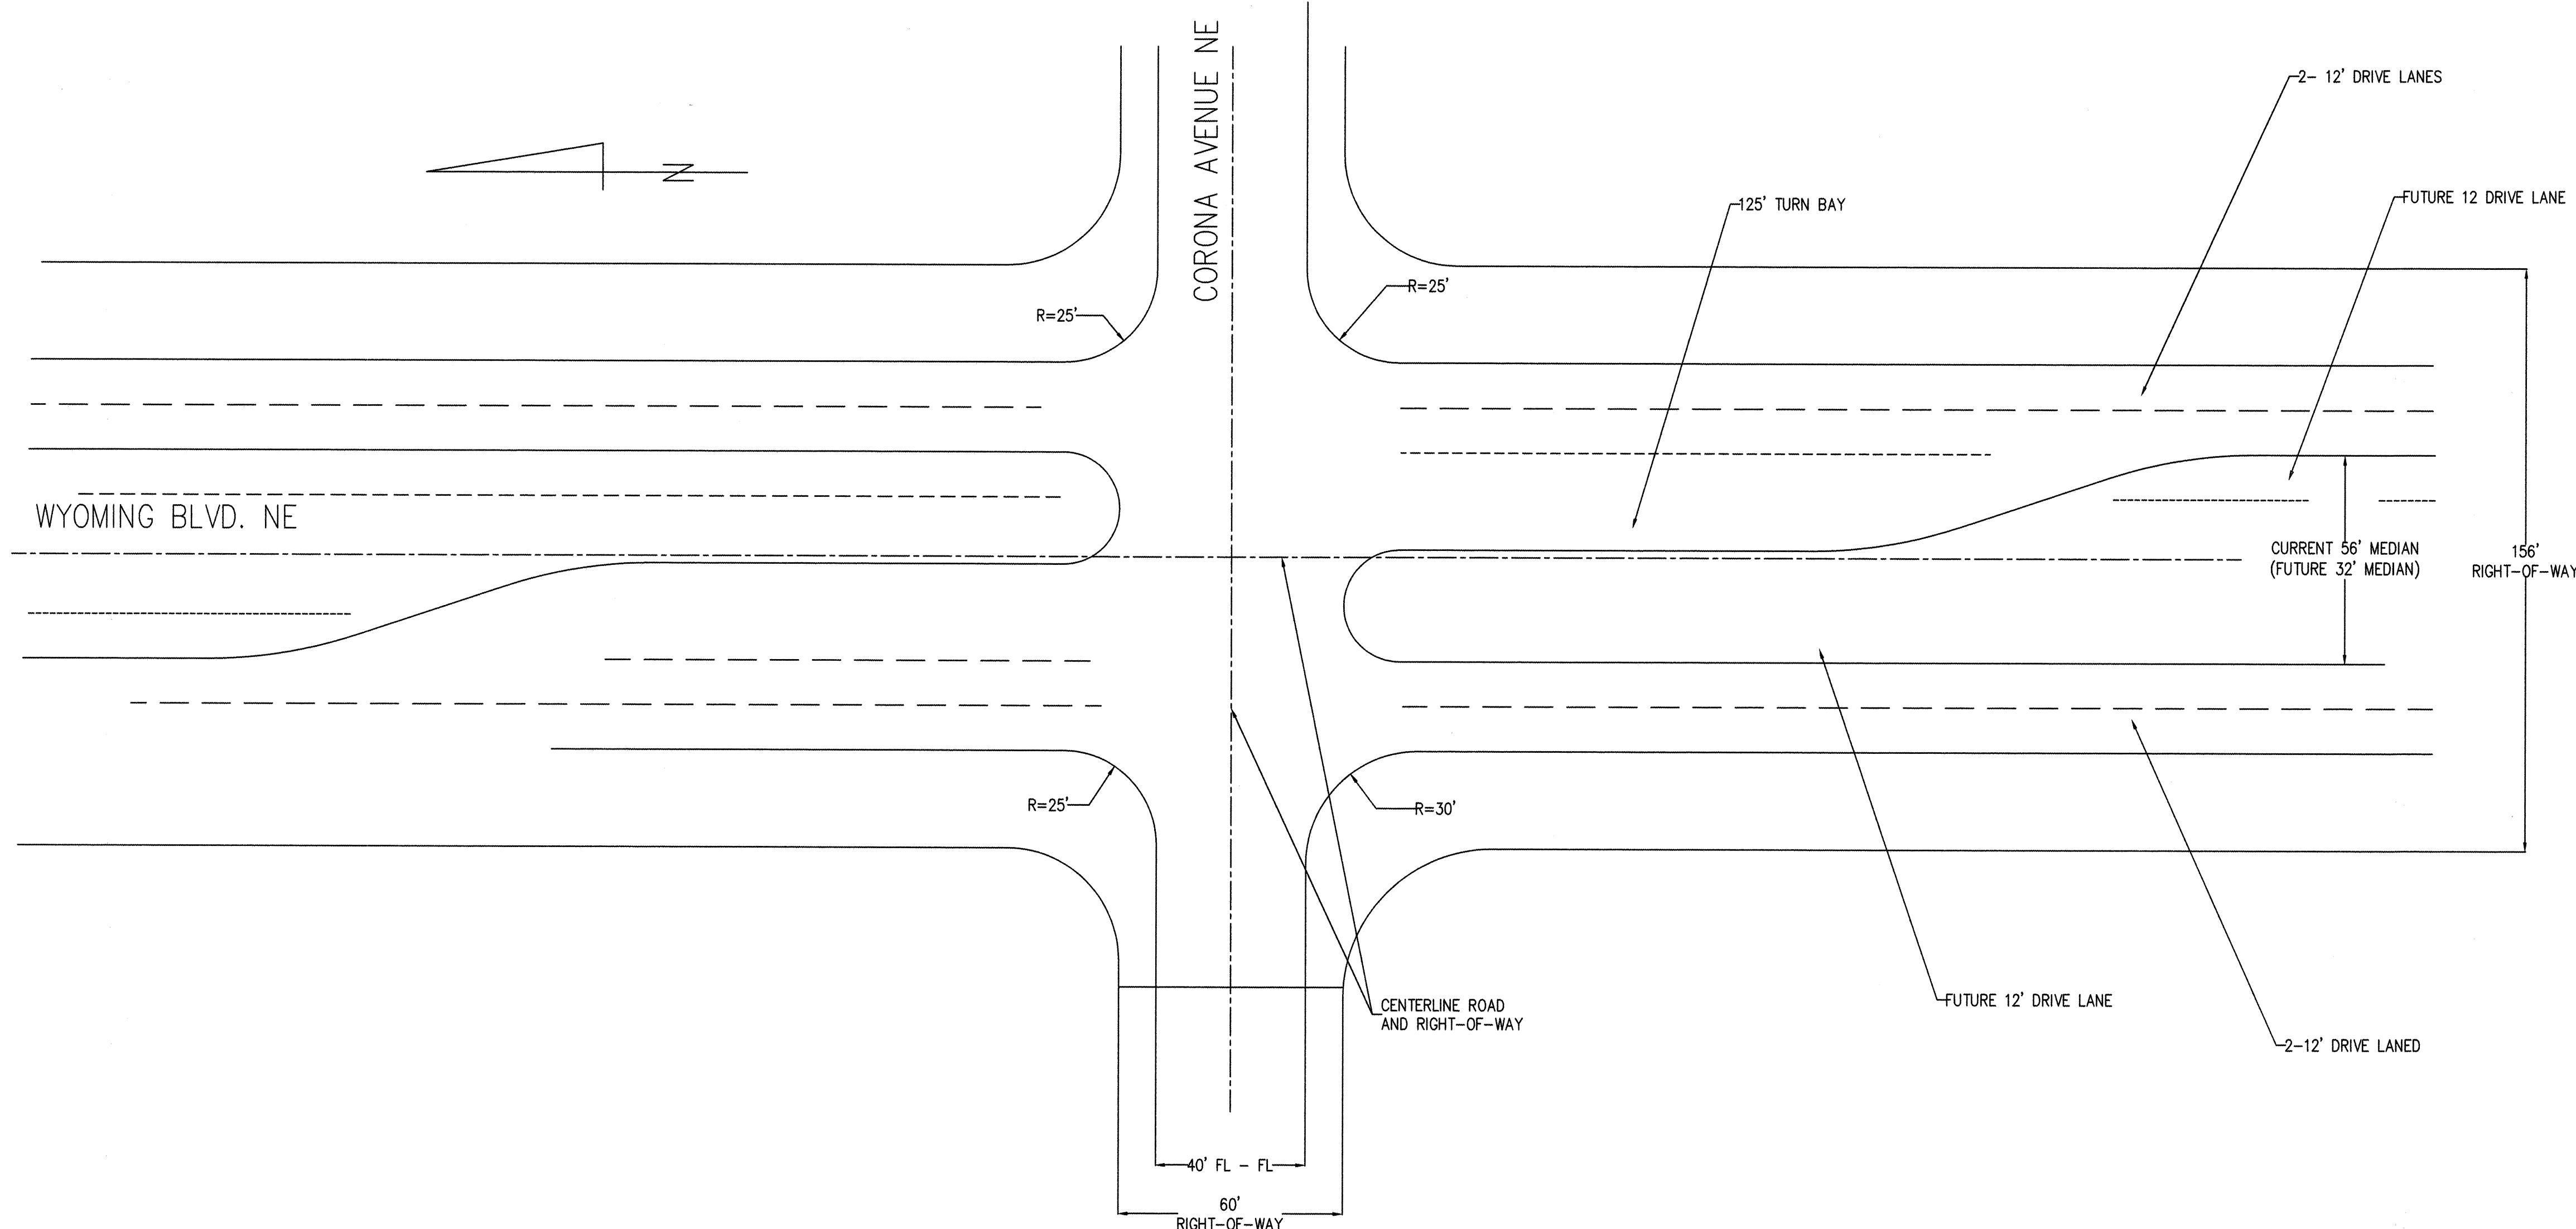

ULTIMATE INTERSECTION CONFIGURATION DETAIL WYOMING/CORONA AVENUE

ENGINEER'S SEAL		SURVEY INFORMATION		BENCH MARKS		AS BUILT INFORMATION	
		FIELD NOTES				CONTRACTOR	
NO.	BY	DATE	City of Albuquerque bench Mark "HEAVEN", a standard USGS brass tablet stamped "HEAVEN 1969", set in top of a concrete post flush with the ground. Located at the entrance to the "GATE OF HEAVEN" CEMETERY 0.15 miles west of the intersection of Paseo del Norte N.E. and Wyoming Blvd. N.E. Station is on the south side of Paseo del Norte N.E.	WORK STAKED BY INSPECTORS ACCEPTANCE BY FIELD VERIFICATION BY DRAWINGS CORRECTED BY	DATE	DATE	
NO.	DATE	REMARKS	BY	REVISIONS	DESIGN	MICRO-FILM INFORMATION	
				RECORDED BY	DATE	DATE	
				DRAWN BY	DATE	DATE	
				CHECKED BY	DATE	DATE	

FOR INFORMATION ONLY

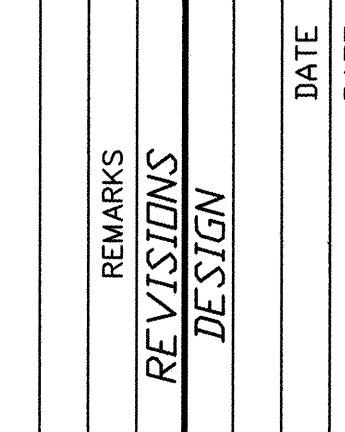


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Civil Engineers
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Albuquerque, New Mexico 87112
(505) 237-8421



CITY OF ALBUQUERQUE
PUBLIC WORKS DEPARTMENT
ENGINEERING DEVELOPMENT GROUP

TITLE: ALBUQUERQUE FIRE DEPT. STATION # 20
TYPICAL SECTIONS

Design Review Committee	City Engineer Approval	LAST DESIGN UPDATE	Mo./Day/Yr.	Mo./Day/Yr.
APPROVED OCT 22 1999 DESIGN REVIEW COMMITTEE	APPROVED OCT 22 1999 CITY ENGINEER			

City Project No. 6042.91 Zone Map No. C-19 Sheet 5a of 13

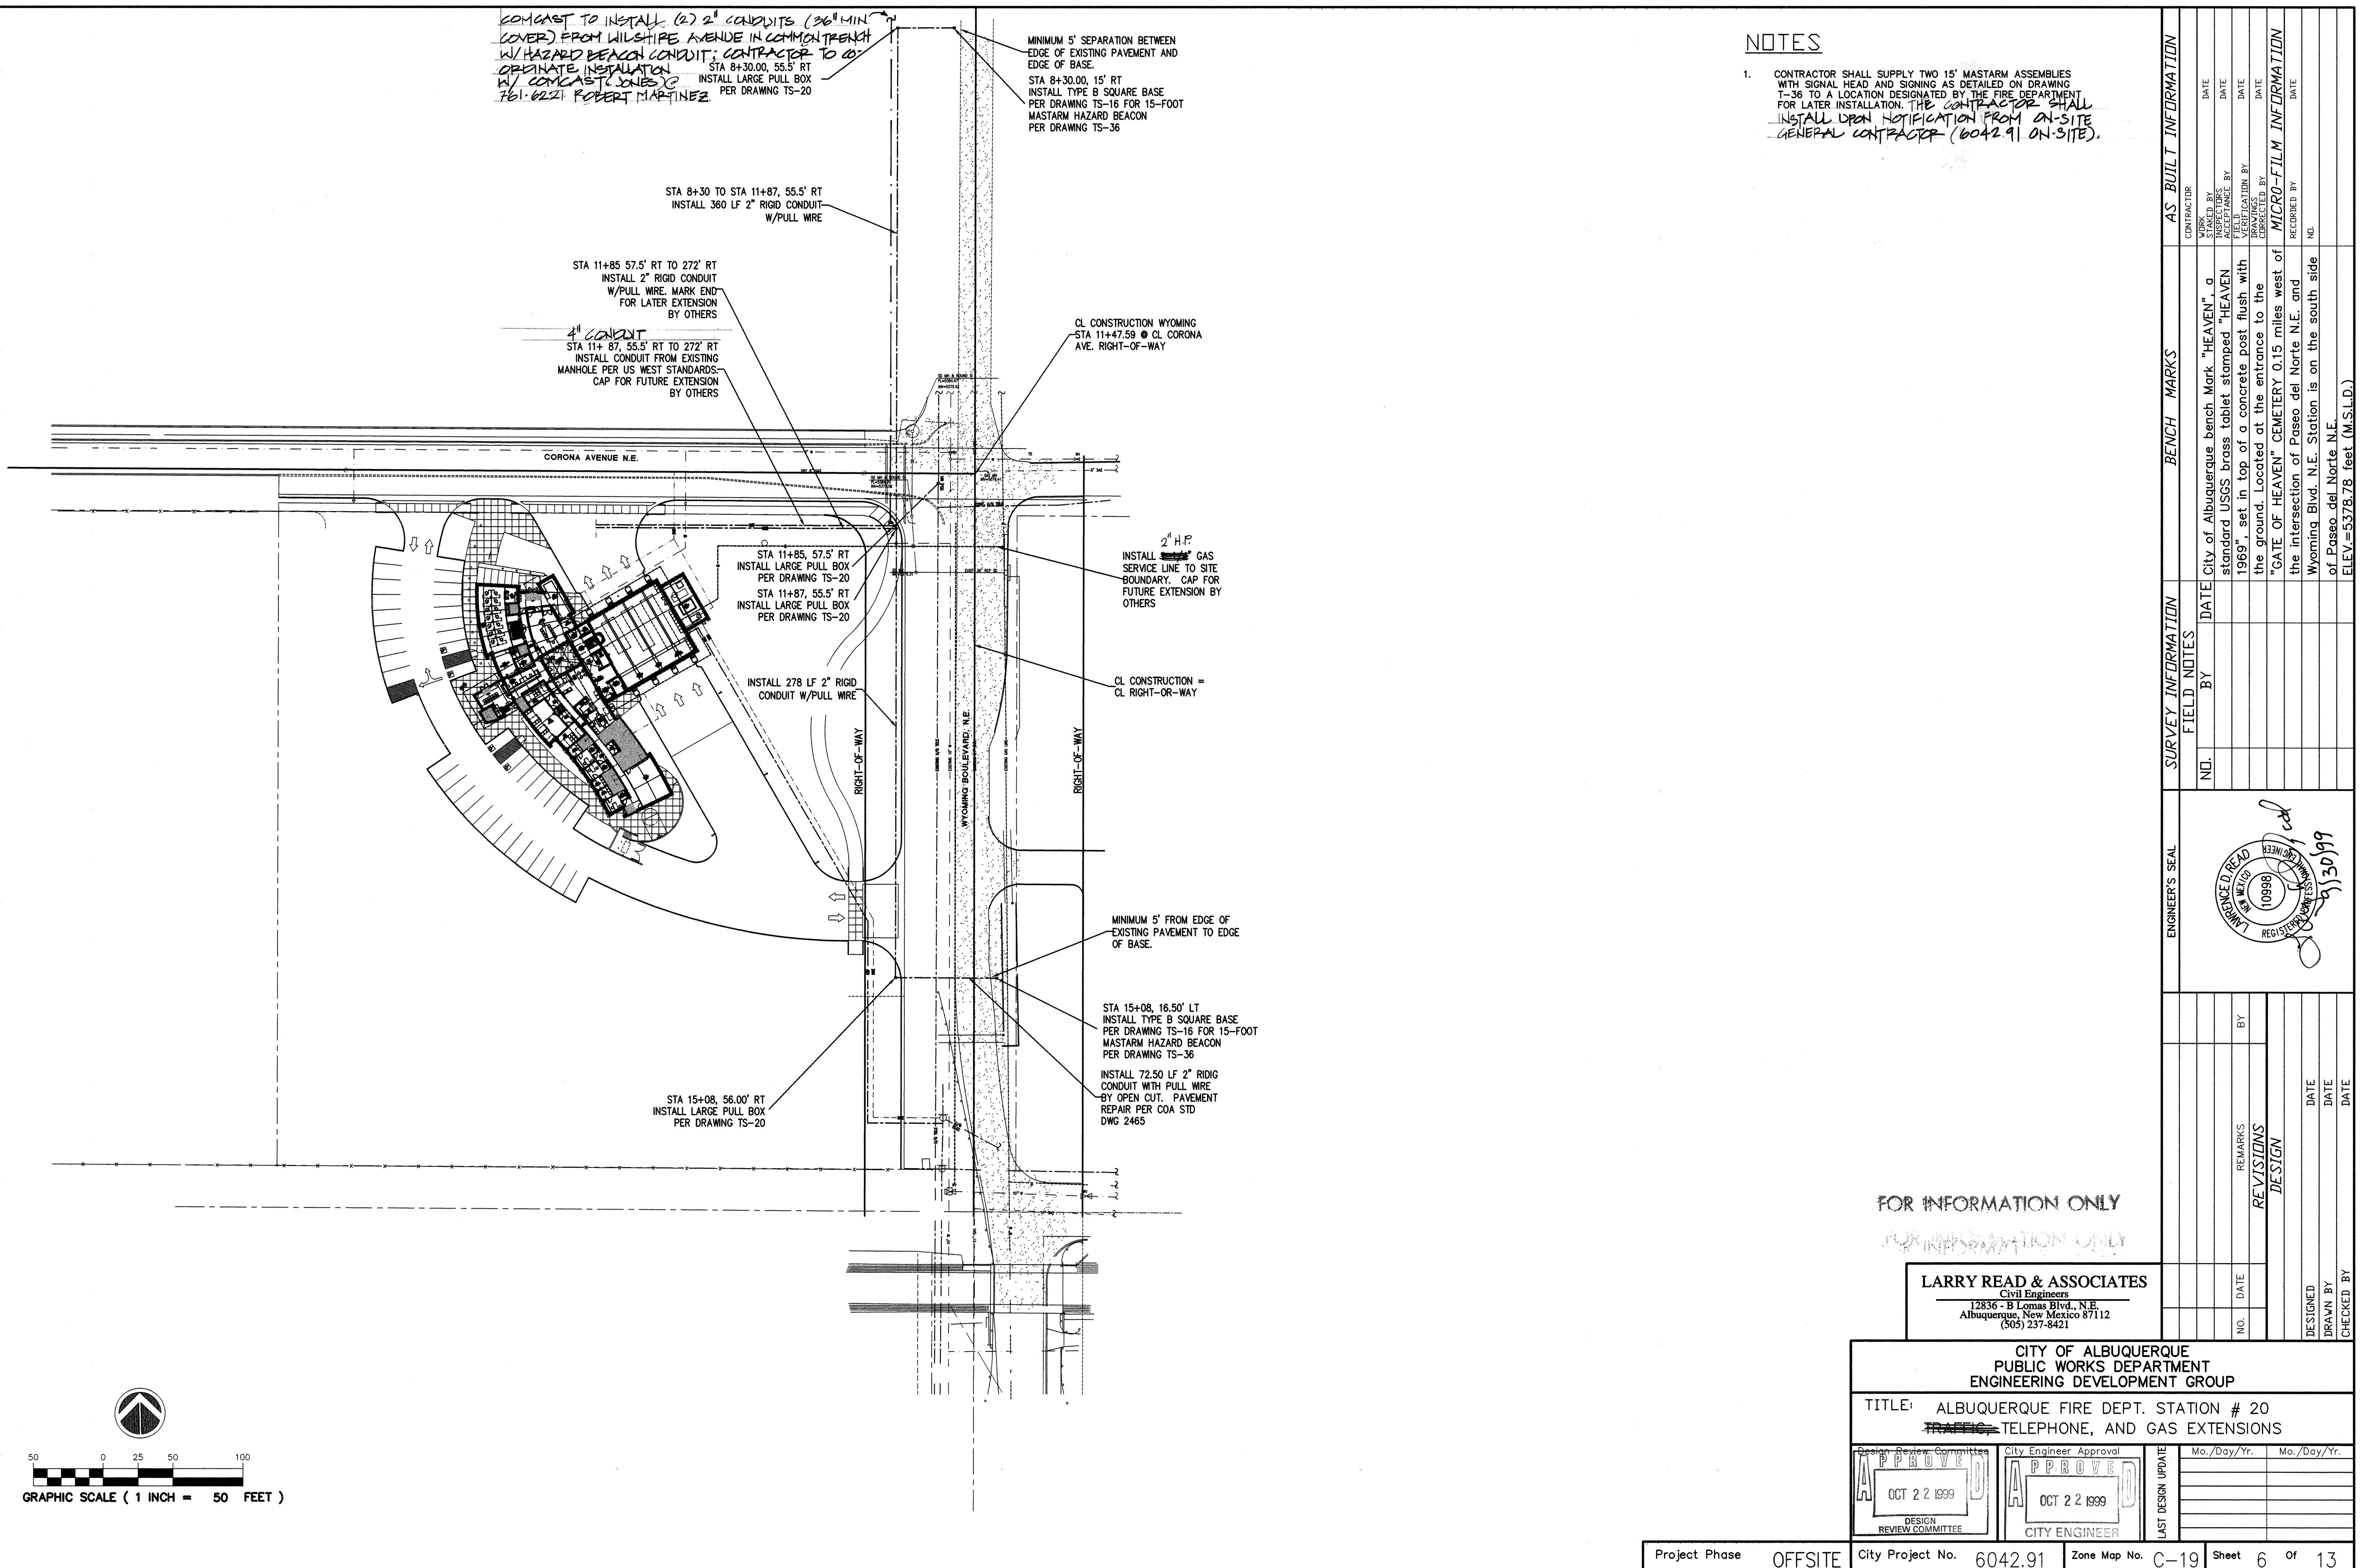

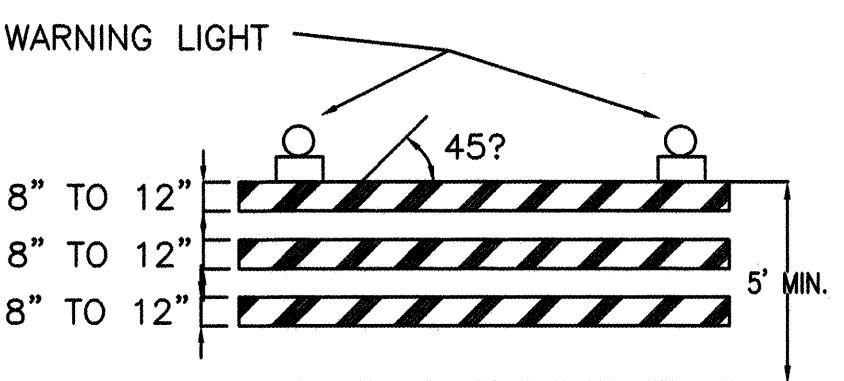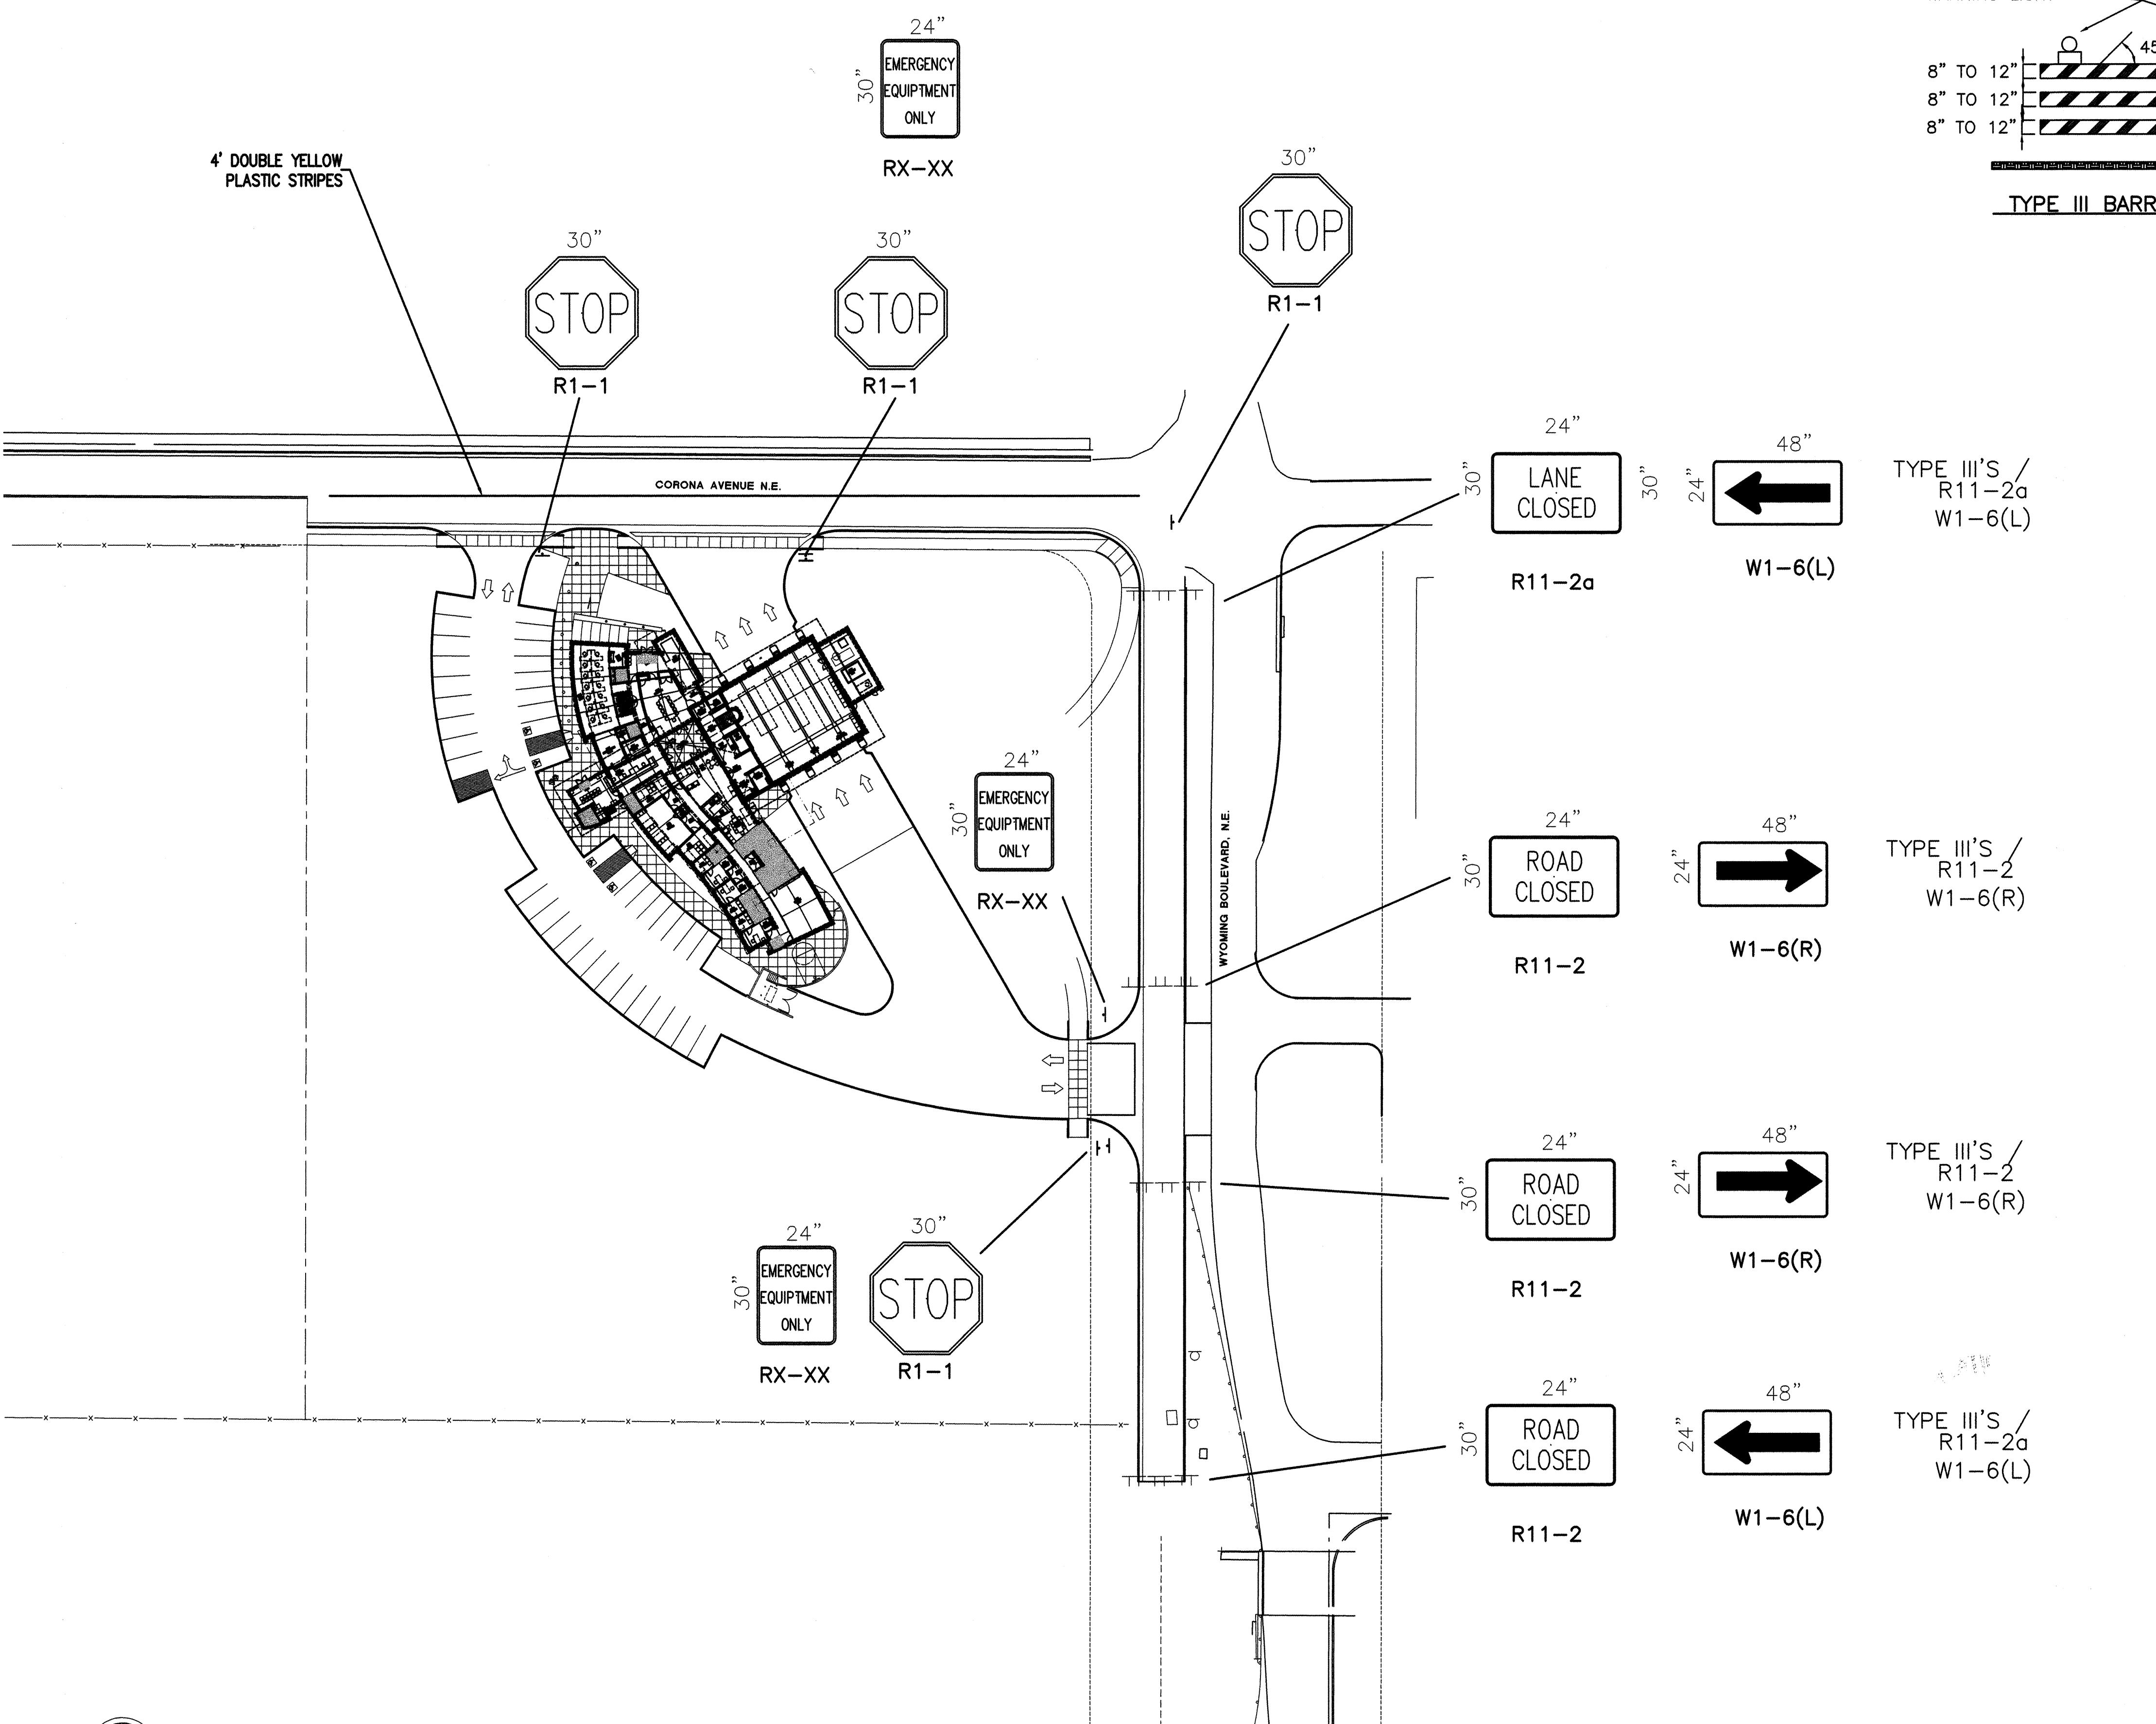

TYPE III BARRICADE

ENGINEER'S SEAL		SURVEY INFORMATION		BENCH MARKS		AS BUILT INFORMATION	
		FIELD NOTES					
NO.	BY	DATE		CITY OF ALBUQUERQUE, BENCH MARK "HEAVEN", A		CONTRACTOR	
		STAKE BY		STAKED BY		DATE	
		1999		1999		1999	
		REMARKS		AS PER ANCE BY		AS PER ANCE BY	
		EY		FIELD		FIELD	
		REVISIONS		VERIFIED BY		VERIFIED BY	
		DESIGN		DRAWN BY		DRAWN BY	
		DATE		DATE		DATE	
		DATE		DATE		DATE	
		DATE		DATE		DATE	
<i>(Circular stamp: LARRY READ & ASSOCIATES, INC., 10996, REGISTERED TRADES, NEW MEXICO, 9/30/99)</i>							

CITY OF ALBUQUERQUE PUBLIC WORKS DEPARTMENT ENGINEERING DEVELOPMENT GROUP		LAST DESIGN UPDATE	
Design Review Committee	City Engineer Approval	Mo./Day/Yr.	Mo./Day/Yr.
APPROVED OCT 22 1999 DESIGN REVIEW COMMITTEE	APPROVED OCT 22 1999 CITY ENGINEER		


FOR INFORMATION ONLY
FOR INFORMATION ONLY


LARRY READ & ASSOCIATES
Civil Engineers
12836 - B Lomas Blvd., N.E.
Albuquerque, New Mexico 87112
(505) 237-8421

**CITY OF ALBUQUERQUE
PUBLIC WORKS DEPARTMENT
ENGINEERING DEVELOPMENT GROUP**

**TITLE: ALBUQUERQUE FIRE DEPT. STATION # 20
PERMANENT TRAFFIC CONTROL PLAN**

Project Phase	OFFSITE	City Project No.	6042.91	Zone Map No.	C-19	Sheet 7	of 13
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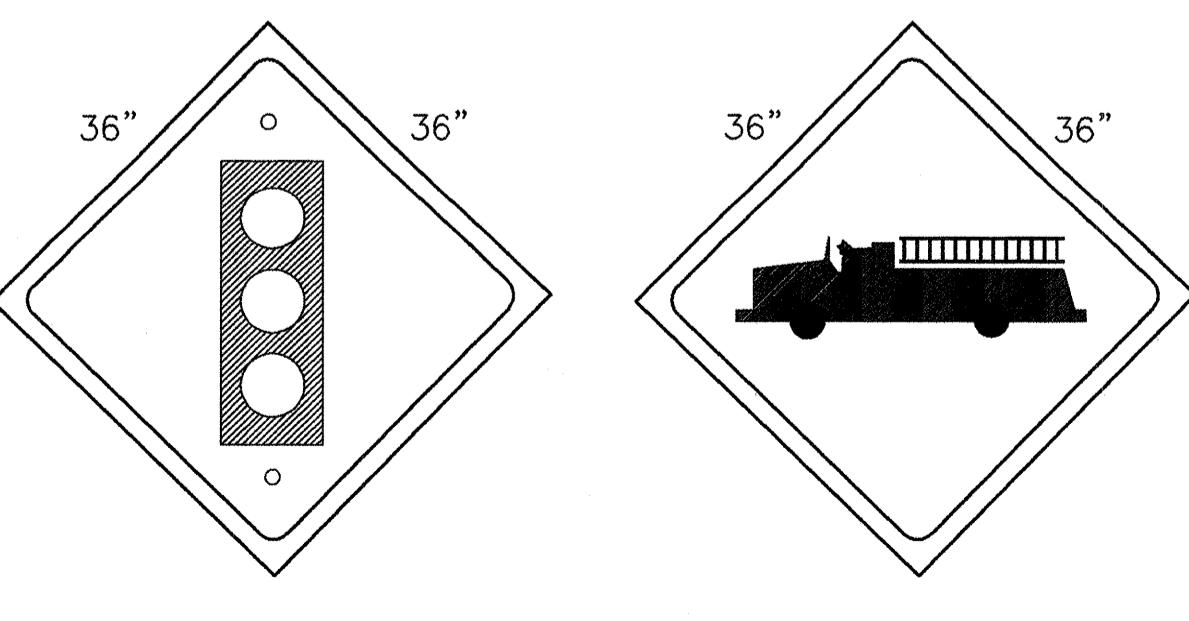
RIGID ELECTRICAL CONDUIT AS SHOWN ON PLANS
SEE PEDESTAL FOUNDATION DETAIL
SEE SHEET TS-16

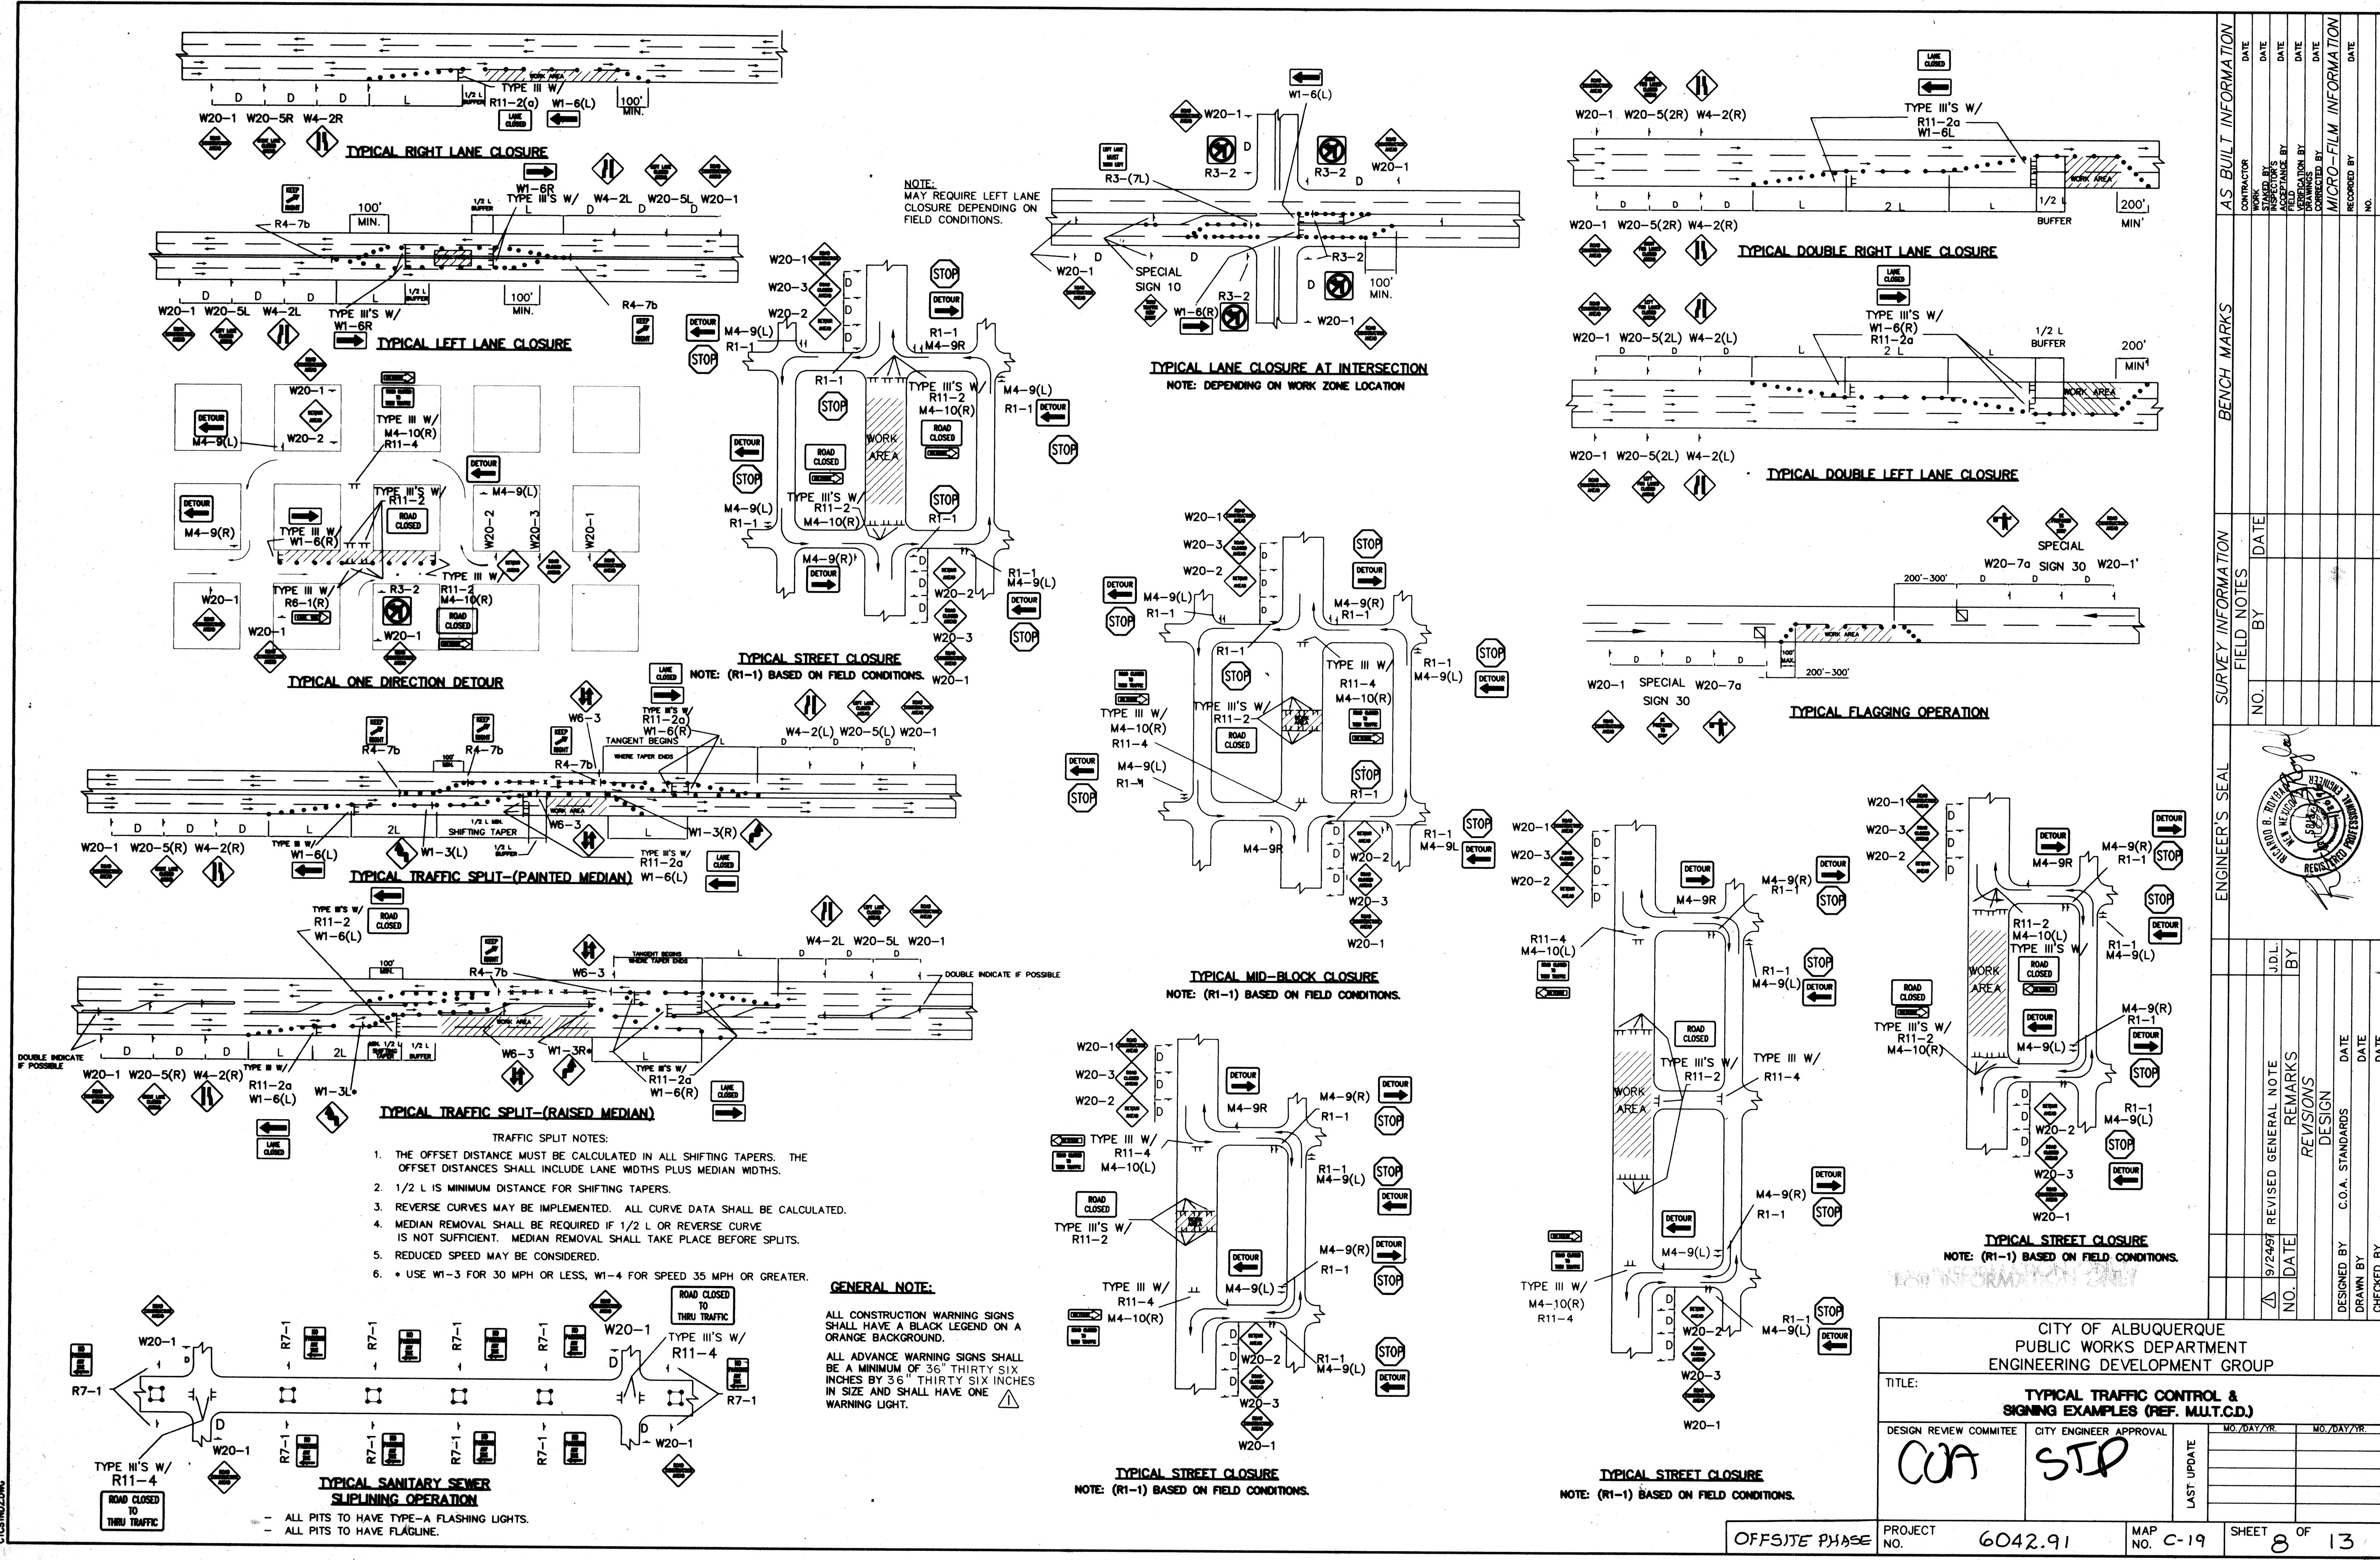HAZARD IDENTIFICATION BEACON DETAIL

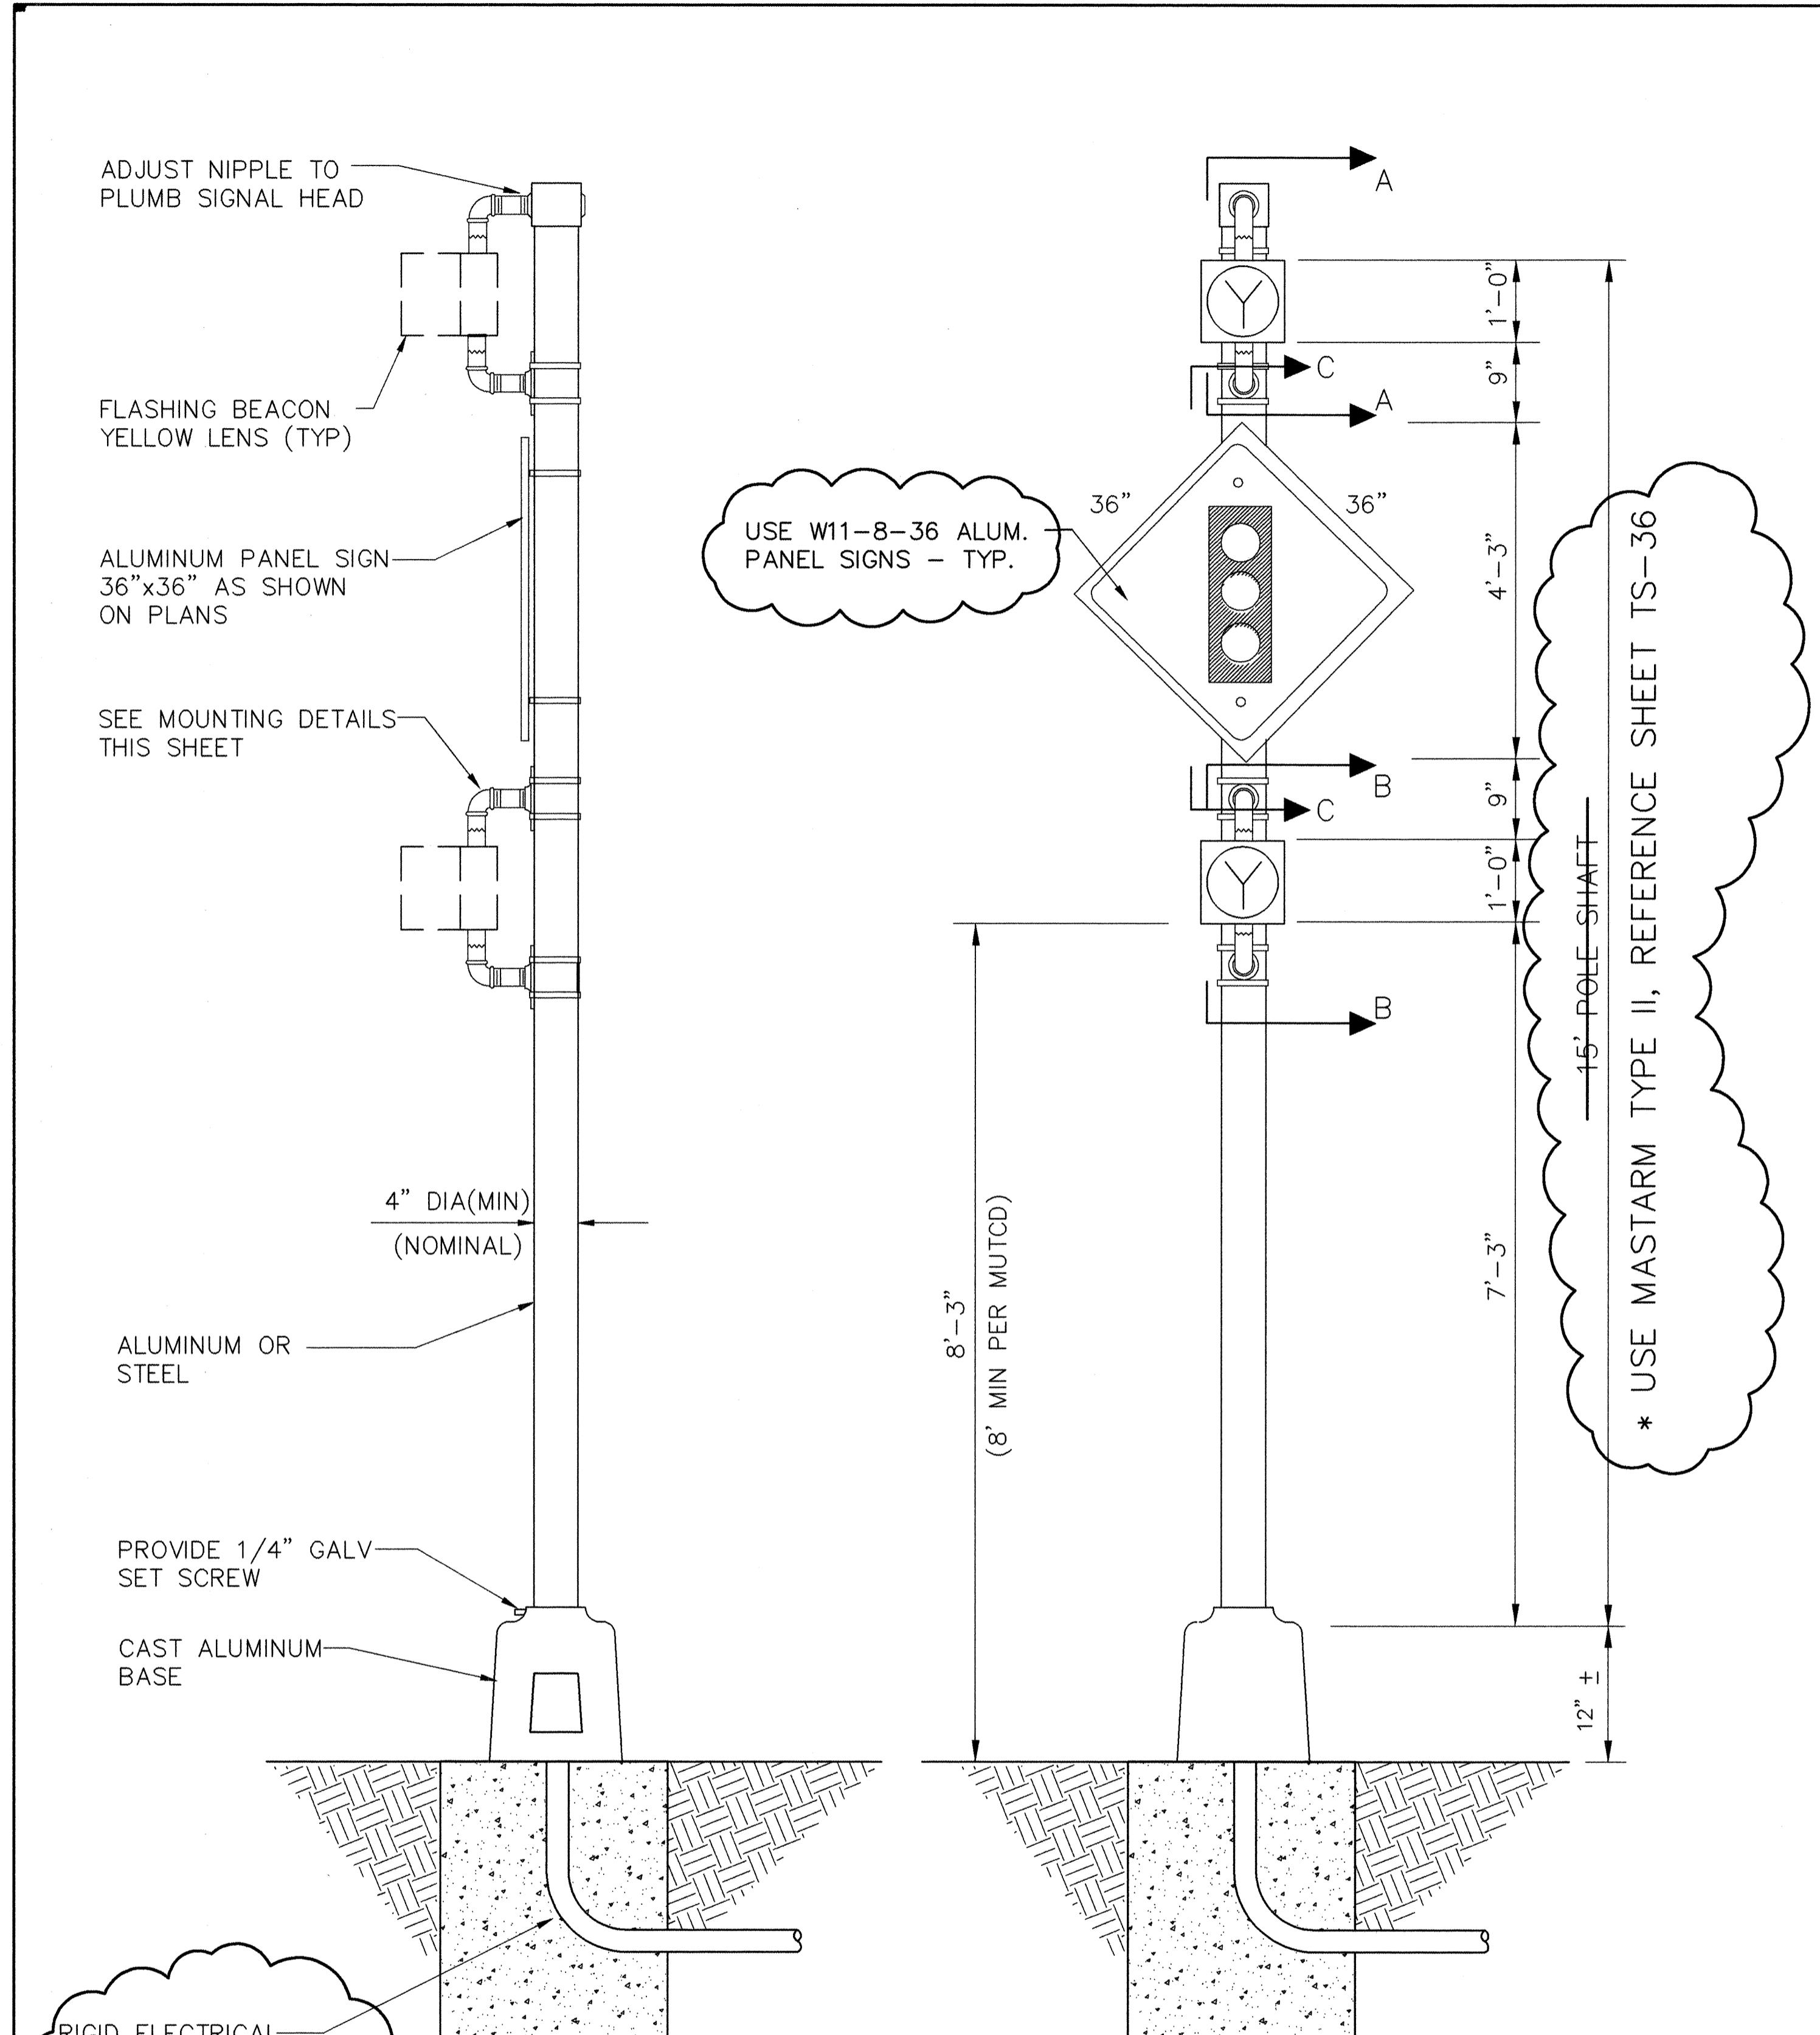
* USE MASTARM TYPE II, REFERENCE SHEET TS-36

NOTES


1. EACH HAZARD IDENTIFICATION BEACON WILL BE MEASURED AND PAID FOR UNDER THE FOLLOWING ITEMS:
 - ITEM ~~0422.004~~ – TRAFFIC SIGNAL PEDESTAL ~~POLE 15'~~
(1 EACH BEACON) REFERENCE SHEET TS-36
 - ITEM ~~0423.001~~ – TRAFFIC SIGNAL FOUNDATION FOR PEDESTAL
~~POLE~~ (1 EACH BEACON) REFERENCE SHEET TS-16
 - ITEM 0427.001 – 1 SECTION TRAFFIC SIGNAL ASSEMBLY
~~(2 EACH BEACON)~~ (4 EACH BEACON)
 - ITEM 0450.001 – ALUMINUM PANEL SIGNS ~~(1 EACH BEACON)~~
(2 EACH BEACON)



TYPICAL SIGN FACE DETAIL FOR HAZARD IDENTIFICATION BEACON

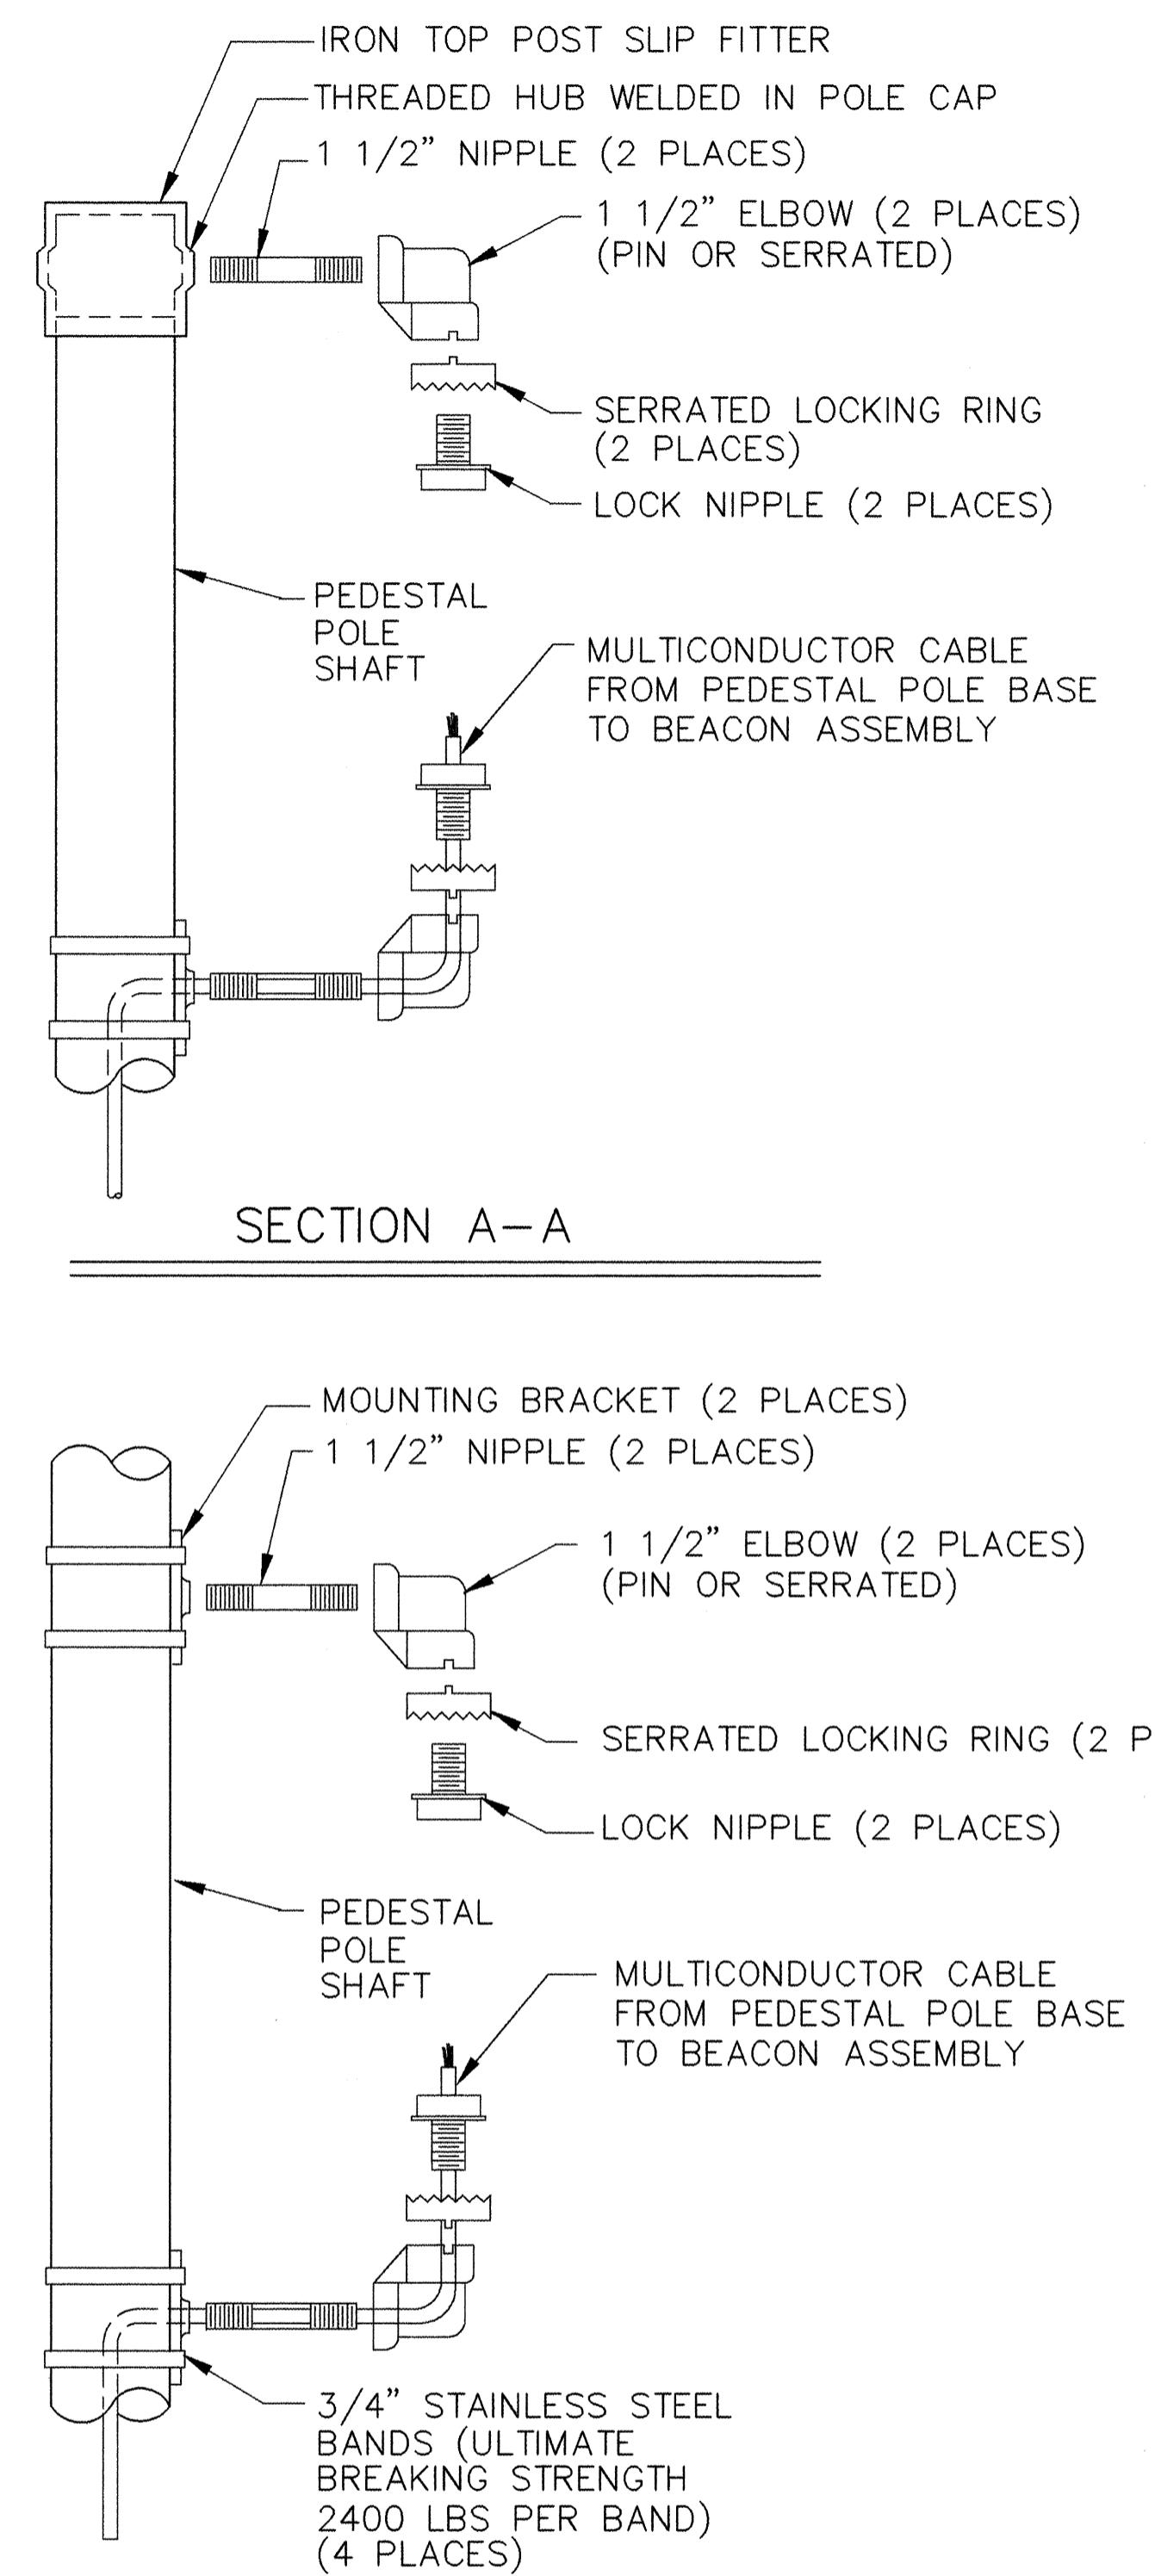

SECTION B-B

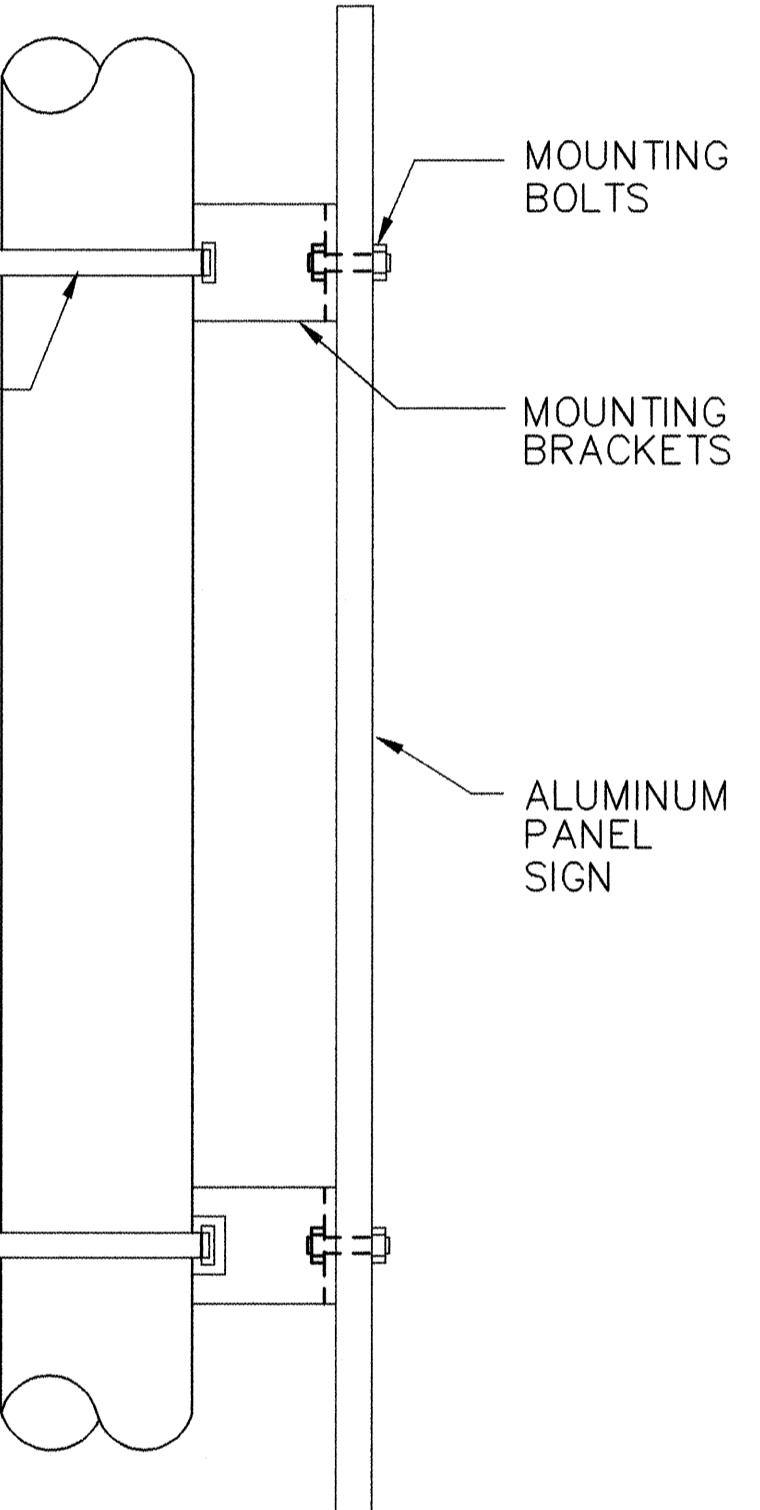



SIGN MOUNT DETAIL
SECTION C-C

FOR INFORMATION ONLY

COLOR


LEGEND: BLACK(NON-REFLECTIVE)
TOP PANEL: YELLOW
BOTTOM PANEL: WHITE
OUTSIDE BORDER: WHITE
INSIDE BORDER: BLACK

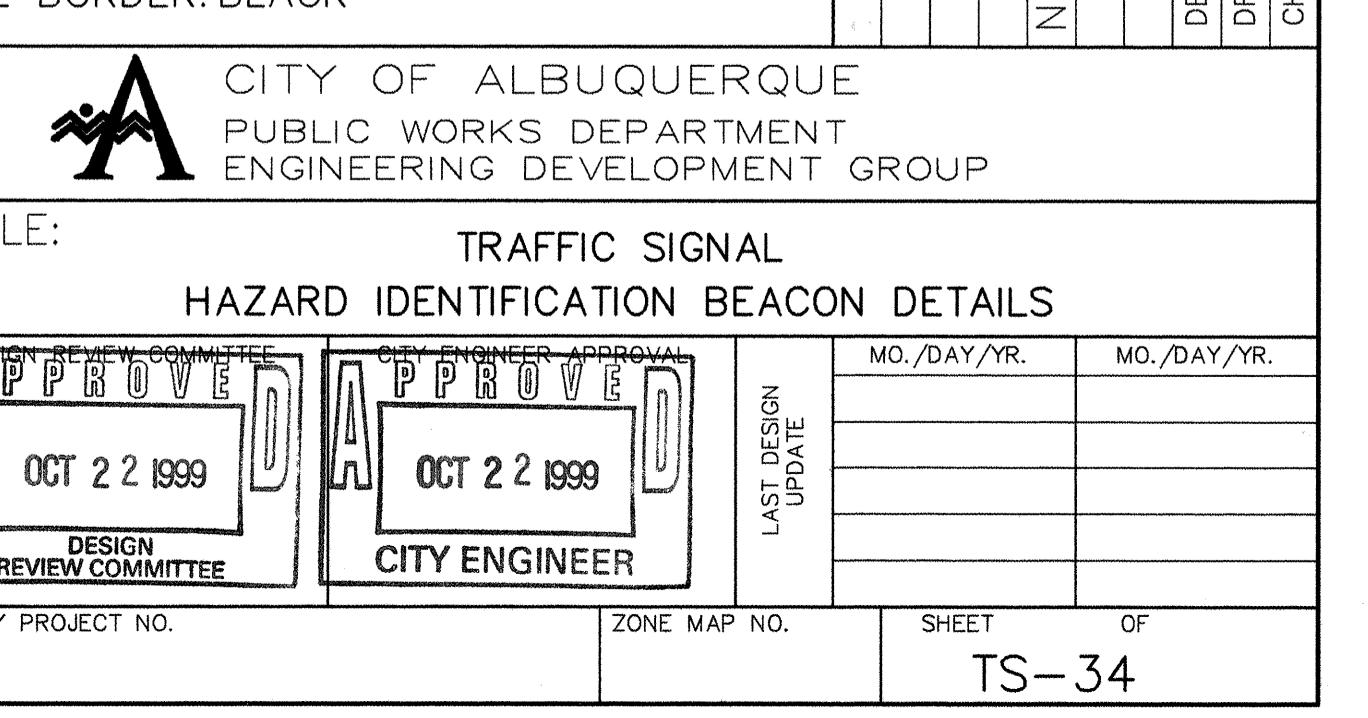

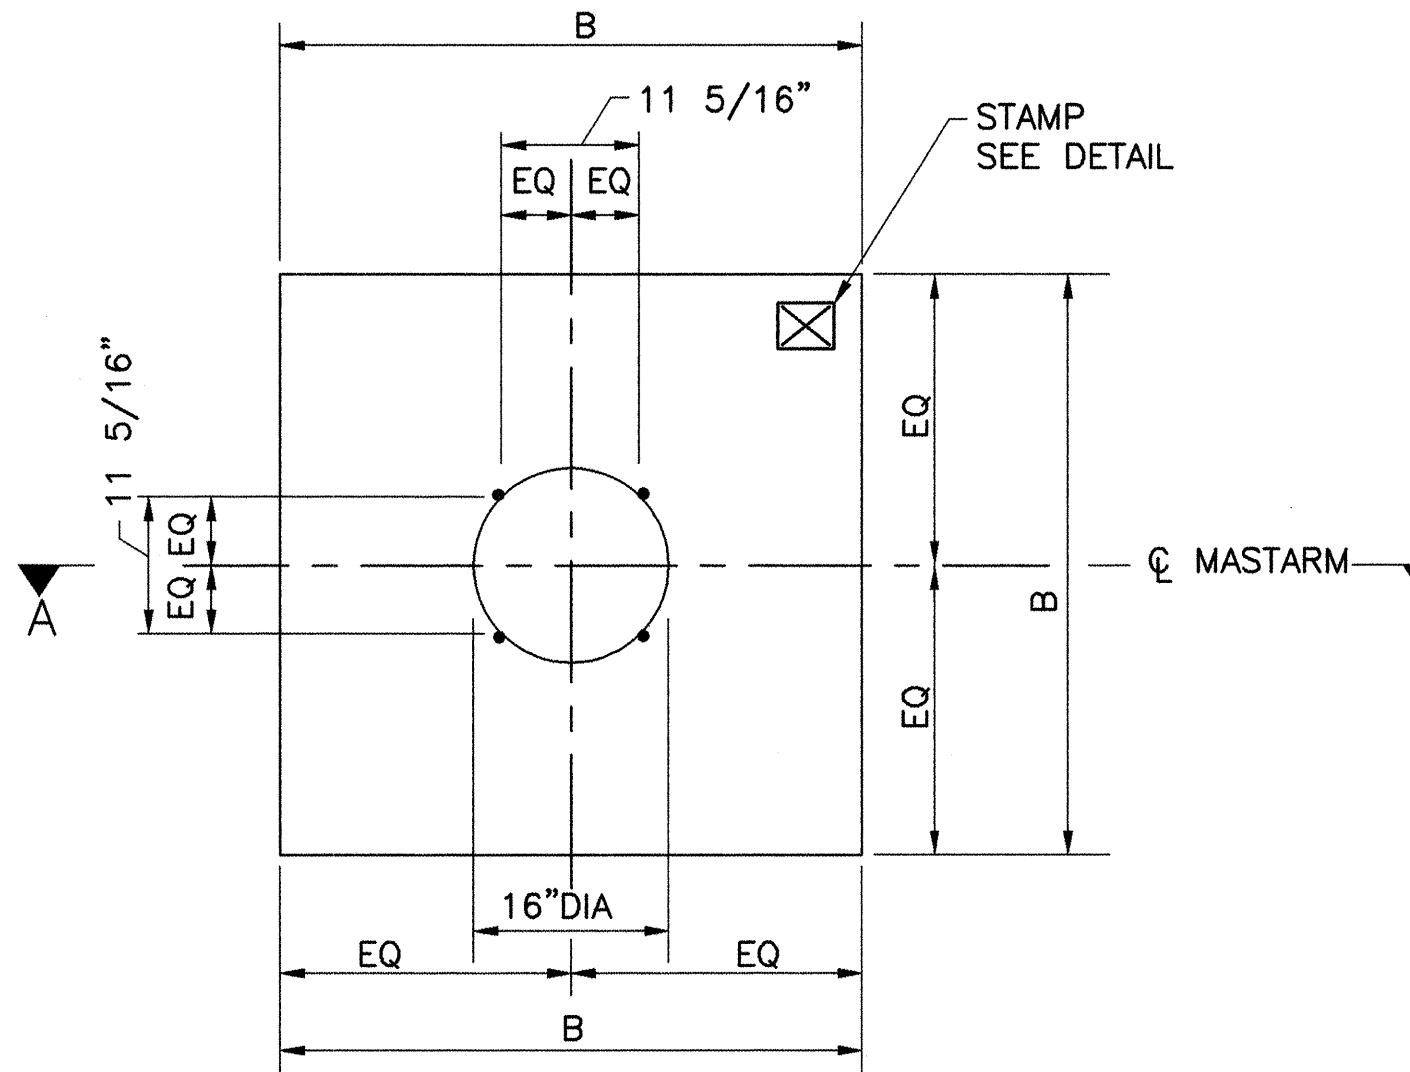

PLAN VIEW (SQUARE)

NO SCALE

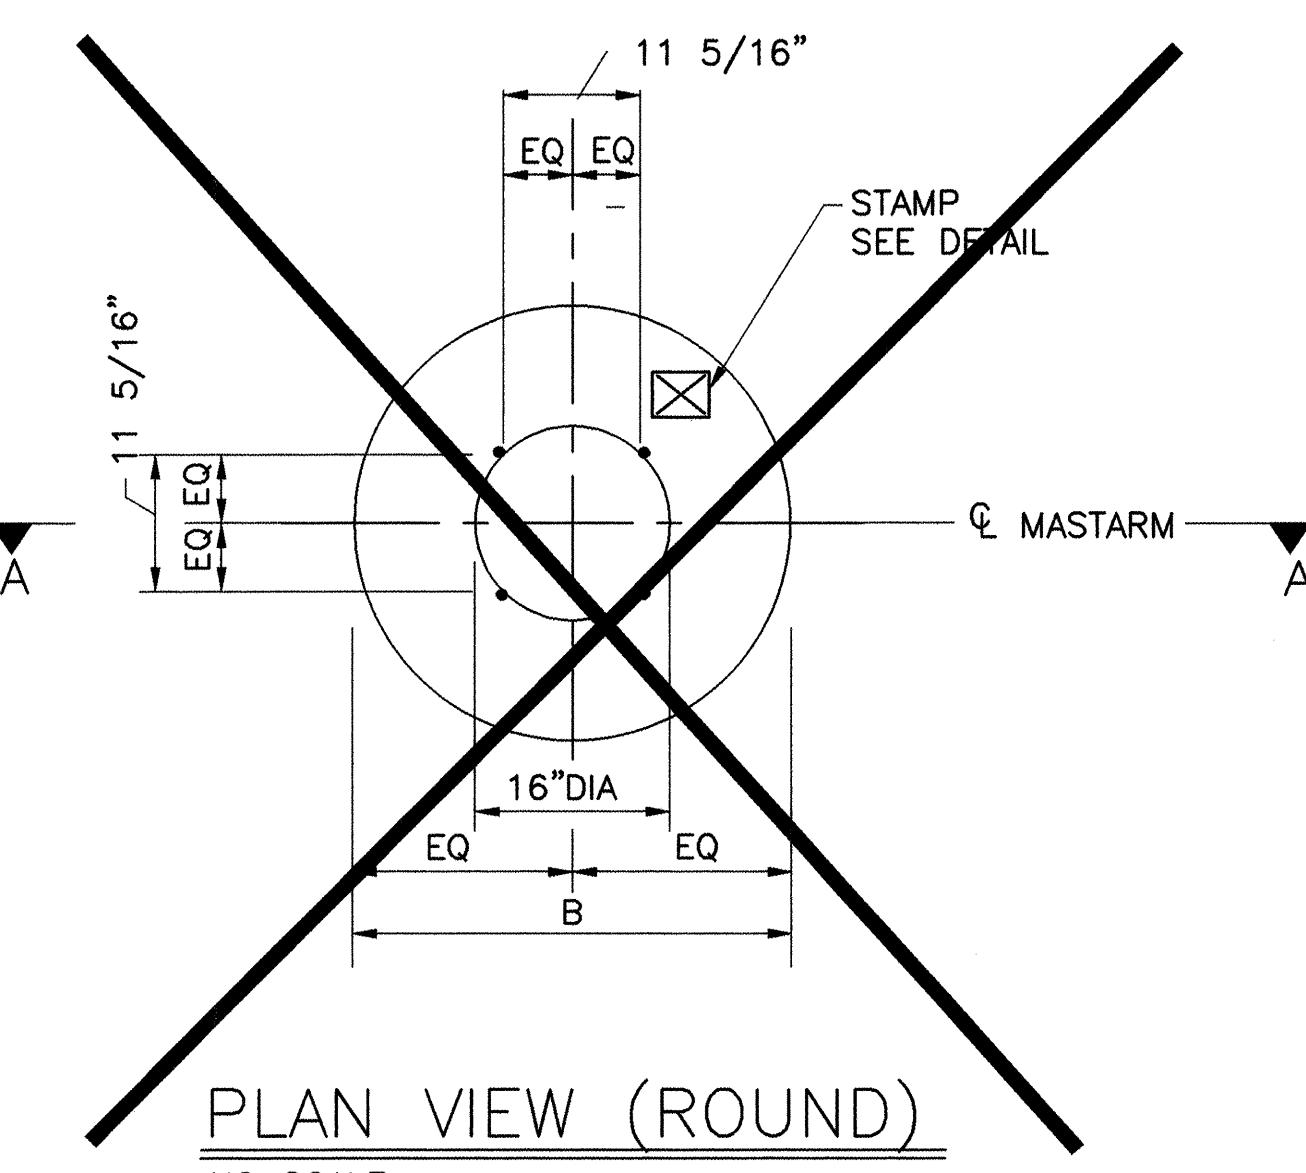


PLAN VIEW (ROUND)

NO SCALE

FOUNDATION DIMENSIONS AND QUANTITIES							
FOUNDATION TYPE	SIGNAL ARM SPAN(FT)	DIMENSION		REINFORCING		REBAR POUNDS	3500 PSI CONCRETE CUBIC YARDS
		B (WIDTH)	D (DEPTH)	V BARS MARK	H BARS MARK		
TYPE A (SQUARE)	15	3'-6"	5'-0"	#4V2	#3H2	49.1 •	2.27 "
	20	"	"	"	"	"	"
	25	"	"	"	"	"	"
TYPE B (SQUARE)	30	4'-0"	6'-3"	#5V1	#3H1	82.6	3.70 "
	35	"	"	"	"	"	"
	40	"	"	"	"	"	"
TYPE A (ROUND)	15	2'-6"	8'-6"	#6V4	#3H4	98.1	1.55 "
	20	"	"	"	"	"	"
	25	"	"	"	"	"	"
TYPE B (ROUND)	30	3'-0"	11'-9"	#7V3	#3H3	179.7	3.08 "
	35	"	"	"	"	"	"
	40	"	"	"	"	"	"


ROUND SHAPE TO BE USED ONLY WHERE SPECIFICALLY NOTED ON PLANS OR WHEN APPROVED BY THE PROJECT MANAGER.

AS-BUILT INFORMATION	
CONTRACTOR	DATE
STAMPED BY	DATE
INSPECTOR'S ACCEPTANCE BY	DATE
VERIFIED BY	DATE
DRAWINGS CORRECTED BY	DATE
MICRO-FILM INFORMATION	DATE
RECORDED BY	DATE
NO.	NO.

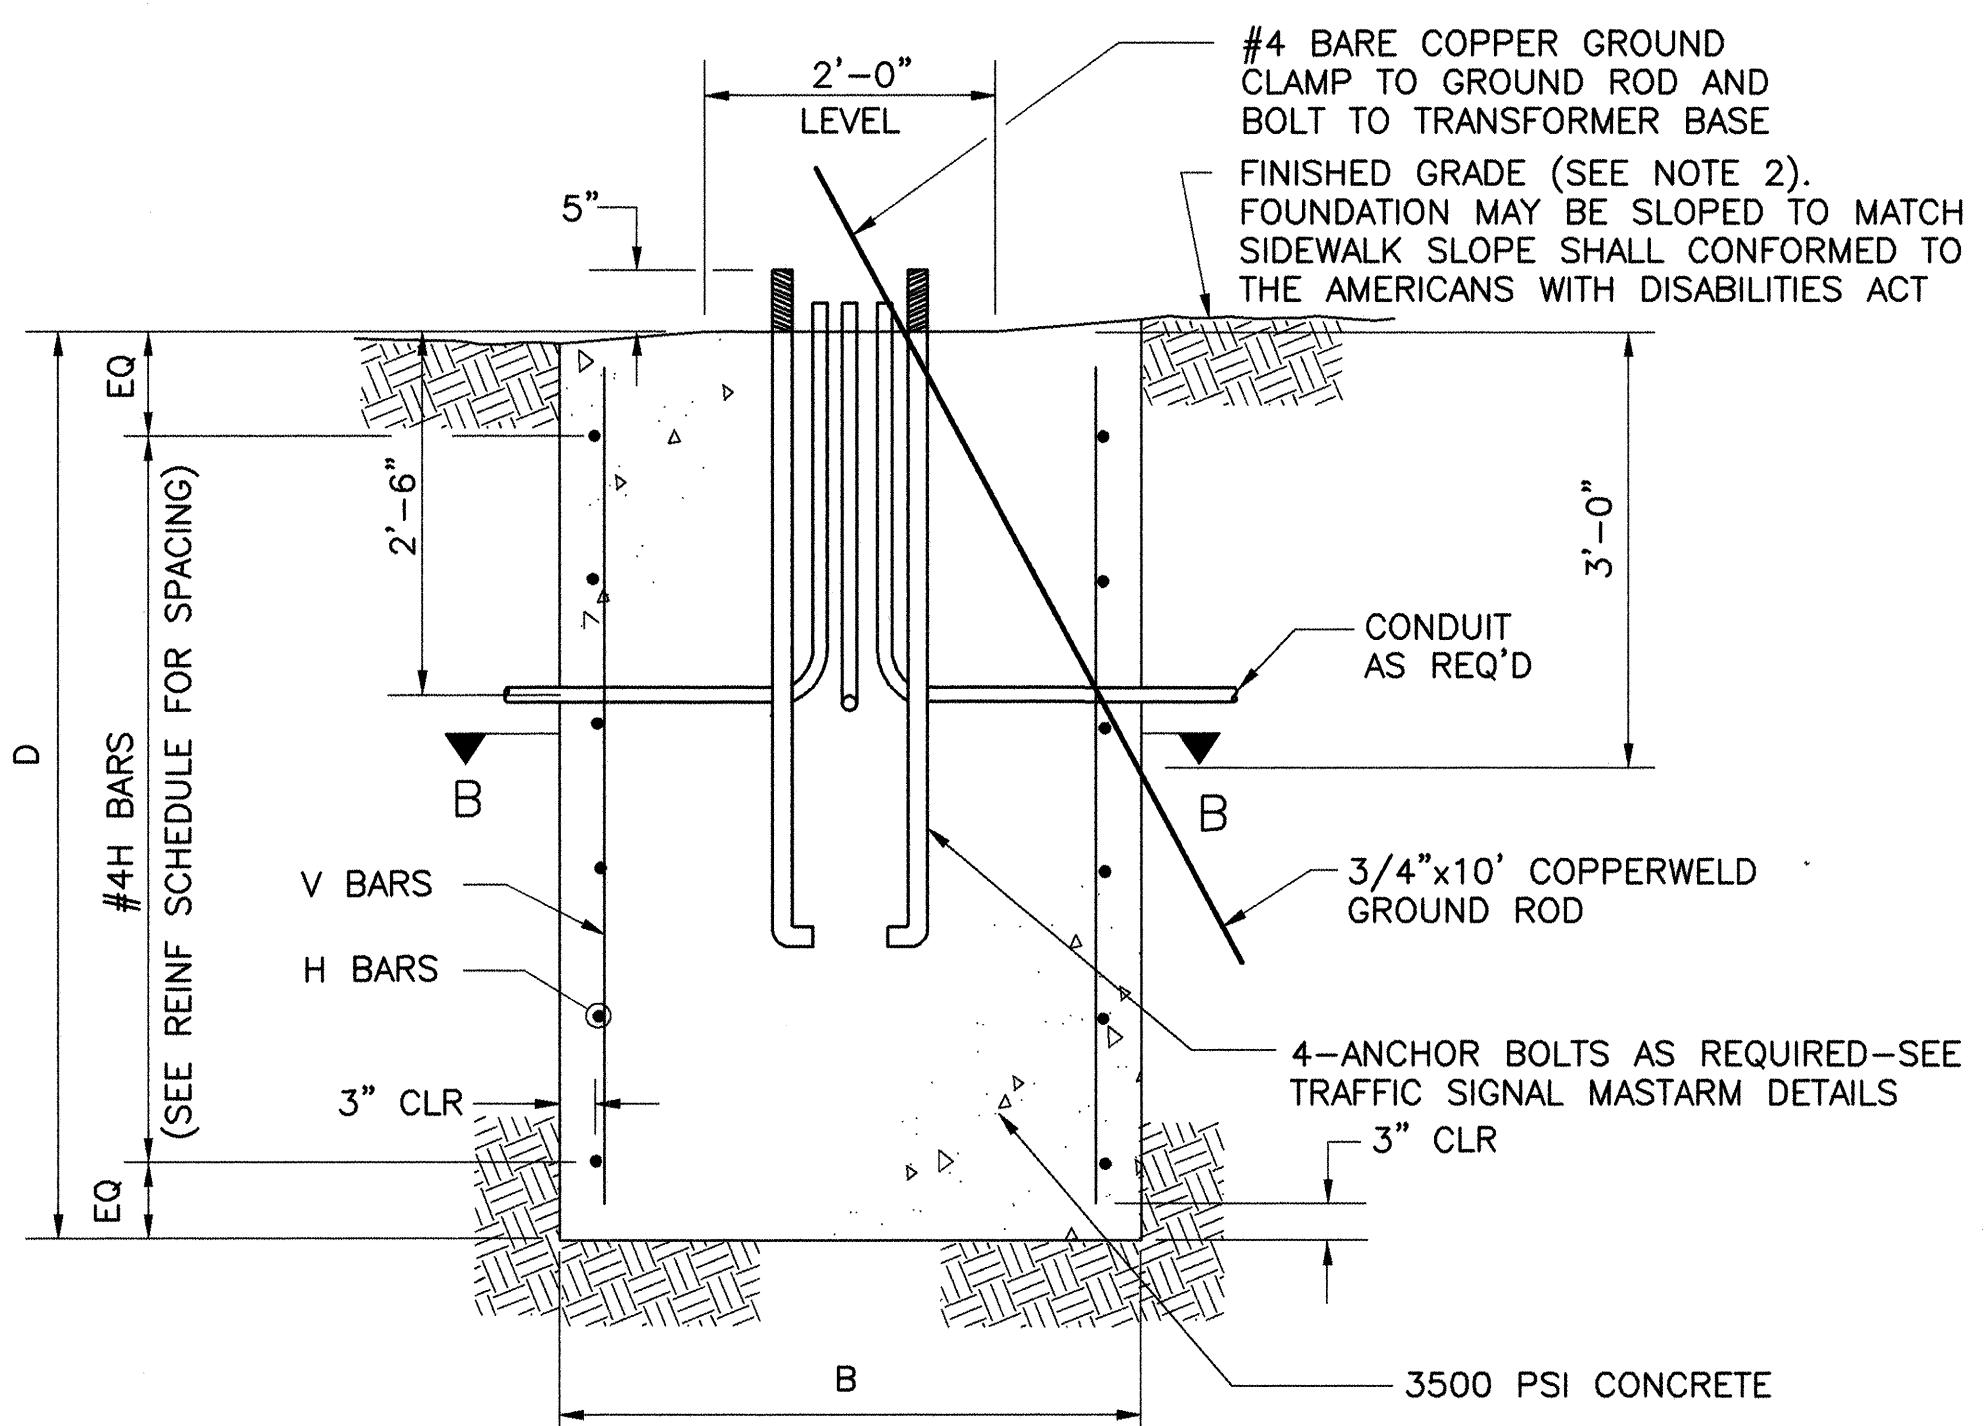


SECTION A-A (ROUND OR SQUARE)

NO SCALE

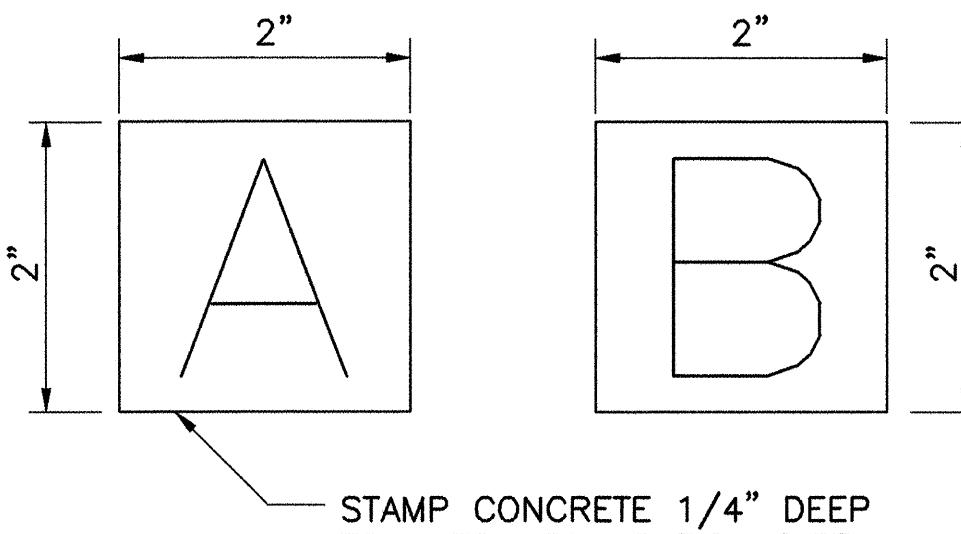


STAMP DETAIL

NO SCALE

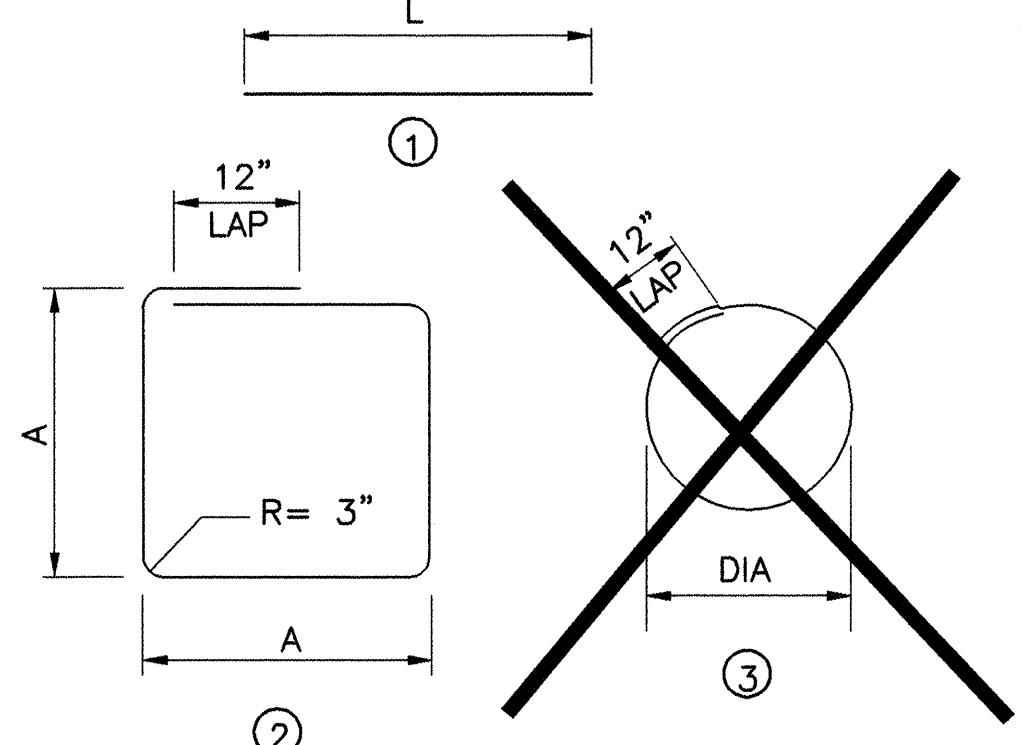


BAR BENDING DIAGRAM

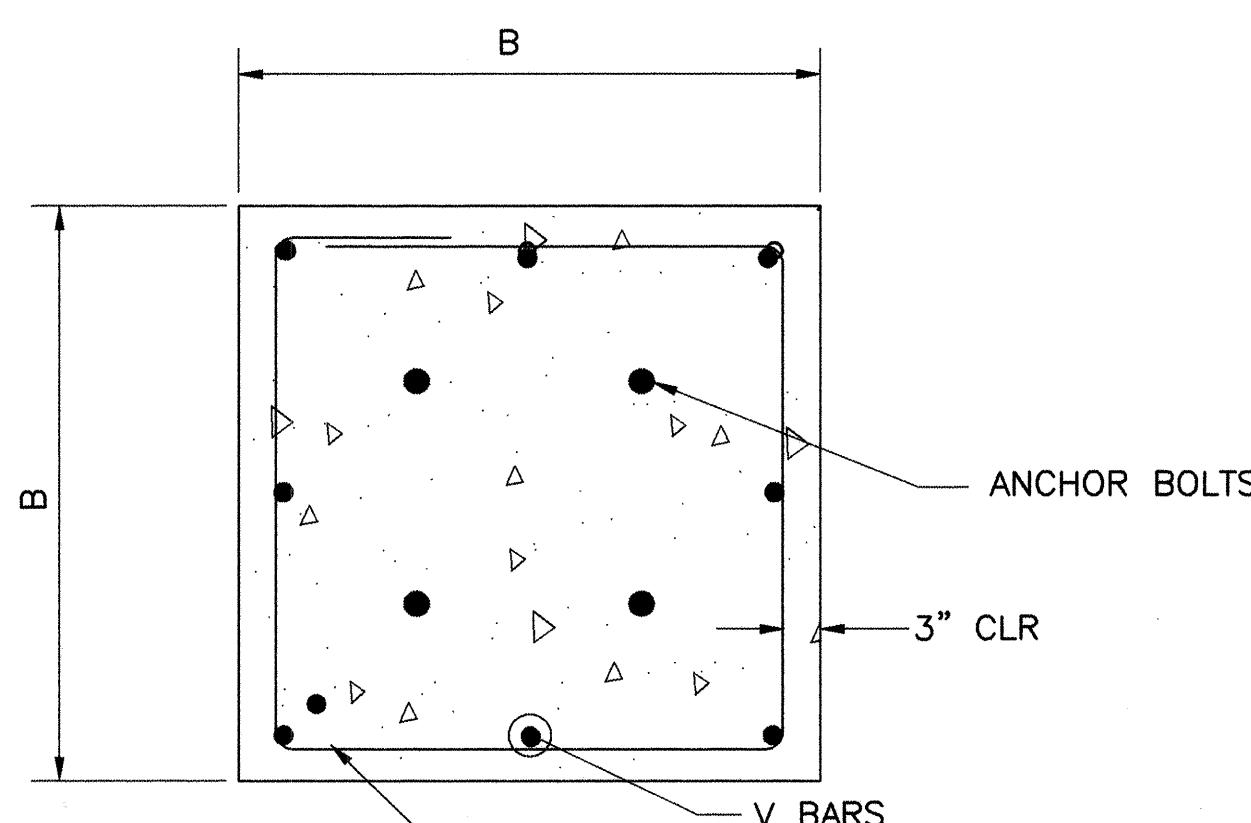

SECTION B-B (SQUARE)

NO SCALE

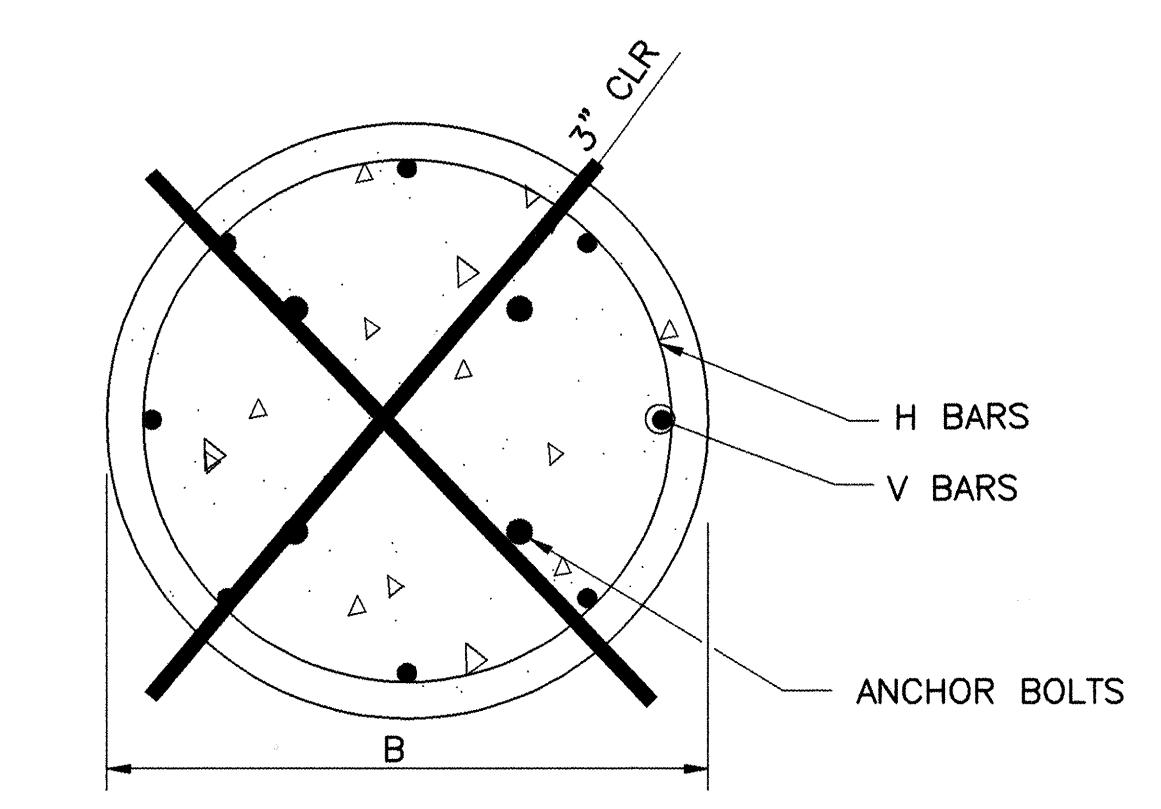

SECTION B-B (ROUND)

NO SCALE

REINFORCING SCHEDULE (GRADE 60 BARS)

MARK	QUANT	TYPE	SIZE	LENGTH	COMMENTS
#5V1	8	1	5	5'-9"	
#4V2	8	1	4	4'-6"	
#7V3	6	1	7	11'-3"	
#6V4	6	1	6	8'-0"	A = 42", TIES AT 14" OC
#3H1	6	2	3	15'-4"	A = 36", TIES AT 12" OC
#3H2	5	2	3	13'-4"	DIA = 30", TIES AT 12" OC
#3H3	12	3	3	9'-3"	DIA = 24", TIES AT 12" OC
#3H4	9	3	3	7'-8"	DIA = 24", TIES AT 12" OC

TRAFFIC SIGNAL MASTARM FOUNDATION NOTES

- REFER TO THE PLANS FOR LOCATIONS OF TRAFFIC SIGNAL MASTARM FOUNDATIONS.
- FINISHED GRADE FOR THE FOUNDATIONS SHALL BE ESTABLISHED IN THE FIELD BY THE PROJECT MANAGER.
- THE FOUNDATIONS SHOWN HERE SHALL BE CONSTRUCTED IN ACCORDANCE WITH THE CITY OF ALBUQUERQUE STANDARD SPECIFICATIONS FOR PUBLIC WORKS CONSTRUCTION, CURRENT REVISION.
- CONCRETE SHALL BE 3500 PSI FOR EXTERIOR STRUCTURES. REFER TO TABLE 101.C OF THE SPECIFICATIONS.
- REINFORCING STEEL SHALL CONFORM TO ASTM A-615 GRADE 60.
- THE TOP 6 INCHES OF THE FOUNDATION PEDESTAL SHALL BE FORMED TO THE DIMENSIONS SHOWN ON THIS SHEET TO FORM NEAT LINES. CONCRETE BELOW 6 LINES MAY BE CAST AGAINST THE EARTH.
- THE CONCRETE SHALL GAIN 80% OF THE DESIGN STRENGTH PRIOR TO INSTALLING THE TRAFFIC SIGNAL MASTARM.
- ALL FOUNDATIONS SHALL INCLUDE COPPERWELD GROUND RODS. ALL GROUND RODS SHALL BE 3/4" DIA X 10'-0" AND WILL BE CONSIDERED INCIDENTAL TO THE FOUNDATIONS BID ITEMS.
- ALL FOUNDATIONS SHALL BE STAMPED EITHER "A" OR "B" TO SHOW TYPE CONSTRUCTED (SEE STAMP DETAIL).

FOR INFORMATION ONLY

CITY OF ALBUQUERQUE PUBLIC WORKS DEPARTMENT ENGINEERING DEVELOPMENT GROUP	
TITLE: TRAFFIC SIGNAL FOUNDATION DETAILS TYPE II AND TYPE III STANDARDS	
DESIGN REVIEW COMMITTEE	CITY ENGINEER APPROVAL
P PROV OCT 22 1999 DESIGN REVIEW COMMITTEE	OCT 22 1999 CITY ENGINEER CITY PROJECT NO. 6042.9J ZONE MAP NO. C-19 SHEET OF TS-16
LAST DESIGN UPDATE	MO./DAY/YR.
NO. DATE	REMARKS REVISIONS DESIGN DRAWN BY COA CHECKED BY COA
NO. DATE	REMARKS REVISIONS DESIGN DRAWN BY COA CHECKED BY COA
NO. DATE	REMARKS REVISIONS DESIGN DRAWN BY COA CHECKED BY COA

AS-BUILT INFORMATION	
CONTRACTOR	DATE
WORK STARTED BY INSPECTOR'S NAME	DATE
FIELD TRAVERSE BY DRAWINGS	DATE
VERIFICATION BY DRAWINGS	DATE
CONNECTED BY MICRO-FILM	DATE
RECORDED BY NAME	DATE

ENGINEER'S SEAL	SURVEY INFORMATION
FIELD NOTES NO. BY DATE	BENCH MARKS
REMARKS NO. DATE	AS-BUILT INFORMATION
REVISIONS BY DESIGN	DATE 8-97
DESIGNED BY COA	DATE 8-97
DRAWN BY COA	DATE 8-97
CHECKED BY COA	DATE 8-97

TYPICAL PULL BOX INSTALLATION

NOTE: SEE "CONCRETE COLLAR DETAIL"

IN COMPACTED EARTH

IN ASPHALT PAVEMENTS

IN CONCRETE PAVEMENTS

CONCRETE COLLAR DETAILS

NOTE: THE CONCRETE COLLAR FOR THE PULL BOXES WILL BE
CONSIDERED INCIDENTAL TO THE PULL BOX BID ITEMS

TRAFFIC SIGNAL PULL BOX (TYPICAL)

NEW CONDUIT INSTALLATION

TRAFFIC SIGNAL PULL BOX (TYPICAL)

RETROFIT INSTALLATION

LARGE PULL BOX

STANDARD PULL BOX

PULL BOX DETAILS

NOTES FOR HEAVY DUTY REINFORCED POLYMER MORTAR PULL BOX AND COVERS

- MATERIAL TO BE AN AGGREGATE CONSISTING OF SAND AND GRAVEL BOUND TOGETHER WITH A POLYMER AND REINFORCED WITH CONTINUOUS WOVEN GLASS STRANDS. THE MATERIAL MUST HAVE THE FOLLOWING MECHANICAL PROPERTIES: COMPRESSIVE STRENGTH - 11,000 PSI, TENSILE STRENGTH - 1,700 PSI, FLEXURAL STRENGTH - 7,500 PSI.
- ALL PULL BOX COVERS SHALL BE HEAVY DUTY REINFORCED POLYMER MORTAR, HAVING A SERVICE LOAD OF 22,568 LBS OVER 10" SQUARE (225 PSI).
- PULL BOX TYPE AND LOGO SHALL BE APPROVED BY THE PROJECT MANAGER.
- THE DIMENSIONS OF THE PULL BOXES SHOWN ARE NOMINAL DIMENSIONS AND MAY VARY AS TO THE MANUFACTURER'S RECOMMENDATIONS. ALL DIMENSIONS SHALL BE VERIFIED BY THE PROJECT MANAGER.
- ELECTRICAL PULL BOX (STANDARD) SHALL BE A HEAVY DUTY REINFORCED POLYMER MORTAR PULL BOX AND COVER MEASURING 13 3/4" x 23 1/4" x 2".


CITY OF ALBUQUERQUE
PUBLIC WORKS DEPARTMENT
ENGINEERING DEVELOPMENT GROUP

TITLE:
TRAFFIC SIGNAL
PULL BOX DETAILS


APPROVED OCT 22 1999 DESIGN REVIEW COMMITTEE	APPROVED OCT 22 1999 CITY ENGINEER	LAST DESIGN UPDATE
MO./DAY/YR.	MO./DAY/YR.	

CITY PROJECT NO. 6042.91 ZONE MAP NO. C-19 SHEET OF TS-20

SATRANS GRAPHICS/DAVID MURRAY
ABEP/DJW

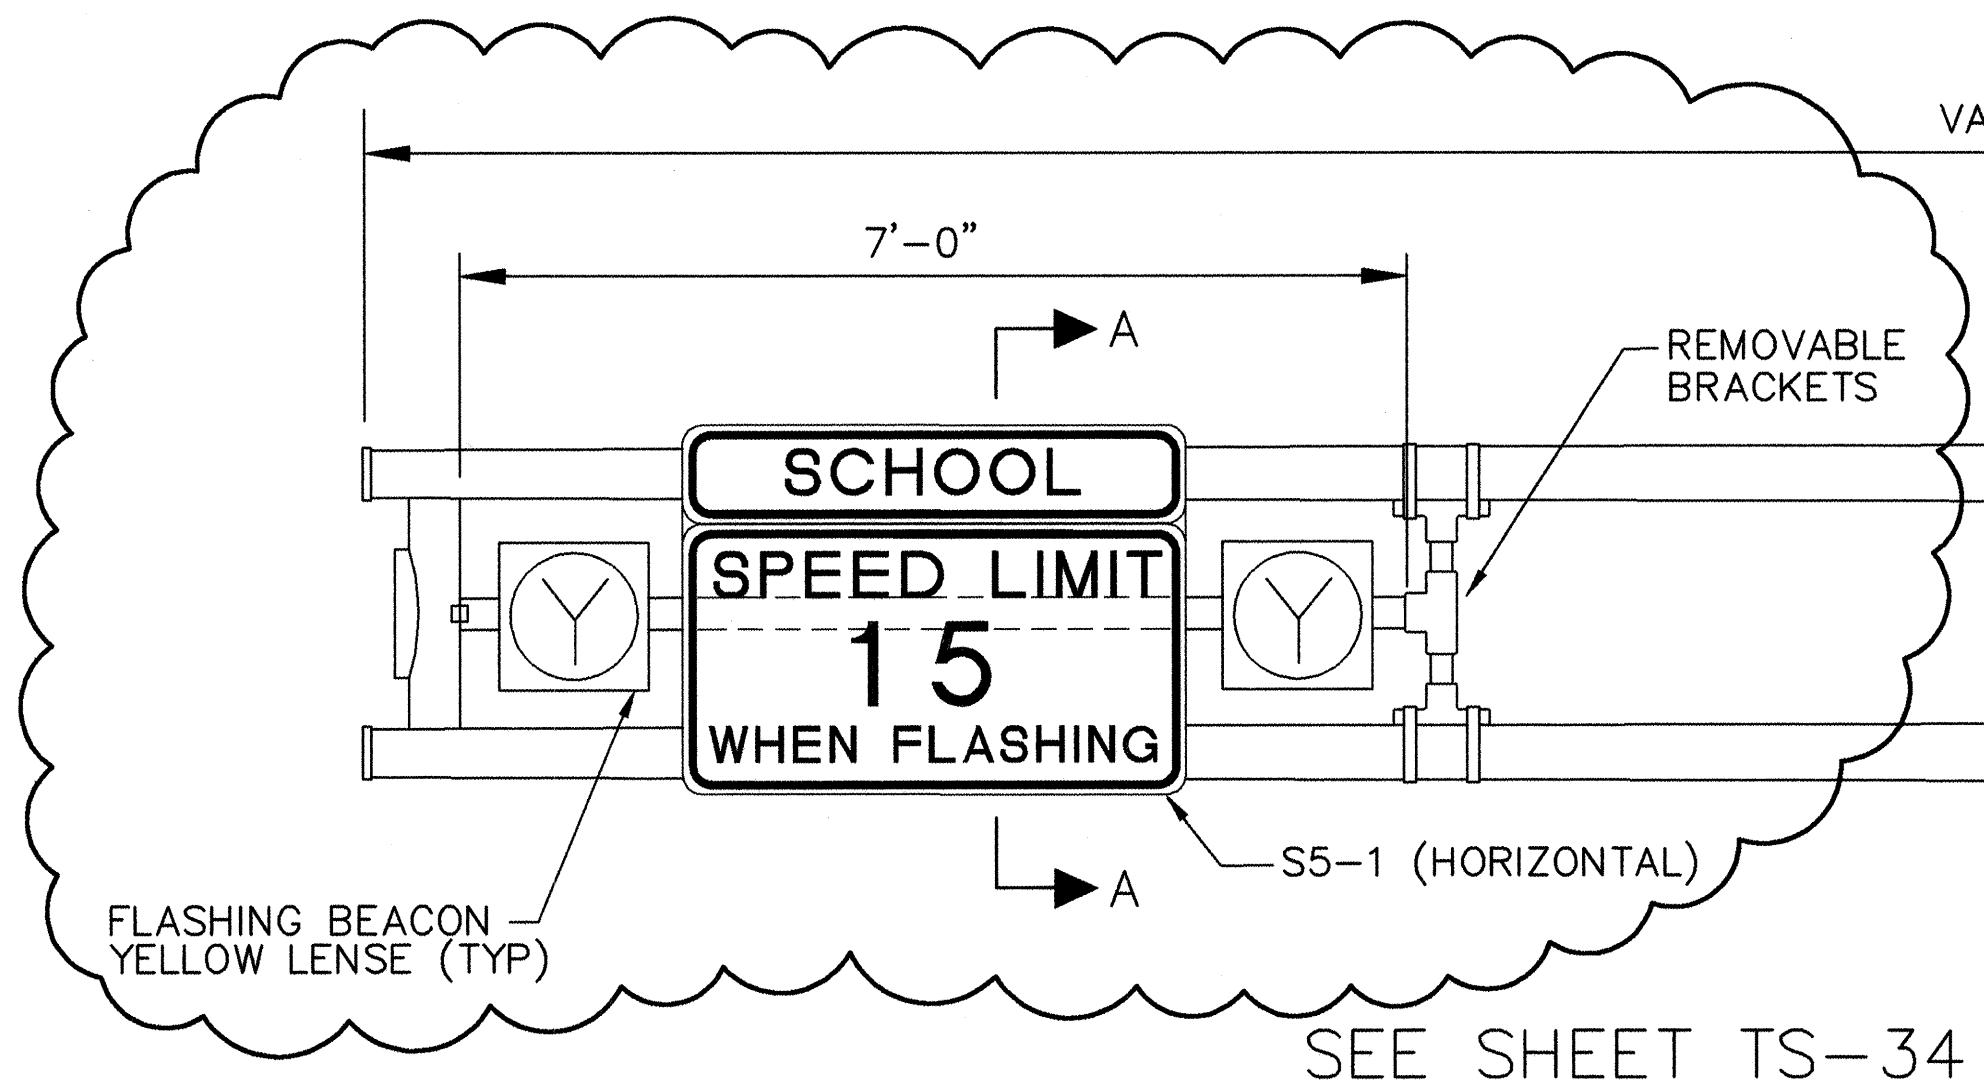


SEE SHEET TS-34

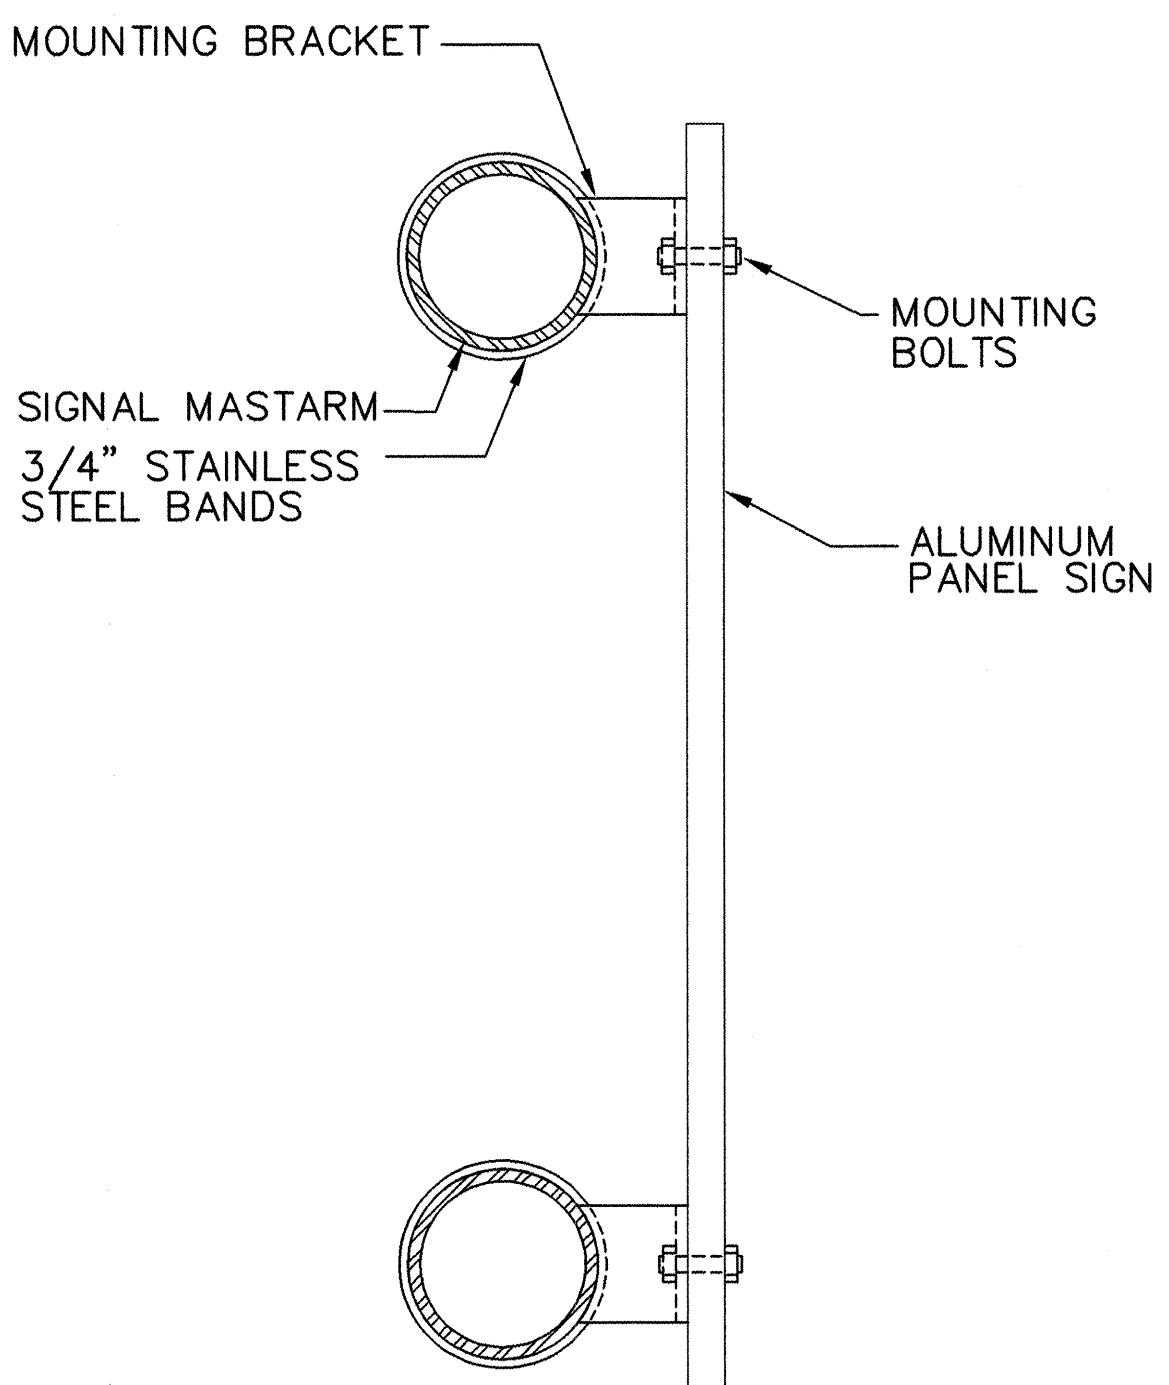


HORIZONTAL SIGN MOUNT DETAIL

SECTION A-A

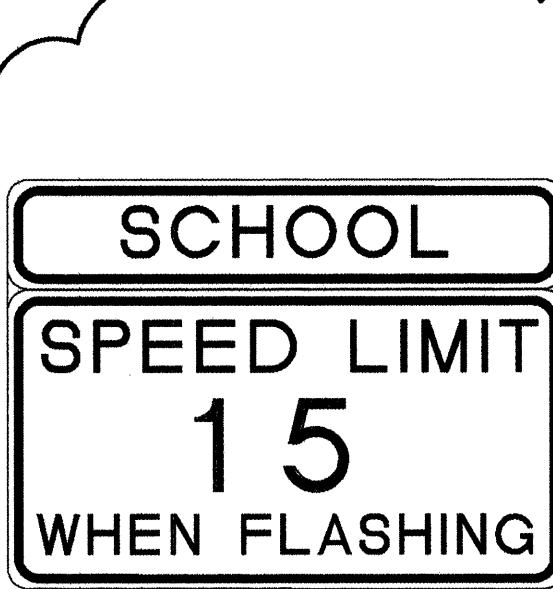

S5-1 (HORIZONTAL)

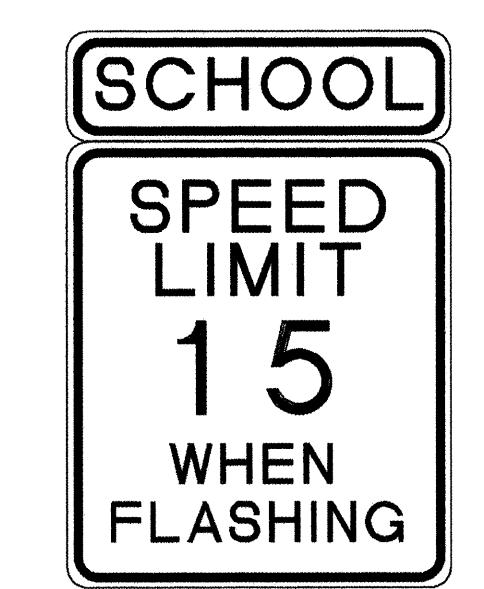


S5-1 (VERTICAL)

TYPICAL SIGN FACE DETAIL FOR SCHOOL BEACON

COLORS

LEGEND: BLACK (NON-REFLECTIVE)
TOP PANEL: YELLOW
BOTTOM PANEL: WHITE
OUTSIDE BORDER: WHITE
INSIDE BORDER: BLACK

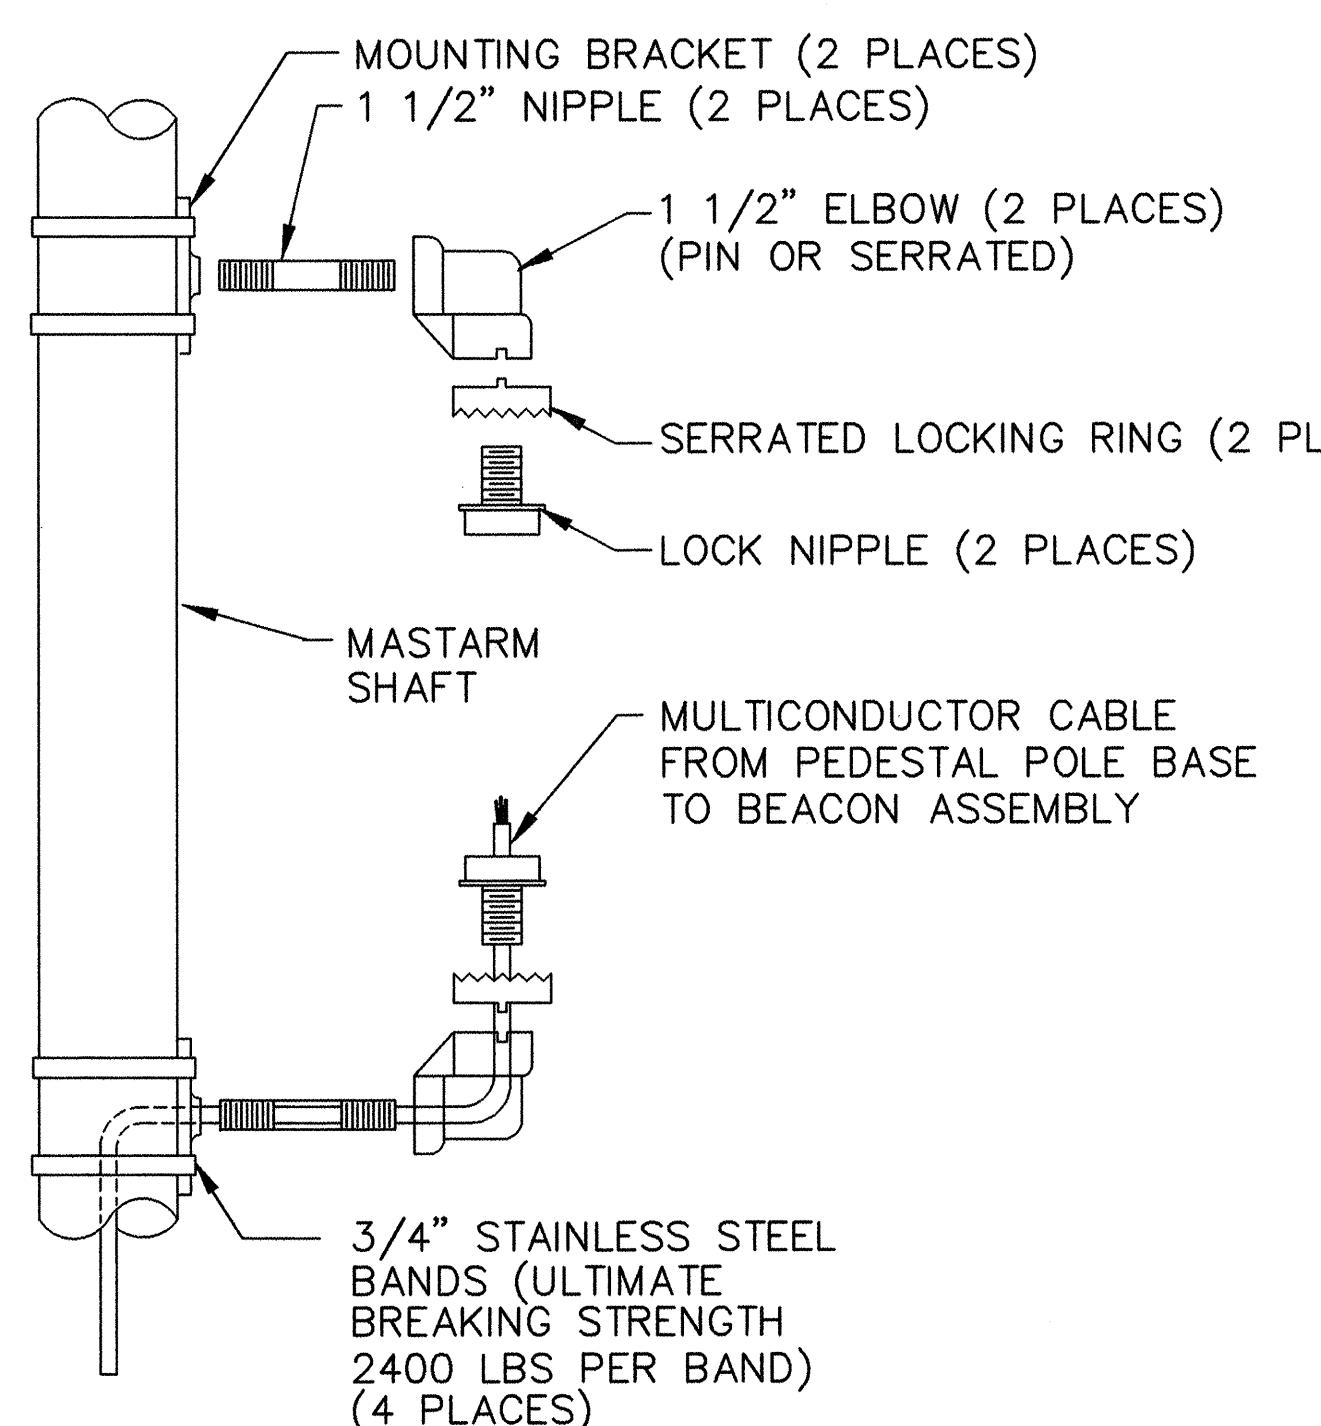

SIGNAL MOUNT DETAIL

SECTION B-B


SEE SHEET TS-34

NOTES:

- EACH SCHOOL BEACON (MASTARM) WILL BE MEASURED AND PAID FOR UNDER THE FOLLOWING ITEMS:
ITEM 0422.0XX - TRAFFIC SIGNAL MASTARM X' ARM (1 EACH BEACON)
ITEM 0423.002 - TRAFFIC SIGNAL MASTARM FOUNDATION (1 EACH BEACON)
ITEM 0427.001 - 1 SECTION TRAFFIC SIGNAL ASSEMBLY (4 EACH BEACON)
ITEM 0450.001 - ALUMINUM PANEL SIGNS (2 EACH BEACON)

SEE SHEET TS-34


SOLAR CONTROL CABINET
WHEN REQUIRED

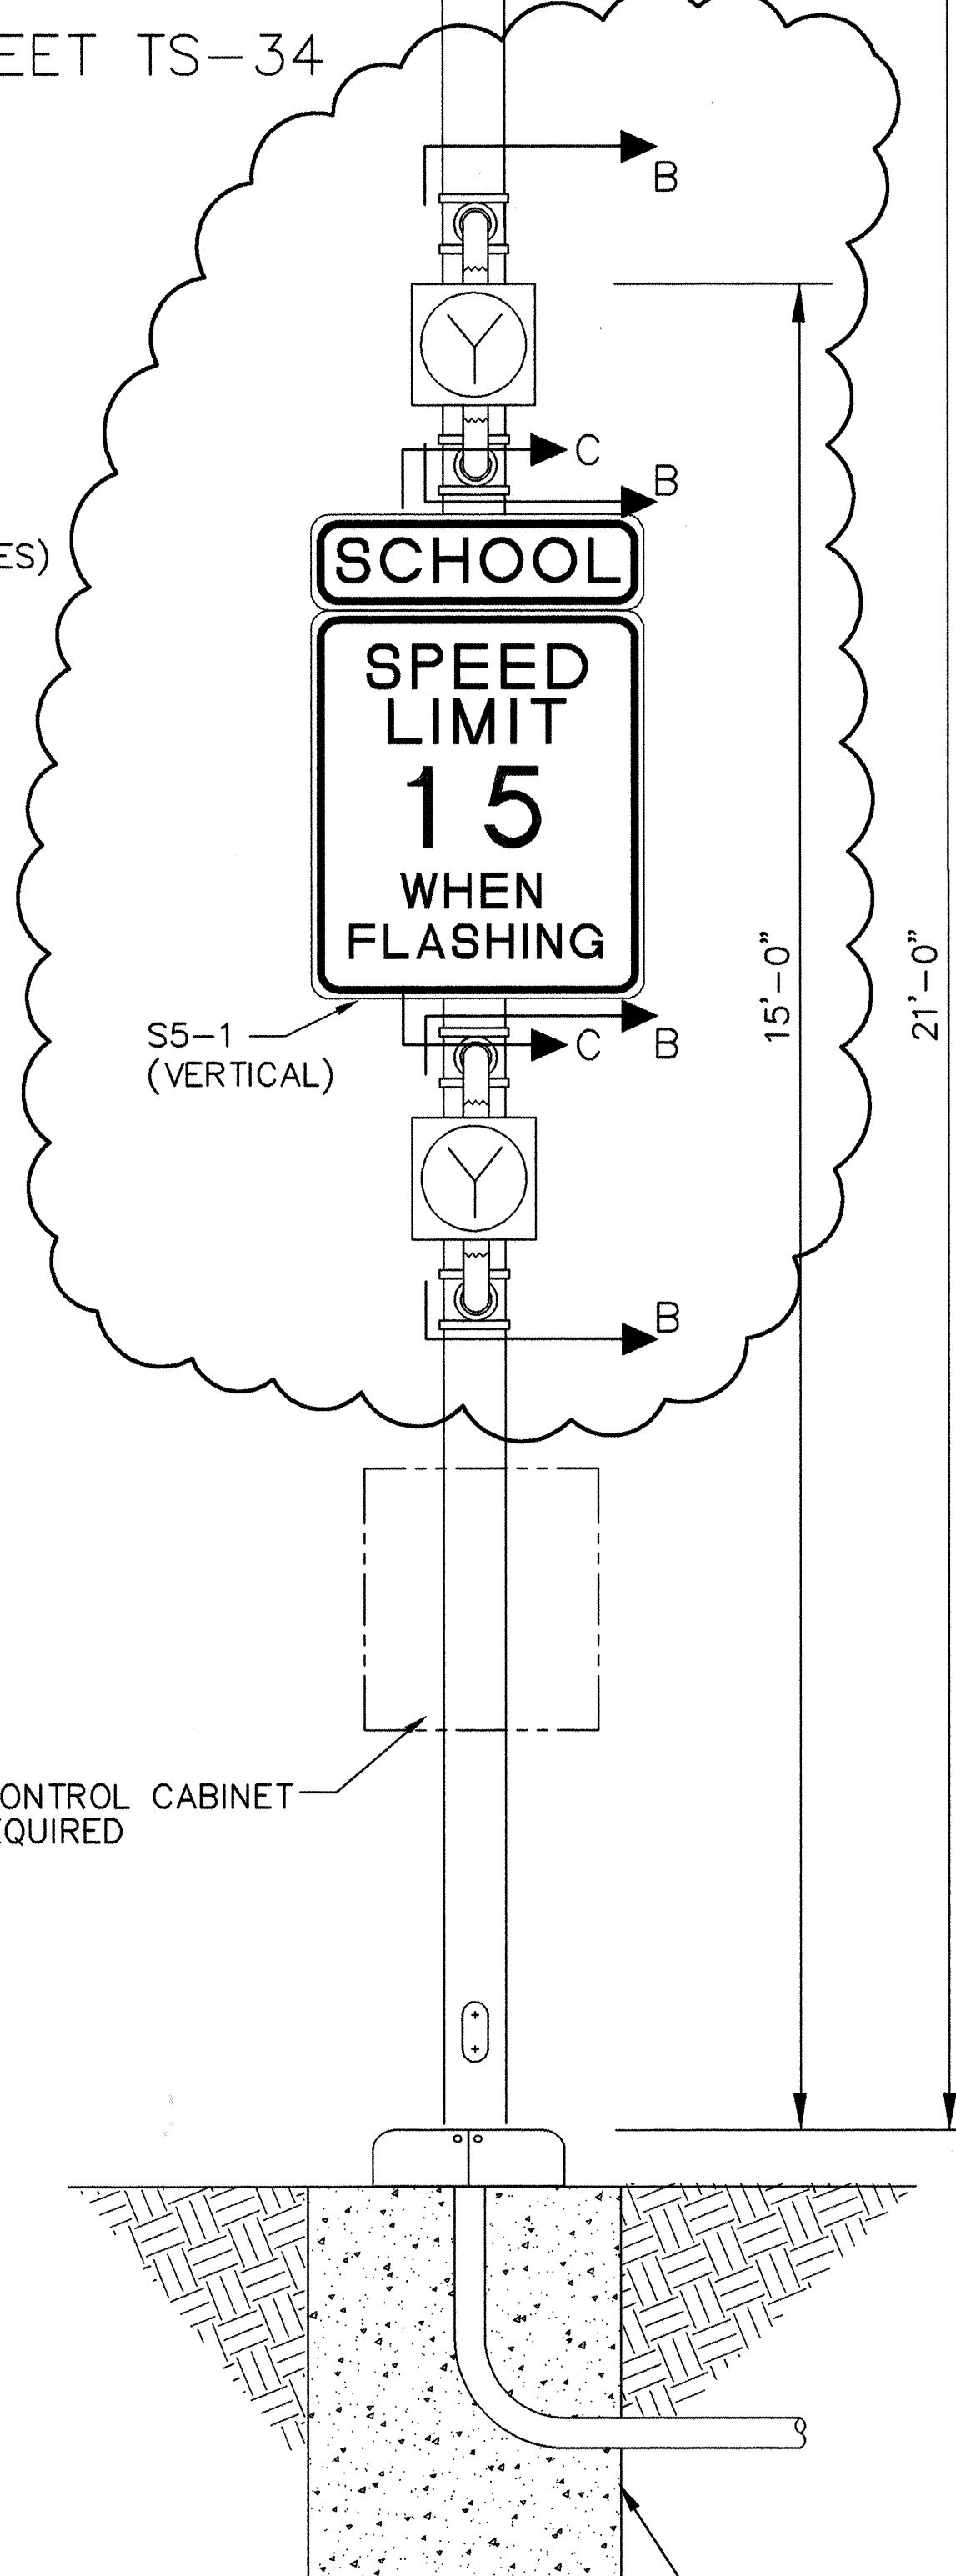


VERTICAL SIGN MOUNT DETAIL

SECTION C-C

FOR INFORMATION ONLY

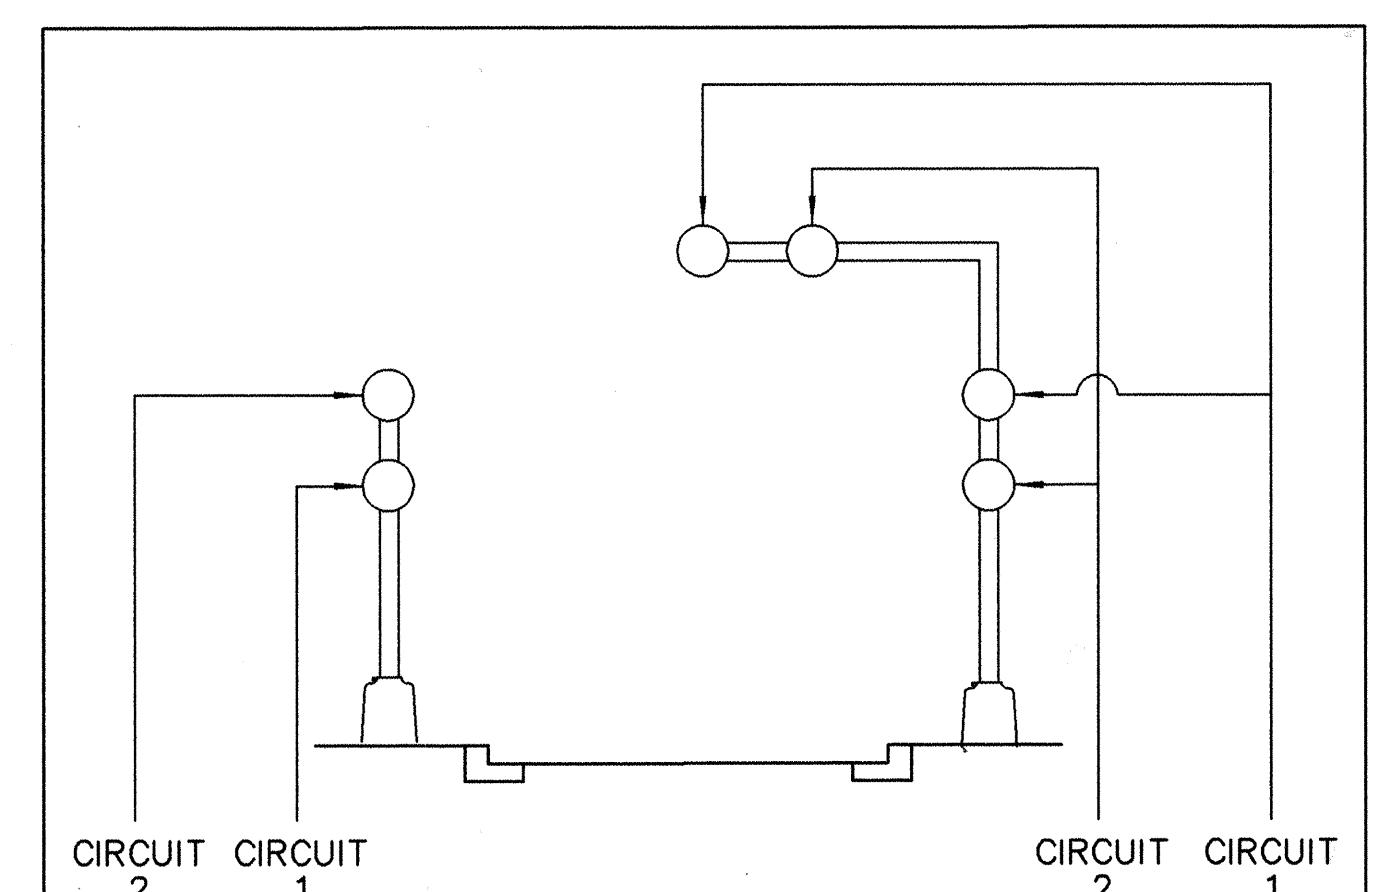

TYPICAL WIRING DIAGRAM FOR DUAL-CIRCUIT FLASHER OPERATION

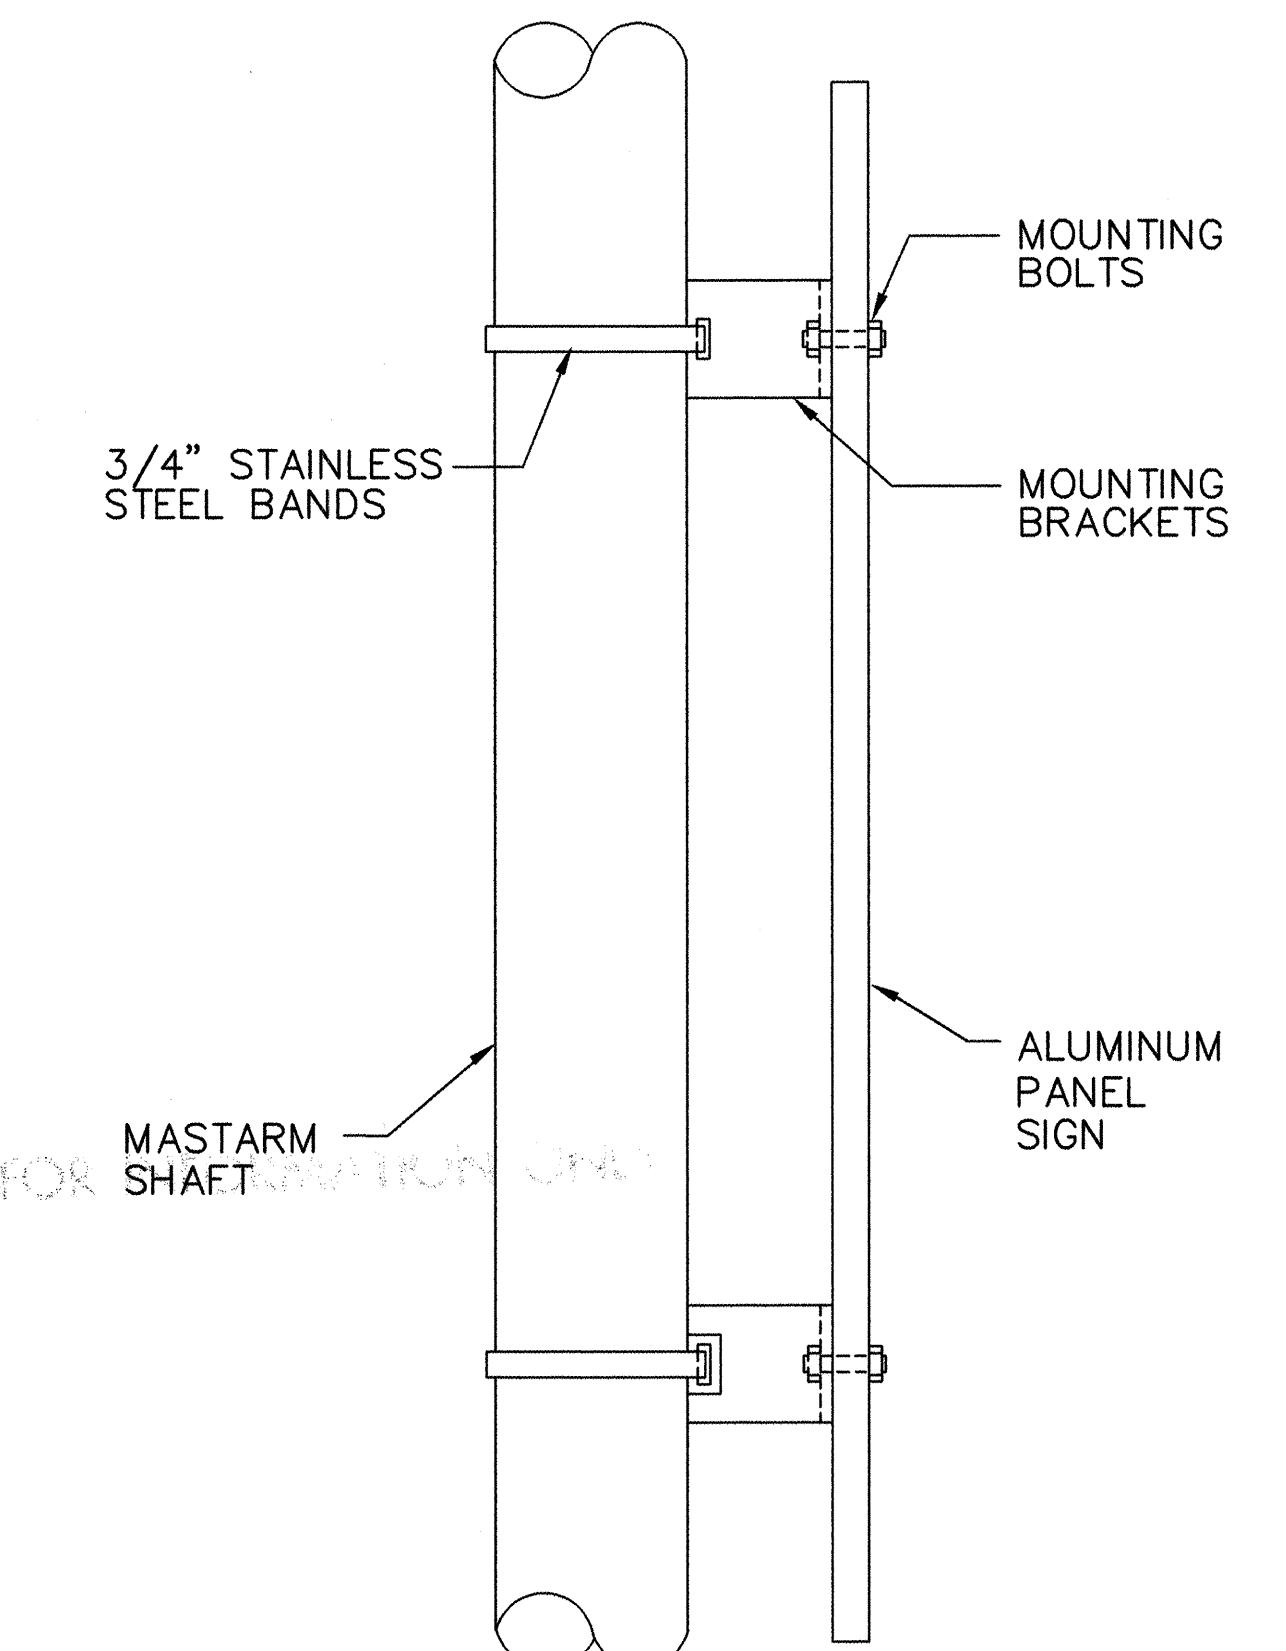

CITY OF ALBUQUERQUE
PUBLIC WORKS DEPARTMENT
ENGINEERING DEVELOPMENT GROUP

TITLE: TRAFFIC SIGNAL SCHOOL BEACON DETAILS (MASTARM)

DESIGN REVIEW COMMITTEE	CITY ENGINEER APPROVAL	NO./DAY/YR.	NO./DAY/YR.
APPROVED	APPROVED	OCT 22 1999	OCT 22 1999
DESIGN REVIEW COMMITTEE	CITY ENGINEER	LAST DESIGN UPDATE	
OCT 22 1999	OCT 22 1999		
DESIGN REVIEW COMMITTEE	CITY ENGINEER	DATE	DATE
		8-97	8-97
		DRAWN BY COA	CHECKED BY COA
		DESIGNED BY COA	REVIEWED BY COA
		APR 1997	APR 1997

CITY PROJECT NO. 6042.91 ZONE MAP NO. C-19 SHEET OF TS-36