

CONSTRUCTION PLANS FOR

OLD ALBUQUERQUE HIGH SCHOOL 24" WATERLINE & 6" SANITARY SEWER

ALBUQUERQUE, NEW MEXICO

INDEX

		SHEET NUMBER	DESCRIPTION		SHEET NUMBER	DESCRIPTION	
		1	COVER SHEET		6	COPPER AVE. / ARNO ST. 24" WATER	RLINE
		2	PLAT		7	ENLARGED PLAN OVERALL PAVING PLAN	
		3 A	OVERALL UTILITY F	PLAN	8	6" SANITARY SEWER PLAN & PROF	N =
		3, 3C	WATER SHUTOFF P	LANS	9,10	COA STANDARD TRAFFIC CONTROL	
		4	TIJERAS AVE 24" V PLAN & PROFILE	VATERLINE & 24" S			
		5	ARNO ST. 24" WAT & PROFILE	ERLINE PLAN	· ·		FOR INTORMATION ON
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TONTRACTOR SHALL ASSUME RESPONSIBILITY FOR ANY DAMAGE TO EXISTING PAVEMENTS.

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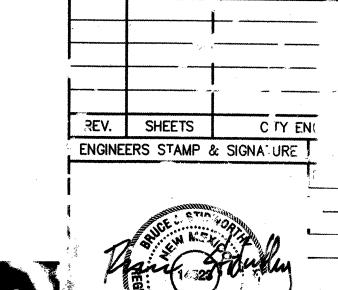
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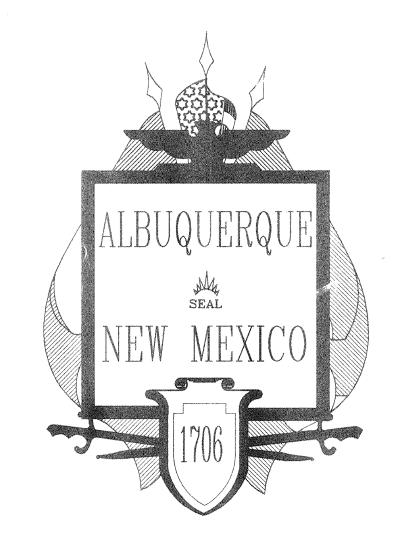
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NOTICE TO CONTRACTORS 6. ALL WORK EFFECTING ARTERIAL ROADWAYS REQUIRES TWENTY FOL YOUR (7. ALL STREET STRIPING ALTERED OR DESTROYED SHALL BE REPLACE. WITH F MARKING BY CONTRACTOR TO THE SAME LOCATION AS WAS EXISTING AS IN DI Y THIS PLAN SET. 8. CONTRACTOR SHALL NOTIFY THE CITY SURVEYOR NO* LESS ORDER THAT THE CITY SURVEYOR MAY TAKE NECESSARY MEAS! 'RVATIC' VEY MONUMENTS. ' "ITRACTOR SHALL NOT DISTURB PERMANENT S. THE C JE THE CITY SURVEYOR AND SHALL NOTIFY THE CITY SURVEYOR AND B XCENSE ACING DISTURBED WITHOUT PERMISSION. REPLACEMENT SHALL SE CON-EYOR. IS MADE IN THE FINISHED ELEVATIONS OF THE PAVEMENT OF A AY IN K MONUMENT IS LOCATED, CONTRACTOR SHALL, AT HIS OWN EXPE THE " COVE" CRADE UNLESS OTHERWISE SPECIFIED. REFER TO SECTION 4.4 C · OF TH SPECIFICATIONS. 9. CONTRACTOR SHALL RECORD DATA ON ALL UTILITY LINES A ALBUQUERQUE FOR THE PREPARATION OF "AS CONSTRUCTED" | CONTE LIVES AND ACCESSORIES UNTIL ALL DATA HAS BEEN RECORDED .9. CONTRACTOR SHALL MAINTAIN A GRAFFITI-FREE WOPE GRAFFITI FROM ALL EQUIPMENT, WHETHER PERMANENT OR TO SCHEDULING OF ANY WORK THAT MAY AFFECT FXIS OR SEV BE OPERATED BY CITY PERSONNEL ONLY. CONTRAC AT LEAST(5) WORKING DAYS PRIOR TO NEEDING VALVES TURNED WATER COMMENCE BETWEEN APRIL 15TH & SEPT, 15TH WITHOUT BETWEEN APRIL 15TH WITH BETWEEN APRIL 15TH WITHOUT BETWEEN APRIL 15TH W ON W/ SYSTEMS DIVISION THE FOLLOWING NC TS ALSO APE X ALL UTUTES AND UTILE BACKER COMPAUTION S X TACK COAT REQUIREMENTS X SIDEWALKS AND WHEELCHAIR CURB RETURN IS CONSTRUCT X IF CURB IS DEPRESSED FOR 8 2004F CURB AND GUTTER ALL STORM DRAINAGE PACILITIES THE REQUESTOR OF DEVELOPER S GUTTER OR SIDEWALK DAMAGED AFTER



CONSTRUCTION PLANS FOR

OLD ALBUQUERQUE HIGH SCHOOL 24" WATERLINE & 6" SANITARY SEWER

ALBUQUERQUE, NEW MEXICO

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ARNO ST. 24" WATERLINE & 24" SD

PLAN & PROFILE

		ONE CONTROL OF CONTROL	
SHEET NUMBER	DESCRIPTION	SHEET NUMBER	DESCRIPTION
	COVER SHEET	6	COPPER AVE. / ARNO ST. 24" WATERLINE ENLARGED PLAN
Page 1	PLAT	7	OVERALL PAVING PLAN
3/4	OVERALL UTILITY PLAN	8	6" SANITARY SEWER PLAN & PROFILE
3B, 3C	WATER SHUTOFF PLANS		
4	TIJERAS AVE 24" WATERLINE PLAN & PROFILE	9,10	COA STANDARD TRAFFIC CONTROL SHEETS

CONSTRUCTION NOTES:

1. THE CONTRACTOR SHALL ABIDE BY ALL LOCAL, STATE, AND FEDERAL LAWS, RULES AND REGULATIONS WHICH APPLY TO THE CONSTRUCTION OF THESE IMPROVEMENTS.

2. PRIOR TO CONSTRUCTION THE CONTRACTOR SHALL EXCAVATE AND VERIFY THE HORIZONTAL AND VERTICAL LOCATIONS OF ALL POTENTIAL OBSTRUCTIONS. SHOULD A CONFLICT EXIST. THE CONTRACTOR SHALL NOTIFY THE ENGINEER OR CONSTRUCTION OBSERVER SO THAT THE CONFLICT CAN BE RESOLVED WITH A MINIMUM AMOUNT OF DELAY.

3. ALL ELECTRICAL, TELEPHONE, CABLE TV, GAS AND OTHER UTILITY LINES, CABLES AND APPURTENANCES ENCOUNTERED DURING CONSTRUCTION THAT REQUIRE RELOCATION, SHALL BE COORDINATED WITH THAT UTILITY. THE CONTRACTOR SHALL BE RESPONSIBLE FOR COORDINATION OF ALL NECESSARY UTILITY ADJUSTMENTS. NO ADDITIONAL COMPENSATION WILL BE ALLOWED FOR DELAYS OR INCONVENIENCES CAUSED BY UTILITY COMPANY WORK CREWS. THE CONTRACTOR MAY BE REQUIRED TO RESCHEDULE HIS ACTIVITIES TO ALLOW UTILITY CREWS TO PERFORM THEIR REQUIRED WORK.

4. DISPOSAL SITE FOR ALL EXCESS EXCAVATION MATERIAL, AND UNSUITABLE MATERIAL SHALL BE OBTAINED BY THE CONTRACTOR IN COMPLIANCE WITH APPLICABLE ENVIRONMENTAL REGULATIONS AND APPROVED BY THE CONSTRUCTION OBSERVER. ALL COSTS INCURRED IN OBTAINING A DISPOSAL SITE AND HAUL THERETO SHALL BE CONSIDERED INCIDENTAL TO THE PROJECT AND NO SEPARATE MEASUREMENT OR PAYMENT SHALL BE MADE.

5. THE CONTRACTOR IS RESPONSIBLE FOR PROTECTING THE EXISTING UTILITY LINES WITHIN THE CONSTRUCTION AREA. ANY DAMAGE TO EXISTING FACILITIES CAUSED BY CONSTRUCTION ACTIVITY SHALL BE REPAIRED OR REPLACED AT THE CONTRACTOR'S EXPENSE AND APPROVED BY THE CONSTRUCTION OBSERVER.

6. CONSTRUCTION ACTIVITY SHALL BE LIMITED TO THE PROPERTY AND/OR PROJECT LIMITS. ANY DAMAGE TO ADJACENT PROPERTIES RESULTING FROM THE CONSTRUCTION PROCESS IS THE RESPONSIBILITY OF THE CONTRACTOR, ANY COSTS INCURRED FOR REPAIRS SHALL BE THE COST OF THE CONTRACTOR.

7. OVERNIGHT PARKING OF CONSTRUCTION EQUIPMENT SHALL NOT OBSTRUCT DRIVEWAYS OR DESIGNATED TRAFFIC LANES. THE CONTRACTOR SHALL NOT STORE ANY EQUIPMENT OR MATERIAL WITHIN THE PUBLIC RIGHT-OF-WAY.

8. THE CONTRACTOR SHALL OBTAIN ALL THE NECESSARY PERMITS FOR THE PROJECT PRIOR TO COMMENCING CONSTRUCTION (I.E. BARRICADING, SURFACE DISTURBANCE, ETC.)

9. THE CONTRACTOR SHALL BE RESPONSIBLE TO REPLACE AT HIS EXPENSE ANY AND ALL PROPERTY CORNERS DESTROYED DURING CONSTRUCTION. ALL PROPERTY CORNERS MUST BE RESET BY A REGISTERED LAND SURVEYOR.

10. ALL PERMANENT PAVEMENT MARKING AND TRAFFIC SIGNING SHALL BE FURNISHED BY THE CONTRACTOR PER PLAN.

11. THE CONTRACTOR SHALL FOLLOW THE CONSTRUCTION TRAFFIC CONTROL AND SIGNING PLAN PROVIDED HEREIN. THE CONTRACTOR SHALL COORDINATE WITH THE CITY OF ALBUQUERQUE, TRAFFIC ENGINEERING DEPARTMENT, PRIOR TO BEGINNING ANY CONSTRUCTION WORK ON OR ADJACENT TO EXISTING STREETS.

12. ALL BARRICADES AND CONSTRUCTION SIGNING SHALL CONFORM TO APPLICABLE SECTIONS OF THE "MANUAL OF UNIFORM TRAFFIC CONTROL DEVICES" (MUTCD), U.S. DEPARTMENT OF TRANSPORTATION, LATEST EDITION.

13. THE CONTRACTOR SHALL MAINTAIN ALL CONSTRUCTION BARRICADES AND SIGNING AT ALL TIMES. THE CONTRACTOR SHALL VERIFY THE PROPER LOCATION OF ALL BARRICADING AT THE END AND BEGINNING OF EACH DAY, OR MORE FREQUENTLY AS CONDITIONS MAY REQUIRE.

14. ALL SAWCUT PAVEMENT SHALL HAVE A UNIFORM EDGE AND BE SPRAYED WITH TACK.

15. WHEN ABUTTING NEW CURB AND GUTTER TO EXISTING PAVEMENT, A 1' WIDE SECTION OF EXISTING PAVEMENT ADJACENT TO THE CURB AND GUTTER SHALL BE SAWCUT, REMOVED, AND REPLACED AS PER THE STANDARD SPECIFICATIONS.

16. THE CONTRACTOR SHALL ASSUME RESPONSIBILITY FOR ANY DAMAGE TO EXISTING PAVEMENTS. PAVEMENT MARKINGS, CURB & GUTTER, DRIVE PADS, WHEELCHAIR RAMPS, AND SIDEWALK DURING CONSTRUCTION, APART FROM THOSE SECTIONS INDICATED FOR REMOVAL ON THE PLANS AND SHALL REPAIR OR REPLACE PER COA STANDARDS, AT HIS OWN EXPENSE.

ADDENDUM NO. ONE (001)

ACCORDANCE WITH OSHA 29CFR 1926.650 SUBPART P.

17. ALL EXCAVATION, TRENCHING, AND SHORING ACTIVITIES MUST BE ACCOMPLISHED IN

IMPORTANT NOTE: SEE SHEET IB OF 10 FOR PLAN SET APPROVAL SIGNATURES

DRB #1000184

Bohannan A Huston 🤏 Courtyard One 7500 JEFFERSON NE Albuquerque NEW MEXICO 87109 ENGINEERS PLANNERS PHOTOGRAMMETRISTS SURVEYORS SOFTWAKE DEVELOPERS



VICINITY MAP
ZONE MAP NO. K-14-Z

NOTICE TO CONTRACTORS

- . TWO WORKING DAYS PRIOR TO ANY EXCAVATION, THE CONTRACTOR MUST CONTACT NEW MEXICO ONE CALL
- I. PRIOR TO CONSTRUCTION, THE CONTRACTOR SHALL EXCAVATE AND VERIFY THE HORIZONTAL AND VERTICAL
- COORDINATION DIVISION, CONTRACTOR SHALL NOTIFY THE CONSTRUCTION COORDINATION ENGINEER (768—2551) PRIOR TO OCCUPYING AN INTERSECTION. REFER TO SECTION 19 OF THE GENERAL CONDITIONS OF THE STANDARD
- ALL STREET STRIPING ALTERED OR DESTROYED SHALL BE REPLACED WITH PLASTIC REFLECTORIZED PAVEMENT
- GRADE UNLESS OTHERWISE SPECIFIED. REFER TO SECTION 4.4 OF THE GENERAL CONDITIONS OF THE STANDARD
- 9. CONTRACTOR SHALL RECORD DATA ON ALL UTILITY LINES AND ACCESSORIES AS REQUIRED BY THE CITY OF ALBUQUERQUE FOR THE PREPARATION OF "AS CONSTRUCTED" DRAWINGS. CONTRACTOR SHALL NOT COVER UTILITY LINES AND ACCESSORIES UNTIL ALL DATA HAS BEEN RECORDED.
- 10. CONTRACTOR SHALL MAINTAIN A GRAFFITI-FREE WORK SITE, CONTRACTOR SHALL PROMPTLY REMOVE AN GRAFFITI FROM ALL EQUIPMENT, WHETHER PERMANENT OR TEMPORARY.
- 11. CONTRACTOR SHALL COORDINATE WITH THE CITY OF ALBUQUERQUE WATER SYSTEMS DIVISION (857-8200) PRIOR TO SCHEDULING OF ANY WORK THAT MAY AFFECT EXISTING PUBLIC WATER OR SEWER UTILITIES. EXISTING VALVES TO BE OPERATED BY CITY PERSONNEL ONLY. CONTRACTOR SHALL CONTACT THE WATER UTLITY DIVISION AT LEAST (5) WORKING DAYS PRIOR TO NEEDING VALVES TURNED ON OR OFF. WORK ON WATER LINES 16" & LARGER MAY NOT COMMENCE BETWEEN APRIL 15TH & SEPT. 15TH WITHOUT PRIOR COORDINATION W/& CONSENT FROM C.O.A. WATER
- THE FOLLOWING NOTES ALSO APPLY WHEN CHECKED
- ALL UTILITIES AND UTILITY SERVICE LINES SHALL BE INSTALLED PRIOR TO PAVING.
- BACKFILL COMPACTION SHALL BE ACCORDING TO SPECIFIED STREET USE.
- TACK COAT REQUIREMENTS SHALL BE DETERMINED BY THE CITY ENGINEER.
- X SIDEWALKS AND WHEELCHAIR RAMPS WITHIN THE CURB RETURNS SHALL BE CONSTRUCTED WHEREVER A NEW CURB RETURN IS CONSTRUCTED.
- IF CURB IS DEPRESSED FOR A DRIVEPAD, THE DRIVEPAD SHALL BE CONSTRUCTED PRIOR TO ACCEPTANCE OF CURB AND GUTTER.
- ALL STORM DRAINAGE FACILITIES SHALL BE COMPLETED PRIOR TO FINAL ACCEPTANCE.
- THE REQUESTOR OR DEVELOPER SHALL BE RESPONSIBLE FOR REPAIR OR REPLACEMENT OF ALL CURB AND

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CONSTRUCTION PLANS FOR

OLD ALBUQUERQUE HIGH SCHOOL 24" VVATERLINE & 6" SANITARY SEWER

ALBUQUERQUE, NEW MEXICO

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	4	TIJERAS AVE 24" WATERL!! PLAN & PROFILE	NE & 24 SD	
	5	ARNO ST. 24" WATERLINE & PROFILE	PLAN	
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ADDENDUM NO. ONE (001)

FOR INFORMATION ONLY



NOTICE TO CONTRACTORS

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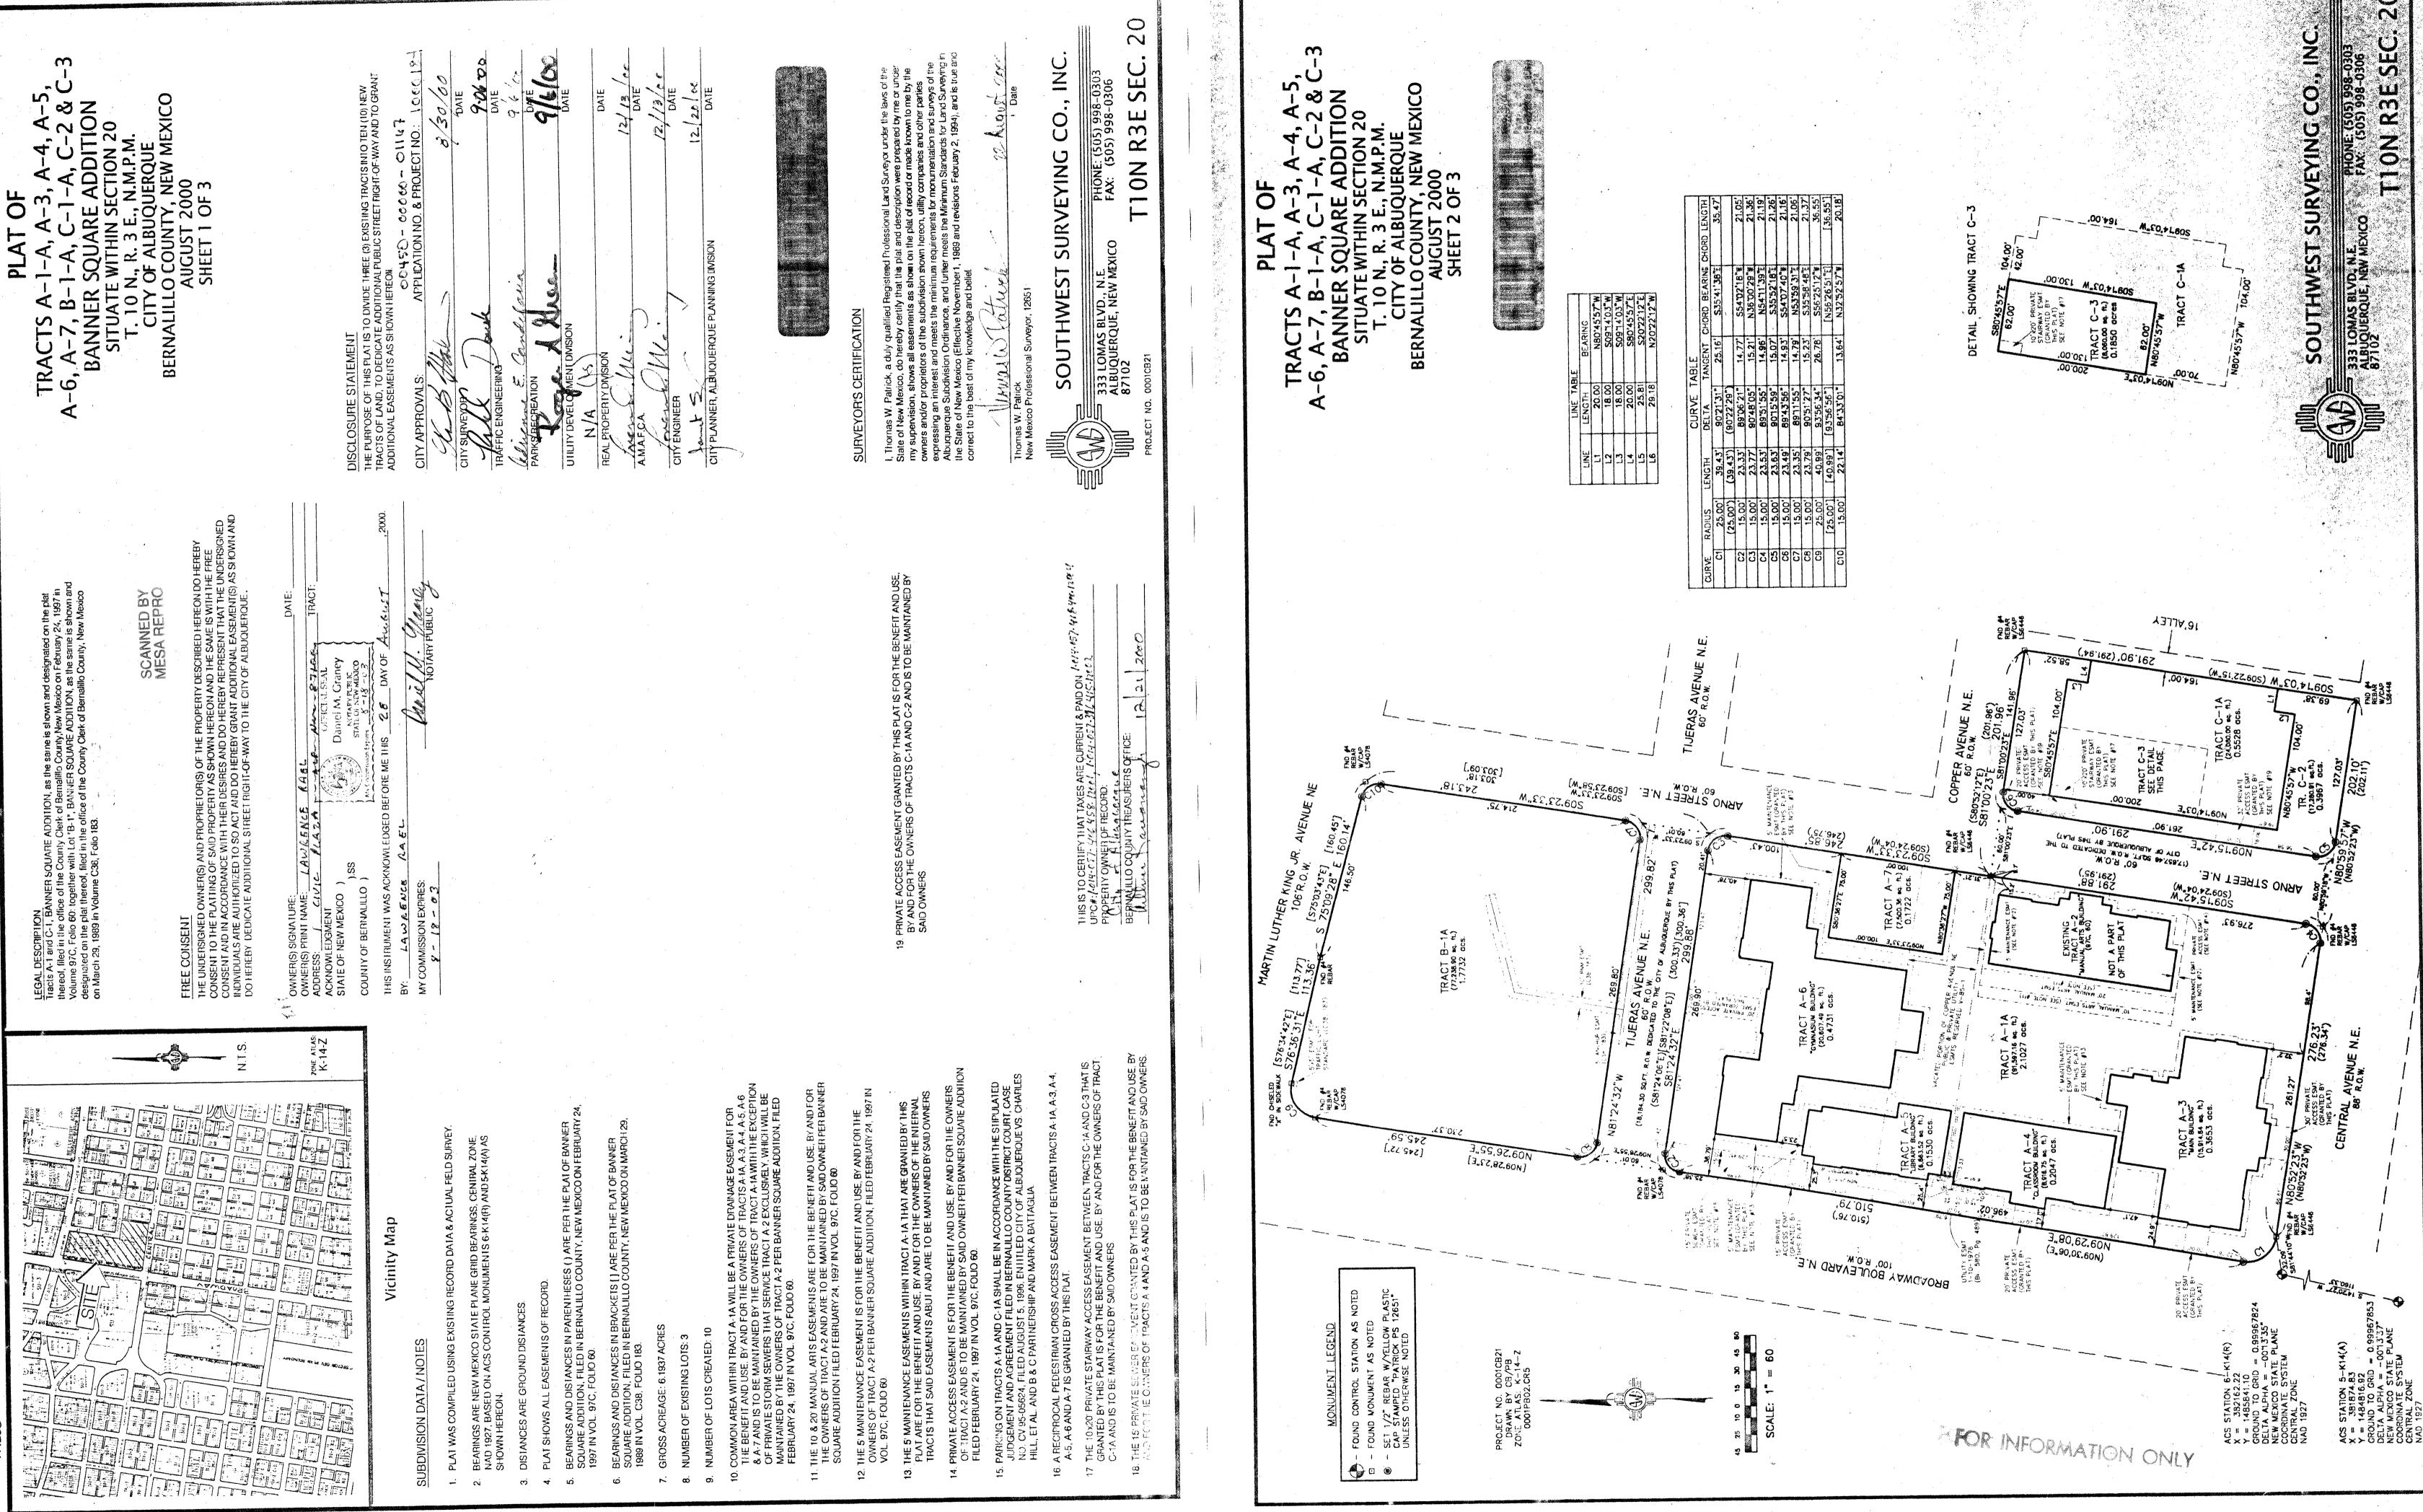
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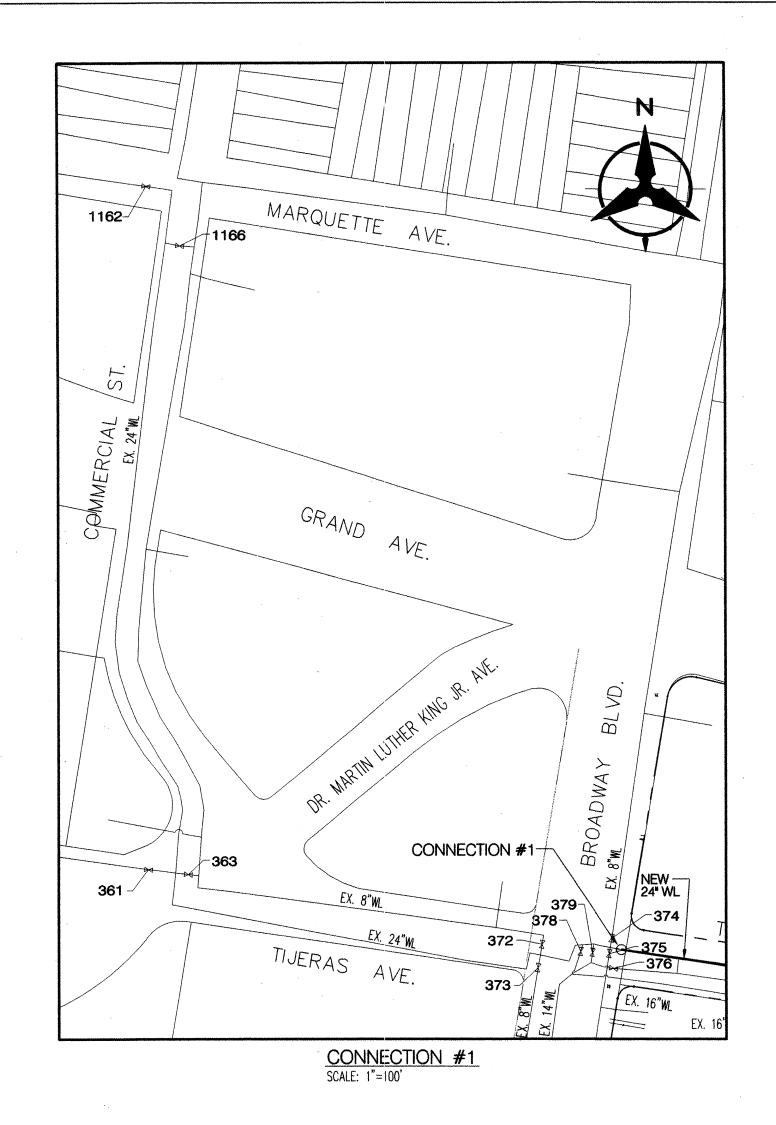
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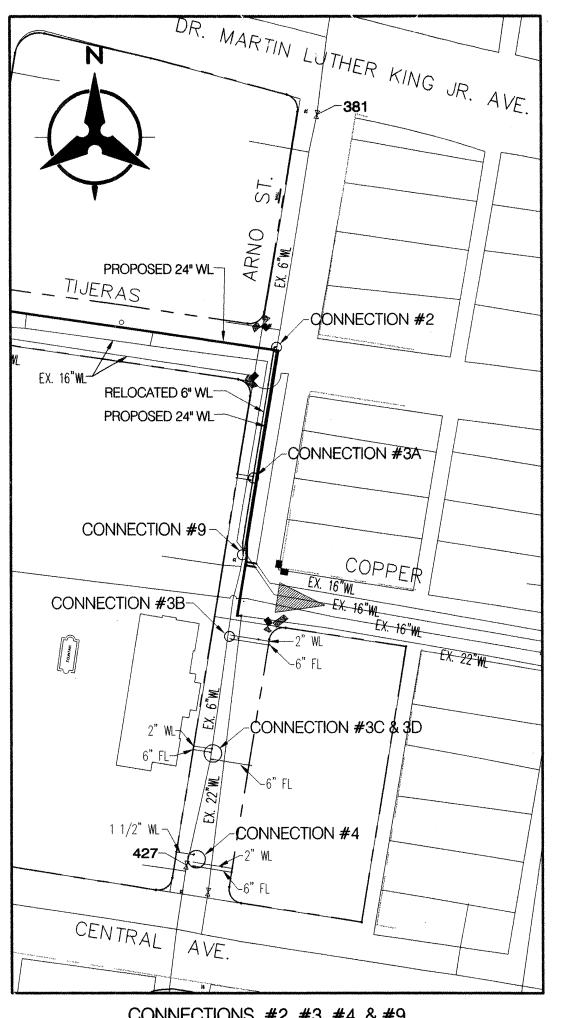


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BHI JOB NO. 00321

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CONNECTIONS #2, #3, #4, & #9 SCALE: 1"=100'



WATER SHUT-OFF PLAN

CONNECTION #1

FOR CONNECTION OF NEW 24" WL TO EXISTING 24" WL AT BROADWAY & TIJERAS, CLOSE VALVE #372, #373, #374, #375, #378, #379, AT TIJERAS & BROADWAY, CLOSE VALVE #361 & #363 AT TIJERAS & COMMERCIAL ST., CLOSE VALVE #1162, & #1166 AT COMMERCIAL AND MARQUETTE AVE., AS SHOWN ON THE COA AUTOMATED WATER DISTRIBUTION SYSTEM SECTIONAL MAP NO. J-14 AND K-14.

CONNECTION #2

FOR CONNECTION OF NEW 6" WATERLINE IN ARNO ST. TO EXISTING 6" WATERLINE IN ARNO ST., CLOSE VALVE #381 AT THE INTERSECTION OF DR. MARTIN LUTHER KING JR. AVE. AND ARNO ST., #427, NORTH OF THE INTERSECTION OF ARNO ST. AND CENTRAL AVE., AS SHOWN ON THE COA AUTOMATED WATER DISTRIBUTION SYSTEM SECTIONAL MAP NO. K-14.

CONNECTION #3A, 3B, 3C, 3D, & 4

FOR CONNECTION OF NEW 6" FIRE LINES IN ARNO ST., CLOSE VALVE #381 AT THE INTERSECTION OF DR. MARTIN LUTHER KING JR. AVE. AND #427, NORTH OF THE INTERSECTION OF ARNO ST. AND CENTRAL AVE., AS SHOWN ON THE COA AUTOMATED WATER DISTRIBUTION SYSTEM SECTIONAL MAP NO. K-14.

CONNECTION #5 (INCLUDING CAPPING OF 16" AT BROADWAY & TIJERAS)

FOR CONNECTION OF NEW 16" WL TO EXISTING NORTHERNMOST 16" WL AT THE INTERSECTION OF ARNO ST. & COPPER AVE., CLOSE VALVE #378 AT THE INTERSECTION OF BROADWAY & TIJERAS AND VALVE #107 AT COPPER & ELM ST. AND VALVE #112 AT COPPER & I-25 AS SHOWN ON THE COA AUTOMATED WATER DISTRIBUTION SYSTEM SECTIONAL MAP NO. K-15.

CONNECTION #9 (INCLUDING CAPPING OF 16" AT BROADWAY & TIJERAS)

FOR CONNECTION OF NEW 6" WATERLINE IN ARNO ST. TO EXISTING 6" WL IN ARNO ST., CLOSE VALVE #381 AT THE INTERSECTION OF DR. MARTIN LUTHER KING JR. AVE. AND #427, NORTH OF THE INTERSECTION OF ARNO ST. AND CENTRAL AVE., AS SHOWN ON THE COA AUTOMATED WATER DISTRIBUTION SYSTEM SECTIONAL MAP NO. K-14.

EXISTING VALVES SHOWN ON THIS PLAN ARE BASED ON AUTOMATED WATER DISTRIBUTION SYSTEM SECTIONAL MAPS, AND ARE NOT EXACT LOCATIONS.

FOR INFORMATION CHLY

WATER REQUIREMENTS

CONTRACTOR WILL BE RESPONSIBLE FOR THE TIMING AND COORDINATION OF THE WATER SHUT-OFF REQUIREMENTS.

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PRIOR TO CONSTRUCTION, THE CONTRACTOR SHALL SUBMIT A WATER SHUT-OFF SCHEDULE TO PWD/WATER UTILITY DIVISION (857-8200). WATER SHUT-OFF SCHEDULE SHALL INCLUDE DURATION OF EACH SHUT-OFF, ALTERNATE FEED PLANS FOR HIGH PRIORITY CUSTOMERS, & DISPOSAL / DECLORINATION PLAN WHERE REQUIRED. SCHEDULE SHALL BE REVIEWED & APPROVED BY WATER UTILITY DIVISION PRIOR TO IMPLEMENTATION

CONTRACTOR SHALL NOT OPERATE CITY VALVES.

NOTE: ALL EXISTING UTILITY INFORMATION SHOWN IN THIS PLAN SET IS BASED ON AS-BUILT DATA & FIELD EVIDENCE. CONTRACTOR SHALL NOT DAMAGE EXISTING UnLITIES. FIELD VERIFY ALL EXISTING **JTILITY LOCATIONS PRIOR TO** CONSTRUCTION.

Bohannan A Huston

Courtyard One 7500 JEFFERSON NE Albuquerque NEW MEXICO 87109

ENGINEERS PLANNERS PHOTOGRAMMETRISTS SURVEYORS SOFTWARE DEVELOPERS





CITY OF ALBUQUERQUE PUBLIC WORKS DEPARTMENT


OLD ALBUQUERQUE HIGH WATER SHUTOFF FLAN


City Engineer Approval DESIGN REVIEW COMMITTEE / ENGINEER City Project No. 'Zone Map No. 657391 K - 14 - Z


BHI JOB NO. 00321

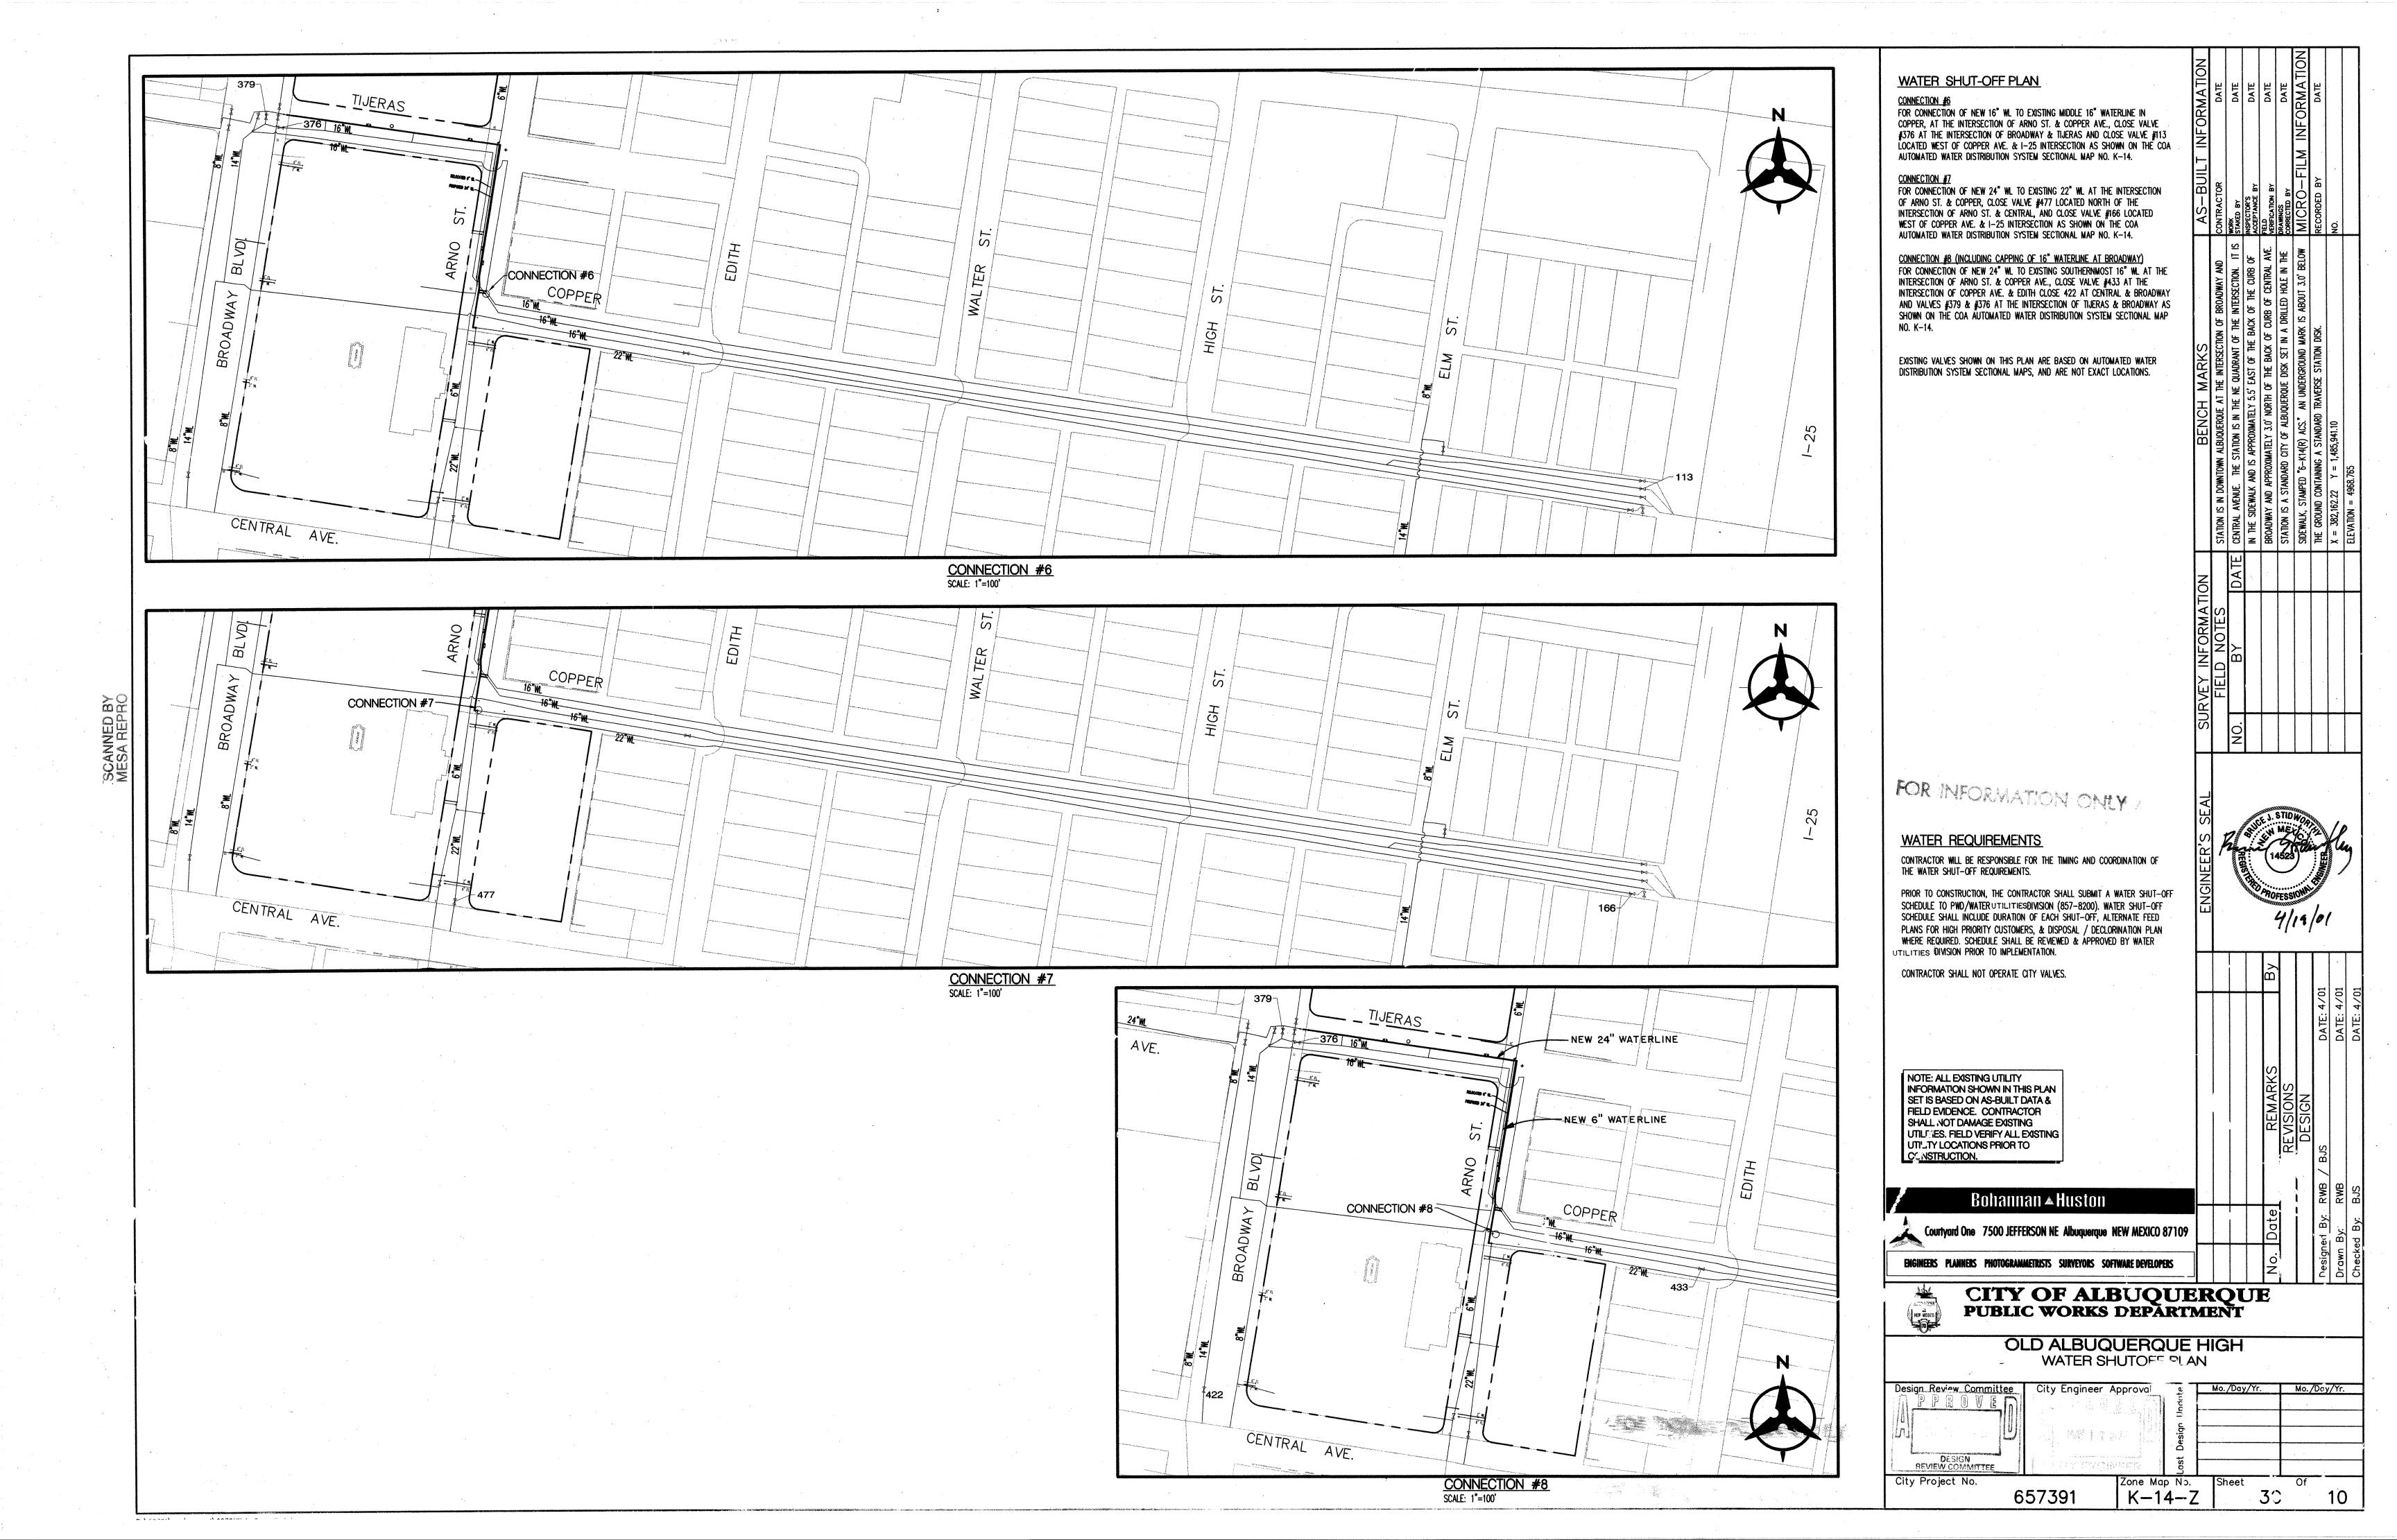


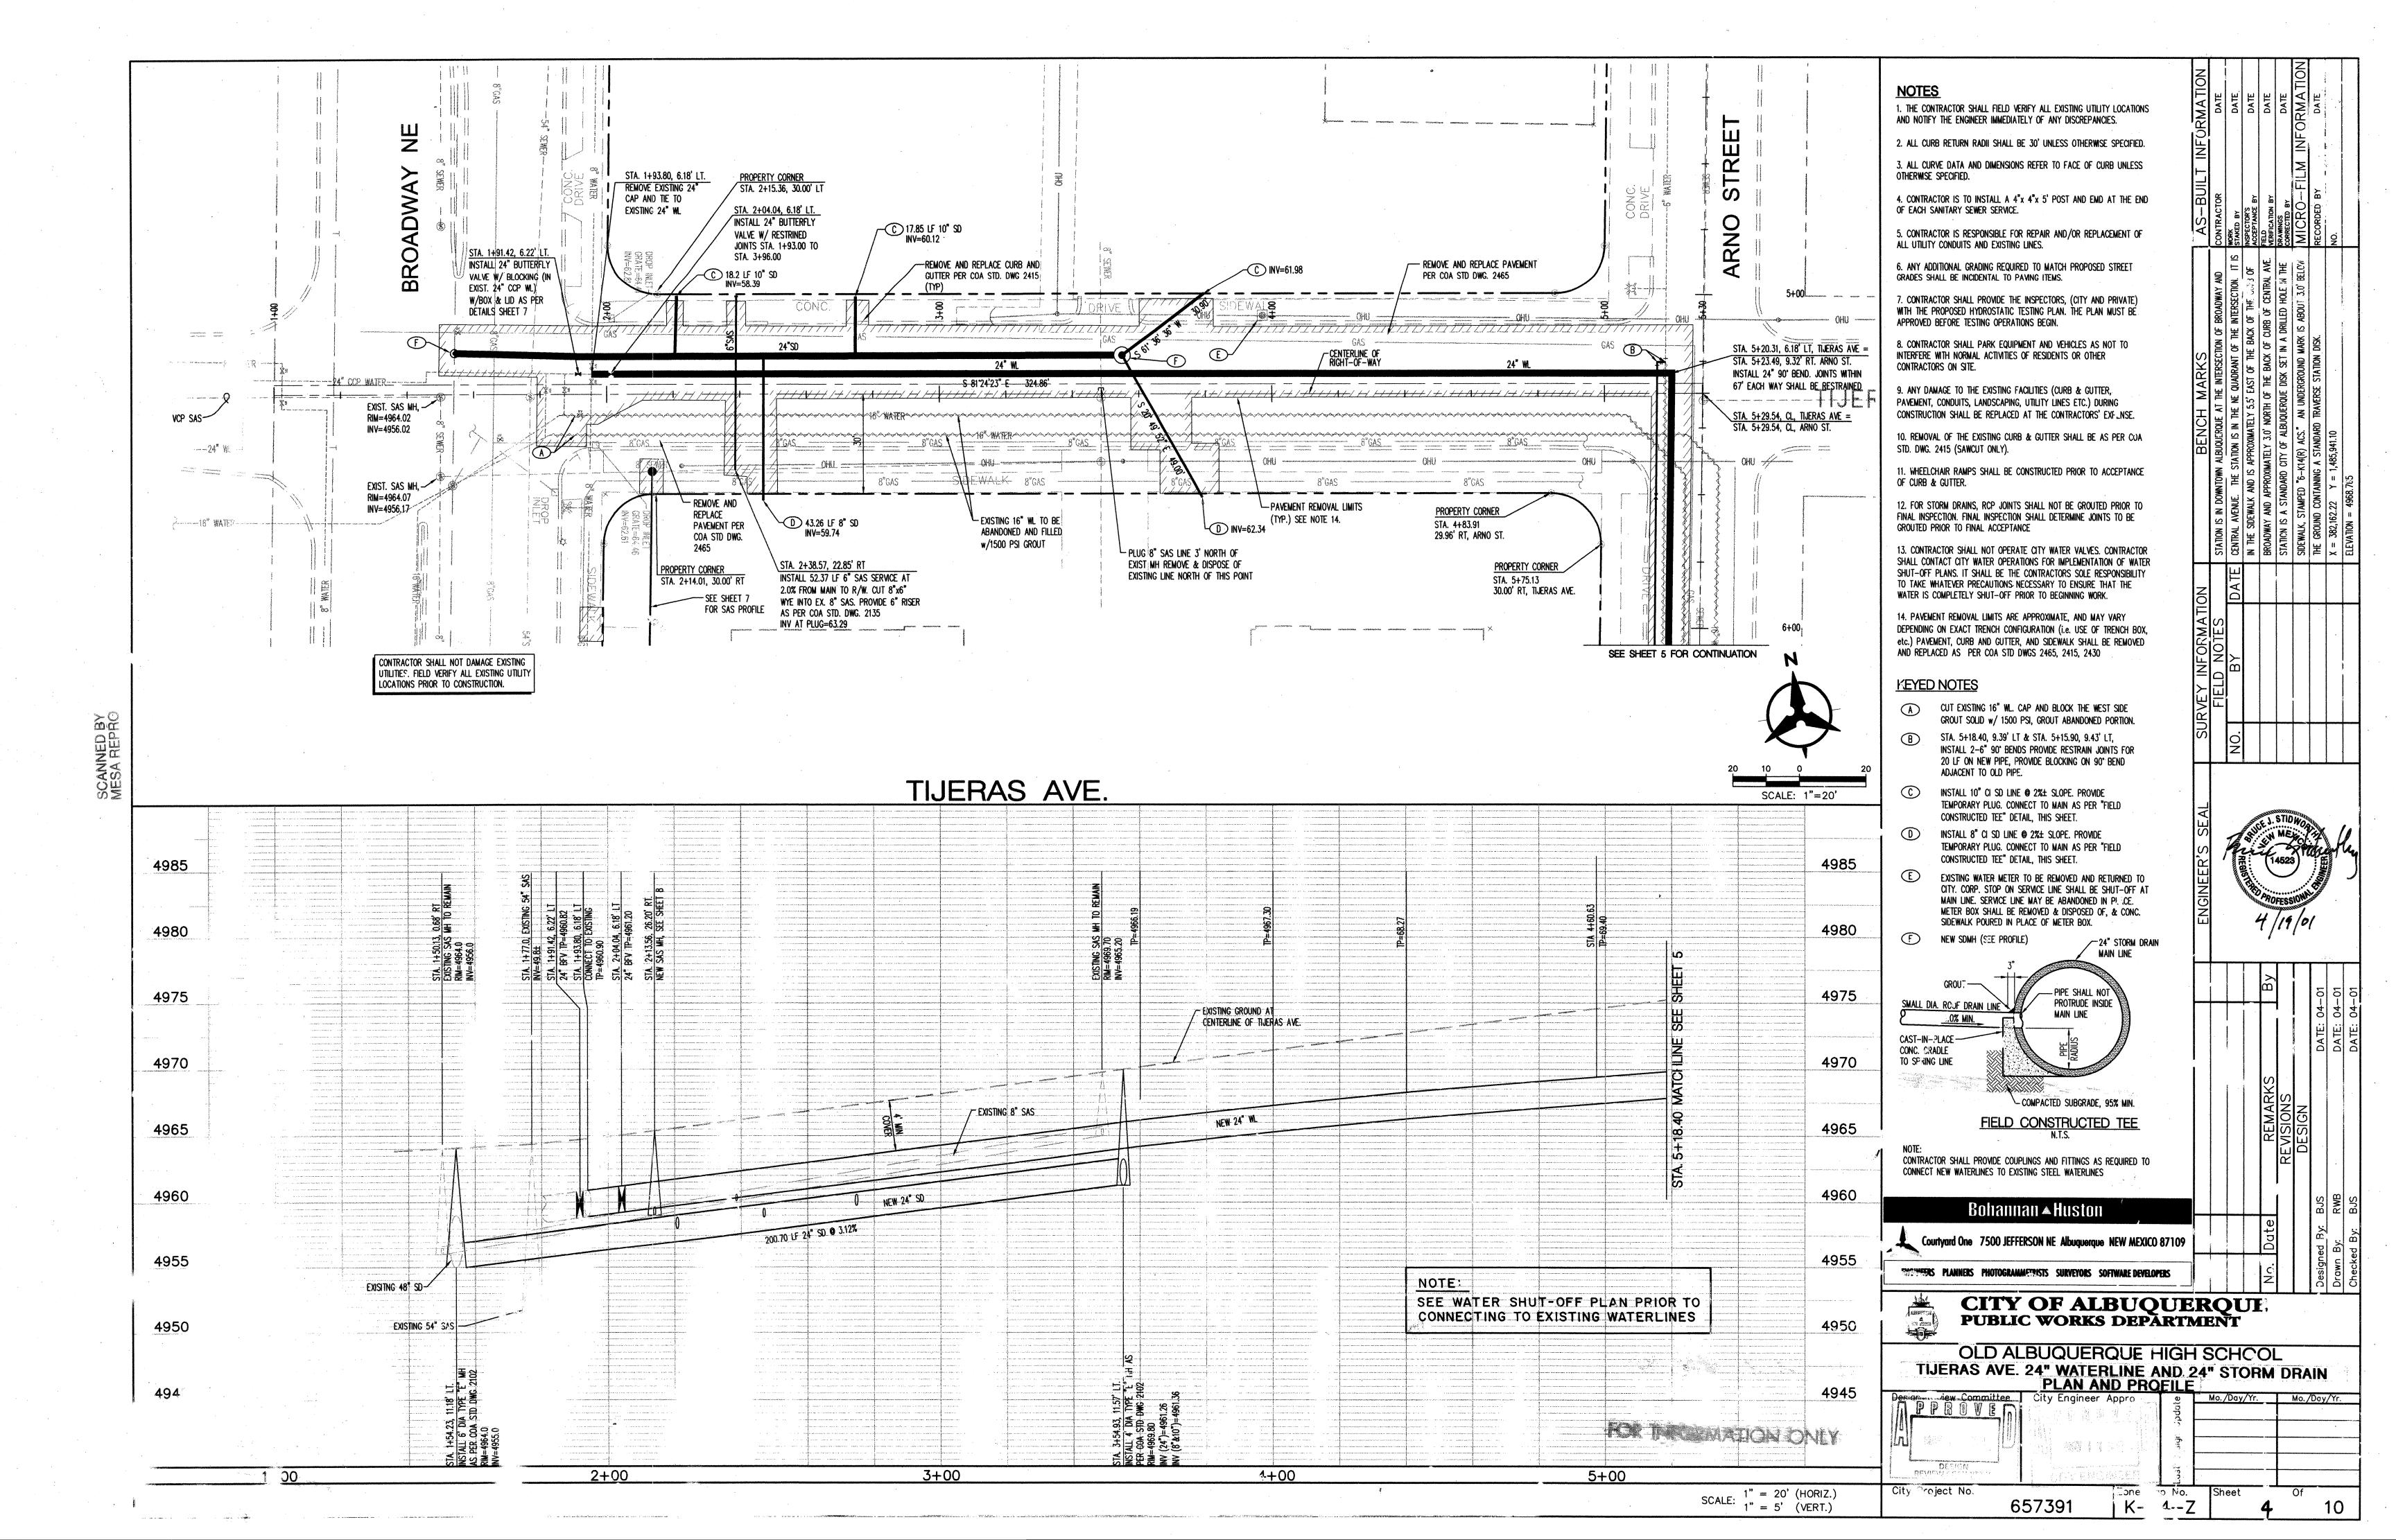

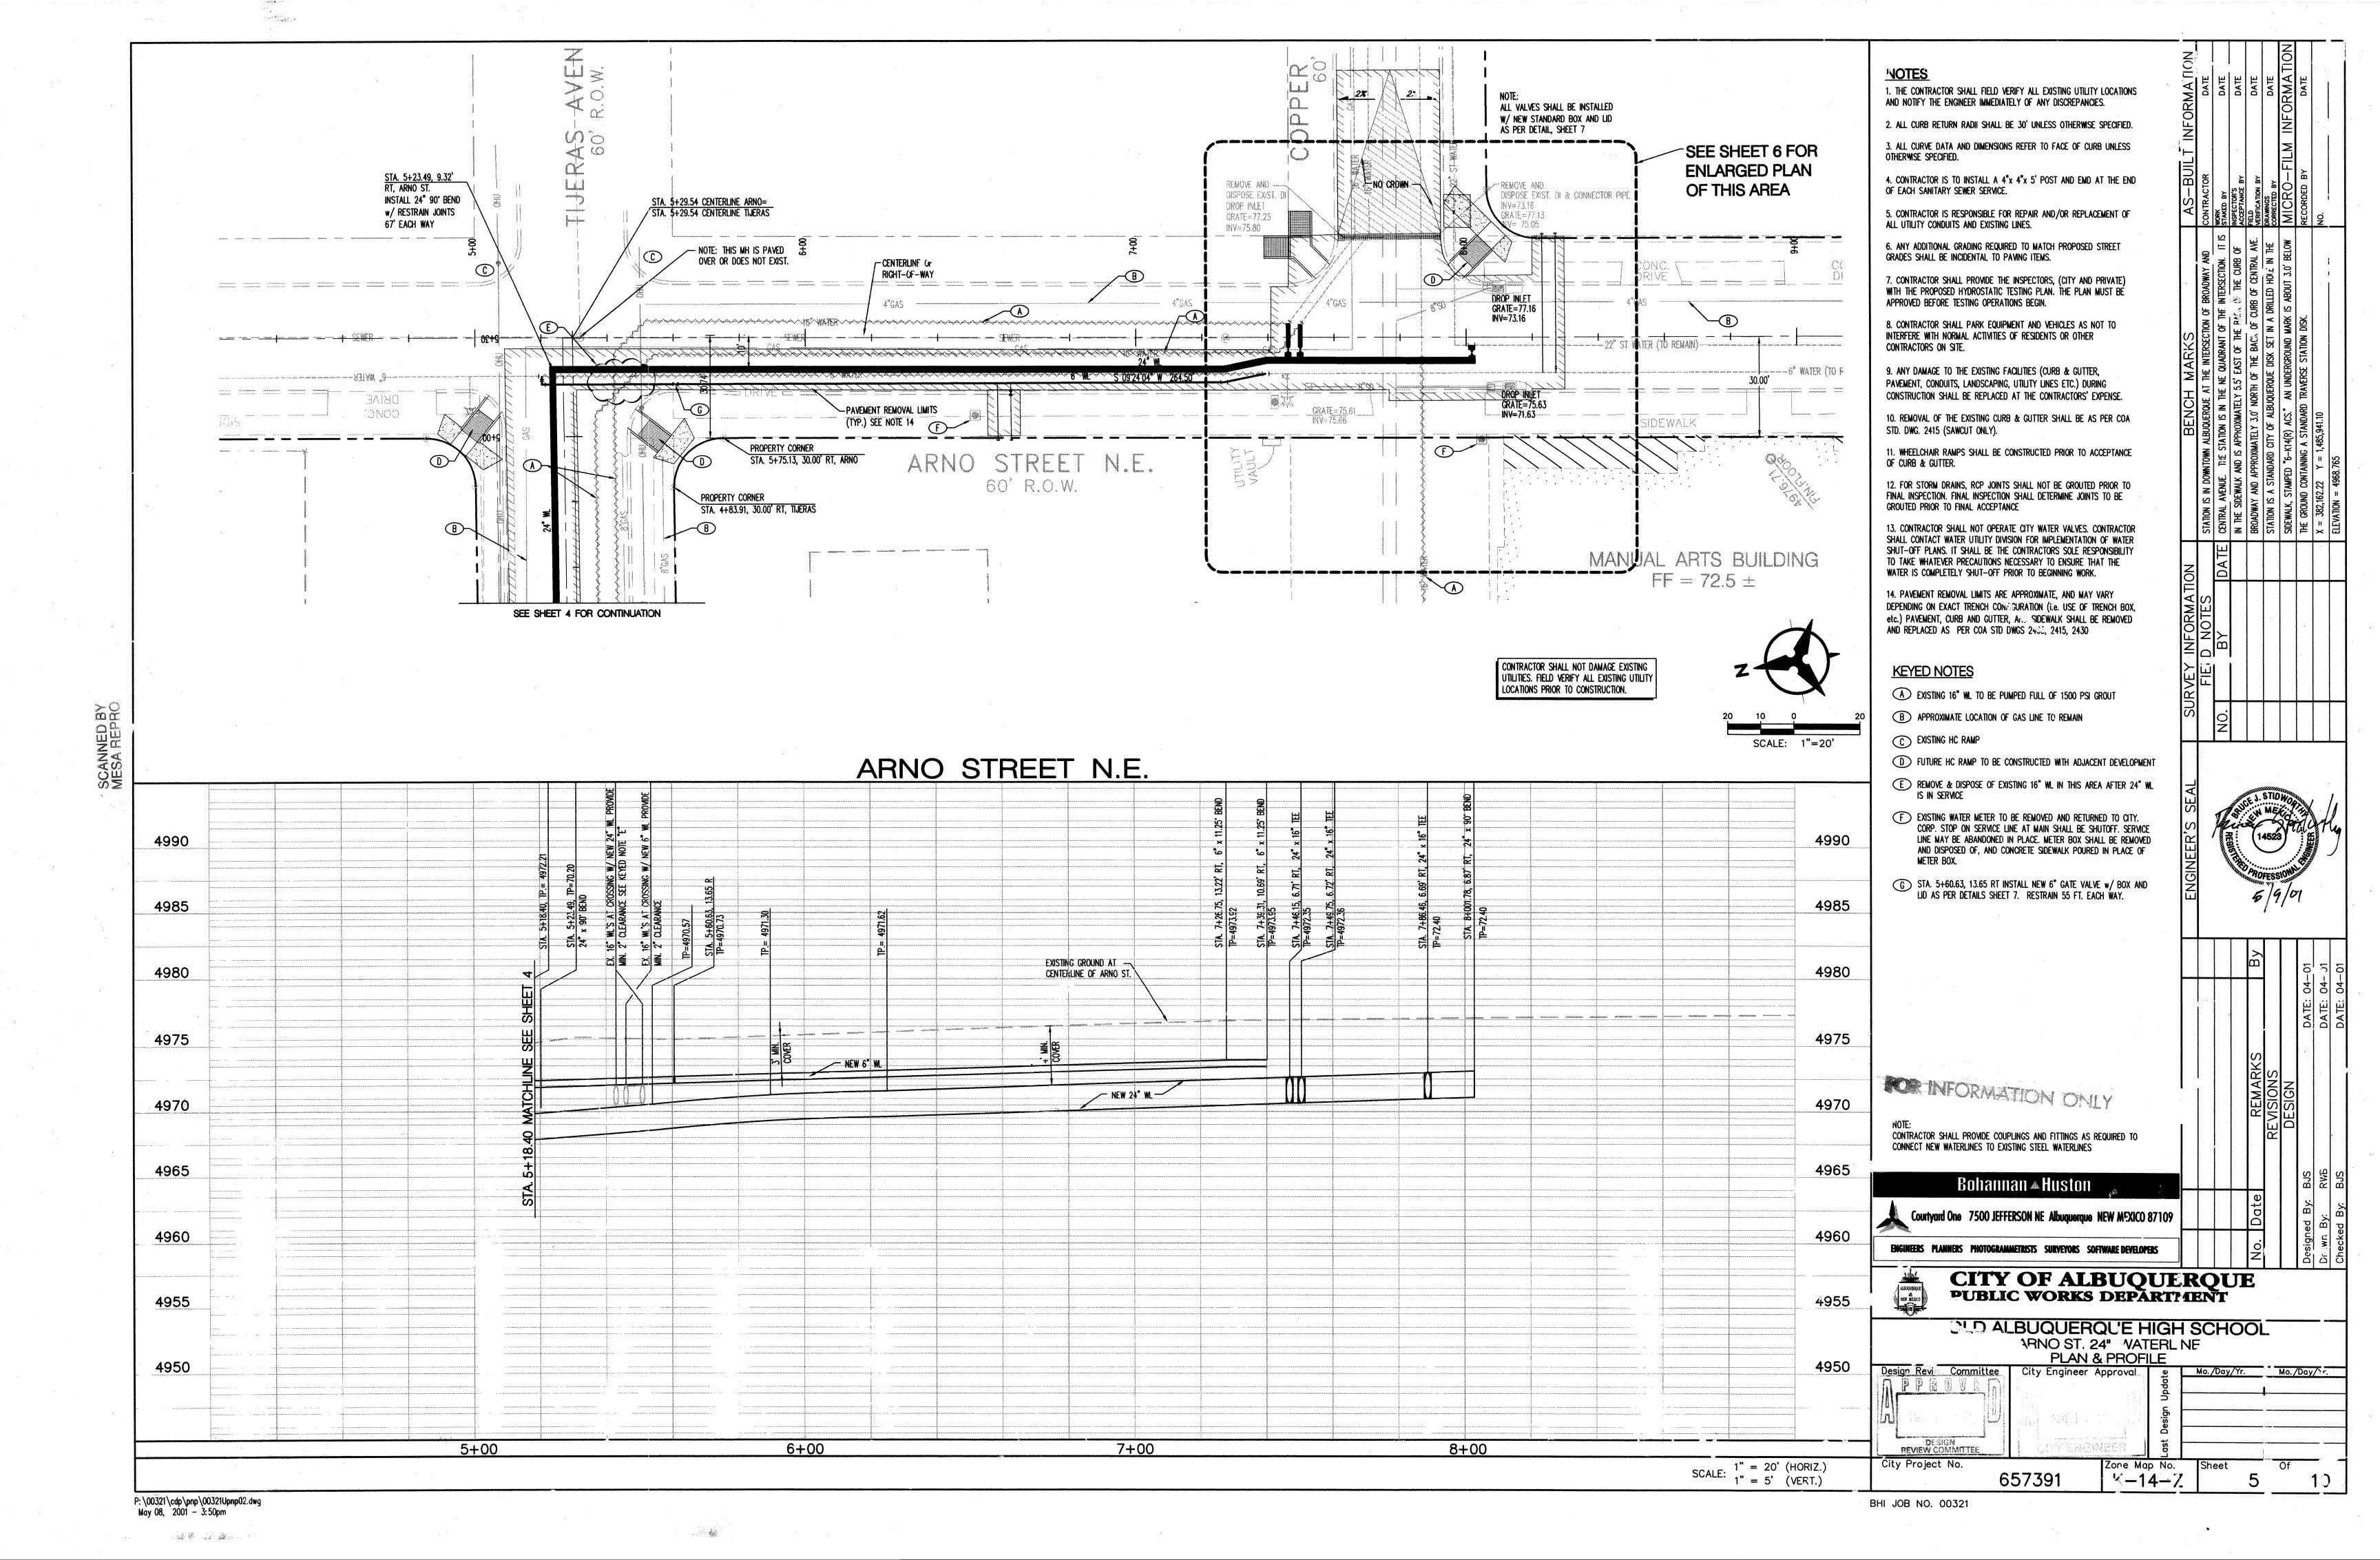

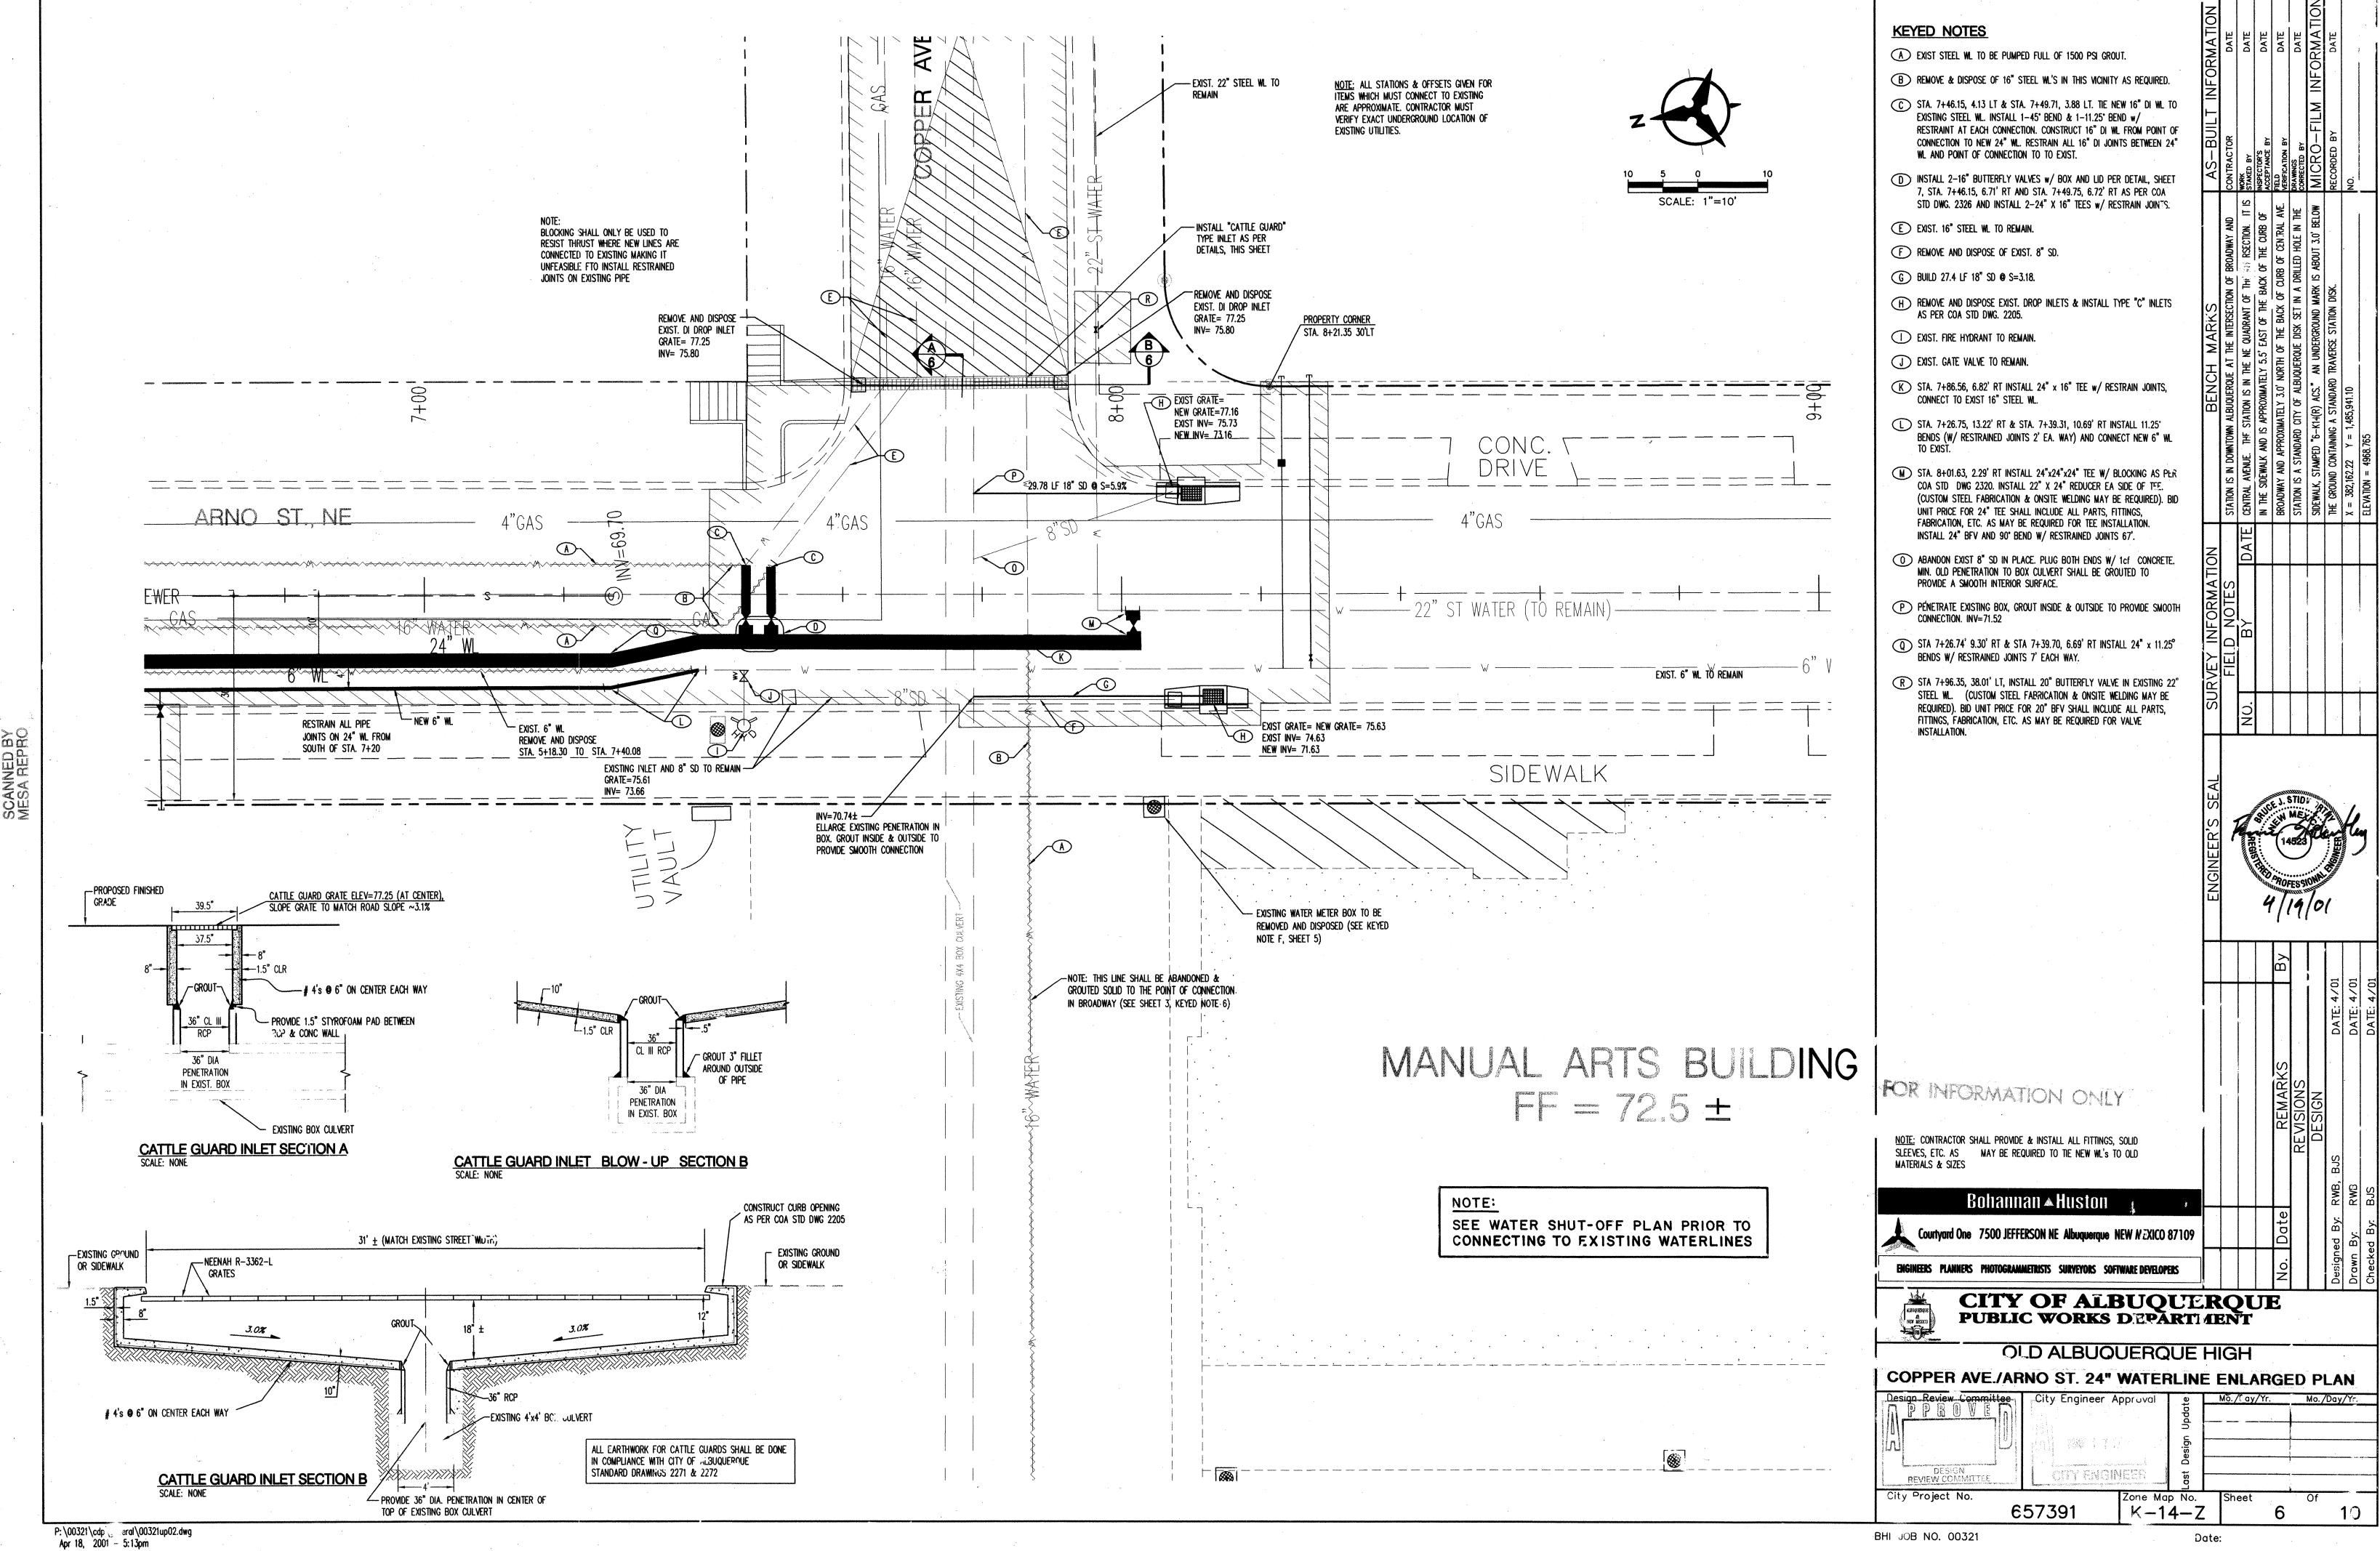

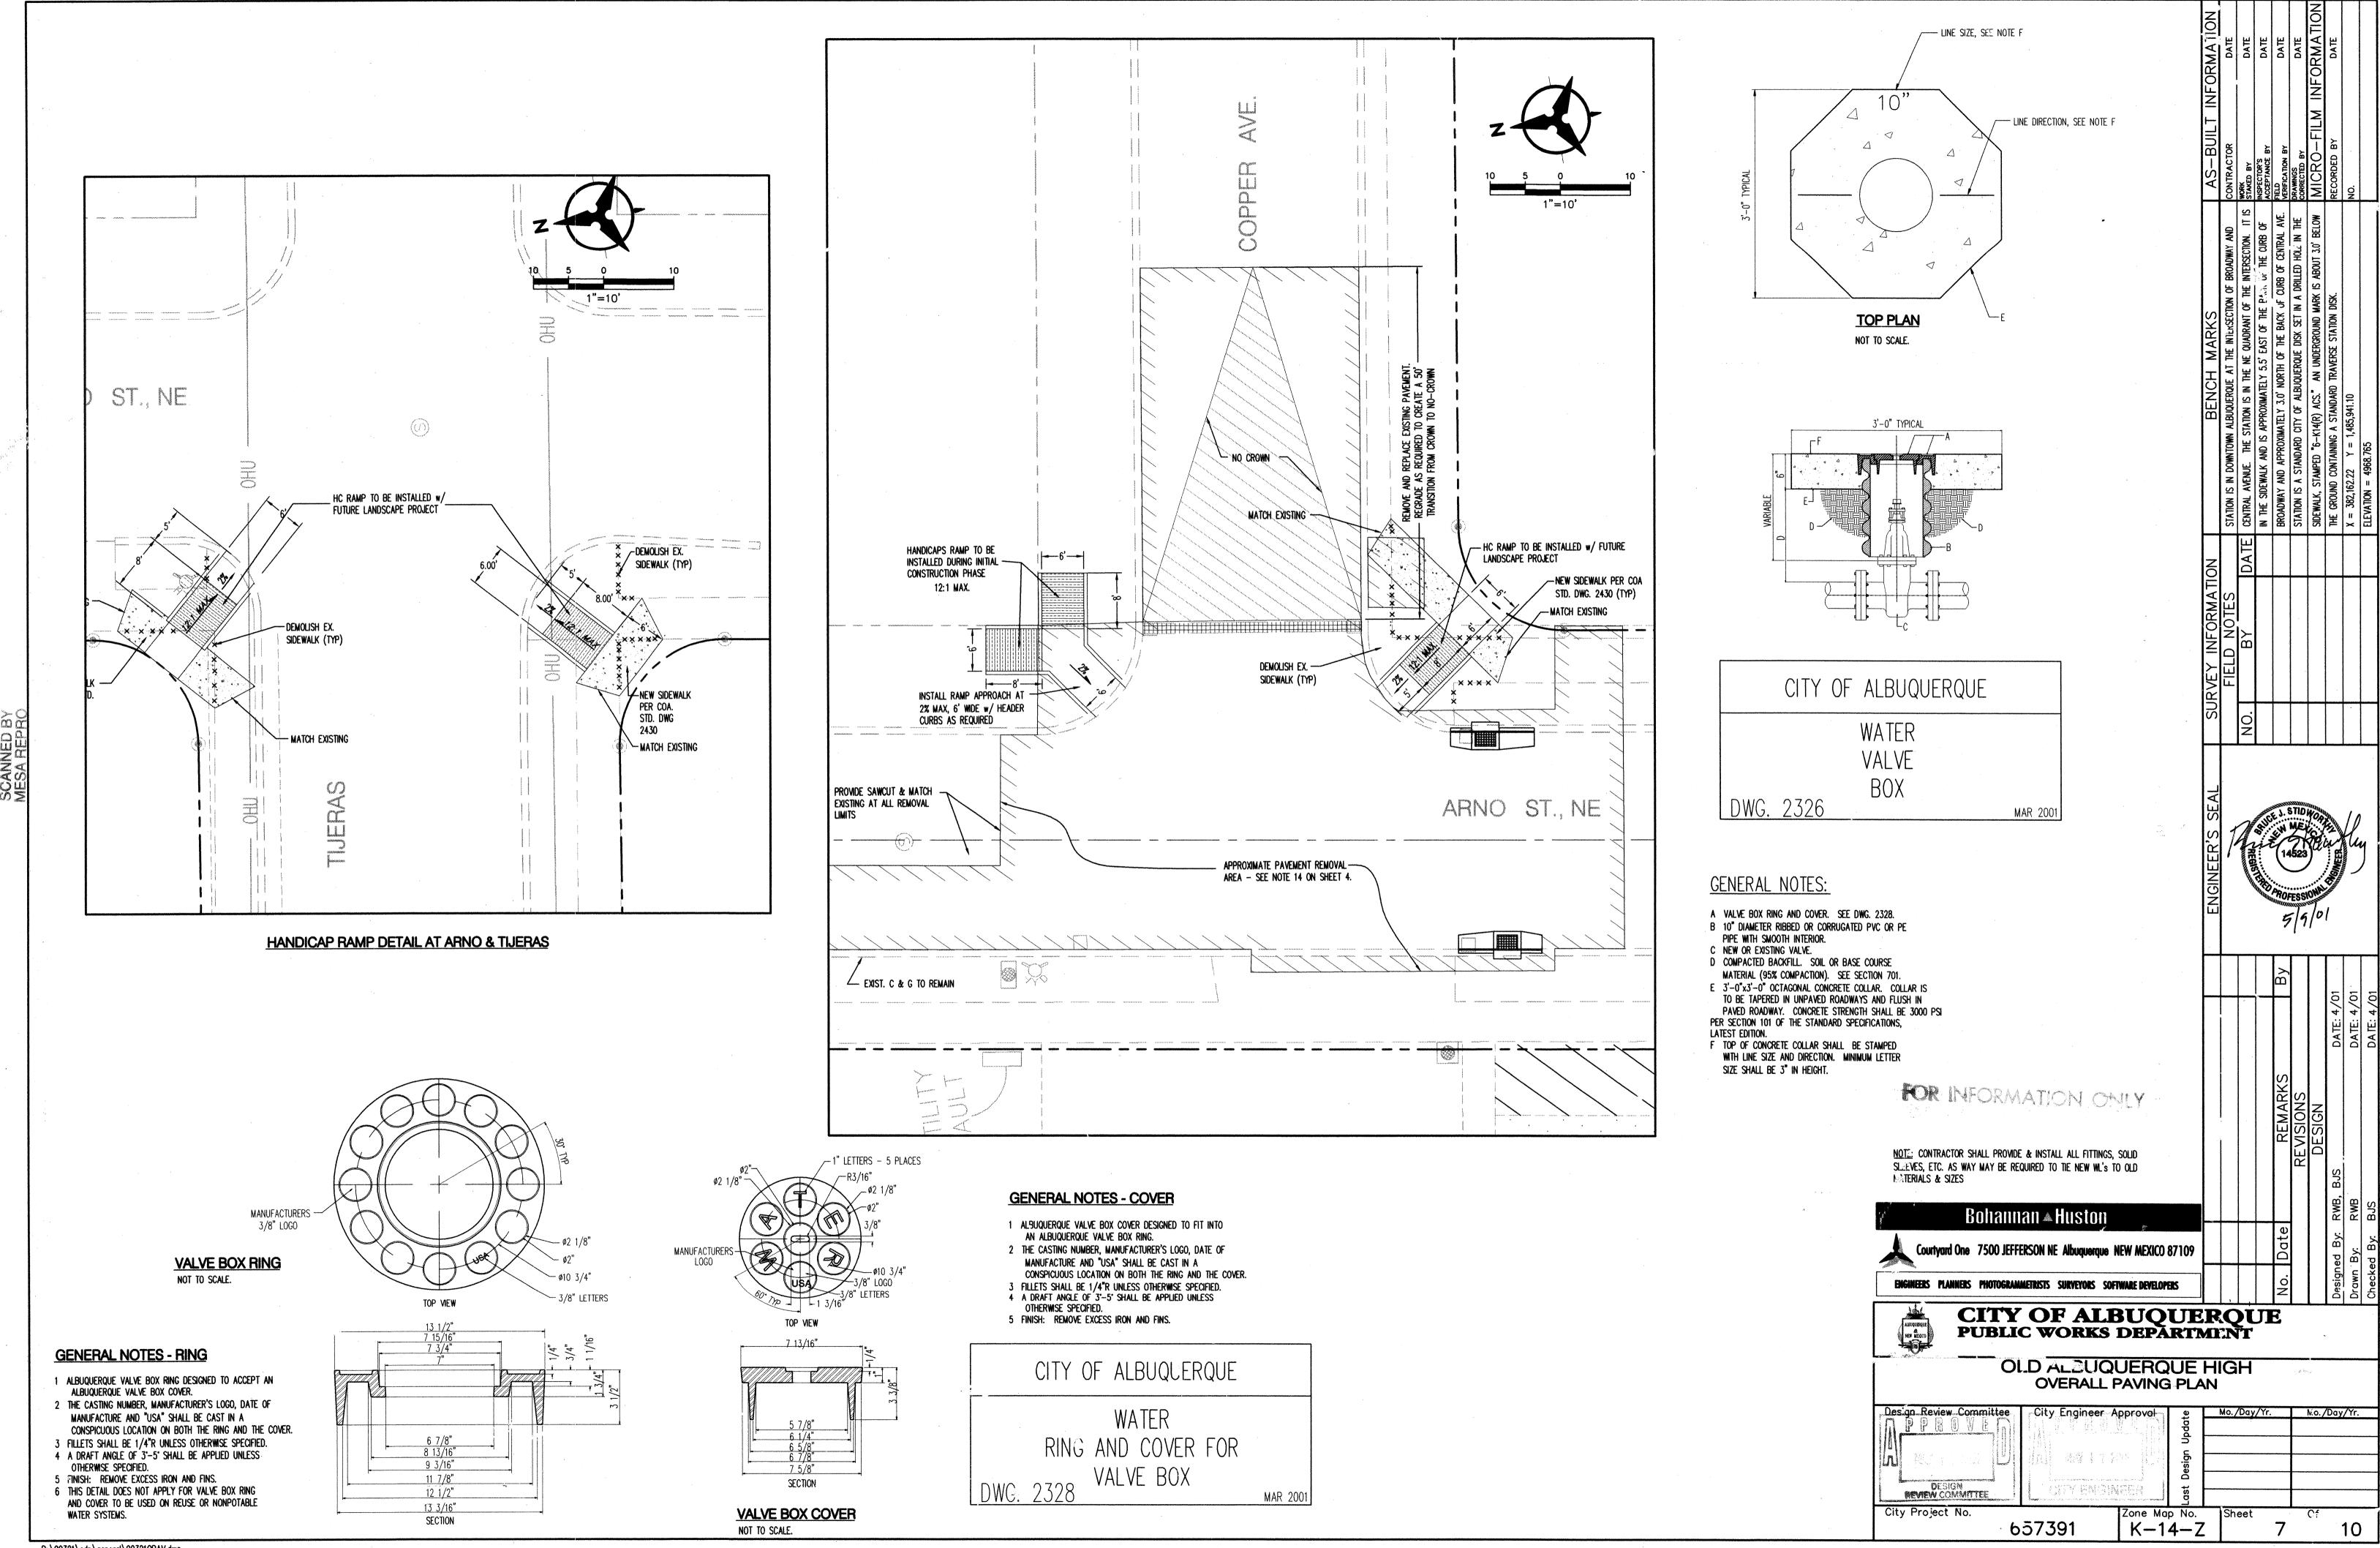

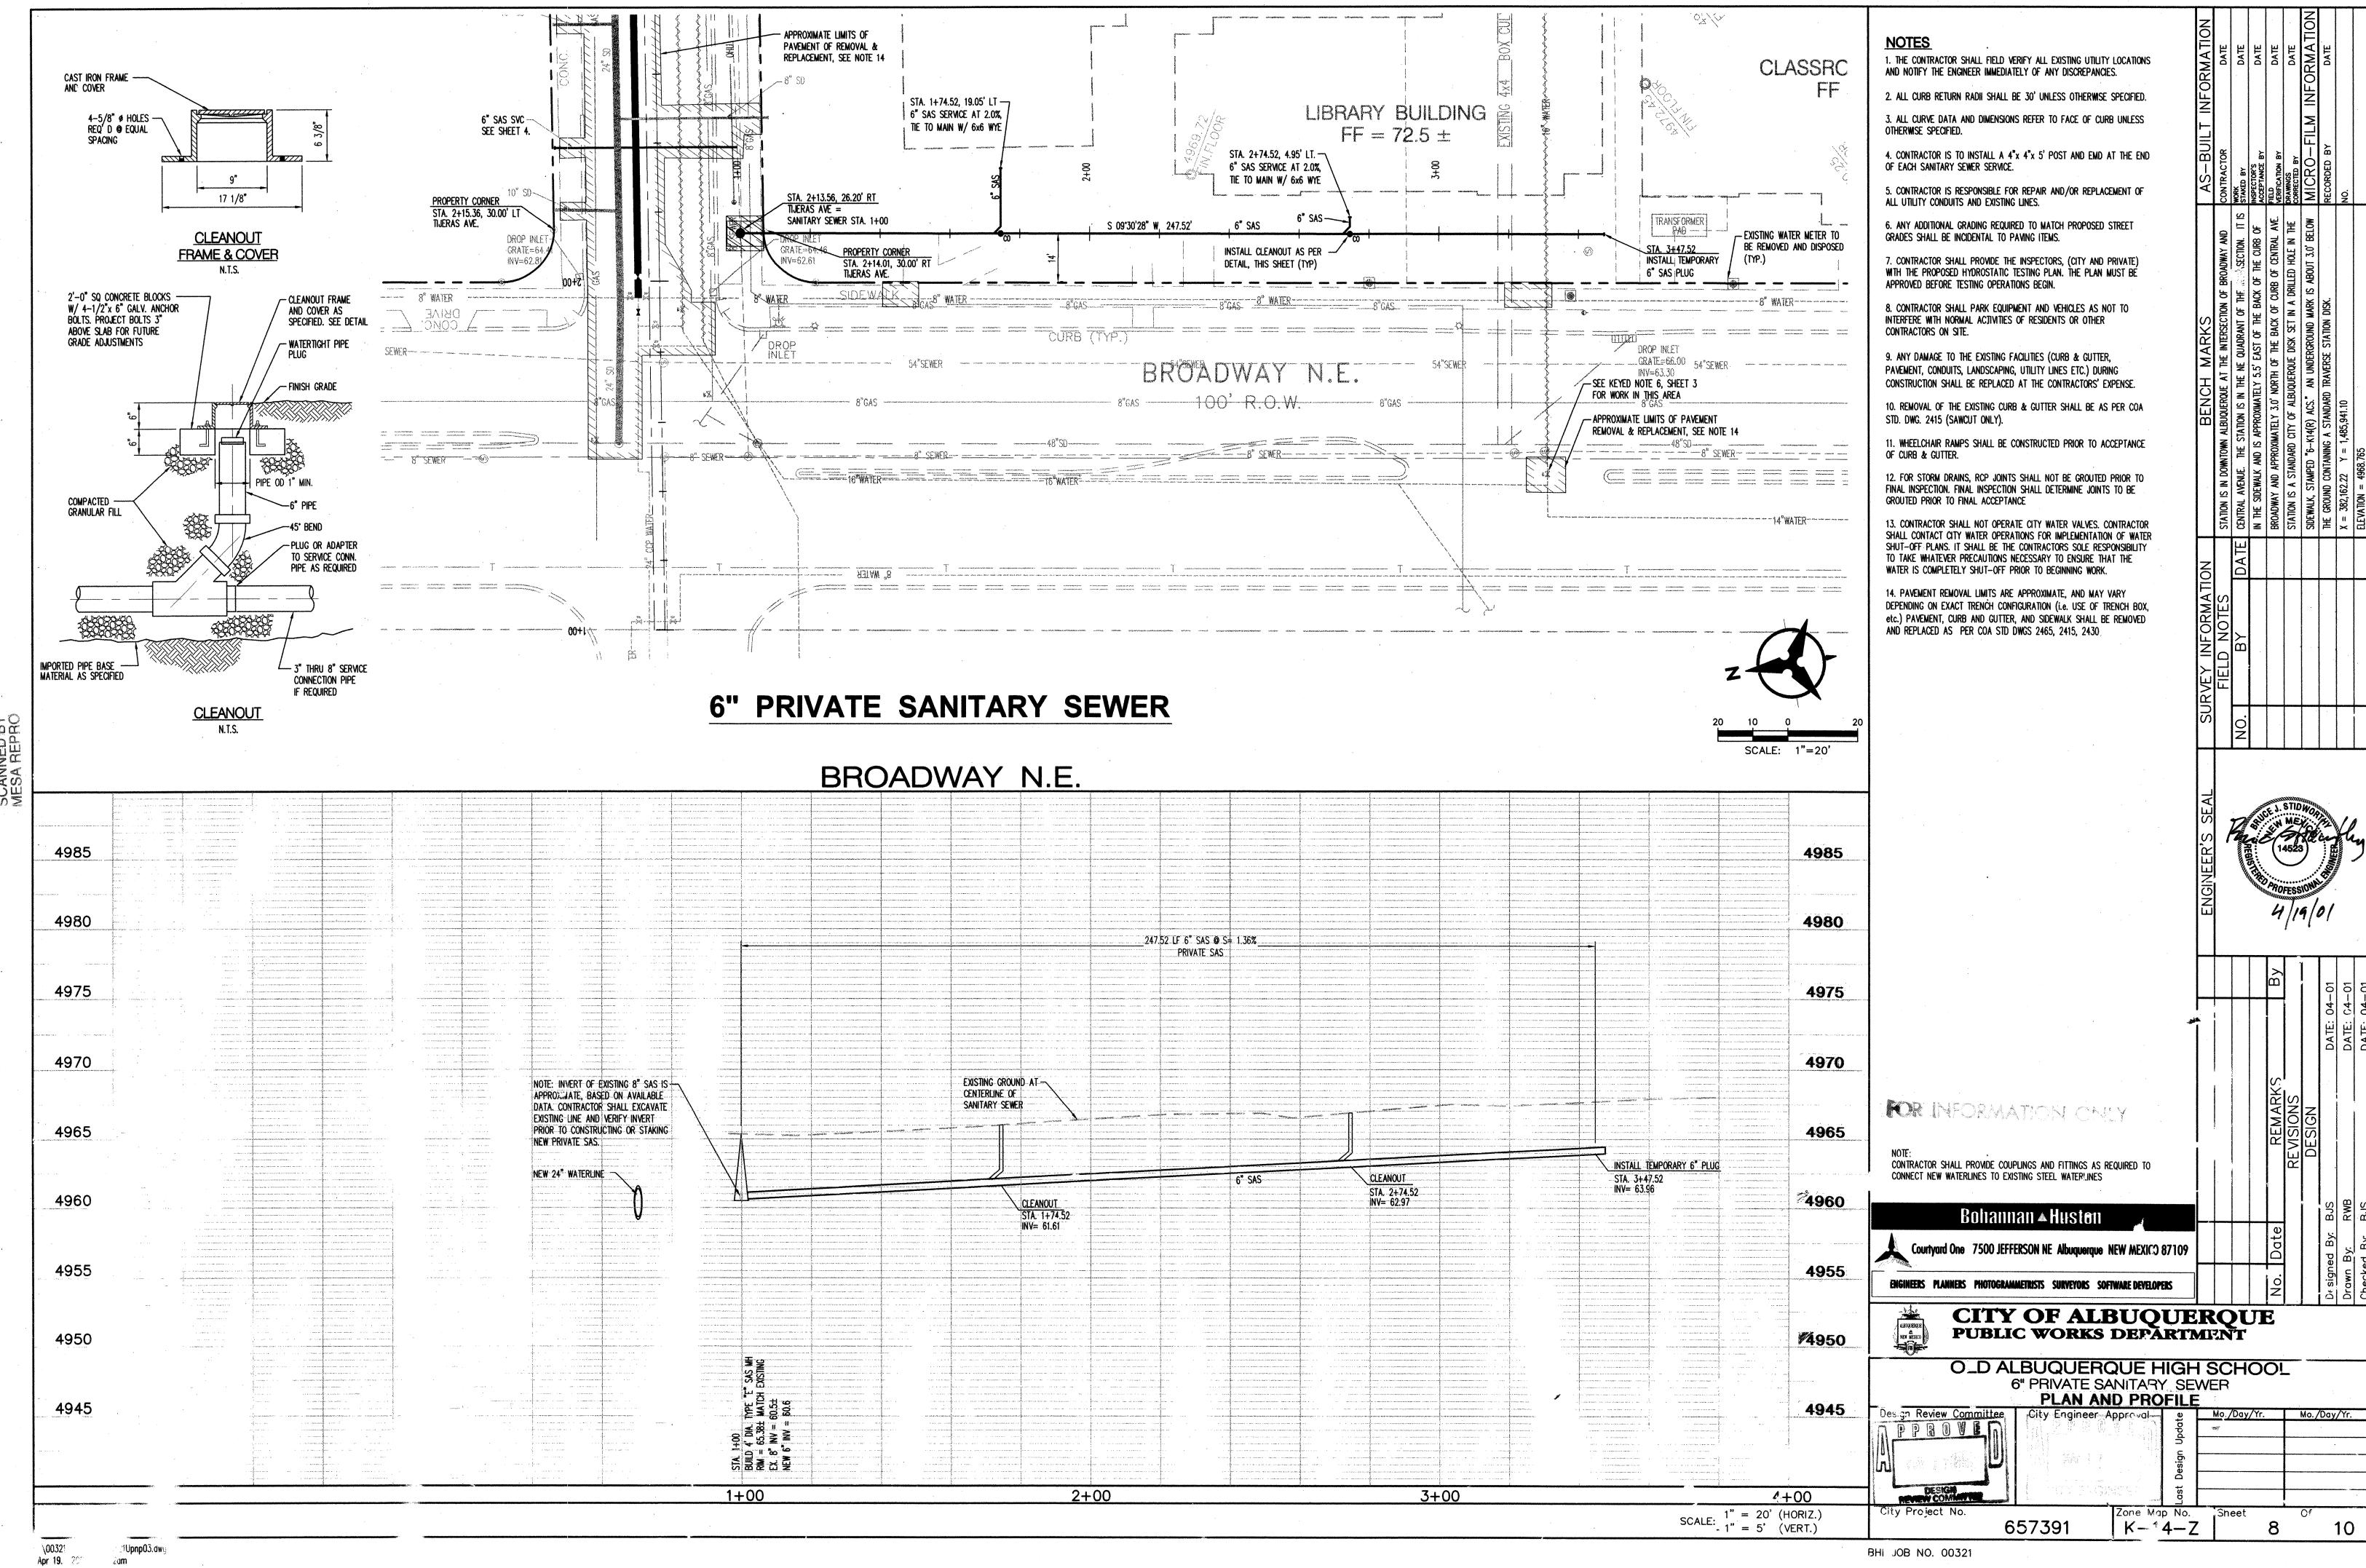



- 2. CONTRACTOR SHALL AT THE TIME OF PERMIT REQUEST, SUBMIT FOR APPROVAL BY CONSTRUCTION COORDINATION, A TRAFFIC CONTROL PLAN DETAILING ALL EXISTING TOPOGRAPHY SUCH AS LANE WIDTHS, DRIVEWAYS AND BUSINESS/RESIDENTIAL ACCESSES. THE TRAFFIC CONTROL PLAN SHALL INCLUDE ALL PHASES OF WORK AND SCHEDULES INVOLVED IN THE CONSTRUCTION PROJECT. ANY SEPERATE PHASES OF A CONSTRUCTION PROJECT SHALL BE GIVEN AN INDIVIDUAL PERMIT EACH. BLANKET PERMITS WILL NOT BE ISSUED.
- 3. THESE TYPICAL TRAFFIC CONTROL PLANS DO NOT REFLECT THE EXISTING TOPOGRAPHY SUCH AS DRIVEWAYS, LANE WIDTHS, AND BUSINESS/RESIDENTIAL ACCESSES. EVERY LOCATION THAT REQUIRES CONSTRUCTION TRAFFIC CONTROL SHALL HAVE A DETAILED TRAFFIC CONTROL PLAN SHOWING ALL EXISTING TOPOGRAPHY.
- 4. CONSTRUCTION SHALL NOT BEGIN UNLESS A TRAFFIC CONTROL PLAN HAS BEEN APPROVED AND VERIFIED BY CONSTRUCTION COORDINATION.
- 5. CONSTRUCTION COORDINATION SHALL BE NOTIFIED 48 HOURS PRIOR TO ANY TRAFFIC CONTROL CHANGES NEEDED BY CONTRACTOR, THAT WERE NOT PREVIOUSLY APPROVED. THESE TRAFFIC CONTROL CHANGES SHALL BE REQUESTED IN WRITING ACCOMPANIED WITH A TRAFFIC CONTROL PLAN REFLECTING SUCH CHANGES.
- 6. ALL CONSTRUCTION TRAFFIC CONTROL DEVICES SHALL COMPLY TO THE MANUAL ON UNIFORM TRAFFIC CONTROL DEVICES (MUTCD), LATEST EDITION. IT IS THE RESPONSIBILITY OF THE CONTRACTOR TO INSTALL, SERVICE AND MAINTAIN ALL TRAFFIC CONTROL DEVICES. TRAFFIC CONTROL DEVICES SHALL NOT BE REMOVED OR ALTERED IN ANY WAY WITHOUT THE APPROVAL OF CONSTRUCTION COORDINATION, PER SECTION 6A-4 OF THE MUTCD, LATEST EDITION.
- 7. THE CONSTRUCTION TRAFFIC CONTROL INITIAL SET-UP SHALL BE BY AN AMERICAN TRAFFIC SAFETY SERVICES ASSOCIATION (ATSSA) CERTIFIED WORKSITE TRAFFIC SUPERVISOR. THE MAINTENANCE AND SERVICING SHALL ALSO BE DONE BY AN ATSSA CERTIFIED WORKSITE TRAFFIC SUPERVISOR OR EQUIVALENT.
- 8. CONTRACTOR IS RESPONSIBLE TO MAINTAIN AND SERVICE ALL TRAFFIC CONTROL DEVICES 24 HOURS A DAY, 7 DAYS A WEEK THROUGHOUT LENGTH OF PROJECT. CONTRACTOR IS RESPONSIBLE THAT ALL TRAFFIC CONTROL DEVICES COMPLY WITH THE MUTCD, LATEST EDITION.
- 9. ALL ADVANCE WARNING SIGNS SHALL BE DOUBLE INDICATED WHENEVER THERE ARE MULTI-LANE TRAFFIC IN ANY ONE GIVEN DIRECTION AND THERE IS SUFFICIENT MEDIAN SPACE.
- 10. ALL BARRICADES IN ALL TAPERS AND TANGENTS SHALL BE PLACED APART, A DISTANCE MEASURED IN FEET, EQUAL TO THAT OF THE POSTED SPEED LIMIT. NO EXCEPTIONS UNLESS APPROVED BY CONSTRUCTION COORDINATION PER MUTCD SECTION 6A-4.
- 11. ALL WORK IN ARTERIAL ROADWAYS SHALL BE ON A CONTINUOUS 24 HOUR PER DAY BASIS UNTIL COMPLETED.
- 12. CONTRACTOR IS RESPONSIBLE TO PROVIDE CONSTRUCTION COORDINATION, A WEEKLY LOG OF DAILY INSPECTIONS OF BARRICADE AND MAINTENANCE SCHEDULES ON PROJECTS THAT ARE OVER ONE WEEK DURATION.
- 13. EQUIPMENT OR MATERIALS SHALL NOT BE STORED WITHIN 15 FEET OF A TRAVELED TRAFFIC LANE DUTING NON-WORKING HOURS WITHOUT THE APPROVAL OF CONSTRUCTION COORDINATION.
- 14. CCNTRACTOR SHALL PROVIDE AND MAINTAIN A SAFE AND ADEQUATE MEANS OF CHANNEL'ZING PEDESTRIAN TRAFFIC AROUND AND THROUGH THE CONSTRUCTION AREA.
- 15. CONTRACTOR IS RESPONSIBLE FOR OBLITERATION OF ANY CONFLICTING STRIPING AND RESPONSIBLE FOR ALL TEMPORARY STRIPING.
- 16. CONTRACTOR SHALL MAINTAIN ACCESS TO ALL FACILITIES, BUSINESSES AND/OR RESIDENTS AT ALL TIMES.
- 17. CONTRACTOR SHALL PROVIDE ACCESS SIGNS FOR BUSINESSES LOCATED WITHIN THE CONSTRUCTION AREA UNDER THE SUPERVISION OF CONSTRUCTION COORDINATION. EACH ACCESS SIGN SHALL HAVE 5 INCH, WHITE OPAQUE LETTERING ON BLUE REFLECTORIZED BACKGROUND. ACCESS SIGNS SHALL BE CONSIDERED INCIDENTAL TO THE BID AND NOT PART OF THE CONTRACT UNLESS OTHERWISE STATED. NO MORE THAN 3 BUSINESSES SHALL BE LISTED ON A ACCESS SIGN. SHOPPING CENTERS AND MALLS SHALL BE LISTED AS SUCH.
- 18. ALL ADVANCE WARNING SIGNS SHALL MEET THE MINIMUM REFLECTIVE INTENSITY REQUIREMENTS SET FORTH BY THE CITY OF ALBUQUERQUE. CONSTRUCTION COORDINATION SHALL DETERMINE ALL REQUIREMENTS AND APPROVE OR DISAPPROVE ANY ADVANCE WARNING SIGN PER SECTION 6A-4 OF THE MUTCD, LATEST EDITION.
- 2 19. 48 HOURS PRIOR TO OCCUPYING OR CLOSING OF A RIGHT-OF-WAY, CONTRACTOR SHALL NOTIFY: POLICE, FIRE DEPARTMENT, SCHOOLS. HOSPITALS, TRANSIT AUTHORITY, BUSINESSES AND/OR RESIDENTS THAT WILL BE AFFECTED BY THE CONSTRUCTION.
- 20. ANY FIELD ADJUSTMENTS SHALL BE APPROVED BY CONSTRUCTION COORDINATION.


- 21. EXCAVATIONS SHALL BE PLATED, TEMPORARILY PATCHED OR RESURFACED PRIOR TO OPENING OF TRAFFIC. A MINIMUM OF 11 FEET SHALL BE PROVIDED FOR TRAFFIC IN ANY GIVEN DIRECTION. CONTRACTOR IS RESPONSIBLE FOR ANY WORK INVOLVED IN SATISFYING THESE REQUIREMENTS.
- 22. CONTRACTOR SHALL AT ALL TIMES COMPLY WITH THE FOLLOWING: 1. STANDARDS AND REQUIREMENTS SET FORTH IN THE MANUAL ON UNIFORM TRAFFIC CONTROL DEVICES, LATEST EDITION. 2. THE CITY OF ALBUQUERQUE TRAFFIC CODE, LATEST EDITION. SECTION 19 OF THE CITY OF ALBUQUERQUE'S STANDARD SPECIFICATIONS FOR PUBLIC WORK CONSTRUCTION, AS WELL AS OTHER
- 23. FAILURE TO COMPLY WITH ANY OF THE ABOVE MENTIONED, WILL BE ADEQUATE CAUSE TO CEASE ALL WORK ON ANY CONSTRUCTION PROJECT. WORK WILL NOT RESUME UNTIL ALL REQUIREMENTS ARE ADDRESSED AND APPROVED BY CONSTRUCTION COORDINATION.
- 24. ALL TRAFFIC CONTROL DEVICES SHALL BE KEPT IN NEW-CLEAN CONDITION, WASHING OF EQUIPMENT IS INCIDENTAL TO IT'S PLACEMENT AND MAINTENANCE.
- 25. TRAFFIC CONTROL STANDARDS APPLY ONLY WHERE THE CONSTRUCTION TRAFFIC CONTROL PLANS ARE NOT SPECIFIC.
- $\frac{\sqrt{3}}{3}$ 26. ADVANCE WARNING SIGNS SHALL BE 36"x36" MIN. WITH SUPER ENGINEERING GRADE SHEETING OR BETTER. MOUNTING HEIGHT AT TOP OF SIGN SHALL BE THE SAME AS FOR A 48" SIGN AS INDICATED IN THE M.U.T.C.D.
- 4 27. CONTRACTOR SHALL MAINTAIN A GRAFFITI-FREE WORKSITE. ALL GRAFFITI SHALL BE PROMPTLY REMOVED FROM ALL EQUIPTMENT, BOTH PERMANENT AND TEMPORARY.


SPECIAL PROJECT TRAFFIC CONTROL NOTES


- 1. NO LANE CLOSURES WILL BE ALLOWED ON BROADWAY BLVD. ON MONDAY THROUGH FRIDAYS FROM 6:00 AM TO 6:00 PM
- 2. AT LEAST ONE LANE OF TRAFFIC ON NORTHBOUND BROADWAY BLVD. MUST BE MAINTAINED AT ALL TIMES
- 3. NO TRAFFIC SPLITS WILL BE ALLOWED ON BROADWAY BLVD
- 4. ALL LANE CLOSURES ON BROADWAY BLVD. AND CENTRAL AVENUE ARE SUBJECT TO ARTERIAL ROAD USAGE FEES OF \$0.01 PER SQUARE FOOT OF BARRICADED AREA PER DAY.

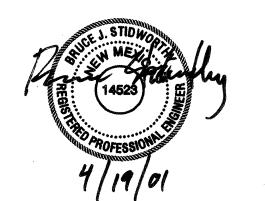

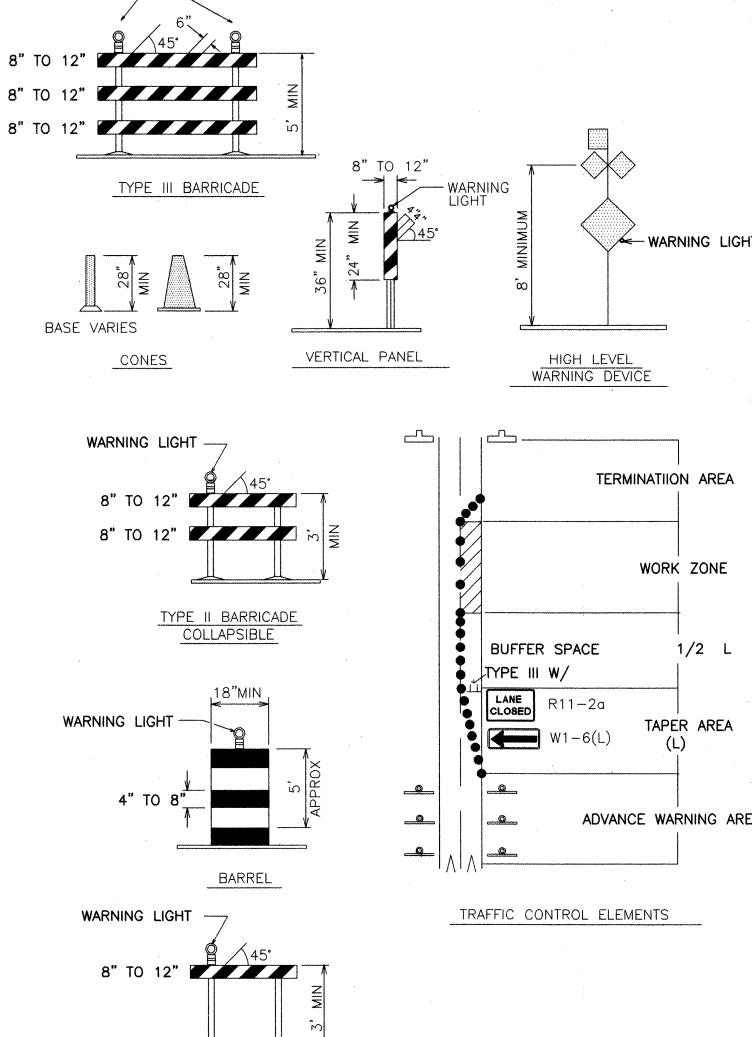

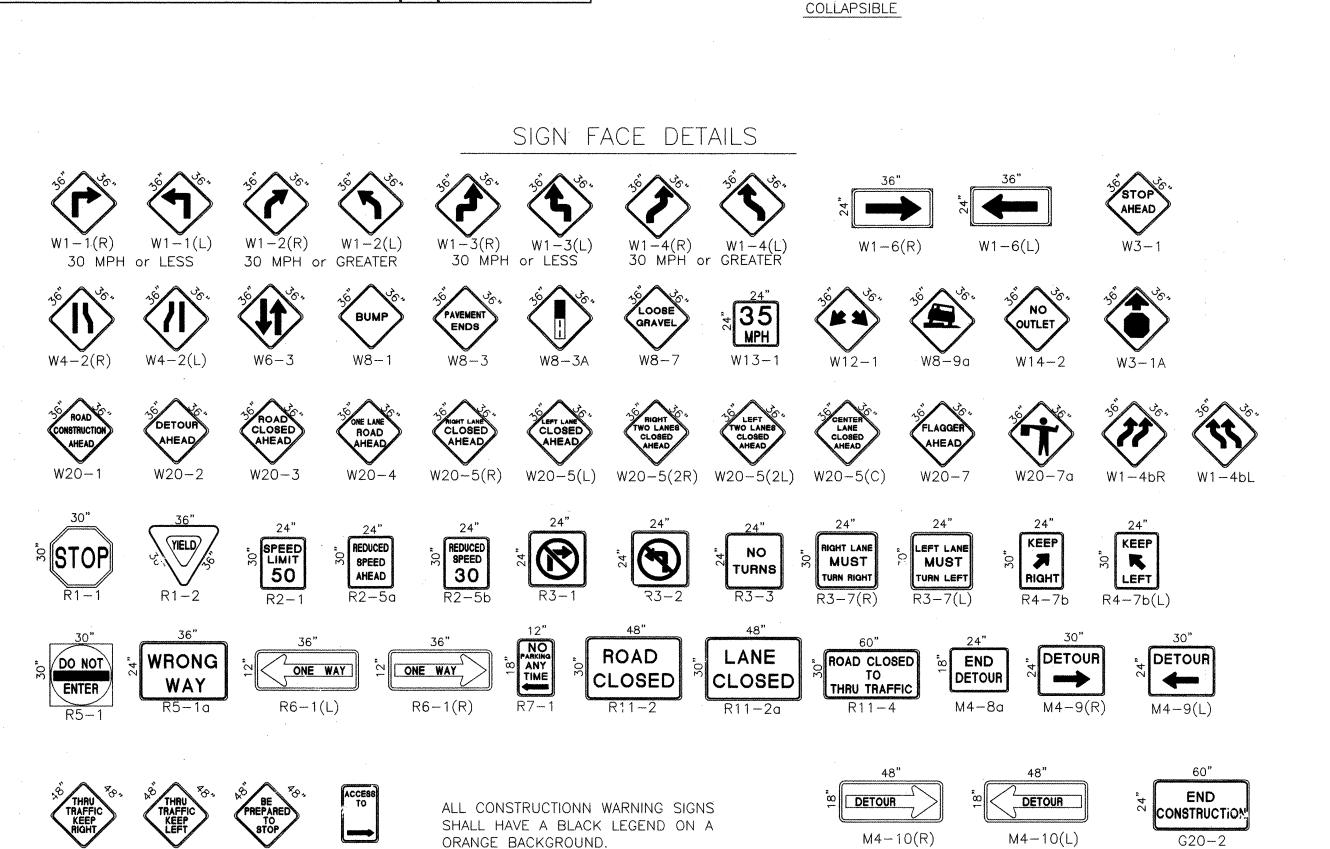

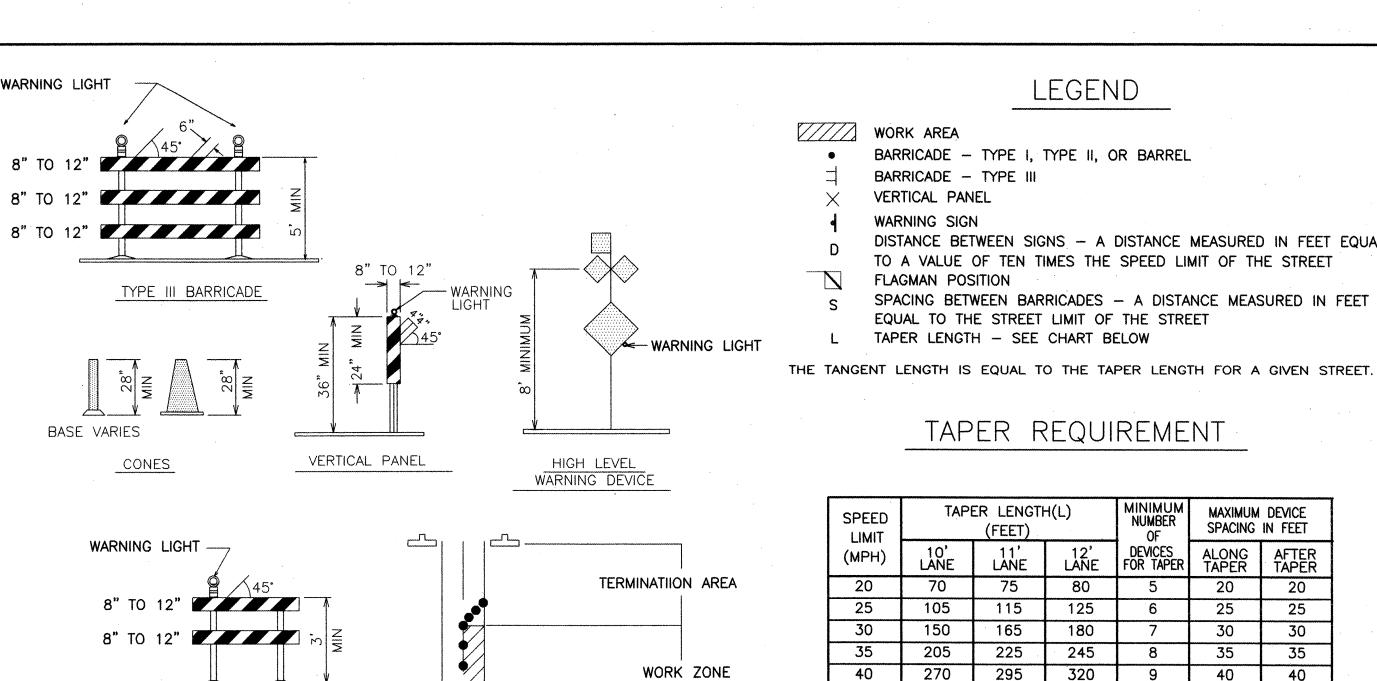

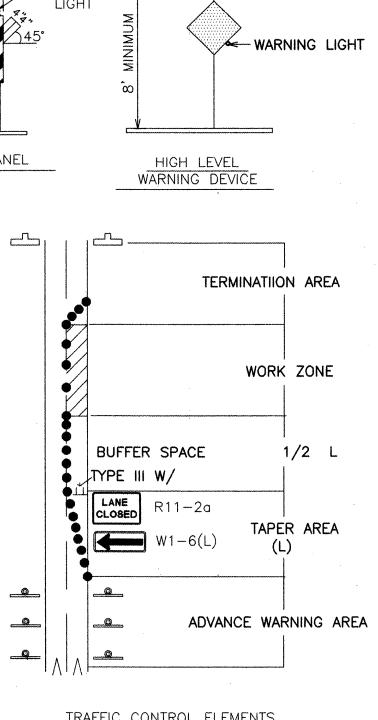

RECOMMENDED SIGN SPACING(D) FOR ADVANCE WARNING SIGN SERIES

SPEED MILES PER HOUR		MINIMUM DISTANCE IN FEET BETWEEN FROM LAST SIGNS SIGN TO TAPE			AST
0-20 25-30 30-35 40-45 50-60	10 X 10 X 10 X	SPEED LI SPEED LI SPEED LI		SPEED SPEED SPEED	LIMIT LIMIT LIMIT


TAPER CRITERIA

TYPE OF TAPER	TAPER LENGTH
UPSTREAM TAPER:	
MERGING TAPER	L MINIMUM
SHIFTING TAPER	1/2 L MINIMUM
SHOULDER TAPER	1/2 L MINIMUM
TWO-WAY TRAFFIC TAPER	100 FEET MAXIMUM
DOWNSTREAM TAPEPS	100 FEET PER LANE


TAPER LENGTH COMPUTATION

SPI	EED L		•				
40			LESS	L	=	<u>WS</u>	2
40	мРН	OR	GREATER	L	==	W	X

L = TAPER LENGTH W = WIDTH OF OFFSET IN FEET

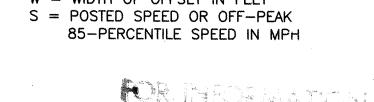

 $L = W \times S$

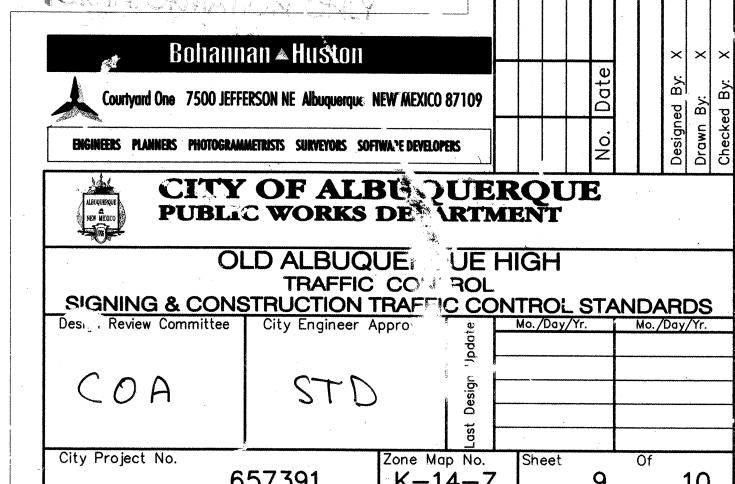

TYPE I BARRICADE

TAPER REQUIREMENT

DISTANCE BETWEEN SIGNS - A DISTANCE MEASURED IN FEET EQUAL

SPACING BETWEEN BARRICADES - A DISTANCE MEASURED IN FEET

TO A VALUE OF TEN TIMES THE SPEED LIMIT OF THE STREET

LEGEND

BARRICADE - TYPE I, TYPE II, OR BARREL

EQUAL TO THE STREET LIMIT OF THE STREET

TAPER LENGTH - SEE CHART BELOW

165

225

295

495

550

605

WORK AREA

BARRICADE - TYPE III

VERTICAL PANEL

WARNING SIGN

SPEED

LIMIT

(MPH)

25

30

50

FLAGMAN POSITION

105

150

205

270

450

500

550

TAPER LENGTH(L) MAXIMUM DEVICE NUMBER SPACING IN FEET (FEET) DEVICES FOR TAPER 11' LANE 75 80 20 115 125

180

245

320

540

600

660

20 25 25 30 35 35 40 13 45 50 13 13 55

657391 K-14-Z

