2 3 4 5 6 7 8 9 10 11 12 13 14 15

SCANNED BY PLANNING

CONSTRUCTION PLANS FOR

TIMARRON WEST UNIT 4 SUBDIVISION

ALBUQUERQUE, NEW MEXICO

INDEX		PAV	ING PLANS	UTILIT	Y PLANS
SHEET NUMBER	DESCRIPTION	SHEET NUMBER	DESCRIPTION	SHEET NUMBER	DESCRIPTION
1	COVER SHEET	5	RED ROBIN ROAD	11	RED ROBIN ROAD
2	PLAT	6	TEAL ROAD/ BLACKBIRD DRIVE	12	TEAL ROAD/BLACKBIRD DRIVE
3A-3B	GRADING PLAN & DETAILS	7	WOODDUCK DRIVE	13	WOODDUCK DRIVE/ PARK STORM DRAIN
4	OVERALL PAVING PLAN	8	MACAW DRIVE/ STARLING ROAD	14	MACAW DRIVE/ STARLING ROAD
5-9	PAVING PLAN AND PROFILE SHEETS	9	114TH STREET		
10	OVERALL UTILITY PLAN		1 .		
11-14	UTILITY PLAN AND PROFILE SHEETS		e e e e e e e e e e e e e e e e e e e		
15	PAVING SECTIONS & DETAILS				

CONSTRUCTION NOTES:

16

17,18

1. THE CONTRACTOR SHALL ABIDE BY ALL LOCAL, STATE, AND FEDERAL LAWS, RULES AND REGULATIONS WHICH APPLY TO THE CONSTRUCTION OF THESE IMPROVEMENTS.

MISCELLANEOUS DETAILS

TRAFFIC CONTROL SHEETS

2. PRIOR TO CONSTRUCTION SHALL EXCAVAITE AND VERIFY THE HORIZONTAL AND VERTICAL LOCATIONS OF ALL POTENTIAL OBSTRUCTIONS. SHOULD A CONFLICT EXIST, THE CONTRACTOR SHALL NOTEY THE ENONEER OF CONSTRUCTION OBSERVER SO THAT THE CONFLICT CAN BE RESCLYED WITH A MINIMUM AMOUNT OF DELAY.

3. ALL ELECTRICAL, TELEPHONE, CABLE TV, GAS AND OTHER UTILITY LINES, CABLES AND APPURTENANCES ENCOUNTERED DURING CONSTRUCTION THAT REQUIRE RELOCATION, SHALL BE COORDINATED WITH THAT UTILITY. THE CONTRACTOR SHALL BE RESPONSIBLE FOR COORDINATION OF ALL NECESSARY UTILITY ADJUSTMENTS. NO ADDITIONAL COMPENSATION WILL BE ALLOWED FOR DELAYS OR INCONVENIENCES CAUSED BY UTILITY COMPANY WORK CREWS. THE CONTRACTOR MAY BE REQUIRED TO RESCHEDULE HIS ACTIVITIES TO ALLOW UTILITY CREWS TO PERFORM THEIR

4. DISPOSAL SITE FOR ALL EXCESS EXCAVATION MATERIAL, AND LINSUITARIE MATERIAL SHALL RE OBTAINED BY THE CONTRACTOR IN COMPULANCE WITH APPLICABLE ENVIRONMENTAL REQUATIONS AND APPROVED BY THE CONSTRUCTION OBSERVER. ALL COSTS INCURRED IN OBTAINING A DISPOSAL SITE AND HAUL FIRERTID SHALL BE CONSDERED INCODERTAL TO THE PROJECT AND NO SERVER.

- 5. THE CONTRACTOR IS RESPONSIBLE FOR PROTECTING THE EXISTING UTILITY LINES WITHIN THE CONSTRUCTION AREA. ANY DAMAGE TO EXISTING FACILITIES CAUSED BY CONSTRUCTION ACTIVITY SHALL BE REPAIRED OR REPLACED AT THE CONTRACTOR'S EXPENSE AND APPROVED BY THE
- 6. Construction activity shall be limited to the property and/or project limits, any damage to adjacent properties resulting from the construction process is the responsibility of the contractor, any costs incurred for repairs shall be the cost
- 7. OVERNICHT PARKING OF CONSTRUCTION EQUIPMENT SHALL NOT OBSTRUCT DRIVEWAYS OR DESIGNATED TRAFFIC LANES. THE CONTRACTOR SHALL NOT STORE ANY EQUIPMENT OR MATERIAL WITHIN THE PUBLIC RICHT-OF-WAY.
- 8. THE CONTRACTOR SHALL OBTAIN ALL THE NECESSARY PERMITS FOR THE PROJECT PRIOR TO COMMENCING CONSTRUCTION (I.E. BARRICADING, SURFACE DISTURBANCE)
- 9. THE CONTRACTOR SHALL BE RESPONSIBLE TO REPLACE AT HIS EXPENSE ANY AND ALL PROPERTY CORNERS DESTROYED DURING CONSTRUCTION. ALL PROPERTY CORNERS MUST BE RESET BY A REGISTERED LAND SURVEYOR.
- 10. ALL PERMANENT PAVEMENT MARKING AND TRAFFIC SIGNING SHALL BE FURNISHED BY THE CONTRACTOR PER PLAN.

- 11. THE CONTRACTOR SHALL FOLLOW THE CONSTRUCTION TRAFFIC CYCUTECL AND SIGNING PLAN PROVIDED HEREIN. THE CONTRACTOR SHALL COORDINATE WITH THE CITY OF ALBUQUEROUE, TRAFFIC ENGINEERING DEPARTMENT, PRIOR TO BEGINNING ANY CONSTRUCTION WORK ON ADJACENT TO EXISTING STREETS.
- THE "MANUAL OF UNIFORM TRAFFIC CONTROL DEVICES" (MUTCD), U.S. DEPARTMENT OF TRANSPORTATION, LATEST EDITION.
- 13. THE CONTRACTOR SHALL MAINTAIN ALL CONSTRUCTION BARRICADES AND SIGNING AT ALL TIMES. THE CONTRACTOR SHALL VERIFY THE PROPER LOCATION OF ALL BARRICADING AT THE END AND BEGINNING OF EACH DAY.
- 14. ALL SAWOUT PAVEMENT SHALL HAVE A UNIFORM EDGE AND BE SPRAYED WITH TACK.
- EXISTING PAVEMENT ADJACENT TO THE CURB AND GUTTER SHALL BE SAWCUT, REMOVED, AND REPLACED AS PER THE STANDARD SPECIFICATIONS.

12. ALL BARRICADES AND CONSTRUCTION SIGNING SHALL CONFORM TO APPLICABLE SECTIONS OF

15. WHEN ABUTTING NEW CURB AND CUTTER TO EXISTING PAVEMENT A 1' WIDE SECTION OF

16. THE CONTRACTOR SHALL ASSUME RESPONSIBILITY FOR ANY DAMAGE TO EXISTING PAVEMENTS, PAVEMENT MARKINGS, CURB & GUITER, DRIVE PADS, HREELCHAIR RAMPS, AND SIDEWALK DURING CONSTRUCTION, APPACT FROM THOSE SECTIONS INDICATED FOR REMOVAL ON THE PLANS AND SHALL REPAIR OR REPLACE PER COA STANDARDS, AT HIS OWN EXPENSE.

DRB #1000475

Bohannan & Huston

Courtyard One 7500 JEFFERSON NE Albuquerque NEW MEXICO 87109 ENGINEERS PLANNERS PHOTOGRAMMETRISTS SURVEYORS SOFTWARE DEVELOPERS

THARRON UNITS 1 & 2


NOTICE TO CONTRACTORS


- AN EXCAVATION/CONSTRUCTION PERMIT WILL BE REQUIRED BEFORE BEGINNING ANY WORK WITHIN THE
- ALBUQUERQUE STANDARD SPECIFICATIONS FOR PUBLIC WORKS CONSTRUCTION, 1986 EDITION AS REVISED
- 3. TWO WORKING DAYS PRIOR TO ANY EXCAVATION, THE CONTRACTOR MUST CONTACT NEW MEXICO ONE CALL SYSTEM (260-1990) FOR LOCATION OF EXISTING UTILITIES.
- 5. FIVE (5) WORKING DAYS PRIOR TO BEGINNING CONSTRUCTION, THE CONTRACTOR SHALL SUBMIT TO CONSTRUCTION COORDINATION DIVISION A DETAILED CONSTRUCTION SCHEDULED. TWO (2) WORKING DAYS PRIOR TO THE START OF CONSTRUCTION, THE CONTRACTOR SHALL OBTAIN A BARRICADING PERMIT FROM THE CONSTRUCTION COORDINATION DIVISION, CONTRACTOR SHALL NOTIFY THE CONSTRUCTION THE CONDITIONAL OF CHIEF (78-251) PRICE TO OCCUPING AN INTERSECTION. REFER TO SECTION 19 OF THE GENERAL CONDITIONS OF THE STANDARD SPECIFICATIONS.
- 6. ALL WORK EFFECTING ARTERIAL ROADWAYS REQUIRES TWENTY-FOUR HOUR CONSTRUCTION
- 7. ALL STREET STRIPING ALTERED OR DESTROYED SHALL BE REPLACED WITH PLASTIC REFLECTORIZED PAVEMENT MARKING BY CONTRACTOR TO THE SAME LOCATION AS WAS EXISTING, OR AS INDICATED BY
- 8. CONTRACTOR SHALL NOTIFY THE ENGINEER NOT LESS THAN SEVEN (7) DAYS PRIOR TO STARTING WORK IN ORDER THAT THE CITY SURVEYOR MAY TAKE NECESSARY MEASURES TO INSURE THE PRESERVATION OF SURVEY MONUMENTS. CONTRACTOR SHALL NOT DISTURP PERMARENT SURVEY MONUMENTS WITHOUT THE CONSENT OF THE CITY SURVEYOR AND SHALL NOTIFY THE CITY SURVEYOR AND SHALL NOTIFY THE CITY SURVEYOR AND HEAR THE EXPENSE OF REPLACING ANY THAT MAY BE DISTURBED WITHOUT PERMISSION. REPLACEMENT SHALL BE DOING CHLY BY THE CITY SURVEYOR. WHEN A CHARGE IS MADE IN THE FINISHED ELEVATIONS OF THE PAREMENT OF ANY ROADWAY IN WHICH A PERMARENT SURVEY MONUMENT IS LOCATED CONTRACTORS TO THE PAREMENT OF ANY ROADWAY IN WHICH A PERMARENT SURVEY MONUMENT IS LOCATED. CONTRACTOR SHALL AT HIS KOWN SEPRISSE AND LITE MAY MURCH COORS TO THE MAY. IS LOCATED, CONTRACTOR SHALL, AT HIS OWN EXPENSE, ADJUST THE MONUMENT COVER TO THE NEW GRADE UNLESS OTHERWISE SPECIFIED. REFER TO SECTION 4.4 OF THE GENERAL CONDITIONS OF THE
- 9. CONTRACTOR SHALL RECORD DATA ON ALL UTILITY LINES AND ACCESSORIES AS REQUIRED BY THE CONTRACTOR STRAIL RECURSO DATA ON ALL UTILITI LINES AND ALCESSORIES AS REQUIRED BY THE CITY OF ALBUQUERQUE FOR THE PREPARATION OF "AS CONSTRUCTED" DRAWNOS. CONTRACTOR SHALL NOT COVER UTILITY LINES AND ACCESSORIES UNTIL ALL DATA HAS BEEN RECORDED.
- CONTRACTOR SHALL MAINTAIN A GRAFFITI-FREE WORK SITE. CONTRACTOR SHALL PROMPTLY REMOVE ANY GRAFFITI FROM ALL EQUIPMENT; WHETHER PERMANENT OR TEMPORARY.
- CONTRACTOR SHALL COORDINATE WITH THE CITY OF ALBUQUERQUE WATER SYSTEMS DIVISION 11. CONTRACTOR STREET CONTRINES WITH THE CHIT OF PRODUCETACINE MATER ASSISTANCE DIVISION (657–6200) FIVE (5) WORKING DATS IN ADVANCE OF ANY WORK THAT MAY AFFECT EXISTING PUBLIC WATER OR SEWER UTILITIES. EXISTING VALVES TO BE OPERATED BY CITY PERSONNEL ONLY. CONTRACTOR SHALL CONTACT THE WATER SYSTEMS DIVISION THREE (3) WORKING DAYS PRIOR TO NEEDING VALVES TURNED ON OR OFF.


THE FOLLOWING NOTES ALSO APPLY WHEN CHECKED


- X ALL UTILITIES AND UTILITY SERVICE LINES SHALL BE INSTALLED PRIOR TO PAVING.
- X BACKFILL COMPACTION SHALL BE ACCORDING TO SPECIFIED STREET USE.
- X TACK COAT REQUIREMENTS SHALL BE DETERMINED BY THE CITY ENGINEER.
- SOEWALKS AND WHEELCHAIR RAMPS WITHIN THE CURB RETURNS SHALL BE CONSTRUCTED WHEREVER A NEW CURB RETURN IS CONSTRUCTED.
- IF CURB IS DEPRESSED FOR A DRIVEPAD, THE DRIVEPAD SHALL BE CONSTRUCTED PRIOR TO ACCEPTANCE OF CURB AND GUTTER.
- X ALL STORM DRAINAGE FACILITIES SHALL BE COMPLETED PRIOR TO FINAL ACCEPTANCE.
- [X] THE REQUESTER OR DEVELOPER SHALL BE RESPONSIBLE FOR REPAIR OR REPLACEMENT OF ALL CURB AND GUTTER OR SDEWALK DAMAGED AFTER APPROVAL BY THE CITY ENGINEER OF WORK COMPLETED BY THE CONTRACTOR.


				***************************************										Т		
														I		
									L							
EV.	SHEETS		NGINEER	DATE	USER DEPARTMEN	IT.	DA	TE		USER	DEPA	RTM	ENT		DA	TE
GINE	ERS STAMP &	SIGNATURE	APPROVALS		ENGINEER	DA	TE	* *	*	* *	* *	*	* *	k ×	*	*
			DRC Chairman		- luf	3-2	7-02		APP	ROVE	D FOR	CO	NSTR	UCT	ION	
			Transportation	文	tour.		7-02									
	15 1 18	<i>₹</i>	Water/Wastewo	iter Na	rent Ohusput		/20)	10)		11	- 2
1	S. S. S.	SEV	Hydrology	Bra	de S. Burkan	1.17	7-02	/	1	- /	11) zin	4/	///	1
7	1486	171	Parks					l		w	$\perp \gamma$	m	<u>yın</u>			
1	見して	/量	Const. Coord.		- Lul	3-2	7.00	City	Eng	ineer		ı	,		Do	ote
1		93)		1				Ĭ			/					
	PROFESSIO	MAL	City Project No		***************************************	<u></u>		- C'-	. 1							<=
			City Froject No	J.				She	et			0	3			
					671683			1			1			1	Ω	

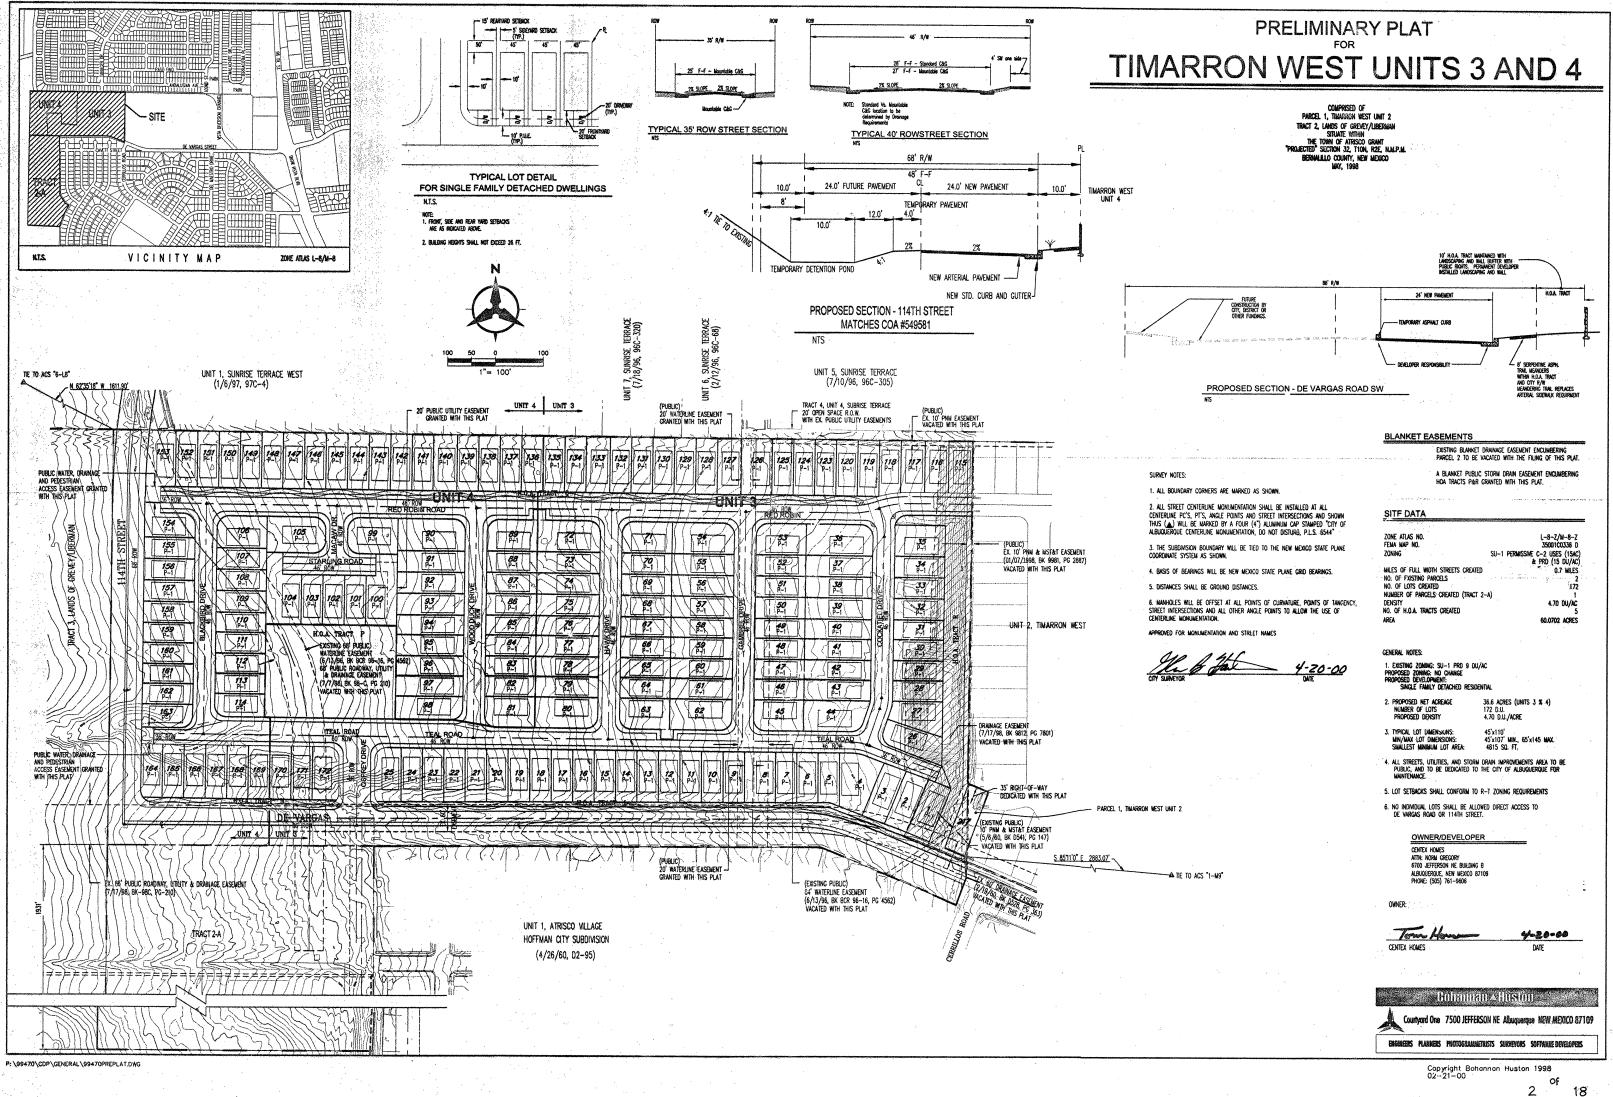


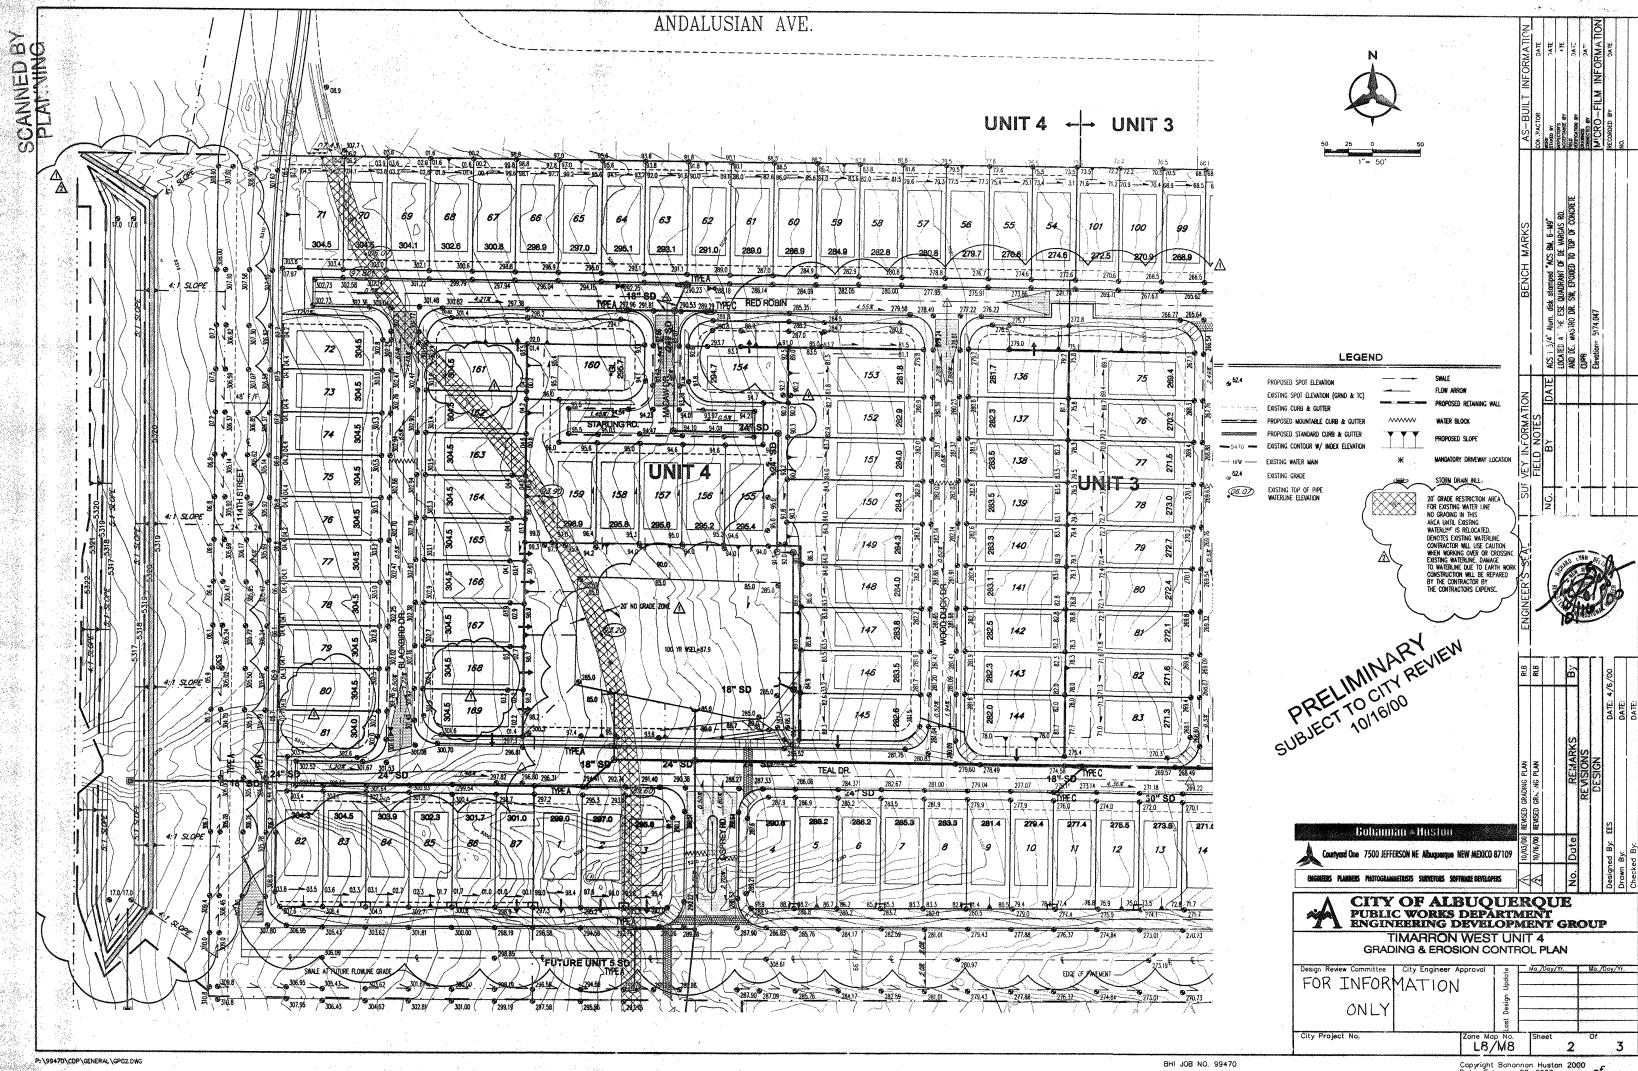


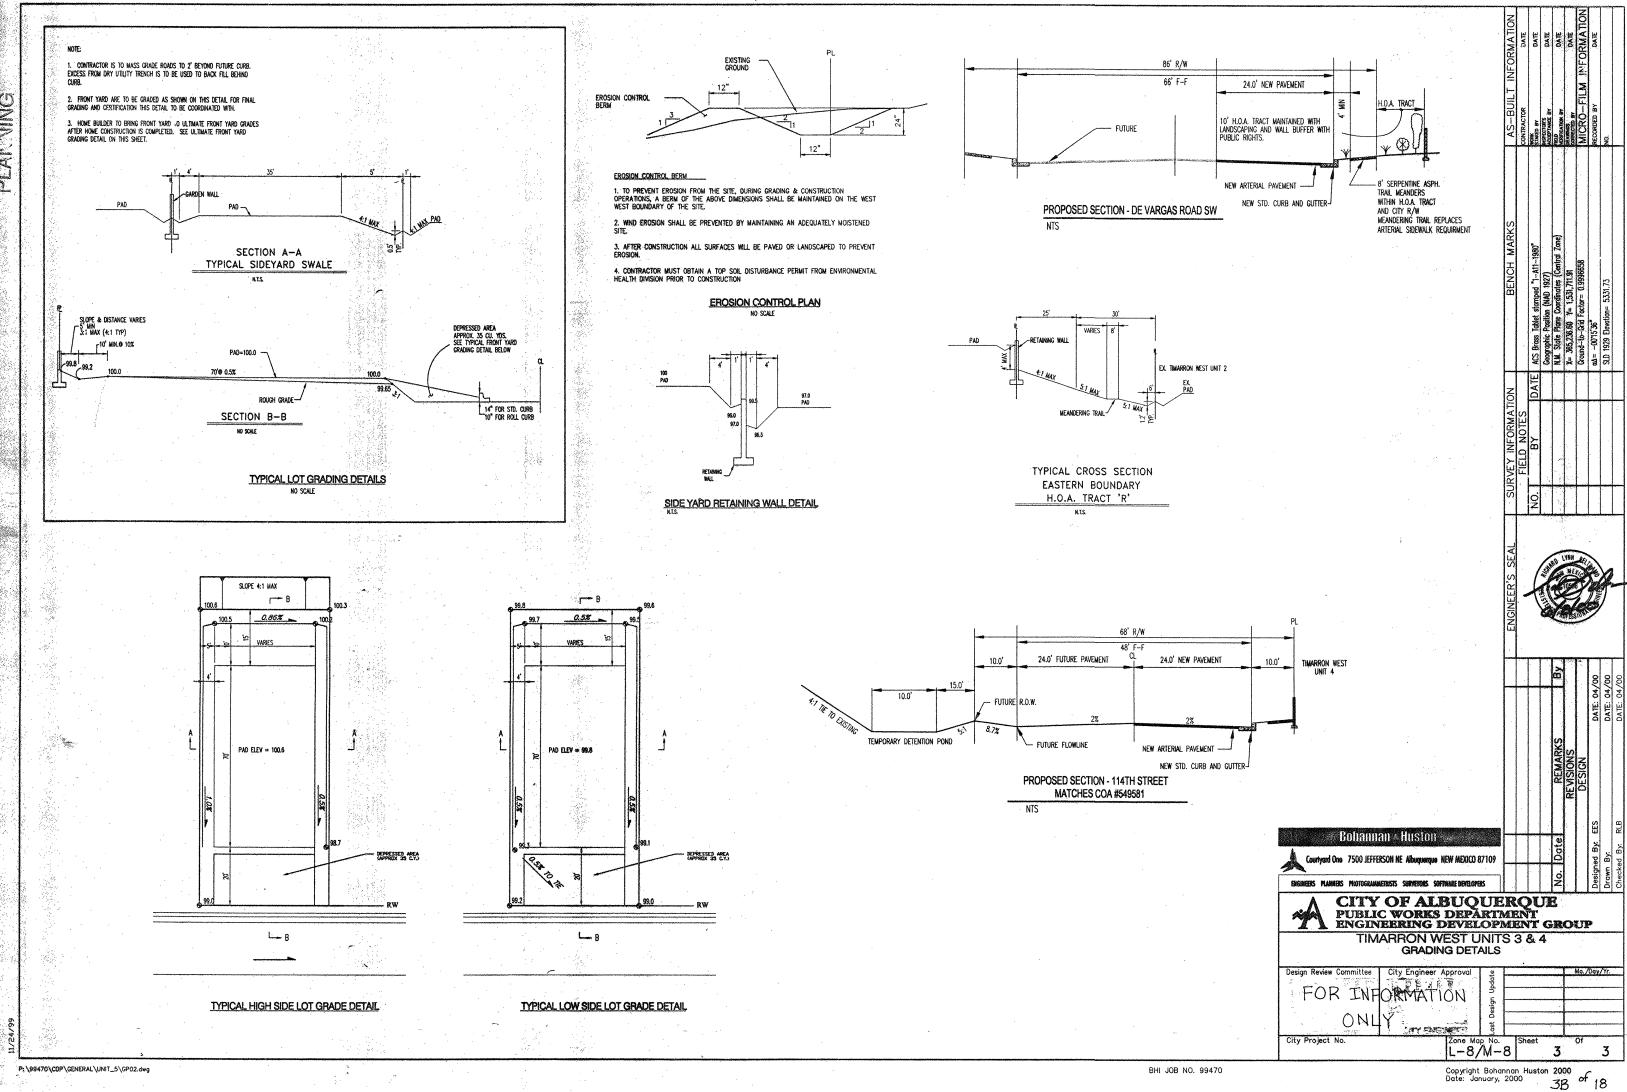

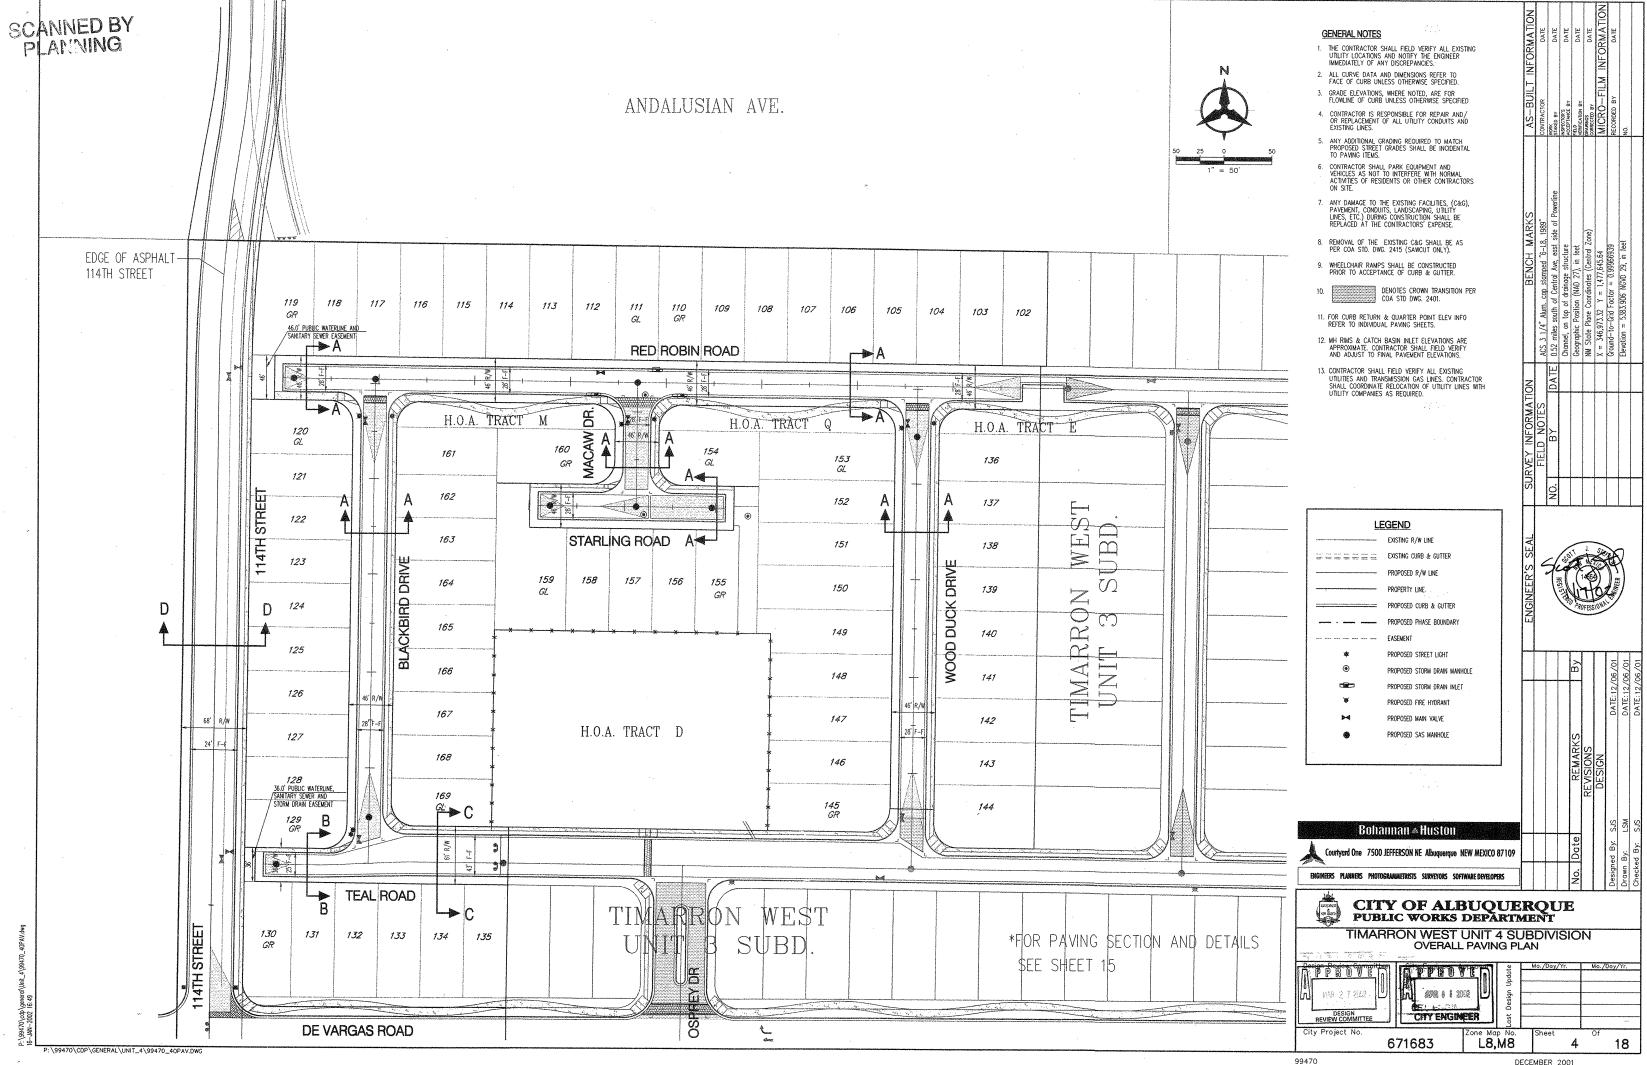

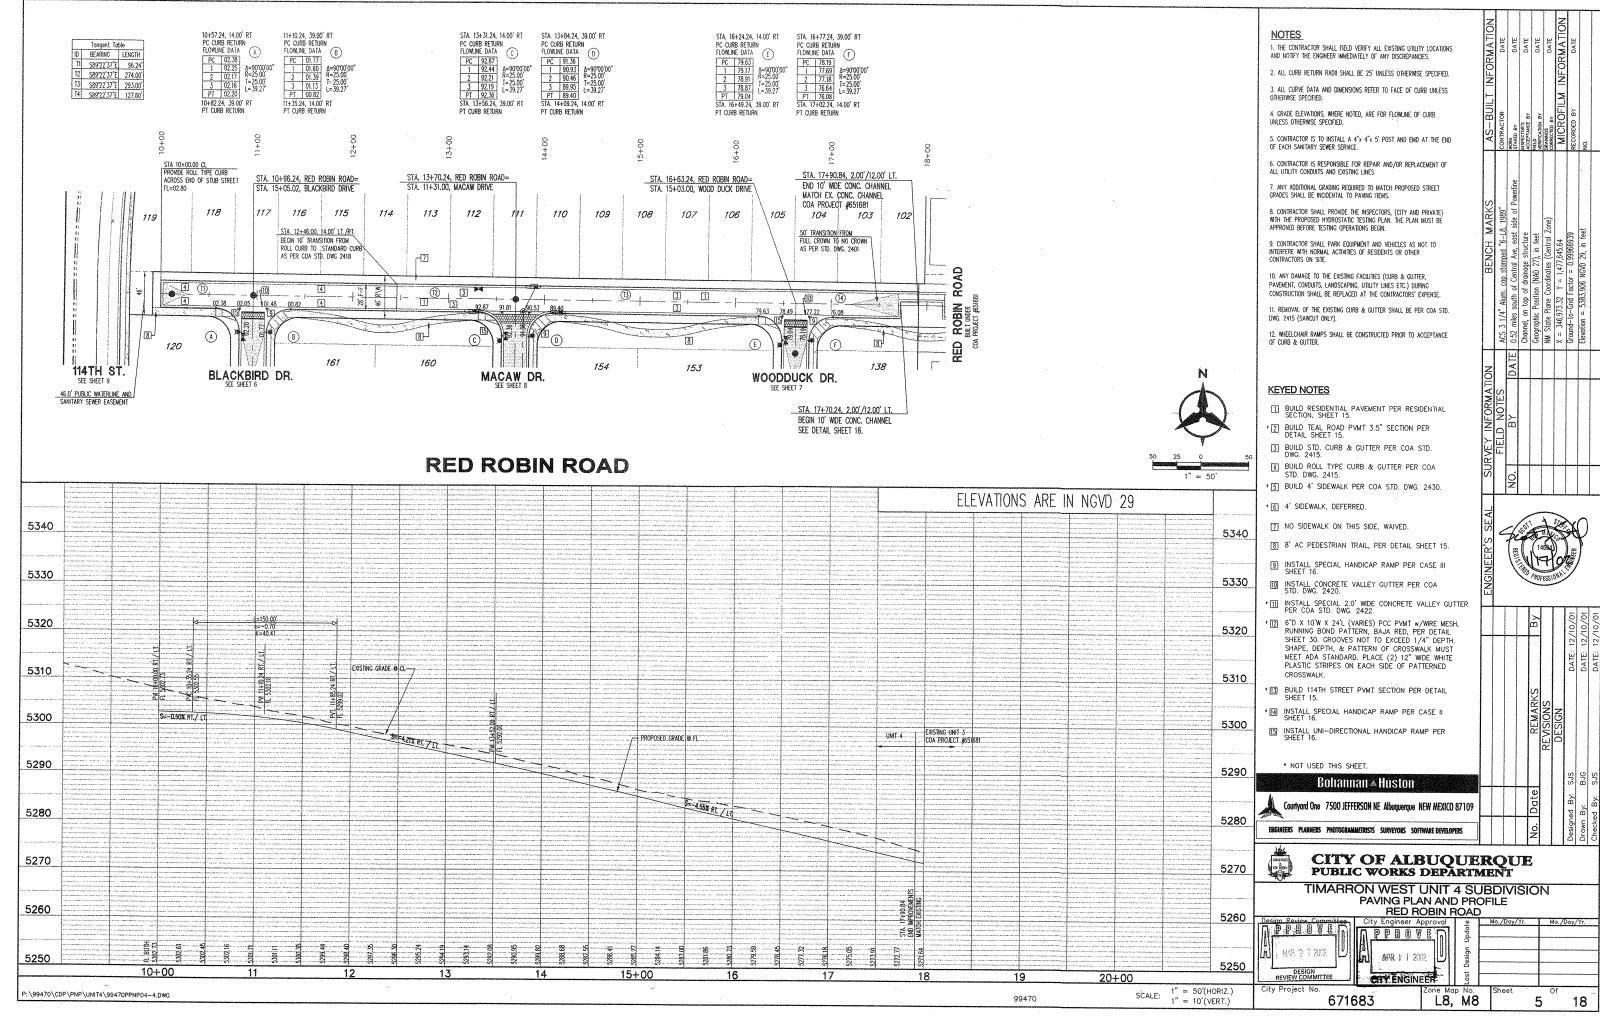

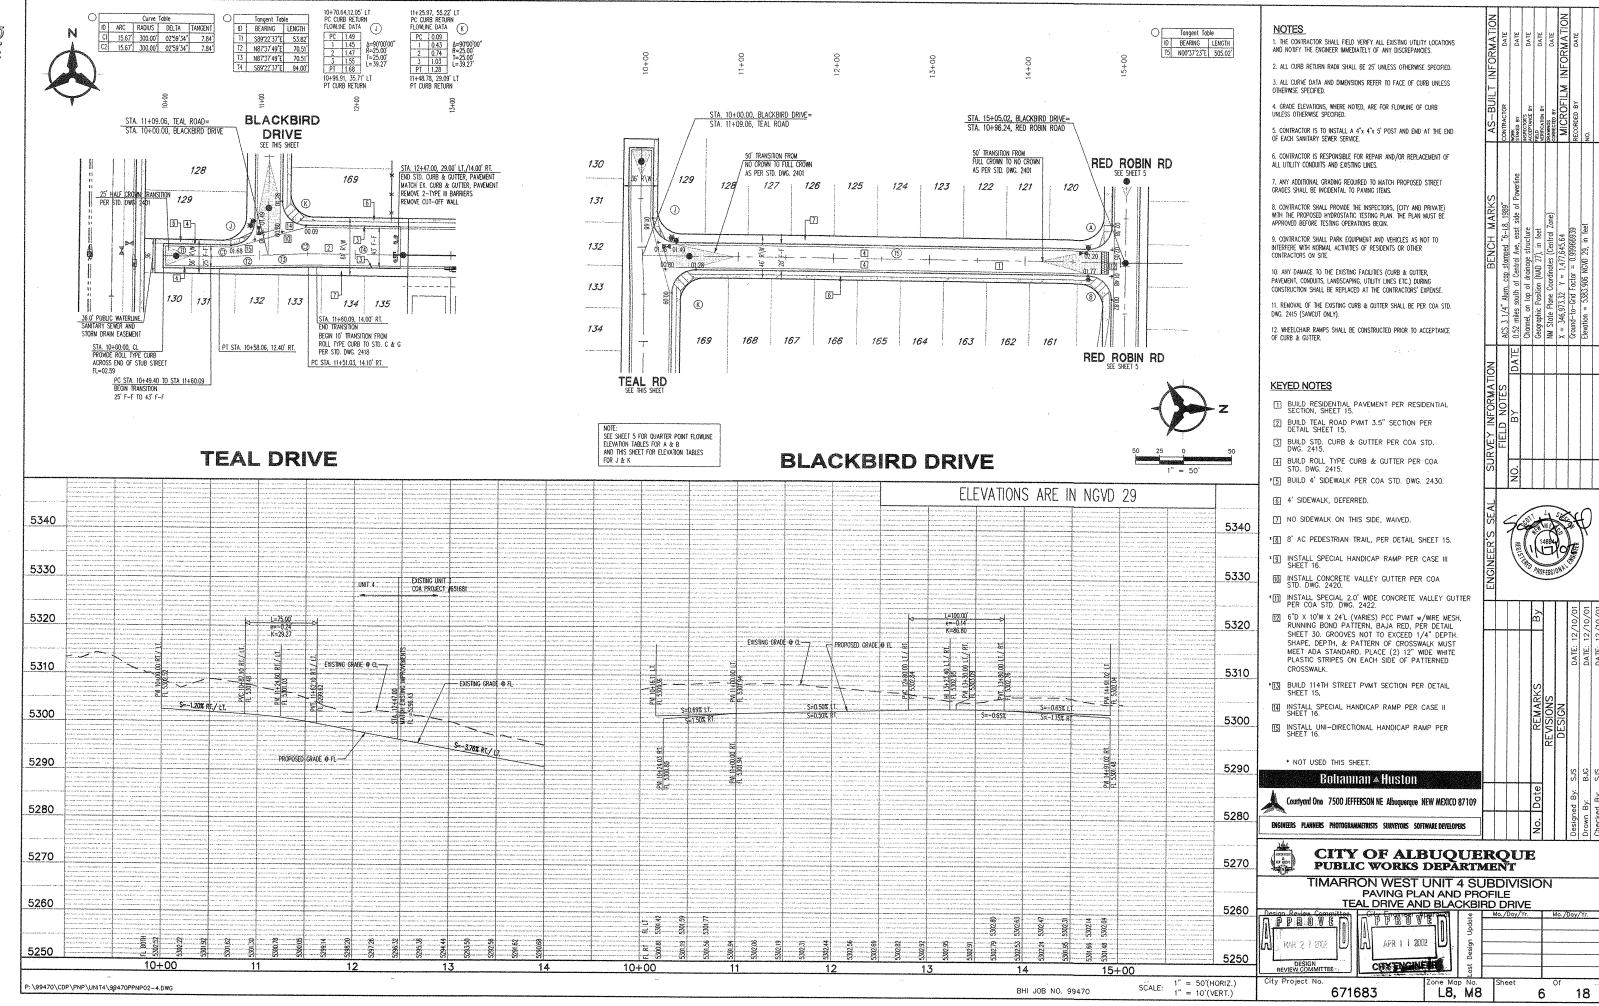

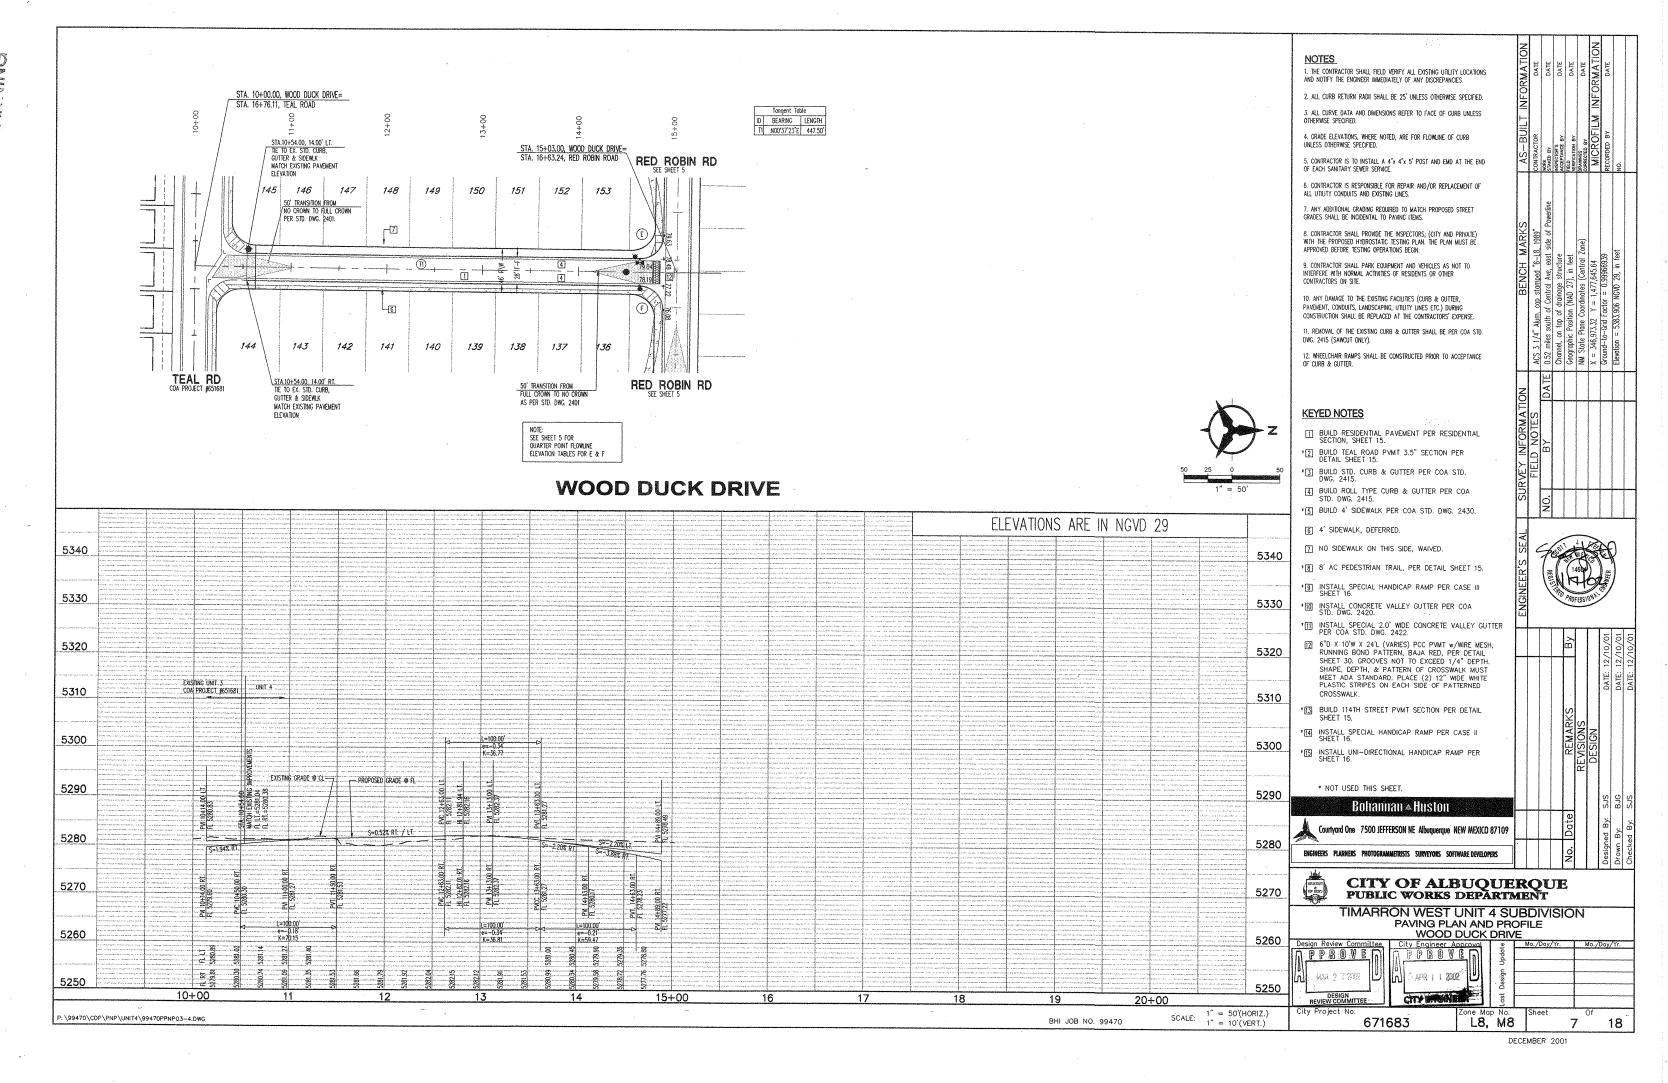



2: \99470\CDP\PNP\UNIT4\99470PPNP01~4.DWG

ID BEARING LENGTH T1 N00'37'23"E 131.00'

10+27.87, 14.00' LT
PC CURB RETURN
FLOMINE DATA

PC 93.51

1 93.77 A=9000
2 93.99 R=25.00
2 93.99 I=39.77

3 94.17 L=25.00
10+97.87, 39.00' LT
PT CURB RETURN

160

[7]-

158

6 TA

159

STA. 10+09.97 END OF STUB STREET

162

164

ROLL TYPE CURB & GUTTER

163 25' HALF-CROWN TRANSITION PER STD. DWG. 2401.

11+50.87, 14.00' LT PT CURB RETURN

MACAW DRIVE

157

98.95 94.027

4}-

156

| Tangent Toble | ID | BEARING | LENGTH | T2 | S89'22'37'E | 102.03 | T3 | S89'22'37'E | 93.00'

STA. 12+05.00 FOR STUB STREET

ROLL TYPE CURB & GUTTER
FL=94.44

152

151

150

BHI JOB NO. 99470

r-6

155



1. THE CONTRACTOR SHALL FIELD VERIFY ALL EXISTING UTILITY LOCATIONS AND NOTIFY THE ENGINEER IMMEDIATELY OF ANY DISCREPANCIES.

2. ALL CURB RETURN RADII SHALL BE 25' UNLESS OTHERWISE SPECIFIED. 3. ALL CURVE DATA AND DIMENSIONS REFER TO FACE OF CURB UNLESS OTHERWISE SPECIFIED. $\footnote{\cite{Charge}}$

4. GRADE ELEVATIONS, WHERE NOTED, ARE FOR FLOWLINE OF CURB UNLESS OTHERWISE SPECIFIED.

5. Contractor is to install a 4"x 4"x 5' post and emd at the end of each sanitary sewer service.

6. CONTRACTOR IS RESPONSIBLE FOR REPAIR AND/OR REPLACEMENT OF ALL UTILITY CONDUITS AND EXISTING LINES.

7. ANY ADDITIONAL GRADING REQUIRED TO MATCH PROPOSED STREET

GRADES SHALL BE INCIDENTAL TO PAVING ITEMS.

8. CONTRACTOR SHALL PROVIDE THE INSPECTORS, (CITY AND PRIVATE) WITH THE PROPOSED HYDROSTATIC TESTING PLAN. THE PLAN MUST BE APPROVED BEFORE TESTING OPERATIONS BEGIN.

9. CONTRACTOR SHALL PARK EQUIPMENT AND VEHICLES AS NOT TO INTERFERE WITH NORMAL ACTIVITIES OF RESIDENTS OR OTHER CONTRACTORS ON SITE.

10. ANY DAMAGE TO THE EXISTING FACULTIES (CURB & GUTTER PAVEMENT, CONDUITS, LANDSCAPING, UTILITY LINES ETC.) DURING CONSTRUCTION SHALL BE REPLACED AT THE CONTRACTORS' EXPENSE.

11. REMOVAL OF THE EXISTING CURB & GUTTER SHALL BE PER COA STD. DWG. 2415 (SAWCUT ONLY).

12. WHEELCHAIR RAMPS SHALL BE CONSTRUCTED PRIOR TO ACCEPTANCE OF CURB & GUTTER.

KEYED NOTES

- BUILD RESIDENTIAL PAVEMENT PER RESIDENTIAL SECTION, SHEET 15.
- *[2] BUILD TEAL ROAD PVMT 3.5" SECTION PER DETAIL SHEET 15.
- *[3] BUILD STD. CURB & GUTTER PER COA STD. DWG. 2415.
- BUILD ROLL TYPE CURB & GUTTER PER COA STD. DWG. 2415.
- *[5] BUILD 4' SIDEWALK PER COA STD. DWG. 2430.
- [6] 4' SIDEWALK, DEFERRED.
- [7] NO SIDEWALK ON THIS SIDE, WAIVED.
- *[8]. 8' AC PEDESTRIAN TRAIL, PER DETAIL SHEET 15.
- * INSTALL SPECIAL HANDICAP RAMP PER CASE III SHEET 16.
- INSTALL CONCRETE VALLEY GUTTER PER COA STD. DWG. 2420.
- III INSTALL SPECIAL 2.0' WIDE CONCRETE VALLEY GUTTER PER COA STD. DWG. 2422.
- 121 6"D X 10"W X 24"L (VARIES) PCC PVMT w/WIRE MESH.
 RUNNING BOND PATTERN, BAJA RED, PER DETAIL
 SHEET 30. GROOVES NOT TO EXCEED 1/4" DEPTH.
 SHAPE, DEPTH. & PATTERN OF CROSSWALK MUST
 MEET ADA STANDARD. PLACE (2) 12" MIDE WHITE
 PLASTIC STRIPES ON EACH SIDE OF PATTERNED
 CROSSWALK CROSSWALK.
- *[] BUILD 114TH STREET PVMT SECTION PER DETAIL SHEET 15,
- INSTALL SPECIAL HANDICAP RAMP PER CASE II SHEET 16.
- INSTALL UNI-DIRECTIONAL HANDICAP RAMP PER SHEET 16.


* NOT USED THIS SHEET.

Bohannan & Huston Courtyard One 7500 JEFFERSON NE Albuquerque NEW MEXICO 87109

ENGINEERS PLANNERS PHOTOGRAMMETRISTS SURVEYORS SOFTWARE DEVELOPERS

CITY OF ALBUQUERQUE PUBLIC WORKS DEPARTMENT TIMARRON WEST UNIT 4 SUBDIVISION

PAVING PLAN AND PROFILE MACAW ROAD AND STARLING ROAD

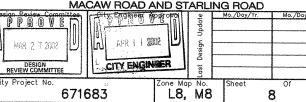


STARLING ROAD RED ROBIN ROAD 158 STA. 11+31.00, MACAW DRIVE= STA. 13+70.24, RED ROBIN ROAD 157 111 STA. 10+00.00, MACAW DRIVE= A HU 110 156 154 155 109


WITH NO CROWN SECTION PER STD. DWG. 2401.


NOTE: SEE SHEET 5 FOR QUARTER POINT FLOWLINE ELEVATION TABLES FOR C & D AND THIS SHEET FOR G & H


STARLING ROAD

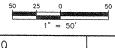



1'' = 10'(VERT.)

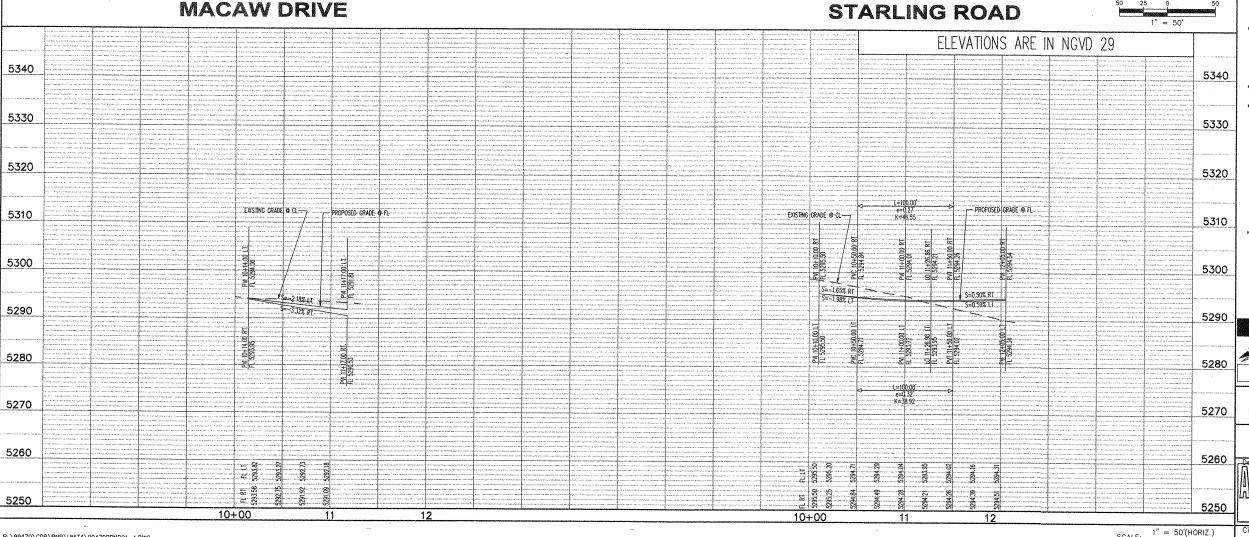


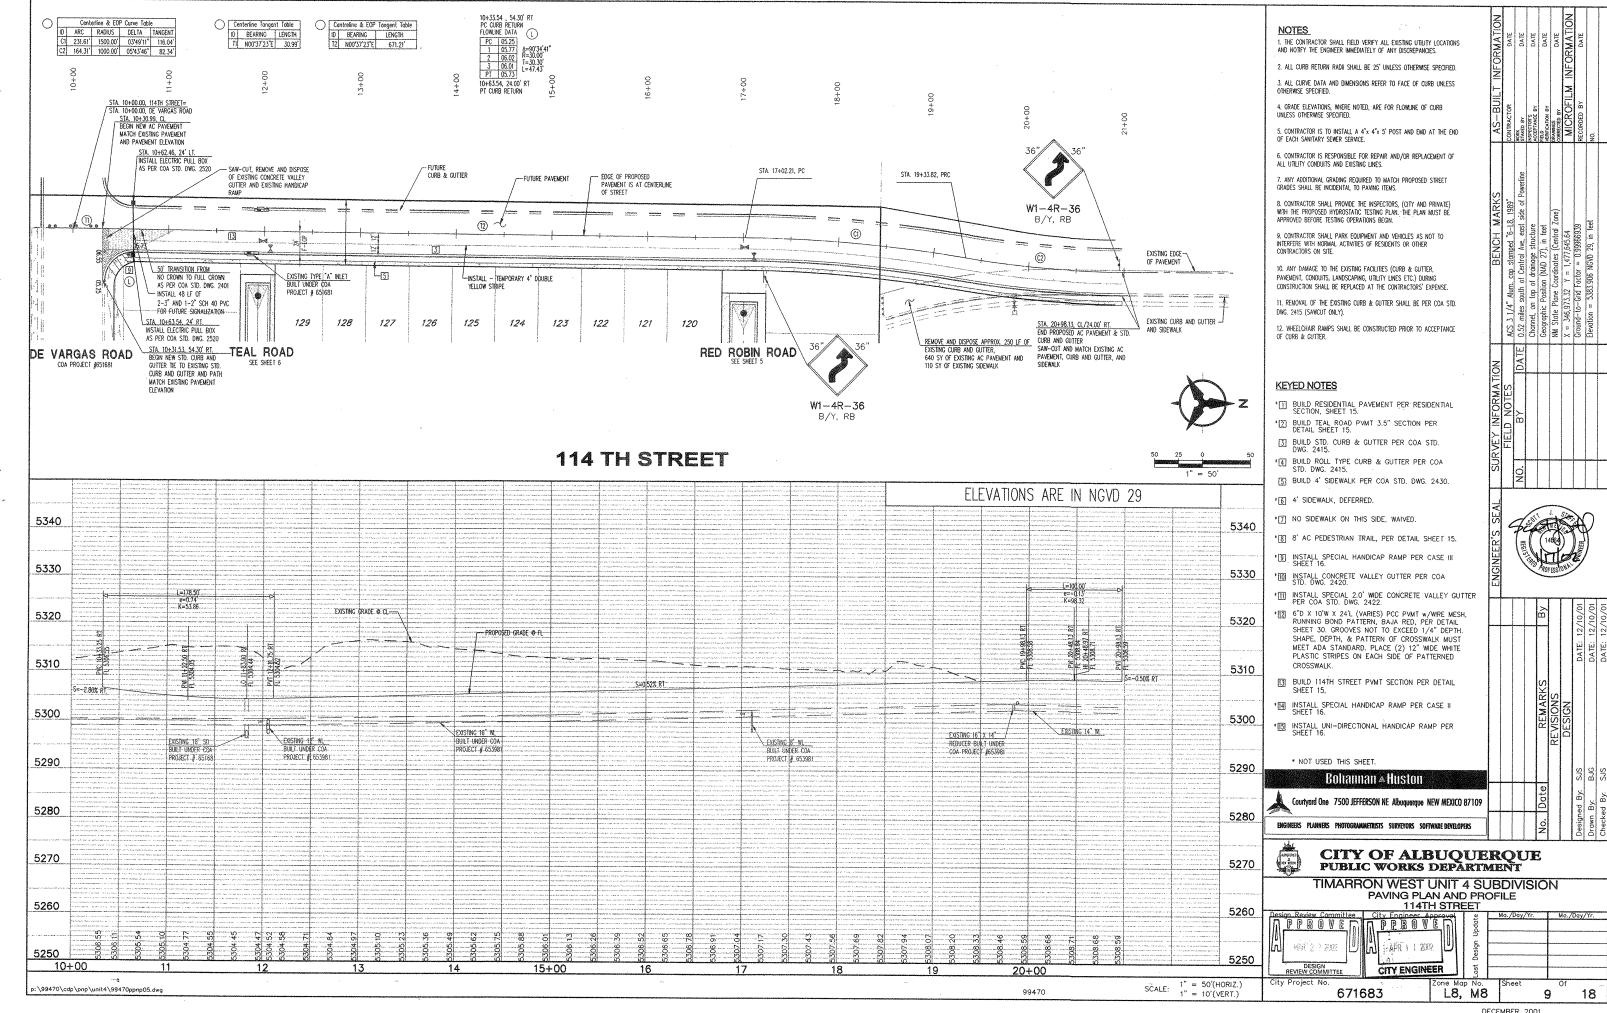


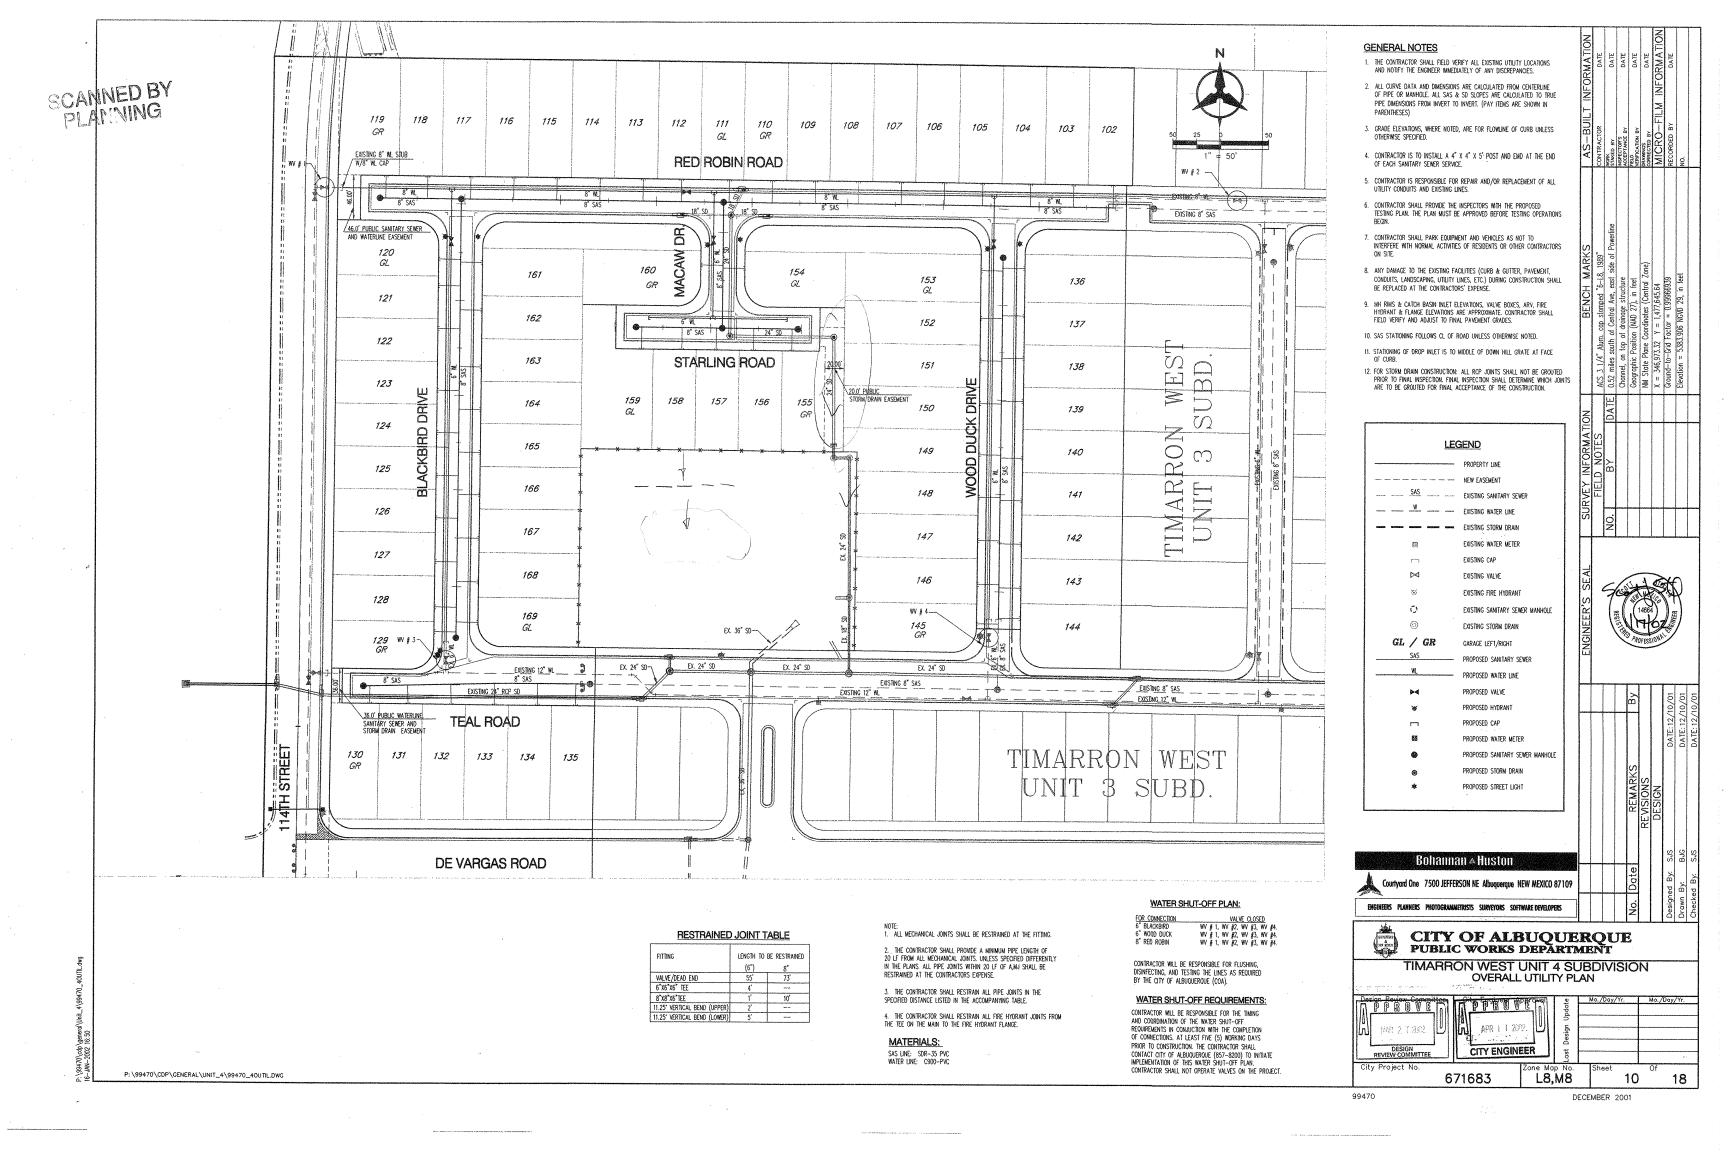


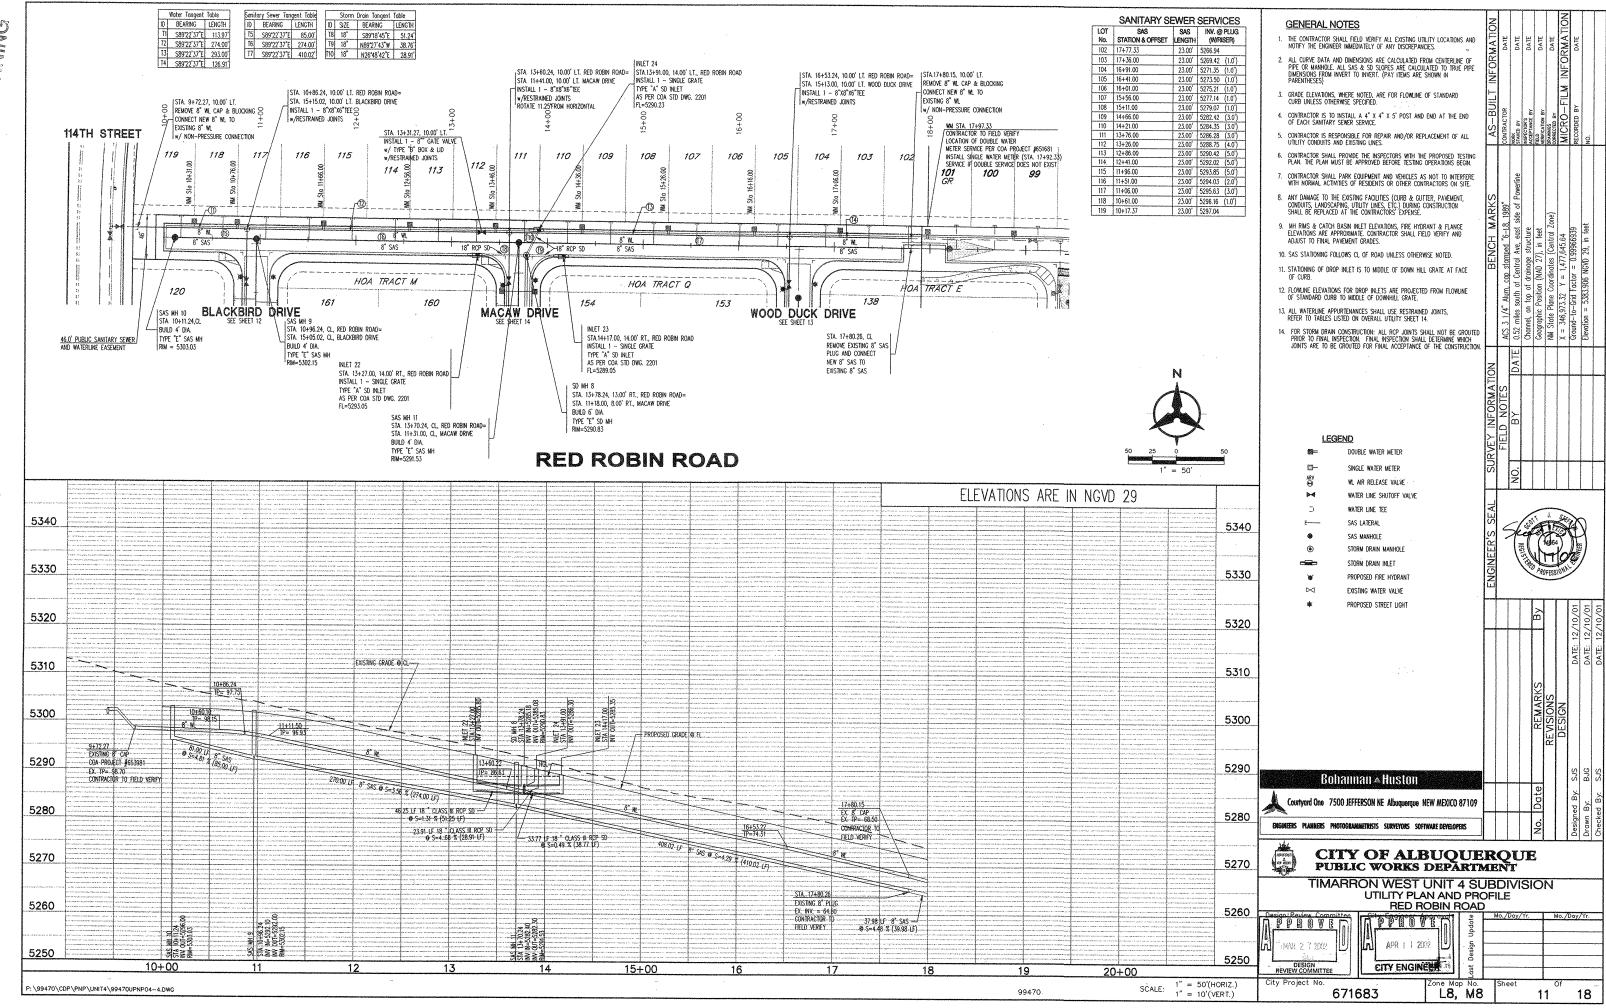


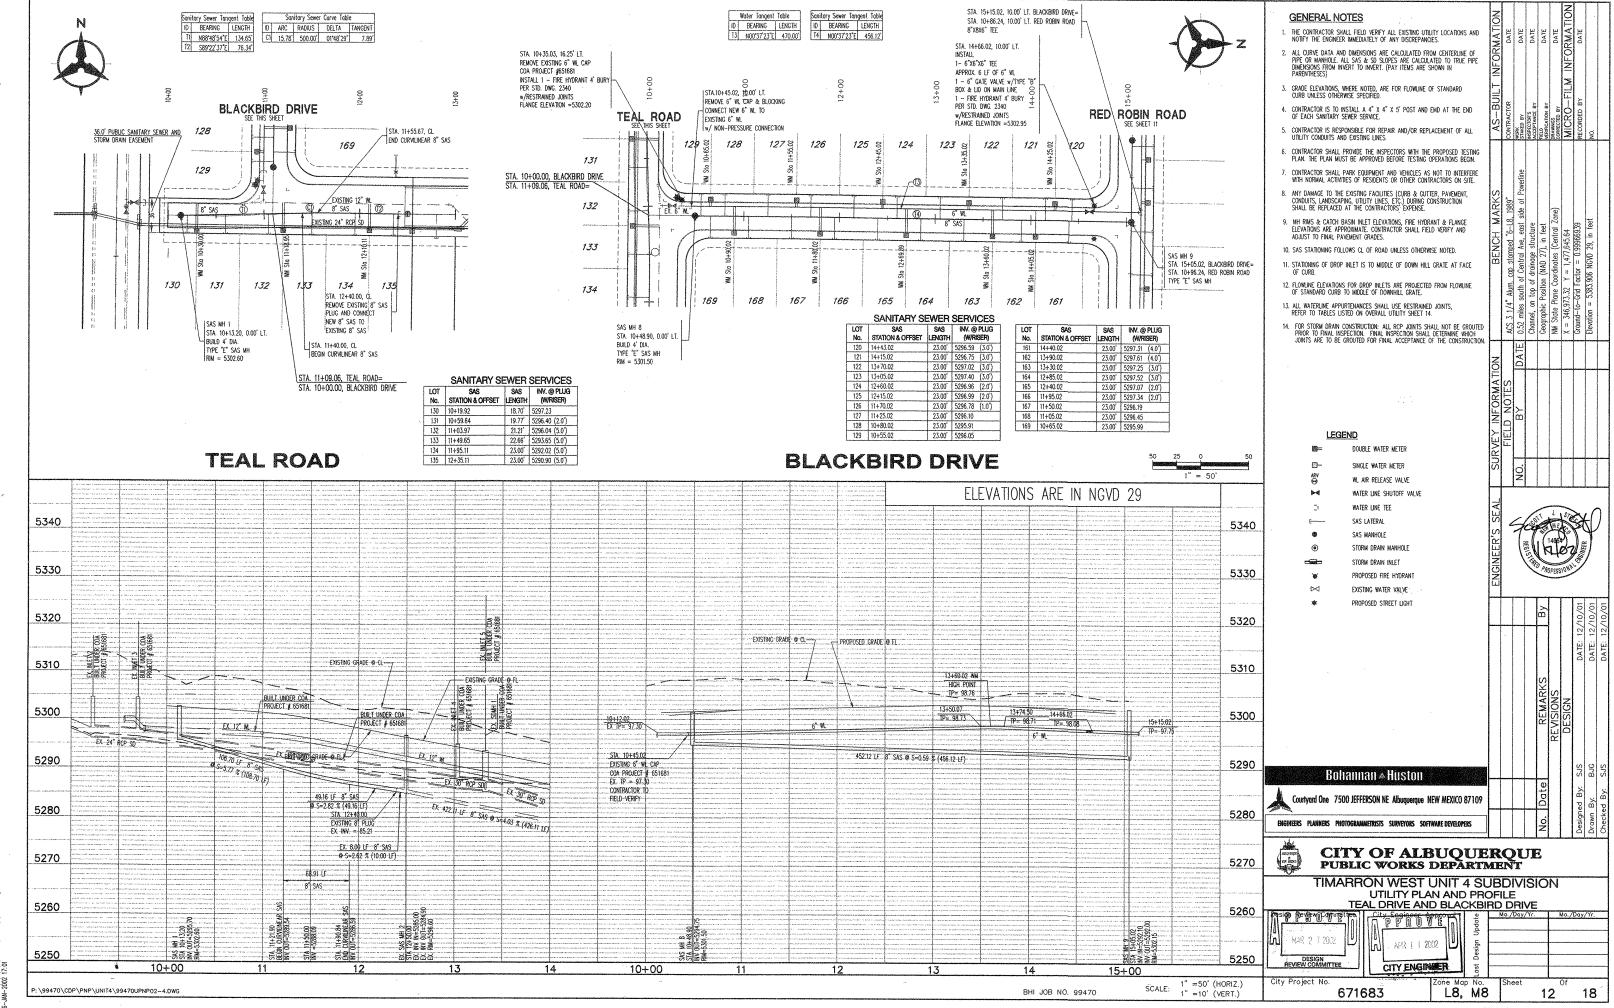

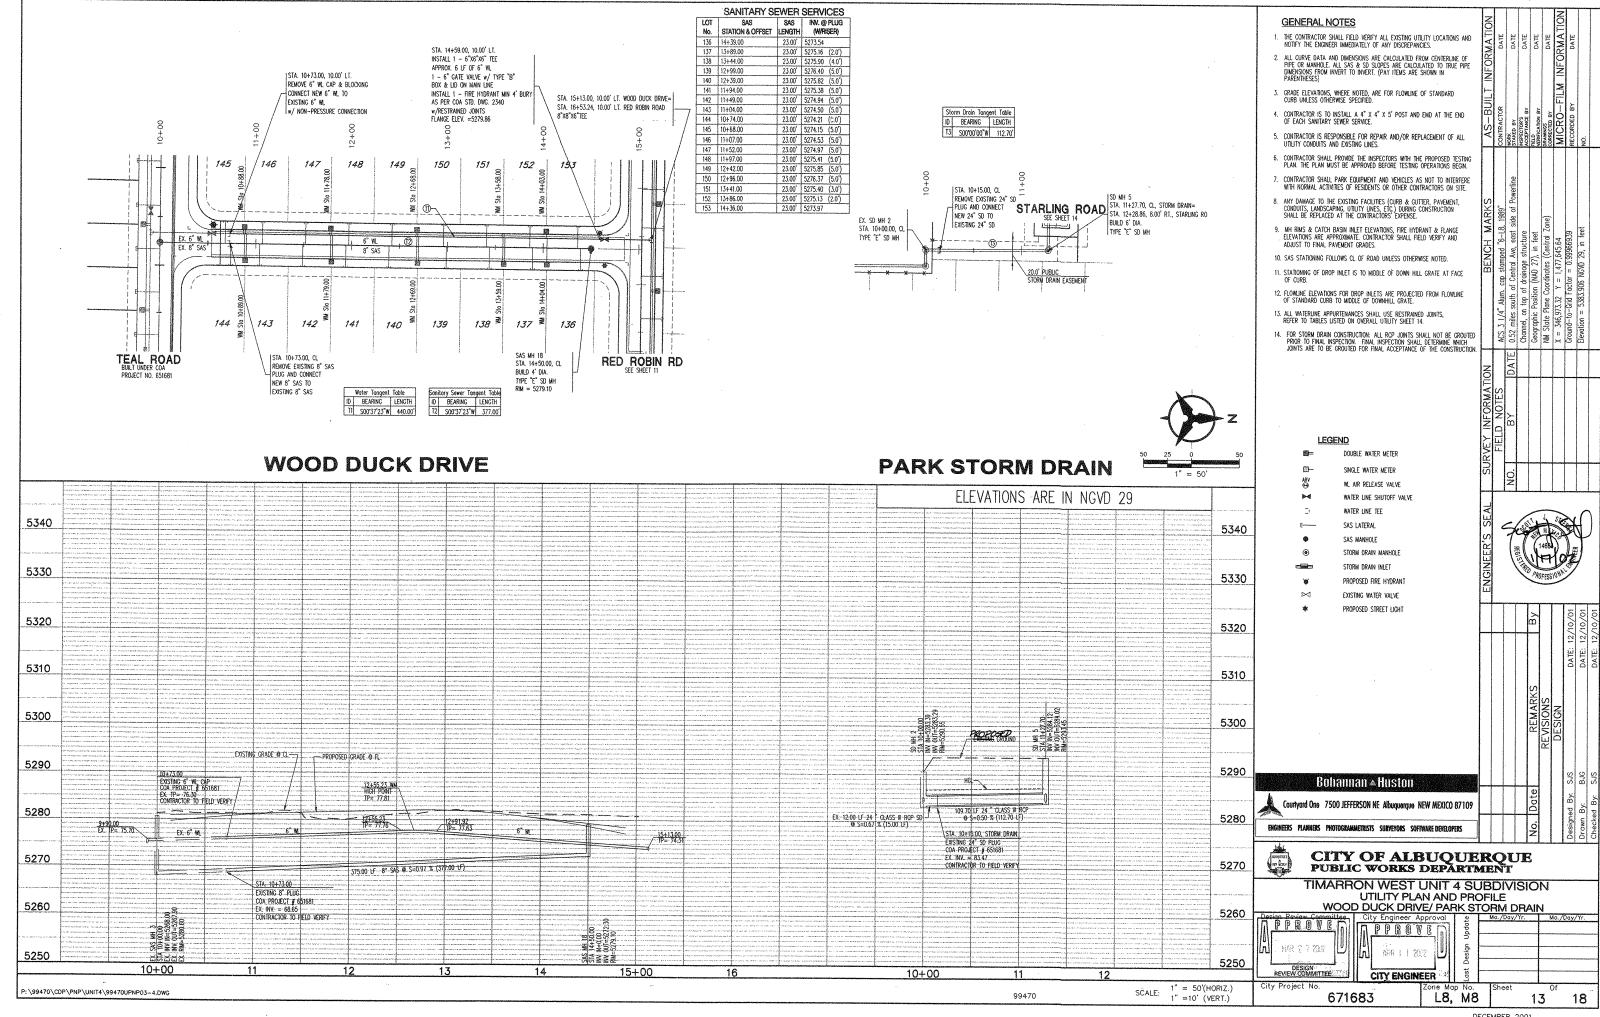

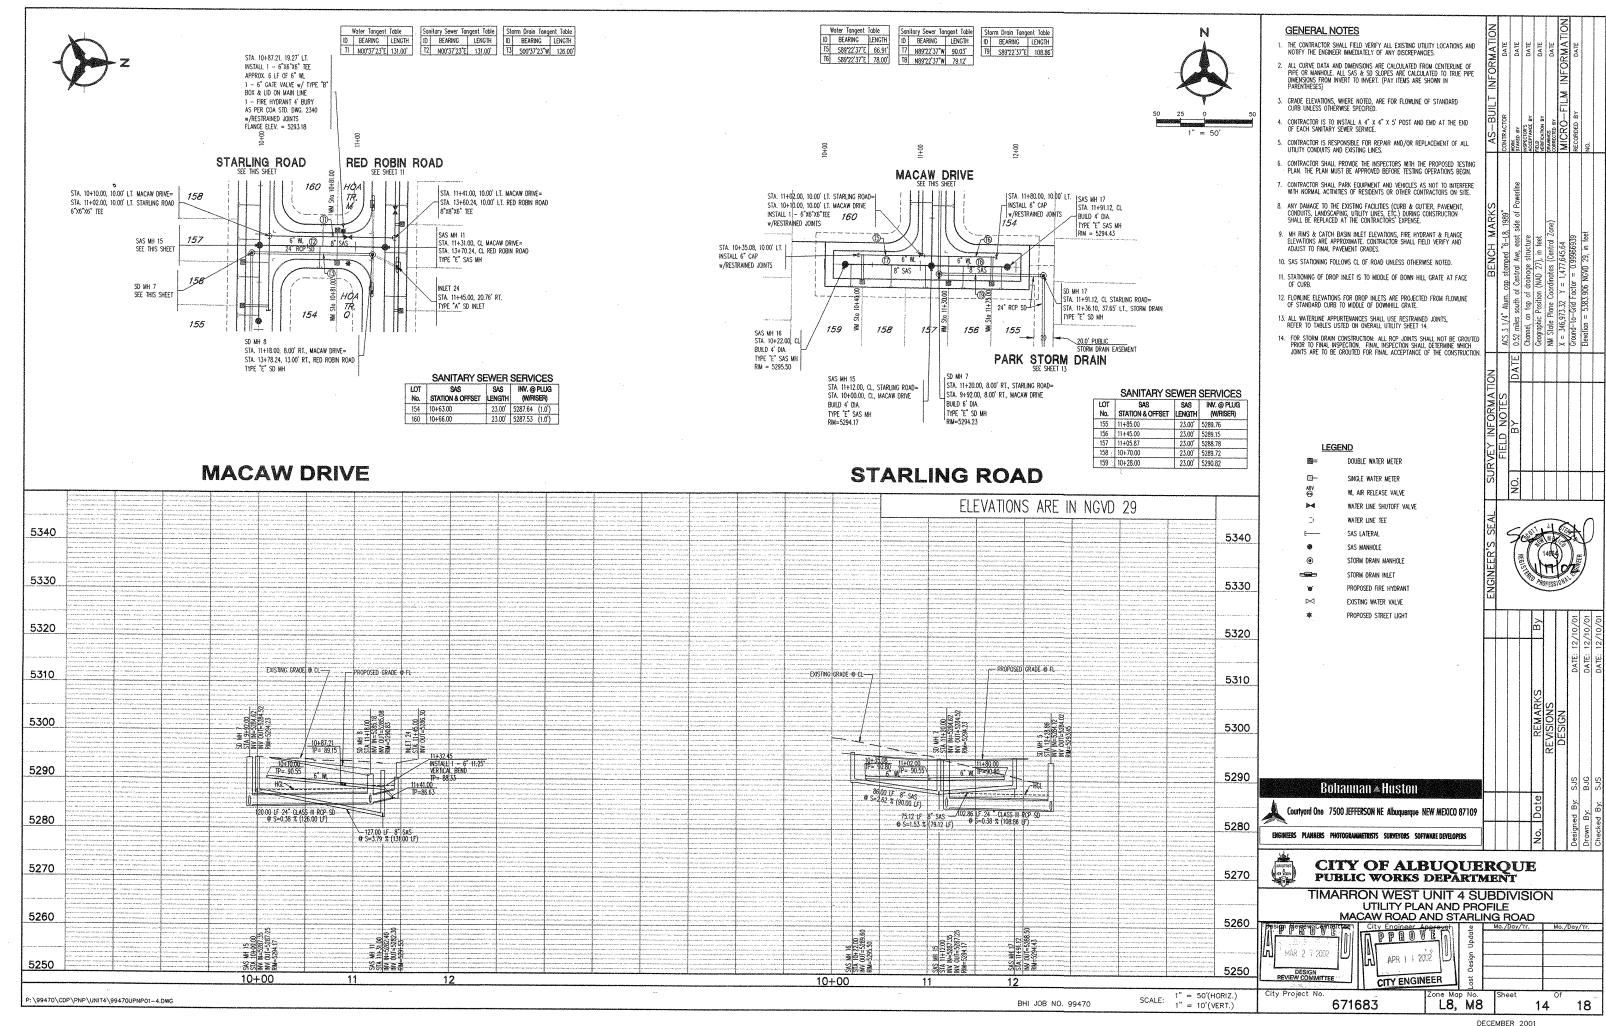

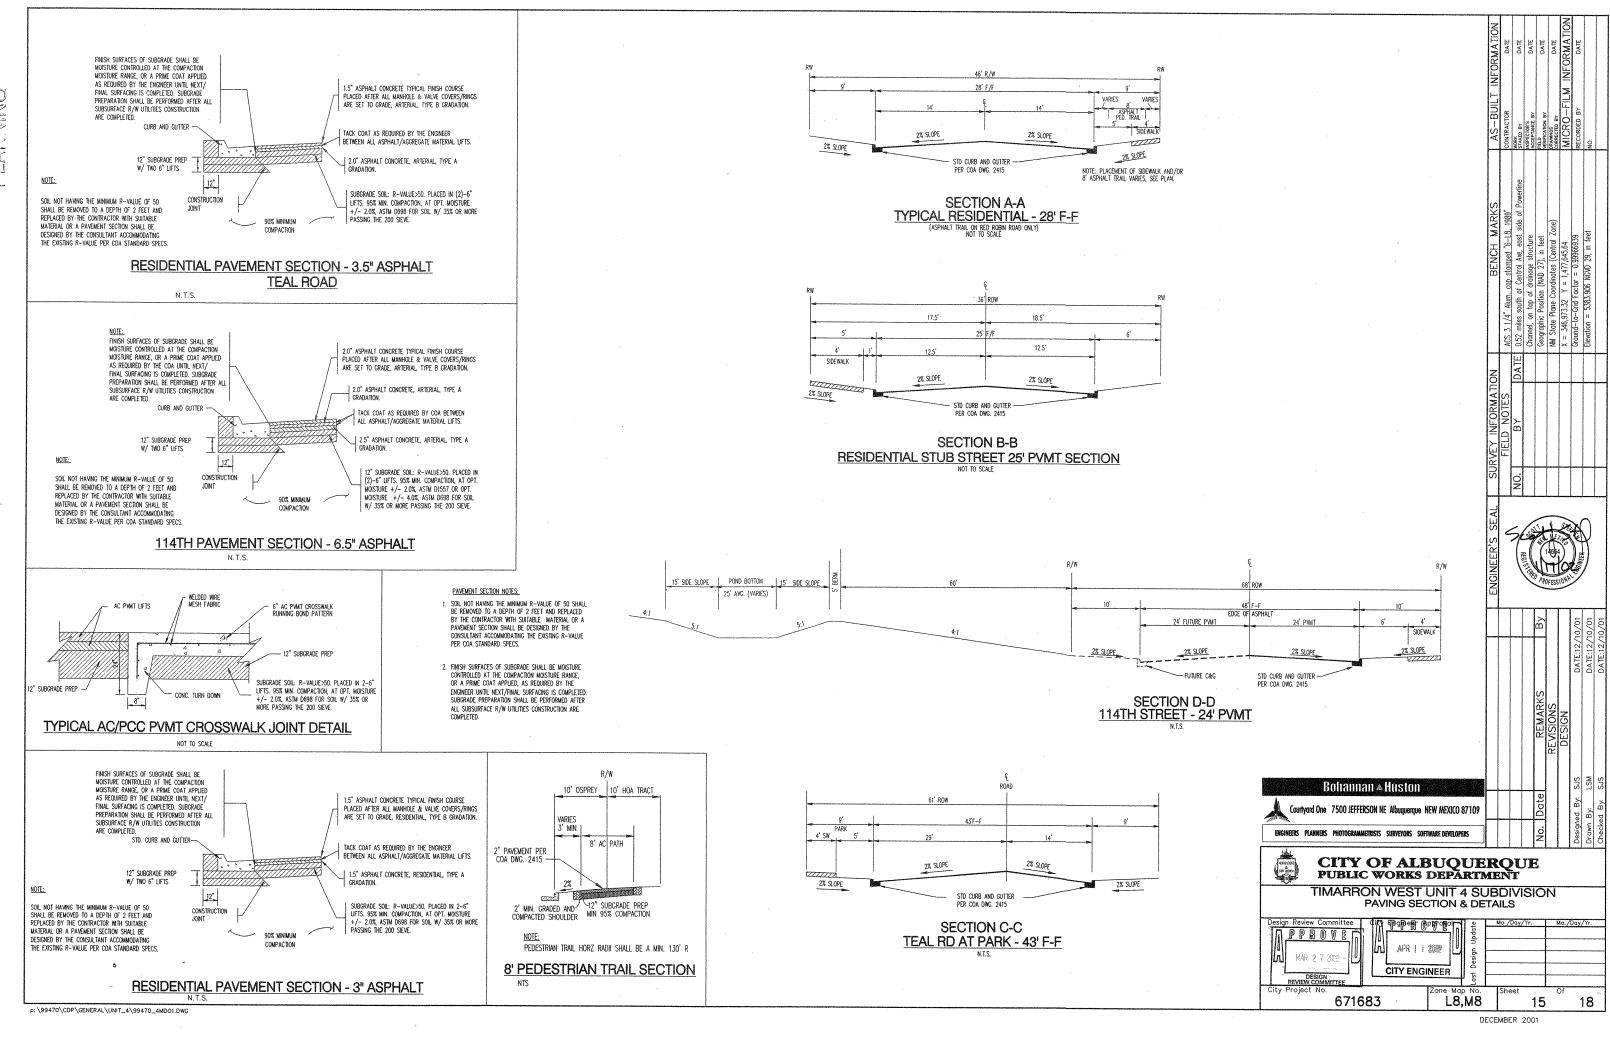

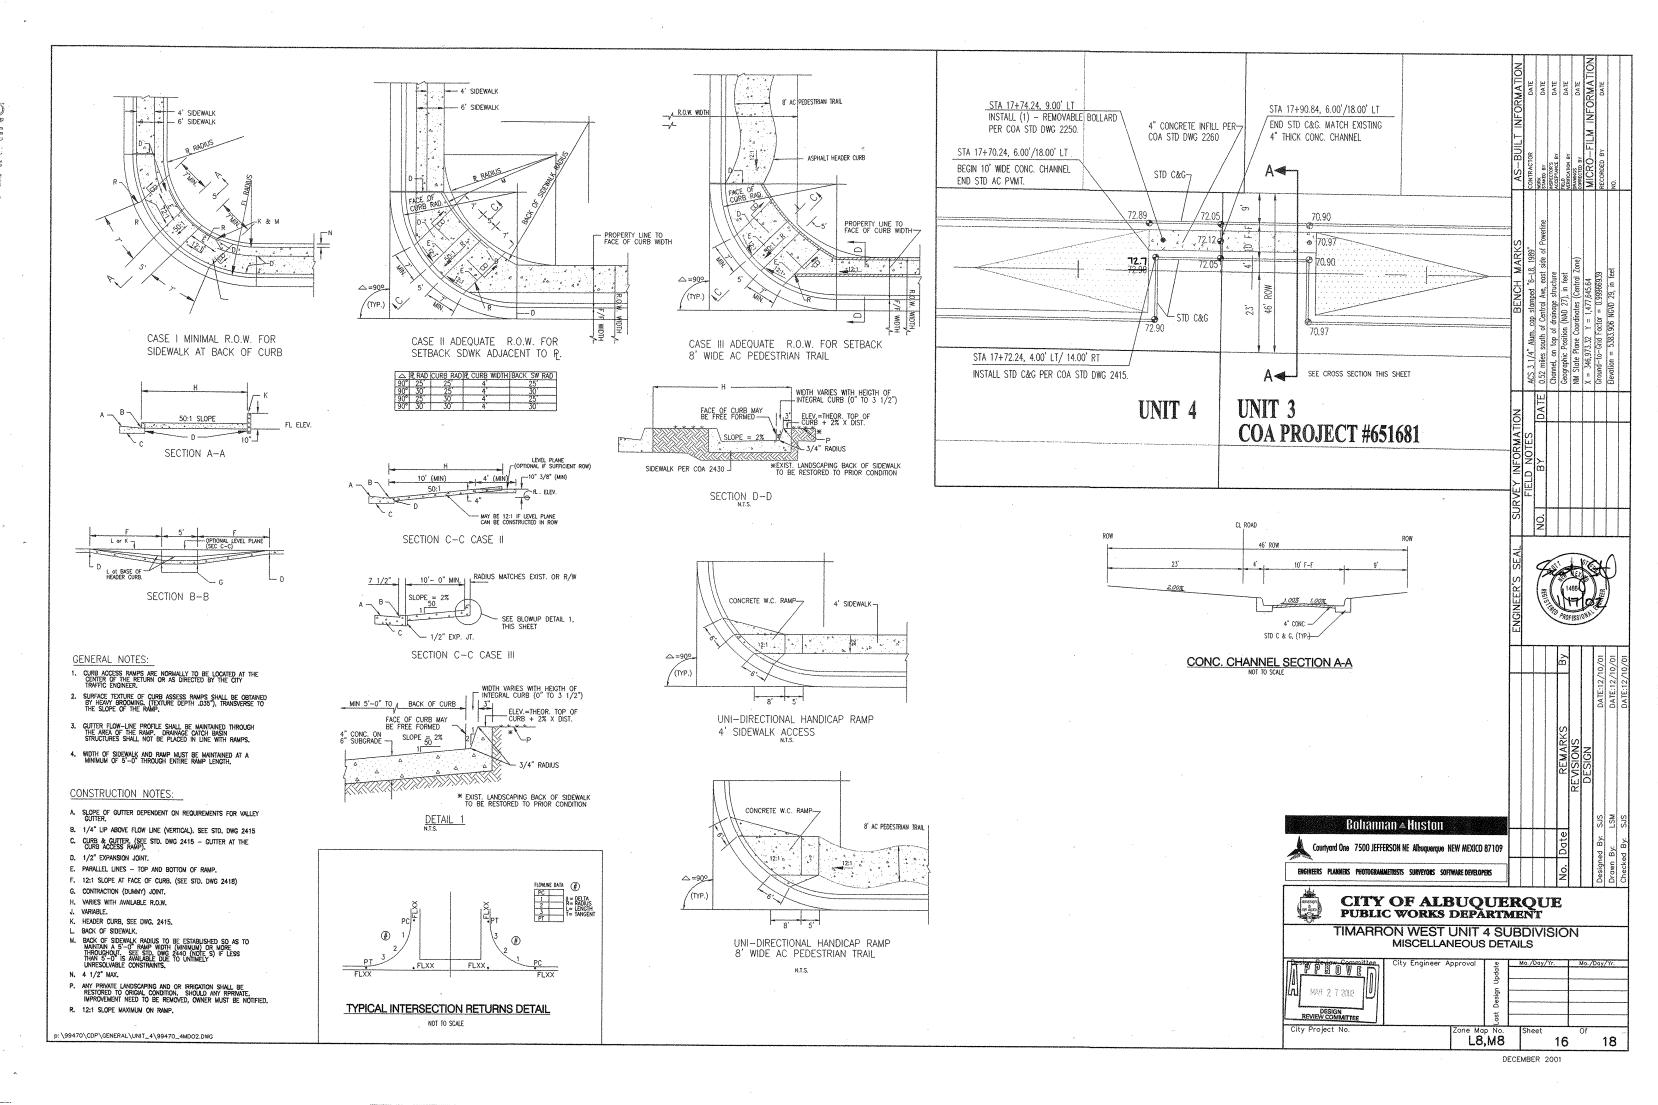

CONSTRUCTION TRAFFIC CONTROL GENERAL NOTES


- 1. CONTRACTOR MUST OBTAIN FROM CONSTRUCTION COORDINATION AN EXCAVATION/BARRICADING PERMIT BEFORE ENGAGING IN ANY CONSTRUCTION, MAINTENANCE OR REPAIR WORK IN ANY OF THE CITY OF ALBUQUERQUE'S RIGHTS-OF-WAY, EMERGENCY WORK THAT WOULD PRESERVE LIFE OR PROPERTY IS EXCLUDED WITH THE UNDERSTANDING, THAT A PERMIT SHALL BE OBTAINED WITHIN 24 TO 48 HOURS.
- 2. CONTRACTOR SHALL AT THE TIME OF PERMIT REQUEST, SUBMIT FOR APPROVAL BY CONSTRUCTION COORDINATION, A TRAFFIC CONTROL PLAN DETAILING ALL EXISTING TOPOGRAPHY SUCH AS LANE WIDTHS, DRIVEWAYS, AND BUSINESS/RESIDENTIAL ACCESSES. THE TRAFFIC CONTROL PLAN SHALL INCLUDE ALL PHASES OF WORK AND SCHEDULES INVOLVED IN THE CONSTRUCTION PROJECT. ANY SEPERATE PHASES OF A CONSTRUCTION PROJECT SHALL BE GIVEN AN INDIVIDUAL PERMIT EACH. BLANKET PERMITS WILL NOT BE ISSUED.
- 3. THESE TYPICAL TRAFFIC CONTROL PLANS DO NOT REFLECT THE EXISTING TOPOGRAPHY SUCH AS DRIVEWAYS, LANE WIDTHS, AND BUSINESS/RESIDENTIAL ACCESSES. EVERY LOCATION THAT REQUIRES CONSTRUCTION TRAFFIC CONTROL SHALL HAVE A DETAILED TRAFFIC CONTROL PLAN SHOWING ALL FXISTING TOPOGRAPHY
- 4. CONSTRUCTION SHALL NOT BEGIN UNLESS A TRAFFIC CONTROL PLAN HAS REEN APPROVED AND VERIFIED BY CONSTRUCTION COORDINATION
- 5. CONSTRUCTION COORDINATION SHALL BE NOTIFIED 48 HOURS PRIOR TO ANY TRAFFIC CONTROL CHANGES NEEDED BY CONTRACTOR, THAT WERE NOT PREVIOUSLY APPROVED. THESE TRAFFIC CONTROL CHANGES SHALL BE REQUESTED IN WRITING ACCOMPANIED WITH A TRAFFIC CONTROL PLAN REFILE OF THIS SLIPPLE CHANGES.
- 6. ALL CONSTRUCTION TRAFFIC CONTROL DEVICES SHALL COMPLY TO THE MANUAL ON UNIFORM TRAFFIC CONTROL DEVICES (MUTCD), LATEST EDITION, IT IS THE RESPONSIBILITY OF THE CONTRACTOR TO INSTALL, SERVICE AND MAINTAIN ALL TRAFFIC CONTROL DEVICES. TRAFFIC CONTROL DEVICES SHALL NOT BE REMOVED OR ALTERED IN ANY WAY WITHOUT THE APPROVAL OF CONSTRUCTION COORDINATION, PER SECTION 6A-4 OF THE MUTCD, LATEST EDITION.
- THE CONSTRUCTION TRAFFIC CONTROL INITIAL SET—UP SHALL BE BY AN AMERICAN TRAFFIC SAFETY SERVICES ASSOCIATION (ATSSA) CERTIFIED WORKSITE TRAFFIC SUPERVISOR. THE MAINTENANCE AND SERVICING SHALL ALSO BE DONE BY AN ATSSA CERTIFIED WORKSITE TRAFFIC SUPERVISOR OR EQUIVALENT.
- CONTRACTOR IS RESPONSIBLE TO MAINTAIN AND SERVICE ALL TRAFFIC CONTROL DEVICES 24 HOURS A DAY, 7 DAYS A WEEK THROUGHOUT LENGTH OF PROJECT. CONTRACTOR IS RESPONSIBLE THAT ALL TRAFFIC CONTROL DEVICES COMPLY WITH THE MUTCD, LATEST EDITION.
- ALL ADVANCE WARNING SIGNS SHALL BE DOUBLE INDICATED WHENEVER THERE ARE MULTI-LANE TRAFFIC IN ANY ONE GIVEN DIRECTION AND THERE IS SUFFICIENT MEDIAN SPACE,
- 10. ALL BARRICADES IN ALL TAPERS AND TANGENTS SHALL BE PLACED APART, A DISTANCE MEASURED IN FEET, EQUAL TO THAT OF THE POSTED SPEED LIMIT. NO EXCEPTIONS UNLESS APPROVED BY CONSTRUCTION COORDINATION PER MUTCD SECTION 6A-4.
- ALL WORK IN ARTERIAL ROADWAYS SHALL BE ON A CONTINUOUS 24 HOUR PER DAY BASIS UNTIL COMPLETED.
- 12. CONTRACTOR IS RESPONSIBLE TO PROVIDE CONSTRUCTION COORDINATION, A WEEKLY LOG OF DAILY INSPECTIONS OF BARRICADE AND MAINTENANCE SCHEDULES ON PROJECTS THAT ARE OVER ONE WEEK DURATION.
- 13. EQUIPMENT OR MATERIALS SHALL NOT BE STORED WITHIN 15 FEET OF A TRAVELED TRAFFIC LANE DURING NON-WORKING HOURS WITHOUT THE APPROVAL OF CONSTRUCTION COORDINATION.
- 14. CONTRACTOR SHALL.PROVIDE AND MAINTAIN A SAFE AND ADEQUATE MEANS OF CHANNELIZING PEDESTRIAN TRAFFIC AROUND AND THROUGH THE CONSTRUCTION AREA.
- 15. CONTRACTOR IS RESPONSIBLE FOR OBLITERATION OF ANY CONFLICTING STRIPING AND RESPONSIBLE FOR ALL TEMPORARY STRIPING.
- CONTRACTOR SHALL MAINTAIN ACCESS TO ALL FACILITIES, BUSINESSES AND/OR RESIDENTS AT ALL TIMES.
- 17. CONTRACTOR SHALL PROVIDE ACCESS SIGNS FOR BUSINESSES LOCATED WITHIN THE CONSTRUCTION AREA UNDER THE SUPERVISION OF CONSTRUCTION COORDINATION. EACH ACCESS SIGN SHALL HAVE 5 INCH, WHITE OPAQUE LETTERING ON BLUE REFLECTORIZED BACKGROUND. ACCESS SIGNS SHALL BE CONSIDERED INCIDENTAL TO THE BID AND NOT PART OF THE CONTRACT UNLESS OTHERWISE STATED. NO MORE THAN 3 BUSINESSES SHALL BE LISTED ON AN ACCESS SIGN. SHOPPING CENTERS AND MALLS SHALL BE LISTED AS SUCH.
- 18. ALL ADVANCE WARNING SIGNS SHALL MEET THE MINIMUM REFLECTIVE INTENSITY REQUIREMENTS SET FORTH BY THE CITY OF ALBUQUERQUE. CONSTRUCTION COORDINATION SHALL DETERMINE ALL REQUIREMENTS AND APPROVE OR DISAPPROVE ANY ADVANCE WARNING SIGN PER SECTION 6A-4 OF THE MUTCD, LATEST EDITION.
- 19. 48 HOURS PRIOR TO OCCUPYING OR CLOSING OF A RIGHT-OF-WAY, CONTRACTOR SHALL NOTIFY: POLICE, FIRE DEPARTMENT, SCHOOLS, HOSPITALS, TRANSIT AUTHORITY, BUSINESSES AND/OR RESIDENTS THAT WILL BE AFFECTED BY THE CONSTRUCTION.
- 20. ANY FIELD ADJUSTMENTS SHALL BE APPROVED BY CONSTRUCTION


- 21. EXCAVATIONS SHALL BE PLATED, TEMPORARILY PATCHED OR RESURFACED PRIOR TO OPENING OF TRAFFIC. A MINIMUM OF 11 FEET SHALL BE PROVIDED FOR TRAFFIC IN ANY GIVEN DIRECTION. CONTRACTOR IS RESPONSIBLE FOR ANY WORK INVOLVED IN SATISFYING THESE REQUIREMENTS.
- 22. CONTRACTOR SHALL AT ALL TIMES COMPLY WITH THE FOLLOWING:


 1. STANDARDS AND REQUIREMENTS SET FORTH IN THE MANUAL ON UNIFORM TRAFFIC CONTROL DEVICES, LATEST EDITION.

 2. THE CITY OF ALBUQUERQUE TRAFFIC CODE, LATEST EDITION,

 3. SECTION 19 OF THE CITY OF ALBUQUERQUE'S STANDARD SPECIFICATIONS FOR PUBLIC WORK CONSTRUCTION, AS WELL AS OTHER SECTIONS.
- 23. FAILURE TO COMPLY WITH ANY OF THE ABOVE MENTIONED, WILL BE ADEQUATE CAUSE TO CEASE ALL WORK ON ANY CONSTRUCTION PROJECT. WORK WILL NOT RESUME UNTIL ALL REQUIREMENTS ARE ADDRESSED AND APPROVED BY CONSTRUCTION COORDINATION.
- 24. ALL TRAFFIC CONTROL DEVICES SHALL BE KEPT IN NEW-CLEAN CONDITION, WASHING OF EQUIPMENT IS INCIDENTAL TO IT'S PLACEMENT AND MAINTENANCE.
- 25. TRAFFIC CONTROL STANDARDS APPLY ONLY WHERE THE CONSTRUCTION TRAFFIC CONTROL PLANS ARE NOT SPECIFIC.
- 26. ADVANCE WARNING SIGNS SHALL BE 36"x36" MIN. WITH SUPER ENGINEERING GRADE SHEETING OR BETTER. MOUNTING HEIGHT AT TOP OF SIGN SHALL BE THE SAME AS FOR A 48" SIGN AS INDICATED IN THE M.U.T.C.D.
- 27. CONTRACTOR SHALL MAINTAIN A GRAFFITI-FREE WORKSITE. ALL GRAFFITI SHALL BE PROMPTLY REMOVED FROM ALL EQUIPTMENT, BOTH PERMANENT AND TEMPORARY.

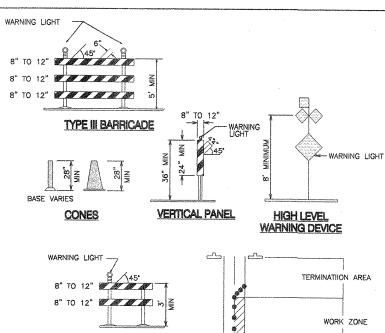

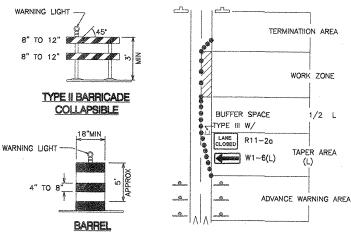

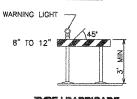


TRAFFIC CONTROL ELEMENTS

END CONSTRUCTIO

TYPE I BARRICADE COLLAPSIBLE

SIGN FACE DETAILS

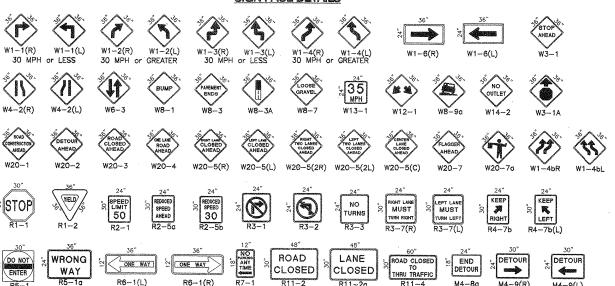








ALL CONSTRUCTIONN WARNING SIGNS SHALL HAVE A BLACK LEGEND ON A ORANGE BACKGROUND.

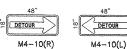

TAPER REQUIREMENT

THE TANGENT LENGTH IS EQUAL TO THE TAPER LENGTH FOR A GIVEN STREET.

EQUAL TO THE STREET LIMIT OF THE STREET

TAPER LENGTH - SEE CHART BELOW

LEGEND

DISTANCE BETWEEN SIGNS - A DISTANCE MEASURED IN FEET EQUAL

TO A VALUE OF TEN TIMES THE SPEED LIMIT OF THE STREET

SPACING BETWEEN BARRICADES - A DISTANCE MEASURED IN FEET

BARRICADE - TYPE I, TYPE II, OR BARREI

BARRICADE - TYPE III

VERTICAL PANEL WARNING SIGN

FLAGMAN POSITION

WORK AREA

SPEED LIMIT	TAP	ER LENGTI (FEET)	H(L)	MINIMUM NUMBER OF	MAXIMUM SPACING	
(MPH)	10' LANE	LANE	12' LANE	DEVICES FOR TAPER	ALONG TAPER	AFTER TAPER
20	70	75	80	5	20	20
25	105	115	125	6	25	25
30	150	165	180	7	30	30
35	205	225	245	8	35	35
40	270	295	320	9	40	40
45	450	495	540	13	45	45
50	500	550	600	13	50	50
55	550	605	660	13	55	55

RECOMMENDED SIGN SPACING(D) FOR ADVANCE WARNING SIGN SERIES

SPEED MILES PER HOUR	BETWEEN					ILES BETWEEN FROM L							?
0-20	10	Х	SPEED	LIMIT	10	Х	SPEED LIMIT						
25-30	10	Χ	SPEED	LIMIT	10	Χ	SPEED LIMIT						
30-35	10	Χ	SPEED	LIMIT	10	Χ	SPEED LIMIT						
40-45	10	Χ	SPEED	LIMIT	10	χ	SPEED LIMIT						
50-60	10	Х	SPEED	LIMIT	10	Х	SPEED LIMIT						

TAPER CRITERIA

TYPE OF TAPER	TAPER LENGTH
UPSTREAM TAPER:	,
MERGING TAPER	L MINIMUM
SHIFTING TAPER	1/2 L MINIMUM
SHOULDER TAPER	1/2 L MINIMUM
TWO-WAY TRAFFIC TAPER	100 FEET MAXIMUM
DOWNSTREAM TAPERS	100 FEET PER LANI

TAPER LENGTH COMPUTATION

SP	EED L	IMIT						
40	мрн	OR	LESS	L	===	WS 60	2	
40	MPH	OR	GREATER	L	=	W	x	5

L = TAPER LENGTH
W = WIDTH OF OFFSET IN FEET
S = POSTED SPEED OR OFF-PEAK

Bohannan ≜Hu ton			_		SJS	LSM	
Courtyard One 7500 JEFFERSON NE Albuquenque NEW MEXICO 87109			Date		ed By.	By:	
ENGINEERS PLANNERS PHOTOGRAMMETRISTS SURVEYORS SOFTWARE DEVELOPERS			Š		Design	Drawn	
364	 	-	 	 			_

PUBLIC	OF ALBUC C WORKS DEP	ĀRTI	MENT	
TI	ON WEST UNIT RAFFIC CONTROL CTION TRAFFIC CO	SIGN	ING &	
Design Review Committee	City Engineer Approval		Mo./Day/Yr.	Ma./Day/
COA	COA	Update		

COA STD	COA	1	Last Design Update				
City Project No.	71683	Zone Ma L8,	р No. М8	Sheet	17	Of	1

기기

AND AND CURB

