



P:\\$Year-2003\7703\7703-acad\7703-\$current\7703-support\7703-Cover.dwg, 6/8/2005 8:55:47 AM, pcogburn, 1:1

SPRUCE PARK RENOVATION

1300 ROMA AVENUE N.E.
ALBUQUERQUE, NEW MEXICO

PROJECT DESIGN AND CONSTRUCTION MANAGEMENT: DEPARTMENT OF MUNICIPAL DEVELOPMENT PARK DESIGN AND CONSTRUCTION DIVISION


OWNER: PARKS AND RECREATION DEPARTMENT

| INDEX OF DRAWINGS | |
|-------------------|--------------|
| SHEET TITLE | SHEET NUMBER |
| COVER SHEET | . 1 |
| DEMOLITION PLAN | 2 |
| GRADING PLAN | 3 |
| CONSTRUCTION PLAN | 4 |
| LAYOUT PLAN | 5 |
| IRRIGATION PLAN | 6 |
| PLANTING PLAN | 7 |

| TURF FIGURES | |
|-------------------|------------|
| TOTAL PARK AREA | 1.04 ACRES |
| TURF AREA | 1 ACRES |
| HARD SURFACE AREA | .04 ACRES |
| | |

WATER METER ADDRESS 1300 ROMA AVENUE N.E., ALBUQUERQUE, NEW MEXICO


SITE AMENITIES EXISTING BENCHES REMOVED - 4 EXISTING SWING SET REMOVED - 1 BENCHES INSTALLED - 6 PLAY EQUIPMENT INSTALLED - 1 COMPOSIT STRUCTURE EXISTING TABLES REMOVED - 2 DOG BAG DISPENSER INSTALLED - 1 TABLES INSTALLED - 2 EXITING TRASH RECEPTACLES TO REMAIN - 7

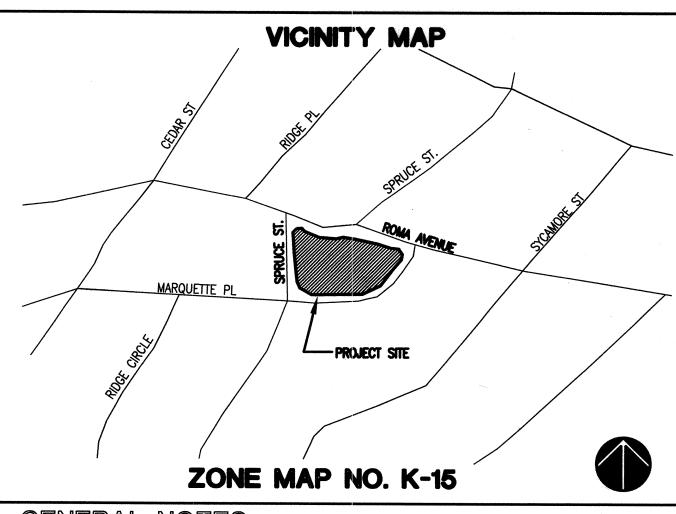


GENERAL NOTES

1. ALL WORK ON THESE PLANS TO BE PERFORMED UNDER CONTRACT, EXCEPT AS OTHERWISE STATED OR PROVIDED HEREIN, SHALL BE CONSTRUCTED IN ACCORDANCE WITH THE CITY OF ALBUQUERQUE STANDARD SPECIFICATIONS – PUBLIC WORKS CONSTRUCTION – 1986 EDITION, AS AMENDED THROUGH UPDATE #6.

- 2. TWO (2) WORKING DAYS PRIOR TO ANY EXCAVATION, THE CONTRACTOR MUST CONTACT NEW MEXICO ONE CALL SYSTEM, 260—1990, FOR LOCATION INFORMATION OF EXISTING LITHIUTIES.
- 3. IF ANY UTILITY LINES, PIPELINES, OR UNDERGROUND UTILITY LINES ARE SHOWN ON THESE DRÁWINGS THEY ARE SHOWN IN AN APPROXIMATE MANNER ONLY, AND SUCH LINES MAY EXIST WHERE NONE ARE SHOWN. IF ANY SUCH EXISTING LINES ARE SHOWN, THE LOCATION IS BASED ON INFORMATION PROVIDED BY THE OWNER OF SAID UTILITY, AND THE INFORMATION MAY BE INCOMPLETE, OR MAY BE OBSOLETE BY THE TIME CONSTRUCTION COMMENCES. THE LANDSCAPE ARCHITECT HAS CONDUCTED ONLY PRELIMINARY INVESTIGATION OF THE LOCATION, DEPTH, SIZE, OR TYPE OF EXISTING UTILITY LINES, PIPELINES OR UNDERGROUND UTILITY LINES. THIS INVESTIGATION IS NOT CONCLUSIVE, AND MAY NOT BE COMPLETE, THEREFORE, MAKES NO REPRESENTATION PERTAINING THERETO, AND ASSUMES NO RESPONSIBILITY OR LIABILITY. THEREFORE THE CONTRACTOR SHALL INFORM ITSELF OF THE LOCATION OF ANY UTILITY LINES, PIPELINES, OR UNDERGROUND UTILITY LINE IN OR NEAR THE AREA OF THE WORK IN ADVANCE OF AND DURING EXCAVATION WORK. THE CONTRACTOR IS FULLY RESPONSIBLE FOR ANY AND ALL DAMAGE CAUSED BY ITS FAILURE TO LOCATE, IDENTIFY AND PRESERVE ANY AND ALL EXISTING UTILITIES, PIPELINES, AND UNDERGROUND LINE. IN PLANNING AND CONDUCTING EXCAVATION, THE CONTRACTOR SHALL COMPLY WITH STATE STATUTES, MUNICIPAL AND LOCAL ORDINANCES, RULES AND REGULATIONS, IF ANY, PERTAINING TO THE LOCATION OF THESE UTILITY LINES AND FACILITIE
- 4. SHOULD A CONFLICT EXIST BETWEEN THESE PLANS AND THE ACTUAL FIELD CONDITIONS, THE CONTRACTOR SHALL PROMPTLY NOTIFY THE LANDSCAPE ARCHITECT IN WRITING SO TAHT THE CONFLICT CAN BE RESOLVED WITH THE MINIMUM AMOUNT OF DELAY FOR ALL PARTIES.
- 5. THE CONTRACTOR SHALL MAINTAIN ACCESS TO ADJACENT PROPERTIES DURING CONSTRUCTION
- 6. ALL WORK ON THIS PROJECT SHALL BE PERFORMED IN ACCORDANCE WITH THE APPLICABLE FEDERAL, STATE AND LOCAL LAWS, RULES AND REGULATIONS CONCERNING SAFETY AND HEALTH.
- 7. ALL UTILITIES AND UTILITY SERVICE LINES SHALL BE INSTALLED PRIOR TO PAVING.
- 8. BACKFILL COMPACTION SHALL BE ACCORDING TO SPECIFIED STREET USE.
- 9. TACK COAT REQUIREMENTS SHALL BE DETERMINED DURING CONSTRUCTION BY THE LANDSCAPE ARCHITEC
- 10. CONTRACTOR SHALL COORDINATE WITH THE WATER SYSTEM DIVISION FOR THE EXECUTION OF THE VALVE SHUT OFF PLAN, NOT LESS THAN SEVEN (7) WORKING DAYS IN ADVANCE OF ANY WORK THAT MAY AFFECT THE EXISTING PUBLIC WATER UTILITIES. ONLY WATER SYSTEM PERSONNEL SHALL OPERATE EXISTING VALVES, REFER TO SECTION 18 OF THE SPECIFICATIONS.
- 11. CONTRACTOR SHALL NOTIFY CITY SURVEYING NOT LESS THAN SEVEN (7) DAYS PRIOR TO STARTING WORK IN ORDER THAT CITY SURVEYING MAY TAKE NECESSARY MEASURES TO INSURE THE PRESERVATION OF SURVEY MONUMENTS. CONTRACTOR SHALL NOT DISTURB PERMANENT SURVEY MONUMENTS WITHOUT THE CONSENT AND PERMISSION OF CITY SURVEYING. REPLACEMENT SHALL BE DONE ONLY BY CITY SURVEYING. WHEN A CHANGE IS MADE IN THE FINISHED ELEVATION OF THE PAVEMENT OF ANY ROADWAY IN WHICH A PERMANENT SURVEY MONUMENT IS LOCATED, CONTRACTOR SHALL, AT ITS OWN EXPENSE, ADJUST THE MONUMENT AND ITS COVER TO THE NEW GRADE UNLESS OTHERWISE SPECIFIED. REFER TO SECTION 4.4 OF THE SPECIFICATIONS.
- 2. FIVE (5) WORKING DAYS PRIOR TO BEGINNING CONSTRUCTION, THE CONTRACTOR SHALL SUBMIT TO THE CONSTRUCTION COORDINATION DIVISION, A DETAILED CONSTRUCTION SCHEDULE TWO (2) DAYS PRIOR TO CONSTRUCTION. THE CONTRACTOR SHALL OBTAIN A BARRICADE PERMIT FROM THE CONSTRUCTION COORDINATION DIVISION. CONTRACTOR SHALL NOTIFY BARRICADE ENGINEER (924–3400) PRIOR TO OCCUPYING AN INTERSECTION. CONTRACTOR MUST REFER TO SECTION 19 OF THE STANDARD SPECIFICATIONS FOR TRAFFIC CONTROL.
- 13. ALL STREET STRIPING ALTERED OR DESTROYED SHALL BE REPLACED WITH PLASTIC REFLECTORIZED PAVEMENT MARKINGS TO SAME LOCATION AND AS EXISTING OR AS INDICATED BY THIS PLAN SET.
- 14. CONTRACTOR SHALL MAINTAIN A GRAFFITI-FREE WORK SITE. CONTRACTOR SHALL PROMTLY REMOVE ANY AND ALL GRAFFITI FROM EQUIPMENT, WHETHER PERMANENT OR TEMPORARY.

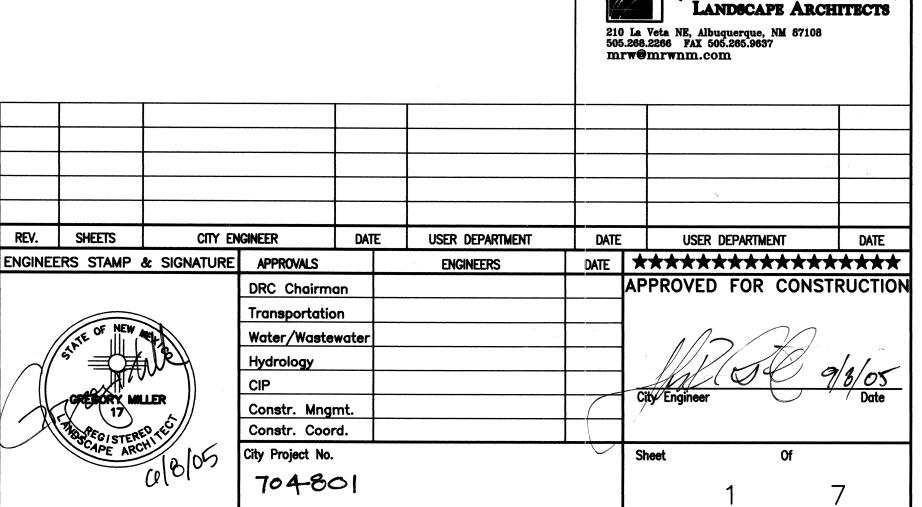

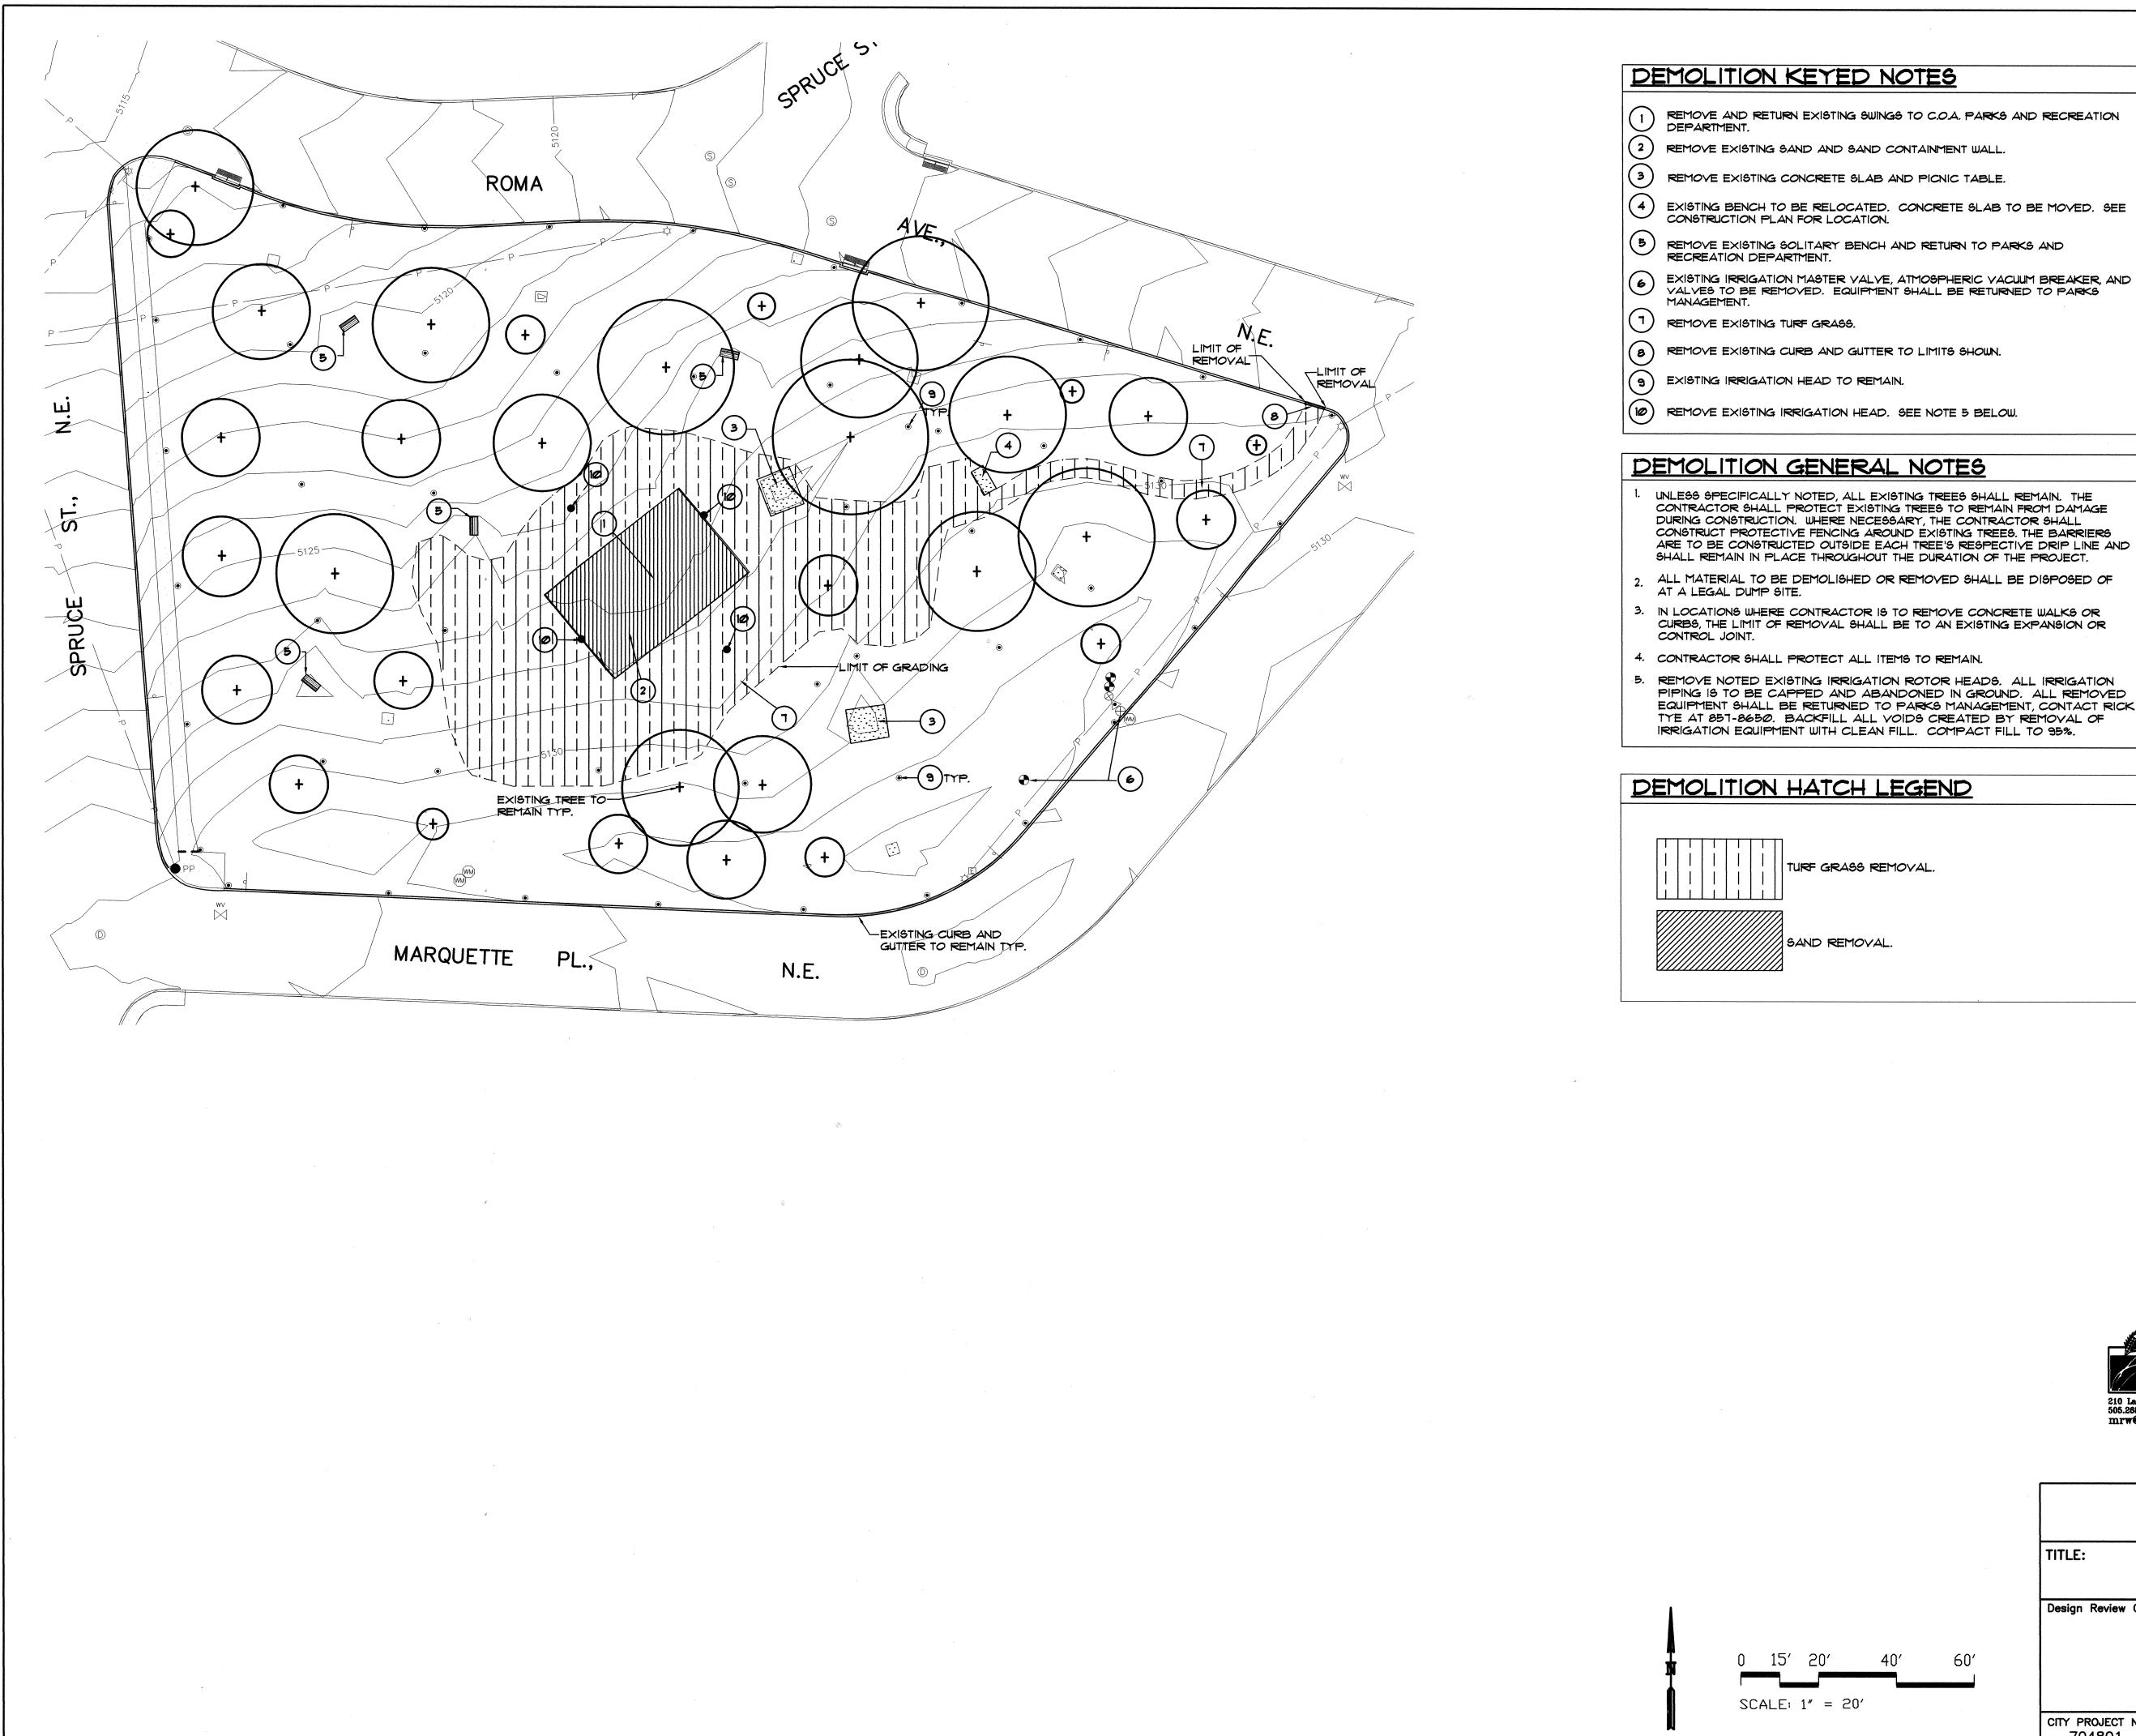

| _ | | | | | | | | | - |
|---|----|----|----|----|-----|-----|-----|------|---|
| | DE | EM | OL | IT | ION | KE' | red | NOTE | |

- REMOVE AND RETURN EXISTING SWINGS TO C.O.A. PARKS AND RECREATION
- (2) REMOVE EXISTING SAND AND SAND CONTAINMENT WALL.
- REMOVE EXISTING CONCRETE SLAB AND PICNIC TABLE.
- 5 REMOVE EXISTING SOLITARY BENCH AND RETURN TO PARKS AND
- EXISTING IRRIGATION MASTER VALVE, ATMOSPHERIC VACUUM BREAKER, AND VALVES TO BE REMOVED. EQUIPMENT SHALL BE RETURNED TO PARKS
- REMOVE EXISTING CURB AND GUTTER TO LIMITS SHOWN.
- REMOVE EXISTING IRRIGATION HEAD. SEE NOTE 5 BELOW.


DEMOLITION GENERAL NOTES


- CONTRACTOR SHALL PROTECT EXISTING TREES TO REMAIN FROM DAMAGE DURING CONSTRUCTION. WHERE NECESSARY, THE CONTRACTOR SHALL CONSTRUCT PROTECTIVE FENCING AROUND EXISTING TREES. THE BARRIERS ARE TO BE CONSTRUCTED OUTSIDE EACH TREE'S RESPECTIVE DRIP LINE AND SHALL REMAIN IN PLACE THROUGHOUT THE DURATION OF THE PROJECT.
- ALL MATERIAL TO BE DEMOLISHED OR REMOVED SHALL BE DISPOSED OF
- 3. IN LOCATIONS WHERE CONTRACTOR IS TO REMOVE CONCRETE WALKS OR CURBS, THE LIMIT OF REMOVAL SHALL BE TO AN EXISTING EXPANSION OR
- 4. CONTRACTOR SHALL PROTECT ALL ITEMS TO REMAIN.
- 5. REMOVE NOTED EXISTING IRRIGATION ROTOR HEADS. ALL IRRIGATION PIPING IS TO BE CAPPED AND ABANDONED IN GROUND. ALL REMOVED EQUIPMENT SHALL BE RETURNED TO PARKS MANAGEMENT, CONTACT RICK TYE AT 857-8650. BACKFILL ALL VOIDS CREATED BY REMOVAL OF IRRIGATION EQUIPMENT WITH CLEAN FILL. COMPACT FILL TO 95%.


DEMOLITION HATCH LEGEND


| , | | CITY OF ALBUQUERQUE DEPARTMENT OF MUNICIPAL DEVELOPMENT PARK DESIGN AND CONSTRUCTION DIVISION |
|---|--------|---|
| | TITLE: | SPRUCE PARK LANDSCAPE IMPROVEMENTS |
| | | DEMOLITION PLAN |

Mo/Day/yr. Mo/Day/yr. CITY PROJECT NO. 704801 ZONE MAP NO. OF

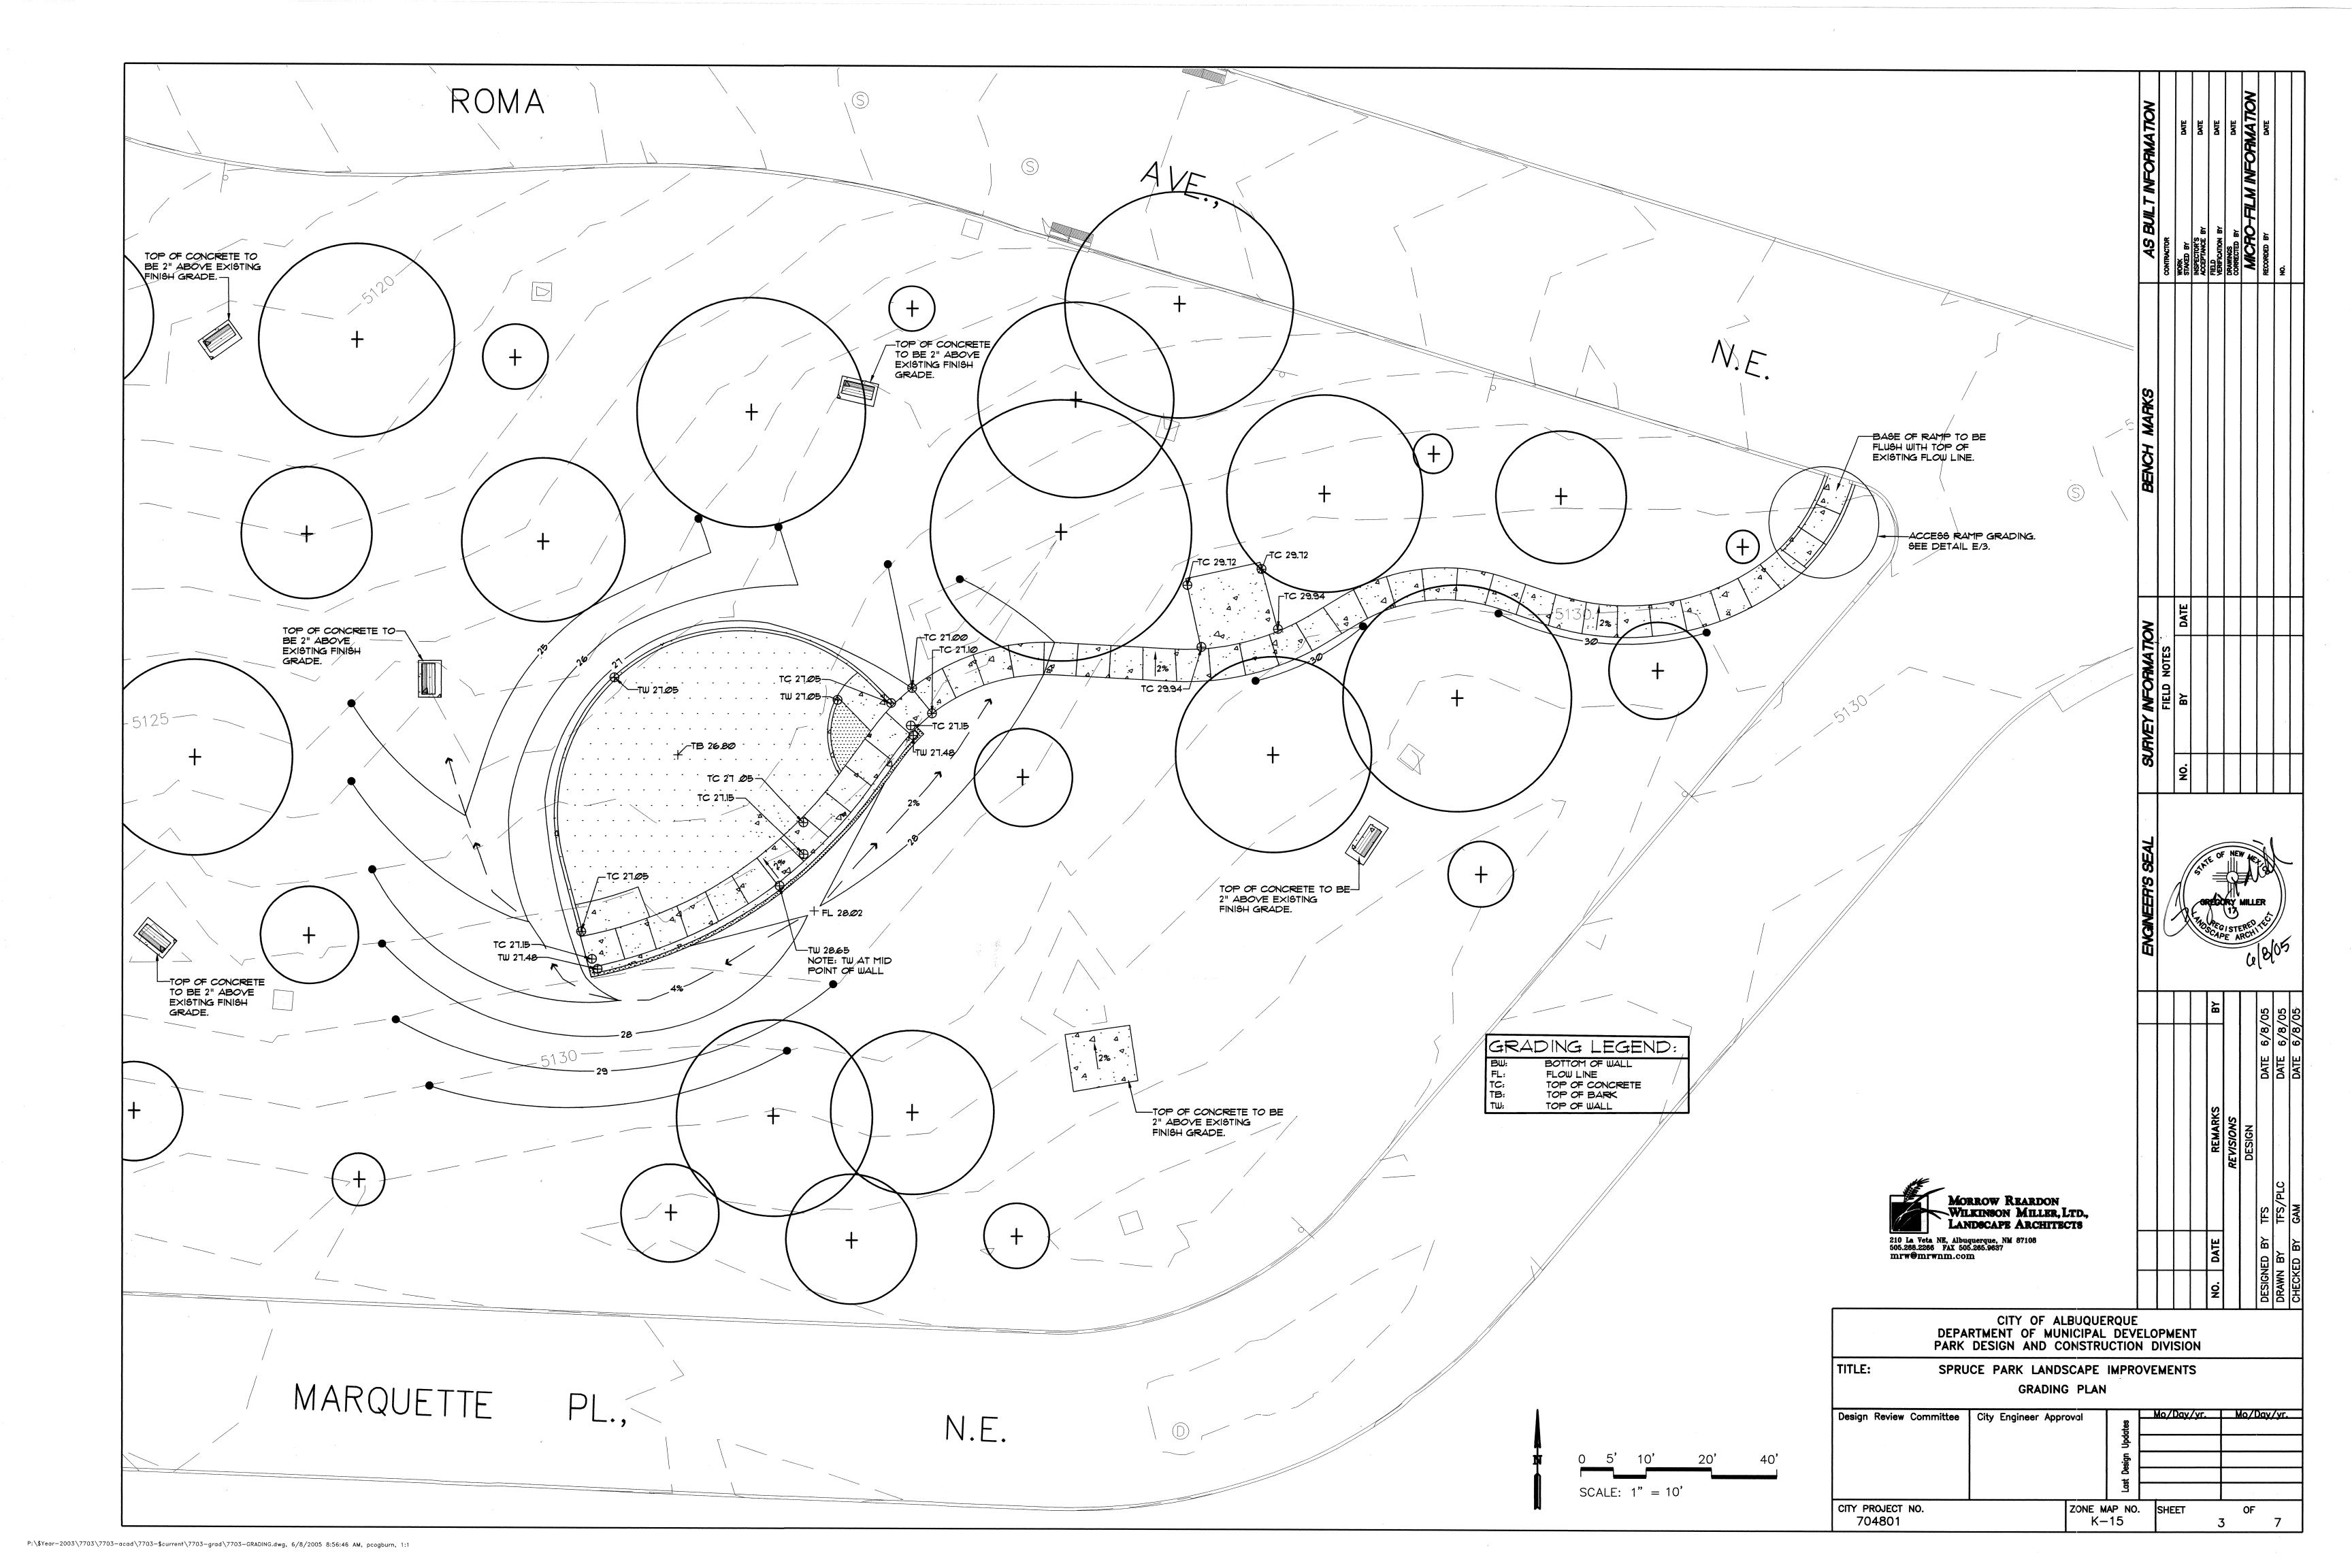

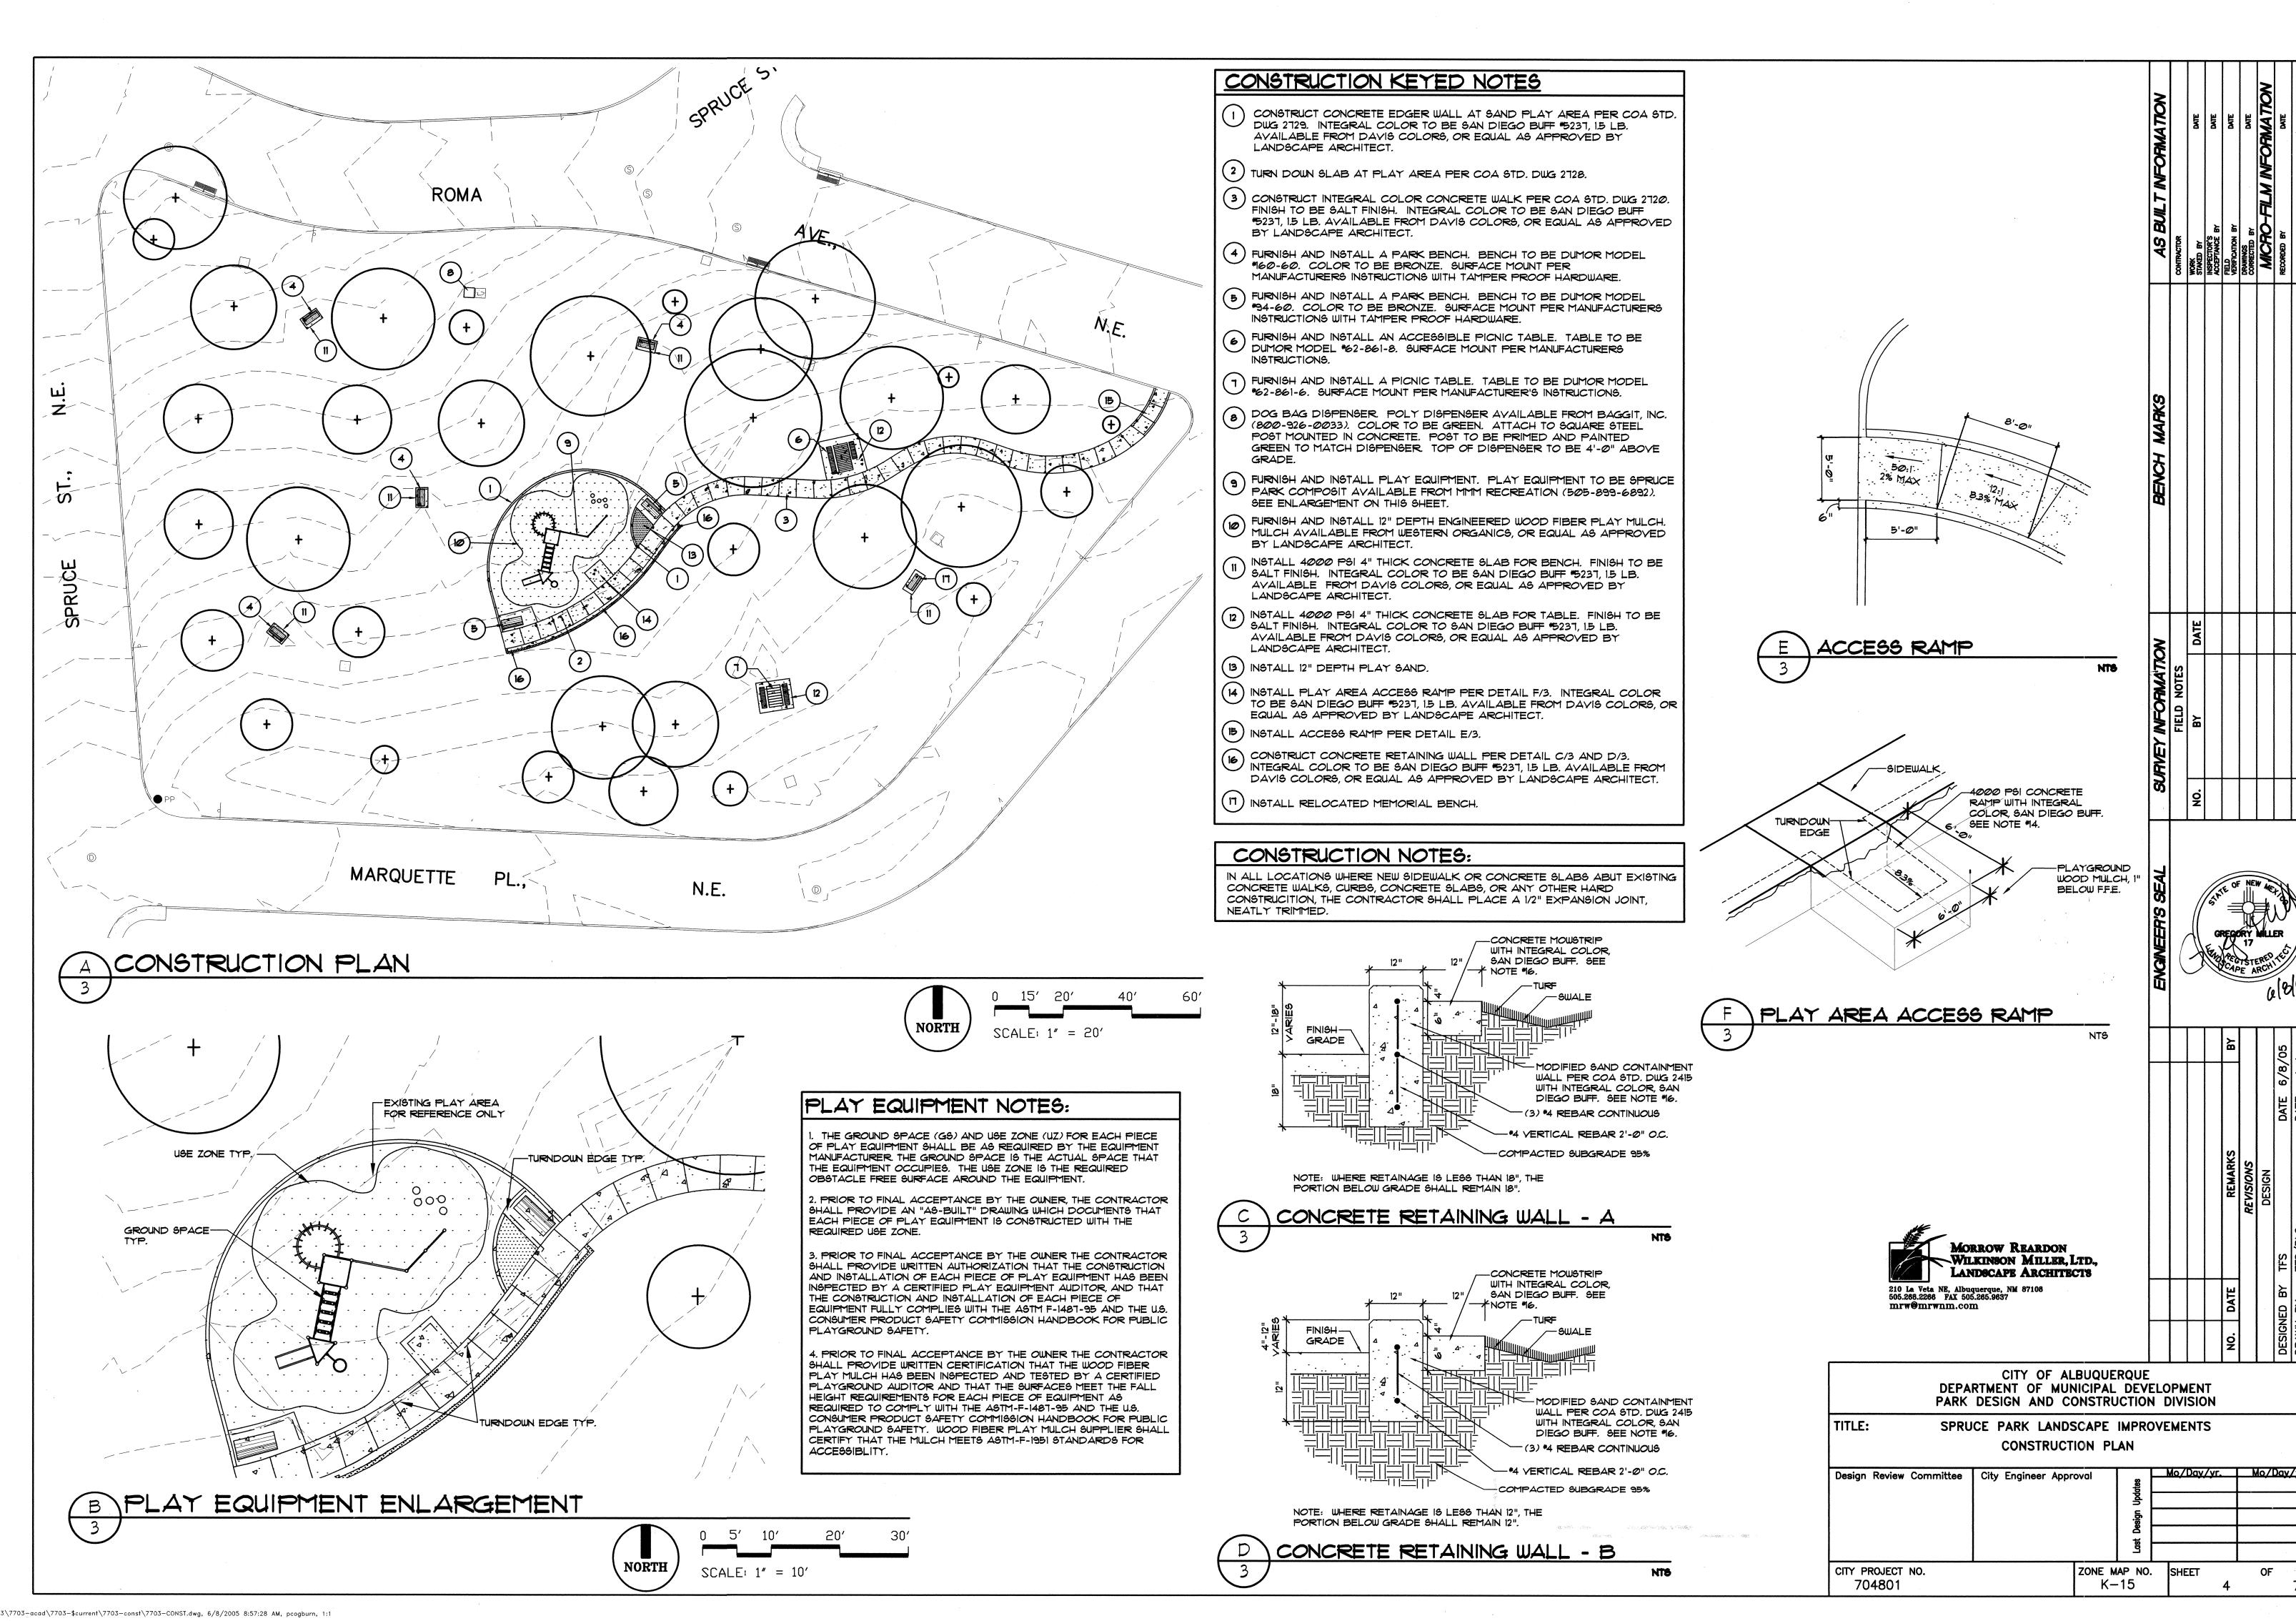

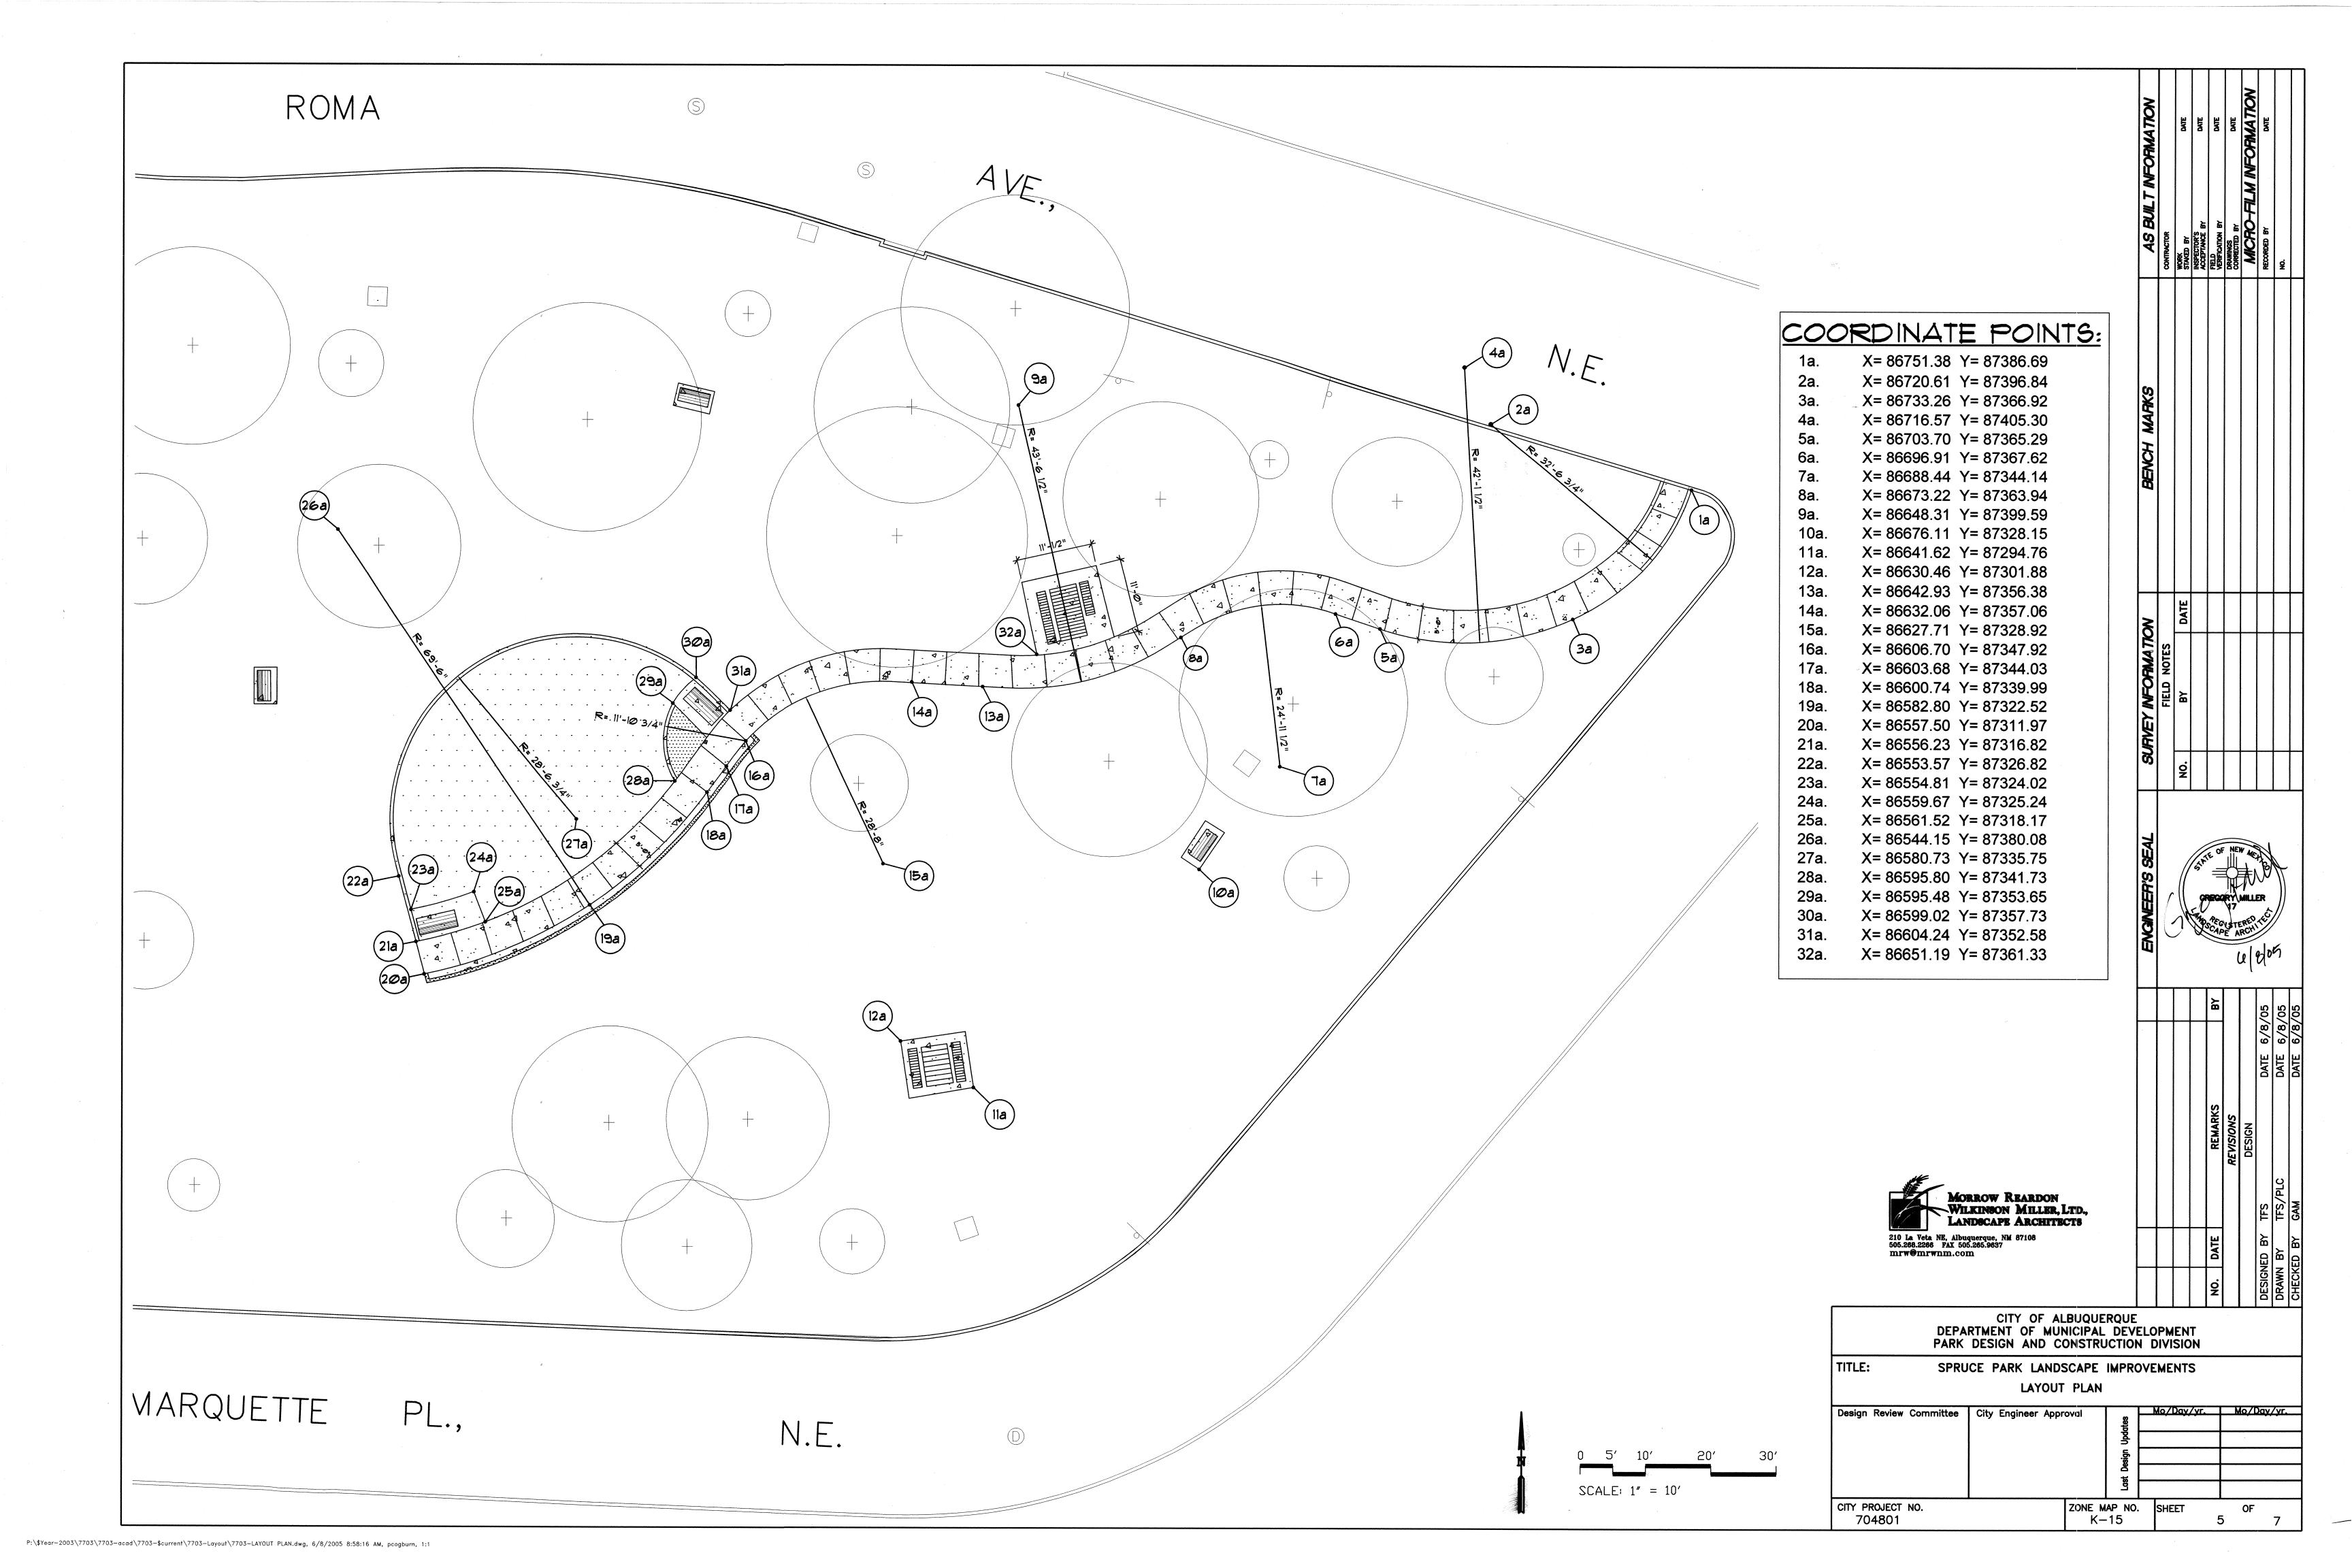

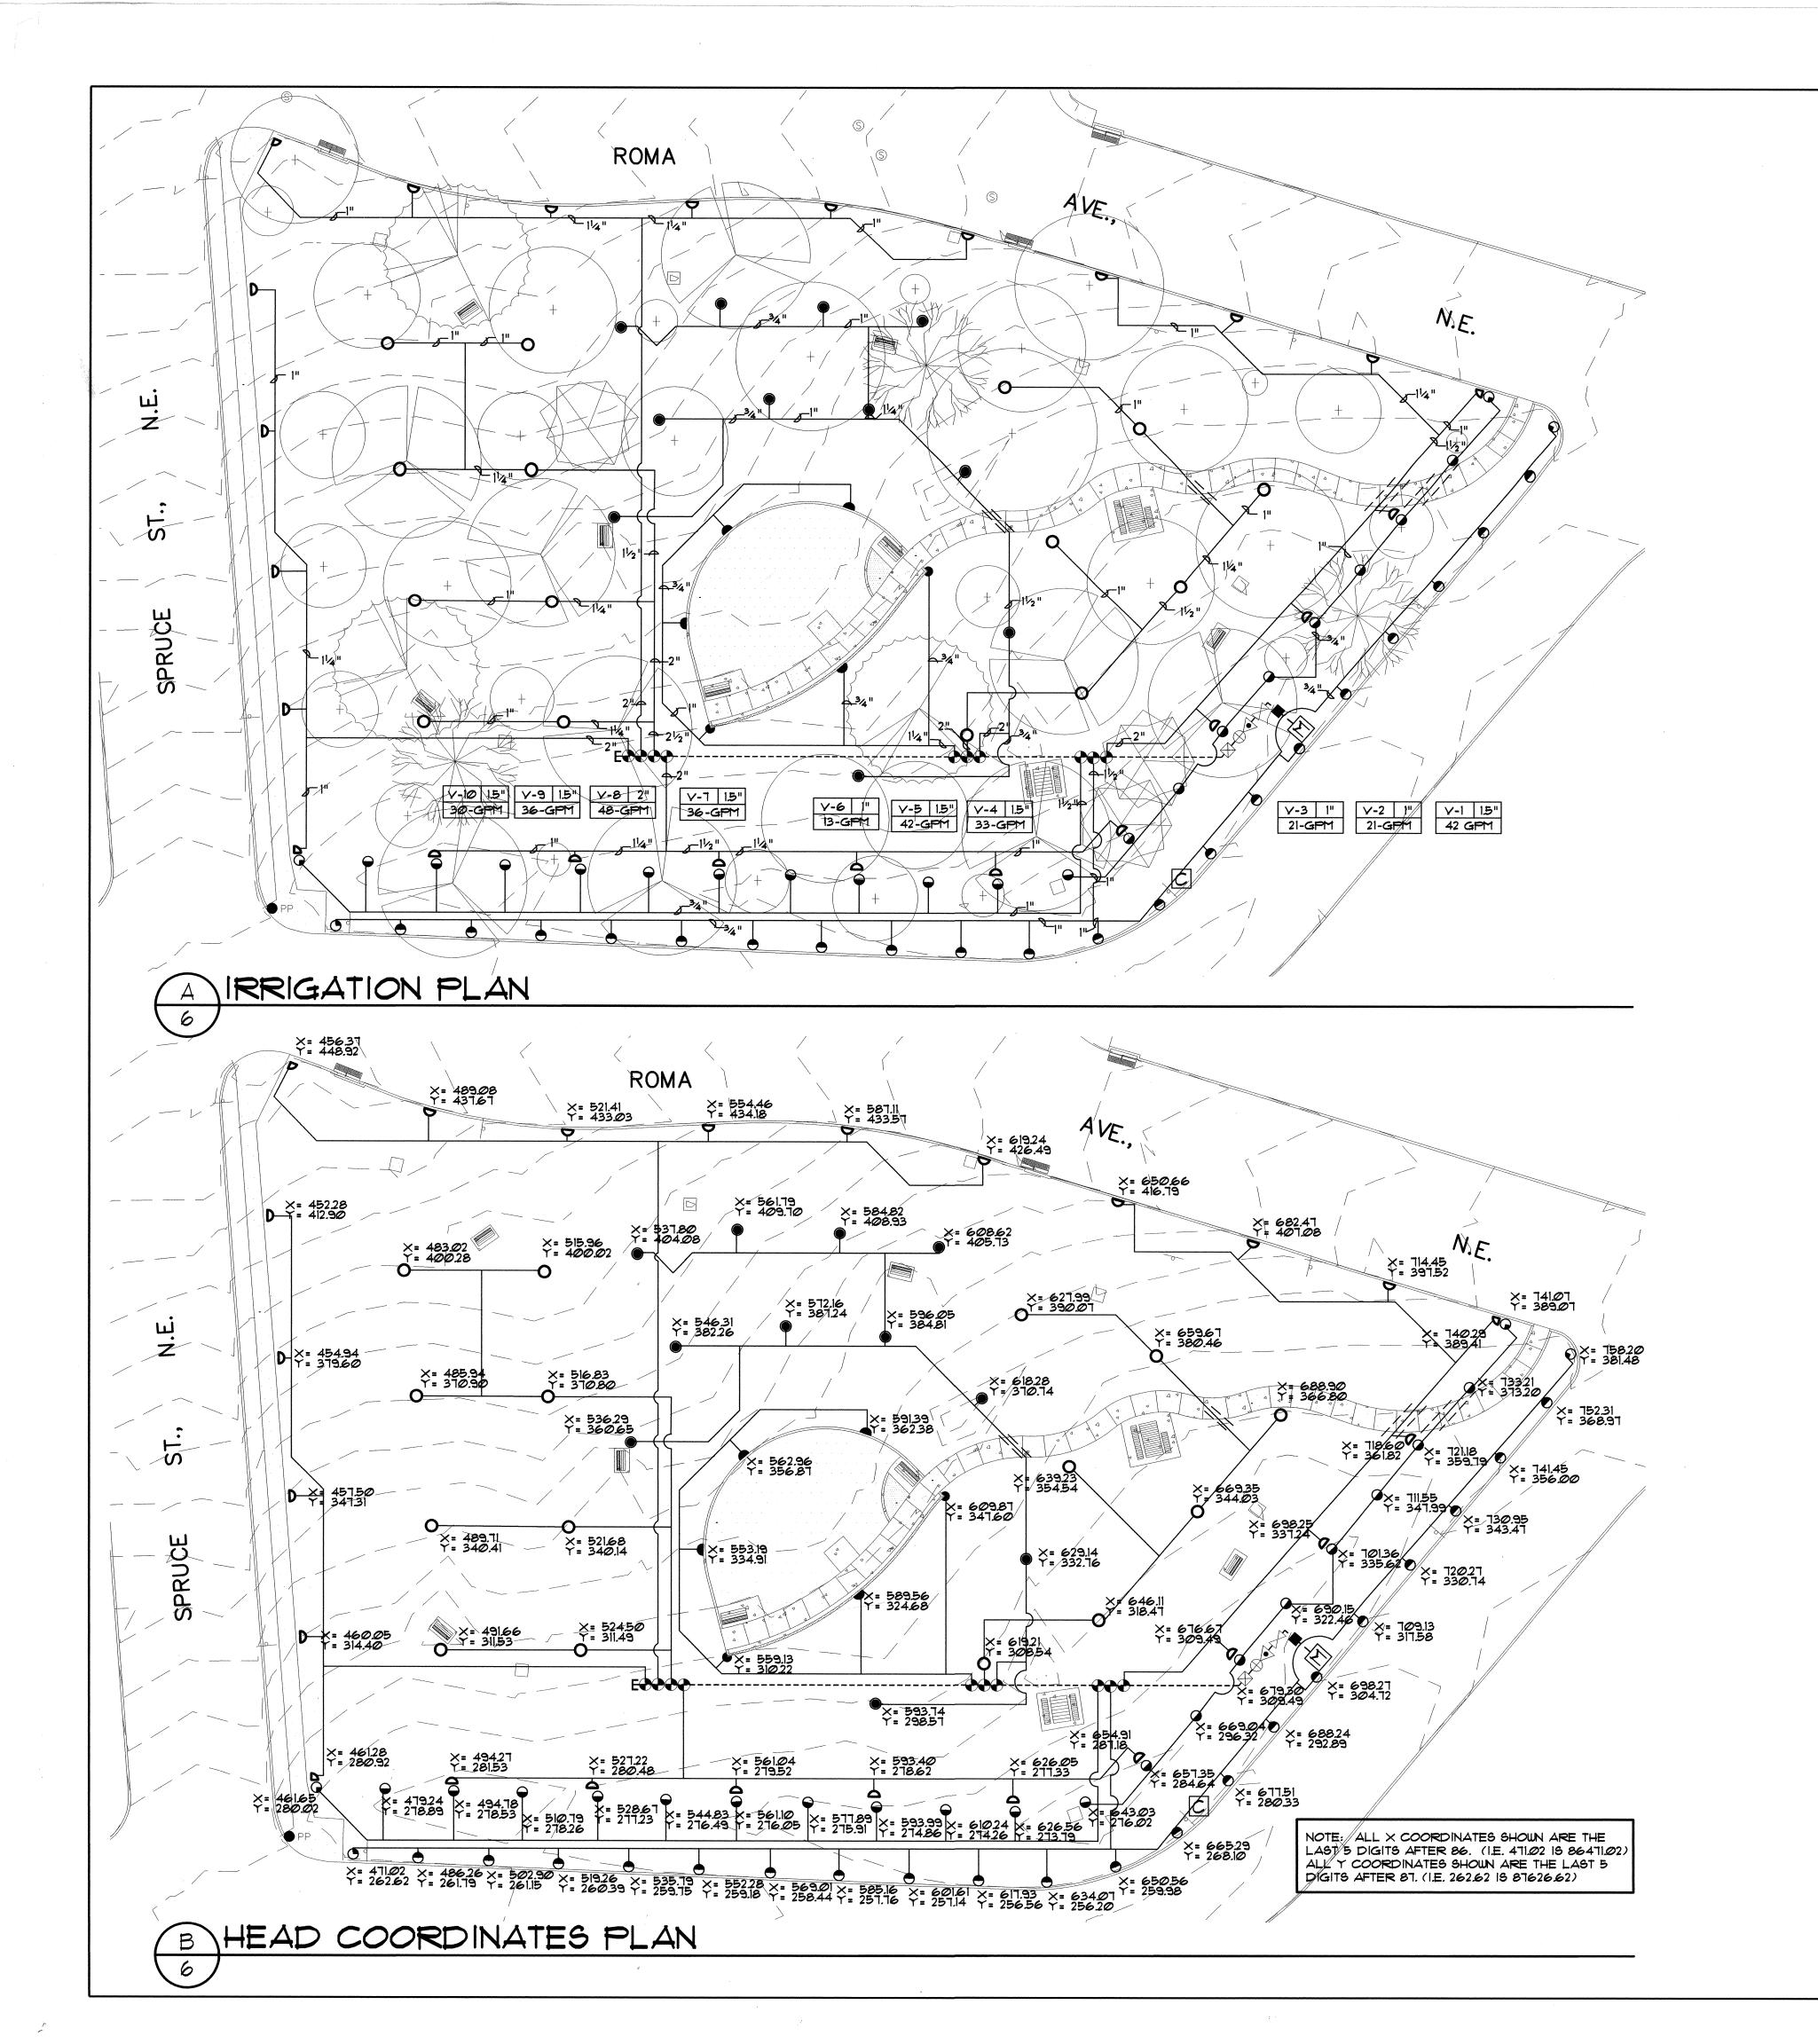

IRRIGATION LEGEND

- WATER METER 3", LOCATION IS SCHEMATIC, CONTRACTOR SHALL VERIFY LOCATION. INSTALL PER COA STD DRAWINGS.
- LATERAL PIPING, SCH. 40, BELL END, SOLVENT WELD PVC, SIZE 3". DEPTH OF DURY 28" FOR CONTINUOUS PRESSURE IRRIGATION MAIN AND 18" FOR NON-CONTINUOUS.

 LATERAL PIPING, SCH. 40, BELL END, SOLVENT WELD PVC. SIZE AS SHOWN ON PLAN. DEPTH OF BURY, 18". PIPE CONVEYING LESS THAN 5 GPM SHALL BE 34".
 - REMOTE CONTROL VALVE ASSEMBLY, RAINBIRD PEB SERIES PLASTIC BODY 24-VOLT AUTOMATIC VALVE, SIZE AS SHOWN ON PLAN. CONNECT TO EXISTING CONTROLLER PER COA DWG.* 2703
 - GOLVENT WELD CAP, SCH. 40 PVC, LINE SIZE.
 - FLOW METER MASTER METER 3" TURBINE INSTALL PER MANUFACTURER'S INSTRUCTIONS

 ROTARY POP-UP SPRINKLER ASSEMBLIES, HUNTER 1-20 SERIES, 4" POP-UP AS

FOLLOWS: PER COA DWG. *2709.

MODEL NO. RADIUS GPM PSI PR []

1-20-ADS-20LA 28' 2.1 60 .49

1-20-ADS-20LA 28' 2.1 60 .49

1-20-365-3.05R 25' 3.0 60 .46

1-20-ADS-56R 18' 5 60 60

1-20-ADS-1.05R 18' 1.0 60 59

1-20-ADS-3.0 34' 2.7 60 .72

1-20-ADS-6.0LA 33' 60 60 82

0 1-20-365-6.0LA 33' 60 60 .41

- CAREFREE WATER CONDITIONER, 2". AVAILABLE FROM ANNE LA LOPA FREELANCE PRODUCTIONS (505-660-4162). INSTALL PER MANUFACTURER'S INSTRUCTIONS.
- GATE VALVE, REDUCED PRESSURE BACKFLOW PREVENTION DEVICE, AND MASTER VALVE ASSEMBLY. BACKFLOW PREVENTER TO BE FEBCO 880V, 3". INSTALL PER DETAIL C/6.
- IRRIGATION CONTROLLER IS-MIA-U4W-RW-SS, AND DATA ACCESS UNIT IS-XLDAL, WITH CENTRAL FIU UPGRADE IS-C-IMU-UK, ICC CENTRAL SOFTWARE IS-ICC-13.52v, AND TRAINING IS-ICC-TRAINING. AVAILABLE FROM WATER RESOURCES INC. (505-293-3434). INSTALL PER MANUFACTURER'S INSTRUCTIONS.

IRRIGATION NOTES

CONTRACTOR SHALL FURNISH ALL LABOR, MATERIALS AND EQUIPMENT NECESSARY TO CONSTRUCT PROPOSED IRRIGATION SYSTEM IN ACCORDANCE WITH PLANS, WRITTEN SPECIFICATIONS AND DETAILS.

- THIS SYSTEM WAS DESIGNED AT A MINIMUM STATIC PRESSURE OF 85 PSI AT THE POINT OF CONNECTION, AS REPORTED BY COA WATER DEPT. CONTRACTOR SHALL VERIFY ACTUAL PSI AND DELIVER RESULTS TO LANDSCAPE ARCHITECT PRIOR TO CONSTRUCTION. IN THE EVENT THE ACTUAL PSI IS LESS THAN 85 PSI THE CONTRACTOR SHALL RECEIVE DIRECTION FROM LANDSCAPE ARCHITECT REGARDING DESIGN MODIFICATIONS IF NECESSARY.
- 3. ALL TRENCHING FOR MAINLINE OR LATERAL PIPING UNDER THE DRIP LINE OF AN EXISTING TREE SHALL BE DONE BY HAND.
- 4. IT IS ANTICIPATED THAT THE PROPOSED SYSTEM WILL REDUCE WATER USE IN THE PARK BY THE FOLLOWING MEANS: INCREASED DISTRIBUTION UNIFORMITY-REDUCED OVER SPRAY OUTSIDE THE LIMITS OF THE PARK. ZONING TO ALLOW DIFFERENTIATED RUN TIMES OF LOW /HIGH ELEVATION AREAS. GROUPING OF LIKE-ARC HEADS ON THE SAME ZONES.
- 5. THE EXISTING TURF GRASS SHALL REMAIN. AREAS DISTURBED OR CLEARED FOR CONSTRUCTION SHALL BE SODDED WITH ALBUQUERQUE PARK BLEND.

| PROGRAM | VALVES | HEAD TYPE | TOTAL GPM | PRECIP RATE | RUN TIME |
|---------|--------|----------------------|-----------|-------------|----------|
| 1 | ד,ו | 1-20-ADS-6.0LA | 35 | .82 IN/HR | 49 MIN |
| 2 | 2,3 | 1-20-ADS-56R/1.06R | 42 | .59 IN/HR | 68 MIN |
| 3 | 9,10 | 1-20-ADS-6.0LA | 66 | .82 IN/HR | 49 MIN |
| 4 | 4,6 | 1-20-ADS-1.55R/3.05R | 46 | .46 IN/HR | 87 MIN |
| 5 | 5,8 | 1-20-36S-6.0LA | 95 | .41 IN/HR | 98 MIN |

| NUMBER | SIZE | HEAD TYPE | ARC | TOTAL GPM | |
|--------|------|--------------------|------|-----------|--|
| 1 | 1.5" | 1-20-ADS-6.0LA | HALF | 42 | |
| 2 | 1" | 1-20-ADS-55R/1.05R | HALF | 21 | |
| 3 | 1" | 1-20-ADS-55R/LØSR | HALF | 21 | |
| 4 | 1.5" | 1-20-365-3.05R | FULL | 33 | |
| 5 | 1.5" | 1-20-365-6.0LA | FULL | 41 | |
| 6 | 1" | 1-20-ADS-159R | HALF | 13 | |
| 7 | 1.5" | 1-20-ADS-6.0LA | HALF | 36 | |
| 8 | 2" | 1-20-369-6.0LA | FULL | 48 | |
| 9 | 1.5" | 1-20-ADS-6.0LA | HALF | 3Ø | |
| 10 | 1.5" | 1-20-ADS-6.0LA | HALF | 36 | |

0 15' 20' 40' 60' SCALE: 1" = 20'



CITY OF ALBUQUERQUE
DEPARTMENT OF MUNICIPAL DEVELOPMENT
PARK DESIGN AND CONSTRUCTION DIVISION

TITLE:

SPRUCE PARK
IRRIGATION PLAN - ADDENDUM #1


Design Review Committee City Engineer Approval


Mo/Day/yr. Mo/Day/yr.

City Engineer Approval

Septimized Transport No. To Approval

Septimiz

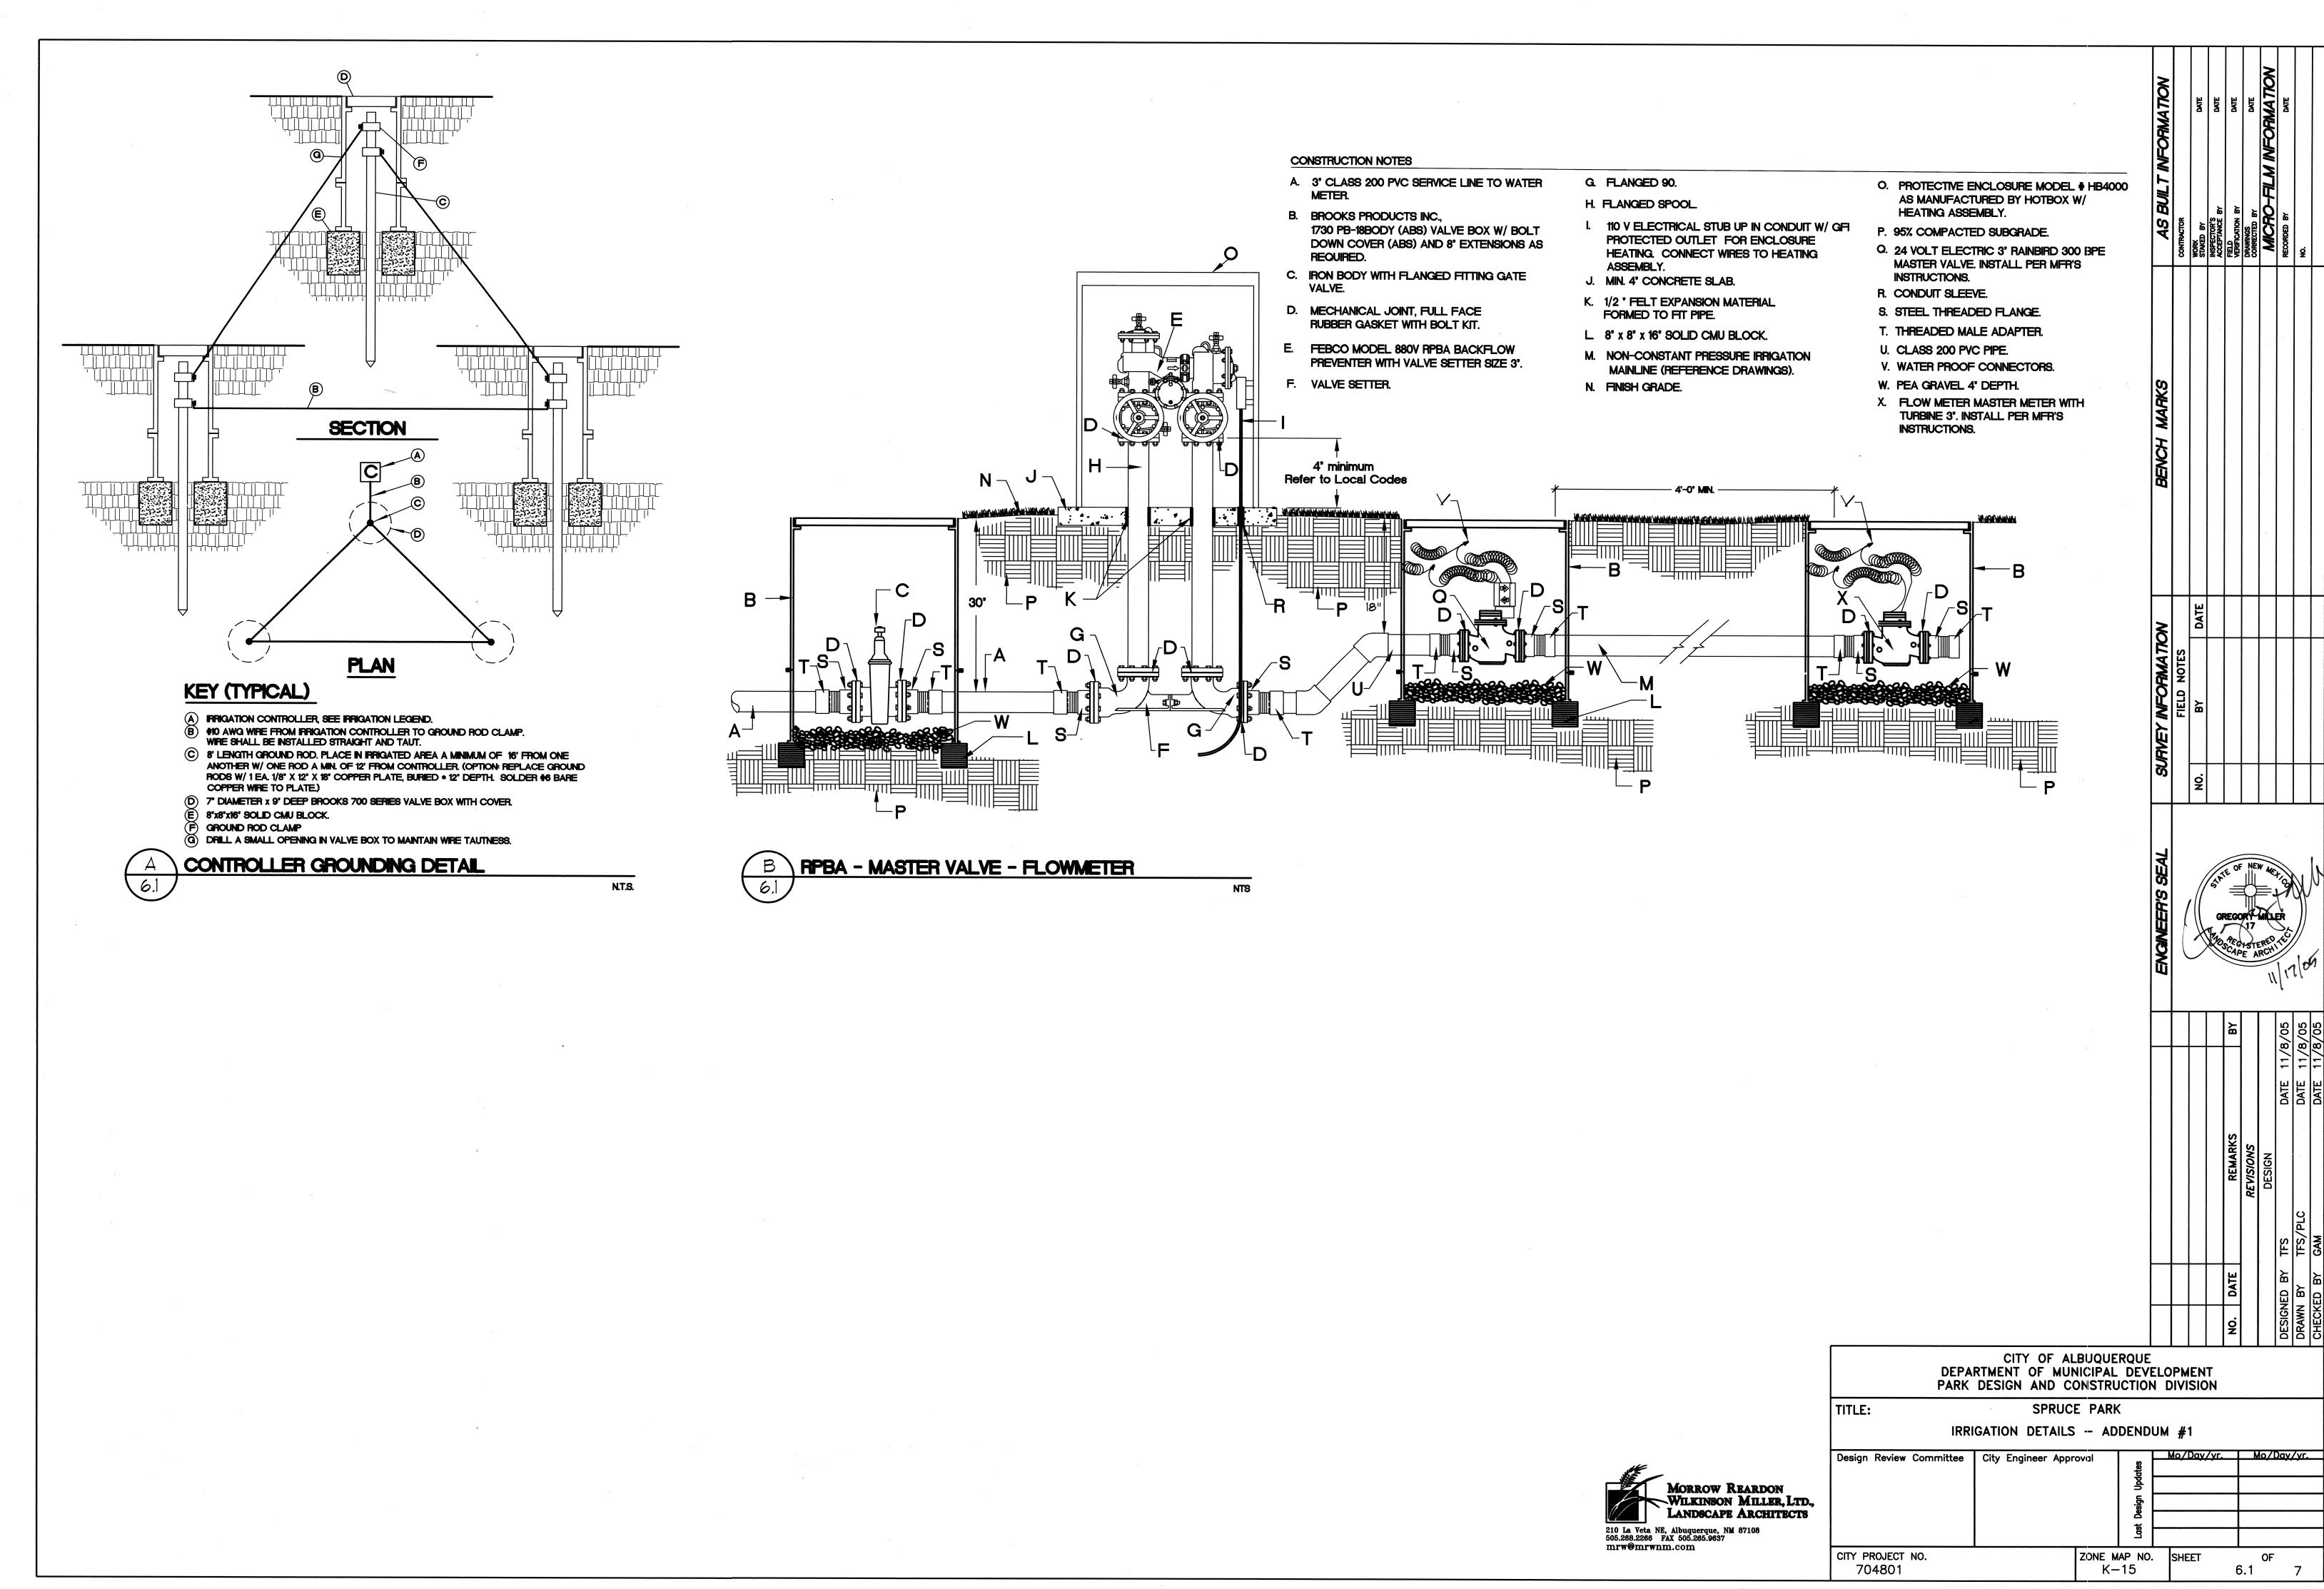

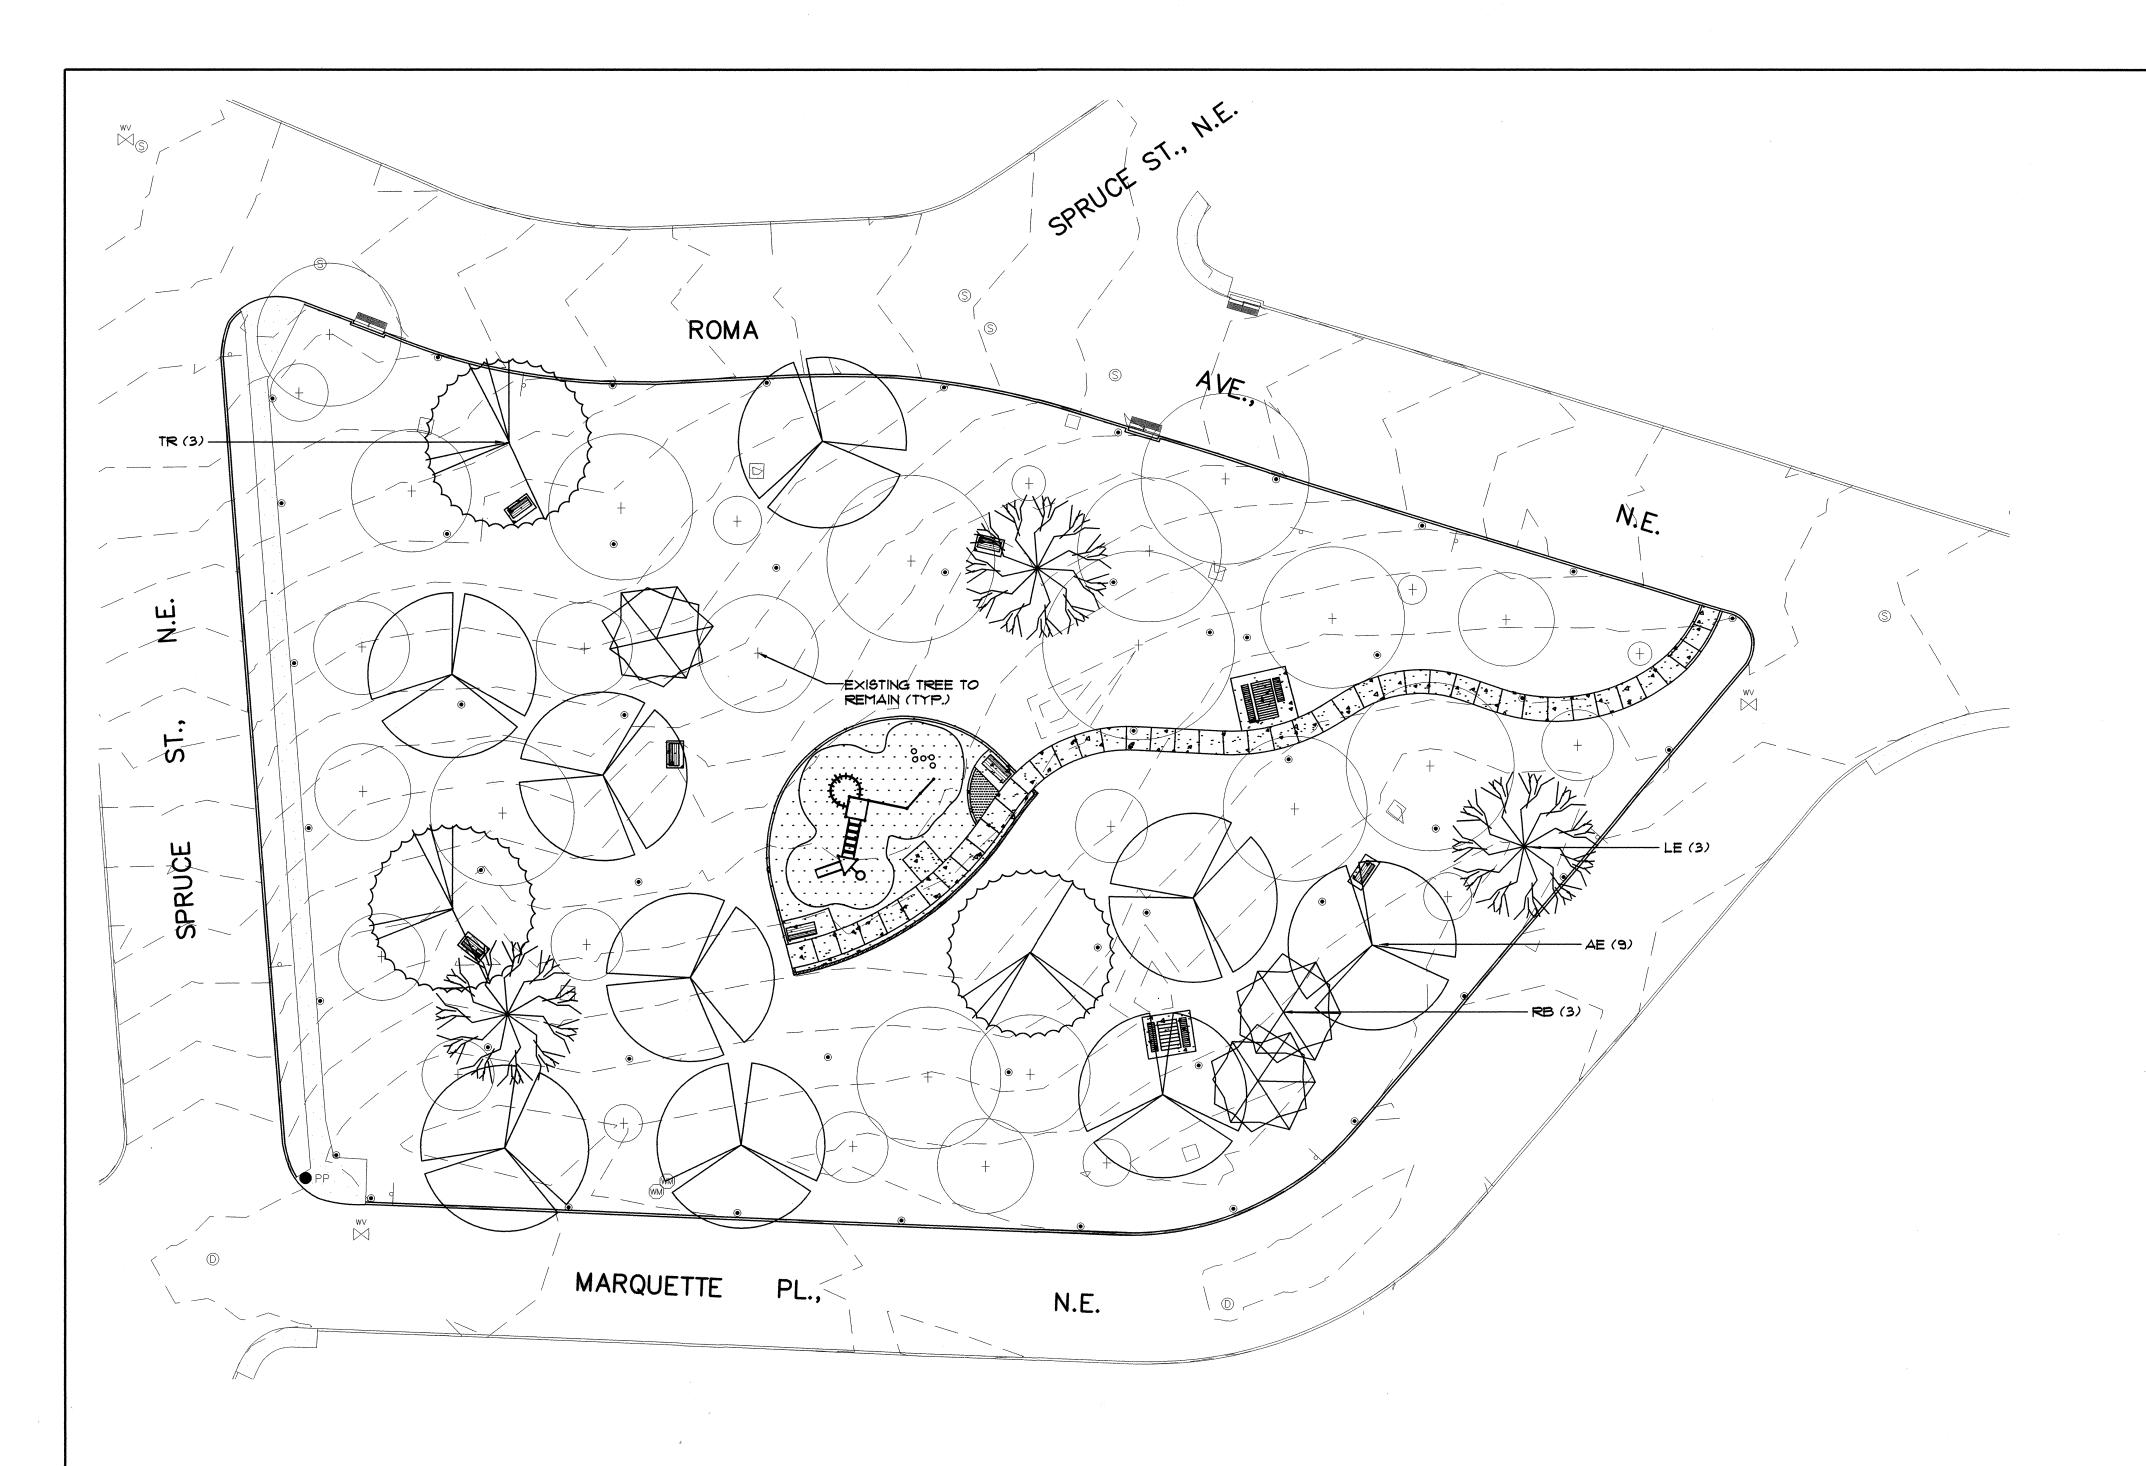

| | | | | SIZE | | | |
|--------|-----|---------------|-------------------|----------|--------------------------|--------------------|---------------|
| SYMBOL | KEY | COMMON NAME | BOTANICAL NAME | QUANTITY | INSTALLED | MATURE | CONDITION |
| M/ W/ | ΑE | American Elm | Ulmus americana | 9 | 2 1/2" cal., 12'-14' ht. | 30' ht. x 20' spd. | B 4 B |
| | LE | Lacebark Elm | Ulmus parvifolia | 3 | 2 1/2" cal., 12'-14' ht. | 30' ht. x 20' spd. | B \$ B |
| | TR | Texas Red Oak | Quercus buckleyi | 3 | 2 1/2" cal., 12'-14' ht. | 30' ht. x 20' epd. | BŧB |
| | RB | Red Bud | Cercia canadensia | 3 | 6' - 8' ht. | 20' ht. & spd. | B 4 B |

PLANTING NOTES

- IN CASE OF DISCREPANCY IN PLANT QUANTITIES SHOWN ON THE PLANT LIST AND THOSE SHOWN ON THE PLANTING PLAN, THE QUANTITIES SHOWN ON THE PLAN SHALL GOVERN. CONTRACTOR SHALL VERIFY ALL QUANTITIES PRIOR TO BID AND INSTALLATION. NO ADDITIONAL PAYMENT WILL BE MADE FOR ANY DISCREPANCIES IN QUANTITIES BETWEEN THE PLANTING PLAN AND THE PLANT LIST.
- 2. IF THERE IS A DISCREPANCY IN THE FIELD OR NURSERY PLANTS BETWEEN THE CONTAINER SIZE CALLED OUT UNDER "REMARKS" AND HEIGHT & SPREAD CALLED OUT UNDER "SIZE", THE SPECIFIED PLANT MUST MEET HEIGHT & SPREAD REQUIREMENTS SPECIFIED UNDER "SIZE", EVEN IF THE LARGER CONTAINER SIZE IS REQUIRED TO MEET THESE SPECIFICATIONS, AT NO ADDITIONAL COST TO THE OWNER.
- 3. A 36" DIAMETER OF 2" DEPTH BARK MULCH SHALL BE PROVIDED AT BASE OF ALL TREES IN TURF AREA.
- 4. THE CONTRACTOR SHALL PRUNE LOWER BRANCHES OF DECIDUOUS TREES AS DIRECTED BY LANDSCAPE ARCHITECT.
- 5. TREES SHALL BE PLANTED PER COA DWG. # 2713, 2714, AND 2716.



CITY PROJECT NO.

704801

CITY OF ALBUQUERQUE
DEPARTMENT OF MUNICIPAL DEVELOPMENT
PARK DESIGN AND CONSTRUCTION DIVISION

TITLE: SPRUCE PARK LANDSCAPE IMPROVEMENTS
PLANTING PLAN

Design Review Committee City Engineer Approval

September 19 | Mo/Day/yr. | Mo/Day/yr. |
September 19 | Mo/Day/yr. | Mo/Day/yr. |
September 19 | Mo/Day/yr. |

ZONE MAP NO. SHEET

K-15

OF

0 15' 20' 40' 6' SCALE: 1" = 20'