CITY OF ALBUQUERQUE DEPARTMENT OF MUNICIPAL DEVELOPMENT

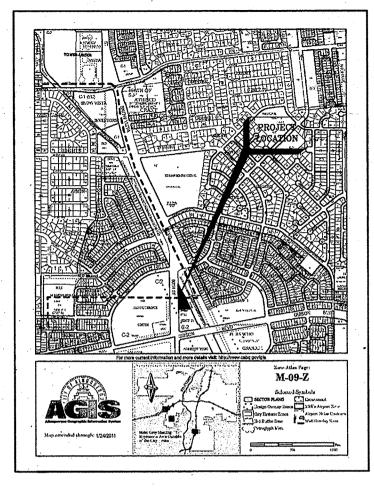
CONSTRUCTION PLANS FOR

PNM SUBSTATION SIDEWALK IMPROVEMENTS FOR 1800 98th STREET SW

ALBUQUERQUE, NEW MEXICO
JUNE 28, 2013

DRAWING INDEX

SHEET No.	SHEET TITLE
1 OF 4	COVER SHEET, APPROVALS, AND VICINITY MAP
2 OF 4	SITE AND GRADING PLANS AND
2A AND 2B OF 4	ORIGINAL STAMPED GRADING AND DRAINAGE PLAN
3 OF 4	MISCELLANEOUS DETAILS
4 OF 4	MISCELLANEOUS DETAILS



VICINITY MAP

FOR INFORMATION ONLY

As-builts and Closeout package not submitted. Construction verified by aerial imagery.

By: Jim Roed Date: 12-18-19

THE FOLLOWING NOTES ALSO APPLY WHEN CHECKED:

- ALL UTILITIES AND UTILITY SERVICE LINES SHALL BE INSTALLED PRIOR TO PAVING.
- SPECIFIED STREET USE.

 TACK COAT REQUIREMENTS SHALL BE DETERMINED
- SIDEWALK AND WHEELCHAIR RAMPS WITHIN THE CURB RETURNS SHALL BE CONSTRUCTED WHEREVER
- ALL STORM DRAINAGE FACILITIES SHALL BE

REV. SHEETS CITY ENGINEER DATE USER DEPARTMENT DATE

ENGINEER'S SEAL APPROVALS ENGINEER DATE

DRC CHARMAN

TRANSPORTATION

WATERWASTEWATER

HYDROLOGY

CIP

CONST. MNGMT.

CONST. COORD.

AMAFCA

PARKS

CITY PROJECT NO. 722779

LISER DEPARTMENT DATE

USER DEPARTMENT DATE

APPROVED FOR CONSTRUCTION

TANSPORTATION

WATERWASTEWATER

HYDROLOGY

CONST. MNGMT.

CONST. COORD.

AMAFCA

PARKS


SHEET OF

CITY PROJECT NO. 722779


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Engineers • Planners

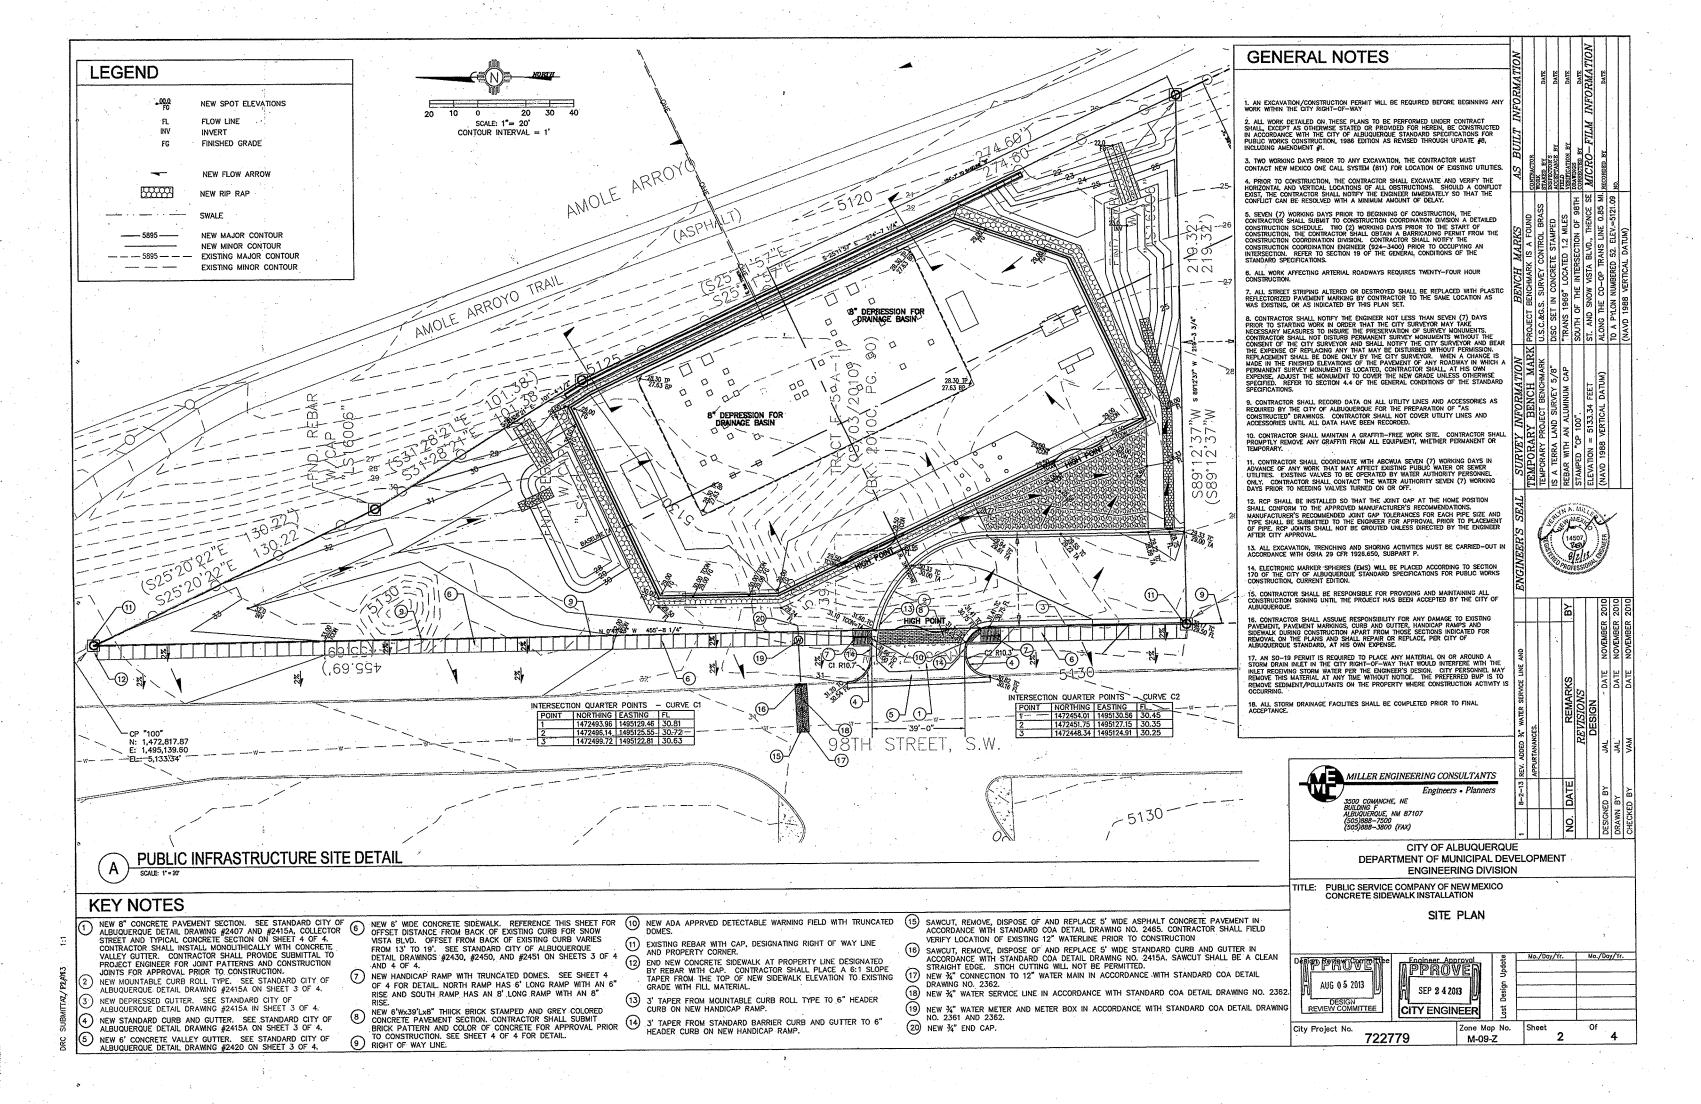3500 COMANCHE, NE
BUILDING F.
ALBUQUERQUE, NM 87107
(505)888-7500
(505)888-3500 (74X)



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FLOOD ZONE MAP

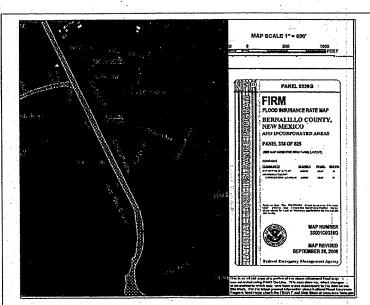EXISTING ON SITE CONDITIONS

THE PROJECT SITE CONDITIONS

THE PROJECT SITE CONSISTS OF 1.17 ACRES (MORE OR LESS) AND IS CURRENTLY UNDEVELOPED AND CONSISTS OF BARE LAND WITH SPARSE NATIVE VEGETATION. THE PROJECT SITE SLOPES TO THE SOUTHEAST, TO THE AMOLE ARROYO ALONG THEESTERN PROPERTY LINE. THE PROPERTY SLOPES MODERATELY AT ABOUT 4% TO 6% TO THE SOUTHEAST. THE EASTERN PROPERTY JUST OUTSIDE THE PROPERTY 6% 10 THE SOUTHEAST. THE EASTERN PROPERTY JUST OUTSIDE THE PROPERTY LINE SLOPES 4' TO 10' DOWN AT AN APPROXIMATE SLOPE OF 5:1 TO THE AMOLE TRAIL. THE SUBJECT PROPERTY IS BORDERED ON THE WEST BY SNOW VISTA BOULEVARD SW, ON THE SOUTH BY A PRIVATE OWNER (VACANT LAND) AND ON THE EAST BY THE AMOLE TRAIL AND AMOLE ARROYO. THE EXISTING LAND TREATMENTS FOR THE SITE ARE CATEGORIZED AS 100% A, 0% B, 0% C AND 0% D.

PROPOSED CONDITIONS

THE PROPOSED IMPROVEMENTS WILL CONSIST OF A 217'x110' PNM ELECTRICAL SUBSTATION. THE SUBSTATION HAS PNM EQUIPMENT INSIDE OF DECORATIVE BLOCK WALLS. THE SURFACE INSIDE THE WALLS WILL BE SURFACED WITH A GRAVEL MATERIAL. PNM REQUIRES THAT ALL STORM WATER RUNOFF WITHIN THE SUBSTATION WALLS BE CONTAINED WITHIN THE WALLS OF THE SUBSTATION WITHIN A 8" DEEP DEPRESSION AS INDICATED ON THE GRADING PLAN. THE SUBSTATION WILL 8" DEEP DEPRESSION AS INDICATED ON THE GRADING PLAN. THE SUBSTATION WILL BE ACCESSED BY A 34" WIDE ASPHALT PAVED DRIVEWAY FROM SNOW VISTA BOULEVARD S.W. LOCATED WEST OF THE PROPOSED SUBSTATION. THE ONLY IMPERVIOUS AREAS ARE SMALL CONCRETE FOOTINGS WITHIN THE SUBSTATION WALLS, THE TOP OF THE SUBSTATION WALLS, AND THE ENTRANCE DRIVEWAY WHICH WILL CONSIST OF CURB AND GUTTER AND ASPHALT. THE SITE HAS BEEN DELINEATED INTO TWO EXISTING ON—SITE BASINS (BASINS A AND B), AND THREE ONSITE BASINS. (BASINS A, B), and C) AS INDICATED ON THE EXISTING AND PROPOSED DRAINAGE BASIN MAPS ON THIS SHEET. THE PROPOSED LAND TREATMENTS ARE PROVIDED IN THE HYDROLOGY TABLES DIRECTLY BELOW THE EXISTING AND PROPOSED DRAINAGE BASIN MAPS ON THIS SHEET.

THE RUNOFF FROM BASIN A WILL BE CONTAINED IN WATER HARVEST AREA #1. THE WATER FROM BASIN B WILL BE CONTAINED WITHIN THE SUBSTATION WALLS AND THE WATER FROM BASIN C WILL BE CONTAINED IN WATER HARVEST AREA #2.

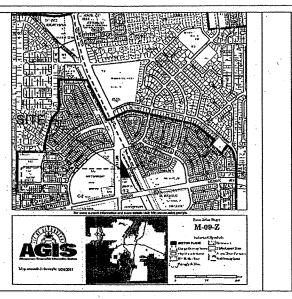
OFFSITE FLOWS

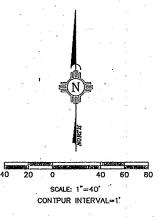
THERE ARE NO APPARENT OFFSITE FLOWS AFFECTING THE SITE.-1.

CONCLUSION

REVISION

CONCLUSION
WHEN FULLY DEVELOPED, THE WATER HARVEST AREAS WILL CONTAIN THE RUNOFF VOLUME GENERATED FROM THE 100-YEAR 24 HOUR STORM EVENT. THE VOLUME CALCULATIONS FOR THE WATER HARVEST AREAS ARE PROVIDED IN THE SUPPLEMENTAL DRAINAGE CALCULATIONS ON THIS SHEET. EROSION PROTECTION WILL BE PLACED AT AREAS SUSCEPTIBLE TO CONCENTRATED FLOWS AND ALL DISTURBED AREAS WILL BE RE-VEGETATED IN ACCORDANCE WITH NMAPWA REQUIREMENTS.






VICINITY MAP

GENERAL NOTES:

TOPOGRAPHIC SURVEY PERFORMED AND COMPILED BY TERRA LAND SURVEYS, LLC. CORRALES, NEW MEXICO AUGUST 2011.

- PROJECT BENCHMARK IS A FOUND U.S.C.&G.S. SURVEY CONTROL BRASS DISC SET IN CONCRETE STAMPED "TRANS 1969" LOCATED 1.2 MILES SOUTH OF THE INTERSECTION OF 98th STREET AND SNOW WISTA BLVD., THENCE SOUTHEAST ALONG SNOW WISTA BLVD. AND THE CO-OP ELECTRIC TRANSMISSION LINE 0.85 MILES TO A PYLON NUMBERED 52. ELEVATION = 5,121.09 FEET (NAVD 1988 VERTICAL DATUM).
- TEMPORARY BENCHMARK IS A TERRA LAND SURVEY 5/8" REBAR WITH AN ALUMINUM CAP STAMPED "CP 100". ELEVATION=5,133.34 FEET (NAVD 88 VERTICAL DATUM)
- COORDINATES ARE GROUND/PROJECT VALUES BASED ON NEW MEXICO STATE PLANE COORDINATE SYSTEM, CENTRAL ZONE, NAD 27 DATUM.
- TOPOGRAPHIC SURVEY WAS COMPILED UTILIZING GROUND COORDINATES REFERENCED TO THE NAD 83 NEW MEXICO CENTRAL ZONE COORDINATE SYSTEM. PRIMARY HORIZONTAL AND VERTICAL CONTROL WAS ESTABLISHED UTILIZING GPS RTK METHODS (COMBINED GROUND TO GRID FACTOR =
- THE CONTRACTOR IS RESPONSIBLE FOR ALL TEMPORARY SEDIMENT AND EROSION CONTROL DEVICES DURING THE CONSTRUCTION PHASE.
- CONTRACTOR SHALL OBTAIN A GRADING PERMIT FROM THE CITY OF ALBUQUERQUE, PRIOR TO ANY GRADING OR CONSTRUCTION.
- TWO WORKING DAYS PRIOR TO ANY EXCAVATION CONTRACTOR MUST CONTACT LINE LOCATING SERVICE 260-1990 FOR LOCATION OF EXISTING UTILITIES.
- LIFTS OF MAXIMUM OF 8". THE EMBANKMENTS SHALL BE WETTED AND COMPACTED TO 95% OPTIMUM DENSITY PER ASTM D1557 AND 95% UNDER ALL STRUCTURES INCLUDING DRIVEWAYS AND PARKING LOTS.
- 10. MAINTENANCE OF THESE FACILITIES SHALL BE THE RESPONSIBILITY OF THE OWNER(S) OF THE PROPERTY SERVED.
- 11. THE CONTRACTOR SHALL FIELD VERIFY LOCATION AND SIZE OF ALL UTILITIES PRICE TO CONSTRUCTION.
- 12. THE SUBJECT PROPERTY IS LOCATED WITHIN ZONE X.
 DESIGNATING AREAS DETERMINED TO BE
 OUTSIDE THE 100-YEAR FLOOD PLANE ACCORDING TO THE
 FLOOD INSURANCE RATE MAP, ALBUQUERQUE, NEW MEXICO
 AND UNINCORPORATED AREAS PER MAP NO 35001C 3366.

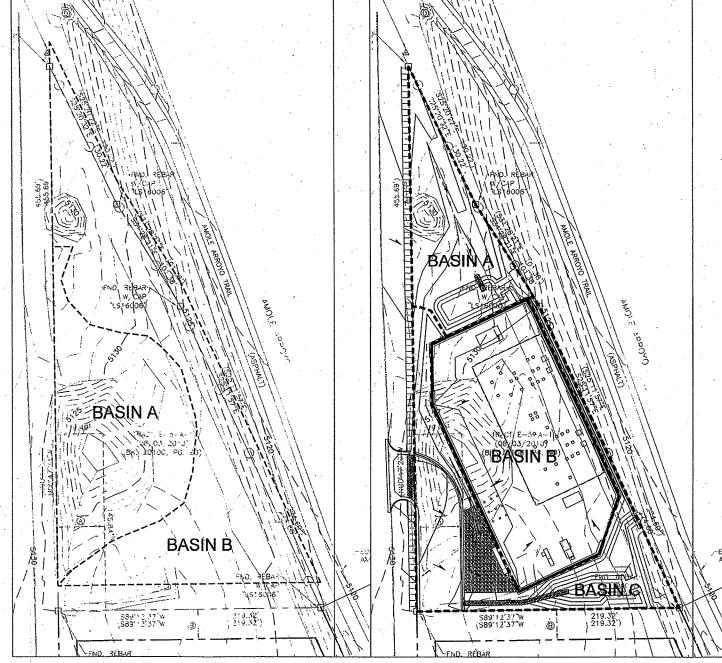- ALL WORK PERFORMED SHALL COMPLY WITH THE REQUIREMENTS OF THE CITY OF ALBUQUERQUE STORM DRAINAGE REGULATIONS. ALL WORK PERFORMED SHALL COMPLY WITH THE REQUIREMENTS OF THE CITY OF ALBUQUERQUE "GRADING AND DRAINAGE DESIGN REQUIREMENTS AND POLICIES FOR LAND DEVELOPMENT."
- THE OWNER, CONTRACTOR AND/OR BUILDER SHALL COMPLY WITH ALL APPROPRIATE LOCAL, STATE AND FEDERAL REGULATIONS AND REQUIREMENTS.
- THE CONTRACTOR SHALL TAKE ALL APPROPRIATE AND REASONABLE MEASURES TO PREVENT SEDIMENT OR POLLUTANT LADEN STORM WATER FROM EXITING THE SITE DURING CONSTRUCTION. STORMWATER MAY BE DISCHARGED IN A MANNEP WHICH COMPLIES WITH THE APPROVED GRADING AND DRAINAGE PLAN.
- THE CONTRACTOR SHALL TAKE ALL APPROPRIATE MEASURES TO PREVENT THE MOVEMENT OF CONSTRUCTION RELATED SEDIMENT, DUST, MUD, POLLUTANTS, DEBRIS, WASTE, ETC FROM THE SITE BY WIND, STORM FLOW OR ANY OTHER METHOD EXCLUDING THE INTENTIONAL, LEGAL TRANSPORTATION OF SAME IN A MANNER ACCEPTABLE BY
- 17. THE CONTRACTOR SHALL NOT DISTURB AREAS OUTSIDE THE AREAS SHOWN AS "SLOPE LIMITS" ON THE GRADING AND DRAINAGE PLAN.
- 18. IN THE EVENT THAT THE PNM SPECIFICATIONS DO NOT ADDRESS A SPECIFIC ELEMENT OF WORK OUTLINED IN THESE DRAWINGS, THE GOVERNING SPECIFICATION THAT SHALL BE UTILIZED AND REFERENCED BY THE CONTRACTOR SHALL BE THE CITY OF ALBUQUERQUE STANDARD SPECIFICATIONS



EXISTING DRAINAGE BASIN MAP

PROPOSED DRAINAGE BASIN MAP

DRAINAGE DATA

Precipila	tion Zone 1	- 100-year	Storm	P(360) =	2.20	in	P(1440) =	2.66	in ·
	Basin	Land Treatment Factors				1			
Basin	Area	Α	В	,C	D	Ew	V(100-6)	V(100-24)	Q(100
	(Ac)		(Acres)			(in)	(af)	(af)	(cfs)
Existing (Conditions		1						
A	0.45	0.45	0.00	()	0.00	0.44	0.017	0.017	0.58
В	0.72	0.72	0.00	0.00	0.00	0.44	0.026	0.026	0.93
Total	1.17		· ·						1.51
Proposed	d Conditions	}		ALCOHOL: NAME OF TAXABLE PARTY.					
A .	0.27	0.13	0.00	0.14	0.00	0.73	0.016	0.016	0.57
В	0.52	0.00	0.00	0.49	0.03	1.05	0.045	0.047	1.54
C	0.38	0.03	0.00	0.24	0.11	1.23	0.039	0.043	1.21
Total	1.17						1.		3.32


Precipita	ation Zone 1	- 10-year S	torm	P(360) =	1.47	in	P(1440):	1.78	in
	Basin	L	8						
Basin	Area	Α	В.	С	D	Ew	V(10-6)	V(10-24)	Q(10)
	(Ac)		(Acres)		(in)	(af)	(af)	(cfs)
Existing	Conditions			1					
Α	0.45	0.45	0.00	0.00	0.00	0.08	0.003	0.003	0.11
В	0.72	0.72	0.00	0.00	0.00	0.08	0.005	0.005	0.17
Total	1.17					· .			0.28
Propose	d Conditions	;	٠.						
A ·	0.27	0.13	0.00	0.14	0.00	0.27	0.006	0.006	0.24
В	0.52	0.00	0.00	0.49	0.03	0.49	0.021	0.022	0.82
С.	0.38	0.03	0.00	0.24	0.11	0.64	0.020	0.023	0.68
Total	1.17								1.74




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FOR ANY DESIGN OR TECHNICAL INFORMATION SHOWN THEREON OF PNM PUBLIC SERVICE COMPANY OF NEW MEXICO VICINITY MAP, FLOOD ZONE MAP.

DRAINAGE BASINS, AND CALCULATIONS SNOW VISTA SUBSTATION JJ

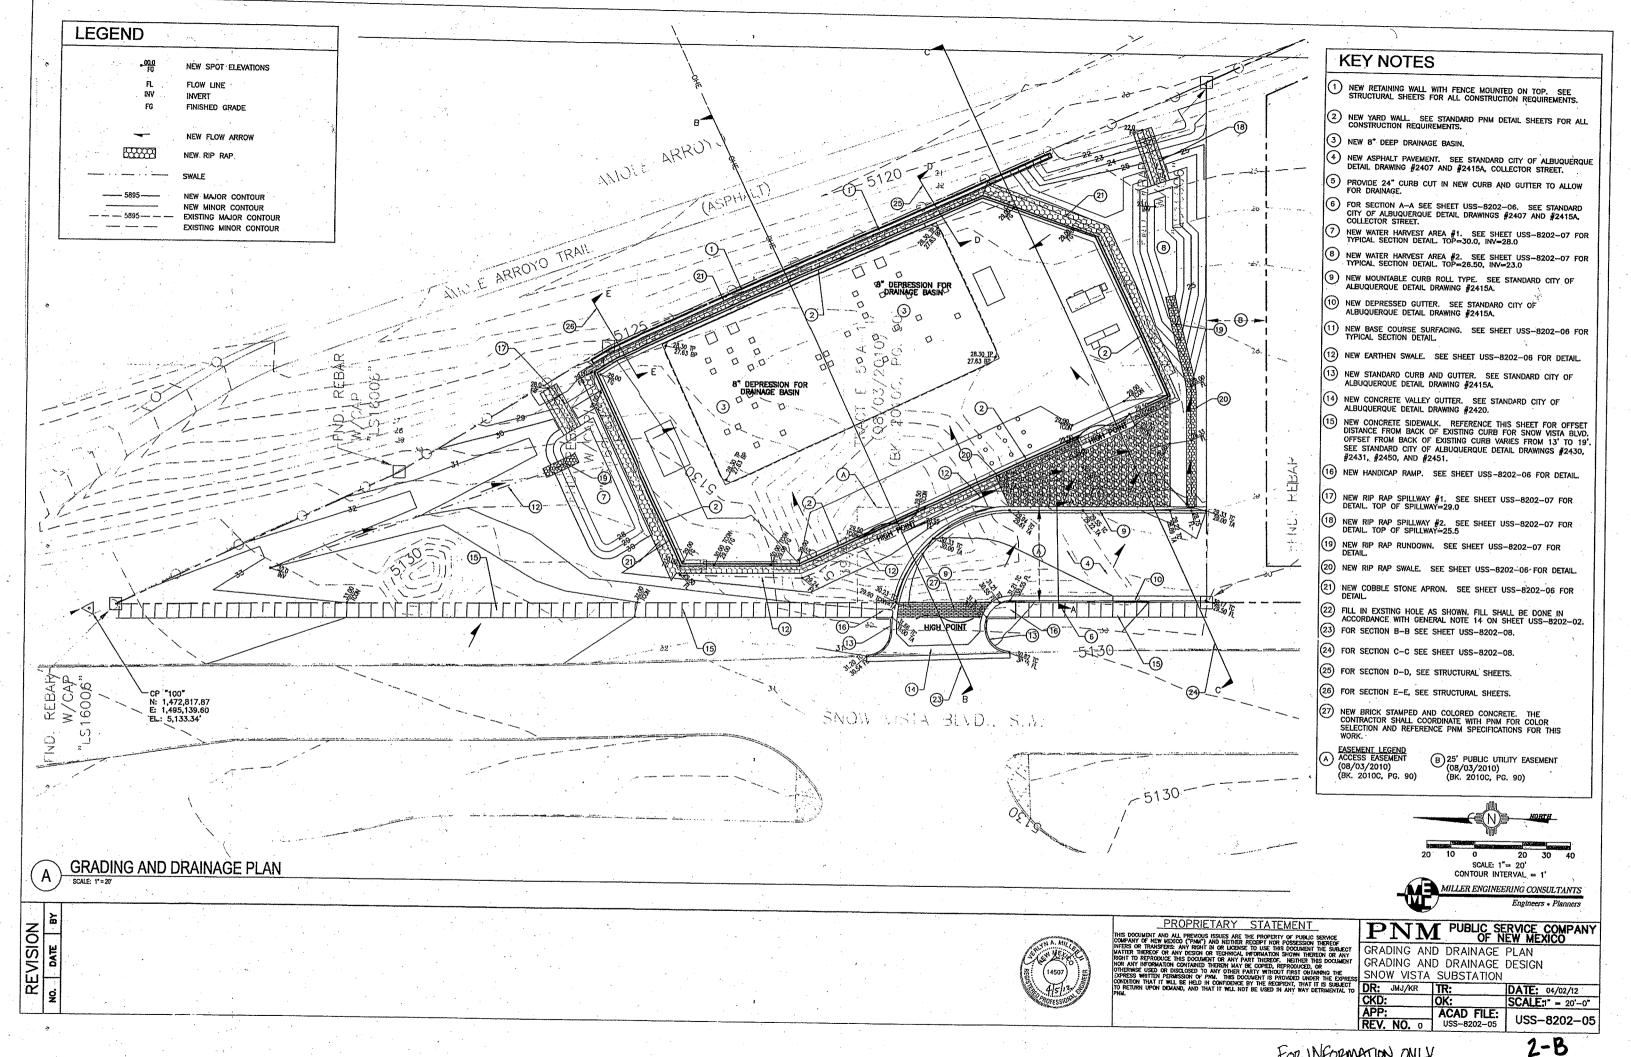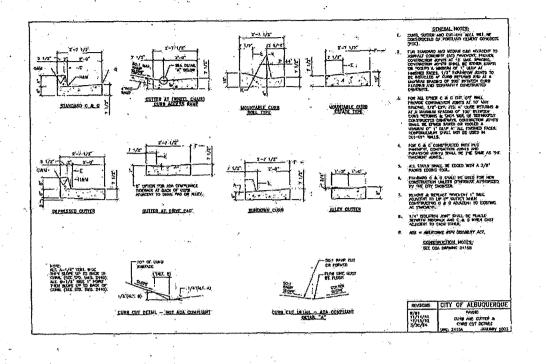DATE: 04/02/12 SCALE:1" = 40'-0" ACAD FILE: USS-8202-04 USS-8202-04







CROWN WAS LINE

A STANDARD DRAWING 2415A SCALE NO SCALE

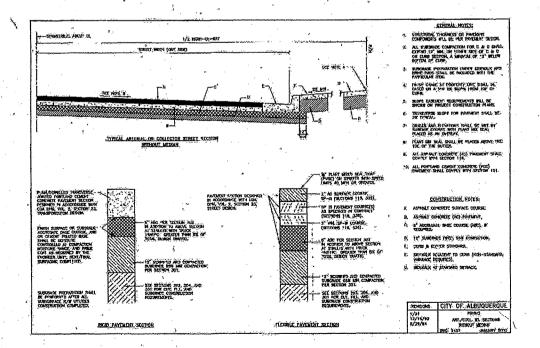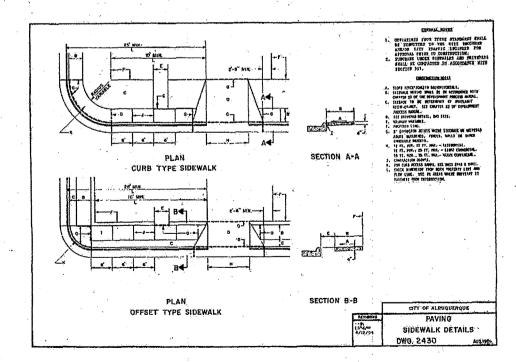STANDARD DRAWING 2420





STANDARD DRAWING 2407

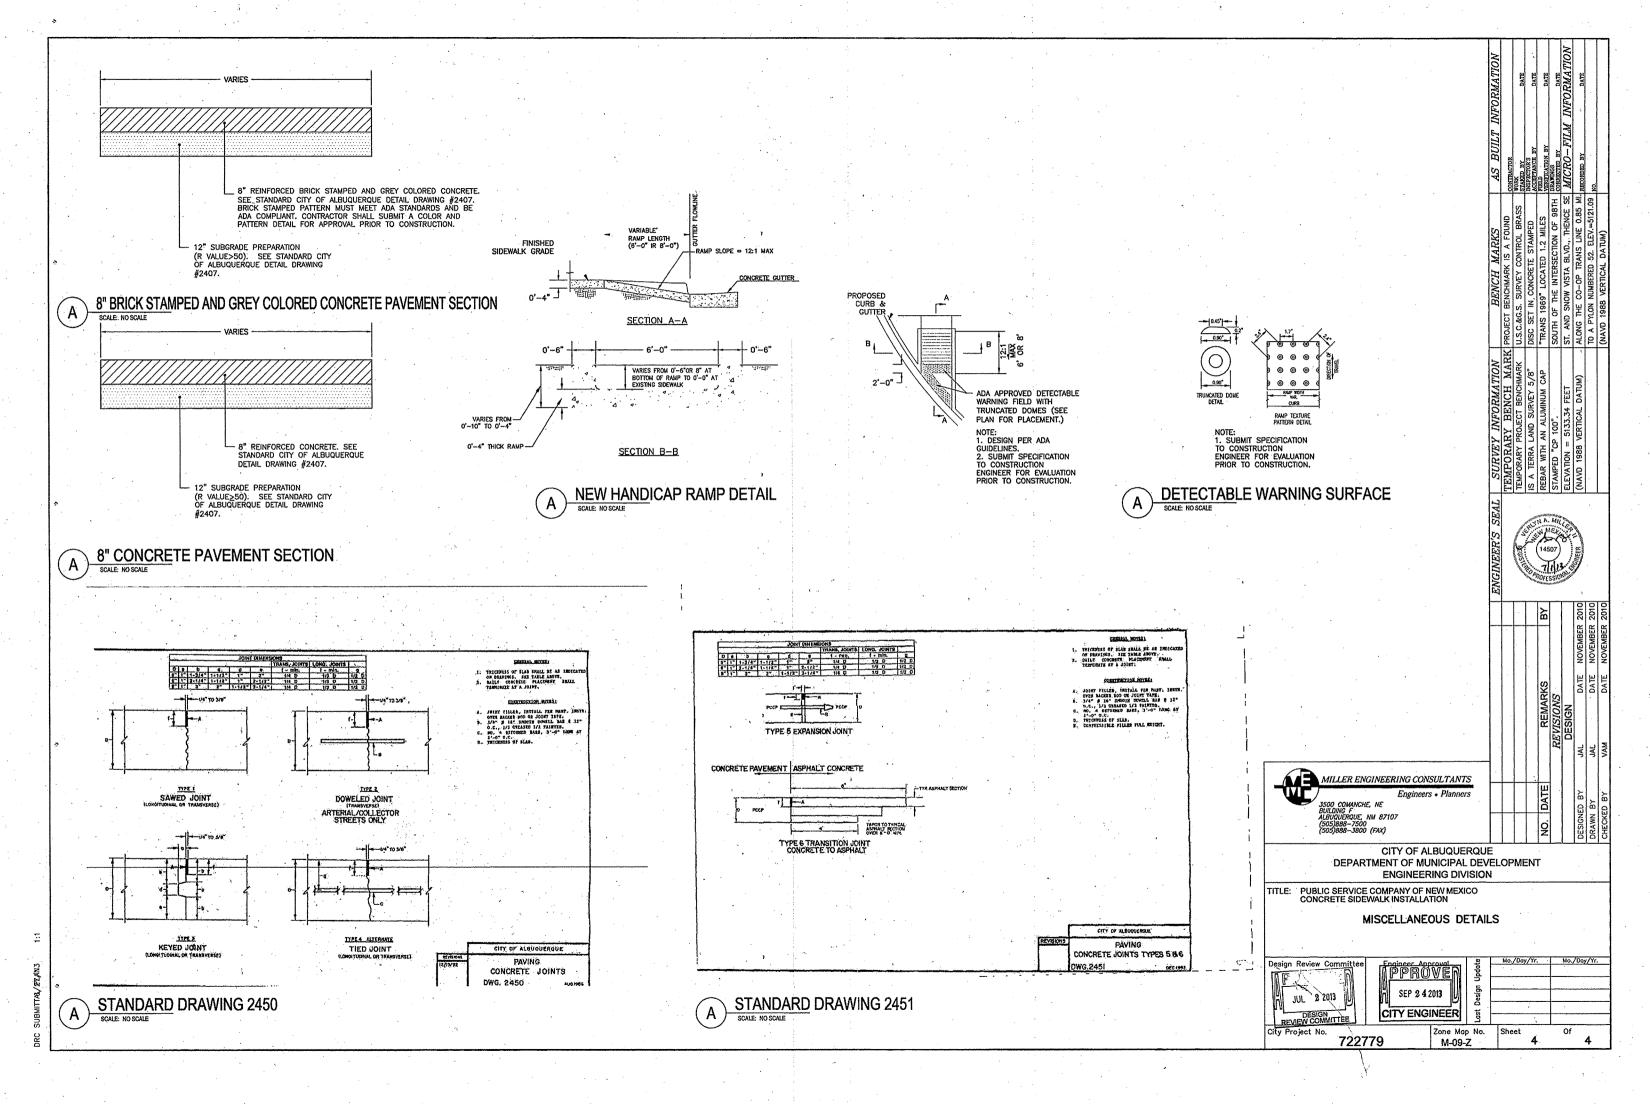
STANDARD DRAWING 2430
SCALE: NO SCALE

MILLER ENGINEERING CONSULTANTS
Engineers • Planners 1--7500 1--3800 (FAX) CITY OF ALBUQUERQUE DEPARTMENT OF MUNICIPAL DEVELOPMENT **ENGINEERING DIVISION** TITLE: PUBLIC SERVICE COMPANY OF NEW MEXICO CONCRETE SIDEWALK INSTALLATION MISCELLANEOUS DETAILS Engineer Approval Sheet 3 Zone Map No. City Project No. 722779

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