

**PUBLIC IMPROVEMENT PLANS
FOR
HERITAGE AT THE TRAILS UNIT 2
ALBUQUERQUE, NEW MEXICO**

JULY 2004

2 3 4 5 6 7 8 9 10 11 12 13 14 15
06-11384-821 06

PREPARED FOR:
CENTEX HOMES
5120 MASTHEAD NE
ALBUQUERQUE, NM 87109

PREPARED BY:
ISAACSON & ARFMAN, P.A.
128 MONROE ST. NE
ALBUQUERQUE, NM 87108

INDEX TO DRAWINGS


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	OFFSITE UTILITIES - STA 10+00.00 TO END

SURVEYORS CERTIFICATION

I, Russ P. Hugg, New Mexico Professional Surveyor Number 9750, hereby certify that the as-built information shown hereon is the result of an actual field survey performed by me or under my direct supervision and that the same is true and correct to the best of my knowledge and belief.

Russ P. Hugg
NMPS No. 9750
July 1, 2005

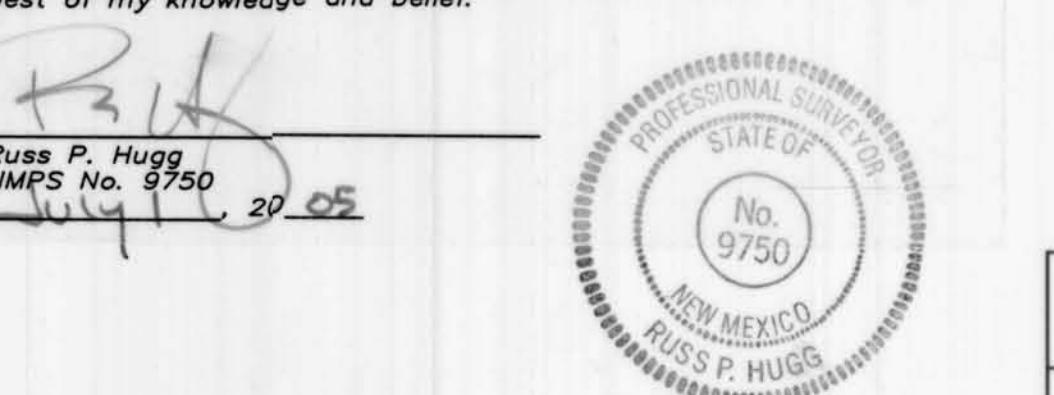

RECORD DRAWINGS

I, Patrick J. Conley of the firm of Smith Engineering Company, A Registered Professional Engineer in the State of New Mexico, do hereby certify, to the best of my knowledge and belief, that the infrastructure installed as part of this project has been inspected by a qualified person under my direct supervision and has been constructed in general accordance with the plans and specifications, while someone from Smith Engineering Company was onsite, approved by the City Engineer and that the original design intent of the approved plans has been met, except as noted by me on the as-built construction drawings. The Certification is based on site inspections by me or personnel under my direction, and as-built survey information provided by Russ Hugg (Surveyor Name) NMPS number 9750 (PS#).





C-9-Z

VICINITY MAP

1"=750'±

GENERAL NOTES

- ALL WORK DETAILED ON THESE PLANS TO BE PERFORMED UNDER CONTRACT SHALL, EXCEPT AS OTHERWISE STATED OR PROVIDED FOR HEREON, BE CONSTRUCTED IN ACCORDANCE WITH THE CITY OF ALBUQUERQUE STANDARD SPECIFICATIONS FOR PUBLIC WORKS CONSTRUCTION 1986 EDITION AS AMENDED WITH UPDATE NO. 7.
- ALL WORK ON THIS PROJECT SHALL BE PERFORMED IN ACCORDANCE WITH APPLICABLE FEDERAL, STATE, AND LOCAL LAWS, RULES, AND REGULATIONS CONCERNING CONSTRUCTION SAFETY AND HEALTH.
- PRIOR TO CONSTRUCTION, THE CONTRACTOR SHALL EXCAVATE & VERIFY THE HORIZONTAL AND VERTICAL LOCATIONS OF ALL OBSTRUCTIONS. SHOULD A CONFLICT EXIST, THE CONTRACTOR SHALL NOTIFY THE ENGINEER SO THAT THE CONFLICT CAN BE RESOLVED WITH MINIMUM DELAY.
- TWO (2) WORKING DAYS PRIOR TO ANY EXCAVATION, CONTRACTOR MUST CONTACT LINE LOCATING SERVICE, NM ONE CALL SYSTEMS, INC. @ 260-1990 FOR LOCATION OF EXISTING UTILITIES.
- CONTRACTOR SHALL CONDUCT HIS OPERATIONS IN A MANNER WHICH WILL MINIMIZE INTERFERENCE WITH LOCAL TRAFFIC. CONTRACTOR SHALL COMPLY WITH ALL APPLICABLE LAWS, ORDINANCES, RULES, REGULATIONS, AND ORDERS OF ANY PUBLIC BODY HAVING JURISDICTION FOR THE SAFETY OF PERSONS OR PROPERTY, AND TO PROTECT THEM FROM DAMAGE, INJURY, OR LOSS. CONTRACTOR SHALL ERECT AND MAINTAIN, AS REQUIRED BY THE CONDITIONS AND PROGRESS OF THE WORK, ALL NECESSARY SAFEGUARDS FOR SAFETY CONTINUOUSLY AND NOT LIMITED TO NORMAL WORKING HOURS, THROUGHOUT THE DURATION OF THE PROJECT. CONTRACTOR SHALL ADHERE TO SECTION 19 OF THE GENERAL CONDITIONS OF THE CITY OF ALBUQUERQUE STANDARD SPECIFICATIONS FOR PUBLIC WORKS CONSTRUCTION, 1986, AS AMENDED WITH UPDATE NO. 7.
- THE CONTRACTOR AGREES THAT HE SHALL ASSUME THE SOLE AND COMPLETE RESPONSIBILITY FOR THE JOB SITE CONDITIONS DURING THE COURSE OF CONSTRUCTION OF THIS PROJECT, INCLUDING SAFETY OF ALL PERSONS AND PROPERTY; THAT THIS REQUIREMENT SHALL APPLY CONTINUOUSLY AND NOT BE LIMITED TO NORMAL WORKING HOURS; AND THAT THE CONTRACTOR SHALL DEFEND, INDEMNIFY, AND HOLD HARMLESS THE OWNER & ENGINEER FROM ANY AND ALL LIABILITY REAL OR ALLEGED, IN CONNECTION WITH THE PERFORMANCE OF WORK ON THIS PROJECT, EXCEPTING LIABILITY ARISING FROM THE SOLE NEGLIGENCE OF THE OWNER OR ENGINEER.
- TRAFFIC CONTROL: FIVE (5) WORKING DAYS PRIOR TO BEGINNING CONSTRUCTION THE CONTRACTOR SHALL SUBMIT TO THE CONSTRUCTION COORDINATION DIVISION A DETAILED CONSTRUCTION SCHEDULE. TWO (2) WORKING DAYS PRIOR TO CONSTRUCTION, THE CONTRACTOR SHALL OBTAIN A BARRICAADING PERMIT FROM THE CONSTRUCTION COORDINATION DIVISION. CONTRACTOR SHALL NOTIFY BARRICADE ENGINEER (924-3400) PRIOR TO OCCUPYING AN INTERSECTION. SEE SECTION 19 OF THE SPECIFICATIONS. ALL STREET STRIPING ALTERED OR DESTROYED SHALL BE REPLACED WITH PLASTIC REFLECTORIZED PAVEMENT MARKINGS BY CONTRACTOR TO LOCATION AS EXISTING OR AS SHOWN IN THIS PLAN SET.
- WHEN ABUTTING EXISTING PAVEMENT TO NEW, SAWCUT EXISTING PAVEMENT TO A STRAIGHT EDGE, AND AT A RIGHT ANGLE, OR AS APPROVED BY THE FIELD ENGINEER. REMOVAL OF BROKEN OR CRACKED PAVEMENT WILL ALSO BE REQUIRED.
- EXISTING CURB AND CUTTER NOT TO BE REMOVED UNDER THE CONTRACT WHICH IS DAMAGED OR DISPLACED BY THE CONTRACTOR SHALL BE REMOVED AND REPLACED BY THE CONTRACTOR AT HIS EXPENSE.
- ALL FINAL BACKFILL FOR TRENCHES SHALL BE COMPAKTED TO A MINIMUM 90% MAXIMUM DENSITY PER ASTM D-1557 AND AS DIRECTED BY SECTION 701.14.2 AND STANDARD DRAWING NUMBER 2315.
- THE CONTRACTOR SHALL PROMPTLY CLEAN UP ANY MATERIAL EXCAVATED WITHIN THE PUBLIC RIGHT-OF-WAY OR PRIVATE ROADWAY EASEMENTS SO THAT THE EXCAVATED MATERIAL IS NOT SUSCEPTIBLE TO BEING WASHED DOWN THE STREET OR INTO ANY PUBLIC DRAINAGE FACILITY.
- PROPOSED WATERLINE MATERIALS SHALL BE EITHER PVC PIPE MEETING AWWA C900 REQUIREMENTS (6"-12") OR DUCTILE IRON PIPE, THICKNESS CLASS 50 (6"-16").
- ANY WORK OCCURRING WITHIN A FULLY DEVELOPED ARTERIAL ROADWAY REQUIRES 24 HR. CONSTRUCTION.
- ALL EXCAVATION, TRENCHING AND SHORING ACTIVITIES MUST BE ACCOMPLISHED IN ACCORDANCE WITH OSHA 29CFR 1926.650 SUBPART P.
- CONTRACTOR SHALL MAINTAIN A GRAFFITI-FREE WORK SITE. CONTRACTOR SHALL PROMPTLY REMOVE ANY AND ALL GRAFFITI FROM EQUIPMENT, WHETHER PERMANENT OR TEMPORARY.
- ALL UTILITY WORK SHALL BE CONSTRUCTED IN ACCORDANCE WITH NEW MEXICO UTILITIES, INC. SPECIFICATIONS FOR WATER AND WASTEWATER FACILITIES (MOST RECENT REVISIONS).
- THE CONTRACTOR SHALL NOTIFY NEW MEXICO UTILITIES. (898-2661) THREE WORKING DAYS PRIOR TO BEGINNING THE CONSTRUCTION OF THE UTILITIES.

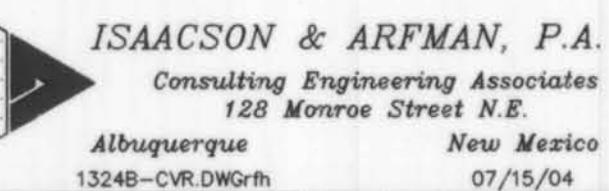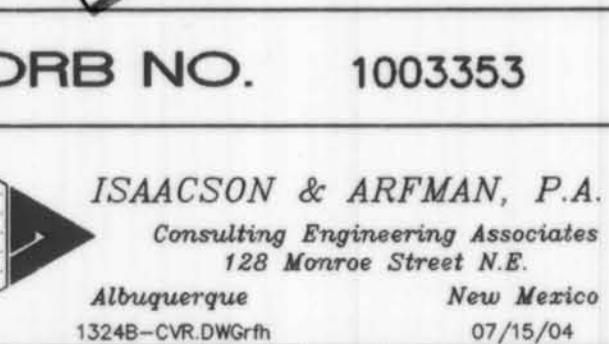

REV.	Sheets	City Engineer	Date	User Department	Date	User Department	Date
ENGINEER'S STAMP & SIGNATURE		APPROVALS		ENGINEER			
DRC Chairman				John [Signature]	9-23-04		
Transportation					9-23-04		
Water/Wastewater				Danny [Signature]	7/29/04		
Hydrology				Bradley [Signature]	7/29/04		
NMUI				John [Signature]	7/29/04		
Constr. Mngmt.				John [Signature]	7/29/04		
Constr. Coord.				John [Signature]	9-23-04		
City Project No.	738482						
Sheet	1	OF					

1 OF 19

APPROVED FOR CONSTRUCTION

City Engineer Date

**VICINITY MAP****SUBDIVISION DATA / NOTES**

- Total Number of Existing Tracts: 1
- Total Number of Lots created: 50
- Total Number of Tracts created: 3
- Gross Subdivision Acreage: 9.4494 Ac.
- Total Mileage of Full Width Streets Created: 0.59
- Bearings are New Mexico State Plane Grid Bearings (Central Zone).
- Distances are ground distances.
- Bearings and distances in parenthesis are record.
- Basis of boundary are the following plats (and documents) of record entitled: PLAT OF "THE TRAILS" (12-15-03, 03C-375)
- Field Survey performed on March, 2003.
- Title Report: None provided.
- This property is apparently affected by reservations, restrictions and agreements contained within easements, documents and memorandums as listed within the above mentioned Title Report.
- Basis of boundary is from the plats of record entitled:

 - UNPLATTED LAND OF "VOLCANO SIX LIMITED"
 - TRACT OS-1 OPEN SPACE
 - TRACT OS-2 OPEN SPACE
 - UNPLATTED LAND OF "THE ARCHDIOCESE OF SANTA FE"
 - UNPLATTED LAND OF "PARADISE WEST INC."
 - PLAT OF "THE TRAILS, TRACT D" (12-15-03, 03C-375)
 - PLAT OF "THE TRAILS, TRACT J" (12-15-03, 03C-375)
 - PLAT OF "THE TRAILS, TRACT G" (12-15-03, 03C-375)

- all records of Bernalillo County, New Mexico.
- Current Zoning: R-D.
- These properties are within the New Mexico Utilities, Inc. (NMU, Inc.) franchise area, water and sanitary sewer system capabilities are based on the NMU, Inc. facilities, not the City of Albuquerque.
- Centerline (in lieu of R/W) monumentation to be installed at all centerline PC's, PT's, angle points and street intersections prior to acceptance of subdivision street improvements and will consist of a standard four-inch (4") aluminum alloy cap stamped "City of Albuquerque", "Centerline Monumentation", "Survey Marker", "Do Not Disturb", "PLS #7719".
- All property corners to be set with 5/8" rebar with cap "ALS LS 7719".

ALDRICH LAND SURVEYING
P.O. BOX 30701, ALBO., N.M. 87190
505-884-1990

1324BPT1.DWG.m 07/26/04

LEGAL DESCRIPTION

A tract of land situate within the Town of Alameda Grant, projected Section 16, Township 11 North, Range 2 East, New Mexico Principal Meridian, City of Albuquerque, Bernalillo County, New Mexico being all of TRACT B, THE TRAILS as the same is shown and designated on said plat filed for record in the office of the County Clerk of Bernalillo County, New Mexico on December 15, 2003 in Book 2003C, Page 375 and containing 9.4494 acres more or less.

DISCLOSURE STATEMENT

The intent of this plat is to subdivide the subject tract into residential lots, to create 3 tracts, to dedicate public rights-of-way, to grant those easements necessary to serve the residential development, and to vacate easements.

FREE CONSENT AND DEDICATION

The subdivision shown hereon is with the free consent and in accordance with the desires of the undersigned Owner(s) and/or Proprietor(s) thereof and said Owner(s) and/or Proprietor(s) do hereby dedicate all streets and public rights-of-way shown hereon to the City of Albuquerque in fee simple with warranty covenants and do hereby grant: all access, utility and drainage easements shown hereon including the right to construct, operate, inspect, and maintain facilities therein; and all public utility easements shown hereon for the common and joint use of gas, electrical power and communication services for overhead and/or buried distribution lines, conduits, and pipes for underground and/or overhead utilities where shown or indicated, and including the right of ingress and egress for construction and maintenance, and the right to trim interfering trees and shrubs. Said Owner(s) and/or Proprietor(s) do hereby consent to all of the foregoing and do hereby certify that this subdivision is their free act and deed.

OWNER

HERITAGE AT THE TRAILS HOMEOWNERS ASSOCIATION

RICHARD T. BRESSAN
PRESIDENT

Date

ACKNOWLEDGMENTSTATE OF NEW MEXICO } SS
COUNTY OF BERNALILLO }

This instrument was acknowledged before me on _____, 2004, by Richard T. Bressan as President of Heritage at the Trails Homeowners Association, a New Mexico Non-Profit Corporation, on behalf of said Corporation.

My Commission Expires: _____

Notary Public

OWNER
CENTEX HOMESNORMAN A. GREGORY
LAND DEVELOPMENT MANAGER

Date

ACKNOWLEDGMENTSTATE OF NEW MEXICO } SS
COUNTY OF BERNALILLO }

This instrument was acknowledged before me on _____, 2004, by Norman A. Gregory as Land Development Manager of Centex Homes, a Nevada General Partnership, on behalf of said General Partnership.

My Commission Expires: _____

Notary Public

APPROVALS

DRB PROJECT NO. 1003353

APPLICATION NO.

Utility Approvals

PNM ELECTRIC SERVICES DIVISION DATE

PNM GAS SERVICES DIVISION DATE

QWEST DATE

COMCAST DATE

NEW MEXICO UTILITIES
City Approvals DATE

CITY SURVEYOR DATE

REAL PROPERTY DIVISION DATE

ENVIRONMENTAL HEALTH DEPARTMENT DATE

TRAFFIC ENGINEERING, TRANSPORTATION DIVISION DATE

UTILITIES DEVELOPMENT DATE

PARKS AND RECREATION DEPARTMENT DATE

AMAFCA DATE

CITY ENGINEER DATE

DRB CHAIRPERSON, PLANNING DEPARTMENT DATE

SURVEYOR'S CERTIFICATION

I, Timothy Aldrich, a duly qualified Registered Professional Land Surveyor under the laws of the State of New Mexico, do hereby certify that this plat and description were prepared by me or under my supervision, shows all easements as shown on the plat of record or made known to me by the owners and/or proprietors of the subdivision shown hereon, utility companies and other parties expressing an interest and meets the minimum requirements for monumentation and surveys of the Albuquerque Subdivision Ordinance, and further meets the Minimum Standards for Land Surveying in the State of New Mexico (Effective November 1, 1989 and revisions effective December 25, 1991, February 2, 1994 and October 2000), and is true and correct to the best of my knowledge and belief.


Timothy Aldrich, P.S. No. 7719

Date

SHEET 1 OF 3**PLAT FOR HERITAGE AT THE TRAILS SUBDIVISION UNIT 2**

BEING A REPLAT OF
TRACT B, THE TRAILS
WITHIN THE TOWN OF ALAMEDA GRANT
PROJECTED SECTION 16,
T. 11 N., R. 2 E., NMMP
CITY OF ALBUQUERQUE,
BERNALILLO COUNTY, NEW MEXICO
AUGUST 2004




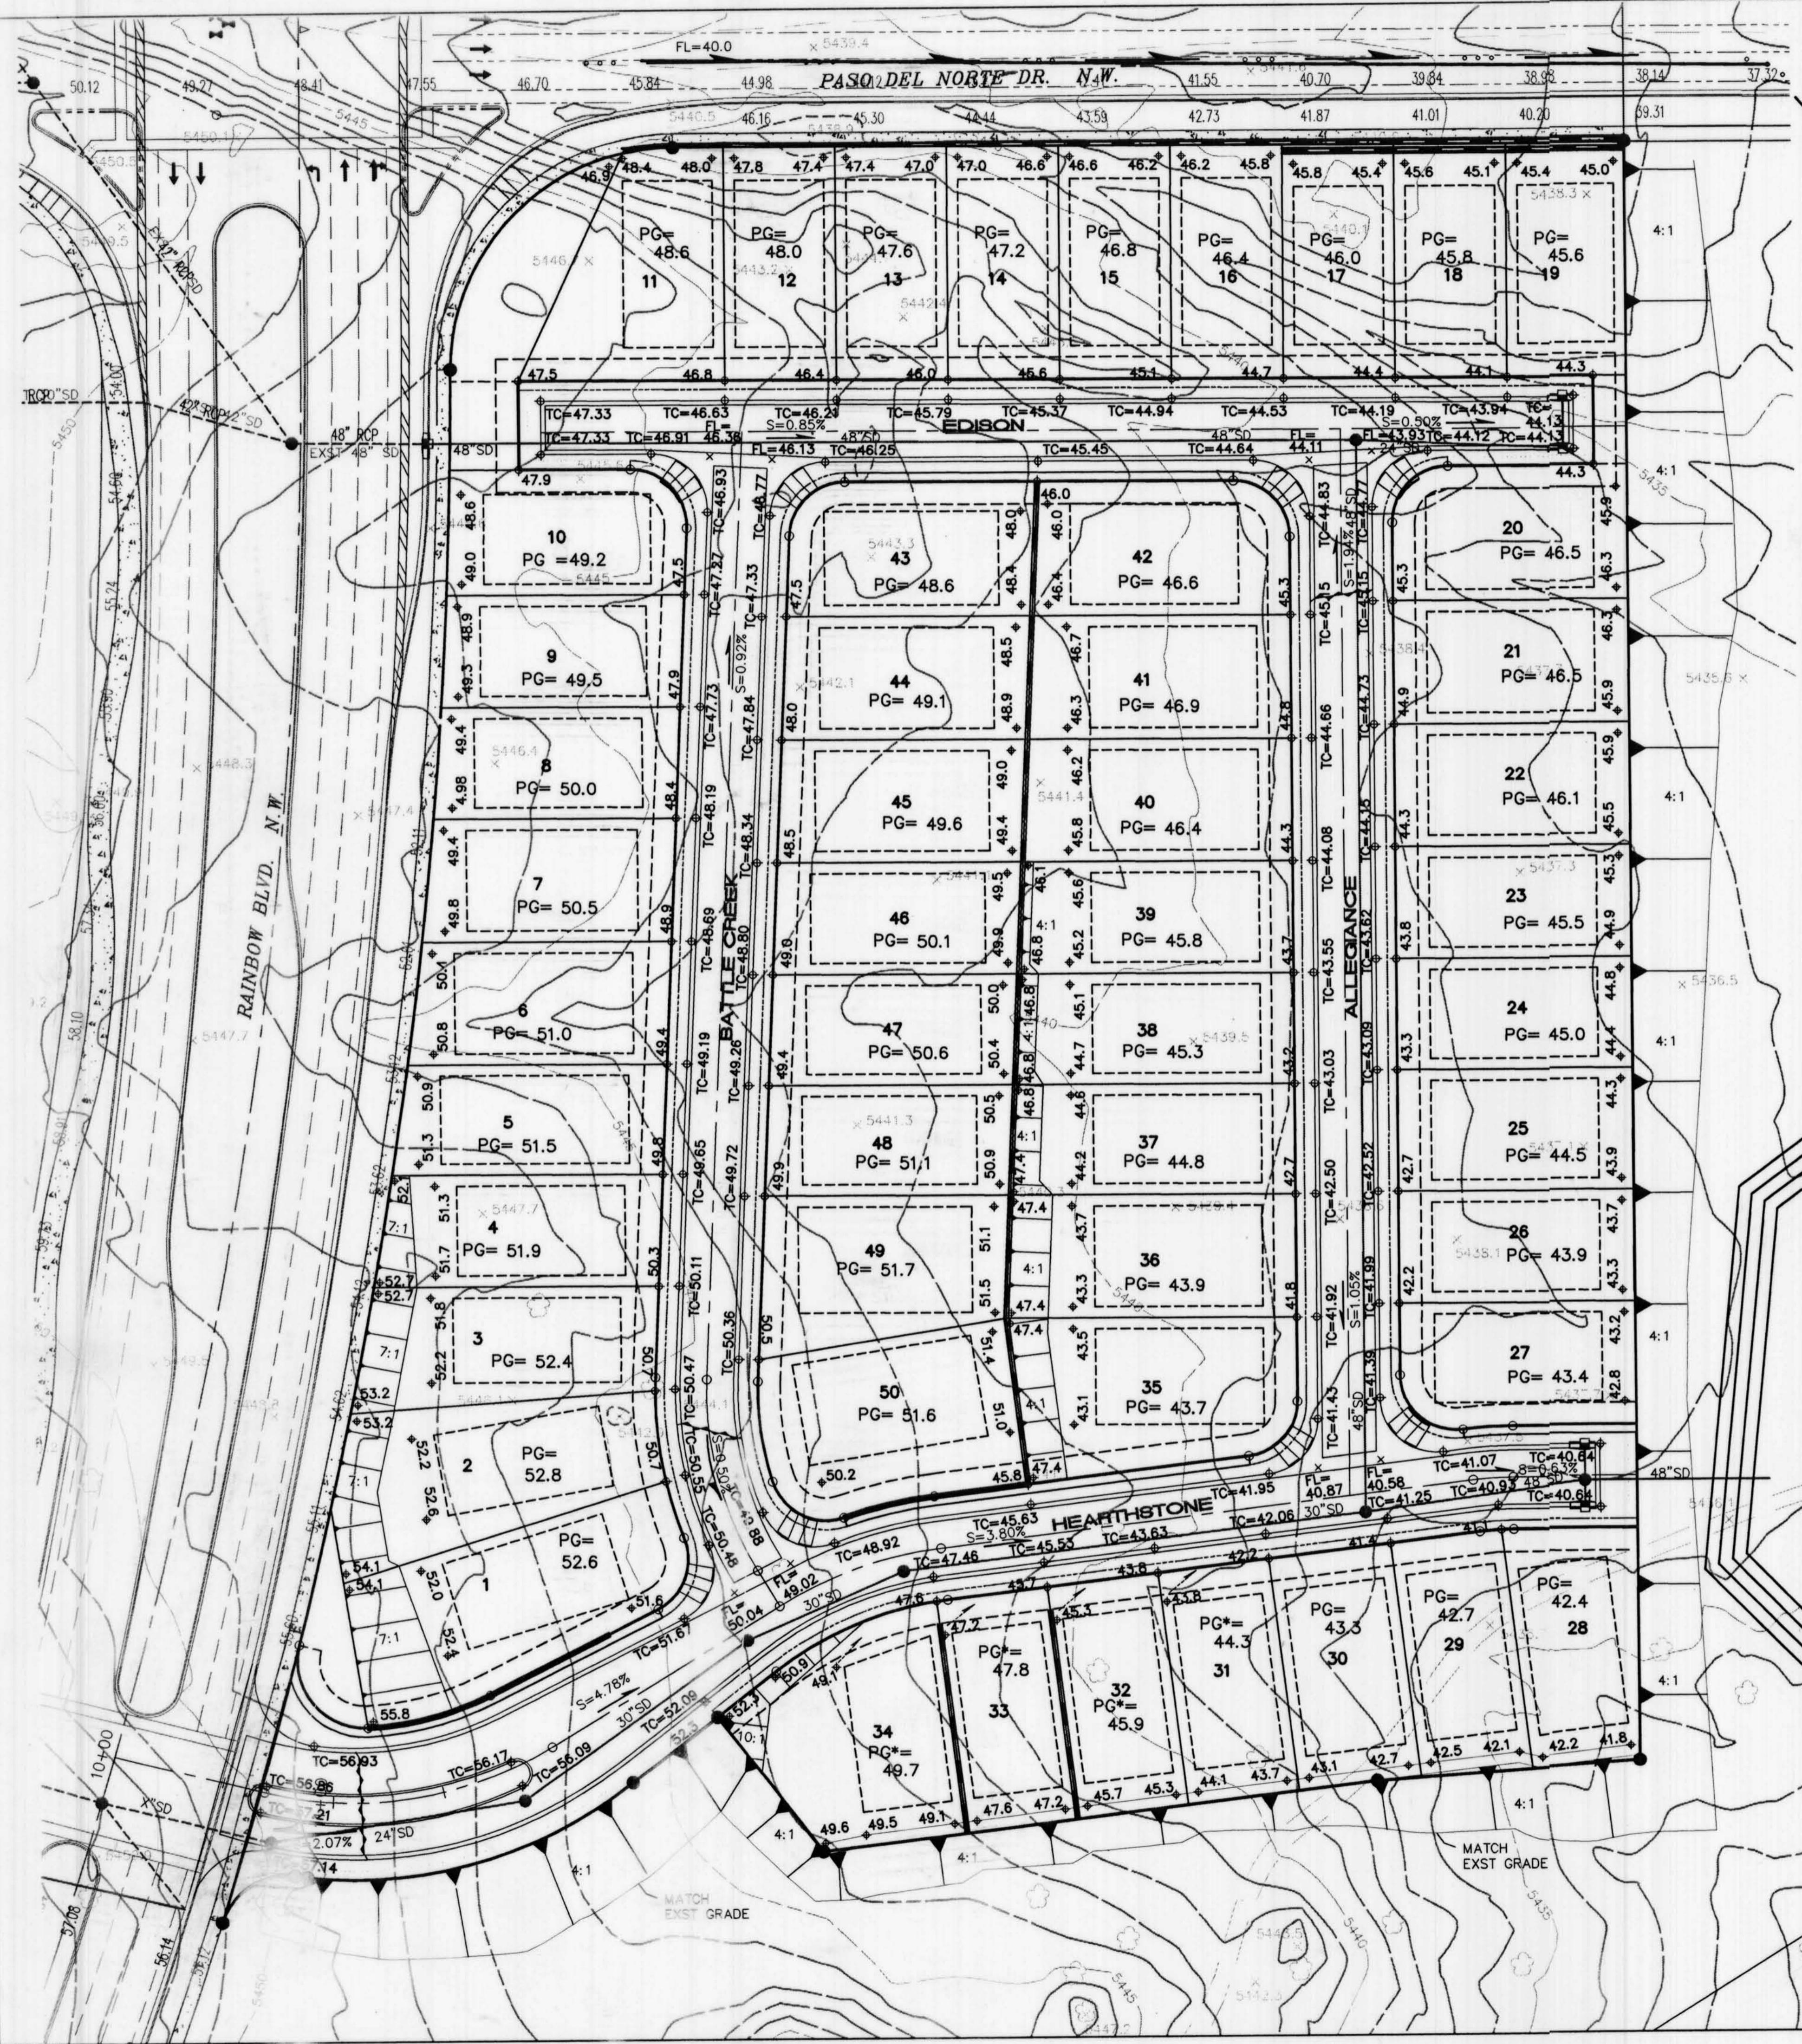

SCALE:
1"=40'
40 30 20 10 0 40 80

LEGEND

- 5200 EXISTING CONTOUR
- ◆ 78.3 PROPOSED SPOT ELEVATION
- FLOW ARROW
- PG=6881.0 PAD GRADE ELEVATION
- TC=81.95 TOP OF CURB ELEVATION
- FL=81.45 FLOWLINE ELEVATION
- ~~~~~ WATER BAR
- PROPOSED RETAINING WALL
- STORM DRAIN MANHOLE
- PG*= SEE DETAIL XX ON SHEET 3
- 4:1 PROPOSED SLOPE

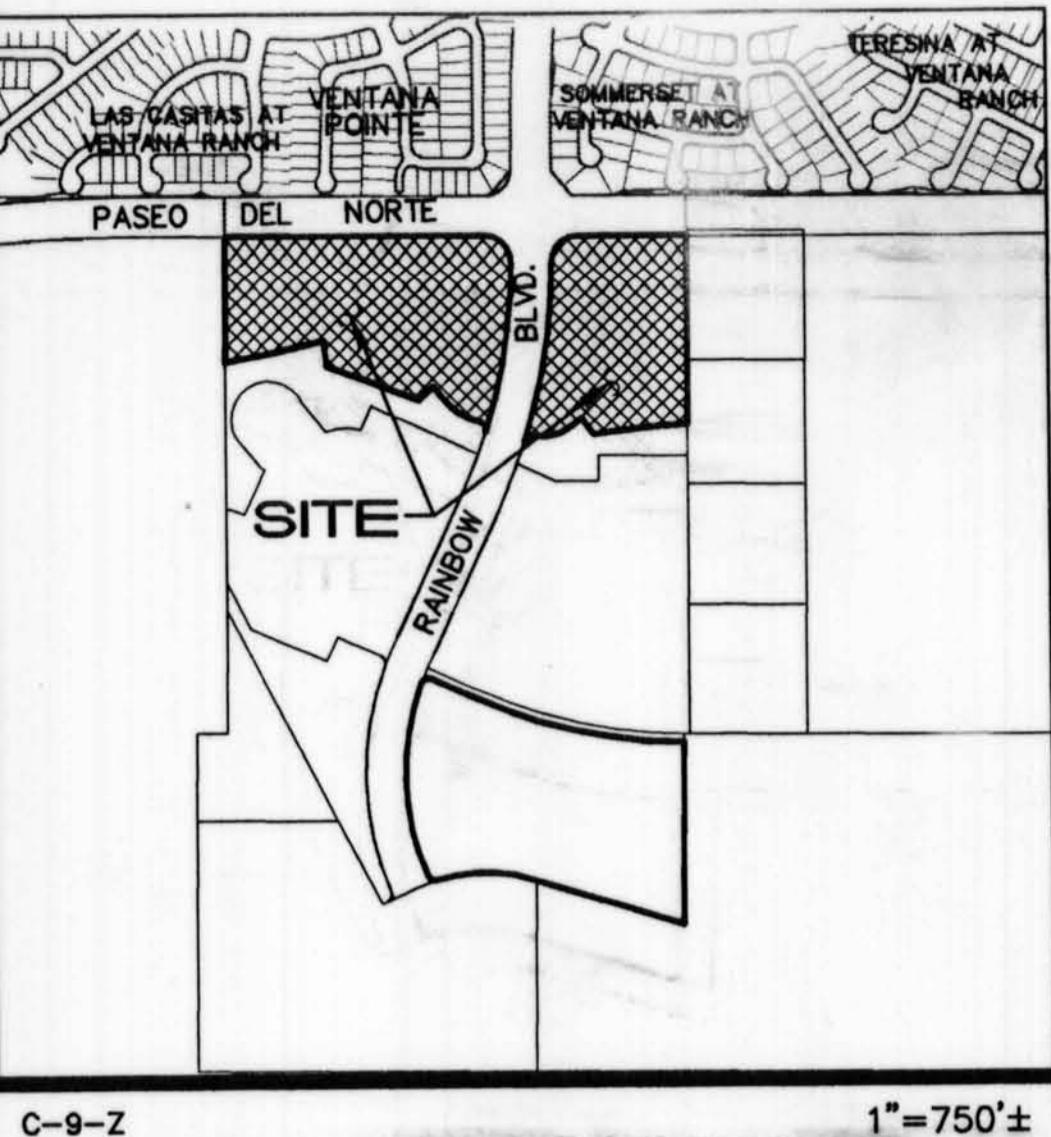

HERITAGE AT
THE TRAILS UNIT 2
GRADING & DRAINAGE PLAN


ISAACSON & ARFMAN, P.A.
Consulting Engineering Associates
22 Monroe Street N.E.
Albuquerque, New Mexico
15088
GENEVIEVE L. DOMAN
PROFESSIONAL ENGINEER
New Mexico
3250
General
SHEET 1 OF 3
1324B-GRD.DWG
03/19/04
738482

FOR INFORMATION
ONLY



LEGEND

- 5200 — EXISTING CONTOUR
- 52 — PROPOSED CONTOUR
- ◆ 78.3 — PROPOSED SPOT ELEVATION
- FLOW ARROW
- PG=6881.0 PAD GRADE ELEVATION
- SIDWALK CULVERT
- TC=81.95 TOP OF CURB ELEVATION
- FL=81.45 FLOWLINE ELEVATION
- ~~~~~ WATER BAR
- PROPOSED RETAINING WALL
- TW=52.0 TOP OF RETAINING WALL ELEVATION
- BW=50.0 BOTTOM OF RETAINING WALL ELEVATION
- INV=72.5 INVERT ELEVATION
- STORM DRAIN MANHOLE

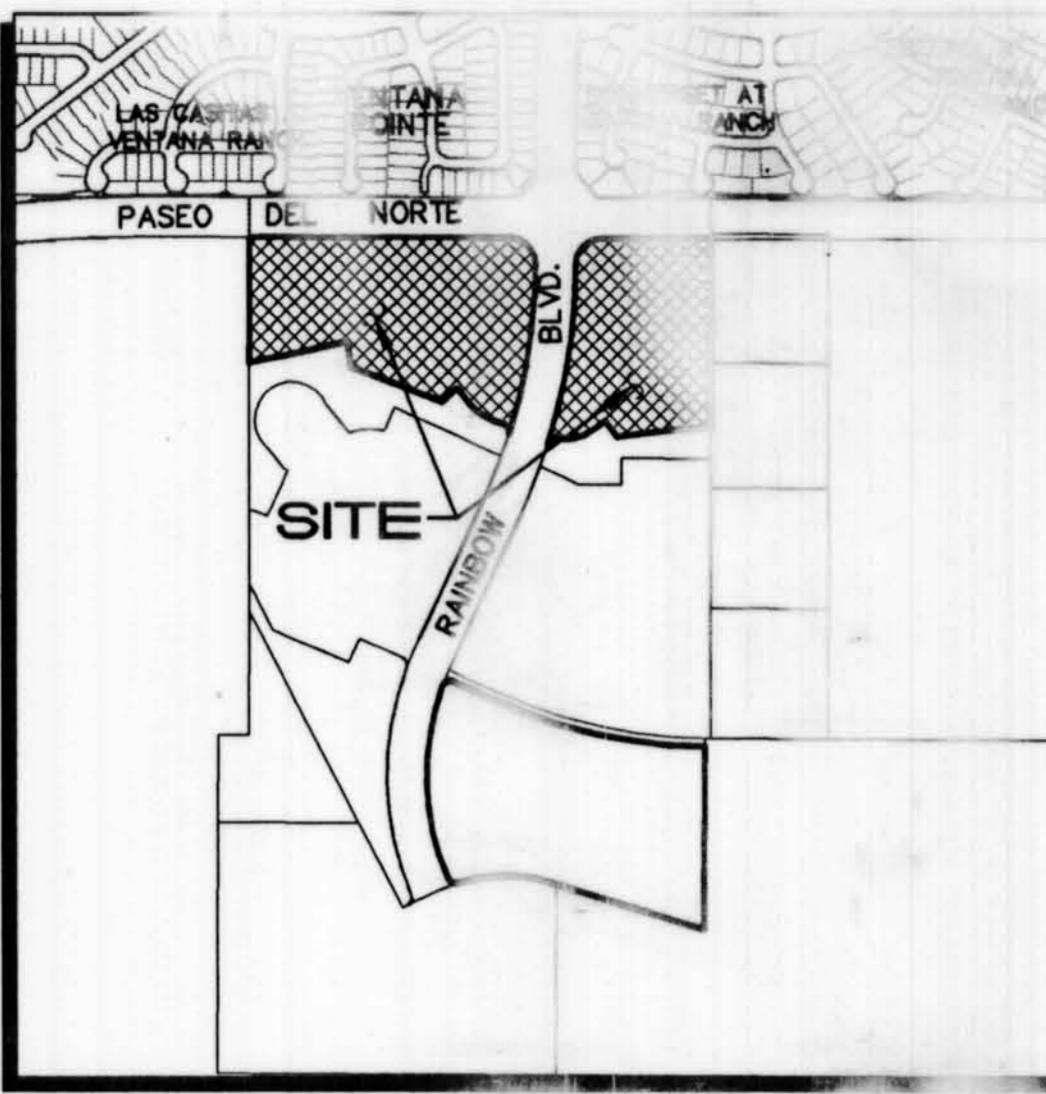

C-9-Z VICINITY MAP

GRADING NOTES:

1. ALL TRASH, DEBRIS, & SURFACE VEGETATION SHALL BE CLEARED AND LEGALLY DISPOSED OFFSITE.
2. ALL SUBGRADE AND FILL SHALL BE COMPACTED TO A MINIMUM OF 90% ASTM D-1557.
3. EXCAVATION IS UNCLASSIFIED AND INCLUDES EXCAVATION TO SUBGRADE ELEVATIONS INDICATED, REGARDLESS OF CHARACTER OF MATERIALS ENCOUNTERED.
4. CONFORM TO ELEVATIONS AND DIMENSIONS SHOWN ON PLANS WITHIN A TOLERANCE OF 0.3± FEET.
5. SCARIFY AND COMPACT SUBGRADE FOR FILLS. PLACE FILL MATERIALS IN LAYERS NOT MORE THAN 8" IN LOOSE DEPTH. MOISTEN AS NECESSARY TO PROVIDE OPTIMUM MOISTURE (±2%) CONTENT.
6. UNIFORMLY GRADE AREAS WITHIN LIMITS OF GRADING AS SHOWN ON PLAN. SMOOTH FINISHED SURFACE WITHIN SPECIFIED TOLERANCE, COMPACT WITH UNIFORM SLOPES BETWEEN POINTS WHERE ELEVATIONS ARE INDICATED.
7. MAXIMUM SLOPES SHALL BE 3:1 MINIMUM SLOPES SHALL BE 1%.
8. TWO (2) WORKING DAYS PRIOR TO ANY EXCAVATION, CONTRACTOR MUST CONTACT NEW MEXICO ONE CALL SYSTEM, 260-1990, FOR LOCATION OF EXISTING UTILITIES.
9. IF ANY UTILITY LINES, PIPELINES, OR UNDERGROUND UTILITY LINES ARE SHOWN ON THESE DRAWINGS, THEY ARE SHOWN IN AN APPROXIMATE MANNER ONLY, AND SUCH LINES MAY EXIST WHERE NONE ARE SHOWN. IF ANY SUCH EXISTING LINES ARE SHOWN, THE LOCATION IS BASED UPON INFORMATION PROVIDED BY THE OWNER OF SAID UTILITY, AND THE INFORMATION MAY BE INCOMPLETE, OR MAY BE OBSOLETE BY THE TIME CONSTRUCTION COMMENCES. THE ENGINEER HAS CONDUCTED ONLY PRELIMINARY INVESTIGATION OF THE LOCATION, DEPTH, SIZE OR TYPE OF EXISTING UTILITY LINES, PIPELINES, OR UNDERGROUND UTILITY LINES. THIS INVESTIGATION IS NOT CONCLUSIVE, AND MAY NOT BE COMPLETE, THEREFORE, MAKES NO REPRESENTATION PERTAINING THERETO, AND ASSUMES NO RESPONSIBILITY OR LIABILITY THEREFOR. THE CONTRACTOR SHALL INFORM ITSELF OF THE LOCATION OF ANY UTILITY LINE, PIPELINE, OR UNDERGROUND UTILITY LINE IN OR NEAR THE AREA OF THE WORK IN ADVANCE OF AND DURING EXCAVATION WORK. THE CONTRACTOR IS FULLY RESPONSIBLE FOR ANY AND ALL DAMAGE CAUSED BY ITS FAILURE TO LOCATE, IDENTIFY, AND PRESERVE ANY AND ALL EXISTING UTILITIES, PIPELINES, AND UNDERGROUND UTILITY LINES. IN PLANNING AND CONDUCTING EXCAVATION, THE CONTRACTOR SHALL COMPLY WITH STATE, MUNICIPAL AND LOCAL ORDINANCES, RULES AND REGULATIONS, IF ANY, PERTAINING TO THE LOCATION OF THESE LINES AND FACILITIES.
10. OWNER WILL PROVIDE SOIL TESTING AND INSPECTION SERVICES DURING EARTHWORK OPERATIONS. CONTRACTOR SHALL ALLOW TESTING SERVICE TO INSPECT AND APPROVE COMPACTED SUBGRADES AND FILL LAYERS BEFORE FURTHER CONSTRUCTION WORK IS DONE. SHOULD COMPACTION TESTS INDICATE INADEQUATE DENSITY, CONTRACTOR SHALL PROVIDE ADDITIONAL COMPACTION AND TESTING AT NO ADDITIONAL EXPENSE.
11. OWNER HAS ESTABLISHED SUBDIVISION BOUNDARY CORNERS. CONTRACTOR SHALL PROVIDE ALL OTHER CONSTRUCTION STAKING INCLUDING TRACT CORNERS. CONTRACTOR SHALL LOCATE AND PRESERVE ALL BOUNDARY CORNERS AND REPLACE ANY LOST OR DISTURBED CORNERS.
12. OWNER WILL PROVIDE A STORM WATER POLLUTION PREVENTION PLAN (SWPPP) AND INSPECTION. CONTRACTOR SHALL COMPLY WITH THE BEST MANAGEMENT PRACTICES (BMP'S) AS SPECIFIED IN THE SWPPP, AND WITH ALL FEDERAL, STATE, AND LOCAL REGULATIONS.

HERITAGE AT
THE TRAILS - UNIT 2
GRADING & DRAINAGE PLAN
RETAINING WALLS




1324B-GRD.DWG 05/19/04 SHEET 2 OF 3


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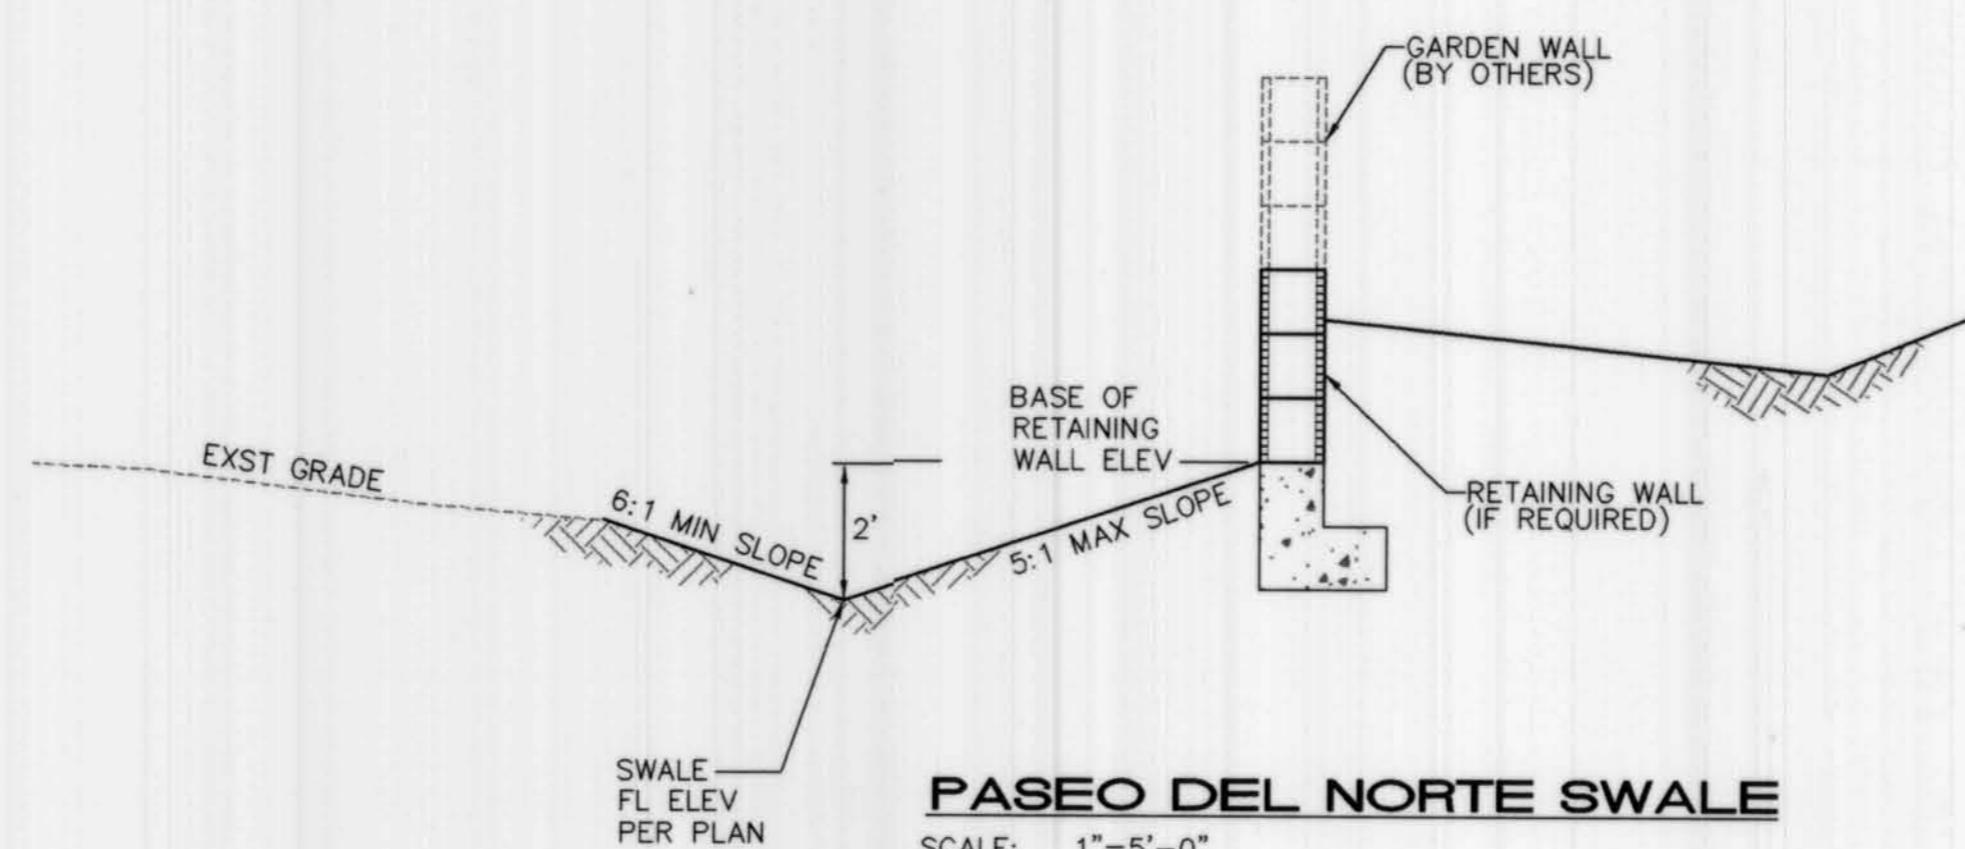
SHEET 5 OF 19








COMPACT ZONE—CONTRACTOR
SHALL COMPACT SOILS IN THIS
AREA TO A MINIMUM OF 95%
COMPACTION PER ASTM D698,
FOR A DEPTH OF 12 INCHES.

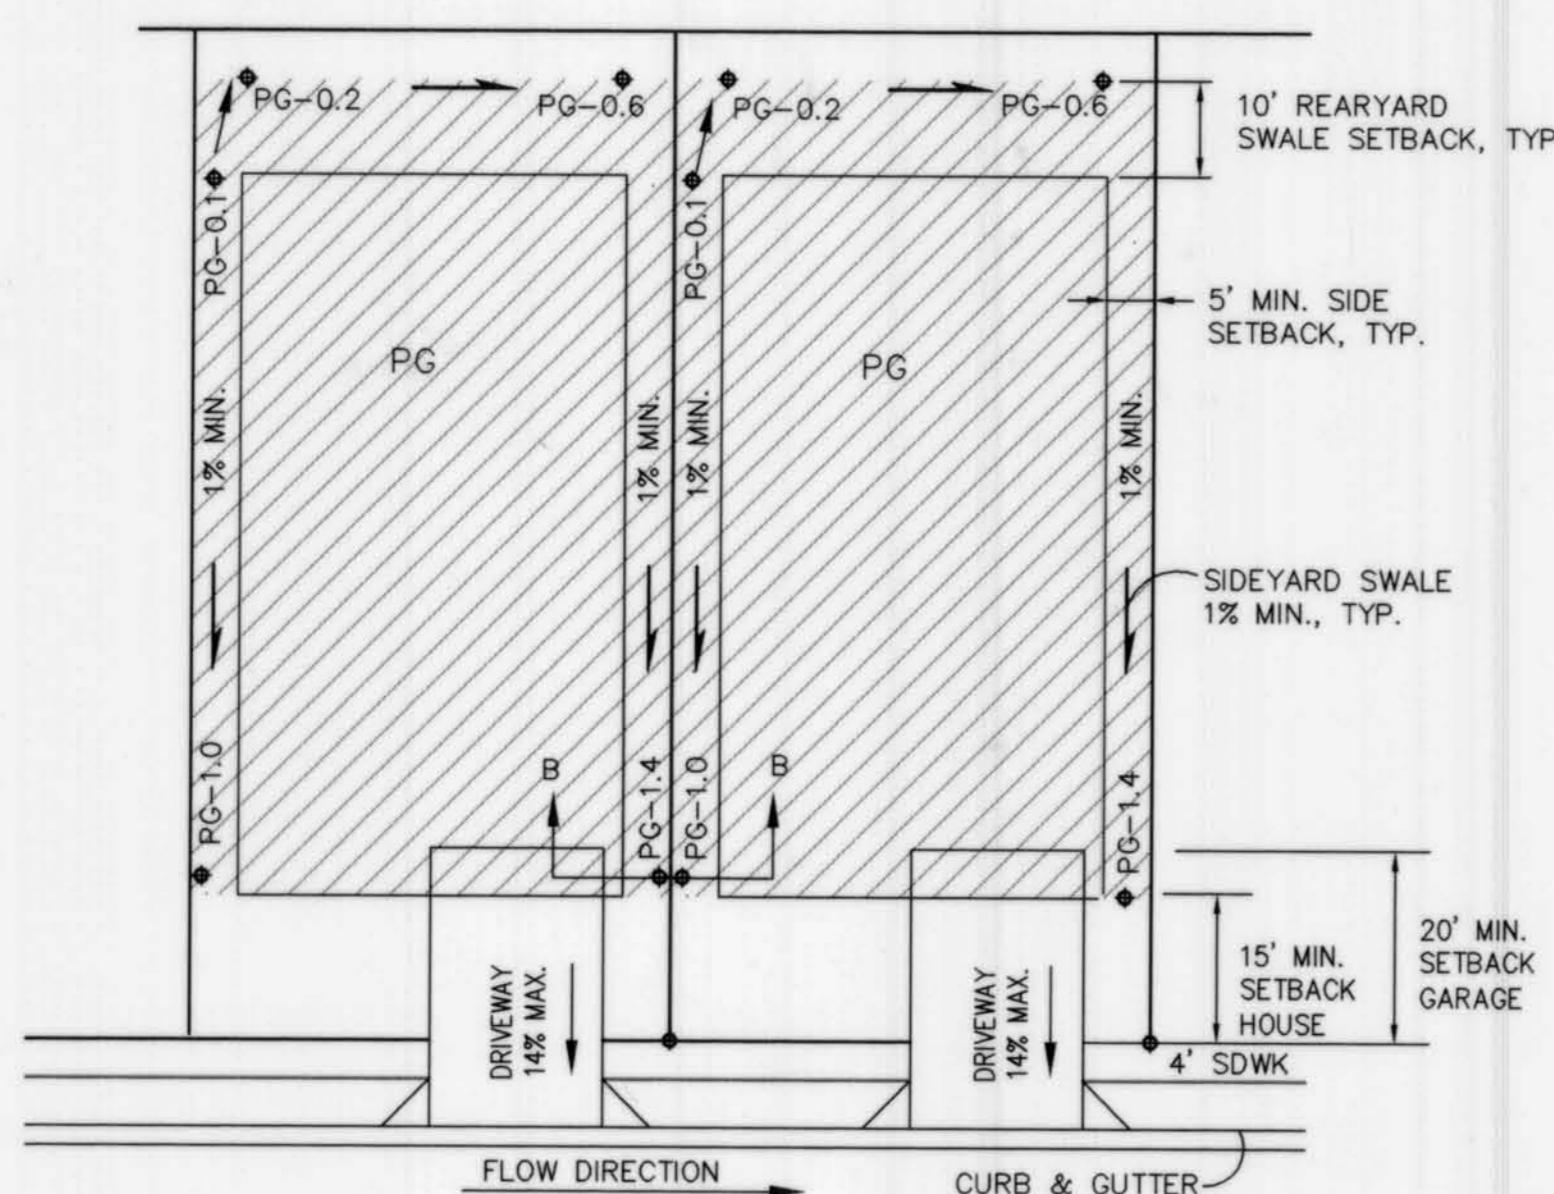

AN ASTERISK (*) NOTED BY THE LOT NUMBER ON
THE PLANS INDICATES THAT THE DRIVEWAY IS TO BE
PLACED ON THE LOW SIDE OF THE LOT.

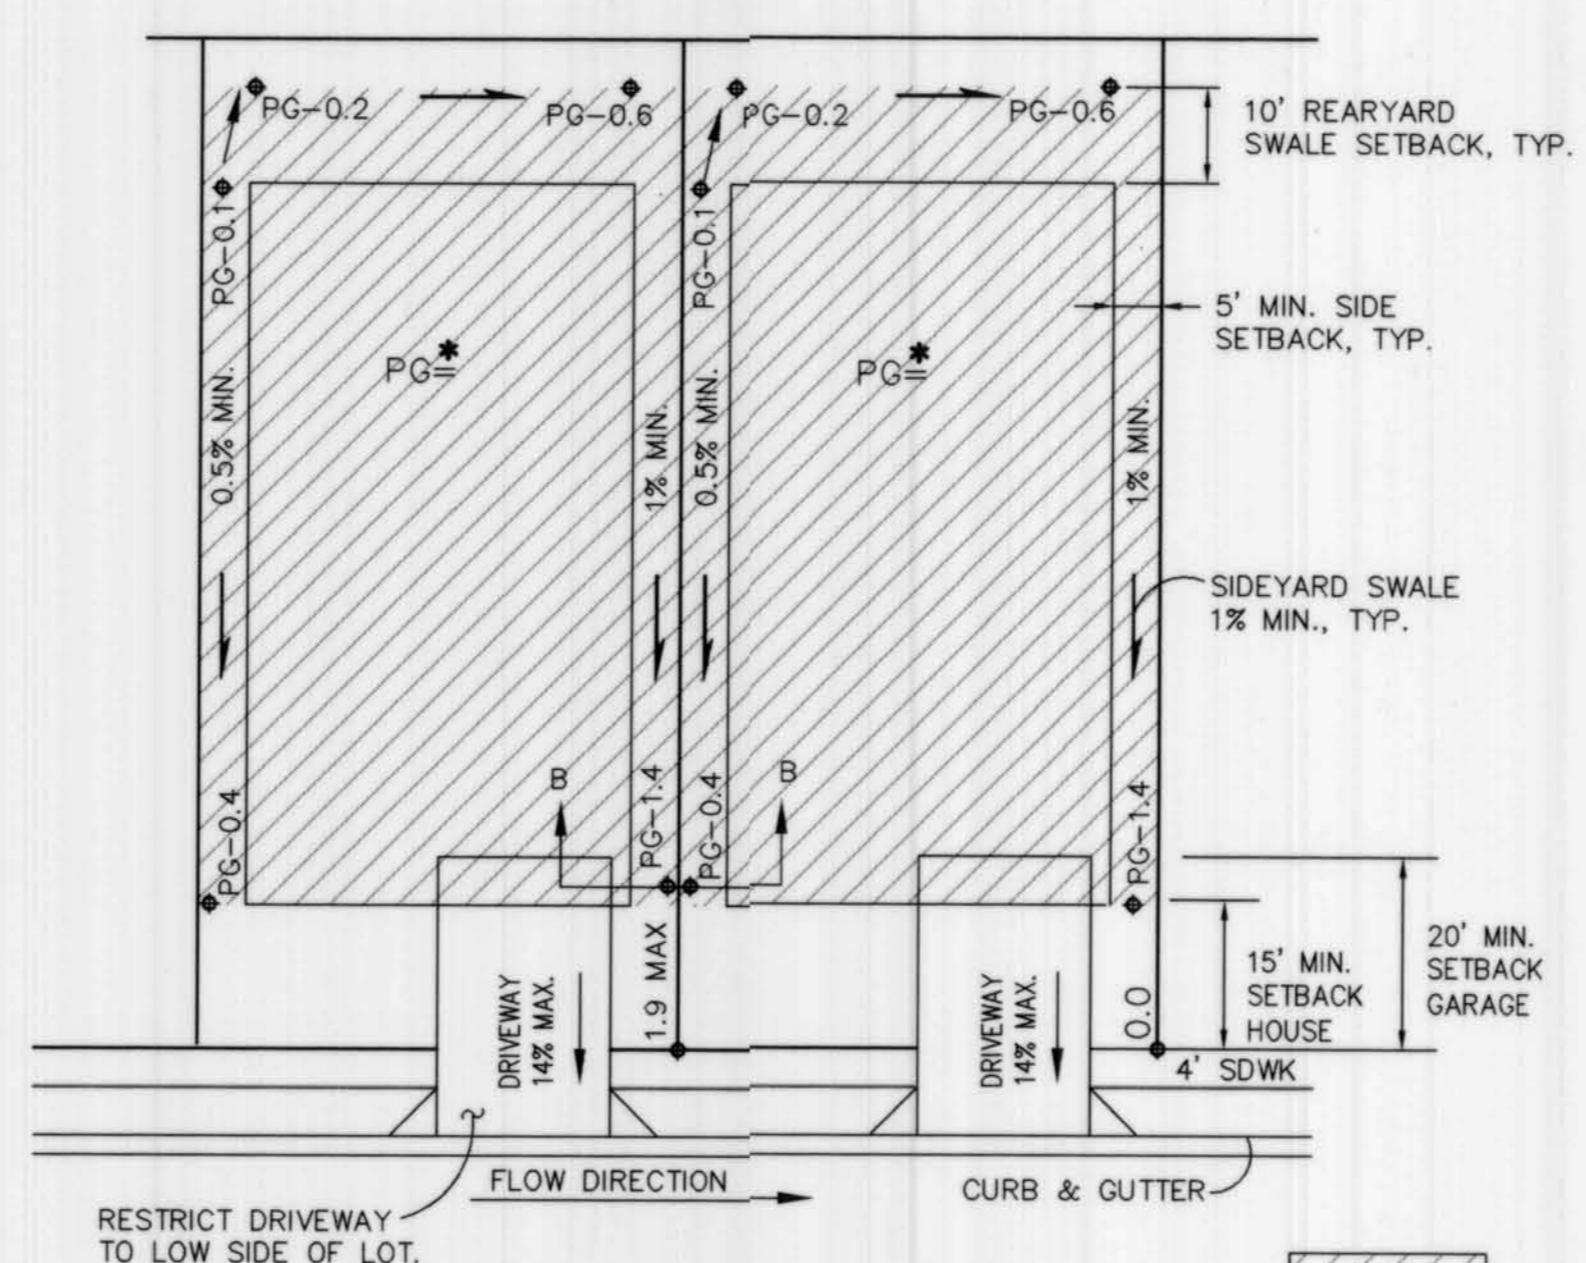

PASEO DEL NORTE SWALE
SCALE: 1"=5'-0"

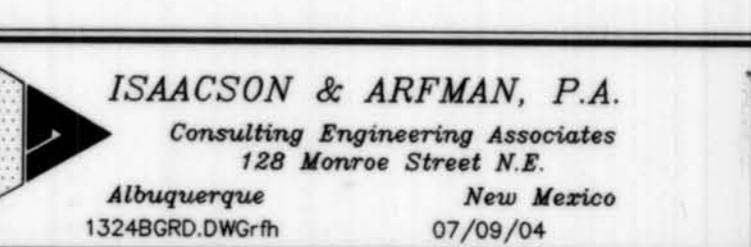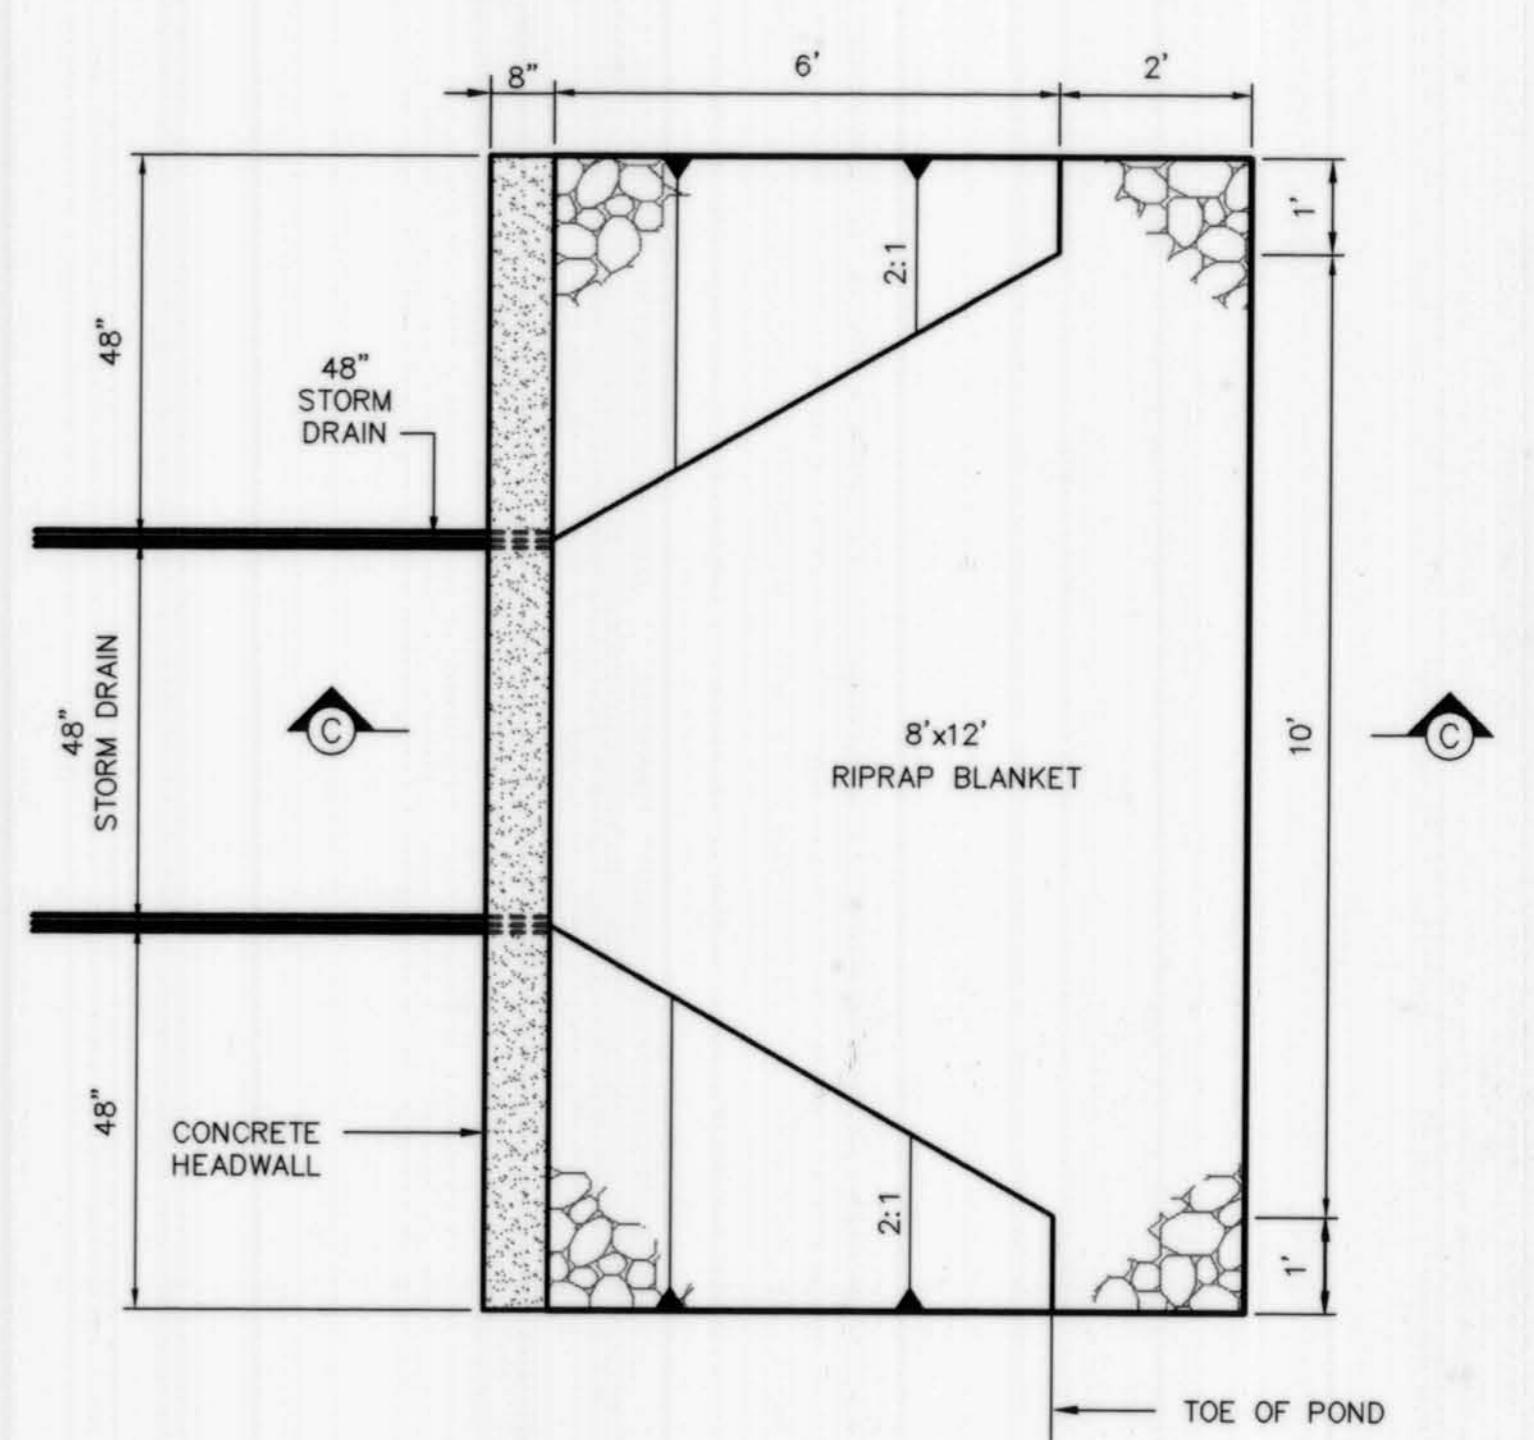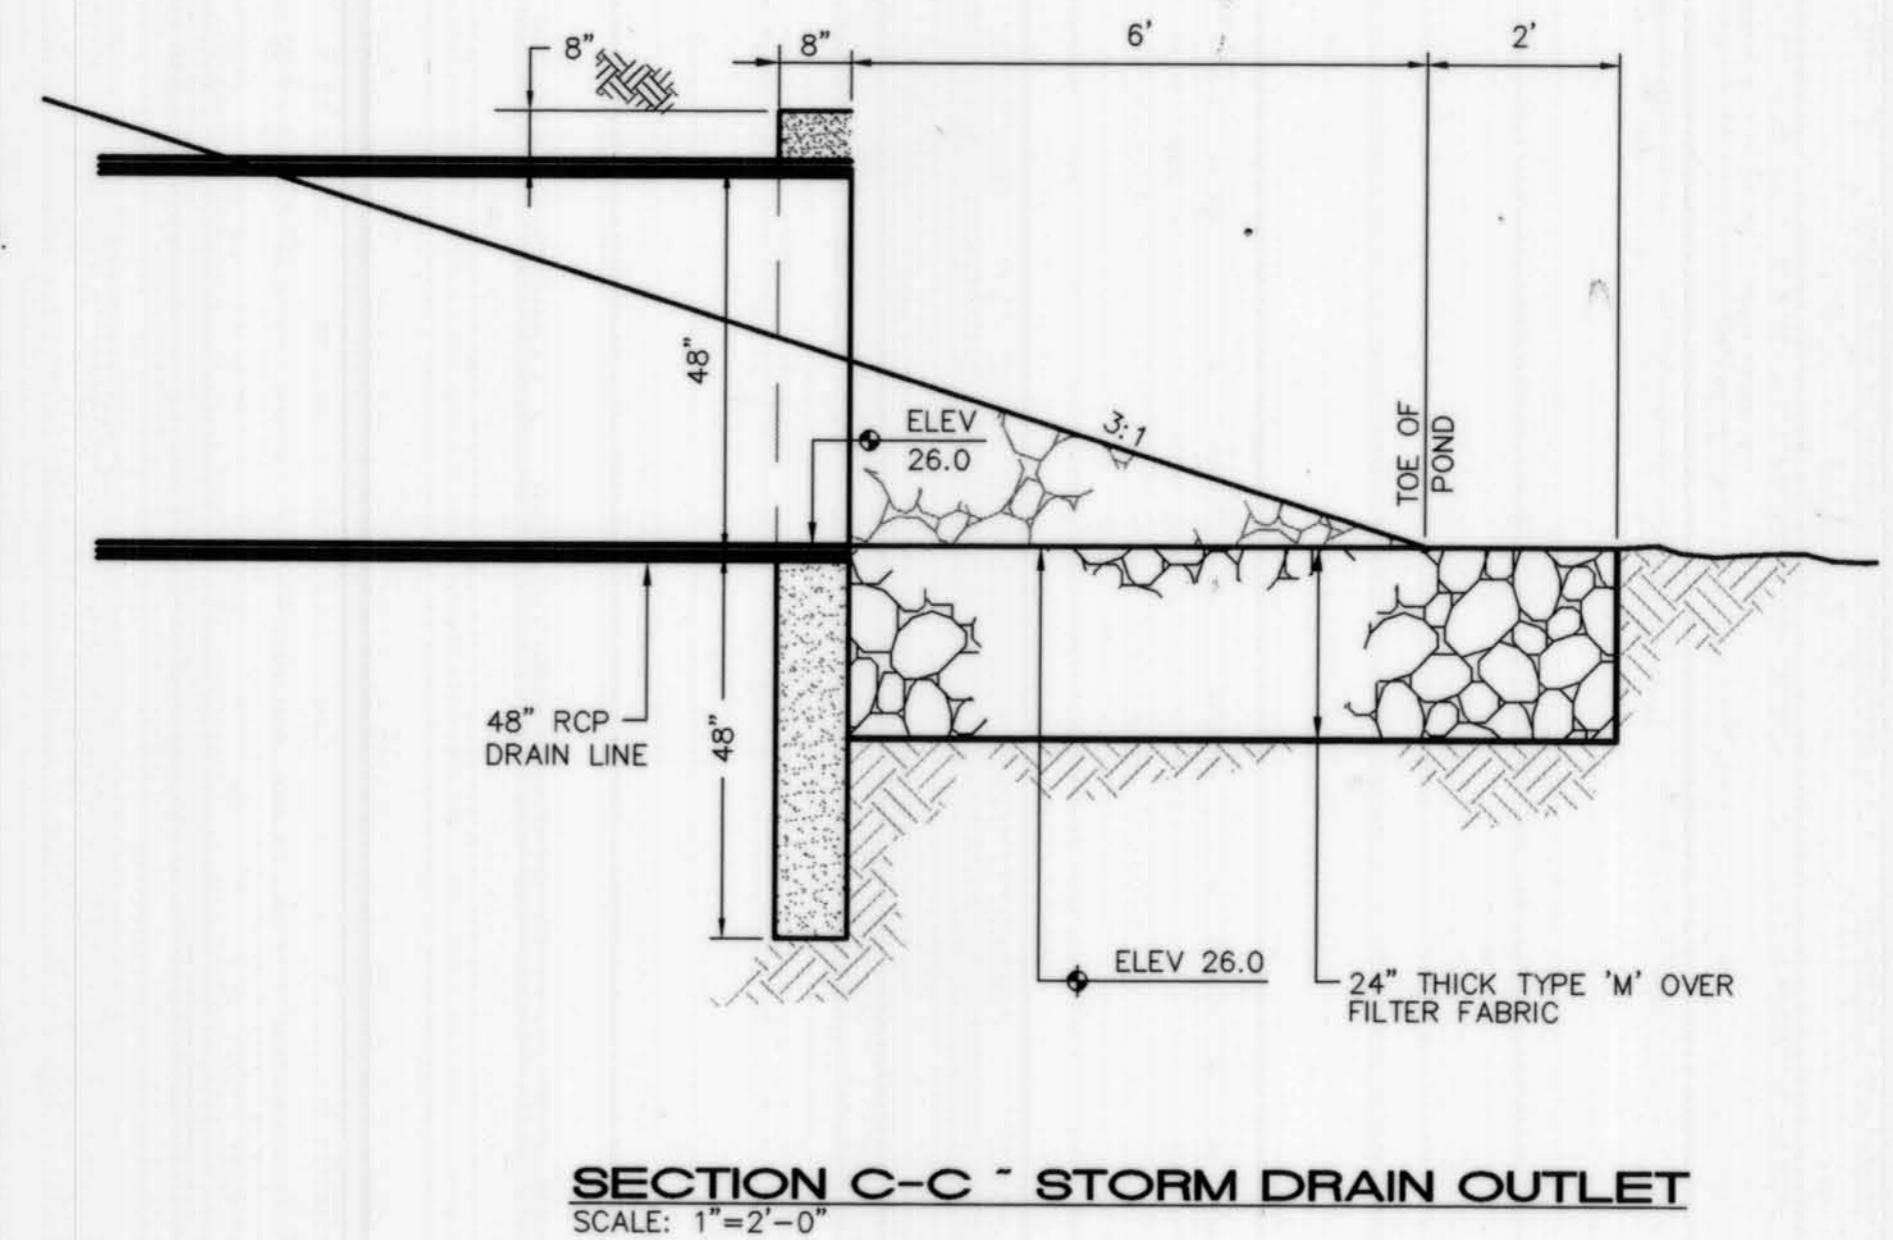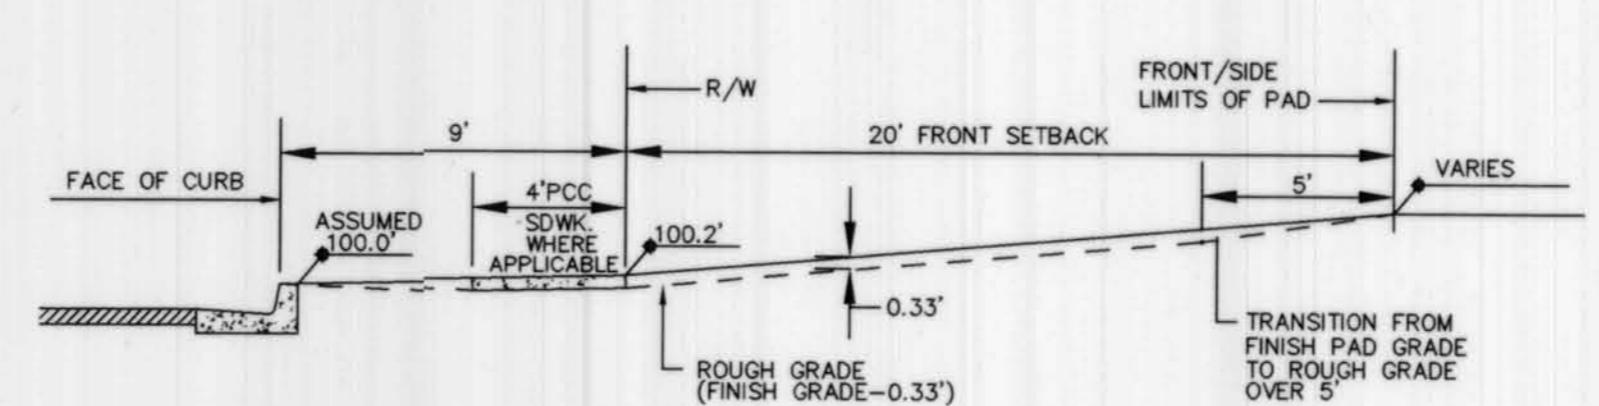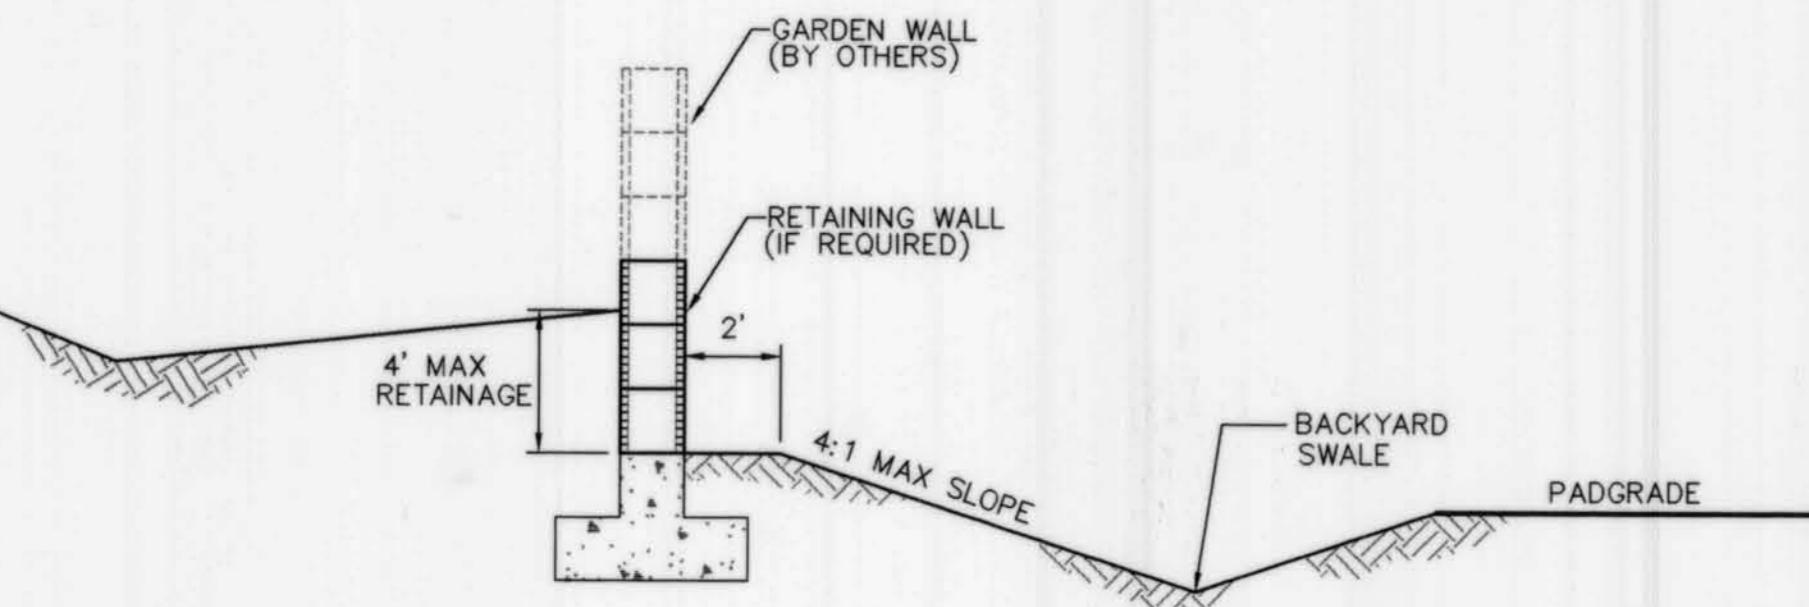

CITY OF ALBUQUERQUE
PUBLIC WORKS DEPARTMENT
ENGINEERING GROUP







TITLE: HERITAGE AT THE TRAILS UNIT 2
GRADING DETAILS

Design Review Committee	City Engineer Approval	Mo./Day/Yr.	Mo./Day/Yr.
Last Design Update			
City Project No.	738482	Zone Map No.	C-9-Z
Sheet	6	Of	19


For Information
Only





Genevieve
L. Donar
Professional Engineer
15088
7/21/04

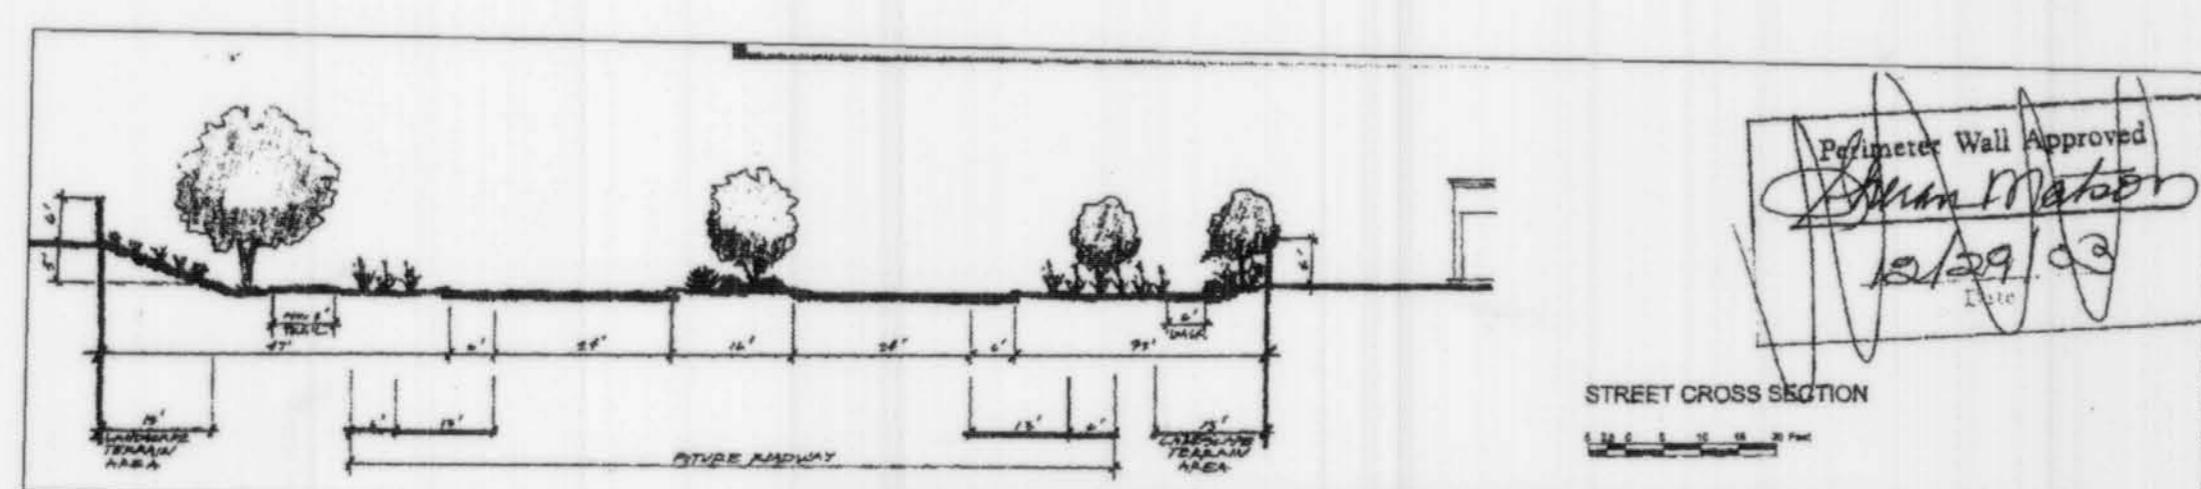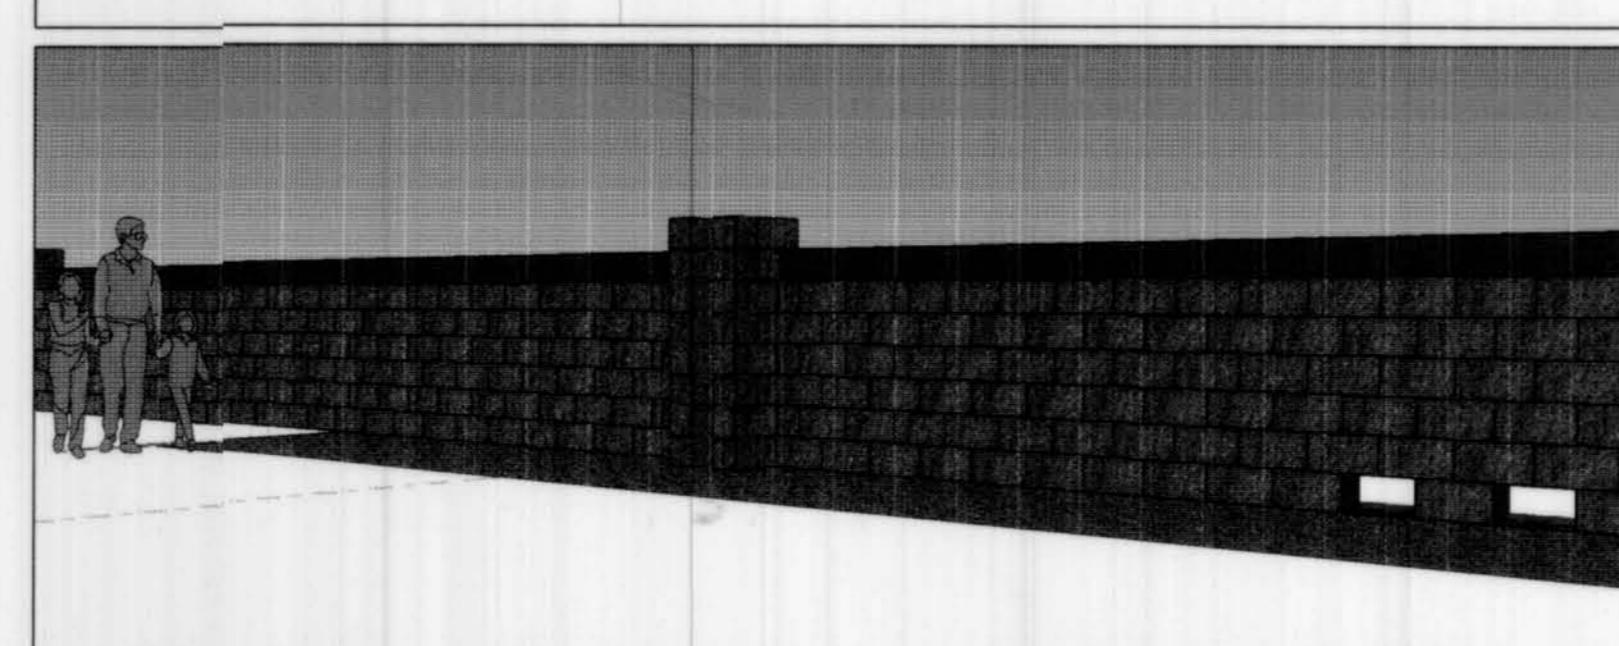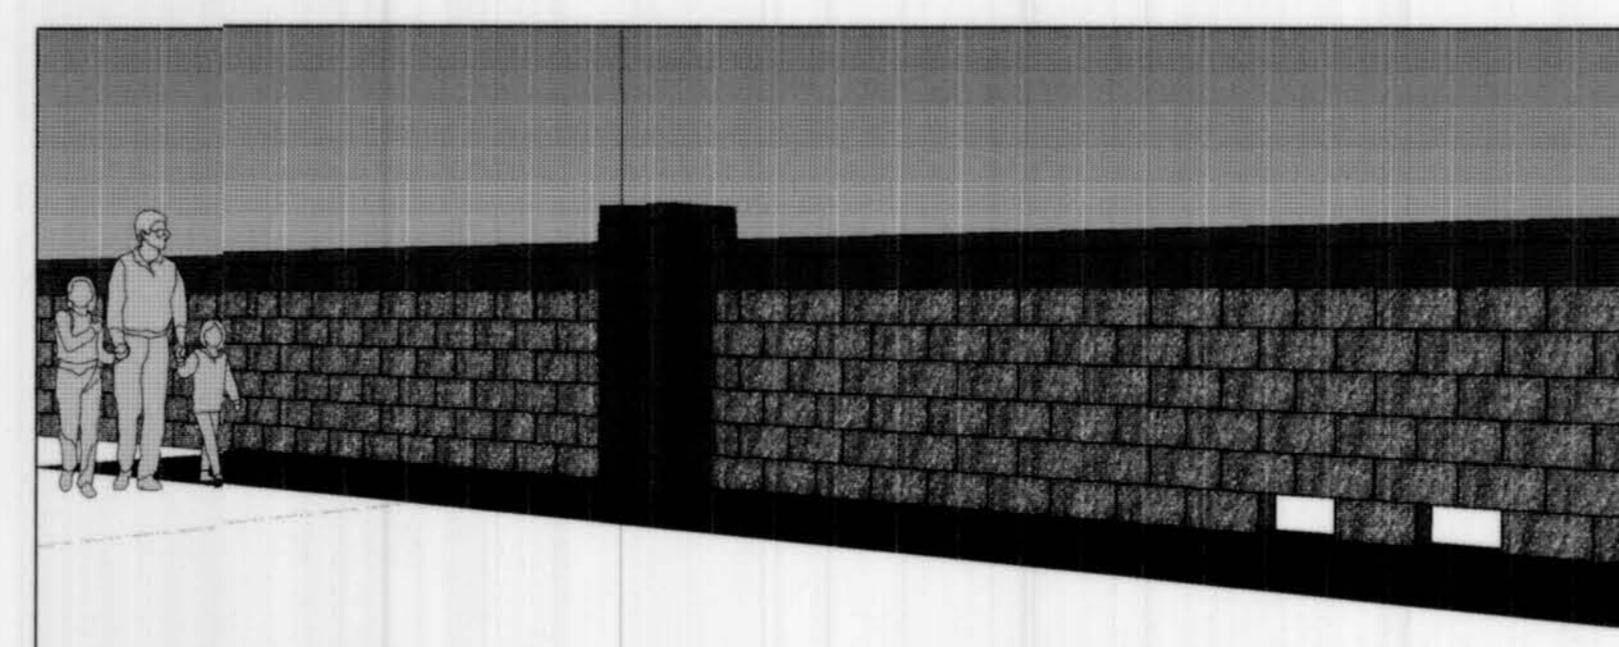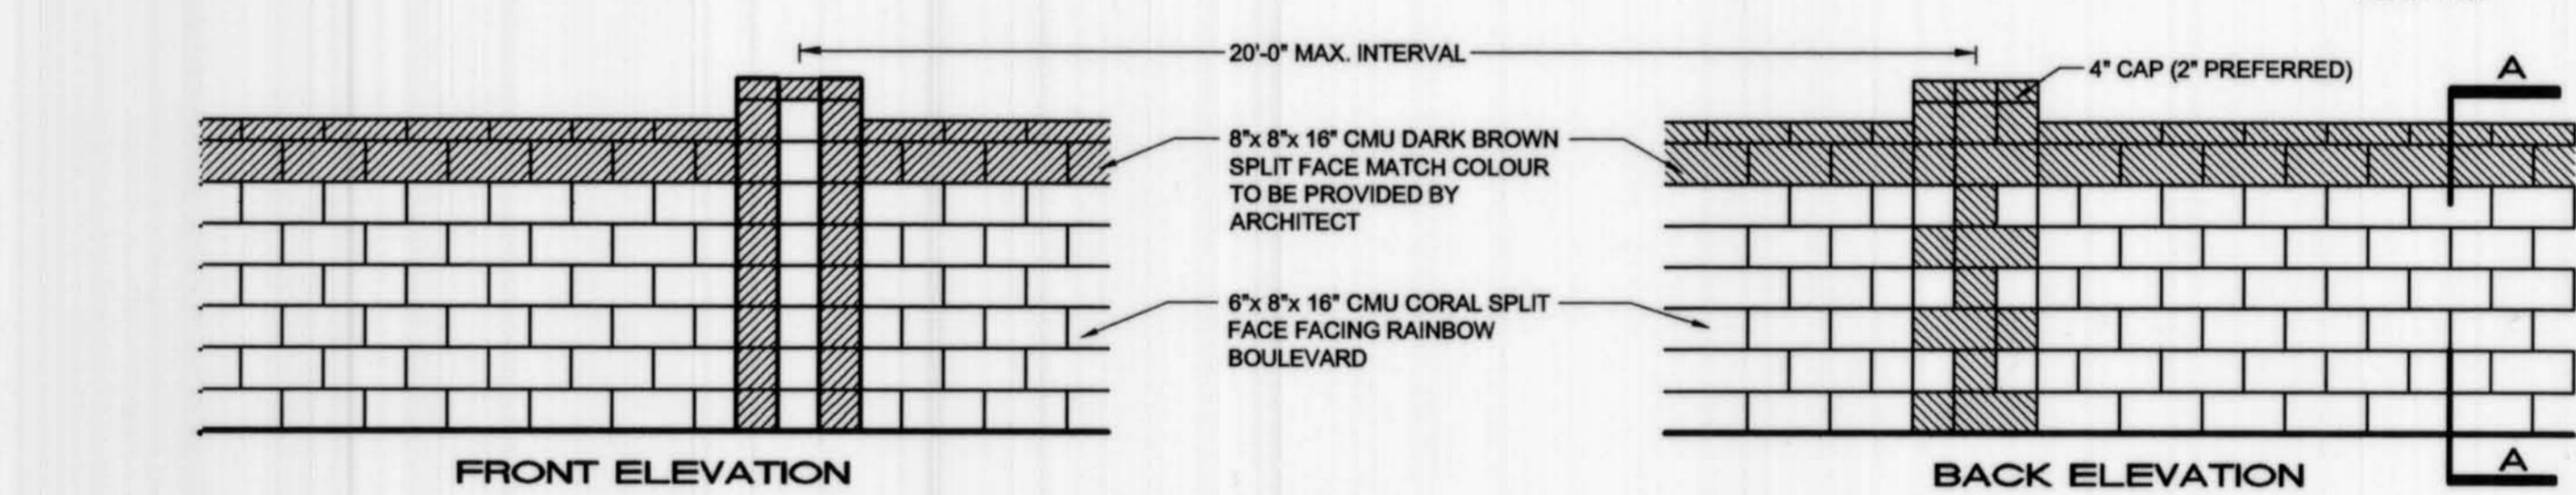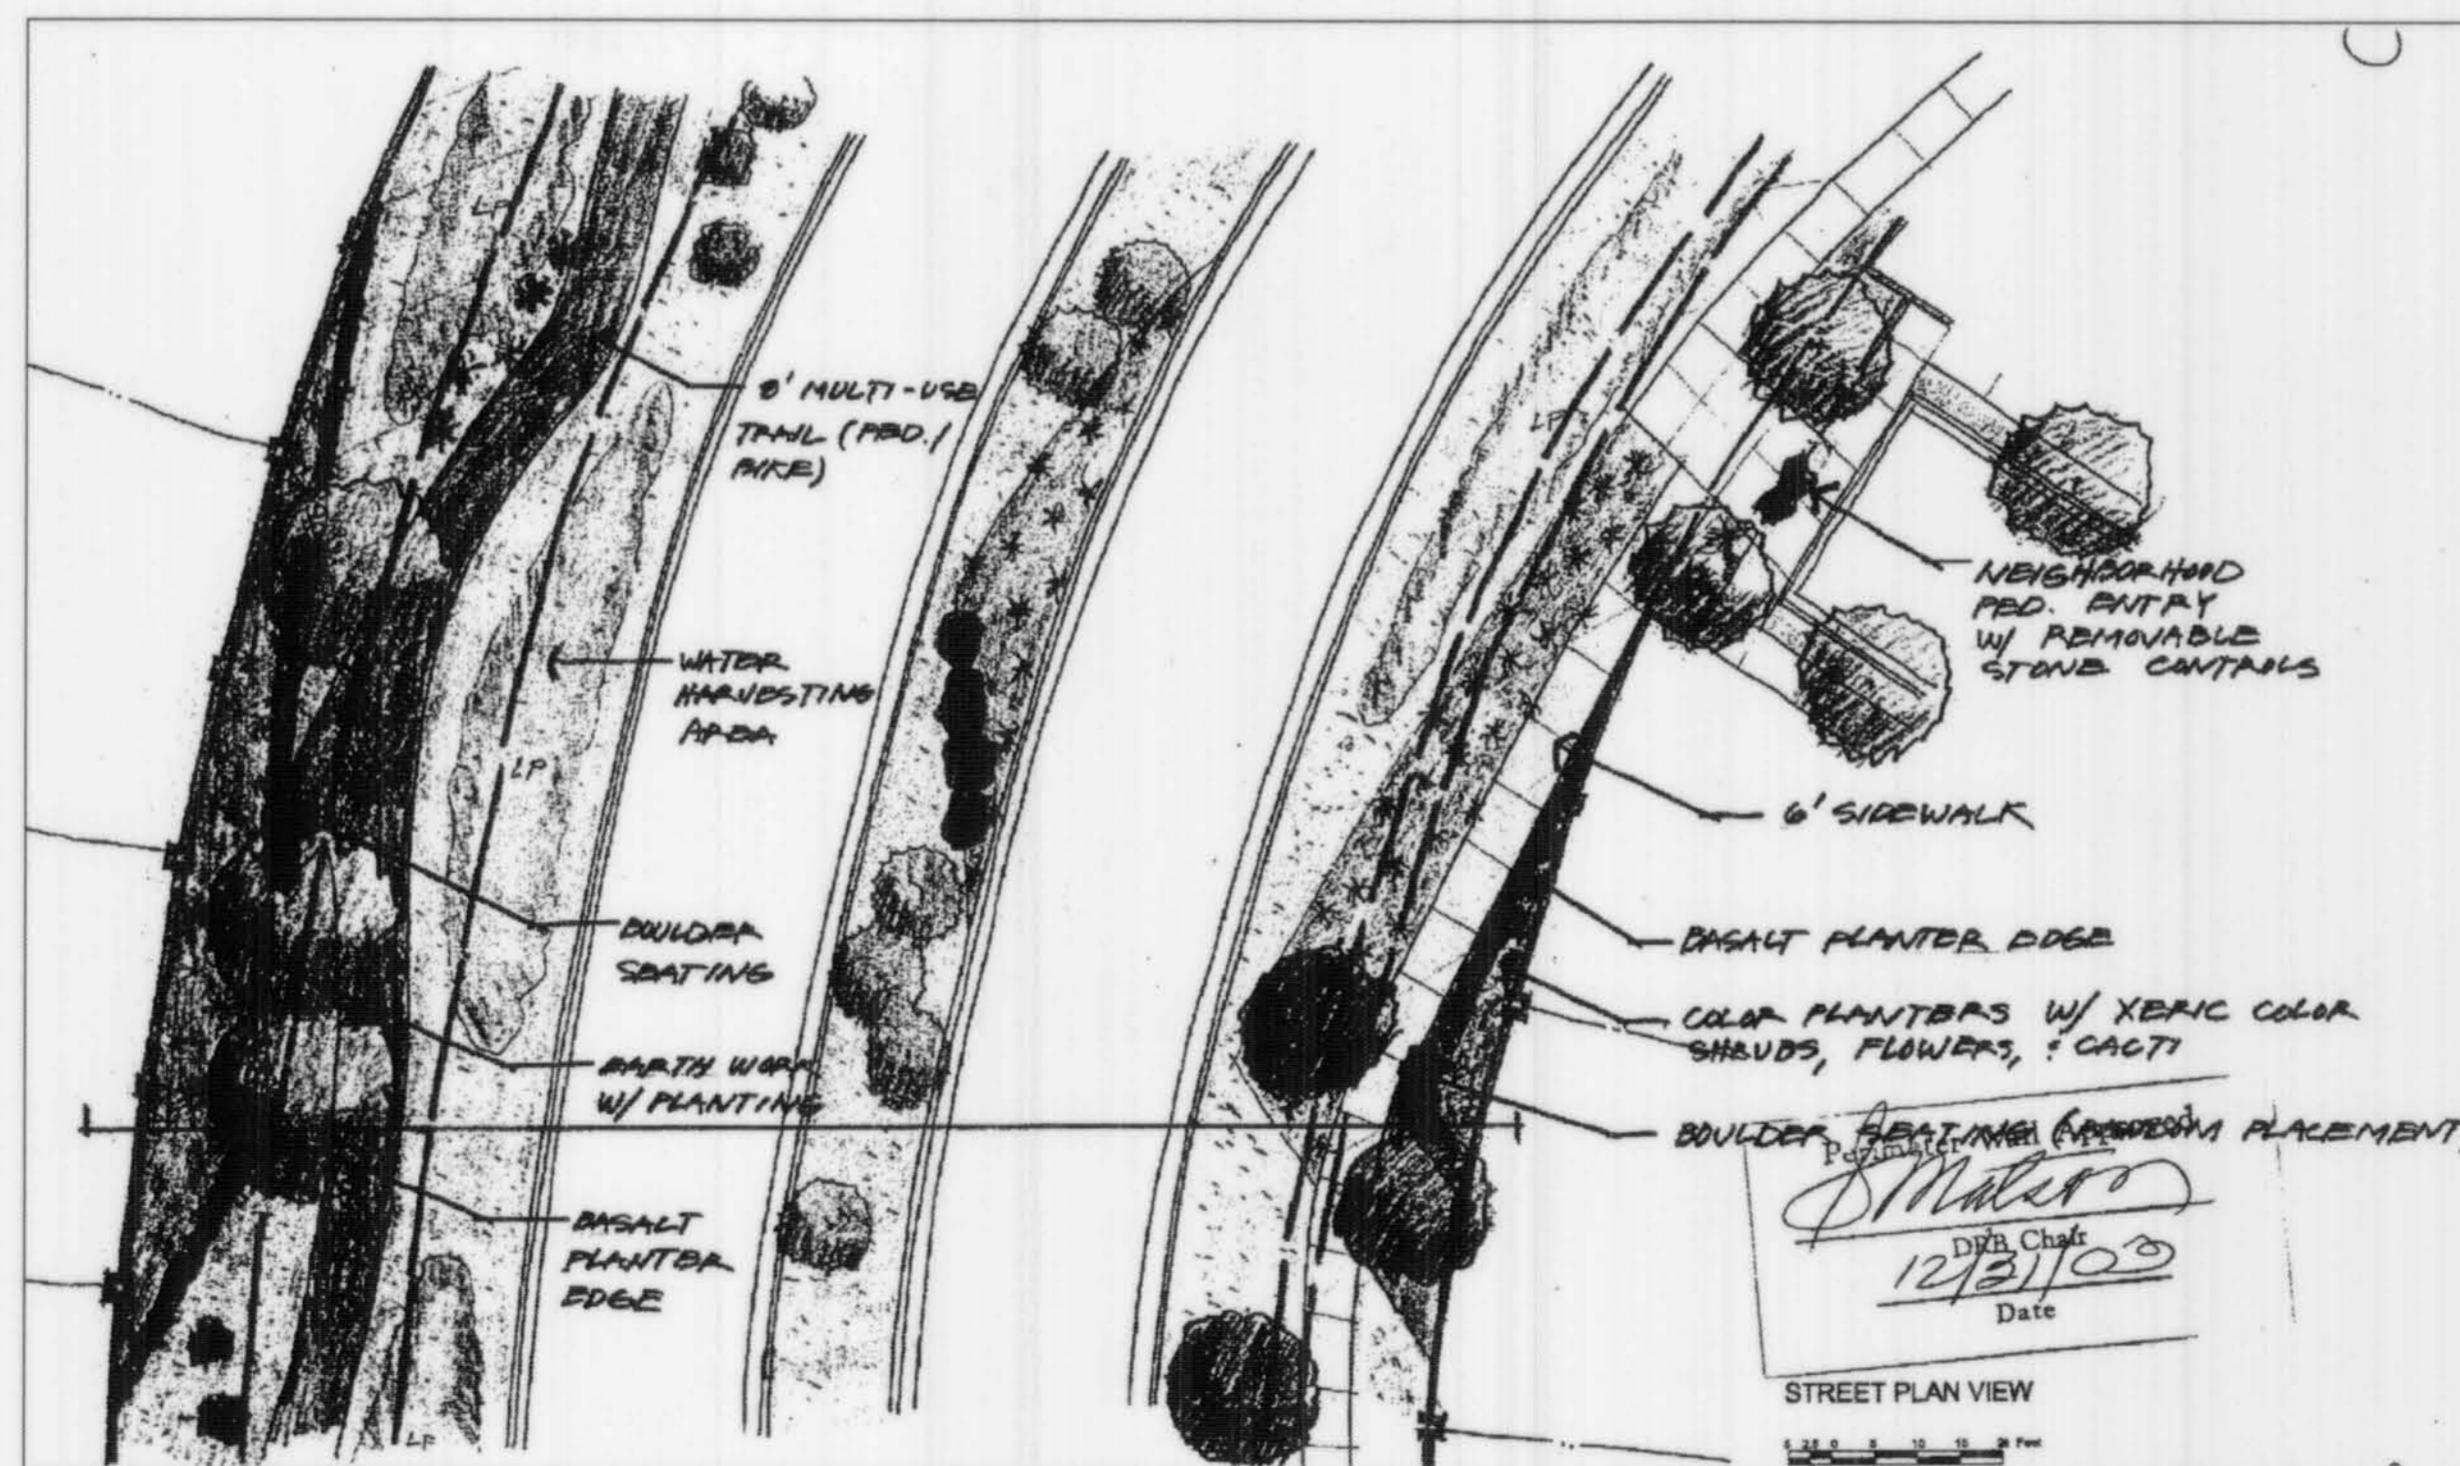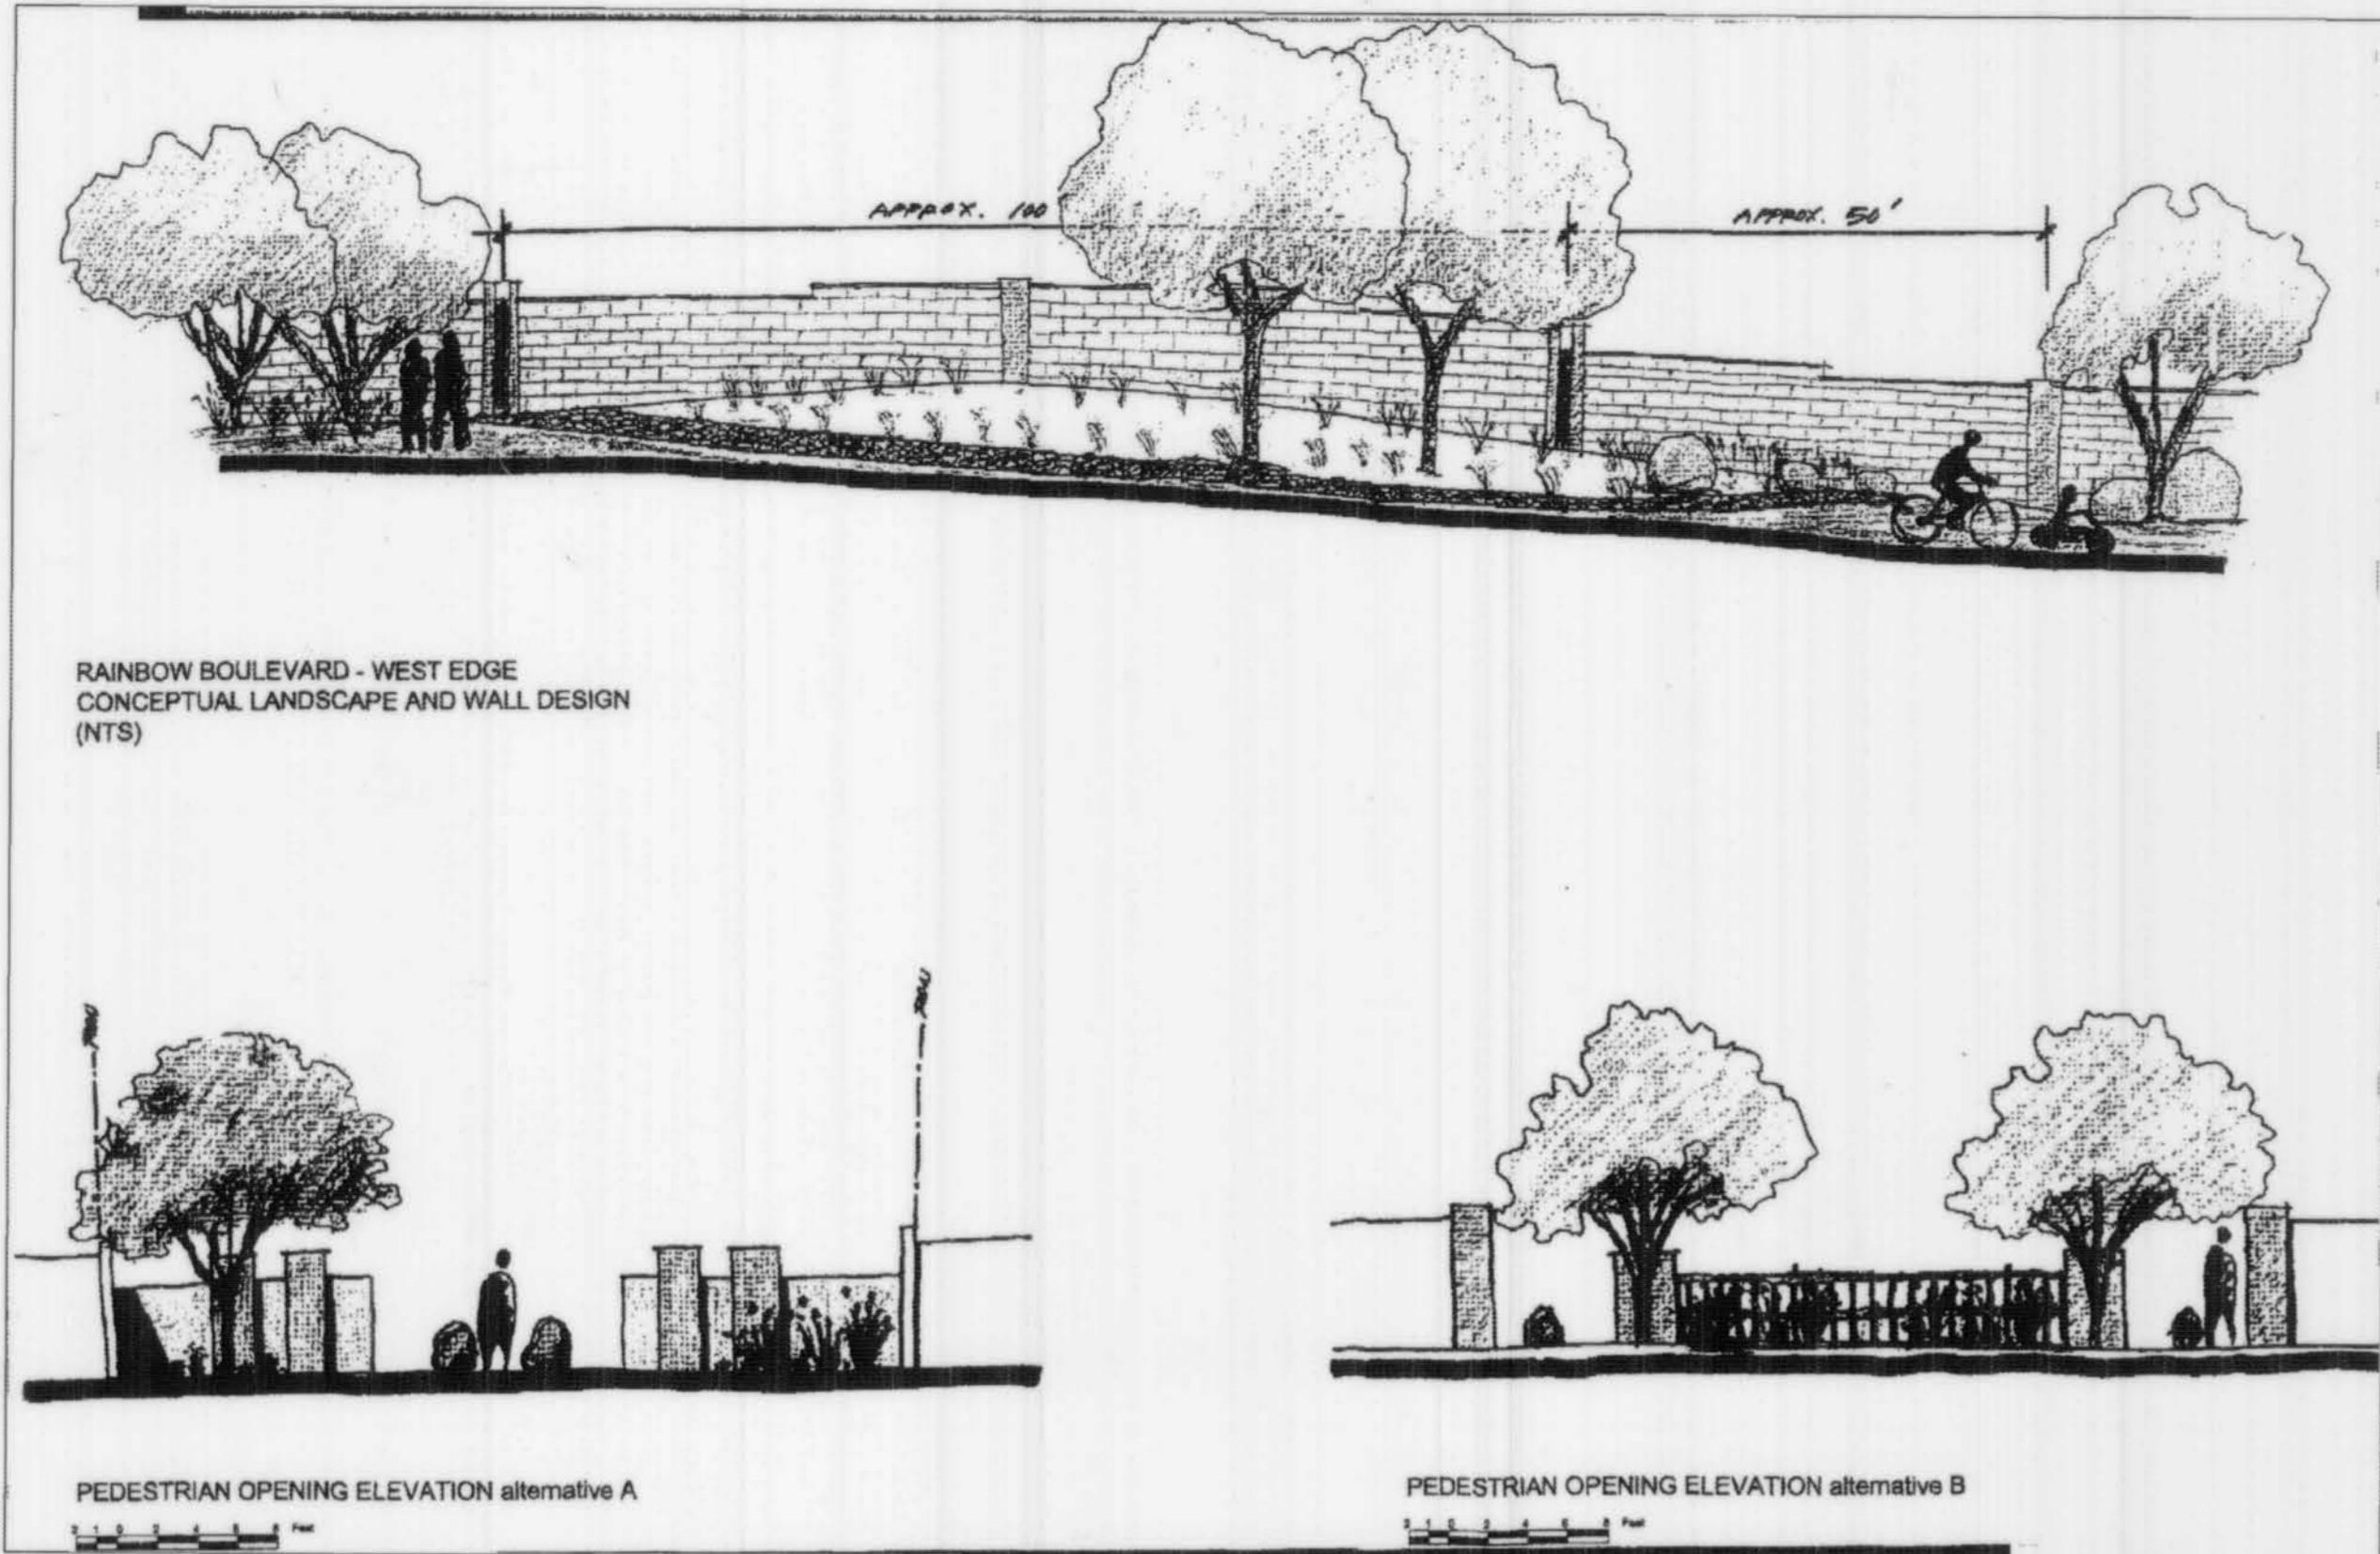

ZONE ATLAS #: C-9
NEAREST INTERSECTION:
PASEO DEL NORTE & RAINBOW
DRB PROJECT #: 1003354

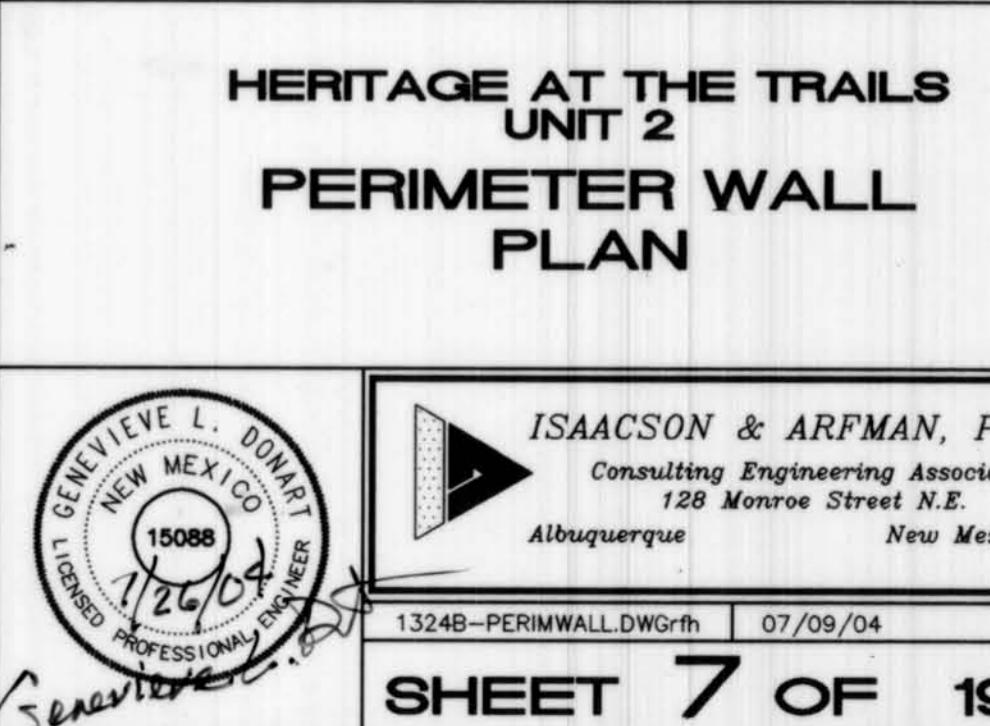

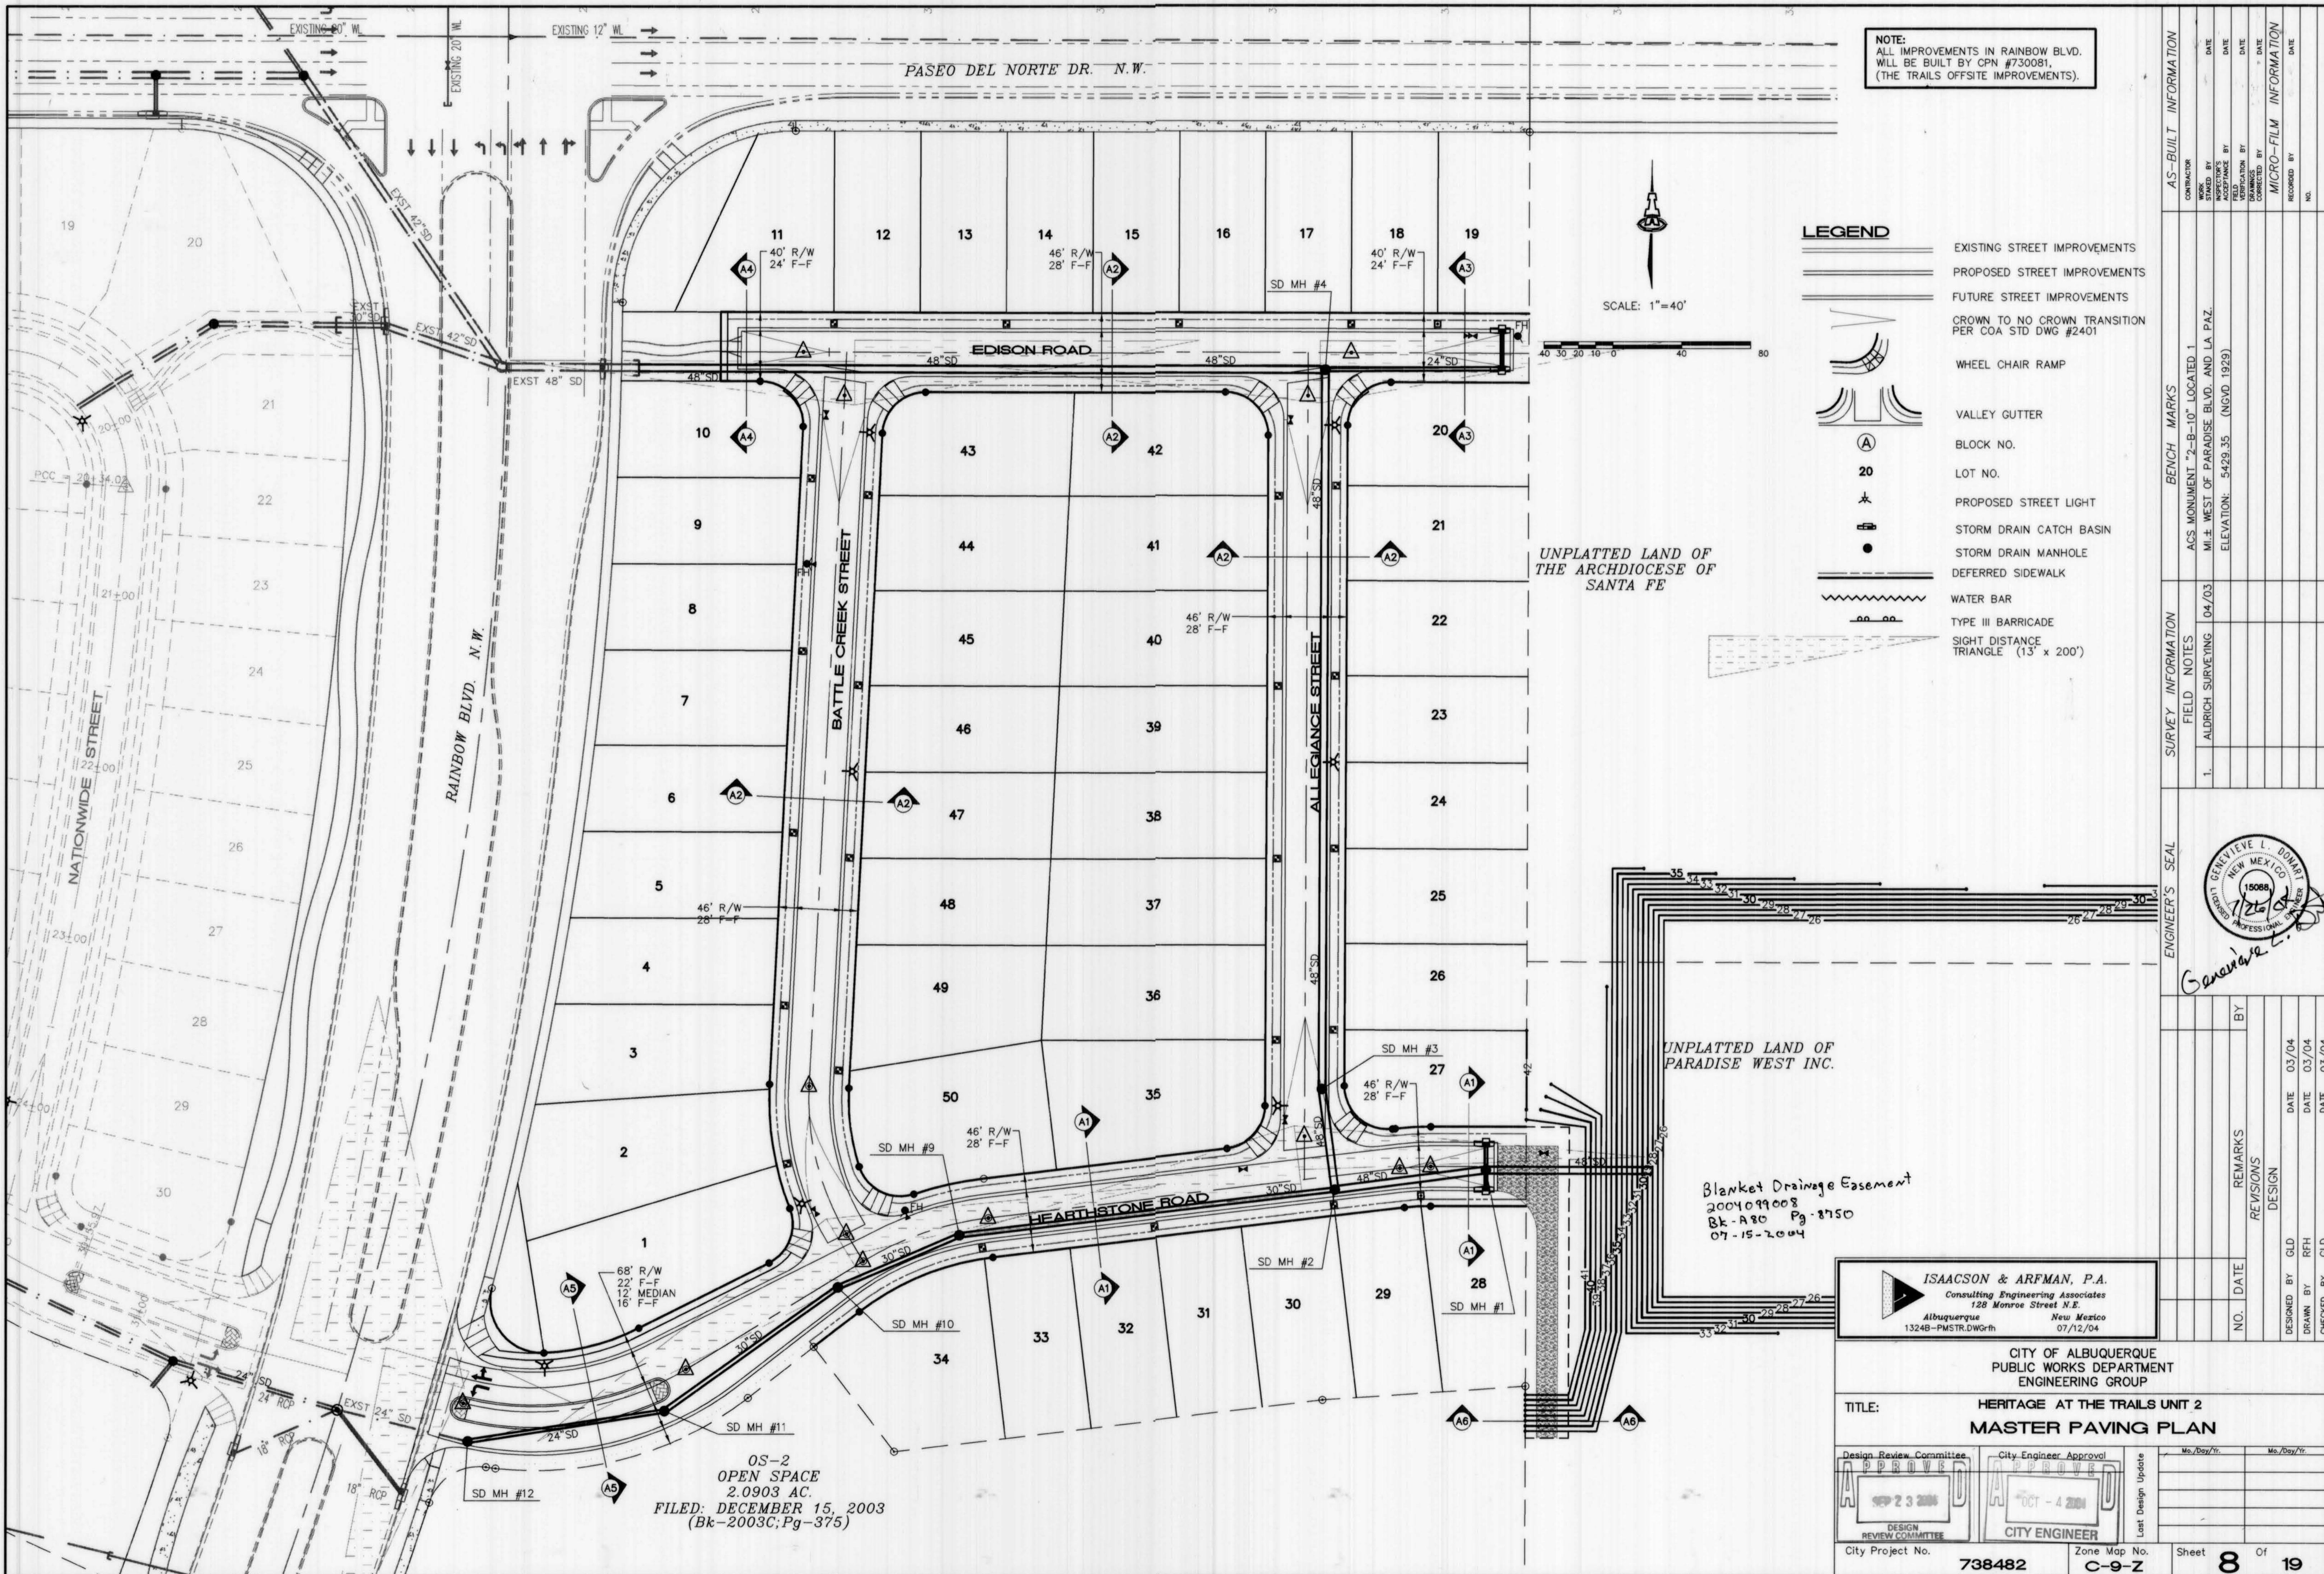

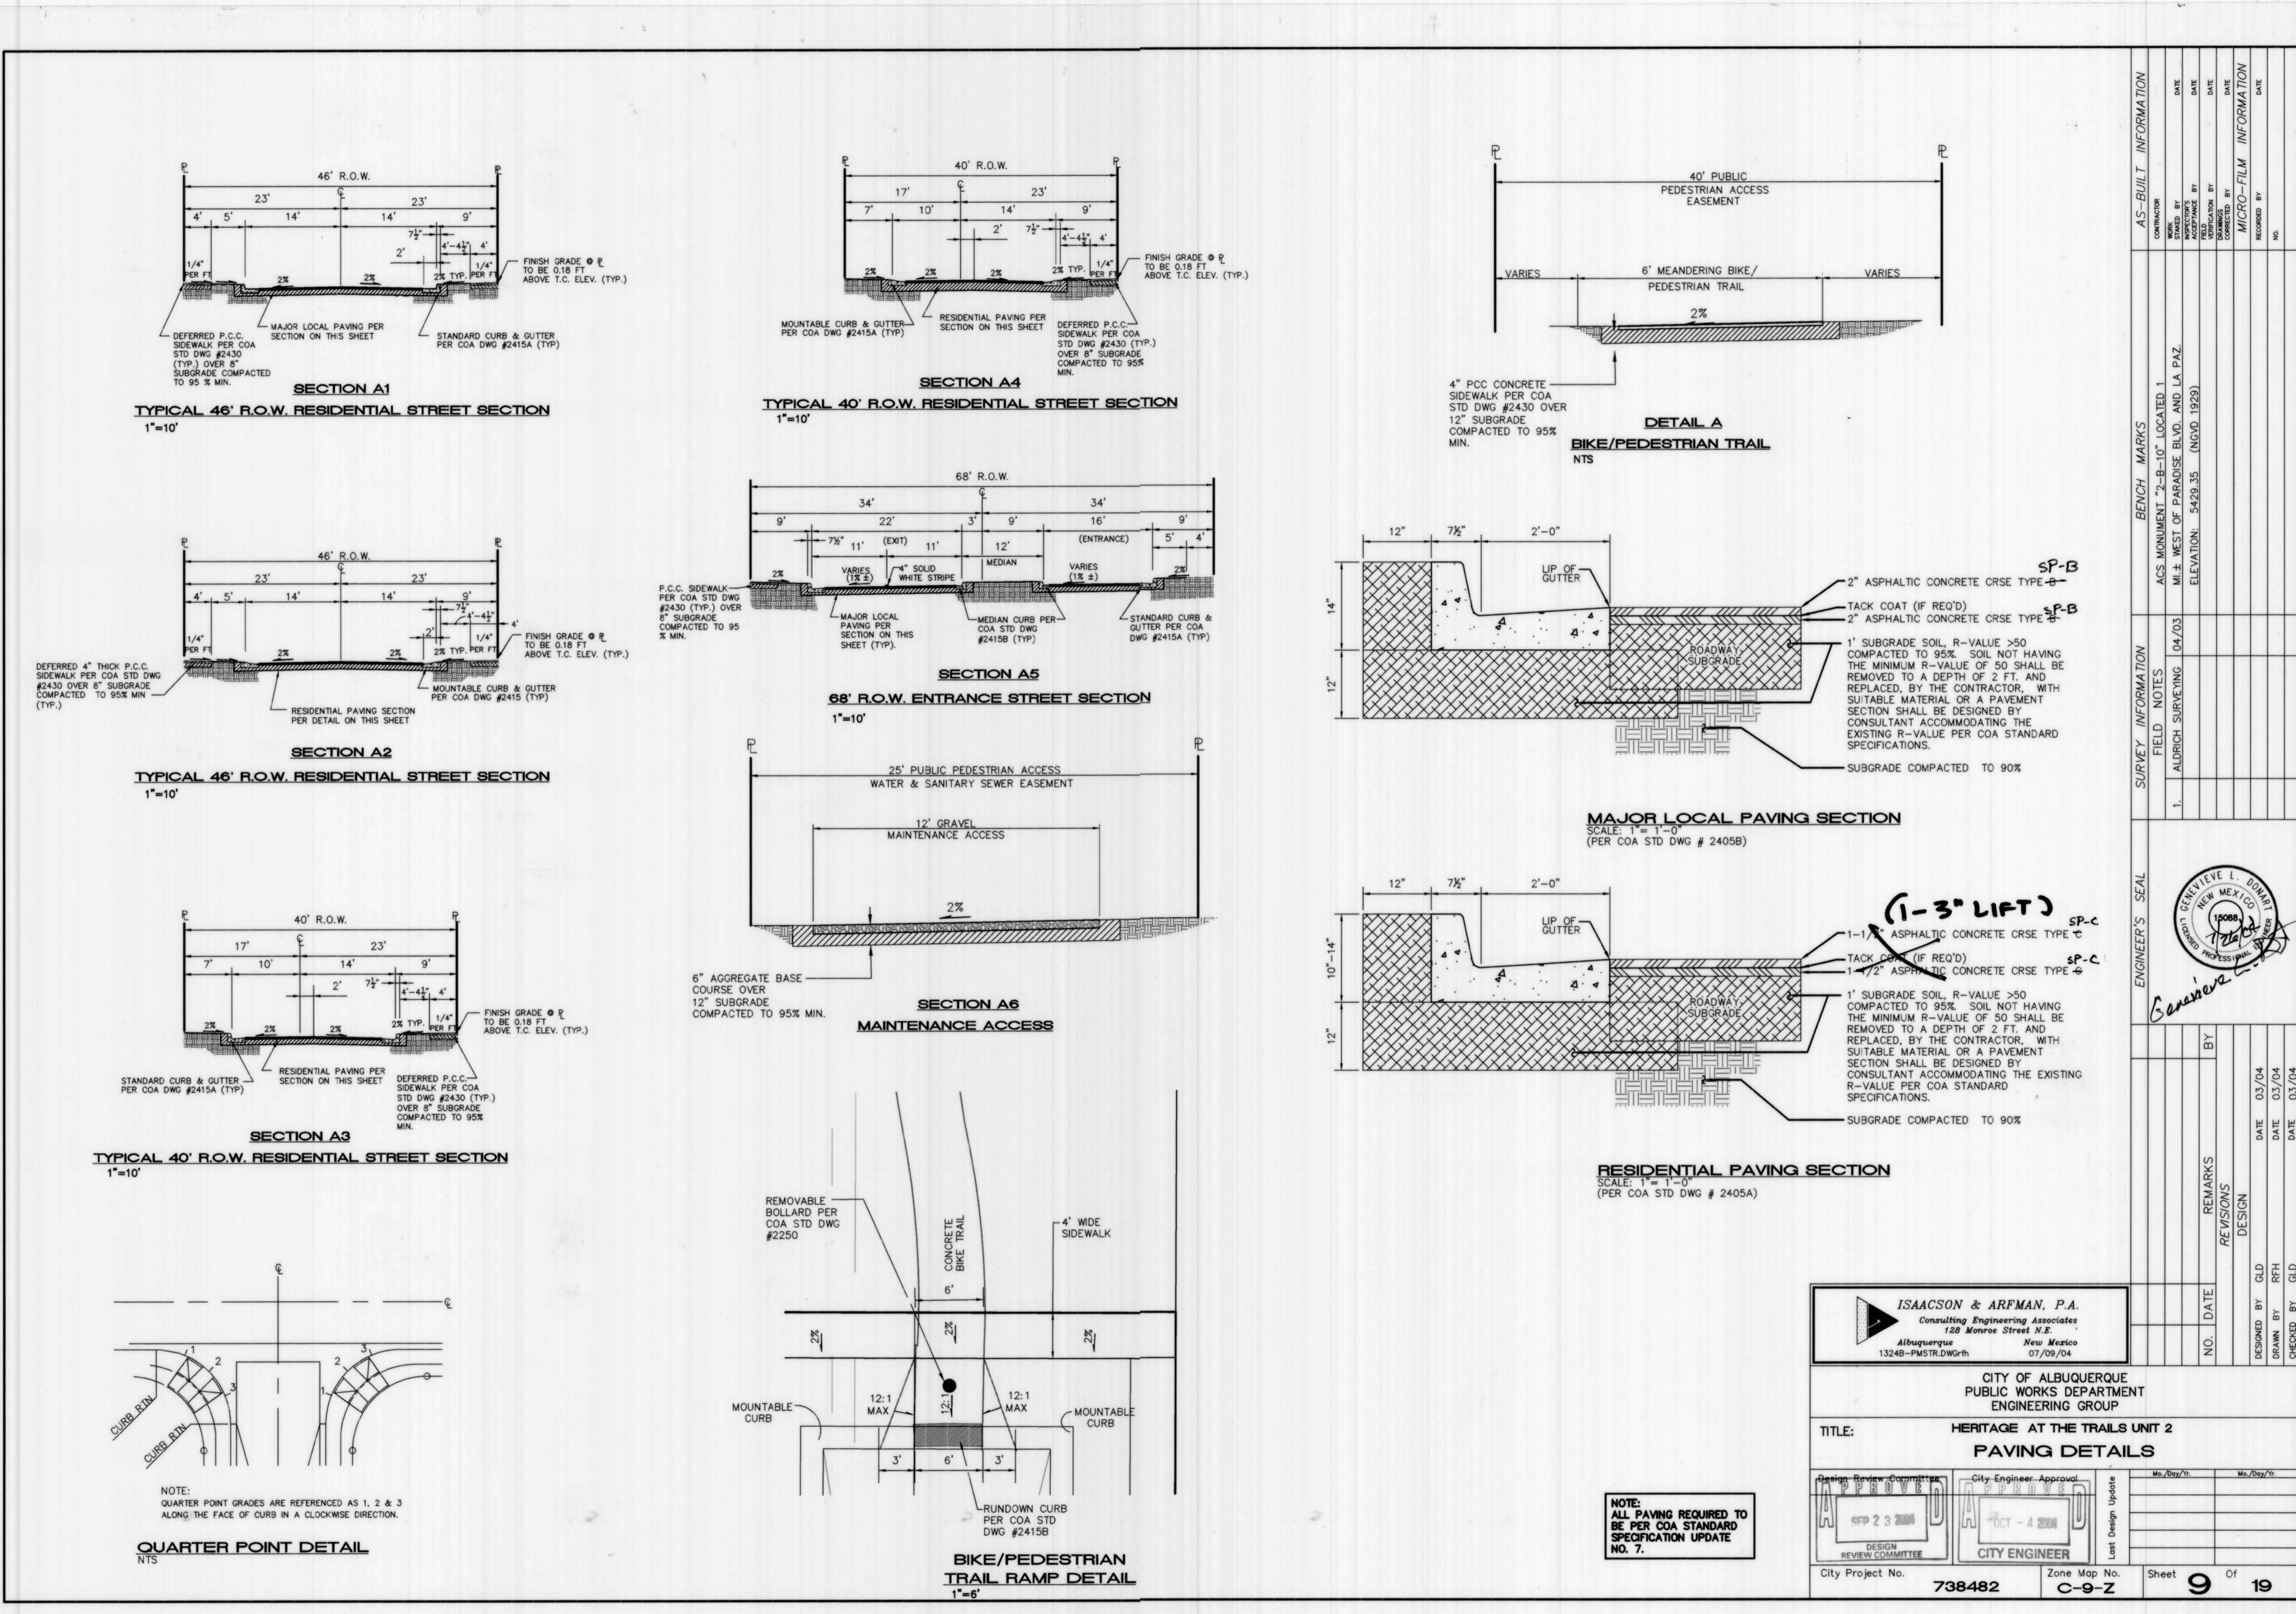

KEYED CONSTRUCTION NOTES

1. CONSTRUCT HANDICAP RAMP PER COA STD DWG #2441, CASE II WITH HEADER CURB.
2. STANDARD CURB & GUTTER PER COA STD DWG #2415A.
3. CONSTRUCT PCC VALLEY GUTTER 6' WIDE, 1 1/2" INVERT PER COA STD DWG #2420.
4. CROWN TO NO CROWN TRANSITION 50' MIN. LENGTH PER COA STD DWG #2401.
5. TRANSITION FROM MOUNTABLE TO STANDARD CURB PER COA STD DWG #2418.
6. MOUNTABLE CURB & GUTTER PER COA STD DWG #2415A.
7. MEDIAN CURB & GUTTER PER COA STD DWG #2415B.
8. DEFERRED 4' WIDE PCC SIDEWALK PER COA STD DWG #2430.
9. CONSTRUCT 4' WIDE PCC SIDEWALK PER COA STD DWG #2430.
10. 6' WIDE CONCRETE BIKE TRAIL PER DETAIL SHEET #9.
11. PCC PATTERNED CONCRETE PER COA STD DWG #2408 TO 10' FROM MEDIAN NOSE.
12. REMOVE EXIST SIDEWALK AS NEEDED, MATCH SIDEWALK TO BACK OF PROPOSED WHEELCHAIR RAMPS.
13. CONSTRUCT HANDICAP RAMP PER COA STD DWG #2426.
14. PAINT MEDIAN CURB AT NOSE WITH REFLECTIVE YELLOW PAINT.
15. CONSTRUCT RAMP PER BIKE/PEDESTRIAN RAMP DETAIL ON SHEET 9.
16. THERMOPLASTIC MARKING - LEFT ONLY ARROW.
17. THERMOPLASTIC MARKING - THROUGH & RIGHT ARROW.
18. THERMOPLASTIC MARKING - SOLID WHITE STRIPE.
19. CAREFULLY REMOVE 108.58 LF OF EXISTING CURB & GUTTER.
20. 10 LF MOUNTABLE CURB PER COA STD DWG #2415A. CENTERED ON THE R.O.W. CENTERLINE.

AS-BUILT INFORMATION		CONTRACTOR WORK PERFORMED BY SURV TEK DATE
FIELD NOTES	BENCH MARKS	
1. ALDRICH SURVEYING 04/03	ACS MONUMENT "2-B-10" LOCATED 1 M.I. WEST OF PARADISE BLVD. AND LA PAZ. ELEVATION: 5429.35 (NGVD 1929)	



STORM DRAIN INLET INFORMATION				
INLET NO. ◇	INLET TYPE	STATION* & OFFSET	TOP GR. EL.	INV. OUT
1	TYPE A	9+99.50, 14' RT	39.78 39.60	32.80
2	TYPE A	9+99.50, 14' LT	39.78 39.71	36.00



* STATIONING IS TO MIDPOINT OF GRATE ◇ FACE OF CURB


CONNECTOR PIPE INFORMATION				
FROM INLET NO. ◇	Q (CFS)	DIA. (IN)	LENGTH (FT)	SLOPE (FT/FT)
1	6.40	18"	15'	0.053
2	6.40	18"	11'	0.146

ISAACSON & ARFMAN, P.A.
Consulting Engineering Associates
128 Monroe Street N.E.
New Mexico
Albuquerque
1324-PVIDWGrlf
07/26/04

NO. DATE REMARKS
DESIGN BY GLD
DRAWN BY RFH
CHECKED BY GLD
DATE 03/04
DATE 03/04
DATE 03/04


CITY OF ALBUQUERQUE PUBLIC WORKS DEPARTMENT ENGINEERING GROUP				
TITLE: HERITAGE AT THE TRAILS UNIT 2 HEARTHSTONE ROAD N.W. STA 10+00.00 TO END PAVING & STORM DRAIN PLAN & PROFILE				
Design Review Committee	City Engineer Approval			
APPROVED CDP 2 3 2004 DESIGN REVIEW COMMITTEE	APPROVED OCT - 4 2004 CITY ENGINEER			
City Project No.	Zone Map No.			
738482	C-9-Z			
Last Design Update	Mo./Day/Yr.			
	Mo./Day/Yr.			

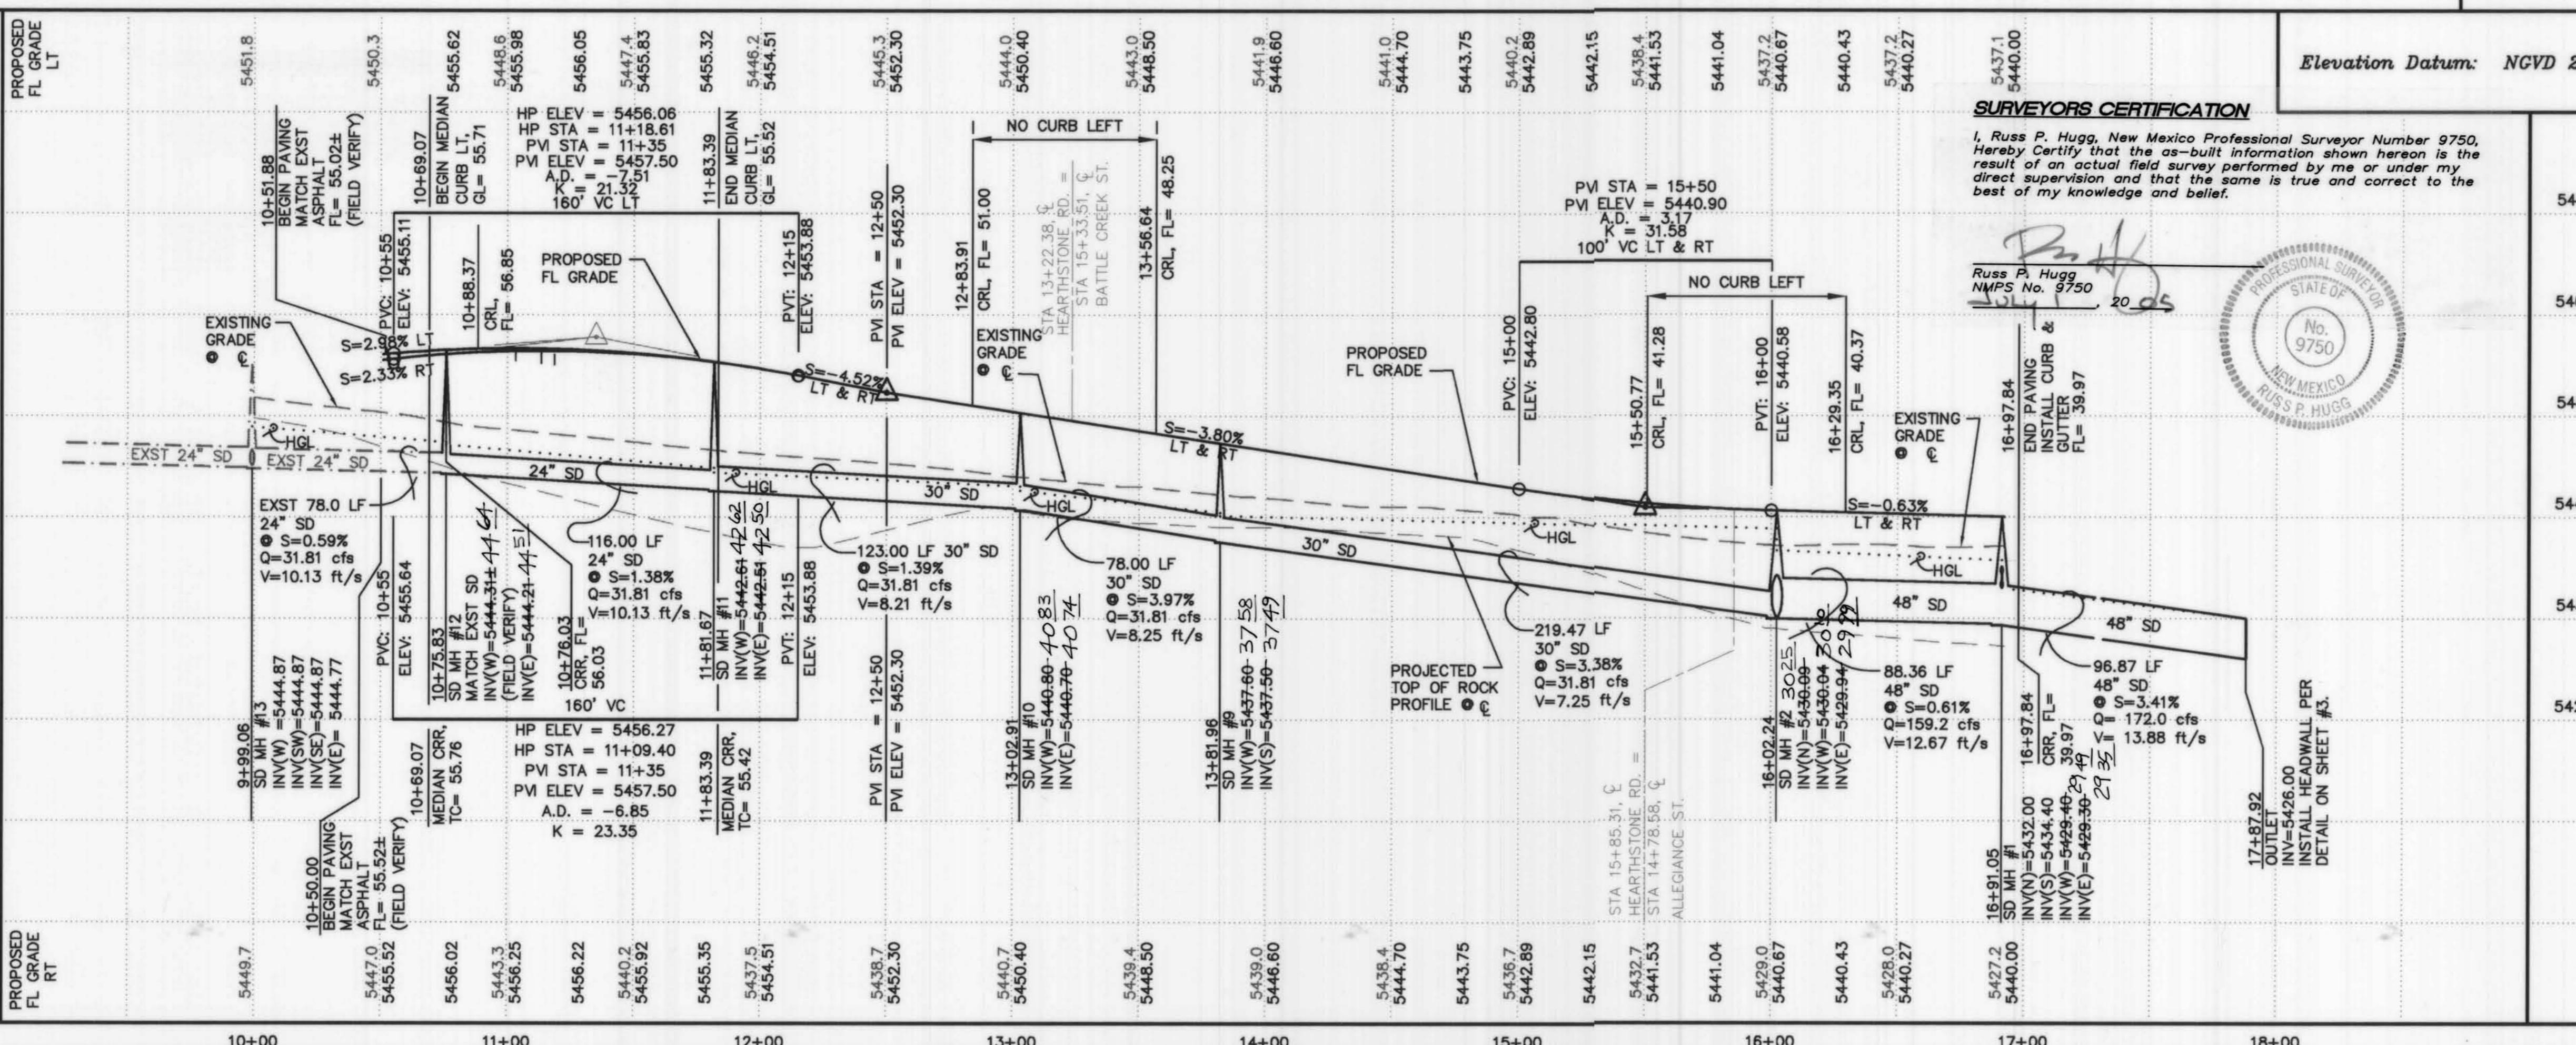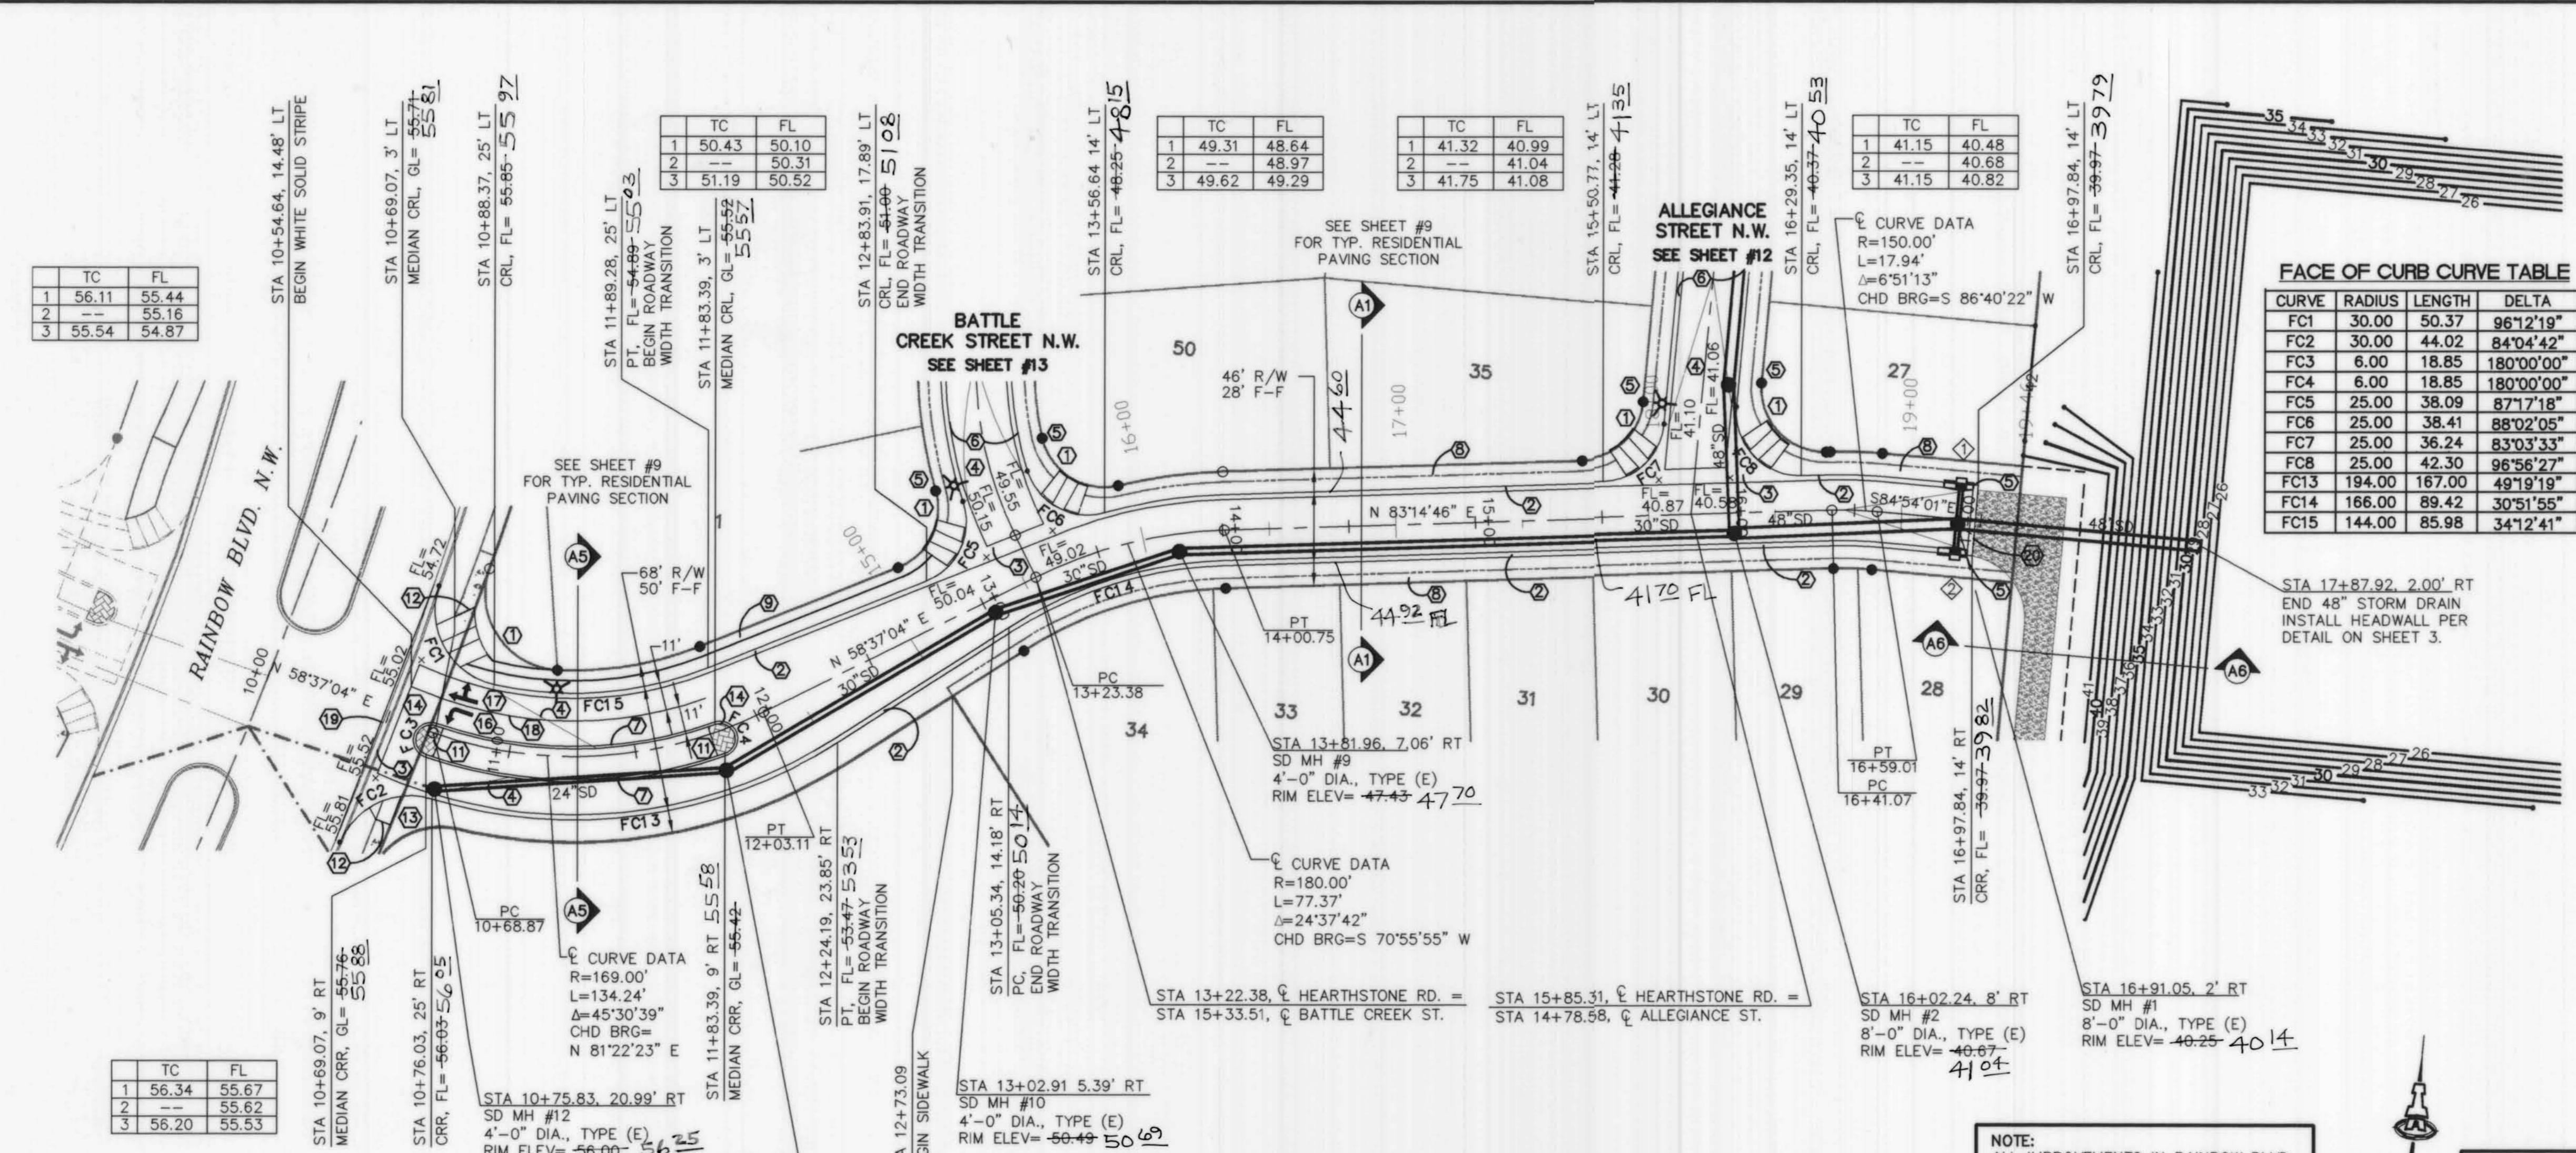

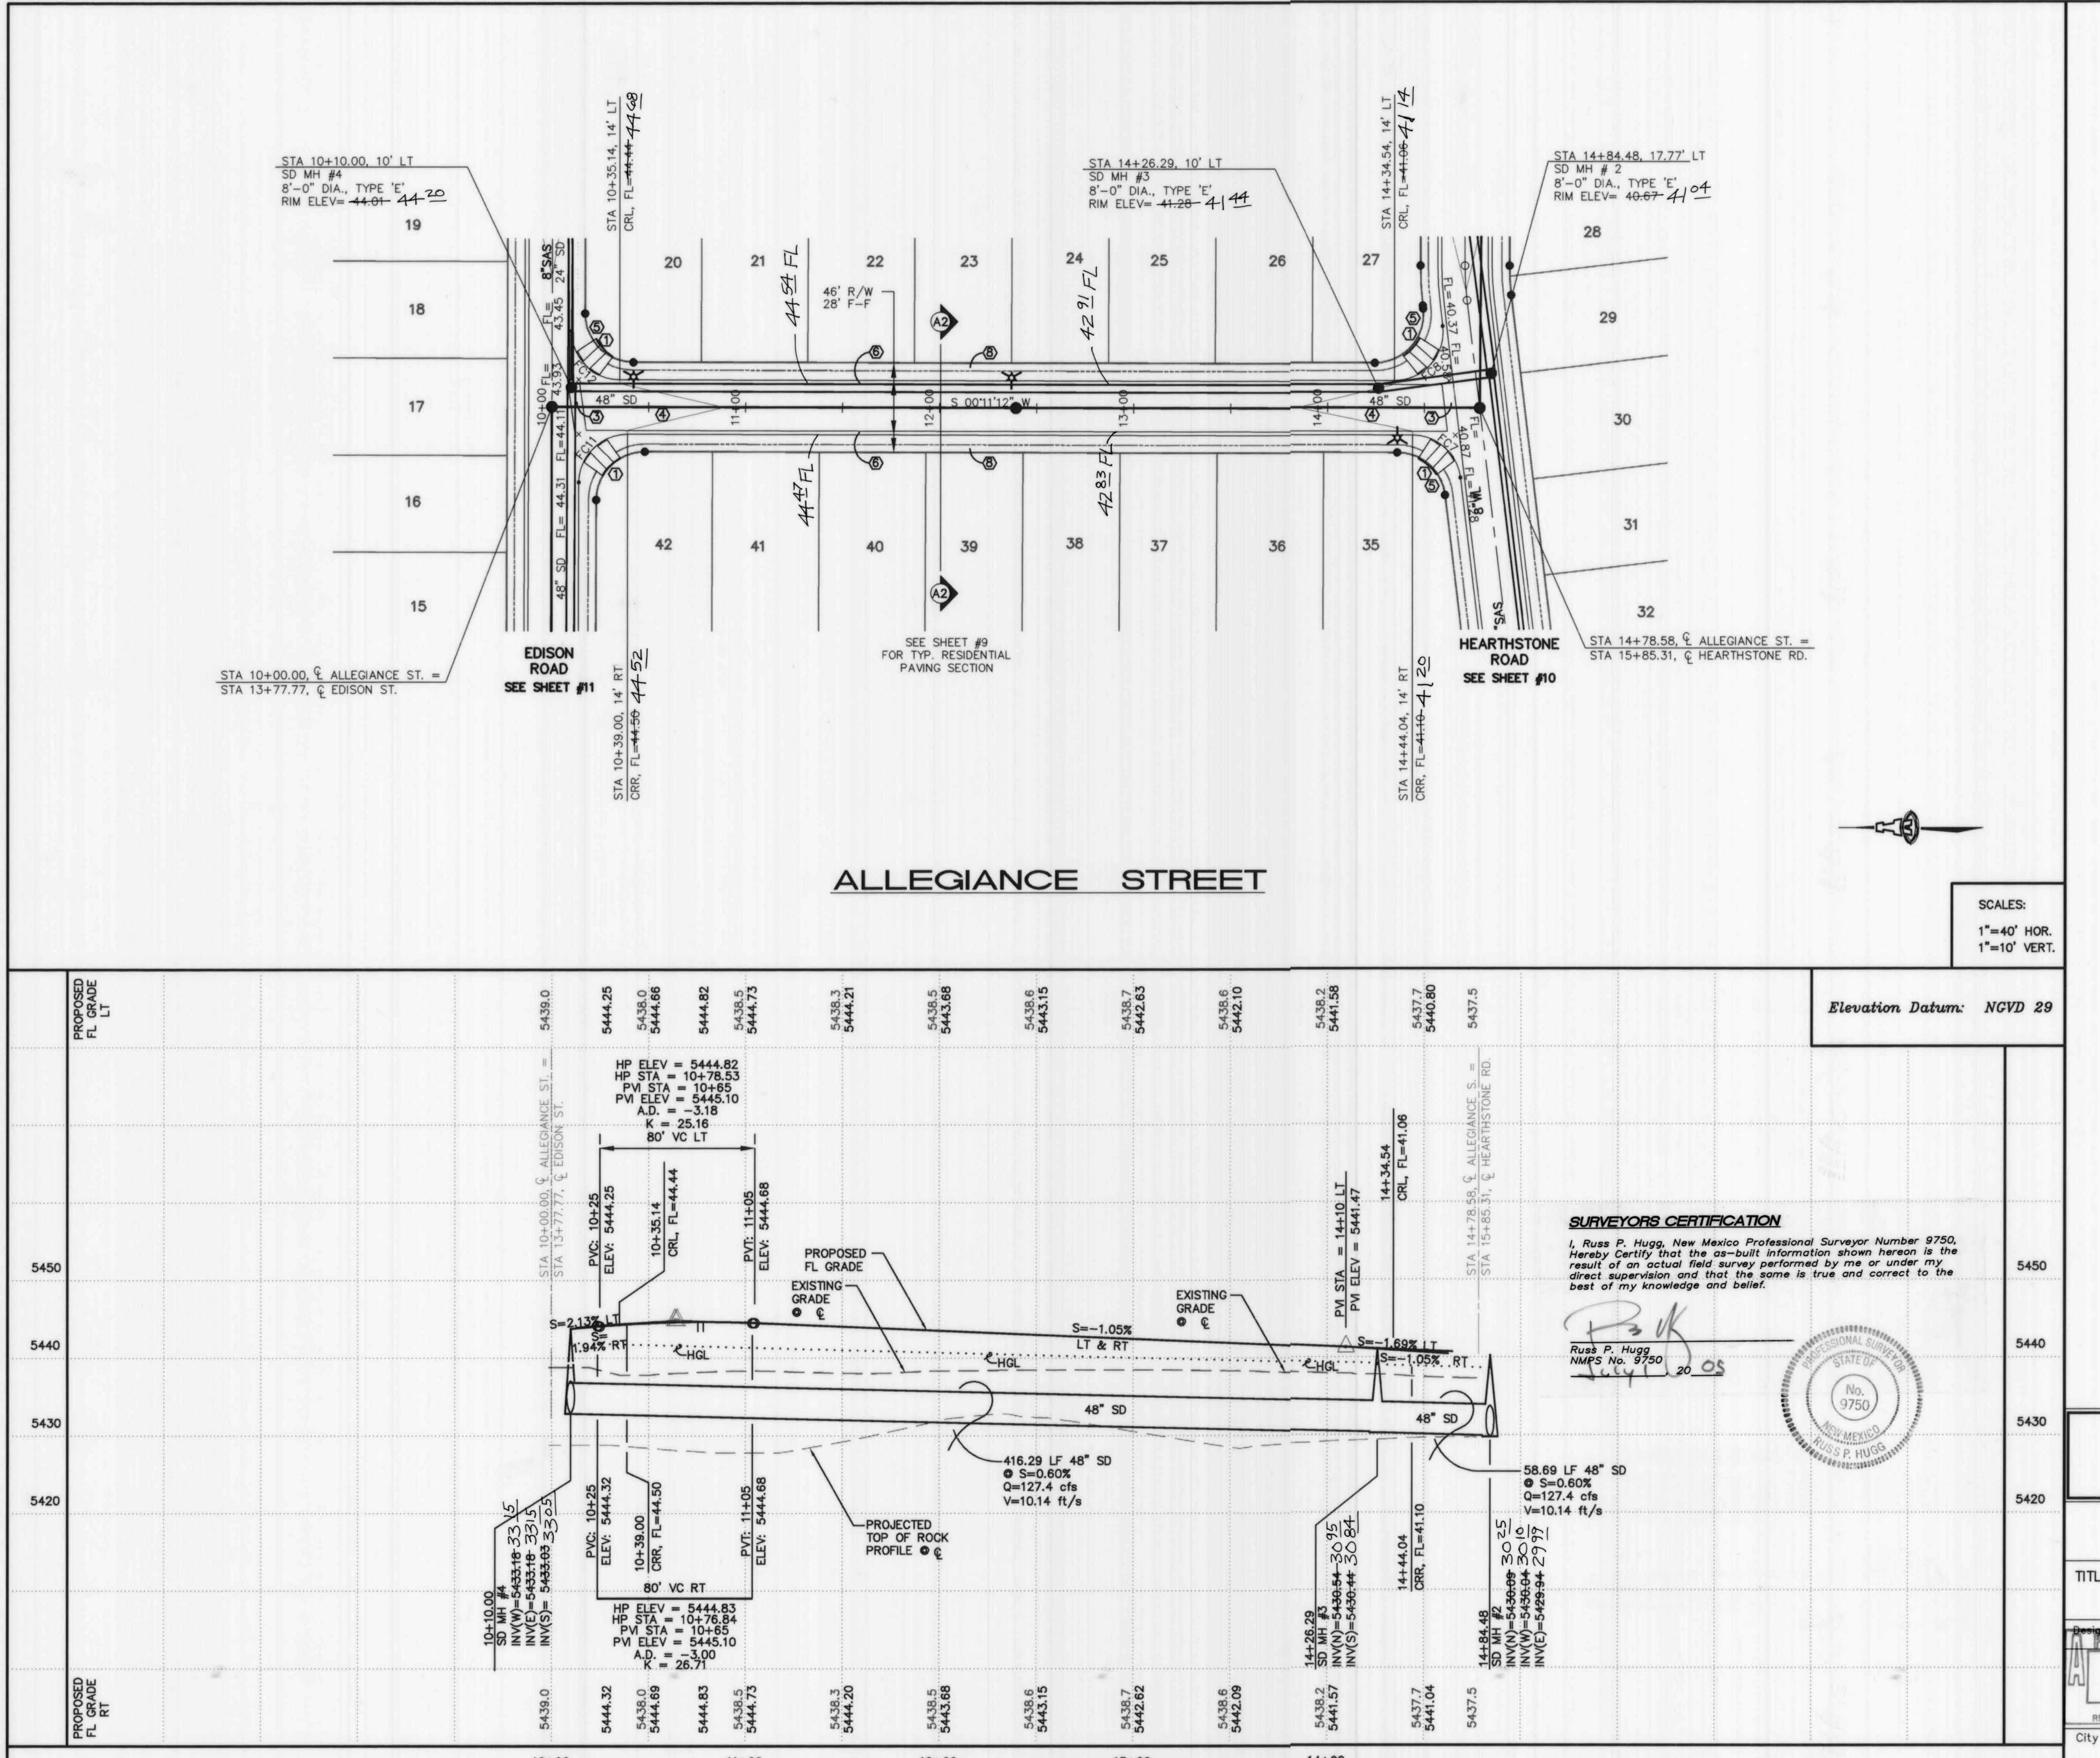


- KEYED CONSTRUCTION NOTES**
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 - STANDARD CURB & GUTTER PER COA STD DWG #2415A.
 - CONSTRUCT PCC VALLEY GUTTER 6' WIDE, 1 1/2" INVERT PER COA STD DWG #2420.
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 - MEDIAN CURB & GUTTER PER COA STD DWG #2415B.
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 - PCC PATTERNED CONCRETE PER COA STD DWG #2408 TO 10' FROM MEDIAN NOSE.
 - REMOVE EXIST SIDEWALK AS NEEDED. MATCH SIDEWALK TO BACK OF PROPOSED WHEELCHAIR RAMPS.
 - CONSTRUCT HANDICAP RAMP PER COA STD DWG #2426.
 - PAINT MEDIAN CURB AT NOSE WITH REFLECTIVE YELLOW PAINT.
 - CONSTRUCT RAMP PER BIKE/PEDESTRIAN RAMP DETAIL ON SHEET 9.
 - THERMOPLASTIC MARKING - LEFT ONLY ARROW.
 - THERMOPLASTIC MARKING - THROUGH & RIGHT ARROW.
 - THERMOPLASTIC MARKING - SOLID WHITE STRIPE.
 - CAREFULLY REMOVE 108.58 LF OF EXISTING CURB & GUTTER.
 - 10 LF MOUNTABLE CURB PER COA STD DWG #2415A. CENTERED ON THE R.O.W. CENTERLINE.

AS-BUILT INFORMATION	
CONTRACTOR	WORK STAGED BY SURVEY TEK
ACCEPTANCE BY SURVEY TEK	DATE 2/25/05
VERIFICATION BY SURVEY TEK	DATE 2/26/05
CORRECTED BY SURVEY TEK	DATE 2/26/05
MICRO-FILM INFORMATION	
RECORDED BY	NO.
AC'S MONUMENT "2-B-10" LOCATED 1 MI ± WEST OF PARADISE BLVD. AND LA PAZ. ELEVATION: 5429.35 (NGVD 1929)	

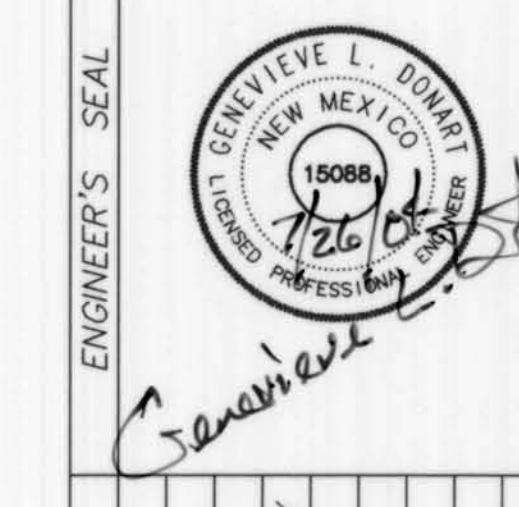

FACE OF CURB CURVE TABLE


CURVE	RADIUS	LENGTH	DELTA
FC7	25.00	36.24	83'03"33"
FC8	25.00	42.30	96'56"27"
FC11	25.00	39.27	90'00"00"
FC12	25.00	39.27	90'00"00"

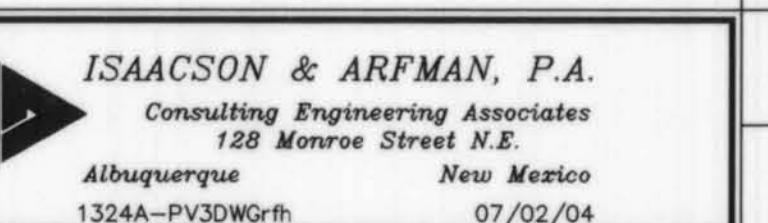

**CITY OF ALBUQUERQUE
PUBLIC WORKS DEPARTMENT
ENGINEERING GROUP**

TITLE: HERITAGE AT THE TRAILS UNIT 2
ALLEGIANCE STREET
STA 10+00.00 TO END
PAVING & STORM DRAIN PLAN & PROFILE

Design Review Committee	City Engineer Approved
APPROVED SPR 2 2004 DESIGN REVIEW COMMITTEE	APPROVED OCT - 4 2004 CITY ENGINEER
City Project No.	Zone Map No.
738482	C-9-Z
Sheet 12	Of 19

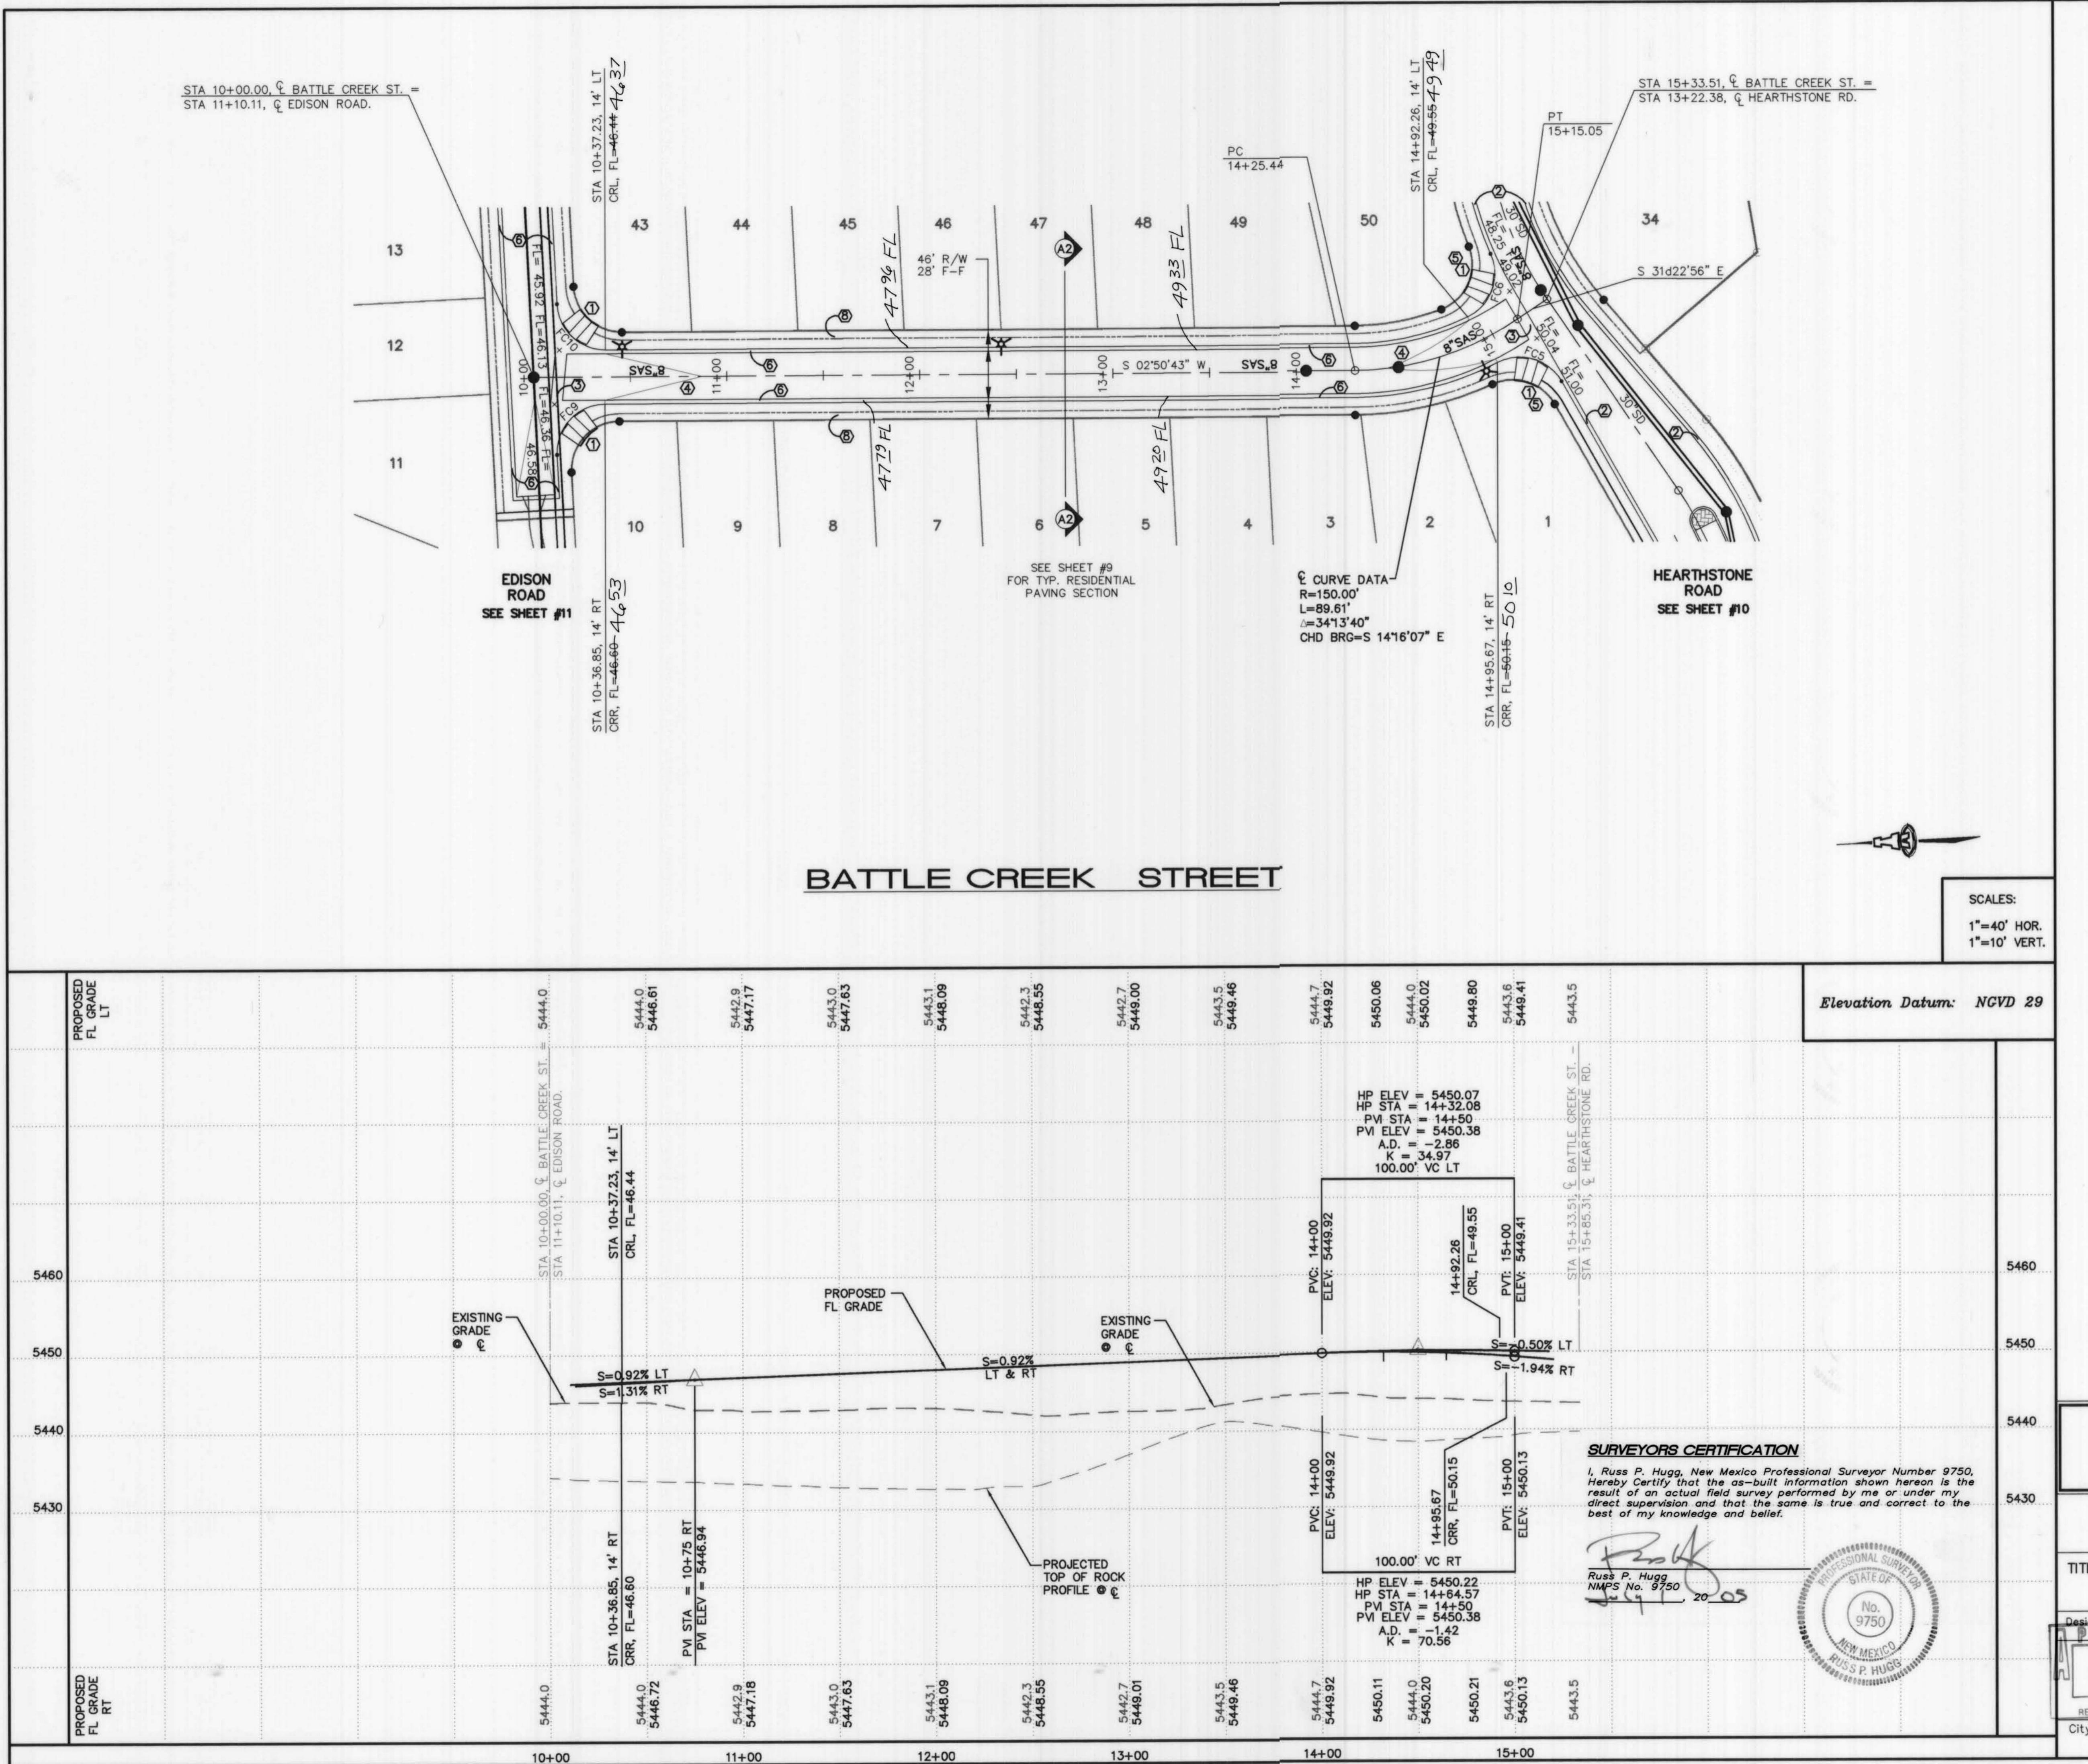


- KEYED CONSTRUCTION NOTES**
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 - STANDARD CURB & GUTTER PER COA STD DWG #2415A.
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 - 10 LF MOUNTABLE CURB PER COA STD DWG #2415A. CENTERED ON THE R.O.W. CENTERLINE.

AS-BUILT INFORMATION		SURVEY INFORMATION		BENCH MARKS	
CONTRACTOR	WORKED BY SURV TEK DATE 04/06/05	FIELD NOTES	AC'S MONUMENT "2-B-10" LOCATED 1 MI. WEST OF PARADISE BLVD. AND LA PAZ. ELEVATION: 5429.35 (NGVD 1929)	STATED AS FOLLOWS	ACCEPTANCE BY FIELD SURV TEK DATE 04/06/05



General

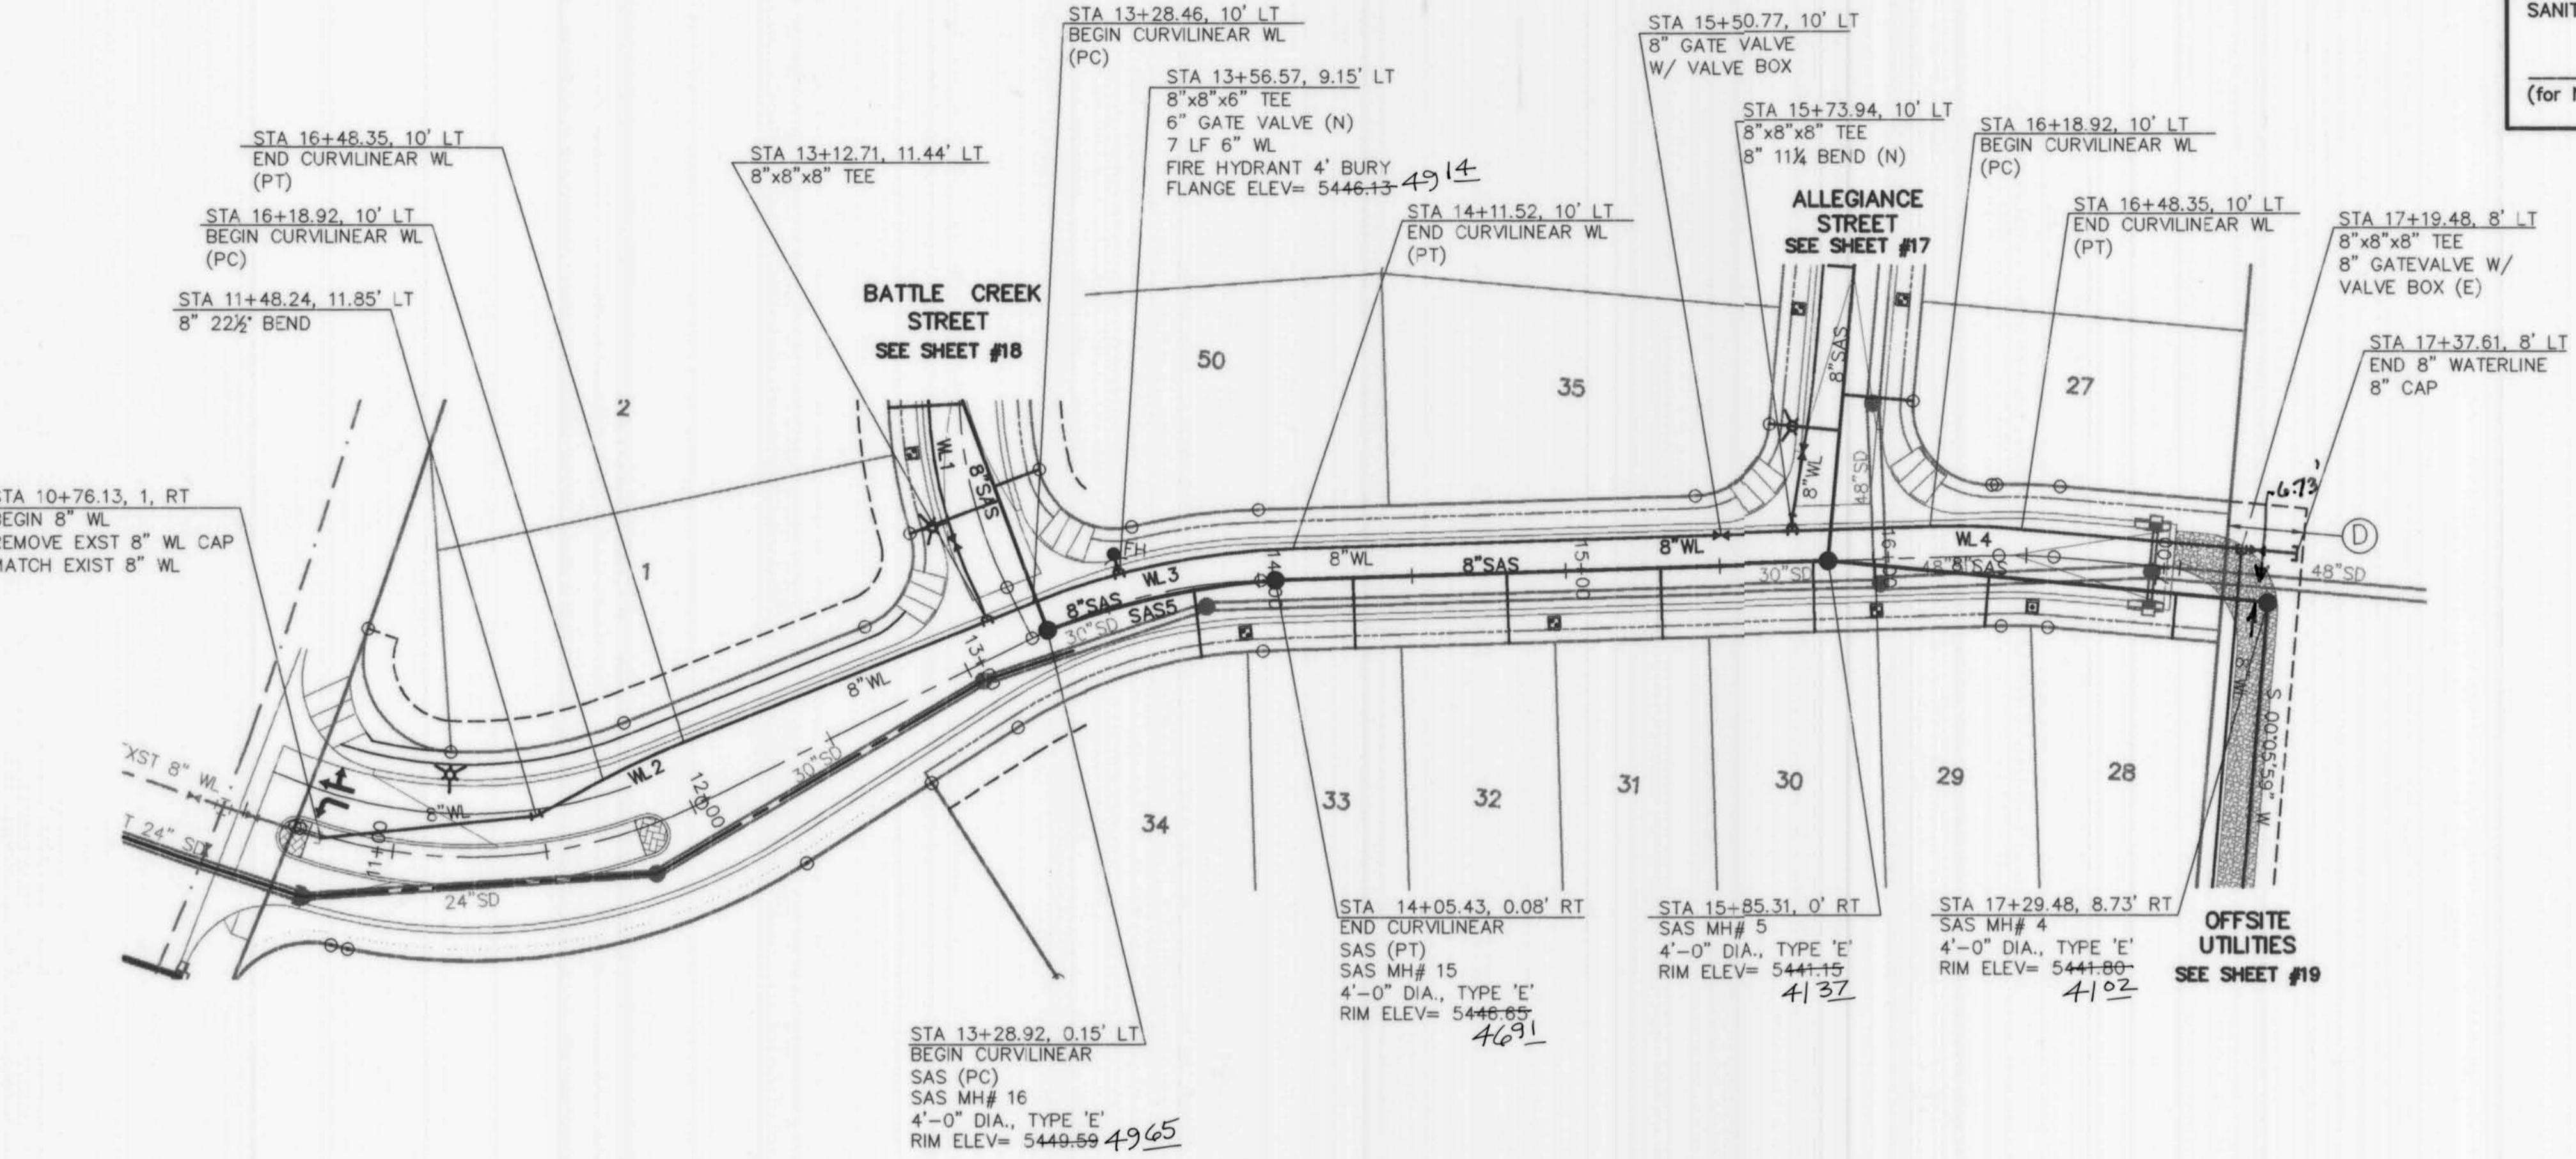

APPROVED FOR WATER AND
SANITARY SEWER CONSTRUCTION.
[Signature] 7-K-01
(for NEW MEXICO UTILITIES, INC.) DATE

GENERAL NOTES

- CONSTRUCT SAS SERVICES PER NMUI STANDARD SPECS.
- CONSTRUCT ALL SINGLE & DOUBLE WATER SERVICES PER NMUI STANDARD SPECS, EXHIBITS A, B, C, & D.
- SEE SHEET #14 FOR WATER SHUT-OFF PLAN.
- SEE SHEET #14 FOR RESTRAINED JOINT LENGTHS FOR WATER LINE FITTINGS.
- CONSTRUCT FIRE HYDRANTS PER DESIGNATED DEPTHS & LENGTHS PER COA STD DWG #2340 AND NMUI STANDARD SPECS.
- INSTALL VALVE RING & COVER PER COA STD DWG #2328 AND NMUI STANDARD SPECS.
- INSTALL A CONCRETE COLLAR AROUND ALL SAS MH RIMS AND VALVE BOXES PER NMUI STANDARD SPECS.

AS-BUILT INFORMATION
CONTRACTOR: *[Signature]*
WORK INSPECTED BY: *SURV TEK* DATE: 06/25
DRAWINGS CORRECTED BY: *SURV TEK* DATE: 06/05
MICRO-FILM INFORMATION
RECORDED BY: *[Signature]* NO.

LEGEND


- SINGLE WATER METER & BOX
- DOUBLE WATER METER & BOX
- GATE VALVE W/ VALVE BOX
- FIRE HYDRANT
- SAS MANHOLE
- WATER LINE W/ FITTING

UTILITY SERVICE TABLE

LOT NO.	STATION		SAS INV @ R/W
	FIELD	NOTES	
28	WATER, LENGTH	SAS, LENGTH	35.28*
29	16+52.48, 10'(S)	16+99.48, 16'	35.28*
30	16+00.72, 9'	16+35.66, 17'	35.69*
31	15+80.31, 23'	15+80.31, 23'	36.06*
32	15+30.72, 23'	15+30.72, 23'	37.11*
33	14+95.72, 9'	14+80.72, 23'	38.86*
34	13+94.99, 9'	14+30.72, 23'	40.76
		13+77.78, 22'	42.77

ALL WATER SERVICES ARE DOUBLE EXCEPT WHERE NOTED AS (S) SINGLE.


* INSTALL SAS SERVICE RISERS

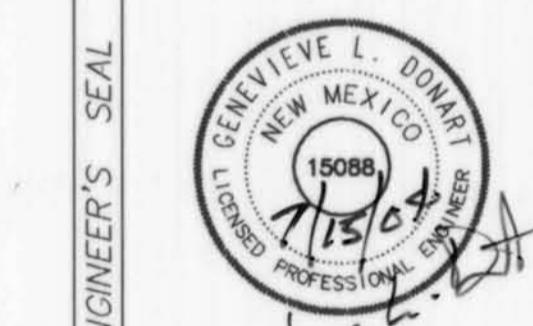


UTILITY CURVE TABLE				
CURVE	RADIUS	LENGTH	DELTA	CHD BRG
WL1	160.00	94.53	33'51"04"	S 14°04'49" E
WL2	250.00	29.11	6'40"20"	S 60°00'11" W
WL3	250.00	86.86	19'54"25"	S 73°17'33" W
WL4	250.00	29.90	6'51"13"	S 86°40'22" W
SAS5	297.69	71.55	13'46"18"	S 71°56'04" W

EASEMENT DATA

D 25' PUBLIC WATER & SANITARY SEWER EASEMENT GRANTED BY

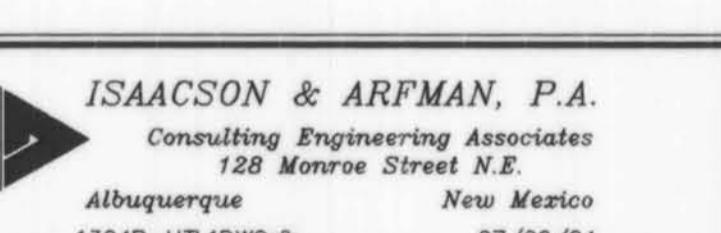

DESIGNED BY GLD	DRAWN BY RFH	DATE 03/04
DRAWN BY GLD	REVISIONS	DATE 03/04
CHECKED BY GLD	REMARKS	DATE 03/04
NO. DATE	REVISIONS	DESIGN
ISAACSON & ARFMAN, P.A. Consulting Engineering Associates 128 Monroe Street N.E. Albuquerque New Mexico 1324B-UTL1DWGrh 07/06/04		
CITY OF ALBUQUERQUE PUBLIC WORKS DEPARTMENT ENGINEERING GROUP		
TITLE: HERITAGE AT THE TRAILS UNIT 2 HEARTHSTONE TRAIL ROAD STA 10+00.00 TO END UTILITY PLAN & PROFILE		
Design-Review Committee APPROVED City Engineer Approval   Last Design Update: SEP 23 2004 Date: OCT - 4 2004 Design Review Committee APPROVED City Engineer Approval Last Design Update: SEP 23 2004 Date: OCT - 4 2004 City Project No. 738482 Zone Map No. C-9-Z Mo./Day/Yr. Mo./Day/Yr.		

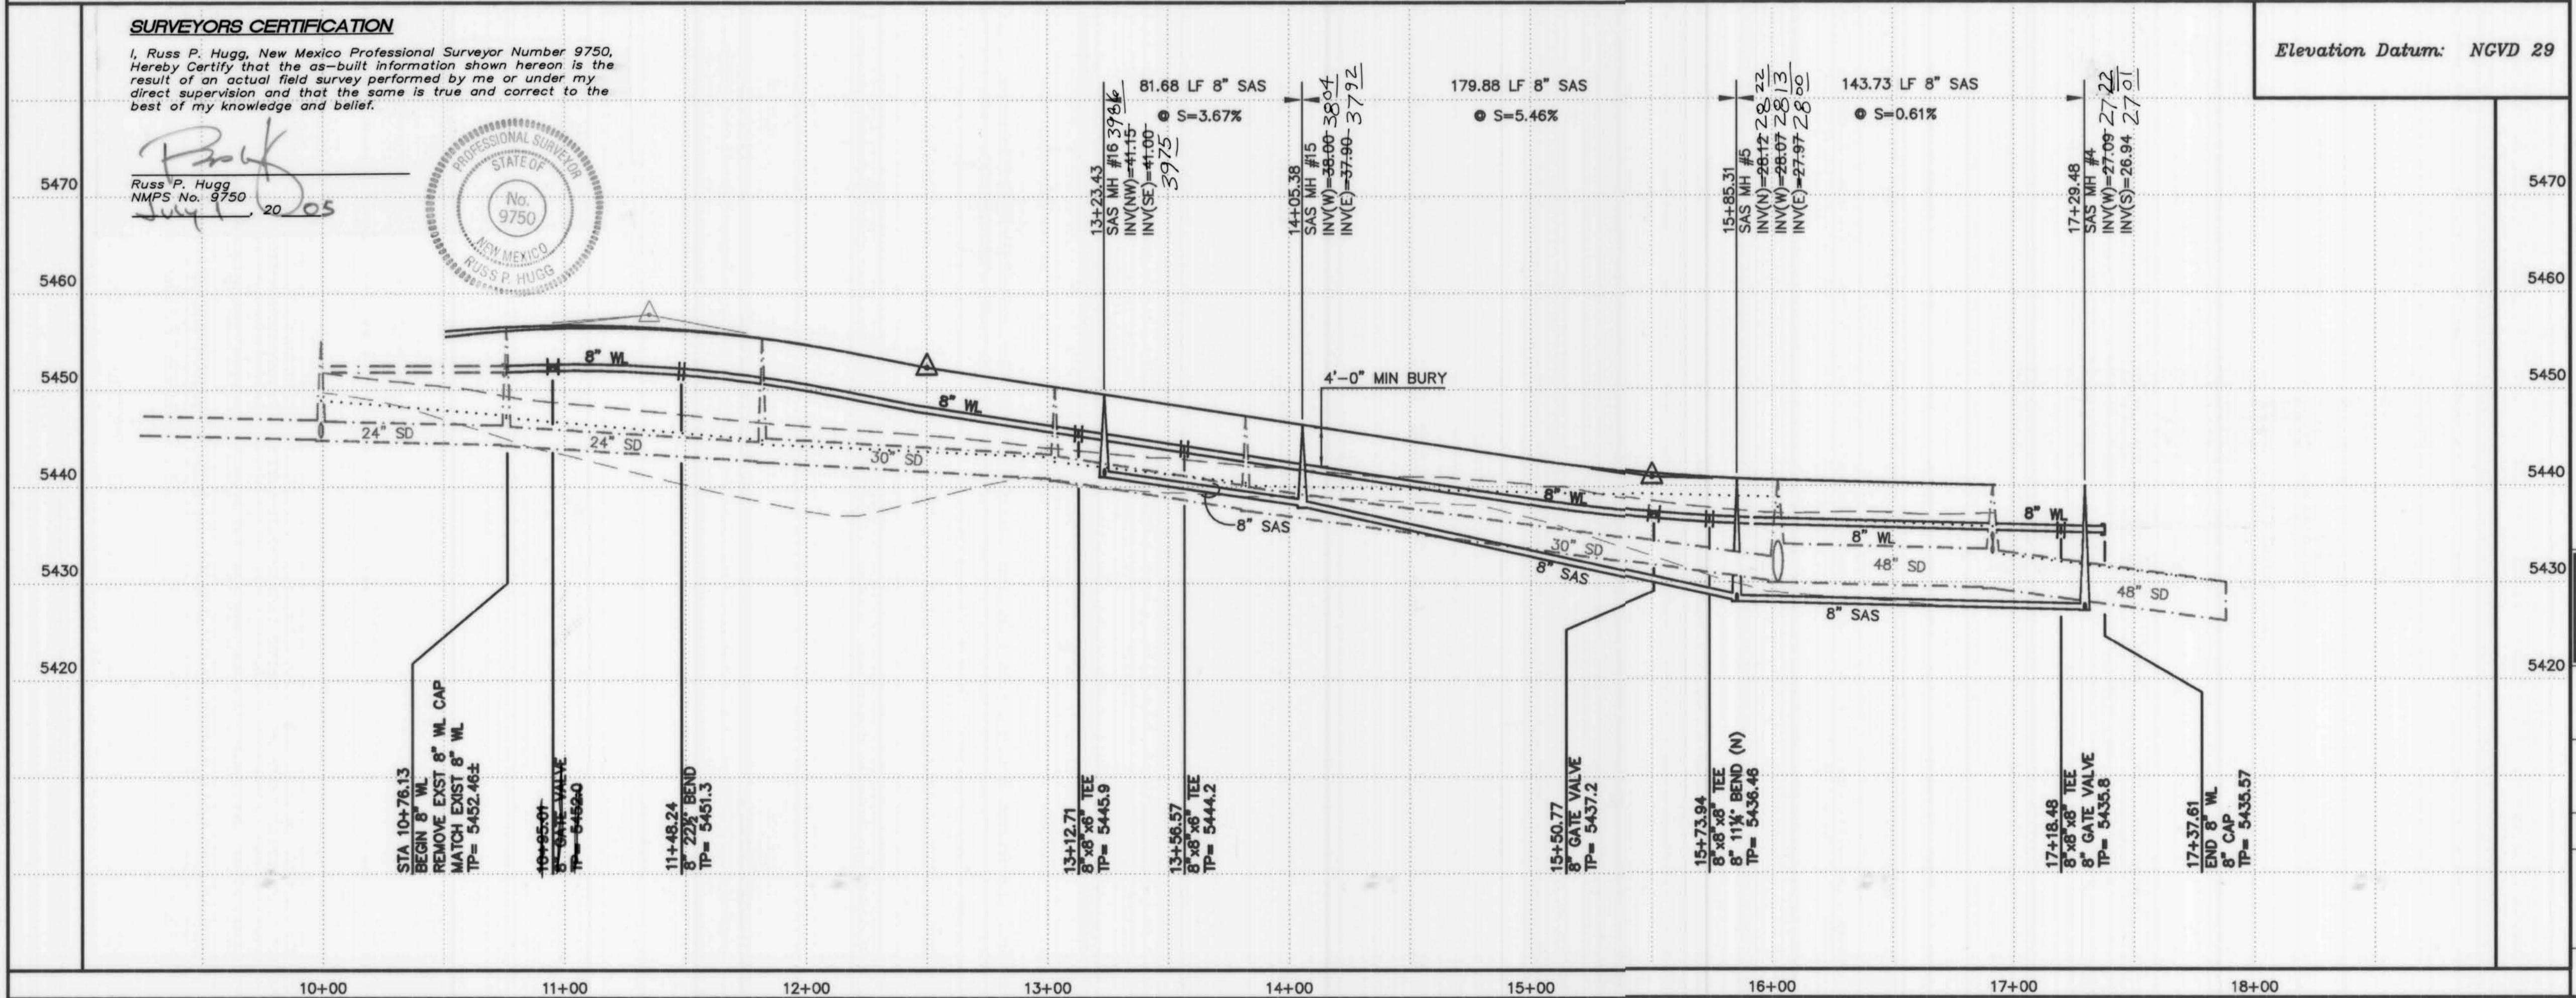

APPROVED FOR WATER AND
SANITARY SEWER CONSTRUCTION.
[Signature]
(for NEW MEXICO UTILITIES, INC.) DATE

GENERAL NOTES

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2. CONSTRUCT ALL SINGLE & DOUBLE WATER SERVICES PER NMUI STANDARD SPECS, EXHIBITS A, B, C, & D.
3. SEE SHEET #14 FOR WATER SHUT-OFF PLAN.
4. SEE SHEET #14 FOR RESTRAINED JOINT LENGTHS FOR WATER LINE FITTINGS.
5. CONSTRUCT FIRE HYDRANTS PER DESIGNED DEPTHS & LENGTHS PER COA STD DWG #2340 AND NMUI STANDARD SPECS.
6. INSTALL VALVE RING & COVER PER COA STD DWG #2328 AND NMUI STANDARD SPECS.
7. INSTALL A CONCRETE COLLAR AROUND ALL SAS MH RIMS AND VALVE BOXES PER NMUI STANDARD SPECS.

LEGEND

- SINGLE WATER METER & BOX
- DOUBLE WATER METER & BOX
- GATE VALVE W/ VALVE BOX
- FIRE HYDRANT
- SAS MANHOLE
- WATER LINE W/ FITTING


UTILITY SERVICE TABLE

LOT NO.	STATION		SAS INV @ R/W
	FIELD NOTES	SURVEY INFORMATION	
1.	ALDRICH SURVEYING	04/03	AIC MONUMENT "B-10" LOCATED 1 MI ± WEST OF PARADISE BLVD. AND LA PAZ. ELEVATION: 5429.35 (NGVD 1929)
11	11+02.58, 7'	10+87.58, 23'	41.76*
12		11+37.58, 23'	41.34*
13	12+02.58, 7'	11+87.58, 23'	40.91*
14		12+37.58, 23'	40.49*
15	13+02.58, 7'	12+87.58, 23'	40.07*
16		13+37.58, 23'	39.65*
17	14+02.58, 7'	13+87.58, 23'	39.28*
18		14+22.58, 23'	39.09*
19	14+52.58, 7'(S)	14+67.58, 23'	38.86*

ALL WATER SERVICES ARE DOUBLE EXCEPT WHERE NOTED AS (S) SINGLE.

* INSTALL SAS SERVICE RISERS



CONTRACTOR	AS-BUILT INFORMATION
WORK STAGED BY SURV TEK	DATE 2/05
INSPECTORS BY SURV TEK	DATE 2/05
FIELD VERIFICATION BY SURV TEK	DATE 2/05
DRAWINGS OWNED BY SURV TEK	DATE 2/05
MICRO-FILM INFORMATION	DATE 2/05
RECORDED BY	NO.

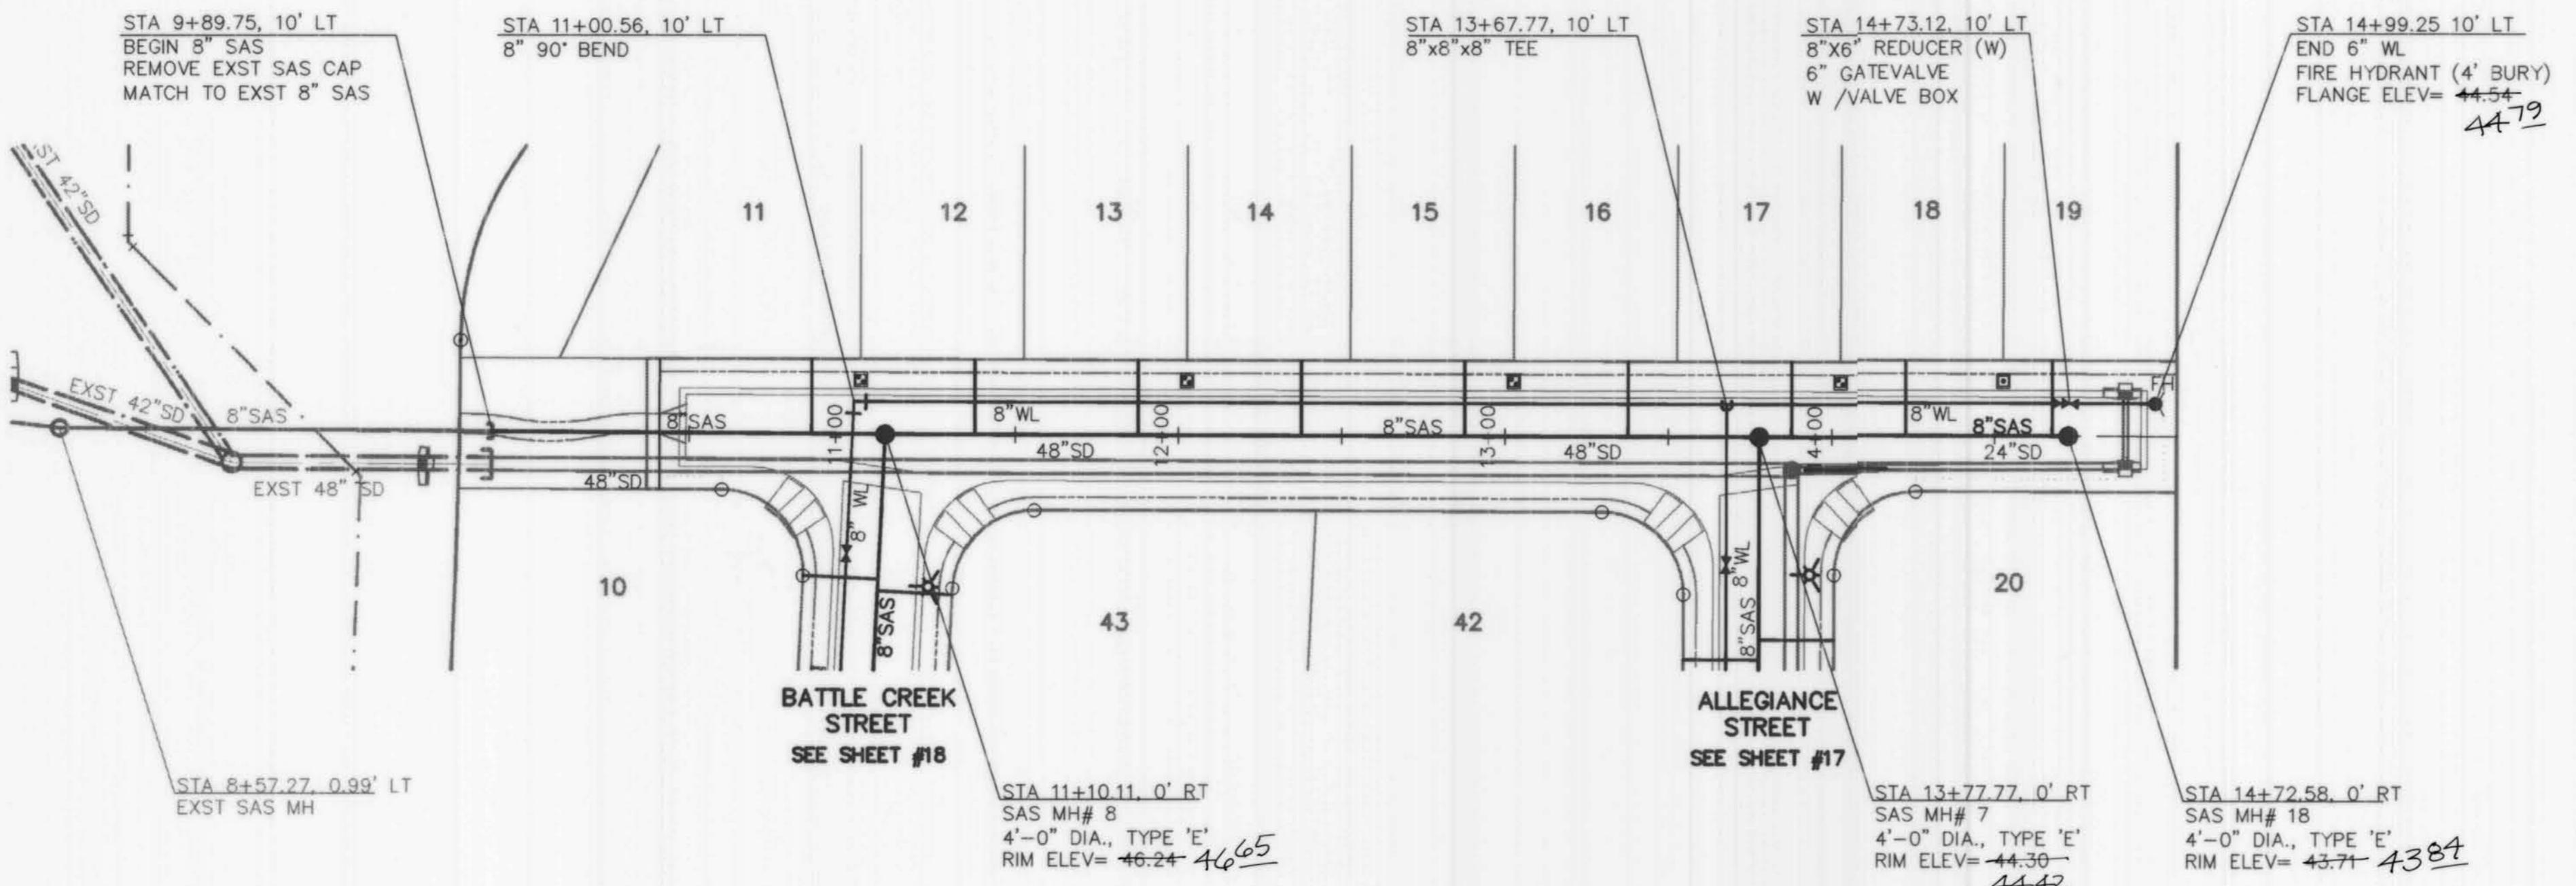

EDISON ROAD

NOTE:
ALL IMPROVEMENTS IN RAINBOW BLVD.
WILL BE BUILT BY CPN #730081.
(THE TRAILS OFFSITE IMPROVEMENTS).

Elevation Datum: NGVD 29

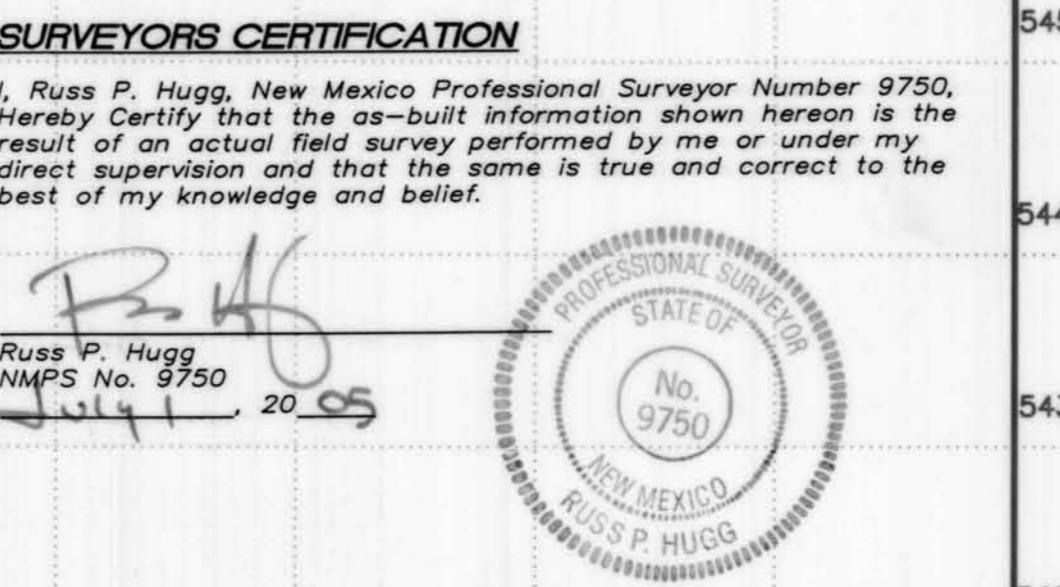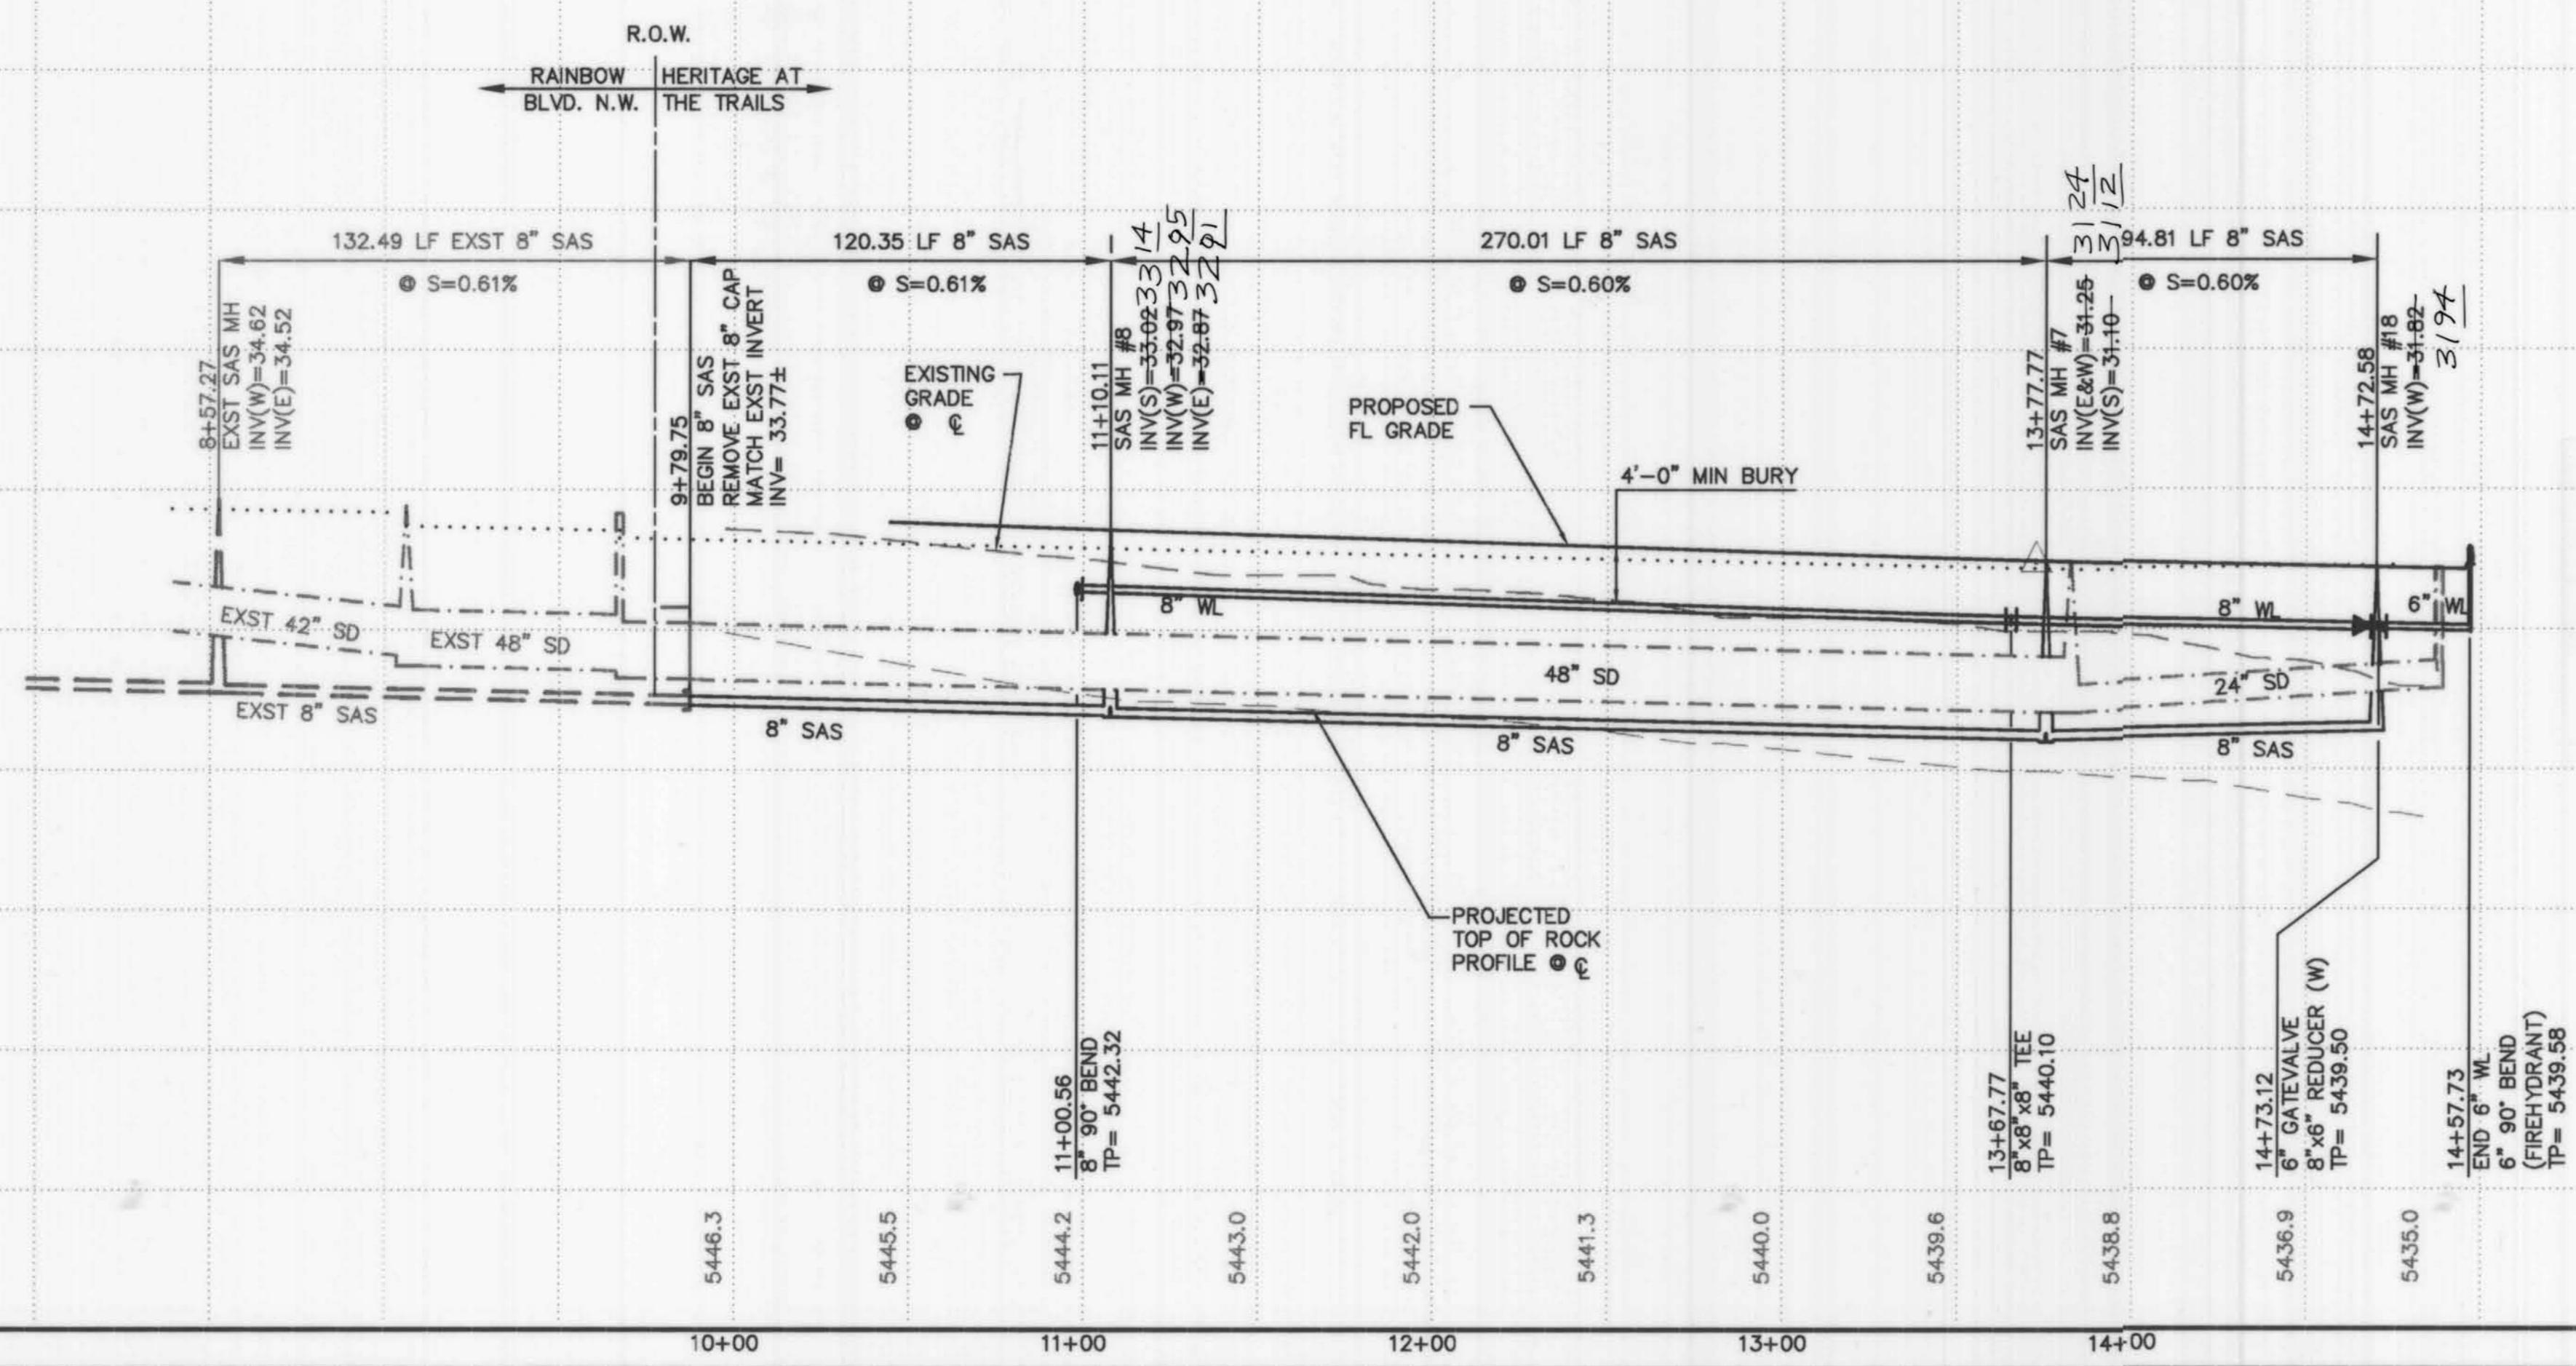


ISAACSON & ARFMAN, P.A.
Consulting Engineering Associates
128 Monroe Street N.E.
Albuquerque
New Mexico
1324B-UTL2DWrfh
07/06/04

CITY OF ALBUQUERQUE
PUBLIC WORKS DEPARTMENT
ENGINEERING GROUP


TITLE: HERITAGE AT THE TRAILS UNIT 2
EDISON ROAD
STA 9+50.00 TO END
UTILITY PLAN & PROFILE

Design Review Committee APPROVED	City Engineer Approval APPROVED	Mo./Day/yr.
APP 23 2004	OCT - 4 2004	Mo./Day/yr.
DESIGN REVIEW COMMITTEE	CITY ENGINEER	
City Project No. 738482		Zone Map No. C-9-Z
Last Design Update		Sheet 16 Of 19

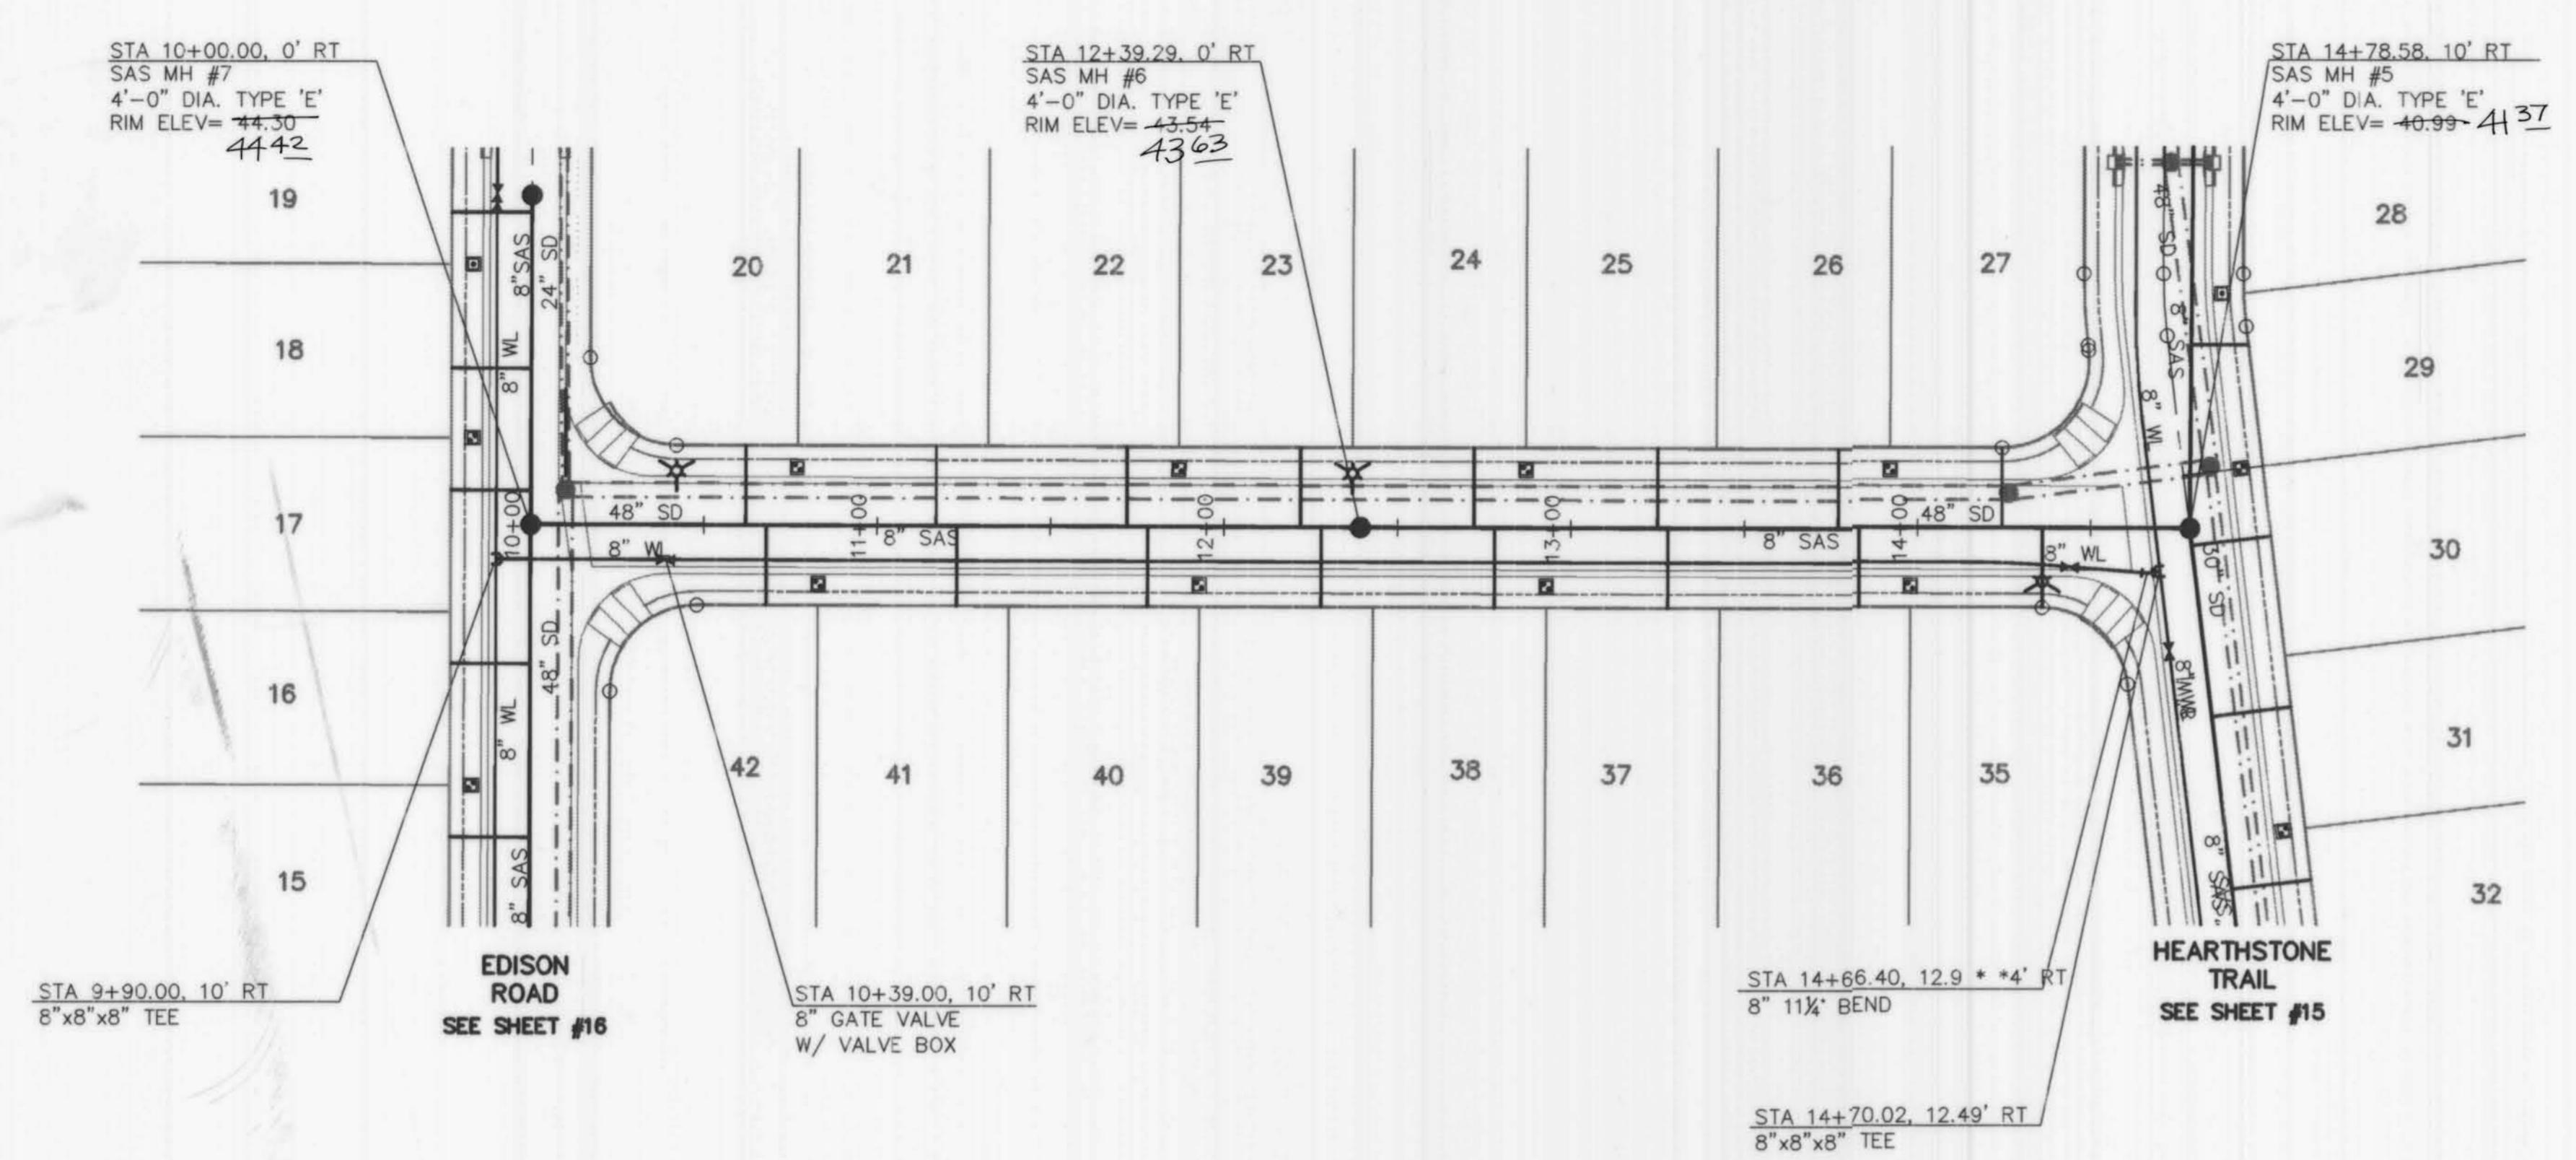

ALLEGIANCE STREET

GENERAL NOTES		
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2. CONSTRUCT ALL SINGLE & DOUBLE WATER SERVICES PER NMUI STANDARD SPECS, EXHIBITS A, B, C, & D.		
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4. SEE SHEET #14 FOR RESTRAINED JOINT LENGTHS FOR WATER LINE FITTINGS.		
5. CONSTRUCT FIRE HYDRANTS PER DESIGNATED DEPTHS & LENGTHS PER COA STD DWG #2340 AND NMUI STANDARD SPECS.		
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AS-BUILT INFORMATION		
CONTRACTOR WORK STAGED ACCEPTANCE BY DATE		
FIELD INFORMATION		
1. ALDRICH SURVEYING	04/03	ACS MONUMENT '2-B-10' LOCATED 1 M.L. ± WEST OF PARADISE BLVD. AND LA PAZ. ELEVATION: 5429.35 (NGVD 1929)
BENCH MARKS		
SURVEYOR'S SEAL		
FIELD NOTES		
ELEVATION DATUM: NGVD 29		
REVISIONS		
DESIGN		

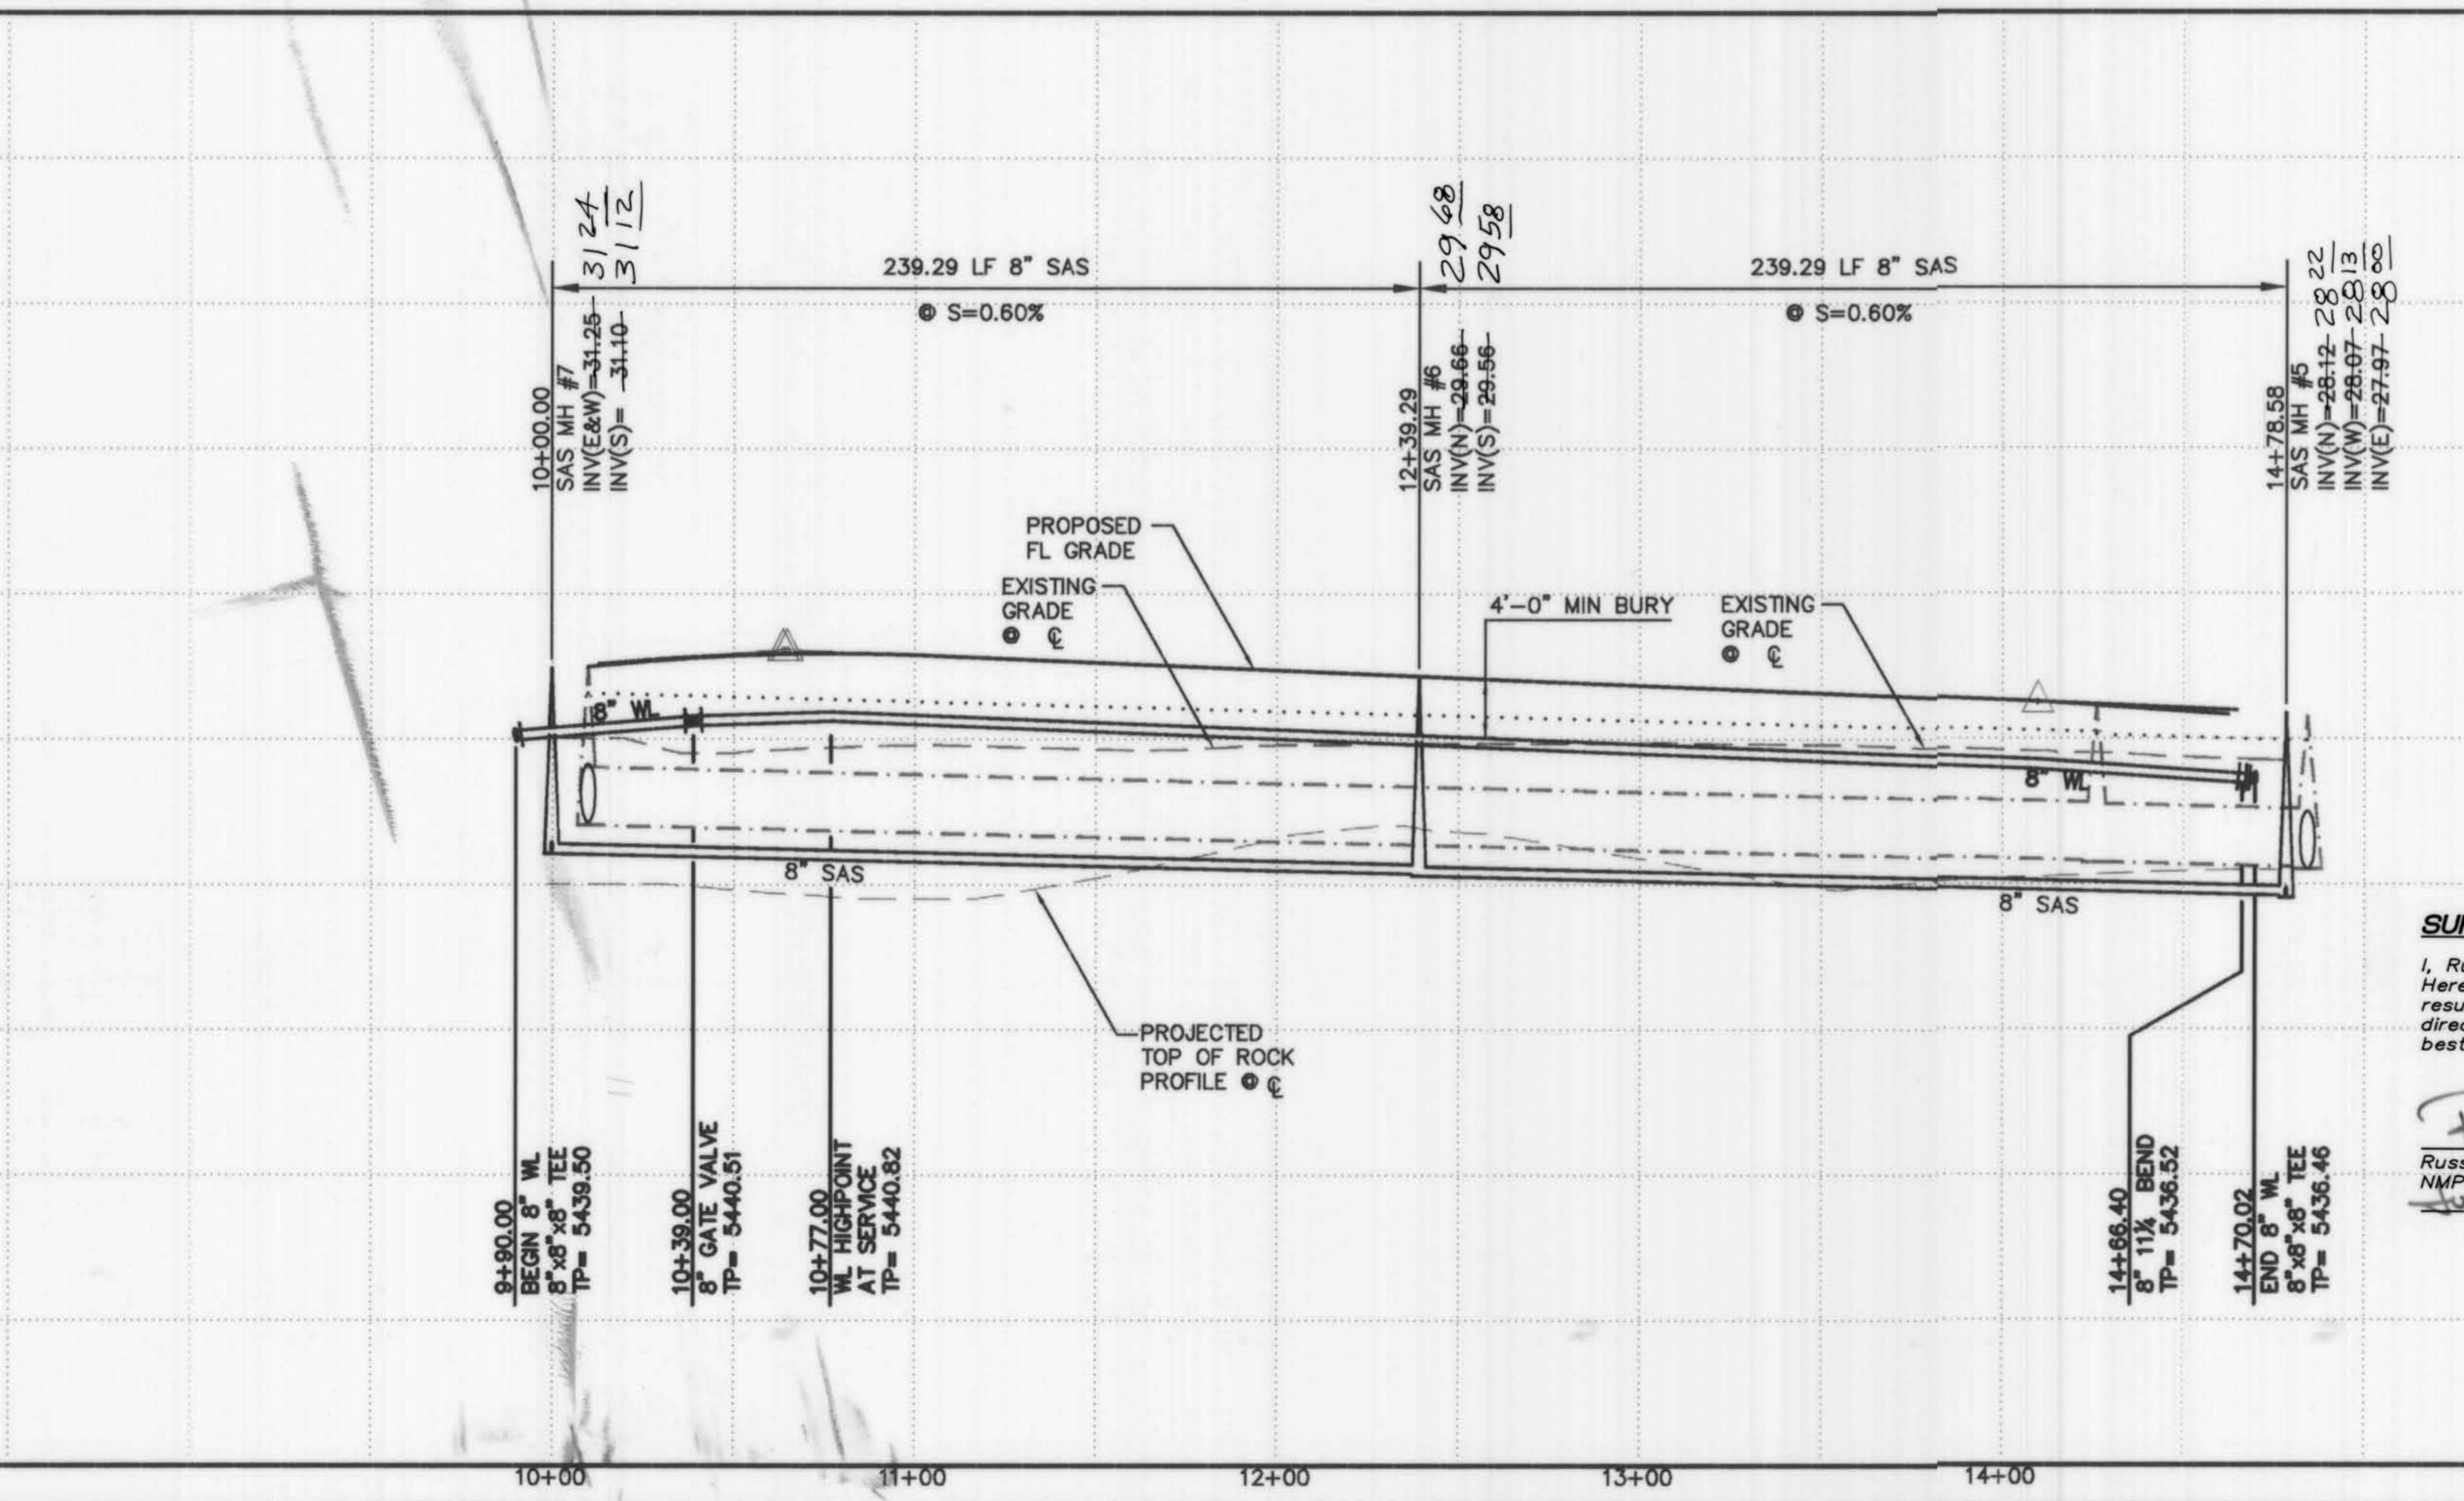

SURVEYORS CERTIFICATION

I, Russ P. Hugg, New Mexico Professional Surveyor Number 9750, hereby certify that the as-built information shown hereon is the result of an actual field survey performed by me or under my direct supervision and that the same is true and correct to the best of my knowledge and belief.

Russ P. Hugg
NMPSS No. 9750
July 1, 2005



ISAACSON & ARFMAN, P.A.
Consulting Engineering Associates
128 Monroe Street N.E.
Albuquerque New Mexico
1324B-UTIL3DWGrth
07/09/04

CITY OF ALBUQUERQUE
PUBLIC WORKS DEPARTMENT
ENGINEERING GROUP

TITLE: HERITAGE AT THE TRAILS UNIT 2
ALLEGIANCE STREET
STA 10+00.00 TO END
UTILITY PLAN & PROFILE


Design Review Committee	City-Engineer Approval
APPROVE APPROVED APPROVED APPROVED APPROVED APPROVED	APPROVE APPROVED APPROVED APPROVED APPROVED APPROVED
DESIGN REVIEW COMMITTEE City Project No. 738482	OCT - 4 2004 CITY ENGINEER
Last Design Update Mo./Day/Yr.	Mo./Day/Yr.
City Project No. 738482	Zone Map No. C-9-Z
Sheet 17 Of 19	

APPROVED FOR WATER AND
SANITARY SEWER CONSTRUCTION.
[Signature]
(for NEW MEXICO UTILITIES, INC.) DATE

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CONTRACTOR	WORK STAGED BY SURV TEK	DATE DATA02/05
ACCEPTANCE BY	SURV TEK	DATE DATA06/05
FIELD SURVEY BY	SURV TEK	DATE DATA06/05
RECORDED BY	MICRO-FILM INFORMATION	DATE NO.



BATTLE CREEK STREET

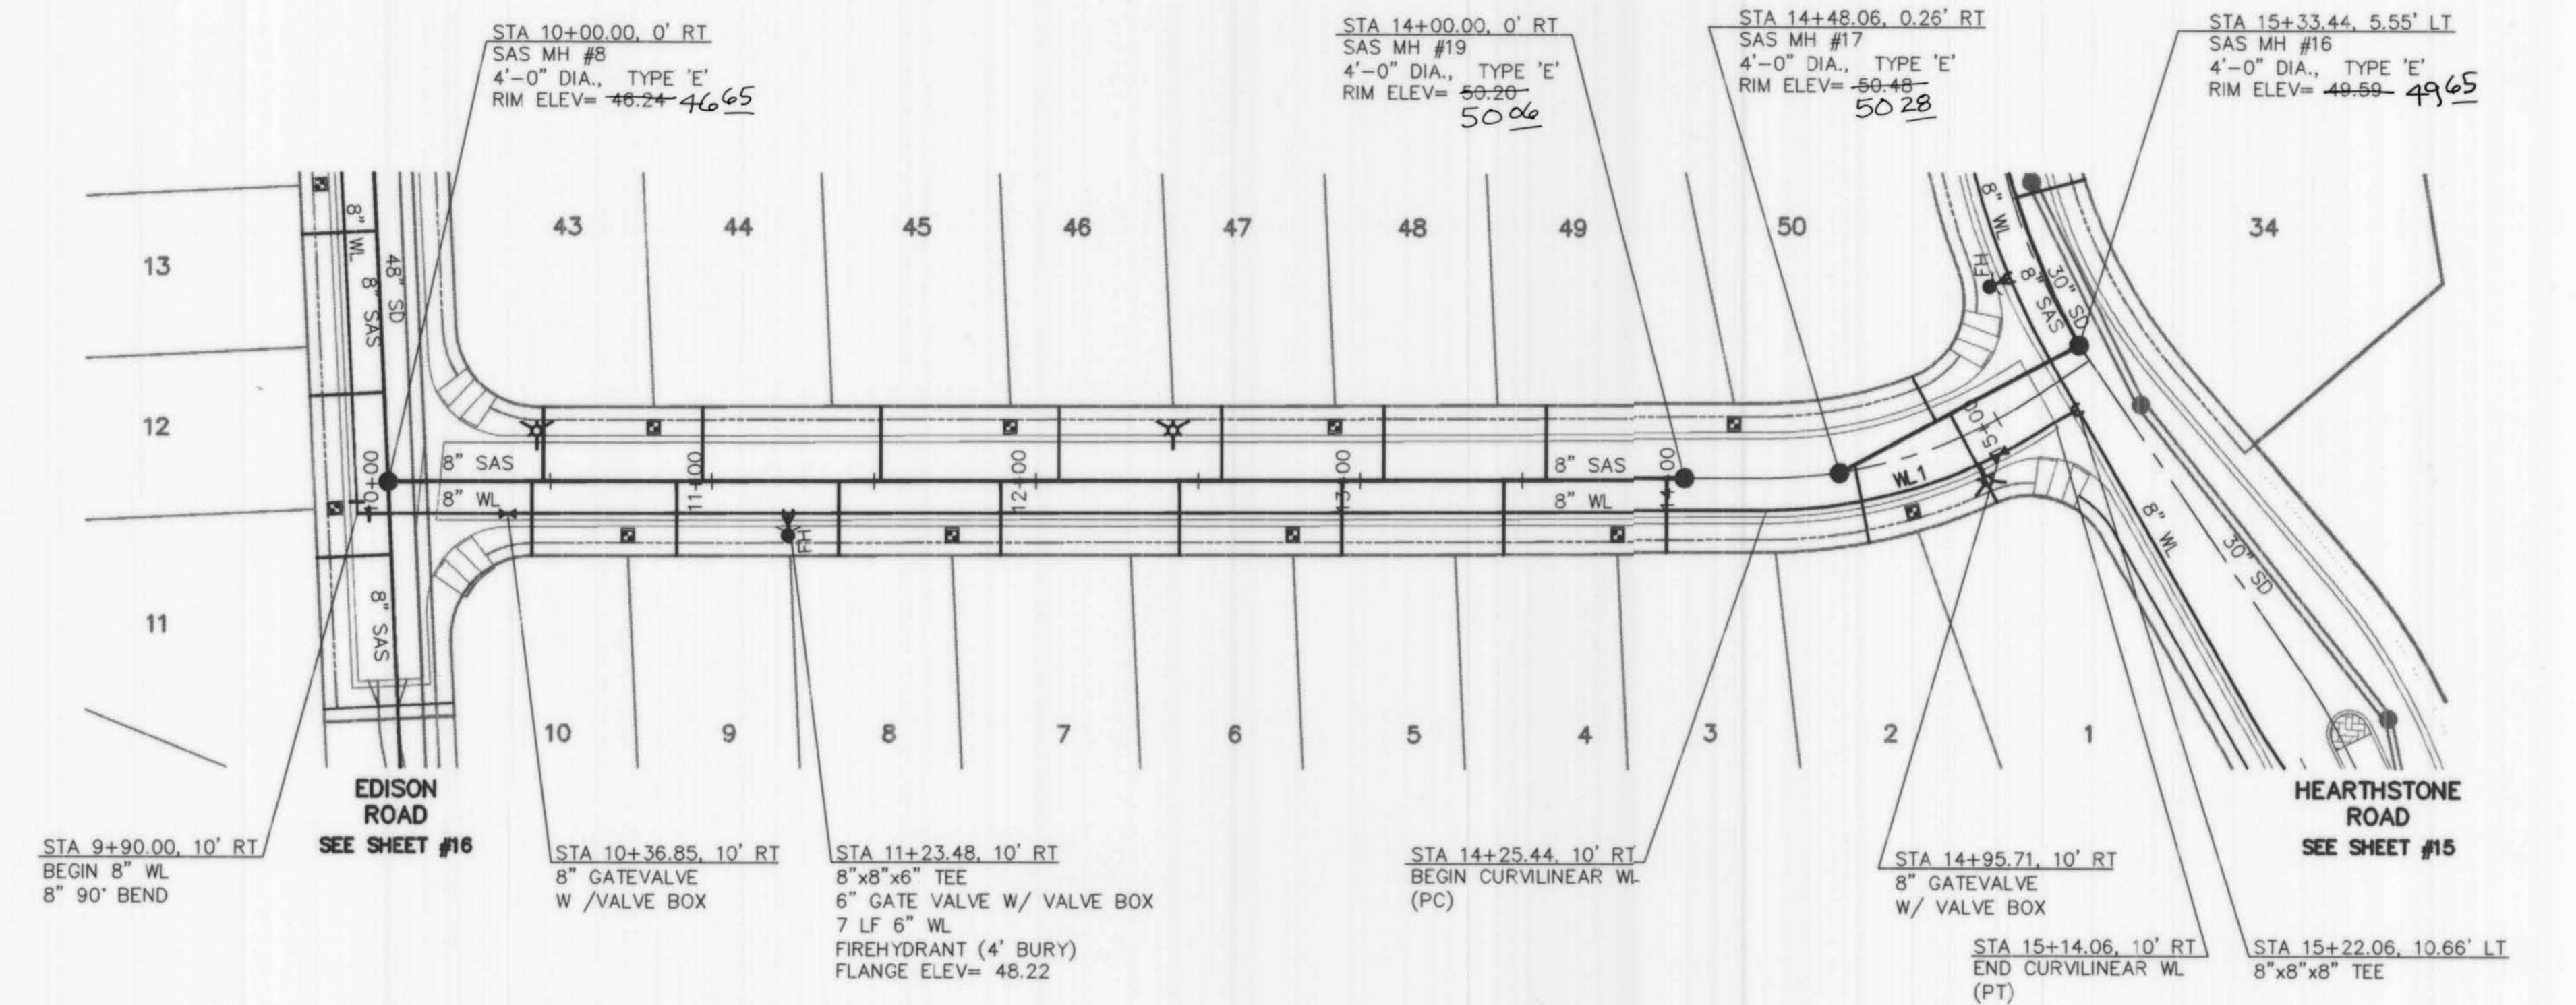UTILITY CURVE TABLE				
CURVE	RADIUS	LENGTH	DELTA	CHD BRG
WL1	160.00	94.53	33'51"04"	S 14°04'49" E

BENCH MARKS
ACS MONUMENT '2-B-10" LOCATED 1
M.L. WEST OF PARADISE BLVD. AND LA PAZ.
ELEVATION: 5429.35 (NGVD 1929)

LEGEND

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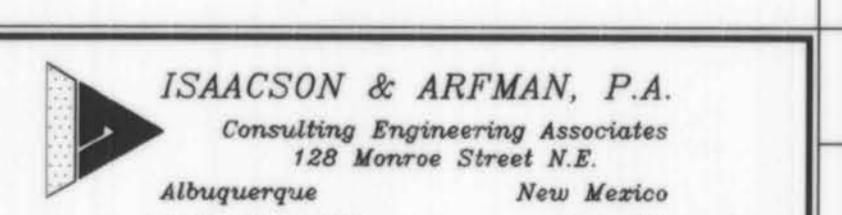
SCALES:
1"=40' HOR.
1"=10' VERT.

UTILITY SERVICE TABLE

LOT NO.	STATION		SAS INV @ R/W
	WATER, LENGTH	SAS, LENGTH	
43	10+82.02, 27'	10+47.82, 23'	42.0
44	10+97.02, 23'	10+97.02, 23'	42.5
45	11+52.08, 23'	11+52.08, 23'	43.0
46	12+07.14, 23'	12+07.14, 23'	43.5
47	12+57.19, 23'	12+57.19, 23'	44.0
48	12+92.25, 27'	13+07.25, 23'	44.4
49	14+57.30, 23'	13+57.30, 23'	44.9
50	14+57.72, 23'	14+79.72, 23'	45.5
1	14+66.51, 7'	14+89.16, 23'	45.5
2	14+53.11, 23'	14+53.11, 23'	45.5
3	13+79.36, 7'	13+94.37, 23'	45.2
4	13+44.31, 23'	13+44.31, 23'	44.7
5	12+79.25, 7'	12+94.25, 23'	44.3
6	12+44.20, 23'	12+44.20, 23'	43.8
7	11+89.14, 23'	11+89.14, 23'	43.3*
8	11+74.14, 7'	11+39.09, 23'	42.9*
9	10+89.03, 23'	10+89.03, 23'	42.4*
10	10+74.03, 7'	10+44.27, 23'	42.0


ALL WATER SERVICES ARE DOUBLE EXCEPT WHERE NOTED AS (S) SINGLE.

* INSTALL SAS SERVICE RISERS.





CITY OF ALBUQUERQUE
PUBLIC WORKS DEPARTMENT
ENGINEERING GROUP

TITLE: HERITAGE AT THE TRAILS UNIT 2
BATTLE CREEK STREET
STA 10+00.00 TO END
UTILITY PLAN & PROFILE

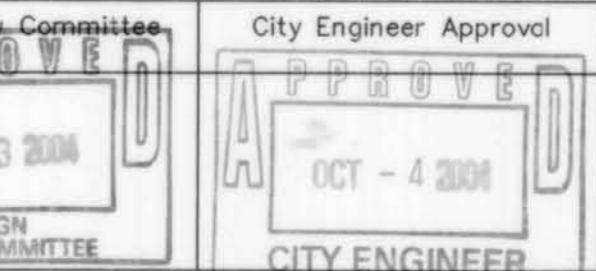

Mo./Day/Yr. Mo./Day/Yr.
Last Design Update
City Project No. 738482 Zone Map No. C-9-Z Sheet 18 Of 19

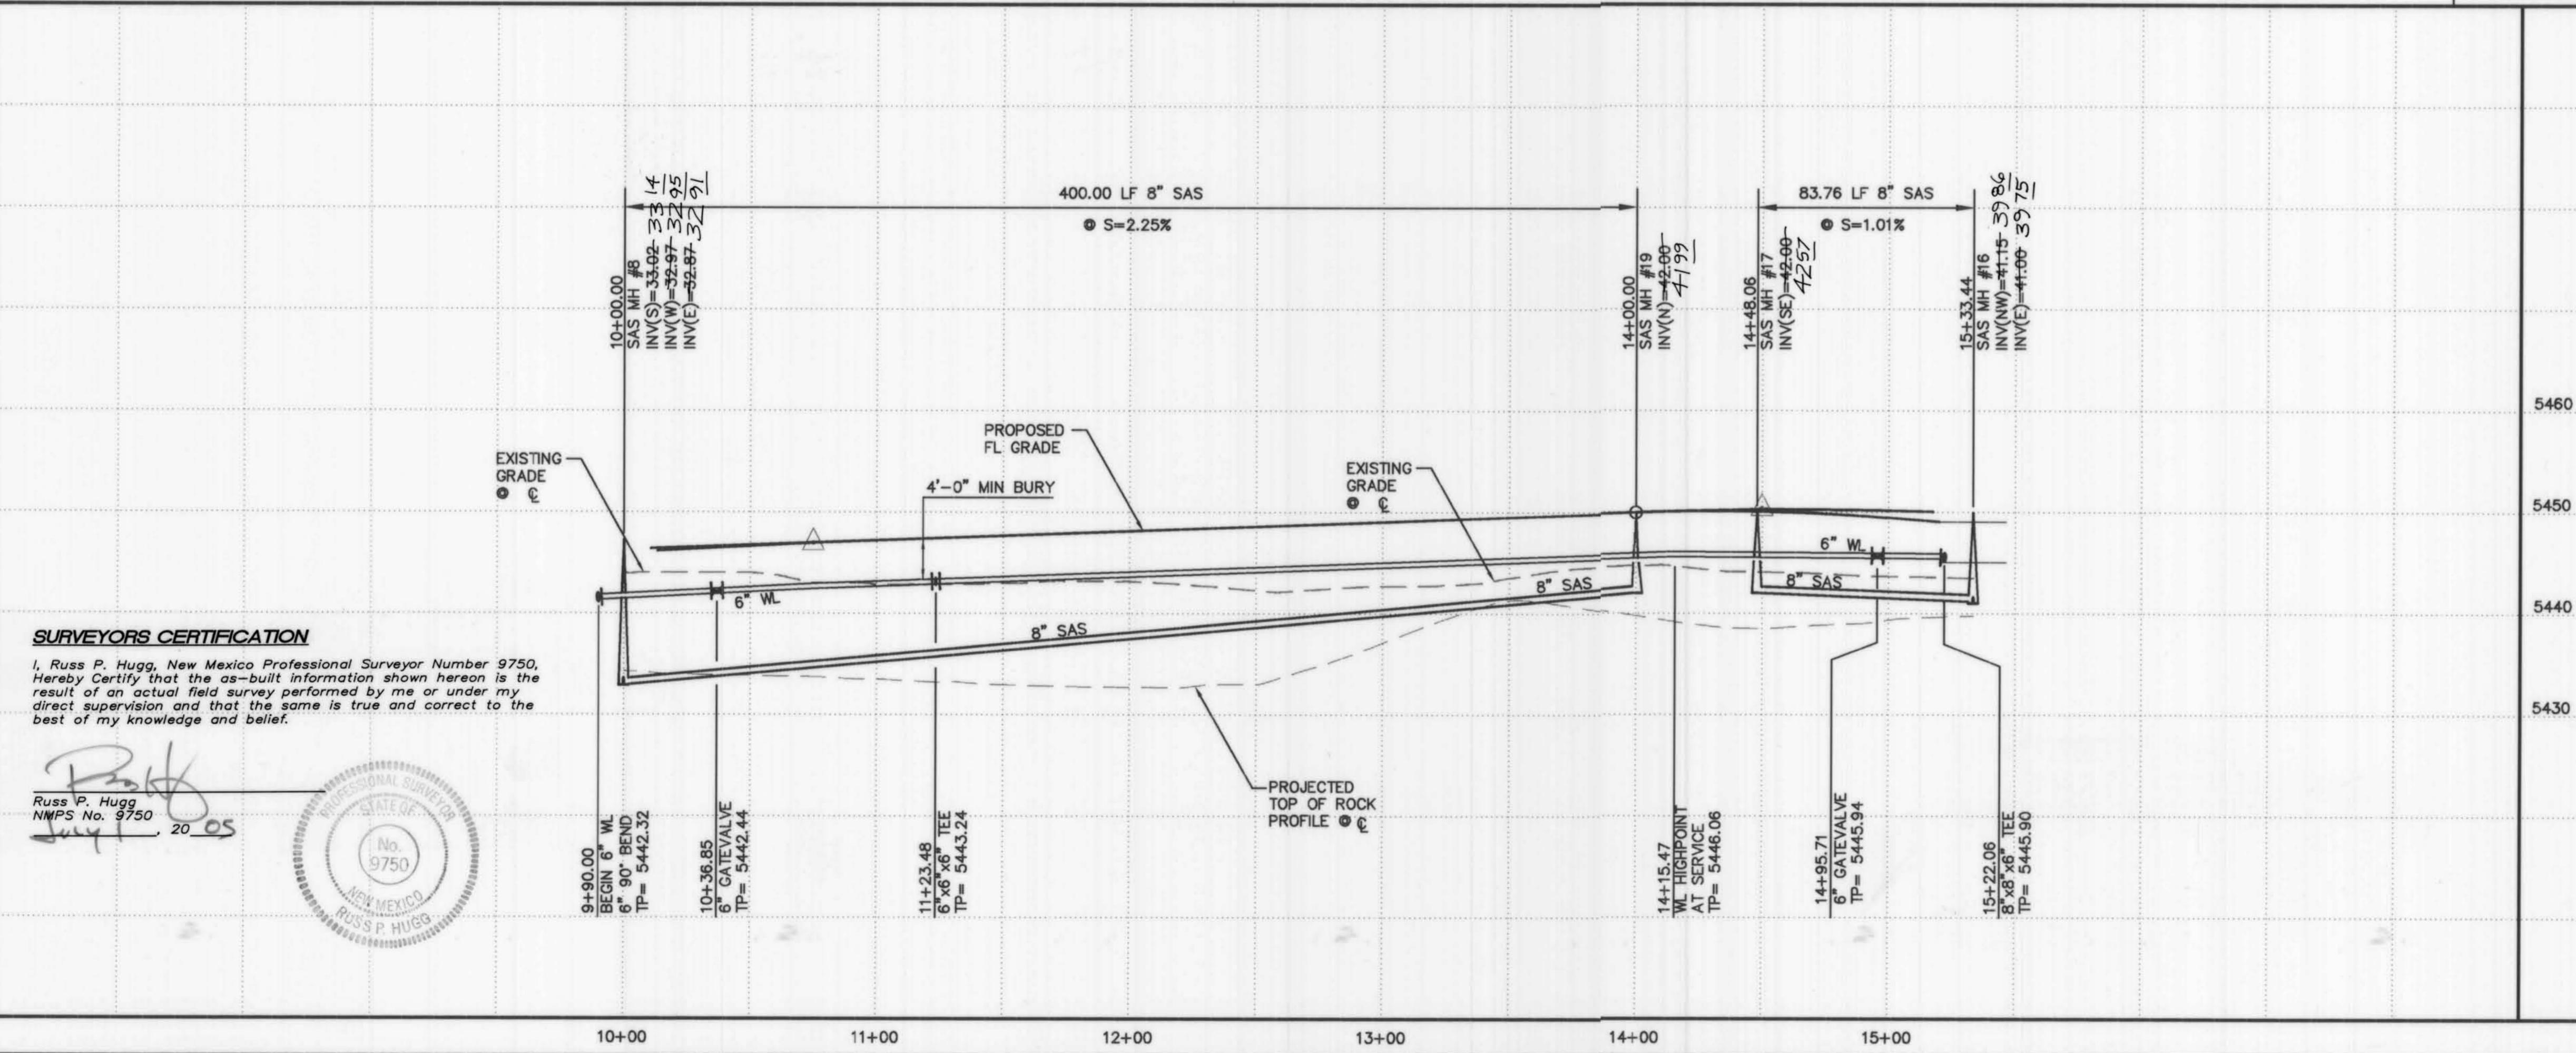

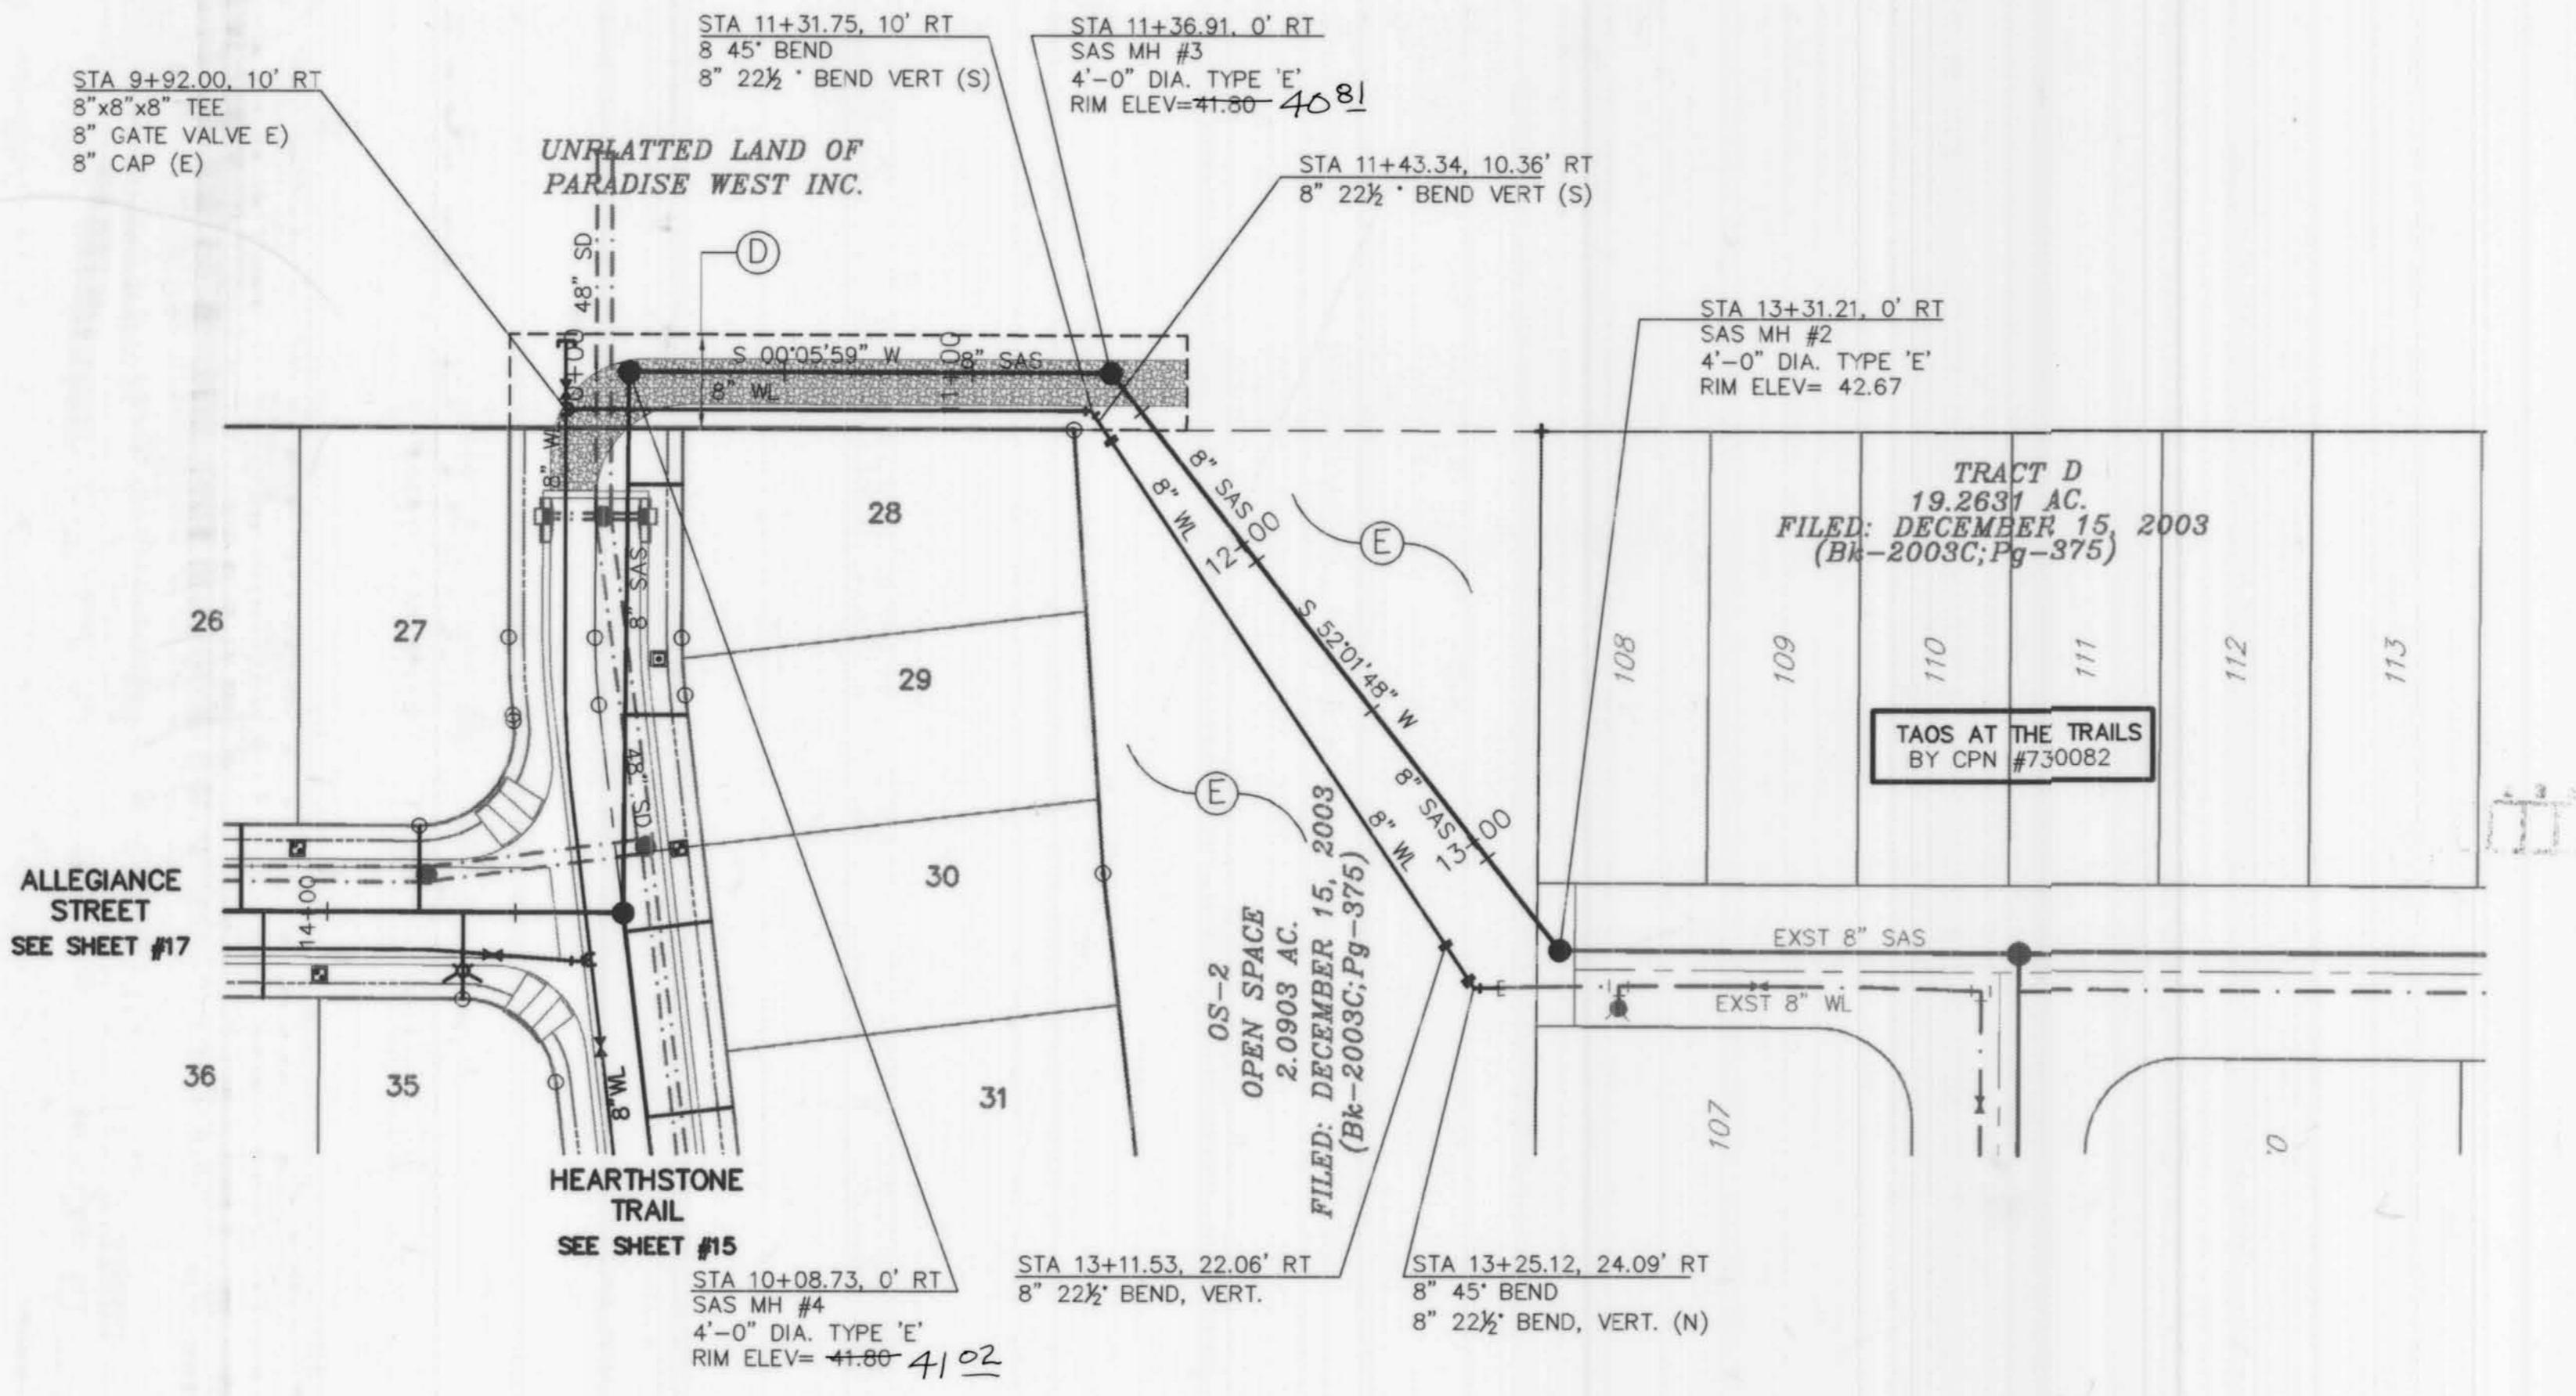


OFFSITE UTILITIES

APPROVED FOR WATER AND SANITARY SEWER CONSTRUCTION.
 (for NEW MEXICO UTILITIES, INC.) DATE
[Signature]

GENERAL NOTES


1. CONSTRUCT SAS SERVICES PER NMUI STANDARD SPECS.
2. CONSTRUCT ALL SINGLE & DOUBLE WATER SERVICES PER NMUI STANDARD SPECS, EXHIBITS A, B, C, & D.
3. SEE SHEET #14 FOR WATER SHUT-OFF PLAN.
4. SEE SHEET #14 FOR RESTRAINED JOINT LENGTHS FOR WATER LINE FITTINGS.
5. CONSTRUCT FIRE HYDRANTS PER DESIGNATED DEPTHS & LENGTHS PER COA STD DWG #2340 AND NMUI STANDARD SPECS.
6. INSTALL VALVE RING & COVER PER COA STD DWG #2328 AND NMUI STANDARD SPECS.
7. INSTALL A CONCRETE COLLAR AROUND ALL SAS MH RIMS AND VALVE BOXES PER NMUI STANDARD SPECS.

LEGEND

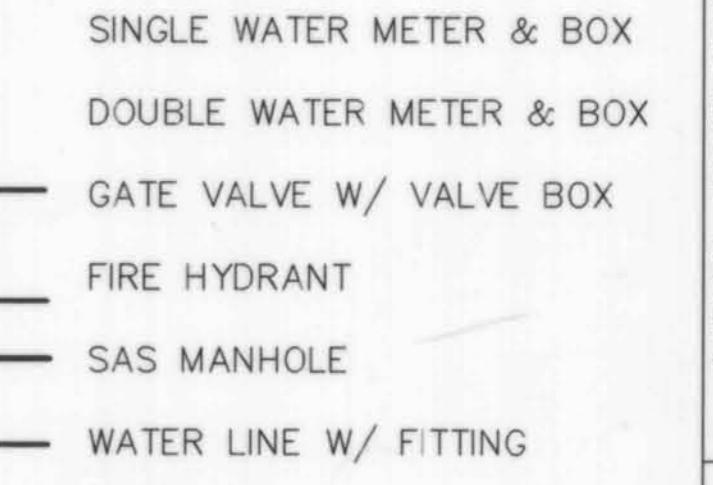


SCALES:
 1"=40' HOR.
 1"=10' VERT.

Elevation Datum: NGVD 29

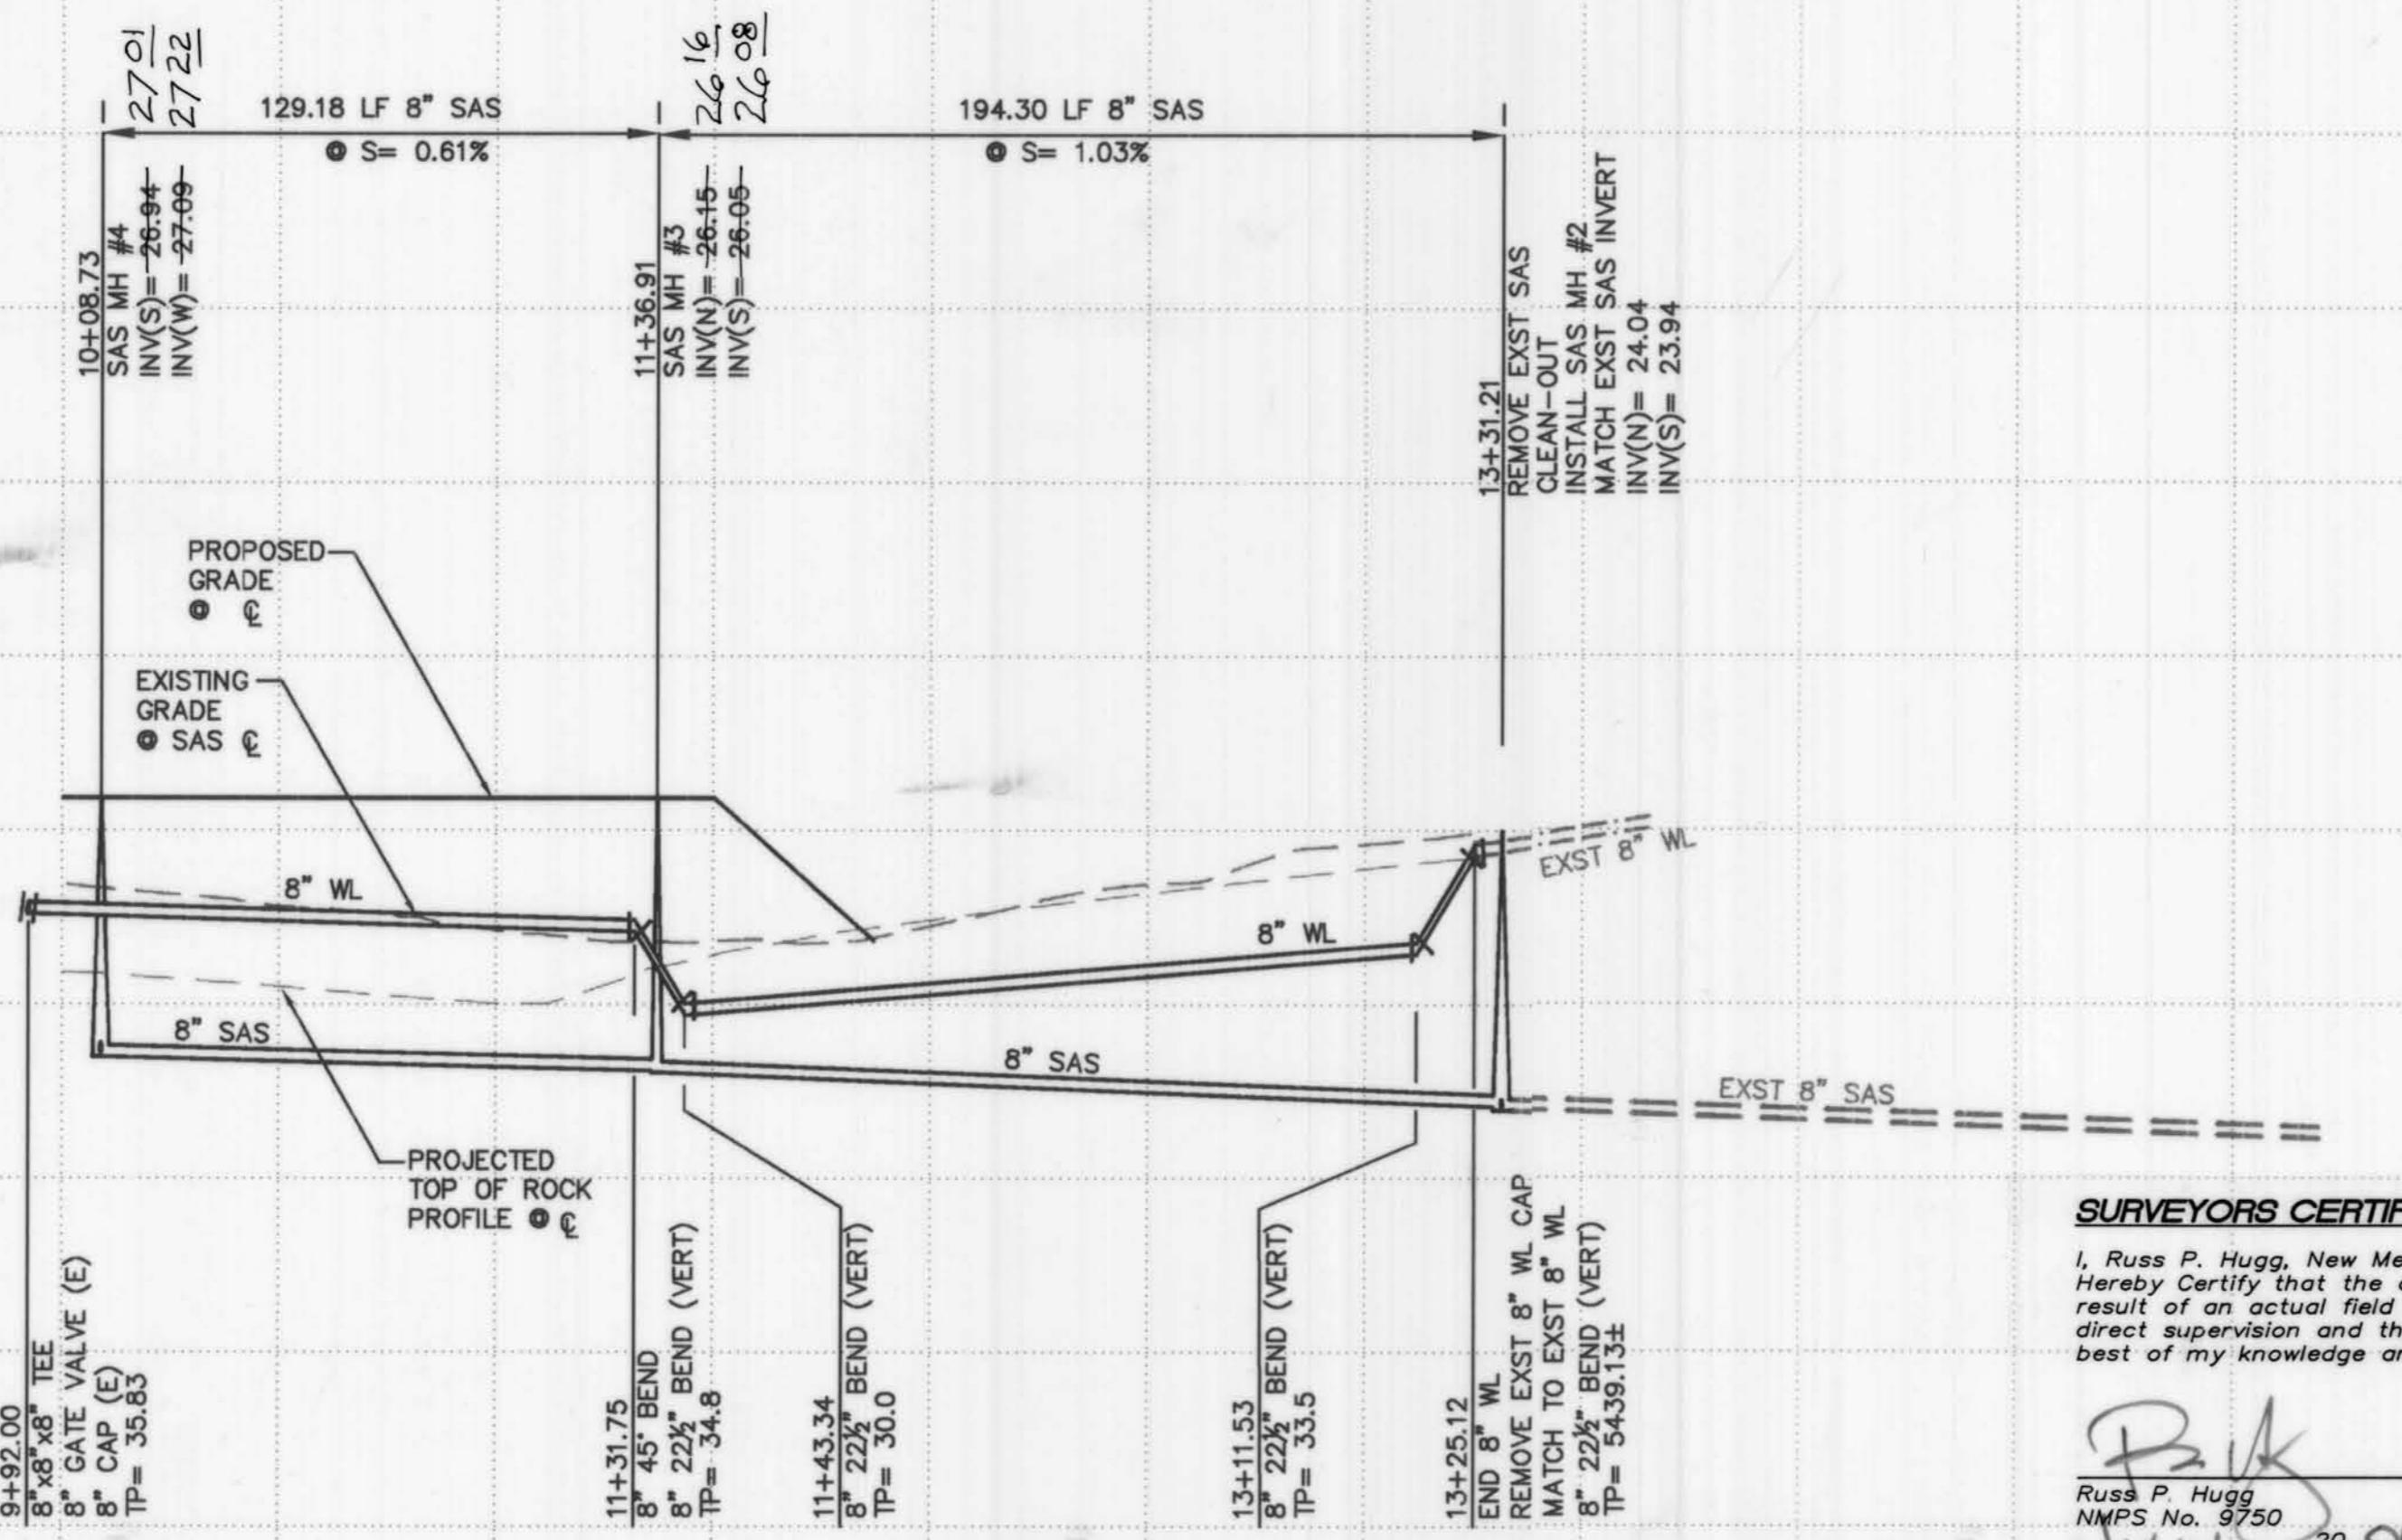

SURVEYORS CERTIFICATION
 I, Russ P. Hugg, New Mexico Professional Surveyor Number 9750, hereby Certify that the as-built information shown hereon is the result of an actual field survey performed by me or under my direct supervision and that the same is true and correct to the best of my knowledge and belief.

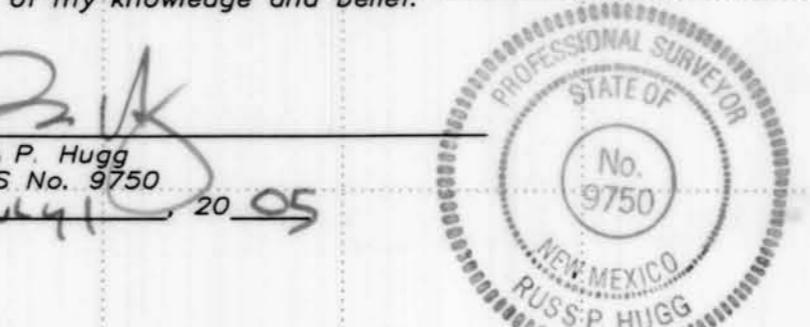

ISAACSON & ARFMAN, P.A.
 Consulting Engineering Associates
 128 Monroe Street N.E.
 Albuquerque
 New Mexico
 1324B-UTIL5DWGfh
 07/04/04

CITY OF ALBUQUERQUE
 PUBLIC WORKS DEPARTMENT
 ENGINEERING GROUP

TITLE: HERITAGE AT THE TRAILS UNIT 2
 OFFSITE UTILITY
 STA 10+00.00 TO END
 UTILITY PLAN & PROFILE

Design Review Committee APPROVED	City Engineer Approval APPROVED
<i>[Signature]</i> SEP 2 3 2004	<i>[Signature]</i> OCT 4 2004
DESIGN REVIEW COMMITTEE	CITY ENGINEER
City Project No. 738482	Zone Map No. C-9-Z

AS-BUILT INFORMATION		GENERAL NOTES	
FIELD NOTES	WORK STAGED BY SURVEYOR	CONTRACTOR	DATE
1. ALDRICH SURVEYING 04/03	M.I. WEST OF PARADISE BLVD. AND LA PAZ.	FIELD SURVEY BY SURVEY TEK	DATE 02/05
	ELEVATION: 5429.35 (NGVD 1929)	CORRECTED BY SURVEY TEK	DATE 02/05
		MICRO-FILM INFORMATION	DATE
		RECORDED BY	NO.



[Signature]

REVISIONS DESIGN
 NO. DATE REMARKS
 1. DATE DESIGN
 DRAWN BY GLD
 CHECKED BY GLD
 DRAWN BY RFH
 CHECKED BY RFH
 Mo./Day/Yr. Mo./Day/Yr.

Last Design Update
 Mo./Day/Yr. Mo./Day/Yr.
 City Project No. 738482 Zone Map No. C-9-Z Sheet 19 of 19