

016-130748a-0811

PUBLIC IMPROVEMENT PLANS
FOR
ALISO LOFTS, PHASE II
ALBUQUERQUE, NEW MEXICO

NOVEMBER 2006

PREPARED FOR:
ENVIRONMENTAL DYNAMICS, INC.
320 CENTRAL AVE SW.
ALBUQUERQUE, NM 87102

PREPARED BY:
ISAACSON & ARFMAN, P.A.
128 MONROE ST. NE
ALBUQUERQUE, NM 87108


INDEX TO DRAWINGS

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CERTIFICATE OF SUBSTANTIAL COMPLIANCE ON PLANS

I, Genevieve L. Donart of the firm of Isaacson & Arfman, P.A., a Registered Professional Engineer in the State of New Mexico, do hereby certify, to the best of my knowledge and belief, that the infrastructure installed as part of this project has been inspected by me or by a qualified person under my direct supervision and has been constructed in accordance with the plans and specifications approved by the City Engineer and that the original design intent of the approved plans has been met, except as noted by me on the ~~as-built~~ construction drawings. This Certification is based on site inspections by me or ~~as-built~~ under my direction and survey information provided by the firm Surveys Southwest, stamped Anthony Harris, NMPS number 11463



Genevieve L. Donart

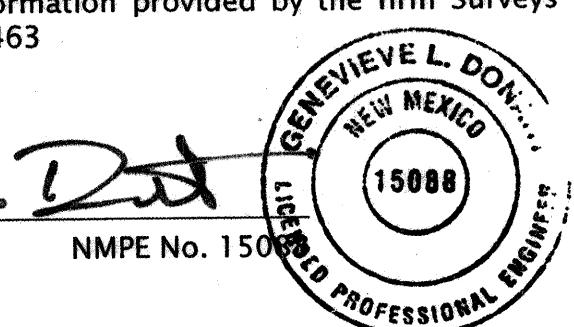

SURVEYOR'S CERTIFICATION

"I ANTHONY L. HARRIS, A DULY QUALIFIED REGISTERED PROFESSIONAL LAND SURVEYOR UNDER THE LAWS OF THE STATE OF NEW MEXICO, DO HEREBY CERTIFY THAT THE 'AS-BUILT' INFORMATION SHOWN ON THESE DRAWINGS WAS OBTAINED FROM FIELD CONSTRUCTION AND 'AS-BUILT' SURVEYS PERFORMED BY ME OR UNDER MY SUPERVISION, THAT THE 'AS-BUILT' INFORMATION SHOWN ON THESE DRAWINGS WAS ADDED BY ME OR MY SUPERVISION, AND THAT THIS 'AS-BUILT' INFORMATION IS TRUE AND CORRECT TO THE VEST OF MY KNOWLEDGE AND BELIEF." SURVEYS SOUTHWEST LTD. IS NOT RESPONSIBLE FOR ANY OF THE DESIGN CONCEPTS, CALCULATIONS, ENGINEERING, OR INTENT OF THE RECORD DRAWINGS.


Anthony L. Harris, NMPS 11463
DATE: 2-12-08

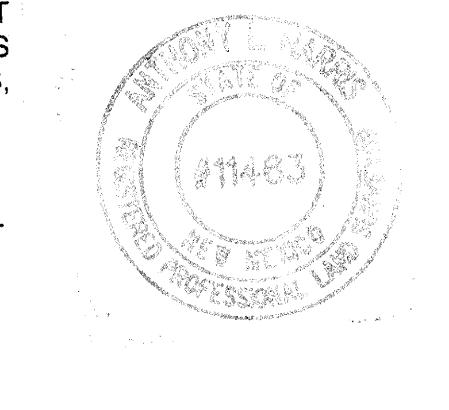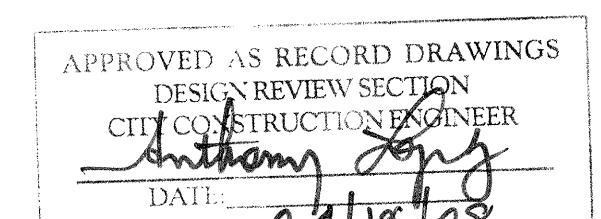

GENERAL NOTES

1. ALL WORK DETAILED ON THESE PLANS TO BE PERFORMED UNDER CONTRACT SHALL, EXCEPT AS OTHERWISE STATED OR PROVIDED FOR HEREON, BE CONSTRUCTED IN ACCORDANCE WITH THE CITY OF ALBUQUERQUE STANDARD SPECIFICATIONS FOR PUBLIC WORKS CONSTRUCTION 1986 EDITION AS AMENDED WITH UPDATE NO. 7, INCLUDING AMENDMENT 1.
2. ALL WORK ON THIS PROJECT SHALL BE PERFORMED IN ACCORDANCE WITH APPLICABLE FEDERAL, STATE, AND LOCAL LAWS, RULES, AND REGULATIONS CONCERNING CONSTRUCTION SAFETY AND HEALTH.
3. PRIOR TO CONSTRUCTION, THE CONTRACTOR SHALL EXCAVATE & VERIFY THE HORIZONTAL AND VERTICAL LOCATIONS OF ALL OBSTRUCTIONS. SHOULD A CONFLICT EXIST, THE CONTRACTOR SHALL NOTIFY THE ENGINEER SO THAT THE CONFLICT CAN BE RESOLVED WITH MINIMUM DELAY.
4. TWO (2) WORKING DAYS PRIOR TO ANY EXCAVATION, CONTRACTOR MUST CONTACT LINE LOCATING SERVICE, NM ONE CALL SYSTEMS, INC. @ 260-1994 FOR LOCATION OF EXISTING UTILITIES.
5. CONTRACTOR SHALL CONDUCT HIS OPERATIONS IN A MANNER WHICH WILL MINIMIZE INTERFERENCE WITH LOCAL TRAFFIC. CONTRACTOR SHALL COMPLY WITH ALL APPLICABLE LAWS, ORDINANCES, RULES, REGULATIONS, AND ORDERS OF ANY PUBLIC BODY HAVING JURISDICTION FOR THE SAFETY OF PERSONS OR PROPERTY, AND TO PROTECT THEM FROM DAMAGE, INJURY, OR LOSS. CONTRACTOR SHALL ERECT AND MAINTAIN, AS REQUIRED BY THE CONDITIONS AND PROGRESS OF THE WORK, ALL NECESSARY SAFEGUARDS FOR SAFETY CONTINUOUSLY AND NOT LIMITED TO NORMAL WORKING HOURS, THROUGHOUT THE DURATION OF THE PROJECT. CONTRACTOR SHALL ADHERE TO SECTION 19 OF THE GENERAL CONDITIONS OF THE CITY OF ALBUQUERQUE STANDARD SPECIFICATIONS FOR PUBLIC WORKS CONSTRUCTION, 1986, AS AMENDED WITH UPDATE NO. 7.
6. THE CONTRACTOR AGREES THAT HE SHALL ASSUME THE SOLE AND COMPLETE RESPONSIBILITY FOR THE JOB SITE CONDITIONS DURING THE COURSE OF CONSTRUCTION OF THIS PROJECT, INCLUDING SAFETY OF ALL PERSONS AND PROPERTY; THAT THIS REQUIREMENT SHALL APPLY CONTINUOUSLY AND NOT BE LIMITED TO NORMAL WORKING HOURS; AND THAT THE CONTRACTOR SHALL DEFEND, INDEMNIFY, AND HOLD HARMLESS THE OWNER & ENGINEER FROM ANY AND ALL LIABILITY REAL OR ALLEGED, IN CONNECTION WITH THE PERFORMANCE OF WORK ON THIS PROJECT, EXCEPTING LIABILITY ARISING FROM THE SOLE NEGLIGENCE OF THE OWNER OR ENGINEER.
7. TRAFFIC CONTROL: FIVE (5) WORKING DAYS PRIOR TO BEGINNING CONSTRUCTION THE CONTRACTOR SHALL SUBMIT TO THE CONSTRUCTION COORDINATION DIVISION A DETAILED CONSTRUCTION SCHEDULE. TWO (2) WORKING DAYS PRIOR TO CONSTRUCTION, THE CONTRACTOR SHALL OBTAIN A BARRICAADING PERMIT FROM THE CONSTRUCTION COORDINATION DIVISION. CONTRACTOR SHALL NOTIFY CONSTRUCTION COORDINATION ENGINEER (924-3400) PRIOR TO OCCUPYING AN INTERSECTION. SEE SECTION 19 OF THE SPECIFICATIONS. ALL STREET STRIPING ALTERED OR DESTROYED SHALL BE REPLACED WITH PLASTIC REFLECTORIZED PAVEMENT MARKINGS BY CONTRACTOR TO LOCATION AS EXISTING OR AS SHOWN IN THIS PLAN SET.
8. WHEN ABUTTING EXISTING PAVEMENT TO NEW, SAWCUT EXISTING PAVEMENT TO A STRAIGHT EDGE AND AT A RIGHT ANGLE, OR AS APPROVED BY THE FIELD ENGINEER. REMOVAL OF BROKEN OR CRACKED PAVEMENT WILL ALSO BE REQUIRED.
9. EXISTING CURB AND GUTTER NOT TO BE REMOVED UNLESS THE CONTRACT WHICH IS DAMAGED OR DISPLACED BY THE CONTRACTOR SHALL BE REMOVED AND REPLACED BY THE CONTRACTOR AT HIS EXPENSE.
10. ALL FINAL BACKFILL FOR TRENCHES SHALL BE COMPACTED TO A MINIMUM 95% MAXIMUM DENSITY PER ASTM D-1557 AND AS DIRECTED BY SECTION 701.14.2 AND STANDARD DRAWING NUMBER 2315.

DRB NO. 1004779
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Ph. 505-268-8828 Fax. 505-268-2632
1520CVR.dwg Jan 05,2007

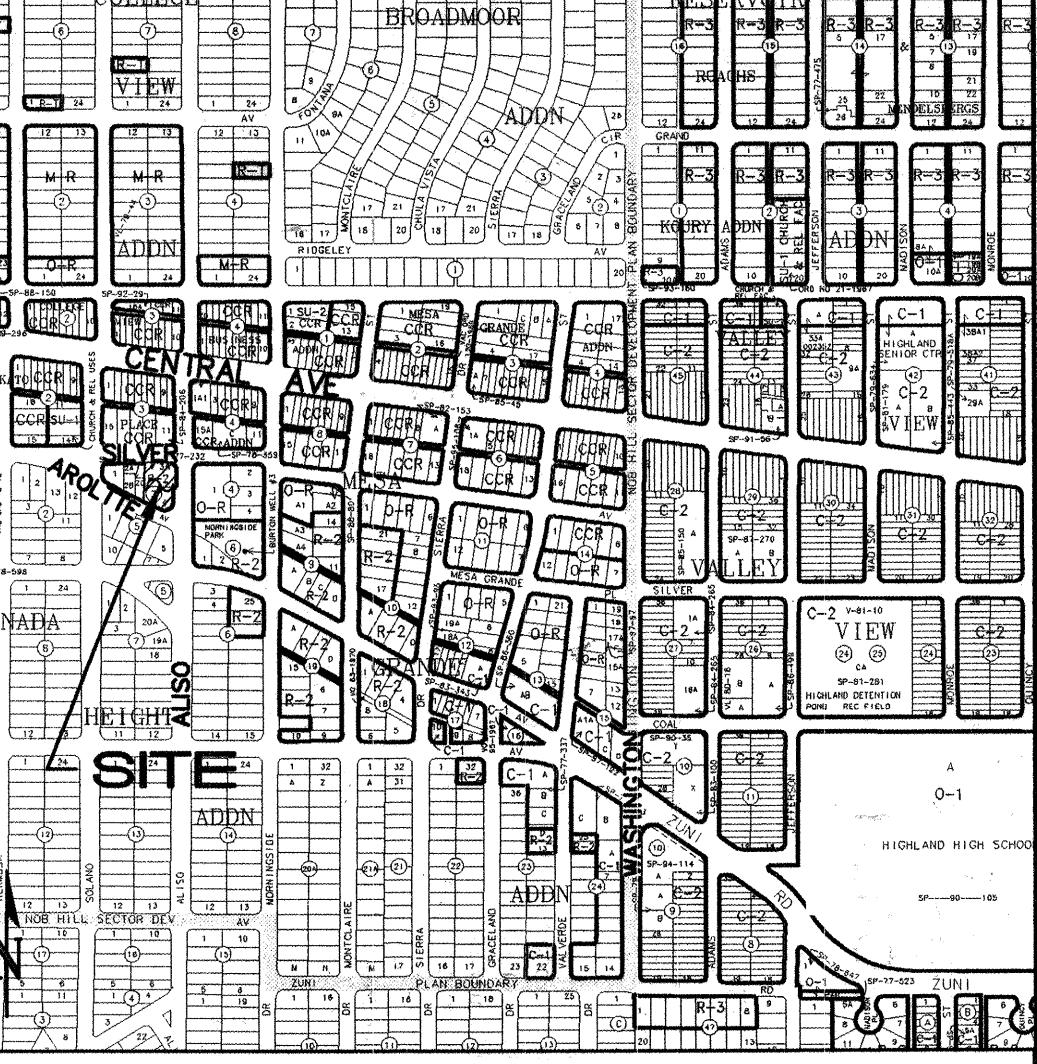

K-17-Z

VICINITY MAP

1"=750'±

20. CONTRACTOR SHALL MAINTAIN A GRAFFITI-FREE WORK SITE. CONTRACTOR SHALL PROMPTLY REMOVE ANY AND ALL GRAFFITI FROM EQUIPMENT, WHETHER PERMANENT OR TEMPORARY.
21. THE CONTRACTOR WILL BE RESPONSIBLE FOR DISPOSING OF ALL DEBRIS, INCLUDING, NOT LIMITED TO HAZARDOUS WASTE, AT DISPOSAL SITES APPROVED BY GOVERNMENTAL AGENCIES REGULATING THE DISPOSAL OF SUCH MATERIALS.
22. TACK COAT FOR SURFACE COURSE REQUIREMENTS WILL BE DETERMINED BY THE ENGINEER.
23. PERMANENT PAVEMENT STRIPING AND MARKINGS WILL BE PLACED BY THE CONTRACTOR. THE ROAD SHALL NOT BE OPENED TO THE TRAFFIC UNTIL IT IS STRIPED. ALL STRIPING, PAVEMENT MARKINGS INCLUDING CROSSWALKS, ARROWS AND LINE MARKINGS ARE TO BE CONSTRUCTED OF HOT PLASTIC OR COLD PLASTIC IN ACCORDANCE WITH THE MANUAL OF UNIFORM TRAFFIC CONTROL DEVICES.
24. ELECTRONIC MARKER DISKS (EMD) WILL BE PLACED ACCORDING TO SECTION 170 OF THE CITY OF ALBUQUERQUE SPECIFICATIONS FOR PUBLIC WORKS CONSTRUCTION, 1986 EDITION AS REVISED THROUGH UPDATE #7.
25. ALL WATER VALVE BOXES AND MANHOLES IN THE STREET CONSTRUCTION ARE TO BE ADJUSTED TO FINISH GRADE AND WILL BE MEASURED AND PAID PER EACH.
26. CONTRACTOR SHALL SUPPORT ALL EXISTING, UNDERGROUND UTILITY LINES WHICH BECOME EXPOSED DURING CONSTRUCTION. PAYMENT FOR SUPPORTING WORK SHALL BE INCIDENTAL TO WATERLINE AND/OR SEWER LINE COSTS.
27. CONTRACTOR SHALL ASSIST THE ENGINEER/INSPECTOR IN THE RECORDING OF DATA ON ALL UTILITY LINES AND ACCESSORIES AS REQUIRED BY THE CITY OF ALBUQUERQUE FOR THE PREPARATION OF RECORD DRAWINGS. CONTRACTOR SHALL NOT COVER UTILITY LINES AND ACCESSORIES UNTIL ALL DATA HAS BEEN RECORDED.
28. CONTRACTOR WILL BE RESPONSIBLE FOR PROVIDING AND MAINTAINING ALL CONSTRUCTION SIGNING UNTIL PROJECT HAS BEEN ACCEPTED BY THE CITY.


REV.	Sheets	CITY ENGINEER	DATE	USER DEPARTMENT	DATE	USER DEPARTMENT	DATE
ENGINEERS STAMP & SIGNATURE		APPROVALS	ENGINEER	*****			
		DRC Chairman		2-13-07			
		Transportation		11/30/07			
		Water/Wastewater		11/17/07			
		Hydrology		11/22/07			
		Constr. Mgmt.		11/22/07			
		Constr. Coord.		11/22/07			
		City Project No.		757482		Sheet	1 of 10

CANNED BY
PLANNING

**PLAT OF
LOT 3A-1, BLOCK 3
GRANADA HEIGHTS
SITUATE WITHIN SECTION 23,
T. 10N., R. 3 E., N.M.P.M.
CITY OF ALBUQUERQUE
BERNALILLO COUNTY, NEW MEXICO**


AUGUST 2006
SHEET 2 OF 2

SATION: 6 1/17
X = 394.155.831
Y = 48.155.831
GROUND TO GRID = 0.98966413
DELTA ALPHA = -0.1212
NEW MEXICO STATE PLANE
CENTRAL ZONE
NAD 1927

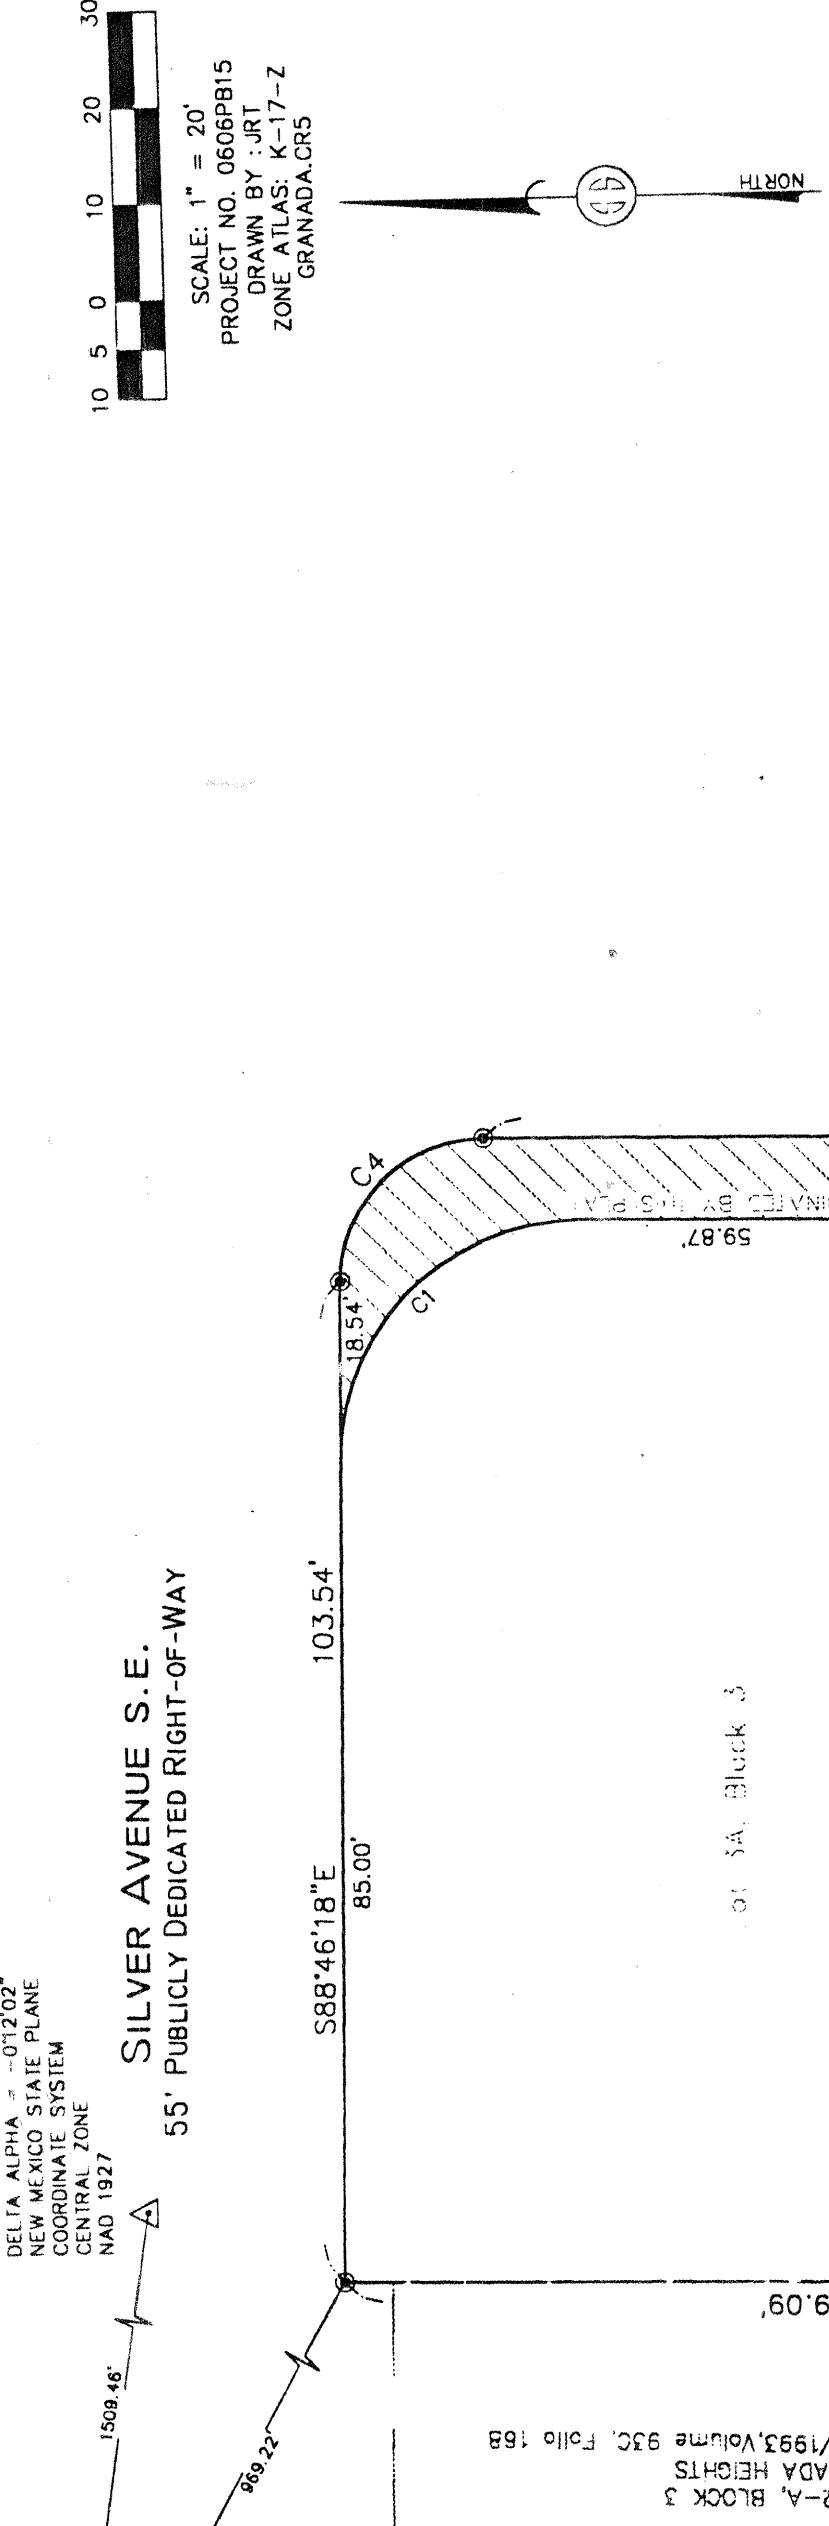

GENERAL NOTES

- A. PERMITS AND CODES:
1. CONTRACTOR RESPONSIBLE FOR ALL STATE AND LOCAL PERMITS AND SUBMITTALS REQUIRED, THIS INCLUDES BUT IS NOT LIMITED TO STRUCTURAL, ELECTRICAL, MECHANICAL, AND UTILITY HOOK-UPS. CONTRACTOR IS RESPONSIBLE FOR FOLLOWING GUIDELINES SET FORTH IN THE 1991 UBC AND ANSI I.I.I-1998.
2. ELECTRICAL WIRING METHODS AND MATERIALS SHALL MEET THE PROVISIONS OF THE NATIONAL ELECTRICAL CODE AND NEW MEXICO ELECTRICAL CODE AND OTHER APPLICABLE CODES OR STANDARDS.
3. PLUMBING SHALL MEET ALL PROVISIONS OF THE UNIFORM PLUMBING CODE, UNIFORM MECHANICAL CODE, AND THE NEW MEXICO PLUMBING AND MECHANICAL CODE AND OTHER APPLICABLE CODES OR STANDARDS.
4. IF THERE ARE ANY CONFLICTS BETWEEN INFORMATION PROVIDED IN THESE DOCUMENTS, THE ARCHITECT IS TO BE NOTIFIED IMMEDIATELY.
- B. OPTIONS AND MODIFICATIONS:
ANY MODIFICATIONS AND CHANGES SHOULD BE REVIEWED BY THE ARCHITECT. NO STRUCTURAL CHANGES SHALL BE MADE WITHOUT THE WRITTEN CONSENT OF THE ARCHITECT.
- C. CONCRETE & STEM WALLS:
ALL CONCRETE TO BE MINIMUM 3000 PSI.
- D. SITE:
1. CARE SHOULD BE TAKEN TO MINIMIZE DAMAGE TO EXISTING TREES, GRADE, AND FOLIAGE AROUND BUILDING FOOTPRINT.
2. SITE TO BE KEPT CLEAN AND SAFE AT ALL TIMES, TRASH IS TO BE CONTAINED AND HAULED OFF WEEKLY, RECYCLE AS MUCH SCRAP AND PACKAGING AS POSSIBLE.
3. RE-GRADE AROUND BUILDING TO ENHANCE FREE DRAINAGE AWAY FROM BUILDING, FINAL GRADING TO BE RAKED CLEAN.
4. CONTRACTOR IS RESPONSIBLE FOR ALL UTILITY HOOK-UPS TO THE BUILDINGS, THIS INCLUDES WATER, ELECTRICITY, PHONE LINES (SPR MIN), & CABLE TV.

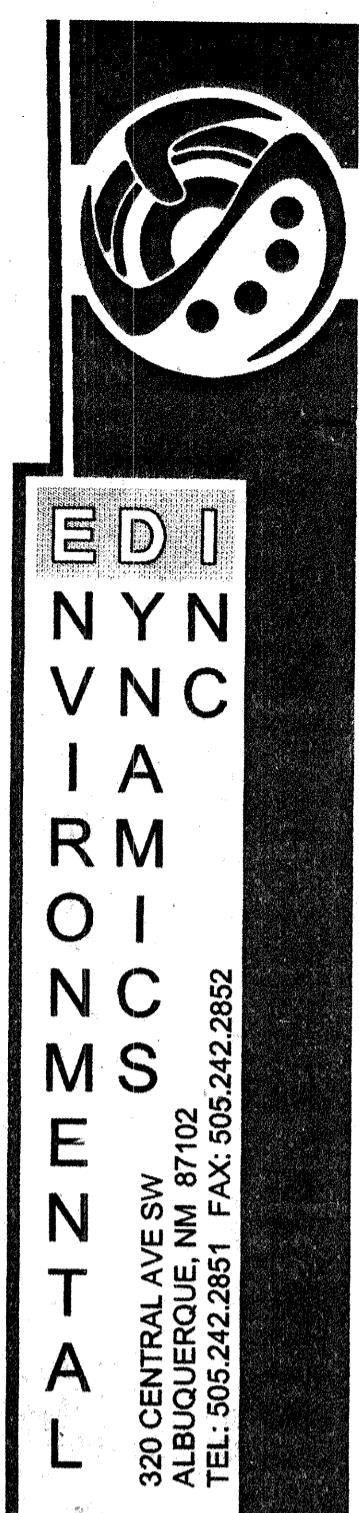

ALISO II
201 ALISO SE
ALBUQUERQUE NM 87108

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ISSUE:
CONSTRUCTION DOCUMENTS

DRAWN: OVT
CHECKED: MFR
DATE: 10.20.06

REVISIONS
BLDG DEPT COMMENTS
11-5-06 (in process)
BLDG DEPT COMMENTS
11-26-06


SITE PLAN

0546

AS101

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SILVER AVE, SE

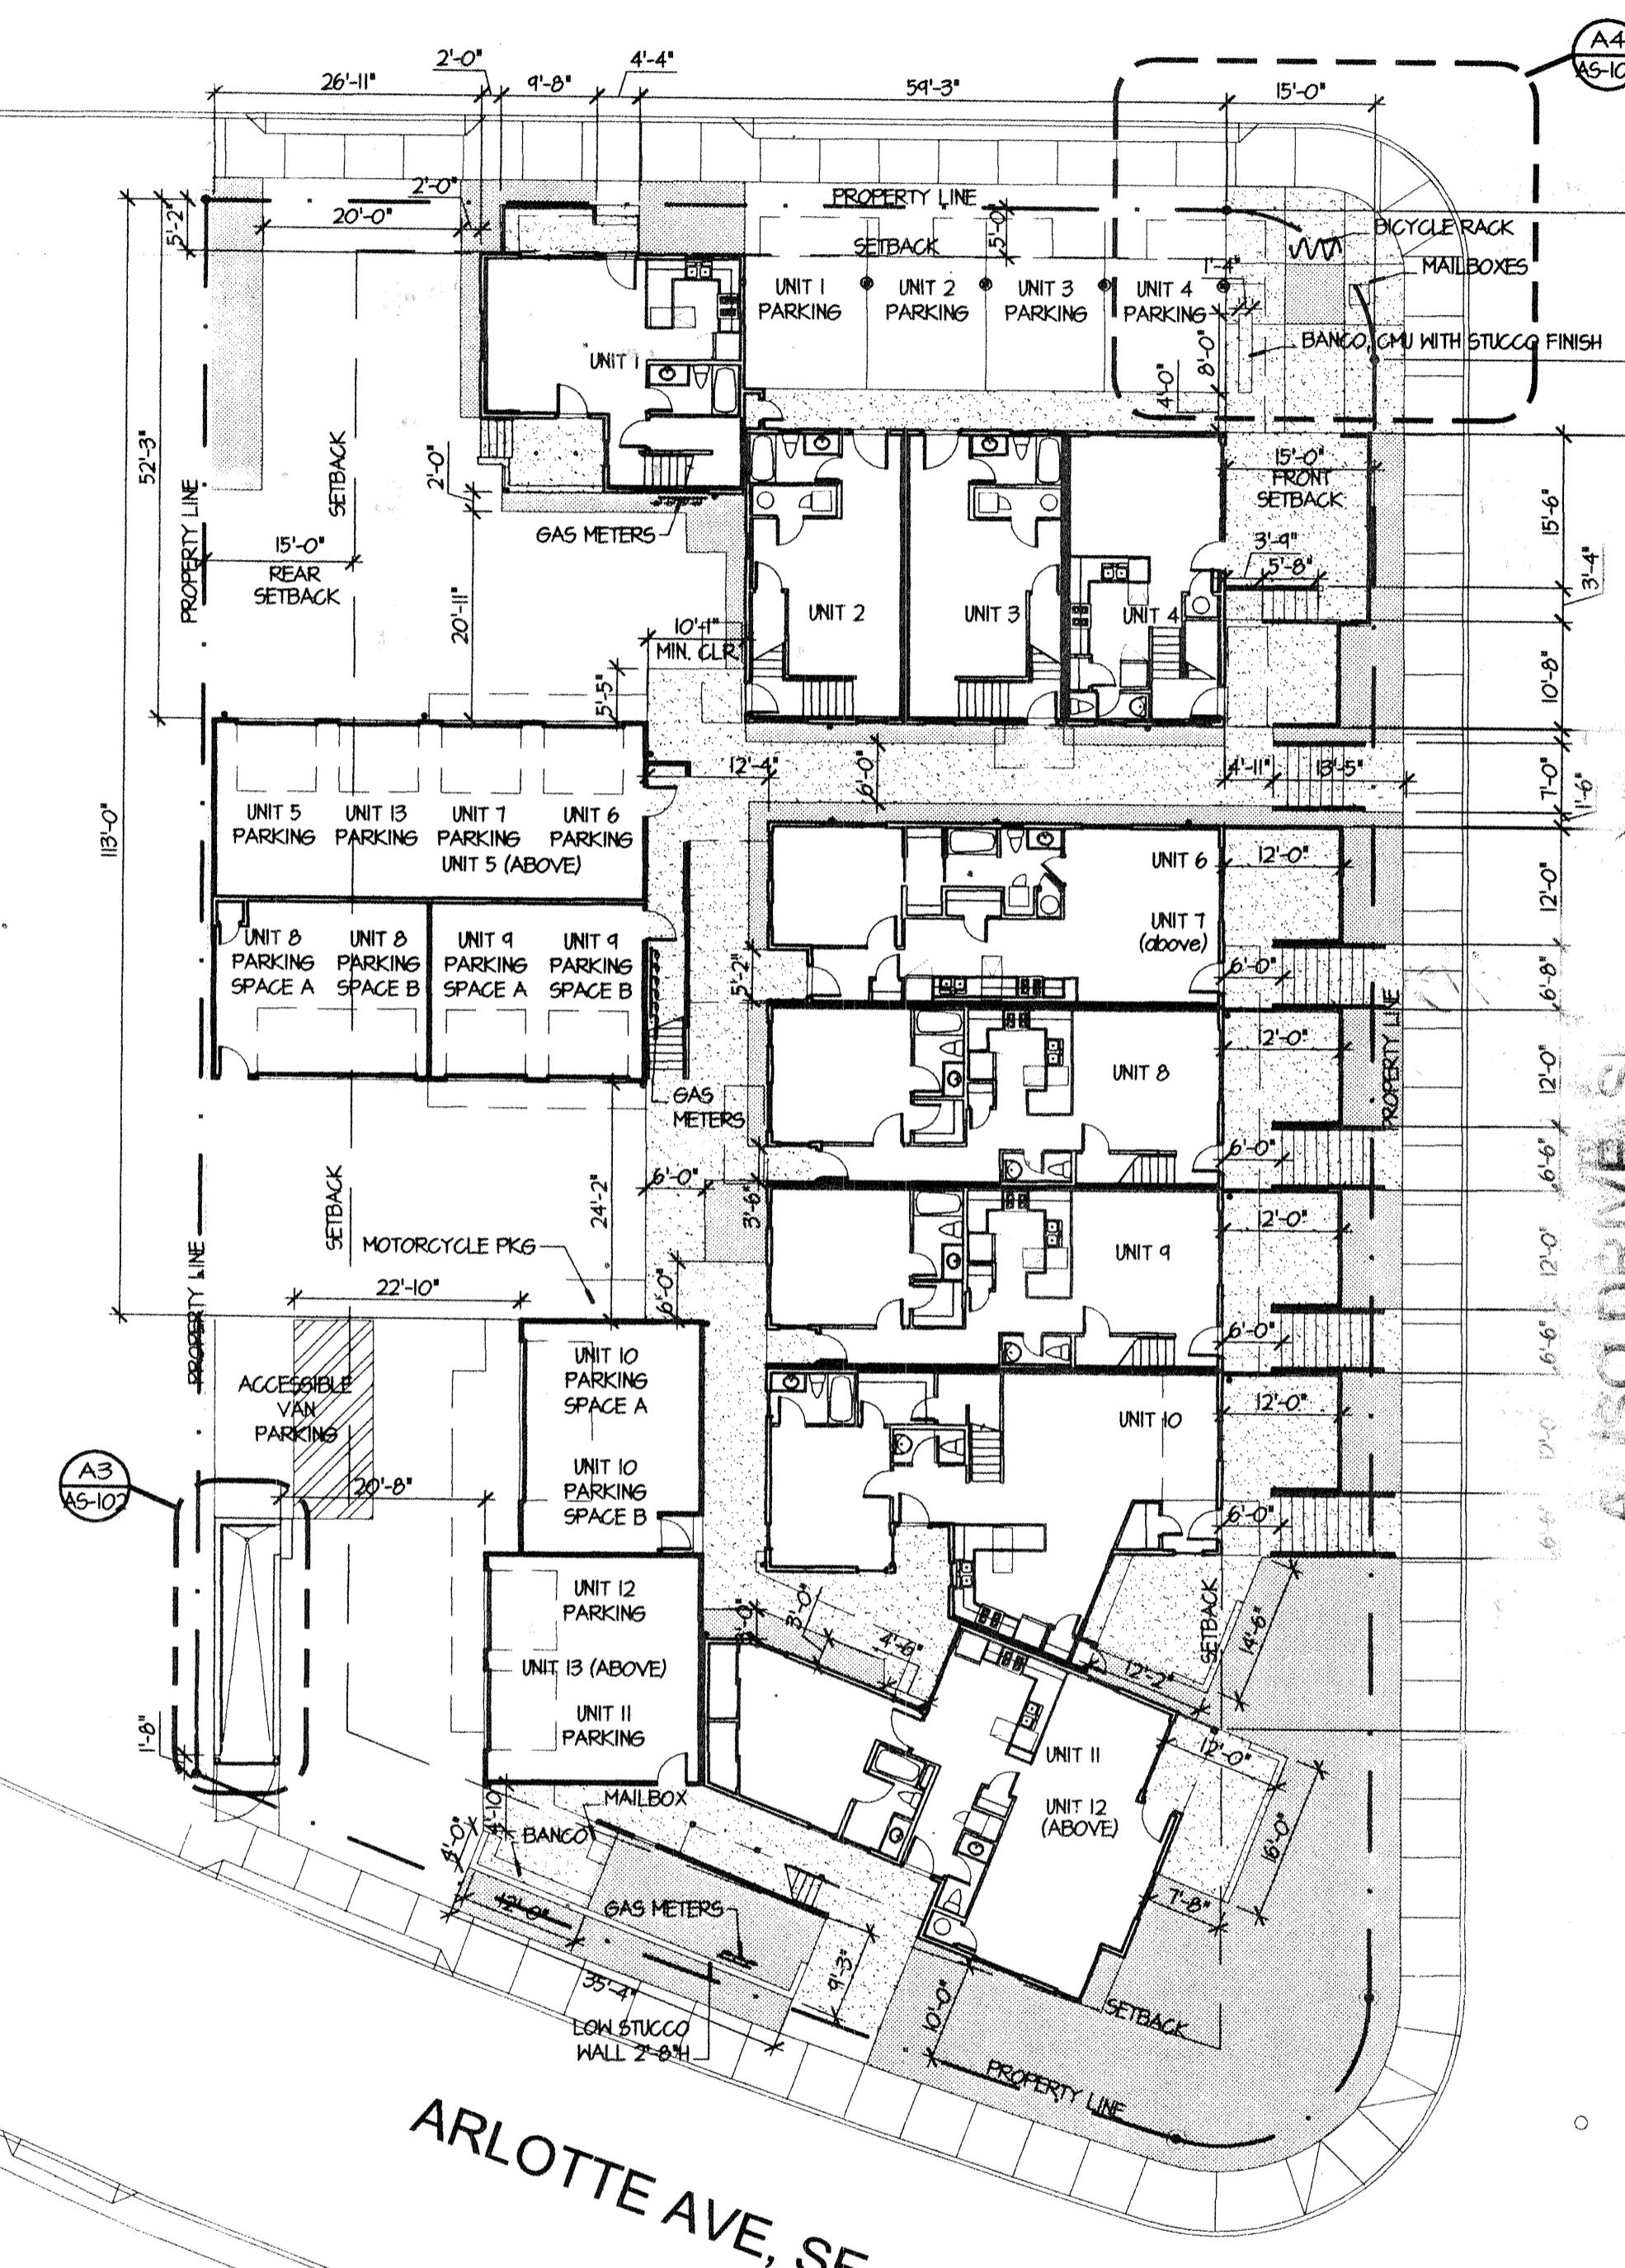

LEGEND

PLANTED AREA (SEE LANDSCAPE PLAN)

ONSITE EXTERIOR CONCRETE



ASPHALT

A1 SITE PLAN - 13 units

1/16"=1'-0"

FOR INFO
ONLY

SHEET 3 OF 10

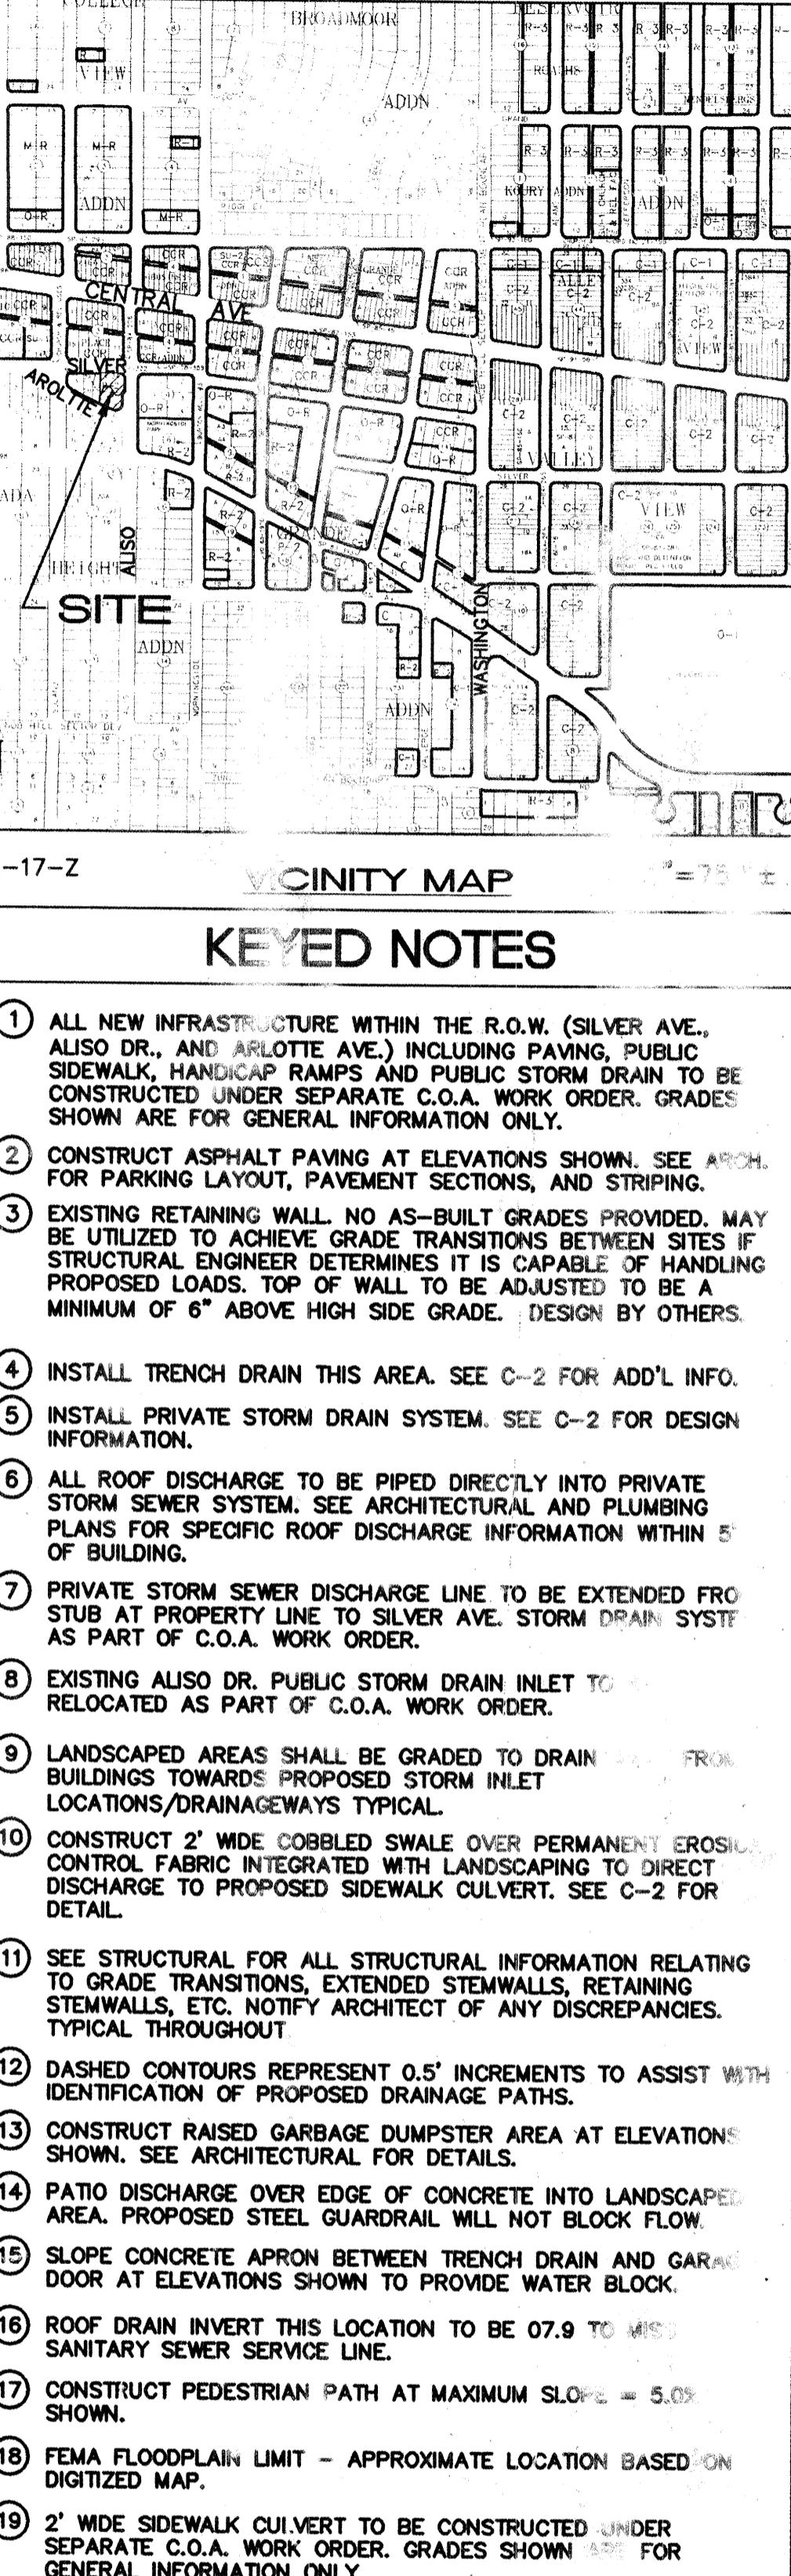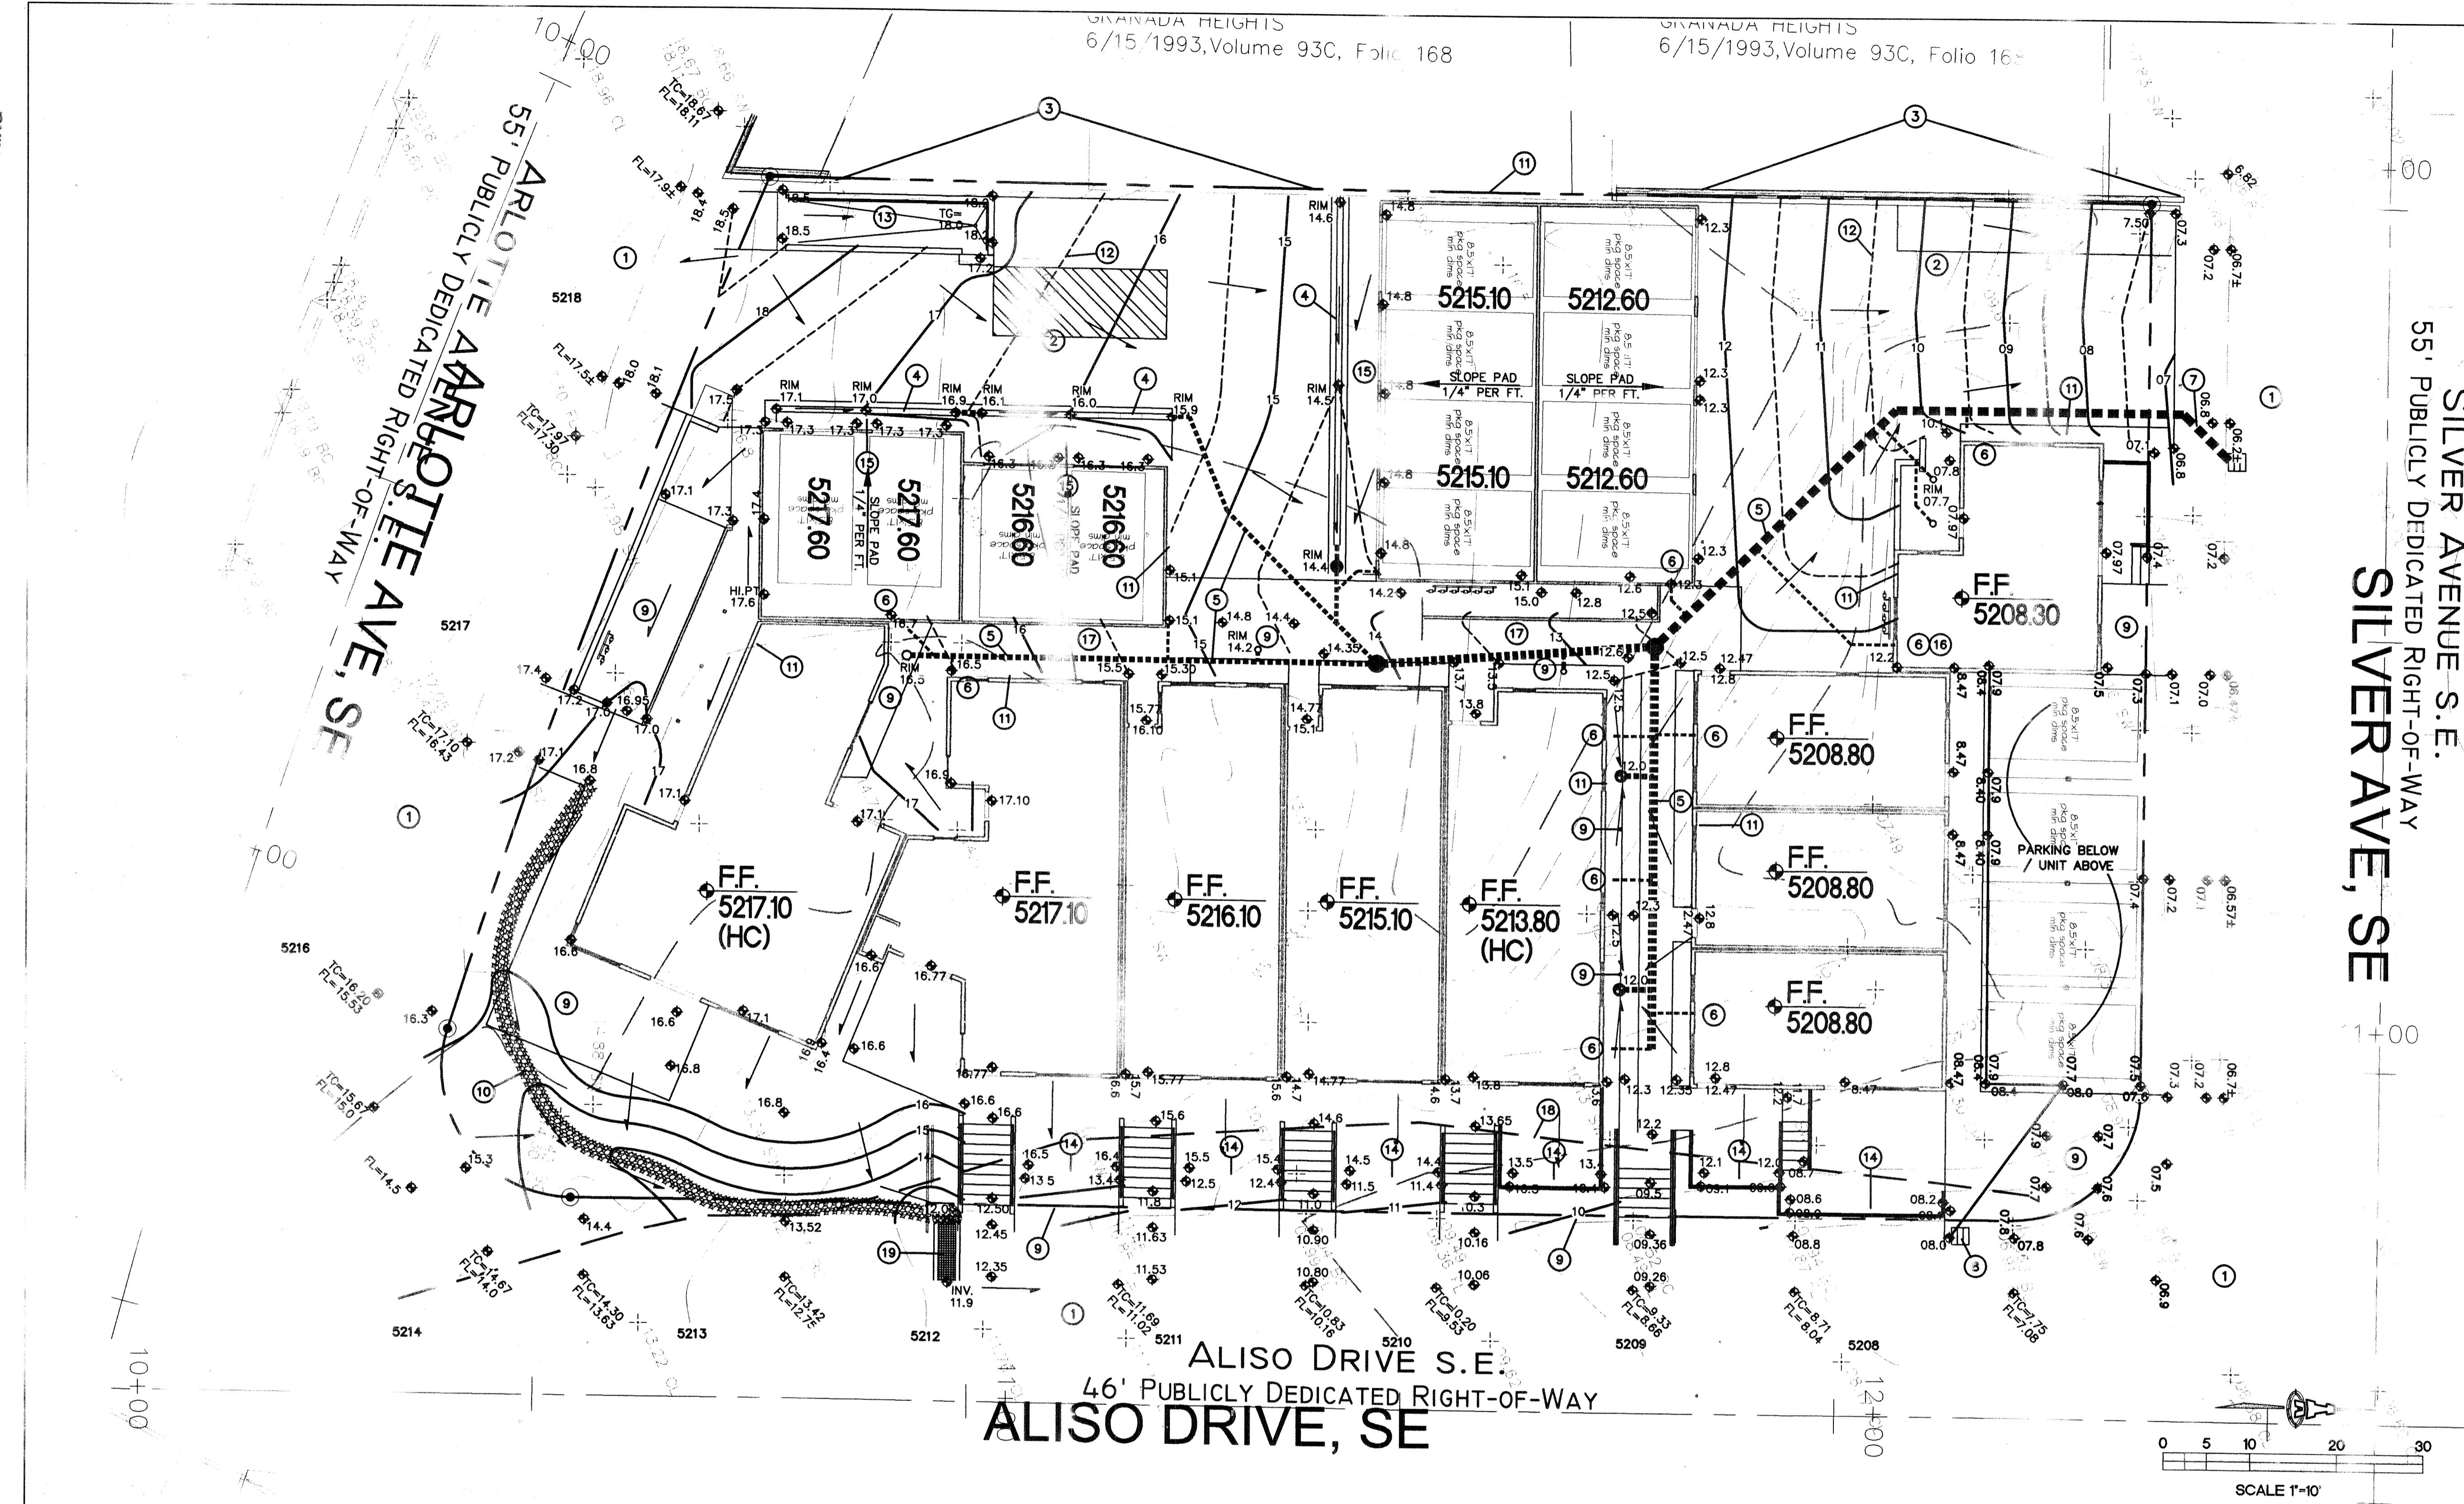

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Ph. 505-268-8828 Fax. 505-268-2632
1520GRD.dwg Nov 15, 2006

**ALISO LOFTS
PHASE II**

ENVIRONMENTAL DYNAMICS


DRAINAGE AND GRADING PLAN

Date:	No. Revision	Date	Job No.
10.16.06			1520
Drawn By			C-1
BJB			
Ok'd By			
FCA			


**FOR INFO
ONLY**

SHEET 4- OF 10

M:\ACTIVE\LD 2000\1520\dwg\1520PMSTR.dwg, 1/26/2007 2:11:09 PM

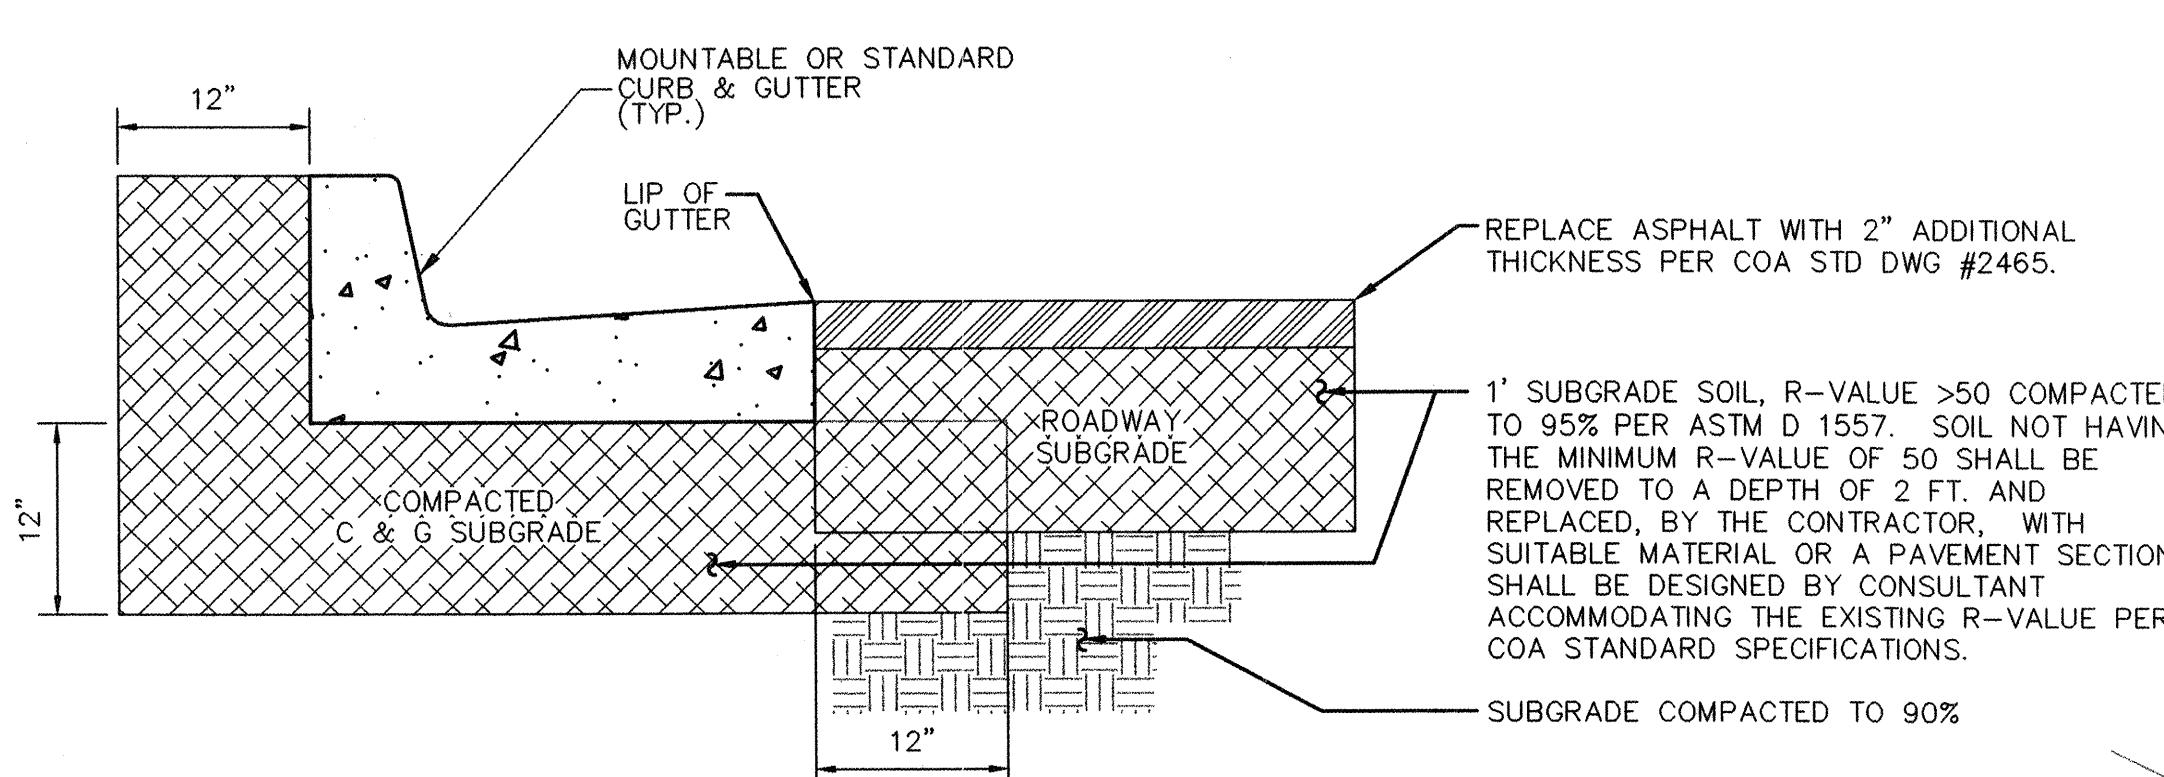

RESIDENTIAL PAVING SECTION

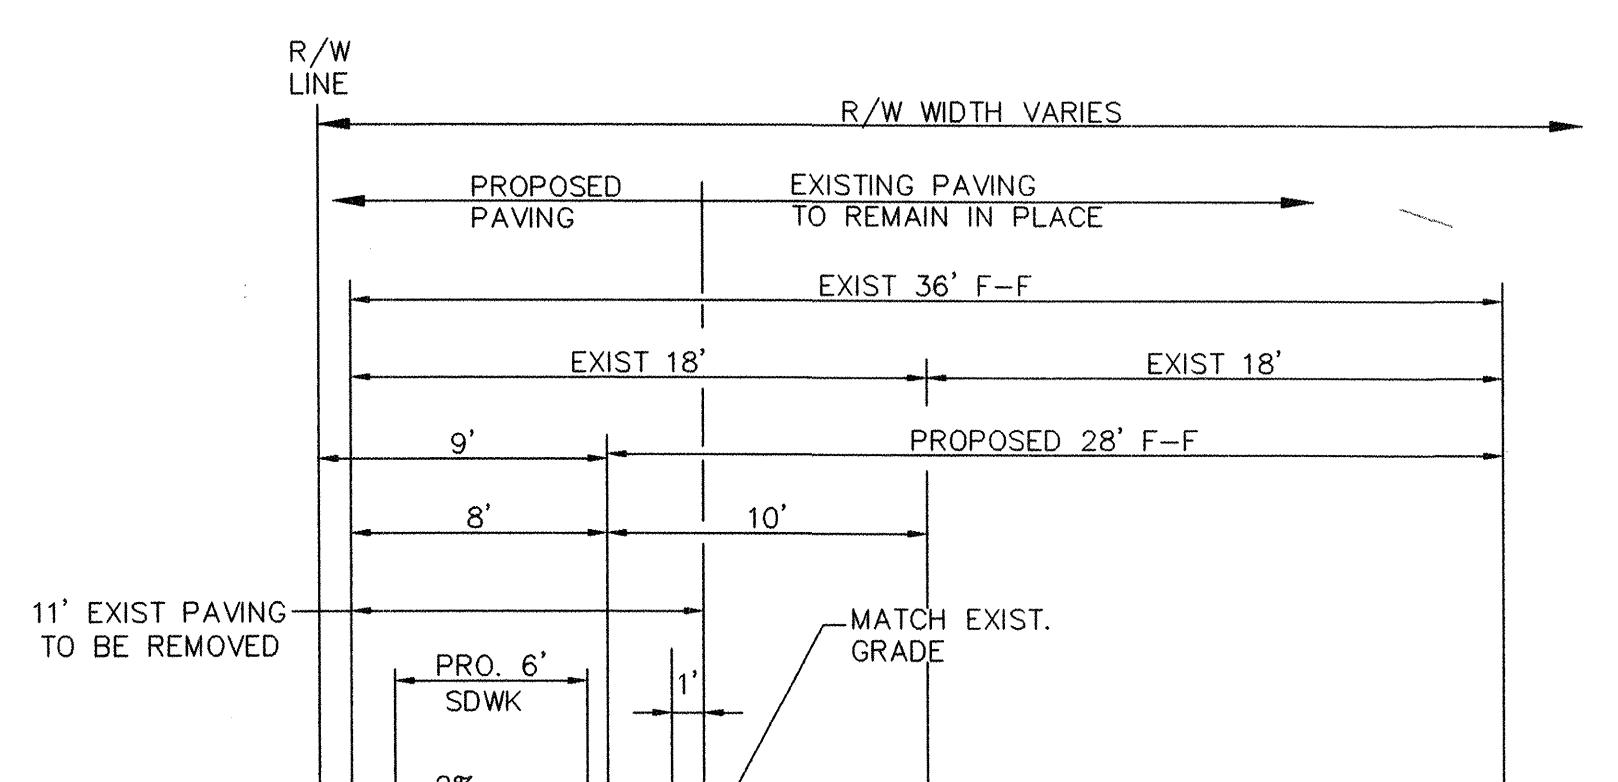


REMOVE & DISPOSE OF EXIST. ASPHALT, CURB & GUTTER AND SIDEWALK.

NEATLY SAWCUT, REMOVE & DISPOSE OF EXIST. PAVING.


RESIDENTIAL PAVING SECTION PER SECTION THIS SHEET

STANDARD CURB & GUTTER PER COA STD DWG #2415A.

ALISO DR.
SECTION A-A
SCALE: 1"=6'

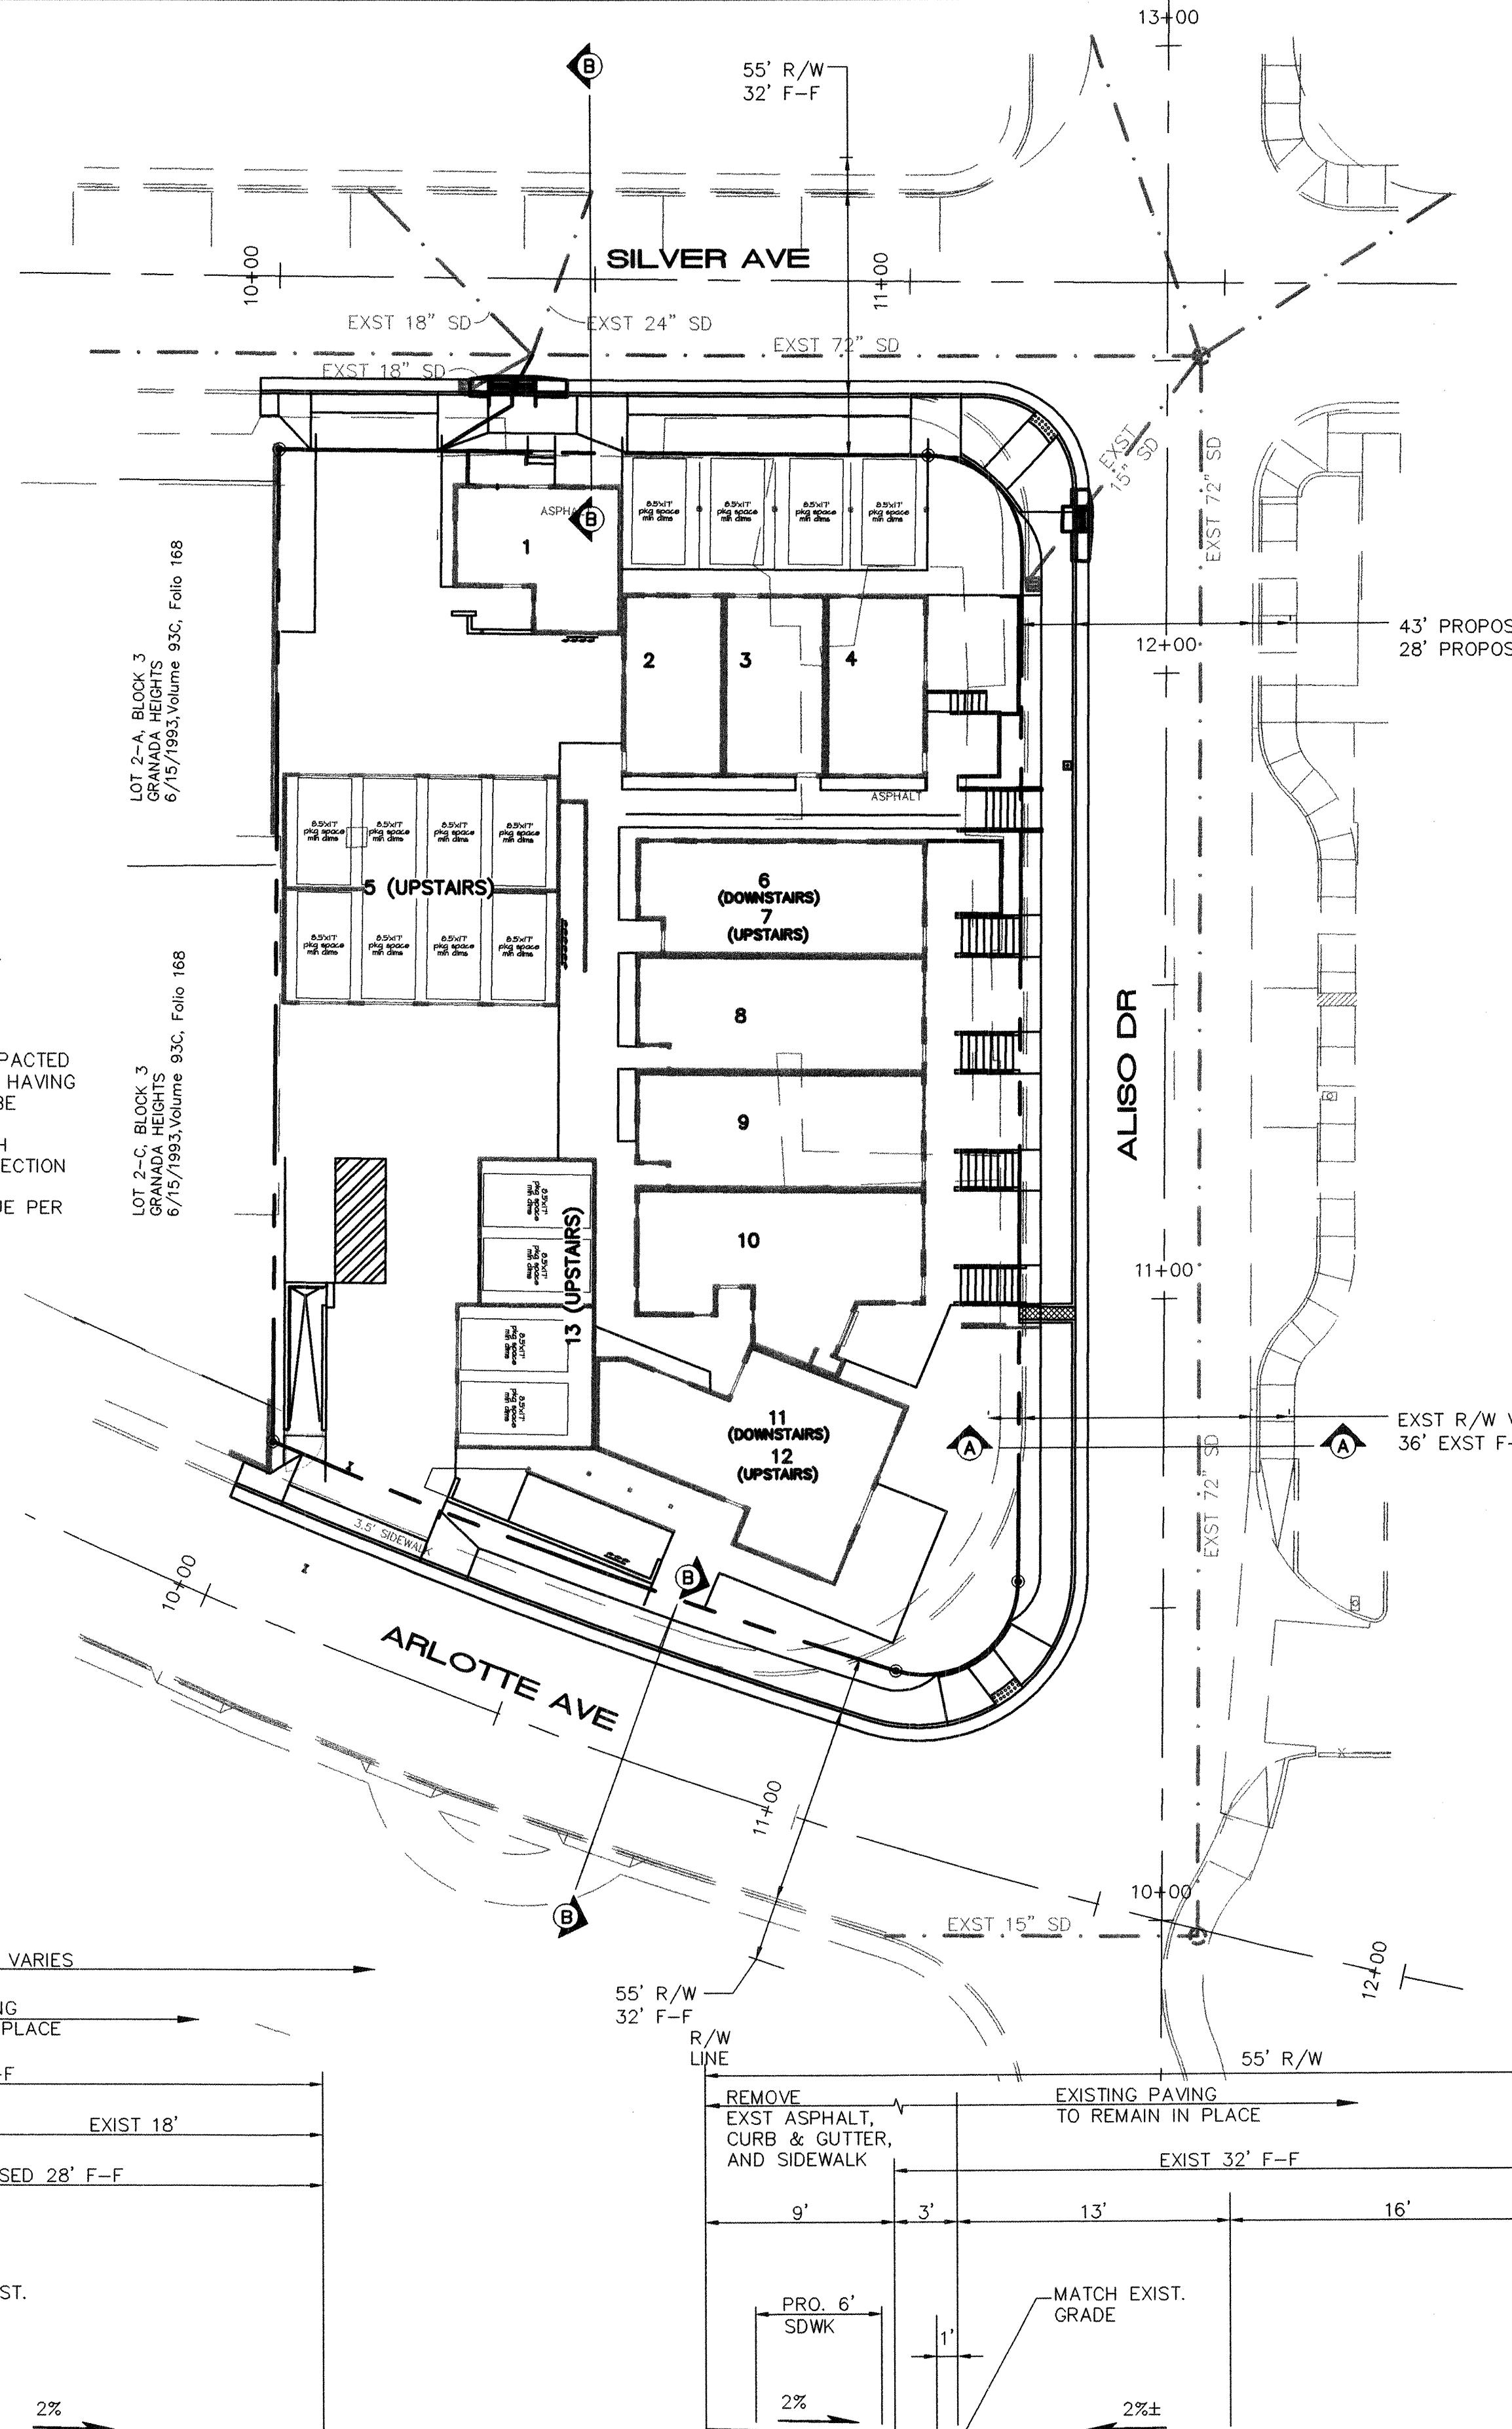


SILVER AVE. & ALOTTE DR.
SECTION B-B
SCALE: 1"=6'

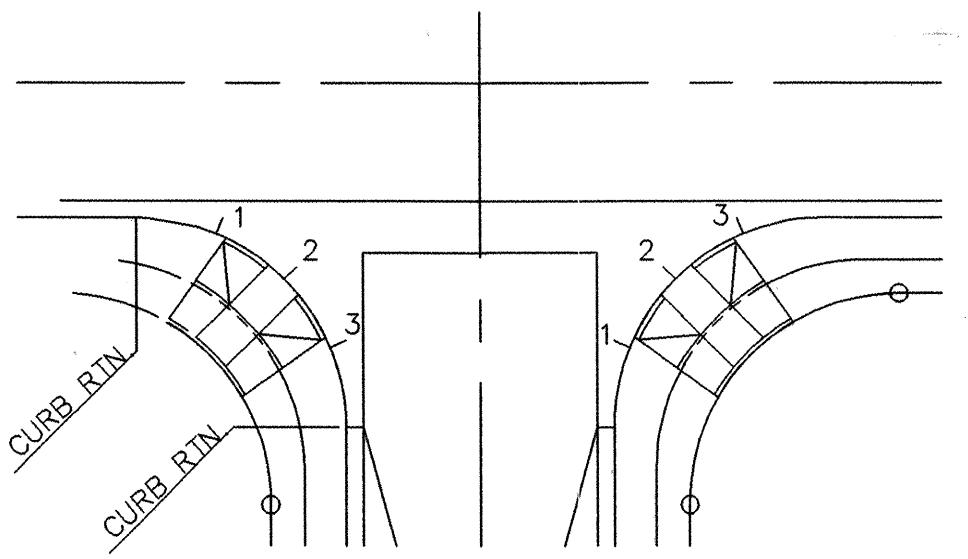


NOTE:
QUARTER POINT GRADES ARE REFERENCED AS 1, 2 & 3
ALONG THE FACE OF CURB IN A CLOCKWISE DIRECTION.

QUARTER POINT DETAIL

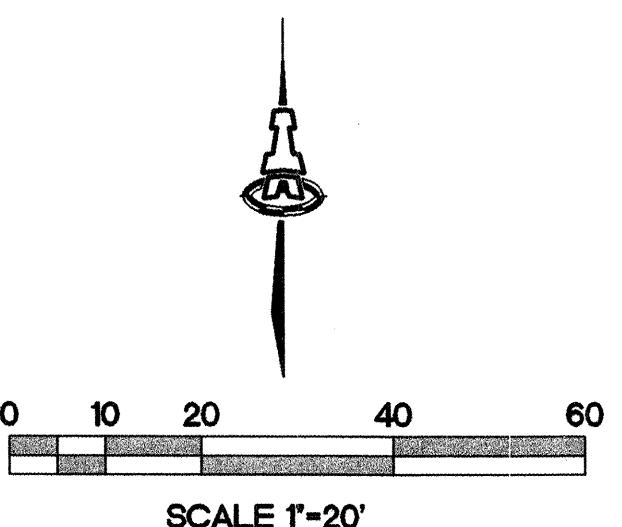

LEGEND

	EXISTING STREET IMPROVEMENTS
	PROPOSED STREET IMPROVEMENTS
	<p>WHEEL CHAIR RAMP</p> <p>PROPOSED STORM DRAIN CATCH BASIN</p> <p>PROPOSED STORM DRAIN MANHOLE</p> <p>PROPOSED SIDEWALK</p> <p>EXISTING STORM DRAIN</p> <p>EXISTING STORM DRAIN MANHOLE</p> <p>EXISTING STORM DRAIN INLET</p> <p>PROPOSED SIDEWALK CULVERT</p>

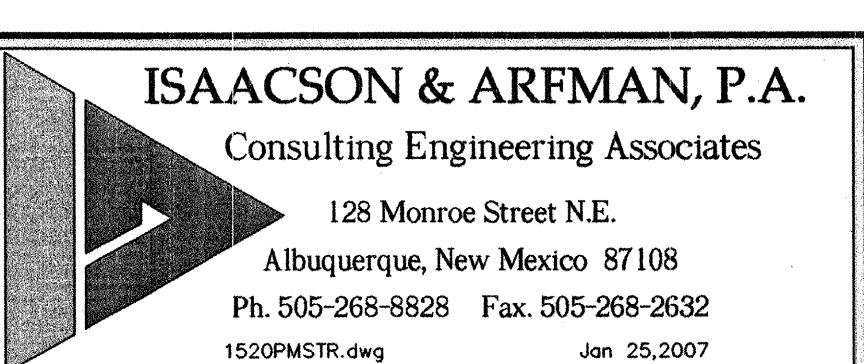


CITY OF ALBUQUERQUE
PUBLIC WORKS DEPARTMENT
ENGINEERING GROUP


ALISO LOFTS PHASE II

LOT 2-C, BLOCK 3
GRANADA HEIGHTS
6/15/1993, Volume 93C, Folio 168

LOT 2-A, BLOCK 3
GRANADA HEIGHTS
6/15/1993, Volume 93C, Folio 168

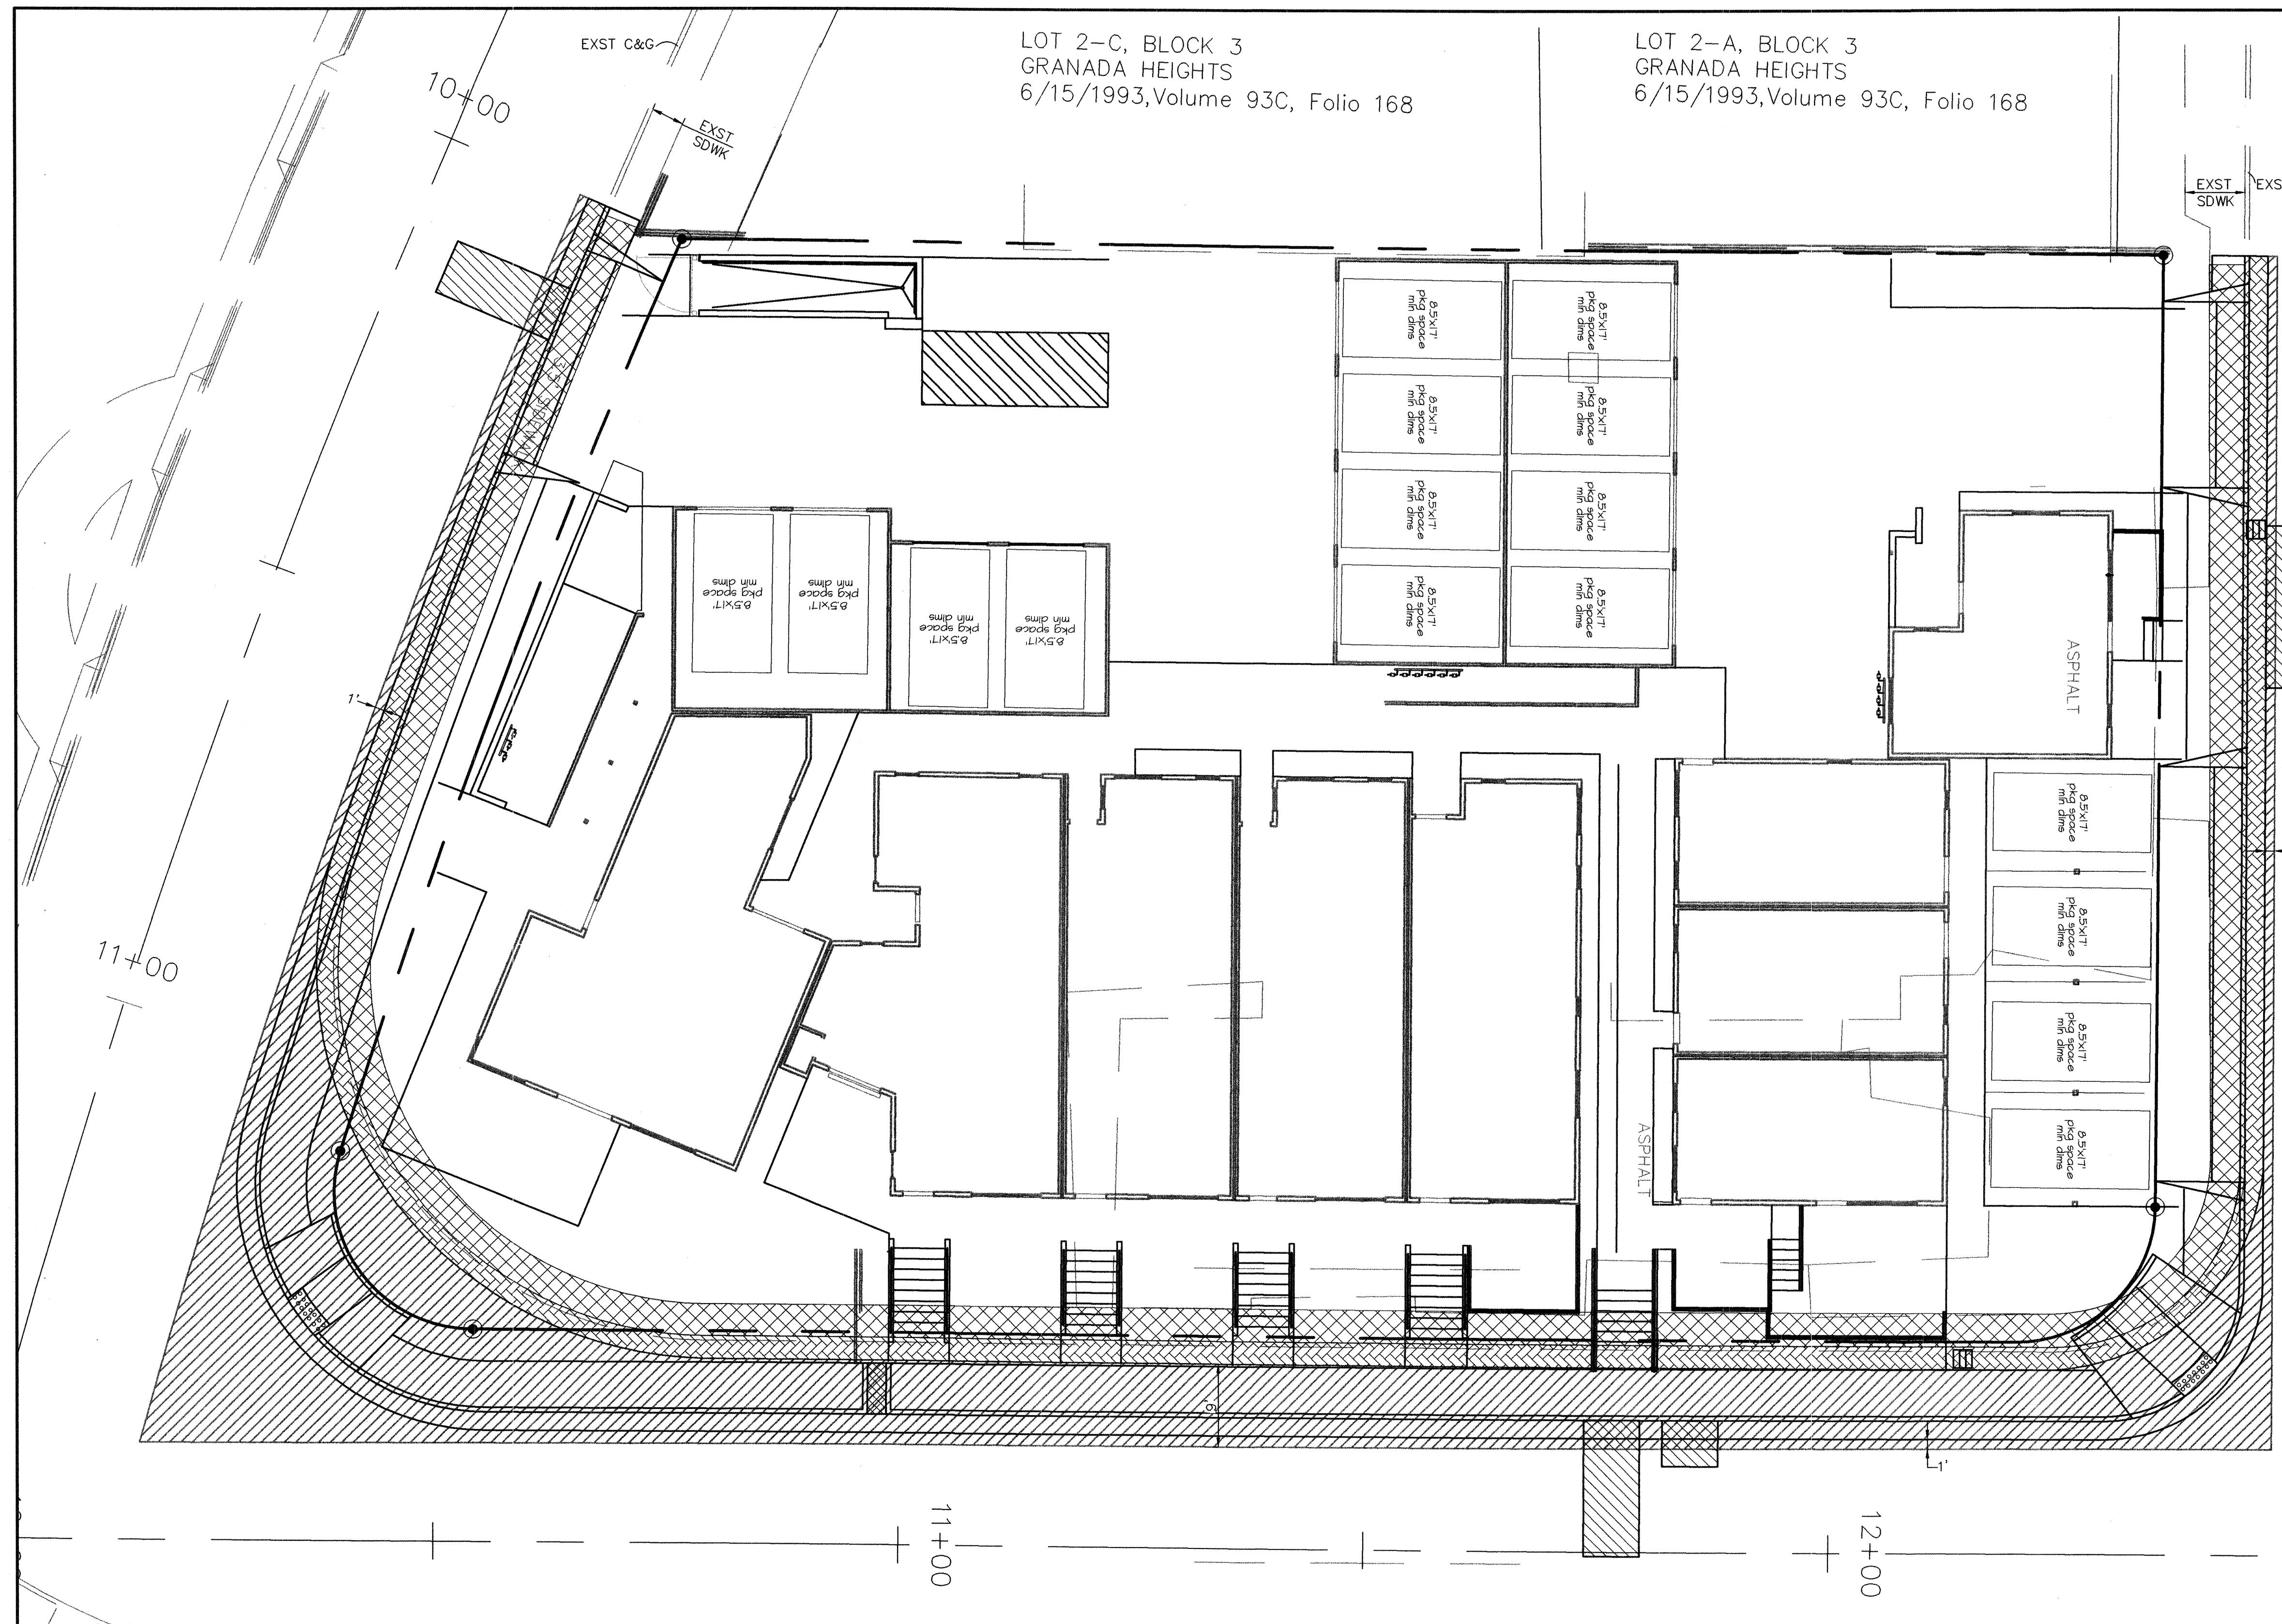

LEGEND

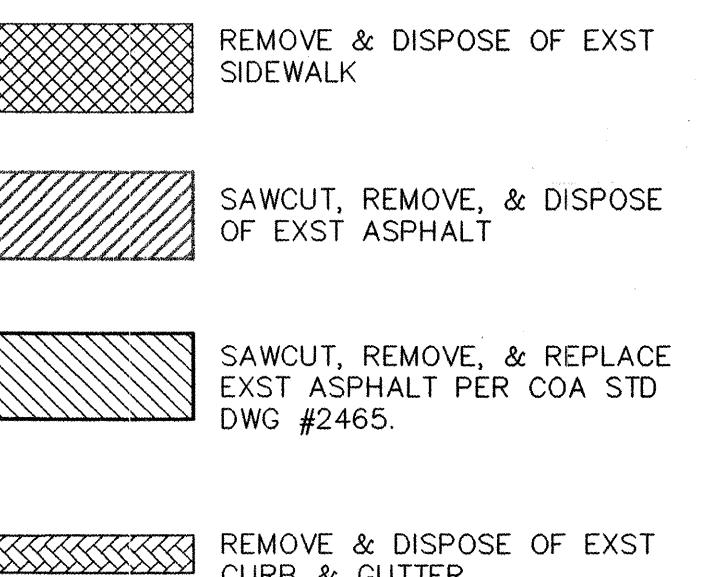

AACSON & ARFMAN, P.A.


Consulting Engineering Associates


128 Monroe Street N.E.
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CITY OF ALBUQUERQUE
PUBLIC WORKS DEPARTMENT
ENGINEERING GROUP

ALISO LOFTS PHASE II


PAVING REMOVAL PLAN

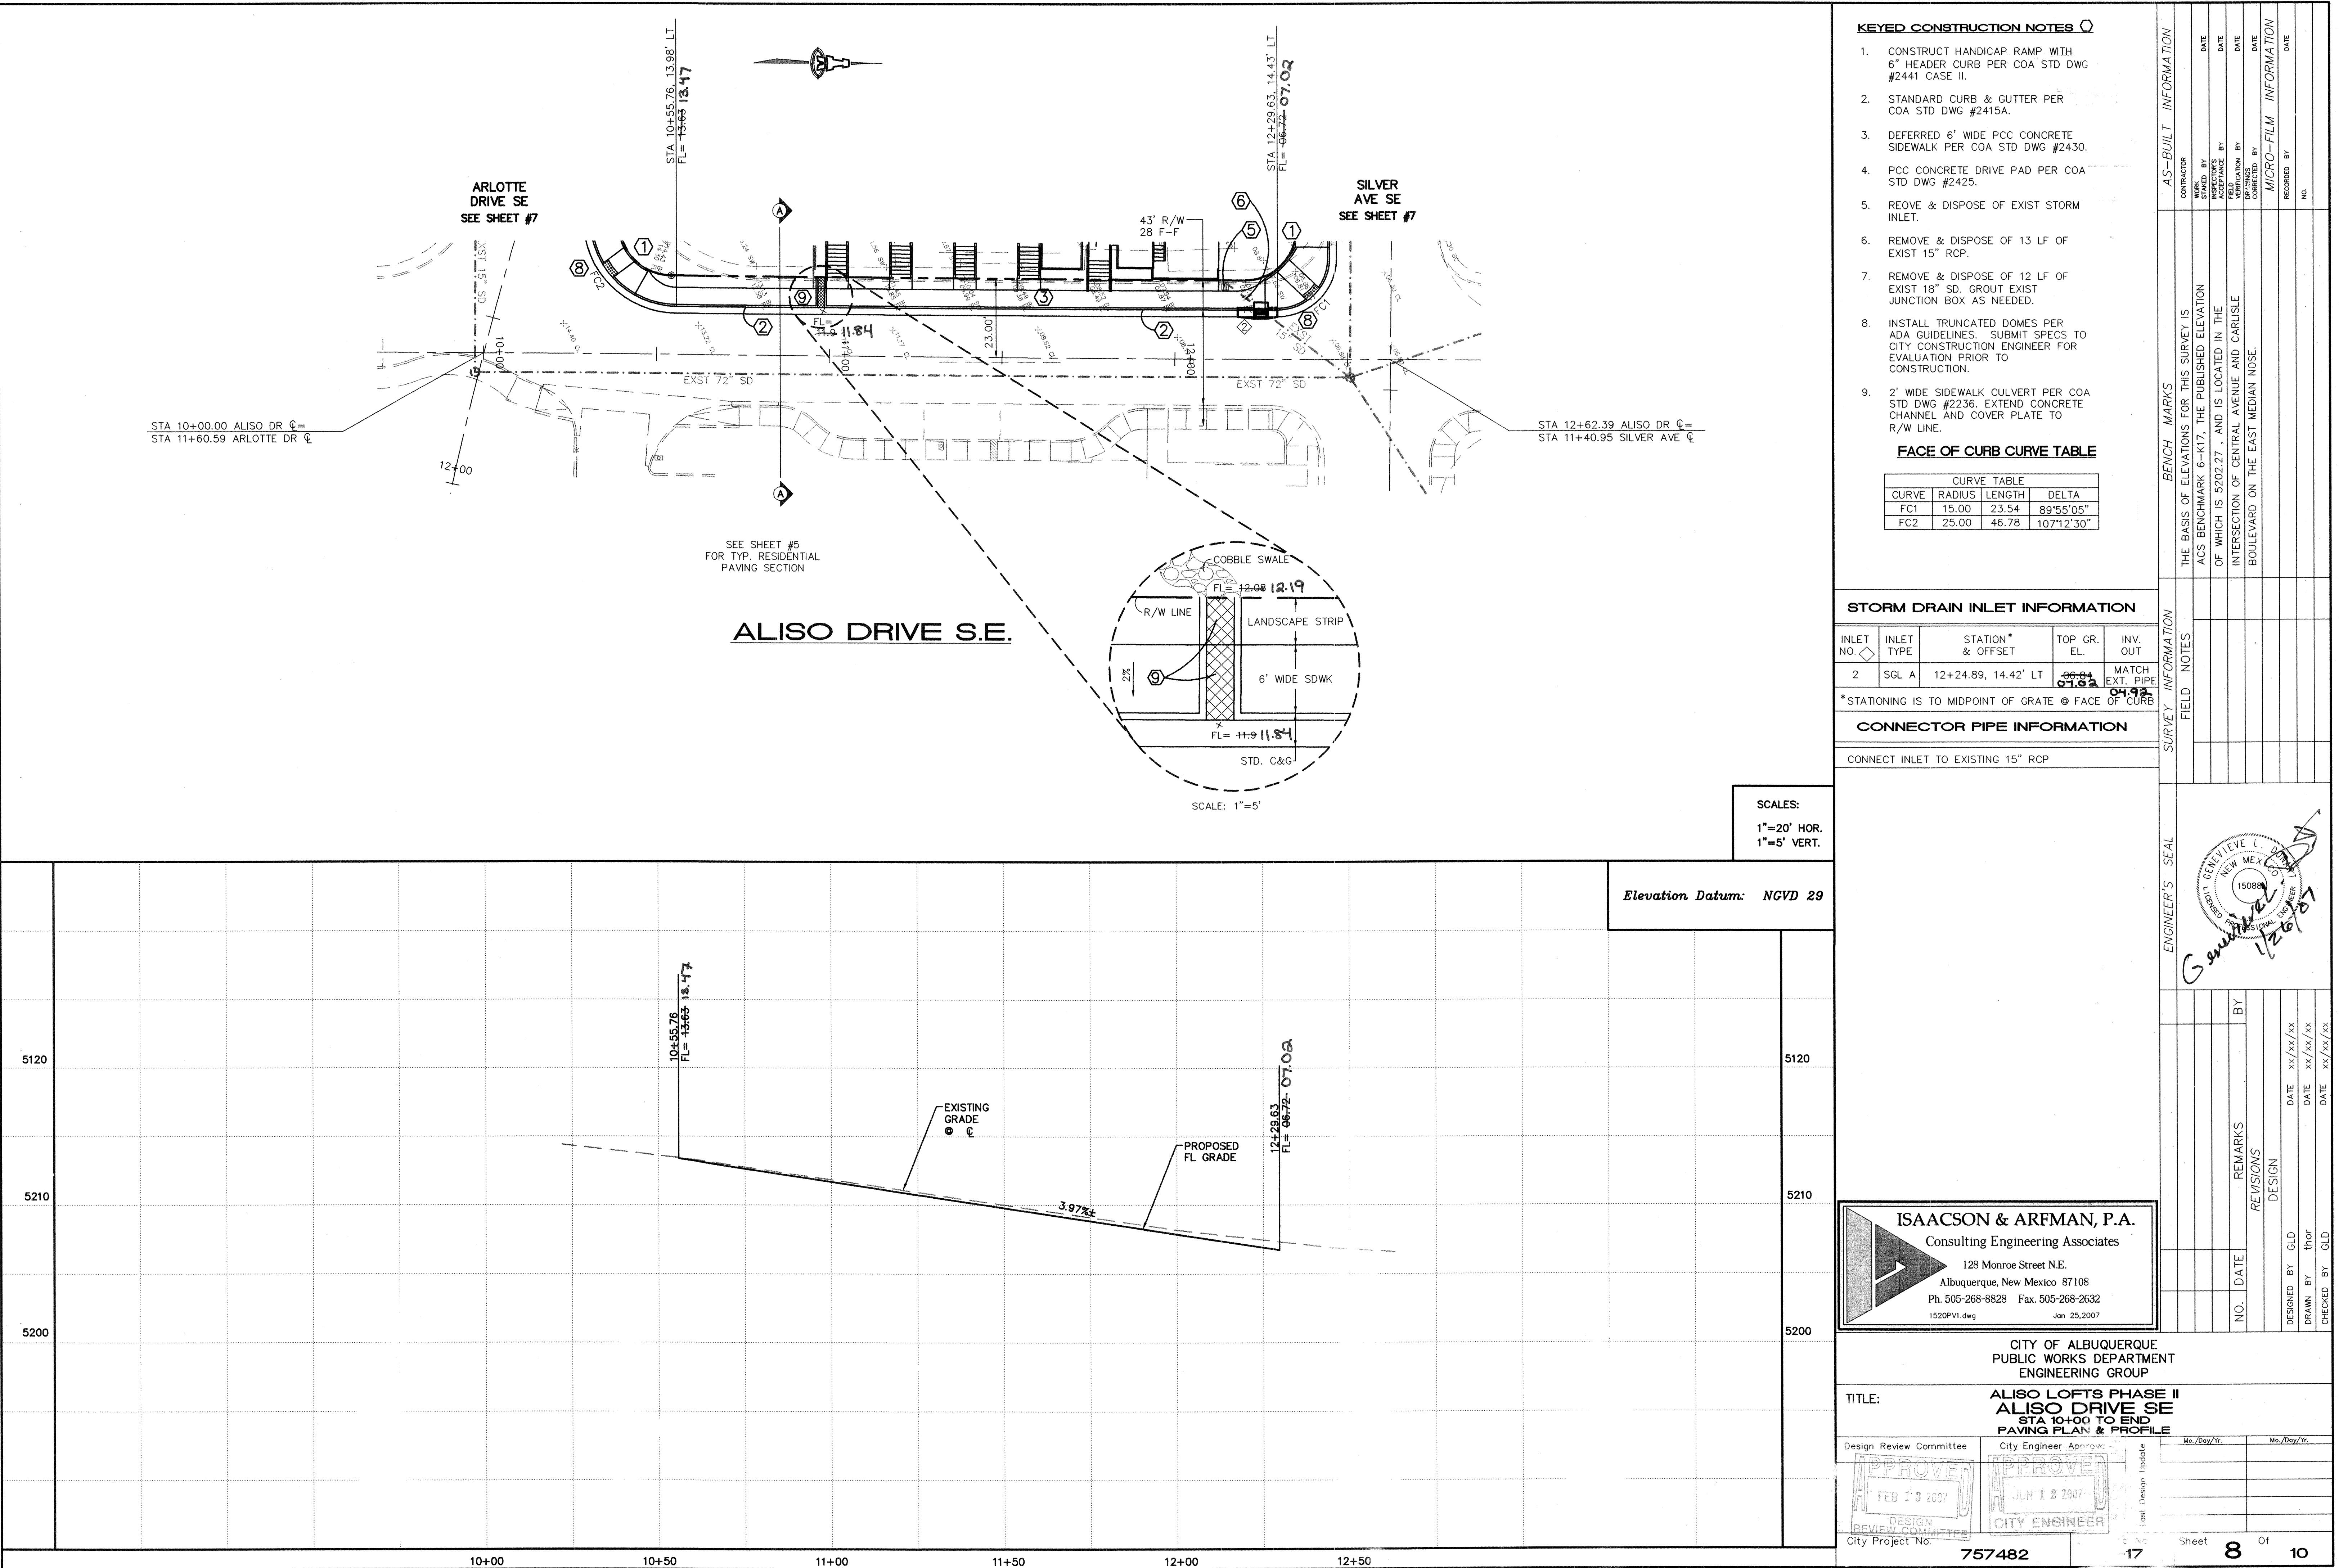

**LEGEND**

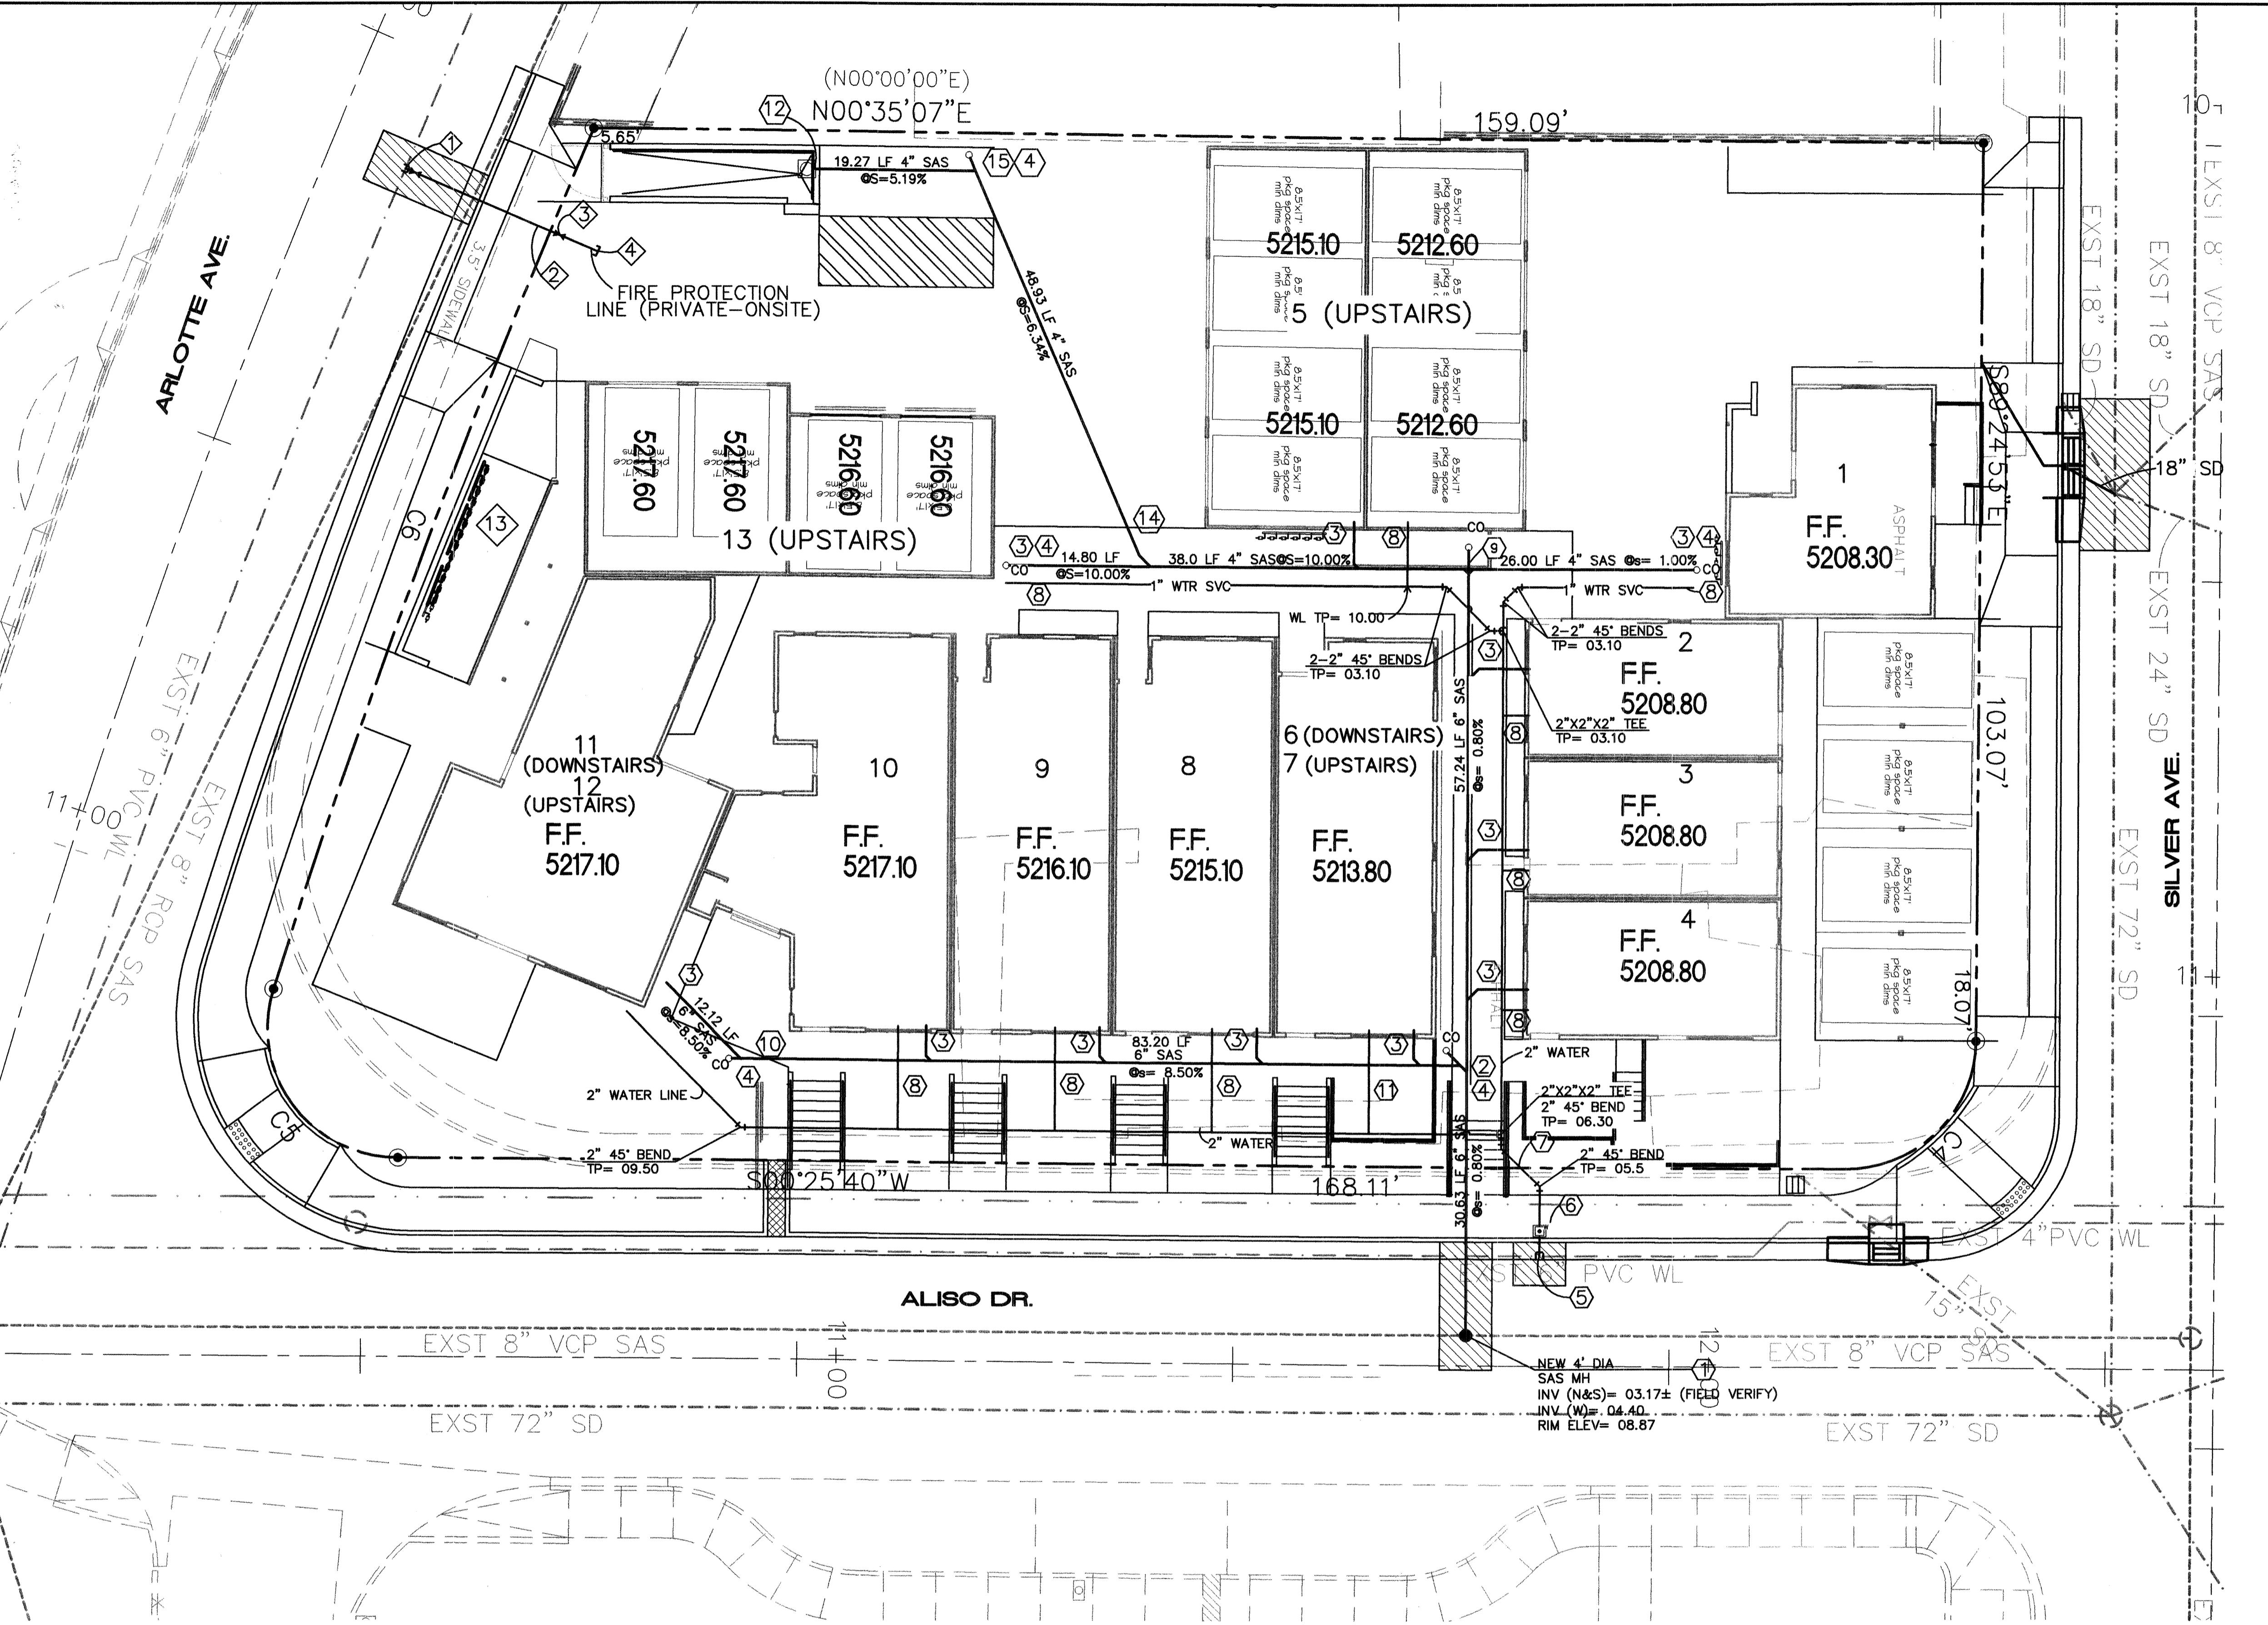SAWCUT, REMOVE & REPLACE PAVING W/ 2" ADDITIONAL THICKNESS PER COA STD DWG #2465 SEE PAVEMENT REMOVAL PLAN ON SHEET 6.

SAS SERVICE INVERTS			
UNIT	INV ELEV	UNIT	INV ELEV
1	05.36	8	11.10
2	05.70	9	12.10
3	05.47	10	13.10
4	05.36	11/12	12.75
5	08.60	13	10.38
6/7	09.80	GARBAGE ENCLOSURE	13.00

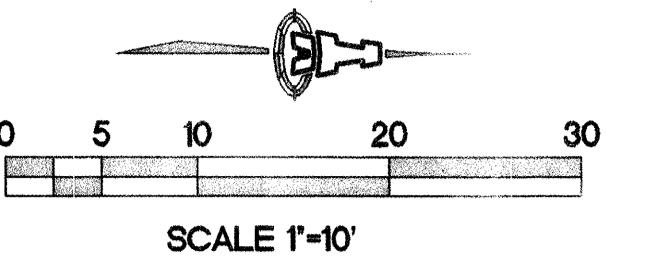**KEYED NOTES**

- CONSTRUCT 4' DIA. TYPE 'C' PUBLIC SANITARY SEWER MANHOLE PER COA STD DWG #210. REMOVE AND REPLACE 8 SY ASPHALT PAVEMENT PER COA STD DWG #2465.
- 6" SAS WYE INV= 04.65
6" CLEANOUT, SEE DETAIL
- 4" SAS SERVICE. SEE TABLE FOR SAS SERVICE INVERTS.
- 4" CLEANOUT, SEE DETAIL.
- 1½" WATER SERVICE, TAP ON 4" WATERLINE. REMOVE AND REPLACE 3 SY ASPHALT PAVEMENT PER COA STD DWG #2465.
- 1½" SINGLE WATER METER SETTING & METER BOX.
- 2" (OR AS DIMENSIONED) PRIVATE WATER SERVICE (DISTRIBUTION) LINE W/ FITTINGS AS NECESSARY.
- ¾" WATER SERVICE LINE TO INDIVIDUAL UNITS.
- 6"X4" SAS CROSS
4" CLEANOUT, SEE DETAIL.
6"X4" REDUCER (WEST) INV= 05.10
- 6" SAS WYE INV= 11.72
- 1½" COMBINED WATER SERVICE LINE TO UNITS 6 AND 7.
- 4" P-TRAP AND AREA DRAIN. GRATE EL= 13.1
- GAS METERS PER MECHANICAL PLAN
- 4" SAS WYE AND 4" 22.5° BEND INV= 08.90
- 4" SAS WYE INV= 12.00

FIRE PROTECTION LINE

- 6"X4" DRY CONNECTION
1-4" GATE VALVE
1-VALVE BOX
REMOVE & REPLACE 7 SY ASPHALT PAVING PER COA STD DWG #2465.
- 24 LF 4" WATERLINE.
- 1-4" GATE VALVE
1-VALVE BOX
TP= 15.00
- TEMPORARY 4" CAP & BLOCKING AS NECESSARY.

NOTE: SEE PUBLIC WORK ORDER PLANS FOR RELOCATED STORM DRAIN INLET AT S.E. CORNER OF ALISO DR. & SILVER AVE.

GENERAL NOTES

- ONSITE WATER & SAS TO BE BUILT BY PRIVATE CONTRACT. WATER, SAS, & STORM DRAIN IN RIGHT-OF-WAY TO BE BUILT BY WORK ORDER.
- SEE SHEET 10 FOR DETAILS, RESTRAINED JOIN LENGTHS, AND WATER SHUT OFF PLAN.



CITY OF ALBUQUERQUE
PUBLIC WORKS DEPARTMENT
ENGINEERING GROUP

TITLE: ALISO LOFTS PHASE II		MASTER UTILITY PLAN	
Design Review Committee	City Engineer Approval	Mo./Day/Yr.	Mo./Day/Yr.
IMPROVED	UNAPPROVED	FEB 13 2007	JUN 12 2007
DESIGN REVIEW COMMITTEE	CITY ENGINEER	Los Design Update	
City Project No. 757482		Zone Map No. K-17	Sheet 9 Of 10


RESTRAINED JOINT LENGTHS, L _T , FOR TEES, (FT.)		
ALL JOINTS AT THE TEE MUST BE RESTRAINED.		
SIZE	RUN	BRANCH
12x12x12	15	17
12x12x10	10	18
12x12x8	6	19
12x12x6	3	19
12x12x4	1	19
10x10x10	12	18
10x10x8	8	15
10x10x6	4	16
10x10x4	2	4
8x8x8	9	20
8x8x6	5	17
8x8x4	2	15
6x6x6	6	20
6x6x4	2	20

THIS TABLE IS BASED UPON THE FOLLOWING CRITERIA:

DEPTH OF BURY 3.0 FT. MINIMUM
FACTOR OF SAFETY 1.25
MATERIAL PVC PIPE
SOIL TYPE: GM/SM - SILTY GRAVELS AND SILTY SANDS,
GRAVEL-SAND-SILT MIXTURES.
TEST PRESSURE 150 PSI
TRENCH TYPE 4: PIPE BEDDED IN SAND, GRAVEL, OR CRUSHED
STONE TO DEPTH OF 1/8 PIPE DIAMETER, 4 INCHES
MINIMUM; BACKFILL COMPAKTED TO TOP OF PIPE

DIFFERENT CRITERIA, E.G., DUCTILE IRON PIPE, GREATER DEPTH OF BURY, ETC., WILL REQUIRE DIFFERENT RESTRAINED LENGTHS. THESE MUST BE CALCULATED BY A QUALIFIED PROFESSIONAL ENGINEER AND APPROVED BY THE PUBLIC WORKS DEPARTMENT.

RESTRAINED JOINT LENGTHS FOR WATERLINE FITTINGS

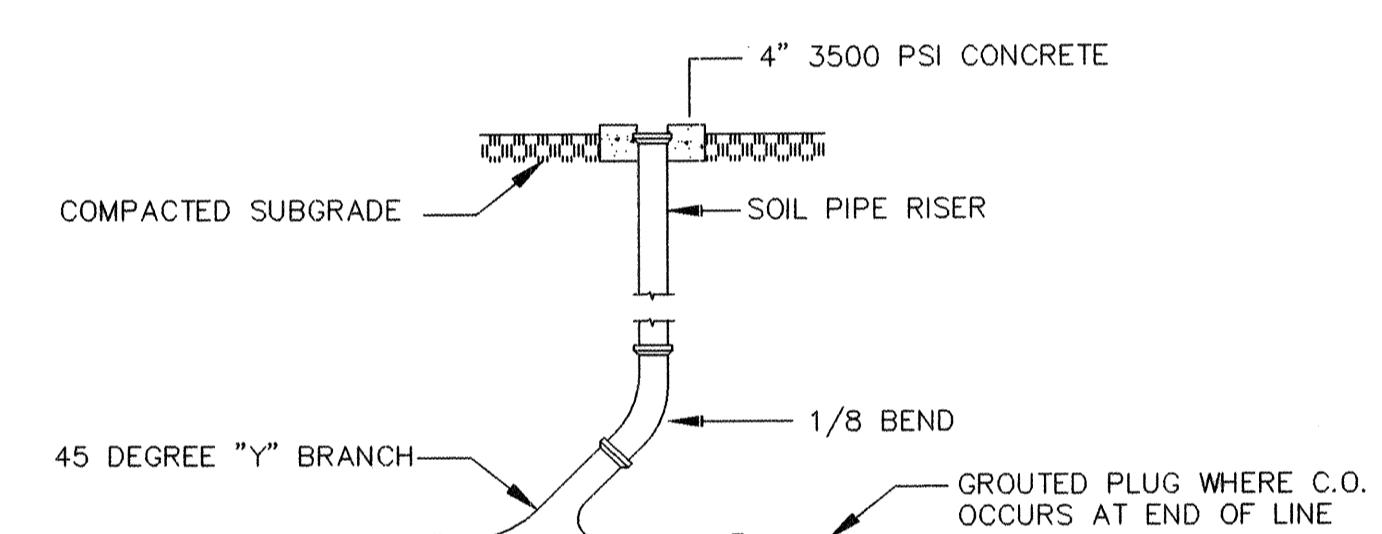

SINGLE CLEANOUT DETAIL

~~letter by
same line
Bismillah
the Righteous
of the Qur'an~~

GENERAL NOTES

1. CONSTRUCT SAS SERVICES PER COA STD DWG #2125.
 2. CONSTRUCT ALL SINGLE & DOUBLE WATER SERVICES PER COA STD DWG #2361, #2362, & #2363.
 3. SEE SHEET # FOR WATER SHUT-OFF PLAN.
 4. SEE SHEET # FOR RESTRAINED JOINT LENGTHS FOR WATER LINE FITTINGS.
 5. CONSTRUCT FIRE HYDRANTS PER DESIGNATED DEPTHS & LENGTHS PER COA STD DWG #2340.
 6. SEE COA STD DWG #2328 FOR VALVE RING & COVER DETAIL.

WATER SHUT-OFF PLAN

SHUT-OFF VALVES [662] & [664] TO PROVIDE
NON-PRESSURE CONNECTION. THE CONTRACTOR SHALL
CONTACT WATER SYSTEMS DIVISION (857-8200) 7
WORKING DAYS PRIOR TO SHUT-OFF OR TURN-ON AT
VALVES. ONLY CITY PERSONNEL ARE ALLOWED TO
OPERATE VALVES.

