

CONSTRUCTION PLANS FOR 98TH & SAGE PAVING & UTILITY IMPROVEMENTS

ALBUQUERQUE
BERNALILLO COUNTY, NEW MEXICO
OCTOBER 2005

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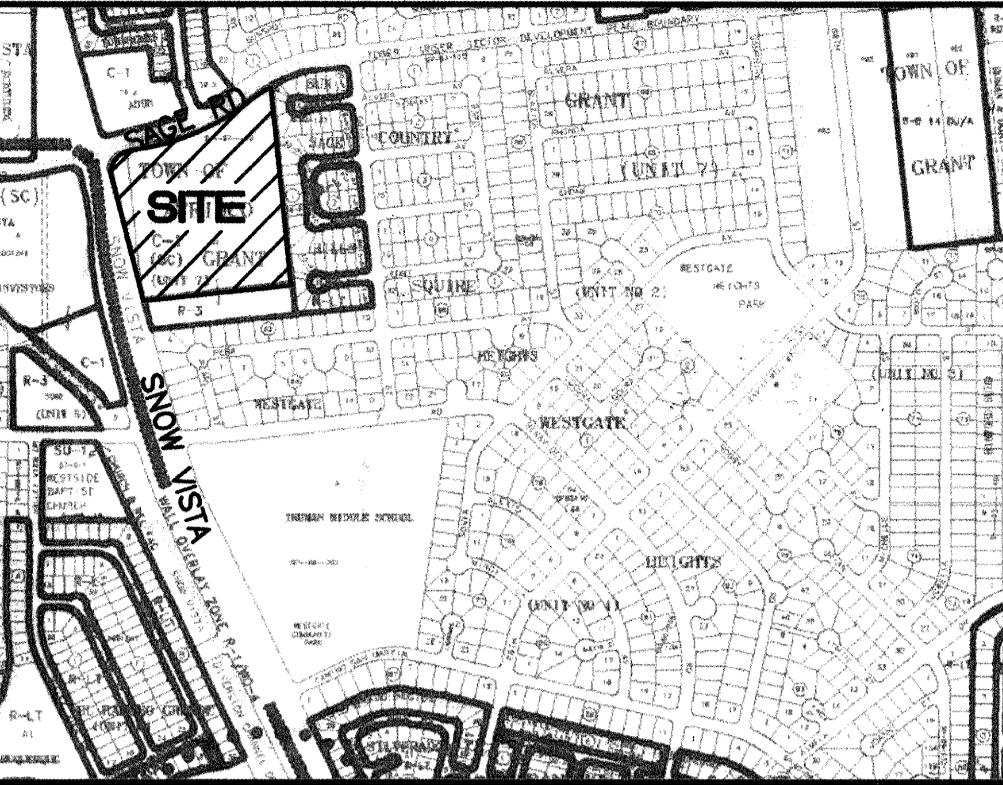
CERTIFICATE OF SUBSTANTIAL COMPLIANCE ON PLANS

I, Ronald R. Bohannan, of the firm of Tierra West LLC, a Registered Professional Engineer in the State of New Mexico, do hereby certify, to the best of my knowledge and belief, that the infrastructure installed as part of this project has been inspected by me or by a qualified person under my direct supervision and has been constructed in accordance with the plans and specifications approved by the City Engineer and that the original design intent of the approved plans has been met, except as noted by me on the as-built construction drawings. This Certification is based on site inspections by me or personnel under my direction with survey information provided by Baseline Field Services NMPLS# 5110.



DRB # 1003981

TIERRA WEST, LLC
8509 JEFFERSON NE ALBUQUERQUE, NEW MEXICO 87113 (505)858-3100



VICINITY MAP

M-9

SCALE NONE

NOTICE TO CONTRACTORS
1. ALL WORK DETAILED ON THESE PLANS TO BE PERFORMED UNDER CONTRACT SHALL, EXCEPT AS OTHERWISE STATED OR PROVIDED FOR HEREON, BE CONSTRUCTED IN ACCORDANCE WITH THE CITY OF ALBUQUERQUE STANDARD SPECIFICATIONS FOR PUBLIC WORKS CONSTRUCTION, 1988 EDITION (UPDATE #7)

2. TWO WORKING DAYS PRIOR TO ANY EXCAVATION, THE CONTRACTOR MUST CONTACT NEW MEXICO ONE CALL SYSTEM (260-1990) FOR LOCATION OF EXISTING UTILITIES.

3. ANY WORK AFFECTING AN ARTERIAL ROADWAY REQUIRES 24-HOUR CONSTRUCTION.

4. PRIOR TO CONSTRUCTION, THE CONTRACTOR SHALL EXCAVATE AND VERIFY THE HORIZONTAL AND VERTICAL LOCATIONS OF ALL OBSTRUCTIONS. SHOULD A CONFLICT EXIST, THE CONTRACTOR SHALL NOTIFY THE ENGINEER OR SURVEYOR IMMEDIATELY SO THAT THE CONFLICT CAN BE RESOLVED WITH A MINIMUM AMOUNT OF DELAY.

5. FIVE (5) WORKING DAYS PRIOR TO BEGINNING OF CONSTRUCTION, THE CONTRACTOR SHALL SUBMIT TO CONSTRUCTION COORDINATIONS DIVISION A DETAILED CONSTRUCTION SCHEDULE. TWO (2) WORKING DAYS PRIOR TO CONSTRUCTION, THE CONTRACTOR SHALL OBTAIN A BARRICADE PERMIT FROM THE CONSTRUCTION COORDINATION DIVISION. CONTRACTOR SHALL NOTIFY BARRICADE ENGINEER (924-3400) PRIOR TO occupying AN INTERSECTION. REFER TO STANDARD SPECIFICATIONS.

6. ALL STREET STRIPING ALTERED OR DESTROYED SHALL BE REPLACED WITH PLASTIC REFLECTORIZED PAVEMENT MARKINGS BY THE CONTRACTOR TO LOCATION AS EXISTING OR AS INDICATED BY THIS PLAN SET.

7. CONTRACTOR SHALL NOTIFY THE ENGINEER NOT LESS THAN SEVEN (7) DAYS PRIOR TO STARTING WORK IN ORDER THAT THE ENGINEER MAY TAKE NECESSARY MEASURES TO INSURE THE PRESERVATION OF SURVEY MONUMENTS. CONTRACTOR SHALL NOT DISTURB PERMANENT SURVEY MONUMENTS WITHOUT THE CONSENT OF THE ENGINEER AND SHALL NOTIFY THE ENGINEER AND BEAR THE EXPENSE OF REPLACING ANY THAT MAY BE DISTURBED WITHOUT PERMISSION. REPLACEMENT SHALL BE DONE ONLY BY THE CITY SURVEYOR. WHEN A CHANGE IS MADE IN THE FINISHED ELEVATIONS OF THE PAVEMENT OF ANY ROADWAY IN WHICH A PERMANENT SURVEY MONUMENT IS LOCATED, CONTRACTOR SHALL, AT HIS OWN EXPENSE, ADJUST THE SURVEY POINT TO THE NEW ROAD, UNLESS OTHERWISE SPECIFIED. REFER TO SECTION 4-4 OF THE GENERAL CONDITIONS OF THE STANDARD SPECIFICATIONS. ANY PERMANENT SURVEY MONUMENT LOCATED WITHIN 50' OF THIS PROJECT THAT IS NOT SHOWN ON THE PLAN AND IS DESTROYED DURING CONSTRUCTION WILL BE REPLACED AT THE DESIGNERS EXPENSE.

8. FOR STORM DRAIN CONSTRUCTION, RCP PIPE JOINTS SHALL NOT BE GROUTED PRIOR TO FINAL INSPECTION. FINAL INSPECTION WILL DETERMINE JOINTS TO BE GROUTED FOR FINAL ACCEPTANCE OF THE CONSTRUCTION.

9. CONTRACTOR SHALL MAINTAIN A GRAFFITI-FREE WORK SITE. CONTRACTOR SHALL PROMPTLY REMOVE ANY AND ALL GRAFFITI FROM EQUIPMENT, WHETHER PERMANENT OR TEMPORARY.

THE FOLLOWING NOTES ALSO APPLY WHEN CHECKED



- ALL UTILITIES AND UTILITY SERVICE LINES SHALL BE INSTALLED PRIOR TO PAVING.
- BACKFILL COMPACTION SHALL BE ACCORDING TO SPECIFIED STREET USE.
- TACK COAT REQUIREMENTS SHALL BE DETERMINED BY THE PROJECT ENGINEER.
- SIDEWALKS AND WHEELCHAIR RAMPS WITHIN THE CURB RETURNS SHALL BE CONSTRUCTED WHEREVER A NEW CURB RETURN IS CONSTRUCTED.
- IF CURB IS DEPRESSED FOR A DRIVEPAD, THE DRIVEPAD SHALL BE CONSTRUCTED PRIOR TO ACCEPTANCE OF CURB AND GUTTER.
- ALL STORM DRAINAGE FACILITIES SHALL BE COMPLETED PRIOR TO FINAL ACCEPTANCE.






REV	SHEETS	CITY ENGINEER	DATE	USER DEPT.	DATE	USER DEPT.	DATE
ENGINEERS STAMP & SIGNATURE							
DRC Chairman	Ronald R. Bohannan	RONALD R. BOHANNAN	12/12/05	APPROVALS	ENGINEER	DATE	12/12/05
Transportation	John S.	JOHN S.	11/18/05				
Water/Wastewater	William G. Byley	WILLIAM G. BYLEY	11/18/05				
Hydrology	Bradley J. Brugman	BRADLEY J. BRUGMAN	11/18/05				
AMAFCA	N/A	N/A					
Constr. Mngmt.	N/A	N/A					
Constr. Coord.	Ronald R. Bohannan	RONALD R. BOHANNAN	12/12/05				
CITY PROJECT NO.							
7697.81							
SHEET							
1 - 12							

GENERAL NOTES:

- ALL CONCRETE IS TO BE 3000 PSI @ 28 DAYS.
- MINIMUM COMPACTION UNDER FOOTINGS IS TO BE 95% PER ASTM D 1557 FOR A DEPTH OF 12" MOISTURE CONTENT IS TO BE $\pm 2.0\%$.
- BACK FILL AGAINST WALLS IS TO BE HAND-PLACED AND COMPACTED.
- ALL BARS ARE TO BE GRADE 60, ASTM 615.
- TRUSS TYPE DUR-O-WALL EVERY OTHER COURSE.
- DOWELS SHALL BE AT LEAST EQUAL IN SIZE AND SPACING TO V-BARS, SHALL PROJECT A MINIMUM OF 30 BAR DIA. INTO THE FILLED BLOCK CORES, AND SHALL EXTEND TO THE TOE OF THE FOOTING.
- USE EITHER EXPANSION JOINTS ON 20' CENTERS OR PILASTERS EVERY 16'.

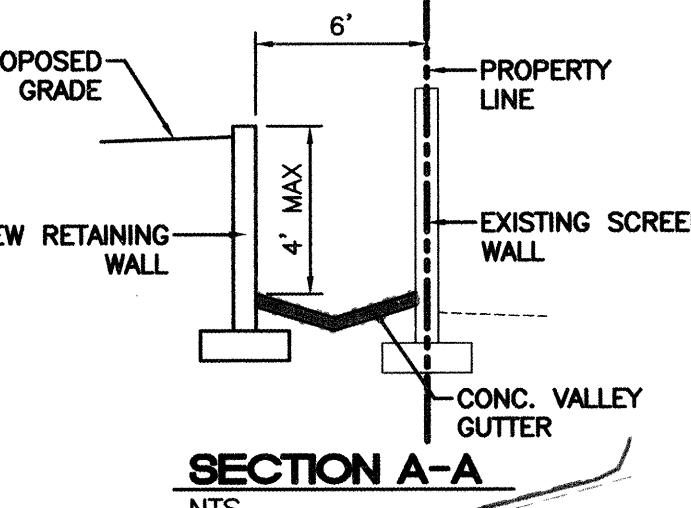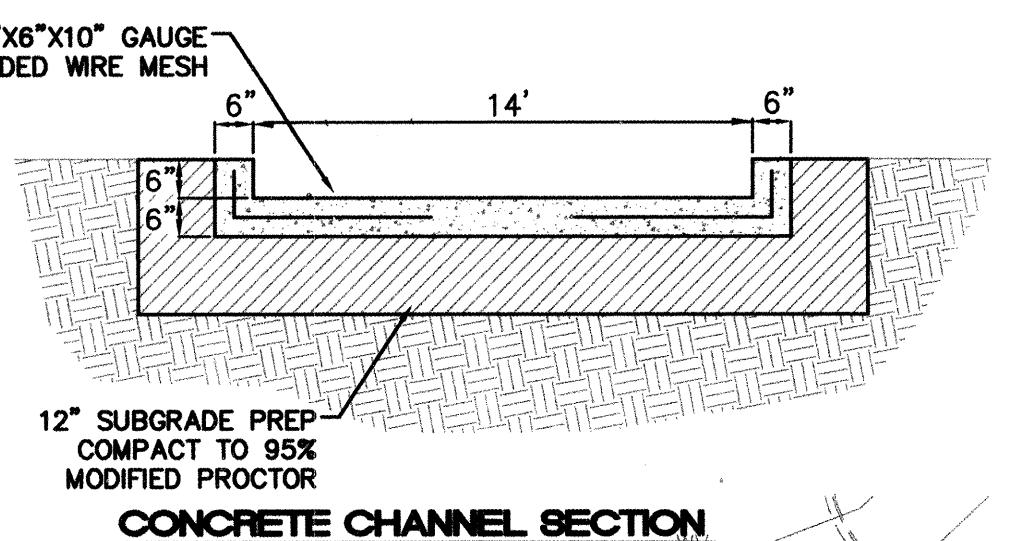

SAGE ROAD, S.W.
(86' R.O.W.)

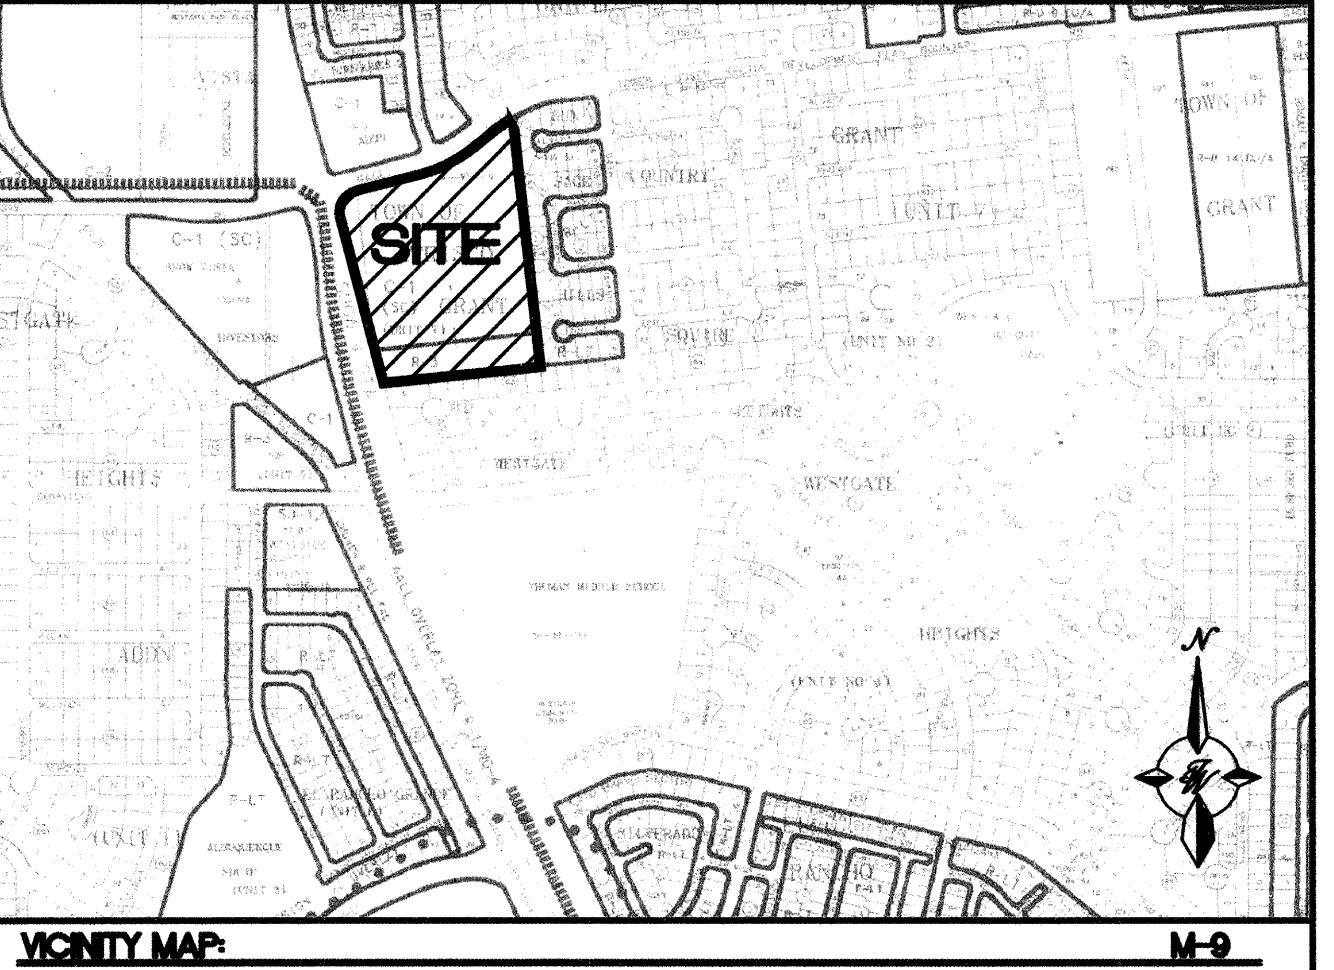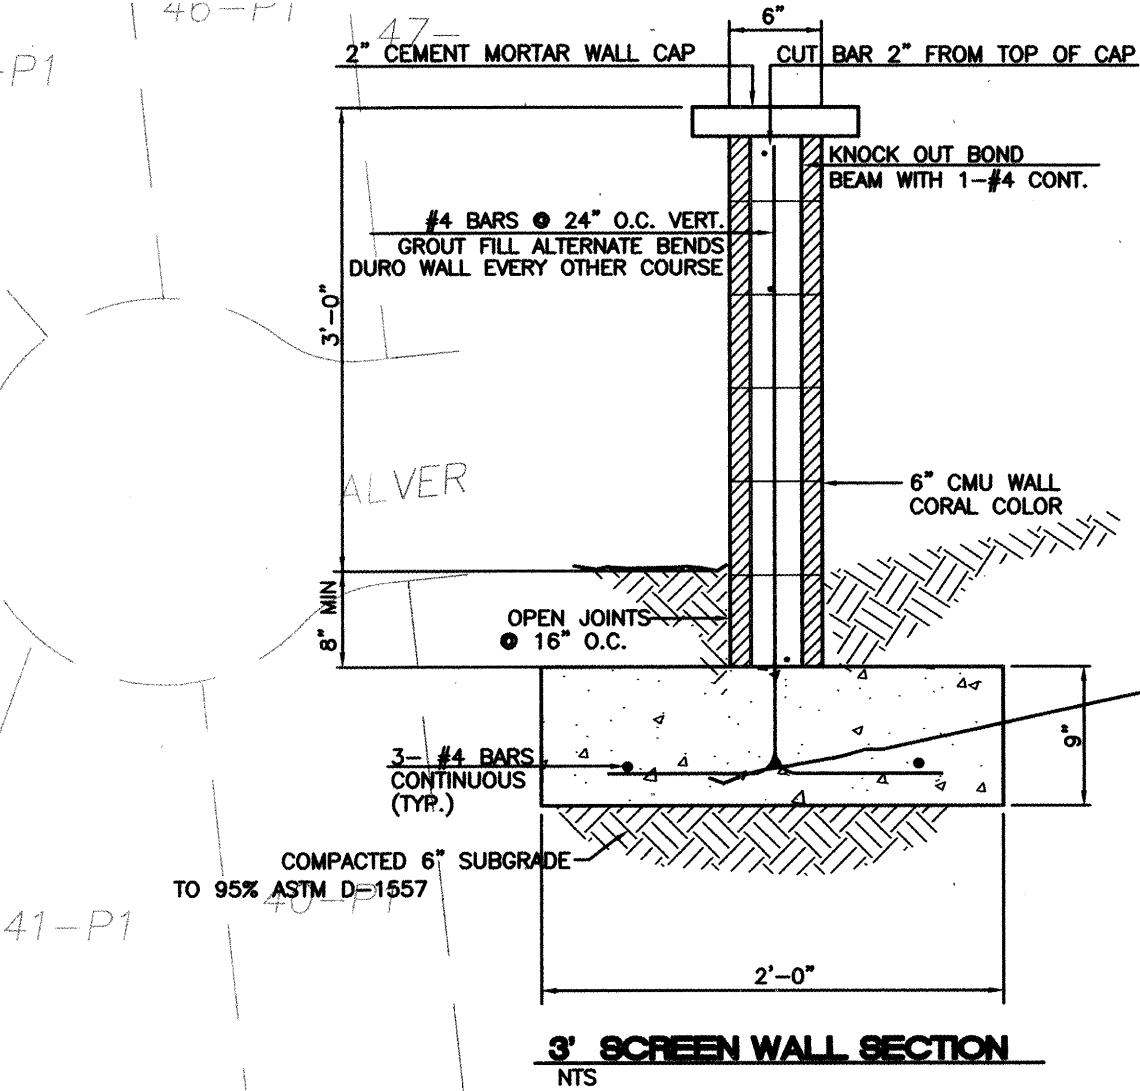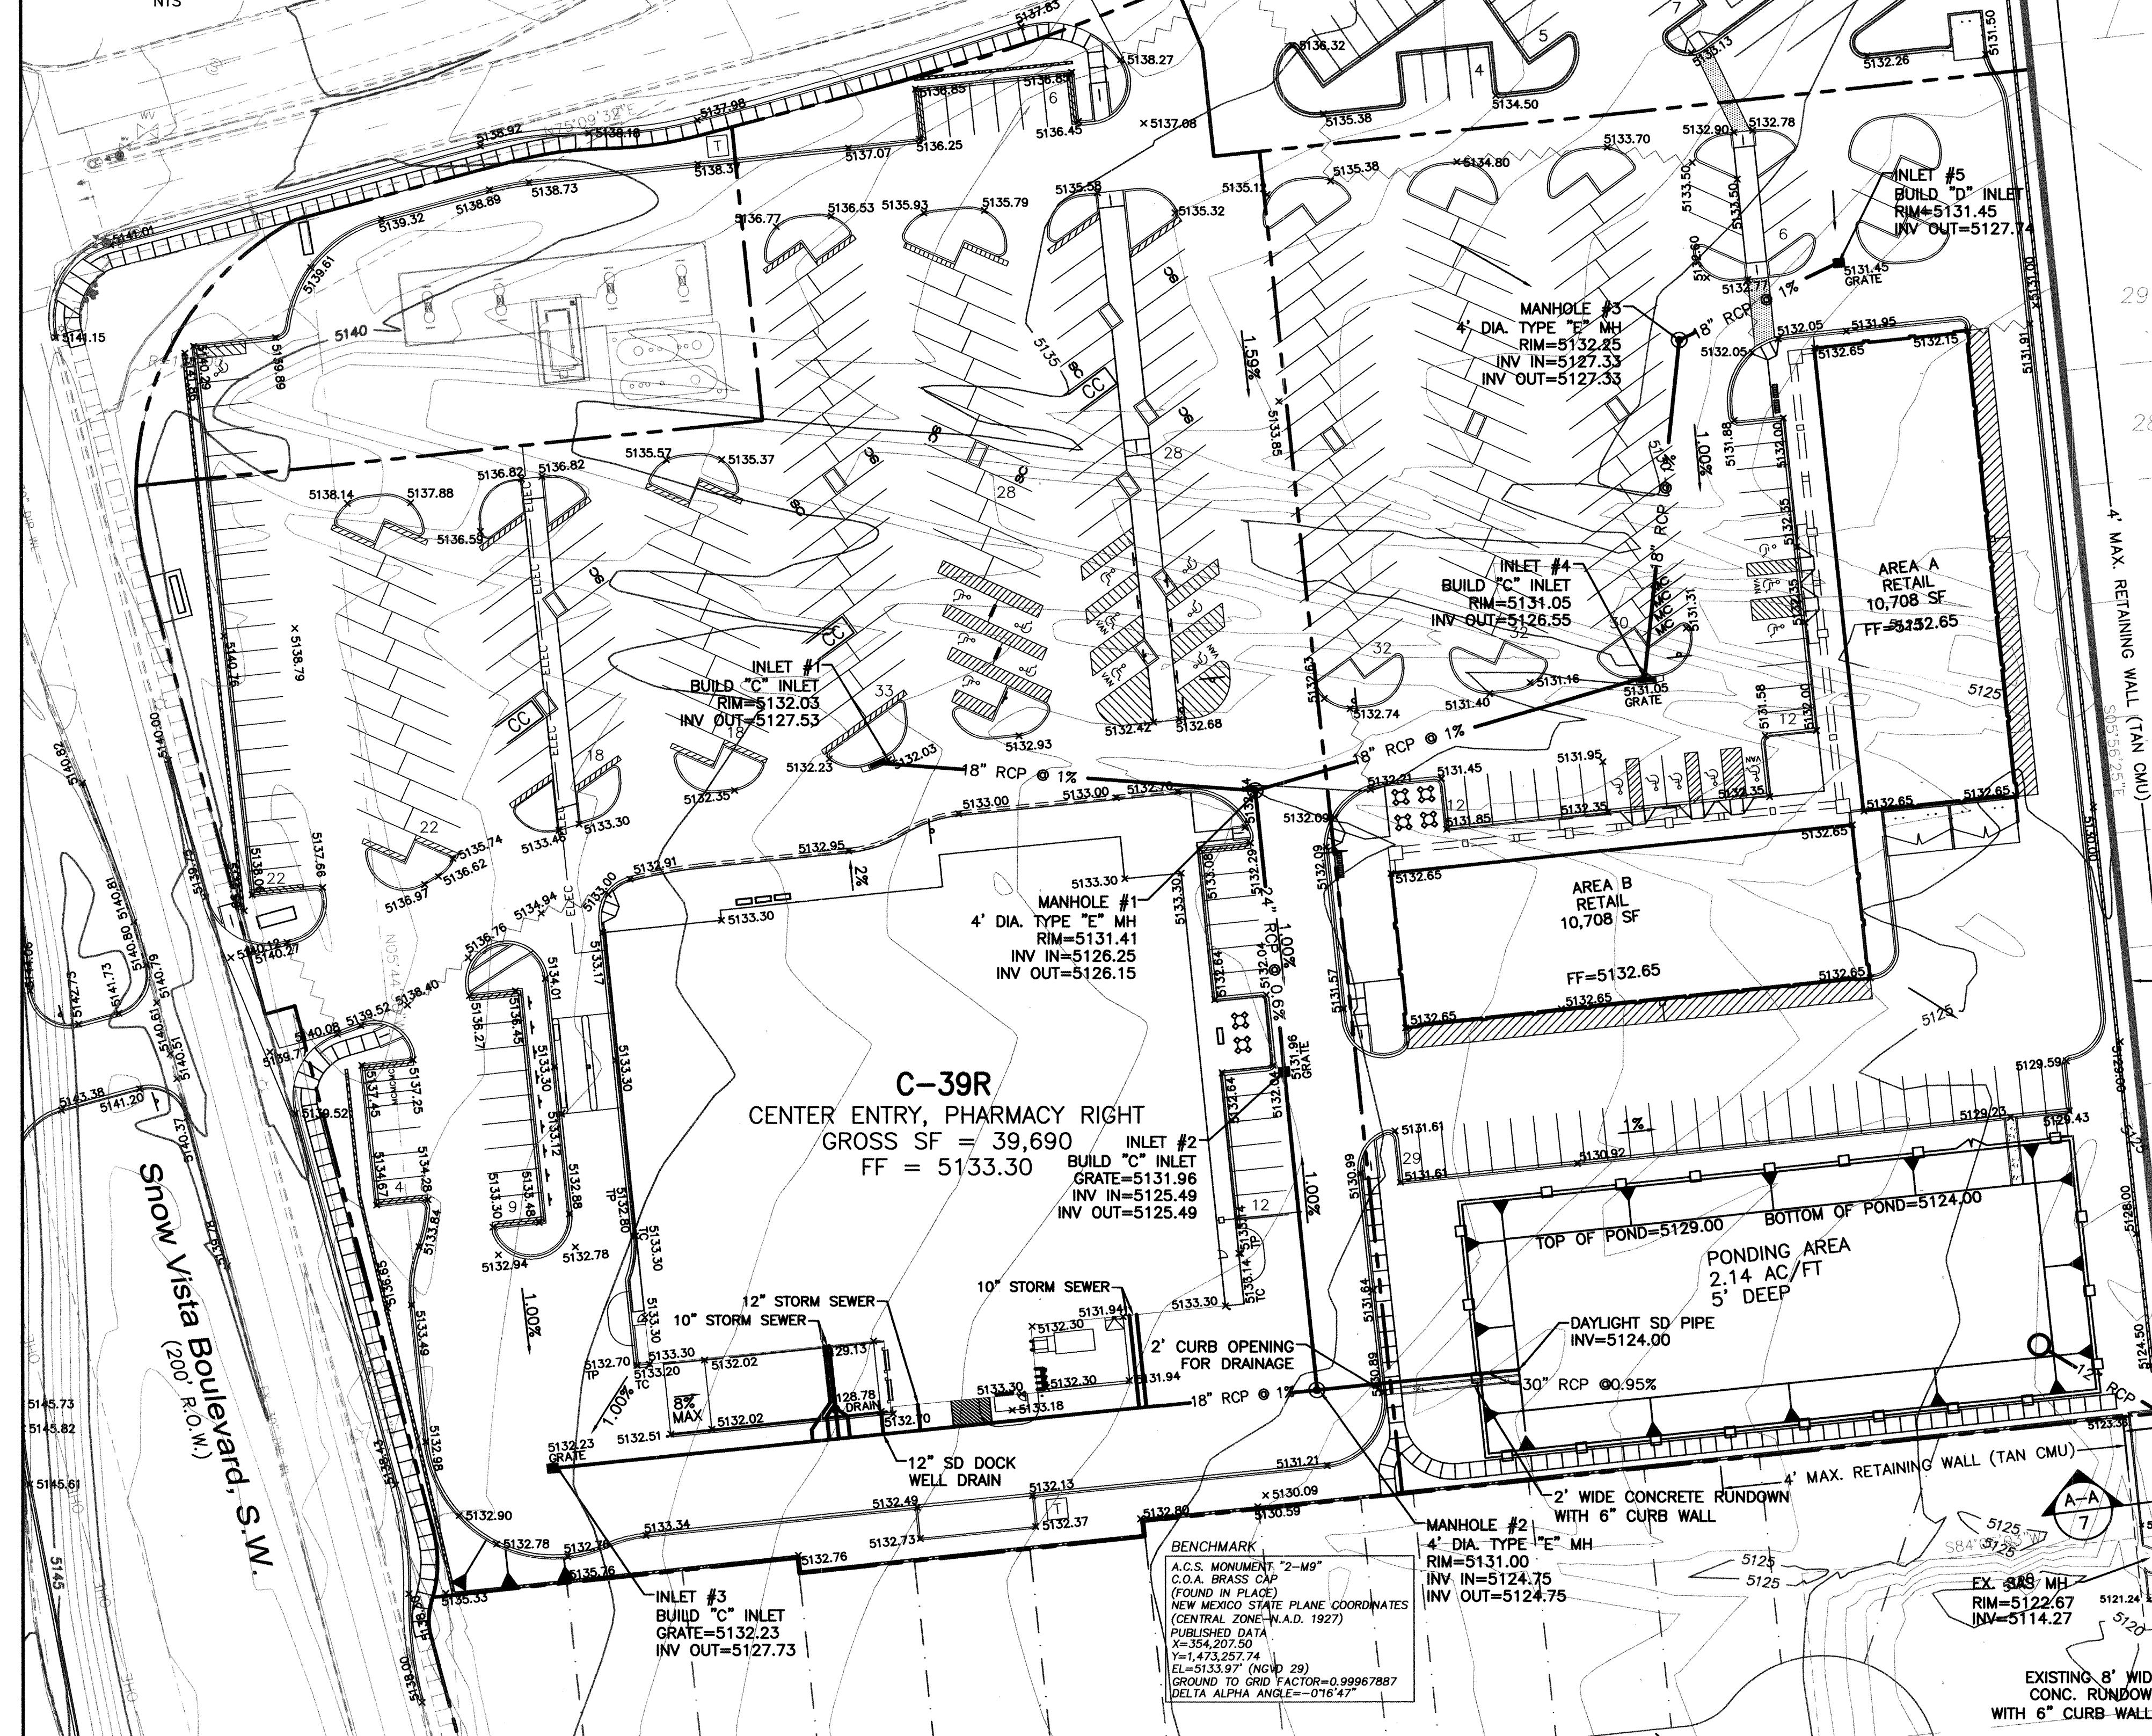



LEGAL DESCRIPTION:
Parcel "A-1" and Remaining Westerly Portion of Parcel "A", Town of Atrisco Grant, Unit 7

8 INCH REINFORCED CONCRETE MASONRY WALL					
H	A	B	T	Y-BARS	X-BARS
ft.-in.	ft.-in.	ft.-in.	in.	#4 @32" O.C.	#4 @24" O.C.
2'-0"	8"	2'-0"	9"	#4 @32" O.C.	#4 @24" O.C.
2'-8"	8"	2'-0"	9"	#4 @32" O.C.	#4 @24" O.C.
3'-0"	10"	2'-8"	9"	#4 @32" O.C.	#4 @24" O.C.
4'-8"	12"	3'-4"	10"	#5 @32" O.C.	#4 @18" O.C.
5'-4"	14"	3'-10"	10"	#6 @16" O.C.	#4 @18" O.C.
6'-0"	16"	4'-8"	12"	#6 @ 8" O.C.	#4 @12" O.C.


12 INCH REINFORCED CONCRETE MASONRY WALL					
H	A	B	T	Y-BARS	X-BARS
ft.-in.	ft.-in.	ft.-in.	in.	#6 @18" O.C.	#4 @24" O.C.
5'-4"	14"	3'-8"	10"	#4 @16" O.C.	#4 @18" O.C.
6'-0"	15"	4"-2"	12"	#4 @16" O.C.	#4 @18" O.C.
6'-6"	16"	4"-6"	12"	#5 @16" O.C.	#5 @18" O.C.
8'-0"	18"	5"-4"	12"	#7 @18" O.C.	#6 @12" O.C.
8'-8"	20"	5"-8"	12"	#7 @16" O.C.	#6 @12" O.C.

GENERAL NOTES:

- ALL CONCRETE IS TO BE 4000 PSI @ 28 DAYS.
- MINIMUM COMPACTION UNDER FOOTINGS IS TO BE 95% PER ASTM D 1557 FOR A DEPTH OF 12" MOISTURE CONTENT IS TO BE $\pm 2.0\%$.
- BACK FILL AGAINST WALLS IS TO BE HAND-PLACED AND COMPACTED.
- ALL BARS ARE TO BE GRADE 60, ASTM 615.
- TRUSS TYPE DUR-O-WALL EVERY OTHER COURSE.
- JOVIAL BARS SHALL BE AT LEAST EQUAL IN SIZE AND SPACING TO V-BARS, SHALL PROJECT A MINIMUM OF 30 BAR DIA. INTO THE FILLED BLOCK CORES, AND SHALL EXTEND TO THE TOE OF THE FOOTING.
- PROPOSED 8" FOAM AND 12" WALLS WHERE H EXCEEDS 6'-0". USE EITHER EXPANSION JOINTS ON 20' CENTERS OR PILASTERS EVERY 16'.
- BOND BEAM, 1-#4 BARS FOR WALLS UNDER 3'-4", 2-#4 BARS FOR WALLS UNDER 5'-4", 2-#5 BARS FOR WALLS OVER 5'-4".

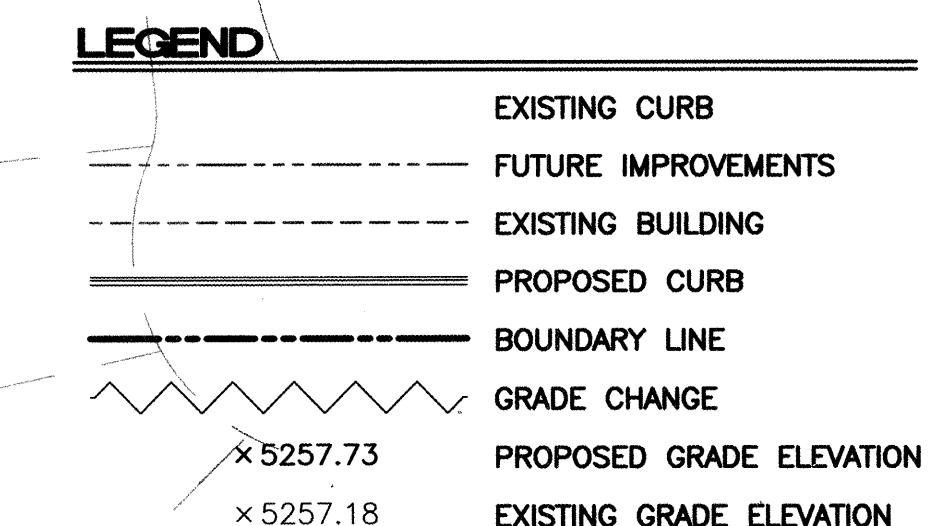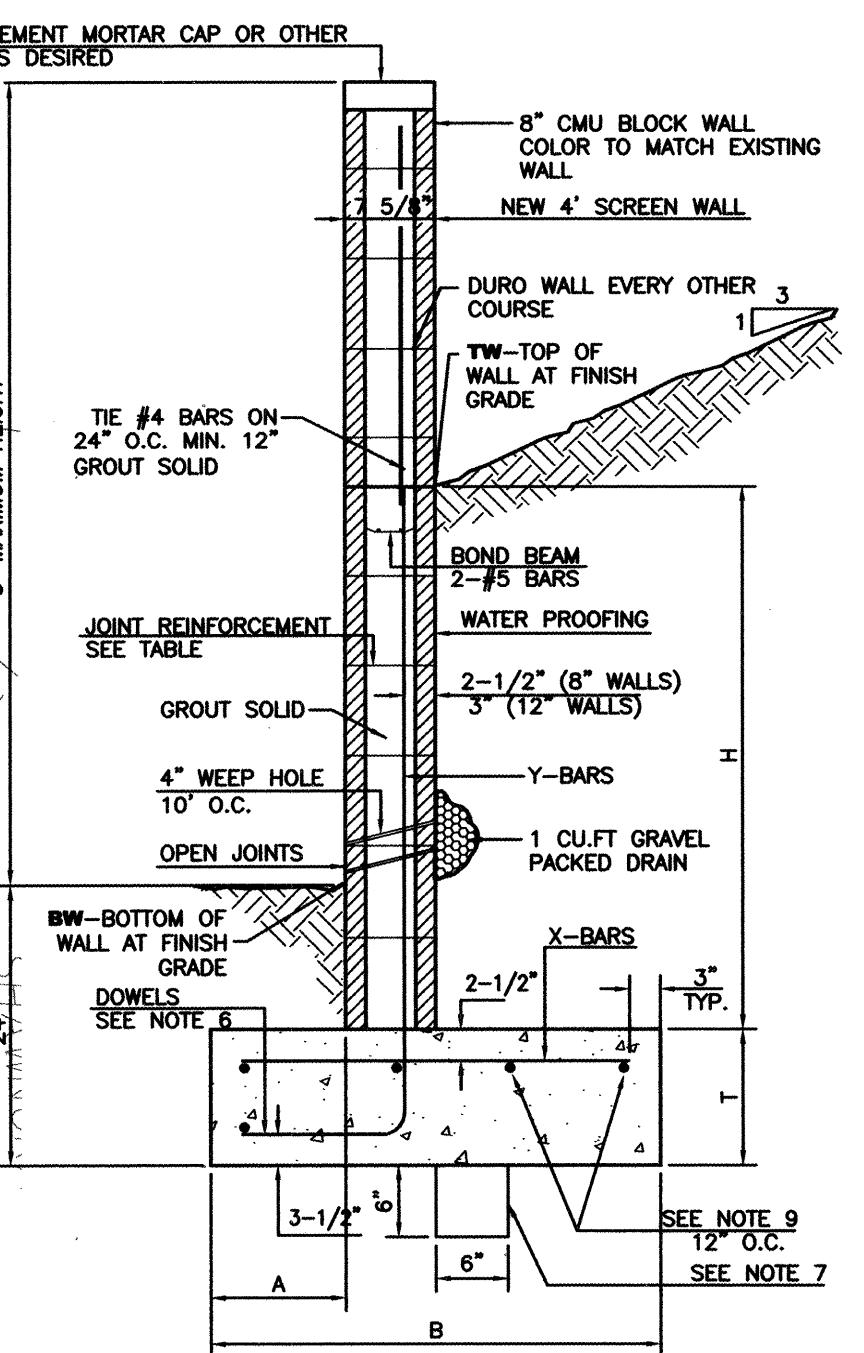

CAUTION:
ALL EXISTING UTILITIES SHOWN WERE OBTAINED FROM RESEARCH, AS-BUILTS, SURVEYS OR INFORMATION PROVIDED BY OTHERS. IT SHALL BE THE SOLE RESPONSIBILITY OF THE CONTRACTOR TO CONDUCT ALL NECESSARY FIELD INVESTIGATIONS PRIOR TO AND INCLUDING AN EXCAVATION TO DETERMINE THE ACTUAL LOCATION OF UTILITIES AND OTHER IMPROVEMENTS, PRIOR TO STARTING THE WORK. ANY CHANGES FROM THIS PLAN SHALL BE COORDINATED WITH AND APPROVED BY THE ENGINEER.

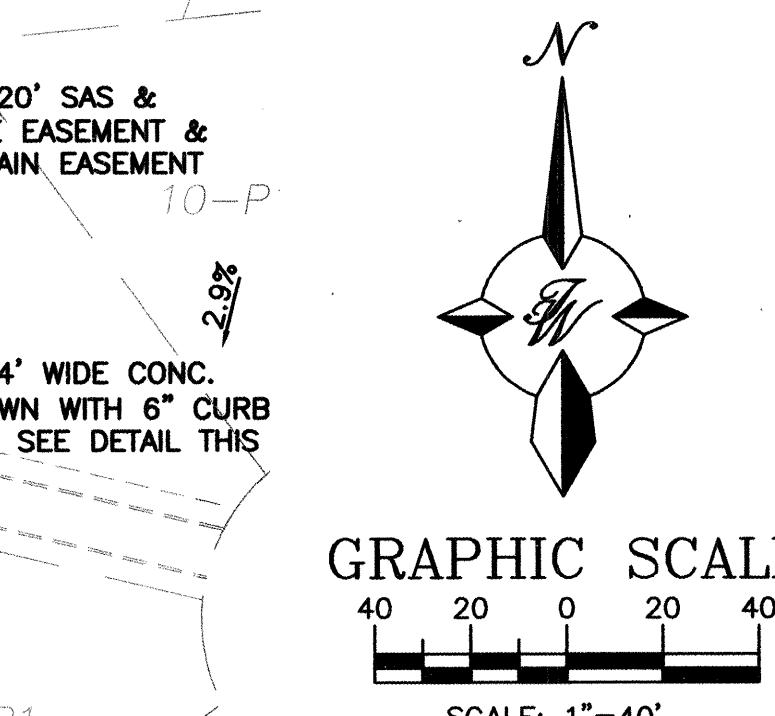


EROSION CONTROL PLAN, NPDES PERMIT AND POLLUTION PREVENTION NOTES

- CONTRACTOR IS RESPONSIBLE FOR OBTAINING A TOPSOIL DISTURBANCE PERMIT PRIOR TO BEGINNING WORK.
- CONTRACTOR IS RESPONSIBLE FOR CLEANING ALL SEDIMENT OUT OF EXISTING RIGHT-OF-WAY.
- CONTRACTOR IS RESPONSIBLE FOR MAINTAINING ALL STORM RUN OFF ON SITE.
- REPAIR OF DAMAGED FACILITIES AND CLEAN-UP OF SEDIMENT ACCUMULATION ON ADJACENT PROPERTIES AND IN PUBLIC FACILITIES IS THE RESPONSIBILITY OF THE CONTRACTOR.
- ALL EXPOSED EARTH SURFACES MUST BE PROTECTED FROM WIND AND WATER EROSION PRIOR TO FINAL ACCEPTANCE OF ANY PROJECT.
- CONTRACTOR IS RESPONSIBLE FOR OBTAINING NPDES PERMIT FOR THE SITE

ROUGH GRADING APPROVAL

ENGINEER'S SEAL	DRAWN BY ET
RONALD R. BOHANNAN RAY BOHANNAN PE. #7868	DATE 07-11-05
2520-GRC-7-8-05	
GRADING AND DRAINAGE PLAN	
TIERRA WEST, LLC 8509 JEFFERSON NE ALBUQUERQUE, NEW MEXICO 87113 (505)858-3100	
SHEET # 3 of 12	
JOB # 25020	

FOR REFERENCE ONLY

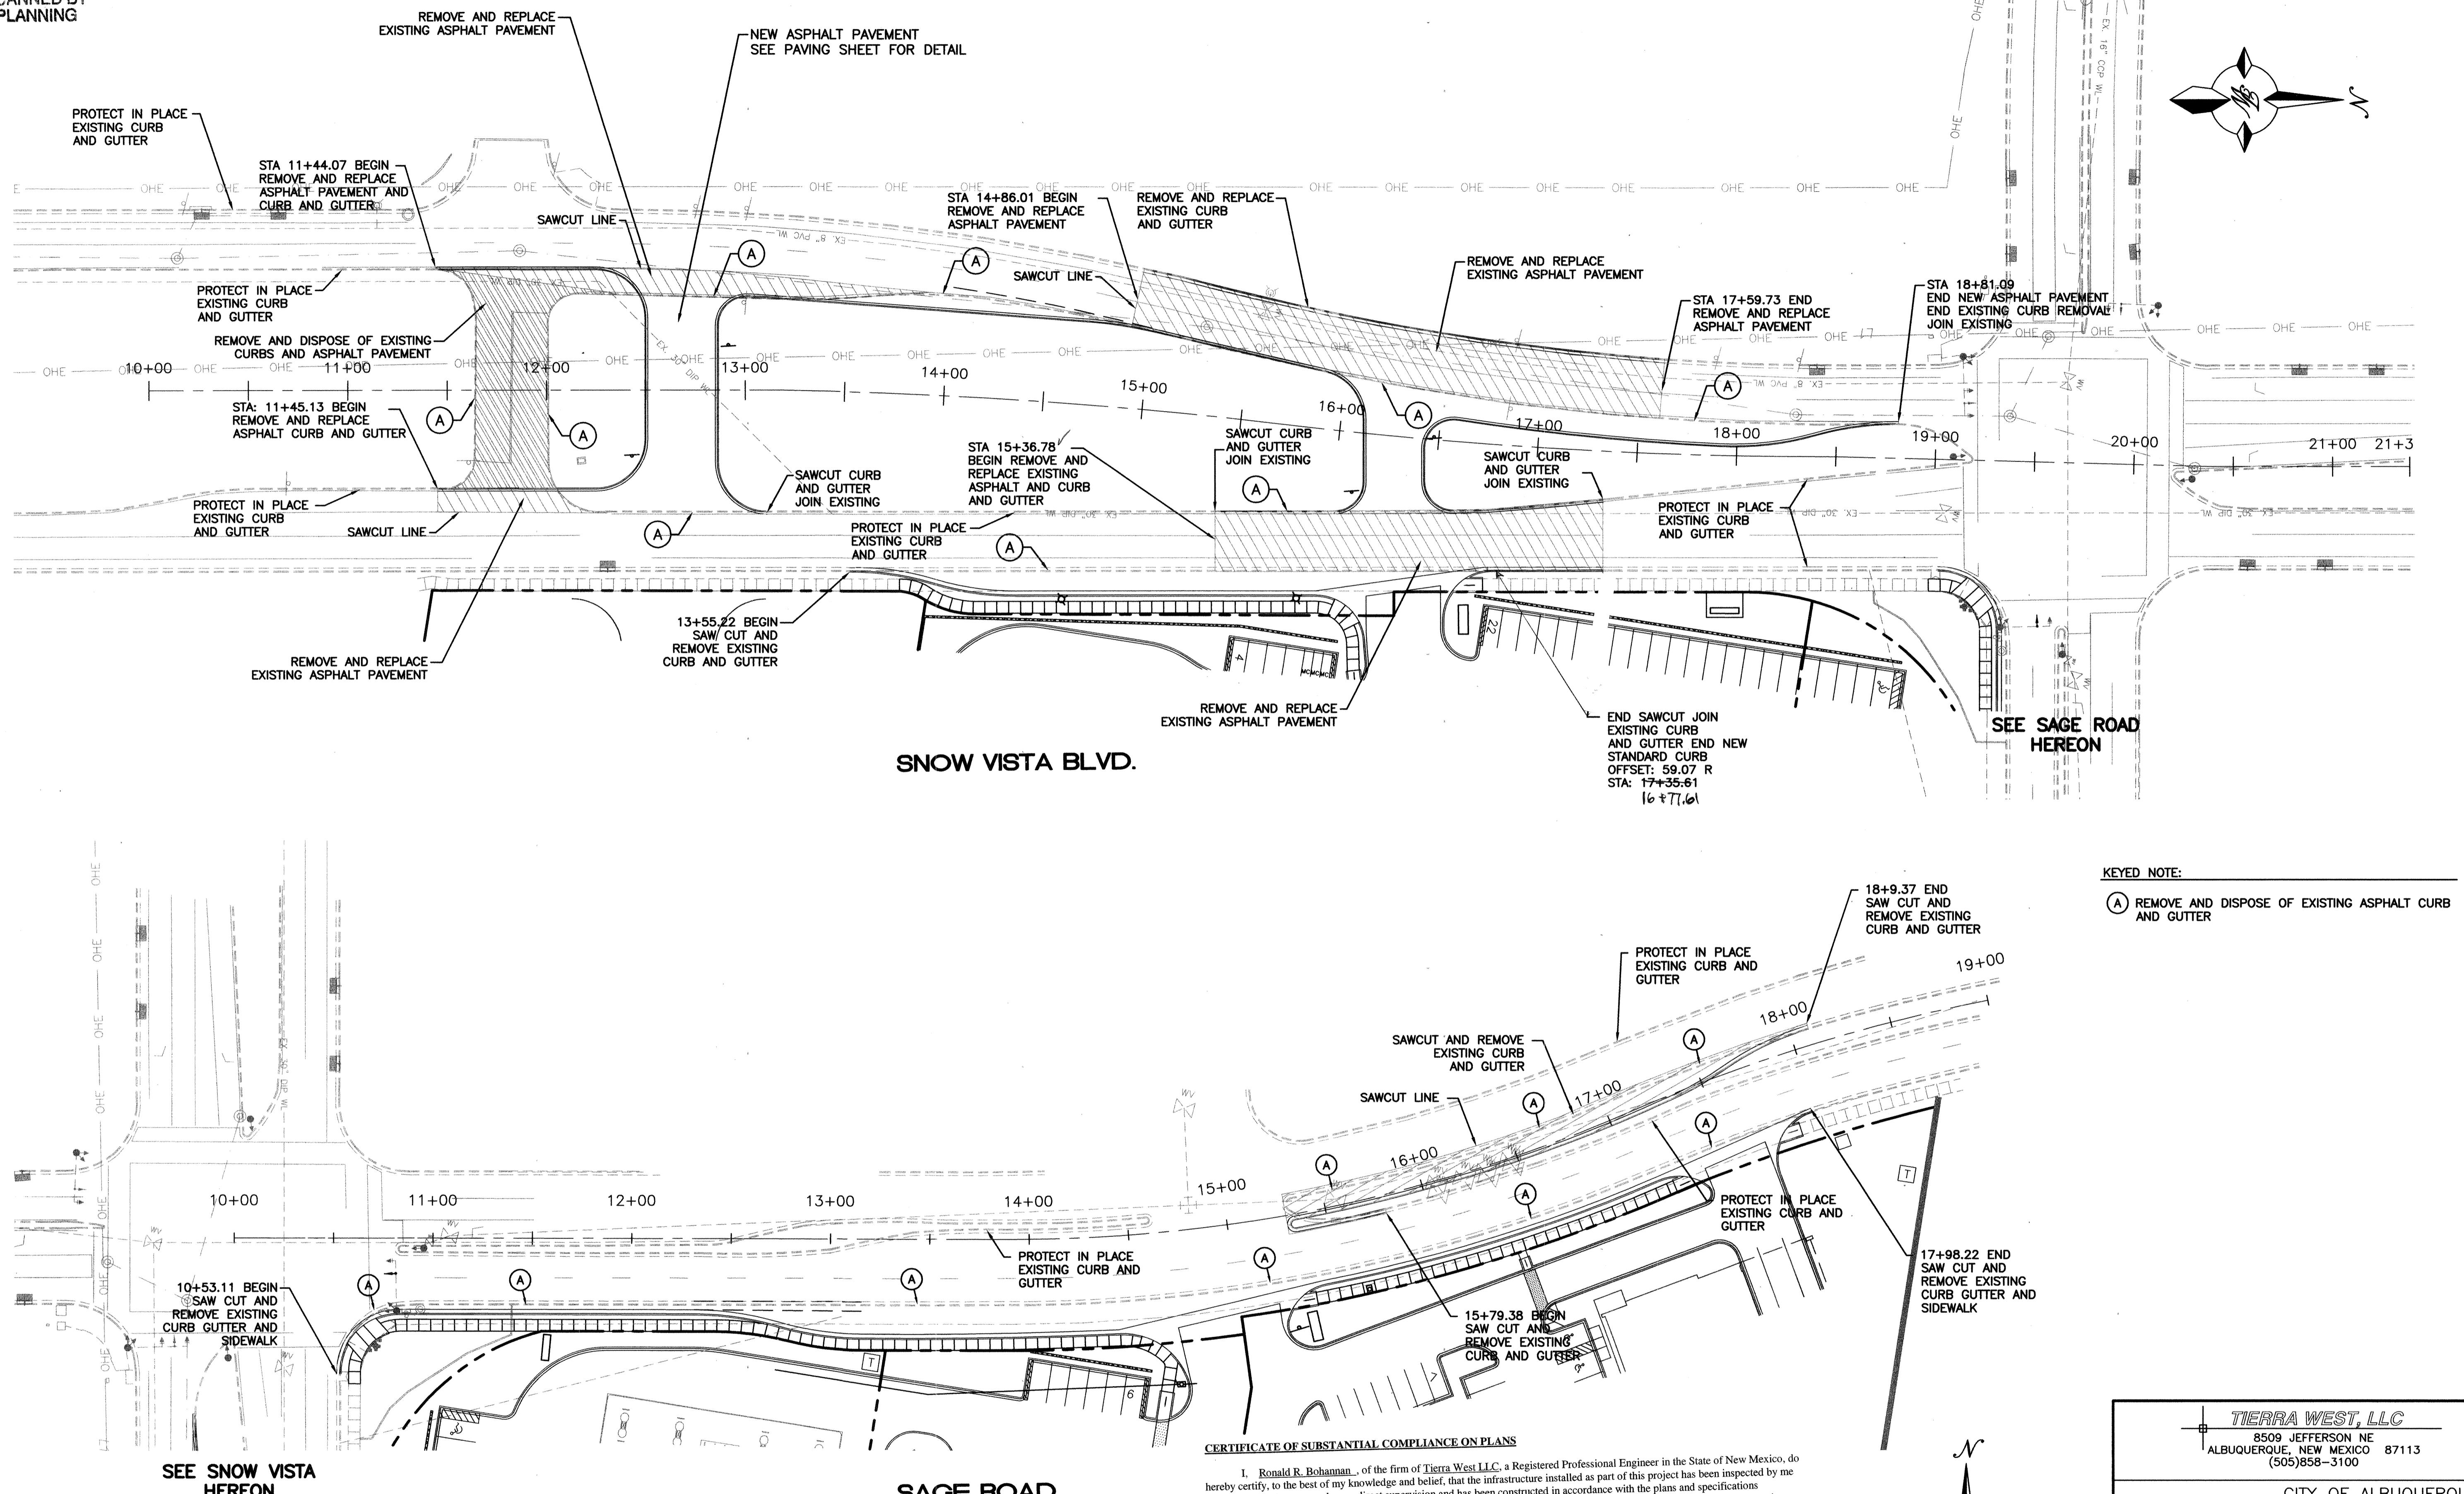

AS BUILT INFORMATION	
BENCH MARKS	AC'S. MONUMENT "2-149"
FIELD NOTES	CO.A. BRASS CAP
NO. BY DATE	NM STATE PLANE COORDINATES
RECORDED BY DATE	Central Zone - N.A.D. 1927
RECORDED BY DATE	X=54.207.50
RECORDED BY DATE	Y=47.257.74
RECORDED BY DATE	Z=0.096787
RECORDED BY DATE	Da = 01'16.47"
RECORDED BY DATE	ELEV=5133.97 (NG/D29)




DESIGNED BY: SA	DRAWN BY: EMT	REMARKS	REVISIONS	DESIGN

TITLE: 98TH AND SAGE
PAVEMENT REMOVAL
SNOW VISTA BLVD AND SAGE ROAD


DESIGN REVIEW COMMITTEE APPROVED CITY ENGINEER APPROVAL

LAST DESIGN UPDATE NO./DAY/YR. NO./DAY/YR.

CITY PROJECT NO. 7697.81 ZONE MAP NO. M-9 SHEET OF 4 - 12

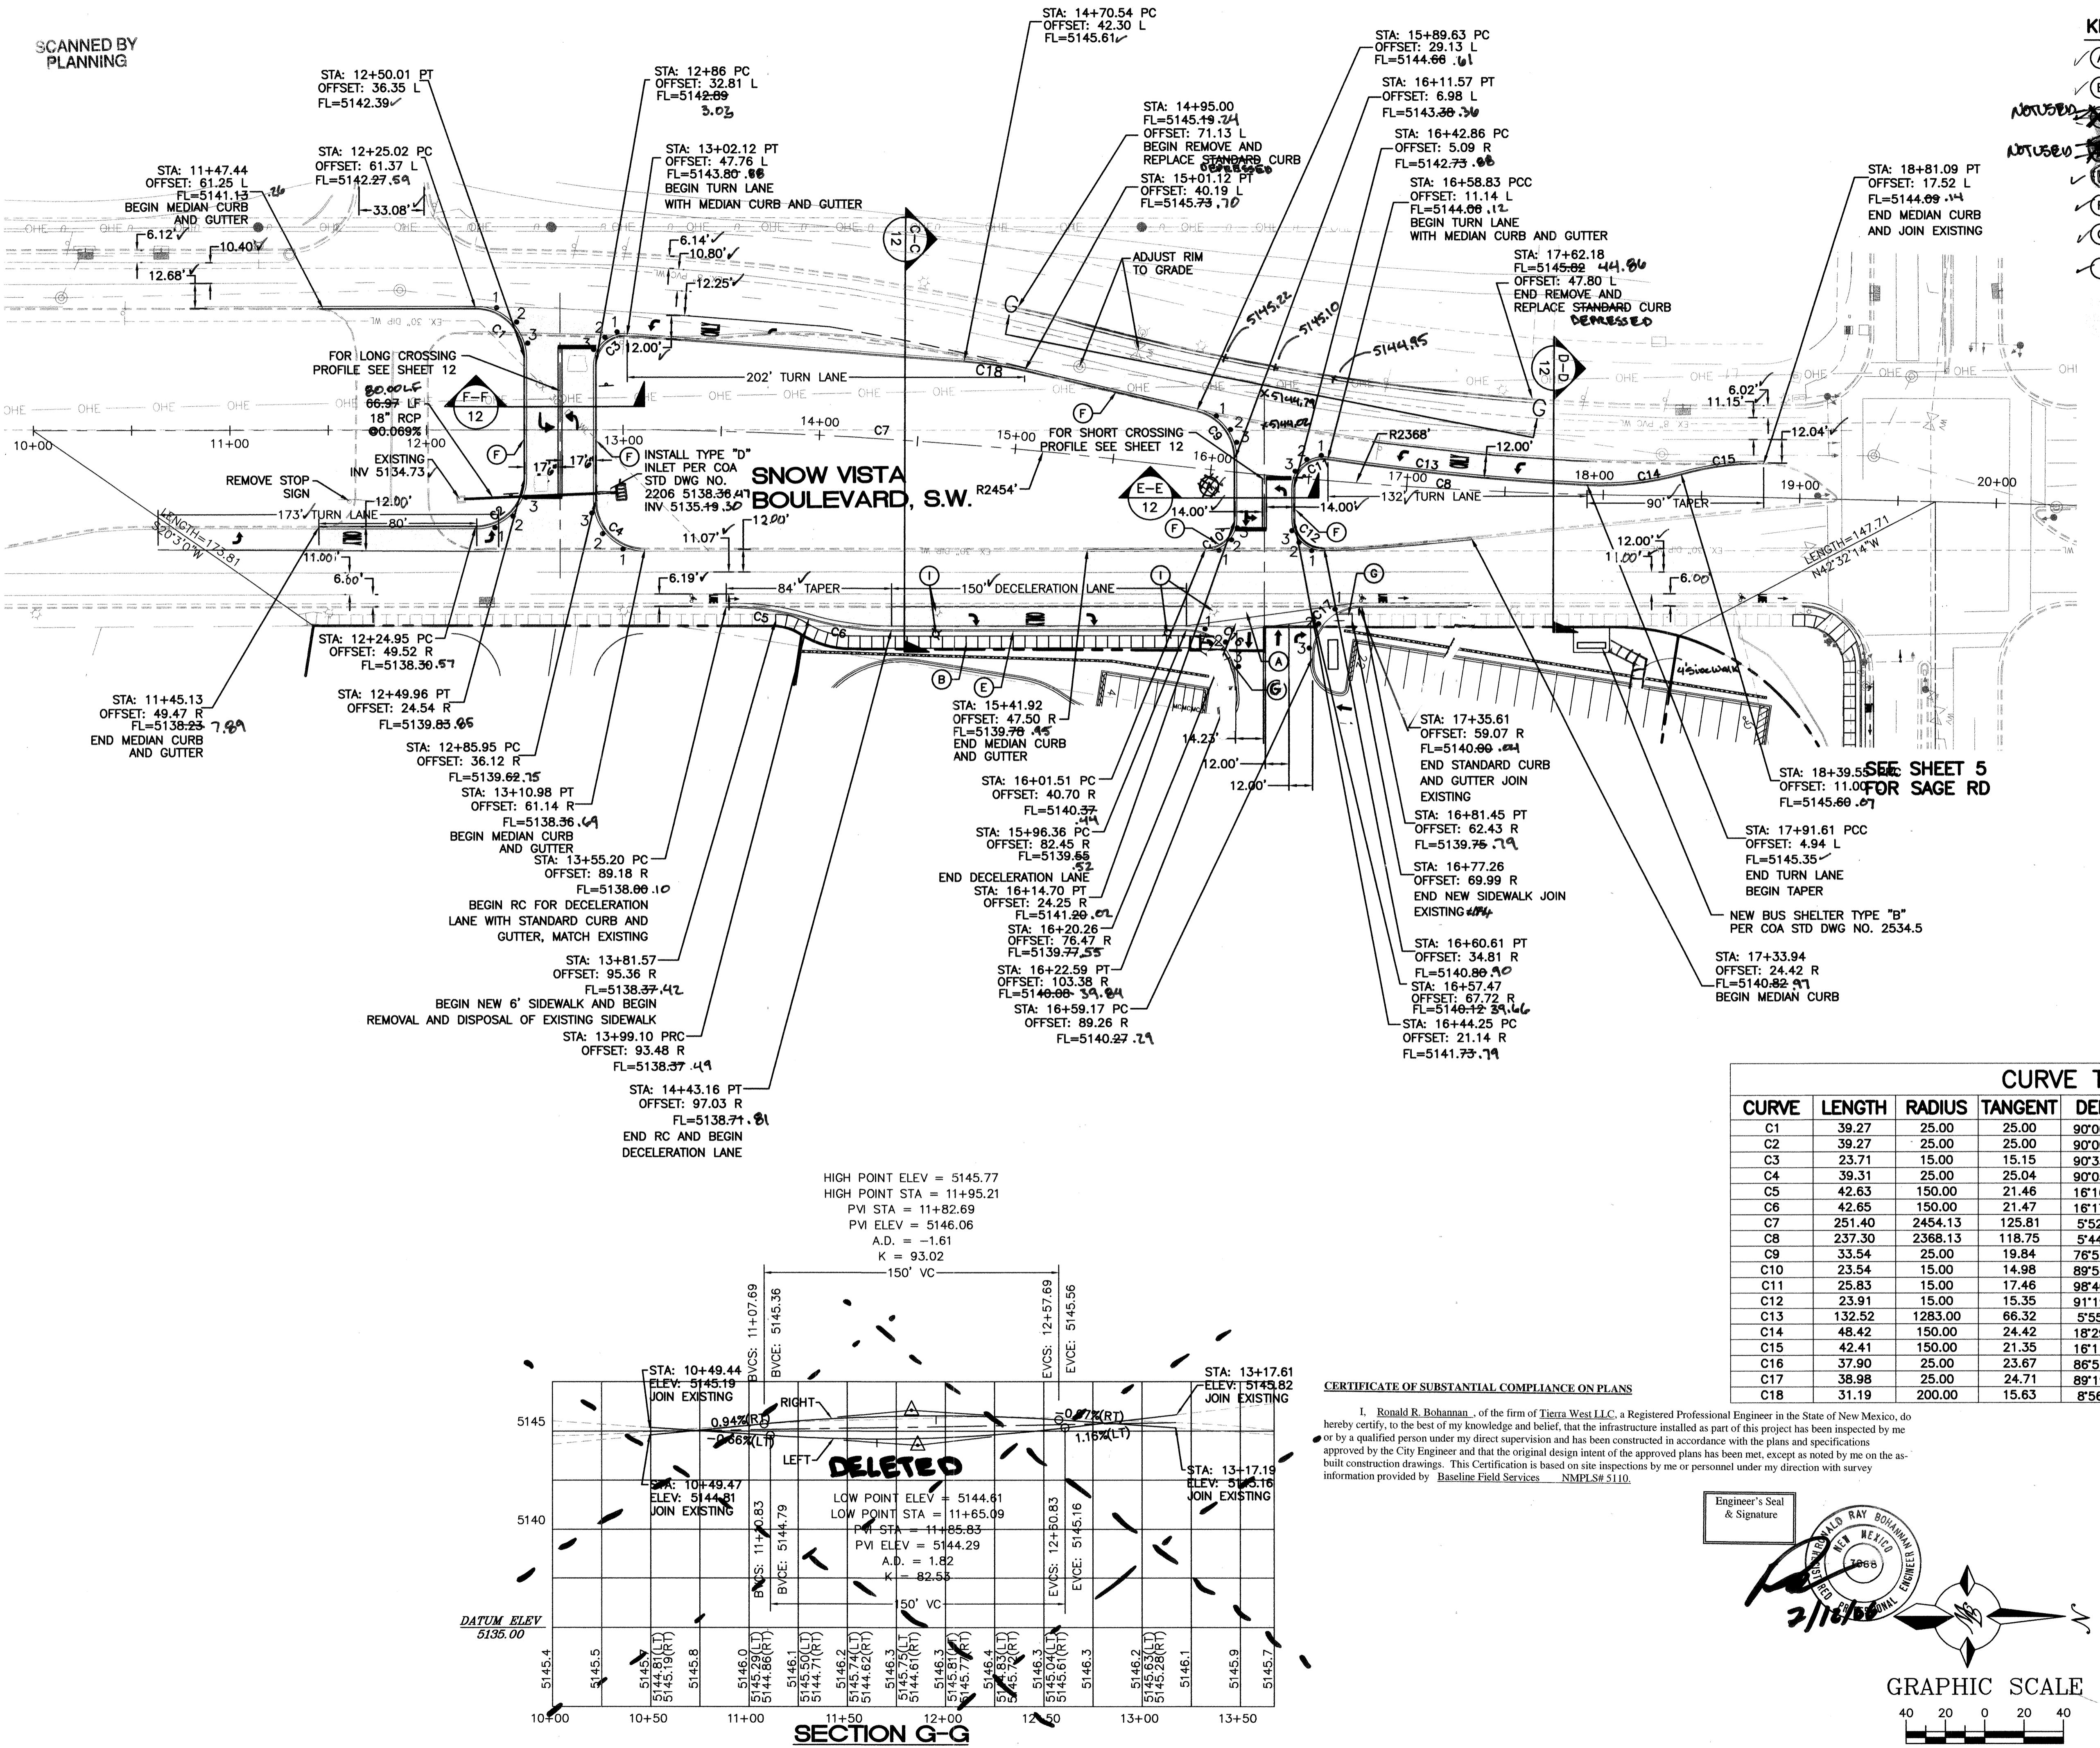

TIERRA WEST, LLC	8509 JEFFERSON NE	ALBUQUERQUE, NEW MEXICO 87113
		(505)858-3100
CITY OF ALBUQUERQUE		
PUBLIC WORKS DEPARTMENT		
ENGINEERING GROUP		
TITLE: 98TH AND SAGE		
PAVING IMPROVEMENTS		
SNOW VISTA BLVD		
DESIGNED BY: EM	DRAWN BY: EM	REMARKS: DESIGN
NO.:	DATE:	REVISIONS:
DRAWN NAME: 2520-Snow Vista-Pv.dwg		
CHECKED BY: RR		
DESIGNED BY: SA	DRAWN BY: RR	JOB NO.: 252020
DATE: 12-9-05		DATE: 12-9-05
APPROVED	APPROVED	LAST DESIGN UPDATE
DEC 12 2005	DEC 12 2005	MO./DAY/YR. MO./DAY/YR.
DESIGN REVIEW COMMITTEE	CITY ENGINEER APPROVAL	
CITY PROJECT NO. 7697.81		ZONE MAP NO. M-9
SHEET OF 5 - 12		

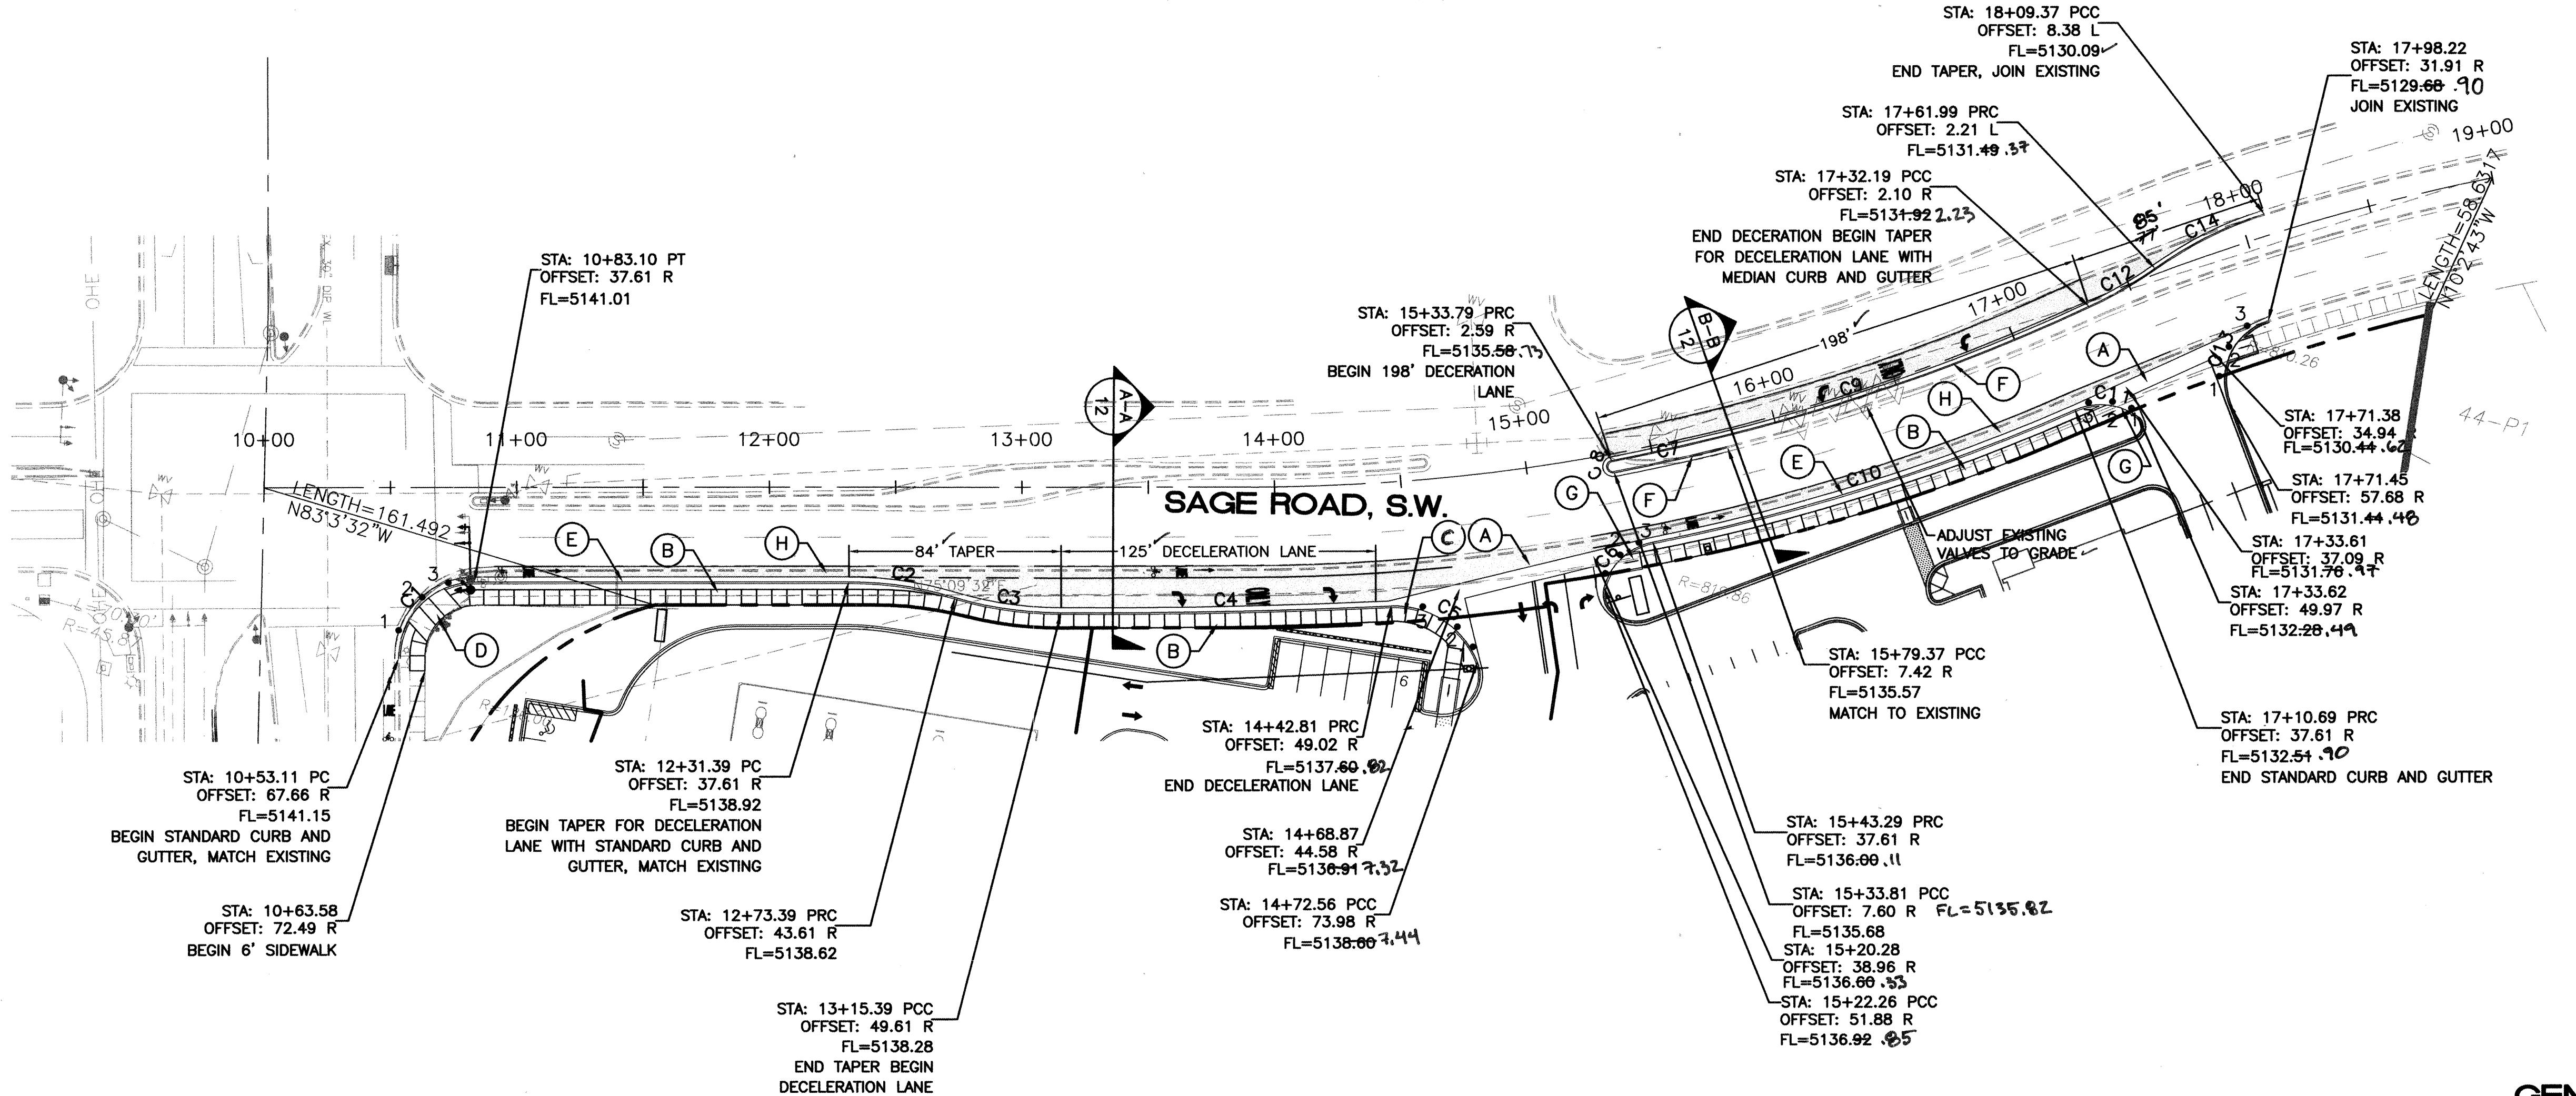

CURVE TABLE							
CURVE	LENGTH	RADIUS	TANGENT	DELTA	CHORD BEARING	CHORD LENGTH	
C1	47.17	30.00	30.04	9°04'57"	S3°07'01"W	42.46	
C2	42.57	150.00	21.43	16°15'37"	S8°31'20"W	42.43	
C3	42.57	150.00	21.43	16°15'36"	N8°31'21"E	42.43	
C4	130.70	2479.28	65.36	3°01'14"	N7°04'04"E	130.68	
C5	43.39	35.00	24.98	71°02'02"	N7°15'32"W	40.67	
C6	27.84	25.00	15.56	63°47'46"	S3°22'09"W	26.42	
C7	46.00	818.21	23.01	3°13'16"	N6°22'09"E	45.99	
C8	7.87	2.51	INFINITE	180°00'00"	S2°54'13"E	5.01	
C9	198.90	813.20	99.95	14°00'51"	N5°18'22"E	198.41	
C10	175.51	814.50	88.09	12°20'45"	N5°44'09"E	175.17	
C11	26.29	25.00	14.51	60°15'26"	S8°14'30"W	25.10	
C12	30.17	150.00	15.13	11°31'21"	N4°57'45"E	30.11	
C13	40.42	25.00	26.17	9°37'41"	S10°57'14"W	36.16	
C14	48.28	150.00	24.35	18°26'26"	S4°05'18"W	48.07	

QUARTER POINTS

C1	FL	ELEV.	C5	FL	ELEV.
	1	41.11		1	38.35
	2	41.08		2	38.10
	3	41.04		3	37.85
C6	FL	ELEV.	C11	FL	ELEV.
	1	36.69		1	32.33
	2	36.46		2	32.39
	3	36.23		3	32.45
C13	FL	ELEV.			
	1	31.00			
	2	30.56			
	3	30.12			

CERTIFICATE OF SUBSTANTIAL COMPLIANCE ON PLANS

I, Ronald R. Bohannan, of the firm of Tierra West LLC, a Registered Professional Engineer in the State of New Mexico, do hereby certify, to the best of my knowledge and belief, that the infrastructure installed as part of this project has been inspected by me or by a qualified person under my direct supervision and has been constructed in accordance with the plans and specifications approved by the City Engineer and that the original design intent of the approved plans has been met, except as noted by me on the as-built construction drawings. This Certification is based on site inspections by me or personnel under my direction with survey information provided by Baseline Field Services NMPLS# 5110.

Engineer's Seal & Signature



GENERAL NOTES:


1. ADJUST ALL WATER VALVE COVERS TO NEW GRADE INCLUDING TWO PRV MH COVERS.
2. ADJUST TELEPHONE MH COVER TO NEW GRADE.

KEYED NOTE:

- ✓ (A) 6' VALLEY GUTTER PER COA STD DWG #2420
- ✓ (B) 6' SIDEWALK TO BE BUILT WITH THIS WORK ORDER PER COA STD DWG #2430
- ✓ (C) WHEEL CHAIR RAMP PER COA STD DWG #2441 CASE I
- ✓ (D) WHEEL CHAIR RAMP PER COA STD DWG #2441 CASE II
- ✓ (E) STANDARD CURB PER COA STD DWG #2415A
- ✓ (F) MEDIAN CURB PER COA STD DWG #2415B
- ✓ (G) UNIDIRECTIONAL WHEELCHAIR RAMP SEE DETAIL SHEET 12
- ✓ (H) 6' BIKE LANE

NEW PAVEMENT

TIERRA WEST, LLC		8509 JEFFERSON NE ALBUQUERQUE, NEW MEXICO 87113 (505)858-3100
CITY OF ALBUQUERQUE PUBLIC WORKS DEPARTMENT ENGINEERING GROUP		
TITLE: 98TH AND SAGE PAVING IMPROVEMENTS SAGE ROAD S.W.		
DESIGNED BY: SA	DRAWN BY: EMT	CHECKED BY: RRBD
NO. DATE	REMARKS	REVISIONS
DESIGNED BY: SA	DRAWN NAME: 2520-98th-Pv.dwg	CHECKED BY: RRBD
NO. DATE	JOB NO.: 25020	DATE: 10-26-05
LAST DESIGN UPDATE	MO./DAY/YR.	MO./DAY/YR.
APPROVED DEC 1 2 2005 DESIGN REVIEW COMMITTEE	APPROVED DEC 1 2 2005 CITY ENGINEER	
CITY PROJECT NO. 7697.81		ZONE MAP NO. M-9
SHEET 6 - 12		OF

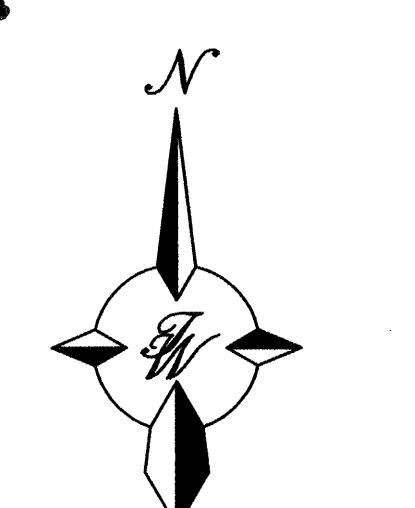



SCALE: 1"=40'
40 20 0 40 40

GRAPHIC SCALE

AS BUILT INFORMATION	
ENGINEER'S SEAL	SURVEY INFORMATION
FIELD NOTES	BENCH MARKS
NO. BY	ACS MONUMENT "2-MG"
	C.O.A. BRASS CAP
	MM STATE PLANE COORDINATES
	Central Zone - N.A.D. 1927
	X=354,207.50 Y=1,473,257.74
	C-G-0-967887
	Do= 0' 16.47"
	ELEV=1533.97 (NCV29)
RECORDED BY	DATE
	NO.
MICRO-FILM INFORMATION	
DATE	DATE


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RESTRAINED JOINT LENGTHS FOR TEES*						
SIZE	LENGTH ALONG RUN**					
	5'	4'	3'	2'	1'	0'
12x12x12	14	18	22	25	29	33
12x12x10	6	10	14	19	23	28
12x12x8	1	1	7	12	18	23
12x12x6	1	1	1	3	10	18
12x12x4	1	1	1	1	2	12
10x10x10	9	13	17	20	24	28
10x10x6	1	1	1	6	12	18
10x10x4	1	1	1	1	4	12
8x8x8	5	9	13	16	20	23
8x8x6	1	1	3	8	13	18
8x8x4	1	1	1	1	6	12
6x6x6	1	3	7	10	14	18
8x8x4	1	1	1	1	6	12

*RESTRAINTS ONLY PLACED ON THE BRANCH
**LENGTH ALONG RUN REFERS TO THE LENGTH OF PIPE ON
EITHER SIDE OF THE TEE BEFORE THE NEXT JOINT.

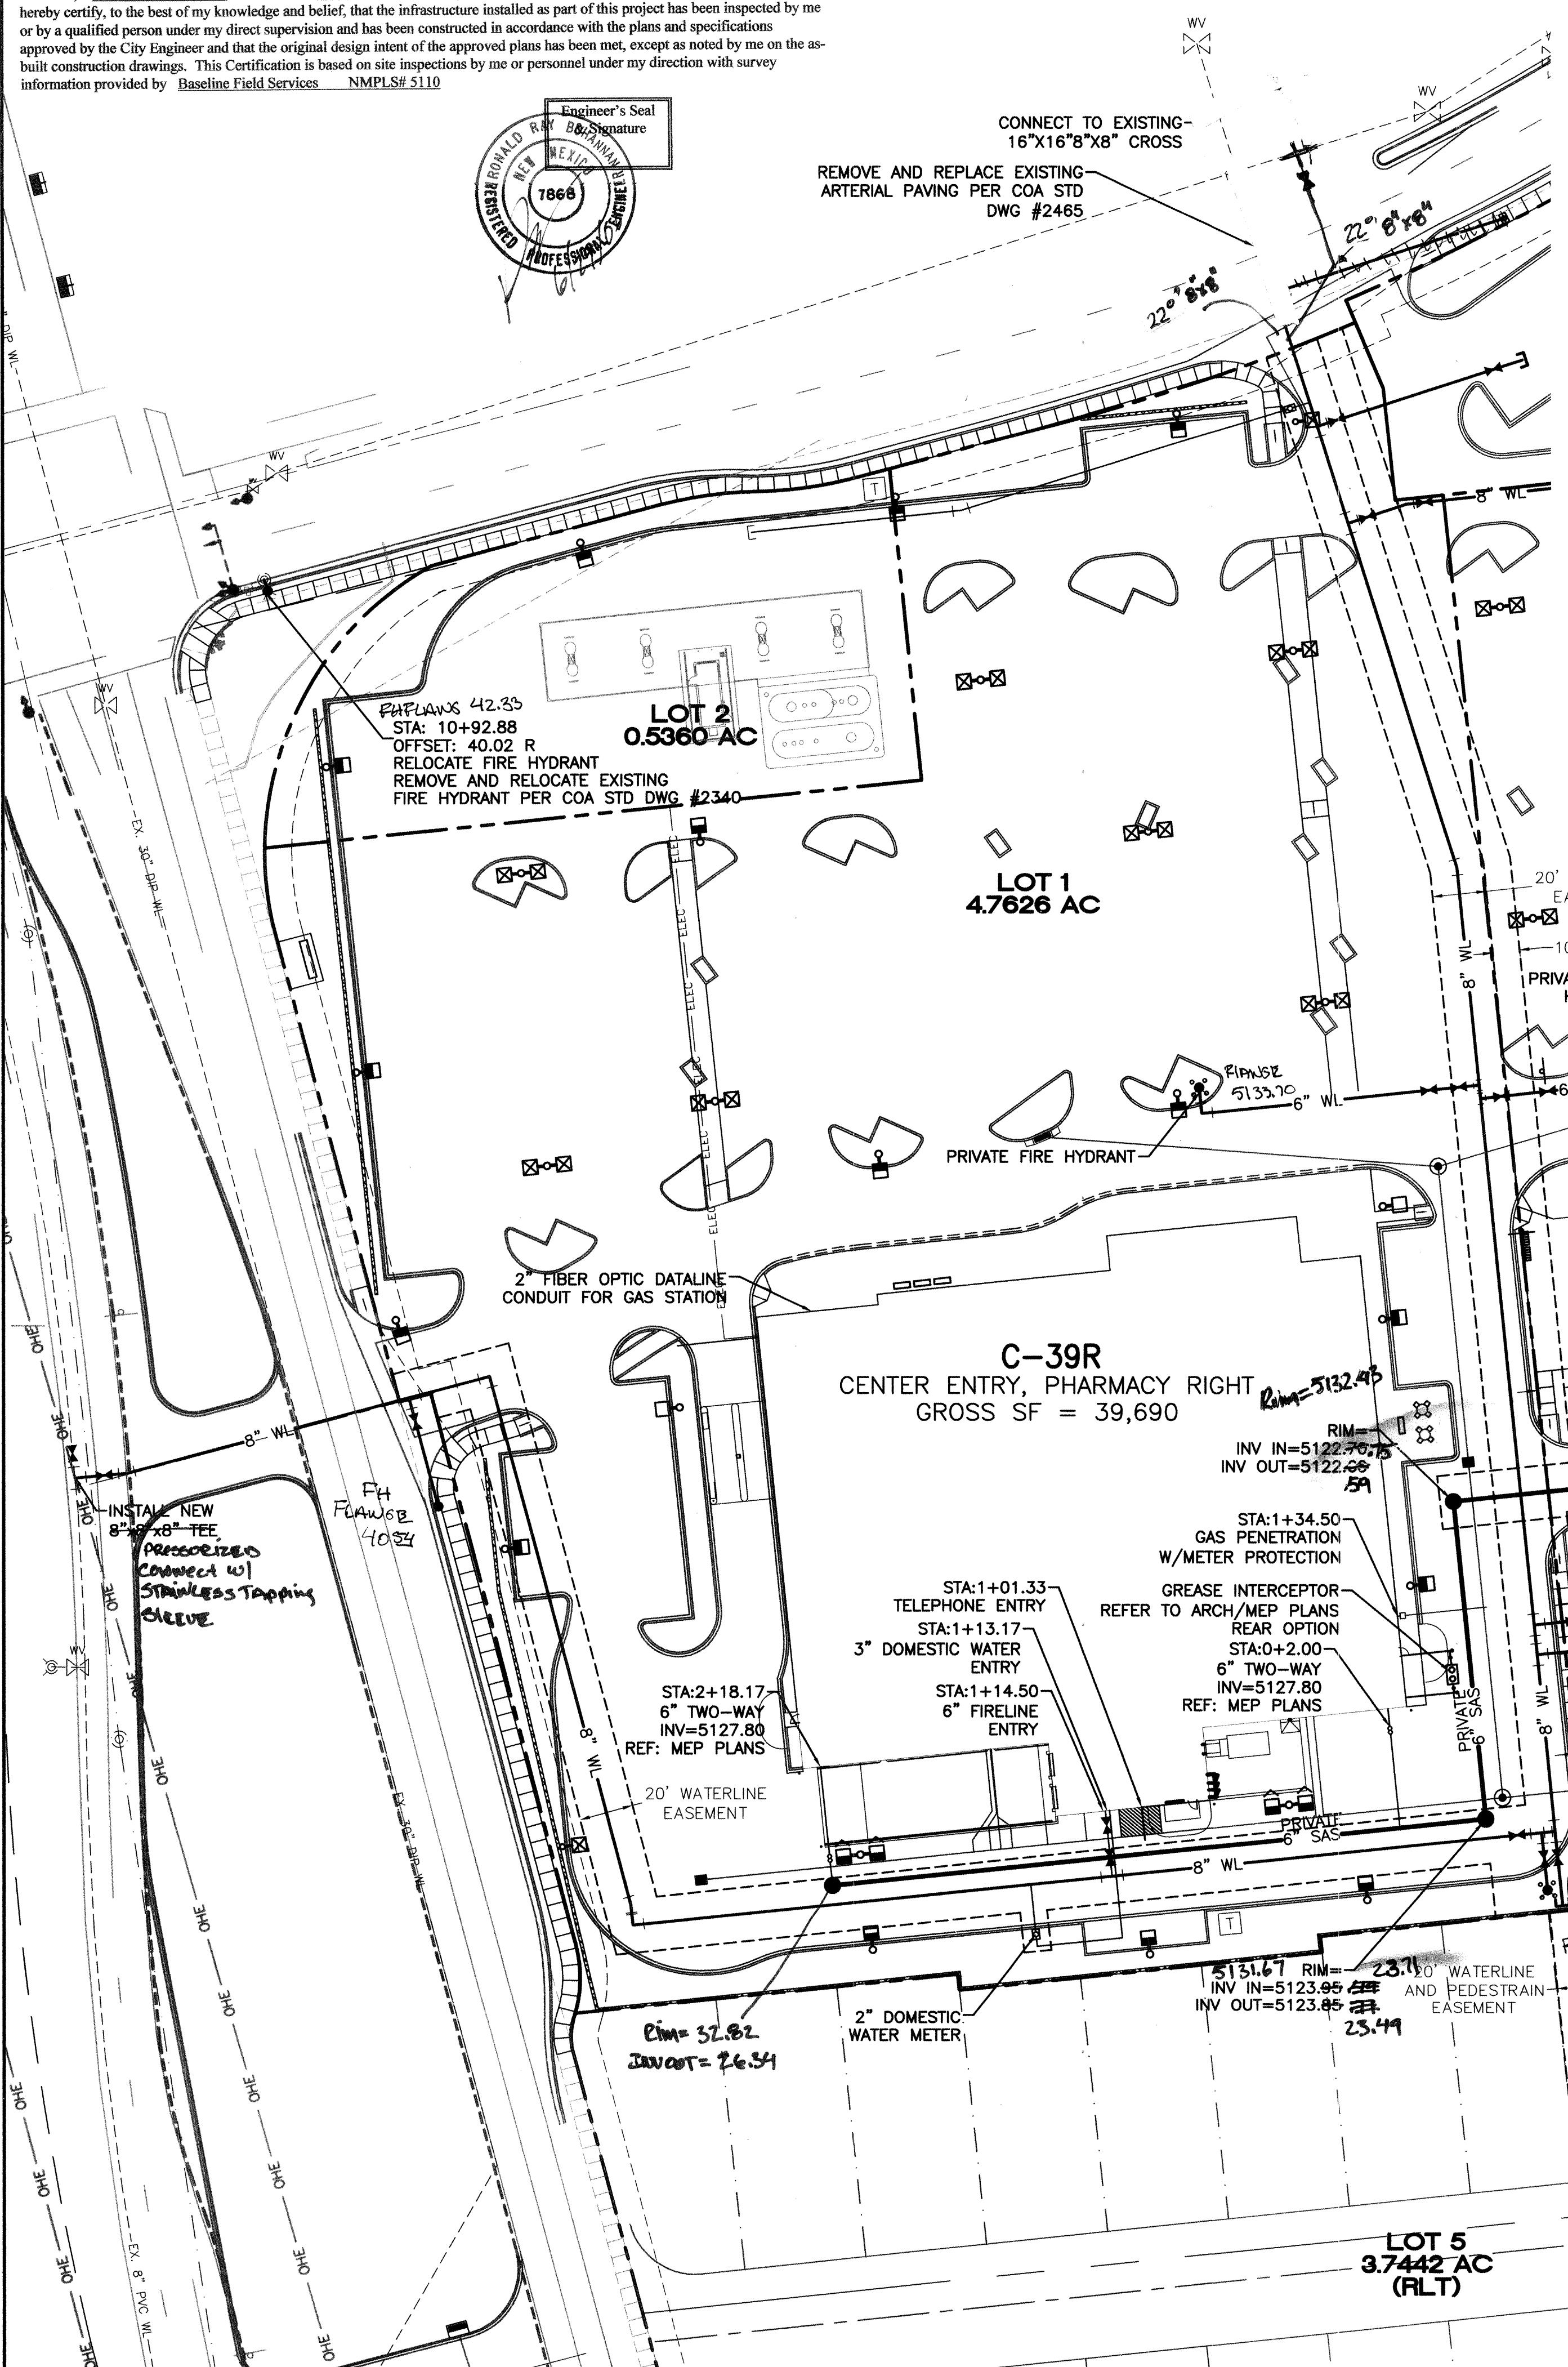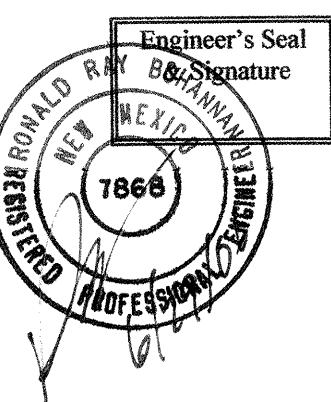

12" SUBGRADE PREP
COMPACT TO 95%
MODIFIED PROCTOR

CONCRETE CHANNEL SECTION A-A
NTS

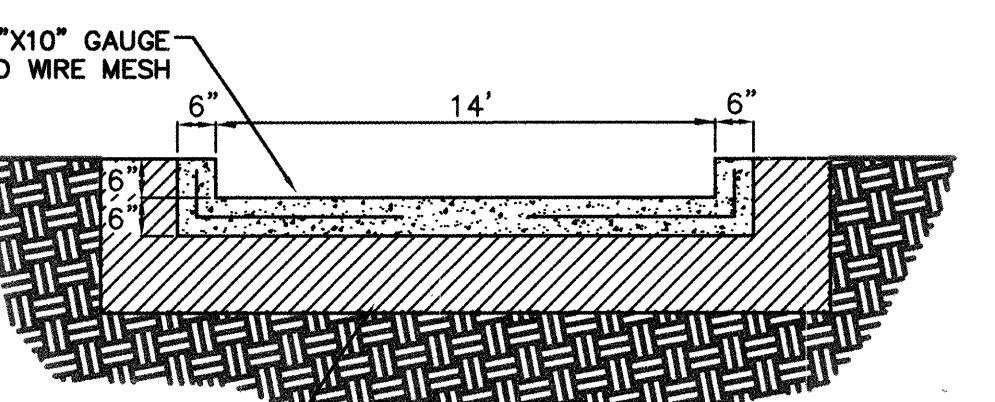GENERAL NOTES:

- ALL WATER AND SEWER UTILITY WORK TO BE DONE IN ACCORDANCE WITH C.O.A. STANDARDS AND SPECIFICATIONS LATEST EDITION.
2. 4' MINIMUM BURY REQUIRED FOR ALL UTILITIES UNLESS OTHERWISE NOTED.
3. REFERENCE ARCHITECTURAL PLANS FOR WATER LINE RISER LOCATIONS.
4. CLEAN OUTS ARE TO BE BUILT PER UNIFORM PLUMBING CODE STANDARDS.
5. ALL PLUMBING PIPE MATERIAL TO BE USED PER UPC.
6. FIRE LINE AND DOMESTIC WATERLINE MUST HAVE BACKFLOW PREVENTORS PER UPC. IF BACKFLOW PREVENTOR IS INSTALLED EXTERIOR OF BUILDING A HOT BOX SHALL BE INSTALLED AND USED.
7. ALL EX. SD INLETS AND MH SHALL HAVE CONCRETE COLLARS POURED AND BE ADJUSTED TO FINISHED GRADE.
8. ALL EXCAVATION, TRENCHING AND SHORING ACTIVITIES MUST BE CARRIED OUT IN ACCORDANCE WITH OSHA 29 CFR 1926.650 SUBPART P.
9. ALL UTILITY DISTANCES SHOWN ARE FOR REFERENCE ONLY.

RESTRINED JOINT LENGTHS FOR REDUCERS***

SIZE	L. SIDE	SIZE	L. SIDE
12x10	17	10x6	18
12x8	18	10x4	23
12x6	25	8x6	10
12x4	29	8x4	17
10x8	10	6x4	9

***RESTRAINTS ONLY PLACED ON LARGE LARGE SIDE

LEGEND

○ EX. 8" SAS	EXISTING SAS MANHOLE
● PROPOSED SAS MANHOLE	PROPOSED SAS CLEANOUT
— 8" SAS	PROPOSED SANITARY SEWER LINE
— SANITARY SEWER SERVICE LINE	EXISTING WATER LINE
----- EX. 16" WL -----	PROPOSED WATER LINE
— 10" WL	PROPOSED CURB
— BOUNDARY LINE	PROPOSED STORM SEWER MANHOLE
○ 24" RCP	PROPOSED STORM SEWER LINE
— PROPOSED DRY UTILITY TRENCH	EXISTING DRY UTILITY TRENCH

NOTICE TO CONTRACTORS

1. AN EXCAVATION/CONSTRUCTION PERMIT WILL BE REQUIRED BEFORE BEGINNING ANY WORK WITHIN CITY RIGHT-OF-WAY. AN APPROVED COPY OF THESE PLANS MUST BE SUBMITTED AT THE TIME OF APPLICATION FOR THIS PERMIT.

2. ALL WORK DETAILED ON THESE PLANS TO BE PERFORMED, EXCEPT AS OTHERWISE STATED OR PROVIDED HEREON, SHALL BE CONSTRUCTED IN ACCORDANCE WITH COA SPECIFICATIONS FOR WATER AND WASTEWATER FACILITIES (MOST RECENT REVISIONS).

3. TWO WORKING DAYS PRIOR TO ANY EXCAVATION, CONTRACTOR MUST CONTACT NEW MEXICO ONE CALL SYSTEM (260-1999), FOR LOCATION OF EXISTING UTILITIES.

4. PRIOR TO CONSTRUCTION, THE CONTRACTOR SHALL EXCAVATE AND VERIFY THE HORIZONTAL AND VERTICAL LOCATIONS OF ALL CONSTRUCTIONS. SHOULD A CONFLICT EXIST, THE CONTRACTOR SHALL NOTIFY THE ENGINEER SO THAT THE CONFLICT CAN BE RESOLVED WITH A MINIMUM AMOUNT OF DELAY.

5. BACKFILL COMPACTION SHALL BE ACCORDING TO STANDARD STREET USE.

6. MAINTENANCE OF THESE FACILITIES SHALL BE THE RESPONSIBILITY OF THE OWNER OF THE PROPERTY SERVED.

7. WORK ON ARTERIAL STREETS SHALL BE PERFORMED ON A 24-HOUR BASIS.

8. CONTRACTOR IS RESPONSIBLE TO PROVIDE UTILITY STUBS 5' FROM BUILDING

9. CONTRACTOR SHALL DETERMINE LOCATION OF ANY UNDERGROUND FACILITY IN OR NEAR WORK AREAS, INCLUDING REQUESTS TO OWNERS/OPERATORS OF SAID FACILITIES PER SECTION 62-14-5 NMSA 1978.

10. CONTRACTOR SHALL PLAN ALL EXCAVATION TO MINIMIZE INTERFERENCE OR DAMAGE OF UNDERGROUND FACILITIES.

11. CONTRACTOR SHALL PROVIDE ADVANCE TELEPHONE NOTICE OF COMMENCEMENT, EXTENT AND DURATION OF ALL EXCAVATION WORK TO THE ONE-CALL NOTIFICATION SYSTEM, OR TO OWNERS/OPERATORS OF ANY EXISTING UNDERGROUND FACILITY IN OR NEAR THE EXCAVATION AREA THAT ARE NOT MEMBERS OF THE ONE-CALL NOTIFICATION CENTER; IN ORDER THAT OWNERS/OPERATORS MAY LOCATE AND MARK UNDERGROUND FACILITY PER SECTION 62-14-5 NMSA 1978 PRIOR TO ANY COMMENCEMENT OF WORK. CONTRACTOR SHALL REQUEST REAFFIRMATION OF LOCATION EVERY TEN (10) WORKING DAYS AFTER INITIAL REQUEST.

12. CONTRACTOR SHALL MAINTAIN EIGHTEEN (18) INCHES BETWEEN EXISTING UNDERGROUND FACILITIES FOR WHICH HAVE BEEN PREVIOUSLY IDENTIFIED AND MARKED BY THE OWNERS/OPERATORS OF SAID FACILITIES. CUTTING EDGE OR POINT OF ANY MECHANICAL EXCAVATING EQUIPMENT UTILIZED IN EXCAVATION AREA WILL BE USED IN A MANNER NECESSARY TO PREVENT DAMAGE TO EXISTING UNDERGROUND FACILITIES.

13. CONTRACTOR SHALL PROVIDE SUPPORT FOR EXISTING UNDERGROUND FACILITIES IN OR NEAR EXCAVATION AREA AS NECESSARY TO PREVENT DAMAGE TO SAID FACILITIES.

14. CONTRACTOR SHALL BACKFILL ALL EXCAVATIONS IN A MANNER AND WITH MATERIALS AS MAY BE NECESSARY TO PREVENT DAMAGE TO AND PROVIDE RELIABLE SUPPORT DURING AND FOLLOWING BACK FILLING ACTIVITIES FOR PREEXISTING UNDERGROUND FACILITIES IN OR NEAR EXCAVATION AREA.

15. CONTRACTOR SHALL IMMEDIATELY NOTIFY BY TELEPHONE THE OWNER/OPERATOR OF ANY UNDERGROUND FACILITY WHICH MAY HAVE BEEN DAMAGED OR DISLODGED DURING EXCAVATION WORK.

16. CONTRACTOR SHALL NOT MOVE OR OBLITERATE MARKINGS MADE PURSUANT TO CHAPTER 62, ARTICLE 14 NMSA 1978, OR FABRICATE MARKINGS IN AN UNMARKED LOCATION FOR THE PURPOSE OF CONCEALING OR AVOIDING LIABILITY FOR VIOLATION OF OR NONCOMPLIANCE WITH THE PROVISIONS OF CHAPTER 62, ARTICLE 11 NMSA 1978.

CAUTION:

ALL EXISTING UTILITIES SHOWN WERE OBTAINED FROM RESEARCH, AS-BUILTS, SURVEYS OR INFORMATION PROVIDED BY OTHERS. IT SHALL BE THE SOLE RESPONSIBILITY OF THE CONTRACTOR TO CONDUCT ALL NECESSARY FIELD INVESTIGATIONS PRIOR TO AND INCLUDING ANY EXCAVATION, TO DETERMINE THE ACTUAL LOCATION OF UTILITIES AND OTHER IMPROVEMENTS, PRIOR TO STARTING THE WORK. ANY CHANGES FROM THIS PLAN SHALL BE COORDINATED WITH AND APPROVED BY THE ENGINEER.

TIERRA WEST, LLC
8509 JEFFERSON NE
ALBUQUERQUE, NEW MEXICO 87113
(505)858-3100



CITY OF ALBUQUERQUE
PUBLIC WORKS DEPARTMENT
ENGINEERING GROUP

TITLE:
98TH AND SAGE
MASTER UTILITY IMPROVEMENT

DESIGN REVIEW COMMITTEE APPROVED DEC 12 2005 DESIGN REVIEW COMMITTEE	CITY ENGINEER APPROVAL DEC 12 2005 CITY ENGINEER	MO./DAY/YR. MO./DAY/YR.
CITY PROJECT NO. 7697.81		ZONE MAP NO. M-9
SHEET 7 OF 12		



DESIGNED BY: EMT	DRAWN BY: EMT	REVISIONS
NO. DATE	NO. DATE	REVISIONS
REVISIONS	REVISIONS	DESIGN
DESIGNED BY: SA	DRAWN NAME: 2520-MUC.dwg	DATE: 10-26-05
CHECKED BY: RRB	RECHECKED BY: RRB	

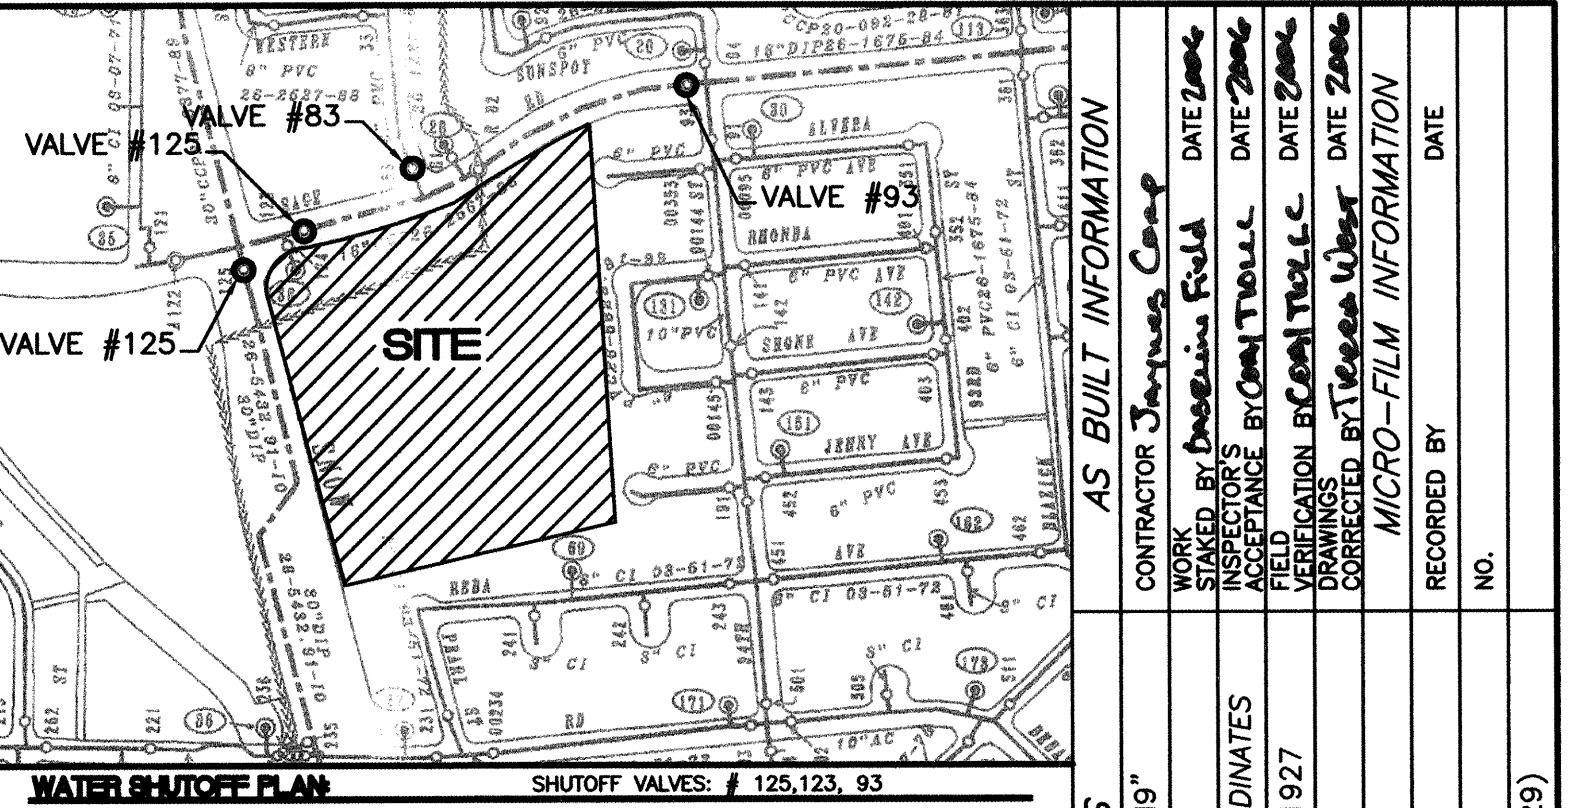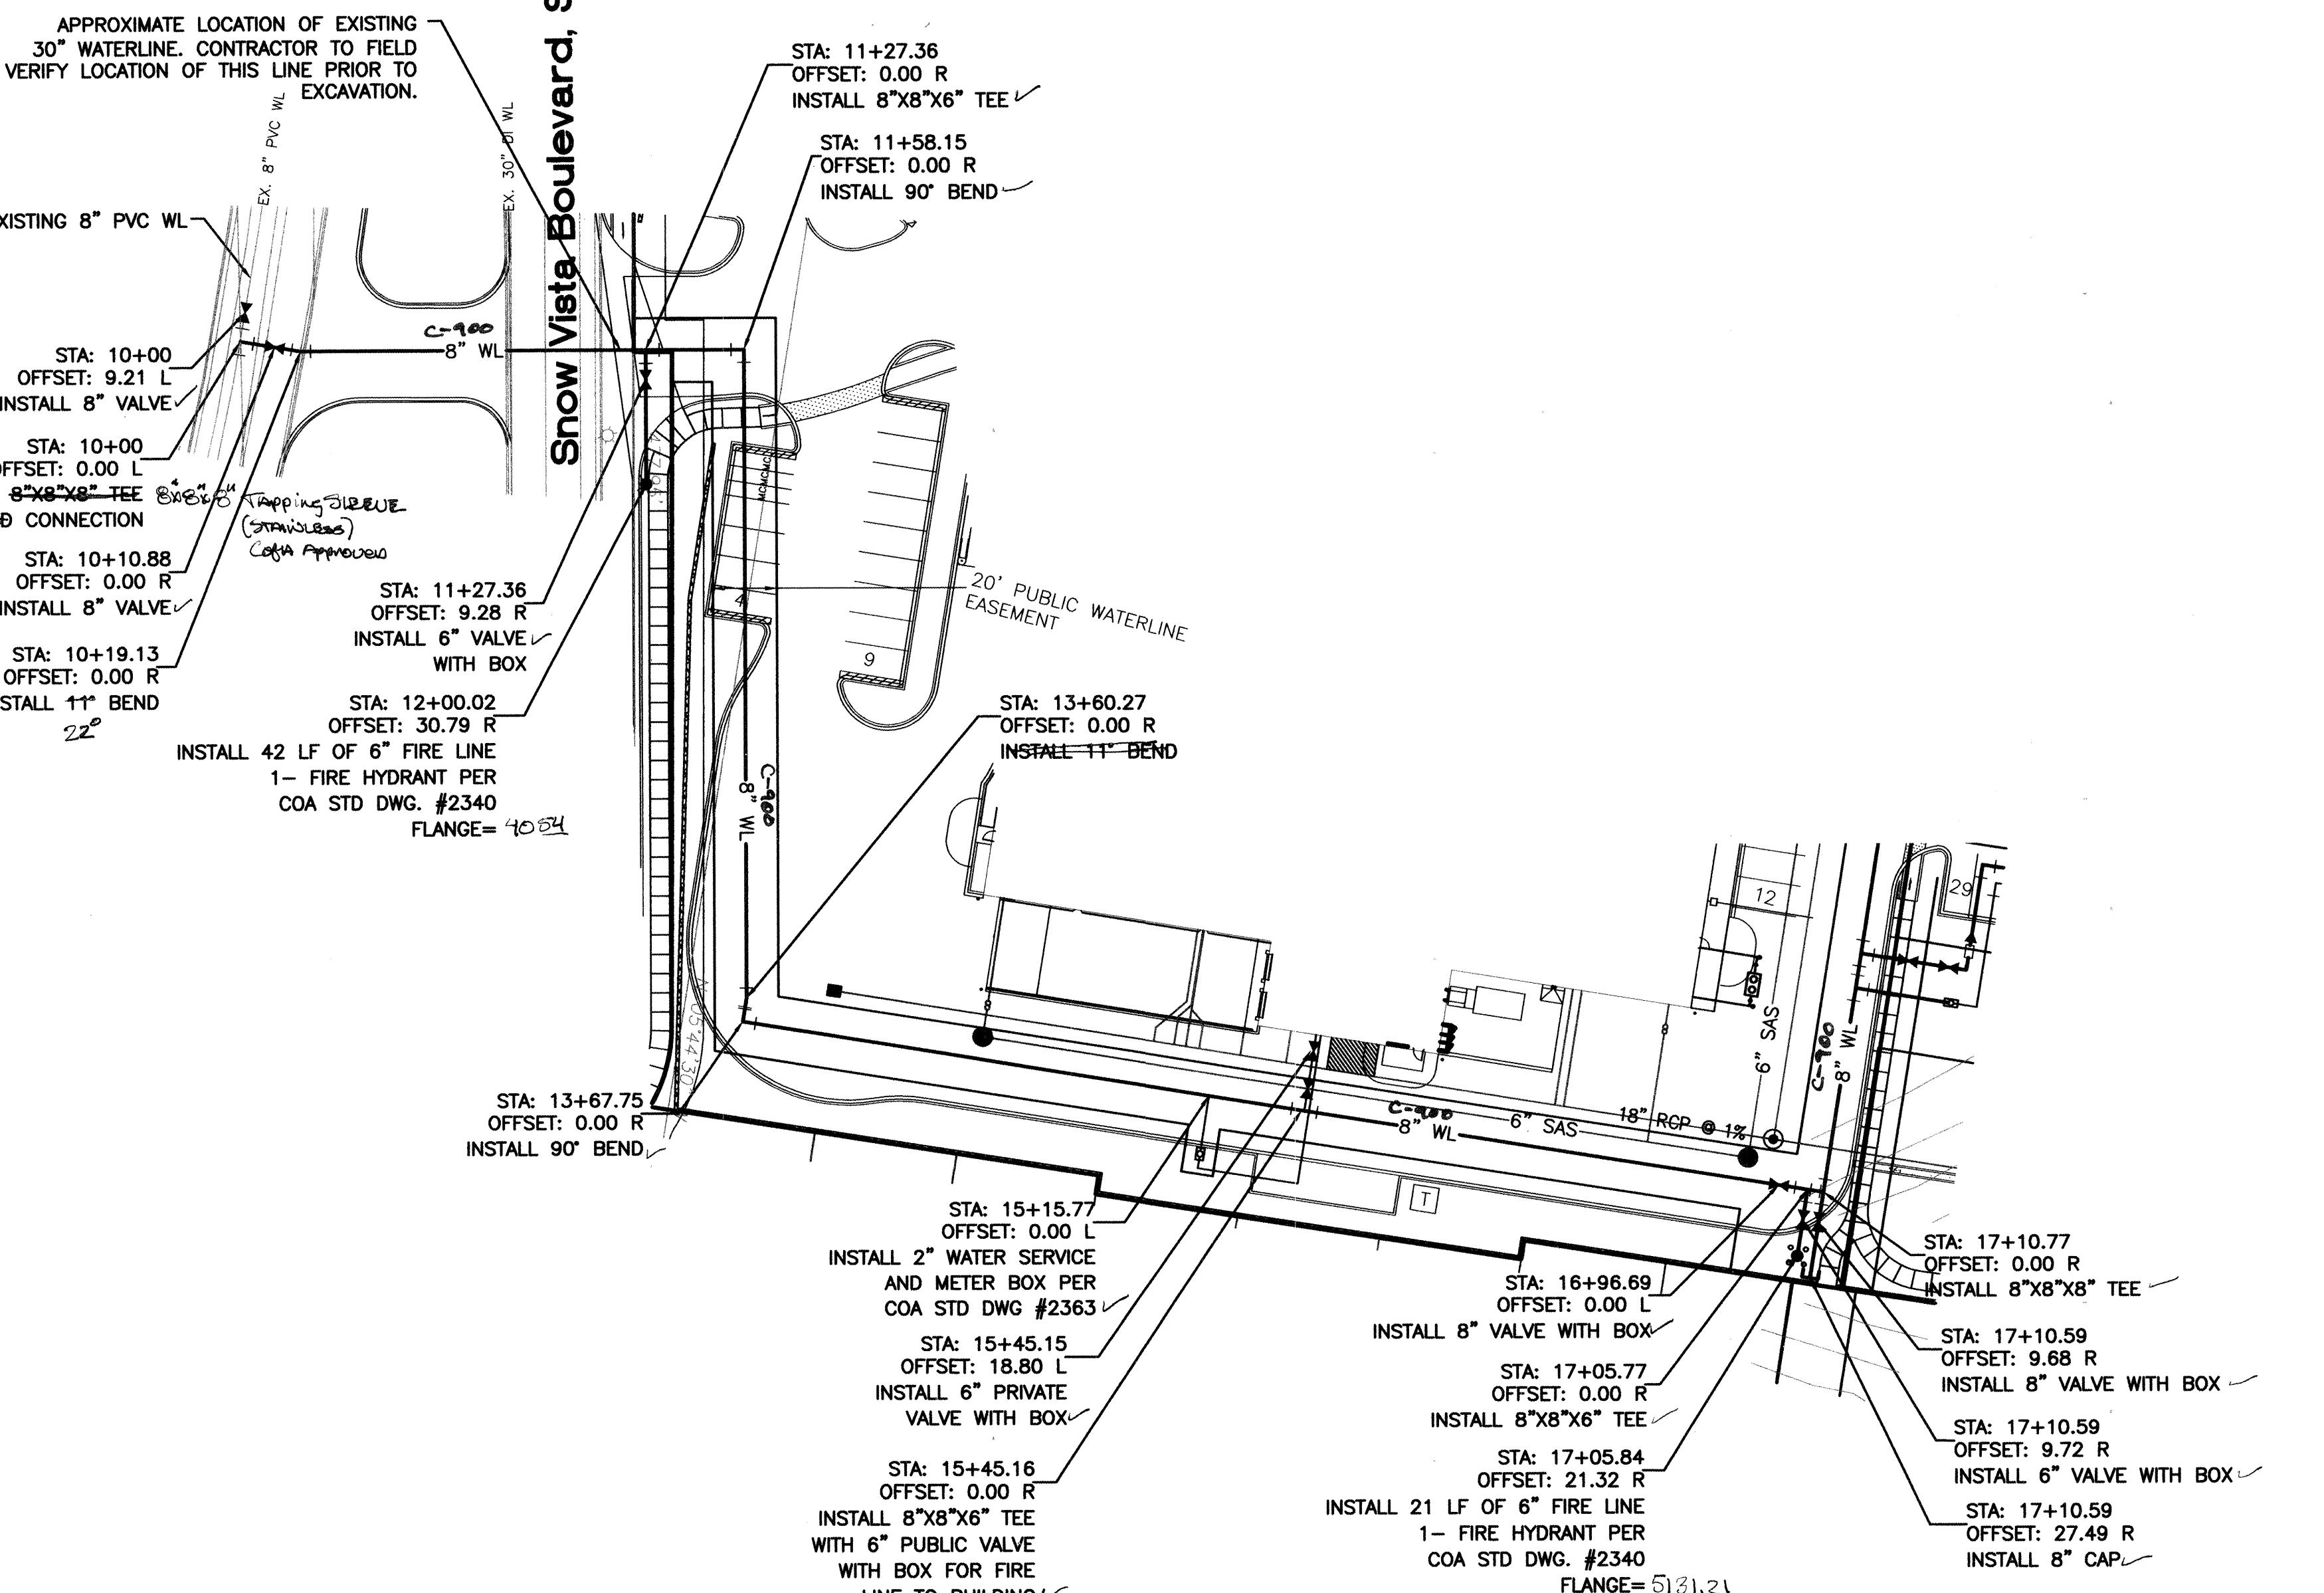


AS BUILT INFORMATION	
CONTRACTOR <i>James Cane</i>	DATE <i>2/2005</i>
STAKED BY <i>Baseline Field</i>	DATE <i>2/2005</i>
INSPECTORS BY <i>COA</i>	DATE <i>2/2005</i>
FIELD STAKEOUTS <i>None</i>	DATE <i>2/2005</i>
VEGETATION REMOVED <i>None</i>	DATE <i>2/2005</i>
DRAWINGS REVISED <i>None</i>	DATE <i>2/2005</i>
MICRO-FLIM INFORMATION	DATE
RECORDED BY <i>No</i>	NO.
ELEV=5133.97 (NSyD9)	


- ONLY WATER SYSTEMS PERSONNEL ARE AUTHORIZED TO OPERATE VALVES.
 - NOTIFY CITY OF ALBUQUERQUE, WATER SYSTEMS DIVISION (PHONE 857-8200) SEVEN (7) WORKING DAYS IN ADVANCE OF NEEDING EXECUTION OF THE WATER SHUT OFF PLAN
 - APPROXIMATE SHUT OFF TIME WILL BE 24 HOURS.
 - SHUTOFF THE VALVES INDICATED IN THE PLAN ABOVE.
- NOTE:**
- SEE MASTER UTILITY PLAN FOR SANITARY SEWER SERVICE CONNECTION DETAILS.
 - ALL FIRE HYDRANTS ARE TO BE BUILT PER COA STD DWG #2340
 - ALL EXISTING UTILITY CONNECTION LOCATIONS AND MARKS MUST BE FIELD VERIFIED BY CONTRACTOR PRIOR TO AND CONSTRUCTION OF UTILITIES.
 - SEE SHEET 7 FOR RESTRAINING TABLE.
 - ELECTRONIC MARKER DISCS ARE REQUIRED FOR WATER LINE AND SANITARY SEWER LINES AS PER CITY STANDARD SECTION 170.

CERTIFICATE OF SUBSTANTIAL COMPLIANCE ON PLANS

I, Ronald R. Bohannan, of the firm of Tierra West LLC, a Registered Professional Engineer in the State of New Mexico, do hereby certify, to the best of my knowledge and belief, that the infrastructure installed as part of this project has been inspected by me or by a qualified person under my direct supervision and has been constructed in accordance with the plans and specifications approved by the City Engineer and that the original design intent of the approved plans has been met, except as noted by me on the as-built construction drawings. This Certification is based on site inspections by me or personnel under my direction with survey information provided by *Baseline Field Services NMPLES# 5110*.

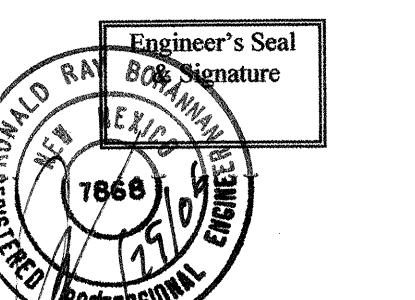

CAUTION:
EXISTING UTILITIES ARE NOT SHOWN.
IT SHALL BE THE SOLE RESPONSIBILITY
OF THE CONTRACTOR TO CONDUCT ALL
NECESSARY FIELD INVESTIGATIONS PRIOR
TO ANY EXCAVATION TO DETERMINE THE
ACTUAL LOCATION OF UTILITIES & OTHER
IMPROVEMENTS.

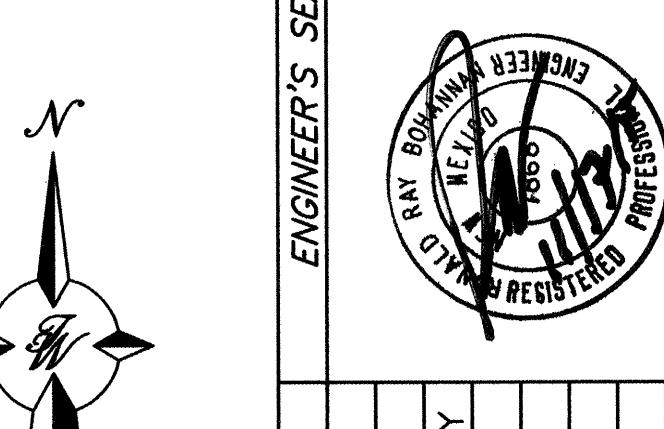
SCALE: HORIZ. 1"=50'
VERT. 1"=10'

TIERRA WEST, LLC
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ALBUQUERQUE, NEW MEXICO 87113
(505)858-3100

CITY OF ALBUQUERQUE
PUBLIC WORKS DEPARTMENT
ENGINEERING GROUP


TITLE:
98TH AND SAGE
UTILITY IMPROVEMENTS
WATERLINE

DESIGN REVIEW COMMITTEE APPROVED DEC 13 2004 DESIGN REVIEW COMMITTEE	CITY ENGINEER APPROVAL DEC 13 2005 CITY ENGINEER
CITY PROJECT NO. 7697.81 ZONE MAP NO. M-9 SHEET 8 OF 12	

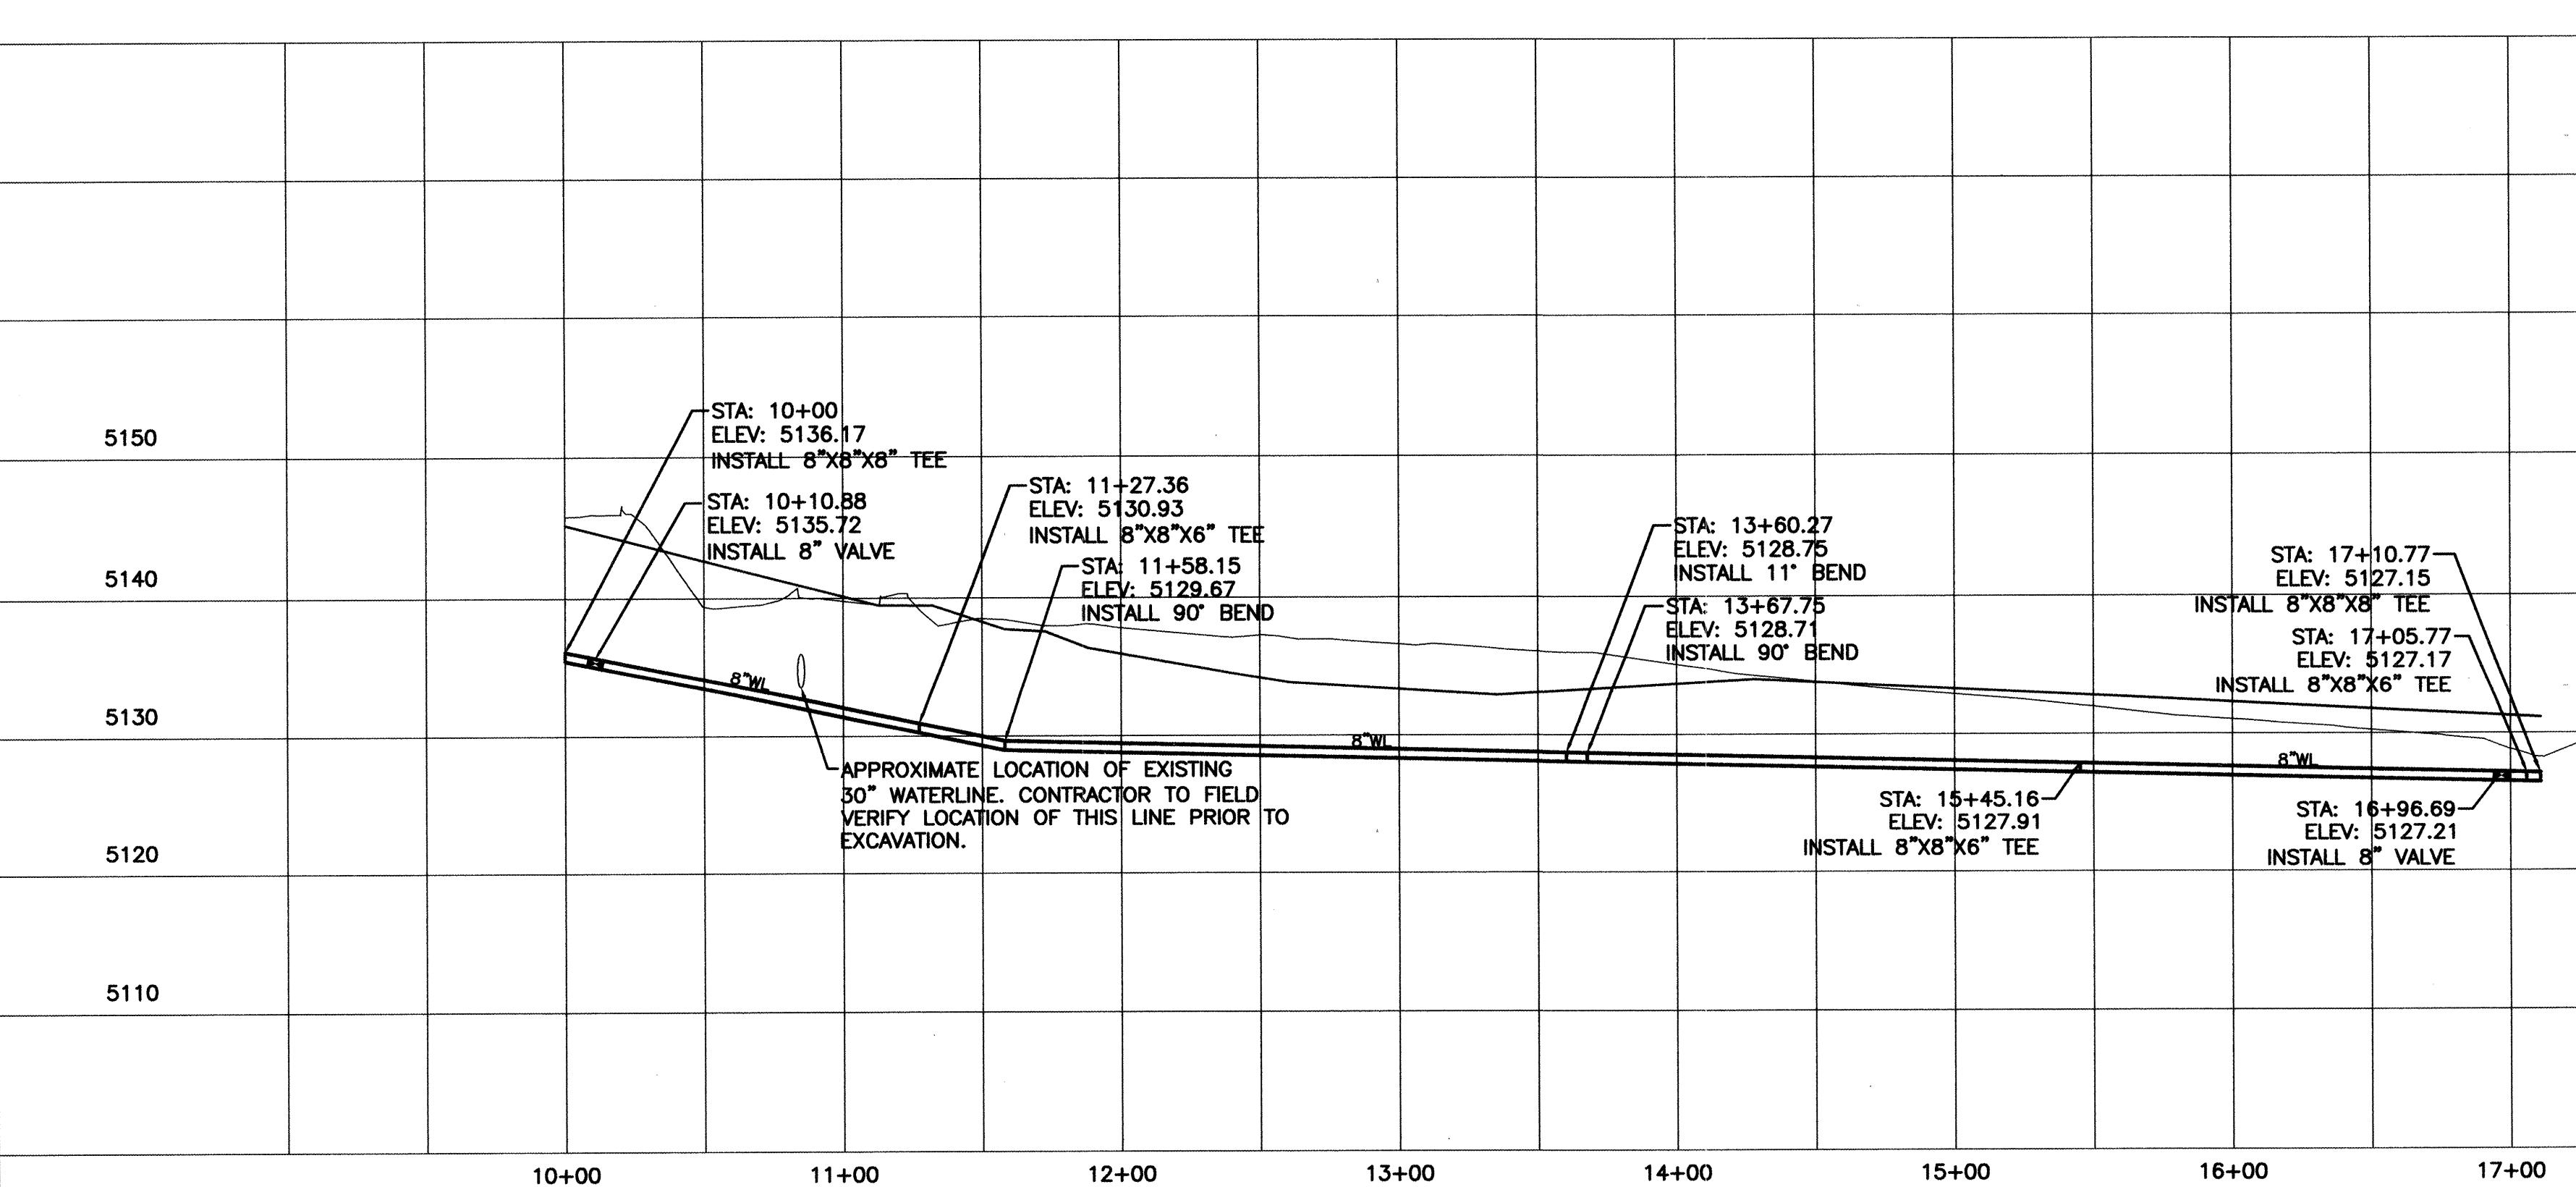


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- NOTE:**
- SEE MASTER UTILITY PLAN FOR SANITARY SEWER SERVICE CONNECTION DETAILS.
 - ALL FIRE HYDRANTS ARE TO BE BUILT PER C.O.A. STD DWG #2340
 - ALL EXISTING UTILITY CONNECTION LOCATIONS AND INVERTS MUST BE FIELD VERIFIED BY CONTRACTOR PRIOR TO AND CONSTRUCTION OF UTILITIES.
 - SEE SCHEDULE FOR RESUMMING TABLE.
 - PRIVATE GATE VALVE SHALL BE CAST IRON VALVE CANS.
 - ELECTRONIC MARKER DISCS ARE REQUIRED FOR WATER LINES AND SANITARY SEWER LINES AS PER CITY STANDARD SECTION 170.

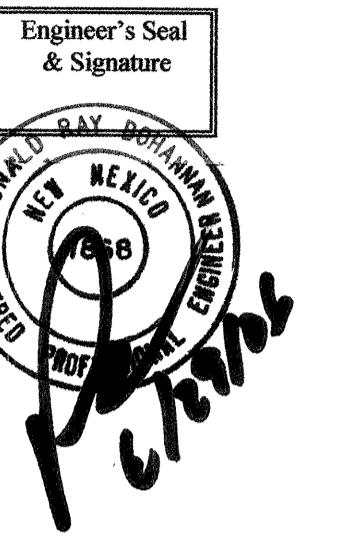

CAUTION:
EXISTING UTILITIES ARE NOT SHOWN.
IT SHALL BE THE SOLE RESPONSIBILITY
OF THE CONTRACTOR TO CONDUCT ALL
NECESSARY FIELD INVESTIGATIONS PRIOR
TO ANY EXCAVATION TO DETERMINE THE
ACTUAL LOCATION OF UTILITIES & OTHER
IMPROVEMENTS.

SCALE: HORIZ. 1"=50'
VERT. 1"=10'

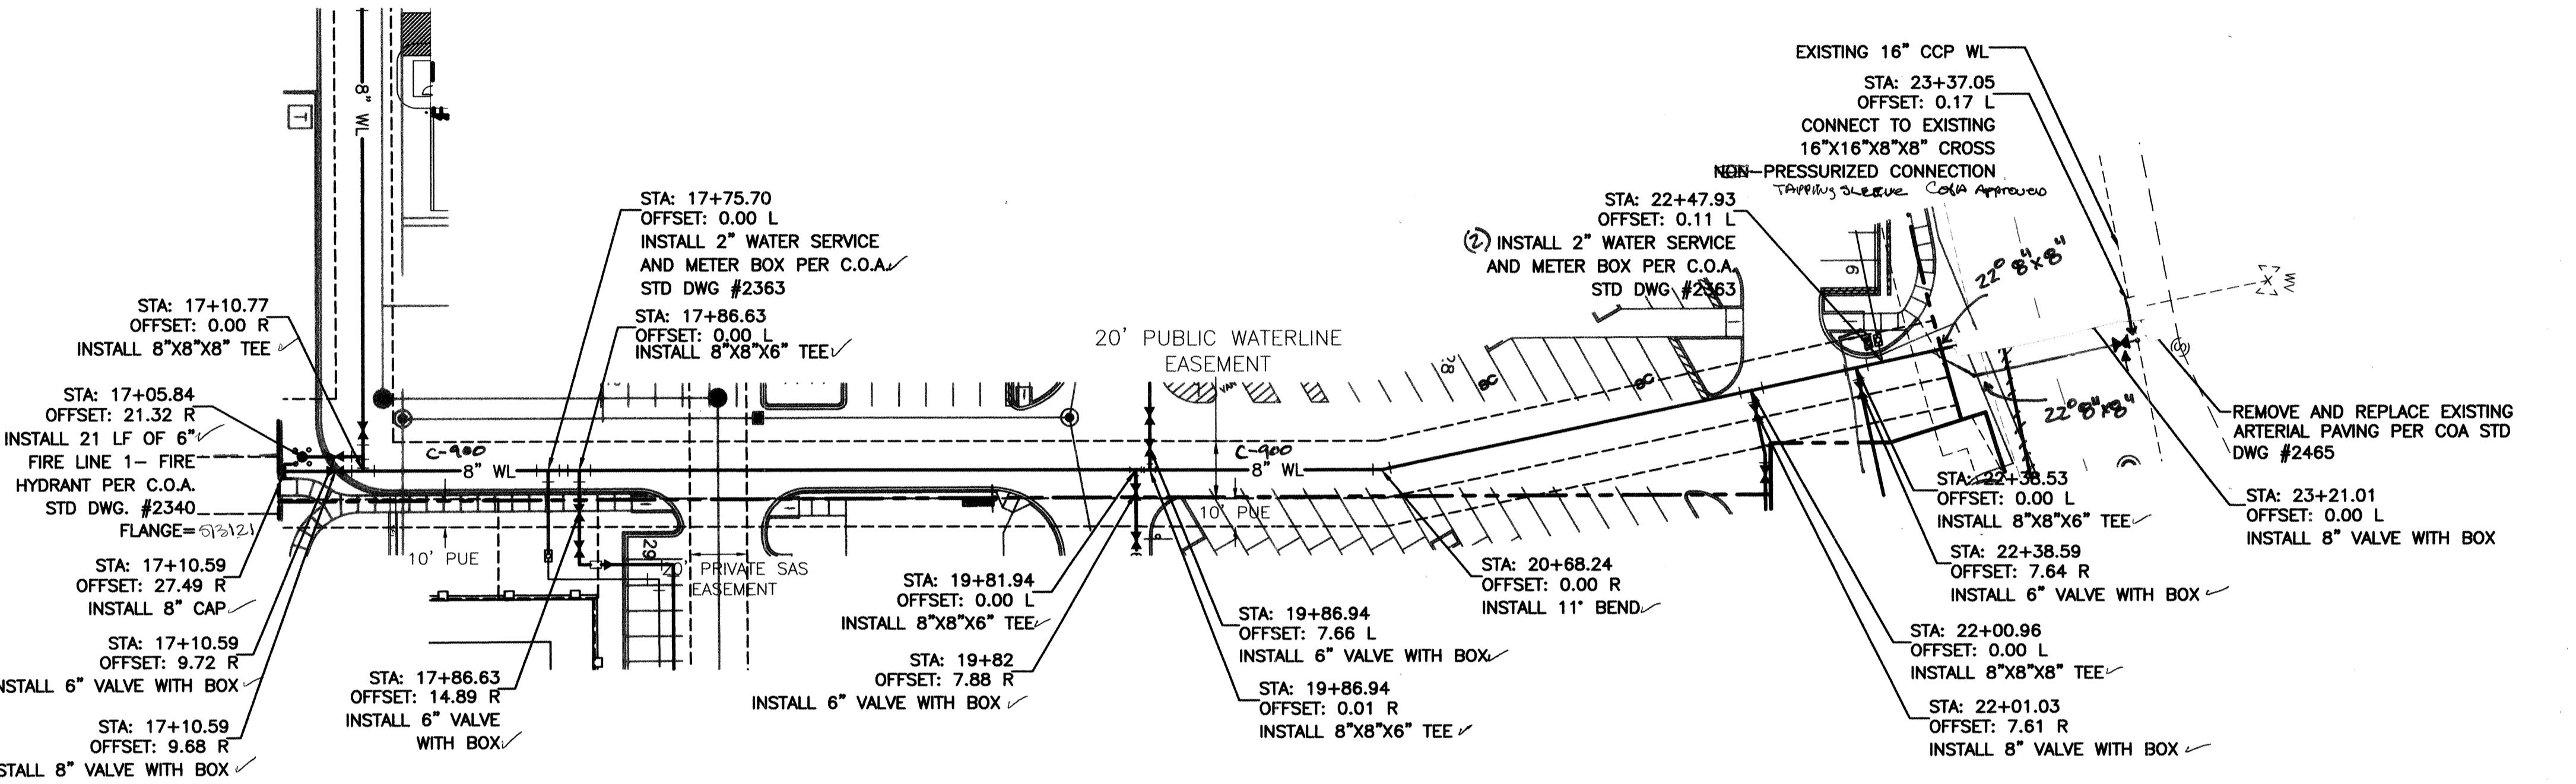ENGINEER'S SEAL		SURVEY INFORMATION		BENCH MARKS		AS BUILT INFORMATION	
NO.	BY	FIELD NOTES	DATE	ACS. MONUMENT "Z" MS*	C.O.A. BRASS CAP	CONTRACTOR SIGNATURE	DATE
				NM STATE PLANE COORDINATES	NM STATE PLANE COORDINATES		
				Central Zone - N.A.D. 1927	Central Zone - N.A.D. 1927		
				X=354,207.50	X=354,207.50		
				Y=1,473,257.74	Y=1,473,257.74		
				C-G-0-9967887	C-G-0-9967887		
				Do= 0' 16.47"	Do= 0' 16.47"		
				ELEV=5133.97 (NGVD29)	ELEV=5133.97 (NGVD29)		

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(505)858-3100

CITY OF ALBUQUERQUE
PUBLIC WORKS DEPARTMENT
ENGINEERING GROUP

98TH AND SAGE
UTILITY IMPROVEMENTS
WATERLINE

DESIGNED BY: SA	DRAWN BY: EMT	JOB NO.: 25020	DATE: 11-08-05
REVISIONS	REMARKS		
DESIGN	REVIEW COMMITTEE	APPROVED	MO./DAY/YR.
	APPROVED	DEC 12 2005	MO./DAY/YR.
	REVIEW COMMITTEE	DESIGN	MO./DAY/YR.
	CITY ENGINEER	APPROVED	MO./DAY/YR.
	CITY ENGINEER	DEC 12 2005	MO./DAY/YR.
	CITY ENGINEER	DESIGN	MO./DAY/YR.
LAST DESIGN UPDATE			
CITY PROJECT NO.	7697.81	ZONE MAP NO.	M-9
SHEET OF	9 - 12		


CONDUIT AND CONDUCTOR REQUIREMENTS

CONDUIT LENGTH, SIZE, AND TYPE				CONDUIT FILL BY CONTRACTOR LENGTH AND TYPE											
RUN ID	SIZE/LENGTH 2" 3" 4"	TYPE	REMARKS	MCC 5 (# @ FT)	MCC 7 (# @ FT)	MCC 20 (# @ FT)	SCC #2 (# @ FT)	SCC #4 (# @ FT)	SCC #6 (# @ FT)	DLIC (# @ FT)	CC #6 (# @ FT)	CC #12 (# @ FT)	OPTICOM SYSTEM (# @ FT)	VIDEO CABLE (# @ FT)	LUMINAIRE SCC #10 (# @ FT)
11	LEAVE EXIST. CONDUIT	REC	PB3 TO PB14	REUSE EXIST. WIRE											
12	LEAVE EXIST. CONDUIT	REC	PB3 TO PB14	REUSE EXIST. WIRE											
8	EXTEND EXIST. CONDUIT 5'	REC	PB2 TO PB01		2 @ 43'			1 @ 43'						SPARE	
9	EXTEND EXIST. CONDUIT 5'	REC	PB1 TO PB2												
10	REUSE EXISTING		MA2 TO PB2												
7	EXTEND EXIST. CONDUIT 5'														
	TOTALS			86'	86'			43'							

- ALL WORK ON THESE PLANS TO BE PERFORMED UNDER THIS CONTRACT SHALL CONFORM TO THE CURRENT NATIONAL ELECTRICAL CODE. THE STANDARDS OF THE NATIONAL BOARD OF FIRE UNDERWRITERS FOR ELECTRIC WIRING AND APPARATUS, AND THE CITY'S TRAFFIC ENGINEERING OPERATIONS THIRD DRAFT SPECIFICATIONS (JUNE 1994),
- LOCATIONS OF CONDUITS, FOUNDATIONS, CONTROL CABINETS, POLES, PULL BOXES, MANHOLES, AND SLICE CABINETS SHOWN ON THE PLANS ARE SCHEMATIC AND SHALL BE ADJUSTED IN THE FIELD TO AVOID UTILITY CONFLICTS AND TO MAXIMIZE CLEAR SPACE AVAILABLE FOR PEDESTRIANS AND WHEELCHAIRS TO COMPLY WITH THE AMERICANS WITH DISABILITIES ACT. THE CONTRACTOR SHALL MEET WITH THE CITY'S TRAFFIC ENGINEERING OPERATIONS PERSONNEL IN THE FIELD AT ALL LOCATIONS TO SPOT EQUIPMENT BEFORE BEGINNING WORK. ALL SUCH EQUIPMENT SHALL BE INSTALLED WITHIN THE RIGHT-OF-WAY. FOUNDATIONS, POLES, CONTROL CABINETS, AND SLICE CABINETS SHALL NOT BE PLACED IN THE PEDESTRIAN PATH.
- THE CONTRACTOR IS WARNED THAT EXISTING CONDUITS MAY CONTAIN AC POWER AND CAUTION SHALL BE EXERCISED IN INTERCEPTING OR INSTALLING CABLE IN EXISTING CONDUIT.
- THE CONTRACTOR SHALL BORE, DRILL, OR PUSH WHEN CROSSING EXISTING PAVEMENT AND ANY DRIVEWAYS FOR SIDE STREET CROSSING. BEFORE CONDUIT CAN BE BORED, DRILLED, OR PUSHED THE CONTRACTOR SHALL LOCATE ALL EXISTING UTILITIES. THE CONTRACTOR SHALL LOCATE AND EXPOSE GAS LINES WHICH CROSS ANY PROPOSED BORES. THESE EXCAVATIONS SHALL REMAIN OPEN UNTIL AFTER THE BORE IS COMPLETE. CONTRACTOR SHALL REMOVE AND REPLACE IN KIND ANY SIDEWALK OR PAVEMENT REQUIRED TO EXPOSE SUCH LINES. THE CONTRACTOR MAY CUT, TRENCH, AND REPLACE EXISTING PAVEMENT ONLY BY THE PROJECT MANAGER.
- SPlicing OF COMMUNICATIONS CABLE WILL NOT BE PERMITTED IN PULL BOXES. Splicing of COMMUNICATIONS CABLE WILL BE PERMITTED ONLY AT SLICE CABINETS OR CONTROLLER CABINETS WITH SLICE BARS. Slicing of TRAFFIC SIGNALS MCC WILL BE PERMITTED IN LARGE PULL BOXES. Splicing of OPTICAL DETECTOR CABLE WILL NOT BE PERMITTED FROM THE DETECTOR TO THE CONTROLLER CABINET.
- ALL VIDEO DETECTION COAXIAL AND POWER CABLES SHALL BE TAGGED AT THE CONTROLLER CABINET TO IDENTIFY EACH CABLE BY CAMERA NUMBER AND LOCATION. ALL OPTICAL DETECTOR CABLE SHALL BE TAGGED AT THE CONTROL CABINET TO IDENTIFY EACH BY DIRECTION AND LOCATION.
- THE CONTRACTOR SHALL NOTIFY THE CITY OF ALBUQUERQUE TRAFFIC ENGINEERING OPERATIONS (857-8000) THREE WORKING DAYS IN ADVANCE OF ANY ANTICIPATED WORK ON SIGNALS. TRAFFIC ENGINEERING OPERATIONS PERSONNEL WILL ASSIST THE CONTRACTOR IN FIELD LOCATION OF EQUIPMENT, AND MUST BE PRESENT WHEN SIGNALS ARE SHUT-OFF OR TURNED ON. THE CONTRACTOR SHALL ALSO NOTIFY THE CITY OF ALBUQUERQUE TRAFFIC ENGINEERING OPERATIONS EACH TIME A TRAFFIC SIGNAL CONTROLLER DOOR IS OPENED.
- THE CONTRACTOR SHALL NOTIFY PUBLIC SERVICE COMPANY 30 DAY IN ADVANCE OF ANY ANTICIPATED POWER SERVICE CONNECTIONS OR MODIFICATIONS. THE CONTRACTOR SHALL COORDINATE WITH PUBLIC SERVICE TO MAINTAIN ELECTRICAL SERVICE IN THE CITY'S NAME. ALL COSTS FOR PUBLIC SERVICE COMPANY TO PROVIDE POWER WILL BE PAID FOR DIRECTLY BY THE CITY OF ALBUQUERQUE.
- LIVE UNUSED CONDUCTORS WILL NOT BE ALLOWED AT MASTARM POLES AND PEDESTAL POLES. ALL SUCH UNUSED CONDUCTORS SHALL BE DISCONNECTED AT THE LARGE PULL BOX ADJACENT TO THE POLE. ALL WIRE SPLICES SHALL BE WATERPROOF. ALL UNUSED CONDUCTORS SHALL BE WATERPROOFED USING NYLON CRIMPED ON WIRES CAPS.
- IF TRENCH WIDTHS LESS THAN 12" ARE PROPOSED BY THE CONTRACTOR, APPROVED COMPACTION METHODS SHALL BE USED DURING BACKFILL TO PREVENT LATENT TRENCH FAILURES. THE CONTRACTOR SHALL USE GROUT OR LEAN FILL AS APPROVED BY THE PROJECT MANAGER IN LIEU OF EARTH BACKFILL.
- CONDUITS CONTAINING ONLY LOW VOLTAGE COMMUNICATIONS CABLES, THE REQUIREMENTS FOR A SINGLE CONDUCTOR BARE COPPER #8 AWG MAY BE WAIVED WHERE PERMITTED BY THE NATIONAL ELECTRIC CODE.
- EXISTING CONDUITS TO BE REMOVED OR ABANDONED SHALL HAVE WIRING REMOVED.
- EXISTING CONDUITS SHALL BE REPAIRED, ADJUSTED, OR REPLACED AS DIRECTED BY THE PROJECT MANAGER WHERE ELECTRICAL PULL BOXES OR TRAFFIC MANHOLES ARE INSTALLED OR REPLACED.
- THE CONTRACTOR SHALL PROVIDE OFF-DUTY POLICE OFFICERS TO DIRECT TRAFFIC WHEN SIGNALS ARE TURNED OFF.

2558 TRAFFIC SIGNAL FOUNDATION DETAILS TYPE II AND TYPE III STANDARDS
 2560 TRAFFIC SIGNAL MISCELLANEOUS DETAILS
 2562C TRAFFIC SIGNAL MASTARM DETAILS TYPE III STANDARD
 2562C TRAFFIC SIGNAL TYPE III STANDARD-MISCELLANEOUS DETAILS
 2568 TRAFFIC SIGNAL MACHINE VISION VEHICLE DETECTION DETAILS
 2569 TRAFFIC SIGNAL OPTICAL DETECTOR INSTALLATION DETAILS
 2570 TRAFFIC SIGNAL ELECTRICAL SERVICE DETAIL


SIGNAL PHASING

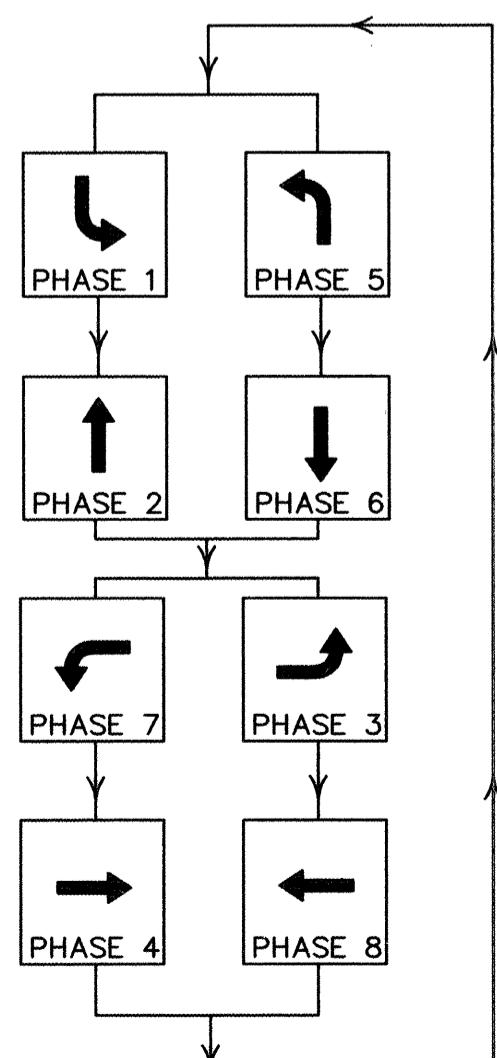

CERTIFICATE OF SUBSTANTIAL COMPLIANCE ON PLANS

I, Ronald R. Bohanan, of the firm of Tierra West LLC, a Registered Professional Engineer in the State of New Mexico, do hereby certify, to the best of my knowledge and belief, that the infrastructure installed as part of this project has been inspected by me or by a qualified person under my direct supervision and has been constructed in accordance with the plans and specifications approved by the City Engineer and that the original design intent of the approved plans has been met, except as noted by me on the as-built construction drawings. This Certification is based on site inspections by me or personnel under my direction with survey information provided by Baseline Field Services NMPLS#5110.

Engineer's Seal & Signature

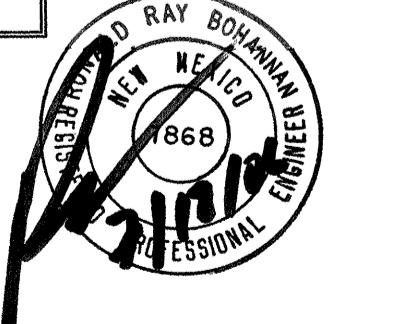


SYMBOL KEY

- M1 SIGNAL & CABINET ID
- 99 NEW CONDUIT RUN ID
- S1 CONDUIT RUN ID (POWER SERVICE)
- C1 CONDUIT RUN ID (INTERCONNECT)



GRAPHIC SCALE

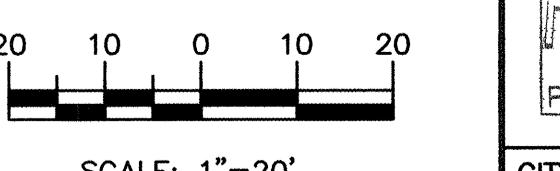


SCALE: 1"=20'

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CITY OF ALBUQUERQUE
PUBLIC WORKS DEPARTMENT
ENGINEERING GROUP

98TH AND SAGE
SIGNAL PLAN

DESIGN REVIEW COMMITTEE APPROVED DEC 1 2 2005 DESIGN REVIEW COMMITTEE	CITY ENGINEER APPROVED DEC 1 2 2005 CITY ENGINEER	MO./DAY/YR.	MO./DAY/YR.
LAST DESIGN UPDATE			
CITY PROJECT NO.	ZONE MAP NO.	SHEET OF	
7697.81	M-9	10 - 12	

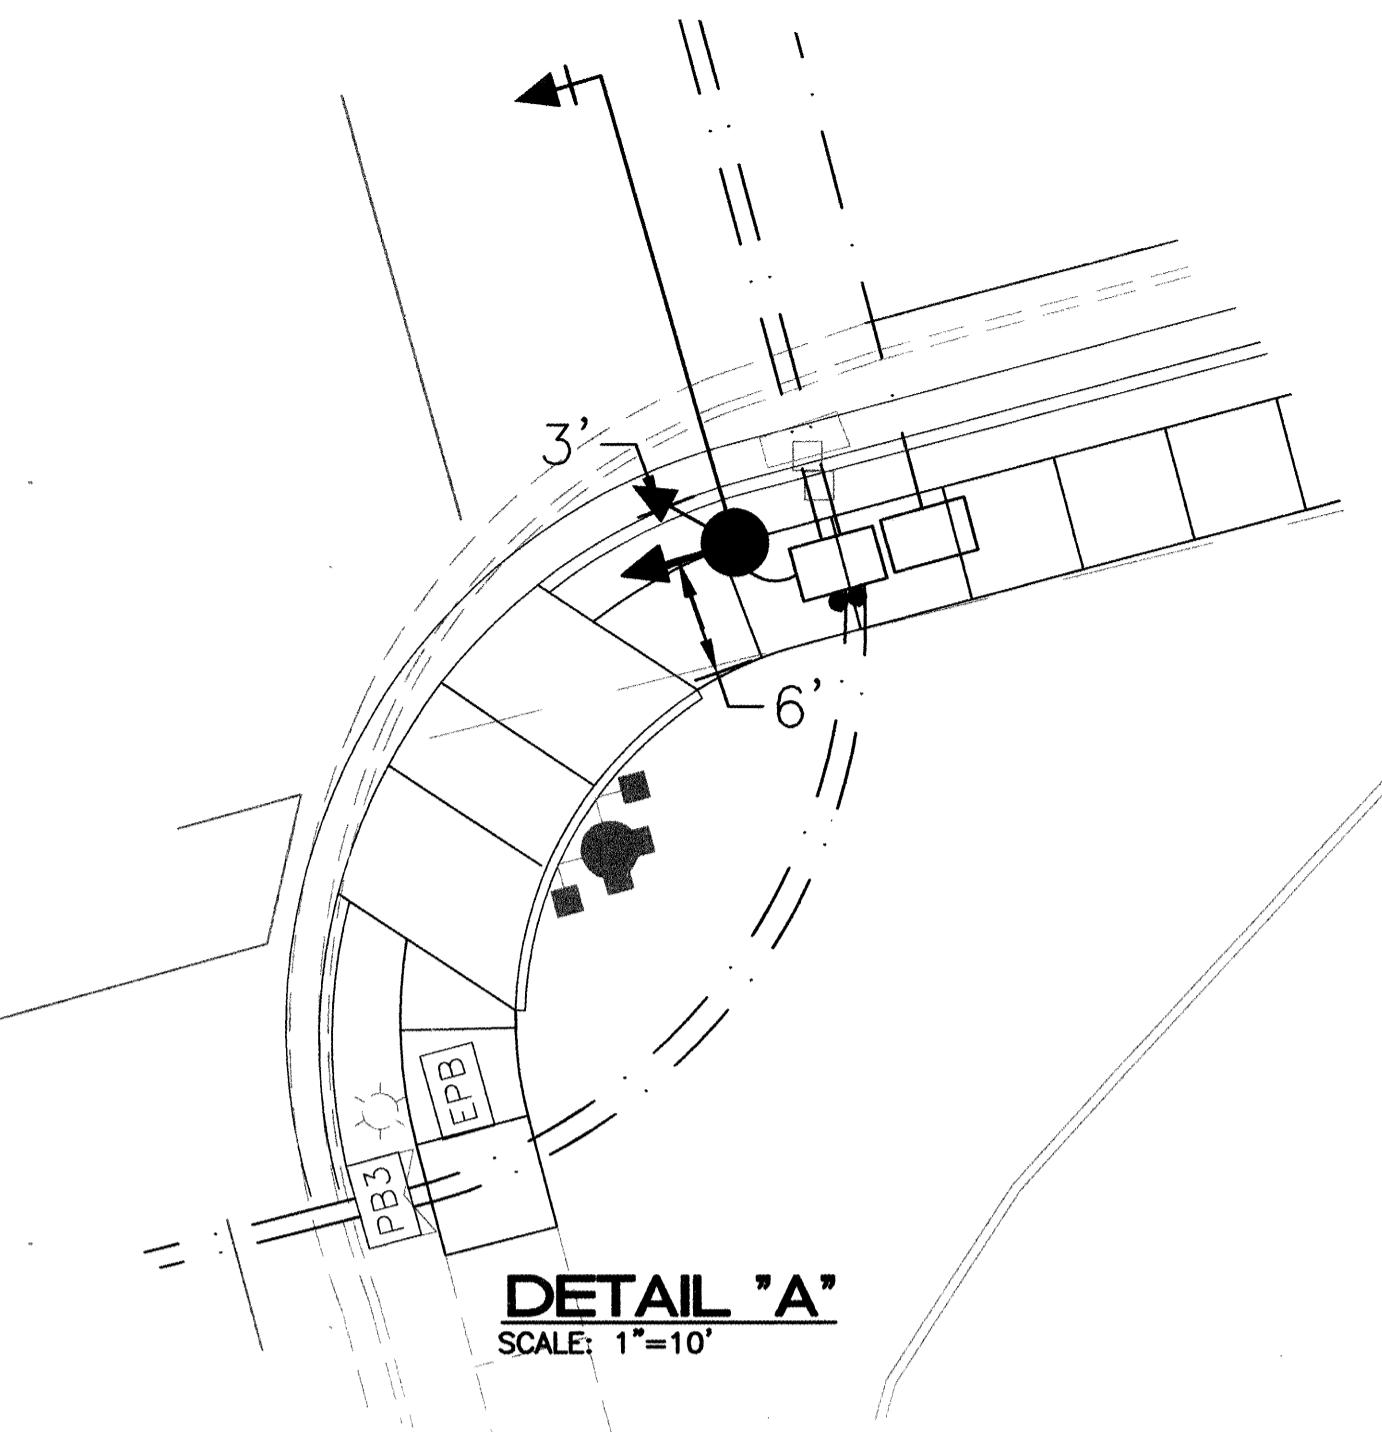

AS BUILT INFORMATION	
BENCH MARKS	A.C.S. MONUMENT 2-K9
FIELD NOTES	COA. BRASS CAP
NO. DATE	NM STATE PLANE COORDINATES
BY	Central Zone- N.M.D. 1927
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	Y=1.473.257.74
	G=0=0.9867887
	D=0= 016.47"
	ELEV=5133.87 (NGVD29)





ABBREVIATIONS

- MA1 MASTARM NUMBER
 PP1 PEDESTAL POLE NUMBER
 PPB1 PEDESTRIAN PUSH BUTTON NUMBER
 CC1 CONTROL CABINET NUMBER
 SC1 SPLICE CABINET NUMBER
 PB1 PULL BOX NUMBER (SIGNALS)
 PBS1 PULL BOX NUMBER (POWER)
 PBC1 PULL BOX NUMBER (INTERCONNECT)
 DL1(1) DETECTOR LOOP PHASE # (LOOP #)
 3A SIGNAL HEAD NUMBER
 P1 PEDESTRIAN SIGNAL NUMBER
 BP BACK PLATE
 EC EXTENDED CALL LOOP DETECTOR
 SD SYSTEM LOOP DETECTOR
 MH1 TRAFFIC MANHOLE NUMBER
 M METER

NOTES

- EXISTING LINE LOCATION PER CITY OF ALBUQUERQUE PROJECT # 4188.91
- CONTRACTOR IS RESPONSIBLE FOR ALL NECESSARY ADJUSTMENTS AND PROGRAMMING MODIFICATIONS FOR VIDEO CAMERA
- REUSE EXISTING VIDEO CABLE IF POSSIBLE. NO SPLICES WILL BE ALLOWED.
- IF SWEEPS ARE NECESSARY USE MINIMUM 5' RADIOUS.
- IF EXISTING EQUIPMENT OR CONDITIONS ARE NOT AS INDICATED ON PLAN, CONTRACTOR IS TO CONTACT ENGINEER.



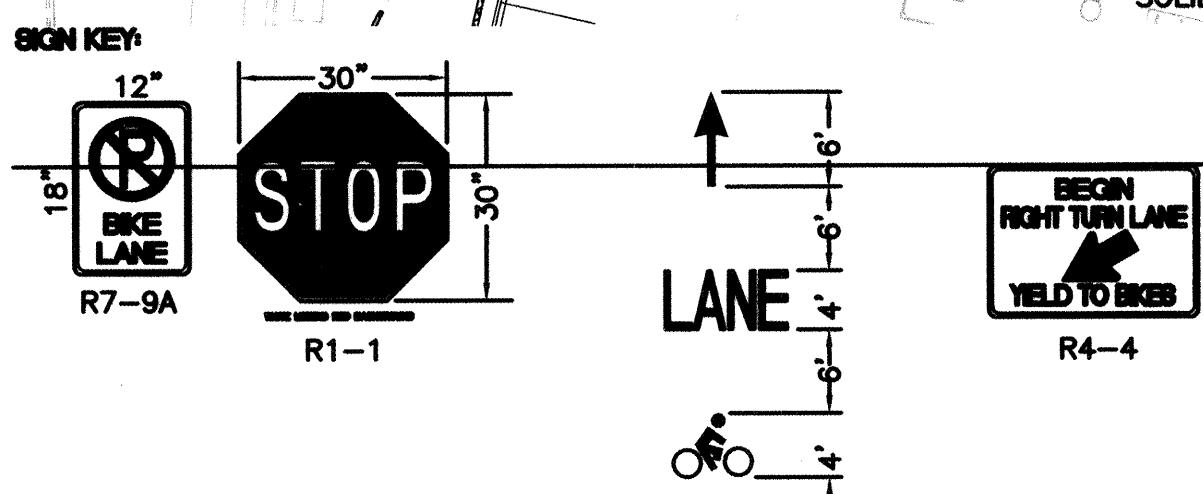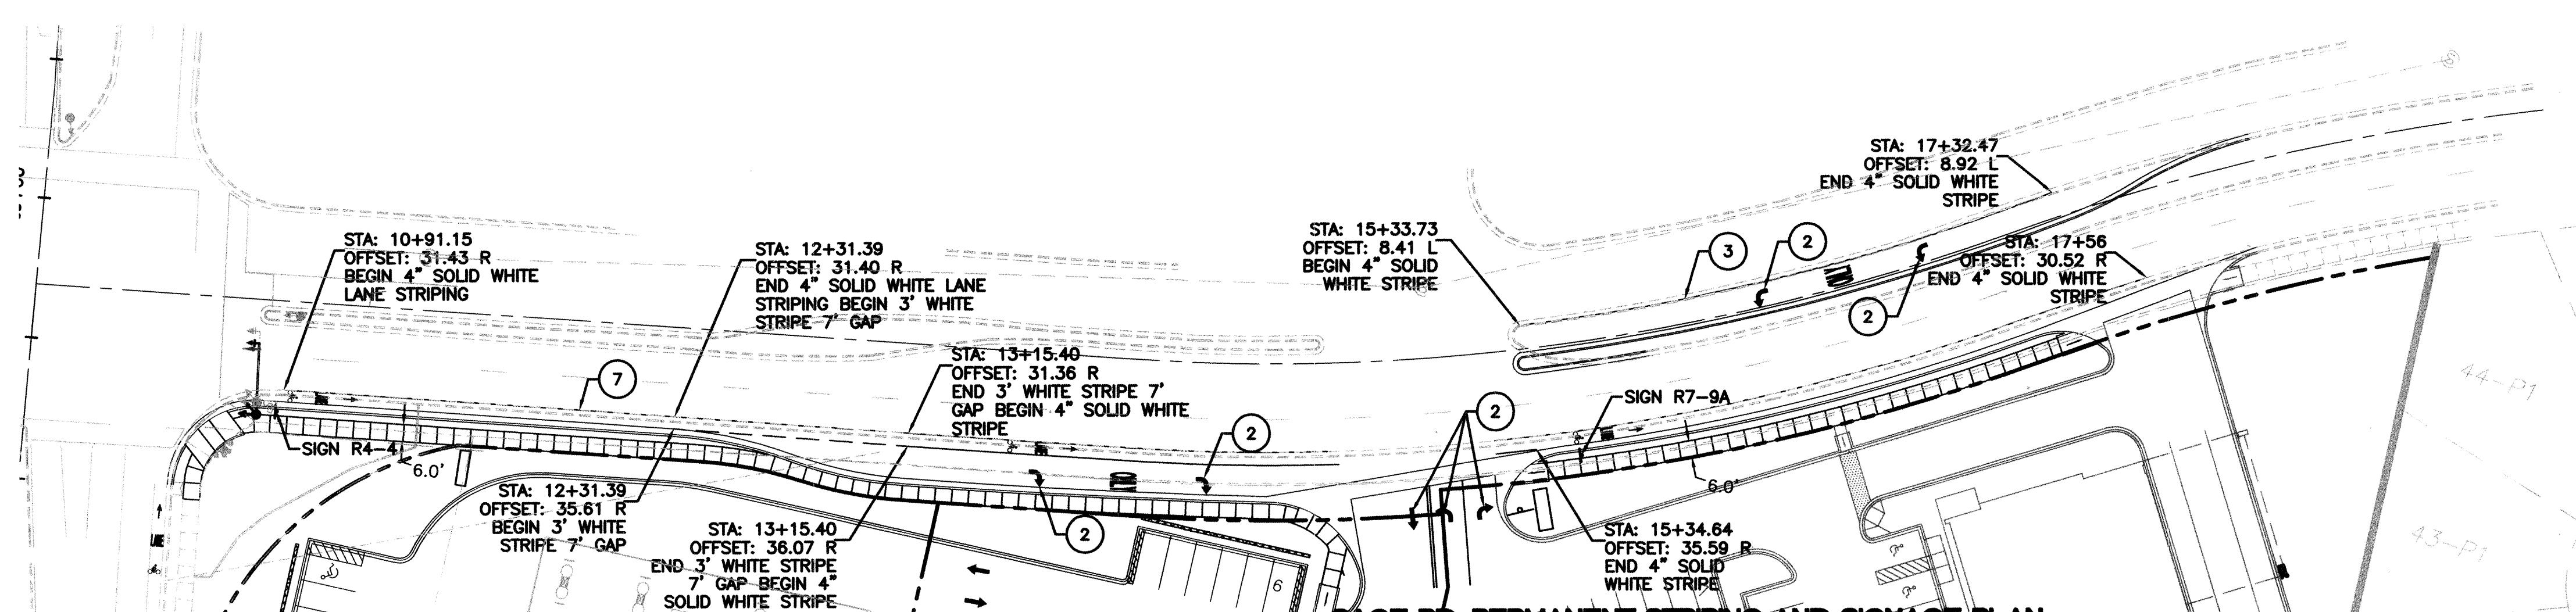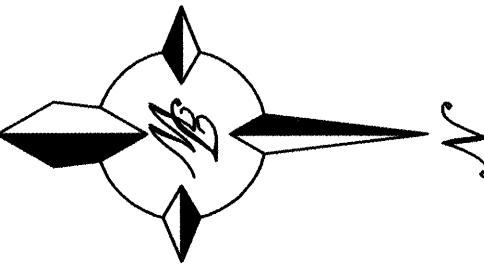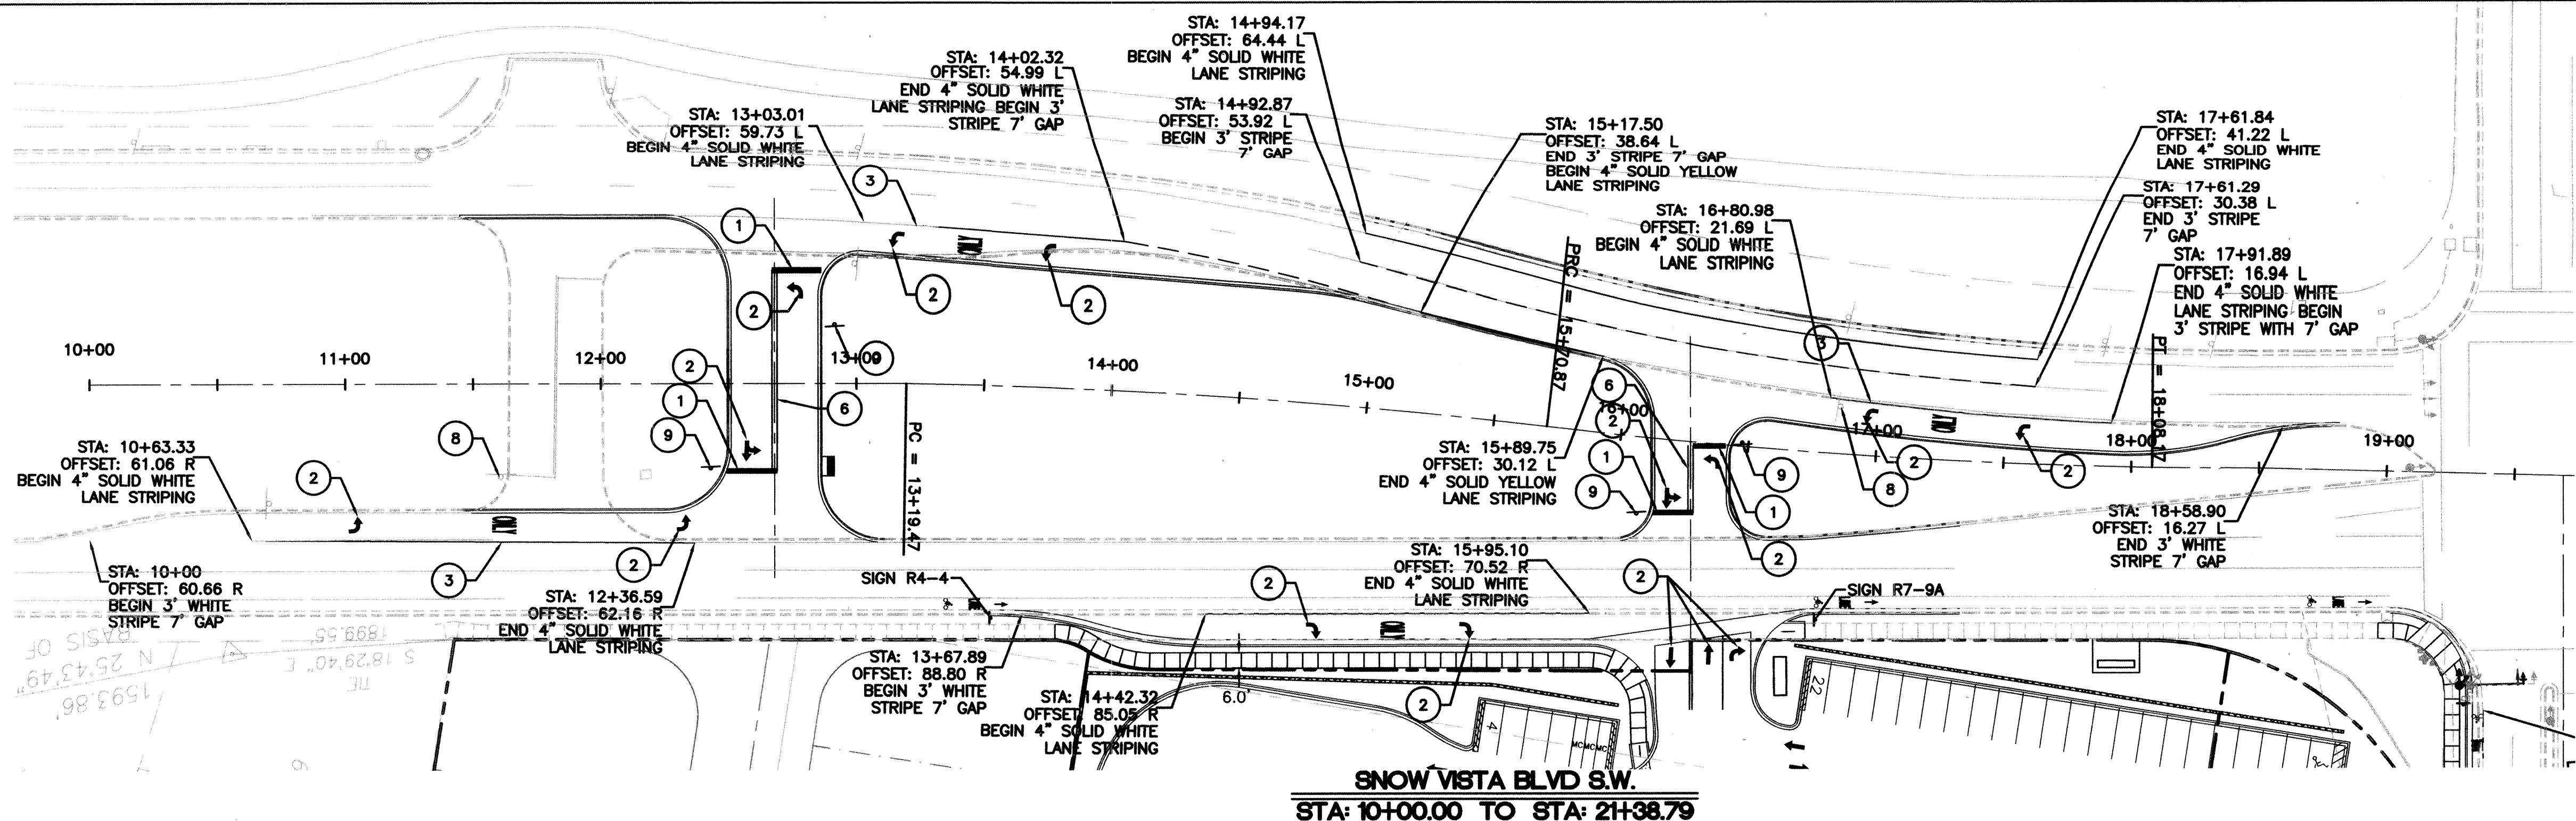


* SIGN FACES SHOWN FOR REFERENCE; CONTRACTOR SHALL VERIFY DIRECTION OF ARROW TO CORRELATE WITH INSTALLATION LOCATION AND TRAFFIC MOVEMENTS.

** CONTRACTOR SHALL COORDINATE WITH TRAFFIC OPERATIONS PRIOR SIGNING AND STRIPING

CERTIFICATE OF SUBSTANTIAL COMPLIANCE ON PLANS


I, Ronald R. Bohannan, of the firm of Tierra West LLC, a Registered Professional Engineer in the State of New Mexico, do hereby certify, to the best of my knowledge and belief, that the infrastructure installed as part of this project has been inspected by me or by a qualified person under my direct supervision and has been constructed in accordance with the plans and specifications approved by City Engineer and that the original design intent of the approved plans has been met, except as noted by me on the as-built construction drawings. This Certification is based on site inspections by me or personnel under my direction with survey information provided by Baseline Field Services NMPLS# 5110.

Engineer's Seal & Signature

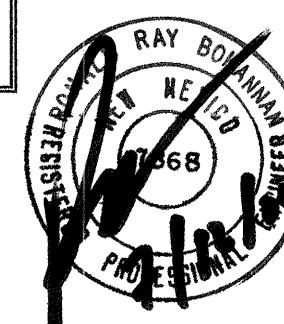


NOTE:
ALL SYMBOLS, STOP BARS AND CROSSWALKS SHALL BE PREFORMED THERMOPLASTIC TAPE.

ARROW DETAILS

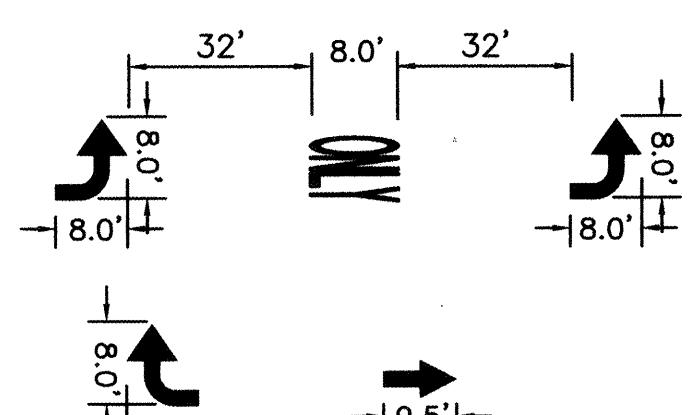


- NOTES:**
- COORDINATE WITH TRAFFIC OP'S PRIOR TO SIGNING & STRIPING.
 - PAINT ALL MEDIAN NOSES YELLOW W/ GLASS BEADS.
 - PREFORMED THERMO PLASTIC SHALL BE USED FOR ALL NEW TRAFFIC CONTROL MARKINGS: TURNING ARROWS, WORD "ONLY" AND STRIPING.

GRAPHIC SCALE

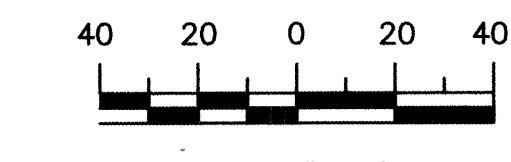

SCALE: 1"=40'

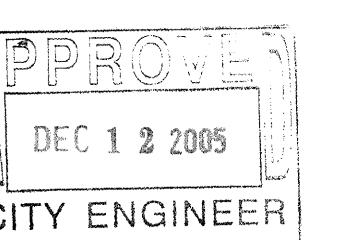

ENGINEER'S SEAL	98TH AND SAGE
PERMANENT STRIPING PLAN	
98TH AND SAGE	
TERRA WEST, LLC	
8509 JEFFERSON NE	
ALBUQUERQUE, NEW MEXICO 87113	
(505)858-3100	
RONALD R. BOHANNAN P.E. #7868	





DRAWN BY	E.M.T.
DATE	12-9-05
2000 SWPP DETAILS 09-19-05	
SHEET #	11 OF 12
JOB #	25020

GENERAL NOTE


- STRIPING ERADICATION SHALL BE ACCOMPLISHED BY WATER BLASTING OR SURFACE PLANING OF THE ROADWAY TO A MINIMUM OF 0.25 INCHES AND A WIDTH TO EQUAL 2 TIMES THE WIDTH OF THE STRIPE OR MARKING TO BE REMOVED.

EXISTING CURB & GUTTER
PROPOSED CURB & GUTTER
BOUNDARY LINE
CENTERLINE
EXISTING SIDEWALK
PROPOSED SIDEWALK
EXISTING STREET LIGHT
EXISTING STORM SEWER INLET
PROPOSED PERMANENT STRIPING
PROPOSED (TURN LANE) PERMANENT STRIPING
PROPOSED (TURN LANE) PERMANENT STRIPING

CAUTION:
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**NOTES:**

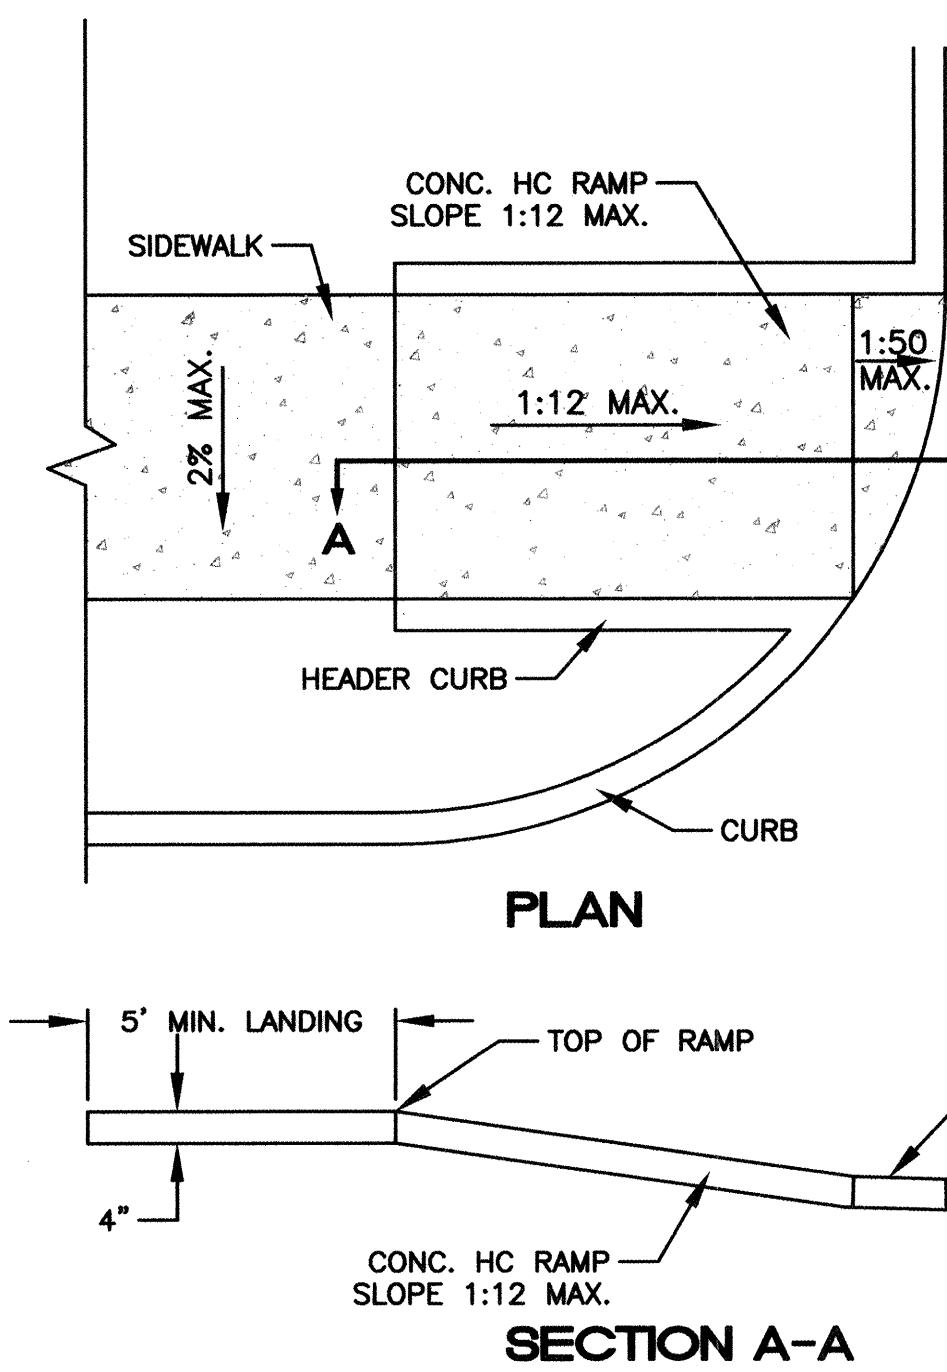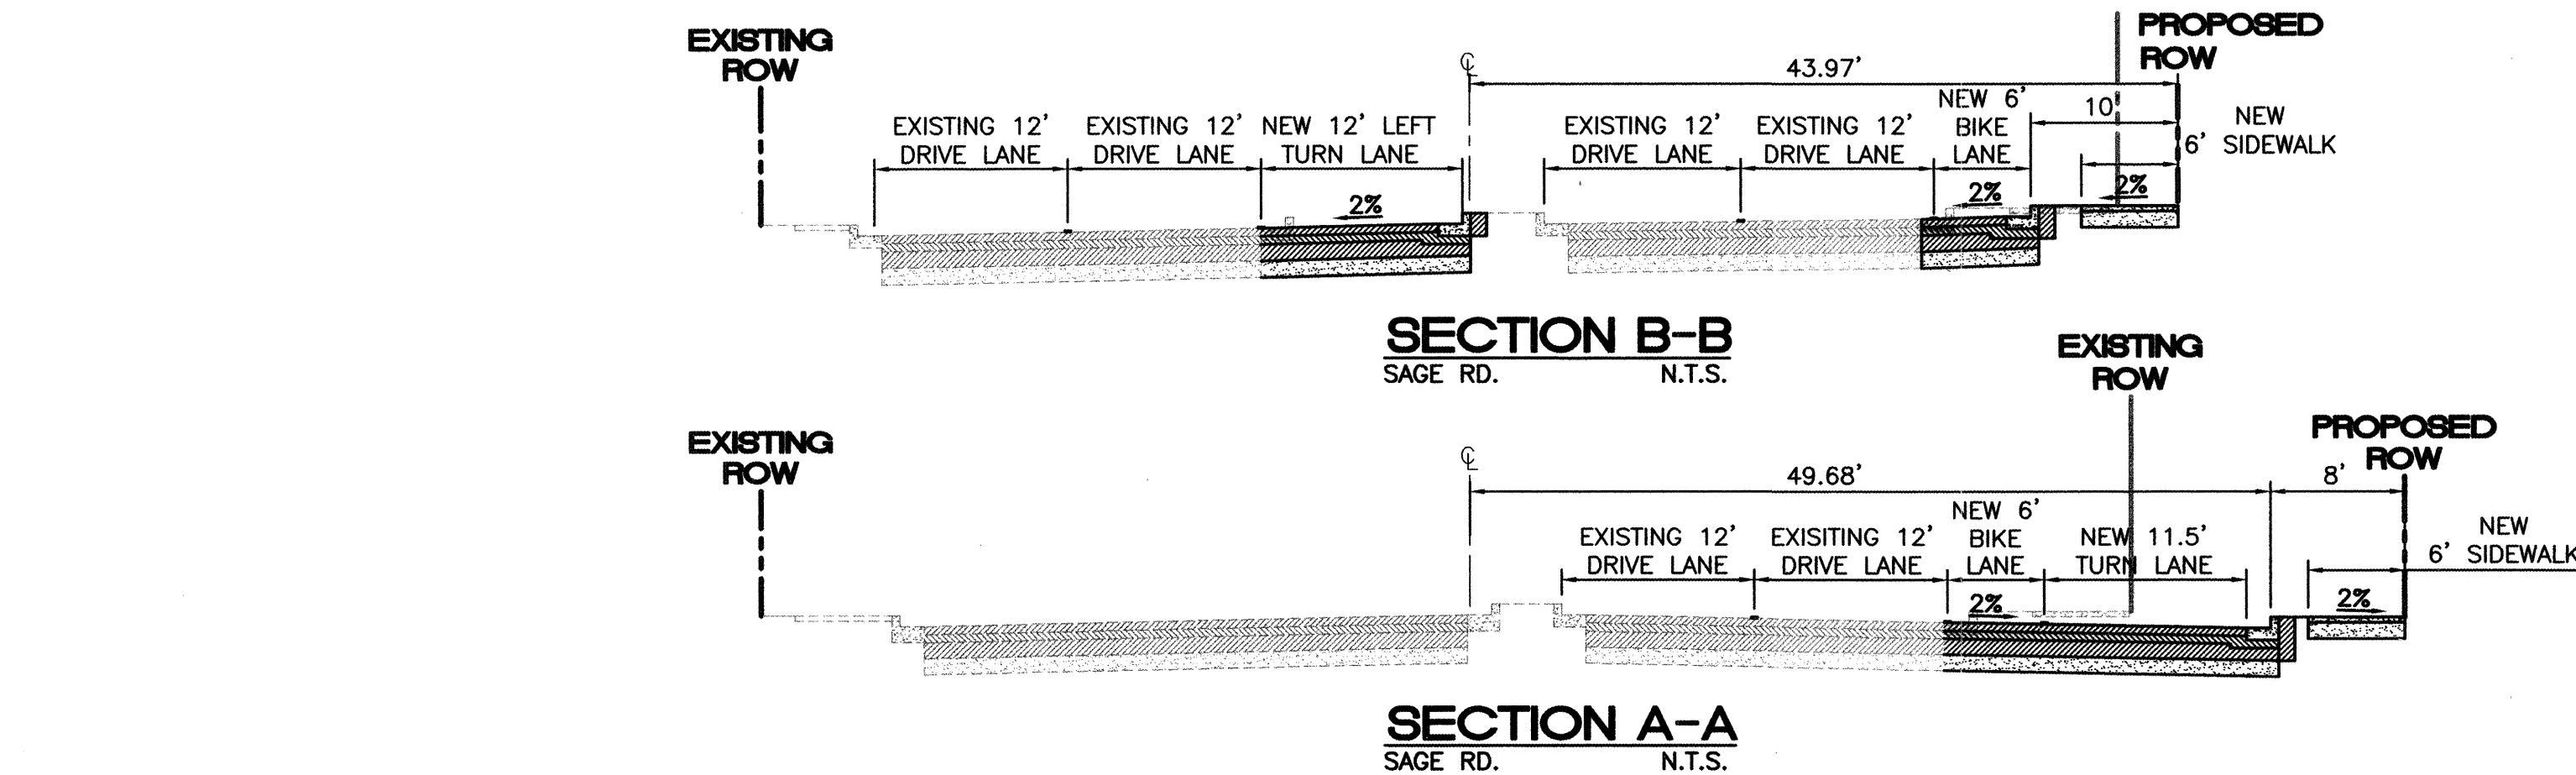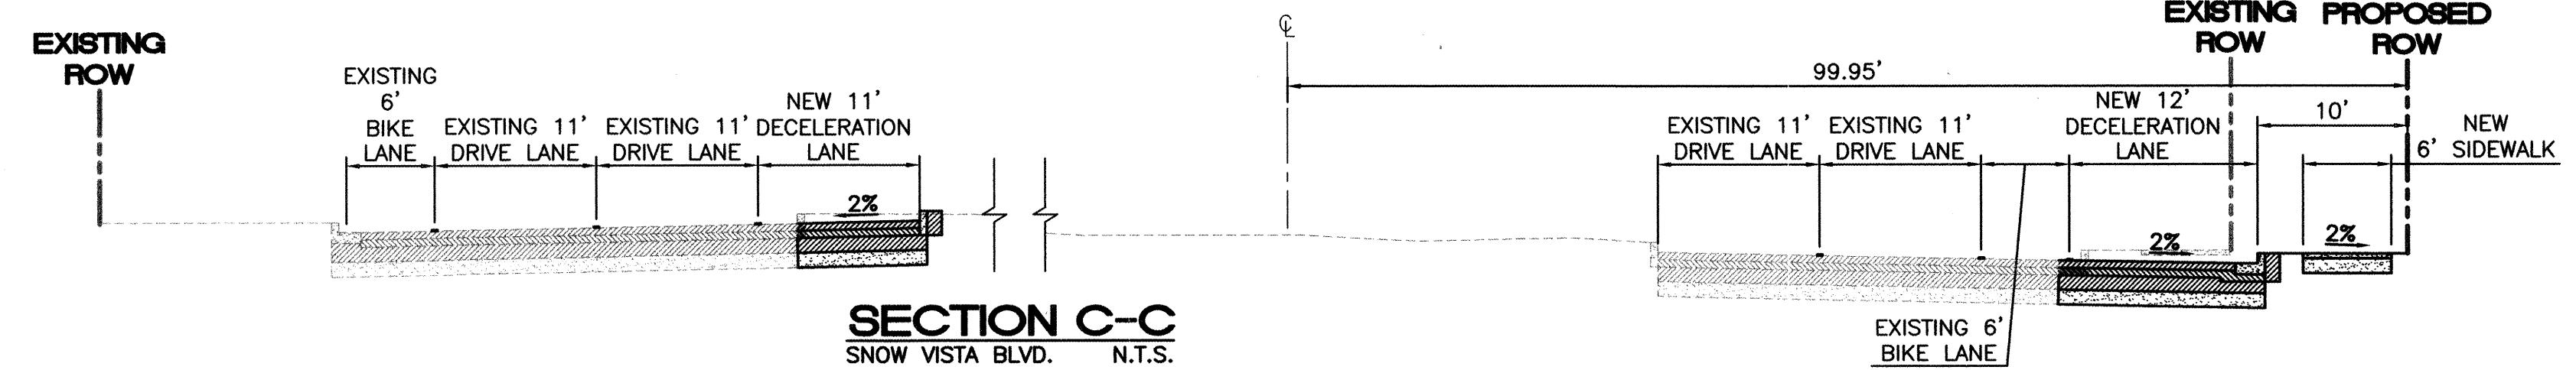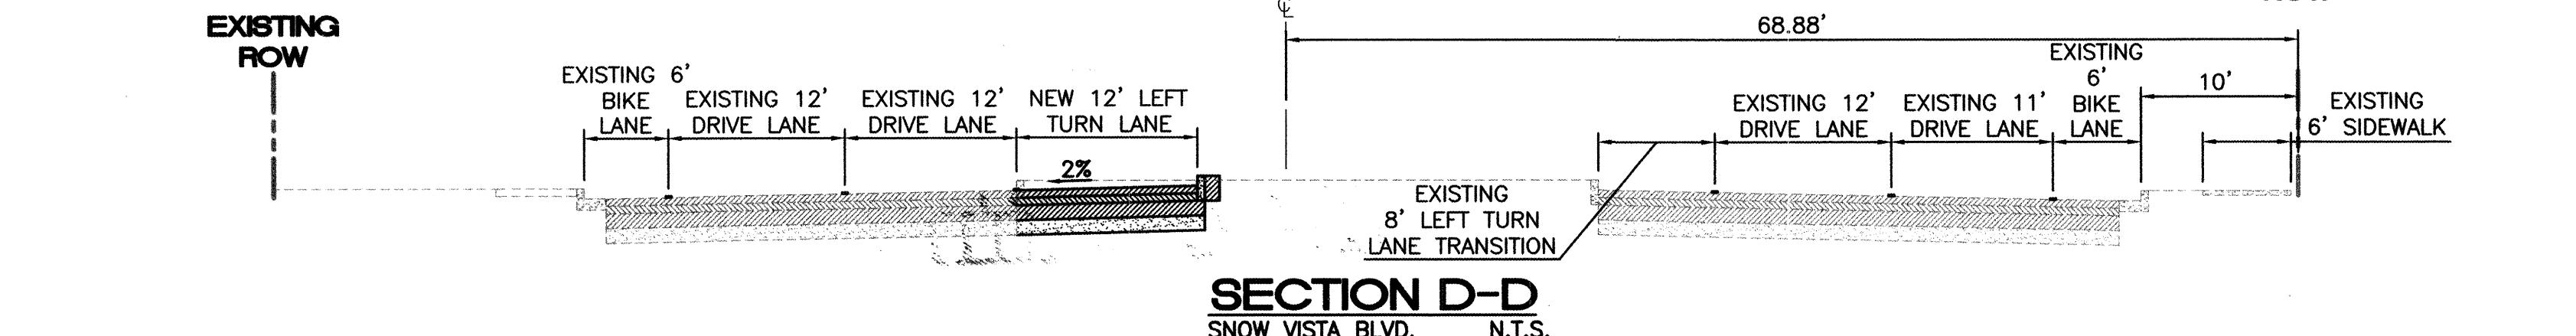1. THE SURFACE OF RAMP AND SIDES SHALL HAVE A TRANSVERSE BROOMED SURFACE TEXTURE ROUGHER THAN THE SURROUNDING SIDEWALK.
2. THE BOTTOM OF THE RAMP SHALL HAVE A 1/4" LIP OF 45°.
3. RAMP SIDE SLOPE VARIES UNIFORMLY FROM A MAXIMUM OF UP TO 8.33% AT CURB TO CONFORM WITH LONGITUDINAL SIDEWALK SLOPE ADJACENT TO TOP OF THE RAMP.
4. CONSTRUCT PER A.D.A. STANDARDS.



**PROFILE SHORT CROSSING 'A'**SCALE: 1"=40 HORIZONTAL
SCALE: 1"=4 VERTICAL**CERTIFICATE OF SUBSTANTIAL COMPLIANCE ON PLANS**

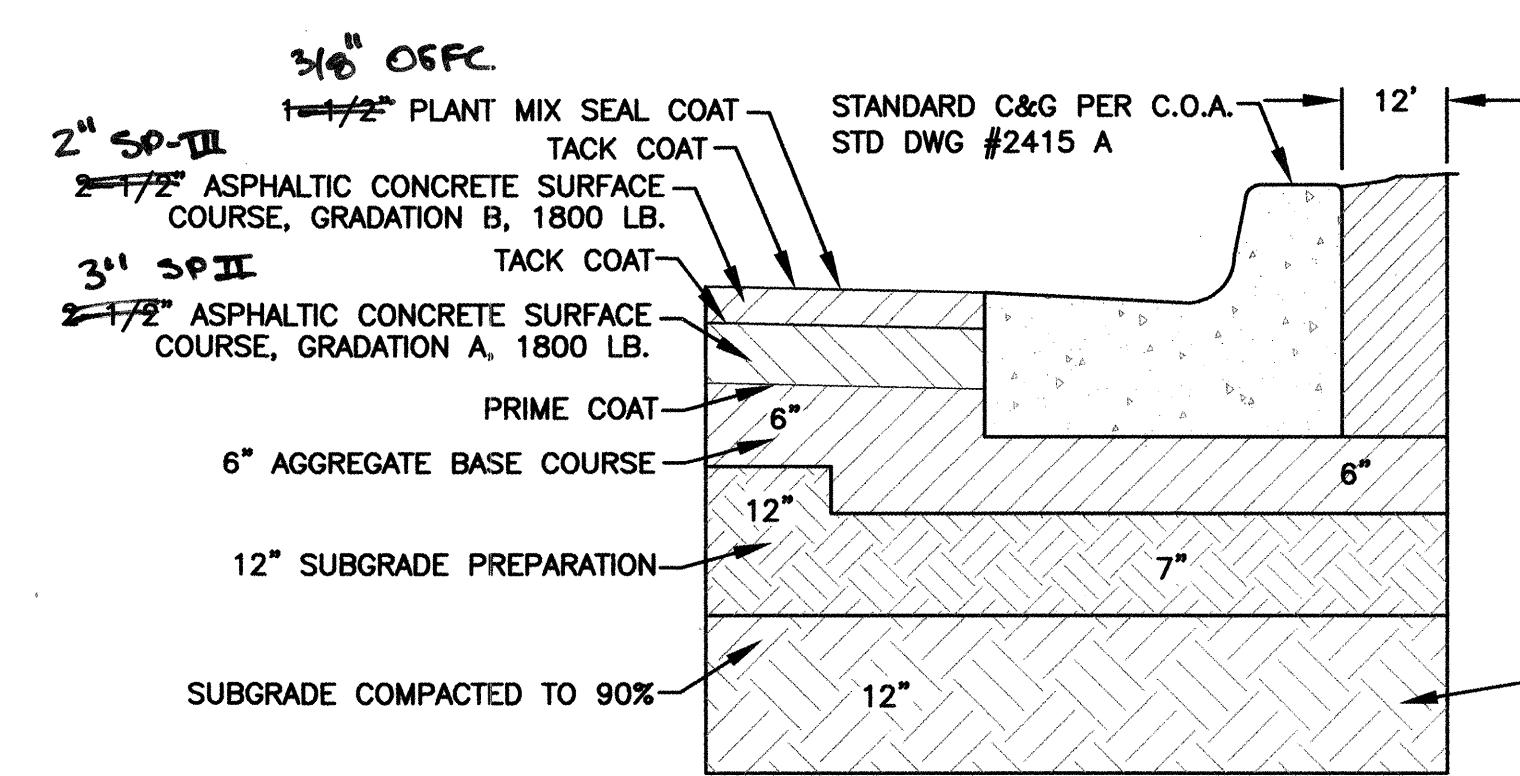I, Ronald R. Bohanan, of the firm of Tierra West LLC, a Registered Professional Engineer in the State of New Mexico, do hereby certify, to the best of my knowledge and belief, that the infrastructure installed as part of this project has been inspected by me or by a qualified person under my direct supervision and has been constructed in accordance with the plans and specifications approved by the City Engineer and that the original design intent of the approved plans has been met, except as noted by me on the as-built construction drawings. This Certification is based on site inspections by me or personnel under my direction with survey information provided by Baseline Field Services NMPLS# 5110.

Engineer's Seal & Signature


**PROFILE LONG CROSSING 'B'**SCALE: 1"=40 HORIZONTAL
SCALE: 1"=4 VERTICAL

TIERRA WEST, LLC	
8509 JEFFERSON NE ALBUQUERQUE, NEW MEXICO 87113 (505)858-3100	
CITY OF ALBUQUERQUE PUBLIC WORKS DEPARTMENT ENGINEERING GROUP	
TITLE: 98TH AND SAGE DETAILS	
DESIGNED BY: IN	DRAWN BY: DY
NO. DATE	REMARKS
REVISIONS	DESIGN
DESIGNED BY: IN	DRAWN NAME: 2520-Signals.dwg
NO. DATE	JOB NO.: 25020
CHECKED BY: RRB	DATE: 12-9-05

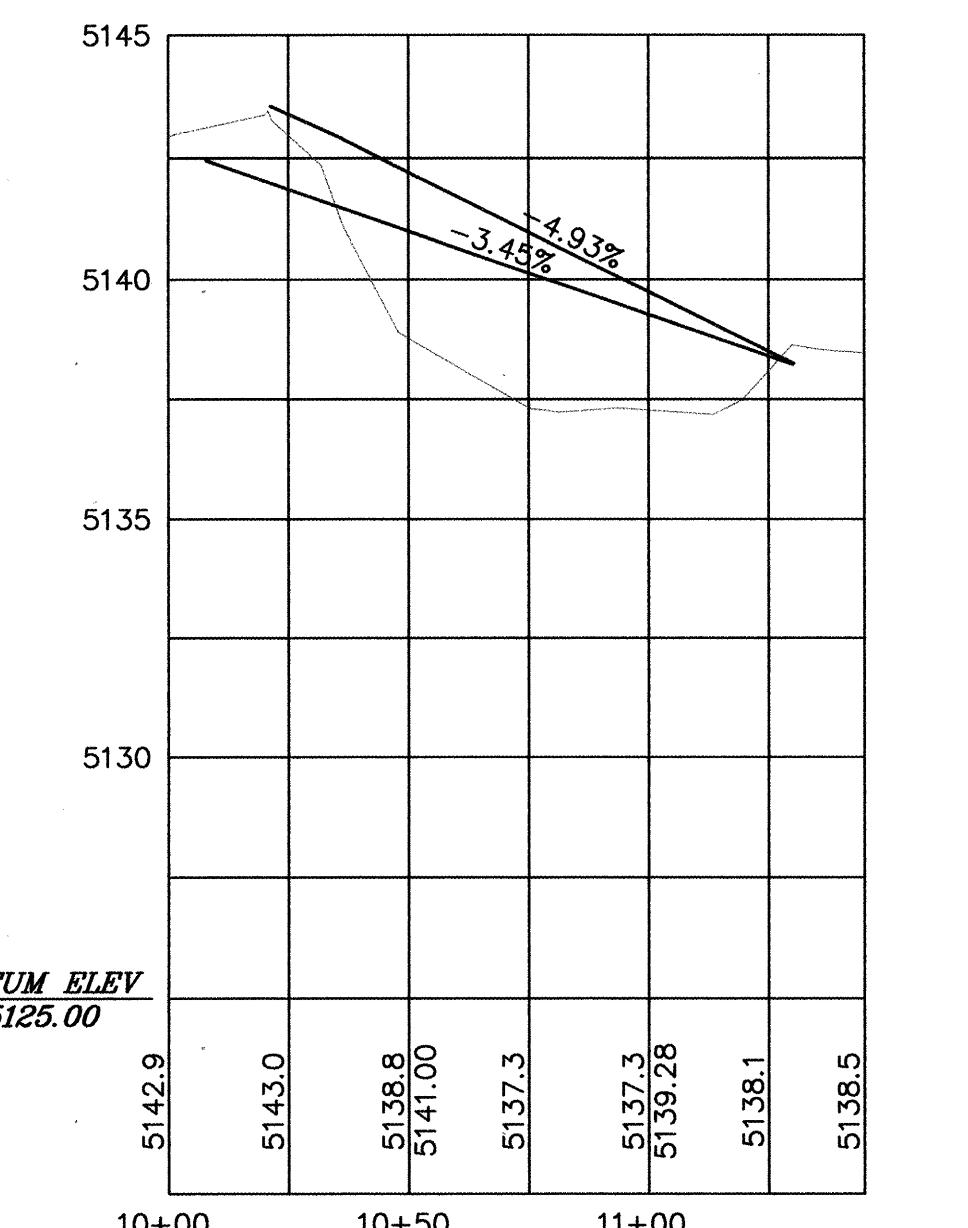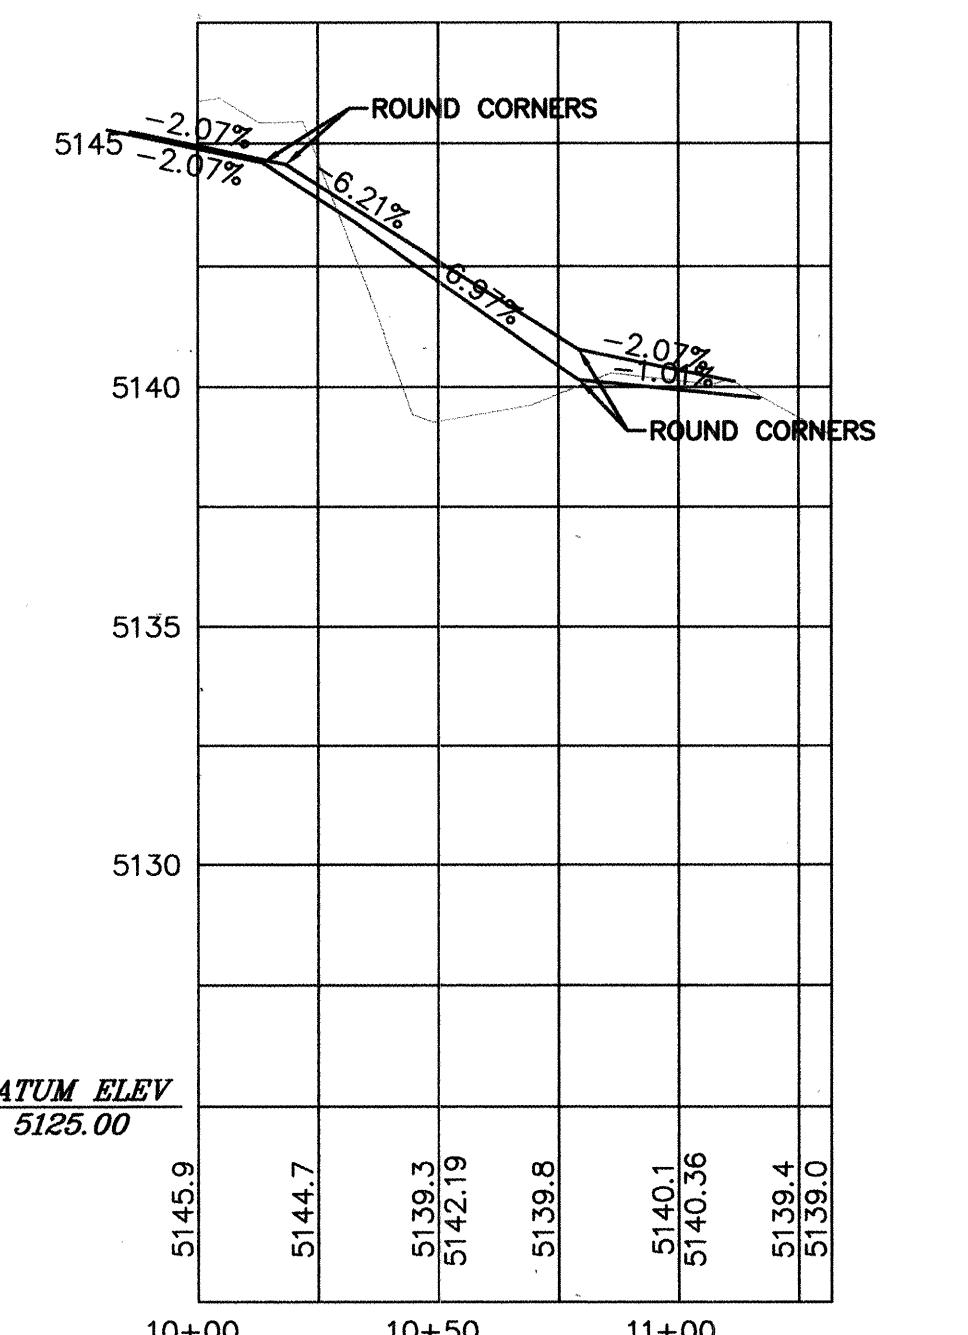


AS BUILT INFORMATION	
BENCH MARKS	SURVEY INFORMATION
A.C.S. MONUMENT "2 MG"	FIELD NOTES
C.O.A. BRASS CAP	NO. BY DATE
NM STATE PLANE COORDINATES	
Central Zone - N.A.D. 1927	
X-354-207.50	
Y=1,473,257.74	
G-G-O-9987987	
Do= 0164.7'	
ELEV=5133.97 (NCV29)	

AS BUILT INFORMATION
FILM INFORMATION
DATE
RECORDED BY
NO.

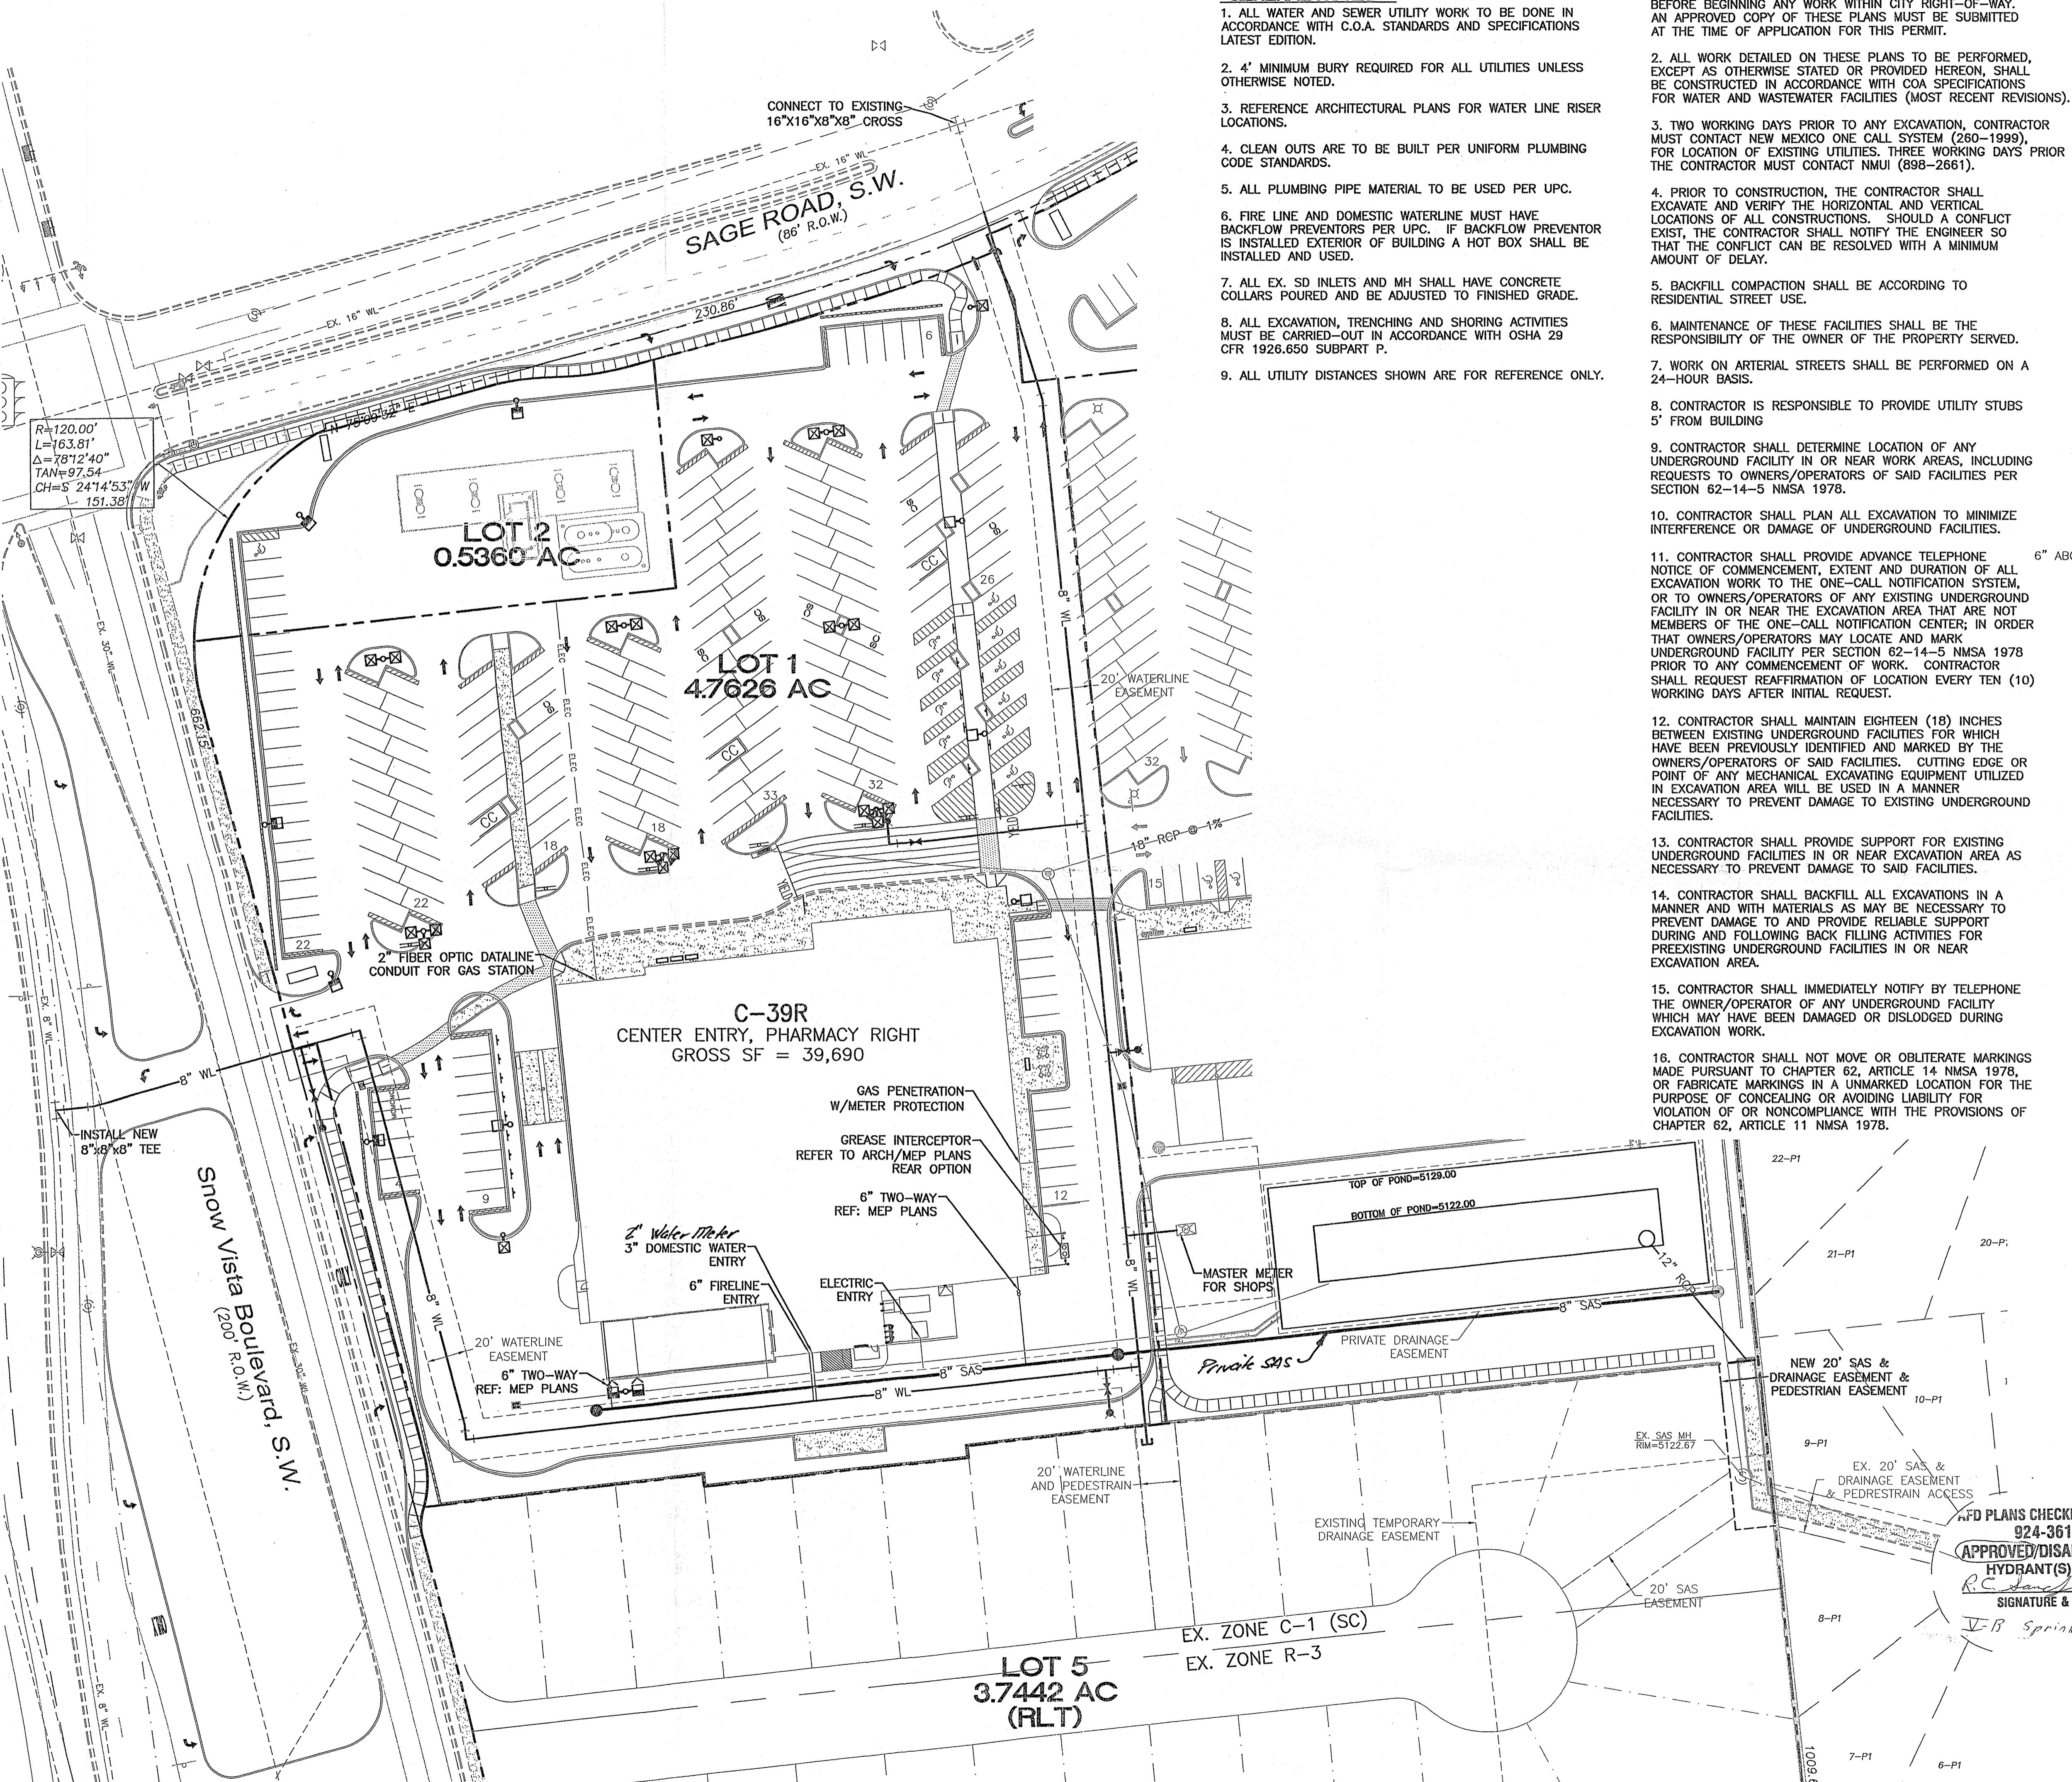


NOTICE TO CONTRACTORS

- AN EXCAVATION/CONSTRUCTION PERMIT WILL BE REQUIRED BEFORE BEGINNING ANY WORK WITHIN CITY RIGHT-OF-WAY. AN APPROVED COPY OF THESE PLANS MUST BE SUBMITTED AT THE TIME OF APPLICATION FOR THIS PERMIT.
- ALL WORK DETAILED ON THESE PLANS TO BE PERFORMED, EXCEPT AS OTHERWISE STATED OR PROVIDED HEREON, SHALL BE CONSTRUCTED IN ACCORDANCE WITH COA SPECIFICATIONS FOR WATER AND WASTEWATER FACILITIES (MOST RECENT REVISIONS).
- TWO WORKING DAYS PRIOR TO ANY EXCAVATION, CONTRACTOR MUST CONTACT NEW MEXICO ONE CALL SYSTEM (260-1999), FOR LOCATION OF EXISTING UTILITIES. THREE WORKING DAYS PRIOR THE CONTRACTOR MUST CONTACT NMUI (898-2661).
- PRIOR TO CONSTRUCTION, THE CONTRACTOR SHALL EXCAVATE AND VERIFY THE HORIZONTAL AND VERTICAL LOCATIONS OF ALL CONSTRUCTIONS. SHOULD A CONFLICT EXIST, THE CONTRACTOR SHALL NOTIFY THE ENGINEER SO THAT THE CONFLICT CAN BE RESOLVED WITH A MINIMUM AMOUNT OF DELAY.
- BACKFILL COMPACTION SHALL BE ACCORDING TO RESIDENTIAL STREET USE.
- Maintenance of THESE FACILITIES SHALL BE THE RESPONSIBILITY OF THE OWNER OF THE PROPERTY SERVED.
- WORK ON ARTERIAL STREETS SHALL BE PERFORMED ON A 24-HOUR BASIS.
- CONTRACTOR IS RESPONSIBLE TO PROVIDE UTILITY STUBS 5' FROM BUILDING
- CONTRACTOR SHALL DETERMINE LOCATION OF ANY UNDERGROUND FACILITY IN OR NEAR WORK AREAS, INCLUDING REQUESTS TO OWNERS/OPERATORS OF SAID FACILITIES PER SECTION 62-14-5 NMSA 1978.
- CONTRACTOR SHALL PLAN ALL EXCAVATION TO MINIMIZE INTERFERENCE OR DAMAGE OF UNDERGROUND FACILITIES.
- CONTRACTOR SHALL PROVIDE ADVANCE TELEPHONE NOTICE OF COMMENCEMENT, EXTENT AND DURATION OF ALL EXCAVATION WORK TO THE ONE-CALL NOTIFICATION SYSTEM, OR TO OWNERS/OPERATORS OF ANY EXISTING UNDERGROUND FACILITY IN OR NEAR THE EXCAVATION AREA THAT ARE NOT MEMBERS OF THE ONE-CALL NOTIFICATION CENTER; IN ORDER THAT OWNERS/OPERATORS MAY LOCATE AND MARK UNDERGROUND FACILITY PER SECTION 62-14-5 NMSA 1978 PRIOR TO ANY COMMENCEMENT OF WORK. CONTRACTOR SHALL REQUEST REAFFIRMATION OF LOCATION EVERY TEN (10) WORKING DAYS AFTER INITIAL REQUEST.
- CONTRACTOR SHALL MAINTAIN EIGHTEEN (18) INCHES BETWEEN EXISTING UNDERGROUND FACILITIES FOR WHICH HAVE BEEN PREVIOUSLY IDENTIFIED AND MARKED BY THE OWNERS/OPERATORS OF SAID FACILITIES. CUTTING EDGE OR POINT OF ANY MECHANICAL EXCAVATING EQUIPMENT UTILIZED IN EXCAVATION AREA WILL BE USED IN A MANNER NECESSARY TO PREVENT DAMAGE TO EXISTING UNDERGROUND FACILITIES.
- CONTRACTOR SHALL PROVIDE SUPPORT FOR EXISTING UNDERGROUND FACILITIES IN OR NEAR EXCAVATION AREA AS NECESSARY TO PREVENT DAMAGE TO SAID FACILITIES.
- CONTRACTOR SHALL BACKFILL ALL EXCAVATIONS IN A MANNER AND WITH MATERIALS AS MAY BE NECESSARY TO PREVENT DAMAGE TO AND PROVIDE RELIABLE SUPPORT DURING AND FOLLOWING BACK FILLING ACTIVITIES FOR PREEXISTING UNDERGROUND FACILITIES IN OR NEAR EXCAVATION AREA.
- CONTRACTOR SHALL IMMEDIATELY NOTIFY BY TELEPHONE THE OWNER/OPERATOR OF ANY UNDERGROUND FACILITY WHICH MAY HAVE BEEN DAMAGED OR DISLODGED DURING EXCAVATION WORK.
- CONTRACTOR SHALL NOT MOVE OR OBLITERATE MARKINGS MADE PURSUANT TO CHAPTER 62, ARTICLE 14 NMSA 1978, OR FABRICATE MARKINGS IN AN UNMARKED LOCATION FOR THE PURPOSE OF CONCEALING OR AVOIDING LIABILITY FOR VIOLATION OF OR NONCOMPLIANCE WITH THE PROVISIONS OF CHAPTER 62, ARTICLE 11 NMSA 1978.

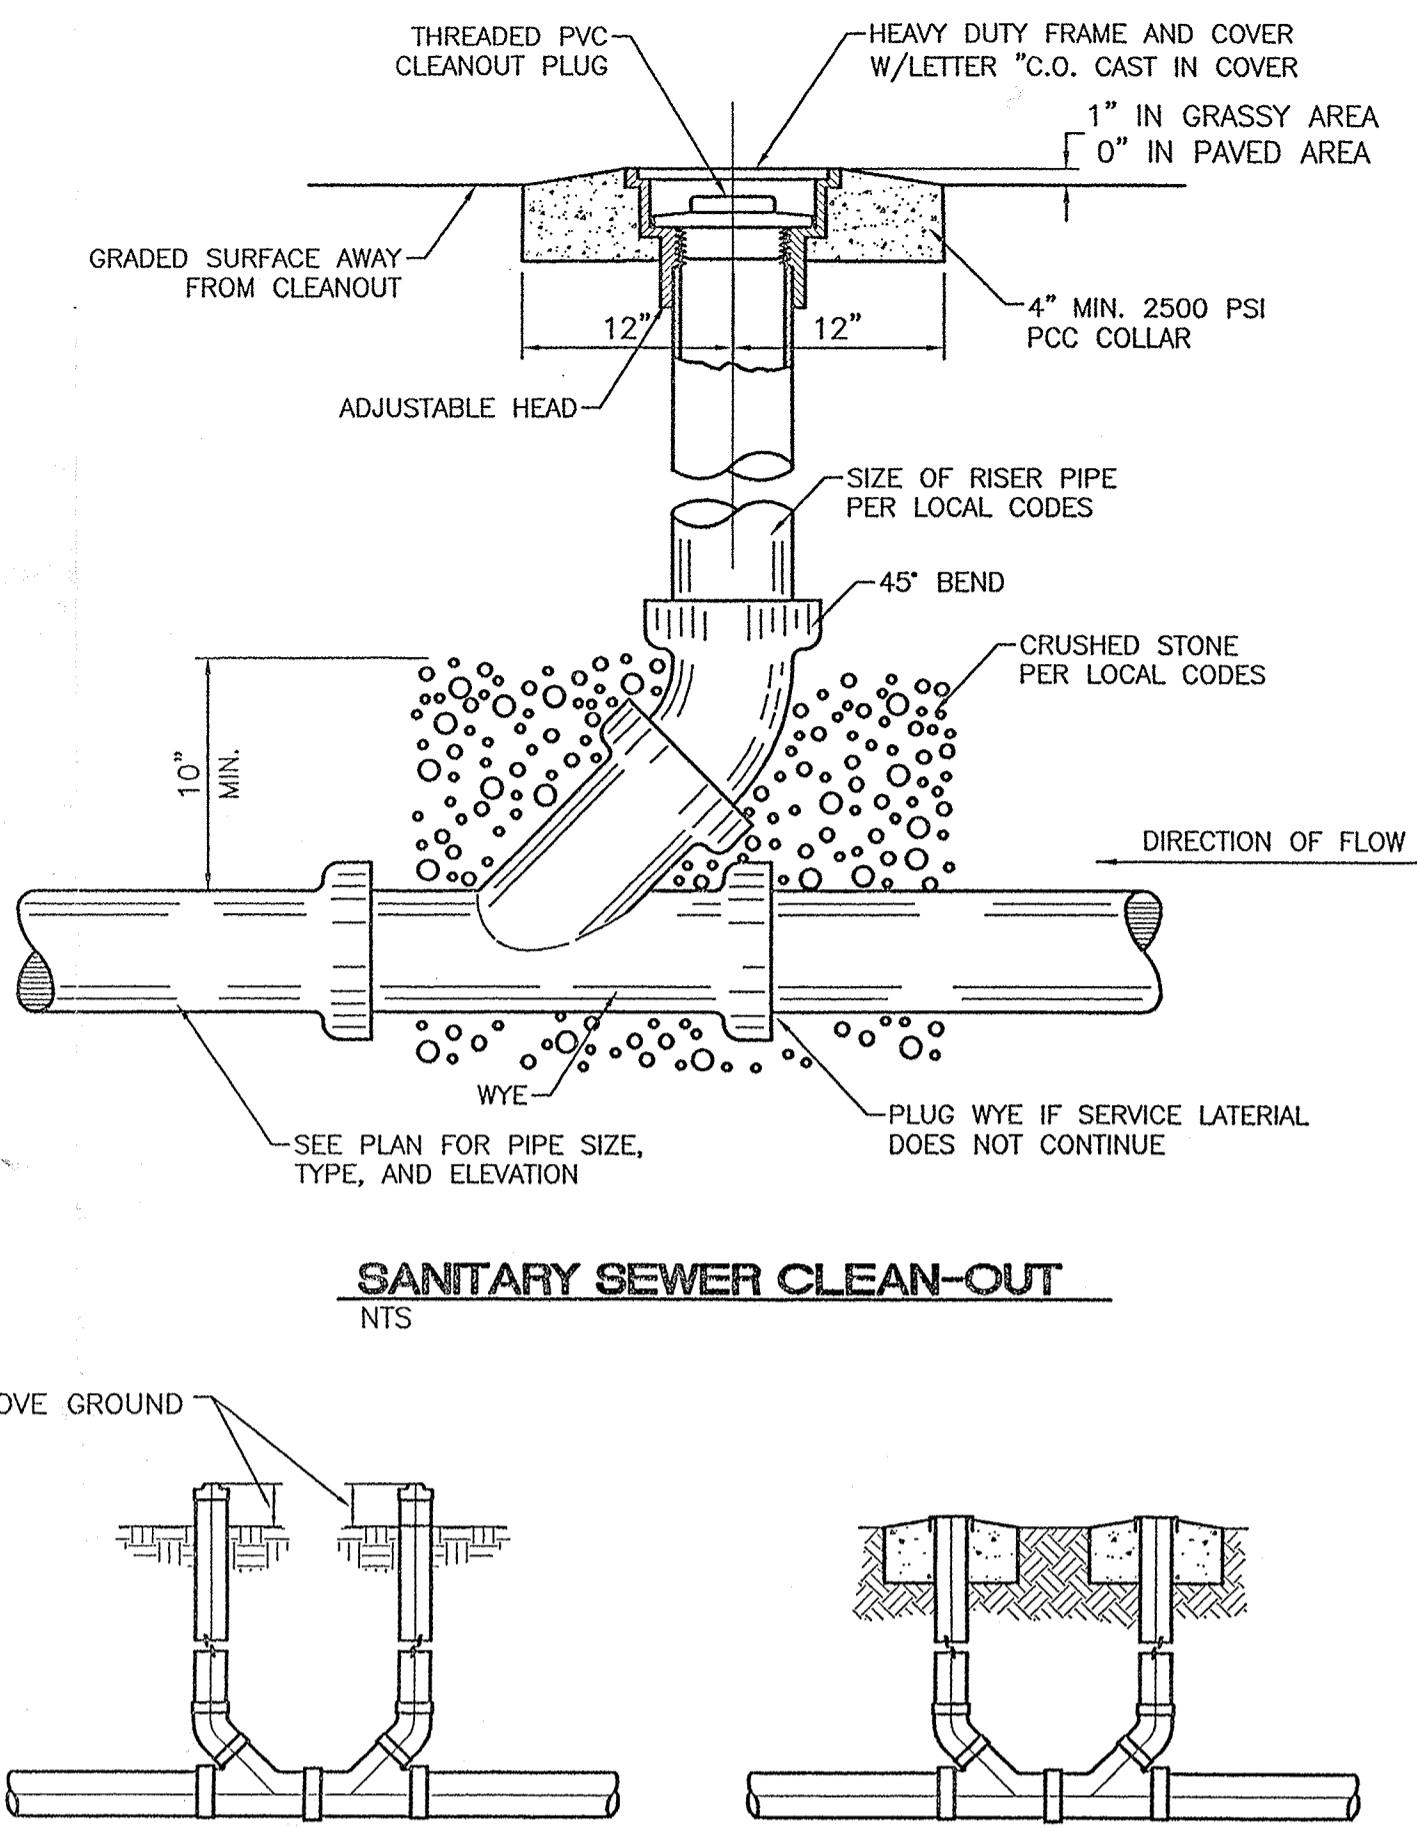


SANITARY SEWER CLEAN-OUT

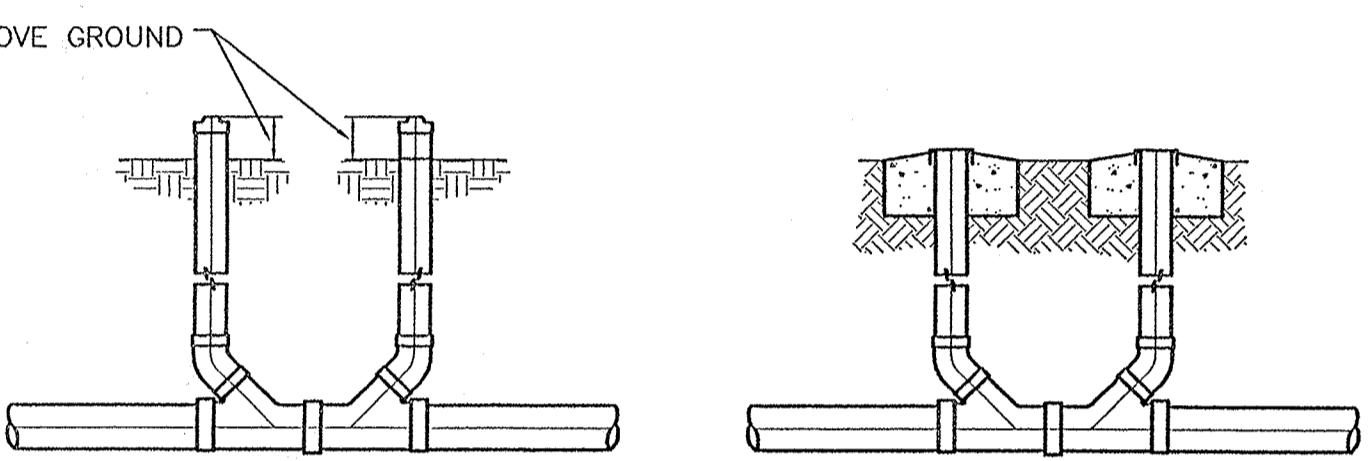

SANITARY SEWER DOUBLE CLEAN-OUTS

LEGEND

○	EXISTING SAS MANHOLE
○	EXISTING SANITARY SEWER LINE
○	PROPOSED SAS MANHOLE
○	PROPOSED SANITARY SEWER LINE
—	SANITARY SEWER SERVICE LINE
—	EXISTING WATER LINE
—	PROPOSED WATER LINE
—	PROPOSED CURB
—	BOUNDARY LINE
○	PROPOSED STORM SEWER MANHOLE
—	PROPOSED STORM SEWER LINE
—	PROPOSED DRY UTILITY TRENCH
—	EXISTING DRY UTILITY TRENCH
○	FIRE HYDRANT

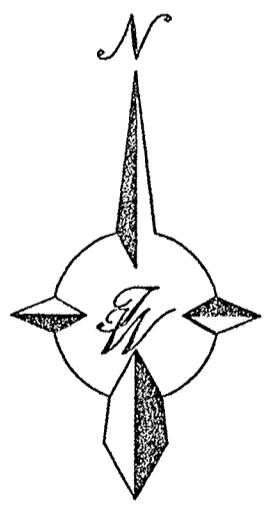

GRAPHIC SCALE

40 20 0 20 40
SCALE: 1"=40'

CAUTION

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FD PLANS CHECKING OFFICE

924-3611

APPROVED/DISAPPROVED


HYDRANT(S) ONLY

R.C. [Signature]

SIGNATURE & DATE

V.B. Sprinkled

RONALD R. BOHANNAN
P.E. #7868

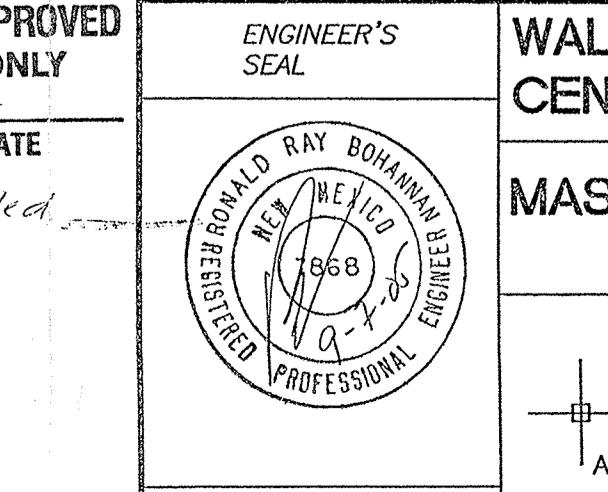

WAL-MART NEIGHBORHOOD
CENTER NM: 3385

MASTER UTILITY PLAN

DRAWN
BY
EMT

DATE
09-02-05

2520-MUB.dwg

SHEET #

5

JOB #
25020

TIERRA WEST, LLC
8509 JEFFERSON NE
ALBUQUERQUE, NEW MEXICO 87113
(505)858-3100

CNP# 769781