# Albuquerque Bernalillo County Water Utility Authority

RECORD DRAWINGS

# RAW WATER TRANSMISSION PIPELINE TO INTEL CORPORATION, BID PACKAGE

NO. 1 - WESTSIDE BLVD

SEPTEMBER 2022



**PURPOSES BY:** 

Victoria Dery **VICTORIA DERY, P.E.** 

2 3 2 0 . 0 3 0 0 1 - 2 0 2 3

CITY OF ALBUQUERQUE PROJECT NUMBERS:	
WESTSIDE BOULEVARD WIDENING	CPN 771891
BID PACKAGE 1	CPN 771863
BID PACKAGE 2A	CPN 771864
BID PACKAGE 2B	CPN 771865

# **CONTACT LIST**

ENTITY	NAME(S)	CONTACT INFORMATION
ALBUQUERQUE BERNALILLO COUNTY WATER UTILITY AUTHORITY P.O. BOX 568 ALBUQUERQUE, NM 87103	VICTORIA DERY	PHONE: 505-289-3501 VDERY@ABCWUA.ORG
AMAFCA 2600 PROSPECT AVE. NE ALBUQUERQUE, NM 87107	DESIGN REVIEW ENGINEER: NICOLE FRIEDT FIELD ENGINEER: NOLAN BENNETT	PHONE: 505-884-2215 NFRIEDT@AMAFCA.ORG
CITY OF ALBUQUERQUE CITY SURVEYOR P.O. BOX 1293 ALBUQUERQUE, NM 87102	LOREN RISENHOOVER	PHONE: 505-768-3614 LRISENHOOVER@CABQ.GOV
CITY OF ALBUQUERQUE CONSTRUCTION SERVICES DIVISION P.O. BOX 1293 ALBUQUERQUE, NM 87102	BRYAN WOLFE	PHONE: 505-924-3400 BWOLFE@CABQ.GOV
CITY OF ALBUQUERQUE MUNICIPAL DEVELOPMENT (TRAFFFIC ENGINEERING) P.O. BOX 1293 ALBUQUERQUE, NM 87102	N/A	PHONE: 505-768-3830 OR 311
PNM ELECTRIC MAIL STOP ES10 4201 EDITH BLVD. N.E. ALBUQUERQUE, NM 87107	STELLA MURDOCH	PHONE: 505-241-3369 STELLA.MURDOCH@PNM.COM
NEW MEXICO GAS MAIL STOP GS66 4625 EDITH BLVD. NE ALBUQUERQUE, NM 87107	DANNA DOMINGUEZ	PHONE: 505-697-3139 DANNA.DOMINGUEZ@NMGCO.COM

#### **RECORD DRAWINGS**

INFORMATION PROVIDED BY OTHERS. THEY ARE NOT INTENDED TO REPRESENT IN DETAIL THE EXACT LOCATION. TYPE OF COMPONENT NOR MANNER OF CONSTRUCTION. THE DESIGN PROFESSIONAL HAS NOT VERIFIED THE ACCURACY AND/OR THE COMPLETENESS OF THIS INFORMATION AND SHALL NOT BE RESPONSIBLE FOR ANY ERRORS OR OMISSIONS WHICH MAY BE INCORPORATED HEREIN AS A RESULT.

Timothy Solinski, PS

ENGINEERING, OR INTENT OF THE RECORD DRAWINGS.

City Inspector

**Construction Engineer** 

Ti She January 4, 2023

505-884-5600




# INDEX OF DRAWINGS

SHEET NO.	DWG NO.	DESCRIPTION	
	GENERAL		
1	G-1	COVER, LOCATION MAP, VICINITY MAPS AND INDEX OF DRAWINGS	
2	G-2	GENERAL NOTES	
3	G-3	LEGEND AND ABBREVIATIONS	
4	G-4	KEY PLAN, SURVEY CONTROL, STAGING AREA AND POTHOLE TABL	_E
5	G-5	HYDRAULIC PROFILE	
	WELL COLLECT	OR PIPELINE FROM CORRALES WELL 5 TO CONTROL TANK	
6	PP-201	PLAN AND PROFILE POB STA 1999+95 TO 2006+00	
7	PP-202	PLAN AND PROFILE STA 2006+00 TO STA 2014+00	
8	PP-203	PLAN AND PROFILE STA 2014+00 TO STA 2022+00	
9	PP-204	PLAN AND PROFILE STA 2022+00 TO STA 2030+00	
10	PP-205	PLAN AND PROFILE STA 2030+00 TO STA 2038+00	
11	PP-206	PLAN AND PROFILE STA 2038+00 TO POE STA 2043+96.78	
	<u>DETAILS</u>		
12	DT-01	ABCWUA STANDARD DETAILS	
13	DT-02	ABCWUA STANDARD DETAILS	
14	DT-03	ABCWUA STANDARD DETAILS	
	DT-04	NOT USED	
4.5	DT-05	NOT USED	J
15 16	DT-06	STANDARD DETAILS	
16 17	DT-07 DT-08	WATER LINE LOWERING	327
17	D1-00	CAV DETAIL 2350B	

#### CERTIFICATE OF SUBSTANTIAL COMPLIANCE ON PLANS

I, JILL L. PETERSON, of the firm JACOBS ENGINEERING, a Licensed Professional Engineer in the State of New Mexico, do hereby certify, to the best of my knowledge and belief, that the infrastructure installed as shown on these Record Drawings has been constructed in accordance with the original design intent of the approved plans RAW WATER TRANSMISSION PIPELINE TO INTEL CORPORATION, BID PACKAGE NO. 1 - WESTSIDE BLVD. This Certification is based upon information provided by the contractor and has been incorporated into these Record Drawings. I further certify that Jacobs Engineering, verified substantial compliance with the plans and specifications as provided by AUI, INC. This certification does not constitute a guarantee of absolute accuracy or completeness, but is believed to be an accurate representation of the improvements built under this project.

CPN 771863 A/E PROJECT NO. 2302.005 TRANSMISSION PIPELINE

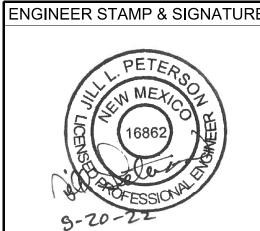

		/				
RΕ	APPROVALS	ENGINEER	DATE	******	*****	****
	DRC CHAIRPERSON			APPROVED FOR CO	NSTRUC	CTION
	TRANSPORTATION					
	WATER/WASTEWATER					
	HYDROLOGY			CITY ENGINEER DA		
	PARKS				DATE	
	CONST. MGMT.				DAIL	
	CONST. COORD.					
	WATER AUTHORITY			SHEET	OF	
	CONSTRUCTION	2320.030	<b>1</b> C	1		17
	PROJECT NO.			1		1 /

Jacobs ALBUQUERQUE, NM 87109

CONSTRUCTION DRAWINGS FOR

# RAW WATER TRANSMISSION PIPELINE TO INTEL CORPORATION, BID PACKAGE NO. 1 - WESTSIDE BLVD

DECEMBER 2021


CITY OF ALBUQUERQUE PROJECT NUMBERS:	
WESTSIDE BOULEVARD WIDENING	CPN 771891
BID PACKAGE 1	CPN 771863
BID PACKAGE 2A	CPN 771864
BID PACKAGE 2B	CPN 771865

#### **CONTACT LIST**


ENTITY	NAME(S)	CONTACT INFORMATION
ALBUQUERQUE BERNALILLO COUNTY WATER UTILITY AUTHORITY P.O. BOX 568 ALBUQUERQUE, NM 87103	VICTORIA DERY	PHONE: 505-289-3501 VDERY@ABCWUA.ORG
AMAFCA 2600 PROSPECT AVE. NE ALBUQUERQUE, NM 87107	DESIGN REVIEW ENGINEER: NICOLE FRIEDT FIELD ENGINEER: NOLAN BENNETT	PHONE: 505-884-2215 NFRIEDT@AMAFCA.ORG
CITY OF ALBUQUERQUE CITY SURVEYOR P.O. BOX 1293 ALBUQUERQUE, NM 87102	LOREN RISENHOOVER	PHONE: 505-768-3614 LRISENHOOVER@CABQ.GOV
CITY OF ALBUQUERQUE CONSTRUCTION SERVICES DIVISION P.O. BOX 1293 ALBUQUERQUE, NM 87102	BRYAN WOLFE	PHONE: 505-924-3400 BWOLFE@CABQ.GOV
CITY OF ALBUQUERQUE MUNICIPAL DEVELOPMENT (TRAFFFIC ENGINEERING) P.O. BOX 1293 ALBUQUERQUE, NM 87102	N/A	PHONE: 505-768-3830 OR 311
PNM ELECTRIC MAIL STOP ES10 4201 EDITH BLVD. N.E. ALBUQUERQUE, NM 87107	STELLA MURDOCH	PHONE: 505-241-3369 STELLA.MURDOCH@PNM.COM
NEW MEXICO GAS MAIL STOP GS66 4625 EDITH BLVD. NE ALBUQUERQUE, NM 87107	DANNA DOMINGUEZ	PHONE: 505-697-3139 DANNA.DOMINGUEZ@NMGCO.COM

# INDEX OF DRAWINGS

SHEET NO.	DWG NO.	DESCRIPTION
	<u>GENERAL</u>	
1	G-1	COVER, LOCATION MAP, VICINITY MAPS AND INDEX OF DRAWINGS
2	G-2	GENERAL NOTES
3	G-3	LEGEND AND ABBREVIATIONS
4	G-4	KEY PLAN, SURVEY CONTROL, STAGING AREA AND POTHOLE TABLE
5	G-5	HYDRAULIC PROFILE
	WELL COLLECT	OR PIPELINE FROM CORRALES WELL 5 TO CONTROL TANK
6	PP-201	PLAN AND PROFILE POB STA 1999+95 TO 2006+00
7	PP-202	PLAN AND PROFILE STA 2006+00 TO STA 2014+00
8	PP-203	PLAN AND PROFILE STA 2014+00 TO STA 2022+00
9	PP-204	PLAN AND PROFILE STA 2022+00 TO STA 2030+00
10	PP-205	PLAN AND PROFILE STA 2030+00 TO STA 2038+00
11	PP-206	PLAN AND PROFILE STA 2038+00 TO POE STA 2043+96.78
	DETAILS	
12	DT-01	ABCWUA STANDARD DETAILS
13	DT-02	ABCWUA STANDARD DETAILS
14	DT-03	ABCWUA STANDARD DETAILS
15	DT-04	ABCWUA STANDARD DETAILS
16 17	DT-05	ABCWUA STANDARD DETAILS
17	DT-06	STANDARD DETAILS
18	DT-07 DT-08	WATER LINE LOWERING
19	טו-טס	CAV DETAIL 2350B

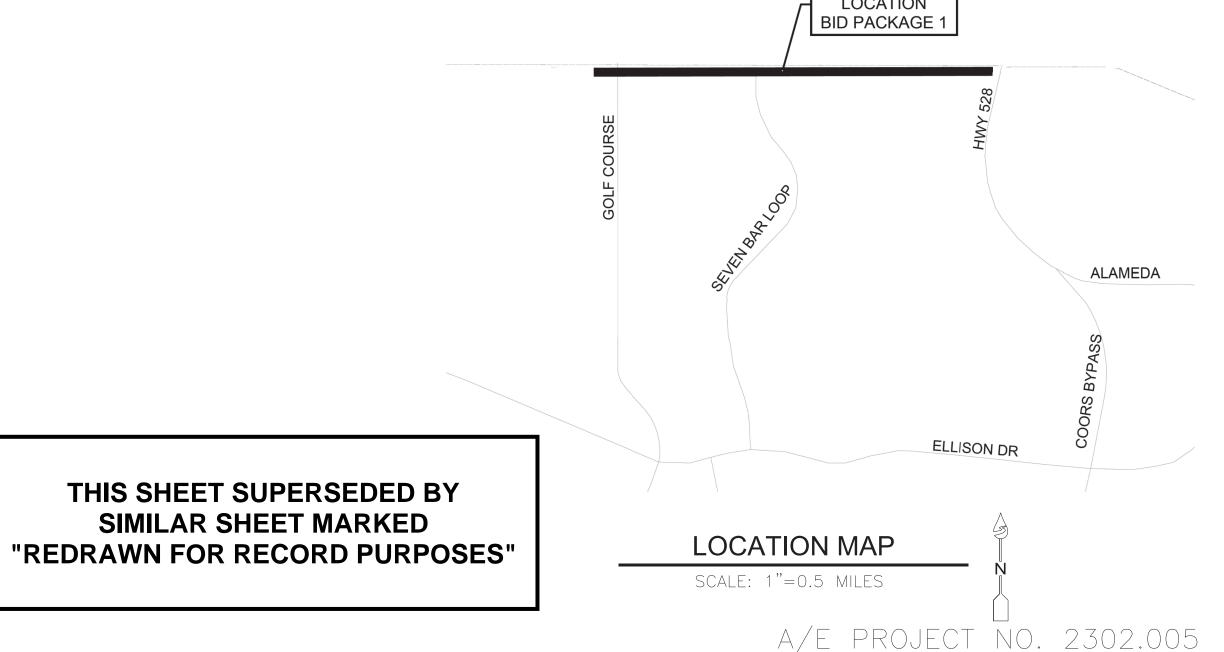



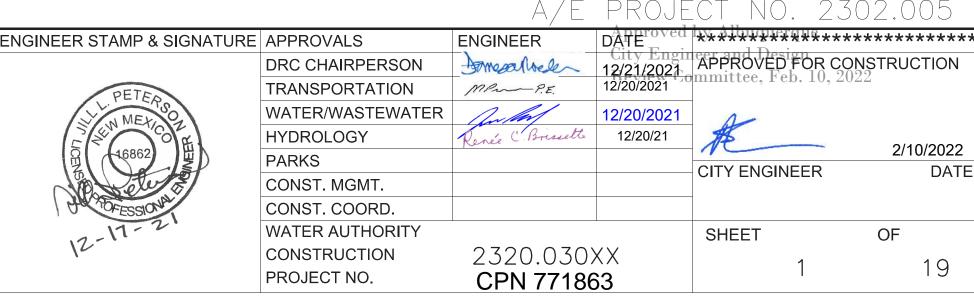

**TRANSMISSION** 

#### **GENERAL NOTES:**

- CONTACT NEW MEXICO ONE CALL, INC., 1-800-321-2537 OR 811, FOR LOCATION OF EXISTING UTILITIES AT LEAST 48 HOURS PRIOR TO EXCAVATION. CONTACT CITY OF ALBUQUERQUE (COA) TRAFFIC ENGINEERING (505-857-8000) FOR LOCATIONS OF TRAFFIC INTERCONNECT WIRING AND OTHER TRAFFIC
- SIGNAL EQUIPMENT. CONSTRUCT WORK DETAILED UNDER THESE DRAWINGS PER THE CONTRACT SPECIFICATIONS FOR THIS PROJECT, IN ACCORDANCE WITH WATER AUTHORITY STANDARD DRAWINGS, AND IN ACCORDANCE WITH COA STANDARD DRAWINGS AND SPECIFICATIONS FOR PUBLIC WORKS CONSTRUCTION
- QUANTITIES SHOWN FOR UNIT PRICE BID ITEMS ARE FOR COMPARISON ONLY. WATER AUTHORITY SHALL BASE PAYMENTS TO CONTRACTOR FOR UNIT PRICE BID ITEMS ON ACTUAL QUANTITIES, DETERMINED AS PROVIDED IN CONTRACT DOCUMENTS. KEEP CONSTRUCTION SITE AND OTHER AREAS FREE FROM ACCUMULATIONS OF WASTE MATERIALS, RUBBISH, AND OTHER DEBRIS. CONFORM TO

(CURRENT EDITION). CONTRACT DOCUMENTS FOR THIS PROJECT SUPERSEDE WATER AUTHORITY AND COA DRAWINGS AND SPECIFICATIONS.

- APPLICABLE LAWS AND REGULATIONS WHEN REMOVING AND DISPOSING OF WASTE MATERIALS, RUBBISH, AND OTHER DEBRIS INCIDENTAL TO CONTRACT.
- DO NOT STORE OR PARK EQUIPMENT IN FRONT OF PRIVATE RESIDENCES OVERNIGHT. MAINTAIN A GRAFFITI-FREE WORK SITE AND PROMPTLY REMOVE GRAFFITI FROM EQUIPMENT (PERMANENT AND TEMPORARY)
- CONTRACTOR IS SOLELY RESPONSIBLE FOR JOB SITE SAFETY, AND FOR KNOWLEDGE AND COMPLIANCE WITH APPLICABLE OSHA STANDARDS -INCIDENTAL TO CONTRACT.
- MAINTAIN TRENCHES IN SAFE CONDITION PROTECTING WORKERS AND PUBLIC. PROTECT TRENCH IN ACCORDANCE WITH OSHA 29 CFR 1926.650 SUBPART P. SLOPE, BRACE, OR SHORE EXCAVATIONS AS REQUIRED BY OSHA REGULATIONS.
- BACKFILL OR PROPERLY FENCE OPEN EXCAVATIONS AT END OF EACH WORKDAY. BACKFILL OPEN EXCAVATIONS WHEN CONTRACTOR WILL NOT BE WORKING AT ON-SITE THE FOLLOWING DAY.
- 10. AN EXCAVATION / CONSTRUCTION PERMIT WILL BE REQUIRED BEFORE BEGINNING WORK WITHIN CITY RIGHT-OF-WAY
- PROVIDE AND MAINTAIN CONSTRUCTION SIGNING UNTIL WATER AUTHORITY AND COA HAVE ACCEPTED THE PROJECT.
- COA NOISE CONTROL ORDINANCE FORBIDS LOUD CONSTRUCTION NOISE BETWEEN THE HOURS OF 10:00 PM AND 7:00 AM.
- 13. DO NOT LOCATE PUMPS OR COMPRESSORS REQUIRED TO RUN FOR THE DURATION OF THE WORK ADJACENT TO RESIDENTIAL PROPERTY; IF UNAVOIDABLE, EMPLOY NOISE ABATEMENT SOLUTIONS.
- 14. NOTIFY COA GEODETIC SURVEY (768-3609) NOT LESS THAN THREE (3) WORKING DAYS PRIOR TO STARTING WORK THAT WILL AFFECT ANY EXISTING GEODETIC SURVEY MONUMENT. REPLACE COA GEODETIC SURVEY, AT CONTRACTOR'S EXPENSE, ACS MONUMENT DAMAGED OR DESTROYED DUE TO FAILURE OF CONTRACTOR TO NOTIFY AS STATED ABOVE.
- 15. NOTIFY ENGINEER NO LESS THAN SEVEN (7) CALENDAR DAYS PRIOR TO STARTING WORK SO THAT THE COA GEODETIC SURVEY MAY TAKE NECESSARY MEASURES TO ENSURE PRESERVATION OF OTHER PERMANENT SURVEY MONUMENTS (NON-ACS). DO NOT DISTURB PERMANENT SURVEY MONUMENTS WITHOUT CONSENT OF THE ENGINEER. EXPENSE OF REPLACING ANY THAT MAY BE DISTURBED WITHOUT PERMISSION IS AT THE EXPENSE OF THE CONTRACTOR. REPLACEMENT MUST BE PERFORMED BY THE COA GEODETIC SURVEY. WHEN A CHANGE IS MADE IN FINISHED ELEVATION OF PAVEMENT OF ROADWAY IN WHICH A PERMANENT SURVEY MONUMENT IS LOCATED, ADJUST MONUMENT COVER TO NEW GRADE, UNLESS OTHERWISE SPECIFIED, AT CONTRACTOR EXPENSE.
- 16. NOTIFY UTILITY OWNERS 48 HOURS IN ADVANCE OF CONSTRUCTION ACTIVITY DISRUPTING UTILITY SERVICE. SUPPORT AND MAINTAIN OPERATIONAL UTILITIES EXPOSED DURING TRENCHING AND OTHER CONSTRUCTION OPERATIONS. COORDINATED WITH UTILITY OWNER PRIOR TO ANY DISTURBANCE INVOLVING GAS, POWER, WATER, FIBER OPTIC, TRAFFIC SIGNAL EQUIPMENT, OR OTHER UTILITY LINES.
- 17. DUE TO INCREASED TRAFFIC VOLUMES EXCAVATION AND/OR BARRICADING PERMITS WILL NOT BE ISSUED FOR WORK AFFECTING HIGH TRAFFIC AREAS BEFORE AND DURING THE STATE FAIR, THE BALLOON FIESTA, AND THE HOLIDAY SHOPPING SEASON. SEE WWW.CABQ.GOV FOR CONSTRUCTION MORATORIUM EFFECTIVE DATES AND MAP OF AREAS. WORK AFFECTING BIKE TRAIL ALONG THE DOMINGO BACA CHANNEL WILL NOT BE ALLOWED DURING BALLOON FIESTA MORATORIUM.
- 18. CONTRACTOR TO USE THE LATEST ONLINE VERSION OF CITY OF ALBUQUERQUE'S STANDARD DRAWINGS. THOSE DETAILS CAN BE ACCESSED WITH THE FOLLOWING LINK: https://www.cabq.gov/planning/building-development-service/design-review-construction-forms

#### **CONSTRUCTION NOTES:**

- ABIDE BY LOCAL, STATE, AND FEDERAL LAWS, RULES AND REGULATIONS WHICH APPLY TO THE CONSTRUCTION OF THESE IMPROVEMENTS PRIOR TO CONSTRUCTION, DETERMINE EXACT HORIZONTAL AND VERTICAL LOCATION AND SIZE OF PERTINENT EXISTING UTILITIES AND / OR OBSTRUCTIONS THAT MAY IMPACT THE ALIGNMENT. SHOULD A CONFLICT EXIST, NOTIFY THE ENGINEER SO THE CONFLICT CAN BE RESOLVED WITHOUT A DELAY. COORDINATE RELOCATION OF UTILITY LINES WITH AFFECTED UTILITY COMPANIES AS REQUIRED. MARK EXACT LOCATION OF ENCOUNTERED UTILITIES AND NEW WATERLINE ON AS-BUILT DRAWINGS.
- PROTECT THE EXISTING PUBLIC AND PRIVATE UTILITY LINES WITHIN THE CONSTRUCTION AREA. ANY DAMAGE TO EXISTING FACILITIES CAUSED BY CONSTRUCTION ACTIVITY SHALL BE REPAIRED OR REPLACED AT THE CONTRACTOR'S EXPENSE UNLESS OTHERWISE NOTED ON THE PLANS AND APPROVED BY THE ENGINEER.
- LIMIT CONSTRUCTION ACTIVITY TO THE RIGHTS-OF-WAY AND EASEMENTS, PROPERTY LIMITS AND/OR PROJECT LIMITS OF DISTURBANCE ANY DAMAGE TO ADJACENT PROPERTIES RESULTING FROM THE CONSTRUCTION PROCESS IS THE RESPONSIBILITY OF THE CONTRACTOR. ANY COSTS INCURRED FOR REPAIRS SHALL BE THE COST OF THE CONTRACTOR.
- REPLACE PROPERTY CORNERS DESTROYED DURING CONSTRUCTION AT CONTRACTOR'S EXPENSE. RESET PROPERTY CORNER BY A
- NEW MEXICO REGISTERED PROFESSIONAL SURVEYOR. SAWCUT PAVEMENT WITH UNIFORM EDGE AND SPRAY WITH A TACK COAT PRIOR TO PAVEMENT PLACEMENT. PER COA,
- USE PARALLEL OR ORTHOGONAL PAVEMENT CUTS ONLY, NO DIAGONAL CUTS IN EXISTING PAVEMENT PER COA STD. DWG. 2465. WHEN ABUTTING NEW PAVEMENT TO THE EXISTING INTERSECTING STREETS SAWCUT THE EXISTING PAVEMENT PER COA TO A STRAIGHT LINE AT RIGHT ANGLES AND REMOVE ANY BROKEN OR CRACKED PAVEMENT. SAW CUTTING IS CONSIDERED INCIDENTAL TO PAVING, THEREFORE. NO DIRECT PAYMENT WILL BE MADE FOR SAW CUTTING. CONTACT COA TO REQUEST AN INSPECTOR TO VERIFY PAVEMENT THICKNESS.
- WHEN ABUTTING NEW CURB AND GUTTER TO EXISTING PAVEMENT, SAWCUT, REMOVE, AND REPLACE A 1' WIDE SECTION OF EXISTING PAVEMENT ADJACENT TO THE CURB AND GUTTER AS PER THE COA STANDARD DRAWING 2465.
- SUPPORT EXPOSED EXISTING UTILITIES INCLUDING SEWER SERVICE LATERALS SUSPENDED ACROSS OR PARALLEL WITH TRENCH EXCAVATION. PROVIDE A SUPPORT PLAN FOR WATER, SANITARY SEWER, AND STORM DRAIN UTILITIES GREATER THAN 16 INCHES, UNLESS OTHERWISE REQUESTED, WHERE THE NEW PIPELINE IS CONSTRUCTED UNDERNEATH THE NEW UTILITY.
- UTILIZE FLOWABLE FILL WHERE NOTED ON PLANS OR WHEREVER BACKFILL MATERIAL CAN NOT BE PLACED AND COMPACTED PER SPECIFICATION BETWEEN THE NEW PIPE LINE AND EXISTING UTILITIES OR IF THE VERTICAL SEPARATION BETWEEN THE NEW PIPE LINE AND EXISTING UTILITY IS LESS THAN 18-INCHES OR IF REQUIRED BY THE DRAWINGS. THIS COST IS INCIDENTAL TO BACKFILL COSTS.
- 10. STRUCTURAL CONCRETE TO BE 4000 PSI UNLESS OTHERWISE NOTED ON PLANS OR SPECIFICATIONS
- ENCASE BURIED DUCTILE IRON PIPE IN PURPLE POLYETHYLENE SHEETING PER SUPPLEMENTAL SPECIFICATION SECTION 801. LIMIT LENGTH OF OPEN TRENCH TO 40 FEET MAXIMUM. TRENCH TO BE FENCED EVERY NIGHT AND DURING NON-WORKING HOURS.
- CONTRACTOR TO DESIGN, PROVIDE AND INSTALL TEMPORARY SUPPORT FOR EXISTING UTILITIES WHERE CROSSING.
- 14. ALL CONSTRUCTION WORK TO BE IN ACCORDANCE WITH COA STANDARD SPECIFICATIONS 2020 EDITION.

#### WATER NOTES:

- COORDINATE WITH ABCWUA AT LEAST SEVEN (7) WORKING DAYS PRIOR TO WATER VALVE SHUTOFFS. NO ONE WITHOUT WRITTEN PERMISSION OR DIRECT SUPERVISION FROM THE WATER AUTHORITY FIELD DIVISION SUPERVISOR MAY OPERATE VALVE OR FIRE HYDRANT PER STANDARD SPECIFICATION SECTION 18.3. CONTRACTOR IS RESPONSIBLE FOR TIMING AND COORDINATION OF WATER VALVE SUT-OFF/TURN-ON REQUESTS
- CONTRACTOR TO SUBMIT AN ELECTRONIC WATER MAIN SHUT-OFF/TURN-ON REQUEST VIA https://www.abcwua.org/info-for-business-water-shut-off-and-turn-on-procedures/ NOTIFY ABCWUA FIELD AND COA FIRE DEPARTMENT AT LEAST SEVEN (7) WORKING DAYS IN ADVANCE OF ANY FIRE HYDRANT TAKEN OUT OF AND RETURNED TO SERVICE - REFER TO STANDARD SPECIFICATIONS.
- FIELD VERIFY WATERLINE CONNECTIONS TO EXISTING FACILITIES SUFFICIENTLY IN ADVANCE OF CONSTRUCTION TO ALLOW OBTAINING CORRECT ADAPTERS AND OTHER FITTINGS.
- INSTALL NEW WATERLINES AT ENGINEERED HORIZONTAL AND VERTICAL CONTROL SHOWN IN THE PLAN AND PROFILE DRAWINGS. PERFORM SURVEY STAKING A MINIMUM OF EVERY 100 FEET PER COA SPECIFICATION SECTION 4, AVAILABILITY OF LANDS; PHYSICAL CONDITIONS;
- PLACE ELECTRONIC MARKER DEVICES (EMD) ACCORDING TO STANDARD SPECIFICATION SECTION 170 INCIDENTAL TO CONTRACT.
- PROVIDE TEMPORARY WATER SERVICE FOR ANY RESIDENCE, SCHOOL, OR BUSINESS THAT WILL BE OUT OF SERVICE MORE THAN FOUR (4) HOURS. SHOEFLY WATERLINE BYPASS IS AN OPTION FOR TEMPORARY SERVICE - INCIDENTAL TO CONSTRUCTION.
- CONTRACTOR IS RESPONSIBLE FOR TIMING AND COORDINATION OF WATER VALVE SUT-OFF/TURN-ON REQUESTS. CONTRACTOR TO SUBMIT AN ELECTRONIC WATER MAIN SHUT-OFF/TURN-ON REQUEST VIA https://www.abcwua.org/info-for-business-water-shut-off-and-turn-on-procedures/. SUBMIT REQUEST FOR WATER SHUT-OFF OR TURN-ON AT LEAST FOURTEEN (14) WORKING DAYS IN ADVANCE FOR MAINS DESIGNATED AS A TRANSMISSION LINE MASTER PLAN LINE, COLLECTOR OR WELL COLLECTOR LINE. REQUESTS MADE AFTER 8:00 A.M. WILL BE LOGGED IN AND SCHEDULED ON THE FOLLOWING WORK DAY AND THE FOURTEEN (14) WORKING DAY REQUIREMENT WILL COMMENCE.

#### **SEWER NOTES:**

- UNDER NO CIRCUMSTANCE SHALL SEWAGE OR SOLIDS REMOVED FROM MANHOLES BE DISCHARGED ONTO STREETS OR INTO DITCHES, CATCH BASINS, STORM DRAINS, OR SANITARY SEWER MANHOLES, CLEANOUTS, OR DUMPS.
- IF SEWAGE SPILLS ONTO PUBLIC OR PRIVATE PROPERTY, WASH DOWN, CLEAN UP, AND DISINFECT THE SPILLAGE AT THE CONTRACTORS EXPENSE TO THE SATISFACTION OF WATER AUTHORITY AND THE PROPERTY OWNER. SEE SPECIFICATION SECTION 33 01 30.51, SEWAGE FLOW CONTROL.

#### PAVEMENT/DRAINAGE/CITY OF ALBUQUERQUE/RIO RANCHO:

- SUBMIT TO ENGINEER, WATER AUTHORITY, COA AND CITY OF RIO RANCHO CONSTRUCTION COORDINATION DIVISION A DETAILED CONSTRUCTION SCHEDULE SEVEN (7) WORKING DAYS PRIOR TO BEGINNING CONSTRUCTION. OBTAIN BARRICADING AND CONSTRUCTION PERMITS FROM COA AND / OR BERNALILLO COUNTY AND / OR CITY OF RIO RANCHO AS APPROPRIATE TWO (2) WORKING DAYS PRIOR TO CONSTRUCTION. NOTIFY COA CONSTRUCTION SERVICES (505-924-3400) PRIOR TO OCCUPYING AN INTERSECTION.
- DURING CONSTRUCTION, REPAIR OR REPLACE DAMAGE TO EXISTING FACILITIES AND INFRASTRUCTURE INCLUDING UTILITIES. VALVE BOXES, MANHOLES, SEWER SERVICES, PAVEMENTS, PAVEMENT MARKINGS, CURB AND GUTTER, DRIVE PADS, WHEELCHAIR RAMPS, SIDEWALKS AND OTHER EXISTING FEATURES. REPAIR OR REPLACE PER UTILITY AGENCY, COA, WATER AUTHORITY, RIO RANCHO, AND OWNER OF THE INFRASTRUCTURE STANDARDS AT CONTRACTOR'S EXPENSE.
- ANY PAVEMENT, OR CURB AND GUTTER REMOVAL AND REPLACEMENT ASSOCIATED WITH REPLACEMENT OF WATER SERVICE LINES
- IS INCIDENTAL TO THE SERVICE LINE REPLACEMENT.
- ADJUST WATER VALVE BOXES AND SEWER MANHOLES WITHIN NEW PAVEMENT TO FINISH GRADE PER COA AND ABCWUA STANDARDS. RESTORE FINISHED GRADES TO EXISTING GRADES UNLESS OTHERWISE DIRECTED BY ENGINEER. MAKE SMOOTH TRANSITIONS
- BETWEEN EXISTING GRADE REMAINING IN PLACE AND FINISHED GRADE. REPLACE STREET STRIPING AND MARKINGS ALTERED OR DESTROYED WITH RETRO-REFLECTIVE PREFORMED THERMOPLASTIC
- PAVEMENT MARKINGS BY CONTRACTOR TO SAME LOCATION AS EXISTING.
- WITHIN ALBUQUERQUE CITY LIMITS, REPLACE ARTERIAL/COLLECTOR AND MAJOR LOCAL ASPHALT PAVEMENT IN ACCORDANCE WITH COA STANDARD SPECIFICATIONS AND STANDARD DRAWING 2465 AND REPLACE RESIDENTIAL PAVEMENT PER STANDARD DRAWING 2405A UNLESS OTHERWISE STATED IN THE DRAWINGS.
- CONTRACTOR IS RESPONSIBLE FOR SITE SOIL MANAGEMENT TO MEET THE R-VALUE REQUIREMENT OF 25 OF THE UPPER TWO (2) FEET OF PAVEMENT SUBGRADE SOIL. WITHIN THE CITY ROW, MAINTAIN THE EXISTING R-VALUE. IF THE R-VALUE OF PAVEMENT MATERIAL FAILS TO MEET THE REQUIRED VALUE BY MORE THAN SIX (6) R-VALUE UNITS, A LABORATORY R-VALUE TEST MAY BE REQUIRED AS DIRECTED BY THE ENGINEER. REMOVE AND REPLACE MATERIAL NOT MEETING THE REQUIRED R-VALUE WITH THE MATERIAL HAVING AT LEAST THE DESIGN R-VALUE OR REDESIGN THE PAVEMENT SECTION. VERIFY CONTRACTOR MATERIALS QUALITY CONTROL THROUGH THE ENGINEER.
- DURING CONSTRUCTION OF NEW WORK, INSTALL ANY TEMPORARY DRAINAGE MEASURES NECESSARY TO SAFELY CONVEY STORM WATER RUNOFF TO EXISTING OUTFALLS. INSTALL SILT FENCES AND SEDIMENT CONTROL MEASURES AS SHOWN IN THE SWPPP. ANY DAMAGES TO PRIVATE PROPERTY OR IMPROVEMENTS CONSTRUCTED BY THE CONTRACTOR RESULTING FROM STORM WATER FLOWS ARE THE RESPONSIBILITY OF THE CONTRACTOR.

#### TRAFFIC NOTES:

- DO NOT OBSTRUCT DRIVEWAYS OR DESIGNATED TRAFFIC LANES WITH OVERNIGHT PARKING OF CONSTRUCTION EQUIPMENT. DO NOT STORE ANY EQUIPMENT OR MATERIAL WITHIN THE PUBLIC RIGHT-OF-WAY.
- COORDINATE WITH THE CITY OF ALBUQUERQUE, AND / OR BERNALILLO COUNTY PUBLIC WORKS, AND / OR CITY OF RIO RANCHO WHICHEVER APPLICABLE CONSTRUCTION COORDINATION DIVISION, PRIOR TO BEGINNING ANY CONSTRUCTION WORK ON OR ADJACENT TO EXISTING STREETS.
- ENSURE THAT BARRICADES AND CONSTRUCTION SIGNING CONFORM TO APPLICABLE SECTIONS OF THE "MANUAL ON UNIFORM TRAFFIC CONTROL DEVICES" (MUTCD), U.S. DEPARTMENT OF TRANSPORTATION, LATEST EDITION.
- CONSECUTIVE MAJOR ARTERIALS MAY NOT HAVE CONCURRENT LANE CLOSURES. WORK AFFECTING ARTERIAL ROADWAYS
- REQUIRES TWENTY FOUR HOUR CONSTRUCTION. EXTEND SUBGRADE PREP ONE FOOT BEYOND THE FREE EDGE OF NEW CURB AND GUTTER AND SIDEWALK.
- PREPARE AND SUBMIT A TRAFFIC CONTROL PLAN FOR REVIEW AND APPROVAL

FOR 2 HOURS. RESTRAIN JOINTS FOR THIS TEST.

MAINTAIN A MINIMUM 10 FOOT HORIZONTAL SEPARATION BETWEEN WATER AND SEWER LINES AND MAINTAIN A MINIMUM OF 18 INCH VERTICAL SEPARATION AT A WATERLINE CROSSING A SEWER LINE. WHERE A WATERLINE PASSES BENEATH OR LESS THAN 18 INCH ABOVE AN EXISTING SEWER LINE, ENCASE THE SEWER LINE IN CONCRETE 6 INCH THICK AS DETAILED IN C.O.A. STD. DWG. 2140, FOR AT LEAST 10 FT. USE D.I. OR GASKETED PRESSURE RATED (MIN PRESSURE RATING 150PSI) PVC PIPE WITH GASKETED PRESSURE TYPE JOINTS FOR AT LEAST 10FT ON EACH SIDE OF THE WATERLINE, OR THE SEWER LINE AND APPLY WHERE A PARALLEL WATERLINE IS LESS THAN 10 FT HORIZONTALLY AND LESS THAN 2 FT ABOVE THE SEWER LINE. HYDROSTATICALLY TEST SEWER LINE TO 150PSI

CPN 771863

## **REDRAWN FOR RECORD PURPOSES**

# RECORD DRAWINGS

THESE RECORD DOCUMENTS HAVE BEEN PREPARED BASED ON INFORMATION PROVIDED BY OTHERS. THEY ARE NOT INTENDED TO REPRESENT IN DETAIL THE EXACT LOCATION. TYPE OF COMPONENT NOR MANNER OF CONSTRUCTION. THE DESIGN PROFESSIONAL HAS NOT VERIFIED THE ACCURACY AND/OR THE COMPLETENESS OF THIS INFORMATION AND SHALL NOT BE RESPONSIBLE FOR ANY ERRORS OR OMISSIONS WHICH MAY BE INCORPORATED HEREIN AS A RESULT.

SCALE: 1 "= DESIGNED BY DRAWN BY: ATTENTION CHECKED BY: 0 1/2" 1' GRAPHIC SCALE THIS BAR MEASURES AT FULL SCALE (ANSI D)

DESIGN TRACKING DATE: **12/2021** M COUTURE DATE: 12/2021 C LAMB E FORD DATE: **12/2021** W CHRISTOFFERSON | DATE: 12/2021 CROSS CHK'D BY: J PETERSON DATE: **12/2021** APPROVED BY: MAPS/RECORDS INFO.

**Jacobs** 3721 RUTLEDGE RD NE, SUITE B-1 ALBUQUERQUE, NM 87109 505-884-5600

SUBMITTED BY:

AS BUILT INFORMATION CONTRACTOR AUI, INC CONSTRUCTION 3/01/2022 BEGIN DATE INSPECTOR'S JACOBS DATE **5/31/2022** ACCEPTANCE BY INSPECTOR'S NAME L KOIKE/V TORRES SUBSTANTIAL COMPLETION DATE 5/31/2022 DRAWINGS 8/2022 JACOBS ALBUQUERQUE, NM. CORRECTED BY

ENGINEER'S SEAL THIS DOCUMENT IS AN ELECTRONIC COPY. ORIGINAL DOCUMENT WAS ISSUED AND SEALED ON 12/17/2021 THE ORIGINAL DOCUMENT IS STORED AT THE OFFICES OF JACOBS WATER AUTHORITY

RAW WATER TRANSMISSION PIPELINE TO INTEL CORPORATION,

CONSTRUCTION PROJECT NO.

ALBUQUERQUE BERNALILLO COUNTY WATER UTILITY AUTHORITY

BID PACKAGE NO. 1 - WESTSIDE BLVD

GENERAL NOTES

2320.03001 AP NO. A-13 G-2

#### **GENERAL NOTES:**

- CONTACT NEW MEXICO ONE CALL, INC., 1-800-321-2537 OR 811, FOR LOCATION OF EXISTING UTILITIES AT LEAST 48 HOURS PRIOR TO EXCAVATION. CONTACT CITY OF ALBUQUERQUE (COA) TRAFFIC ENGINEERING (505-857-8000) FOR LOCATIONS OF TRAFFIC INTERCONNECT WIRING AND OTHER TRAFFIC
- CONSTRUCT WORK DETAILED UNDER THESE DRAWINGS PER THE CONTRACT SPECIFICATIONS FOR THIS PROJECT, IN ACCORDANCE WITH WATER AUTHORITY STANDARD DRAWINGS, AND IN ACCORDANCE WITH COA STANDARD DRAWINGS AND SPECIFICATIONS FOR PUBLIC WORKS CONSTRUCTION
- (CURRENT EDITION). CONTRACT DOCUMENTS FOR THIS PROJECT SUPERSEDE WATER AUTHORITY AND COA DRAWINGS AND SPECIFICATIONS. QUANTITIES SHOWN FOR UNIT PRICE BID ITEMS ARE FOR COMPARISON ONLY. WATER AUTHORITY SHALL BASE PAYMENTS TO CONTRACTOR FOR UNIT PRICE BID ITEMS ON ACTUAL QUANTITIES, DETERMINED AS PROVIDED IN CONTRACT DOCUMENTS.
- KEEP CONSTRUCTION SITE AND OTHER AREAS FREE FROM ACCUMULATIONS OF WASTE MATERIALS, RUBBISH, AND OTHER DEBRIS. CONFORM TO APPLICABLE LAWS AND REGULATIONS WHEN REMOVING AND DISPOSING OF WASTE MATERIALS, RUBBISH, AND OTHER DEBRIS - INCIDENTAL TO CONTRACT.
- DO NOT STORE OR PARK EQUIPMENT IN FRONT OF PRIVATE RESIDENCES OVERNIGHT. MAINTAIN A GRAFFITI-FREE WORK SITE AND PROMPTLY REMOVE GRAFFITI FROM EQUIPMENT (PERMANENT AND TEMPORARY).
- CONTRACTOR IS SOLELY RESPONSIBLE FOR JOB SITE SAFETY, AND FOR KNOWLEDGE AND COMPLIANCE WITH APPLICABLE OSHA STANDARDS -INCIDENTAL
- MAINTAIN TRENCHES IN SAFE CONDITION PROTECTING WORKERS AND PUBLIC. PROTECT TRENCH IN ACCORDANCE WITH OSHA 29 CFR 1926.650 SUBPART P. SLOPE, BRACE, OR SHORE EXCAVATIONS AS REQUIRED BY OSHA REGULATIONS.
- BACKFILL OR PROPERLY FENCE OPEN EXCAVATIONS AT END OF EACH WORKDAY. BACKFILL OPEN EXCAVATIONS WHEN CONTRACTOR WILL NOT BE WORKING AT ON-SITE THE FOLLOWING DAY.
- AN EXCAVATION / CONSTRUCTION PERMIT WILL BE REQUIRED BEFORE BEGINNING WORK WITHIN CITY RIGHT-OF-WAY
- PROVIDE AND MAINTAIN CONSTRUCTION SIGNING UNTIL WATER AUTHORITY AND COA HAVE ACCEPTED THE PROJECT.
- COA NOISE CONTROL ORDINANCE FORBIDS LOUD CONSTRUCTION NOISE BETWEEN THE HOURS OF 10:00 PM AND 7:00 AM.
- 13. DO NOT LOCATE PUMPS OR COMPRESSORS REQUIRED TO RUN FOR THE DURATION OF THE WORK ADJACENT TO RESIDENTIAL PROPERTY; IF UNAVOIDABLE, EMPLOY NOISE ABATEMENT SOLUTIONS.
- 14. NOTIFY COA GEODETIC SURVEY (768-3609) NOT LESS THAN THREE (3) WORKING DAYS PRIOR TO STARTING WORK THAT WILL AFFECT ANY EXISTING GEODETIC SURVEY MONUMENT. REPLACE COA GEODETIC SURVEY, AT CONTRACTOR'S EXPENSE, ACS MONUMENT DAMAGED OR DESTROYED DUE TO FAILURE OF CONTRACTOR TO NOTIFY AS STATED ABOVE.
- 15. NOTIFY ENGINEER NO LESS THAN SEVEN (7) CALENDAR DAYS PRIOR TO STARTING WORK SO THAT THE COA GEODETIC SURVEY MAY TAKE NECESSARY MEASURES TO ENSURE PRESERVATION OF OTHER PERMANENT SURVEY MONUMENTS (NON-ACS). DO NOT DISTURB PERMANENT SURVEY MONUMENTS WITHOUT CONSENT OF THE ENGINEER. EXPENSE OF REPLACING ANY THAT MAY BE DISTURBED WITHOUT PERMISSION IS AT THE EXPENSE OF THE CONTRACTOR. REPLACEMENT MUST BE PERFORMED BY THE COA GEODETIC SURVEY. WHEN A CHANGE IS MADE IN FINISHED ELEVATION OF PAVEMENT OF ROADWAY IN WHICH A PERMANENT SURVEY MONUMENT IS LOCATED, ADJUST MONUMENT COVER TO NEW GRADE, UNLESS OTHERWISE SPECIFIED, AT CONTRACTOR EXPENSE.
- 16. NOTIFY UTILITY OWNERS 48 HOURS IN ADVANCE OF CONSTRUCTION ACTIVITY DISRUPTING UTILITY SERVICE. SUPPORT AND MAINTAIN OPERATIONAL UTILITIES EXPOSED DURING TRENCHING AND OTHER CONSTRUCTION OPERATIONS. COORDINATED WITH UTILITY OWNER PRIOR TO ANY DISTURBANCE INVOLVING GAS, POWER, WATER, FIBER OPTIC, TRAFFIC SIGNAL EQUIPMENT, OR OTHER UTILITY LINES.
- 17. DUE TO INCREASED TRAFFIC VOLUMES EXCAVATION AND/OR BARRICADING PERMITS WILL NOT BE ISSUED FOR WORK AFFECTING HIGH TRAFFIC AREAS BEFORE AND DURING THE STATE FAIR, THE BALLOON FIESTA, AND THE HOLIDAY SHOPPING SEASON. SEE WWW.CABQ.GOV FOR CONSTRUCTION MORATORIUM EFFECTIVE DATES AND MAP OF AREAS. WORK AFFECTING BIKE TRAIL ALONG THE DOMINGO BACA CHANNEL WILL NOT BE ALLOWED DURING BALLOON FIESTA MORATORIUM.

#### CONSTRUCTION NOTES:

- ABIDE BY LOCAL, STATE, AND FEDERAL LAWS, RULES AND REGULATIONS WHICH APPLY TO THE CONSTRUCTION OF THESE IMPROVEMENTS. PRIOR TO CONSTRUCTION, DETERMINE EXACT HORIZONTAL AND VERTICAL LOCATION AND SIZE OF PERTINENT EXISTING UTILITIES AND / OR OBSTRUCTIONS THAT MAY IMPACT THE ALIGNMENT. SHOULD A CONFLICT EXIST, NOTIFY THE ENGINEER SO THE CONFLICT CAN BE RESOLVED WITHOUT A DELAY. COORDINATE RELOCATION OF UTILITY LINES WITH AFFECTED UTILITY COMPANIES AS REQUIRED. MARK EXACT LOCATION OF ENCOUNTERED UTILITIES AND NEW WATERLINE ON AS-BUILT DRAWINGS.
- PROTECT THE EXISTING PUBLIC AND PRIVATE UTILITY LINES WITHIN THE CONSTRUCTION AREA. ANY DAMAGE TO EXISTING FACILITIES CAUSED BY CONSTRUCTION ACTIVITY SHALL BE REPAIRED OR REPLACED AT THE CONTRACTOR'S EXPENSE UNLESS OTHERWISE NOTED ON THE PLANS AND APPROVED BY THE ENGINEER.
- LIMIT CONSTRUCTION ACTIVITY TO THE RIGHTS-OF-WAY AND EASEMENTS, PROPERTY LIMITS AND/OR PROJECT LIMITS OF DISTURBANCE ANY DAMAGE TO ADJACENT PROPERTIES RESULTING FROM THE CONSTRUCTION PROCESS IS THE RESPONSIBILITY OF THE CONTRACTOR ANY COSTS INCURRED FOR REPAIRS SHALL BE THE COST OF THE CONTRACTOR.
- REPLACE PROPERTY CORNERS DESTROYED DURING CONSTRUCTION AT CONTRACTOR'S EXPENSE. RESET PROPERTY CORNER BY A NEW MEXICO REGISTERED PROFESSIONAL SURVEYOR.
- SAWCUT PAVEMENT WITH UNIFORM EDGE AND SPRAY WITH A TACK COAT PRIOR TO PAVEMENT PLACEMENT. PER COA, USE PARALLEL OR ORTHOGONAL PAVEMENT CUTS ONLY. NO DIAGONAL CUTS IN EXISTING PAVEMENT PER COA STD. DWG. 2465, WHEN ABUTTING NEW PAVEMENT TO THE EXISTING INTERSECTING STREETS SAWCUT THE EXISTING PAVEMENT PER COA TO A STRAIGHT LINE AT RIGHT ANGLES AND REMOVE ANY BROKEN OR CRACKED PAVEMENT. SAW CUTTING IS CONSIDERED INCIDENTAL TO PAVING, THEREFORE, NO DIRECT PAYMENT WILL BE MADE FOR SAW CUTTING. CONTACT COA TO REQUEST AN INSPECTOR TO VERIFY PAVEMENT THICKNESS
- 7. WHEN ABUTTING NEW CURB AND GUTTER TO EXISTING PAVEMENT, SAWCUT, REMOVE, AND REPLACE A 1' WIDE SECTION OF EXISTING
- PAVEMENT ADJACENT TO THE CURB AND GUTTER AS PER THE COA STANDARD DRAWING 2465. SUPPORT EXPOSED EXISTING UTILITIES INCLUDING SEWER SERVICE LATERALS SUSPENDED ACROSS OR PARALLEL WITH TRENCH EXCAVATION PROVIDE A SUPPORT PLAN FOR WATER, SANITARY SEWER, AND STORM DRAIN UTILITIES GREATER THAN 16 INCHES, UNLESS OTHERWISE REQUESTED, WHERE THE NEW PIPELINE IS CONSTRUCTED UNDERNEATH THE NEW UTILITY.
- UTILIZE FLOWABLE FILL WHERE NOTED ON PLANS OR WHEREVER BACKFILL MATERIAL CAN NOT BE PLACED AND COMPACTED PER SPECIFICATION BETWEEN THE NEW PIPE LINE AND EXISTING UTILITIES OR IF THE VERTICAL SEPARATION BETWEEN THE NEW PIPE LINE AND EXISTING UTILITY IS LESS THAN 18-INCHES OR IF REQUIRED BY THE DRAWINGS. THIS COST IS INCIDENTAL TO BACKFILL COSTS.
- STRUCTURAL CONCRETE TO BE 4000 PSI UNLESS OTHERWISE NOTED ON PLANS OR SPECIFICATIONS.
- ENCASE BURIED DUCTILE IRON PIPE IN PURPLE POLYETHYLENE SHEETING PER SUPPLEMENTAL SPECIFICATION SECTION 801. 12. LIMIT LENGTH OF OPEN TRENCH TO 40 FEET MAXIMUM. TRENCH TO BE FENCED EVERY NIGHT AND DURING NON-WORKING HOURS.
- CONTRACTOR TO DESIGN, PROVIDE AND INSTALL TEMPORARY SUPPORT FOR EXISTING UTILITIES WHERE CROSSING.
- 14. ALL CONSTRUCTION WORK TO BE IN ACCORDANCE WITH COA STANDARD SPECIFICATIONS 2020 EDITION.

#### WATER NOTES:

- COORDINATE WITH ABCWUA AT LEAST SEVEN (7) WORKING DAYS PRIOR TO WATER VALVE SHUTOFFS. NO ONE WITHOUT WRITTEN PERMISSION OR DIRECT SUPERVISION FROM THE WATER AUTHORITY FIELD DIVISION SUPERVISOR MAY OPERATE VALVE OR FIRE HYDRANT PER STANDARD SPECIFICATION SECTION 18.3. CONTRACTOR IS RESPONSIBLE FOR TIMING AND COORDINATION OF WATER VALVE SUT-OFF/TURN-ON REQUESTS. CONTRACTOR TO SUBMIT AN ELECTRONIC WATER MAIN SHUT-OFF/TURN-ON REQUEST VIA https://www.abcwua.org/info-for-business-water-shut-off-and-turn-on-procedures/ NOTIFY ABCWUA FIELD AND COA FIRE DEPARTMENT AT LEAST SEVEN (7) WORKING DAYS IN ADVANCE OF ANY FIRE HYDRANT TAKEN OUT OF
- AND RETURNED TO SERVICE REFER TO STANDARD SPECIFICATIONS.
- FIELD VERIFY WATERLINE CONNECTIONS TO EXISTING FACILITIES SUFFICIENTLY IN ADVANCE OF CONSTRUCTION TO ALLOW OBTAINING CORRECT ADAPTERS AND OTHER FITTINGS.
- INSTALL NEW WATERLINES AT ENGINEERED HORIZONTAL AND VERTICAL CONTROL SHOWN IN THE PLAN AND PROFILE DRAWINGS. PERFORM SURVEY STAKING A MINIMUM OF EVERY 100 FEET PER COA SPECIFICATION SECTION 4. AVAILABILITY OF LANDS: PHYSICAL CONDITIONS: REFERENCE POINTS.
- PLACE ELECTRONIC MARKER DEVICES (EMD) ACCORDING TO STANDARD SPECIFICATION SECTION 170 INCIDENTAL TO CONTRACT.
- PROVIDE TEMPORARY WATER SERVICE FOR ANY RESIDENCE, SCHOOL, OR BUSINESS THAT WILL BE OUT OF SERVICE MORE THAN FOUR (4) HOURS. SHOEFLY WATERLINE BYPASS IS AN OPTION FOR TEMPORARY SERVICE - INCIDENTAL TO CONSTRUCTION.
- CONTRACTOR IS RESPONSIBLE FOR TIMING AND COORDINATION OF WATER VALVE SUT-OFF/TURN-ON REQUESTS. CONTRACTOR TO SUBMIT AN ELECTRONIC WATER MAIN SHUT-OFF/TURN-ON REQUEST VIA https://www.abcwua.org/info-for-business-water-shut-off-and-turn-on-procedures/. SUBMIT REQUEST FOR WATER SHUT-OFF OR TURN-ON AT LEAST FOURTEEN (14) WORKING DAYS IN ADVANCE FOR MAINS DESIGNATED AS A TRANSMISSION LINE MASTER PLAN LINE, COLLECTOR OR WELL COLLECTOR LINE. REQUESTS MADE AFTER 8:00 A.M. WILL BE LOGGED IN AND SCHEDULED ON THE FOLLOWING WORK DAY AND THE FOURTEEN (14) WORKING DAY REQUIREMENT WILL COMMENCE.

#### SEWER NOTES:

- UNDER NO CIRCUMSTANCE SHALL SEWAGE OR SOLIDS REMOVED FROM MANHOLES BE DISCHARGED ONTO STREETS OR INTO DITCHES, CATCH BASINS, STORM DRAINS, OR SANITARY SEWER MANHOLES, CLEANOUTS, OR DUMPS.
- IF SEWAGE SPILLS ONTO PUBLIC OR PRIVATE PROPERTY, WASH DOWN, CLEAN UP, AND DISINFECT THE SPILLAGE AT THE CONTRACTORS EXPENSE TO THE SATISFACTION OF WATER AUTHORITY AND THE PROPERTY OWNER. SEE SPECIFICATION SECTION 33 01 30.51, SEWAGE FLOW CONTROL.

#### PAVEMENT/DRAINAGE/CITY OF ALBUQUERQUE/RIO RANCHO:

- SUBMIT TO ENGINEER, WATER AUTHORITY, COA AND CITY OF RIO RANCHO CONSTRUCTION COORDINATION DIVISION A DETAILED CONSTRUCTION SCHEDULE SEVEN (7) WORKING DAYS PRIOR TO BEGINNING CONSTRUCTION. OBTAIN BARRICADING AND CONSTRUCTION PERMITS FROM COA AND / OR BERNALILLO COUNTY AND / OR CITY OF RIO RANCHO AS APPROPRIATE TWO (2) WORKING DAYS PRIOR TO CONSTRUCTION. NOTIFY COA CONSTRUCTION SERVICES (505-924-3400) PRIOR TO OCCUPYING AN INTERSECTION.
- DURING CONSTRUCTION, REPAIR OR REPLACE DAMAGE TO EXISTING FACILITIES AND INFRASTRUCTURE INCLUDING UTILITIES, VALVE BOXES, MANHOLES, SEWER SERVICES, PAVEMENTS, PAVEMENT MARKINGS, CURB AND GUTTER, DRIVE PADS, WHEELCHAIR RAMPS, SIDEWALKS AND OTHER EXISTING FEATURES. REPAIR OR REPLACE PER UTILITY AGENCY, COA, WATER AUTHORITY, RIO RANCHO, AND OWNER OF THE INFRASTRUCTURE STANDARDS AT CONTRACTOR'S EXPENSE.
- ANY PAVEMENT, OR CURB AND GUTTER REMOVAL AND REPLACEMENT ASSOCIATED WITH REPLACEMENT OF WATER SERVICE LINES IS INCIDENTAL TO THE SERVICE LINE REPLACEMENT.
- ADJUST WATER VALVE BOXES AND SEWER MANHOLES WITHIN NEW PAVEMENT TO FINISH GRADE PER COA AND ABCWUA STANDARDS.
- RESTORE FINISHED GRADES TO EXISTING GRADES UNLESS OTHERWISE DIRECTED BY ENGINEER. MAKE SMOOTH TRANSITIONS BETWEEN EXISTING GRADE REMAINING IN PLACE AND FINISHED GRADE.
- REPLACE STREET STRIPING AND MARKINGS ALTERED OR DESTROYED WITH RETRO-REFLECTIVE PREFORMED THERMOPLASTIC
- PAVEMENT MARKINGS BY CONTRACTOR TO SAME LOCATION AS EXISTING. WITHIN ALBUQUERQUE CITY LIMITS, REPLACE ARTERIAL/COLLECTOR AND MAJOR LOCAL ASPHALT PAVEMENT IN ACCORDANCE WITH
- COA STANDARD SPECIFICATIONS AND STANDARD DRAWING 2465 AND REPLACE RESIDENTIAL PAVEMENT PER STANDARD DRAWING 2405A UNLESS OTHERWISE STATED IN THE DRAWINGS.
- CONTRACTOR IS RESPONSIBLE FOR SITE SOIL MANAGEMENT TO MEET THE R-VALUE REQUIREMENT OF 25 OF THE UPPER TWO (2) FEET OF PAVEMENT SUBGRADE SOIL. WITHIN THE CITY ROW, MAINTAIN THE EXISTING R-VALUE. IF THE R-VALUE OF PAVEMENT MATERIAL FAILS TO MEET THE REQUIRED VALUE BY MORE THAN SIX (6) R-VALUE UNITS, A LABORATORY R-VALUE TEST MAY BE REQUIRED AS DIRECTED BY THE ENGINEER. REMOVE AND REPLACE MATERIAL NOT MEETING THE REQUIRED R-VALUE WITH THE MATERIAL HAVING AT LEAST THE DESIGN R-VALUE OR REDESIGN THE PAVEMENT SECTION. VERIFY CONTRACTOR MATERIALS QUALITY CONTROL THROUGH THE ENGINEER.
- DURING CONSTRUCTION OF NEW WORK, INSTALL ANY TEMPORARY DRAINAGE MEASURES NECESSARY TO SAFELY CONVEY STORM WATER RUNOFF TO EXISTING OUTFALLS. INSTALL SILT FENCES AND SEDIMENT CONTROL MEASURES AS SHOWN IN THE SWPPP. ANY DAMAGES TO PRIVATE PROPERTY OR IMPROVEMENTS CONSTRUCTED BY THE CONTRACTOR RESULTING FROM STORM WATER FLOWS ARE THE RESPONSIBILITY OF THE CONTRACTOR.

#### TRAFFIC NOTES:

- DO NOT OBSTRUCT DRIVEWAYS OR DESIGNATED TRAFFIC LANES WITH OVERNIGHT PARKING OF CONSTRUCTION EQUIPMENT.
- DO NOT STORE ANY EQUIPMENT OR MATERIAL WITHIN THE PUBLIC RIGHT-OF-WAY. COORDINATE WITH THE CITY OF ALBUQUERQUE, AND / OR BERNALILLO COUNTY PUBLIC WORKS, AND / OR CITY OF RIO RANCHO
- WHICHEVER APPLICABLE CONSTRUCTION COORDINATION DIVISION, PRIOR TO BEGINNING ANY CONSTRUCTION WORK ON OR ADJACENT TO EXISTING STREETS.
- ENSURE THAT BARRICADES AND CONSTRUCTION SIGNING CONFORM TO APPLICABLE SECTIONS OF THE "MANUAL ON UNIFORM TRAFFIC CONTROL DEVICES" (MUTCD), U.S. DEPARTMENT OF TRANSPORTATION, LATEST EDITION.
- CONSECUTIVE MAJOR ARTERIALS MAY NOT HAVE CONCURRENT LANE CLOSURES. WORK AFFECTING ARTERIAL ROADWAYS
- REQUIRES TWENTY FOUR HOUR CONSTRUCTION.
- EXTEND SUBGRADE PREP ONE FOOT BEYOND THE FREE EDGE OF NEW CURB AND GUTTER AND SIDEWALK.
- PREPARE AND SUBMIT A TRAFFIC CONTROL PLAN FOR REVIEW AND APPROVAL.
- MAINTAIN A MINIMUM 10 FOOT HORIZONTAL SEPARATION BETWEEN WATER AND SEWER LINES AND MAINTAIN A MINIMUM OF 18 INCH VERTICAL SEPARATION AT A WATERLINE CROSSING A SEWER LINE. WHERE A WATERLINE PASSES BENEATH OR LESS THAN 18 INCH ABOVE AN EXISTING SEWER LINE, ENCASE THE SEWER LINE IN CONCRETE 6 INCH THICK AS DETAILED IN C.O.A. STD. DWG. 2140, FOR AT LEAST 10 FT. USE D.I. OR GASKETED PRESSURE RATED (MIN PRESSURE RATING 150PSI) PVC PIPE WITH GASKETED PRESSURE TYPE JOINTS FOR AT LEAST 10FT ON EACH SIDE OF THE WATERLINE, OR THE SEWER LINE AND APPLY WHERE A PARALLEL WATERLINE IS LESS THAN 10 FT HORIZONTALLY AND LESS THAN 2 FT ABOVE THE SEWER LINE. HYDROSTATICALLY TEST SEWER LINE TO 150PSI FOR 2 HOURS. RESTRAIN JOINTS FOR THIS TEST.

THIS SHEET SUPERSEDED BY SIMILAR SHEET MARKED "REDRAWN FOR RECORD PURPOSES"



Approved by Albuquerque City Engineer and Design Review Committee, Feb. 10, 2022

CPN 771863

WATER UTILITY AUTHORITY RAW WATER TRANSMISSION PIPELINE TO INTEL CORPORATION, ΓITLE: BID PACKAGE NO. 1 - WESTSIDE BLVD

GENERAL NOTES

ALBUQUERQUE BERNALILLO COUNTY

2320.030XX AND NO. G-2CONSTRUCTION PROJECT NO.

DATE REVISION NO. & DESCRIPTION | BY SCALE: DESIGN TRACKING 1 "= DESIGNED BY M COUTURE 12/17/21 DATE: C LAMB DATE: 12/17/21 DRAWN BY: ATTENTION CHECKED BY: E FORD DATE: 12/17/21 0 1/2" 1 CROSS CHK'D BY: W CHRISTOFFERSON DATE: 12/17/21 J PETERSON GRAPHIC SCALE APPROVED BY: DATE: 12/17/21 THIS BAR MEASURES MAPS/RECORDS INFO. AT FULL SCALE (ANSI D)

**Jacobs** 3721 RUTLEDGE RD NE, SUITE B-1 ALBUQUERQUE, NM 87109 505-884-5600

SUBMITTED BY:

DATE DATE

AS BUILT INFORMATION

CONTRACTOR

BEGIN DATE

INSPECTOR'S

SUBSTANTIAL

DRAWINGS

CONSTRUCTION

ACCEPTANCE BY

CORRECTED BY

INSPECTOR'S NAME --

COMPLETION DATE --

WATER AUTHORITY

#### LEGEND:

#### **EXISTING CIVIL LEGEND**

WATER LINE SANITARY SEWER — SSFM — SANITARY SEWER FORCE MAIN GAS LINE

BURIED ELECTRIC

OVERHEAD ELECTRIC — E-OVH—

BURIED TELEPHONE

CABLE

— FO — UNDERGROUND FIBER OPTIC

— CTV —

STORM DRAIN EASEMENT LINE

FENCE

CURB/EDGE OF ROAD TELEPHONE/ELECTRIC/LIGHT POLE

WATER SERVICE METER

**HYDRANT** 

WATER VALVE WATER MANHOLE

STORM DRAIN MANHOLE

SANITARY SEWER MANHOLE

FIBER OPTIC EQUIPMENT

ELECTRIC EQUIPMENT

TELEPHONE EQUIPMENT

#### CIVIL LEGEND

XXX+XX PIPELINE **WORK LIMITS** TRENCH EXCAVATION LIMITS -----PROPERTY LINE, RIGHT-OF-WAY CAV / VACUUM BREAKER **BLOWOFF** | 🔪 | **BUTTERFLY VALVE** SURVEY CONTROL POINT POTHOLE LOCATION GEOTECH BORING

#### SURVEY QUALITY LEVEL

X IS THE UTILITY AND NO LETTER INDICATES SURVEY QUALITY LEVEL B. THIS LEVEL PROVIDES THE POSITION OF SUBSURFACE UTILITIES WITHING APPROXIMATELY 1 FT **ACCURACY** X IS THE UTILITY AND C IS THE SURVEY QUALITY LEVEL. ——X(C) — THIS LEVEL IS OBTAINED FROM VISIBLE ABOVE GROUND UTILITY FEATURES. X IS THE UTILITY AND D IS THE SURVEY QUALITY LEVEL.

——X(D) — THIS LEVEL IS OBTAINED FROM EXISTING RECORDS AND/OR

ORAL RECOLLECTIONS.

#### PIPE COATING COLOR SCHEDULE

BOLLARDS COMBINATION AIR/VACUUM VALVE VENT PIPE **METERS** RAW WATER PIPING VALVES (EXPOSED)

SAFETY YELLOW BEIGE FACTORY COLOR PURPLE FACTORY COLOR LIGHT BLUE OR DARK BLUE

WATER AUTHORITY

WL

VPI

**ABBREVIATIONS:** AGGREGATE BASE COURSE **APPROX APPROXIMATE BACK OF CURB** BOULEVARD BLVD **BLOW OFF** ВО **BID PACKAGE** BP CAV **COMBINATION AIR VALVE** FRICTION COEFFICIENT CCP **CONCRETE CYLINDER PIPE** CIP CAST IRON PIPE CL CENTERLINE COA CITY OF ALBUQUERQUE CONC CONCRETE DIAMETER DIA **DUCTILE IRON PIPE** DIP DR DWG **DRAWING** EAST ELECTRONIC BALL MARKER EBM EASEMENT LINE EL ELV **ELEVATION** ELECTRIC ELEC **EXST EXISTING** FC FACE OF CURB FT FOOT, FEET GPM **GALLONS PER MINUTE HORIZONTAL** HGL HYDRAULIC GRADE LINE HDPE HIGH DENSITY POLYETHYLENE INV INVERT MAX MAXIMUM MIN MINIMUM **MANHOLE** MH NORTH OD **OUTER DIAMETER** OHE **OVERHEAD ELECTRIC** PCC PORTLAND CEMENT CONCRETE PΕ PLAIN END PΙ POINT OF INFLECTION POB POINT OF BEGINNING POE POINT OF ENDING PP PLAN AND PROFILE PSI POUNDS PER SQUARE INCH PVC POLYVINYL CHLORIDE PIPE RJE RESTRAINED JOINT END (SPIGOT) RCP REINFORCED CONCRETE PIPE RD ROAD RESTRAINED JOINT (BELL) ROW, R/W RIGHT OF WAY RW RAW WATER SOUTH, SLOPE SAS SANITARY SEWER SD STORM DRAIN STA STATION STL STEEL **SWPPP** STORM WATER POLLUTION PREVENTION PLAN TOP TOP OF PIPE TH **TEST HOLE** UNK UNKNOWN VITRIFIED CLAY PIPE VCP

ALBUQUERQUE BERNALILLO COUNTY

WATER UTILITY AUTHORITY

VERTICAL POINT INTERSECTION

**WORK LIMIT** 

# SECTION/DETAIL DESIGNATIONS


SECTION (LETTER) OR DETAIL (NUMERAL) DESIGNATION — XXX-X-XXXX ON DRAWING WHERE **SECTION OR DETAIL IS** DRAWING NUMBER TAKEN: (REPLACED WITH A LINE IF TAKEN AND SHOWN ON DRAWING NUMBER SAME SHEET) WHERE SHOWN

XXX-X-XXXX ON DRAWING WHERE SECTION IS SHOWN: DRAWING NUMBER(S) WHERE TAKEN


XXX-X-XXXX ON DRAWING WHERE SECTION IS SHOWN: DRAWING NUMBER(S) WHERE TAKEN

DRAWING TITLE

ON DRAWING WHERE ONLY A TITLE IS REQUIRED WITH NO REFERENCE (eg: ELEVATIONS)

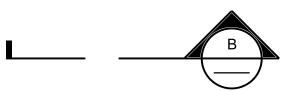


SECTION CALLOUT WHERE SECTION IS ON THE SAME SHEET AND CUT EXTENDS TO A FIXED LIMIT

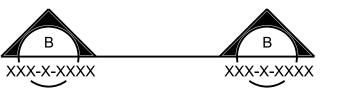

SECTION CALLOUT WHERE SECTION IS ON ANOTHER SHEET AND CUT EXTENDS THROUGHOUT ENTIRE SHEET

KEYNOTE NUMBER

REVISION/ADDENDA NUMBER

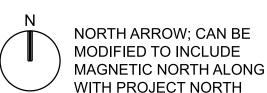

#### **DRAWING IDENTIFICATION SYSTEM**

- SEQUENTIAL NUMBER **TECHNOLOGY** DESIGNATION (SEE BELOW)

TECHNOLOGY DESTINATION		
TECHNOLOGY		
REMOVAL AND RESTORATION		
GENERAL		
PLAN AND PROFILE		
STANDARD DETAILS		

#### **DESIGN DETAIL DESIGNATION:**

- DESIGN DETAIL **DESIGNATION** 1234-567 (NUMERAL) SHOWN ON DESIGN DETAIL DRAWING(S)

ALL DESIGN DETAILS ARE TYPICAL AND MUST BE USED EVEN IF DESIGN DETAIL DESIGNATION IS NOT SHOWN.

THE TERM STANDARD DETAIL, OR A FORM OF IT, IS SYNONYMOUS WITH DESIGN DETAILS. THE DESIGN DETAILS REPRESENT THE CHARACTER AND NATURE OF THE WORK REQUIRED THROUGHOUT THE PROJECT. ALL ASSOCIATED WORK SHALL BE IN ACCORDANCE WITH THE DESIGN DETAILS SHOWN WHETHER THE DETAILS ARE SPECIFICALLY REFERENCED OR NOT.

CPN 771863

# **REDRAWN FOR RECORD PURPOSES**

#### **RECORD DRAWINGS**

THESE RECORD DOCUMENTS HAVE BEEN PREPARED BASED ON INFORMATION PROVIDED BY OTHERS. THEY ARE NOT INTENDED TO REPRESENT IN DETAIL THE EXACT LOCATION. TYPE OF COMPONENT NOR MANNER OF CONSTRUCTION. THE DESIGN PROFESSIONAL HAS NOT VERIFIED THE ACCURACY AND/OR THE COMPLETENESS OF THIS INFORMATION AND SHALL NOT BE RESPONSIBLE FOR ANY ERRORS OR OMISSIONS WHICH MAY BE INCORPORATED HEREIN AS A RESULT.

1"= ATTENTION 0 1/2" 1" GRAPHIC SCALE THIS BAR MEASURES AT FULL SCALE (ANSI D)

SCALE:

DESIGN TRACKING DATE: **12/2021** DESIGNED BY M COUTURE DATE: **12/2021** DRAWN BY: M MONAHAN CHECKED BY: E FORD DATE: **12/2021** W CHRISTOFFERSON | DATE: 12/2021 CROSS CHK'D BY: J PETERSON DATE: **12/2021** APPROVED BY: MAPS/RECORDS INFO.

Jacobs

SUBMITTED BY:

3721 RUTLEDGE RD NE, SUITE B-1 ALBUQUERQUE, NM 87109 505-884-5600

AS BUILT INFORMATION CONTRACTOR AUI, INC CONSTRUCTION 3/01/2022 BEGIN DATE INSPECTOR'S ACCEPTANCE BY JACOBS DATE **5/31/2022** INSPECTOR'S NAME L KOIKE/V TORRES SUBSTANTIAL 5/31/2022 SUBSTANTIAL

JACOBS

DRAWINGS

CORRECTED BY

ENGINEER'S SEAL THIS DOCUMENT IS AN ELECTRONIC COPY. ORIGINAL DOCUMENT WAS ISSUED AND SEALED ON 12/17/2021. THE ORIGINAL DOCUMENT IS STORED AT THE WATER AUTHORITY OFFICES OF JACOBS ALBUQUERQUE, NM.

ALBUQUERQUE BERNALILLO COUNTY WATER UTILITY AUTHORITY

RAW WATER TRANSMISSION PIPELINE TO INTEL CORPORATION BID PACKAGE NO. 1 - WESTSIDE BLVD

LEGEND AND ABBREVIATIONS

WATER AUTHORITY 2320.03001 ZONE A-12 CONSTRUCTION PROJECT NO. 2320.03001 MAP NO. A-13 G-3

## LEGEND:

#### EXISTING CIVIL LEGEND

_,	
W	WATER LINE
	SANITARY SEWER
	SANITARY SEWER FORCE MAIN
G	GAS LINE
E-OVH	OVERHEAD ELECTRIC
—— E ——	BURIED ELECTRIC
— т —	BURIED TELEPHONE
— CTV —	CABLE
— FO —	UNDERGROUND FIBER OPTIC
— SD —	STORM DRAIN
— EL — –	EASEMENT LINE
- • •	FENCE
	CURB/EDGE OF ROAD
<del>-</del>	TELEPHONE/ELECTRIC/LIGHT POLI
	WATER SERVICE METER
	HYDRANT
W	WATER VALVE
W	WATER MANHOLE
SD	STORM DRAIN MANHOLE
SS	SANITARY SEWER MANHOLE
PB FO	FIBER OPTIC EQUIPMENT
E	ELECTRIC EQUIPMENT
TV	TELEPHONE EQUIPMENT

#### CIVIL LEGEND

PIPELINE
WORK LIMITS
TRENCH EXCAVATION LIMITS
PROPERTY LINE, RIGHT-OF-WAY
CAV
BLOWOFF
SURVEY CONTROL POINT
POTHOLE LOCATION
GEOTECH BORING

#### **QUALITY LEVEL**

XXX	XXX IS THE UTILITY AND NO LETTER INDICATES SURVEY
	QUALITY LEVEL B. THIS LEVEL PROVIDES THE POSITION
	OF SUBSURFACE UTILITIES WITHING APPROXIMATELY 1 FT
	ACCURACY

XXX(C) XXX IS THE UTILITY AND C IS THE SURVEY QUALITY LEVEL THIS LEVEL IS OBTAINED FROM VISIBLE ABOVE GROUND UTILITY FEATURES.

XXX IS THE UTILITY AND D IS THE SURVEY QUALITY LEVEL THIS LEVEL IS OBTAINED FROM EXISTING RECORDS AND/OR ORAL RECOLLECTIONS.

#### ABBREVIATIONS:


ABC	AGGREGATE BASE COURSE
APPROX	APPROXIMATE
BLVD	BOULEVARD
30	BLOW OFF
BP	BID PACKAGE
	FRICTION COEFFICIENT
CAV	COMBINATION AIR VALVE
COA	CITY OF ALBUQUERQUE
CIP	CAST IRON PIPE
CL	CENTERLINE
CCP	CONCRETE CYLINDER PIPE
DIA	DIAMETER
OIP	DUCTILE IRON PIPE
DR	DRIVE
DWG	DRAWING
	EAST
EBM	ELECTRONIC BALL MARKER
ĒL .	EASEMENT LINE
ELV	ELEVATION
EXST	EXISTING
₹T	FOOT, FEET
GPM	GALLONS PER MINUTE
HGL	HYDRAULIC GRADE LINE
HDPE	HIGH DENSITY POLYETHYLENE
NV	INVERT
MAX	MAXIMUM
MIN	MINIMUM
<b>Л</b> Н	MANHOLE
N	NORTH
OD .	OUTER DIAMETER
DHE	OVERHEAD ELECTRIC
인	POINT OF INFLECTION
РОВ	POINT OF BEGINNING
POE	POINT OF ENDING
PP	PLAN AND PROFILE
PSI	POUNDS PER SQUARE INCH
PVC	POLYVINYL CHLORIDE PIPE
	. SELVINIE SHESHIDE LILE

RCP REINFORCED CONCRETE PIPE RD REINFORCED JOINT ROW, R/W RIGHT OF WAY RW RAW WATER SOUTH SAS SANITARY SEWER SD STORM DRAIN STA STATION STL STEEL TEST HOLE UNK UNKNOWN VCP VITRIFIED CLAY PIPE WATER AUTHORITY ALBUQUERQUE BERNALILLO COUNTY WATER UTILITY AUTHORITY WL WORK LIMIT VPI VERTICAL POINT INTERSECTION

> THIS SHEET SUPERSEDED BY SIMILAR SHEET MARKED



Approved by Albuquerque City Engineer and Design Review Committee, Feb. 10, 2022 CPN 771863

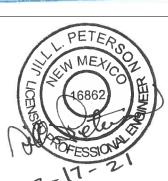

ALBUQUERQUE BERNALILLO COUNTY WATER UTILITY AUTHORITY

TITLE: RAW WATER TRANSMISSION PIPELINE TO INTEL CORPORATION BID PACKAGE NO. 1 - WESTSIDE BLVD

LEGEND AND ABBREVIATIONS

water authority construction project no. 2320.030XX MAP NO.

"REDRAWN FOR RECORD PURPOSES"

		DESIGN TRACKIN	G	
	DESIGNED BY:	M COUTURE	DATE:	12/17/21
	DRAWN BY:	M MONAHAN	DATE:	12/17/21
	CHECKED BY:	E FORD	DATE:	12/17/21
	CROSS CHK'D BY:	W CHRISTOFFERSON	DATE:	12/17/21
	APPROVED BY:	J PETERSON	DATE:	12/17/21
1"	М	APS/RECORDS IN	FO.	

**Jacobs** 3721 RUTLEDGE RD NE, SUITE B-1 ALBUQUERQUE, NM 87109 505-884-5600

SUBMITTED BY:

AS BUILT INFORMATION

			SUF	RVEY CONTROL TA	BLE SEE NOTE 2		
Point:	Latitude(Global)	Longitude(Global)	Height(Global)	Project Northing:	Project Easting:	Elevation:	Description:
							City of Albuquerque aluminum survey control 3.25" cap
2_B8	N35°11'40.28"	W106°44'48.25"	5477.82	1526963.32	1492502.35	5548.12	set in a concrete post 0.10 below back of walk, stamped
							"2-B8 2007".
							City of Albuquerque aluminum survey control 3.25" disc
9_A11	N35°12'47.69"	W106°41'53.17"	5231.57	1533711.81	1507067.90	5301.65	set in a concrete post projecting 0.20 above ground
							stamped "9-A11 2006".
601	N35°13'04.53"	W106°39'39.28"	5152.09	1535366.62	1518187.98	5221.98	1" Copper Plug "JACOBS 601"
602	N35°12'24.98"	W106°43'40.09"	5335.38	1531456.45	1498183.01	5405.57	1" Copper Plug "JACOBS 602"
603	N35°12'22.31"	W106°43'39.15"	5337.23	1531185.75	1498259.57	5407.42	1" Copper Plug "JACOBS 603"
604	N35°12'46.29"	W106°43'07.90"	5304.64	1533598.41	1500865.19	5374.77	2.25" Aluminum Cap "JACOBS 604"
605	N35°12'46.33"	W106°43'12.89"	5311.35	1533604.13	1500451.08	5381.49	1" Copper Plug "JACOBS 605"
651	N35°13'03.74"	W106°41'47.02"	5214.30	1535332.26	1507585.63	5284.34	Photo I.D. / TIP OF BIKE LANE ARROW
652	N35°13'04.07"	W106°41'26.20"	5163.43	1535357.55	1509313.66	5233.44	Photo I.D. / WATER VALVE
653	N35°13'03.95"	W106°41'16.88"	5155.83	1535342.48	1510087.64	5225.83	Photo I.D. / CORNER OF CONC PAN
654	N35°13'07.53"	W106°41'08.61"	5149.12	1535701.28	1510775.52	5219.10	Photo I.D. / TIP OF BIKE LANE ARROW
655	N35°13'03.41"	W106°40'57.67"	5131.24	1535281.24	1511681.90	5201.21	Photo I.D. / TIP OF BIKE LANE ARROW
656	N35°13'03.45"	W106°40'45.36"	5118.12	1535279.96	1512702.97	5188.07	Photo I.D. / TIP OF BIKE LANE ARROW
657	N35°13'03.34"	W106°40'17.61"	5141.59	1535259.59	1515006.64	5211.48	Photo I.D. / SDMH
658	N35°13'03.55"	W106°39'53.05"	5150.38	1535271.64	1517044.95	5220.22	Photo I.D. / TIP OF BIKE LANE ARROW
659	N35°13'03.93"	W106°39'41.39"	5145.91	1535306.55	1518012.20	5215.72	Photo I.D. / TIP OF LEFTMOST TURN LANE ARROW

Project coordinates are modified New Mexico State Plane Centeral Zone (3002) NAD83(2011) coordinates. Elevations are based on the North American vertical datum of 1988

Coordinate System: (NAVD88) and derived from the city of Albuquerque published vertical control monuments 9\_A11 and 2\_B8

Scale Factor: The combined elevation/scale factor used to modify the coordinates from state plane to project coordinates is 1.0003298123

Truncation: The project is scaled from 0,0 and no truncation was performed


Modified state plane scale factor was derived from the reciprocal of the combined factor for City of Albuquerque control point 9\_A11. Modified State Plane:


Horizontal positions for Primary control points 2\_B8 and 601 were established with a redundant static GPS survey completed over two separate days Horizontal positions:

Project elevations are based on City of Albuquerque Control point 9\_A11's published Orthometric height of 5301.647. Project elevations are GPS derived from 9\_A11 using Geoid Basis of elevations:

U.S. Survey Feet

POTHOLE TABLE										
TEST HOLE #	UTILITY	SIZE	UTIL. MAT.	SURVEY PT#	NORTHING	EASTING	ELEV. (GROUND)	MARKER DESCRIPTION	DEPTH	ELEV. (TOP/UTILITY)
TH-01	ELECTRIC	0.33'	PVC	9528	1535271.84	1513265.13	5190.03	TH0-1 Nail / Disc	5.09'	5184.94
TH-02	WATER	1.00'	PVC	9529	1535254.43	1513336.92	5188.92	TH-02 Nail / Disc	5.30'	5183.62
TH-03	ELECTRIC	0.33' & 0.20'	PVC	9530	1535280.53	1513427.20	5191.51	TH-03 Nail / Disc	2.56'	5188.95
TH-04	WATER	1.50'	DUCTILE IRON	9531	1535291.94	1513585.96	5193.49	TH-04 Nail / Disc	4.85'	5188.64
TH-05	WATER	0.50'	PVC	9532	1535280.97	1514540.62	5210.59	TH-05 Nail / Disc	5.90'	5204.69
TH-06	WATER	0.50'	PVC	9533	1535278.41	1514830.58	5212.28	TH-06 Nail / Disc	6.40'	5205.88
TH-07	FO & TEL	0.15' & 0.10'	POLY & D.B.C.	9534	1535265.50	1514983.26	5211.48	TH-07 Nail / Disc	3.89'	5207.59
TH-08	WATER	1.00'	PVC	9535	1535274.78	1514990.34	5211.34	TH-08 Nail / Disc	5.09'	5206.25
TH-10	WATER	1.50'	DUCTILE IRON	9536	1535285.54	1516769.89	5225.29	TH-10 Nail / Disc	5.21'	5220.08
TH-11	FO & TEL	0.15' & 1.10'	POLY & D.B.C.	9537	1535268.38	1516979.07	5221.47	TH-11 CHISELED 'X'	6.95'	5214.52
TH-12	WATER	0.83'	PVC	9538	1535271.49	1516977.53	5221.79	TH-12 Nail / Disc	4.30'	5217.49
TH-13	GAS	0.20'	POLY	9539	1535274.28	1517019.24	5220.91	TH-13 Nail / Disc	3.43'	5217.48
TH-14	WATER	1.50'	DUCTILE IRON	10281	1535279.17	1517508.20	5212.58	TH 14 Nail / Disc	5.70'	5206.88
TH-15	ELECTRIC	0.30' & 0.20'	PVC	9523	1535292.58	1517597.62	5213.00	TH-15 Nail / Disc	3.13'	5209.87
TH-16	FIBER	0.33' (X8)	PVC	10282	1535273.87	1517591.92	5212.53	TH 16 Nail / Disc	6.09'	5206.44
TH-16A	STORM	2.00'	CONCRETE	10282	1535273.87	1517591.92	5212.53	TH 16 Nail / Disc	2.80'	5209.73
TH-17	FO DUCT	1.50'	CONCRETE	9524	1535296.95	1517793.19	5213.68	TH-17 Nail / Disc	4.10'	5209.58
TH-18	GAS	0.50'	STEEL	9525	1535298.50	1517811.78	5213.39	TH-18 Nail / Disc	5.10'	5208.29
TH-19	ELECTRIC	0.33' (X2 & 0.20' (X3)	PVC	9526	1535298.05	1517825.66	5213.34	TH-19 & 21 Nail / Disc	2.96'	5210.38
TH-20	FIBER OPTIC	0.33'	CONDUIT	9527	1535298.05	1517821.22	5213.37	TH-20 Nail / Disc	4.02'	5209.35
TH-22	T.U.N.F.	N/A	N/A	10283	1535289.07	1517840.51	5213.07	TH 22 DRY HOLE	N/A	N/A
TH-2002	FIBER	0.15'	CONDUIT	2845	1535287.87	1518155.66	5219.09	TH-2002 CHISELED 'X'	3.96'	5215.13
TH-2003	FIBER	0.15'	CONDUIT	2844	1535304.84	1518205.08	5221.31	TH-2003 REBAR / CAP	3.65'	5217.66
TH-2004	ELECTRIC	0.50'	PVC	2843	1535346.59	1518229.35	5222.01	TH-2004 REBAR / CAP	5.81'	5216.20
TH-2005	T.U.N.F.	N/A	N/A	N/A	N/A	N/A	N/A	N/A	N/A	N/A
TH-2006	ELECTRIC	0.20' (x2)	PVC	2804	1535361.27	1518296.07	5219.53	TH-2006 REBAR / CAP	3.54'	5215.99
TH-2007	GAS	0.20'	WRAPPED STEEL	2805	1535360.58	1518294.82	5219.46	TH-2007 REBAR / CAP	3.75'	5215.71
TH-2008	GAS	0.67'	WRAPPED STEEL	71509	1535423.69	1518431.14	5217.23	TH 2008 Nail / Disc	4.15'	5213.08
TH-2009	ELECTRIC	0.15'	PVC	71508	1535414.07	1518430.84	5217.32	TH 2009 Nail / Disc	1.94'	5215.38

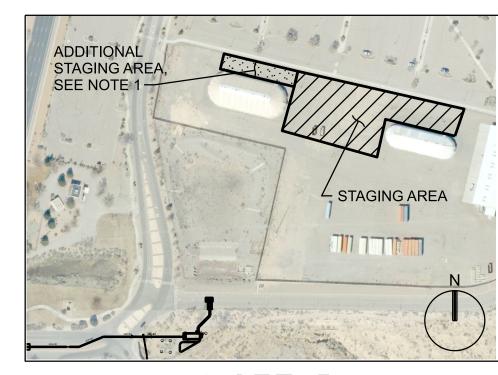

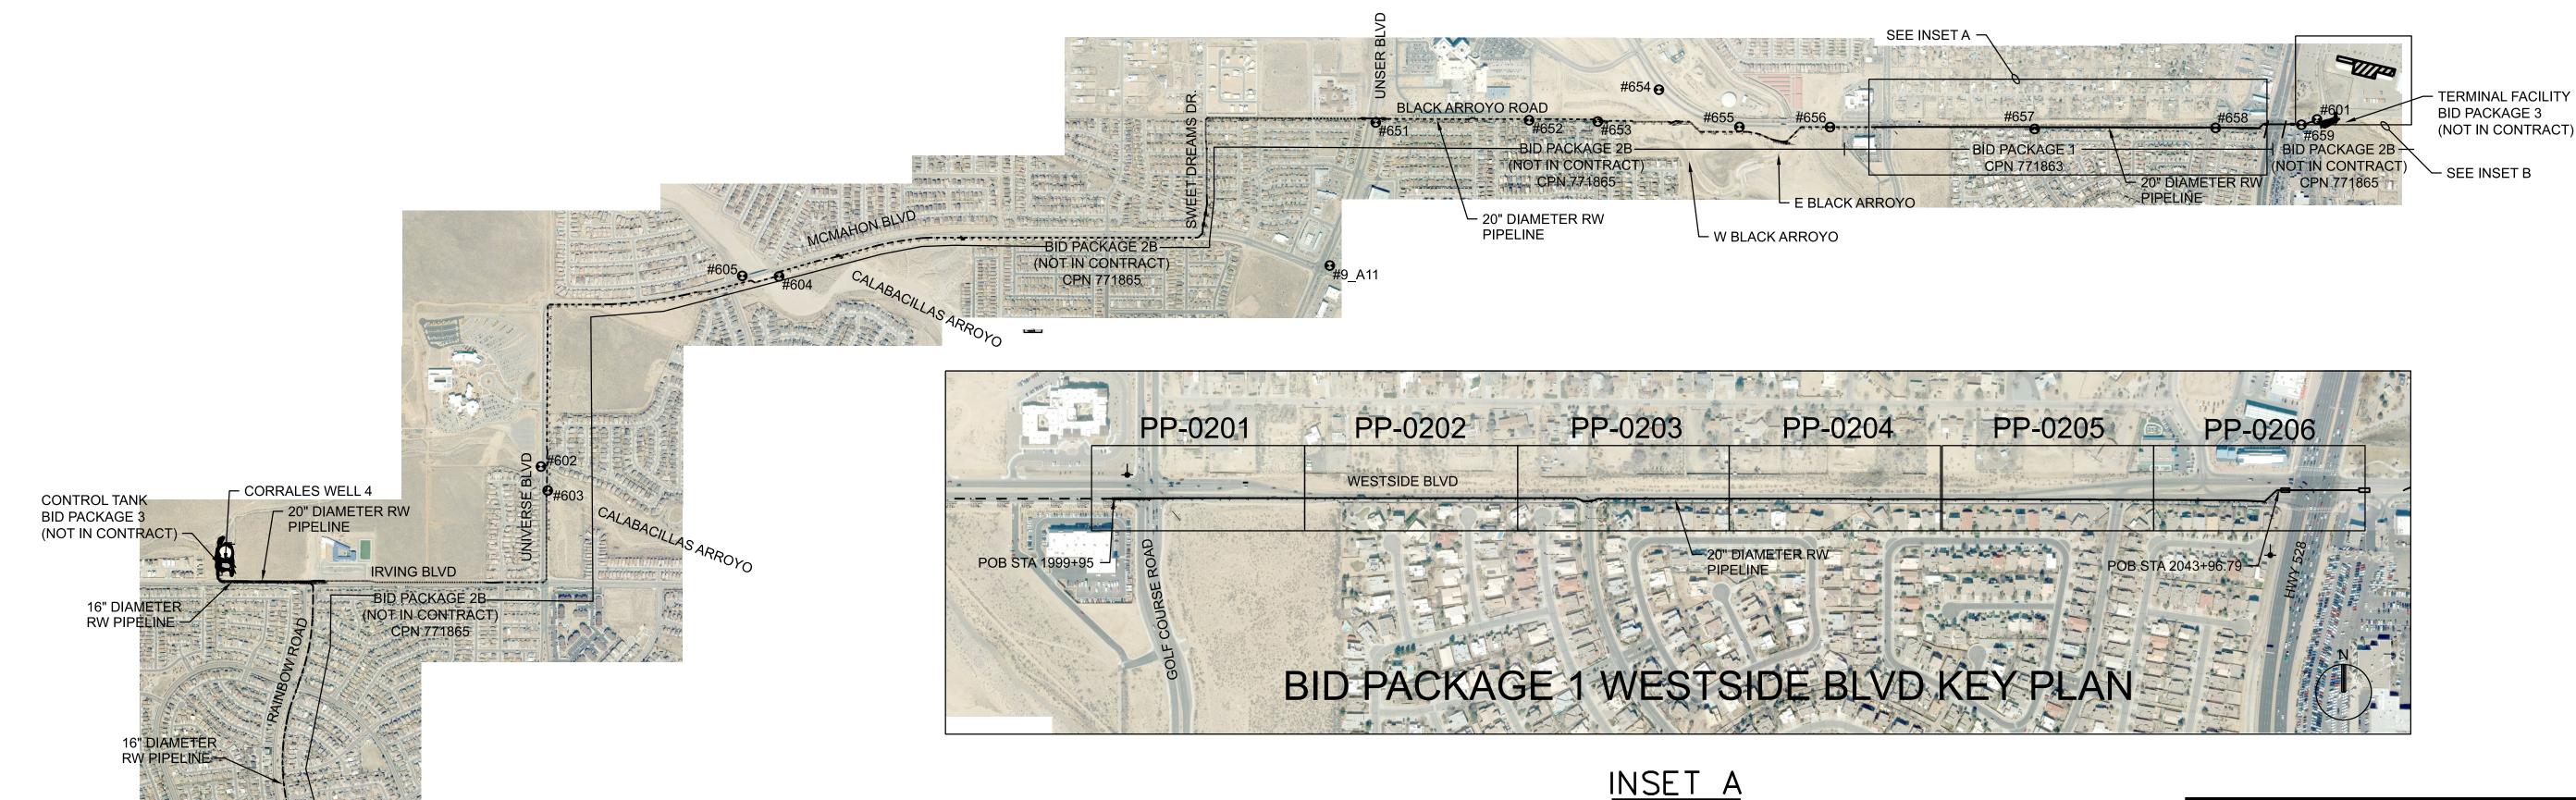

NOTES:


- OWNER APPROVAL IS REQUIRED TO ACCESS ADDITIONAL STAGING AREA
- COA GEODETIC CONTROL MONUMENTS ARE THE BASELINE FOR SURVEY CONTROL SEE https://www.cabq.gov/gis/map-views/geodetic-control

SURVEY CONTROL POINT

**EXST WATER AUTHORITY HYDRANT** 

ALIGNMENT NOT IN PACKAGE

# **REDRAWN FOR RECORD PURPOSES**

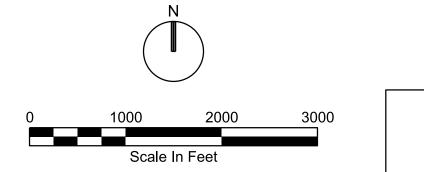

CPN 771863

# **RECORD DRAWINGS**

THESE RECORD DOCUMENTS HAVE BEEN PREPARED BASED ON INFORMATION PROVIDED BY OTHERS. THEY ARE NOT INTENDED TO REPRESENT IN DETAIL THE EXACT LOCATION. TYPE OF COMPONENT NOR MANNER OF CONSTRUCTION. THE DESIGN PROFESSIONAL HAS NOT VERIFIED THE ACCURACY AND/OR THE COMPLETENESS OF THIS INFORMATION AND SHALL NOT BE RESPONSIBLE FOR ANY ERRORS OR OMISSIONS WHICH MAY BE INCORPORATED HEREIN AS A RESULT.

1"= ATTENTION 0 1/2" 1 GRAPHIC SCALE THIS BAR MEASURES AT FULL SCALE (ANSI D)

SCALE:

BID PACKAGE 2A (NOT IN CONTRACT)

> DESIGN TRACKING DATE: **12/2021** DESIGNED BY A ARNING C LAMB DATE: **12/2021** DRAWN BY: DATE: **12/2021** CHECKED BY: E FORD W CHRISTOFFERSON DATE: 12/2021 CROSS CHK'D BY: DATE: 12/2021 APPROVED BY: J PETERSON MAPS/RECORDS INFO.

BID PACKAGE 2A

(NOT IN CONTRACT)

CPN 771864

Jacobs

SUBMITTED BY:

3721 RUTLEDGE RD NE, SUITE B-1 ALBUQUERQUE, NM 87109 505-884-5600

AS BUILT INFORMATION	EN
CONTRACTOR AUI, INC	THIS
CONSTRUCTION 3/01/2022 BEGIN DATE	ELE ORIO
INSPECTOR'S ACCEPTANCE BY JACOBS DATE 5/31/2022	W. SEAL
INSPECTOR'S NAME L KOIKE/V TORRES	<u> </u>
SUBSTANTIAL 5/31/2022	IS
DRAWINGS CORRECTED BY JACOBS DATE 8/2022	OFF ALE

NGINEER'S SEAL S DOCUMENT IS AN ECTRONIC COPY. **IGINAL DOCUMENT** WAS ISSUED AND ALED ON 12/17/2021

001-G-4.dgn

THE ORIGINAL DOCUMENT
IS STORED AT THE
OFFICES OF JACOBS
ALBUQUERQUE, NM.

ALBUQUERQUE BERNALILLO COUNTY WATER UTILITY AUTHORITY

RAW WATER TRANSMISSION PIPELINE TO INTEL CORPORATION, BID PACKAGE NO. 1 - WESTSIDE BLVD

KEY PLAN, SURVEY CONTROL AND STAGING AREA

WATER AUTHORITY ZONE A-12 & MAP NO. A-13 G-4

			SUF	RVEY CONTROL TA	BLE SEE NOTE 2	•	
Point:	Latitude(Global)	Longitude(Global)	Height(Global)	Project Northing:	Project Easting:	Elevation:	Description:
2_B8	N35°11'40.28"	W106°44'48.25"	5477.82	1526963.32	1492502.35	5548.12	City of Albuquerque aluminum survey control 3.25" ca set in a concrete post 0.10 below back of walk, stampe "2-B8 2007".
9_A11	N35°12'47.69"	W106°41'53.17"	5231.57	1533711.81	1507067.90	5301.65	City of Albuquerque aluminum survey control 3.25" disset in a concrete post projecting 0.20 above ground stamped "9-A11 2006".
601	N35°13'04.53"	W106°39'39.28"	5152.09	1535366.62	1518187.98	5221.98	1" Copper Plug "JACOBS 601"
602	N35°12'24.98"	W106°43'40.09"	5335.38	1531456.45	1498183.01	5405.57	1" Copper Plug "JACOBS 602"
603	N35°12'22.31"	W106°43'39.15"	5337.23	1531185.75	1498259.57	5407.42	1" Copper Plug "JACOBS 603"
604	N35°12'46.29"	W106°43'07.90"	5304.64	1533598.41	1500865.19	5374.77	2.25" Aluminum Cap "JACOBS 604"
605	N35°12'46.33"	W106°43'12.89"	5311.35	1533604.13	1500451.08	5381.49	1" Copper Plug "JACOBS 605"
651	N35°13'03.74"	W106°41'47.02"	5214.30	1535332.26	1507585.63	5284.34	Photo I.D. / TIP OF BIKE LANE ARROW
652	N35°13'04.07"	W106°41'26.20"	5163.43	1535357.55	1509313.66	5233.44	Photo I.D. / WATER VALVE
653	N35°13'03.95"	W106°41'16.88"	5155.83	1535342.48	1510087.64	5225.83	Photo I.D. / CORNER OF CONC PAN
654	N35°13'07.53"	W106°41'08.61"	5149.12	1535701.28	1510775.52	5219.10	Photo I.D. / TIP OF BIKE LANE ARROW
655	N35°13'03.41"	W106°40'57.67"	5131.24	1535281.24	1511681.90	5201.21	Photo I.D. / TIP OF BIKE LANE ARROW
656	N35°13'03.45"	W106°40'45.36"	5118.12	1535279.96	1512702.97	5188.07	Photo I.D. / TIP OF BIKE LANE ARROW
657	N35°13'03.34"	W106°40'17.61"	5141.59	1535259.59	1515006.64	5211.48	Photo I.D. / SDMH
658	N35°13'03.55"	W106°39'53.05"	5150.38	1535271.64	1517044.95	5220.22	Photo I.D. / TIP OF BIKE LANE ARROW
659	N35°13'03.93"	W106°39'41.39"	5145.91	1535306.55	1518012.20	5215.72	Photo I.D. / TIP OF LEFTMOST TURN LANE ARROW

Project coordinates are modified New Mexico State Plane Centeral Zone (3002) NAD83(2011) coordinates. Elevations are based on the North American vertical datum of 1988

Coordinate System: (NAVD88) and derived from the city of Albuquerque published vertical control monuments 9\_A11 and 2\_B8

Scale Factor: The combined elevation/scale factor used to modify the coordinates from state plane to project coordinates is 1.0003298123

Truncation: The project is scaled from 0,0 and no truncation was performed

Modified State Plane: Modified state plane scale factor was derived from the reciprocal of the combined factor for City of Albuquerque control point 9\_A11.

Horizontal positions: Horizontal positions for Primary control points 2\_B8 and 601 were established with a redundant static GPS survey completed over two separate days

BID PACKAGE 2A (NOT IN CONTRACT)

PIEDRAS MARCADAS ARROYO


Basis of elevations:

Project elevations are GPS derived from 9\_A11 using Geoid Model 18.

Project elevations are GPS derived from 9\_A11 using Geoid Model 18.


Units: U.S. Survey Feet

**⊖**#2 B8

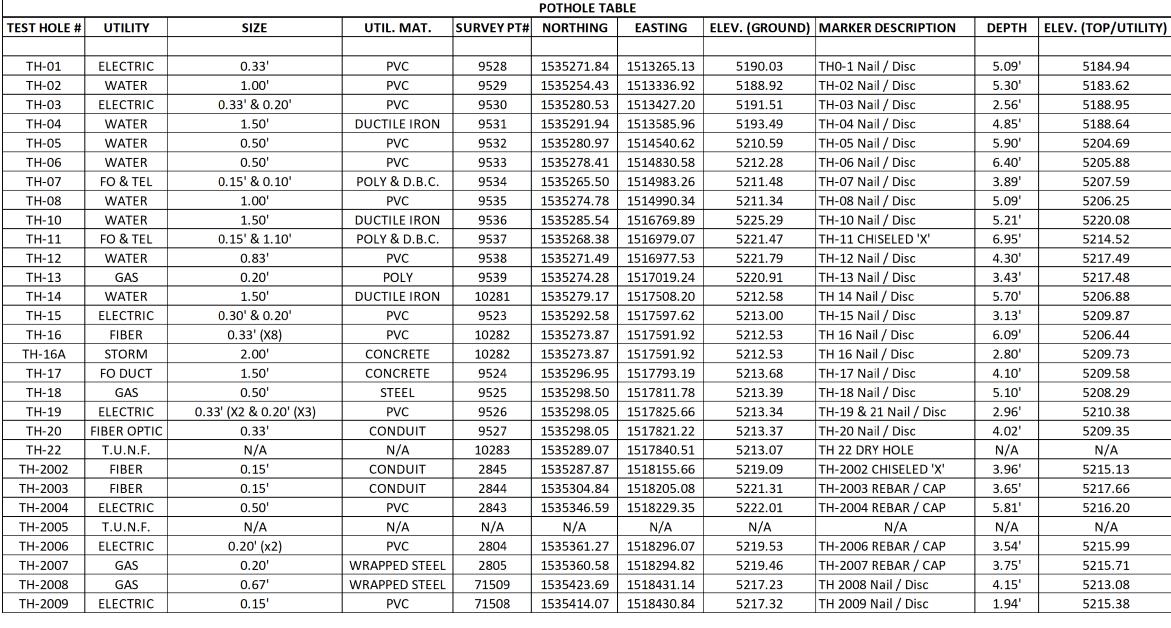



INSET

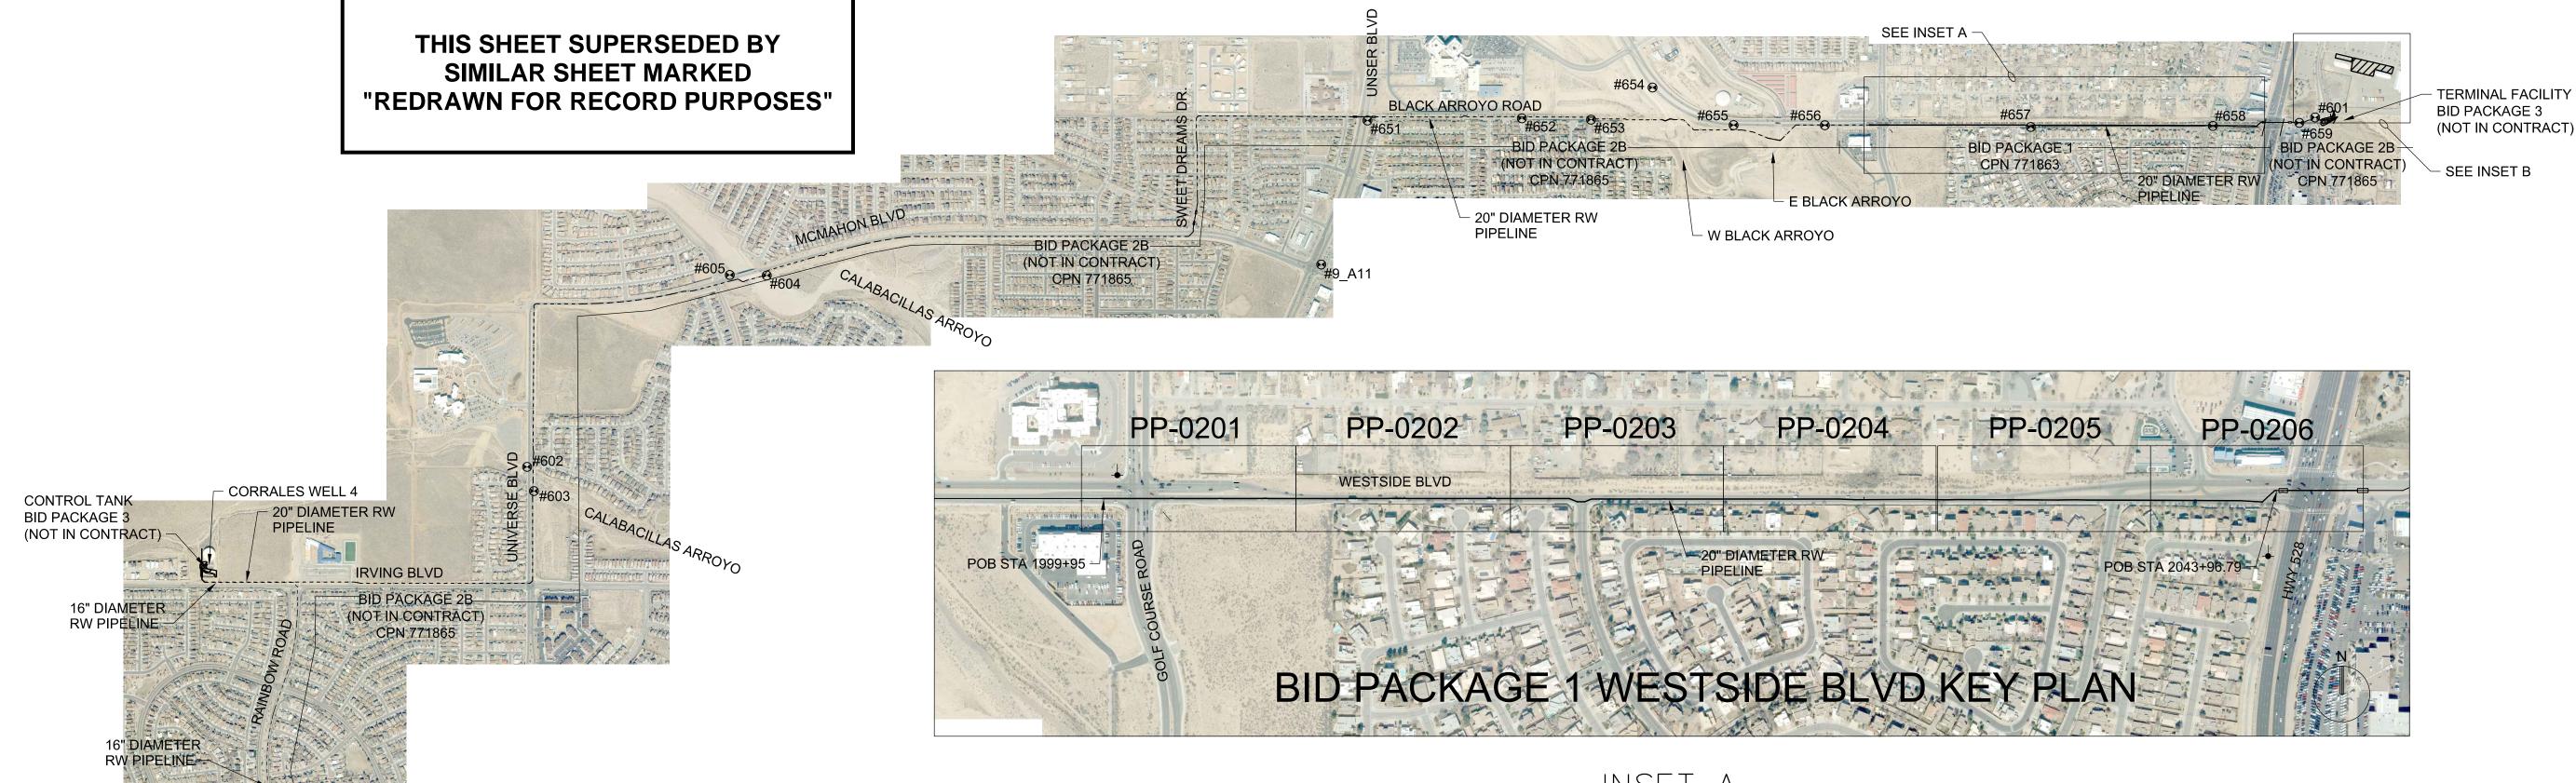

NOTES:

- 1. OWNER APPROVAL IS REQUIRED TO ACCESS ADDITIONAL STAGING AREA.
- COA GEODETIC CONTROL MONUMENTS ARE THE BASELINE FOR SURVEY CONTROL SEE. https://www.cabq.gov/gis/map-views/geodetic-control

INSET A


LEGEND:

SURVEY CONTROL POINT

**↓** EXST WATER AUTHORITY HYDRANT

— — ALIGNMENT NOT IN PACKAGE



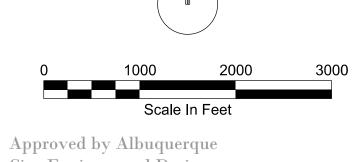

Approved by Albuquerque
City Engineer and Design
Review Committee, Feb. 10, 2022
CPN 771863

NO.	DATE	REVISION NO. & DESCRIPTION	BY	SCALE:
				1"=
				ATTENTION
				0 1/2" 1"
				GRAPHIC SCALE
				THIS BAR MEASURES 1"

SCALE:		DESIGN TRACKING	G	
1 "=	DESIGNED BY:	A ARNING	DATE:	12/17/21
ATTENTION	DRAWN BY:	C LAMB	DATE:	12/17/21
0 1/2" 1"	CHECKED BY:	E FORD	DATE:	12/17/21
	CROSS CHK'D BY:	W CHRISTOFFERSON	DATE:	12/17/21
GRAPHIC SCALE	APPROVED BY:	J PETERSON	DATE:	12/17/21
THIS BAR MEASURES 1" AT FULL SCALE (ANSI D)	M	APS/RECORDS IN	FO.	

BID PACKAGE 2A CPN 771864 (NOT IN CONTRACT)

Jacobs

SUBMITTED BY:

3721 RUTLEDGE RD NE, SUITE B-1 ALBUQUERQUE, NM 87109 505-884-5600

AS BUILT INFORMATION	
CONTRACTOR ——	
CONSTRUCTION BEGIN DATE	
INSPECTOR'S DATE	
INSPECTOR'S NAME	6
SUBSTANTIAL COMPLETION DATE	1 6
DRAWINGS DATE	,



001-G-4.dgn


ALBUQUERQUE BERNALILLO COUNTY
WATER UTILITY AUTHORITY

TITLE: RAW WATER TRANSMISSION PIPELINE TO INTEL CORPORATION,

BID PACKAGE NO. 1 - WESTSIDE BLVD

KEY PLAN, SURVEY CONTROL AND STAGING AREA

WATER AUTHORITY CONSTRUCTION PROJECT NO. 2320.030XX MAP NO. SHEET G-4

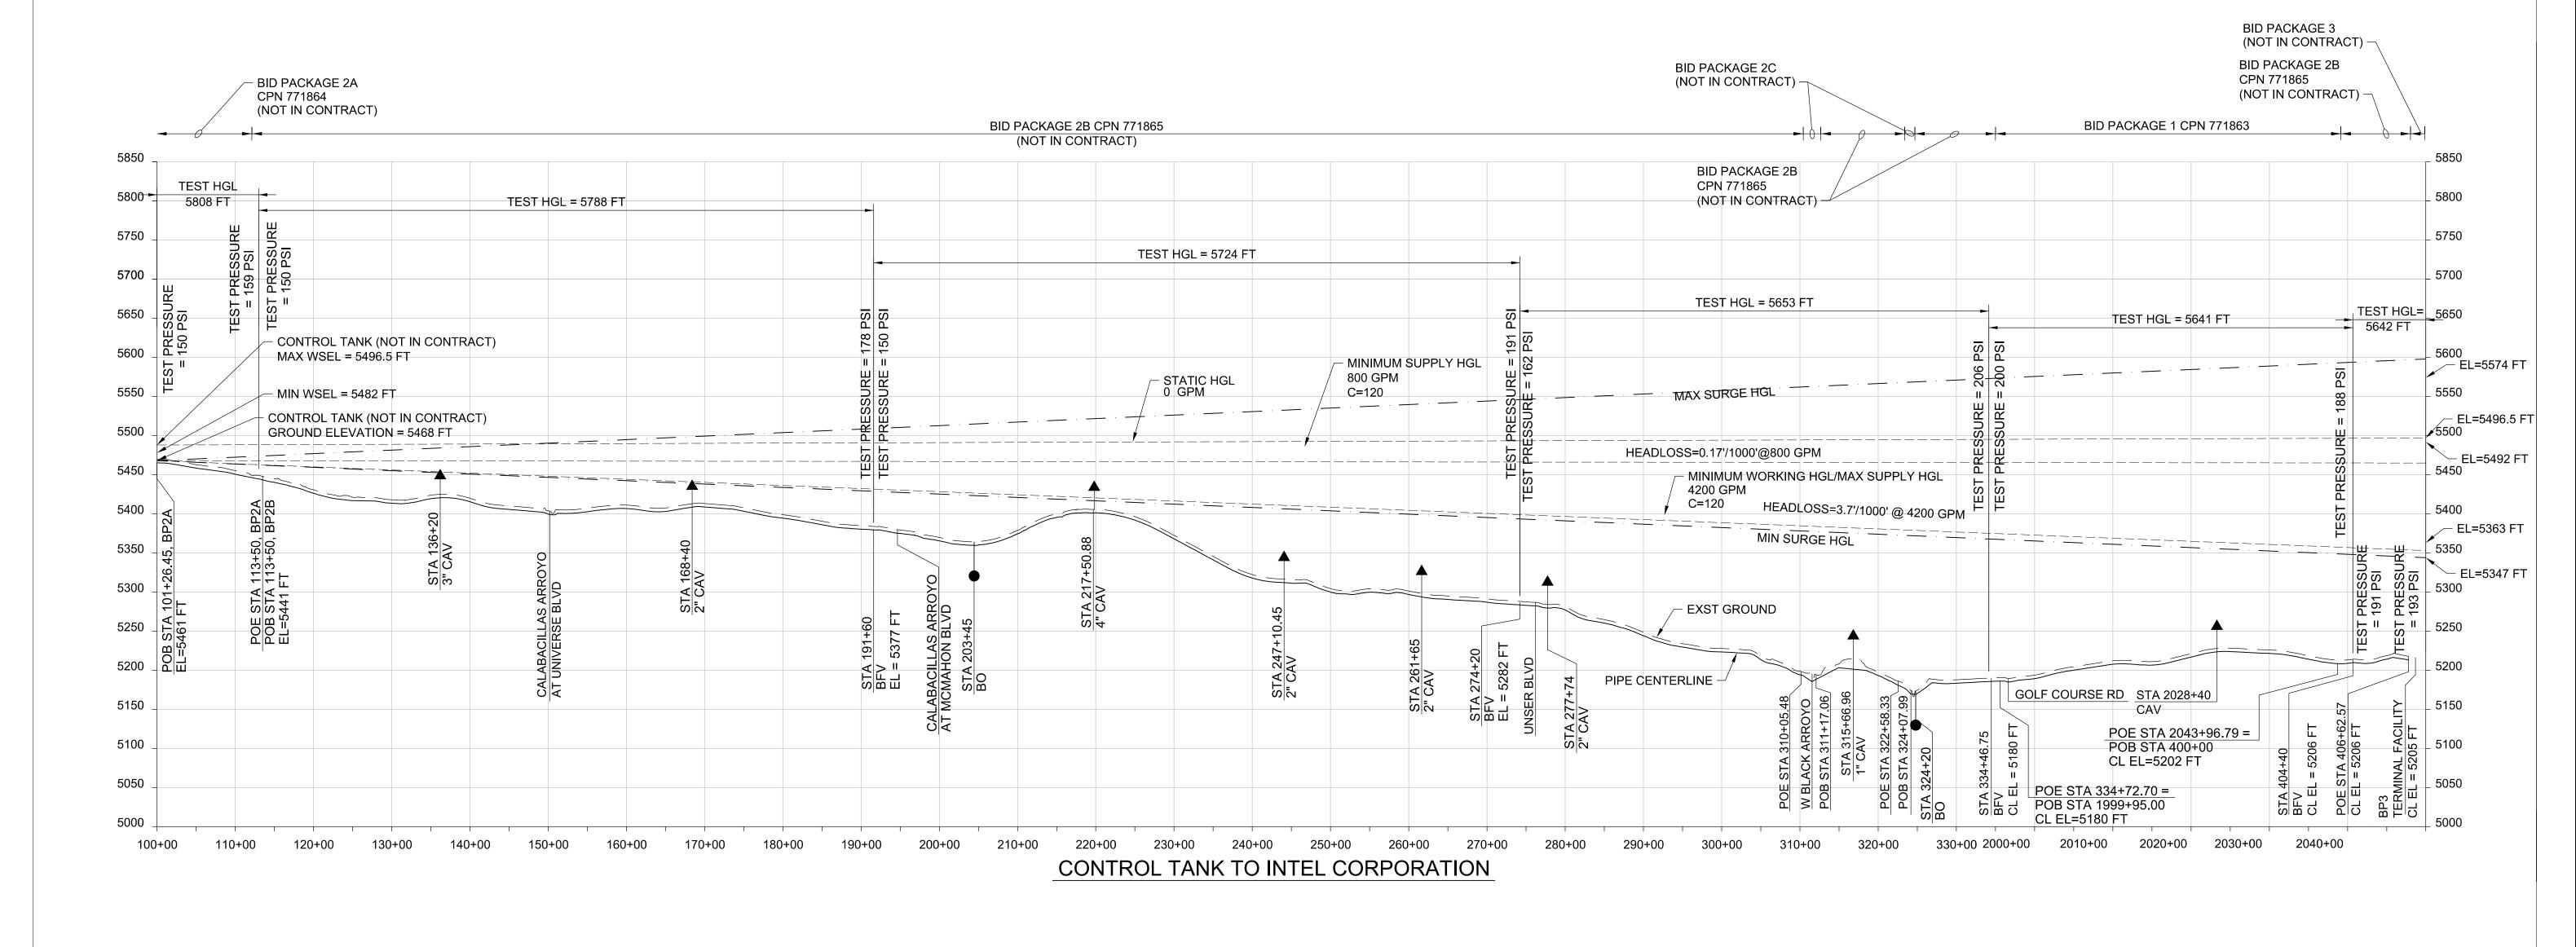


- 1. MAINTAIN TEST PRESSURE AT HGL AS SHOWN.
- 2. SUBMIT HYDROSTATIC TESTING PLAN AND FLUSHING PLAN TO WATER AUTHORITY 28 DAYS PRIOR TO CONDUCTING TESTS. PLAN TO INCLUDE PROPOSED LOCATIONS OF EXISTING HYDRANTS FOR FILLING THE PIPELINE.
- 3. UTILIZE 1/4-INCH DIAMETER 4-INCH DIAL CALIBRATED PRESSURE GAUGE (0-300 PSI) DURING TEST
- 4. THE WATER AUTHORITY WILL GRANT 2 VOLUMES OF WATER AT NO EXPENSE TO THE CONTRACTOR. ESTIMATED VOLUME OF WATER TO FILL PIPELINE ONCE IS APPROXIMATELY 72,000 GALLONS. CONTRACTOR IS RESPONSIBLE FOR THE COST OF THE METER RENTAL, ASSOCIATED PERMIT FEES, AND TEMPORARY INFRASTRUCTURE REQUIRED TO FILL AND FLUSH THE PIPELINE.
- USE 5 FT STUB OUT TO TEST AGAINST BOTH SIDES OF THE CLOSED VALVE AT THE POB AND POE FOR THE SAME DURATION AS THE HYDROSTATIC TEST,
- 6. AFTER SUCCESSFUL COMPLETION OF THE HYDROSTATIC TEST, RELEASE PRESSURE AND MAINTAIN WATER IN THE PIPELINE.
- 7. TEST WATER WILL BE AVAILABLE FROM A HYDRANT WITHIN THE PROJECT SITE, SEE SHEET G-4.

# **REDRAWN FOR RECORD PURPOSES**

DESIGN TRACKING SUBMITTED BY: AS BUILT INFORMATION **RECORD DRAWINGS** SCALE: ENGINEER'S SEAL ALBUQUERQUE BERNALILLO COUNTY 1 "= CONTRACTOR AUI, INC THIS DOCUMENT IS AN DESIGNED BY M COUTURE DATE: 12/2021 WATER UTILITY AUTHORITY ELECTRONIC COPY. CONSTRUCTION THESE RECORD DOCUMENTS HAVE BEEN PREPARED BASED ON 3/01/2022 C LAMB DATE: 12/2021 DRAWN BY: ATTENTION BEGIN DATE ORIGINAL DOCUMENT RAW WATER TRANSMISSION PIPELINE TO INTEL CORPORATION INFORMATION PROVIDED BY OTHERS. THEY ARE NOT INTENDED TO CHECKED BY: E FORD DATE: 12/2021 WAS ISSUED AND ACCEPTANCE BY JACOBS INSPECTOR'S 0 1/2" 1 REPRESENT IN DETAIL THE EXACT LOCATION. TYPE OF COMPONENT BID PACKAGE NO. 1 - WESTSIDE BLVD DATE 5/31/2022 SEALED ON 12/17/2021. NOR MANNER OF CONSTRUCTION. THE DESIGN PROFESSIONAL CROSS CHK'D BY: W CHRISTOFFERSON DATE: 12/2021 HYDRAULIC PROFILE THE ORIGINAL INSPECTOR'S NAME L KOIKE/V TORRES 3721 RUTLEDGE RD NE, SUITE B-1 ALBUQUERQUE, NM 87109 505-884-5600 HAS NOT VERIFIED THE ACCURACY AND/OR THE COMPLETENESS J PETERSON DATE: 12/2021 DOCUMENT GRAPHIC SCALE APPROVED BY: OF THIS INFORMATION AND SHALL NOT BE RESPONSIBLE FOR ANY COMPLETION DATE 5/31/2022 SUBSTANTIAL IS STORED AT THE ERRORS OR OMISSIONS WHICH MAY BE INCORPORATED HEREIN THIS BAR MEASURES 1 MAPS/RECORDS INFO. OFFICES OF JACOBS WATER AUTHORITY AS A RESULT. AT FULL SCALE (ANSI D) DRAWINGS CORRECTED BY JACOBS DATE 8/2022 ALBUQUERQUE, NM. 001-G-5.dgn

5 OF 17

CPN 771863

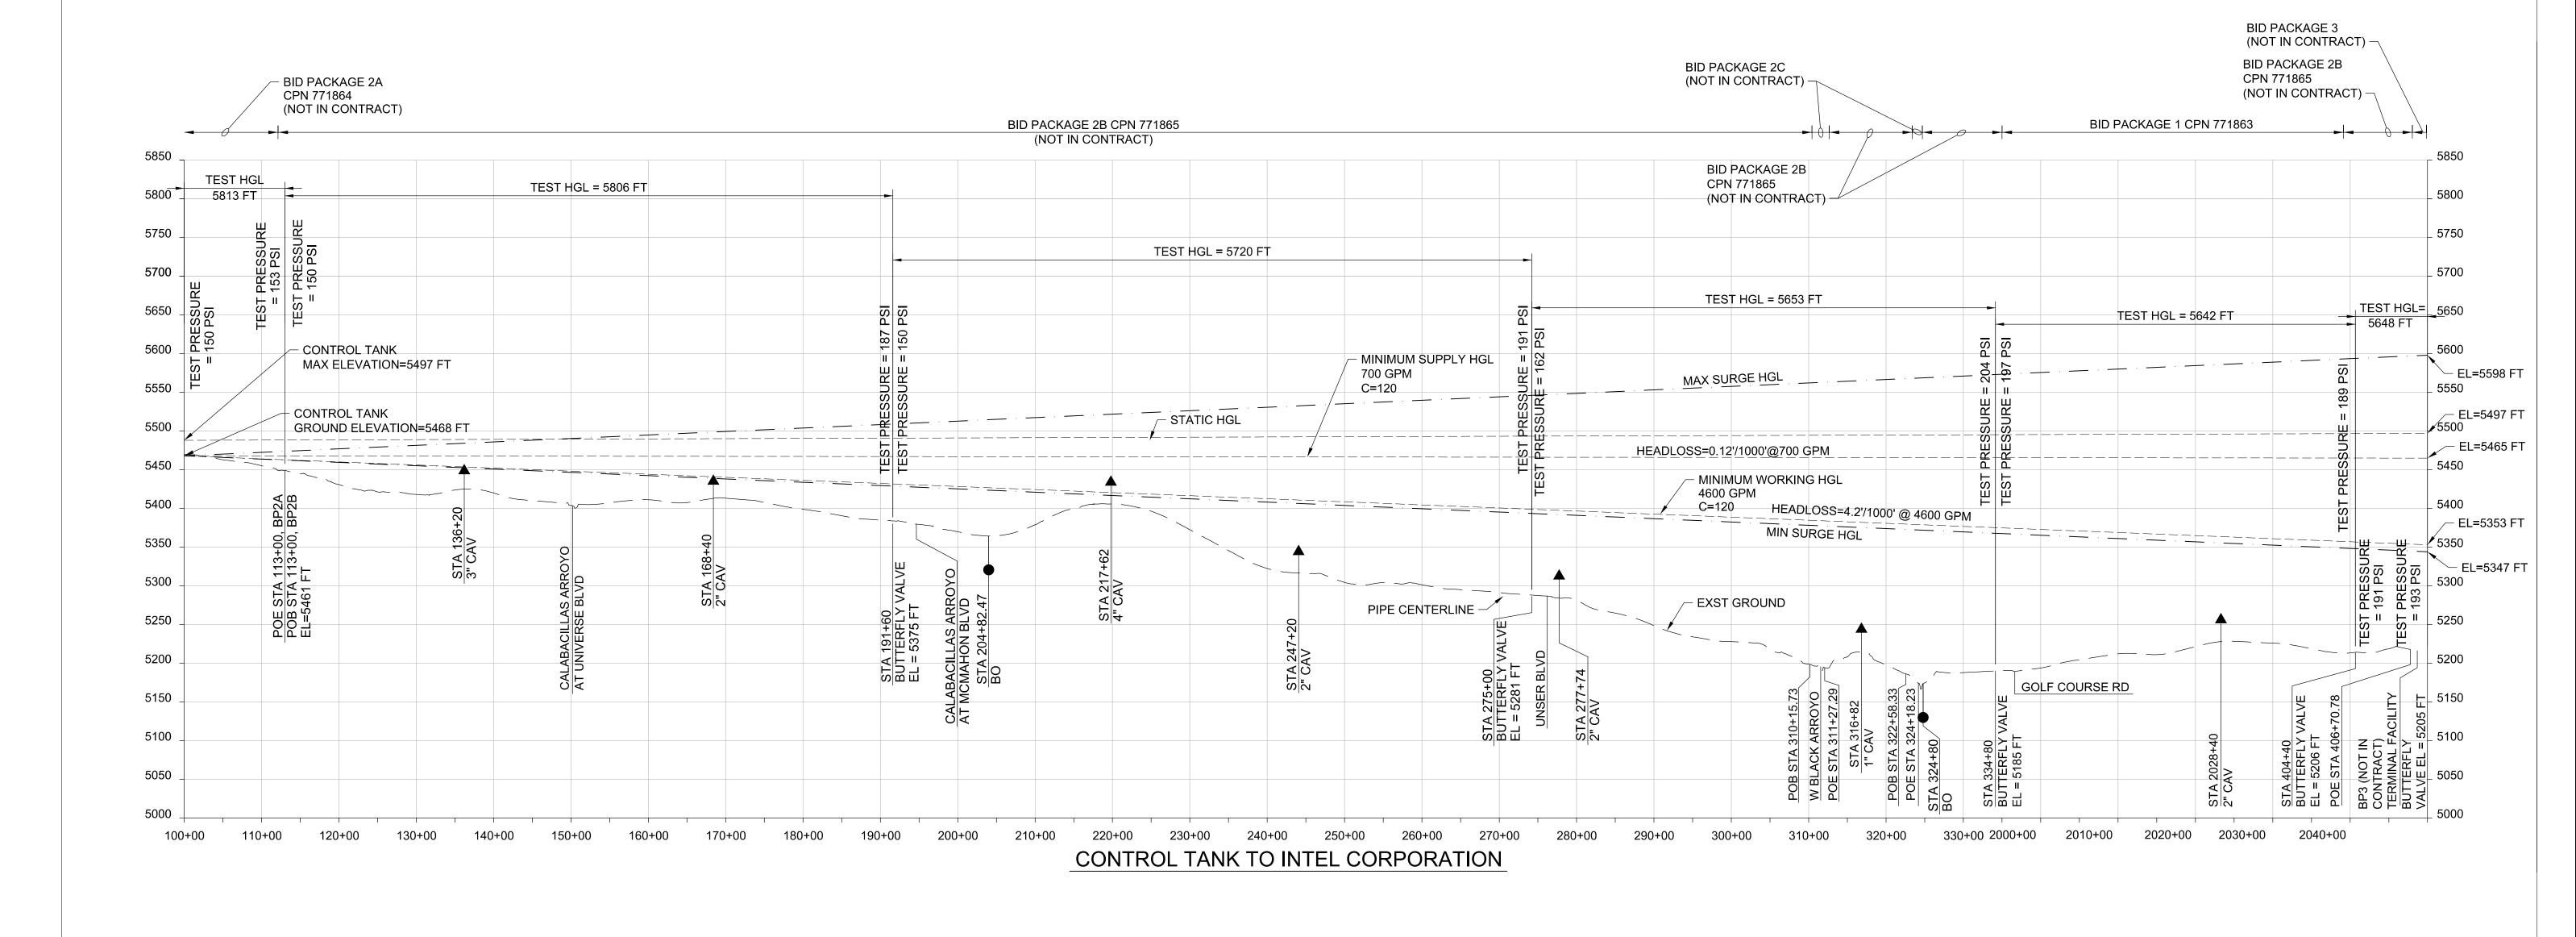

#### NOTES:

- 1. MAINTAIN TEST PRESSURE AT HGL AS SHOWN.
- 2. SUBMIT HYDROSTATIC TESTING PLAN AND FLUSHING PLAN TO WATER AUTHORITY 28 DAYS PRIOR TO CONDUCTING TESTS. PLAN TO INCLUDE PROPOSED LOCATIONS OF EXISTING HYDRANTS FOR FILLING THE PIPELINE.
- 3. UTILIZE 1/4-INCH DIAMETER 4-INCH DIAL CALIBRATED PRESSURE GAUGE (0-300 PSI) DURING TEST
- 4. THE WATER AUTHORITY WILL GRANT 2 VOLUMES OF WATER AT NO EXPENSE TO THE CONTRACTOR. ESTIMATED VOLUME OF WATER TO FILL PIPELINE ONCE IS APPROXIMATELY 72,000 GALLONS. CONTRACTOR IS RESPONSIBLE FOR THE COST OF THE METER RENTAL, ASSOCIATED PERMIT FEES, AND TEMPORARY INFRASTRUCTURE REQUIRED TO FILL AND FLUSH THE PIPELINE.
- 5. USE 5 FT STUB OUT TO TEST AGAINST BOTH SIDES OF THE CLOSED VALVE AT THE POB AND POE FOR THE SAME DURATION AS THE HYDROSTATIC TEST,
- 6. AFTER SUCCESSFUL COMPLETION OF THE HYDROSTATIC TEST, RELEASE PRESSURE AND MAINTAIN WATER IN THE PIPELINE.
- 7. TEST WATER WILL BE AVAILABLE FROM A HYDRANT WITHIN THE PROJECT SITE, SEE SHEET G-4.

THIS SHEET SUPERSEDED BY
SIMILAR SHEET MARKED
"REDRAWN FOR RECORD PURPOSES"



Approved by Albuquerque
City Engineer and Design
Review Committee, Feb. 10, 2022
CPN 771863

NO.	DATE	REVISION NO. & DESCRIPTION	BY	SCALE:
				1"=
				ATTENTION
				0 1/2" 1"
				GRAPHIC SCALE
				THIS BAR MEASURES 1" AT FULL SCALE (ANSI D)

		DESIGN TRACKING	G	
	DESIGNED BY:	M COUTURE	DATE:	12/17/21
	DRAWN BY:	C LAMB	DATE:	12/17/21
	CHECKED BY:	E FORD	DATE:	12/17/21
	CROSS CHK'D BY:	W CHRISTOFFERSON	DATE:	12/17/21
	APPROVED BY:	J PETERSON	DATE:	12/17/21
1"	M	APS/RECORDS IN	FO.	

Jacobs.

3721 RUTLEDGE RD NE, SUITE B-1
ALBUQUERQUE, NM 87109
505-884-5600


SUBMITTED BY:


AS	BUILT INFORMATION	
CONTRACTOR		/
CONSTRUCTION BEGIN DATE		[] []
INSPECTOR'S ACCEPTANCE BY	DATE	 LICENS.
INSPECTOR'S NAME -	_	1
SUBSTANTIAL _ COMPLETION DATE	_	100
DRAWINGS	DATE	 12





	ALBUQUERQUE BERNALILLO COUNTY  WATER UTILITY AUTHORITY
TLE:	RAW WATER TRANSMISSION PIPELINE TO INTEL CORPORATION
	bid package no. 1 – westside blvd HYDRAULIC PROFILE

WATER AUTHORITY CONSTRUCTION PROJECT NO. 2320.030XX ZONE MAP NO. A-12 SHEET

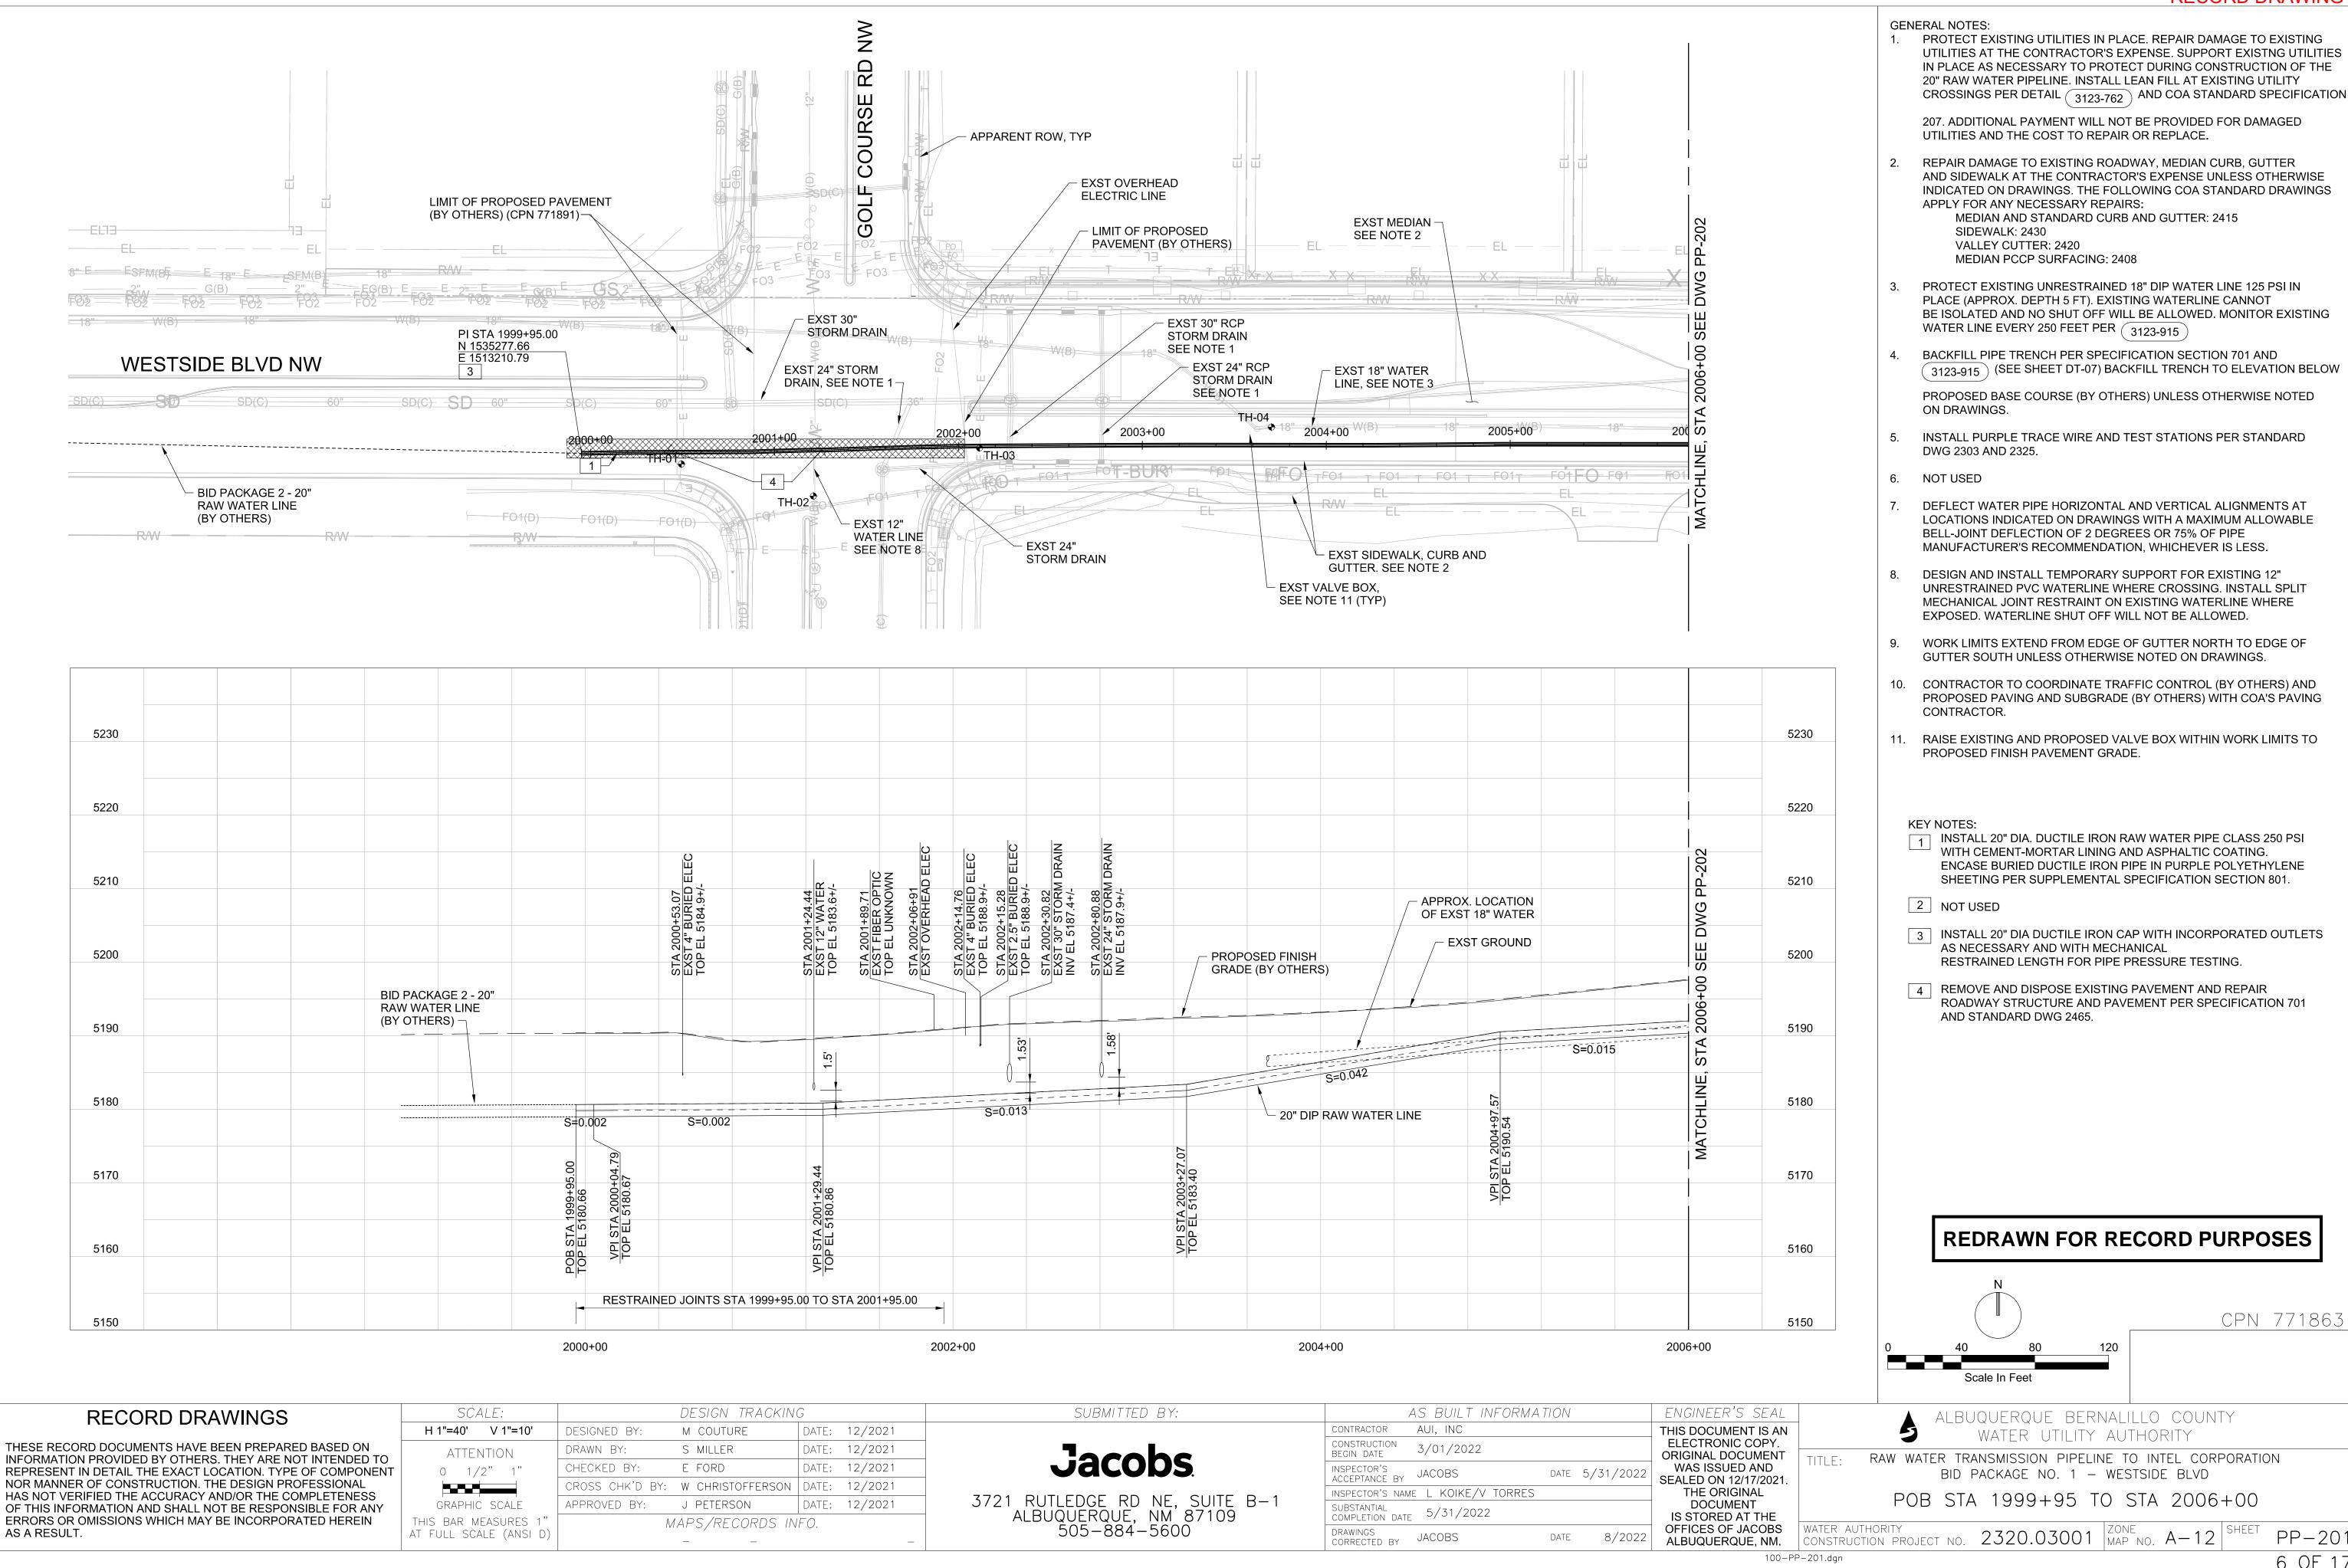

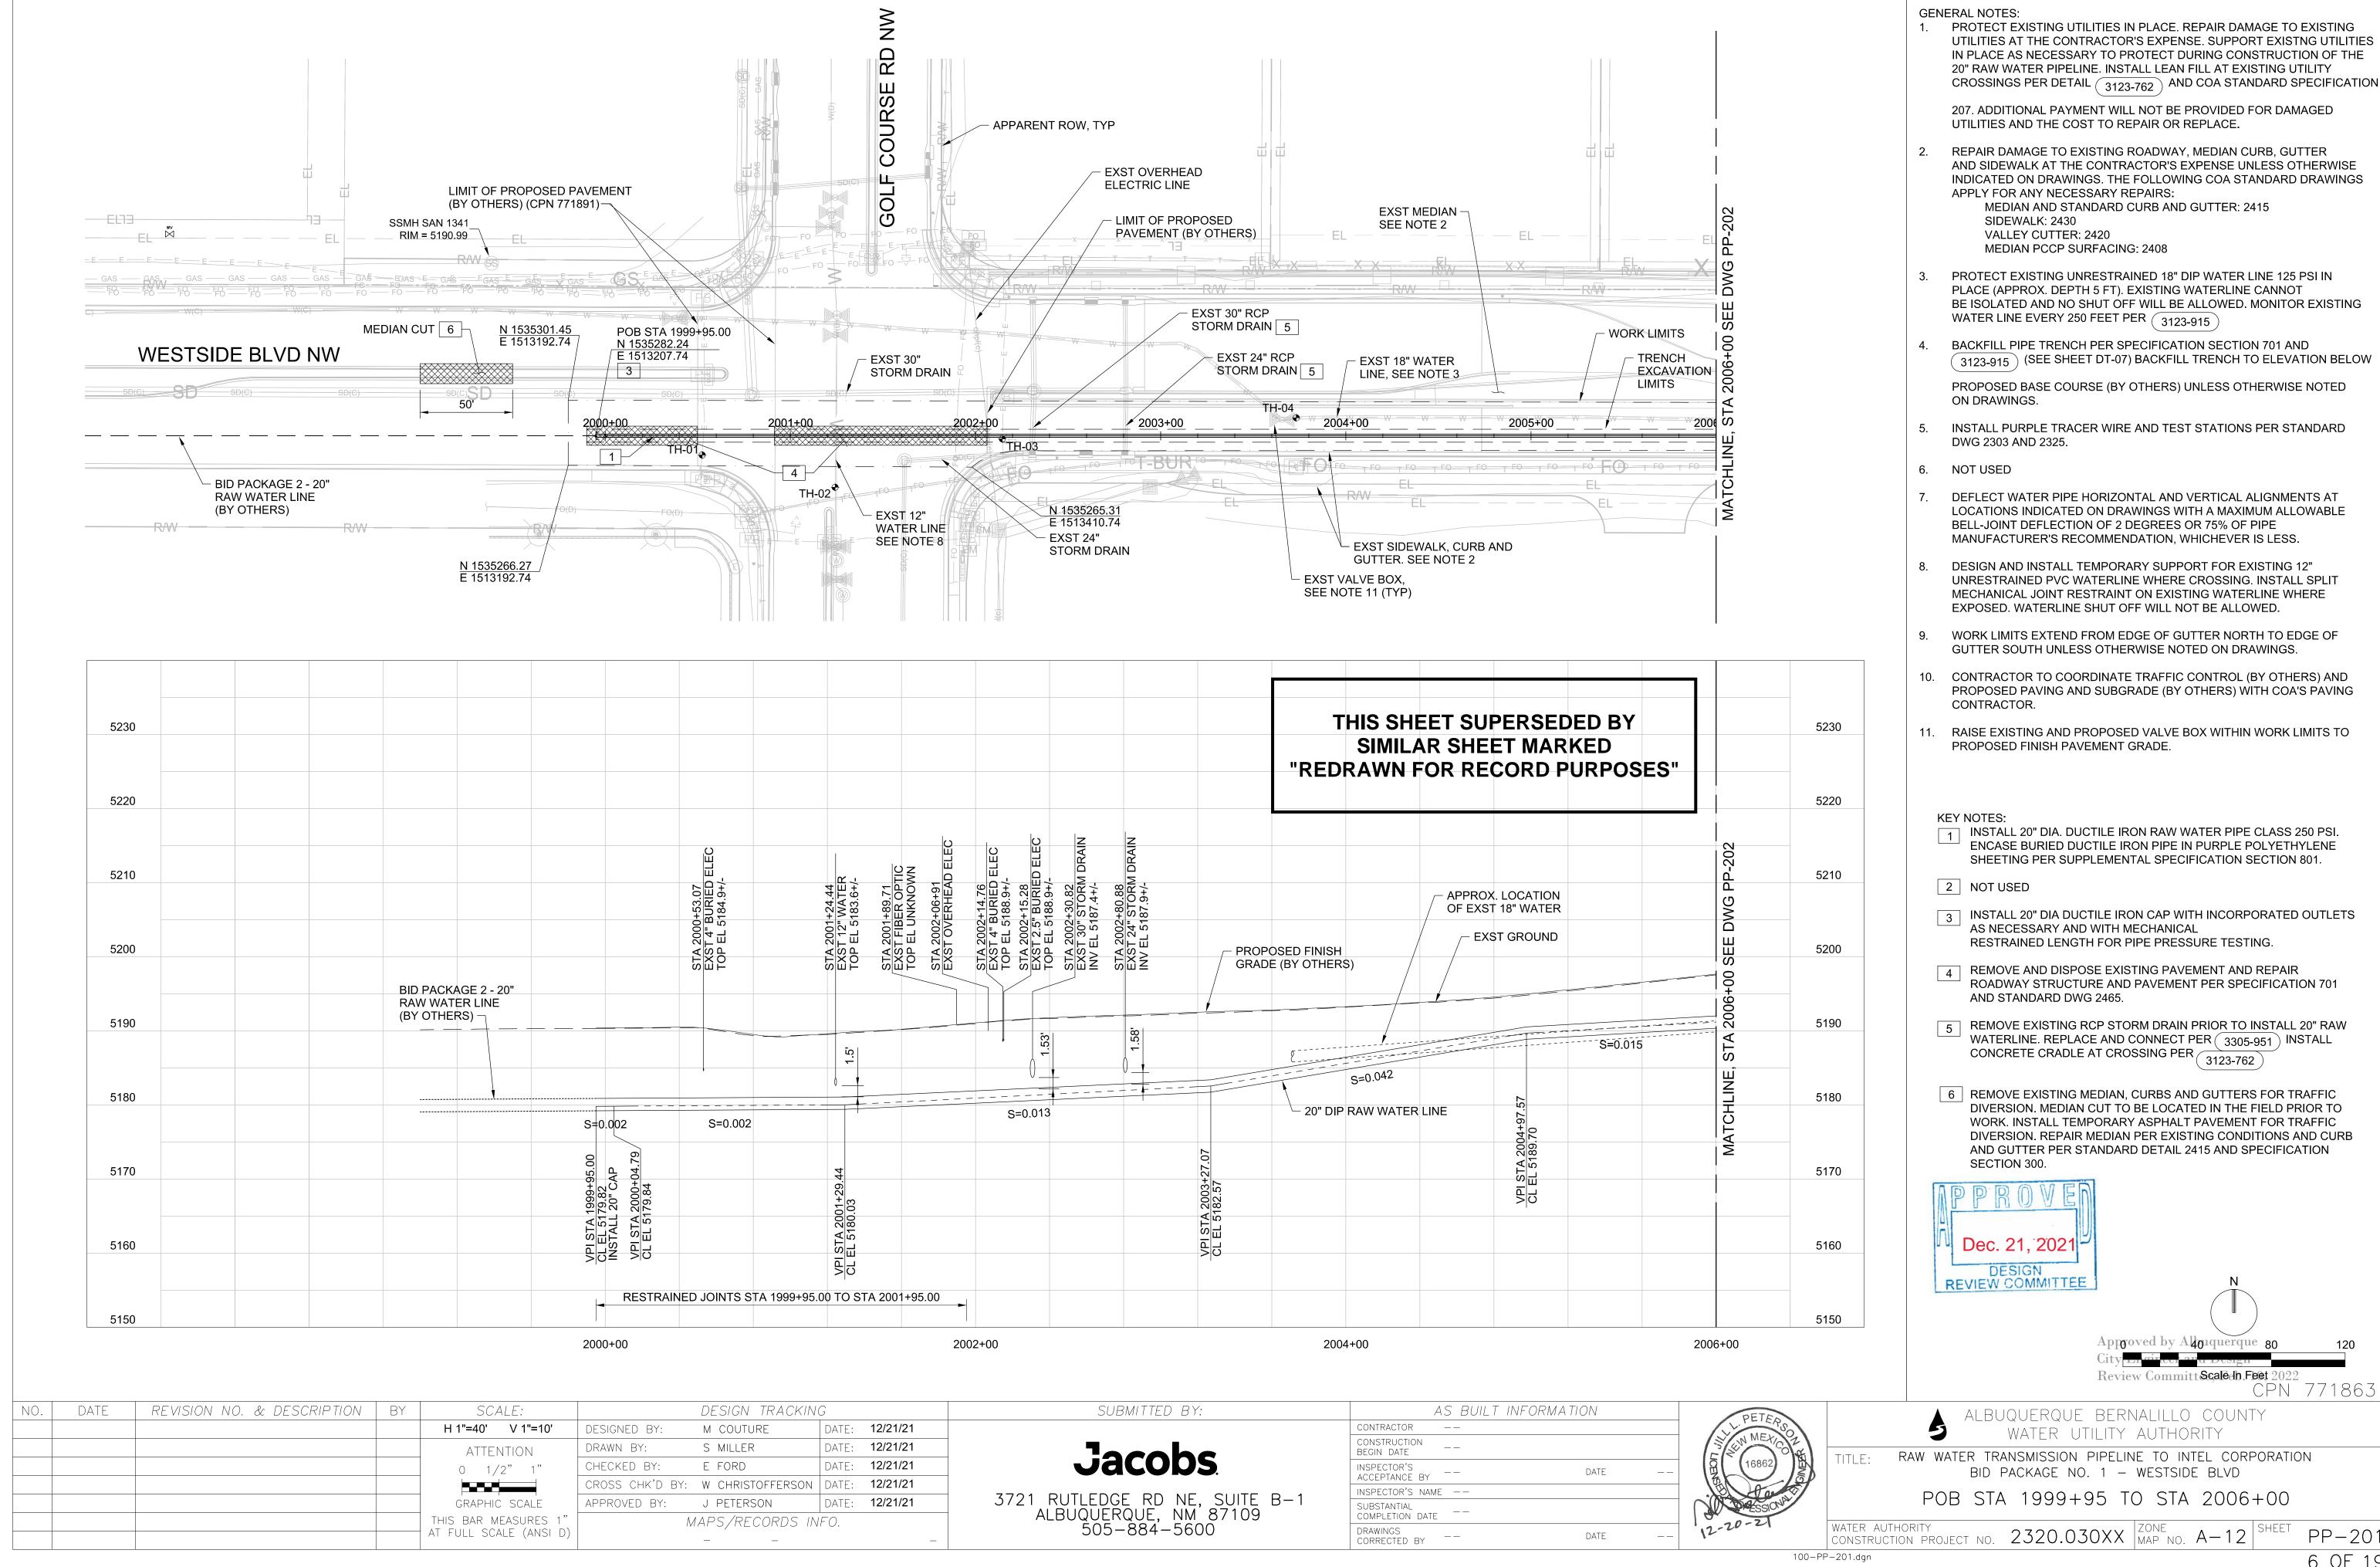

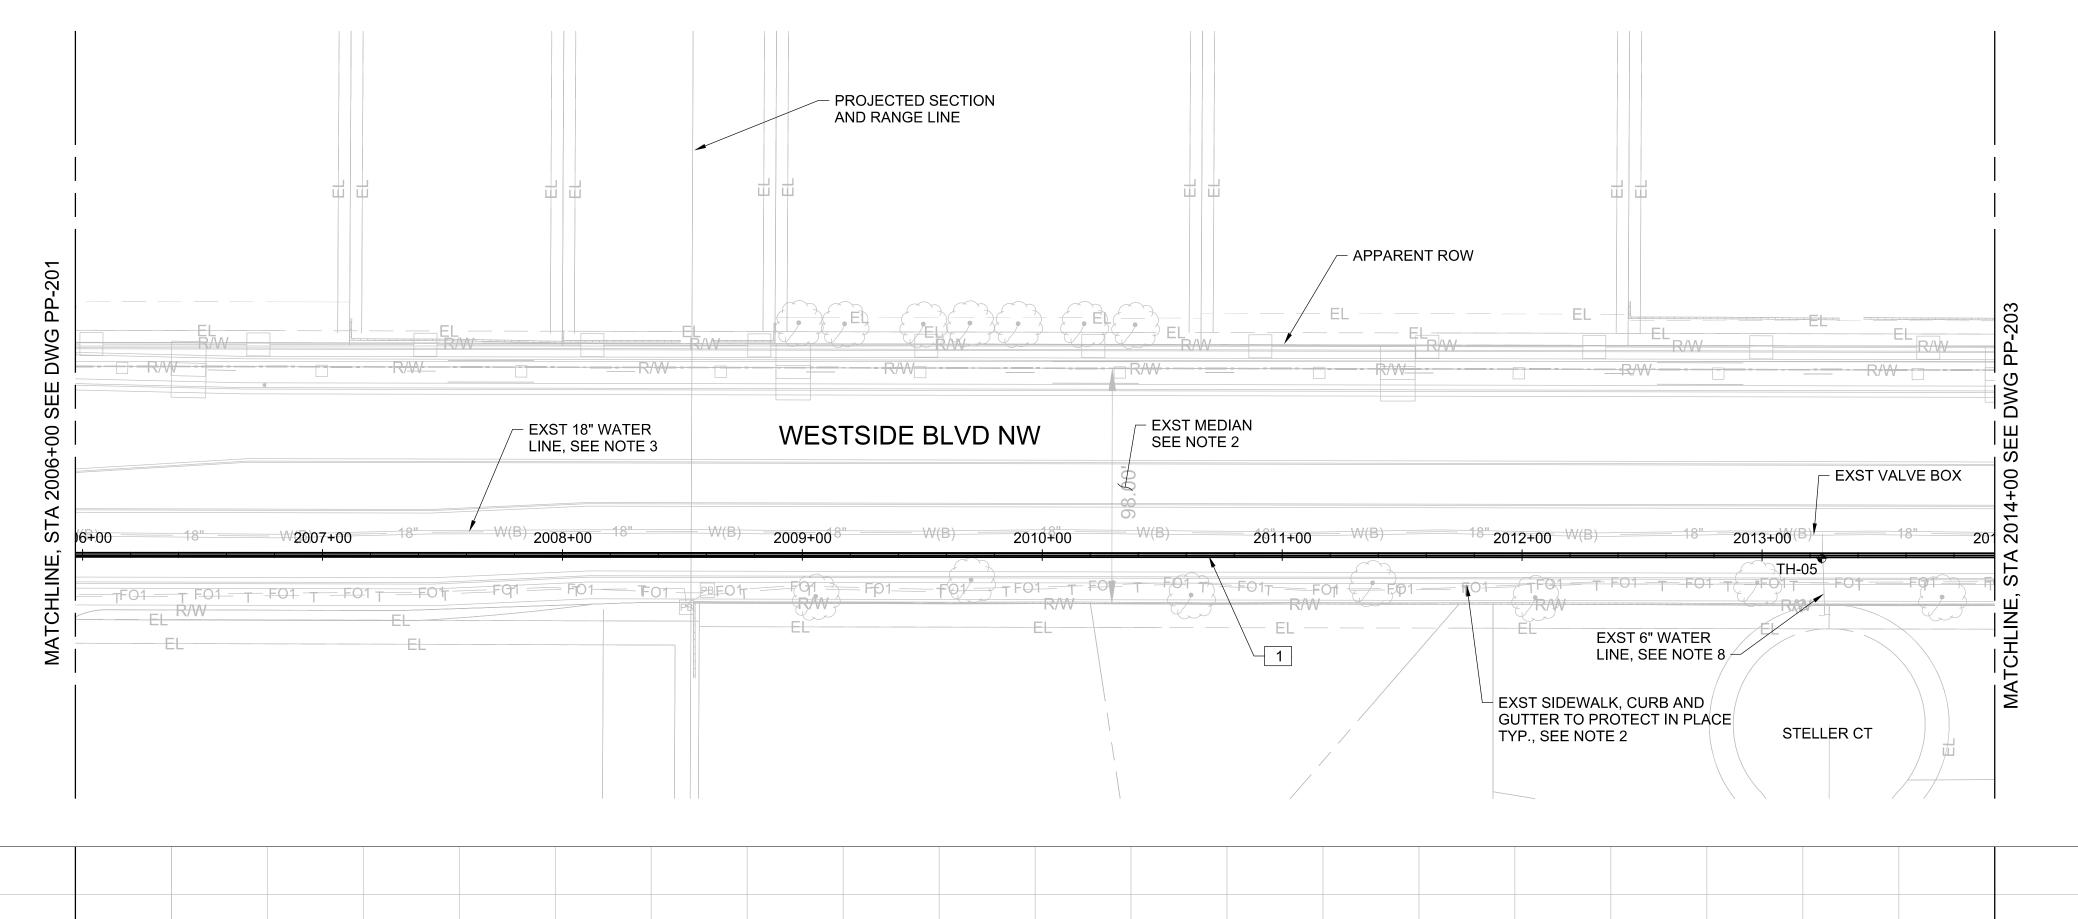

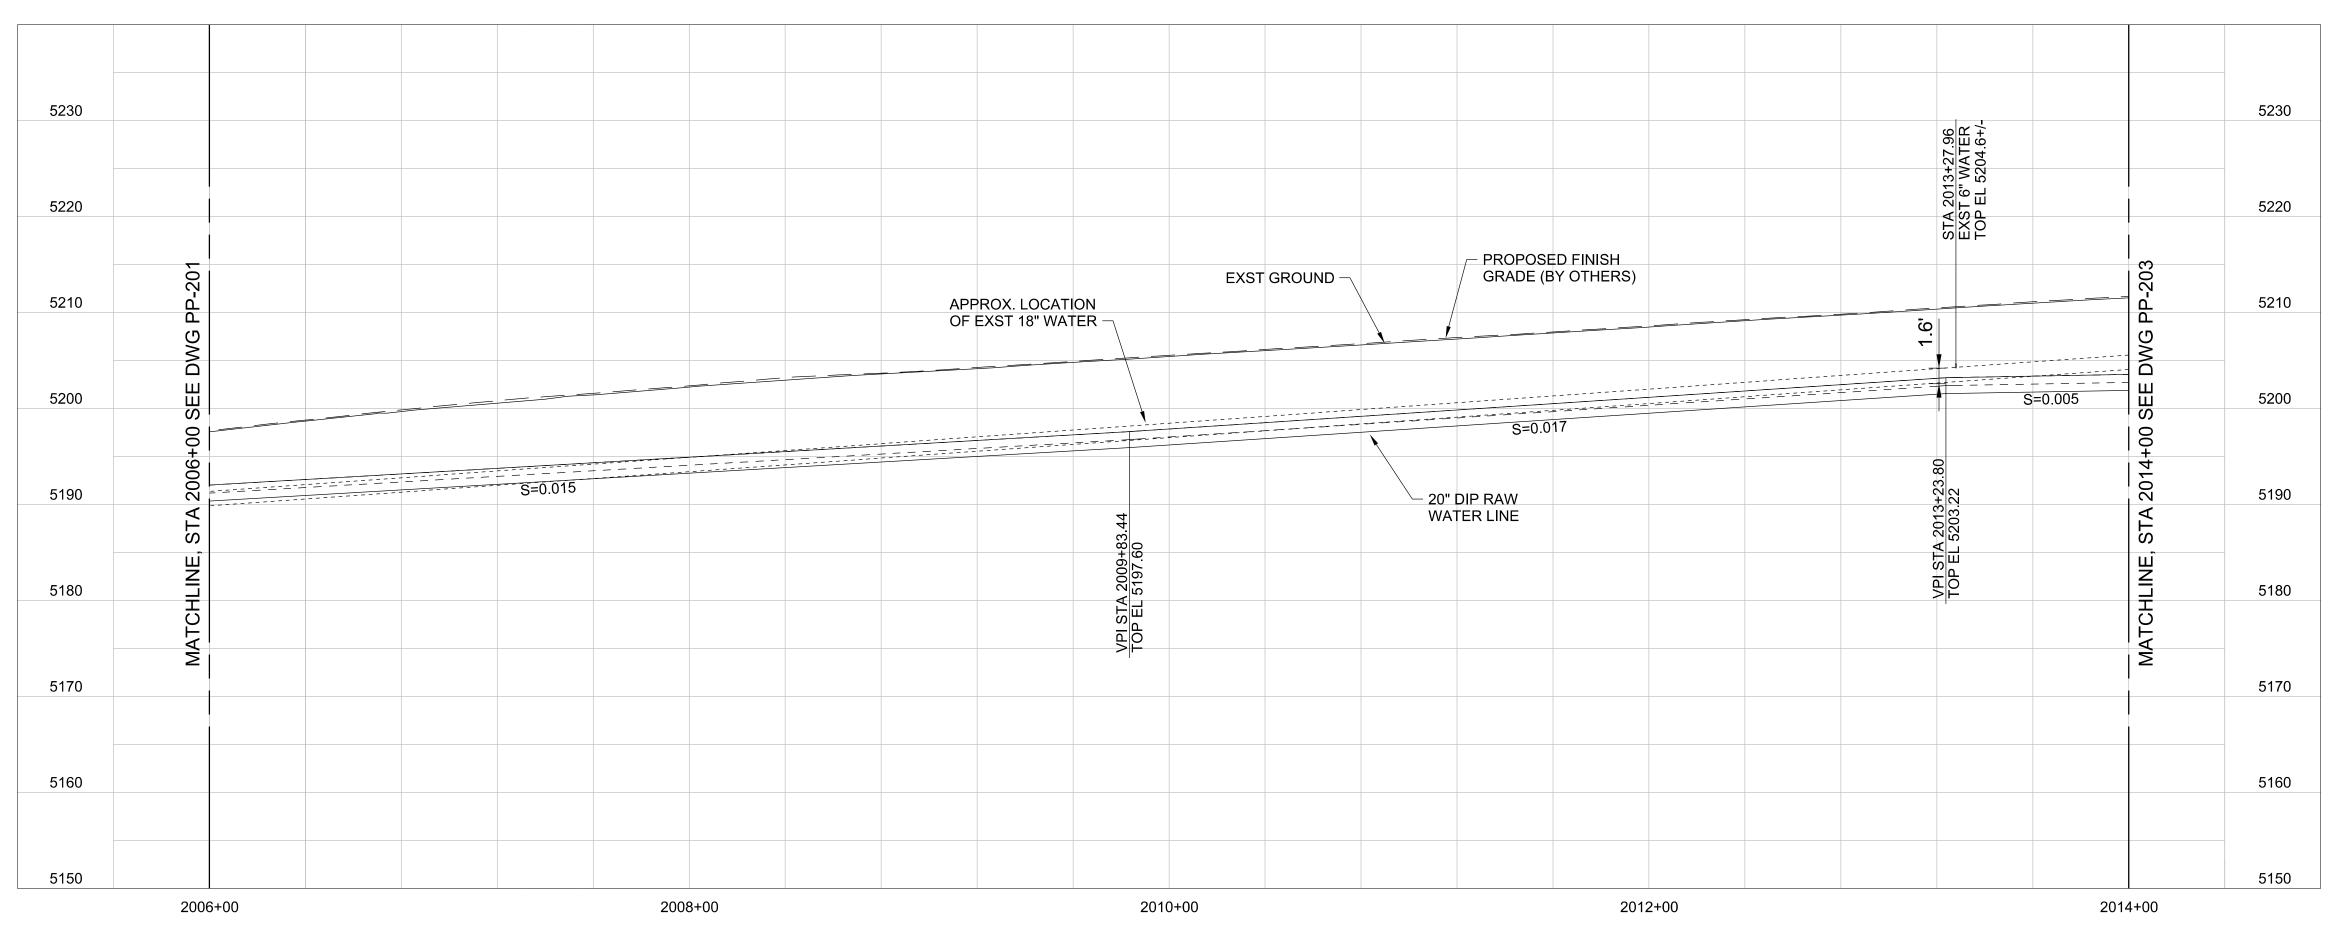

#### **GENERAL NOTES:**

PROTECT EXISTING UTILITIES IN PLACE. REPAIR DAMAGE TO EXISTING UTILITIES AT THE CONTRACTOR'S EXPENSE. SUPPORT EXISTING UTILITIES IN PLACE AS NECESSARY TO PROTECT DURING CONSTRUCTION OF THE 20" RAW WATER PIPELINE. INSTALL LEAN FILL AT EXISTING UTILITY CROSSINGS PER DETAIL ( 3123-762 ) AND COA STANDARD SPECIFICATION

207. ADDITIONAL PAYMENT WILL NOT BE PROVIDED FOR DAMAGED UTILITIES AND THE COST TO REPAIR OR REPLACE.

REPAIR DAMAGE TO EXISTING ROADWAY, MEDIAN CURB, GUTTER AND SIDEWALK AT THE CONTRACTOR'S EXPENSE UNLESS OTHERWISE INDICATED ON DRAWINGS. THE FOLLOWING COA STANDARD DRAWINGS APPLY FOR ANY NECESSARY REPAIRS: MEDIAN AND STANDARD CURB AND GUTTER: 2415

SIDEWALK: 2430 VALLEY CUTTER: 2420 MEDIAN PCCP SURFACING: 2408

- PROTECT EXISTING UNRESTRAINED 18" DIP WATER LINE 125 PSI IN PLACE (APPROX. DEPTH 5 FT). EXISTING WATERLINE CANNOT BE ISOLATED AND NO SHUT OFF WILL BE ALLOWED. MONITOR EXISTING WATER LINE EVERY 250 FEET PER (3123-915)
- BACKFILL PIPE TRENCH PER SPECIFICATION SECTION 701 AND  $\left(\begin{array}{c} 3123-915 \end{array}
  ight)$  (SEE SHEET DT-07) BACKFILL TRENCH TO ELEVATION BELOW


PROPOSED BASE COURSE (BY OTHERS) UNLESS OTHERWISE NOTED ON DRAWINGS.

- INSTALL PURPLE TRACE WIRE AND TEST STATIONS PER STANDARD DWG 2303 AND 2325.
- 6. NOT USED
- DEFLECT WATER PIPE HORIZONTAL AND VERTICAL ALIGNMENTS AT LOCATIONS INDICATED ON DRAWINGS WITH A MAXIMUM ALLOWABLE BELL-JOINT DEFLECTION OF 2 DEGREES OR 75% OF PIPE MANUFACTURER'S RECOMMENDATION, WHICHEVER IS LESS.
- DESIGN AND INSTALL TEMPORARY SUPPORT FOR EXISTING 6" UNRESTRAINED PVC WATERLINE WHERE CROSSING. INSTALL SPLIT MECHANICAL JOINT RESTRAINT ON EXISTING WATERLINE WHERE EXPOSED. WATERLINE SHUT OFF WILL NOT BE ALLOWED.
- WORK LIMITS EXTEND FROM EDGE OF GUTTER NORTH TO EDGE OF GUTTER SOUTH UNLESS OTHERWISE NOTED ON DRAWINGS.
- 10. CONTRACTOR TO COORDINATE TRAFFIC CONTROL (BY OTHERS) AND PROPOSED PAVING AND SUBGRADE (BY OTHERS) WITH COA'S PAVING CONTRACTOR.

#### **KEY NOTES:**

1 INSTALL 20" DIA. DUCTILE IRON RAW WATER PIPE CLASS 250 PSI WITH CEMENT-MORTAR LINING AND ASPHALTIC COATING. ENCASE BURIED DUCTILE IRON PIPE IN PURPLE POLYETHYLENE SHEETING PER SUPPLEMENTAL SPECIFICATION SECTION 801.

## **REDRAWN FOR RECORD PURPOSES**

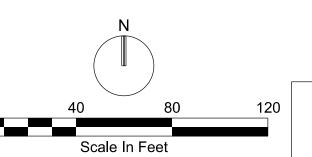

CPN 771863

# **RECORD DRAWINGS**

THESE RECORD DOCUMENTS HAVE BEEN PREPARED BASED ON INFORMATION PROVIDED BY OTHERS. THEY ARE NOT INTENDED TO REPRESENT IN DETAIL THE EXACT LOCATION. TYPE OF COMPONENT NOR MANNER OF CONSTRUCTION. THE DESIGN PROFESSIONAL HAS NOT VERIFIED THE ACCURACY AND/OR THE COMPLETENESS ØETHIS INFORMATION AND SHALL NOT BE RESPONSIBLE FOR ANY ERRORS OR OMISSIONS WHICH MAY BE INCORPORATED HEREIN

AS A RESULT.

SCALE: H 1"=40' V 1"=10' ATTENTION 0 1/2" 1" GRAPHIC SCALE THIS BAR MEASURES 1 AT FULL SCALE (ANSI D)

DESIGN TRACKING DESIGNED BY M COUTURE DATE: 12/2021 DATE: 12/2021 DRAWN BY: S MILLER CHECKED BY: E FORD DATE: 12/2021 W CHRISTOFFERSON DATE: 12/2021 CROSS CHK'D BY: J PETERSON DATE: 12/2021 APPROVED BY: MAPS/RECORDS INFO.

# **Jacobs**

SUBMITTED BY:

3721 RUTLEDGE RD NE, SUITE B-1 ALBUQUERQUE, NM 87109 505-884-5600


AS BUILT INFORMATION ENGINEER'S SEAL CONTRACTOR AUI, INC THIS DOCUMENT IS AN ELECTRONIC COPY. CONSTRUCTION 3/01/2022 BEGIN DATE ORIGINAL DOCUMENT WAS ISSUED AND ACCEPTANCE BY JACOBS INSPECTOR'S DATE 5/31/2022 SEALED ON 12/17/2021. THE ORIGINAL INSPECTOR'S NAME L KOIKE/V TORRES DOCUMENT COMPLETION DATE 5/31/2022 SUBSTANTIAL IS STORED AT THE OFFICES OF JACOBS WATER AUTHORITY DRAWINGS CORRECTED BY JACOBS DATE 8/2022 ALBUQUERQUE, NM.


ALBUQUERQUE BERNALILLO COUNTY WATER UTILITY AUTHORITY


RAW WATER TRANSMISSION PIPELINE TO INTEL CORPORATION BID PACKAGE NO. 1 - WESTSIDE BLVD

STA 2006+00 TO STA 2014+00

WATER AUTHORITY CONSTRUCTION PROJECT NO. 2320.03001 ZONE A-12 & SHEET MAP NO. A-13

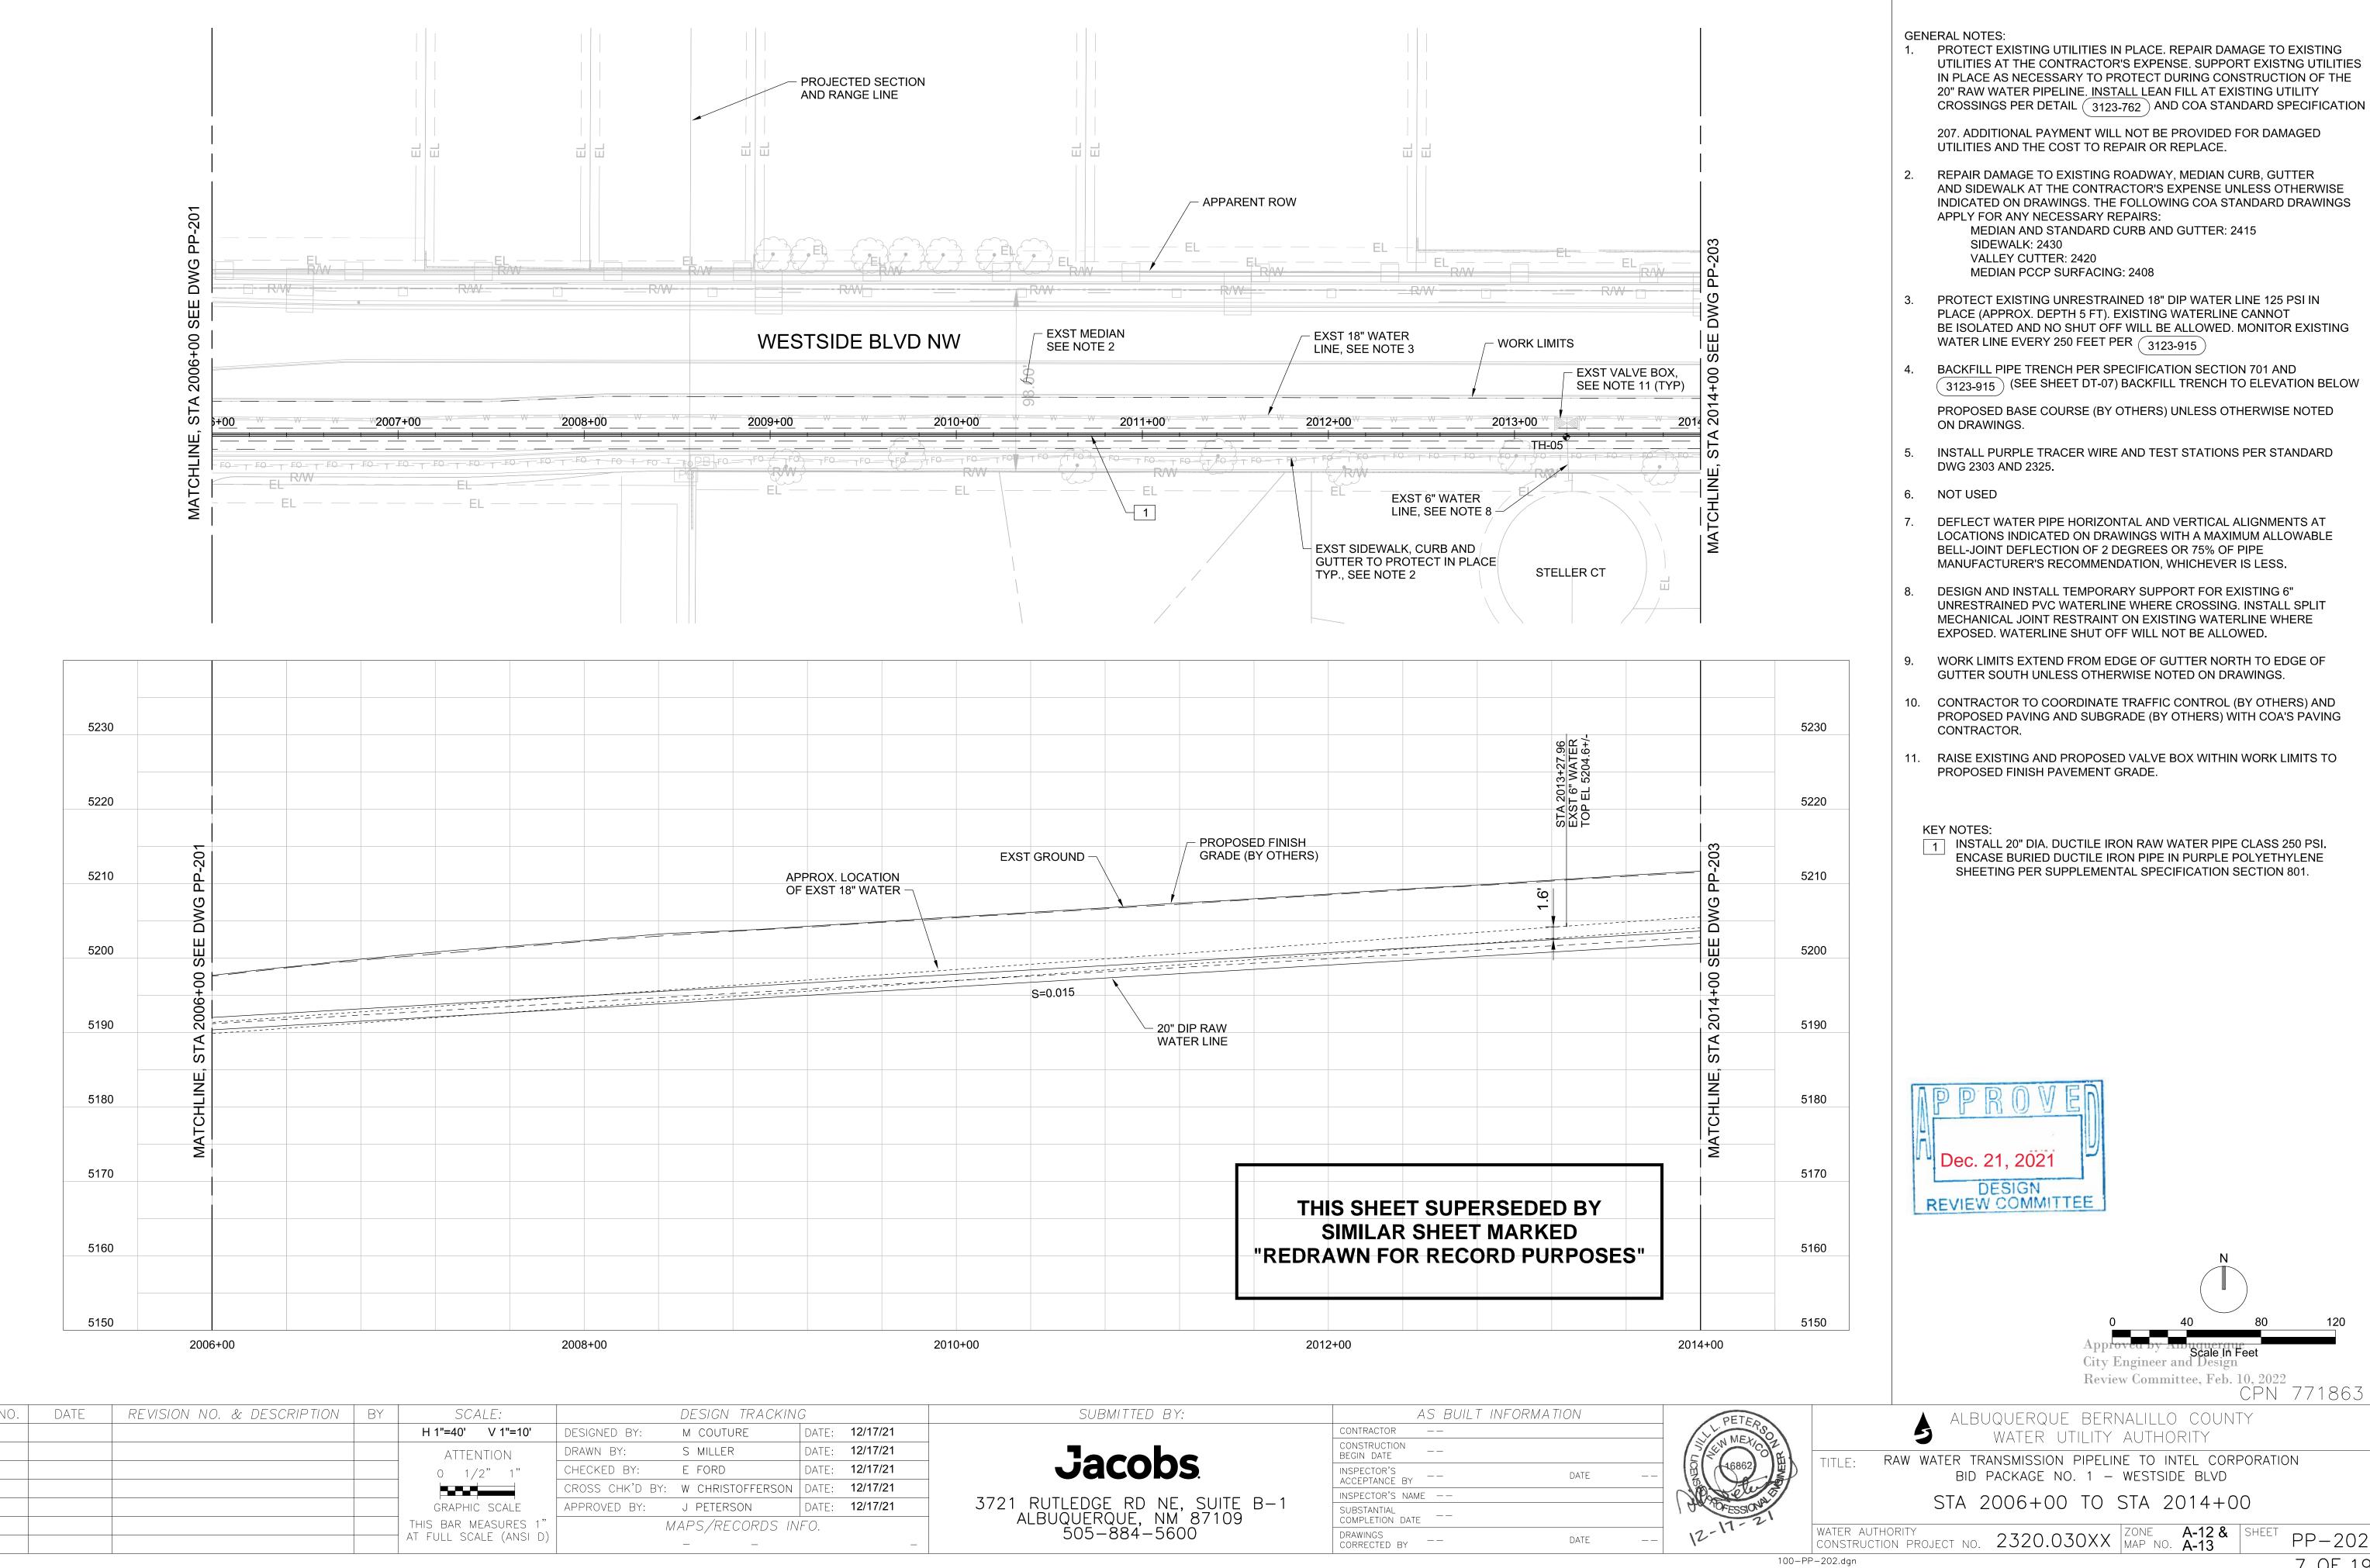


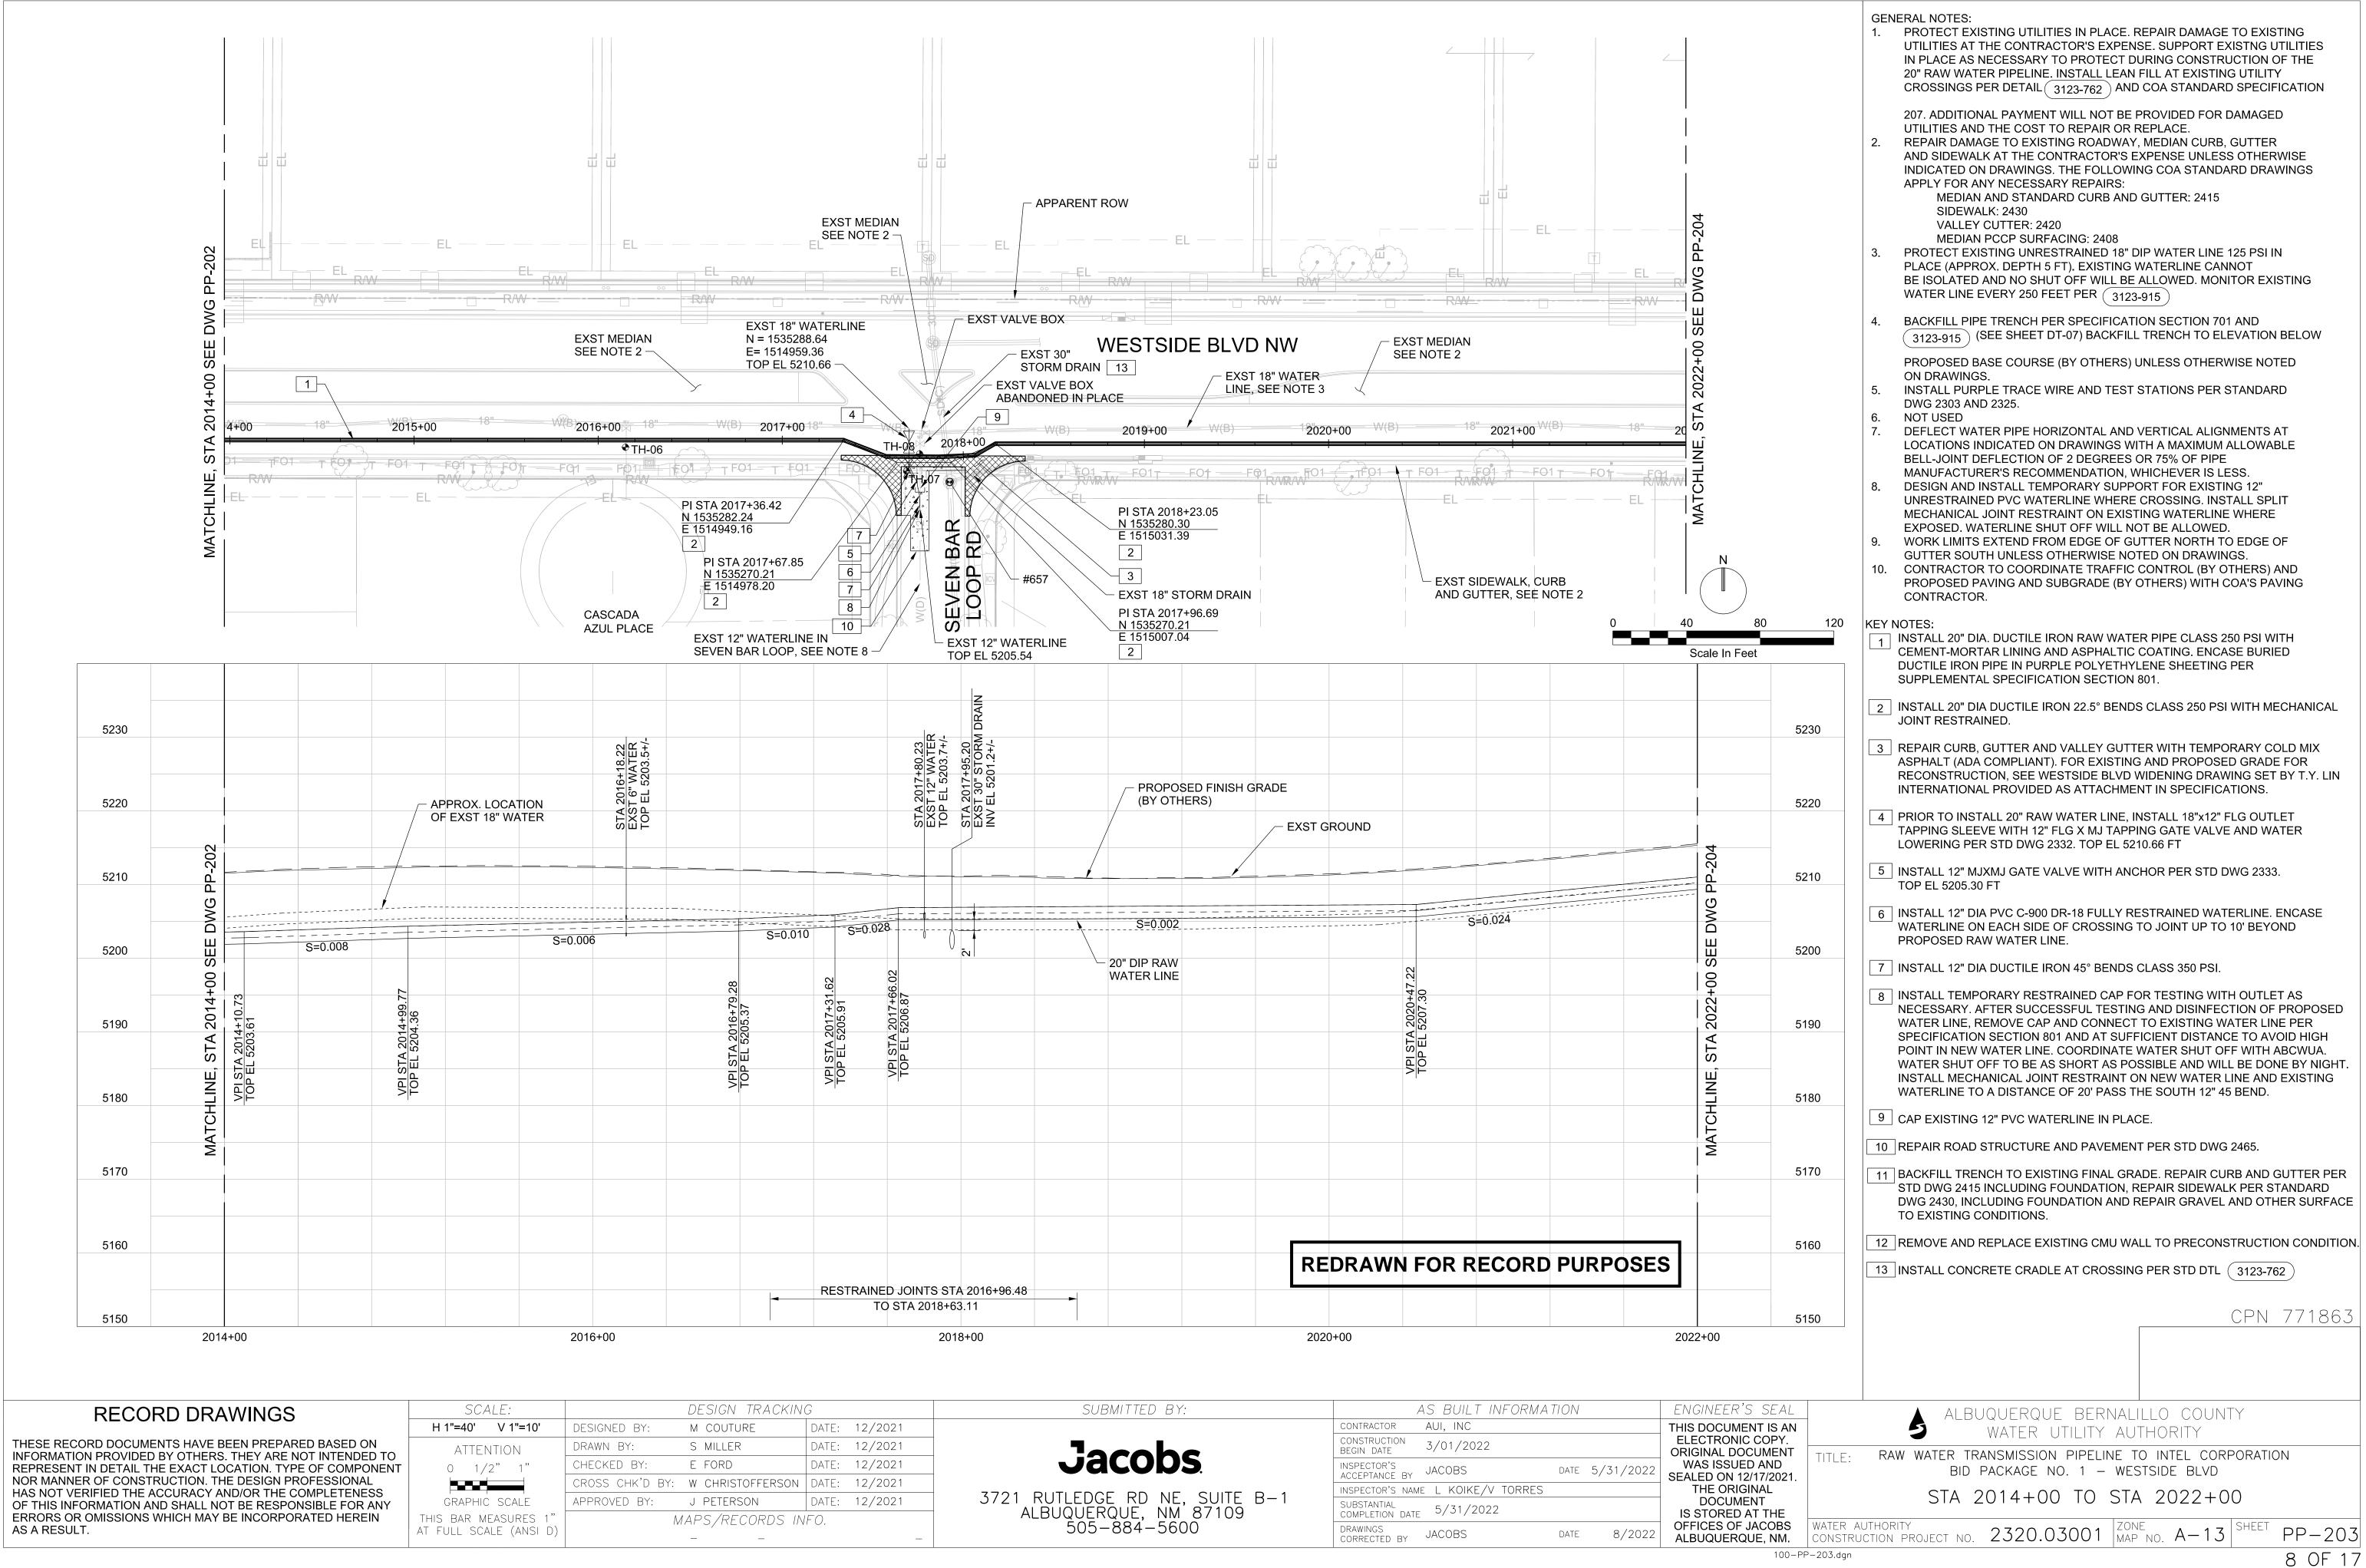


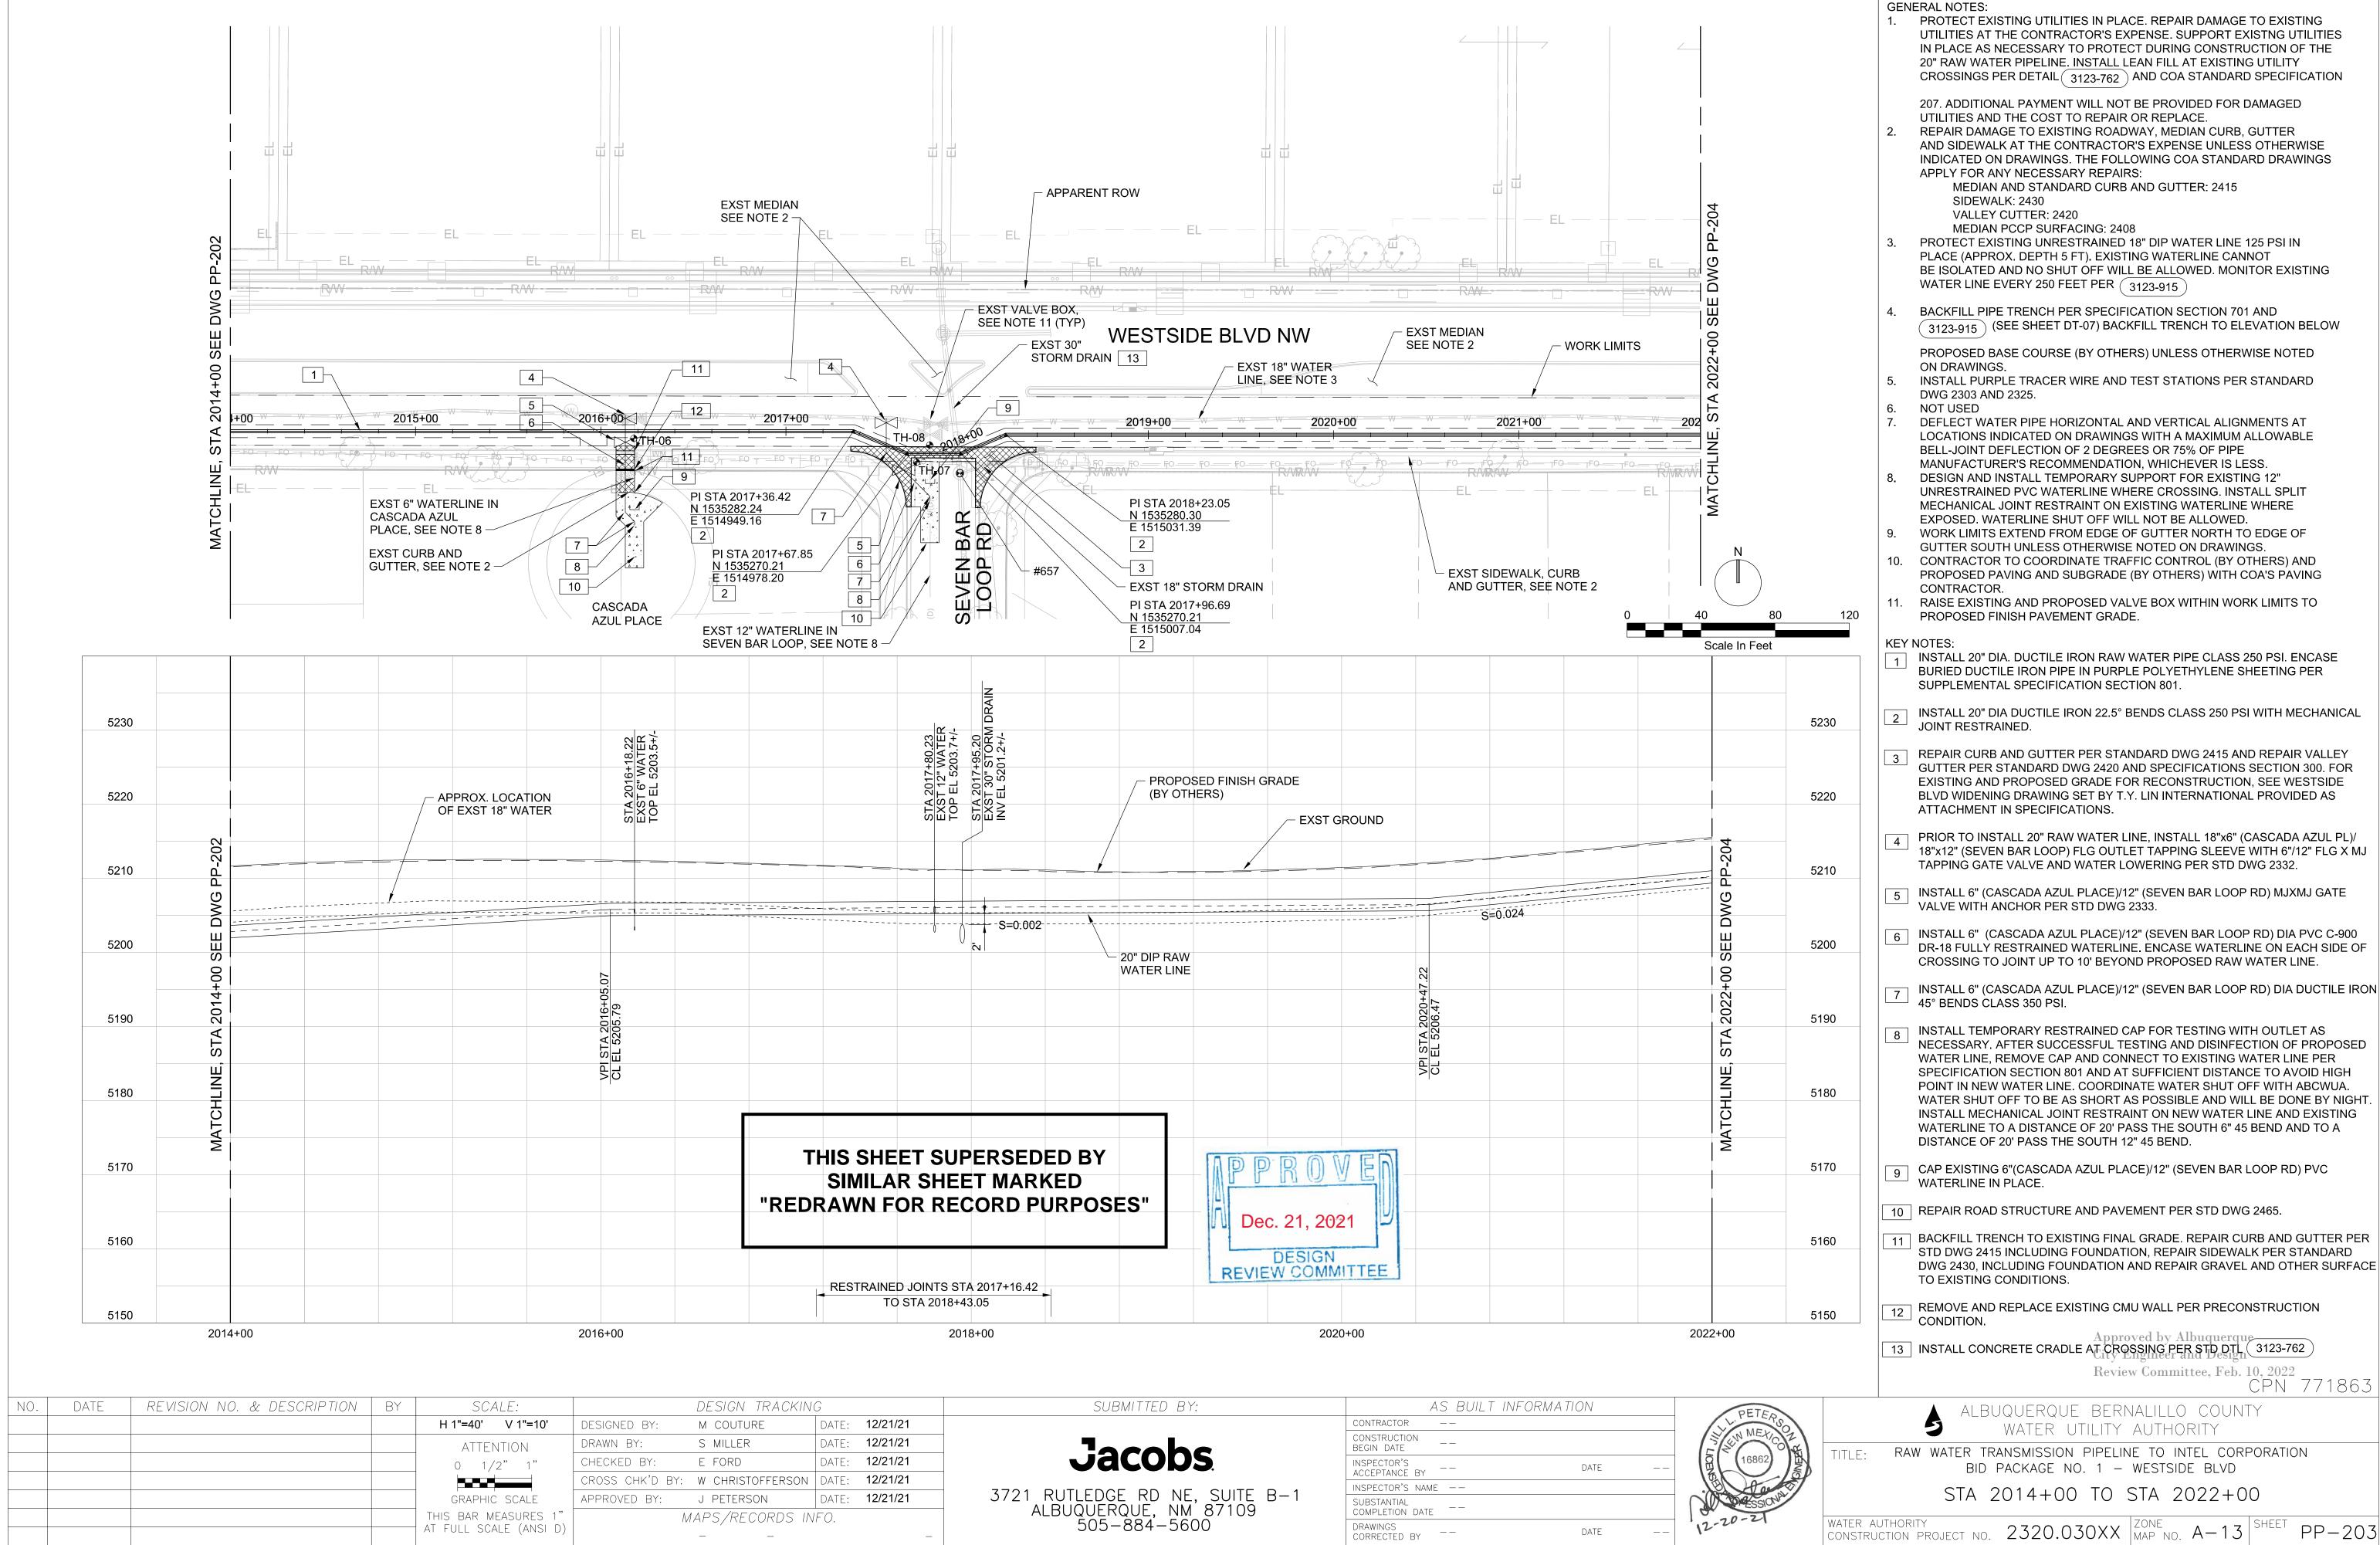


8 OF 19

100-PP-203.dgn

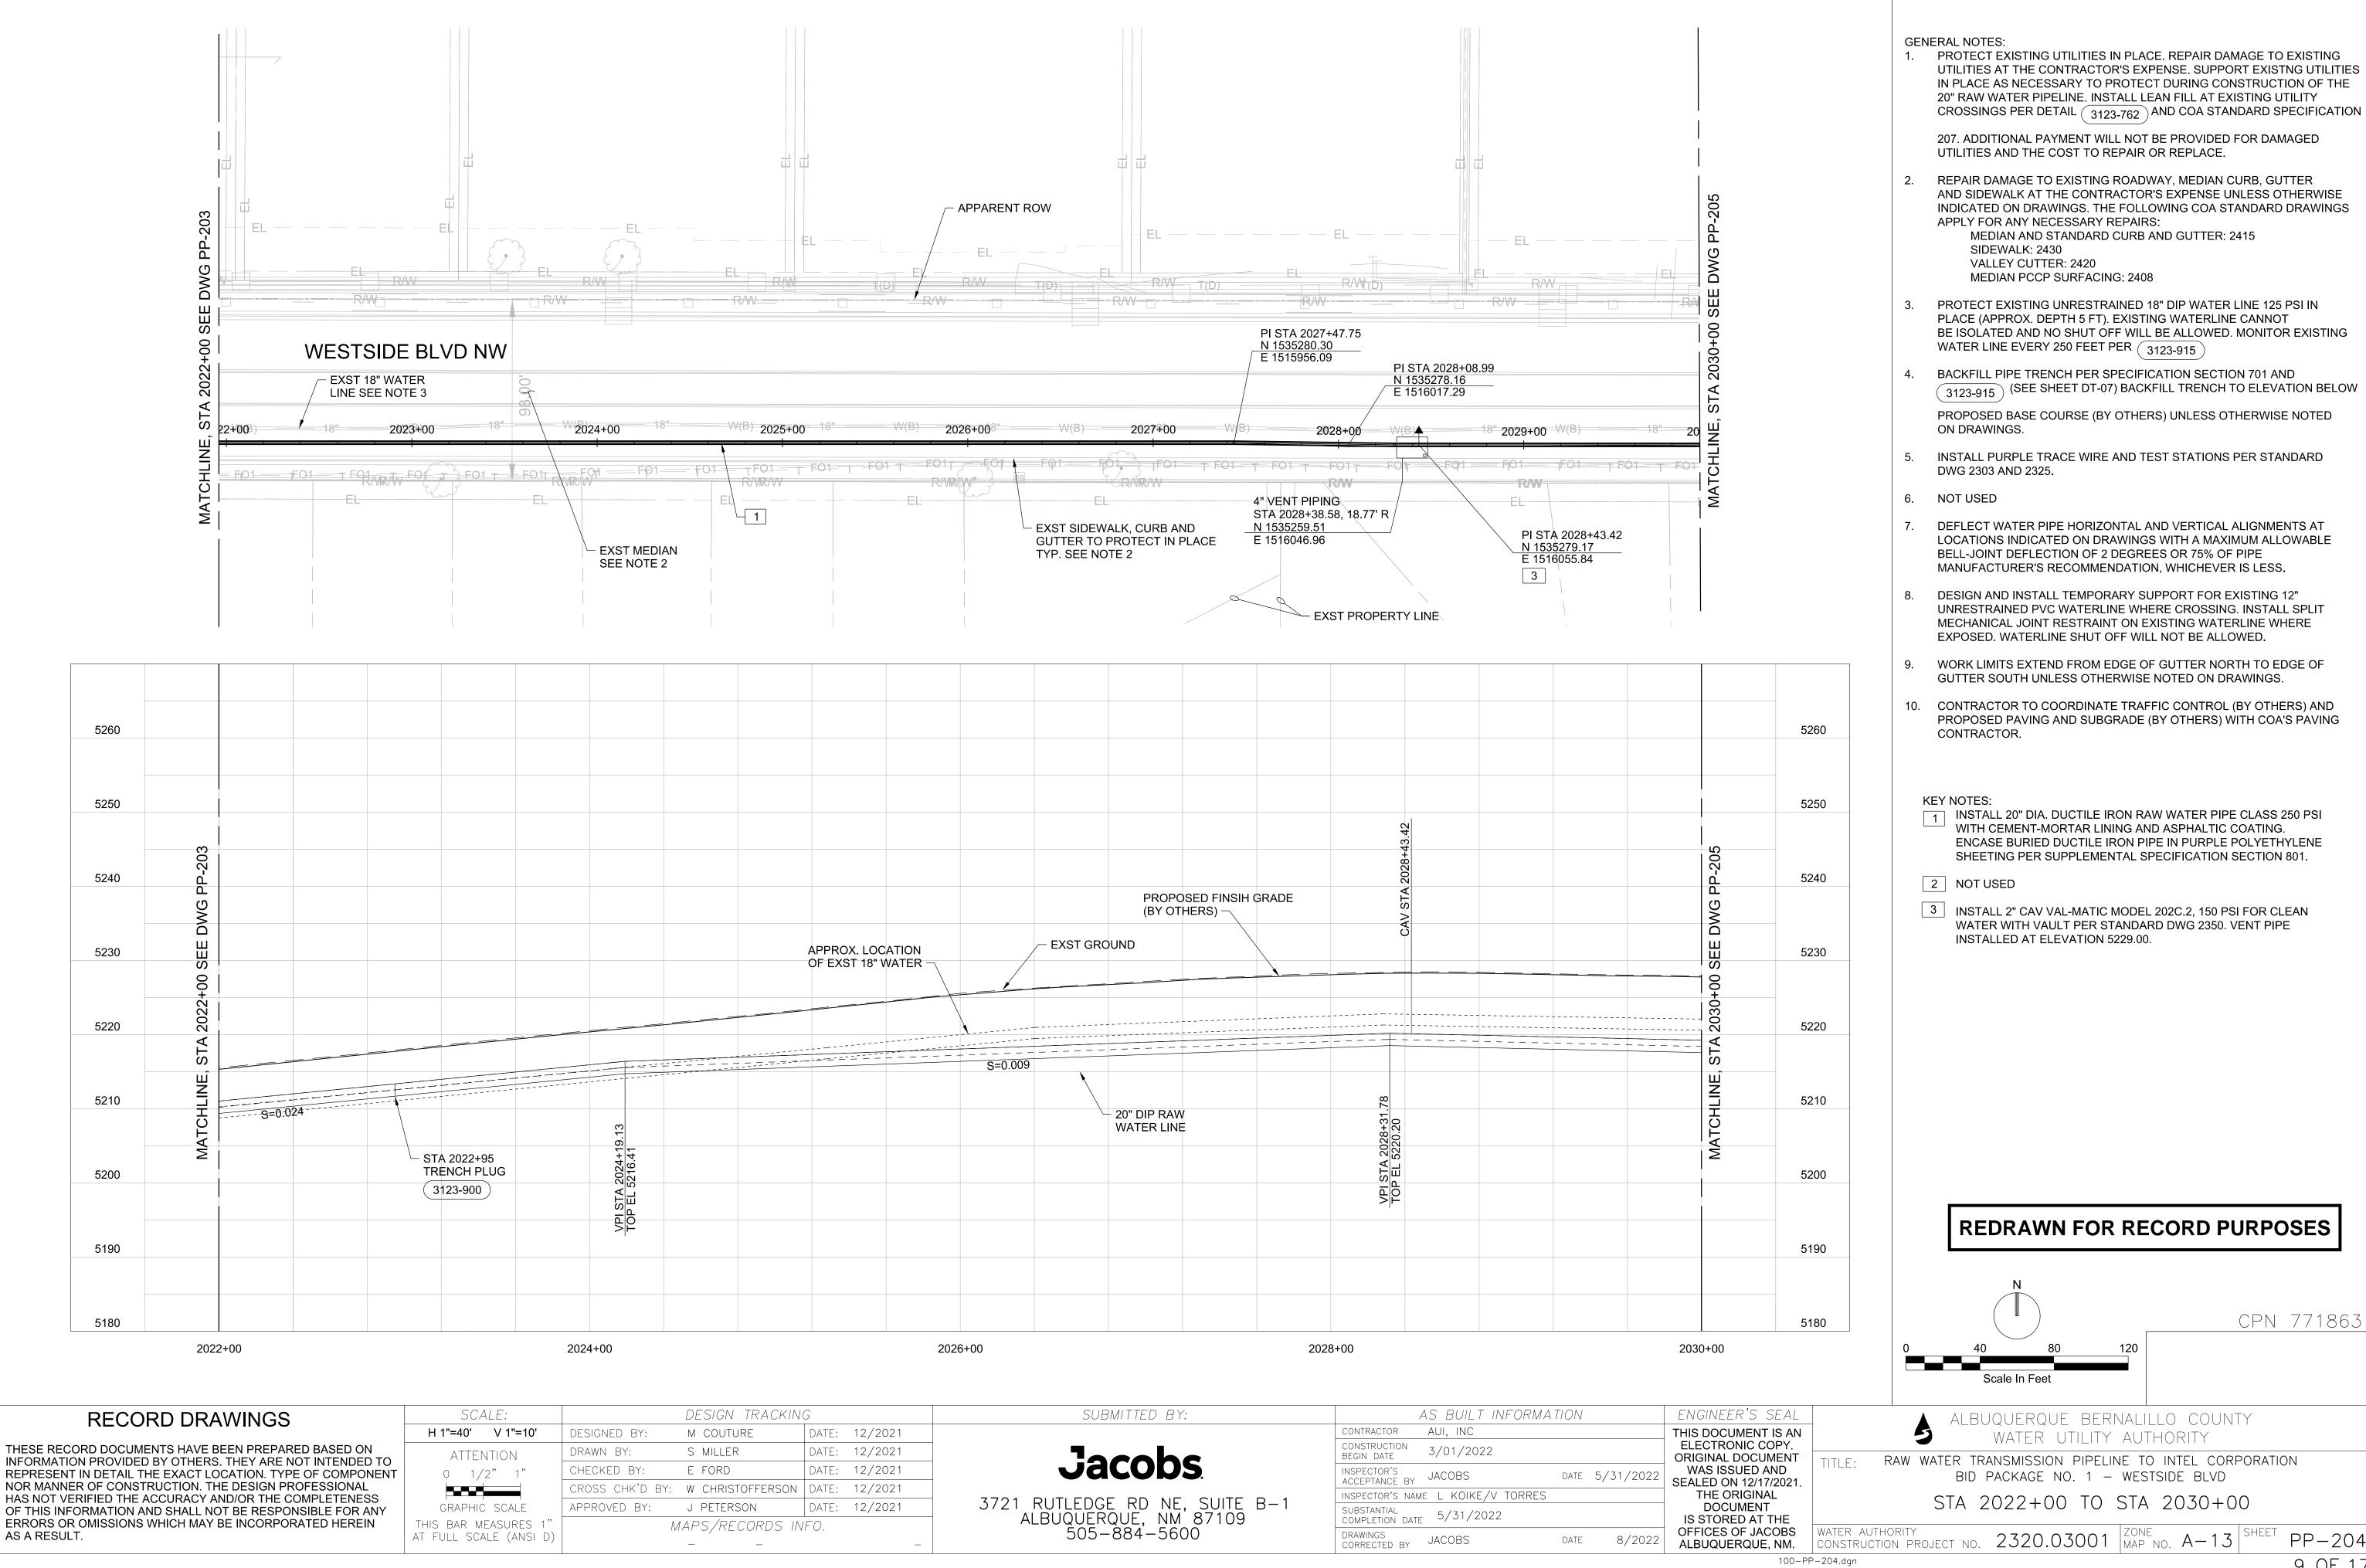

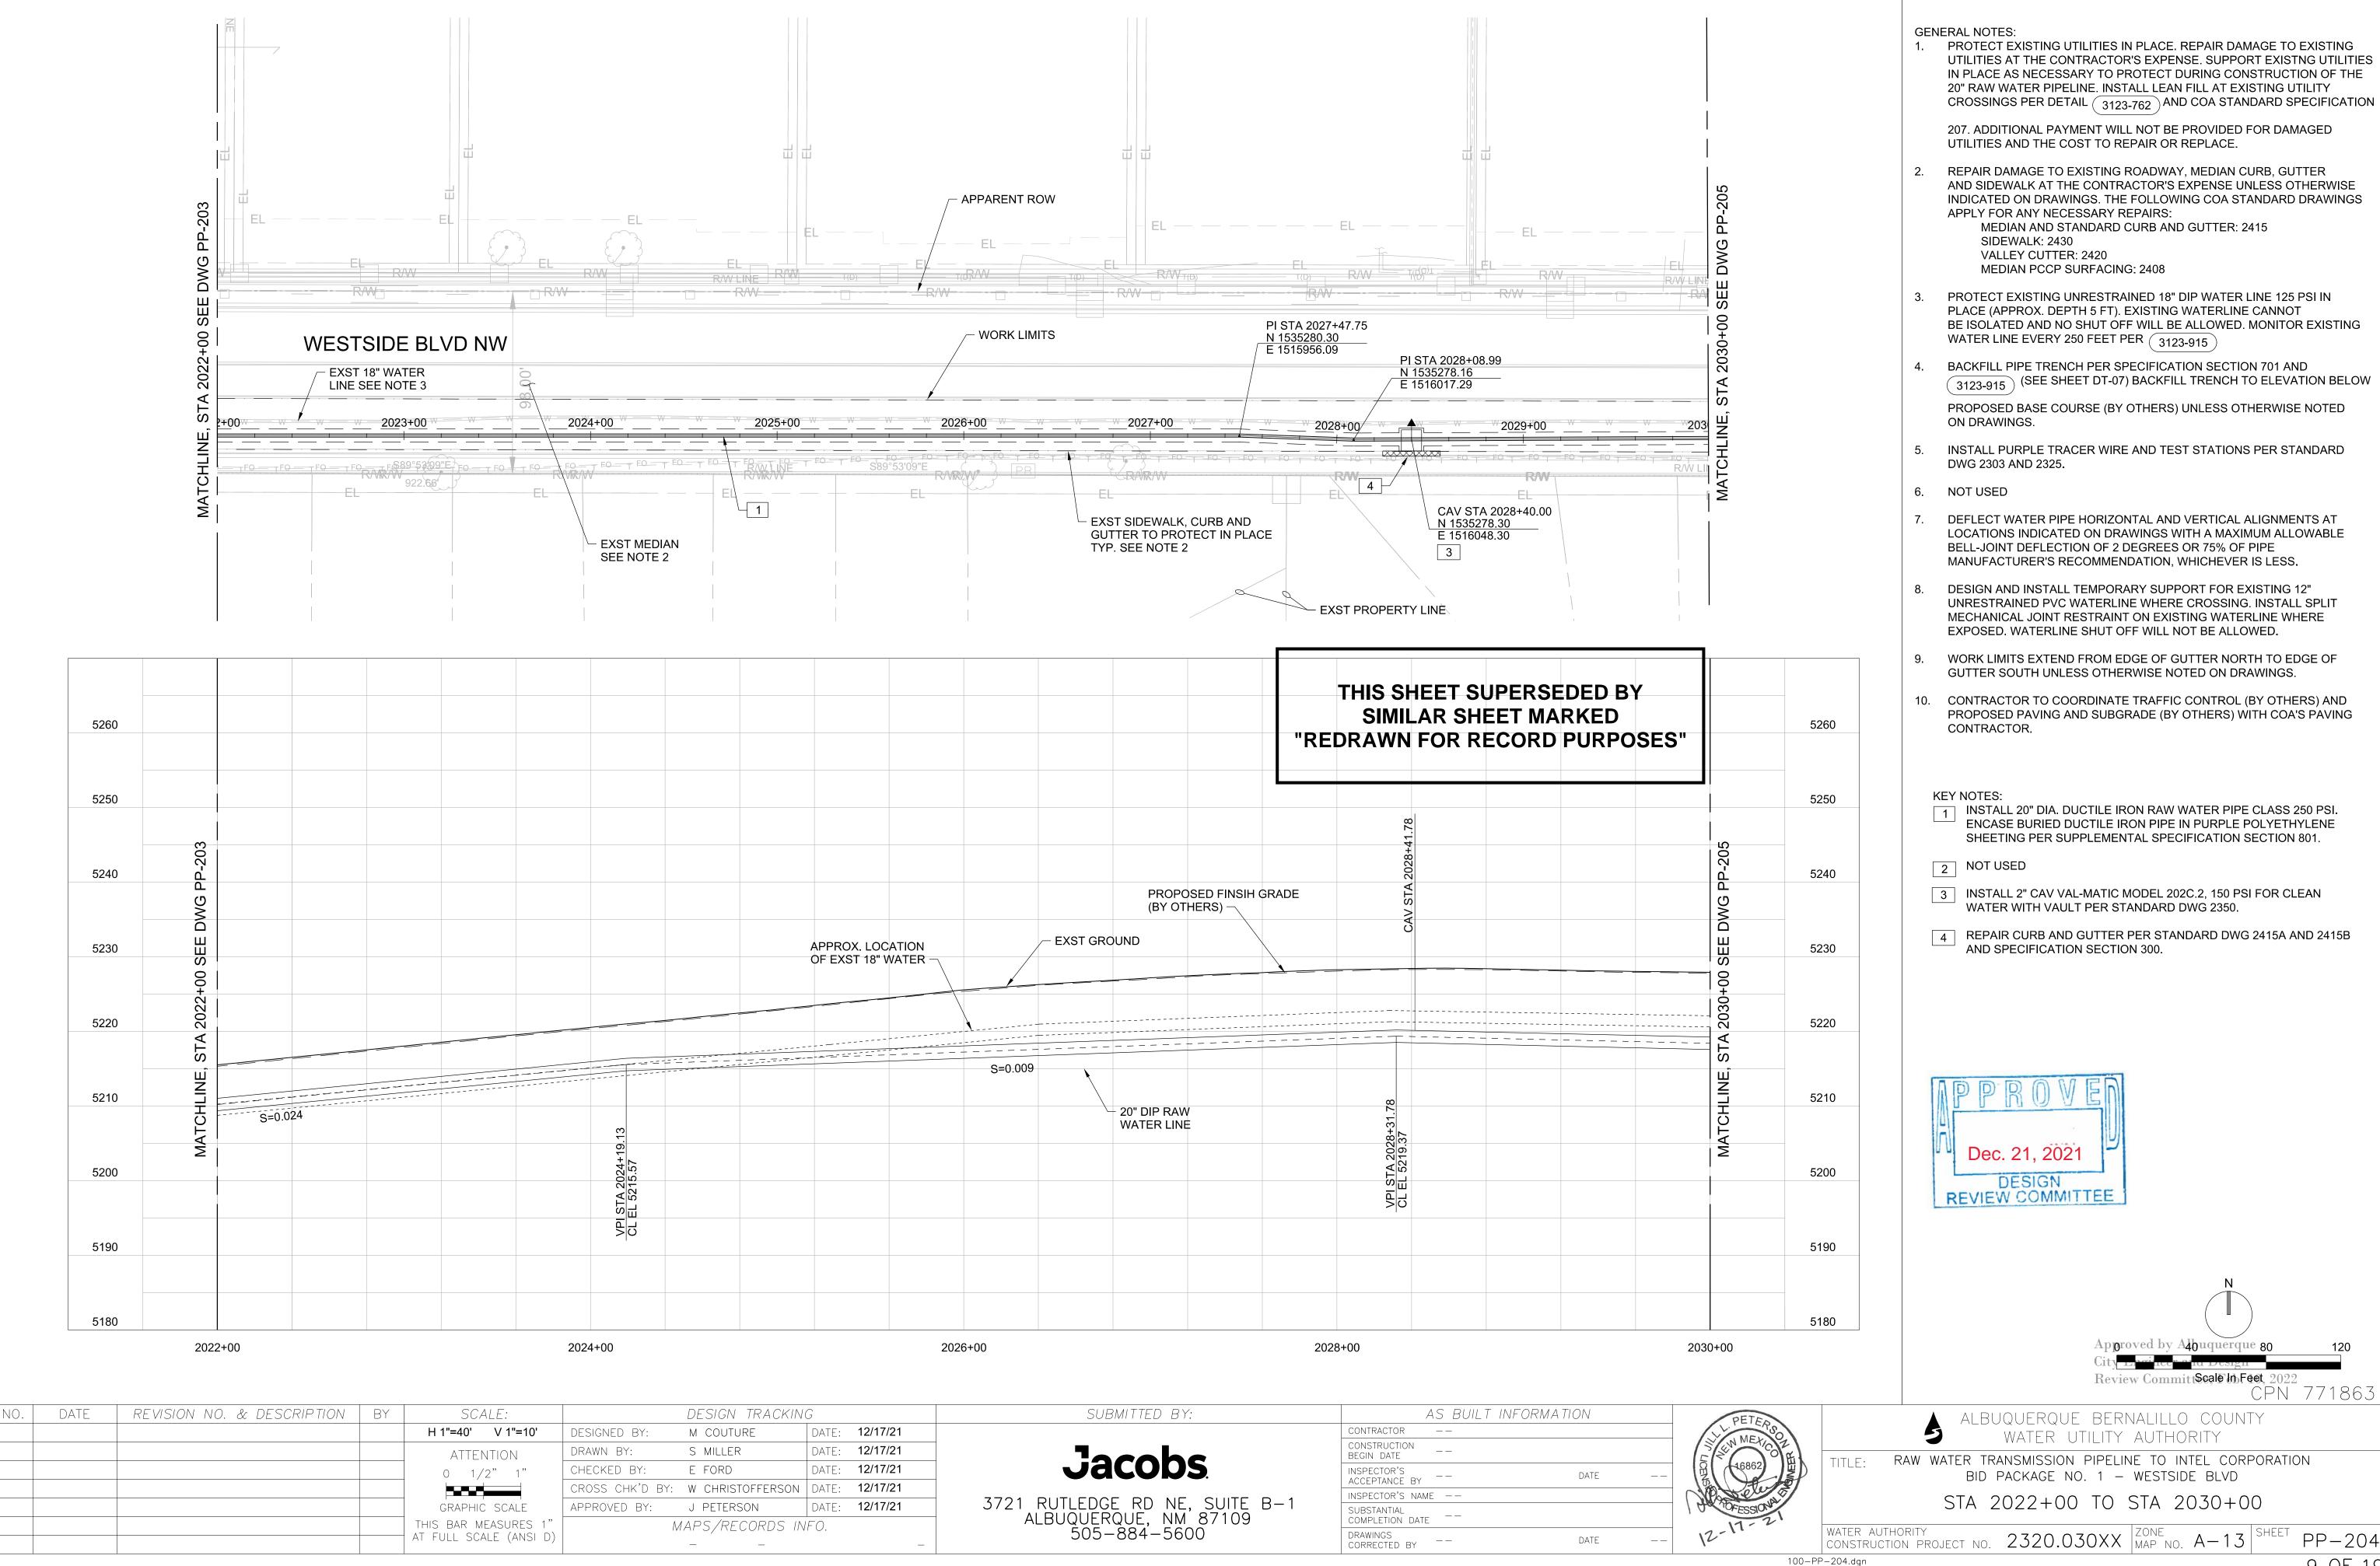

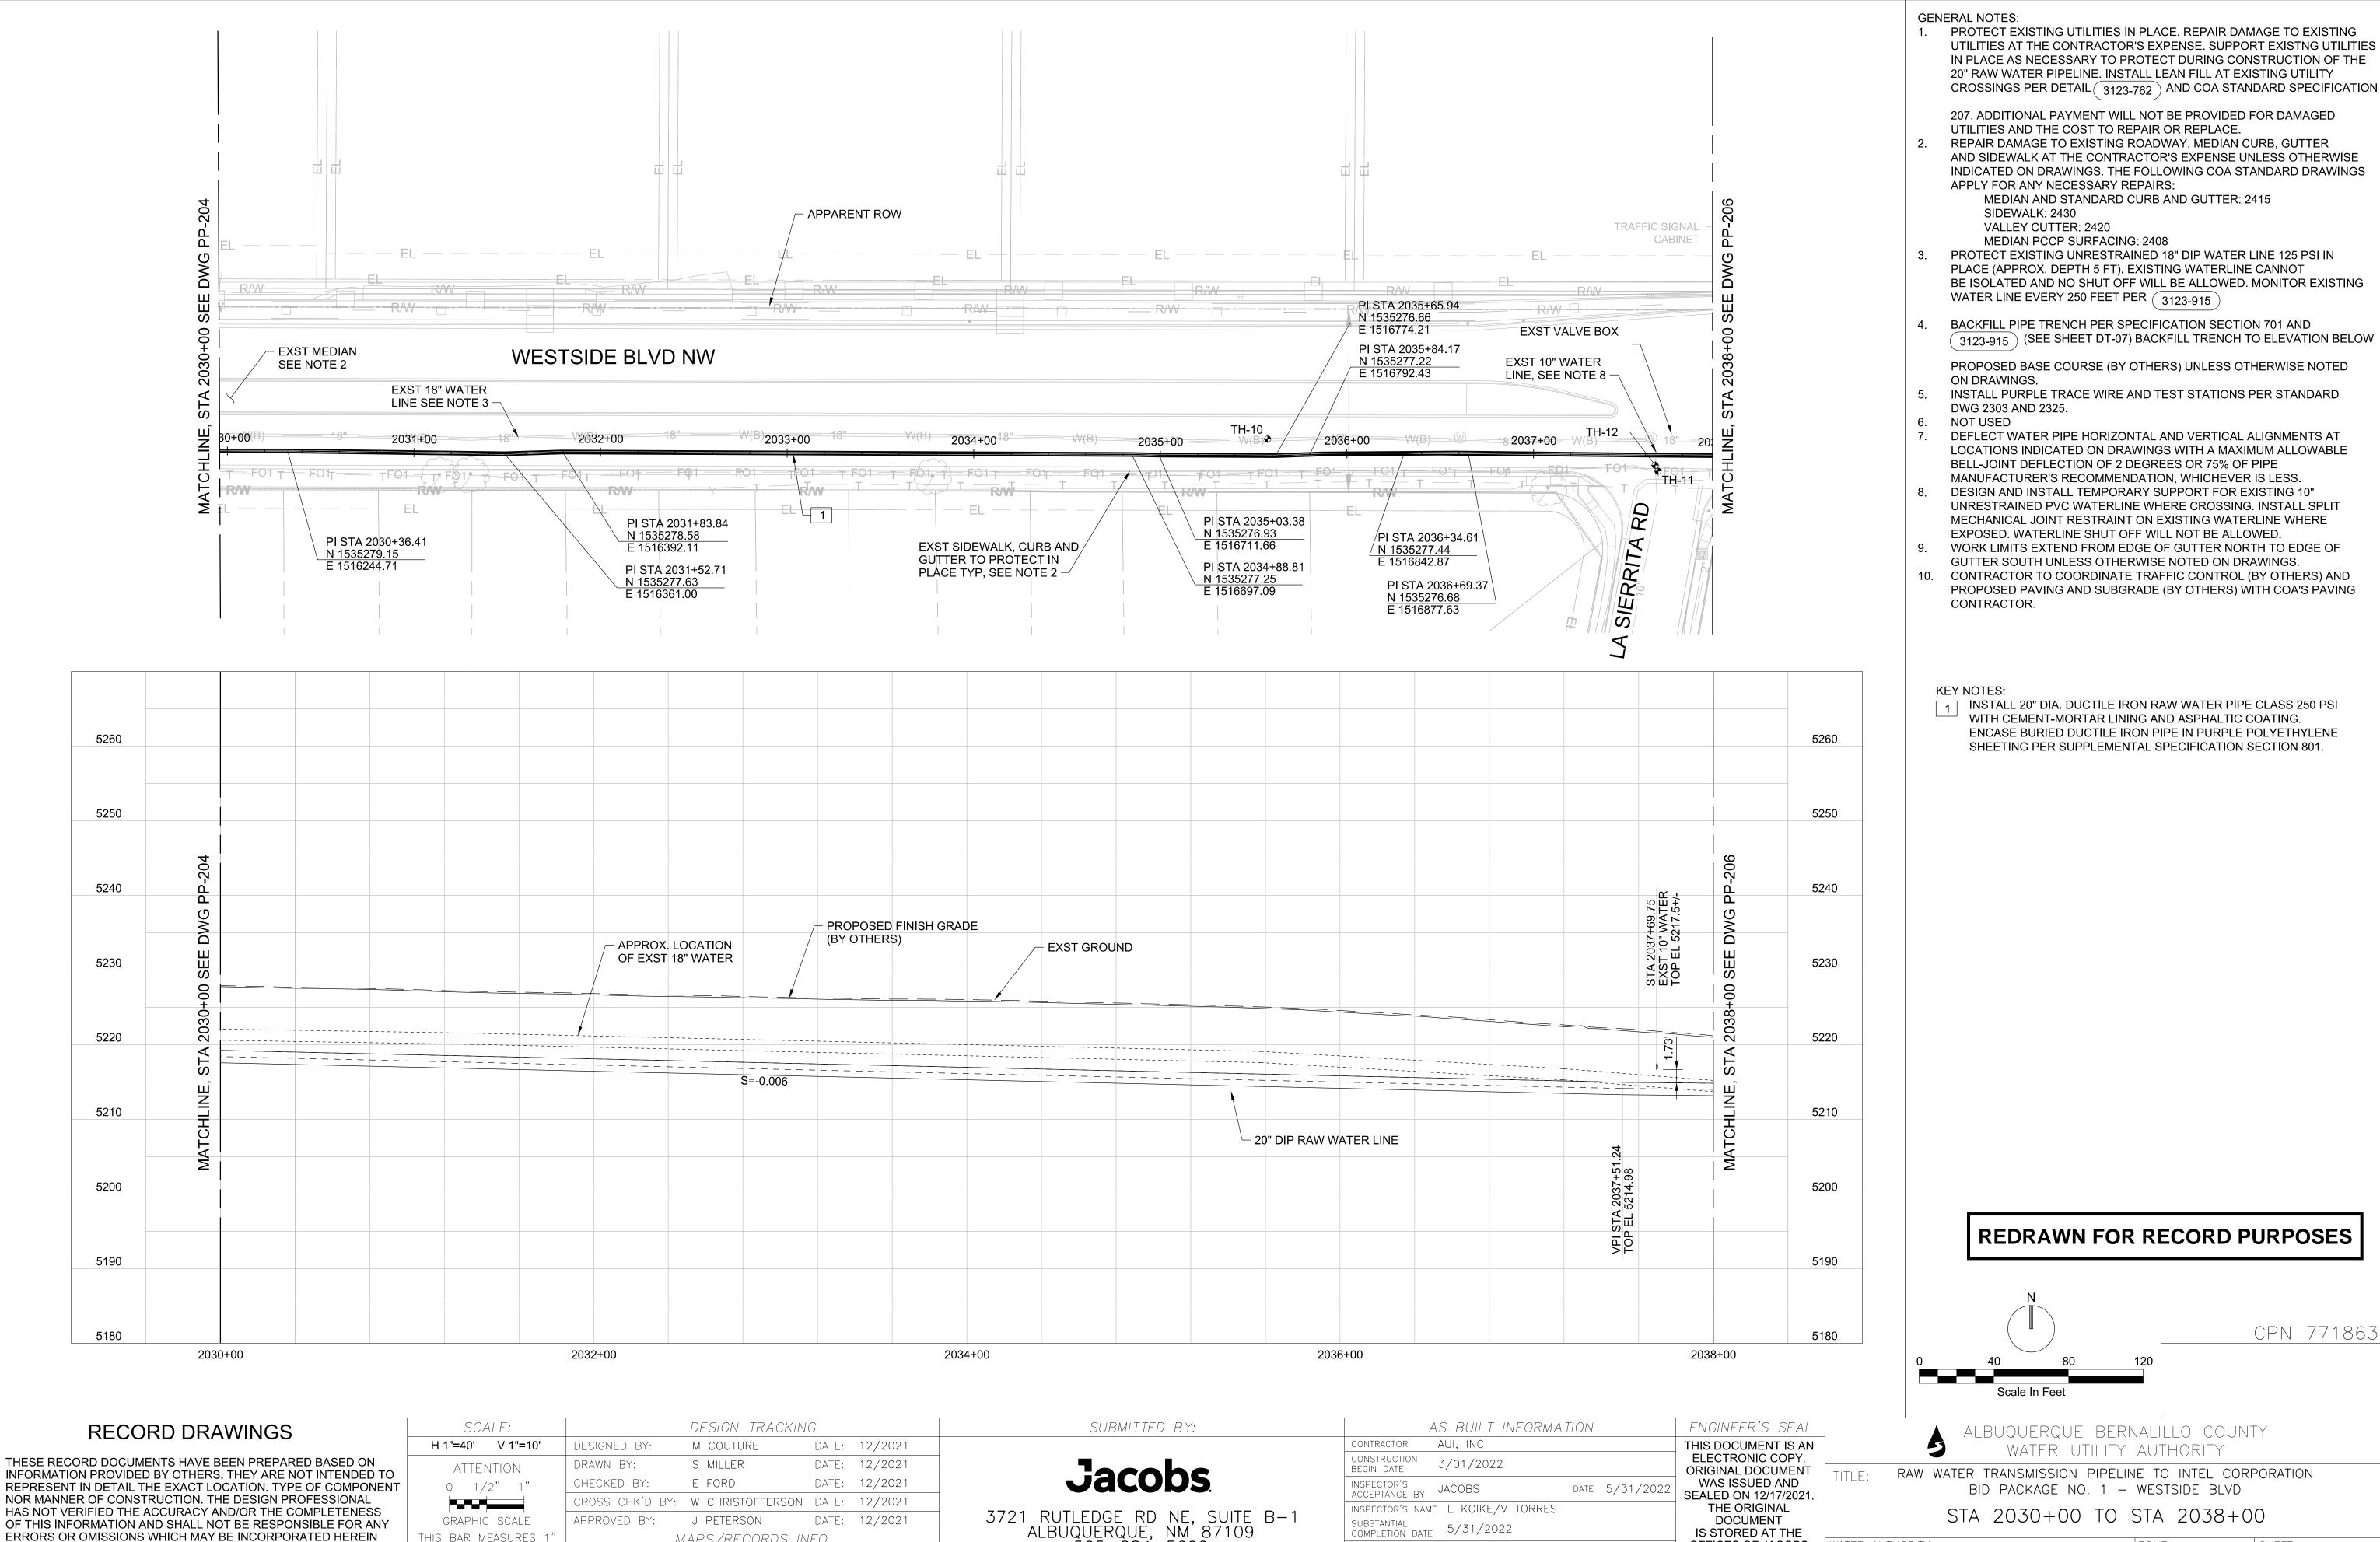

INFORMATION PROVIDED BY OTHERS. THEY ARE NOT INTENDED TO REPRESENT IN DETAIL THE EXACT LOCATION. TYPE OF COMPONENT NOR MANNER OF CONSTRUCTION. THE DESIGN PROFESSIONAL HAS NOT VERIFIED THE ACCURACY AND/OR THE COMPLETENESS

AS A RESULT.

THIS BAR MEASURES 1 AT FULL SCALE (ANSI D) MAPS/RECORDS INFO.


3721 RUTLEDGE RD NE, SUITE B-1 ALBUQUERQUE, NM 87109 505-884-5600


OFFICES OF JACOBS CORRECTED BY JACOBS


DATE


ALBUQUERQUE, NM.


WATER AUTHORITY water authority construction project no. 2320.03001 map no. A-13

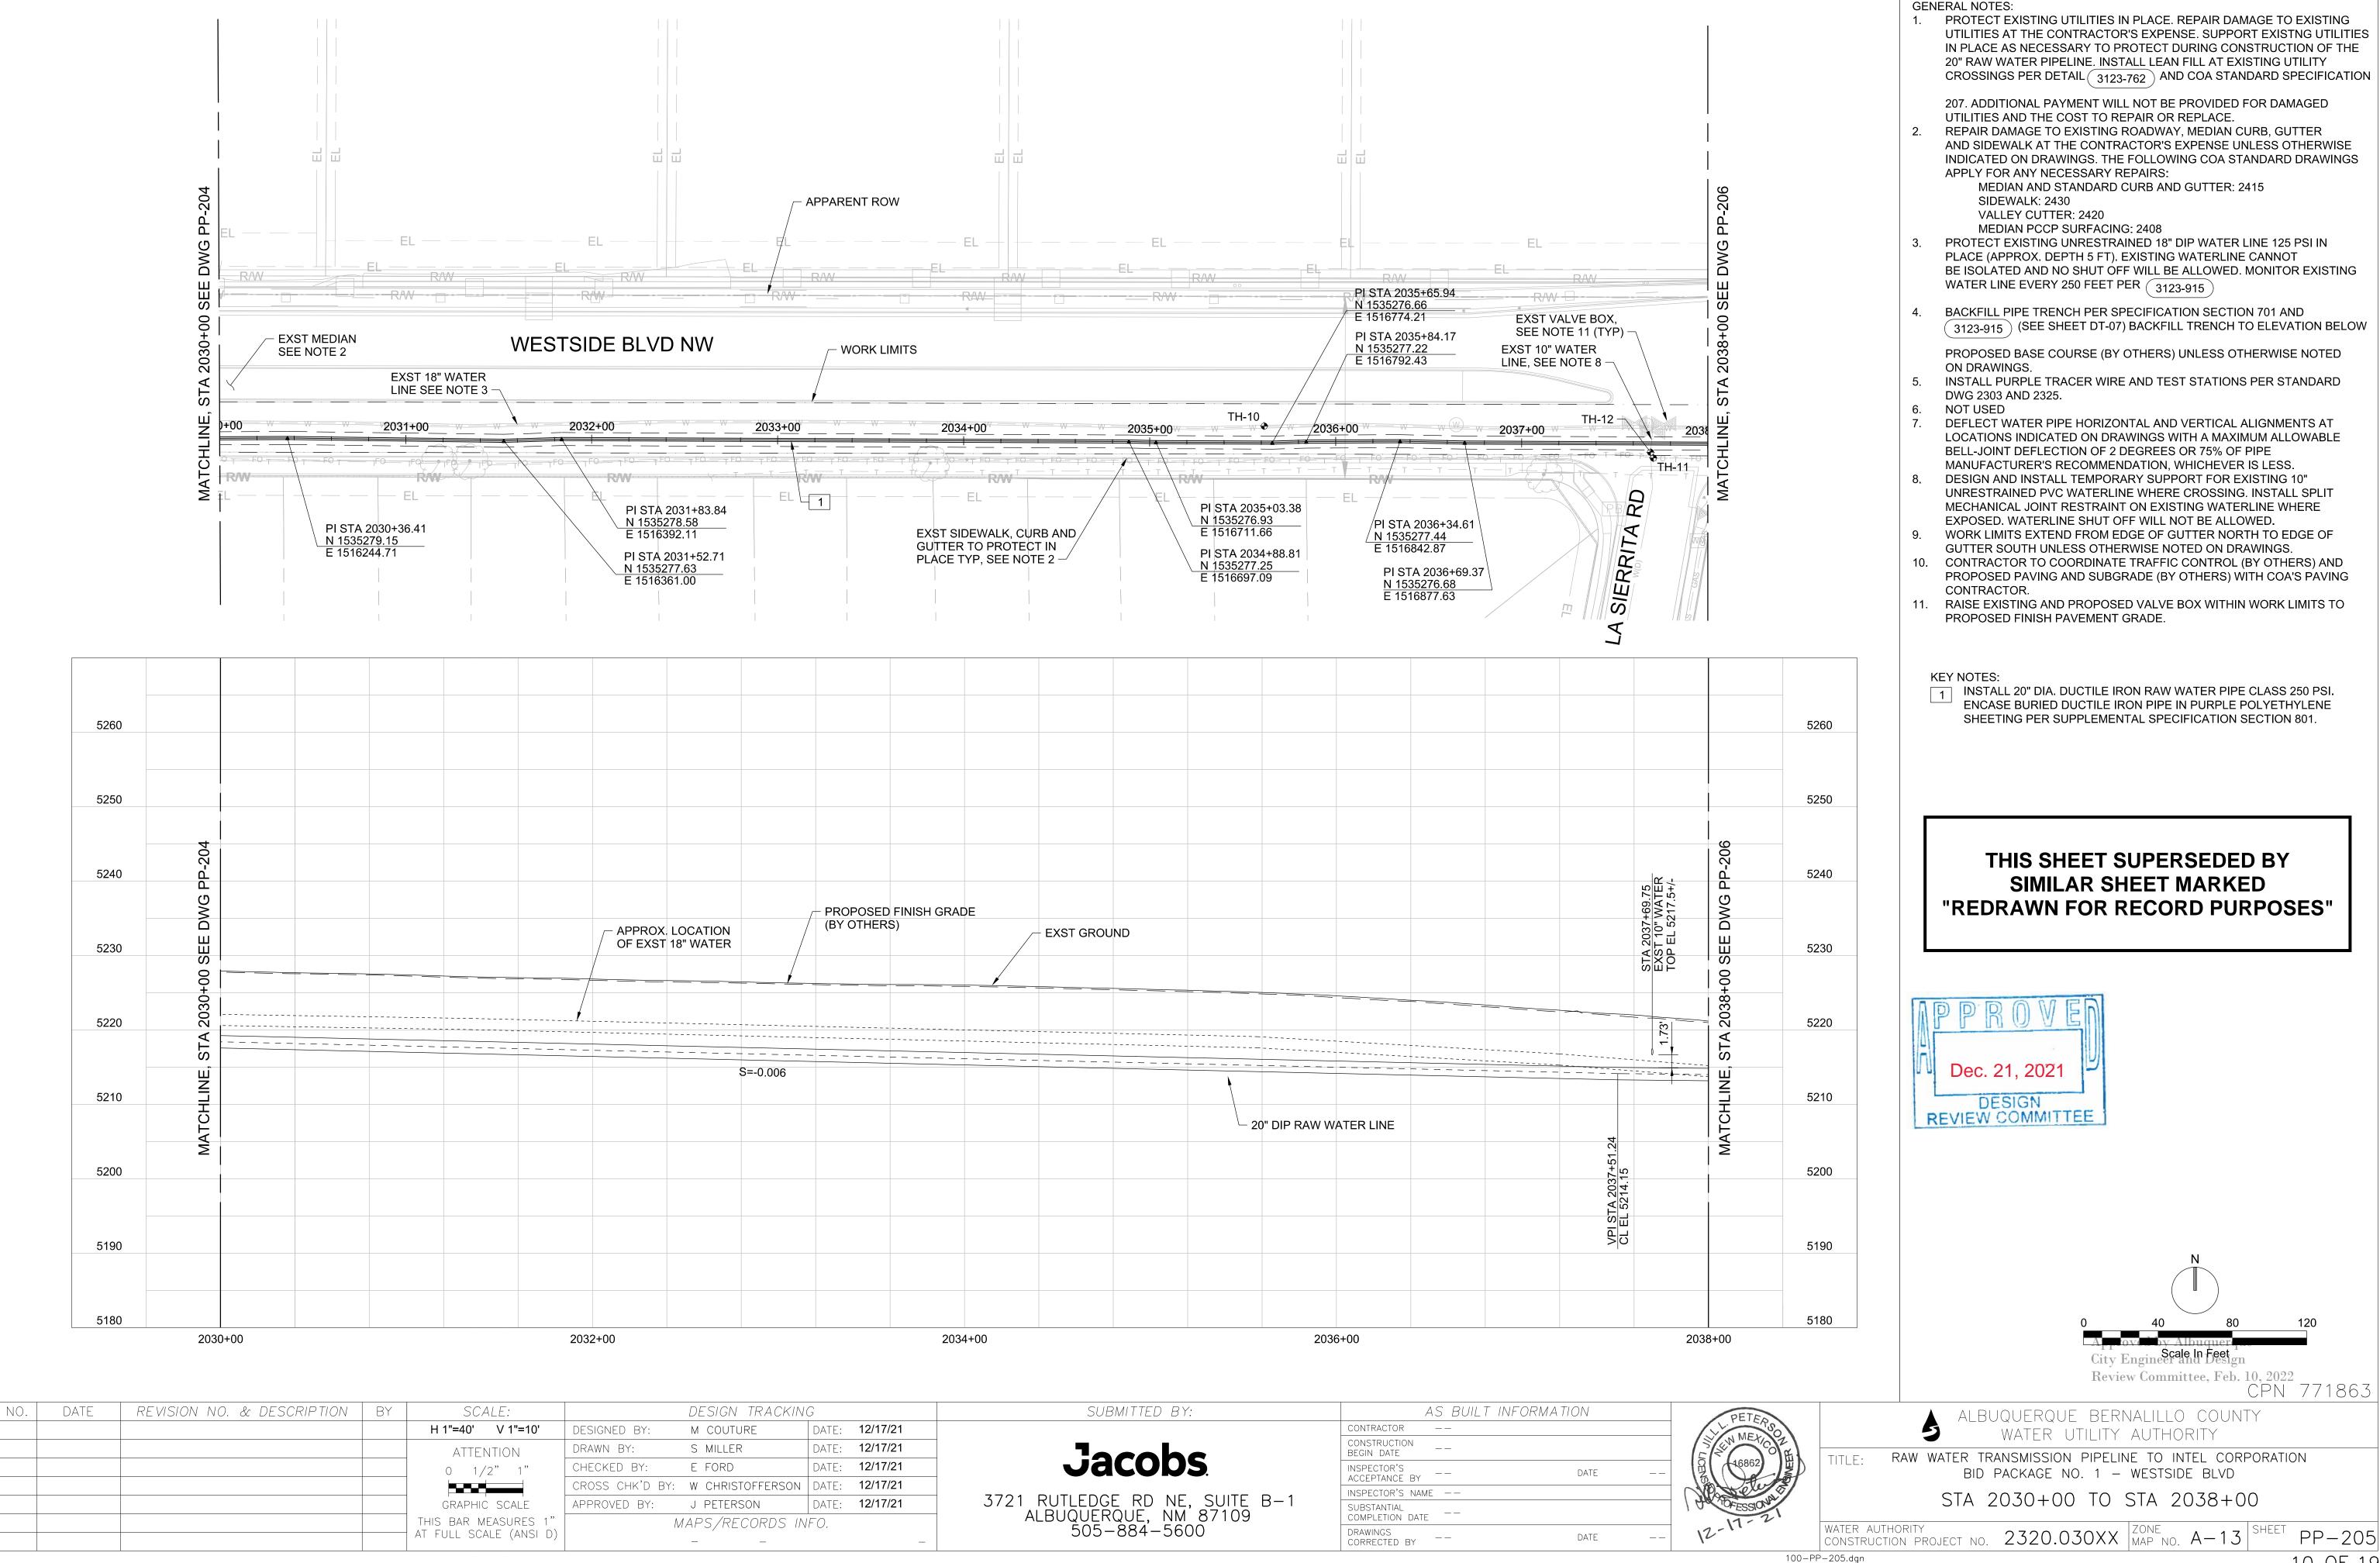

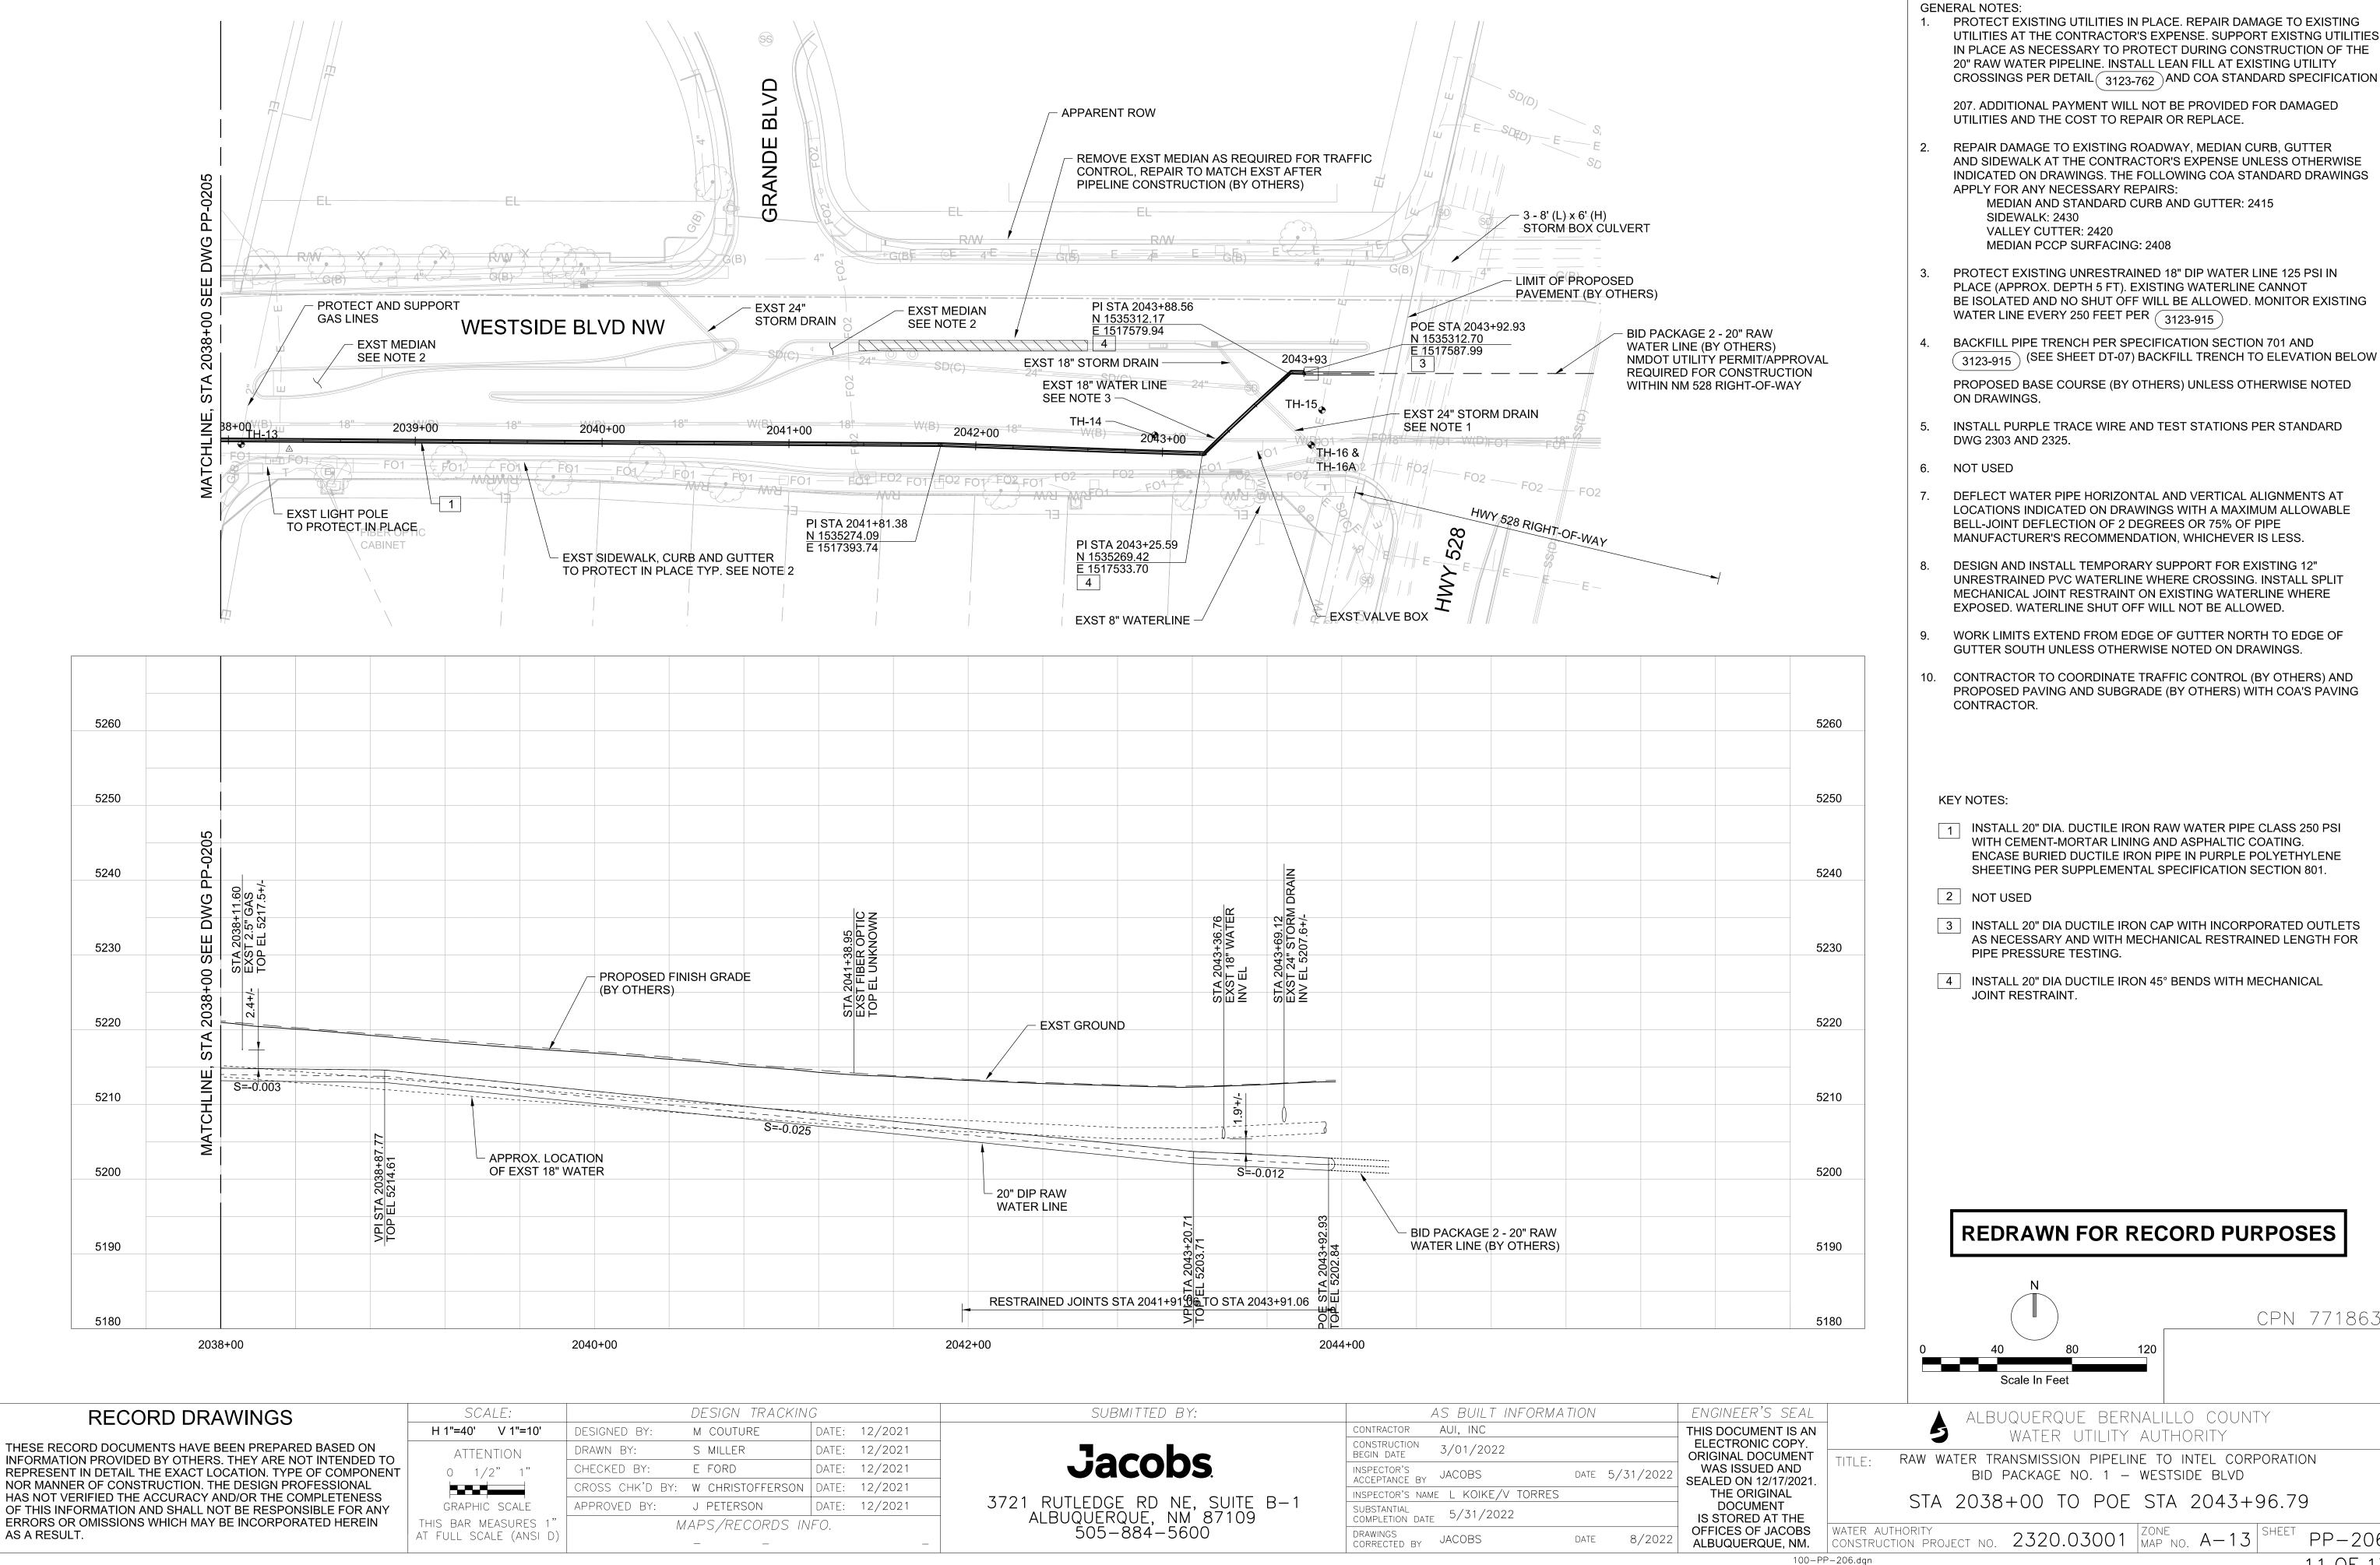


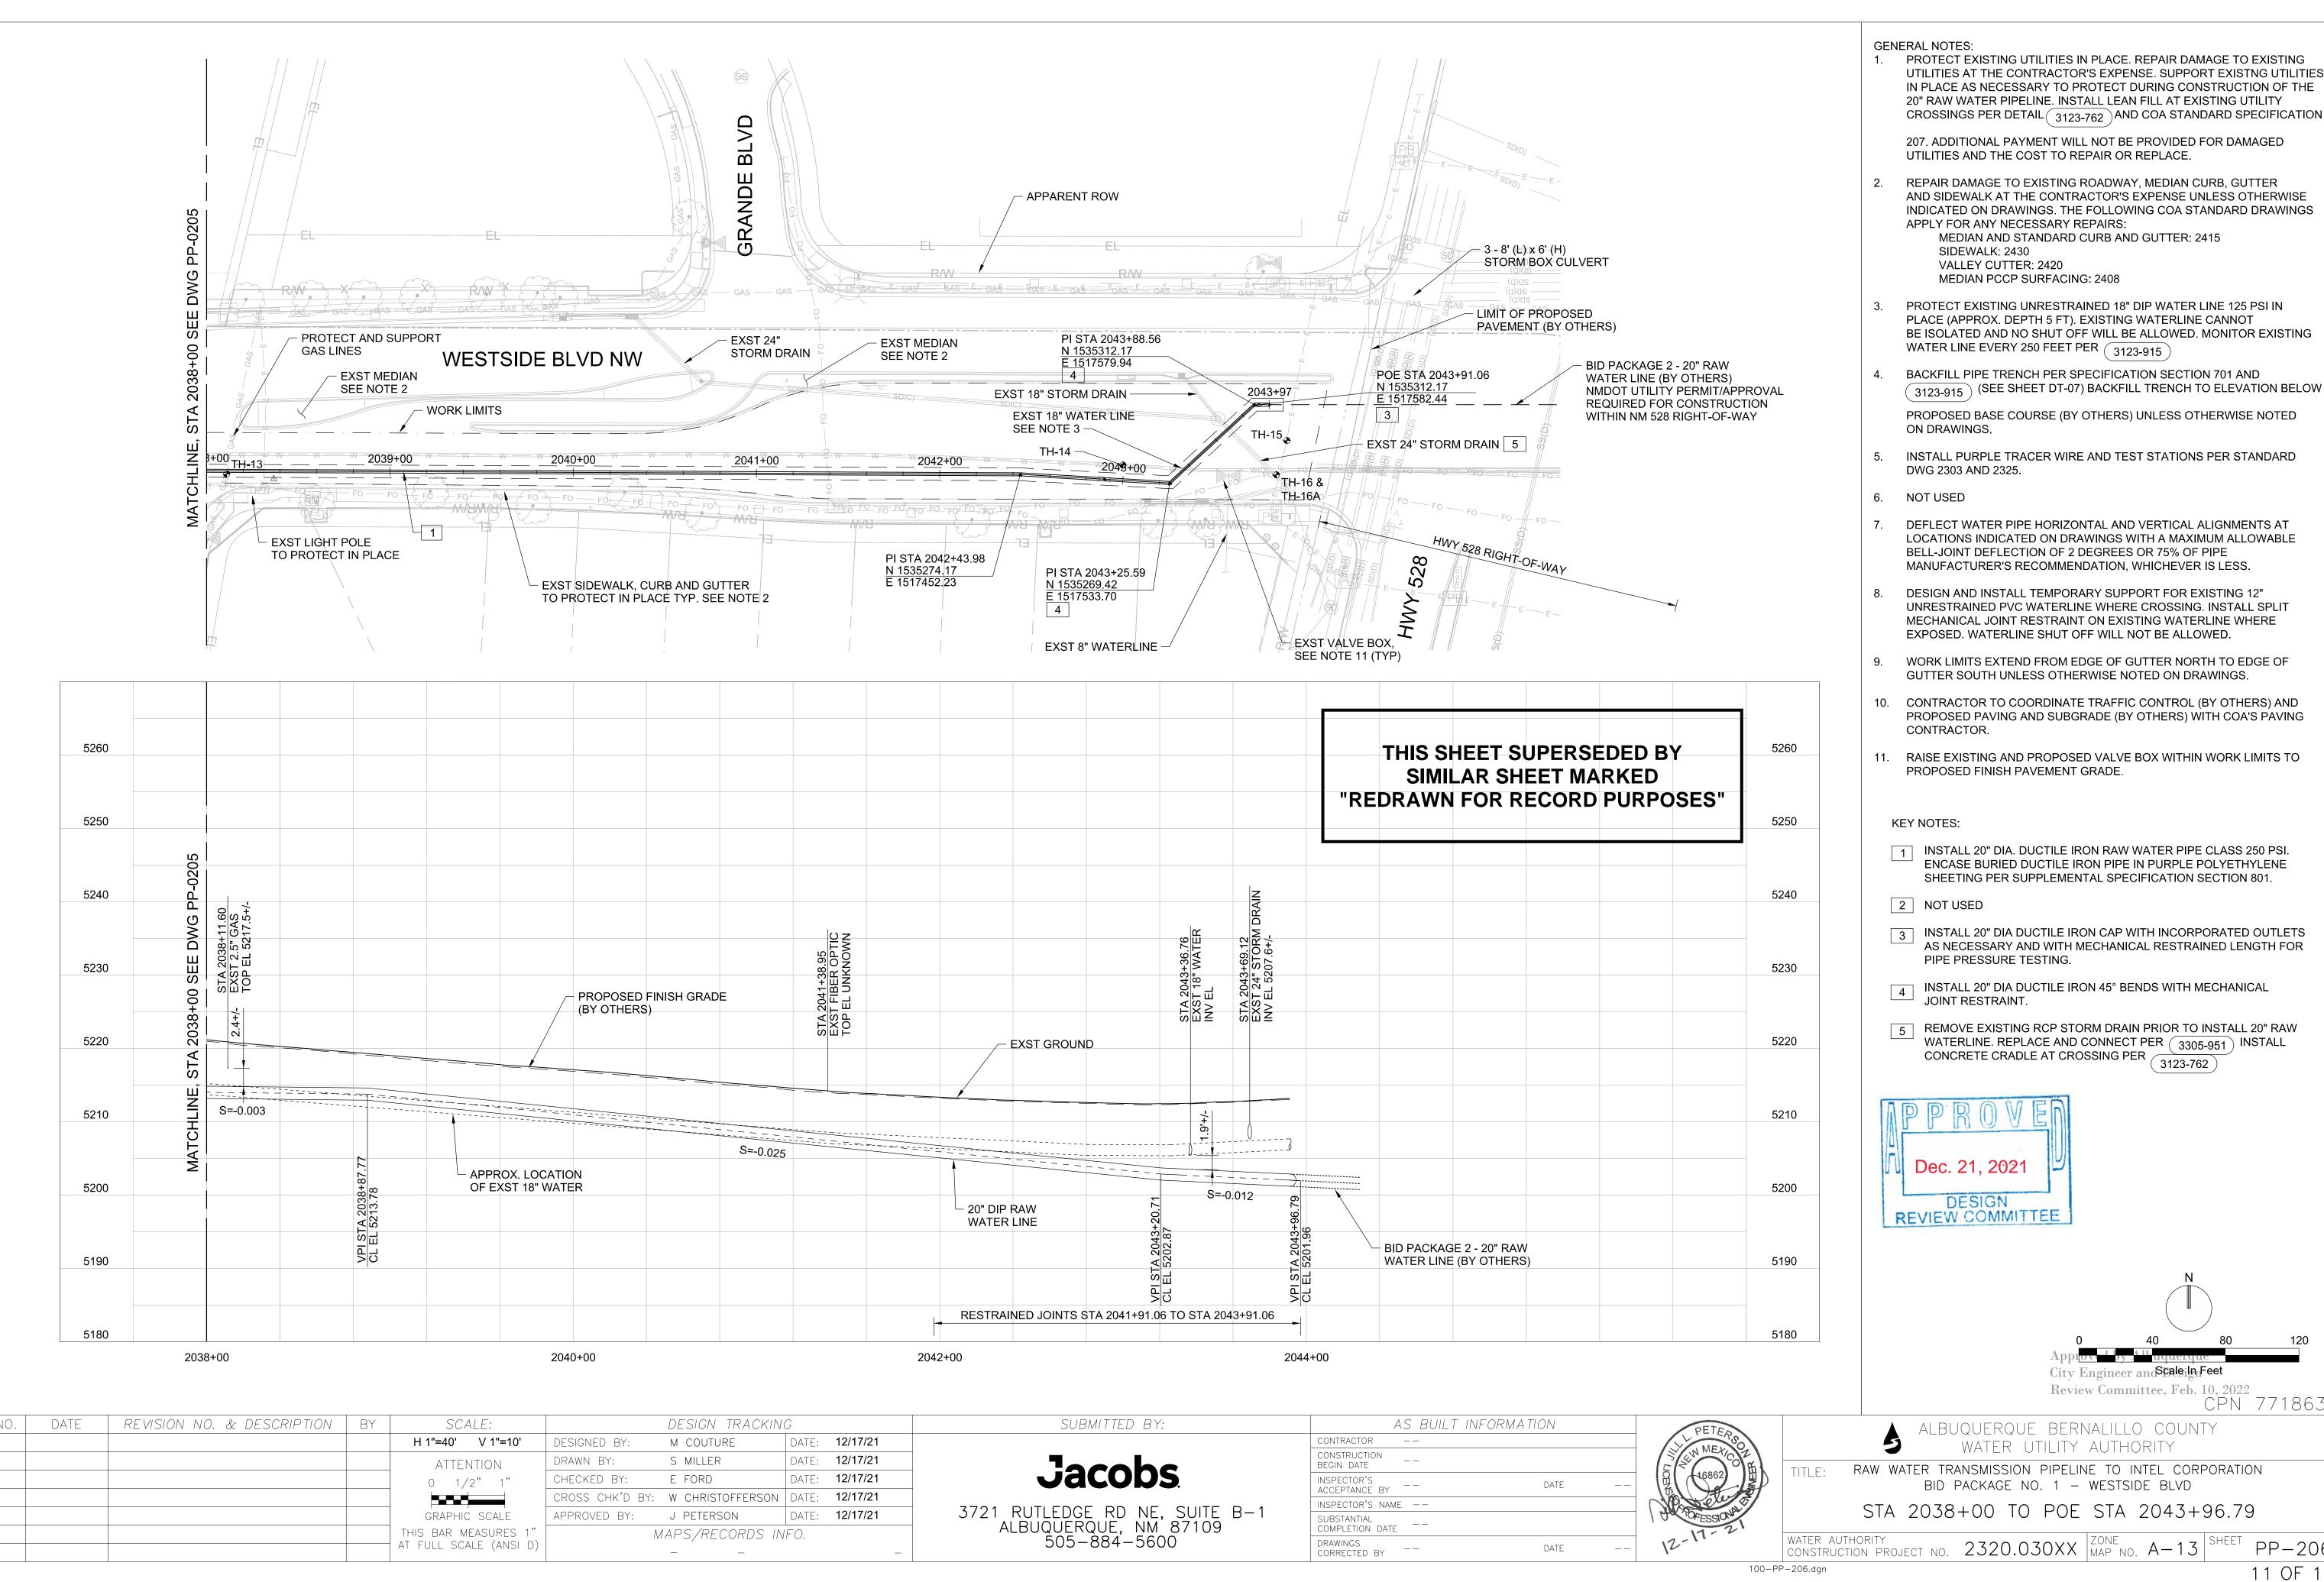


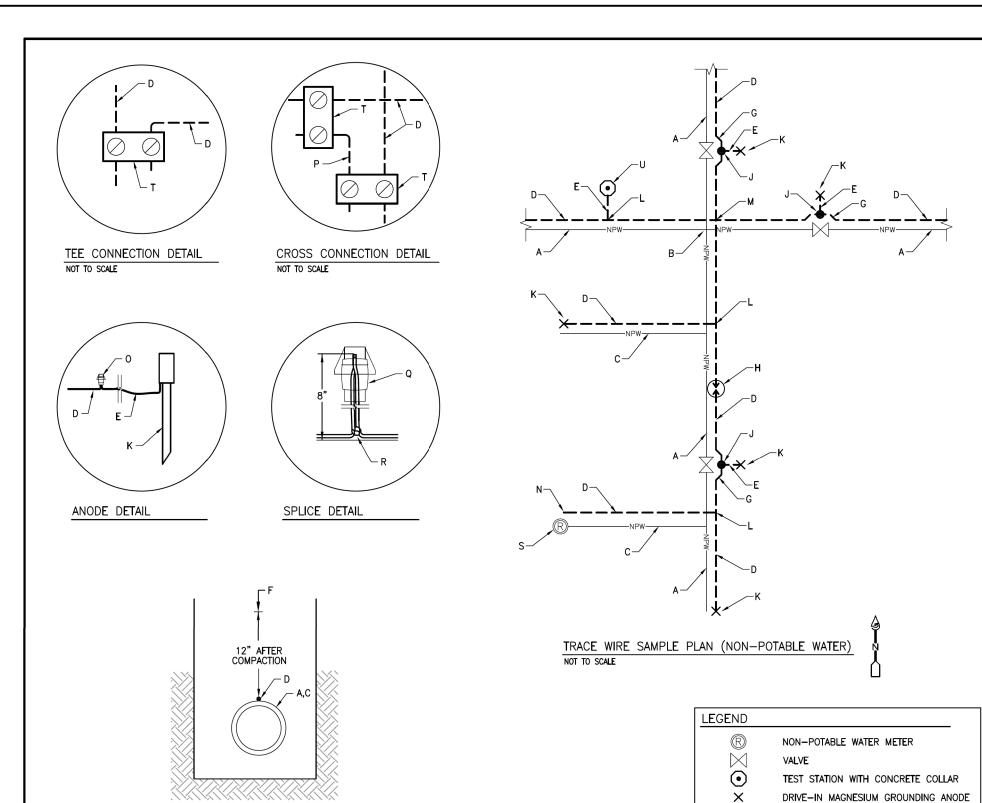

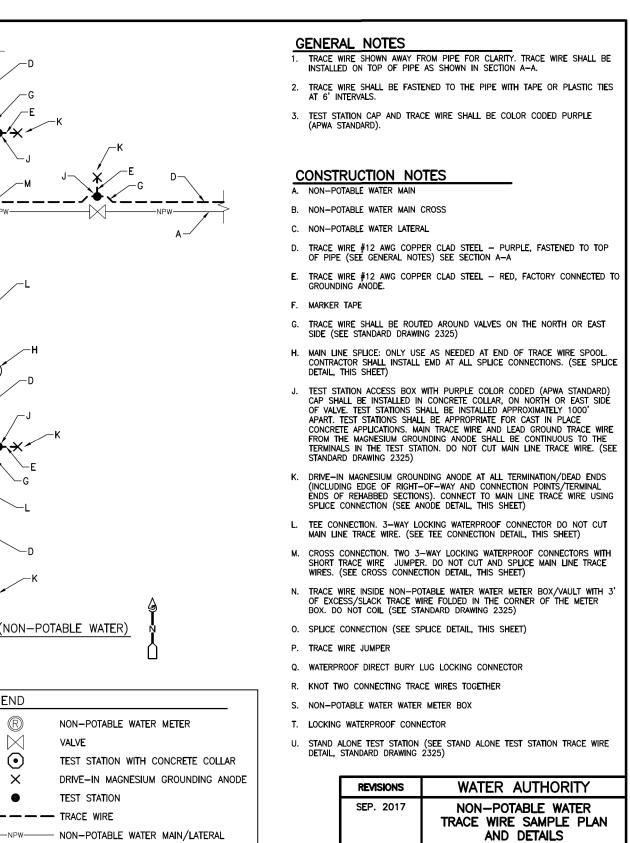


DWG. 2303

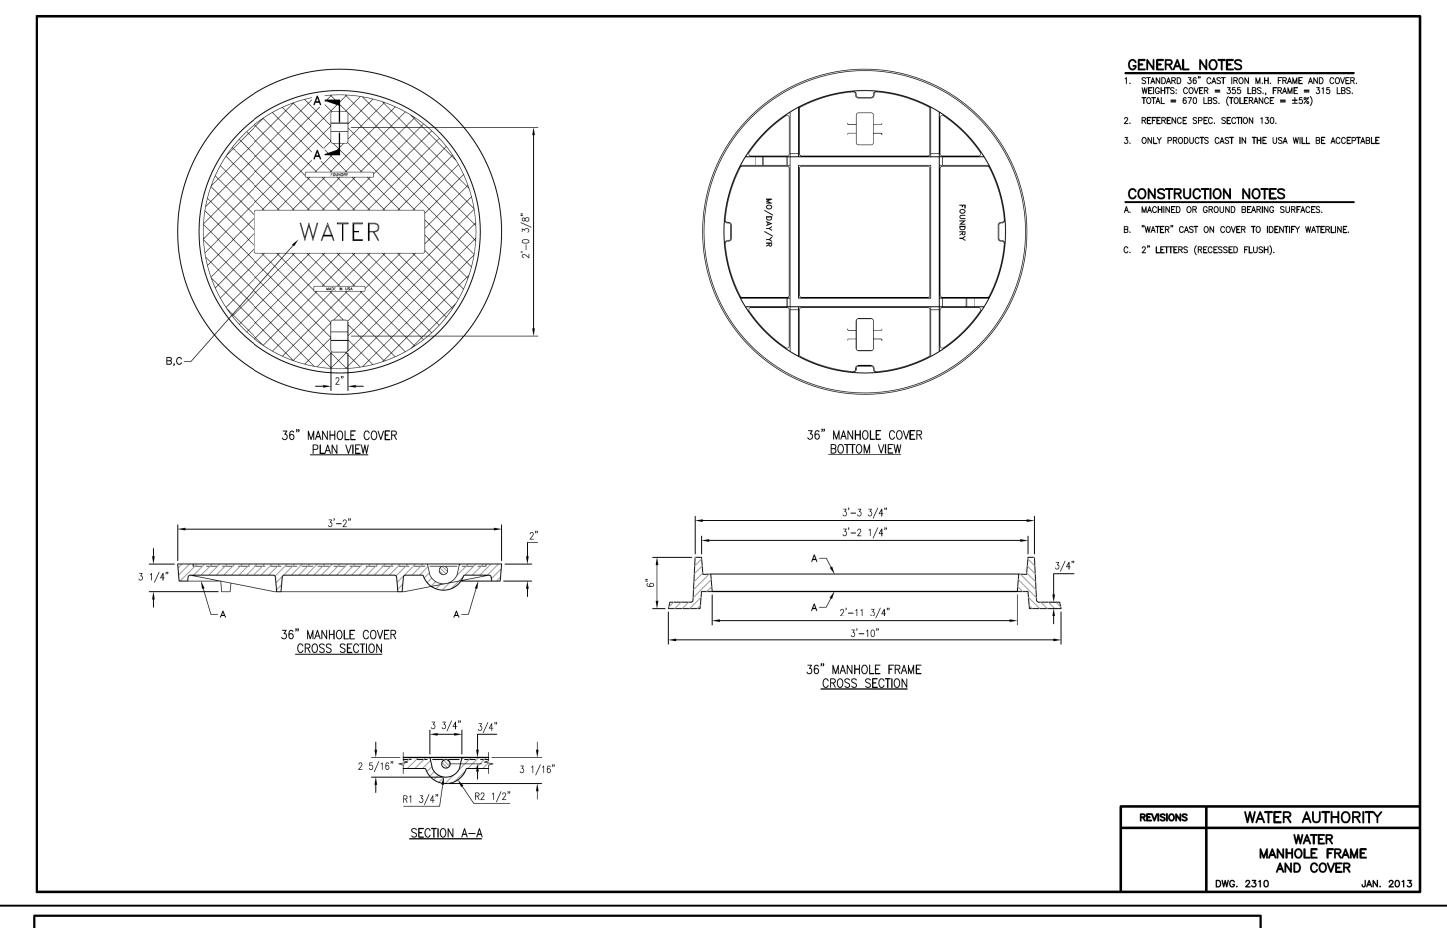

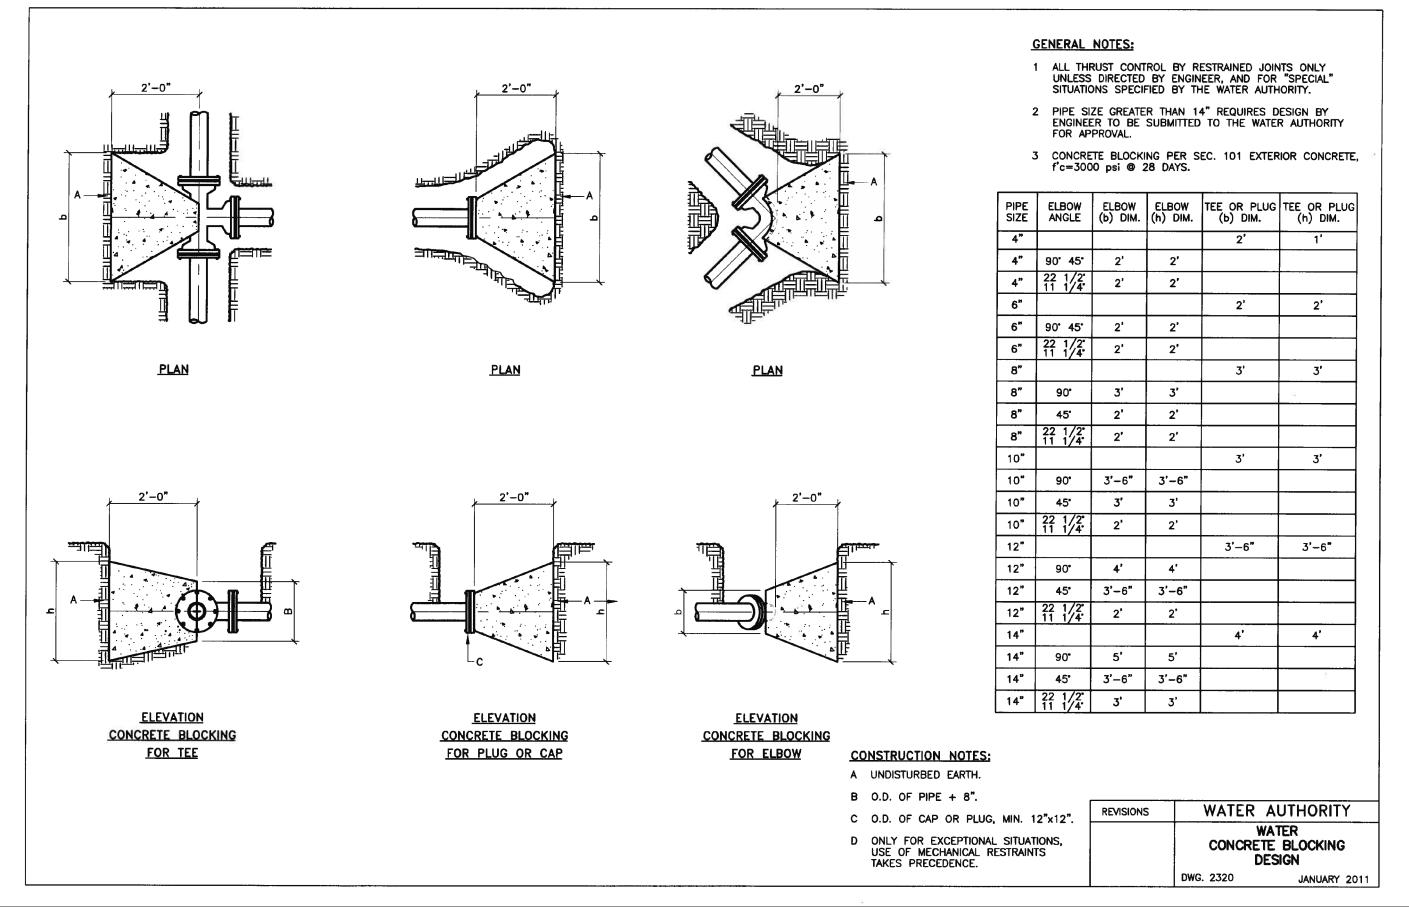

TEST STATION

TRACE WIRE

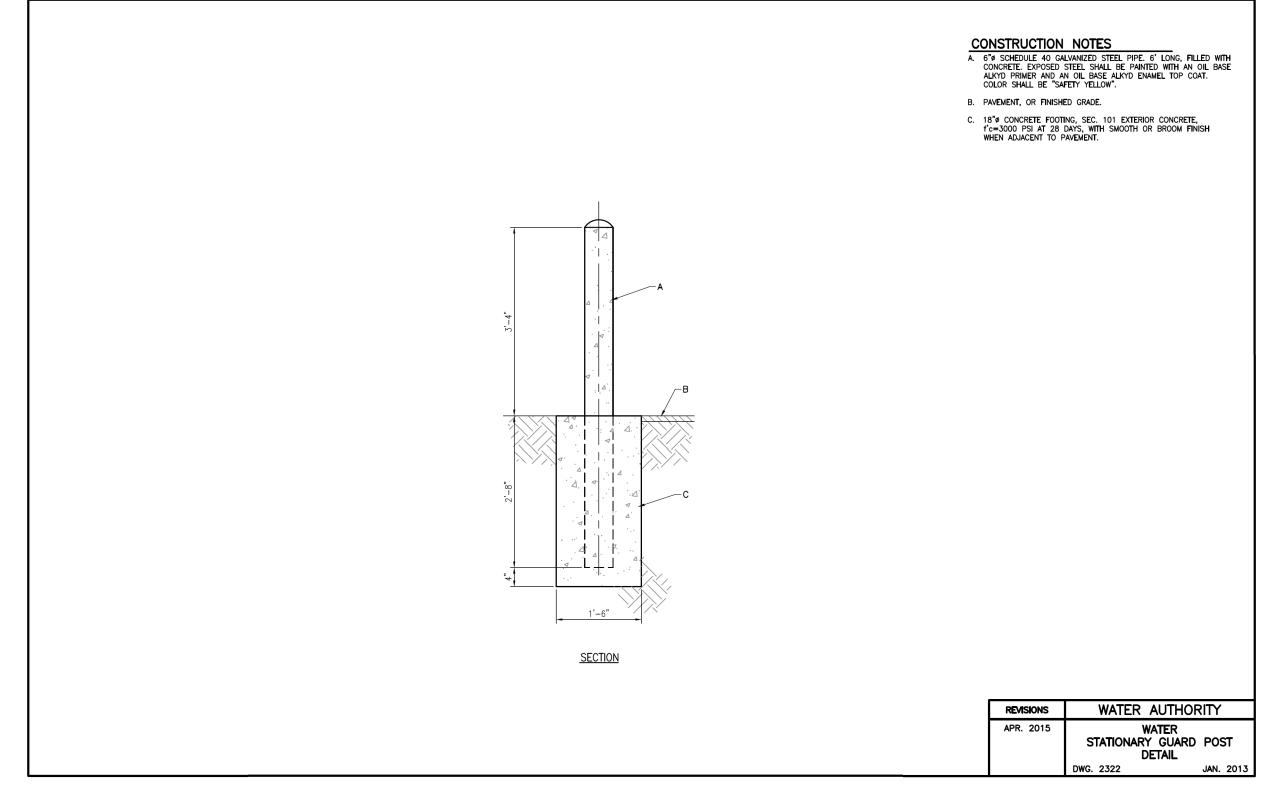

CPN 771863

# **REDRAWN FOR RECORD PURPOSES**

# **RECORD DRAWINGS**

TRACE WIRE DETAILS: SECTION A-A

THESE RECORD DOCUMENTS HAVE BEEN PREPARED BASED ON INFORMATION PROVIDED BY OTHERS. THEY ARE NOT INTENDED TO REPRESENT IN DETAIL THE EXACT LOCATION. TYPE OF COMPONENT NOR MANNER OF CONSTRUCTION. THE DESIGN PROFESSIONAL HAS NOT VERIFIED THE ACCURACY AND/OR THE COMPLETENESS OF THIS INFORMATION AND SHALL NOT BE RESPONSIBLE FOR ANY ERRORS OR OMISSIONS WHICH MAY BE INCORPORATED HEREIN AS A RESULT.

SCALE: 1"= ATTENTION 0 1/2" 1" GRAPHIC SCALE THIS BAR MEASURES 1 AT FULL SCALE (ANSI D)

DESIGN TRACKING DATE: **12/2021** DESIGNED BY M COUTURE DATE: **12/2021** DRAWN BY: C LAMB CHECKED BY: E FORD DATE: **12/2021** CROSS CHK'D BY: W CHRISTOFFERSON | DATE: 12/2021 DATE: 12/2021 J PETERSON APPROVED BY: MAPS/RECORDS INFO.

# Jacobs

SUBMITTED BY:

3721 RUTLEDGE RD NE, SUITE B-1 ALBUQUERQUE, NM 87109 505-884-5600

DRAWINGS

CORRECTED BY

AS	BUILT INFORMAT	ION				
CONTRACTOR AU	I, INC				MATE	0
CONSTRUCTION 3/BEGIN DATE	01/2022					"\
INSPECTOR'S ACCEPTANCE BY <b>JAC</b>	COBS	DATE	5/31/2022		-	
INSPECTOR'S NAME L	KOIKE/V TORRES			1/2		٤
SUBSTANTIAL COMPLETION DATE 5	5/31/2022			1	CHOS	

8/2022





ALBUQUERQUE BERNALILLO COUNTY WATER UTILITY AUTHORITY


RAW WATER TRANSMISSION PIPELINE TO INTEL CORPORATION BID PACKAGE NO. 1 WESTSIDE BLVD


STANDARD DETAILS

WATER AUTHORITY ZONE A-12 & MAP NO. A-13 WATER AUTHORITY DT-01

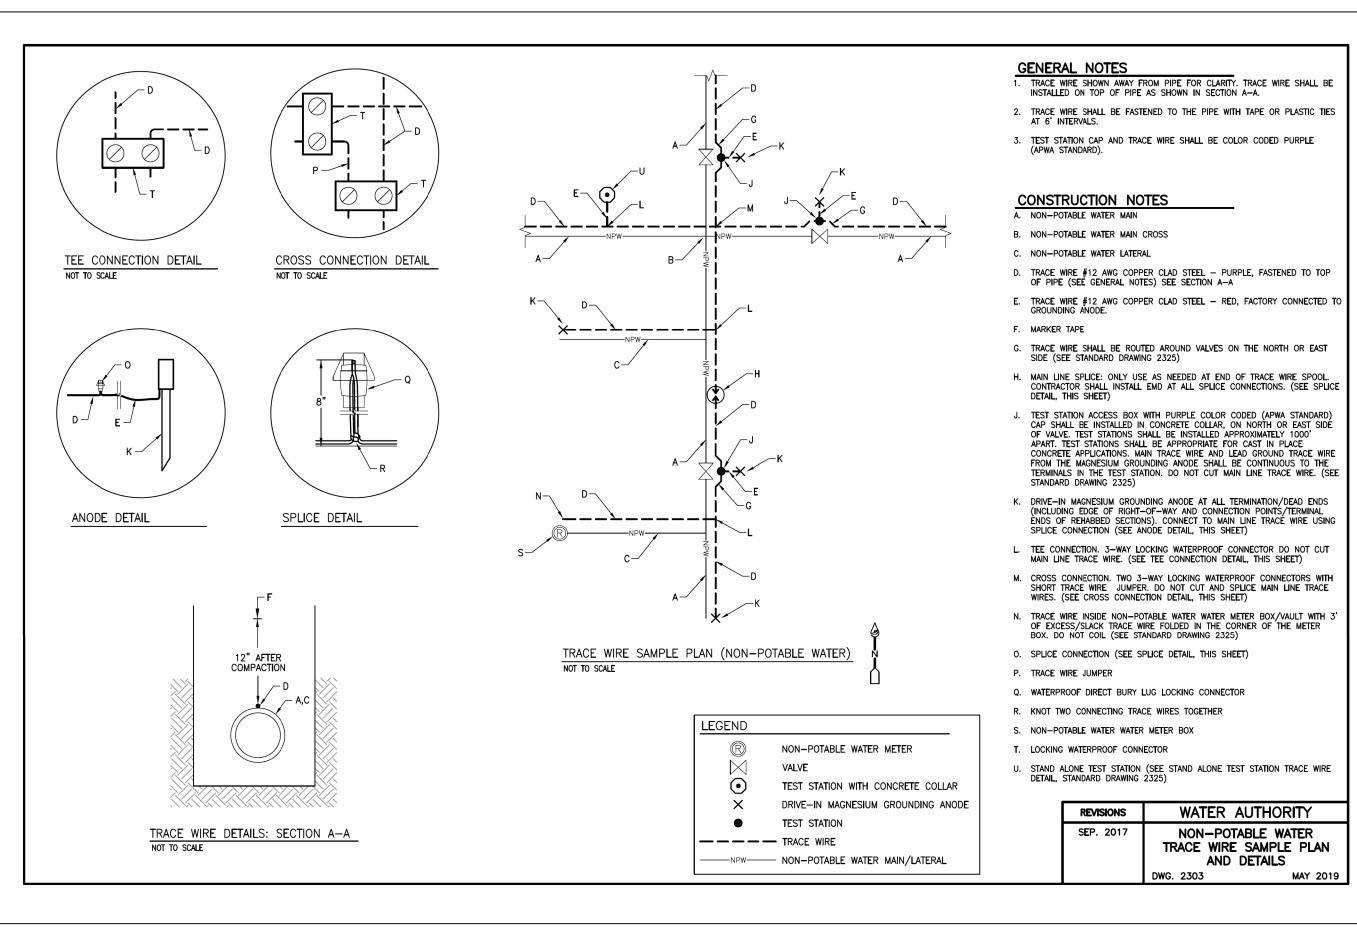

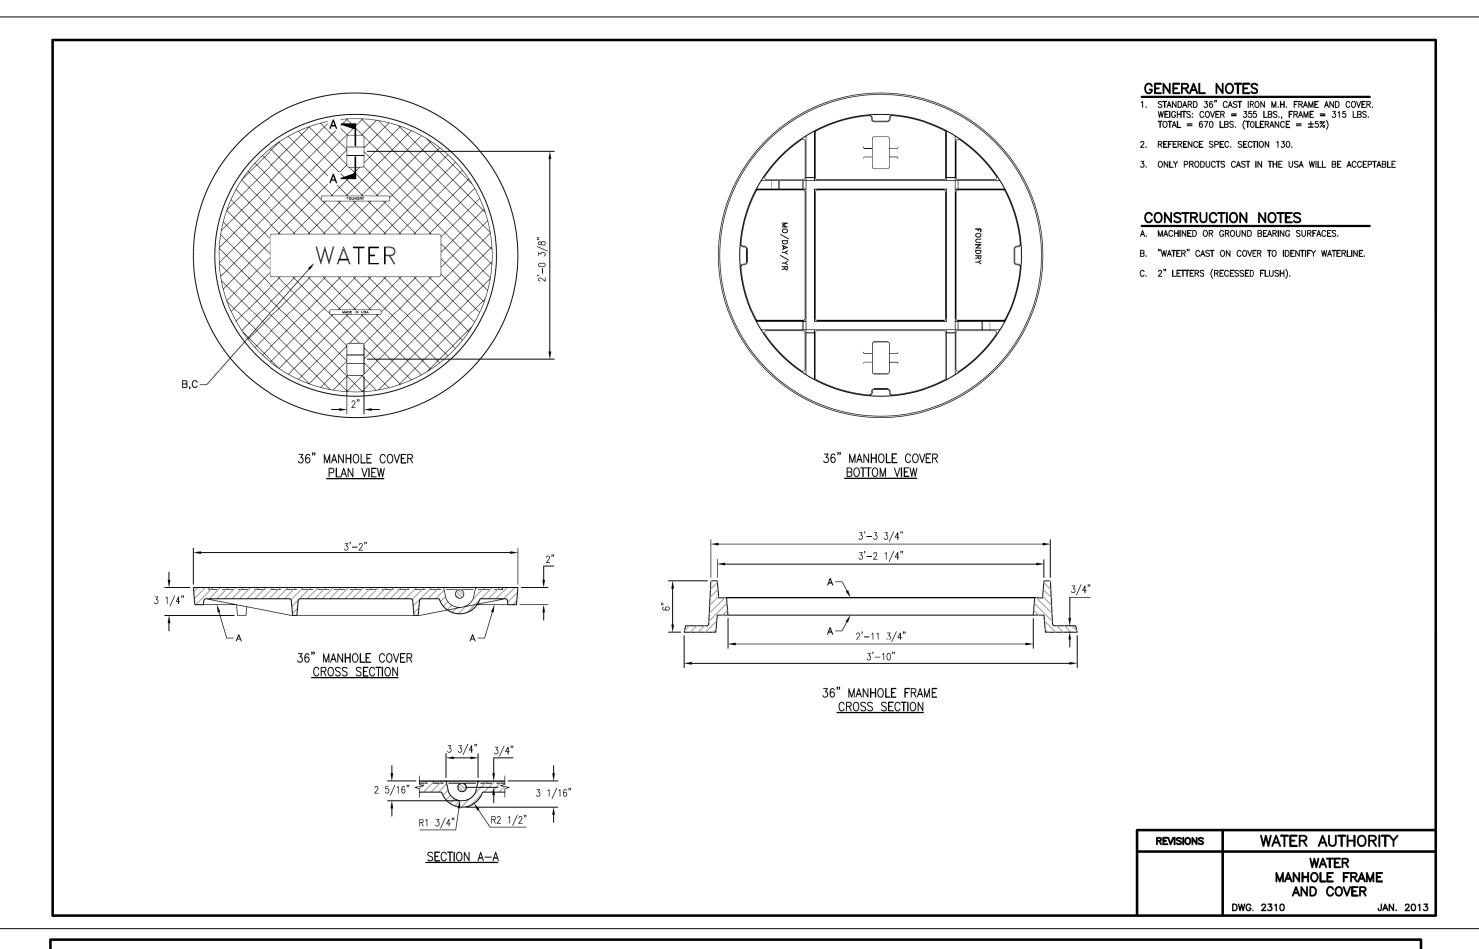

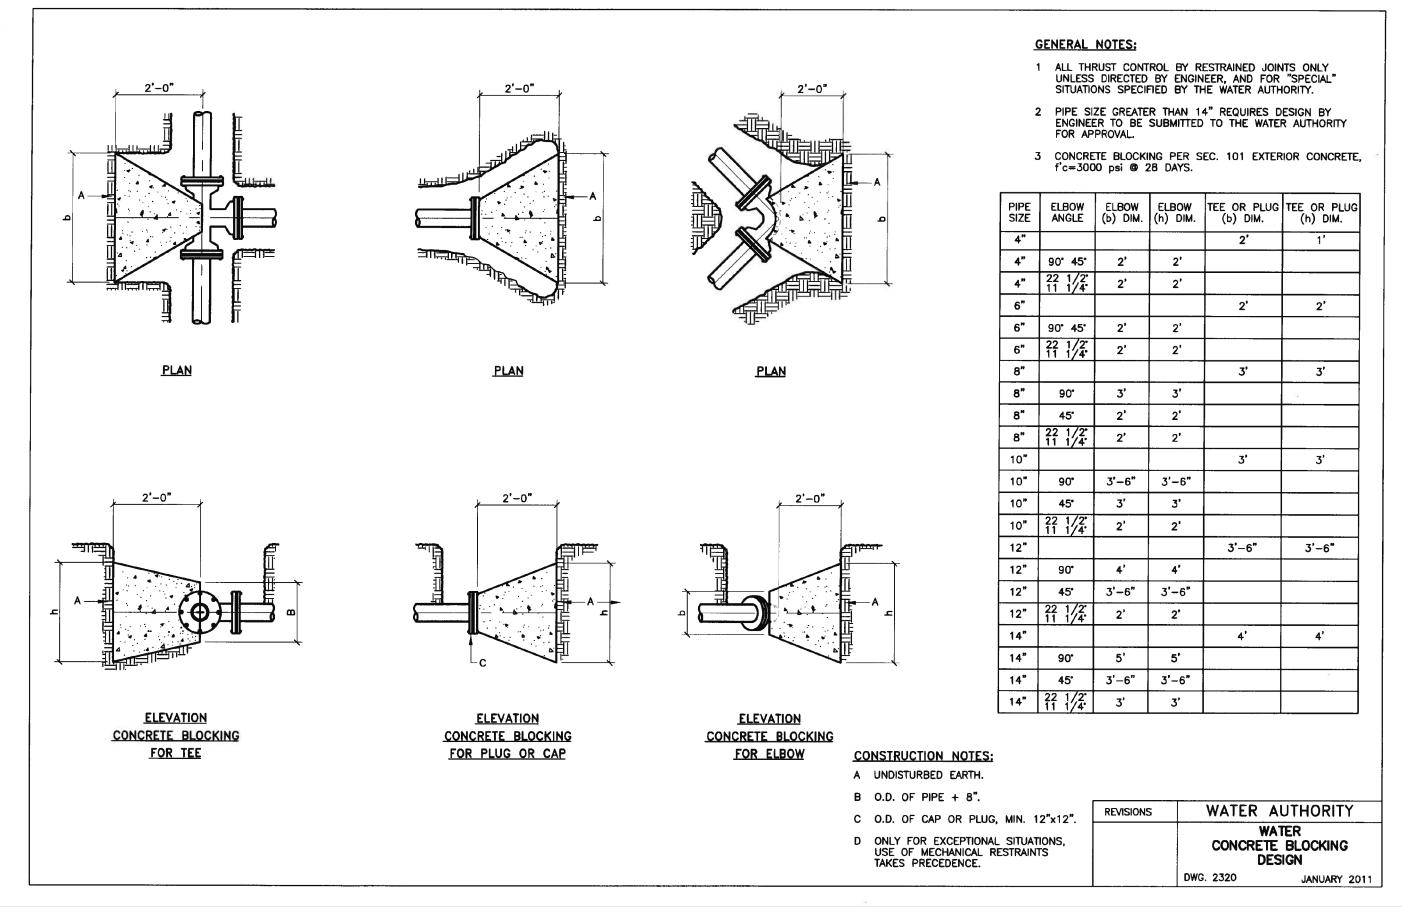

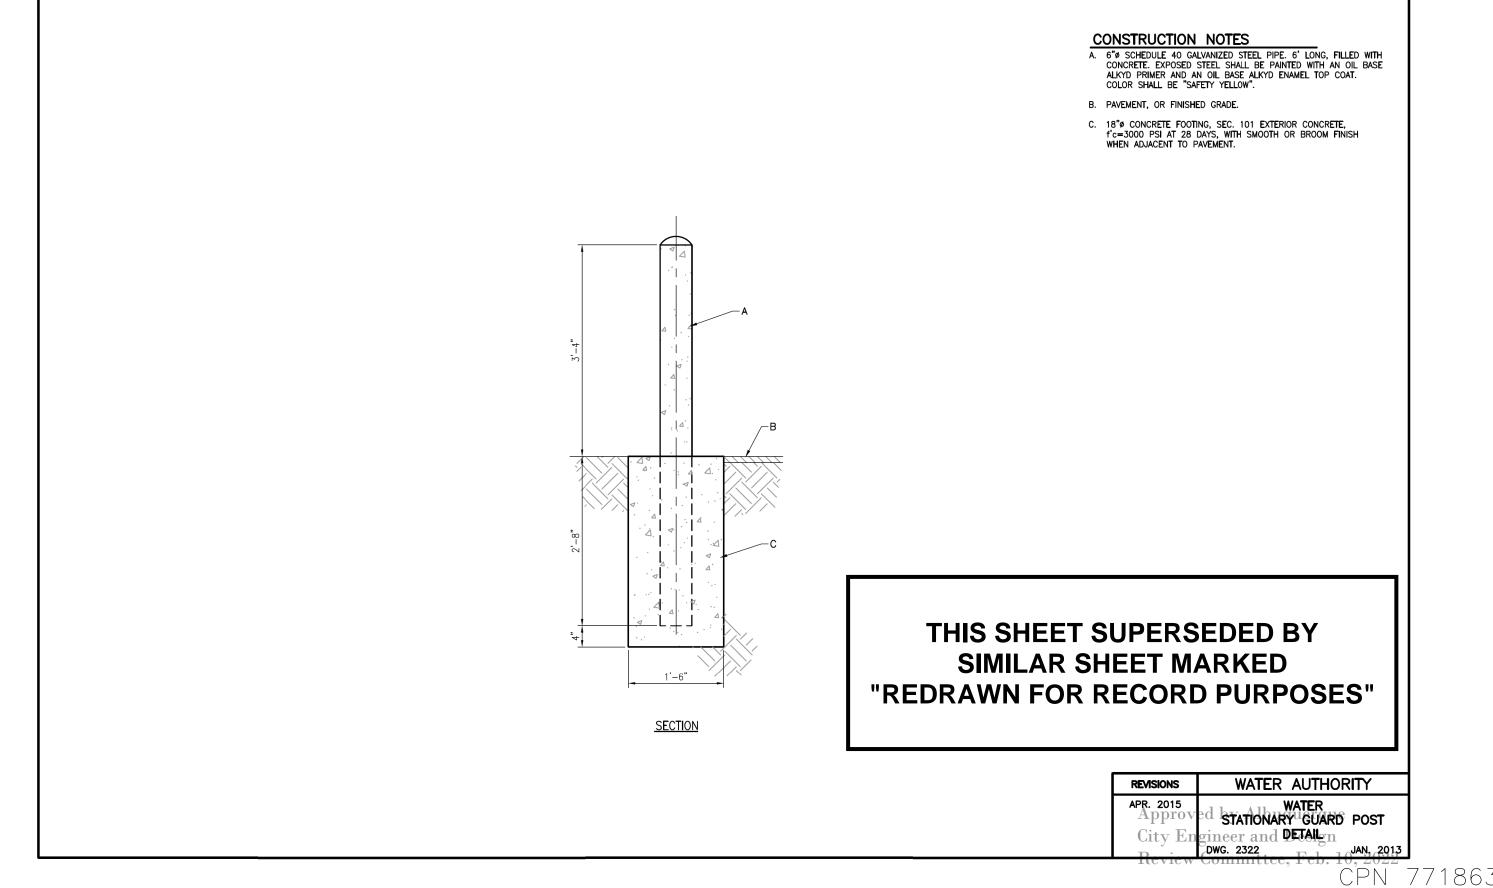


REVISION NO. & DESCRIPTION BY DESIGN TRACKING DATE SCALE: NO. 1 "= DESIGNED BY M COUTURE DATE: 12/17/21 C LAMB DATE: 12/17/21 DRAWN BY: ATTENTION CHECKED BY: E FORD DATE: 12/17/21 0 1/2" 1 CROSS CHK'D BY: W CHRISTOFFERSON DATE: 12/17/21 J PETERSON GRAPHIC SCALE DATE: 12/17/21 APPROVED BY: THIS BAR MEASURES 1 MAPS/RECORDS INFO. AT FULL SCALE (ANSI D)

Jacobs

SUBMITTED BY:

3721 RUTLEDGE RD NE, SUITE B-1 ALBUQUERQUE, NM 87109 505-884-5600

AS BUIL	TINFORMATION	
CONTRACTOR ——		MATEA
CONSTRUCTION BEGIN DATE		
INSPECTOR'S ACCEPTANCE BY	DATE	
INSPECTOR'S NAME		1
SUBSTANTIAL		THORIT
DRAWINGS	DATE	

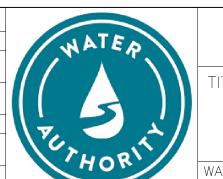



ALBUQUERQUE BERNALILLO COUNTY WATER UTILITY AUTHORITY


RAW WATER TRANSMISSION PIPELINE TO INTEL CORPORATION BID PACKAGE NO. 1 WESTSIDE BLVD

STANDARD DETAILS

WATER AUTHORITY CONSTRUCTION PROJECT NO. 2320.030XX MAP NO. DT - 01

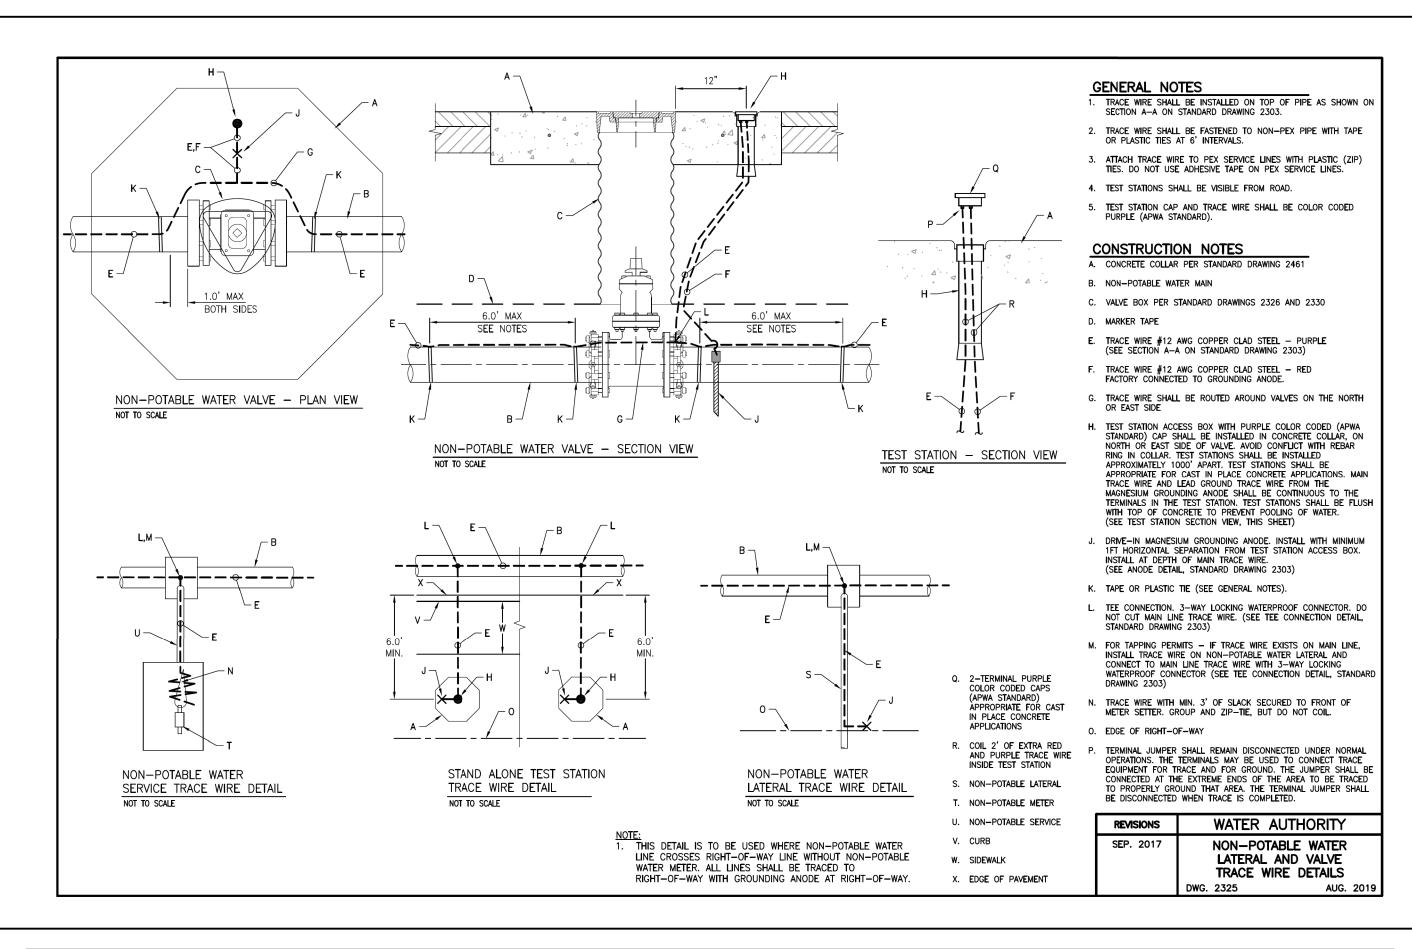

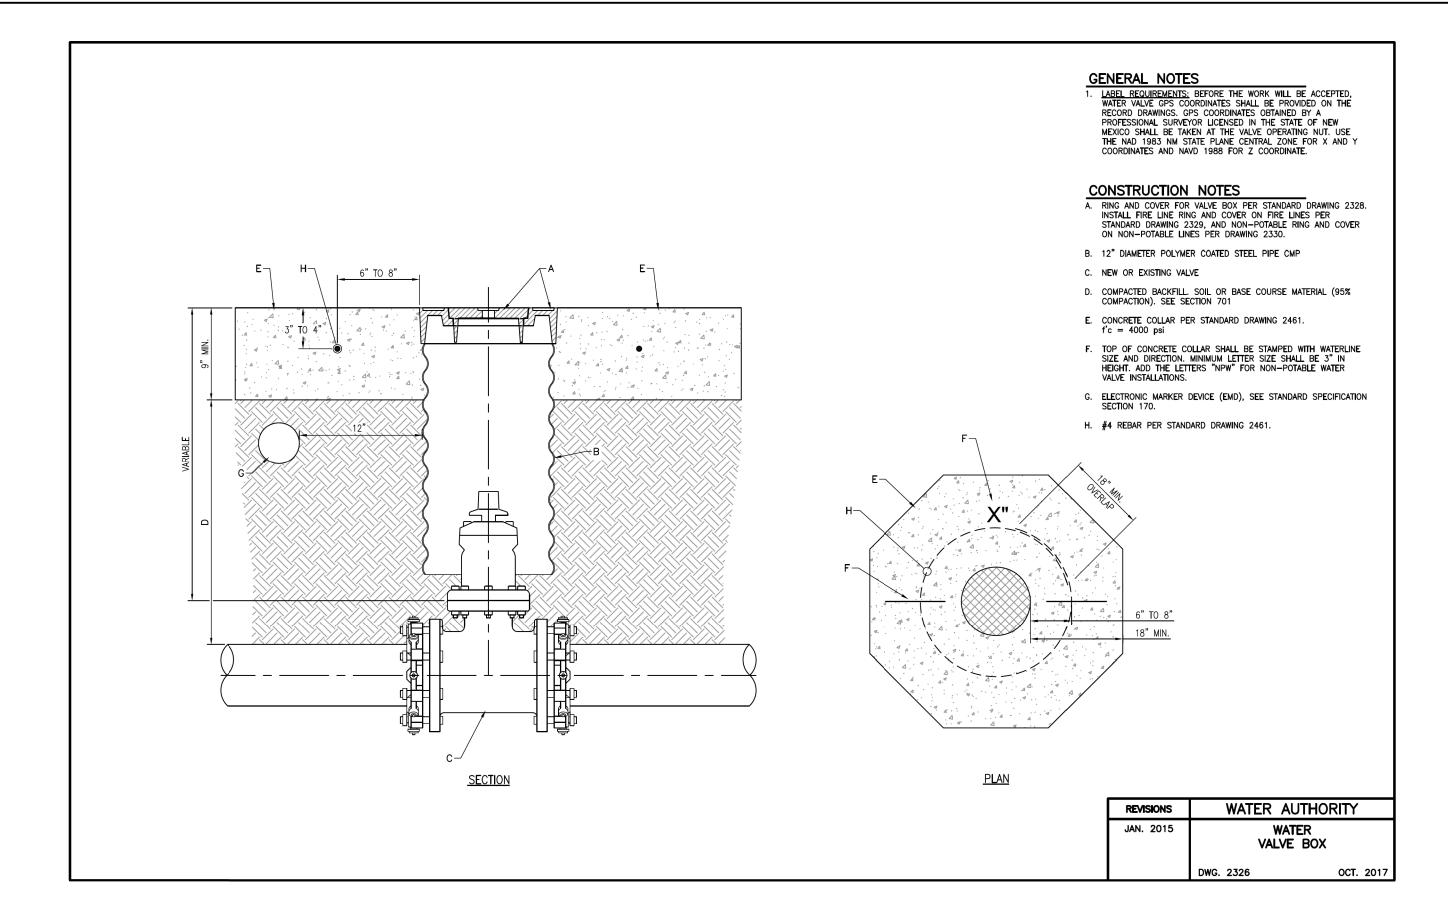

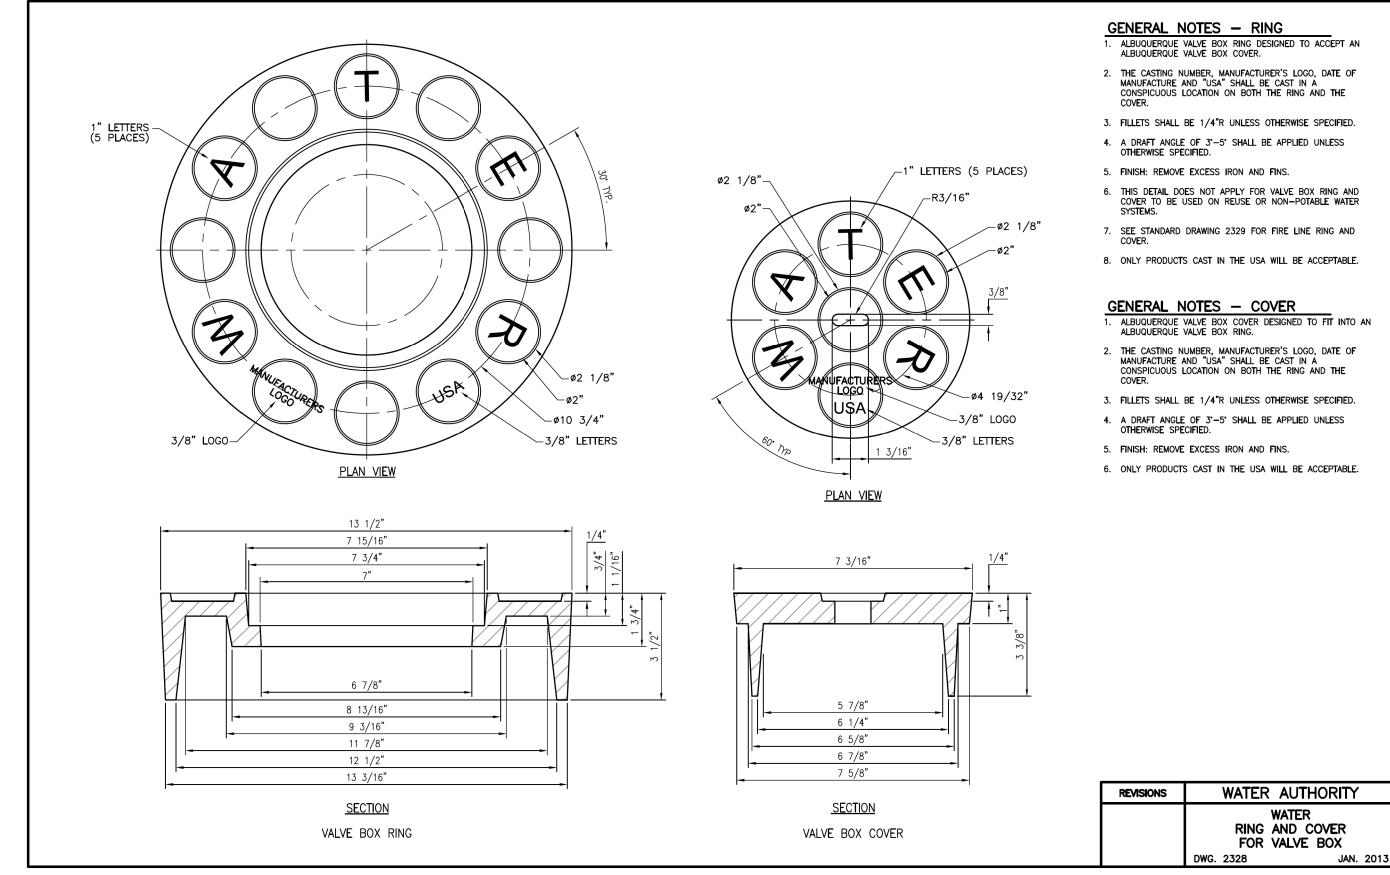

**REDRAWN FOR RECORD PURPOSES** 

DATE **5/31/2022** 8/2022

AS BUILT INFORMATION

DATE

AUI, INC

INSPECTOR'S NAME L KOIKE/V TORRES

JACOBS

3/01/2022

CONTRACTOR

CONSTRUCTION

INSPECTOR'S ACCEPTANCE BY JACOBS

SUBSTANTIAL COMPLETION DATE 5/31/2022

BEGIN DATE

SUBSTANTIAL

CORRECTED BY

DRAWINGS

ALBUQUERQUE BERNALILLO COUNTY WATER UTILITY AUTHORITY

RAW WATER TRANSMISSION PIPELINE TO INTEL CORPORATION BID PACKAGE NO. 1 WESTSIDE BLVD

STANDARD DETAILS

CPN 771863

WATER AUTHORITY

2320.03001 ZONE A-12 & SHEET A-13 DT-02 CONSTRUCTION PROJECT NO. DT-2.dgn 13 OF 17

**RECORD DRAWINGS** 

THESE RECORD DOCUMENTS HAVE BEEN PREPARED BASED ON INFORMATION PROVIDED BY OTHERS. THEY ARE NOT INTENDED TO REPRESENT IN DETAIL THE EXACT LOCATION. TYPE OF COMPONENT NOR MANNER OF CONSTRUCTION. THE DESIGN PROFESSIONAL HAS NOT VERIFIED THE ACCURACY AND/OR THE COMPLETENESS OF THIS INFORMATION AND SHALL NOT BE RESPONSIBLE FOR ANY ERRORS OR OMISSIONS WHICH MAY BE INCORPORATED HEREIN AS A RESULT.


SCALE: 1"= ATTENTION 0 1/2" 1" GRAPHIC SCALE THIS BAR MEASURES 1 AT FULL SCALE (ANSI D)


DESIGN TRACKING DATE: **12/2021** DESIGNED BY M COUTURE C LAMB DATE: **12/2021** DRAWN BY: CHECKED BY: E FORD DATE: **12/2021** CROSS CHK'D BY: W CHRISTOFFERSON | DATE: 12/2021 DATE: 12/2021 J PETERSON APPROVED BY: MAPS/RECORDS INFO.


Jacobs

SUBMITTED BY:

3721 RUTLEDGE RD NE, SUITE B-1 ALBUQUERQUE, NM 87109 505-884-5600

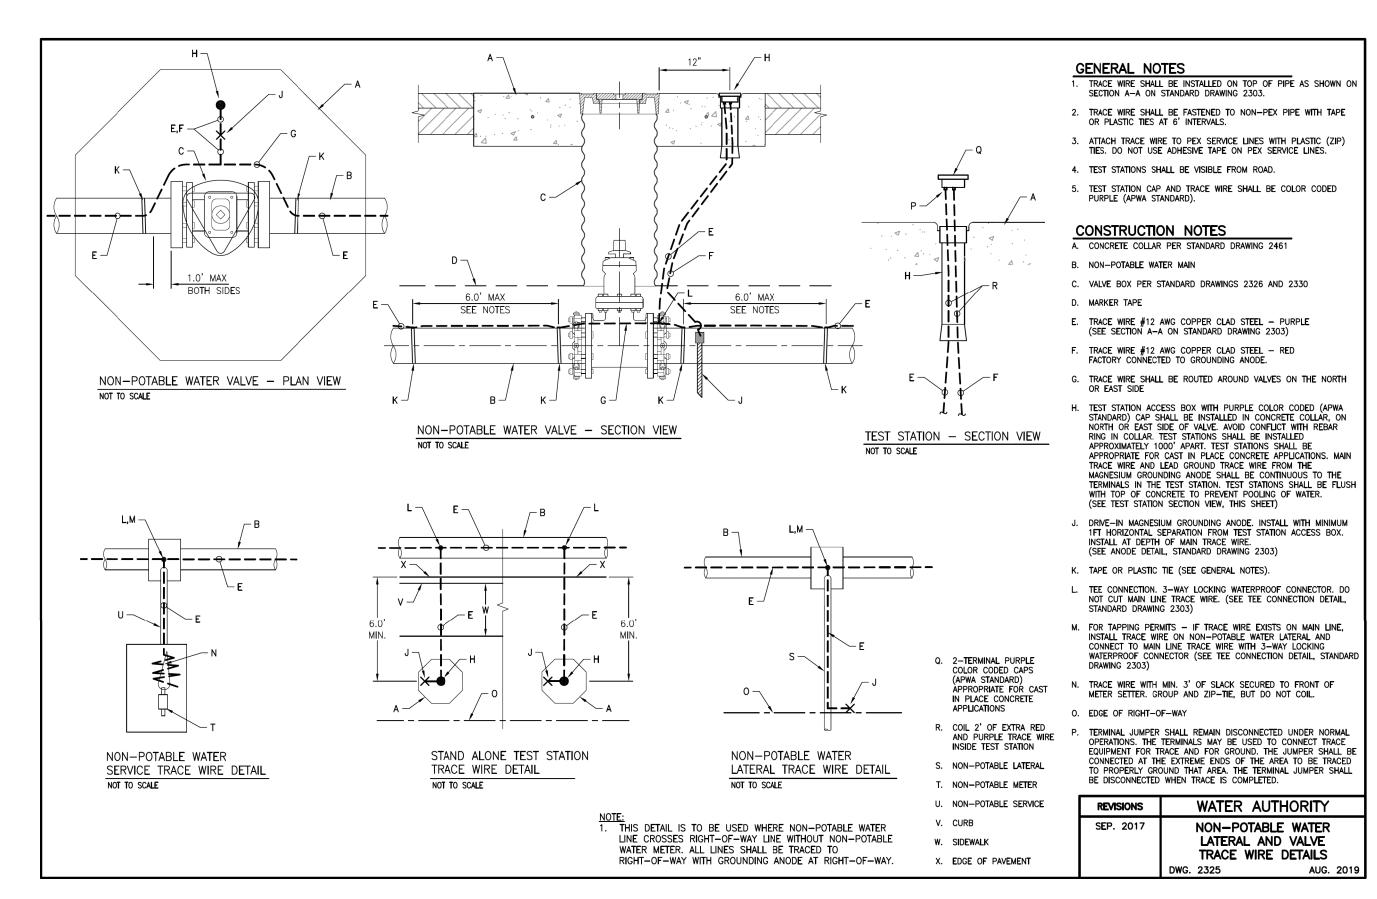

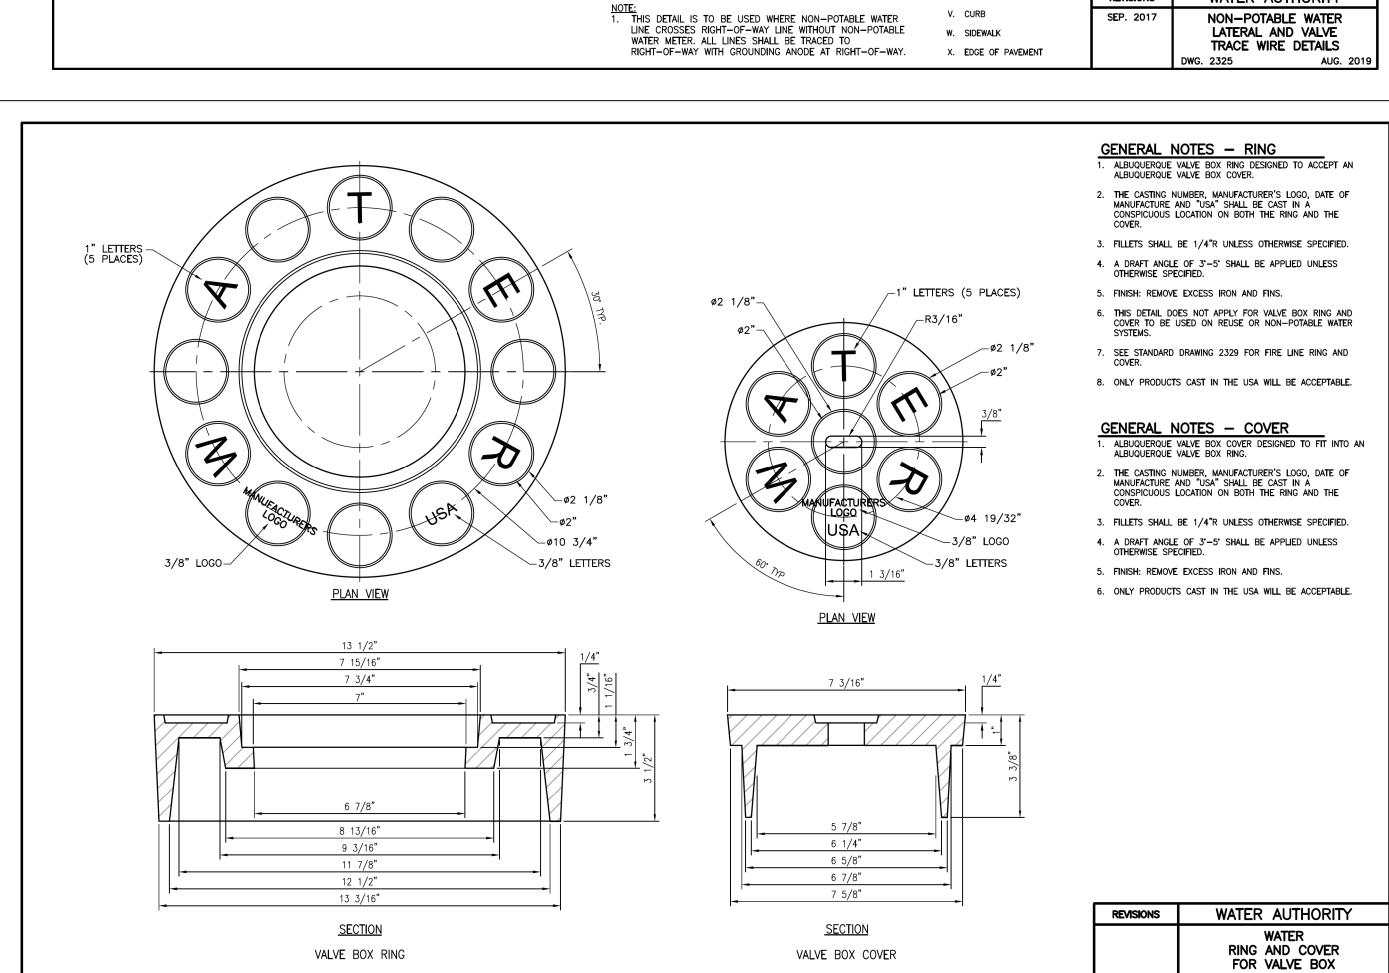

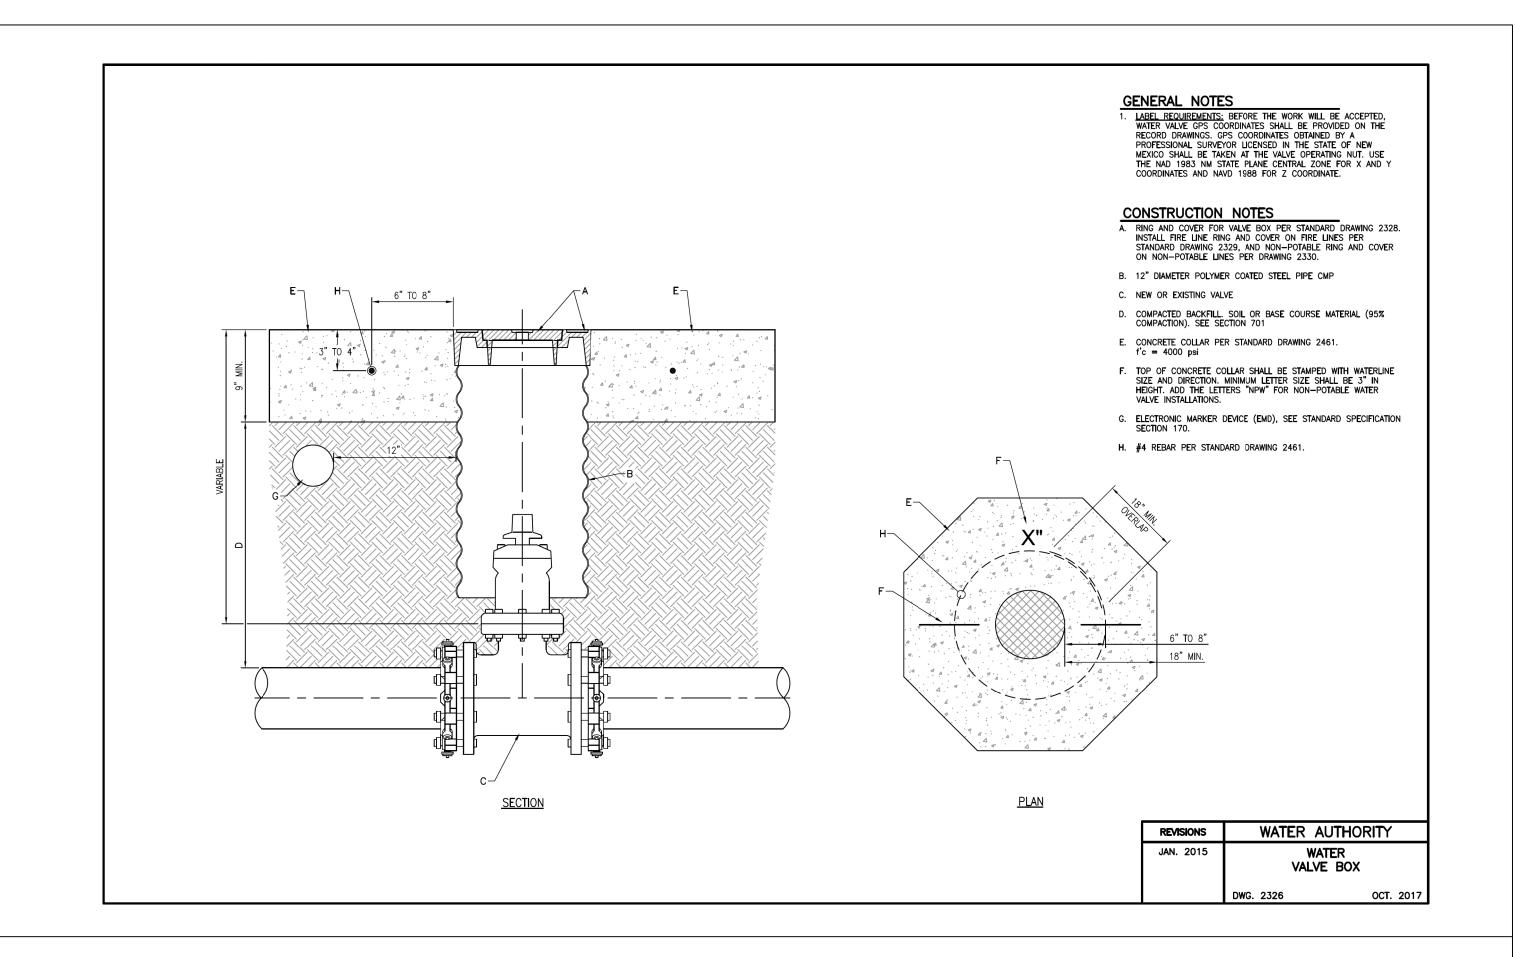

# THIS SHEET SUPERSEDED BY SIMILAR SHEET MARKED "REDRAWN FOR RECORD PURPOSES"

Approved by Albuquerque 71863

REVISION NO. & DESCRIPTION BY DESIGN TRACKING DATE SCALE: 1 "= DESIGNED BY M COUTURE DATE: 12/17/21 C LAMB 12/17/21 DRAWN BY: ATTENTION CHECKED BY: E FORD DATE: 12/17/21 0 1/2" 1 CROSS CHK'D BY: W CHRISTOFFERSON DATE: 12/17/21 J PETERSON GRAPHIC SCALE DATE: 12/17/21 APPROVED BY: THIS BAR MEASURES 1 MAPS/RECORDS INFO. AT FULL SCALE (ANSI D)

Jacobs

SUBMITTED BY:

3721 RUTLEDGE RD NE, SUITE B-1 ALBUQUERQUE, NM 87109 505-884-5600

AS BUILT INFORMATION	
CONTRACTOR ——	
CONSTRUCTION BEGIN DATE	
INSPECTOR'S DATE	
INSPECTOR'S NAME	V
SUBSTANTIAL COMPLETION DATE	1
DRAWINGS DATE	





City Engineer and Design Review Committee, Feb. 10, 2022 CPN 77	7
ALBUQUERQUE BERNALILLO COUNTY	_


WATER UTILITY AUTHORITY RAW WATER TRANSMISSION PIPELINE TO INTEL CORPORATION BID PACKAGE NO. 1 WESTSIDE BLVD

STANDARD DETAILS

CONSTRUCTION PROJECT NO. 2320.030XX MAP NO. DT-02

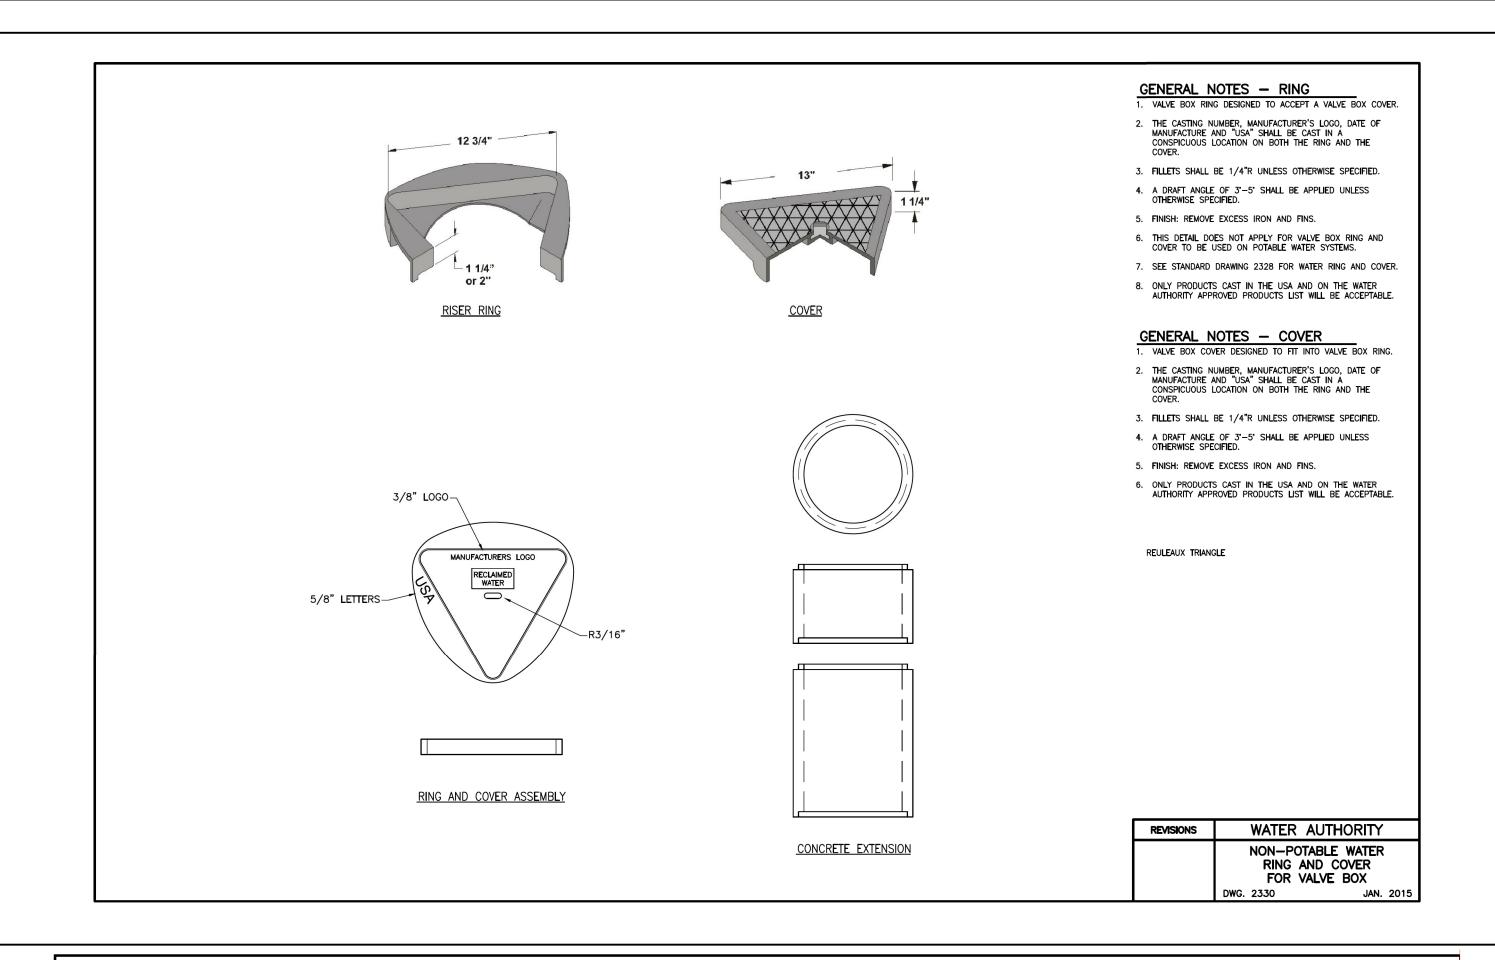

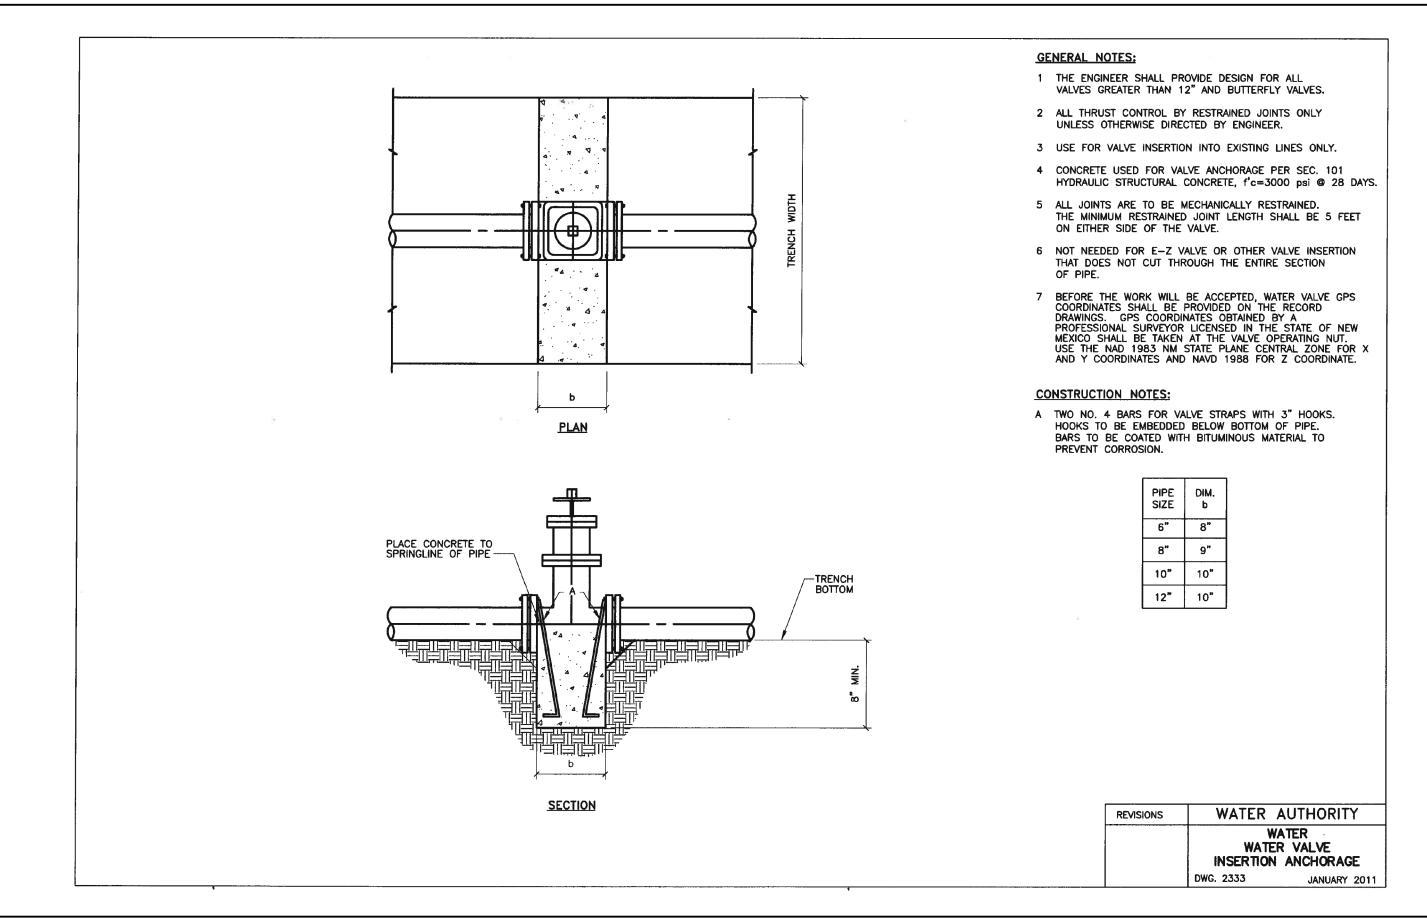

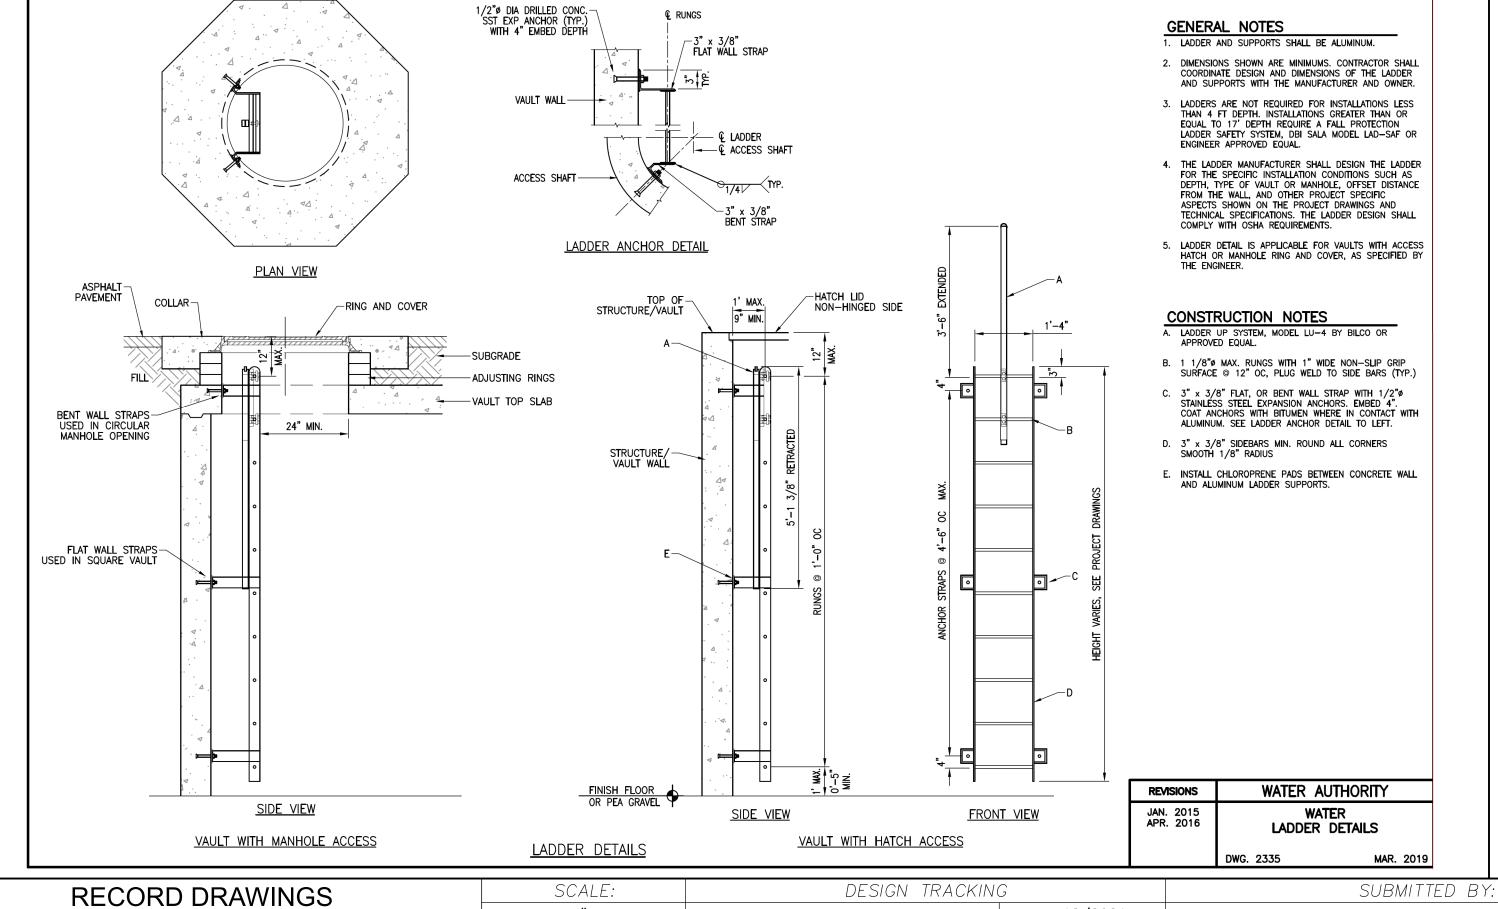

**REDRAWN FOR RECORD PURPOSES** 

DATE **5/31/2022** 8/2022

AS BUILT INFORMATION

DATE

AUI, INC

INSPECTOR'S NAME L KOIKE/V TORRES

JACOBS

3/01/2022

CONTRACTOR

CONSTRUCTION

INSPECTOR'S ACCEPTANCE BY JACOBS

SUBSTANTIAL COMPLETION DATE 5/31/2022

BEGIN DATE

DRAWINGS

CORRECTED BY

ALBUQUERQUE BERNALILLO COUNTY WATER UTILITY AUTHORITY

RAW WATER TRANSMISSION PIPELINE TO INTEL CORPORATION BID PACKAGE NO. 1 WESTSIDE BLVD

STANDARD DETAILS

CPN 771863

WATER AUTHORITY 2320.03001 ZONE A-12 & A-13 DT-03 CONSTRUCTION PROJECT NO. DT-3.dgn 14 OF 17

THESE RECORD DOCUMENTS HAVE BEEN PREPARED BASED ON INFORMATION PROVIDED BY OTHERS. THEY ARE NOT INTENDED TO REPRESENT IN DETAIL THE EXACT LOCATION. TYPE OF COMPONENT NOR MANNER OF CONSTRUCTION. THE DESIGN PROFESSIONAL HAS NOT VERIFIED THE ACCURACY AND/OR THE COMPLETENESS OF THIS INFORMATION AND SHALL NOT BE RESPONSIBLE FOR ANY

ERRORS OR OMISSIONS WHICH MAY BE INCORPORATED HEREIN


AS A RESULT.


1"= ATTENTION 0 1/2" 1 GRAPHIC SCALE THIS BAR MEASURES 1 AT FULL SCALE (ANSI D)

DATE: **12/2021** DESIGNED BY M COUTURE C LAMB DATE: **12/2021** DRAWN BY: CHECKED BY: E FORD DATE: **12/2021** W CHRISTOFFERSON | DATE: 12/2021 CROSS CHK'D BY: J PETERSON DATE: 12/2021 APPROVED BY: MAPS/RECORDS INFO.

Jacobs

3721 RUTLEDGE RD NE, SUITE B-1 ALBUQUERQUE, NM 87109 505-884-5600

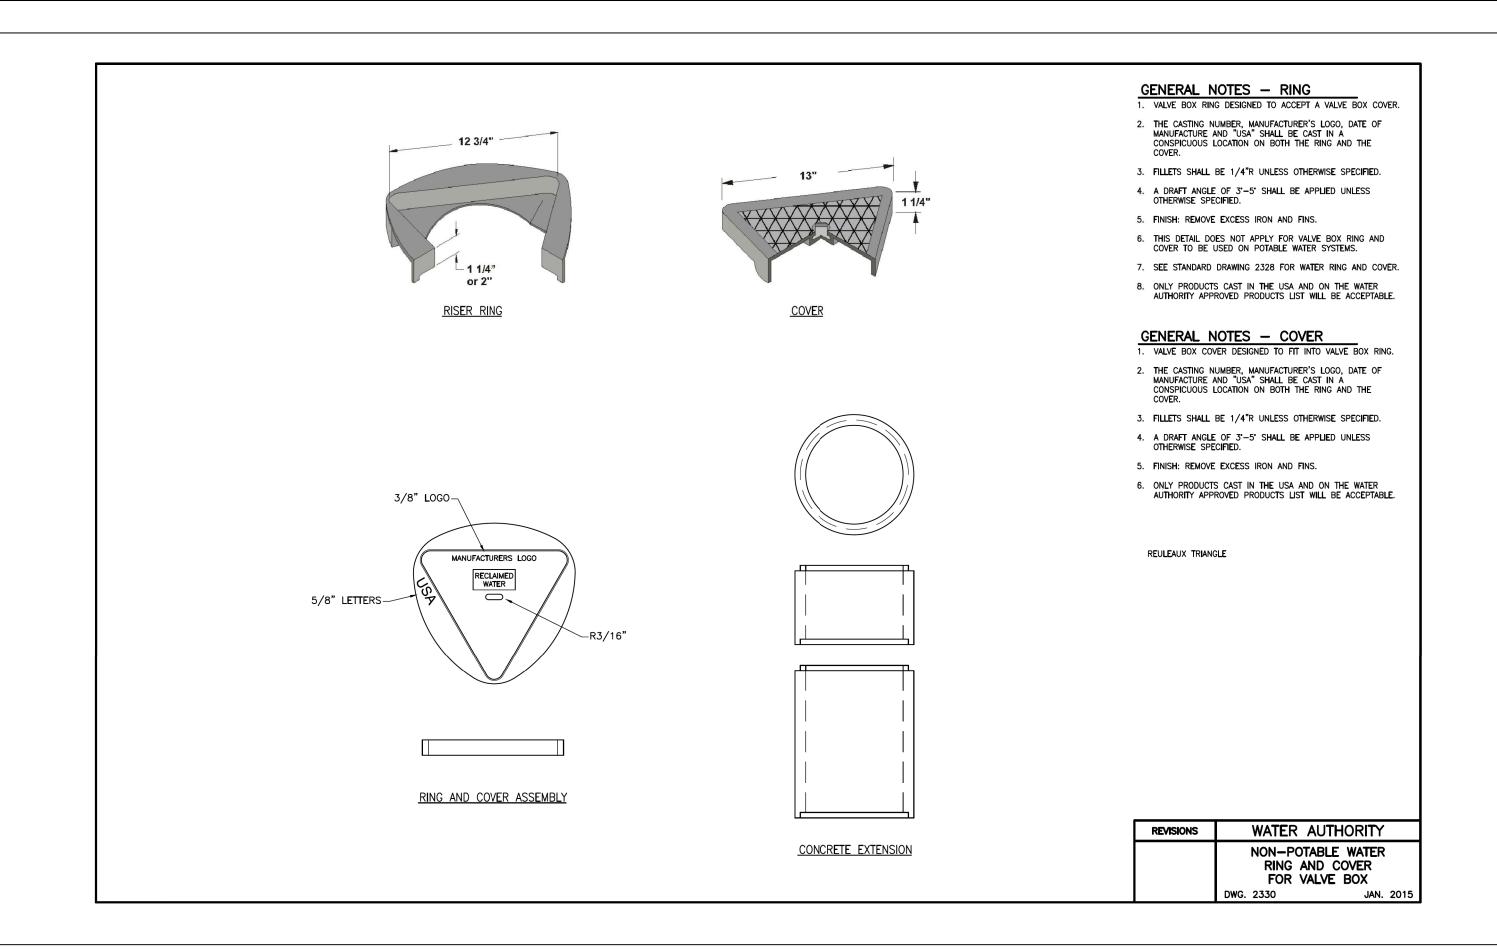

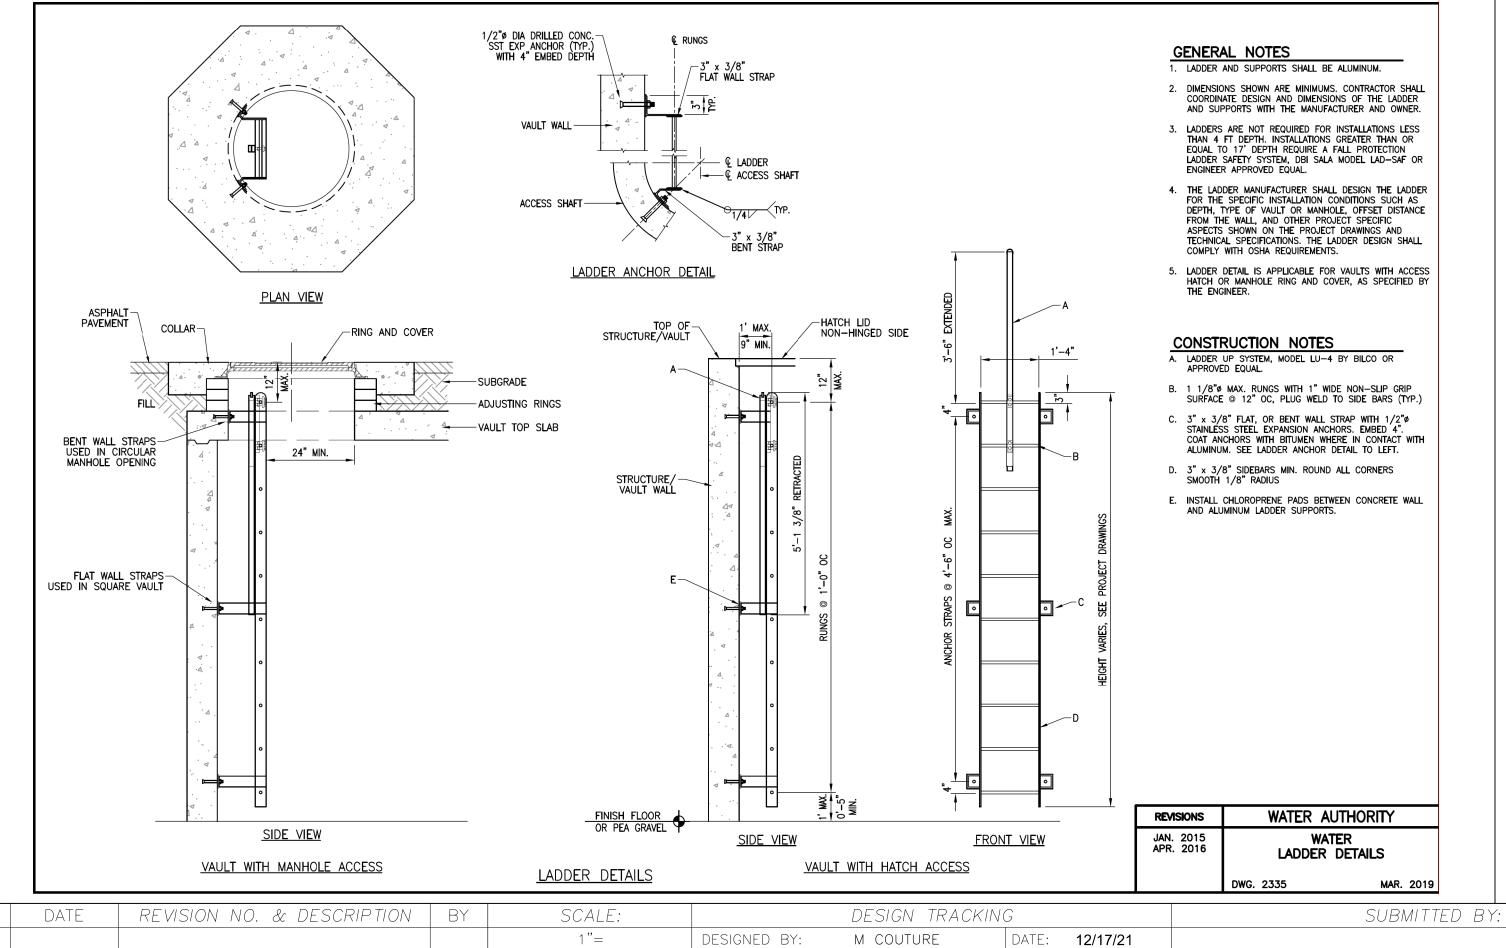

DRAWN BY:

CHECKED BY:

APPROVED BY:

ATTENTION

0 1/2" 1

GRAPHIC SCALE

AT FULL SCALE (ANSI D)

THIS BAR MEASURES 1

C LAMB

E FORD

CROSS CHK'D BY: W CHRISTOFFERSON DATE:

J PETERSON

MAPS/RECORDS INFO.

DATE:

DATE:


DATE:

12/17/21

12/17/21

12/17/21

12/17/21

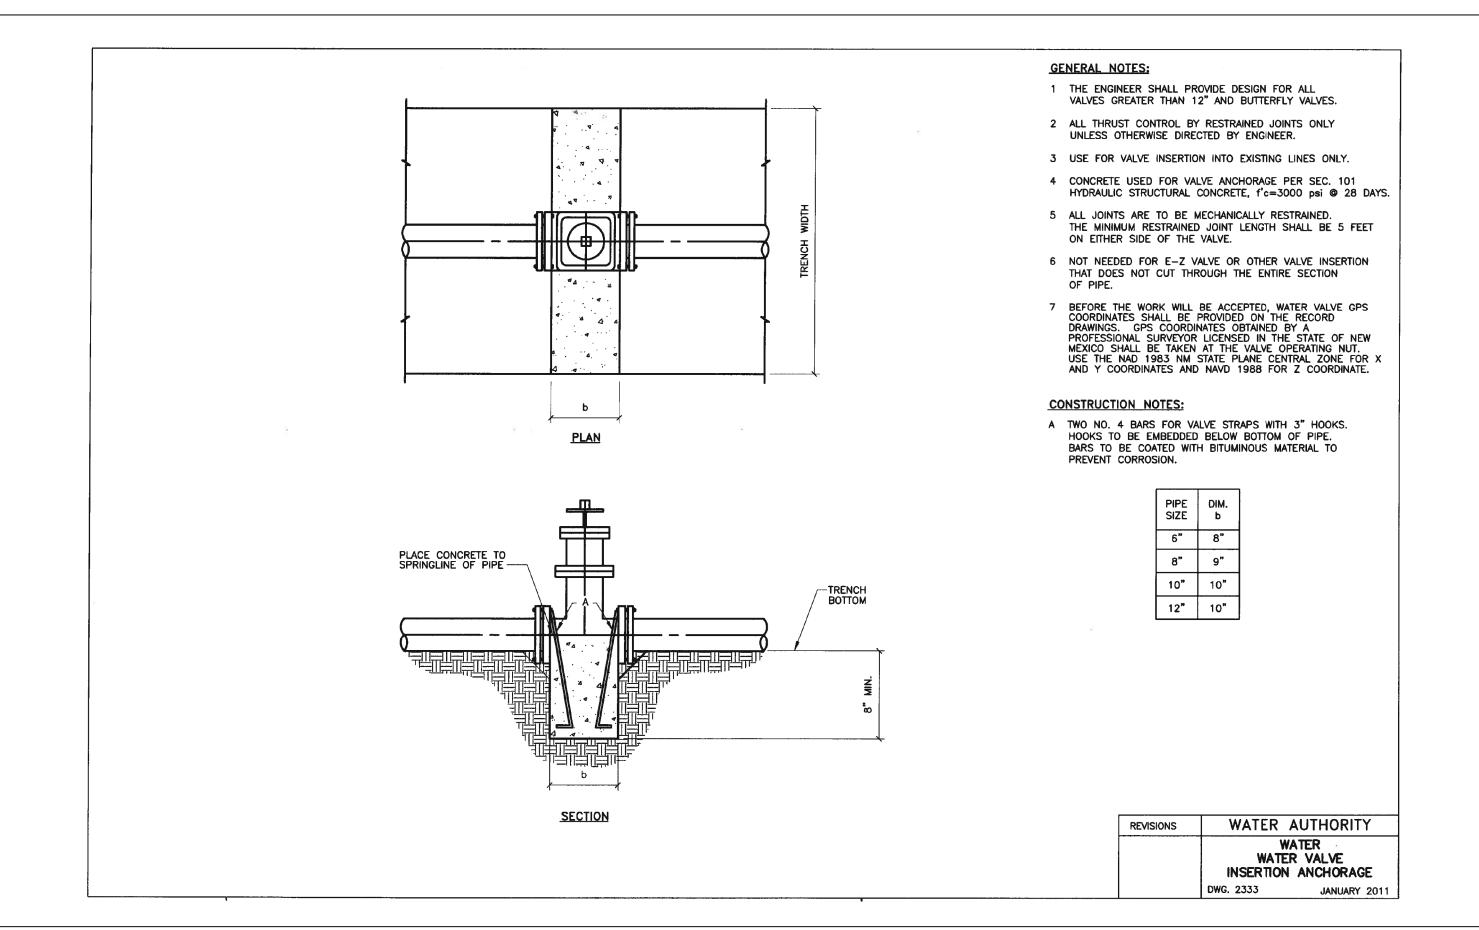

THIS SHEET SUPERSEDED BY SIMILAR SHEET MARKED "REDRAWN FOR RECORD PURPOSES"

Approved by Albuquerque City Engineer and Design Review Committee, Feb. 10, 2022 CPN 771863

3721 RUTLEDGE RD NE, SUITE B-1 ALBUQUERQUE, NM 87109 505-884-5600

as built ini	FORMATION	
CONTRACTOR ——		
CONSTRUCTION BEGIN DATE		
INSPECTOR'S ACCEPTANCE BY	DATE	
INSPECTOR'S NAME		Π÷
SUBSTANTIAL COMPLETION DATE		11
DRAWINGS CORRECTED BY	DATE	




	ALBUQUERQU
5	WATER


JE BERNALILLO COUNTY UTILITY AUTHORITY


RAW WATER TRANSMISSION PIPELINE TO INTEL CORPORATION BID PACKAGE NO. 1 WESTSIDE BLVD


STANDARD DETAILS

WATER AUTHORITY WAILK AUTHORITY CONSTRUCTION PROJECT NO. 2320.030XX X MAP NO. DT-03

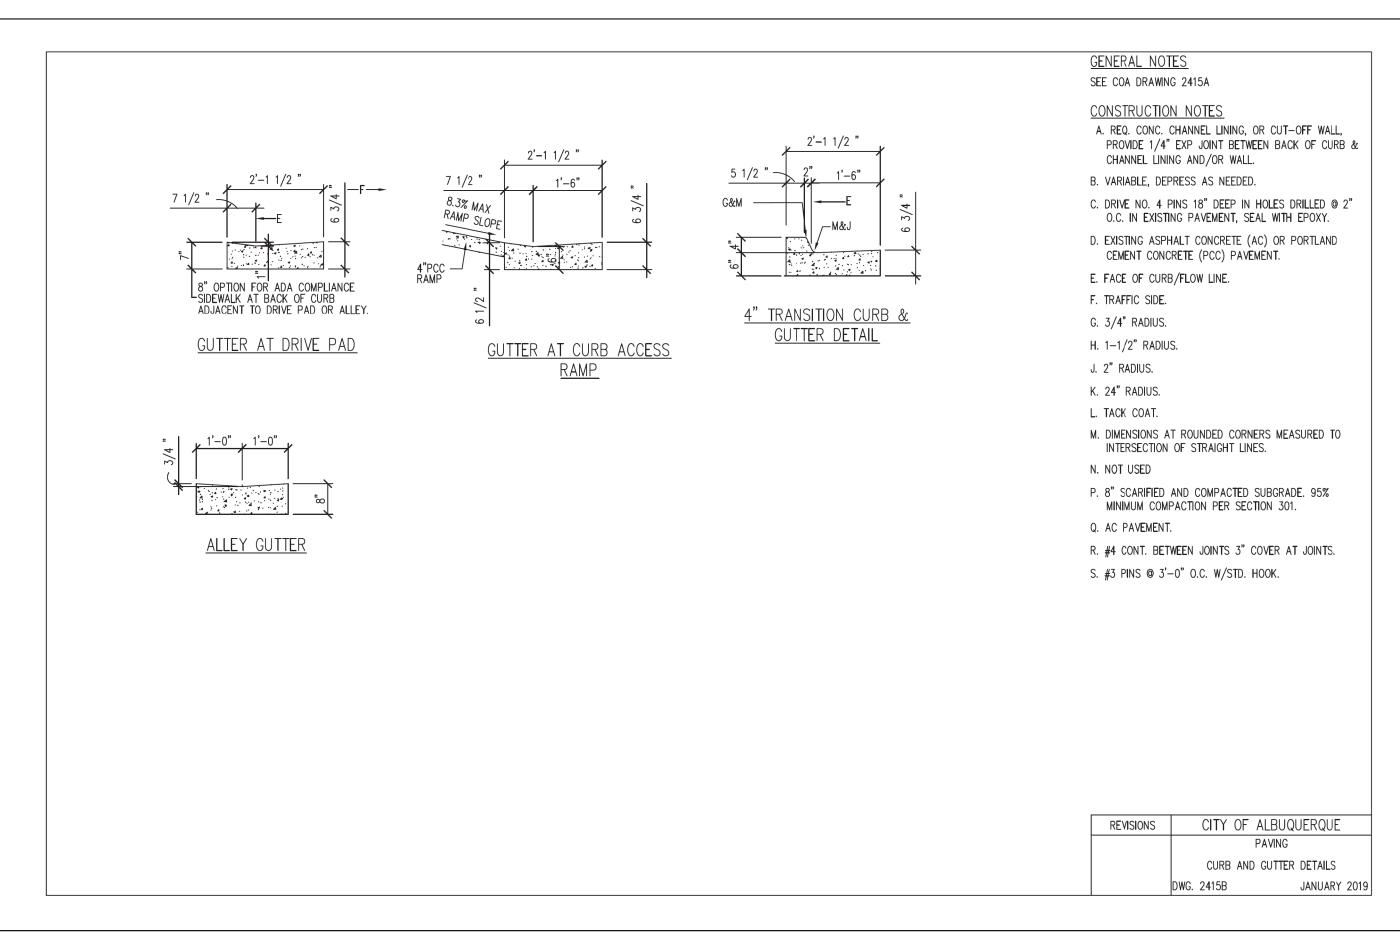

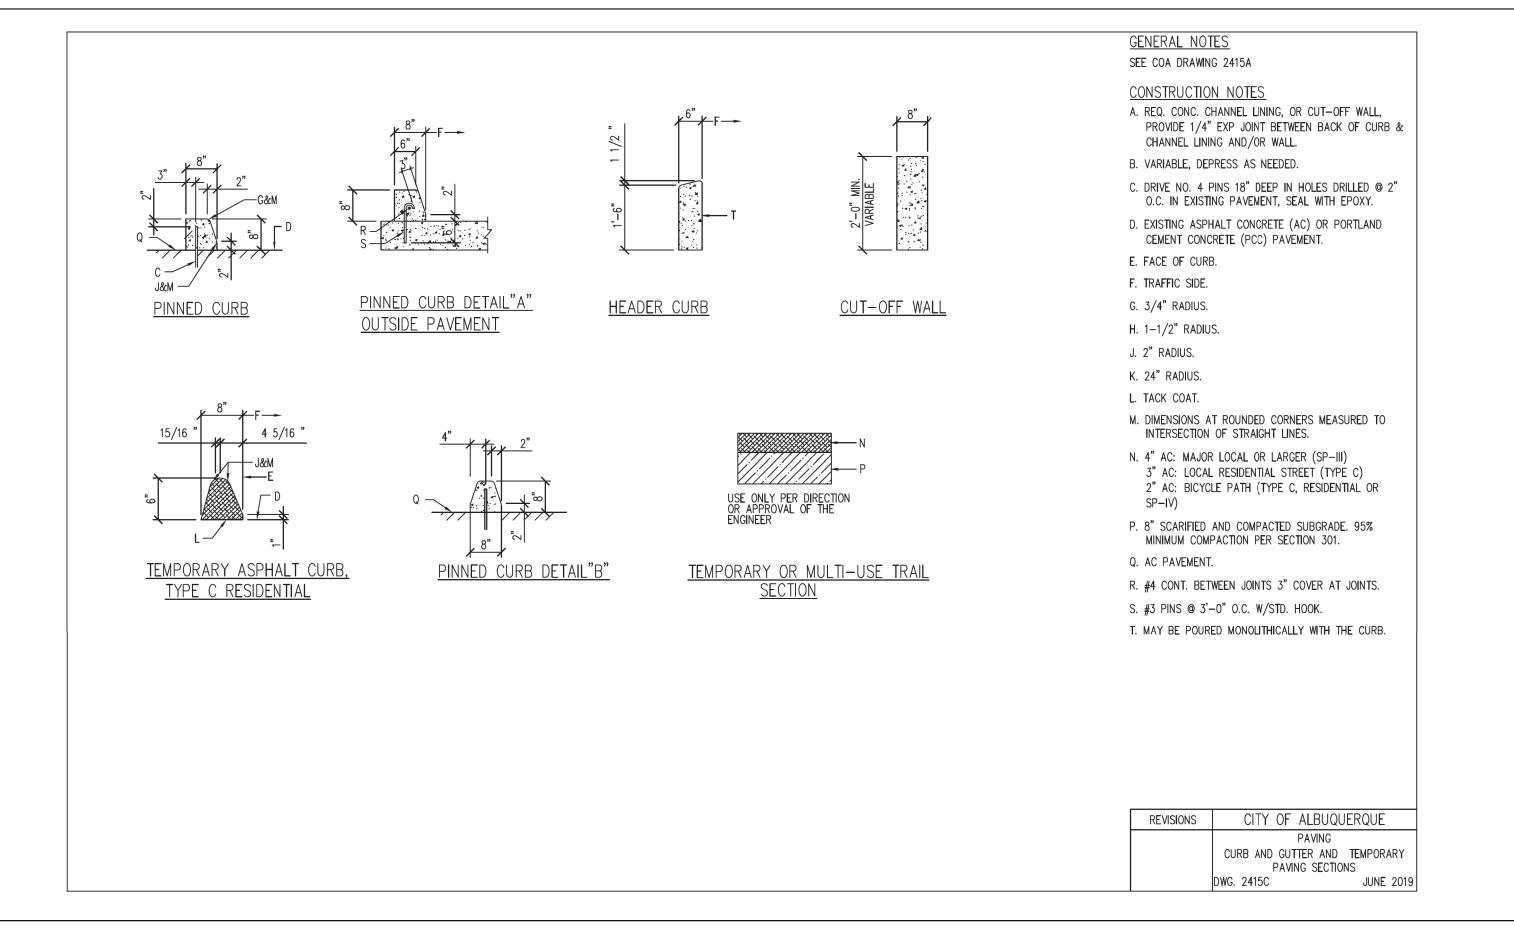

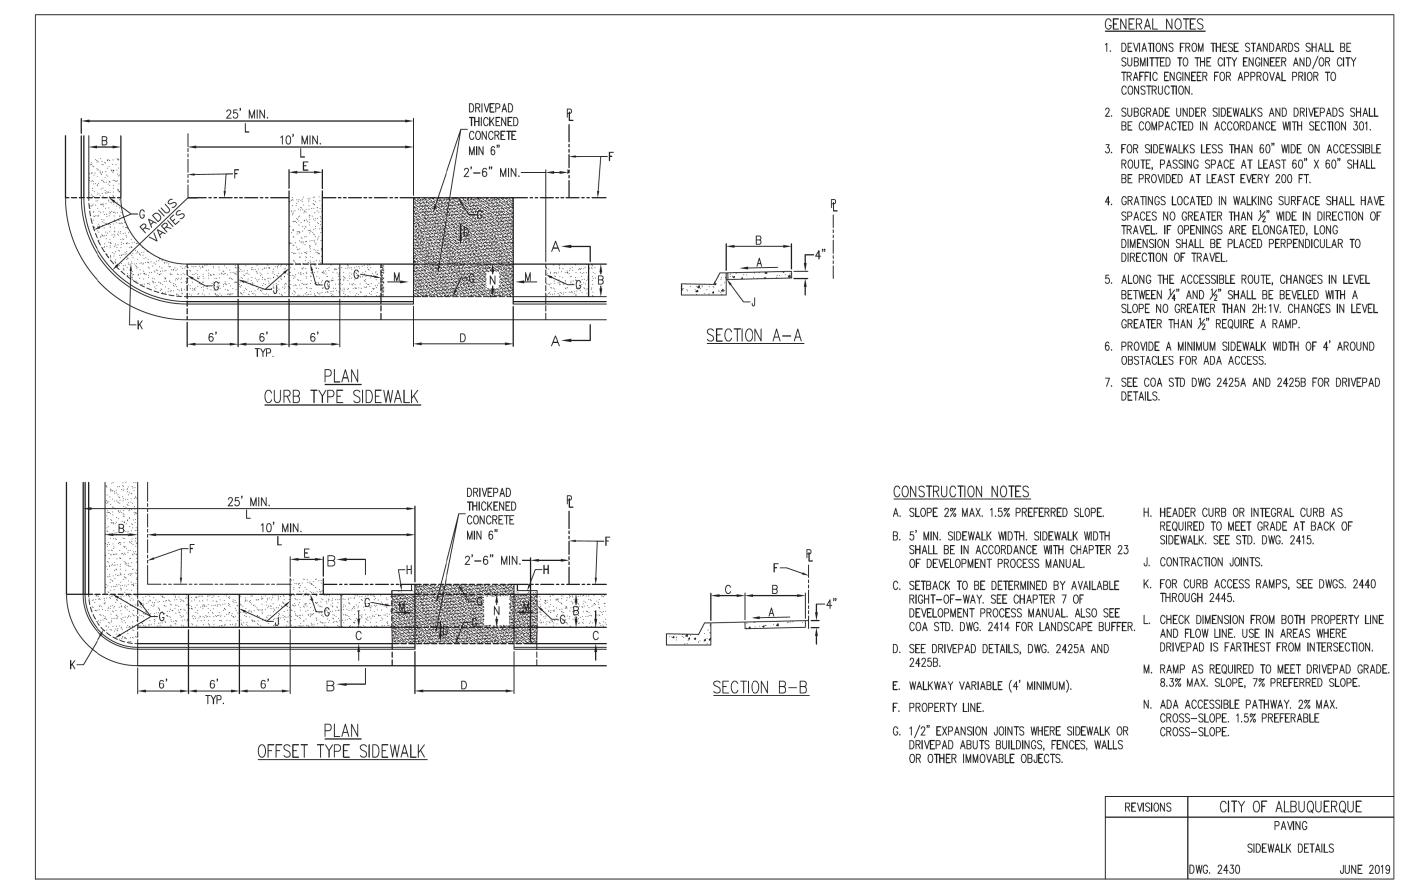

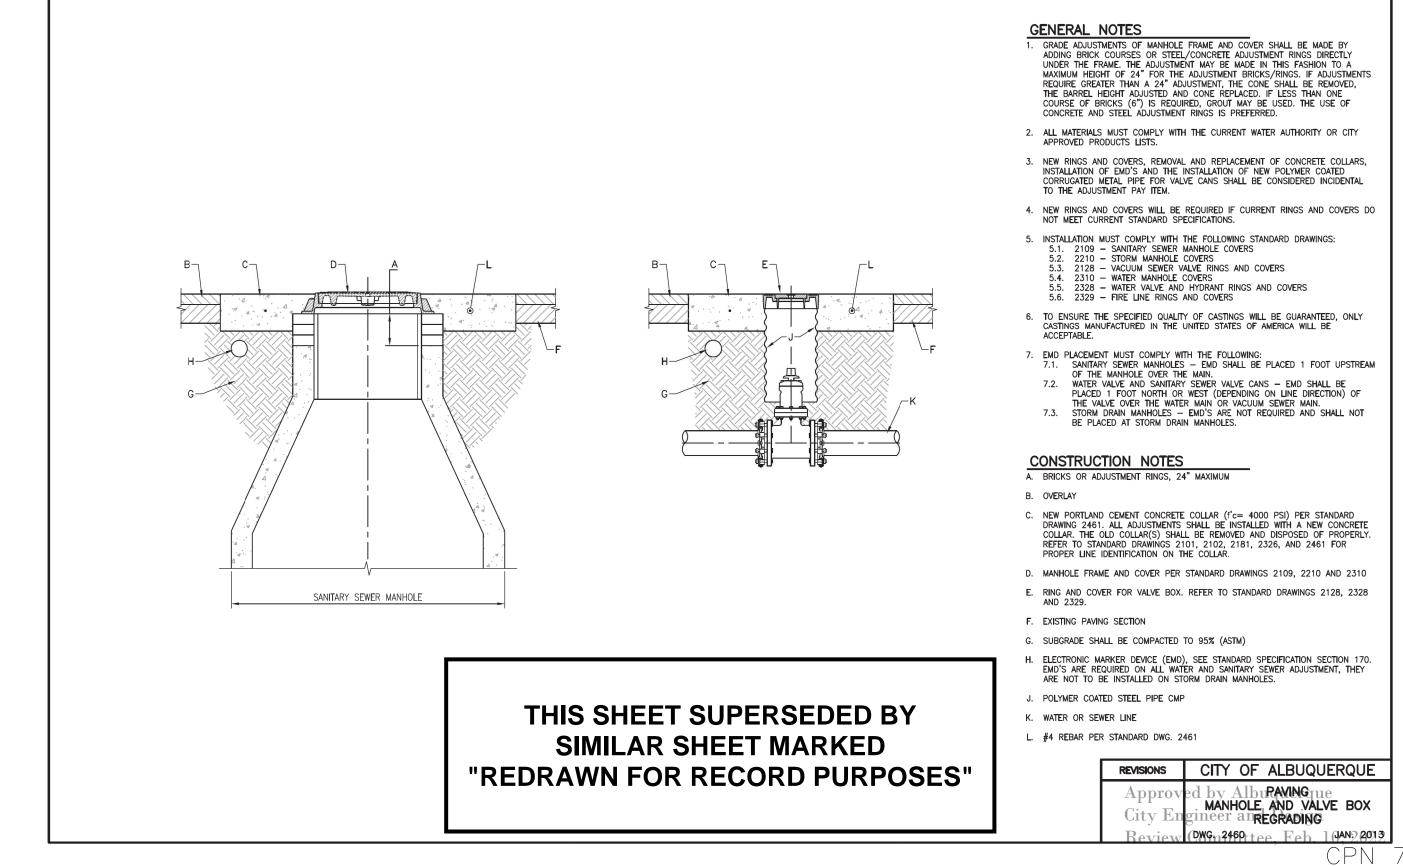

NO.	DATE	REVISION NO. & DESCRIPTION	BY	SCALE:		DESIGN TRACKIN	G	
				1"=	DESIGNED BY:	M COUTURE	DATE:	12/17/21
				ATTENTION	DRAWN BY:	C LAMB	DATE:	12/17/21
				0 1/2" 1"	CHECKED BY:	E FORD	DATE:	12/17/21
					CROSS CHK'D BY:	W CHRISTOFFERSON	DATE:	12/17/21
				GRAPHIC SCALE	APPROVED BY:	J PETERSON	DATE:	12/17/21
				THIS BAR MEASURES 1"	M	APS/RECORDS IN	IFO.	
				AT FULL SCALE (ANSI D)				_

**Jacobs** 

SUBMITTED BY:

3721 RUTLEDGE RD NE, SUITE B-1 ALBUQUERQUE, NM 87109 505-884-5600

AS BUILT INFORMATION	
CONTRACTOR ——	
CONSTRUCTION BEGIN DATE	
INSPECTOR'S DATE	
INSPECTOR'S NAME	Π÷
SUBSTANTIAL COMPLETION DATE	
DRAWINGS DATE	

WATER AUTHORITY


DT-4.dgn




WATER UTILITY AUTHORITY RAW WATER TRANSMISSION PIPELINE TO INTEL CORPORATION BID PACKAGE 1 WESTSIDE BLVD

STANDARD DETAILS

CONSTRUCTION PROJECT NO. 2320.030XX MAP NO. DT-04

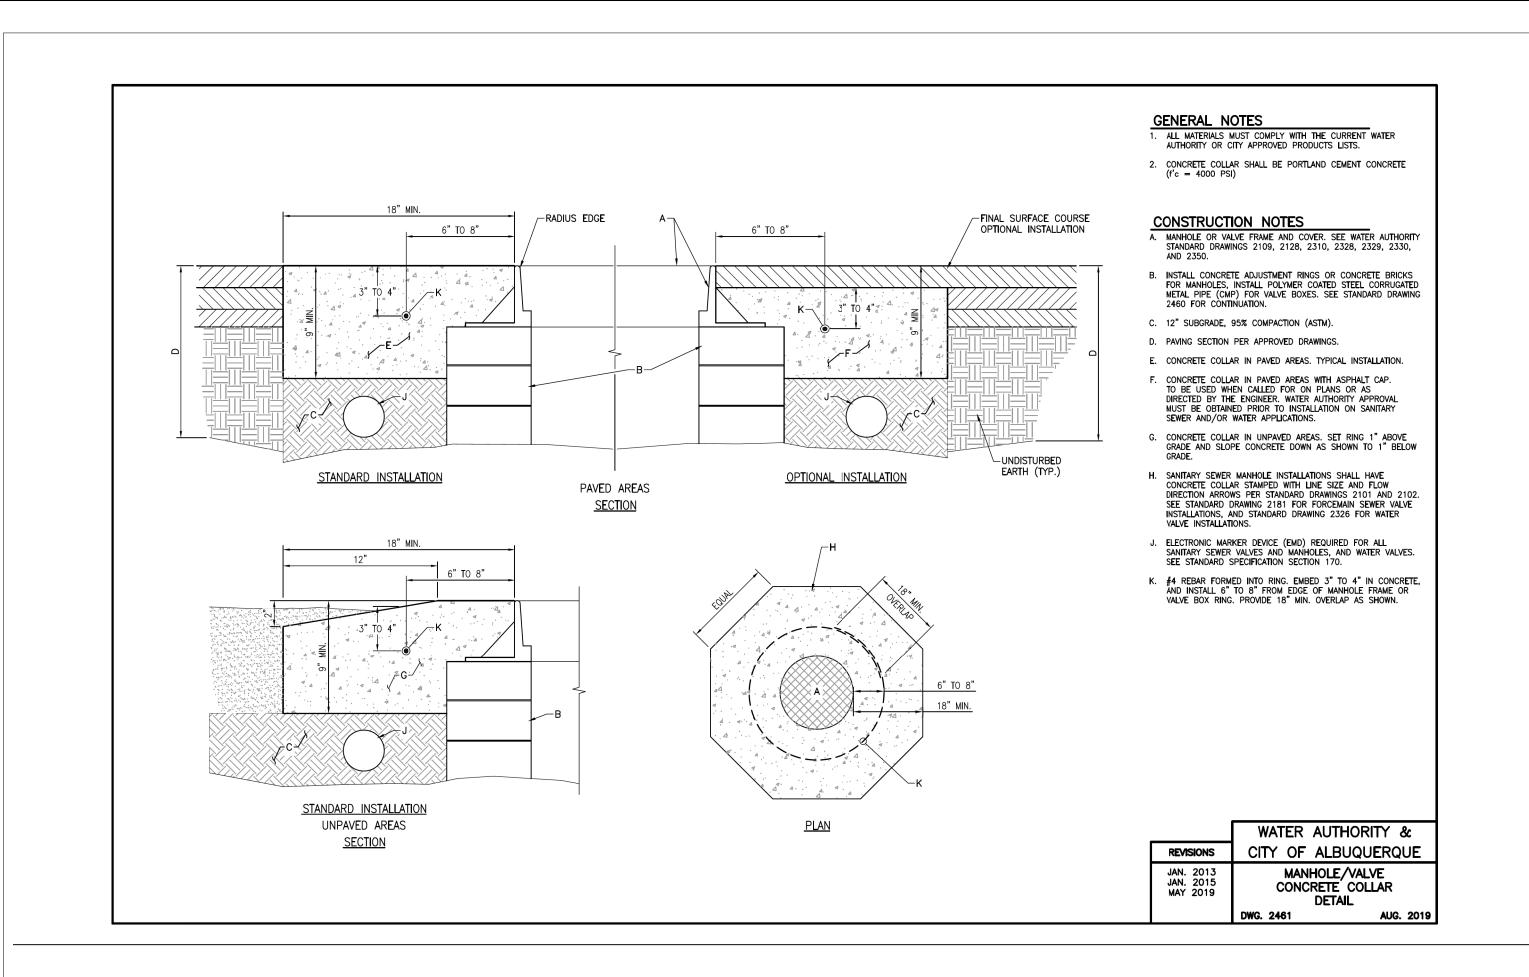

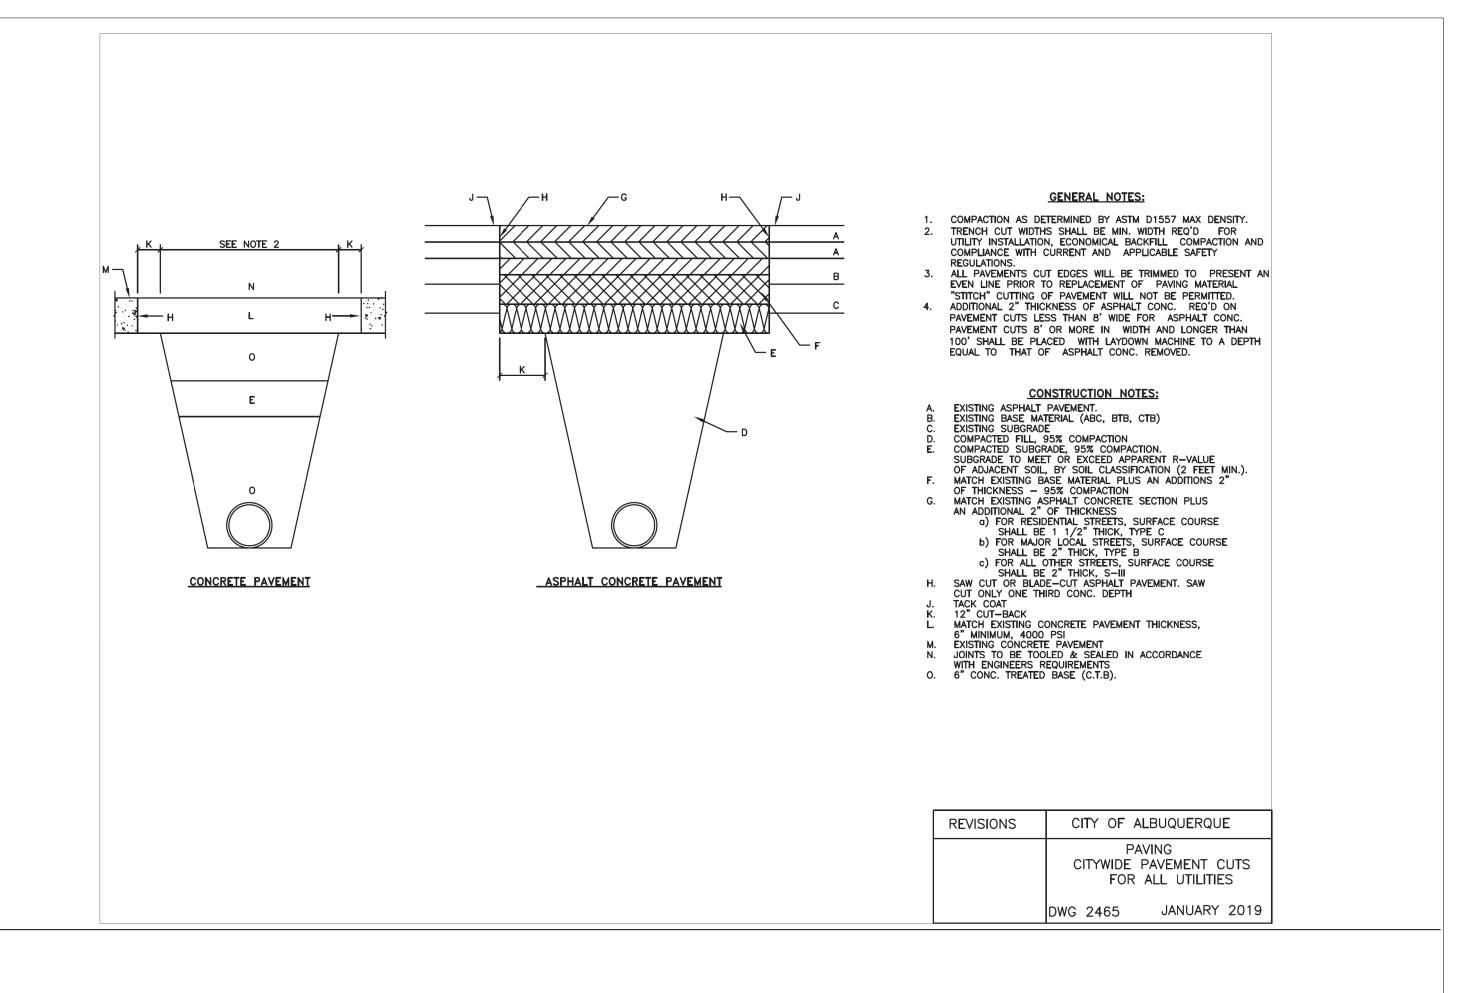

# THIS SHEET SUPERSEDED BY SIMILAR SHEET MARKED "REDRAWN FOR RECORD PURPOSES"

DT-5.dgn

Approved by Albuquerque City Engineer and Design Review Committee, Feb. 10, 2022 CPN 771863

REVISION NO. & DESCRIPTION BY DATE SCALE: 1"= DESIGNED BY M COUTURE DATE: C LAMB DATE: DRAWN BY: ATTENTION DATE: E FORD 0 1/2" 1" CHECKED BY: CROSS CHK'D BY: W CHRISTOFFERSON DATE: J PETERSON DATE: GRAPHIC SCALE APPROVED BY: THIS BAR MEASURES 1

AT FULL SCALE (ANSI D)

DESIGN TRACKING 12/17/21 12/17/21 12/17/21 12/17/21 12/17/21 MAPS/RECORDS INFO.

Jacobs

SUBMITTED BY:

3721 RUTLEDGE RD NE, SUITE B-1 ALBUQUERQUE, NM 87109 505-884-5600

AS BUILT INFORMAT	ION		
CONTRACTOR ——			
CONSTRUCTION BEGIN DATE			1
INSPECTOR'S ACCEPTANCE BY	DATE		
INSPECTOR'S NAME		// <del>*</del>	,
SUBSTANTIAL COMPLETION DATE			C
DRAWINGS	DATE		


	_
WATER	
MAICA	
\ \\ \\ \\ \\ \\ \\ \\ \\ \\ \\ \\ \\ \	
10.	
HOR	

	ALBUQUERQUE BERNALILLO	COUNTY
5	WATER UTILITY AUTHORI	ITY

RAW WATER TRANSMISSION PIPELINE TO INTEL CORPORATION BID PACKAGE 1 WESTSIDE BLVD

STANDARD DETAILS


WATER AUTHORITY CONSTRUCTION PROJECT NO. 2320.030XX MAP NO. DT-05

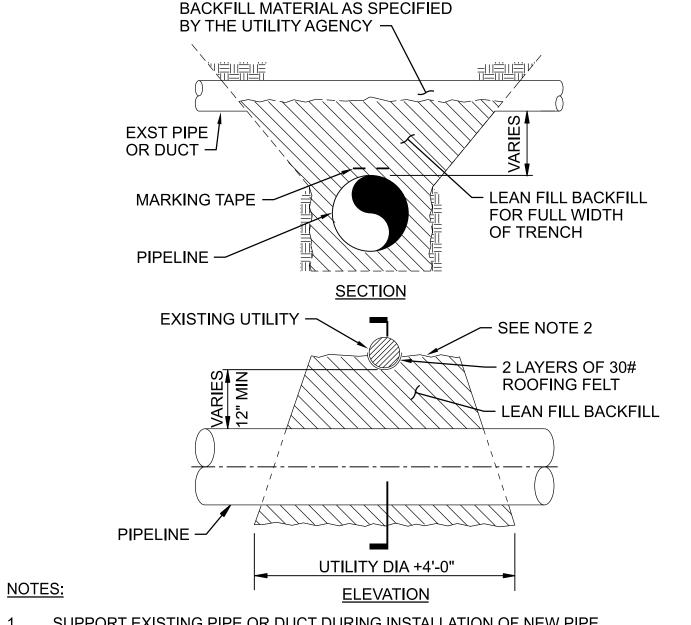

- SUPPORT EXISTING PIPE OR DUCT DURING INSTALLATION OF NEW PIPE.
- INSTALL LEAN FILL BACKFILL TO CENTERLINE OF EXISTING PIPE OR DUCT.
- UNDERGROUND UTILITY SUPPORT AS INDICATED IS TO BE PROVIDED AT UTILITY CROSSINGS 10" DIAMETER OR LARGER.
- MEET OR EXCEED UTILITY AGENCY REQUIREMENTS FOR BACKFILL.
- REMOVE AND REPLACE UTILITY MARKING TAPE, INCLUDE JOINING CLIPS, AS SPECIFIED BY UTILITY AGENCY.

MAJOR UTILITY CROSSING

3123-762

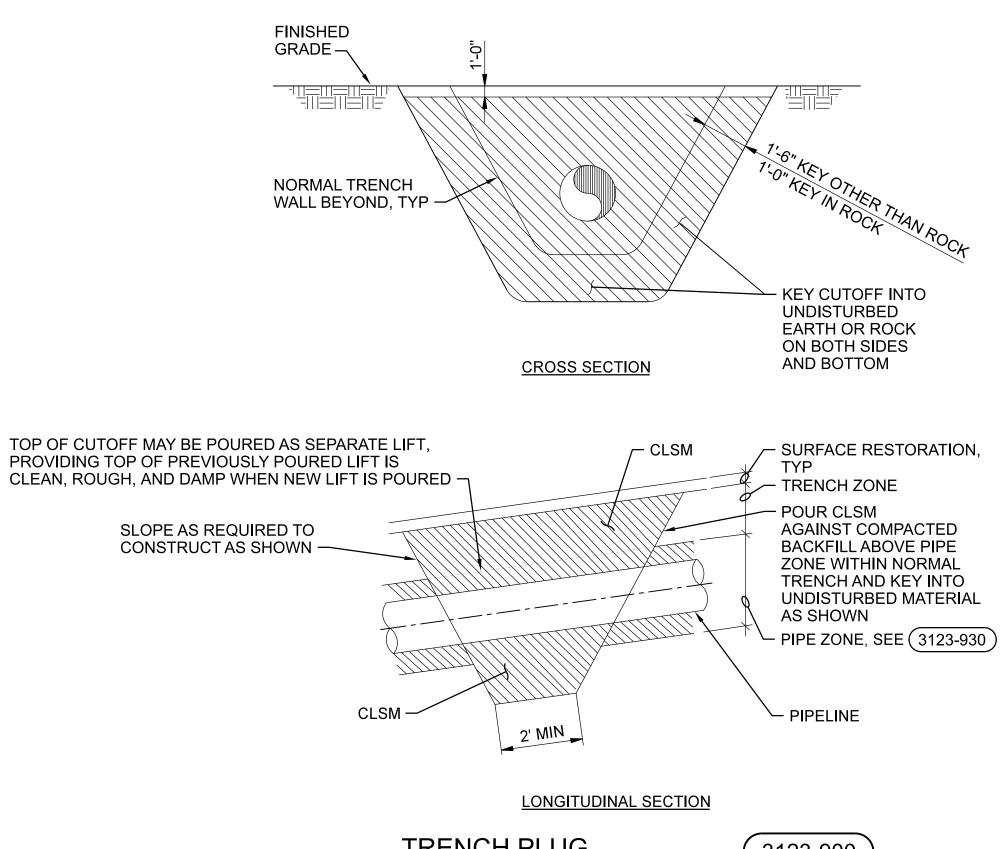

TRENCH PLUG

3123-900

**REDRAWN FOR RECORD PURPOSES** 


#### 13" PROPOSED ABC AGGREGATE 6" PROPOSED (BY OTHERS) PAVEMENT (BY OTHERS) -7' MAX 12" SUBGRADE PREPARATION 45 DEGREE PROJECTED **EXCAVATION LIMITS,** 95% COMPACTION, SEE NOTE 4 LINE, SEE NOTE 6 — SEE NOTE 1-PIPE COVER 12" SEE NOTE 5 AND 6 MARKING TAPE TRACE WIRE - TRENCH ZONE FINAL BACKFILL, NOTE 3 PIPE ZONE NOTE 2 12" MIN` 18" MAX – EXST 18" UNRESTRAINED PVC WATER PIPE BEDDING LINE, SEE NOTE 6 -TRENCH FOUNDATION PER COA SPECIFICATION SECTION 701.12 AS REQUIRED 7.5' MIN NON-WOVEN GEOTEXTILE

#### NOTES:

- 1. SEE SPECIFICATION 31 41 00, SHORING TEMPORARY EARTH RETENTION SYSTEM. DUE TO THE LIMITED AVAILABLE WORKING AREA, THE CONTRACTOR SHALL ASSUME VERTICAL TO NEAR-VERTICAL TRENCHES WILL BE REQUIRED ALONG THE ENTIRE ALIGNMENT. TEMPORARY WORKS TO ALLOW SAFE CONSTRUCTION, SUCH AS SHORING, ARE NOT SHOWN AND ARE CONSIDERED CONTRACTOR'S MEANS AND METHODS. THE CONTRACTOR SHALL BE SOLELY RESPONSIBLE FOR THE DESIGN AND IMPLEMENTATION OF ALL TEMPORARY WORKS, INCLUDING SHORING, TO COMPLY WITH OSHA REQUIREMENTS, TO ADDRESS FIELD CONDITIONS AND TO ACCOMPLISH THE WORK. THE CONTRACTOR SHALL BE SOLELY RESPONSIBLE FOR WORKER SAFETY.
- 2. PIPE ZONE MATERIAL AND BEDDING WITH SUITABLE NATIVE MATERIAL PER COA SPEC SECTION 701.13 AND COMPACTED TO 95% OF MODIFIED PROCTOR PER ASTM D-1557. CONTRACTOR TO DISPOSE OF UNSUITABLE NATIVE MATERIAL AND REPLACE WITH CLASS C MATERIAL FOR BEDDING AND WITH CLASS II OR III FOR PIPE ZONE AS REQUIRED.
- 3. BACKFILL TRENCH ZONE TO ELEVATION BELOW SUBGRADE WITH SUITABLE NATIVE FILL MATERIAL COMPACTED TO 95% OF MODIFIED PROCTOR PER ASTM D-1557 AND PER COA SPEC SECTION 701.14.
- 4. PREPARE SUBGRADE WITH SUITABLE NATIVE FILL MATERIAL COMPACTED TO 95% PER STANDARD SPECIFICATION 301.
- 5. EXST CURB AND GUTTER TO PROTECT IN PLACE UNLESS OTHERWISE INDICATED ON DRAWINGS.
- 6. EXISTING UTILITIES THAT FALL WITHIN A 45 DEGREE LINE PROJECTED UPWARD FROM ANY POINT OF THE TRENCH EXCAVATION SHALL BE MONITORED USING GEOTECHNICAL INSTRUMENTATION CONSISTING OF EITHER UTILITY MONITORING POINTS AND /OR INCLINOMETERS AS SHOWN IN DETAIL (3180-900). INSTRUMENTATION SHALL BE SPACED AT AN INTERVAL OF 250-FEET OR LESS

WHEN HORIZONTAL SEPARATION IS LESS THAN 10 FEET FROM THE OUTSIDE OF PROPOSED RAW WATER LINE EXCAVATION.

- 7. INSTRUMENTATION SHALL BE MONITORED FOR VERTICAL AND LATERAL DISPLACEMENT AT A MINIMUM OF TWO TIMES A DAY WHILE THE EXCAVATION IS OPEN. MOVEMENT LIMITS SHALL BE LESS THAN 0.5-INCHES IN THE VERTICAL AND HORIZONTAL DIRECTION. CONTACT THE ENGINEER IF LIMITS ARE REACHED TO DISCUSS HOW MOVEMENT WILL BE LIMITED. THE CONTRACTOR SHALL STOP ALL WORK IMMEDIATELY AND NOTIFY THE ENGINEER IF MOVEMENTS CONTINUE AND EXCEED 1.0-INCH.
- 8. THE CONTRACTOR SHALL SUBMIT THEIR GEOTECHNICAL INSTRUMENTATION MONITORING PLAN ASSOCIATED WITH THE INSTALLATION OF THE PROPOSED RAW WATER LINE TO THE ENGINEER FOR APPROVAL. THE PLAN SHALL INCLUDE AT A MINIMUM; THE LOCATION AND TYPE OF INSTRUMENTATION PROPOSED, AND THE STEPS THAT SHALL BE USED FOR MONITORING EACH INSTRUMENT.

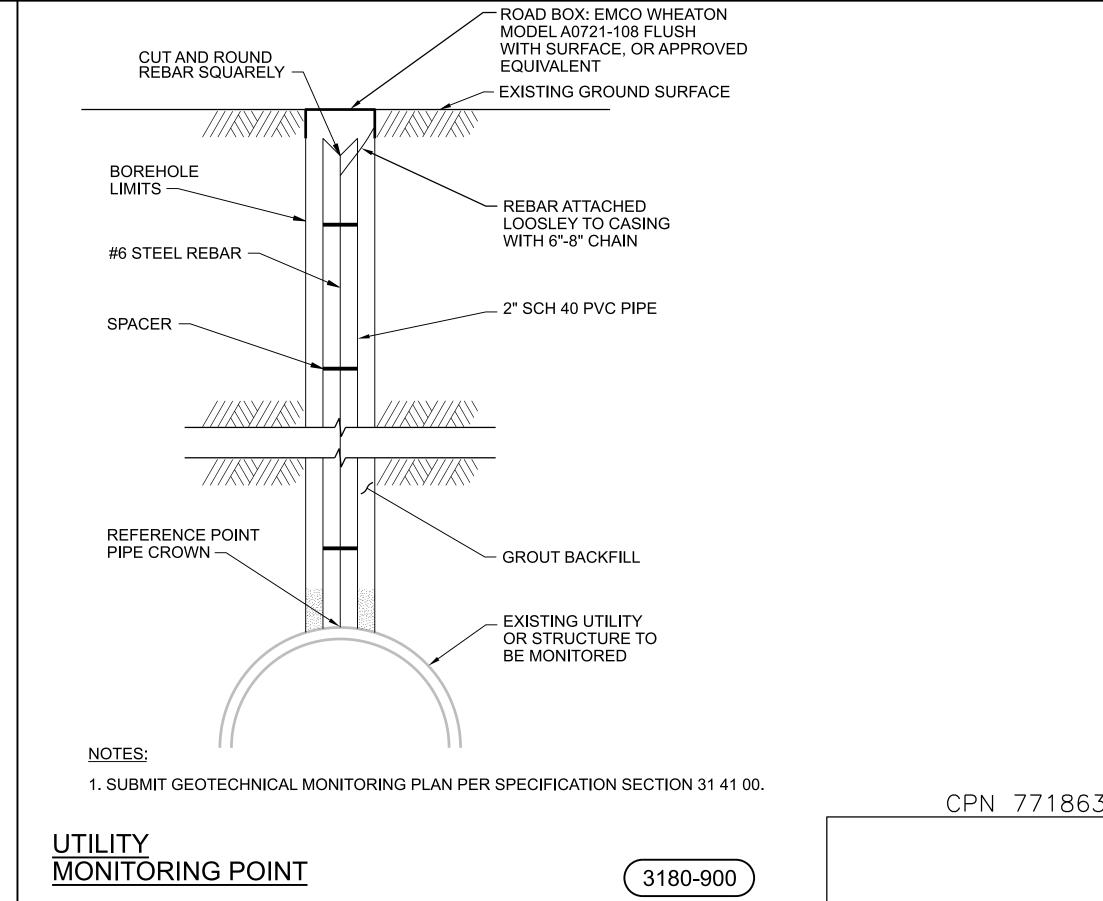

TYPICAL PIPE TRENCH

AT FULL SCALE (ANSI D)

MIRAFI 140N OR EQUAL 2'

MIN OVERLAP ON TOP OF PIPE

(3123-915)

DESIGN TRACKING SCALE: 1"= DATE: **12/2021** DESIGNED BY M COUTURE DATE: **12/2021** DRAWN BY: C LAMB ATTENTION CHECKED BY: E FORD DATE: **12/2021** 0 1/2" 1' W CHRISTOFFERSON | DATE: 12/2021 CROSS CHK'D BY: J PETERSON DATE: **12/2021** GRAPHIC SCALE APPROVED BY: THIS BAR MEASURES MAPS/RECORDS INFO.

**Jacobs** 

3721 RUTLEDGE RD NE, SUITE B-1 ALBUQUERQUE, NM 87109 505-884-5600

SUBMITTED BY:

AS BUILT INFORMATION ENGINEER'S SEAL CONTRACTOR AUI, INC THIS DOCUMENT IS AN ELECTRONIC COPY. CONSTRUCTION 3/01/2022 BEGIN DATE **ORIGINAL DOCUMENT** WAS ISSUED AND INSPECTOR'S **JACOBS** DATE **5/31/2022** ACCEPTANCE BY SEALED ON 12/17/2021 INSPECTOR'S NAME L KOIKE/V TORRES THE ORIGINAL DOCUMENT COMPLETION DATE 5/31/2022 SUBSTANTIAL IS STORED AT THE OFFICES OF JACOBS DRAWINGS JACOBS 8/2022 ALBUQUERQUE, NM. CORRECTED BY

ALBUQUERQUE BERNALILLO COUNTY WATER UTILITY AUTHORITY

RAW WATER TRANSMISSION PIPELINE TO INTEL CORPORATION BID PACKAGE 1 WESTSIDE BLVD

STANDARD DETAILS

WATER AUTHORITY 2320.03001 ZONE A-12 MAP NO. A-13 DT-06 CONSTRUCTION PROJECT NO.

DT-6.dgn

ØETHIS INFORMATION AND SHALL NOT BE RESPONSIBLE FOR ANY EARORS OR OMISSIONS WHICH MAY BE INCORPORATED HEREIN AS A RESULT.

**RECORD DRAWINGS** 


THESE RECORD DOCUMENTS HAVE BEEN PREPARED BASED ON

NOR MANNER OF CONSTRUCTION. THE DESIGN PROFESSIONAL

HAS NOT VERIFIED THE ACCURACY AND/OR THE COMPLETENESS

INFORMATION PROVIDED BY OTHERS. THEY ARE NOT INTENDED TO

REPRESENT IN DETAIL THE EXACT LOCATION. TYPE OF COMPONENT

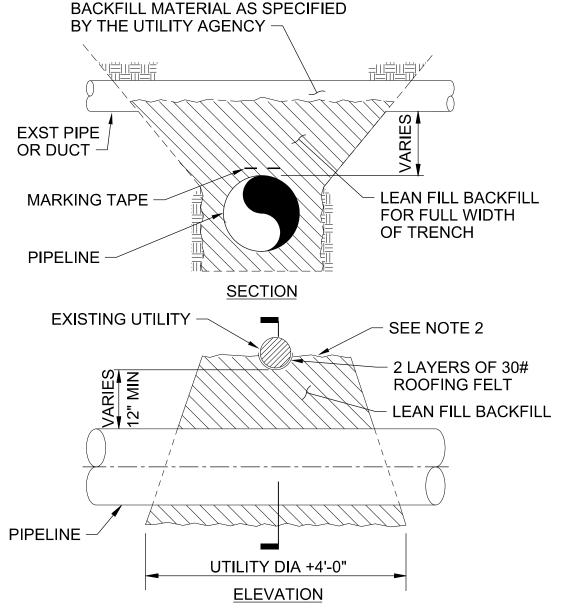


- SUPPORT EXISTING PIPE OR DUCT DURING INSTALLATION OF NEW PIPE.
- INSTALL LEAN FILL BACKFILL TO CENTERLINE OF EXISTING PIPE OR DUCT.
- UNDERGROUND UTILITY SUPPORT AS INDICATED IS TO BE PROVIDED AT UTILITY CROSSINGS 10" DIAMETER OR LARGER.
- MEET OR EXCEED UTILITY AGENCY REQUIREMENTS FOR BACKFILL.
- REMOVE AND REPLACE UTILITY MARKING TAPE, INCLUDE JOINING CLIPS, AS SPECIFIED BY UTILITY AGENCY.

MAJOR UTILITY CROSSING

NOTES:

3123-762

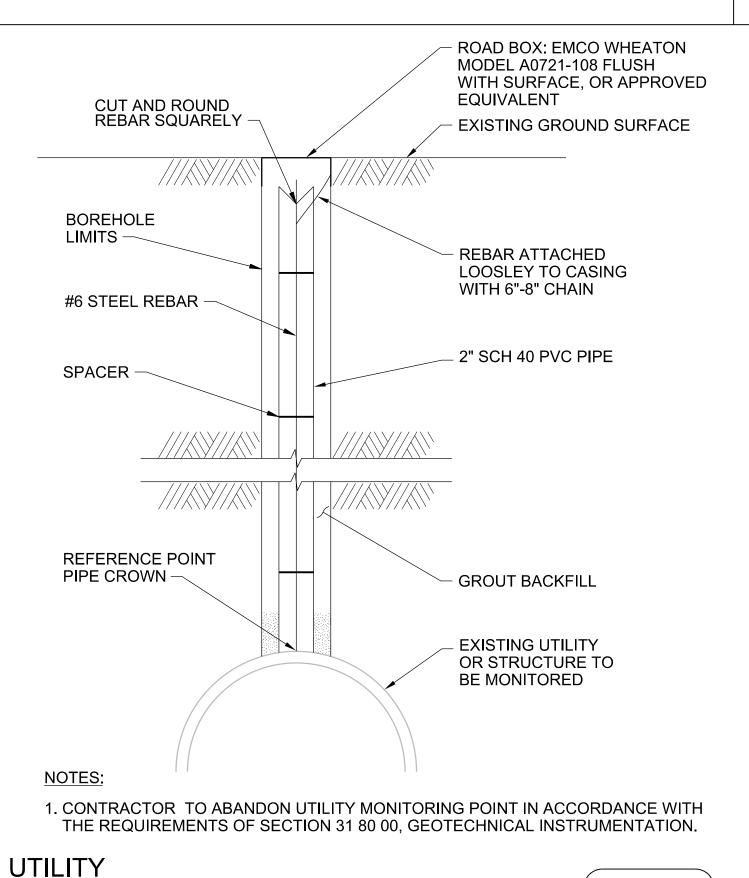

3180-900

#### 13" PROPOSED ABC AGGREGATE 6" PROPOSED (BY OTHERS) PAVEMENT (BY OTHERS) -12" SUBGRADE PREPARATION 7' MAX 45 DEGREE PROJECTED EXCAVATION LIMITS, 95% COMPACTION, SEE NOTE 4 LINE, SEE NOTE 6 SEE NOTE PIPE COVER 12" SEE NOTE 5 AND 6 MARKING TAPE TRACER WIRE TRENCH ZONE FINAL BACKFILL, NOTE 3 PIPE ZONE NOTE 2 12" MIN 18" MAX EXST 18" UNRESTRAINED **PVC WATER** PIPE BEDDING LINE, SEE NOTE 6 TRENCH FOUNDATION PER COA

7.5' MIN

#### NOTES:

- 1. SEE SPECIFICATION 31 41 00, SHORING TEMPORARY EARTH RETENTION SYSTEM. DUE TO THE LIMITED AVAILABLE WORKING AREA. THE CONTRACTOR SHALL ASSUME VERTICAL TO NEAR-VERTICAL TRENCHES WILL BE REQUIRED ALONG THE ENTIRE ALIGINMENT. TEMPORARY WORKS TO ALLOW SAFE CONSTRUCTION, SUCH AS SHORING, ARE NOT SHOWN AND ARE CONSIDERED CONTRACTOR'S MEANS AND METHODS. THE CONTRACTOR SHALL BE SOLELY RESPONSIBLE FOR THE DESIGN AND IMPLEMENTATION OF ALL TEMPORARY WORKS, INCLUDING SHORING, TO COMPLY WITH OSHA REQUIREMENTS, TO ADDRESS FIELD CONDITIONS AND TO ACCOMPLISH THE WORK. THE CONTRACTOR SHALL BE SOLELY RESPONSIBLE FOR WORKER SAFETY.
- 2. PIPE ZONE MATERIAL AND BEDDING WITH SUITABLE NATIVE MATERIAL PER COA SPEC SECTION 701.13 AND COMPACTED TO 95% OF MODIFIED PROCTOR PER ASTM D-1557. CONTRACTOR TO DISPOSE OF UNSUITABLE NATIVE MATERIAL AND REPLACE WITH CLASS C MATERIAL FOR BEDDING AND WITH CLASS II OR III FOR PIPE ZONE AS REQUIRED.
- 3. BACKFILL TRENCH ZONE TO ELEVATION BELOW SUBGRADE WITH SUITABLE NATIVE FILL MATERIAL COMPACTED TO 95% OF MODIFIED PROCTOR PER ASTM D-1557 AND PER COA SPEC SECTION 701.14.
- 4. PREPARE SUBGRADE WITH SUITABLE NATIVE FILL MATERIAL COMPACTED TO 95% PER STANDARD SPECIFICATION 301.
- 5. EXST CURB AND GUTTER TO PROTECT IN PLACE UNLESS OTHERWISE INDICATED ON DRAWINGS.
- 6. EXISTING UTILITIES THAT FALL WITHIN A 45 DEGREE LINE PROJECTED UPWARD FROM ANY POINT OF THE TRENCH EXCAVATION SHALL BE MONITORED USING GEOTECHNICAL INSTRUMENTATION CONSISTING OF EITHER UTILITY MONITORING POINTS AND /OR INCLINOMETERS AS SHOWN IN DETAIL 3180-900. INSTRUMENTATION SHALL BE SPACED AT AN INTERVAL OF 250-FEET OR LESS WHEN HORIZONTAL SEPARATION IS LESS THAN 10 FEET FROM THE OUTSIDE OF PROPOSED RAW WATER LINE EXCAVATION.
- 7. INSTRUMENTATION SHALL BE MONITORED FOR VERTICAL AND LATERAL DISPLACEMENT AT A MINIMUM OF TWO TIMES A DAY WHILE THE EXCAVATION IS OPEN. MOVEMENT LIMITS SHALL BE LESS THAN 0.5-INCHES IN THE VERTICAL AND HORIZONTAL DIRECTION. CONTACT THE ENGINEER IF LIMITS ARE REACHED TO DISCUSS HOW MOVEMENT WILL BE LIMITED. THE CONTRACTOR SHALL STOP ALL WORK IMMEDIATELY AND NOTIFY THE ENGINEER IF MOVEMENTS CONTINUE AND EXCEED 1.0-INCH.
- 8. THE CONTRACTOR SHALL SUBMIT THEIR GEOTECHNICAL INSTRUMENTATION MONITORING PLAN ASSOCIATED WITH THE INSTALLATION OF THE PROPOSED RAW WATER LINE TO THE ENGINEER FOR APPROVAL. THE PLAN SHALL INCLUDE AT A MINIMUM; THE LOCATION AND TYPE OF INSTRUMENTATION PROPOSED, AND THE STEPS THAT SHALL BE USED FOR MONITORING EACH INSTRUMENT.


TYPICAL PIPE TRENCH

REQUIRED

SPECIFICATION SECTION 701.12 AS

3123-915

# THIS SHEET SUPERSEDED BY SIMILAR SHEET MARKED "REDRAWN FOR RECORD PURPOSES"

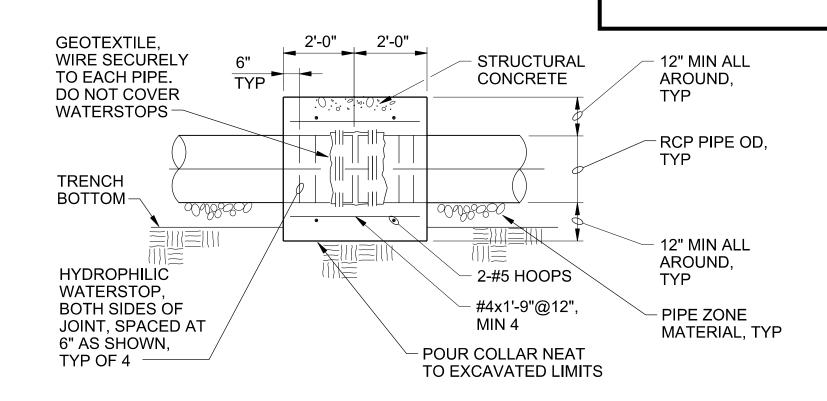

**SECTION** 

CONCRETE CLOSURE COLLAR

Dec. 21, 2021 DESIGN REVIEW COMMITTEE

3305-951 Approved by Albuquerque City Engineer and Design Review Committee, Feb. 10, 2022

CPN 771863

REVISION NO. & DESCRIPTION BY DATE SCALE: DESIGN TRACKING NO. 1"= DESIGNED BY M COUTURE 12/21/21 DATE: C LAMB DATE: 12/21/21 DRAWN BY: ATTENTION CHECKED BY: E FORD DATE: 12/21/21 0 1/2" 1 W CHRISTOFFERSON DATE: 12/21/21 CROSS CHK'D BY: J PETERSON DATE: 12/21/21 GRAPHIC SCALE APPROVED BY: THIS BAR MEASURES MAPS/RECORDS INFO.

AT FULL SCALE (ANSI D)

MONITORING POINT

Jacobs

3721 RUTLEDGE RD NE, SUITE B-1 ALBUQUERQUE, NM 87109 505-884-5600

SUBMITTED BY:

AS BUILT	INFORMATION	
CONTRACTOR		/
CONSTRUCTION		
INSPECTOR'S ACCEPTANCE BY	DATE ——	COEN
INSPECTOR'S NAME		ζ.
SUBSTANTIAL COMPLETION DATE		13
DRAWINGS CORRECTED BY	DATE	12






RAW WATER TRANSMISSION PIPELINE TO INTEL CORPORATION BID PACKAGE 1 WESTSIDE BLVD

STANDARD DETAILS

WATER AUTHORITY CONSTRUCTION PROJECT NO. 2320.030XX X MAP NO. DT-06 DT-6.dgn

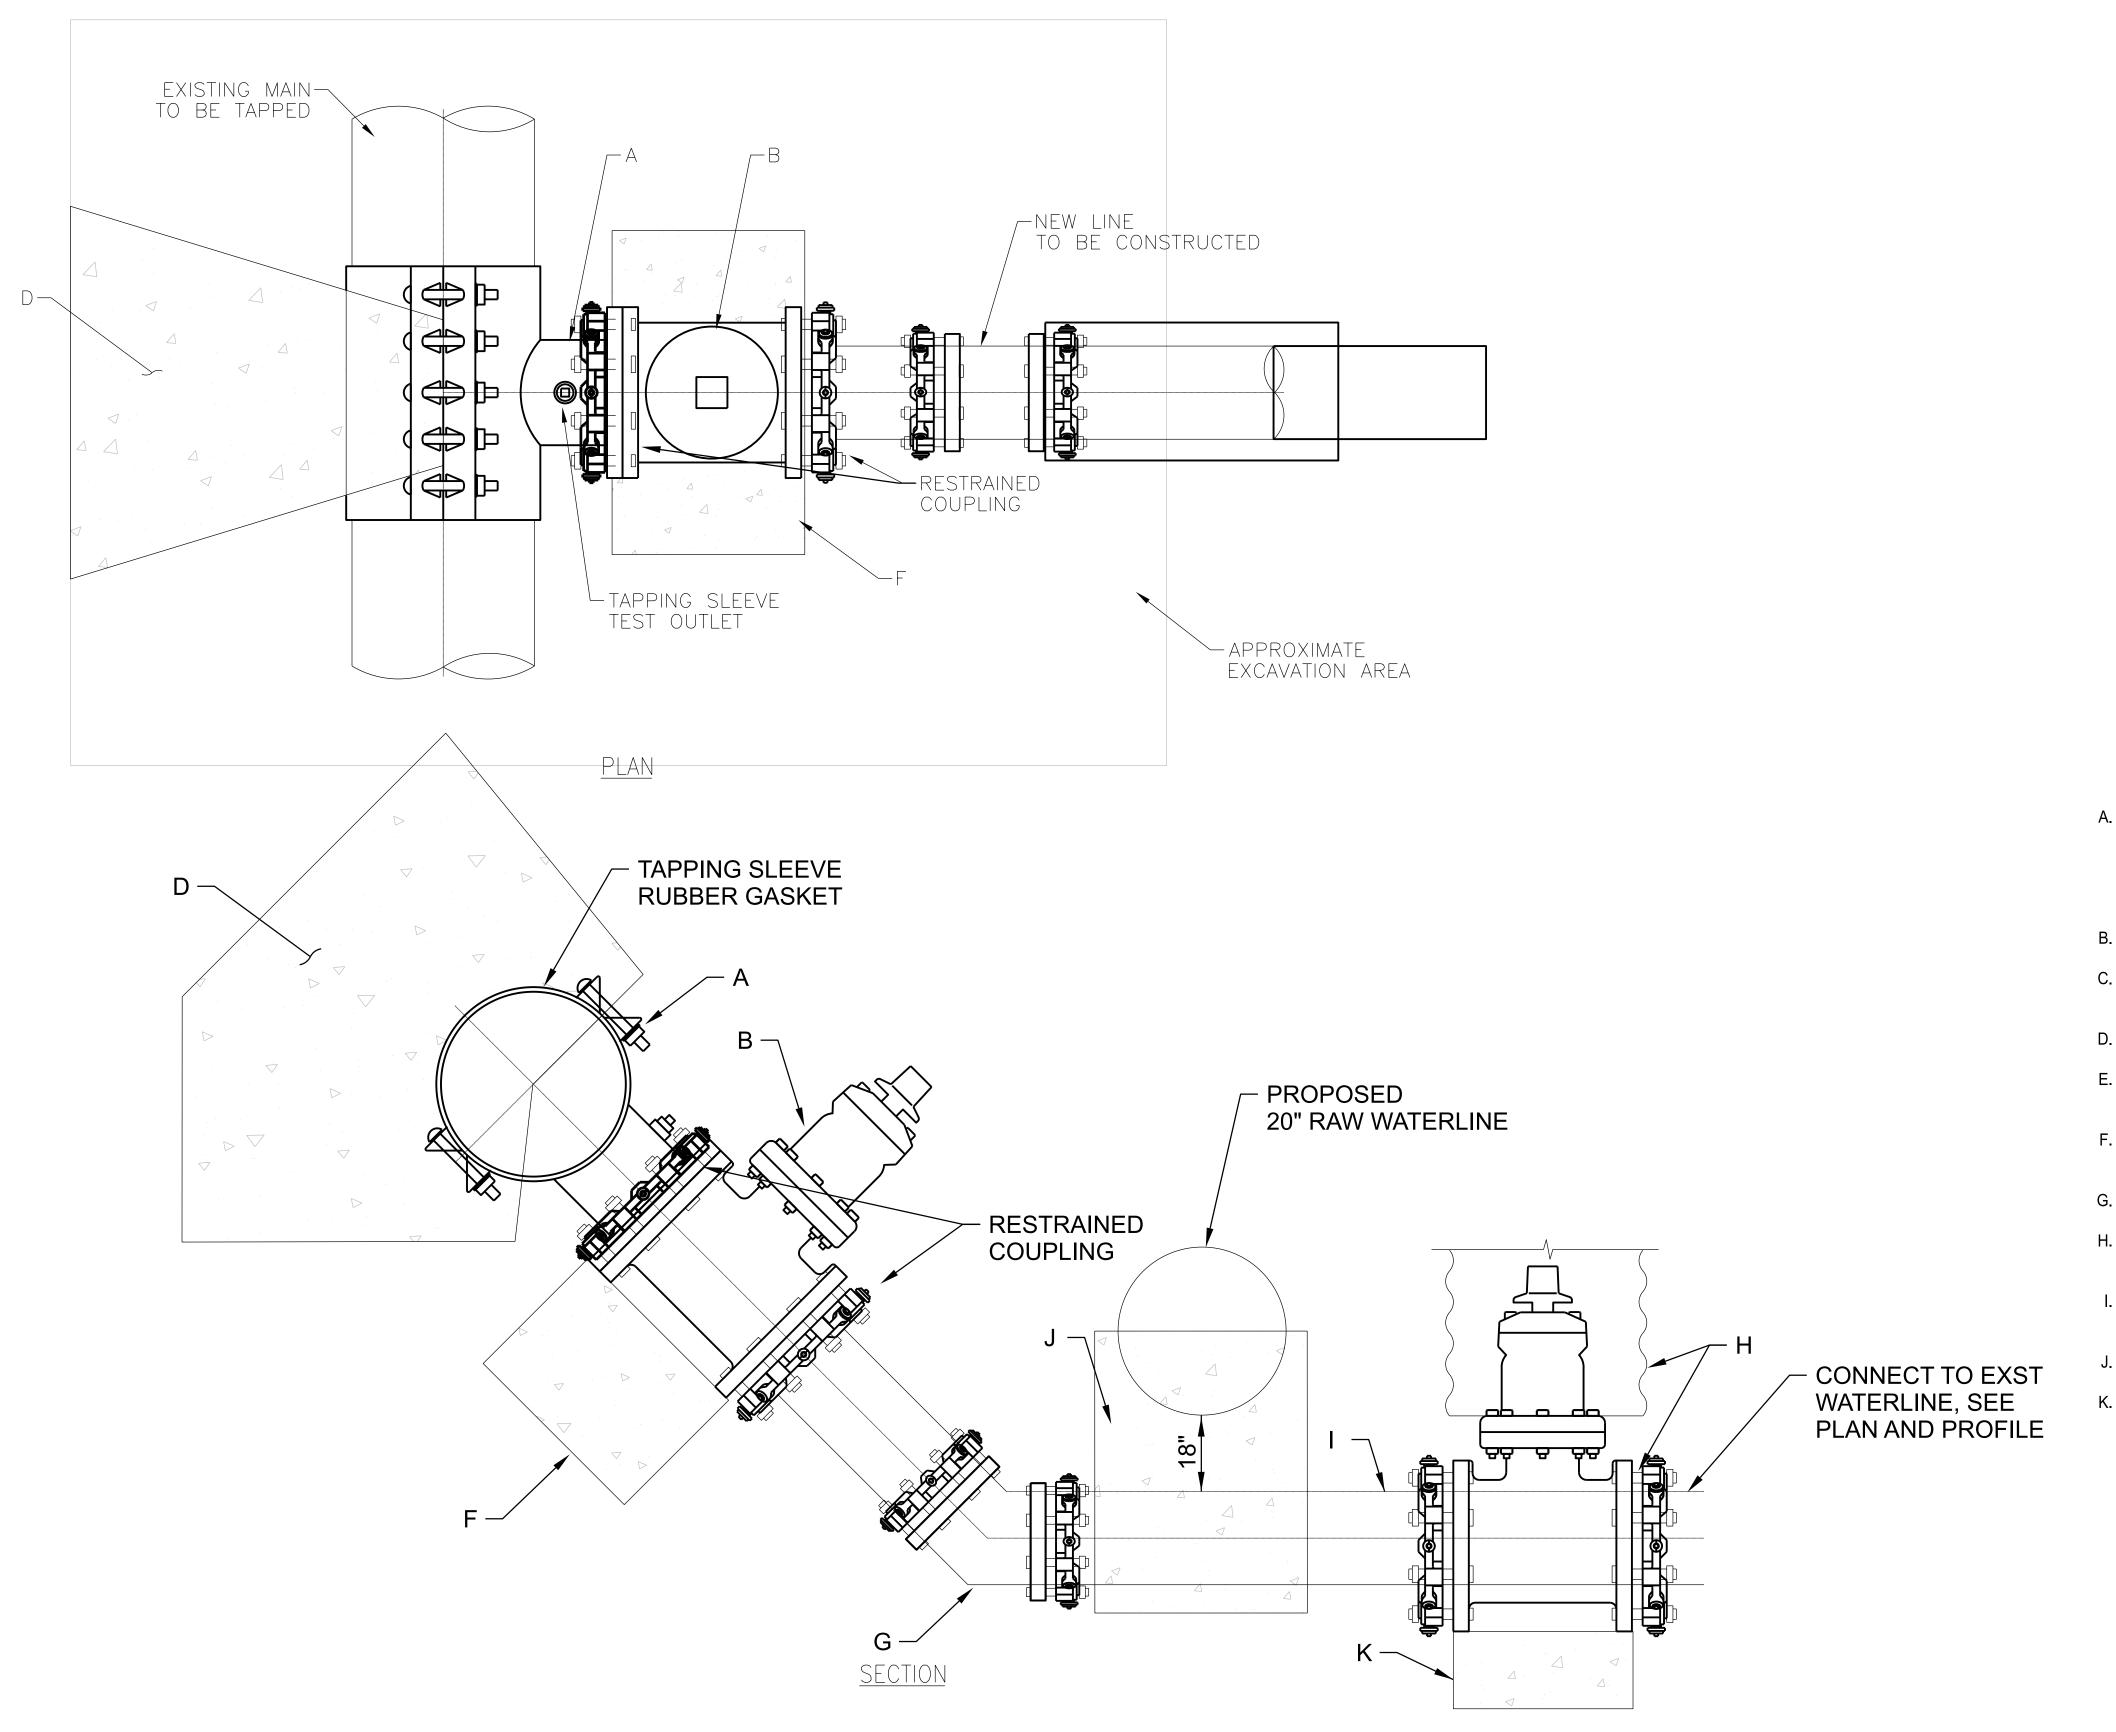

#### **GENERAL NOTES**

- 1. ALL PARTS WITHIN THIS INSTALLATION, INCLUDING THE TAPPING SLEEVE PRODUCT, MUST COINCIDE WITH THE CURRENT WATER AUTHORITY APPROVED PRODUCTS LIST.
- 2. CONFIRM THAT THE TAP DOES NOT EXCEED 2/3 OF THE EXISTING MAIN SIZE.
- 3. A HYDROSTATIC TEST OF THE TAPPING SLEEVE AND VALVE IS MANDATORY PRIOR TO TAPPING THE MAIN.
- 4. A WATER AUTHORITY INSPECTOR SHALL VIEW THE PIPE CONDITION AND INSPECT THE INSTALLATION OF THE SLEEVE PRIOR TO GIVING APPROVAL TO PERFORM THE
- 5. PROTECT ALL NEW PIPING AND PARTS IN CONTACT WITH CONCRETE WITH 8 MIL SHEET PLASTIC.
- 6. THE TAP WILL BE PERFORMED BY A COMPETENT AND KNOWLEDGEABLE INSTALLER, STRICTLY FOLLOWING THE MANUFACTURER'S INSTRUCTIONS. CONTRACTOR SHALL PROVIDE QUALIFICATIONS FOR THE WATER AUTHORITY'S CONSIDERATION AND APPROVAL.
- 7. LABEL REQUIREMENTS: BEFORE THE WORK WILL BE ACCEPTED, WATER VALVE GPS COORDINATES SHALL BE PROVIDED ON THE RECORD DRAWINGS. GPS COORDINATES OBTAINED BY A PROFESSIONAL SURVEYOR LICENSED IN THE STATE OF NEW MEXICO SHALL BE TAKEN AT THE VALVE OPERATING NUT. USE THE NAD 1983 NM STATE PLANE CENTRAL ZONE FOR X AND Y COORDINATES AND NAVD 1988 FOR Z COORDINATE.
- 8. ANY DEVIATION FROM THIS STANDARD DRAWING REQUIRES WRITTEN AUTHORIZATION FROM THE WATER UTILITY AUTHORITY.
- 9. ALL PIPELINE AND FITTINGS TO BE FULLY RESTRAINED.
- 10. BACKFILL TRENCH PER STD DWG (3123-915) OR TO EXISTING FINAL GRADE AS SPECIFIED ON DRAWINGS.

#### **CONSTRUCTION NOTES**

- TAPPING SLEEVE. THE CONTRACTOR SHALL EXPOSE THE PROPOSED TAPPING LOCATION A MINIMUM 3' FROM ANY BELL, COUPLING, VALVE, FITTING, OR OTHER OBSTRUCTION. THOROUGHLY CLEAN WATER MAIN WITH WIRE BRUSH PRIOR TO INSTALLATION OF TAPPING SLEEVE. FLANGE FACE SHALL BE INSTALLED VERTICALLY TRUE AND PLUMB.
- GATE VALVE. USE FL x MJ OR MJ x MJ ALL BOLTS SHALL BE CLEAR OF FOOTING.
- UNDISTURBED EARTH OR COMPACTED SUBGRADE, SEE SECTION 701. 95% DENSITY PER ASTM D 1557.
- THRUST BLOCKING PER STANDARD DRAWING 2320.
- THE TAPPING SLEEVE SHALL BE SUPPORTED BY LEAN FILL/SLURRY TO PREVENT UNDUE STRESS ON THE TAPPING SLEEVE AND VALVE ASSEMBLY.
- VALVE SHALL BE SUPPORTED BY BLOCKING PER STANDARD DRAWING 2320 DURING AND AFTER INSTALLATION.
- DUCTILE IRON FITTING 45 DEGREE BEND MJxMJ.
- GATE VALVE USE MJxMJ INSTALL WATER VALVE BOX PER STD DWG 2326 WITH RING AND COVER FOR POTABLE WATER PER STD DRAWING 2328.
- LEAN FILL ENCASE WATER LINE ON EACH SIDE OF CROSSING WITH PROPOSED RAW WATER LINE TO JOINT UP TO 10' ON BOTH SIDE.
- INSTALL CONCRETE CRADLE SUPPORT PER STD DTL (3123-762)
- ANCHOR GATE VALVE PER STD DWG 2333.

CPN 771863

# **REDRAWN FOR RECORD PURPOSES**

THESE RECORD DOCUMENTS HAVE BEEN PREPARED BASED ON INFORMATION PROVIDED BY OTHERS. THEY ARE NOT INTENDED TO REPRESENT IN DETAIL THE EXACT LOCATION. TYPE OF COMPONENT NOR MANNER OF CONSTRUCTION. THE DESIGN PROFESSIONAL HAS NOT VERIFIED THE ACCURACY AND/OR THE COMPLETENESS OF THIS INFORMATION AND SHALL NOT BE RESPONSIBLE FOR ANY ERRORS OR OMISSIONS WHICH MAY BE INCORPORATED HEREIN

**RECORD DRAWINGS** 

AS A RESULT.

SCALE: 1"= ATTENTION 0 1/2" 1" GRAPHIC SCALE THIS BAR MEASURES 1 AT FULL SCALE (ANSI D)

DESIGN TRACKING M COUTURE DATE: **12/2021** DESIGNED BY C LAMB DATE: **12/2021** DRAWN BY: DATE: **12/2021** CHECKED BY: E FORD CROSS CHK'D BY: W CHRISTOFFERSON DATE: 12/2021 J PETERSON DATE: **12/2021** APPROVED BY: MAPS/RECORDS INFO.

Jacobs

SUBMITTED BY:

3721 RUTLEDGE RD NE, SUITE B-1 ALBUQUERQUE, NM 87109 505-884-5600

AS BUILT INFORMATI	ON		ENGINEER'S SEAL
CONTRACTOR AUI, INC			THIS DOCUMENT IS AN
CONSTRUCTION 3/01/2022 BEGIN DATE			ELECTRONIC COPY. ORIGINAL DOCUMENT
INSPECTOR'S JACOBS	DATE	5/31/2022	WAS ISSUED AND SEALED ON 12/17/2021.
INSPECTOR'S NAME L KOIKE/V TORRES			THE ORIGINAL
SUBSTANTIAL 5/31/2022			DOCUMENT IS STORED AT THE
DRAWINGS CORRECTED BY JACOBS	DATE	8/2022	OFFICES OF JACOBS ALBUQUERQUE, NM.

S DOCUMENT IS AN ECTRONIC COPY. IGINAL DOCUMENT VAS ISSUED AND ALED ON 12/17/2021. THE ORIGINAL DOCUMENT

NGINEER'S SEAL STORED AT THE FICES OF JACOBS


DT-7.dgn

ALBUQUERQUE BERNALILLO COUNTY WATER UTILITY AUTHORITY

RAW WATER TRANSMISSION PIPELINE TO INTEL CORPORATION BID PACKAGE NO.1 WESTSIDE BLVD

WATER LINE LOWERING - 2332

WATER AUTHORITY WATER AUTHORITY ZONE A-12 & SHEET CONSTRUCTION PROJECT NO. 2320.03001 A-13 SHEET

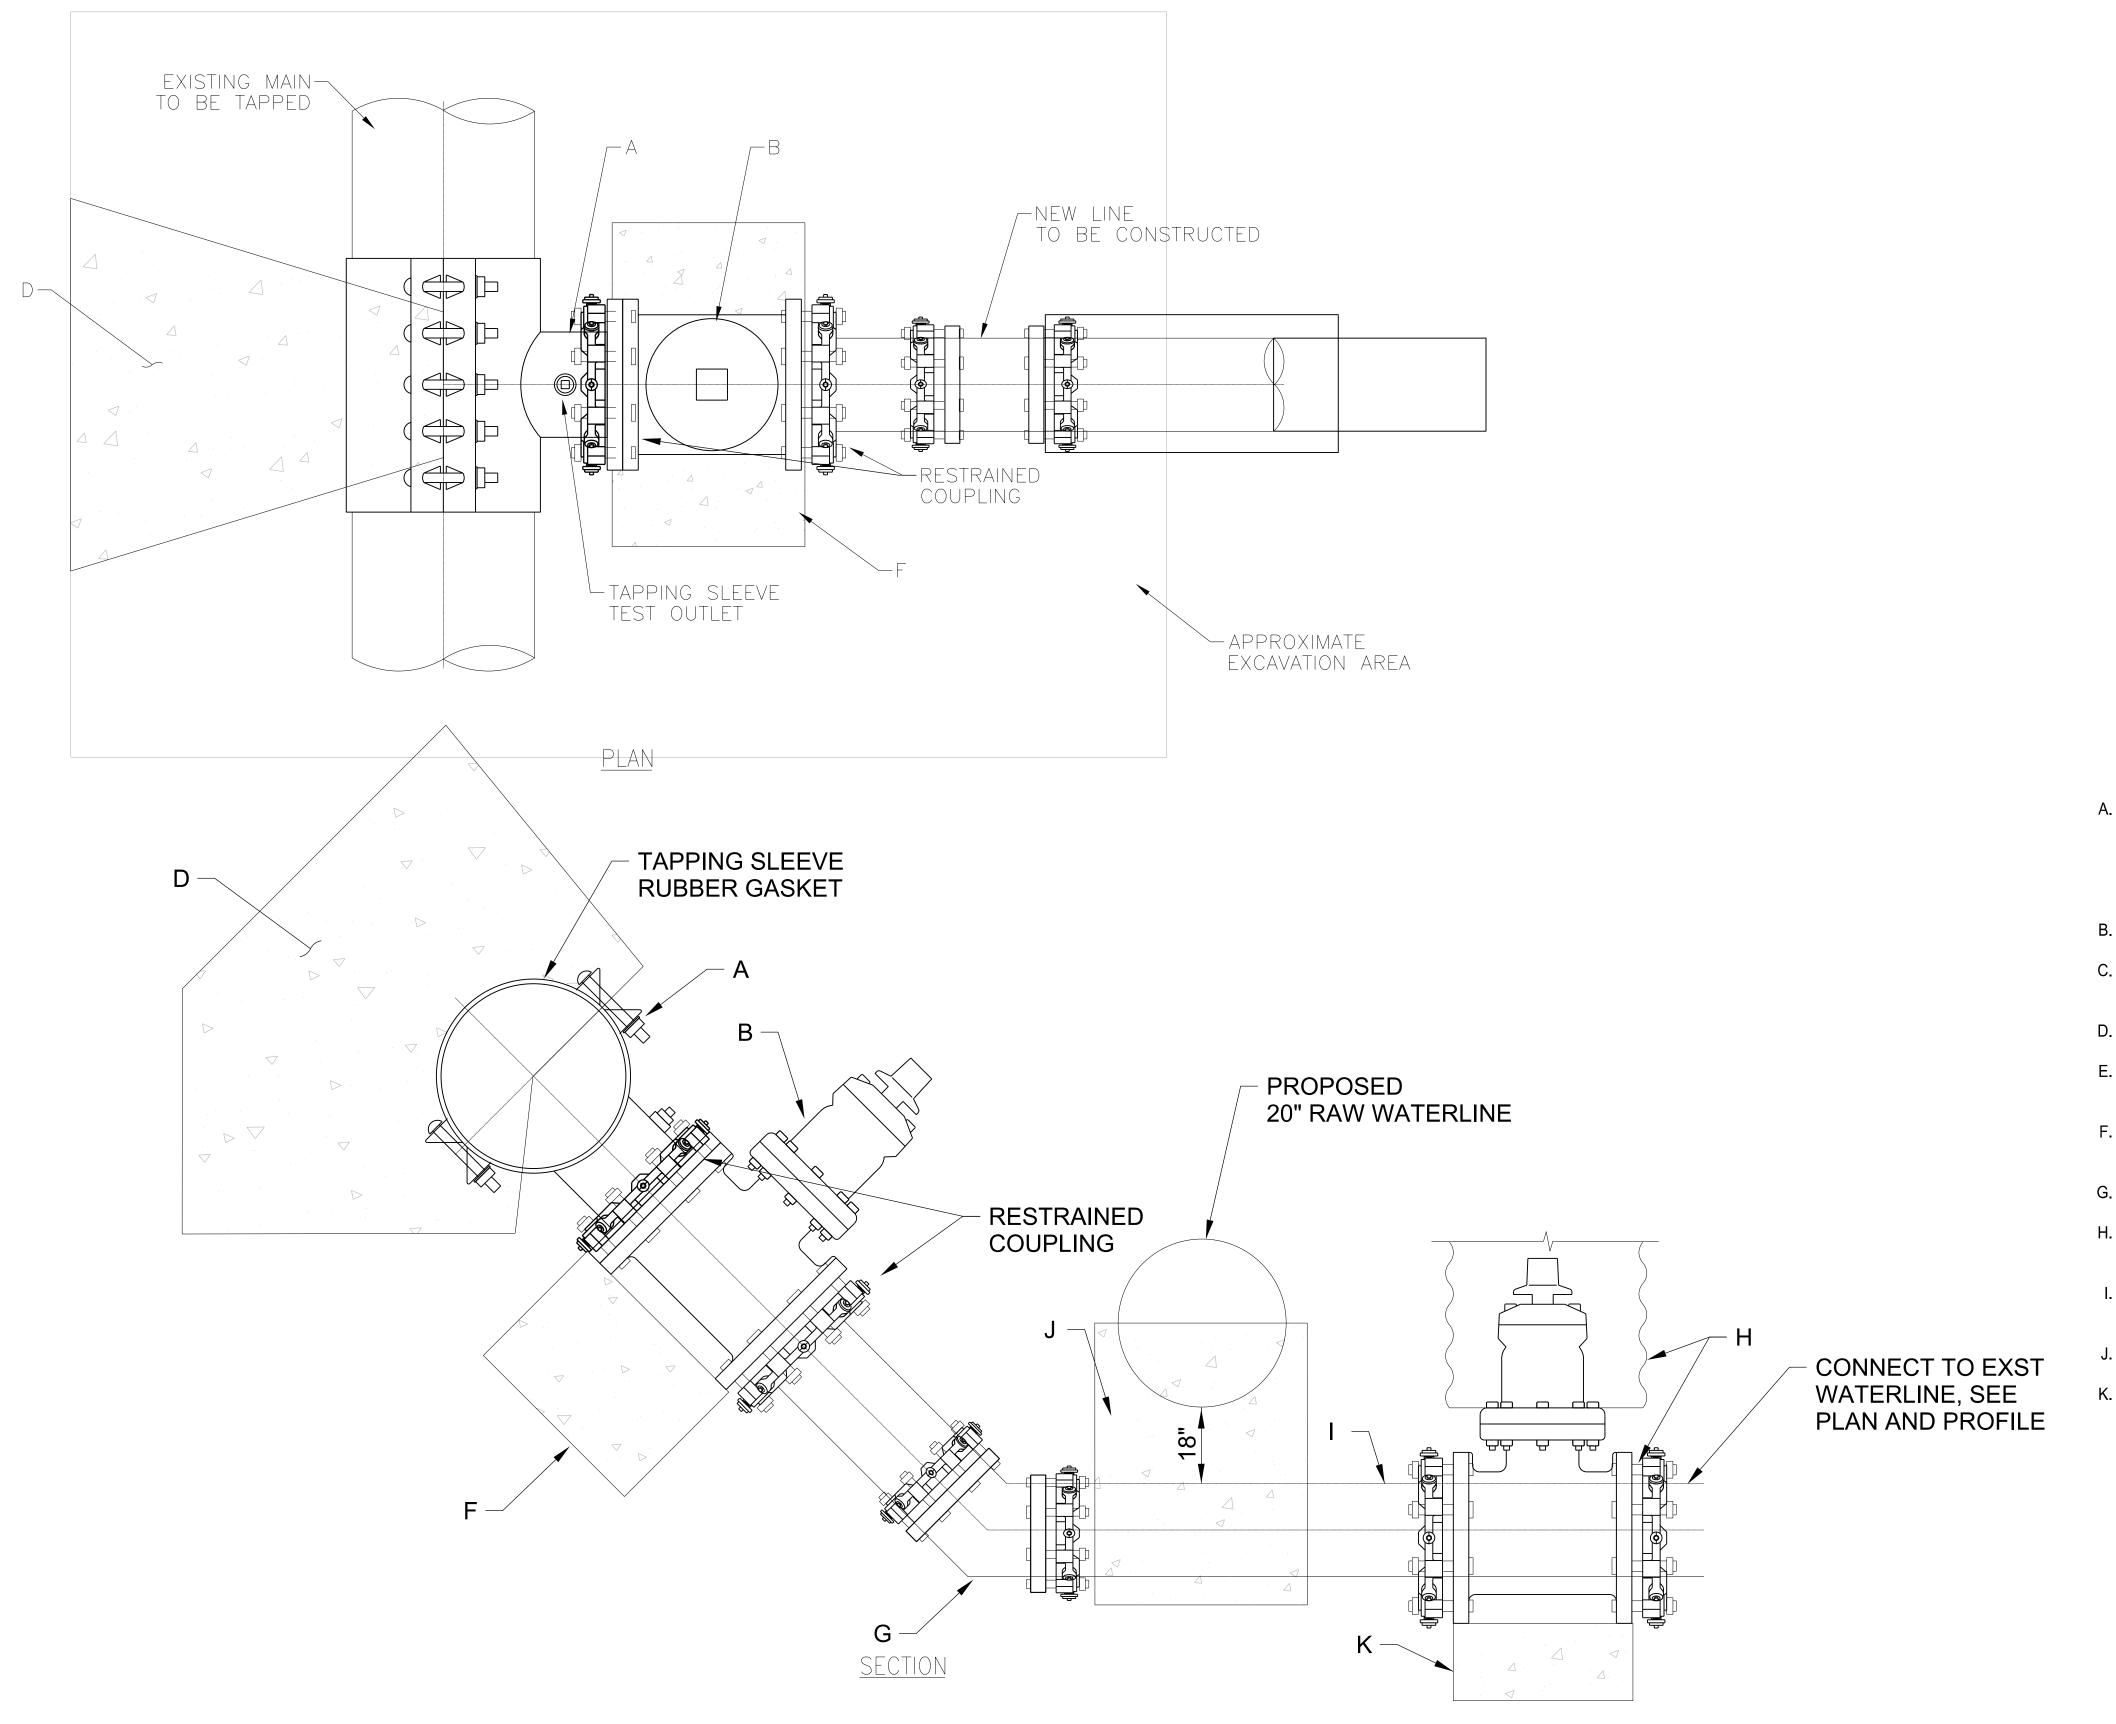

SUBMITTED BY:

Jacobs

3721 RUTLEDGE RD NE, SUITE B-1 ALBUQUERQUE, NM 87109 505-884-5600

CONTRACTOR

BEGIN DATE

DRAWINGS

CONSTRUCTION

INSPECTOR'S ACCEPTANCE BY \_\_\_

INSPECTOR'S NAME --

SUBSTANTIAL COMPLETION DATE --

CORRECTED BY --

--

DESIGN TRACKING

MAPS/RECORDS INFO.

12/17/21

12/17/21

12/17/21

12/17/21

12/17/21

DATE:

DATE:

DATE:

DATE:

M COUTURE

J PETERSON

C LAMB

E FORD

CROSS CHK'D BY: W CHRISTOFFERSON DATE:

REVISION NO. & DESCRIPTION BY

SCALE:

1 "=

ATTENTION

0 1/2" 1"

GRAPHIC SCALE

AT FULL SCALE (ANSI D)

THIS BAR MEASURES 1

DESIGNED BY

DRAWN BY:

CHECKED BY:

APPROVED BY:

DATE

#### **GENERAL NOTES**

- 1. ALL PARTS WITHIN THIS INSTALLATION, INCLUDING THE TAPPING SLEEVE PRODUCT, MUST COINCIDE WITH THE CURRENT WATER AUTHORITY APPROVED PRODUCTS LIST.
- 2. CONFIRM THAT THE TAP DOES NOT EXCEED 2/3 OF THE EXISTING MAIN SIZE.
- 3. A HYDROSTATIC TEST OF THE TAPPING SLEEVE AND VALVE IS MANDATORY PRIOR TO TAPPING THE MAIN.
- 4. A WATER AUTHORITY INSPECTOR SHALL VIEW THE PIPE CONDITION AND INSPECT THE INSTALLATION OF THE SLEEVE PRIOR TO GIVING APPROVAL TO PERFORM THE TAP.
- 5. PROTECT ALL NEW PIPING AND PARTS IN CONTACT WITH CONCRETE WITH 8 MIL SHEET PLASTIC.
- 6. THE TAP WILL BE PERFORMED BY A COMPETENT AND KNOWLEDGEABLE INSTALLER, STRICTLY FOLLOWING THE MANUFACTURER'S INSTRUCTIONS. CONTRACTOR SHALL PROVIDE QUALIFICATIONS FOR THE WATER AUTHORITY'S CONSIDERATION AND APPROVAL.
- 7. LABEL REQUIREMENTS: BEFORE THE WORK WILL BE ACCEPTED, WATER VALVE GPS COORDINATES SHALL BE PROVIDED ON THE RECORD DRAWINGS. GPS COORDINATES OBTAINED BY A PROFESSIONAL SURVEYOR LICENSED IN THE STATE OF NEW MEXICO SHALL BE TAKEN AT THE VALVE OPERATING NUT. USE THE NAD 1983 NM STATE PLANE CENTRAL ZONE FOR X AND Y COORDINATES AND NAVD 1988 FOR Z COORDINATE.
- 8. ANY DEVIATION FROM THIS STANDARD DRAWING REQUIRES WRITTEN AUTHORIZATION FROM THE WATER UTILITY AUTHORITY.
- 9. ALL PIPELINE AND FITTINGS TO BE FULLY RESTRAINED.
- 10. BACKFILL TRENCH PER STD DWG ( 3123-915 ) OR TO EXISTING FINAL GRADE AS SPECIFIED ON DRAWINGS.

#### **CONSTRUCTION NOTES**

- TAPPING SLEEVE. THE CONTRACTOR SHALL EXPOSE THE PROPOSED TAPPING LOCATION A MINIMUM 3' FROM ANY BELL, COUPLING, VALVE, FITTING, OR OTHER OBSTRUCTION. THOROUGHLY CLEAN WATER MAIN WITH WIRE BRUSH PRIOR TO INSTALLATION OF TAPPING SLEEVE. FLANGE FACE SHALL BE INSTALLED VERTICALLY TRUE AND PLUMB.
- GATE VALVE. USE FL x MJ OR MJ x MJ ALL BOLTS SHALL BE CLEAR OF FOOTING.
- UNDISTURBED EARTH OR COMPACTED SUBGRADE, SEE SECTION 701. 95% DENSITY PER ASTM D 1557.
- THRUST BLOCKING PER STANDARD DRAWING 2320.
- THE TAPPING SLEEVE SHALL BE SUPPORTED BY LEAN FILL/SLURRY TO PREVENT UNDUE STRESS ON THE TAPPING SLEEVE AND VALVE ASSEMBLY.
- VALVE SHALL BE SUPPORTED BY BLOCKING PER STANDARD DRAWING 2320 DURING AND AFTER INSTALLATION.
- DUCTILE IRON FITTING 45 DEGREE BEND MJxMJ.
- GATE VALVE USE MJxMJ INSTALL WATER VALVE BOX PER STD DWG 2326 WITH RING AND COVER FOR POTABLE WATER PER STD DRAWING 2328.
- LEAN FILL ENCASE WATER LINE ON EACH SIDE OF CROSSING WITH PROPOSED RAW WATER LINE TO JOINT UP TO 10' ON BOTH SIDE.
- INSTALL CONCRETE CRADLE SUPPORT PER STD DTL (3123-762)
- ANCHOR GATE VALVE PER STD DWG 2333.


Dec. 21, 2021

DESIGN REVIEW COMMITTEE

# THIS SHEET SUPERSEDED BY SIMILAR SHEET MARKED "REDRAWN FOR RECORD PURPOSES"

Approved by Albuquerque City Engineer and Design

Review Committee, Feb. 10, 2022 CPN 771863

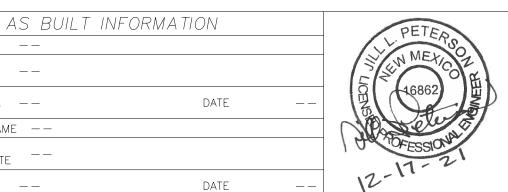




ALBUQUERQUE BERNALILLO COUNTY WATER UTILITY AUTHORITY RAW WATER TRANSMISSION PIPELINE TO INTEL CORPORATION

BID PACKAGE NO.1 WESTSIDE BLVD

WATER LINE LOWERING - 2332

WATER AUTHORITY CONSTRUCTION PROJECT NO. 2320.030XX X MAP NO.

DT-07 18 OF 19

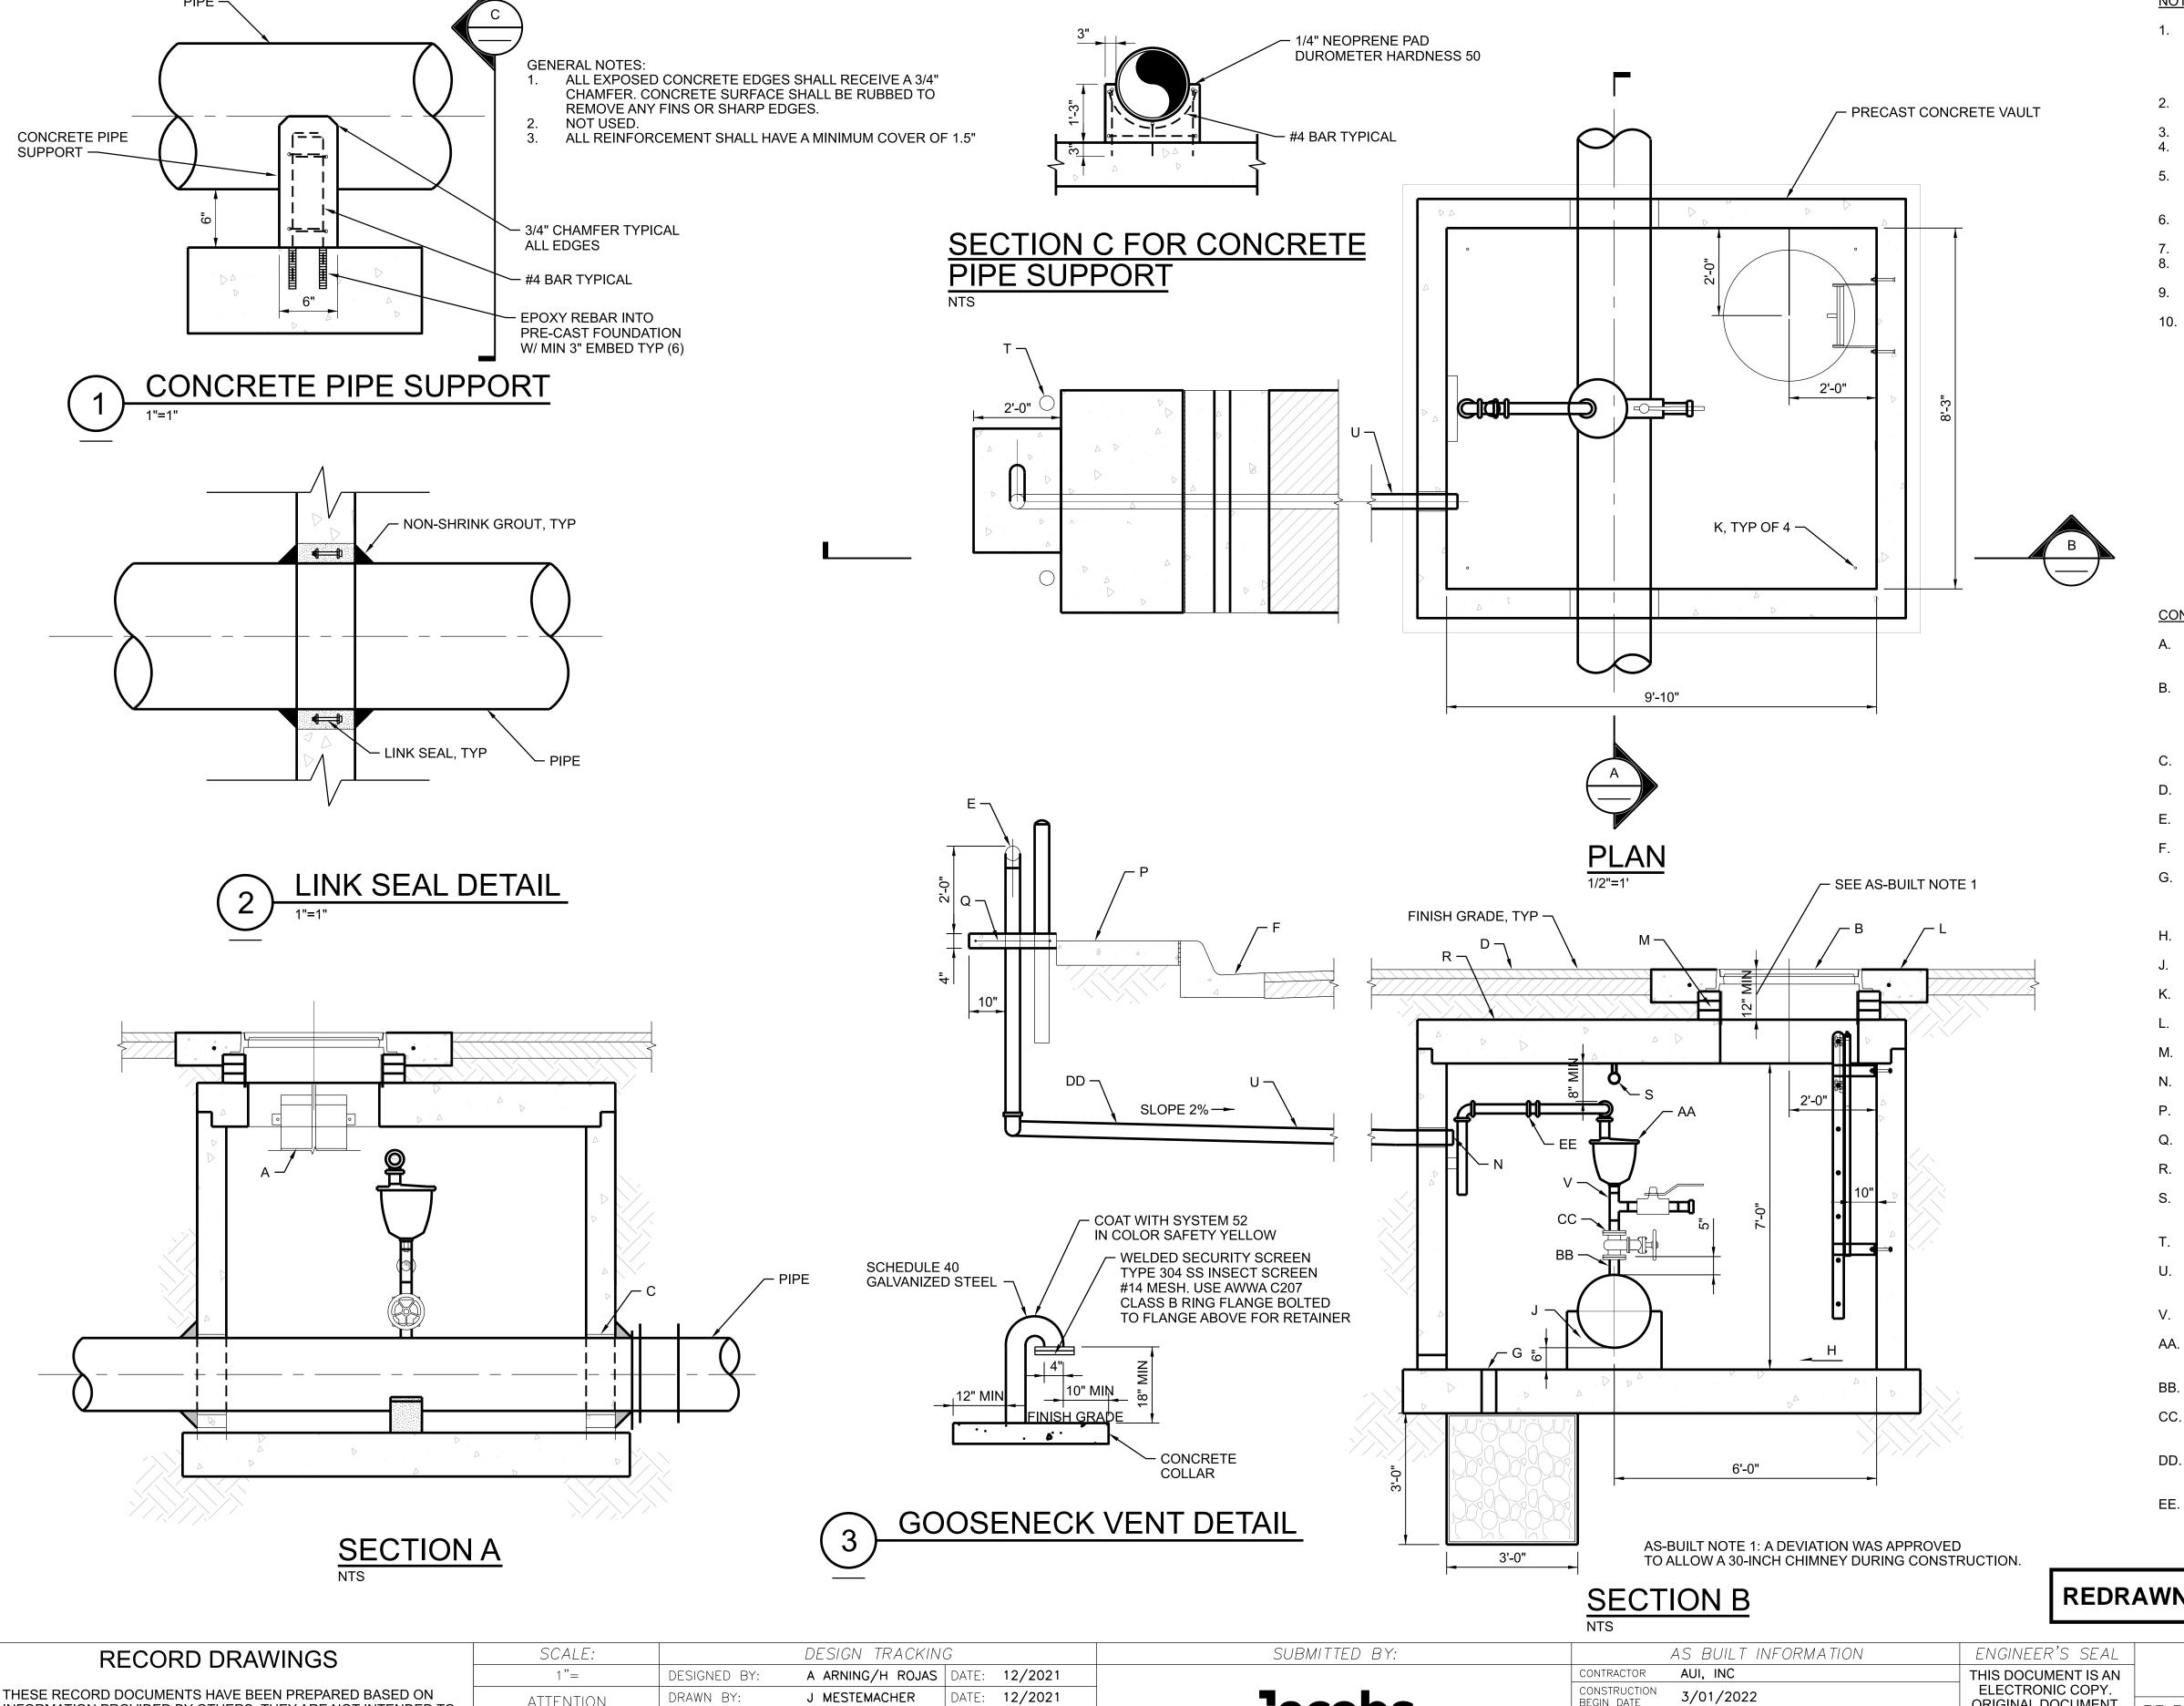

- 1. INTERIOR MAIN PIPING SHALL BE RESTRAINED DUCTILE IRON PIPE. CAV VALVE ASSEMBLY PIPING AND FITTING FOR 2-INCH AND SMALLER PIPE SHALL BE SCH. 40 THREADED, TYPE 316 STAINLESS STEEL. DIAMETER SHALL MATCH SPECIFIC CAV VALVE TO BE INSTALLED. PIPE LARGER THAN 2-INCHES SHALL BE FLANGED DUCTILE
- PARTS WITHIN THE VAULT MUST COINCIDE WITH THE CURRENT WATER AUTHORITY APPROVED PRODUCTS LIST.
- CONCRETE VAULT SHALL BE PRECAST WITH REMOVABLE CONCRETE LID.
- LOCATE ACCESS MANHOLE FRAME, ADJUST RINGS AND COVER ON REMOVABLE CONCRETE LID TO ALLOW LID REMOVAL WITH THESE APPURTENANCES IN PLACE.
- SUBMIT DIMENSIONED AND SCALED SHOP DRAWINGS OF VAULT AND PIPING, AND AIR AND VACUUM VALVE ASSEMBLY PRIOR TO VAULT FABRICATION AND PIPE
- PAINT PURPLE NON POTABLE STRIPE ON DUCTILE IRON, FINAL COLOR SELECTED BY OWNER. INSTALL TRACE WIRE ON PIPE INSIDE THE VAULT.
- BACKFILL MATERIAL SHALL BE 95% DENSITY PER ASTM D 1557.
- EXTEND INTERIOR MAIN PIPING MATERIAL TO AT LEAST 5 FEET OUTSIDE VAULT WALL. NO JOINTS WITHIN VAULT ON MAIN PIPING.
- FOR PRECAST VAULT REQUIREMENTS, REFER TO SECTION 03 40 00, PRECAST CONCRETE STRUCTURES.
- 10. PRECAST VAULT DESIGN CRITERIA

MATERIAL	
STRUCTUAL CONCRETE F'C	4000 PSI
REINFORCING	ASTM 615 GRADE 60
LOADING	
VAULT LID	HS25 LIVE LOAD PLUS 1.3 IMPACT PLUS DEAD LOADS
VAULT WALLS	60 PSF
SURCHARGE (VEHICLE)	2 FEET
VAULT BASE SLAB ALLOWABLE BEARING PRESSURE	1500 PSF

#### **CONSTRUCTION NOTES:**

- LADDER TO BE INSTALLED IN VAULTS PER STANDARD DRAWING 2335. INSTALL LADDER-UP SYSTEM, MODEL LU-4 BY BILCO, NO EXCEPTIONS.
- 36" DIAMETER MANHOLE FRAME AND COVER MARKED "NON-POTABLE" PER STANDARD DRAWING 2310. FOR VAULT INSTALLATION IN R.O.W., ADJUST MANHOLE FRAME AND COVER PER STANDARD DRAWING 2460. FOR ABOVE GROUND VAULTS, INSTALL FLUSH ALUMINUM HATCH AND SLEEVE FOR DAVIT MAST ARM.
- C. LINK SEAL. GROUT PENETRATION AROUND EXTERIOR CIRCUMFERENCE. SEE
- REMOVE AND REPLACE PAVEMENT
- GOOSENECK VENT, 4" DIAMETER SCHEDULE 40 STAINLESS STEEL. SEE
- REMOVE AND REPLACE CURB AND GUTTER PER STANDARD DRAWING 2415A.
- G. 4" DIAMETER DRAIN WITH 3"x3"x3" GRAVEL DRAIN POCKET WITH CLEAN GRAVEL, ASTM C33, NO. 57. LINE DRAIN POCKET WITH GEOTEXTILE FABRIC NMDOT CLASS 3. LOCATE UNDER VENT PIPE.
- H. SLOPE VAULT FLOOR TO DRAIN TYPICAL
  - CAST IN PLACE CONCRETE PIPE SUPPORT. SEE
- RECESSED LIFTING EYE, 4 REQUIRED. FLUSH WITH TOP OF CONCRETE LID.
- L. CONCRETE COLLAR PER STANDARD DRAWING 2461.
- M. ADJUSTMENT RINGS (IF NEEDED) PER STANDARD DRAWING 2460.
- N. UNISTRUT PIPE BRACKET TYPICAL FOR COMBINATION AIR VALVE VENT.
- P. REMOVE AND REPLACE SIDEWALK PER STANDARD DRAWING 2430.
- Q. CONCRETE COLLAR WITH 2 #4 REBAR EACH WAY CENTERED. SEE
- R. TACK COAT
- 1-1/4" STAINLESS STEEL THREADED EYEBOLT, CENTERED ON COMBINATION AIR VALVE ASSEMBLY, 1300 POUNDS LIFT CAPACITY.
- STATIONARY PIPE BOLLARD, SEE STANDARD DRAWING 2322.
- COORDINATE VENT PIPE ORIENTATION FOR EACH VAULT LOCATION DURING SHOP DWG SUBMITTAL.
- V. TEE WITH 1" OUTLET, 1" NIPPLE, 1"BALL VALVE AND CAP.
- AA. COMBINATION AIR VALVE ASSEMBLY, SIZE PER PLANS. SEE SPECIFICATION SECTION 40 27 02B, PROCESS VALVES AND OPERATORS.
- BB. TAPPING SADDLE OR OUTLET ROMAC FTS419 OR APPROVED EQUAL.
- CC. GATE VALVE WITH HANDWHEEL SIZE THE SAME AS COMBINATION AIR AND VACUUM RELEASE VALVE.
- DD. 4" SCHEDULE 40 GALVANIZED STEEL PIPE FOR VAULT VENT. ROUTE TO BACK OF SIDEWALK. FIELD ADJUST DEPTH AND ROUTING TO AVOID EXISTING UTILITIES.
- EE. UNION TYPICAL, ALL AIR AND VACUUM RELEASE VALVES.

CPN 771863

## **REDRAWN FOR RECORD PURPOSES**

THESE RECORD DOCUMENTS HAVE BEEN PREPARED BASED ON	
INFORMATION PROVIDED BY OTHERS. THEY ARE NOT INTENDED TO	
REPRESENT IN DETAIL THE EXACT LOCATION. TYPE OF COMPONENT	
NOR MANNER OF CONSTRUCTION. THE DESIGN PROFESSIONAL	
HAS NOT VERIFIED THE ACCURACY AND/OR THE COMPLETENESS	
OF THIS INFORMATION AND SHALL NOT BE RESPONSIBLE FOR ANY	
ERRORS OR OMISSIONS WHICH MAY BE INCORPORATED HEREIN	THI

AS A RESULT.

	SCALE:
	1"=
N D TO	ATTENTION
NENT	0 1/2" 1"
L SS	
ANY	GRAPHIC SCALE
N	THIS BAR MEASURES 1"
	LAT FULL SCALF (ANSLID) L

CALE:		DESIGN TRACKIN	G		
1"=	DESIGNED BY:	A ARNING/H ROJAS	DATE:	12/2021	
ENTION	DRAWN BY:	J MESTEMACHER	DATE:	12/2021	
/2" 1"	CHECKED BY:	E FORD	DATE:	12/2021	
,	CROSS CHK'D BY:	W CHRISTOFFERSON	DATE:	12/2021	
IC SCALE	APPROVED BY:	J PETERSON	DATE:	12/2021	
MEASURES 1"	MAPS/RECORDS INFO.				
CALE (ANSI D)					_

**Jacobs** 

3721 RUTLEDGE RD NE, SUITE B-1 ALBUQUERQUE, NM 87109 505-884-5600

/	AS BUILT TINT ON WIA	IIIOIV		LINGINLLIN 3 SLAL
CONTRACTOR	AUI, INC			THIS DOCUMENT IS AN
CONSTRUCTION BEGIN DATE	3/01/2022			ELECTRONIC COPY. ORIGINAL DOCUMENT
INSPECTOR'S ACCEPTANCE BY	JACOBS	DATE	5/31/2022	WAS ISSUED AND SEALED ON 12/17/2021.
INSPECTOR'S NAM	E L KOIKE/V TORRES			THE ORIGINAL
SUBSTANTIAL COMPLETION DATE	5/31/2022			DOCUMENT IS STORED AT THE
DRAWINGS CORRECTED BY	JACOBS	DATE	8/2022	OFFICES OF JACOBS ALBUQUERQUE, NM.

GINAL DOCUMENT AS ISSUED AND LED ON 12/17/2021 THE ORIGINAL DOCUMENT STORED AT THE FICES OF JACOBS WATER AUTHORITY


DT-8.dgn

ALBUQUERQUE BERNALILLO COUNTY WATER UTILITY AUTHORITY

RAW WATER TRANSMISSION PIPELINE TO INTEL CORPORATION BID PACKAGE NO.1 WESTSIDE BLVD

CAV DETAIL - 2350

WATER AUTHORITY ZONE A-12 & MAP NO. A-13 DT-08

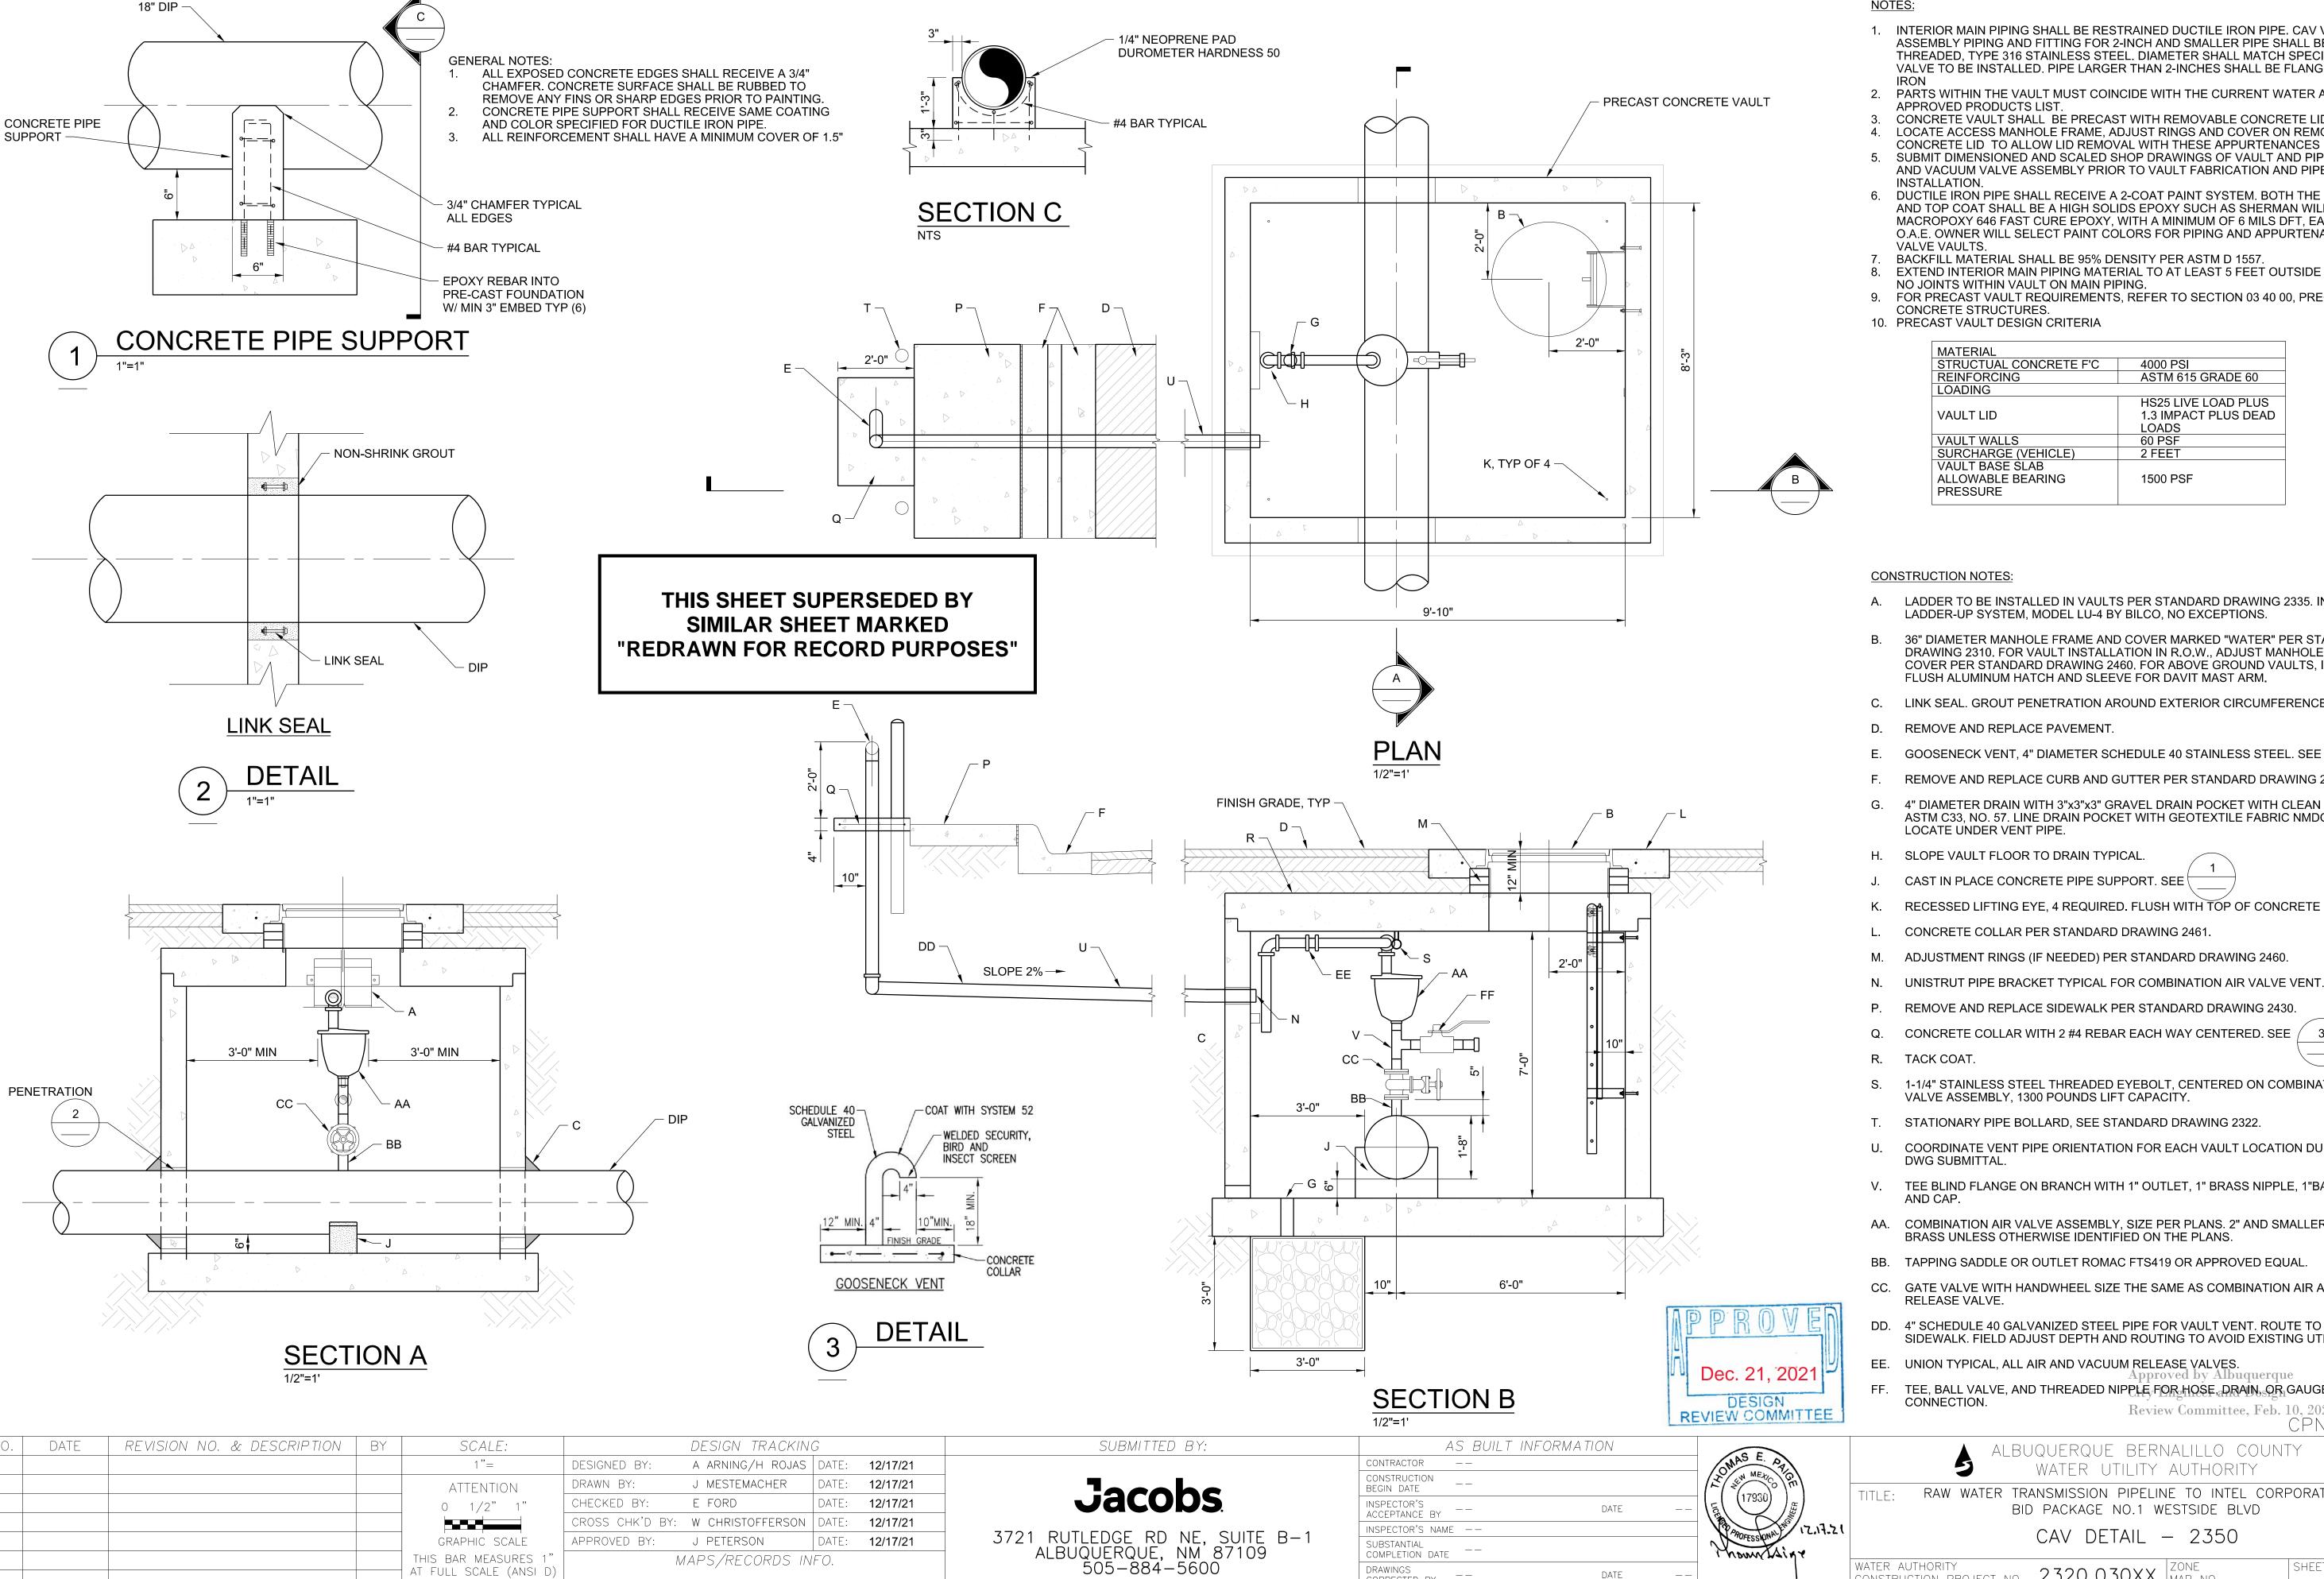

AT FULL SCALE (ANSI D)

NOTES:

1. INTERIOR MAIN PIPING SHALL BE RESTRAINED DUCTILE IRON PIPE. CAV VALVE ASSEMBLY PIPING AND FITTING FOR 2-INCH AND SMALLER PIPE SHALL BE SCH. 40 THREADED, TYPE 316 STAINLESS STEEL. DIAMETER SHALL MATCH SPECIFIC CAV VALVE TO BE INSTALLED. PIPE LARGER THAN 2-INCHES SHALL BE FLANGED DUCTILE

PARTS WITHIN THE VAULT MUST COINCIDE WITH THE CURRENT WATER AUTHORITY

CONCRETE VAULT SHALL BE PRECAST WITH REMOVABLE CONCRETE LID.

LOCATE ACCESS MANHOLE FRAME, ADJUST RINGS AND COVER ON REMOVABLE CONCRETE LID TO ALLOW LID REMOVAL WITH THESE APPURTENANCES IN PLACE

SUBMIT DIMENSIONED AND SCALED SHOP DRAWINGS OF VAULT AND PIPING, AND AIR AND VACUUM VALVE ASSEMBLY PRIOR TO VAULT FABRICATION AND PIPE

DUCTILE IRON PIPE SHALL RECEIVE A 2-COAT PAINT SYSTEM. BOTH THE PRIME COAT AND TOP COAT SHALL BE A HIGH SOLIDS EPOXY SUCH AS SHERMAN WILLIAMS MACROPOXY 646 FAST CURE EPOXY, WITH A MINIMUM OF 6 MILS DFT, EACH COAT O.A.E. OWNER WILL SELECT PAINT COLORS FOR PIPING AND APPURTENANCES INSIDE

BACKFILL MATERIAL SHALL BE 95% DENSITY PER ASTM D 1557.

EXTEND INTERIOR MAIN PIPING MATERIAL TO AT LEAST 5 FEET OUTSIDE VAULT WALL NO JOINTS WITHIN VAULT ON MAIN PIPING

FOR PRECAST VAULT REQUIREMENTS, REFER TO SECTION 03 40 00, PRECAST

MATERIAL	
STRUCTUAL CONCRETE F'C	4000 PSI
REINFORCING	ASTM 615 GRADE 60
LOADING	
	HS25 LIVE LOAD PLUS
VAULT LID	1.3 IMPACT PLUS DEAD
	LOADS
VAULT WALLS	60 PSF
SURCHARGE (VEHICLE)	2 FEET
VAULT BASE SLAB	
ALLOWABLE BEARING	1500 PSF
PRESSURE	

- A. LADDER TO BE INSTALLED IN VAULTS PER STANDARD DRAWING 2335. INSTALL LADDER-UP SYSTEM, MODEL LU-4 BY BILCO, NO EXCEPTIONS.
- 36" DIAMETER MANHOLE FRAME AND COVER MARKED "WATER" PER STANDARD DRAWING 2310. FOR VAULT INSTALLATION IN R.O.W., ADJUST MANHOLE FRAME AND COVER PER STANDARD DRAWING 2460. FOR ABOVE GROUND VAULTS, INSTALL FLUSH ALUMINUM HATCH AND SLEEVE FOR DAVIT MAST ARM.
- C. LINK SEAL. GROUT PENETRATION AROUND EXTERIOR CIRCUMFERENCE.

- REMOVE AND REPLACE CURB AND GUTTER PER STANDARD DRAWING 2415A.
- G. 4" DIAMETER DRAIN WITH 3"x3"x3" GRAVEL DRAIN POCKET WITH CLEAN GRAVEL, ASTM C33, NO. 57. LINE DRAIN POCKET WITH GEOTEXTILE FABRIC NMDOT CLASS 3. LOCATE UNDER VENT PIPE.
- H. SLOPE VAULT FLOOR TO DRAIN TYPICAL
- CAST IN PLACE CONCRETE PIPE SUPPORT. SEE
- K. RECESSED LIFTING EYE, 4 REQUIRED. FLUSH WITH TOP OF CONCRETE LID.
- L. CONCRETE COLLAR PER STANDARD DRAWING 2461.
- ADJUSTMENT RINGS (IF NEEDED) PER STANDARD DRAWING 2460.
- N. UNISTRUT PIPE BRACKET TYPICAL FOR COMBINATION AIR VALVE VENT.
- REMOVE AND REPLACE SIDEWALK PER STANDARD DRAWING 2430.
- Q. CONCRETE COLLAR WITH 2 #4 REBAR EACH WAY CENTERED. SEE / 3
- 1-1/4" STAINLESS STEEL THREADED EYEBOLT, CENTERED ON COMBINATION AIR VALVE ASSEMBLY, 1300 POUNDS LIFT CAPACITY.
- T. STATIONARY PIPE BOLLARD, SEE STANDARD DRAWING 2322.
- COORDINATE VENT PIPE ORIENTATION FOR EACH VAULT LOCATION DURING SHOP
- V. TEE BLIND FLANGE ON BRANCH WITH 1" OUTLET, 1" BRASS NIPPLE, 1"BALL VALVE
- AA. COMBINATION AIR VALVE ASSEMBLY, SIZE PER PLANS. 2" AND SMALLER CAV SST OR BRASS UNLESS OTHERWISE IDENTIFIED ON THE PLANS.
- BB. TAPPING SADDLE OR OUTLET ROMAC FTS419 OR APPROVED EQUAL.
- CC. GATE VALVE WITH HANDWHEEL SIZE THE SAME AS COMBINATION AIR AND VACUUM
- DD. 4" SCHEDULE 40 GALVANIZED STEEL PIPE FOR VAULT VENT. ROUTE TO BACK OF SIDEWALK. FIELD ADJUST DEPTH AND ROUTING TO AVOID EXISTING UTILITIES.
- EE. UNION TYPICAL, ALL AIR AND VACUUM RELEASE VALVES
- Approved by Albuquerqu FF. TEE, BALL VALVE, AND THREADED NIPPLE FOR HOSE, DRAIN, OR GAUGE

Review Committee, Feb. 10, 2022 CPN 771863

RAW WATER TRANSMISSION PIPELINE TO INTEL CORPORATION BID PACKAGE NO.1 WESTSIDE BLVD

CAV DETAIL - 2350

wally authority construction project no. 2320.030XX MAP NO. WATER AUTHORITY

DATE

CORRECTED BY

DT-08 DT-8.dgn