

# CITY OF ALBUQUERQUE **CONSTRUCTION PLANS** FOR

# NEW OFFICE/WAREHOUSE FOR BRUNACINI DEVELOPMENT 541 AIRPORT DR, NW ALBUQUERQUE, NM 87121 CPN 777182

I, JAMES E. LOPEZ, of WILSON & COMPANY, A LICENSED PROFESSIONAL ENGINEER IN THE STATE OF NEW MEXICO, DO HEREBY CERTIFY, TO THE BEST OF MY KNOWLEDGE AND BELIEF, THAT THE INFRASTRUCTURE INSTALLED AS A PART OF THIS PROJECT HAS BEEN INSPECTED BY ME OR BY A QUALIFIED PERSON AND HAS BEEN CONSTRUCTED IN ACCORDANCE WITH THE PLANS AND SPECIFICATIONS APPROVED BY THE CITY ENGINEER AND THAT THE ORIGINAL DESIGN INTENT OF THE APPROVED PLANS HAS BEEN MET, EXCEPT AS NOTED ON THE RECORD DRAWINGS. THIS CERTIFICATION IS BASED ON THE INSPECTIONS CONDUCTED AND AS-BUILT SURVEY PERFORMED BY CARTESIAN SURVEY INC., ON <u>9/19/23</u>.

## SURVEYOR'S CERTIFICATION

, BRIAN J. MARTINEZ, A DULY QUALIFIED, REGISTERED, PROFESSIONAL LAND SURVEYOR UNDER THE LAWS OF THE STATE OF NEW MEXICO, DO HEREBY CERTIFY THAT THE 'AS-BUILT' INFORMATION SHOWN ON THESE DRAWINGS WAS OBTAINED FROM FIELD CONSTRUCTION AND 'AS-BUILT' SURVEYS PERFORMED BY ME OR UNDER MY SUPERVISION, THAT THE 'AS-BUILT' INFORMATION SHOWN ON THESE DRAWINGS WAS ADDED BE ME OR UNDER MY SUPERVISION, AND THAT THIS 'AS-BUILT' INFORMATION IS TRUE AND CORRECT TO THE BEST OF MY KNOWLEDGE AND BELIEF. CARTESIAN SURVEYS IS NOT RESPONSIBLE FOR ANY OF THE DESIGN CONCEPTS, CALCULATIONS, ENGINEERING, OR INTENT OF THE RECORDED DRAWINGS.

BRIAN J. MARTINEZ, NMPS 18374



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APPROVED RECORD DRAWINGS						
City Inspector	Matt Garduno					
Contractor	Sundance Mechanical & Utility					
<b>Construction Engineer</b>	David Bishop					
Date	10/25/2023					

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ING AND DRAINAGE PLAN - FOR INFORMATION ONLY


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DRB PROJECT # PR-2022-007623





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#### GENERAL NOTES:

	ALL WORK DETAILED ON THESE PLANS, EXCEPT AS OTHERWISE STATED OR PROVIDED HEREON, SHALL BE CONSTRUCTED IN ACCORDANCE WITH CITY OF ALBUQUERQUE STANDARD SPECIFICATIONS FOR PUBLIC WORKS CONSTRUCTION, 2020 EDITION UPDATE 1, AND WILL BE REFERRED TO HEREIN AS "STANDARD SPECIFICATIONS".	24.	ELE SPE SAI
2.	ALL WORK ON THIS PROJECT SHALL BE PERFORMED IN ACCORDANCE WITH APPLICABLE FEDERAL, STATE, AND LOCAL LAWS, ORDINANCES, RULES, AND REGULATIONS CONCERNING CONSTRUCTION SAFETY AND HEALTH.	25.	TR/ AC
3.	CONTRACTOR SHALL ASSUME THE SOLE AND COMPLETE RESPONSIBILITY FOR THE JOB SITE CONDITIONS DURING THE COURSE OF CONSTRUCTION OF THIS PROJECT, INCLUDING SAFETY OF ALL PERSONS AND PROPERTY. THIS REQUIREMENT SHALL APPLY CONTINUOUSLY AND NOT BE LIMITED TO NORMAL WORKING HOURS. CONTRACTOR SHALL DEFEND, INDEMNIFY, AND HOLD HARMLESS THE OWNER AND ENGINEER FROM ANY AND ALL LIABILITY REAL OR ALLEGED, IN CONNECTION WITH THE PERFORMANCE OF WORK ON THIS		CO API AT STI SPI
4.	PROJECT, EXCEPT LIABILITY ARISING FROM THE SOLE NEGLIGENCE OF THE OWNER OR ENGINEER. AN EXCAVATION/CONSTRUCTION PERMIT WILL BE REQUIRED BEFORE BEGINNING ANY WORK WITHIN CITY RIGHT-OF-WAY.	28.	PEF ALL
5.	CONTRACTOR SHALL NOTIFY THE CONSTRUCTION ENGINEER (OR PROJECT MANAGER) NOT LESS THAN SEVEN (7) DAYS PRIOR TO STARTING WORK IN ORDER THAT THE CITY SURVEYOR MAY TAKE NECESSARY MEASURES TO INSURE THE PRESERVATION OF SURVEY MONUMENTS. CONTRACTOR SHALL NOT DISTURB PERMANENT SURVEY MONUMENTS WITHOUT THE CONSENT OF THE CITY SURVEYOR AND SHALL NOTIFY THE CITY SURVEYOR AND BEAR THE EXPENSE OF REPLACING ANY THAT MAY BE DISTURBED WITHOUT PERMISSION. ONLY THE CITY SURVEYOR SHALL REPLACE SURVEY MONUMENTS. WHEN A CHANGE IS MADE IN THE FINISHED ELEVATIONS OF THE PAVEMENT OF ANY ROADWAY IN WHICH A PERMANENT SURVEY MONUMENT IS LOCATED, CONTRACTOR SHALL, AT HIS OWN EXPENSE, ADJUST THE MONUMENT COVER TO THE NEW GRADE UNLESS OTHERWISE SPECIFIED. REFER TO STANDARD SPECIFICATIONS SECTION 4.4.	29.	API AD HT ALI IN 1 ST/ CO CO
6.	EXISTING UTILITY LINE LOCATIONS ARE SHOWN IN AN APPROXIMATE MANNER ONLY, AND LINES MAY EXIST WHERE NONE ARE SHOWN. TWO (2) WORKING DAYS PRIOR TO ANY EXCAVATION, CONTRACTOR SHALL CONTACT NEW MEXICO ONE CALL SYSTEM (260-1990) FOR LOCATION OF EXISTING UTILITIES. CONTRACTOR SHALL THEN EXCAVATE AND VERIFY THE HORIZONTAL AND VERTICAL LOCATIONS OF ALL PERTINENT EXISTING UTILITIES AND/OR OBSTRUCTIONS. SHOULD A CONFLICT EXIST, THE CONTRACTOR SHALL NOTIFY THE ENGINEER SO THE CONFLICT CAN BE RESOLVED WITH A MINIMUM AMOUNT OF DELAY. CONTRACTOR SHALL THEN COORDINATE RELOCATION OF UTILITY LINES WITH UTILITY COMPANIES AS REQUIRED. ANY DAMAGE CAUSED BY FAILURE TO LOCATE, IDENTIFY, AND PRESERVE ANY EXISTING UTILITIES IS THE FULL RESPONSIBILITY OF THE CONTRACTOR.	30. 31.	RAN REI IND REI TR/
7.	CONTRACTOR SHALL ASSIST THE ENGINEER/INSPECTOR IN THE RECORDING OF DATA ON ALL UTILITY LINES AND ACCESSORIES AS REQUIRED BY THE CITY OF ALBUQUERQUE FOR THE PREPARATION OF "AS BUILT" DRAWINGS. CONTRACTOR SHALL NOT COVER UTILITY LINES AND ACCESSORIES UNTIL ALL DATA HAS BEEN RECORDED.		RIG CU AR
3.	CONTRACTOR SHALL ASSUME FINANCIAL RESPONSIBILITY FOR ANY DAMAGE TO EXISTING PAVEMENT, PAVEMENT MARKINGS, SIGNAGE, CURB AND GUTTER, HANDICAP RAMPS, AND SIDEWALK DURING CONSTRUCTION APART FROM THOSE SECTIONS INDICATED ON THE PLANS, AND SHALL REPAIR OR REPLACE, PER THE STANDARD SPECIFICATIONS, ANY SUCH DAMAGE.		. THI SID . CO TH/
9.	CONTRACTOR SHALL MAINTAIN A GRAFFITI-FREE WORK SITE. CONTRACTOR SHALL PROMPTLY REMOVE ANY AND ALL GRAFFITI FROM EQUIPMENT, WHETHER PERMANENT OR TEMPORARY.	26	OR
0.	CONTRACTOR SHALL BE RESPONSIBLE TO PROVIDE AND MAINTAIN ALL CONSTRUCTION SIGNING UNTIL THE PROJECT HAS BEEN ACCEPTED BY THE CITY AND OTHER JURISDICTIONAL AUTHORITIES WHERE APPLICABLE.	30.	AT LOI SQ WI
11	CONSTRUCTION ACTIVITY SHALL BE LIMITED TO THE PROPERTY AND/OR PROJECT LIMITS SHOWN. ANY		TO
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CTRONIC MARKER SPHERES (EMS) WILL BE PLACED ACCORDING TO THE ABCWUA STANDARDS AND CIFICATIONS. THE CONTRACTOR SHALL INSTALL A 4" X 4" X5' POST AND EMS AT THE END OF EACH ITARY SEWER SERVICE.

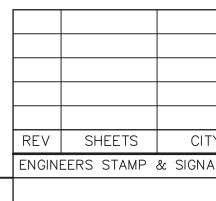CER WIRE SHALL BE INCLUDED FOR ALL PUBLIC WATER AND SEWER MAINS AND FOR WATER SERVICES IN CORDANCE WITH WATER AUTHORITY DETAILS.

ITRACTOR SHALL PROVIDE THE PROPOSED HYDRO TESTING PLANS TO THE WUA INSPECTORS FOR PROVAL PRIOR TO BEGINNING TESTING OPERATIONS.

JTILITY CROSSINGS, WHERE LESS THAN 18" OF VERTICAL SEPARATION FROM STORM DRAIN PIPING OR RUCTURES IS PROPOSED, LEAN FILL CONSTRUCTION (PER SECTION 207 OF THE STANDARD CIFICATIONS) SHALL BE USED TO PROTECT THE WATER OR SEWER LINE. LEAN FILL SHALL EXTEND A RPENDICULAR DISTANCE OF 5 FEET ON EACH SIDE OF THE STORM PIPE OR STRUCTURE.

DESIGNS AND CONSTRUCTION OF ANY UNDERGROUND UTILITIES SHALL COMPLY WITH ADMINISTRATIVE TRUCTION NO. 9 FOR WORK NEARBY OR AFFECTING SAN JUAN CHAMA TRANSMISSION LINES AND URTENANCES. INFORMATION SHALL BE PROVIDED TO THE WATER AUTHORITY ONE (1) MONTH IN ANCE OF THE CONSTRUCTION START DATE. INFORMATION CAN BE FOUND AT P://WWW.ABCWUA.ORG/WATER\_SHUT\_OFF\_AND\_TURN\_ON\_PROCEDURES.ASPX

WATER AND SANITARY SEWER INFRASTRUCTURE SHALL BE CONSTRUCTED UTILIZING MATERIALS LISTED HE APPROVED PRODUCTS LIST AND BE CONSTRUCTED PER THE MOST CURRENT WATER AUTHORITY NDARD DETAILS AND SPECIFICATIONS. MATERIAL SUBMITTALS SHALL BE PROVIDED PRIOR TO NSTRUCTION FOR THE WATER AUTHORITY ENGINEER TO REVIEW PRIOR TO THE START OF NSTRUCTION. INFORMATION CAN BE FOUND AT HTTP://WWW.ABCWUA.ORG/FOR\_BUILDERS.ASPX

#### SPORTATION

STREET STRIPING ALTERED OR DESTROYED SHALL BE REPLACED WITH THERMO-PLASTIC LECTORIZED PAVEMENT MARKING BY CONTRACTOR TO THE SAME LOCATION AS EXISTING OR AS ICATED BY THIS PLAN SET.

10VAL OF EXISTING CURB & GUTTER AND SIDEWALKS SHALL BE TO THE NEAREST JOINT.

ERNIGHT PARKING OF CONSTRUCTION EQUIPMENT SHALL NOT OBSTRUCT DRIVEWAYS OR DESIGNATED FFIC LANES. THE CONTRACTOR SHALL NOT STORE ANY EQUIPMENT OR MATERIAL WITHIN THE PUBLIC HT-OF-WAY.

RB AND GUTTER, SIDEWALKS, AND DRIVE PADS SHALL MATCH THE LINE AND GRADE OF ABUTTING EXISTING EAS AS SHOWN ON THE PLANS OR AS DIRECTED BY THE PROJECT ENGINEER.

SUBGRADE PREP SHALL EXTEND ONE FOOT BEYOND THE FREE EDGE OF NEW CURB AND GUTTER AND EWALK.

NTRACTOR TO TEST SUBGRADE R-VALUE PRIOR TO CONSTRUCTION. IN THE EVENT THE R-VALUE IS LESS N 50, REMOVE 2 FEET OF SUBGRADE MATERIAL AND IMPORT MATERIAL WITH R-VALUE GREATER THAN 50 CONTACT THE ENGINEER IMMEDIATELY SO THE PAVEMENT SECTION CAN BE MODIFIED.

ALL PAVEMENT REMOVAL AND REPLACEMENTS, SAW-CUT EDGES SHALL BE STRAIGHT AND CLEAN, AND IGITUDINAL JOINTS SHALL NOT BE PLACED WITHIN WHEEL PATHS. PATCHES SHALL BE REGULAR AND JARE OR RECTANGULAR, WITH FOUR STRAIGHT SIDES. FINISHED PAVEMENT SURFACE SHALL BE FLUSH H EXISTING PAVEMENT SURFACE, WITH NO SPILLOVER OF ASPHALT OR TACK COAT. CARE MUST BE TAKEN AVOID DAMAGING THE INTEGRITY OR APPEARANCE OF SURROUNDING PAVEMENTS; IF DAMAGED, THE IRE SURFACE PATCH MUST BE EXPANDED TO COVER DAMAGES.

NTRACTOR WILL ENSURE THE ASPHALT HAS A SMOOTH, UNIFORM EDGE WHEN REMOVING AND REPLACING RB AND GUTTER. IF THE ASPHALT EDGE IS NOT SMOOTH AND UNIFORM, CONTRACTOR WILL SAW CUT AND LACE A ONE-FOOT STRIP OF ASPHALT ALONG THE FULL SECTION BEING REPLACED; REFER TO C.O.A. NDARD DRAWING # 2465 WITH THE APPROPRIATE PAVING SECTION BASED ON ROADWAY CLASSIFICATION.

### ROLOGY

STORM DRAINS SHALL BE RCP CLASS III UNLESS OTHERWISE NOTED ON THE PLANS.

P SHALL BE INSTALLED SO THAT THE JOINT GAP AT THE HOME POSITION SHALL CONFORM TO THE PROVED MANUFACTURER'S RECOMMENDATION. MANUFACTURER'S RECOMMENDED JOINT GAP ERANCES FOR EACH PIPE SIZE AND TYPE SHALL BE SUBMITTED TO THE ENGINEER FOR APPROVAL PRIOR PLACEMENT OF PIPE. RCP JOINTS SHALL NOT BE GROUTED UNLESS DIRECTED BY THE ENGINEER AND H CITY APPROVAL.

#### R COMMON NOTES

EXCAVATION, TRENCHING, AND SHORING ACTIVITIES MUST BE ACCOMPLISHED IN ACCORDANCE WITH A 29CFR 1926.650 SUBPART P.

EN DISTURBING MORE THAN ¾ ACRES, CONTRACTOR SHALL SECURE A "TOPSOIL DISTURBANCE PERMIT" OR TO BEGINNING CONSTRUCTION.

DVANCE OF CONSTRUCTION, CONTRACTOR SHALL DETERMINE IF OVERHEAD UTILITY LINES, SUPPORT RUCTURES, POLES, GUYS, ETC. ARE AN OBSTRUCTION TO CONSTRUCTION OPERATIONS. IF ANY STRUCTION TO CONSTRUCTION OPERATIONS IS EVIDENT, CONTRACTOR SHALL BE RESPONSIBLE FOR DRDINATING WITH THE APPROPRIATE UTILITY OWNER TO REMOVE OR SUPPORT THE UTILITY STRUCTION. ANY COST ASSOCIATED WITH THIS EFFORT SHALL BE THE RESPONSIBILITY OF CONTRACTOR.

I WILL PROVIDE AT NO COST TO THE CITY OR THE CONTRACTOR THE REQUIRED PERSONNEL FOR PECTION OR OBSERVATION DEEMED NECESSARY BY PNM WHILE THE CONTRACTOR IS EXPOSING PNM'S LES. HOWEVER, THE CONTRACTOR SHALL BE CHARGED THE TOTAL COST ASSOCIATED WITH REPAIRS TO / DAMAGED CABLES OR FOR ANY COST ASSOCIATED WITH SUPPORTING OR RELOCATING THE POLES AND BLES DURING CONSTRUCTION.

NTRACTOR SHALL SUPPORT AND PROTECT ALL EXISTING. UNDERGROUND UTILITY LINES WHICH BECOME POSED DURING CONSTRUCTION. PAYMENT FOR SUPPORTING WORK SHALL BE INCIDENTAL TO WATERLINE O/OR SEWER LINE COSTS.

NTRACTOR IS TO SUPPORT, PROTECT, AND MAINTAIN THE INTEGRITY OF ALL UNDERGROUND TELEPHONE, CTRIC CABLES AND CABLE TELEVISION UTILITIES AT NO ADDITIONAL COST TO THE OWNER. CABLE IS TO SUPPORTED AT A MAXIMUM SPACING OF FIFTEEN (15) FEET. CONTRACTOR SHALL COORDINATE WITH AND KE NECESSARY PAYMENT (IF ANY) TO UTILITY OWNER FOR DE-ENERGIZATION OF CABLES OR SUPPORT OF BLES BY THE UTILITY OWNER.

NTRACTOR SHALL PROMPTLY CLEAN UP ANY MATERIAL EXCAVATED WITHIN THE PUBLIC RIGHT-OF-WAY OR VATE ROADWAY EASEMENTS TO PREVENT ANY EXCAVATED MATERIAL BEING WASHED DOWN THE STREET INTO ANY PUBLIC DRAINAGE FACILITY.

- 47. CONTRACTOR SHALL CONDUCT ALL WORK IN A MANNER WHICH WILL MINIMIZE INTERFERENCE WIT TRAFFIC.
- 48. ALL EXISTING SIGNS, MARKERS, DELINEATORS, ETC., WITHIN THE CONSTRUCTION LIMITS SHALL BE STORED AND RE-SET BY THE CONTRACTOR.
- 49. DISPOSAL SITE FOR ALL EXCESS EXCAVATION MATERIAL AND UNSUITABLE MATERIAL SHALL BE ARF THE CONTRACTOR IN COMPLIANCE WITH ALL APPLICABLE ENVIRONMENTAL REGULATIONS. NO SEPA MEASUREMENT OR PAYMENT WILL BE MADE FOR COSTS ASSOCIATED WITH OBTAINING A DISPOSAL HAUL THERETO.
- 50. IF CULTURAL RESOURCES, SUCH AS HISTORIC OR PREHISTORIC ARTIFACTS, OR HUMAN REMAINS DISCOVERED DURING EXCAVATION OR CONSTRUCTION, WORK SHALL CEASE AND THE CONSTRUCT ENGINEER SHALL NOTIFY THE COUNTY OFFICE OF THE MEDICAL EXAMINER AT (505) 272-3053. IF THI EXAMINER DETERMINES THAT HUMAN REMAINS ARE NOT PRESENT, THE CONSTRUCTION ENGINEE NOTIFY THE STATE HISTORIC PRESERVATION OFFICER (SHPO) AT 827-6320.
- 51. IF DISTURBING PCC PAVEMENT FOR ART LANES: CONTRACTOR SHALL CONTACT ABQ TRANSIT DEP AT LEAST TWO WEEKS PRIOR TO DISTURBING THE PCC PAVEMENT ASSOCIATED WITH THE ART LAN CONTACT INFO: ROLANDO SUAREZ, PH. 505.205.3444 (RSUAREZ@CABQ.GOV) OR SHAUN GIBSON, PI 505.250.5269 (SGIBSON@CABQ.GOV).

#### GENERAL NOTES USED SELECTIVELY, BASED ON SCOPE OF WORK:

52. WORK AFFECTING ARTERIAL ROADWAYS MAY REQUIRE TWENTY-FOUR-HOUR CONSTRUCTION.

- 53. TWO WEEKS PRIOR TO CONSTRUCTION, THE CONTRACTOR SHOULD NOTIFY THE TRANSIT DEPART ANY IMPACT THE PROPOSED PROJECT WILL HAVE ON THE TRANSIT SYSTEM SUCH AS CAUSING A D CAUSE THE CLOSING OR RELOCATION OF A BUS STOP. THE CONTACT PERSON IS DOUGLAS GOFF, PHONE 505-724-3137, CELL PHONE 505-206-0151, AND E-MAIL DGOFF@CABQ.GOV
- 54. STREET NAME SIGNS, REGULATORY SIGNAGE, AND ANY NECESSARY STRIPING ON PRIVATE STREE DEVELOPER'S RESPONSIBILITY.
- 55. IN ALL AREAS WHERE PUBLIC STREETS OR INFRASTRUCTURE ARE TO BE CONSTRUCTED OVER FIL GEOTECHNICAL ENGINEER SHALL CERTIFY THAT PLACEMENT, COMPACTION, AND ALL OTHER WOR COMPLETED IN ACCORDANCE WITH COA SPECIFICATION SECTION 204. SAID CERTIFICATION, ALONG SUPPORTING TESTING DOCUMENTATION, SHALL BE PROVIDED TO THE CONSTRUCTION ENGINEER OR AT THE PRE-CONSTRUCTION CONFERENCE BEFORE WORK ORDER CONSTRUCTION.

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777182

Design Review Committee

Feb. 15, 2023

**REVIEW COMMITTEE** 

City Project No.

TITLE:


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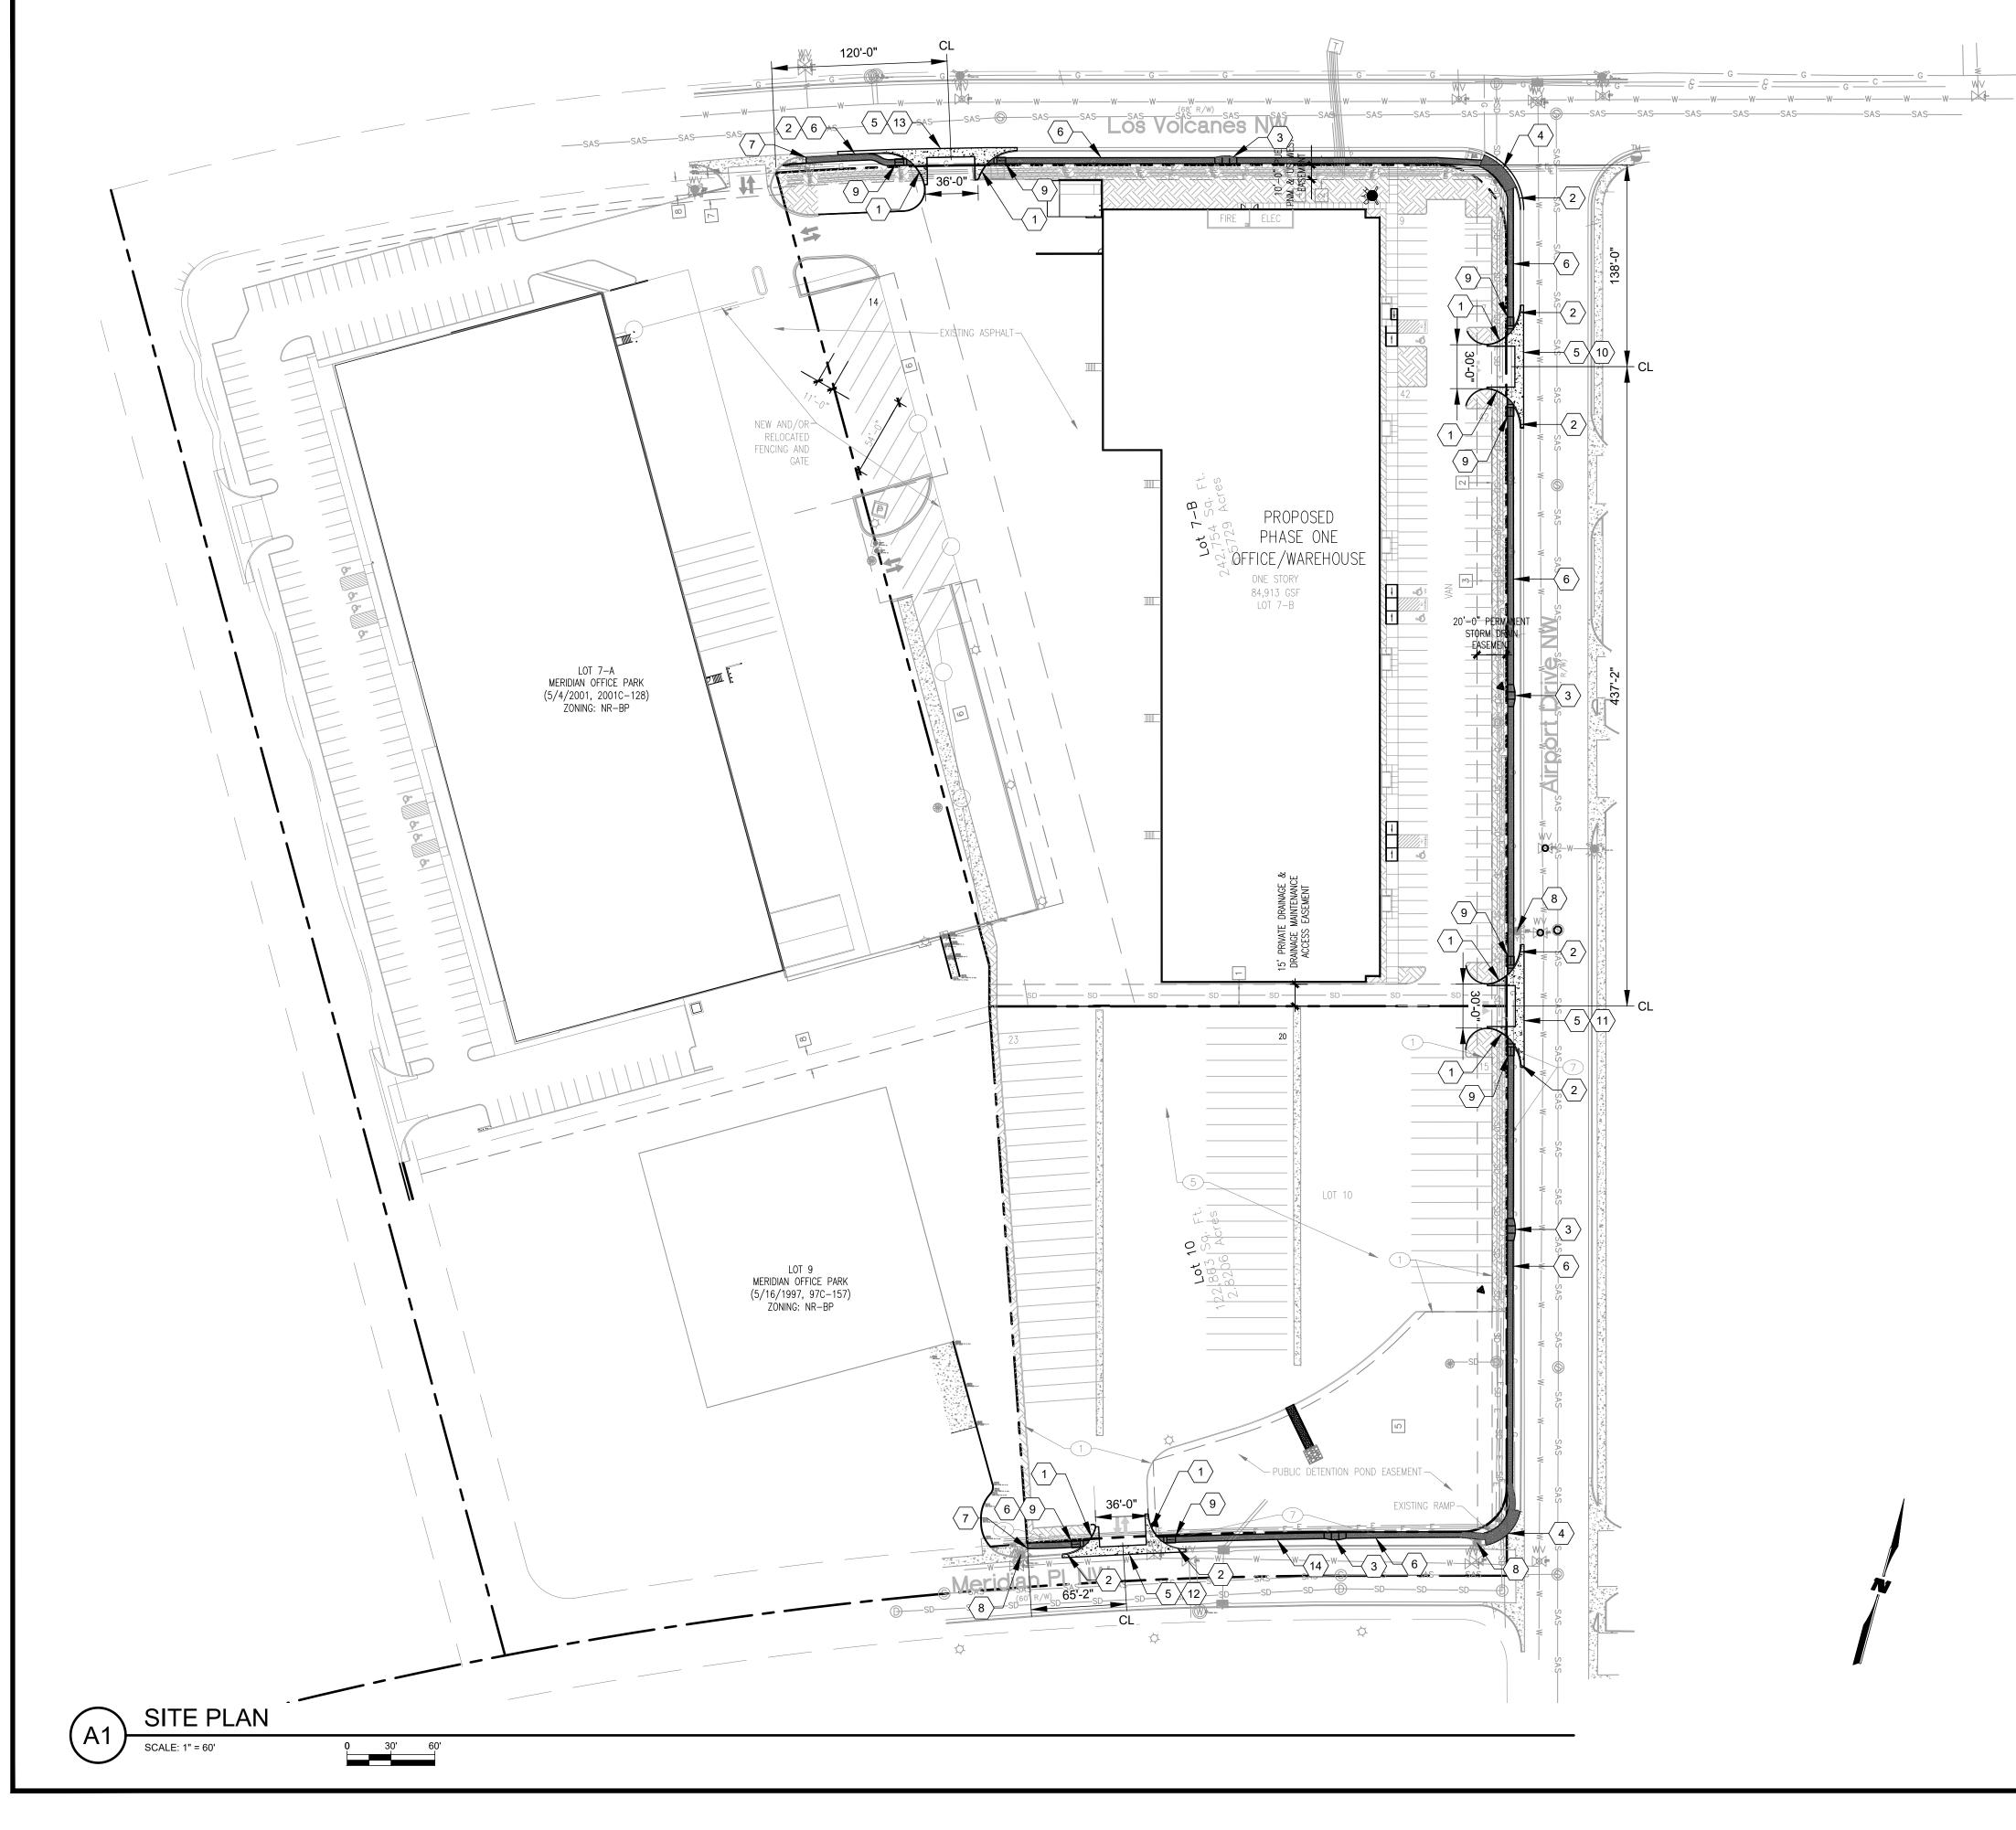
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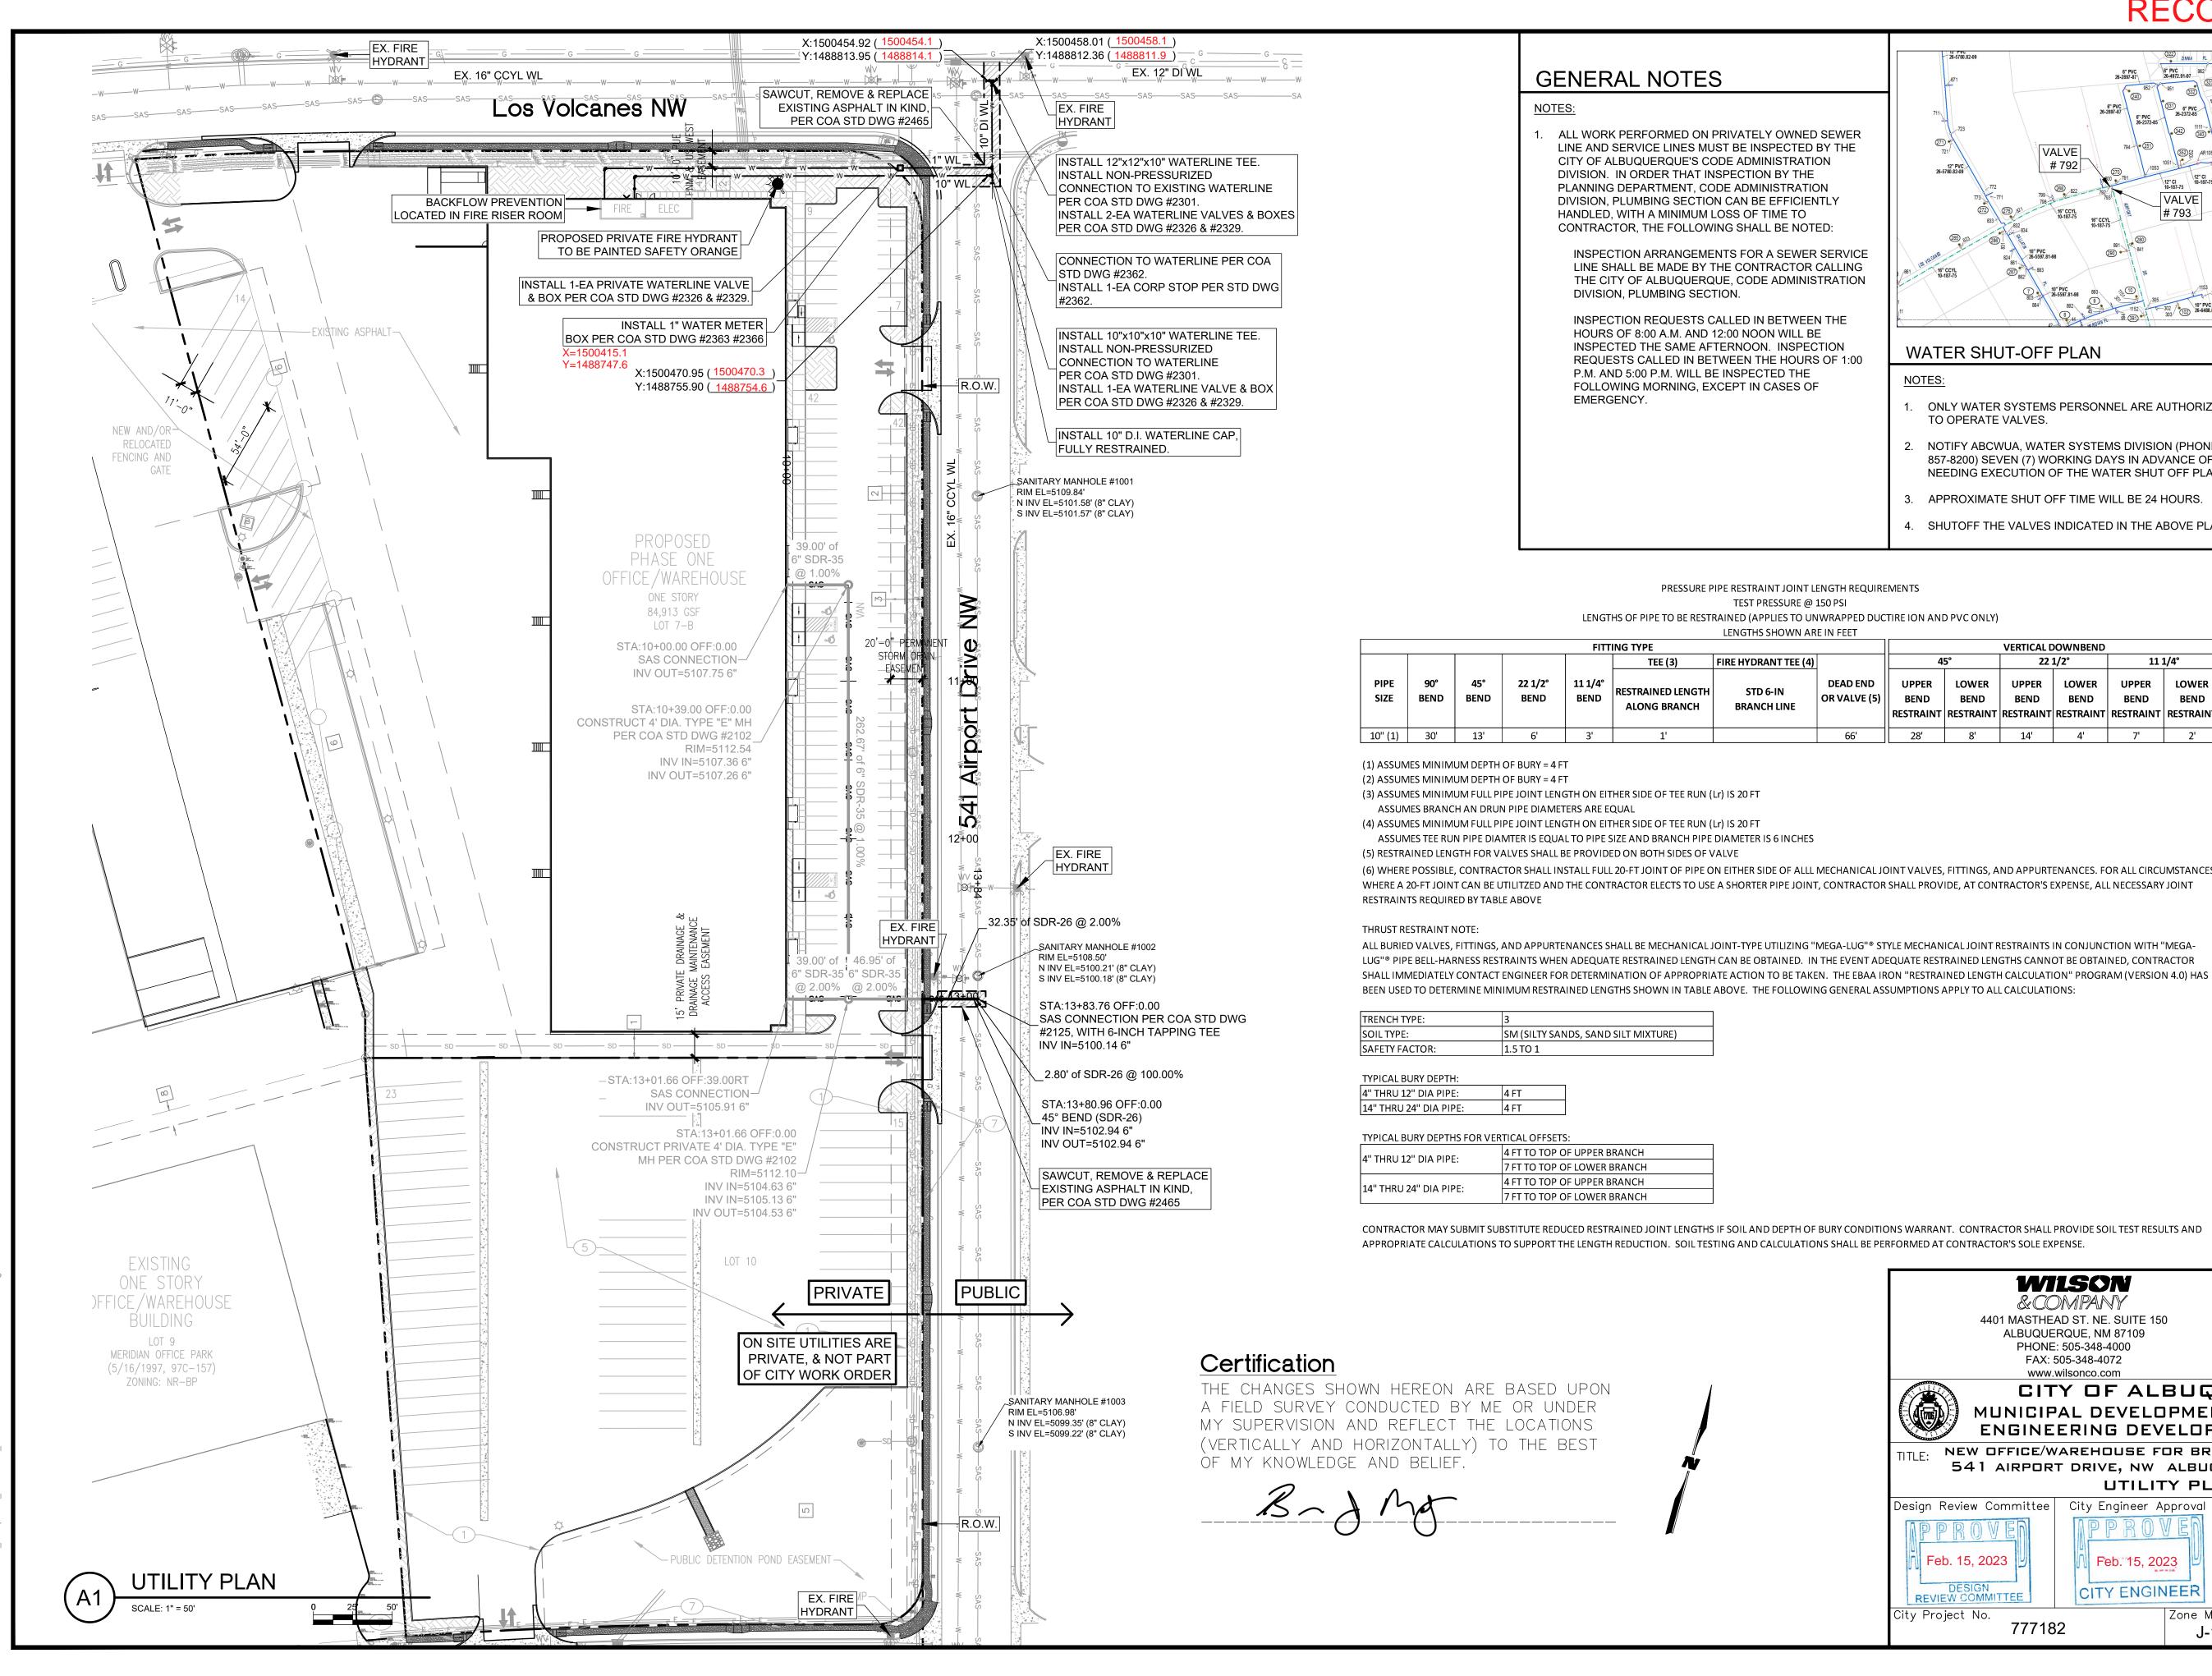
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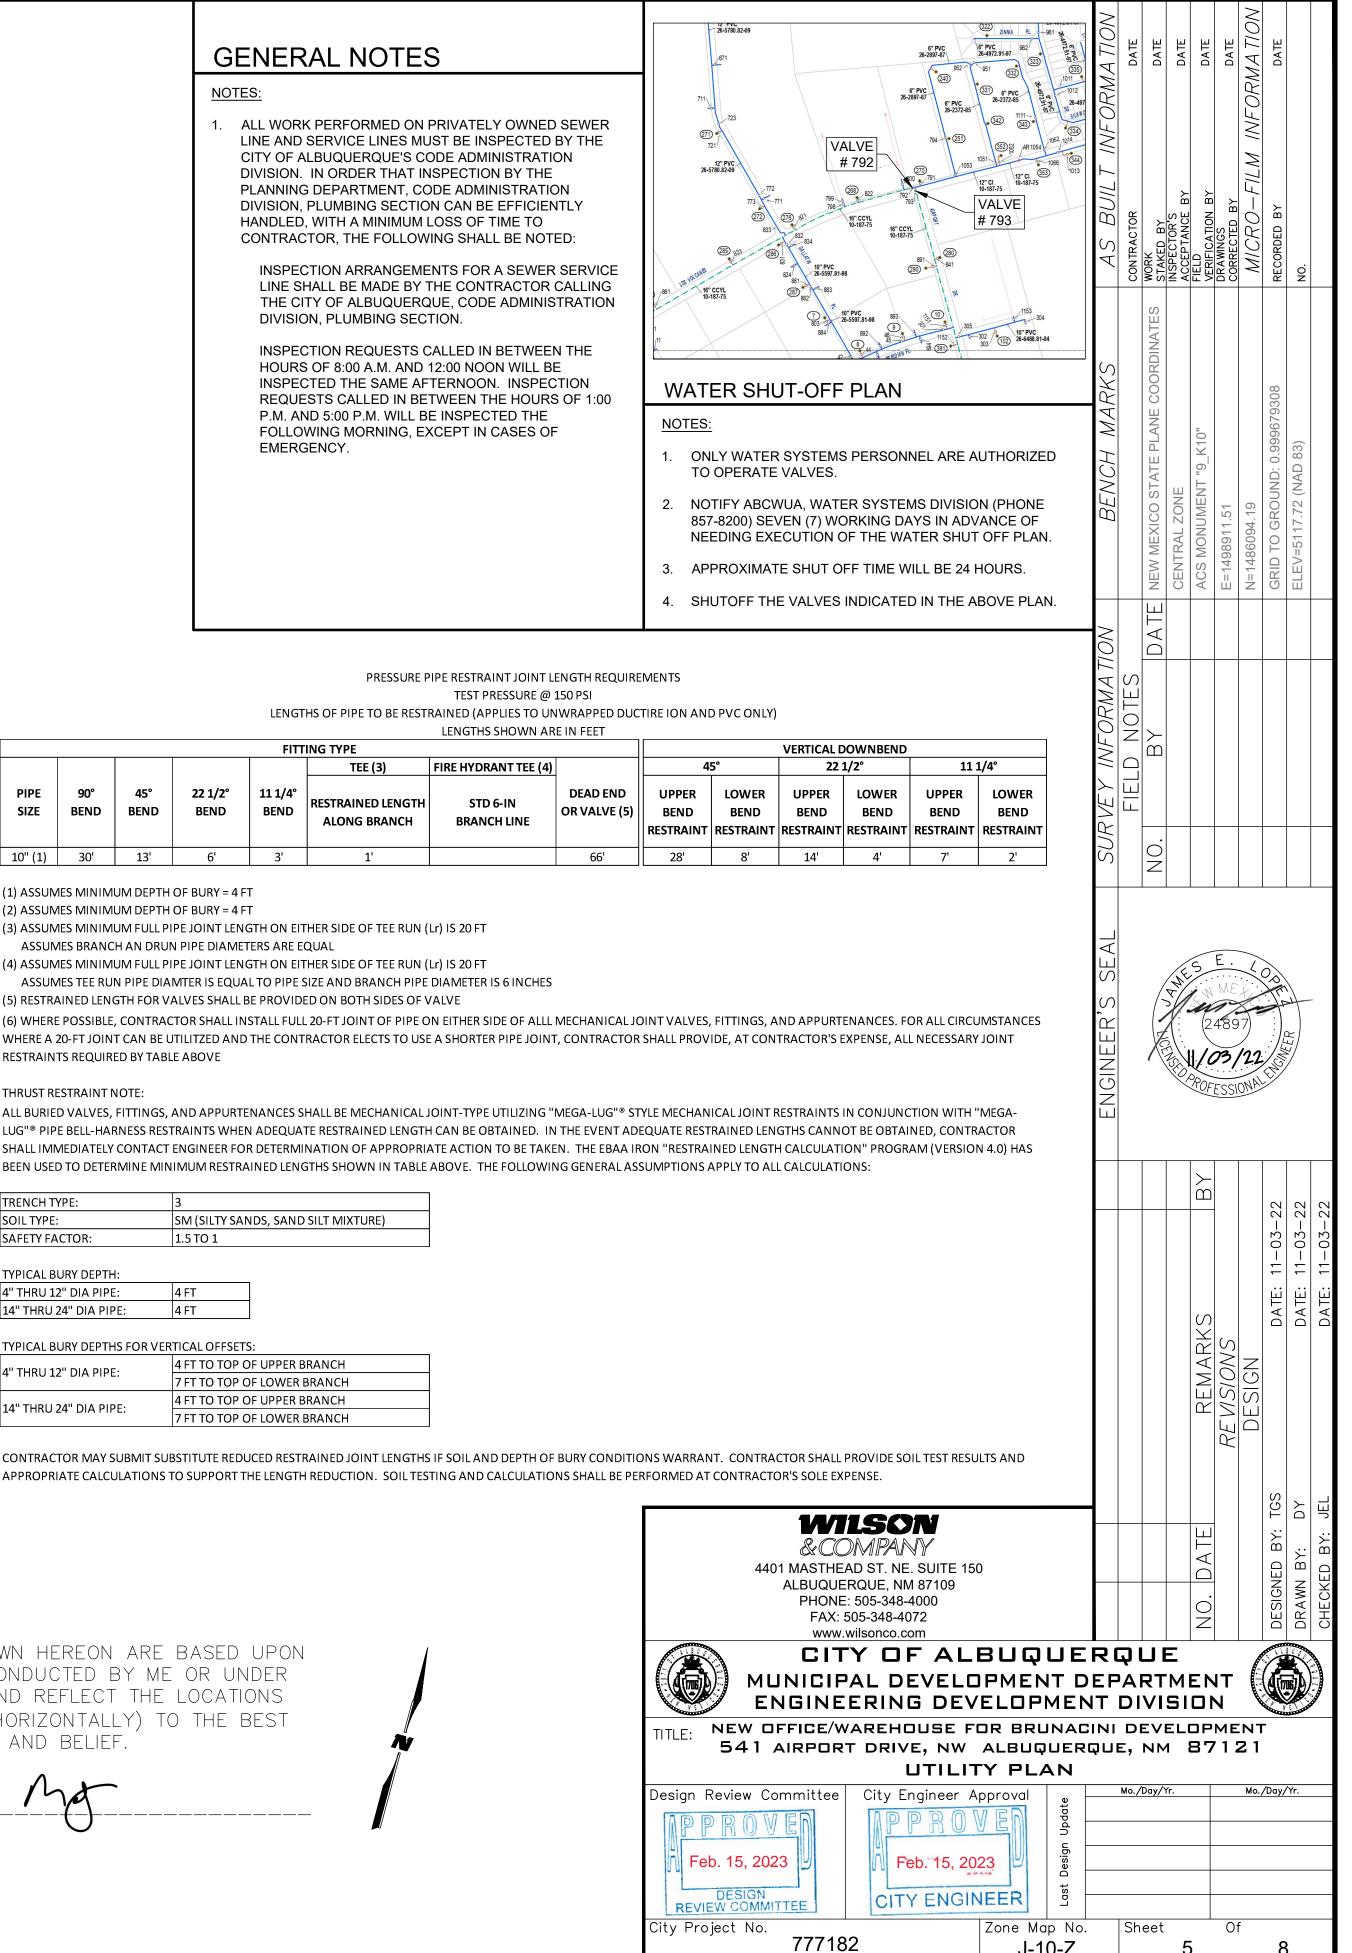


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<ul> <li>KEYNOTES</li> <li>1. CONSTRUCT MEDIAN CURB &amp; GUTTER PER COA STD DWG</li> </ul>	┢	8	S VC	A No		R OS		RE	NO.	
#2415A.			INATES							
<ol> <li>CONSTRUCT STANDARD CURB &amp; GUTTER PER COA STD DWG #2415A.</li> </ol>	RKS		COORDINATE:					08		
3. 5' x 5' WIDENED AREA OF SIDEWALK FOR HC PASSING, REFER TO ARCHITECTURAL DETAIL.	BENCH MARKS		PLANE (		10"			GROUND: 0.999679308	(	
4. CONSTRUCT (WHEELCHAIR) CURB ACCESS RAMP PER COA STD DWG #2441, SEE DETAILS ON SHEET 7.	VCH		STATE P		T "9_K1			ND: 0.9	(NAD 83)	
<ol> <li>6-FT CONCRETE VALLEY GUTTER PER COA STD DWG #2420.</li> </ol>	BEN			ZONE	NUMEN	1.51	94.19			
6. CONSTRUCT NEW 4" PCC SIDEWALK PER DETAIL SHEET .			NEW MEXICO	CENTRAL ZONE	ACS MONUMENT	=1498911.51	N=1486094.19	GRID TO	ELEV=5117.72	
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9. CONSTRUCT ADA RAMP DETAIL "C" PER COA STD DWG	NOL		DAT							
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<ol> <li>12. ENTRANCE "C" SEE SHEET 7.</li> <li>13. ENTRANCE "D" SEE SHEET 7.</li> </ol>	V/ //									
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TITLE: NEW OFFICE/WAREHOUSE FOR BRONAC 541 AIRPORT DRIVE, NW ALBUQUERI SITE PLAN										
Design Review Committee City Engineer Approval		Mo./	′Day/`	Yr.			Мо.,	/Day/	Yr.	
Feb. 15, 2023										
DESIGN REVIEW COMMITTEE CITY ENGINEER										
City Project No.         Zone Map No.           777182         J-10-Z		Sh	eet	2	1	0	f	8		




## **RECORD DRAWINGS**

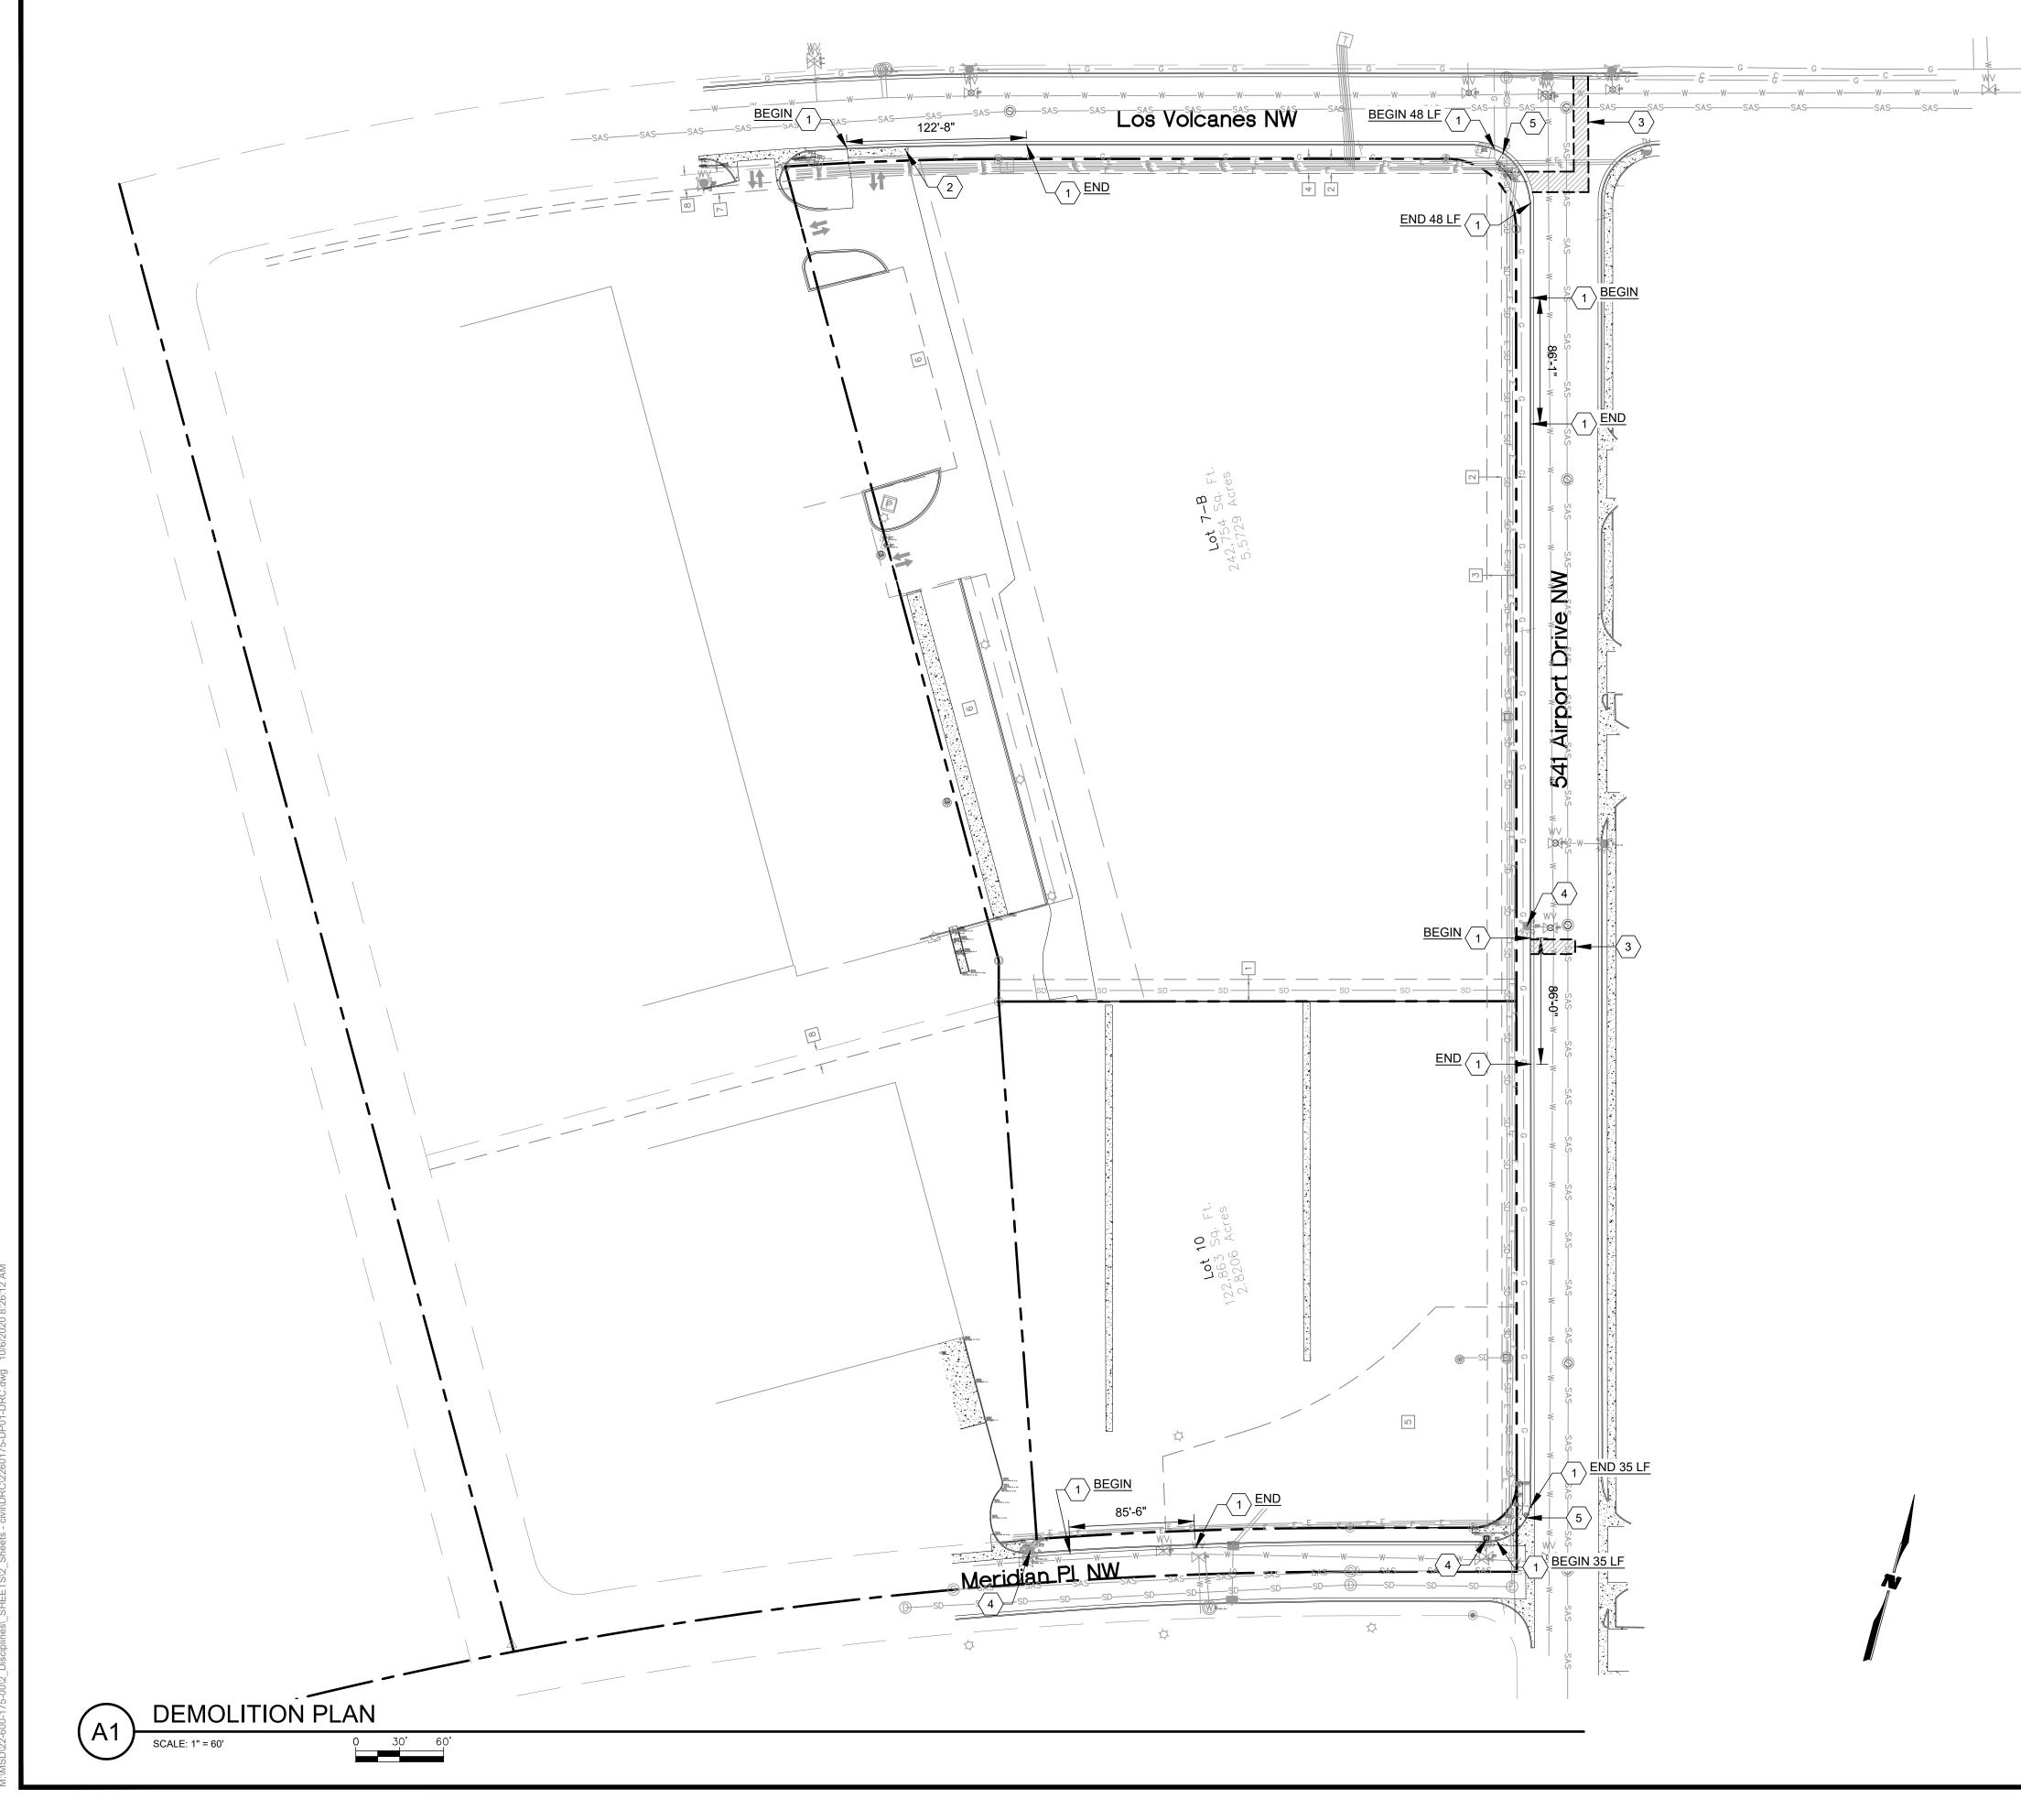

J-10-Z


5

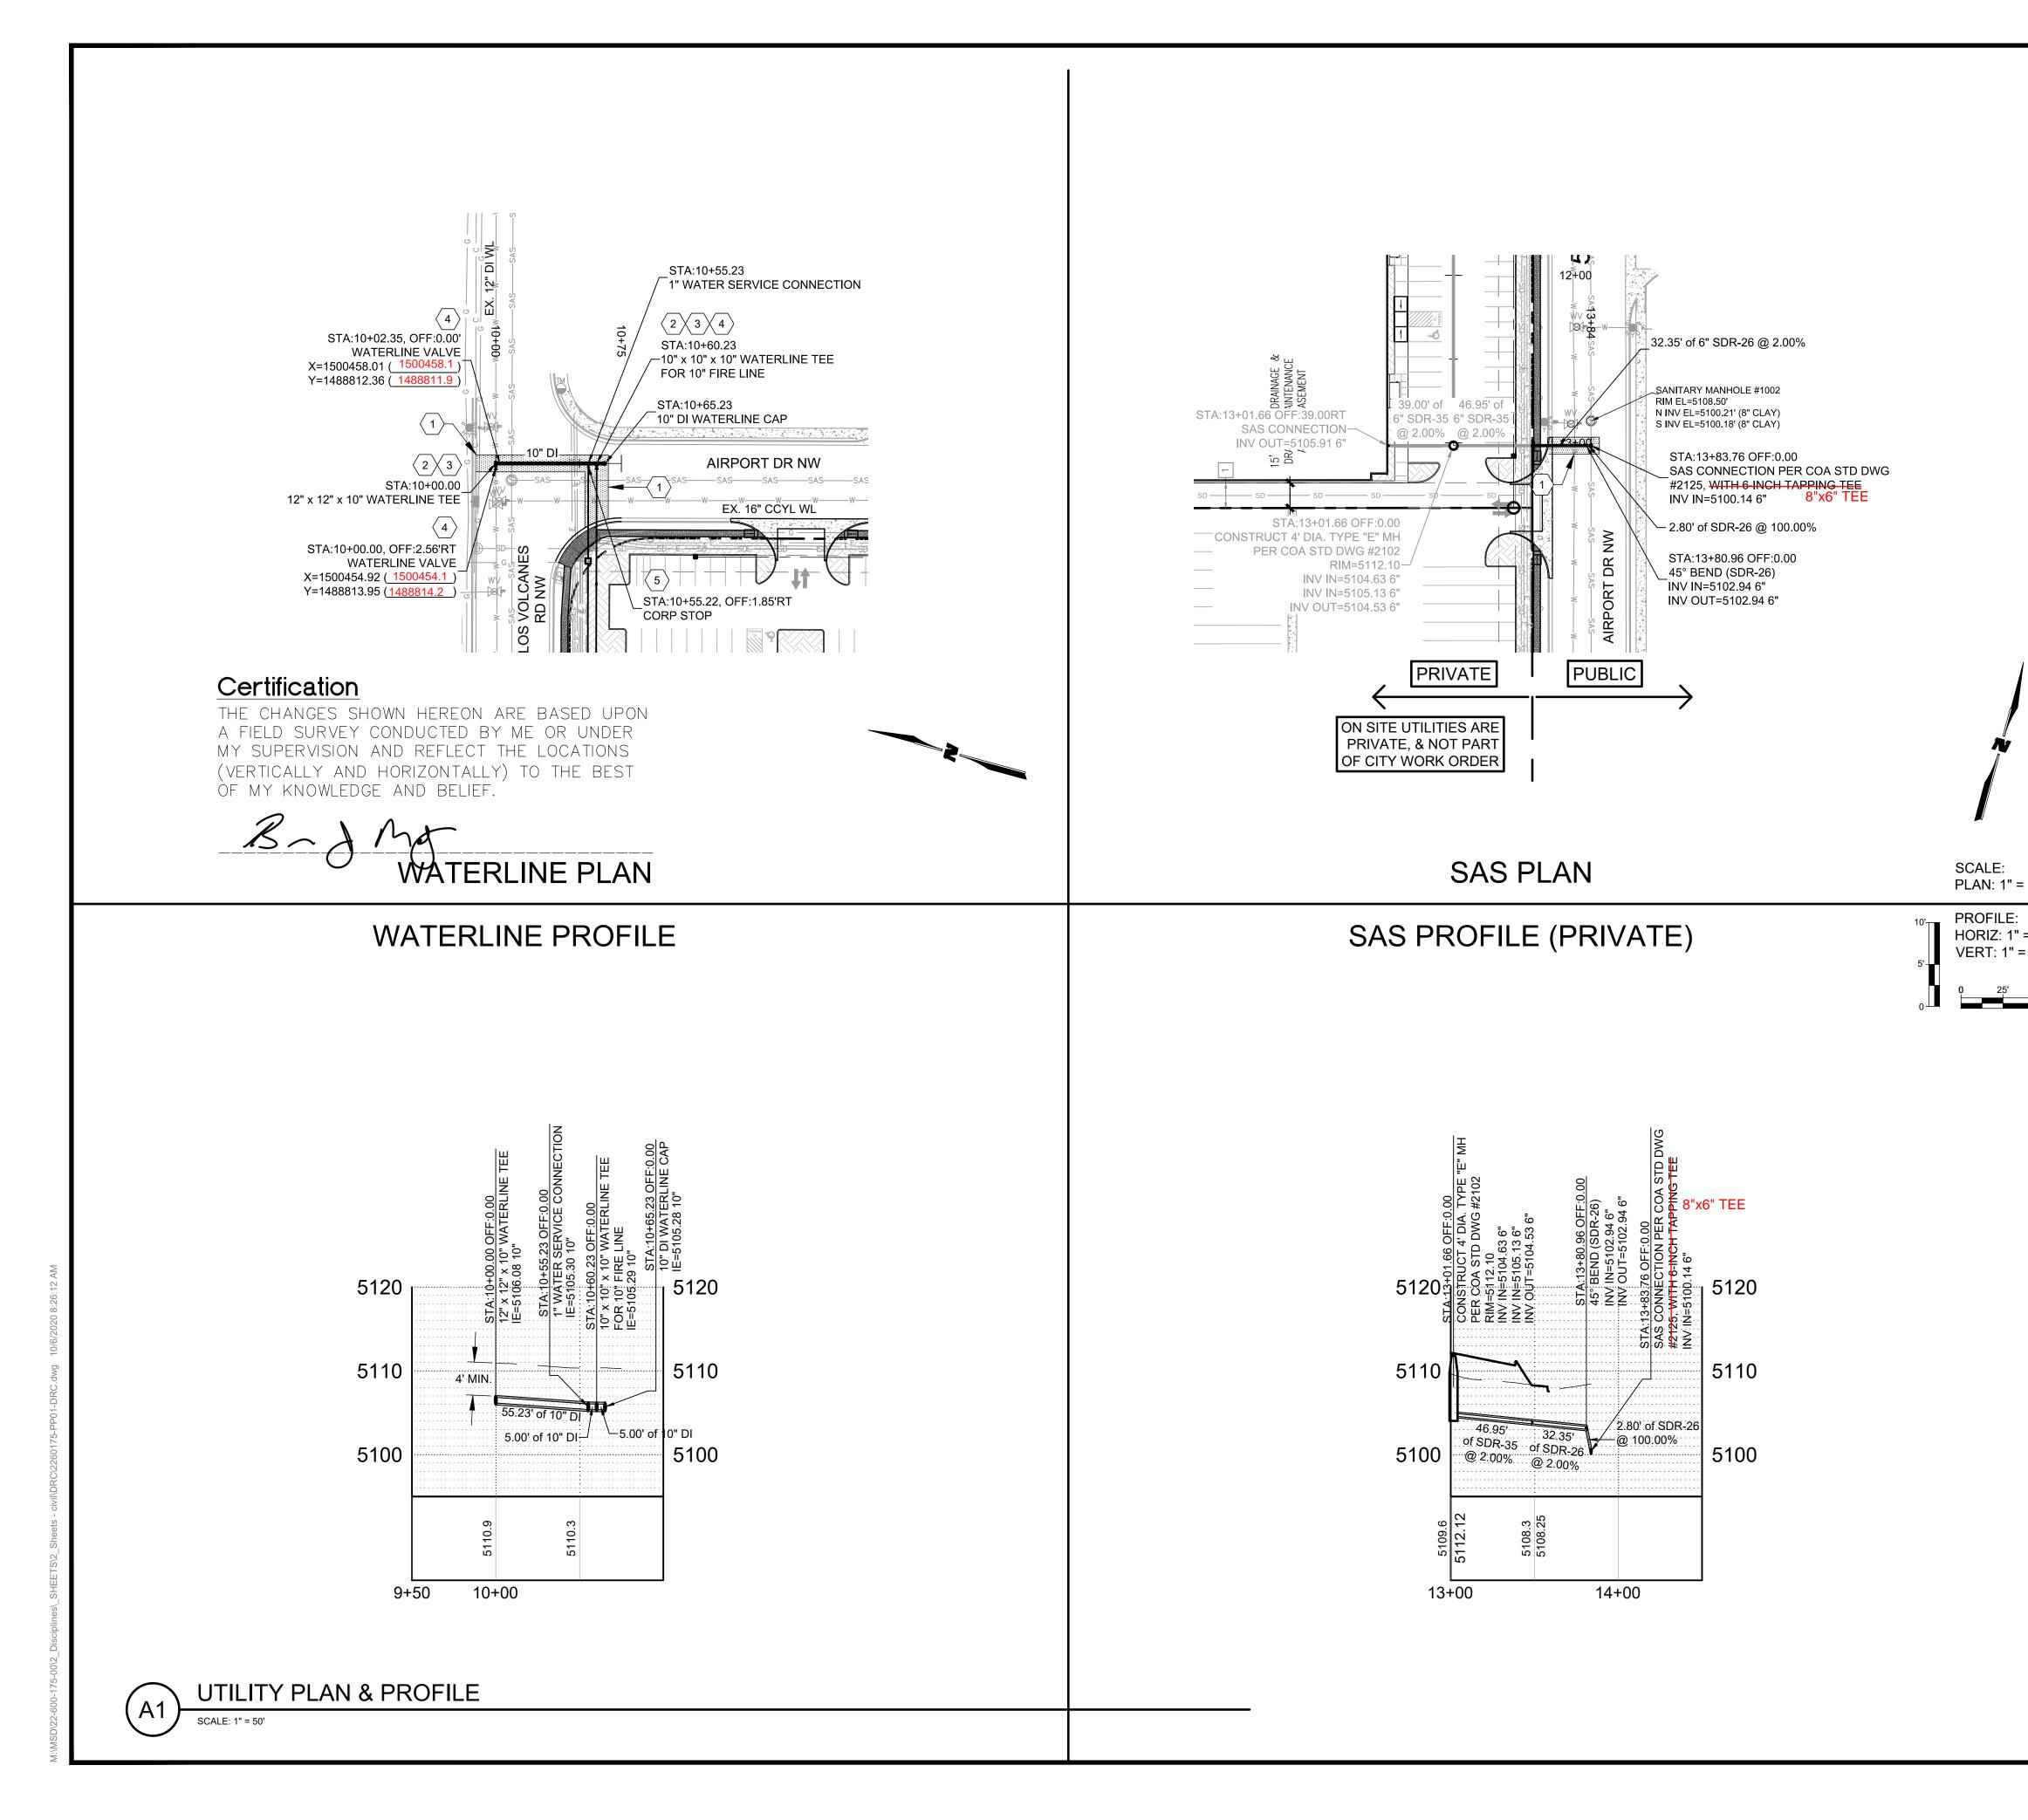

		AS BUILT INFORMATION	CONTRACTOR DATE	WORK STAKED BY DATE	INSPECTOR'S ACCEPTANCE BY DATE	FIELD VERIFICATION BY DATE	DRAWINGS CORRECTED BY DATE	MICRO-FILM INFORMATION	RECORDED BY DATE	NO.	
	<ol> <li>REPLACE EXISTING ASPHALT IN KIND, PER COA STD DWG #2465.</li> <li>INSTALL NON-PRESSURIZED CONNECTION TO EXISTING WATERLINE PER COA STD DWG #2301.</li> <li>CONNECTION TO EXISTING WATERLINE PER COA STD DWG #2301.</li> <li>INSTALL WATERLINE VALVE &amp; BOX PER COA STD DWG #2326 &amp; #2329.</li> <li>CORP STOP.</li> </ol>	N   BENCH MARKS		A TE NEW MEXICO STATE PLANE COORDINATES	CENTRAL ZONE	ACS MONUMENT "9_K10"	E=1498911.51	N=1486094.19	GRID TO GROUND: 0.999679308	ELEV=5117.72 (NAD 83)	
		SURVEY INFORMATION	FIELD NOTES	NO. BY D							
= 50' = 50' = 10'		ENGINEER'S SEAL			the mental	S 2 2 2 ROF	E. ME 489 73 ESSI	/22	Clone	-11-	
						REMARKS	REVISIONS	DESIGN	DATE: 11-03-22	DATE: 11-03-22	DATE: 11-03-22
	WILSON         & COMPANY         4401 MASTHEAD ST. NE. SUITE 150         ALBUQUERQUE, NM 87109         PHONE: 505-348-4000         FAX: 505-348-4072         www.wilsonco.com         Image: Company of the state of the stat	E F T	DI	RT VI	M SI		N		DESIGNED BY: TGS	DRAWN BY: DY	CHECKED BY: JEL
	ITTLE:       NEW OFFICE/WAREHOUSE FOR BRUNAC         541 AIRPORT DRIVE, NW ALBUQUERD         UTILITY PLAN & PRO         Design Review Committee         Image: Provide the provided of the pro	จบเ	E, LE Mo./	NM	1 Yr.	87		<u>Mo.</u>	r /Day/ 		


	Curve Table									
Curve # Length Radius Delta Chord Direction Chord Le										
C1	38.88	28.00	79.55	N67° 28' 33"W	35.83					
C2	35.78	28.00	73.22	S38° 17' 04"W	33.40					
C3	33.33	28.00	68.20	N18° 59' 50"E	31.40					
C4	5.71	15.00	21.82	N64° 00' 28"E	5.68					
C5	5.72	15.00	21.84	S85° 50' 06"W	5.68					

	Curve Table										
Curve #	Length	Radius	Delta	Chord Direction	Chord Length						
C6	33.37	28.00	68.29	N49° 06' 00"W	31.43						
C7	33.13	28.00	67.80	N18° 49' 14"E	31.23						
C8	5.81	15.00	22.21	N63° 49' 28"E	5.78						
C9	5.78	15.00	22.07	S85° 56' 18"W	5.74						
C10	33.21	28.00	67.96	N49° 02' 47"W	31.30						

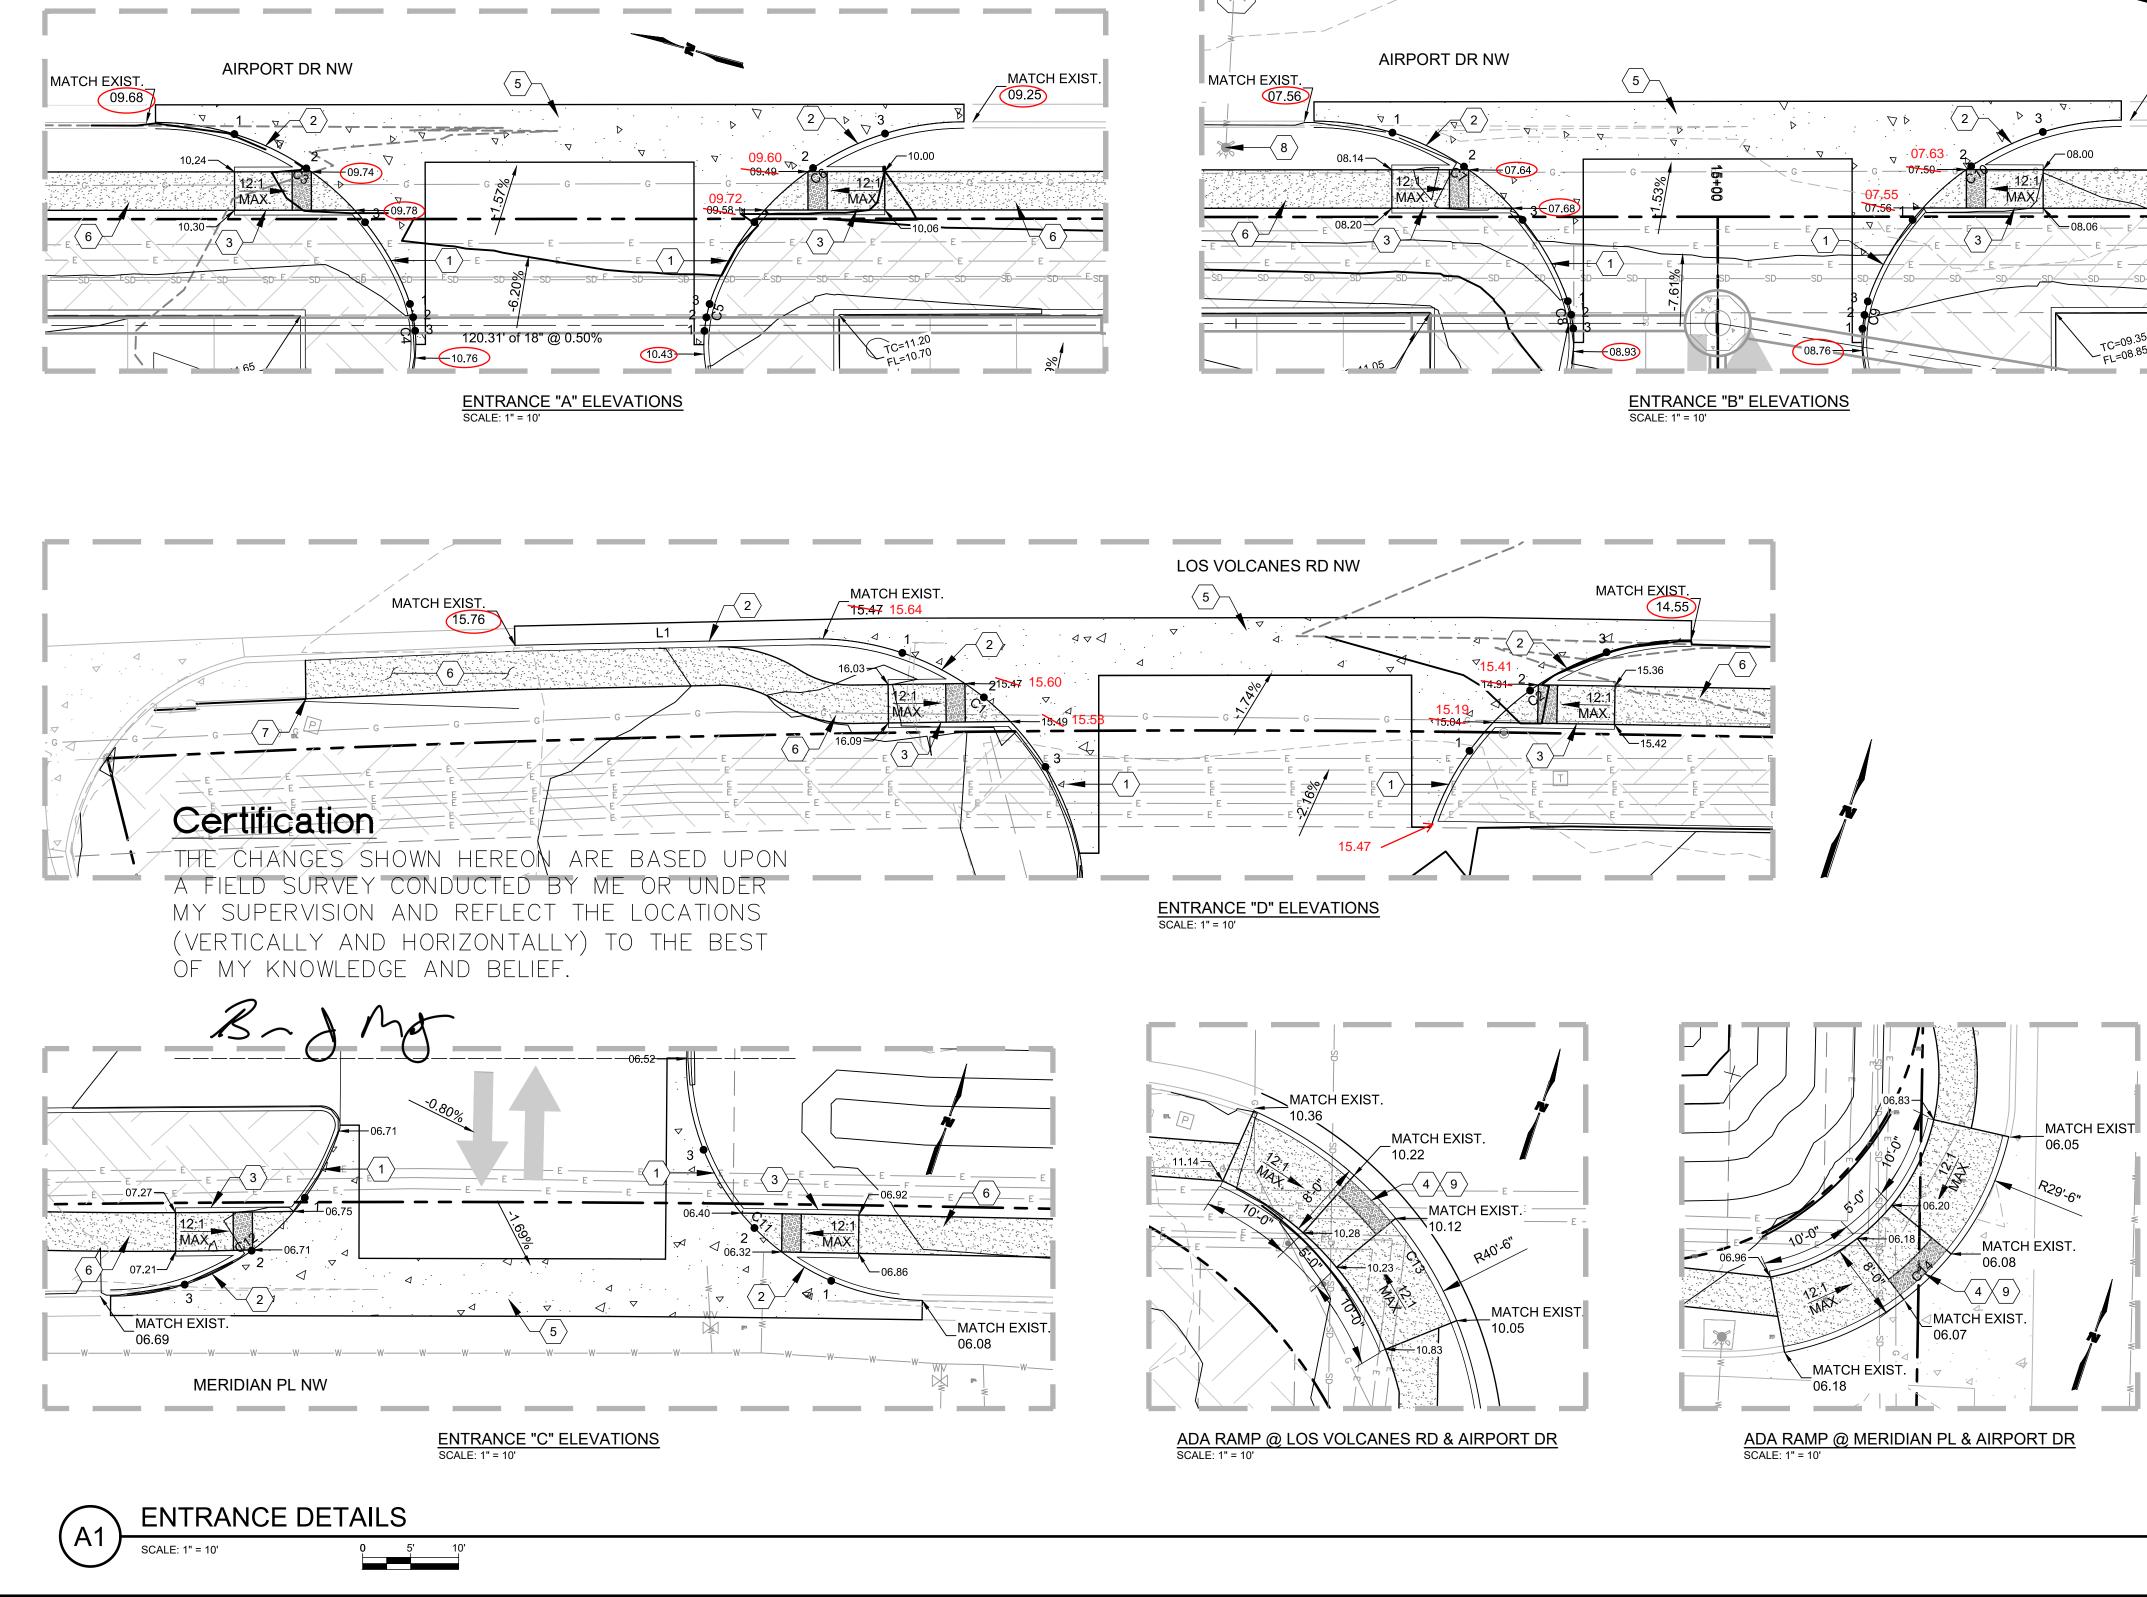

	Curve Table									
Curve # Length Radius Delta Chord Direction Chord Length										
C11	39.09	25.00	89.60	S62° 15' 47"E	35.23					
C12	31.39	25.00	71.93	N36° 08' 26"E	29.36					
C13	47.32	40.50	66.95	N48° 34' 44"W	44.68					
C14	34.30	29.50	66.62	N30° 05' 36"E	32.40					

Parcel Line Table									
Line #	Length	Direction							
L1	30.79	N72° 44' 48.67"E							

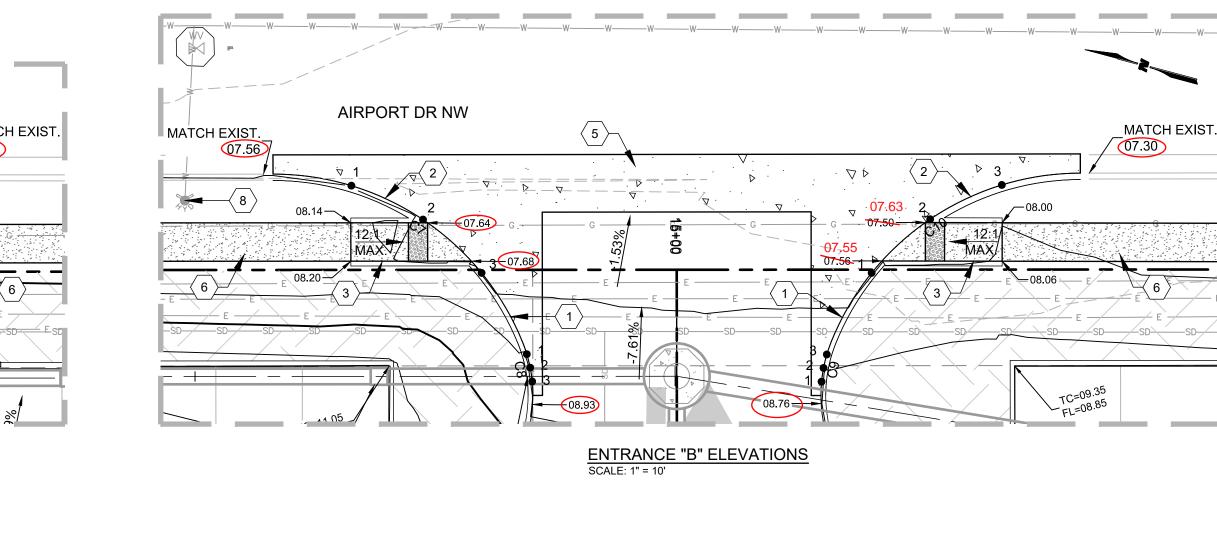

### **RECORD DRAWINGS GENERAL NOTES** SIDEWALK AND CURB RAMPS SHALL COMPLY WITH THE CURRENT REQUIREMENTS OF THE AMERICANS WITH DISABILITIES ACT (ADA). THE CONTRACTOR SHALL

NF


## KEYNOTES


CONSTRUCT MEDIAN CURB & GUTTER PER COA STD DWG #2415A.

CONTACT THE CITY STAFF TO SCHEDULE INSPECTIONS.

- DWG #2415A.
- #2443.
- #2420.

- EXISTING FIRE HYDRANT TO REMAIN. PROTECT IN PLACE.
- CONSTRUCT (WHEELCHAIR) CURB ACCESS RAMP PER COA STD DWG #2441.

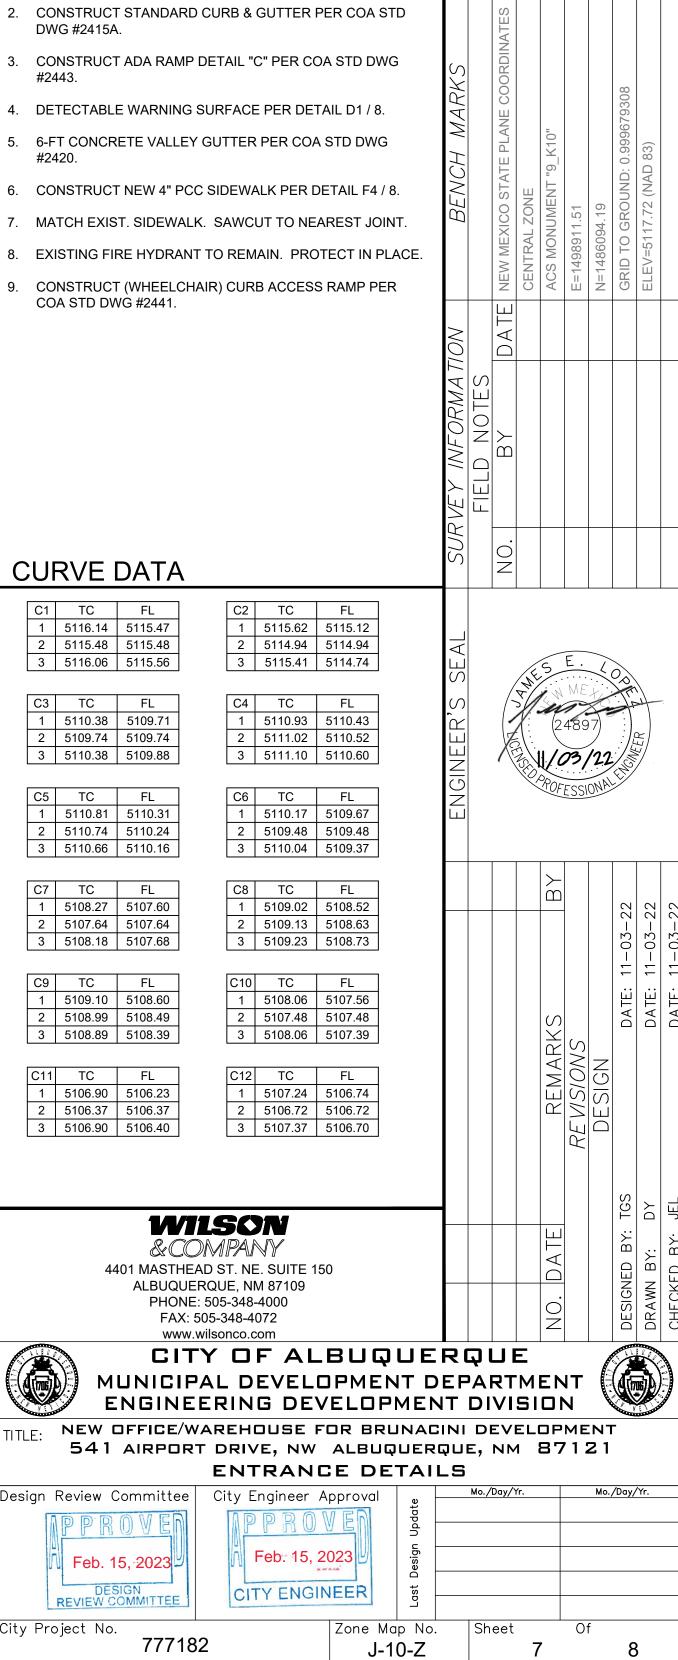

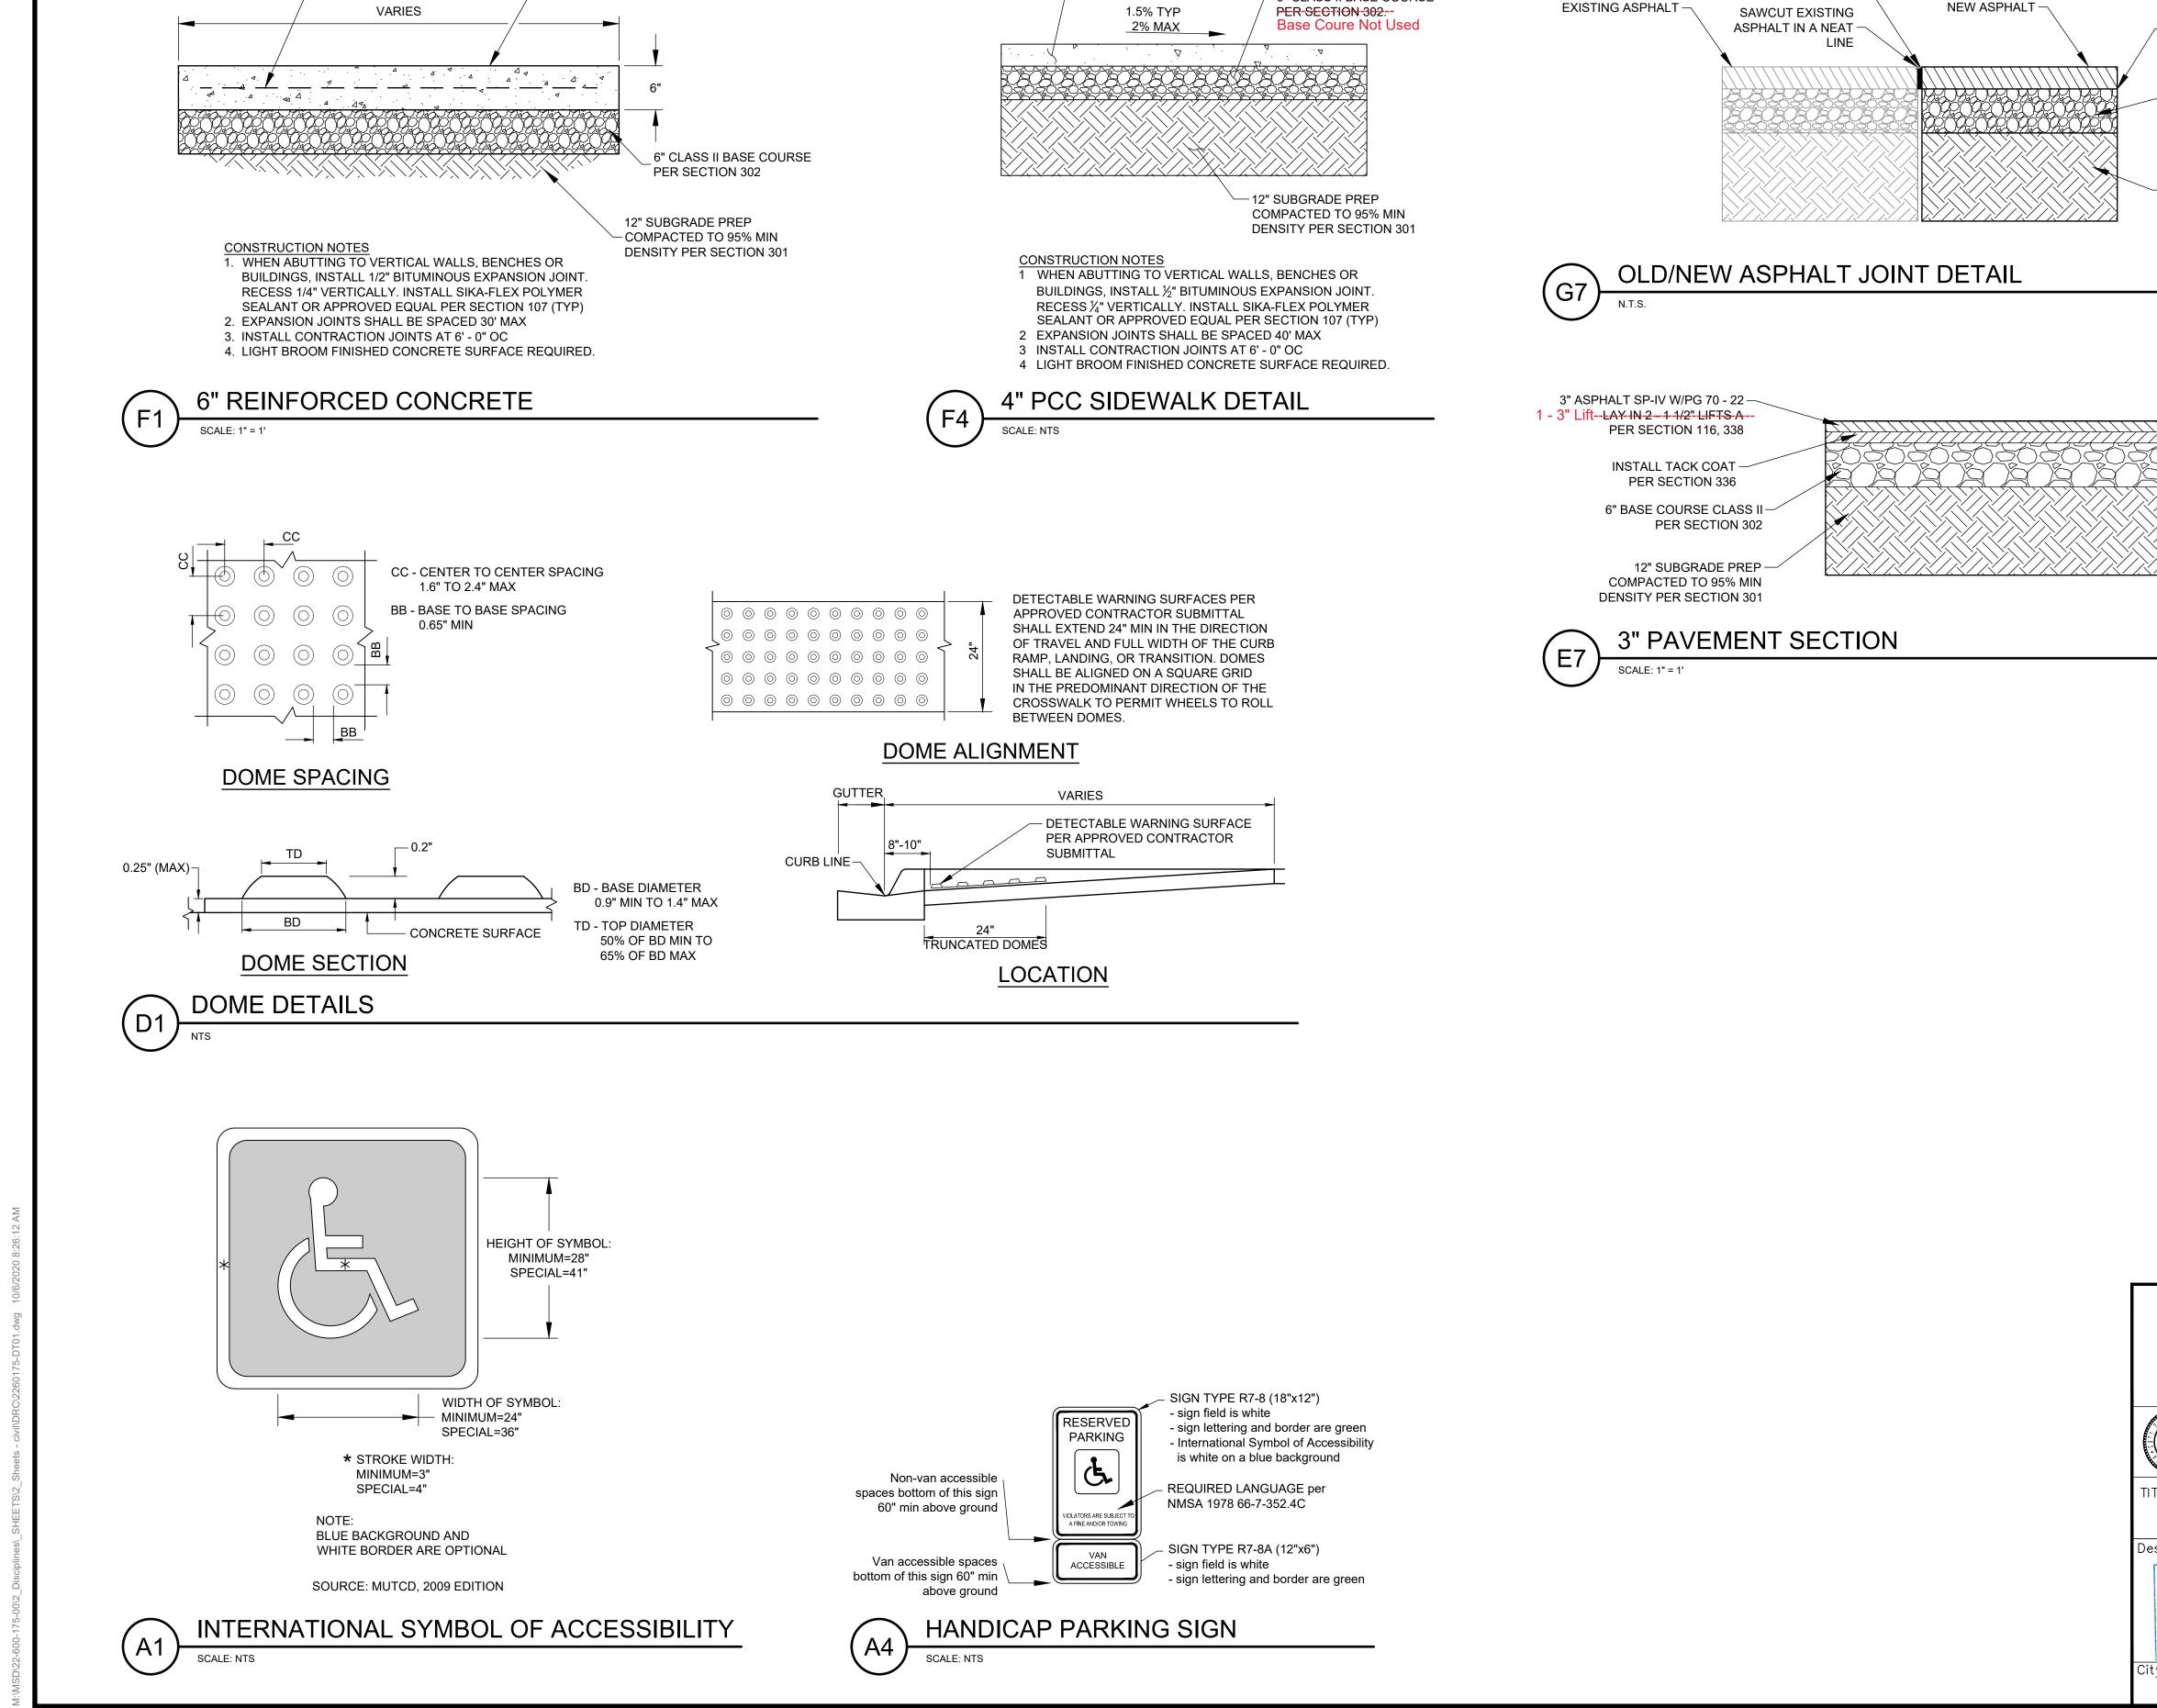

\_\_\_\_\_ 4" PCC

F' C = 3000 PSI @ 28

DAYS PER SECTION 101

- 6"-CLASS-II-BASE COURSE-

TACK COAT -


6" x 6" x 6GA WWM


PER SECTION 102

f 'c = 3000 PSI @ 28

- DAYS PER SECTION

101, 340

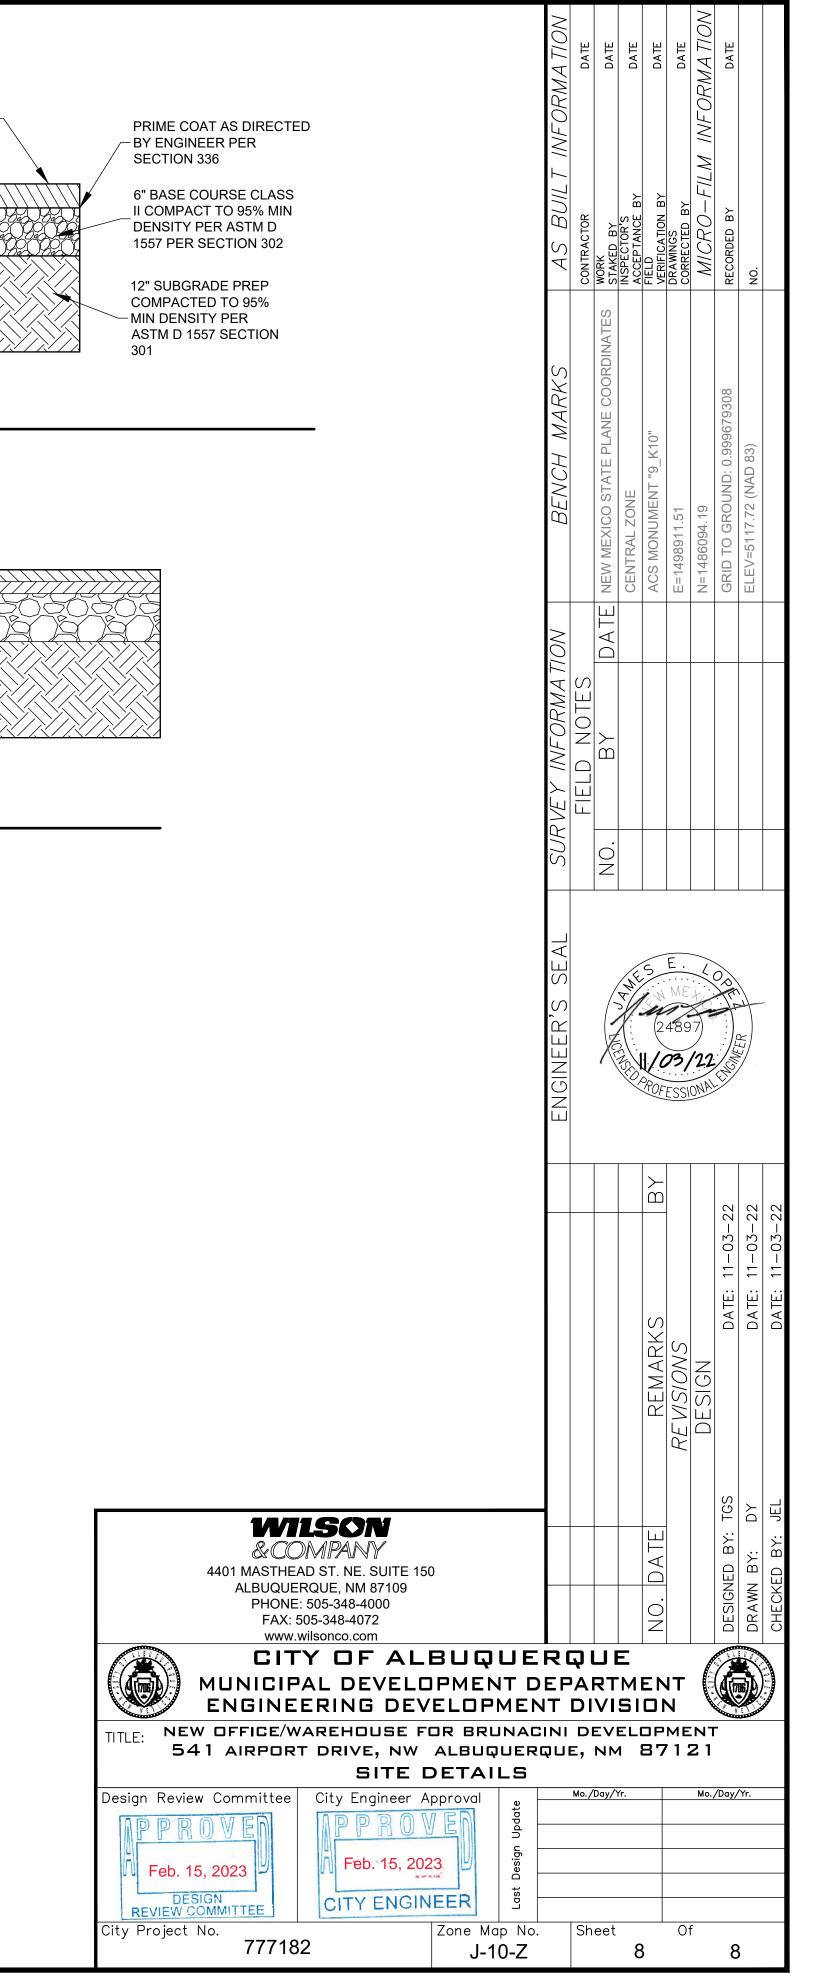

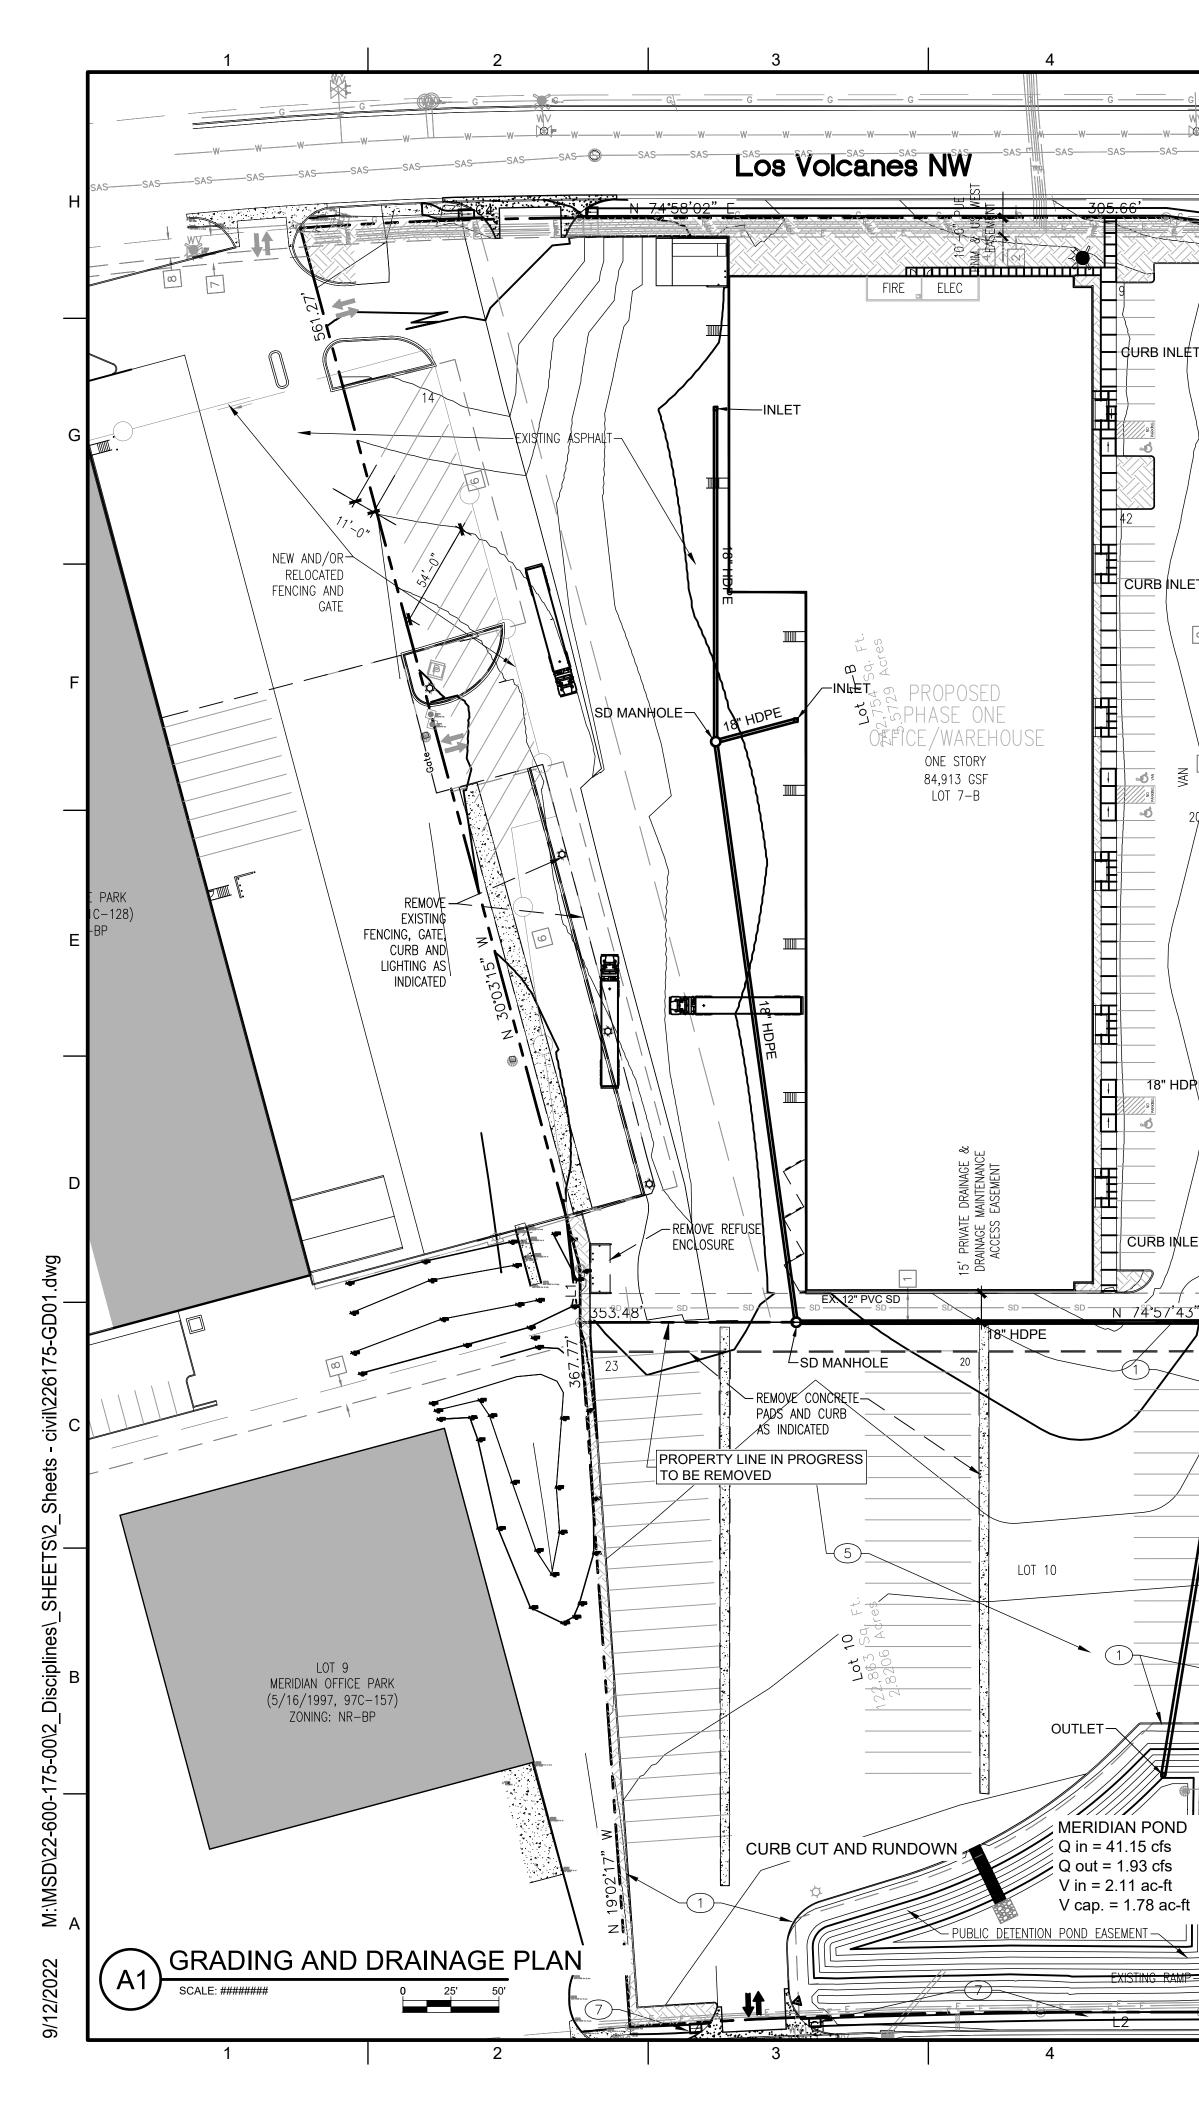

#### Drainage Narrative Introduction

The project site is located at 541 Airport Dr. NW. The site is bounded by Airport Drive NW to the east, Los Volcanes Road NW to the north, Gallatin Place NW to the west, and Meridian Pl. NW to the south. The existing site and proposed improvements are generally contained within Lots 7-B and 10 of Tract M as identified in the Conceptual Master Grading and Drainage Plan prepared for Lots 1-23 of the Meridian Business Park by Easterling & Associates, Inc. in August 1996. The site is not located within a designated FEMA flood plain map, see firm map 35001C0328J.

#### **Existing Conditions**

The existing site topography in Lot 7-B generally drains from northwest to southeast in the conceptual plans prepared by Easterling and was confirmed on a site visit. A berm has been constructed on the eastern edge of the lot that appears to block water from exiting the site in this direction, and instead forces water to flow south into Lot 10 and inevitably into the existing public drainage pond on the southern edge of the lot. The Easterling plans suggested that there be an inlet to receive flow on the southeastern corner of this lot, though no such drainage infrastructure was observed on the site. The site includes a portion of Lot 7-A that is currently developed and includes parking and an access road to the trailer parking in Lot 10. Flow in this segment tends to drain southwest and is seemingly directed toward the existing drainage pond that has been constructed for the development in Lot 7-A west of the site.

Lot 10 drains from north to south (and into the proposed rectangular drainage pond) in the Easterling plan, and this was observed to be generally true by a preliminary site visit. A large majority of Lot 10 consists of compacted dirt and gravel. The remainder is undisturbed aside from a large drainage pond. Currently, the pond discharges to the east toward an existing storm drain system adjacent to Airport Dr. NW via a standpipe with circular 3 in. diameter inlet orifices set at varying elevations and a 5" diameter plate orifice on the outlet pipe. The downstream connection point is an existing storm drain line adjacent to Airport Dr. NW. Some sediment and debris have accrued on the bottom of the pond and the lowermost tiers of orifices on the standpipe have been blocked. According to the Easterling plan, the pond has a design capacity of 1.0404 ac-ft, though topography data of the area shows the current capacity to be 0.8563 ac-ft. There is also an existing offsite basin identified in the Easterling Plan as Basin E1 that drains to the pond via 2 combination inlets in the flowlines of Meridian Pl. Data for this basin was pulled from the Easterling Plan and utilized in the design considerations for the pond.

In its current condition, the on-site basin contributing flow to the pond is delivering up to 17.3 cfs for the 100-year 24-hour event to the pond. This corresponds to a volume of 0.5205 ac-ft prior to development.

#### Interim Conditions (Phase 1)

The proposed site will maintain the general flow from northwest to southeast toward the detention pond in Lot 10. The boundaries of construction in phase 1 are primarily limited to the undeveloped area that comprises Lot 7-B. The existing developed area on the western side of Lot 7-B will be improved in Phase 2. A 73,969 square-foot tenant space is to be constructed, with paved parking, sidewalk, and desert-landscaped median features constructed on the eastern and northern faces of the spaces. On the western face of the building, an asphalt swale will be constructed with slopes less than or equal to 2% up to 50 feet away from the edge of the truck bay. Area inlets and pipe connections will be installed in the swale to collect and distribute flows to the existing detention pond in Lot 10. The parking lot on the eastern face of the building will be superelevated to drain east toward a series of inlets along the eastern curb line. These inlets and the corresponding pipe connections will send the flows south toward the detention pond. The pipe networks on the western and eastern faces of the building will meet at a junction in Lot 10 north of the pond before discharging to the pond via an opening mitered to slope. Most of the vacant lot will become paved and impervious. As mentioned before, the area west of the fence line is not to be disturbed during construction of Phase 1 to maintain the access road.

The existing detention pond in Lot 10 will need to be improved such that it can accommodate the increase in flow from both Phase 1 and 2 during Phase 1. This includes laying the pipe that discharges flow from Phase 1 through Lot 10 prior to Phase 2.

The discharge from the site will increase to 25.4 cfs after development, which corresponds to a difference of 8.1 cfs. The discharge from the site corresponds to a volume of 1.1333 ac-ft for the 100-year 24-hour event after the construction of Phase 1, with a difference in volume of 0.6128 ac-ft between existing and interim conditions. This volume is already higher than the current capacity of the pond in both the conceptual Easterling staging, as well as the staging developed from current topography. The pond will be regraded with 3:1 side slope to maximize the capacity of the pond without expanding the footprint beyond the boundary of the public detention pond easement. The base pond elevation will also be dropped, and the standpipe reconstructed to accommodate the updated allowable discharge for the site. In the drainage master plan, the pond shows a maximum allowable discharge of 1.47 cfs to the storm drain, while Lot 8 (Lot 7B in current platting) was intended to discharge 0.47 cfs to the storm drain further upstream. The owners of the site are in the process of getting Lots 7B and Lots 10 replated into one parcel. This will correspond to a maximum allowable discharge of 1.94 cfs from the pond for the combined lots. A sidewalk culvert will be constructed on the southern face of the pond to serve as an emergency spillway that drains to Meridian Pl. A berm will be constructed to approximately 1 foot above the back of sidewalk elevation to accommodate the spillway and maintain freeboard. Approximately 0.25 ac-ft of runoff needs to be retained to meet MS4 requirements, and the pond will retain approximately 0.41 ac-ft.

The edge of the pond will also have a berm constructed to 1 ft above the invert of the emergency spillway in order to increase freeboard. **Final Conditions (Phase 2)** 

#### The proposed site will maintain the general flow from northeast to southwest toward the detention pond in Lot 10. A large portion of Lot 10, minus the ponding area and landscaping, will be paved and the grading and drainage scheme developed in Phase 1 will be maintained to deliver flows to the existing detention pond. Curb-cuts and a concrete rundown will be installed on the perimeter of the pond to deliver overland flows from the area in Phase 2 and reduce erosion of the pond side slopes. In the previously developed area on the western edge of Lot 7-B, work will be done to expand the northernmost column of parking, including the removal of some pervious landscaping. The western edge of Lot 7-B currently drains to the off-site detention pond on the southeast corner of Lot 7-A, and it is recommended that this grading be maintained if repaying occurs.

The improvements in Lot 10 will increase the discharge from the site to 28.4 cfs. This corresponds to a total volume of 1.4298 ac-ft for the 100-year 24-hour event, with a difference in volume of 0.2957 ac-ft between interim and final conditions, and a difference in discharge of 3 cfs between interim and final conditions.

#### Conclusion

In summary, inlets and storm drain will be installed to capture on-site flows from Phase 1 and deliver the water to the detention pond in Lot 10. The pond will be regraded to accommodate the increase in discharge from Phase 1 and Phase 2 at this time, and the pipe network constructed in Phase 1 will be taken to the pond at this time. The area in Phase 2 will be paved and a concrete rundown and curb cut constructed at the pond to receive the overland flow from the site. A series of sidewalk culverts will also be constructed at this time to serve as an emergency spillway for the pond. The standpipe outlet structure will be reconstructed to retain the MS4 volume for the site and limit the discharge from the site to 1.94 cfs per the drainage master plan and proposed parceling. Lots 7B and 10 will be replated as one parcel in order to permit Lot 7B to discharge through Meridian Pond.

#### Meridian Pond - Proposed Staging

Meridia	n Pond	MS4 Calculations				
Stage	Area	Storage	Cumulative Storage	Cumulative Storage	Basin	Area Ft <sup>2</sup>
Elev. (ft)	Ft <sup>2</sup>	Ft <sup>3</sup>	Ft <sup>3</sup>	Ac-ft	101	310698.37
5099	5730	0.000	0		L	
5100	7112	6420.939	6421			
5101	8576	7843.891	14265			
5102	10110	9343.263	23608			
5103	11712	10911.349	34519			
5104	13383	12547.585	47067			
5105	15121	14251.868	61319			
5106	16928	16024.379	77343	1.7756		

#### Existing Conditions (Pre PH1)

	Total	Total		Ą	E	3	C	>	C		Peak	Excess Precip.	Volume	Volume
Basin	Area (sq ft)	Area (Ac)	%	Ac	%	Ac	%	Ac	%	Ac	Discharge, Q	(Weighted)	(6 <sub>hr</sub> , acre-ft)	(24 <sub>hr</sub> , acre-ft)
101	310698	7.133	0	0	71.1	5.07	23.8	1.70	5.1	0.36	17.3	0.86	0.5108	0.5205
*E1	226512	5.200	0	0	9	0.47	9	0.47	82	4.26	19.9	1.99	0.8615	0.9752
Basin E1 from the Easterling Report Dated 08/96														

Volume

ft^3

10874.44

Total

Volume

Ac-ft 0.25

0.25


Interim Conditions (Post PH1 / Pre PH2)


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	Total	Total		A	E	3	C	>	۵	)	Peak	Excess Precip.	Volume	Volume
Basin	Area (sq ft)	Area	%	Ac	%	Ac	%	Ac	%	Ac	Discharge, Q	(Weighted)	(6 <sub>hr</sub> , acre-ft)	(24 <sub>hr</sub> , acre-ft)
101	310698	7.133	0	0.00	10.8	0.77	28.3	2.02	60.9	4.34	25.4	1.71	1.0175	1.1333
E1	226512	5.200	0	0	9	0.47	9	0.47	82	4.26	19.9	1.99	0.8615	0.9752
* Basin E1 from the Easterling Report Dated 08/96														

#### Final Conditions (Post PH2)


	Total	Total	/	۹	l	3	(	2	C	)	Peak	Excess Precip.	Volume	Volume
Basin	Area (sq ft)	Area	%	Ac	%	Ac	%	Ac	%	Ac	Discharge, Q	(Weighted)	(6 <sub>hr</sub> , acre-ft)	(24 <sub>hr</sub> , acre-ft)
101	310698	7.133	0	0.00	3.2	0.23	6%	0.41	91%	6.48	28.4	2.11	1.2569	1.4298
E1	226512	5.200	0	0	9	0.47	9	0.47	82	4.26	19.9	1.99	0.8615	0.9752
Basin E1 from the Easterling Report Dated 08/96														

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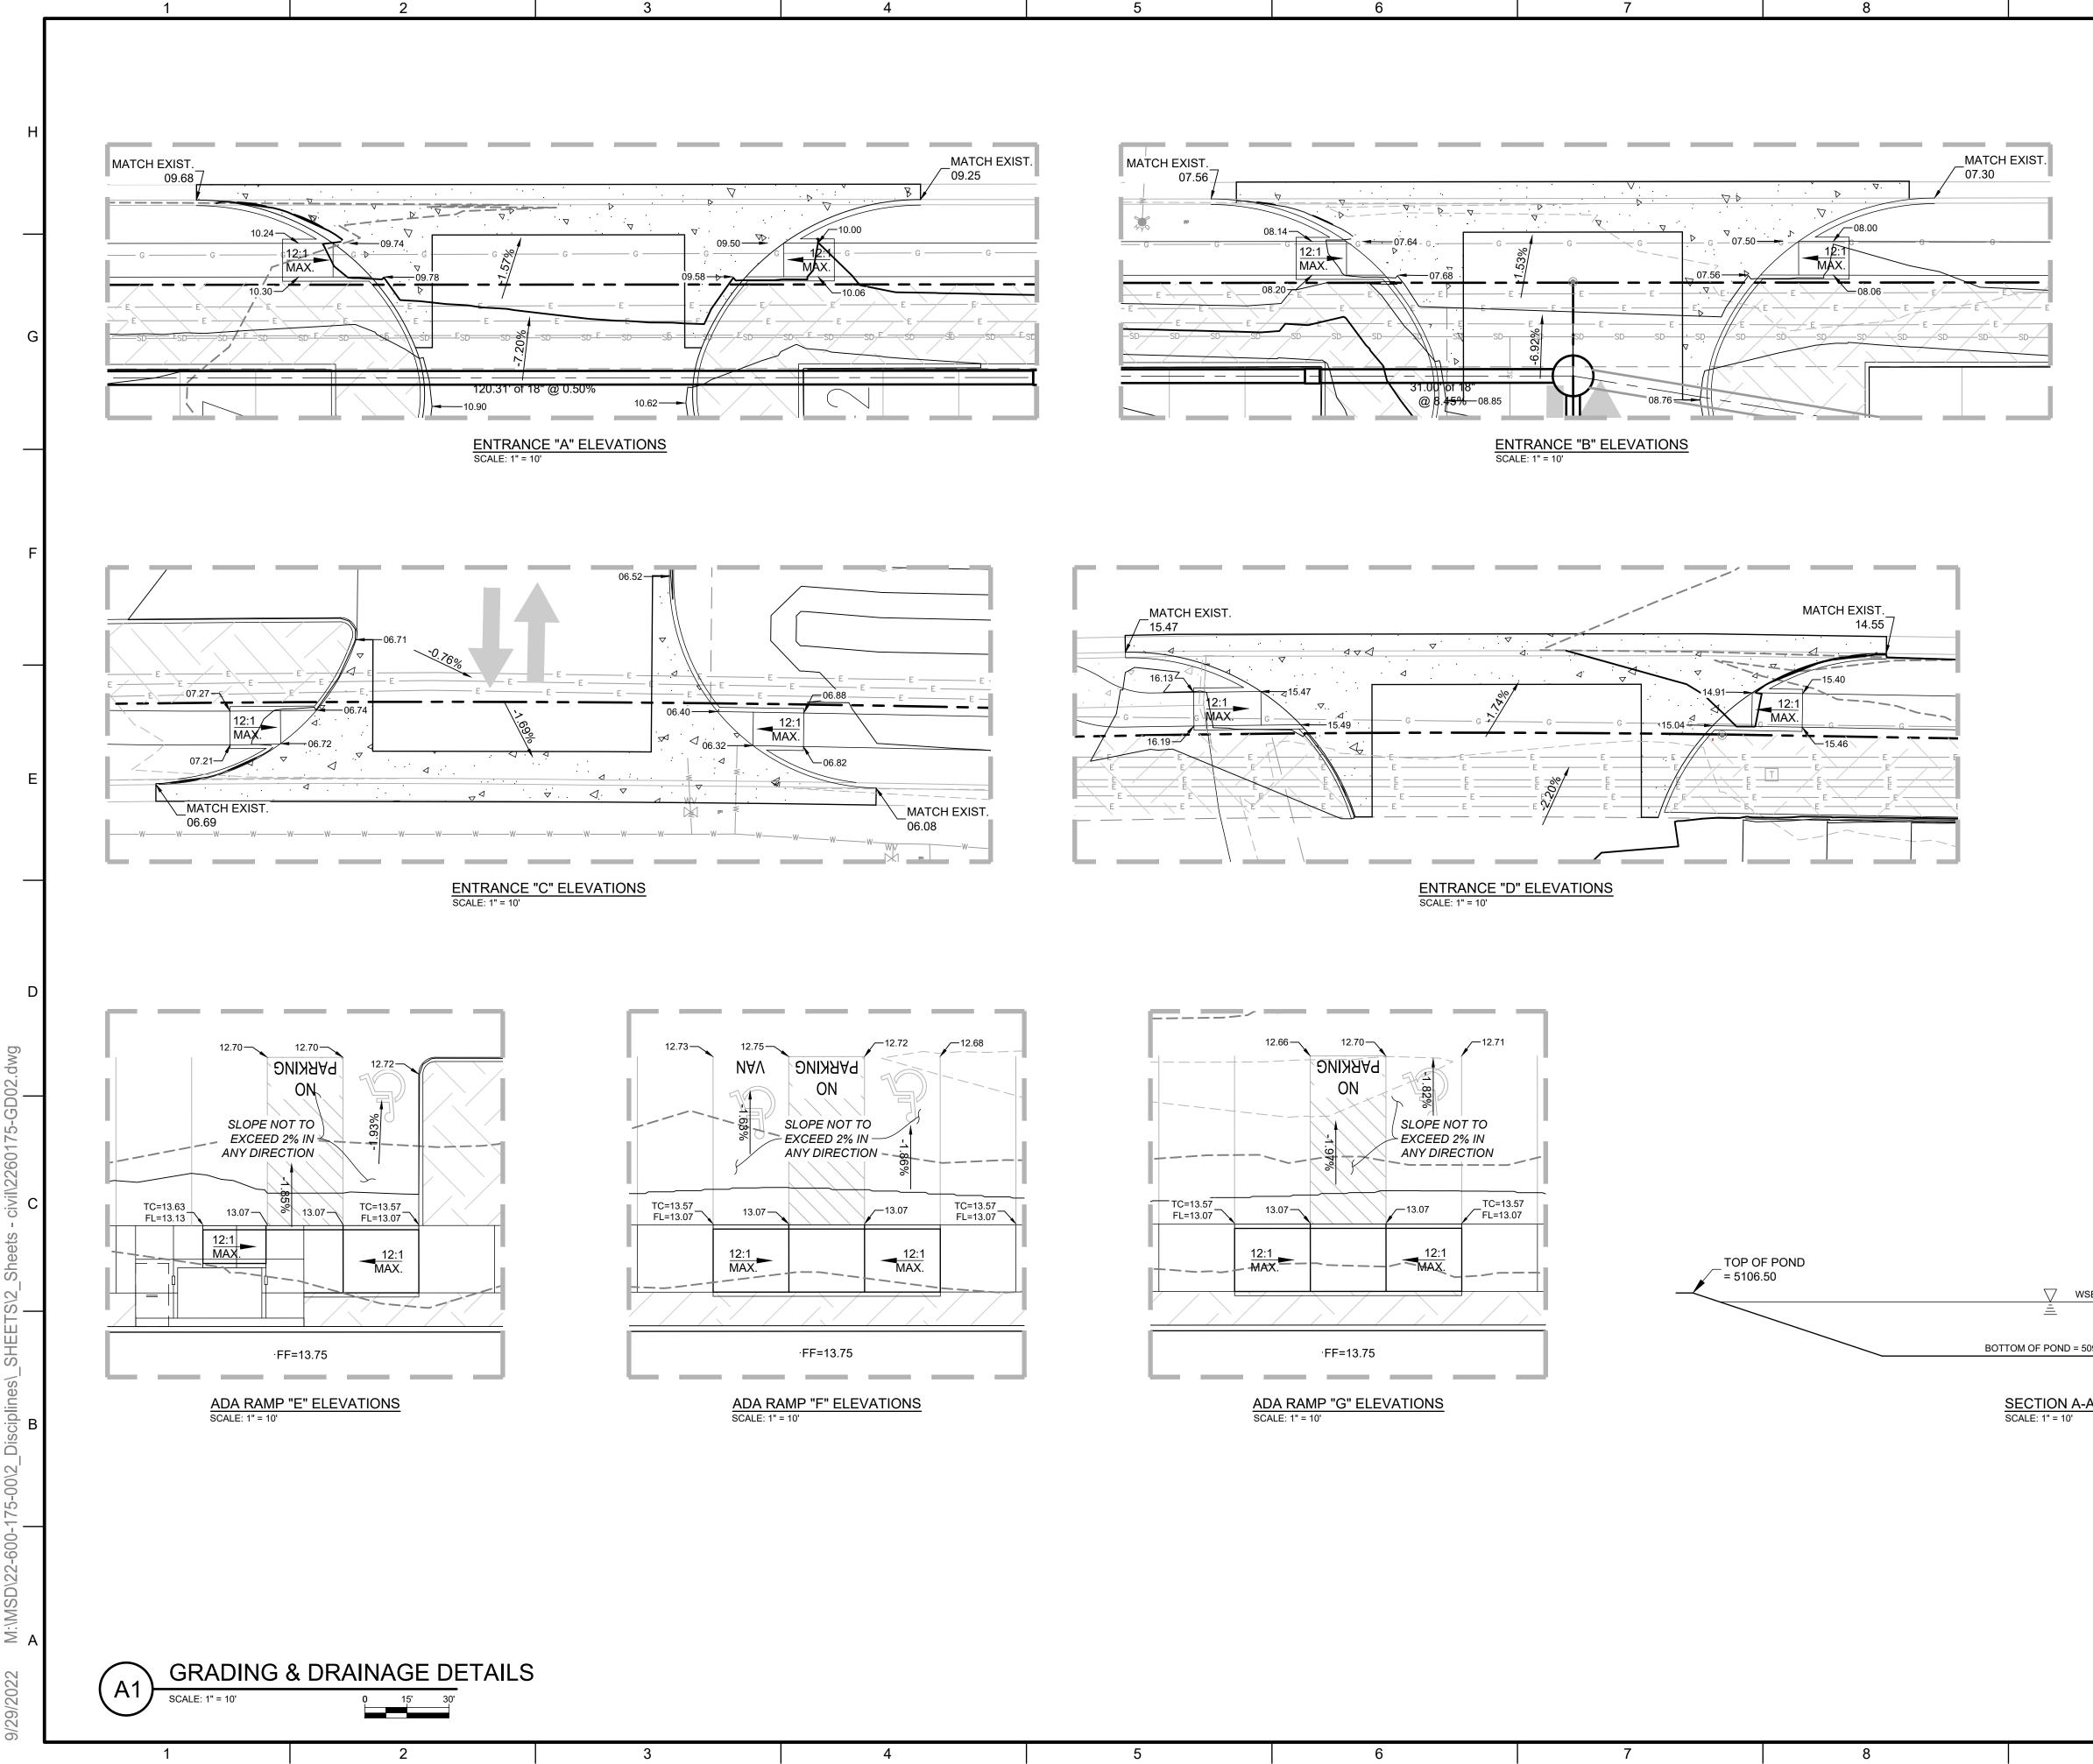


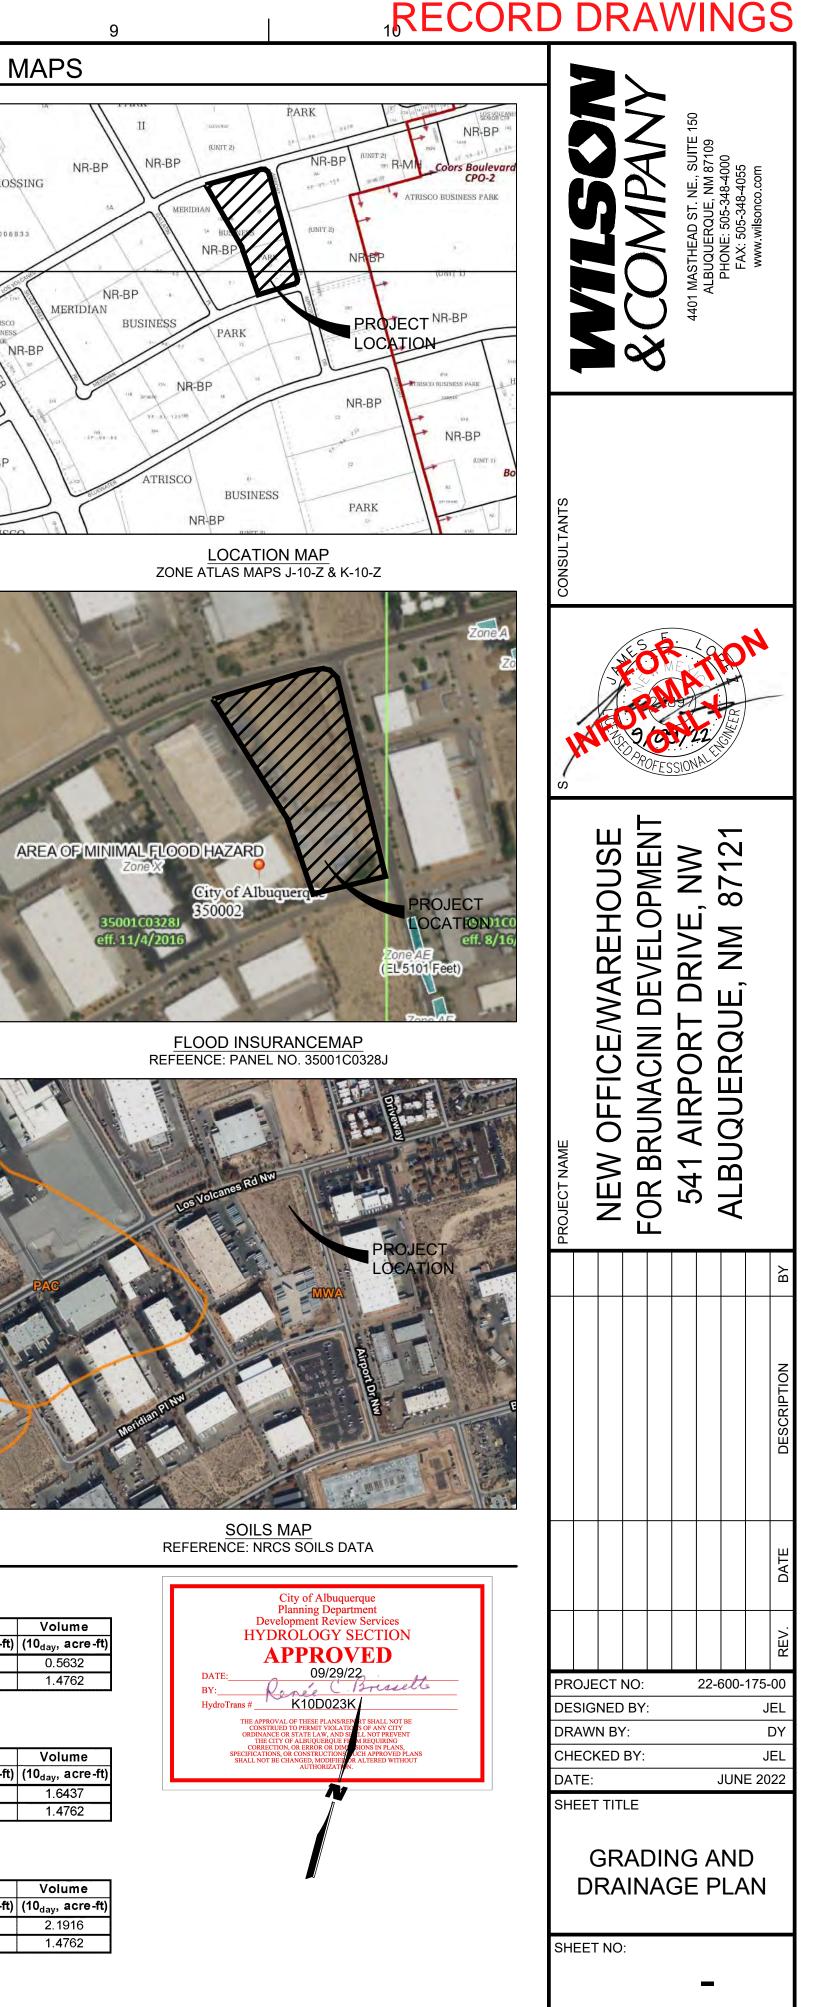

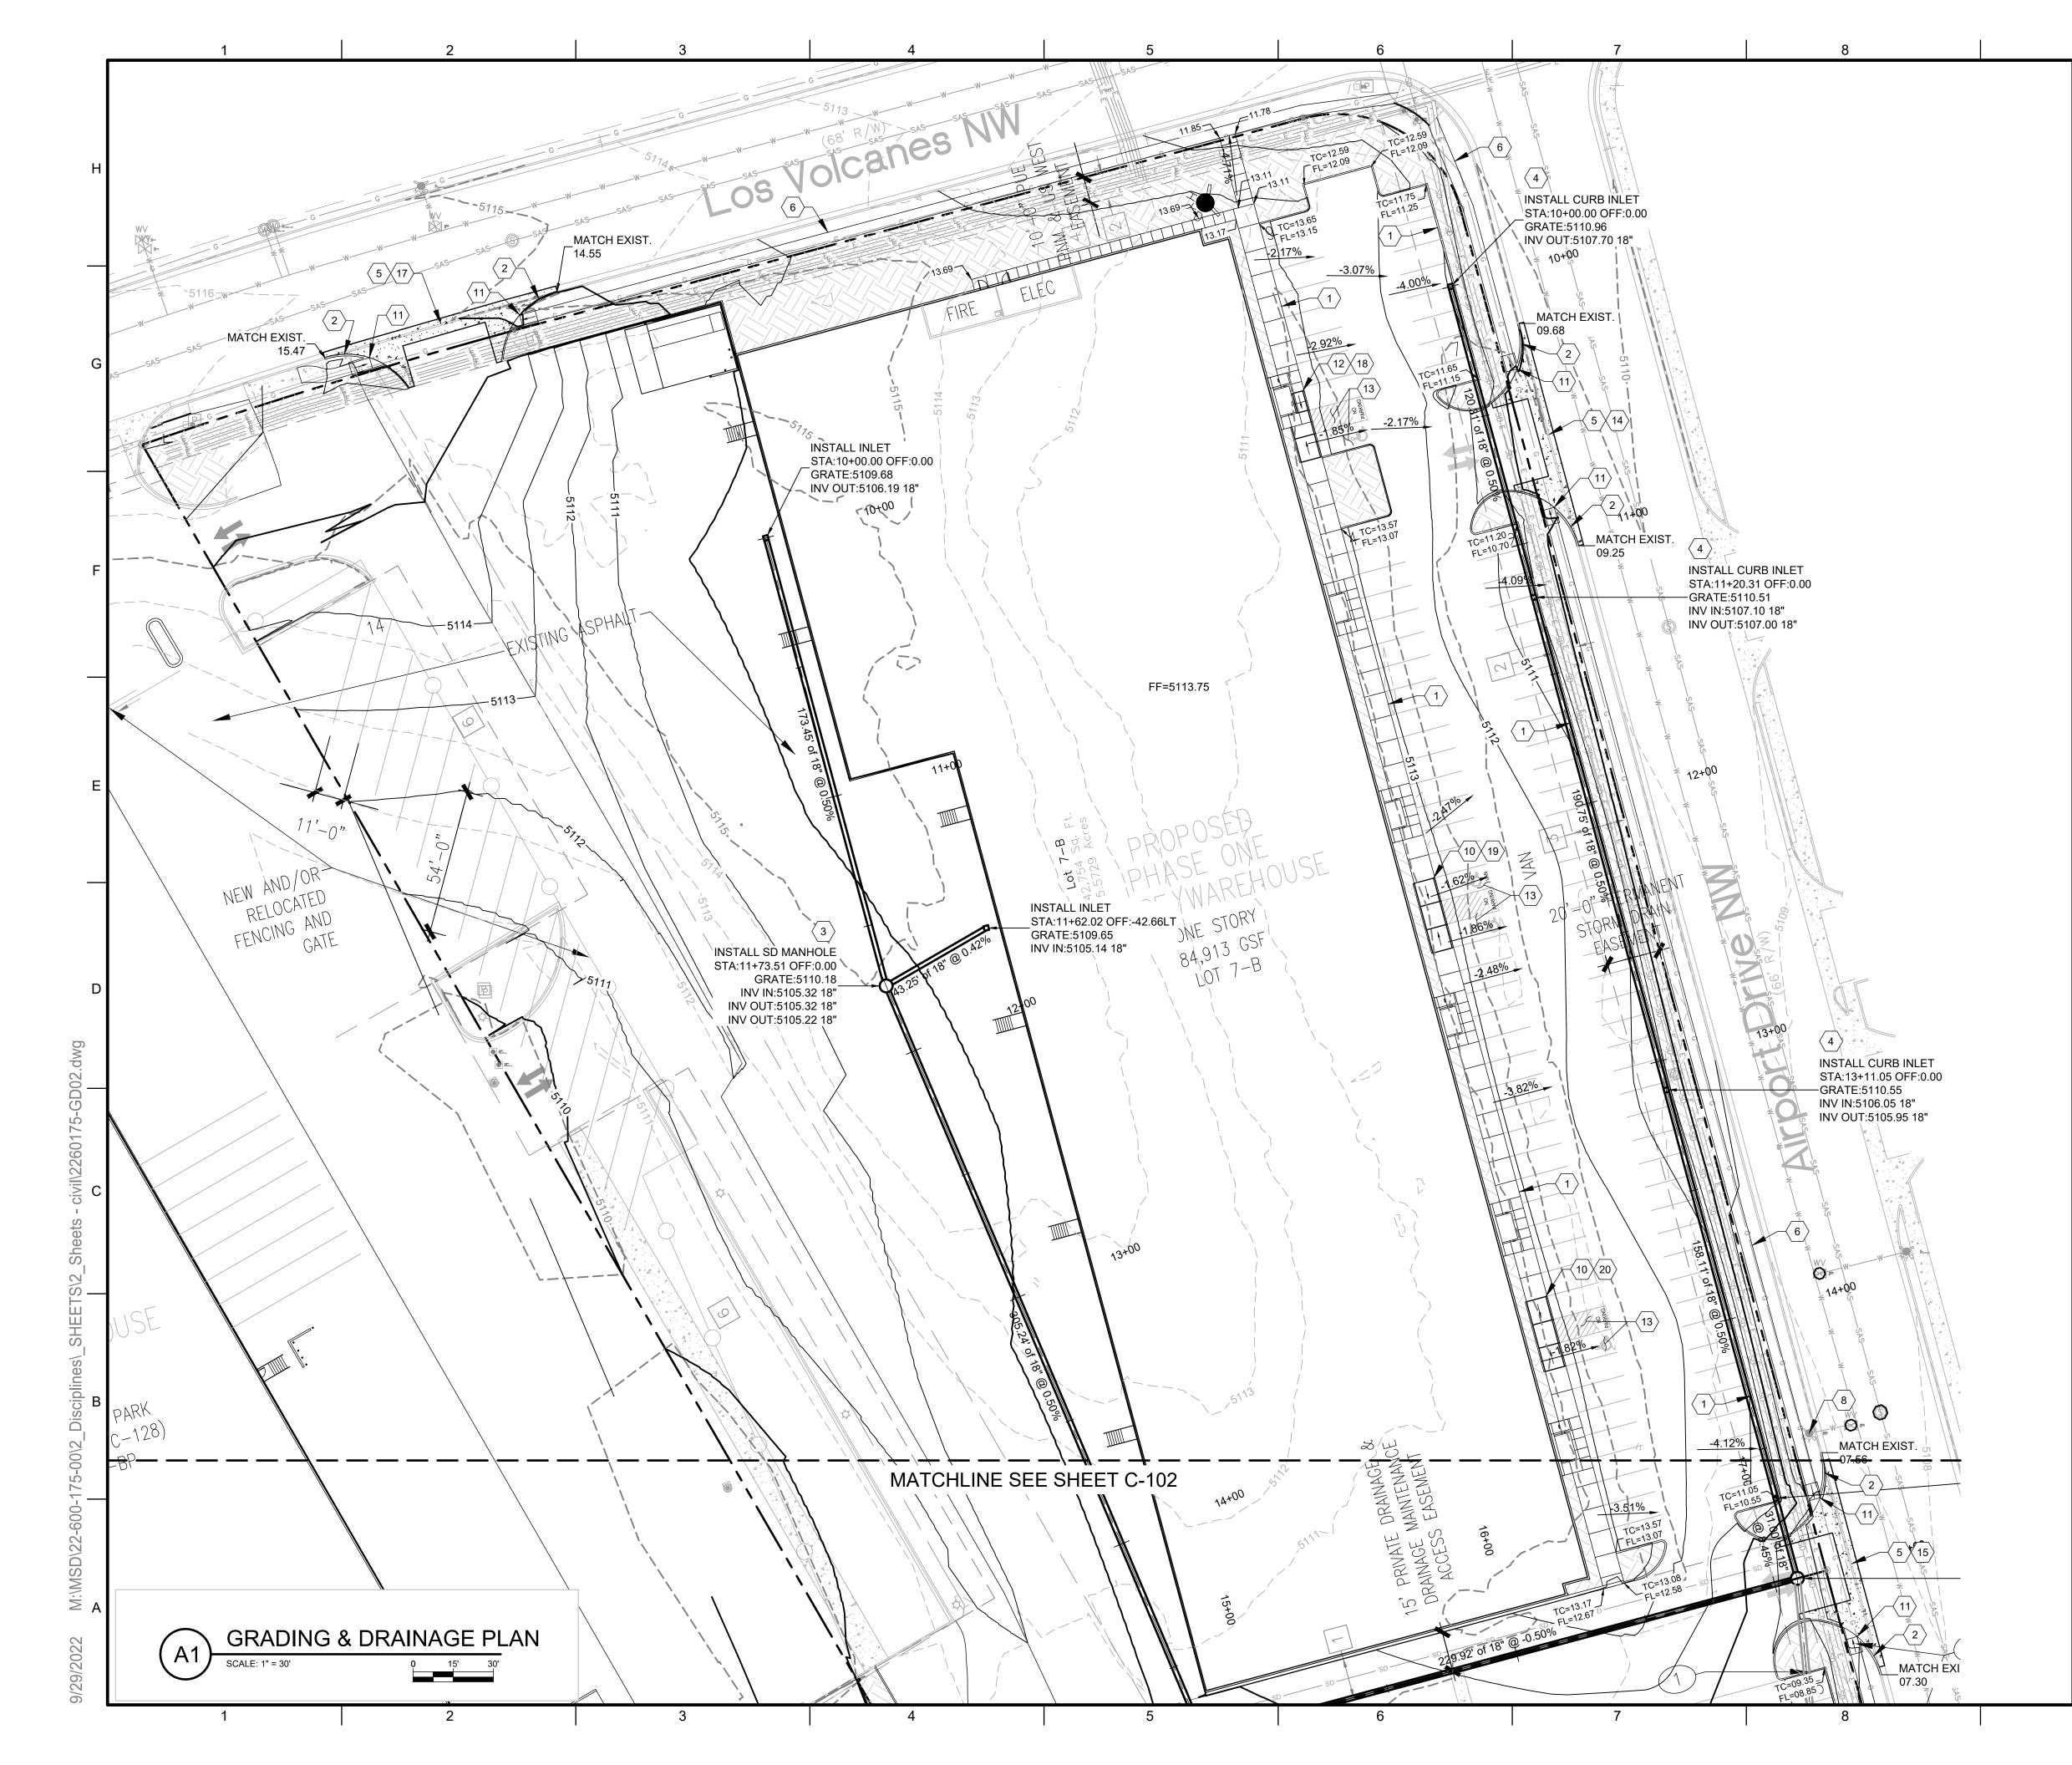	D DRAWINGS
GENERAL NOTES	
1. SIDEWALK AND CURB RAMPS SHALL COMPLY WITH THE CURRENT REQUIREMENTS OF THE AMERICANS WITH DISABILITIES ACT (ADA). THE CONTRACTOR SHALL CONTACT THE CITY STAFF TO SCHEDULE INSPECTIONS.	Adot MASTHEAD ST. NE., SUITE 150 ALBUQUERQUE, NM 87109 PHONE: 505-348-4000 FAX: 505-348-4055 www.wilsonco.com
1. CONSTRUCT MEDIAN CURB & GUTTER PER COA STD DWG #2415A.	
2. CONSTRUCT STANDARD CURB & GUTTER PER COA STD DWG #2415A.	
3. CONSTRUCT 6' DIA. TYPE "C" MH PER COA STD DWG #2101.	
4. INSTALL CURB INLET TYPE "C" PER COA STD DWG #2205.	S
<ol> <li>CONSTRUCT DRIVE PAD PER COA STD DWG #2425.</li> <li>CONSTRUCT NEW 4" PCC SIDEWALK PER DETAIL SHEET C-103.</li> </ol>	CONSULTANTS
7. MATCH EXIST. SIDEWALK. SAWCUT TO NEAREST JOINT.	CO
8. EXISTING FIRE HYDRANT TO REMAIN. PROTECT IN PLACE.	ESE- LOON
<ol> <li>9. 10'x10' RIP-RAP PAD.</li> <li>10. CONSTRUCT ADA RAMP DETAIL "A" PER COA STD DWG</li> </ol>	
#2443. 11. CONSTRUCT ADA RAMP DETAIL "C" PER COA STD DWG	NF 9757/22
<ul><li>#2443.</li><li>12. CONSTRUCT MODIFIED ADA RAMP DETAIL "A" PER COA STD DWG #2443.</li></ul>	0
13. SLOPE NOT TO EXCEED 2% IN ANY DIRECTION.	ти Парала Парала
14. ENTRANCE "A" ELEVATIONS PER SHEET C-103.	OUSE PMEN , NW 87121
15. ENTRANCE "B" ELEVATIONS PER SHEET C-103.	
16. ENTRANCE "C" ELEVATIONS PER SHEET C-103.	
<ol> <li>ENTRANCE "D" ELEVATIONS PER SHEET C-103.</li> <li>ADA RAMP "E" ELEVATIONS PER SHEET C-103.</li> </ol>	
19. ADA RAMP "F" ELEVATIONS PER SHEET C-103.	
20. ADA RAMP "G" ELEVATIONS PER SHEET C-103.	NO CIN NO CIN
21. 5-FOOT CONCRETE RUNDOWN.	
22. DRAINAGE SIDEWALK CULVERT WITH STEEL PLATE TOP PER COA STD DWG #2236.	PROJECT NAME NEW OI FOR BRU 541 AI ALBUQ
	SIPTIC
	DESCRIPTION
	DATE
	REV.
	PROJECT NO: 22-600-175-00
	DESIGNED BY: JEL DRAWN BY: DY
City of Albuquerque Planning Department Development Review Services	CHECKED BY: JEL
HYDROLOGY SECTION APPROVED	DATE: JUNE 2022 SHEET TITLE
DATE: 09/29/22 BY: Prisette HydroTrans # K10D023K	GRADING &
THE APPROVAL OF THESE PLANS/REPORT SHALL NOT BE CONSTRUED TO PERMIT VIOLATIONS OF ANY CITY ORDINANCE OR STATE LAW, AND SHALL NOT PREVENT THE CITY OF ALBUQUERQUE FROM REQUIRING CORRECTIONS, OR CONSTRUCTIONS, SUCH APPROVED PLANS SHALL NOT BE CHANGED, MODIFIED OR ALTERED WITHOUT AUTHORIZATION.	DRAINAGE PLAN
	SHEET NO: C-101

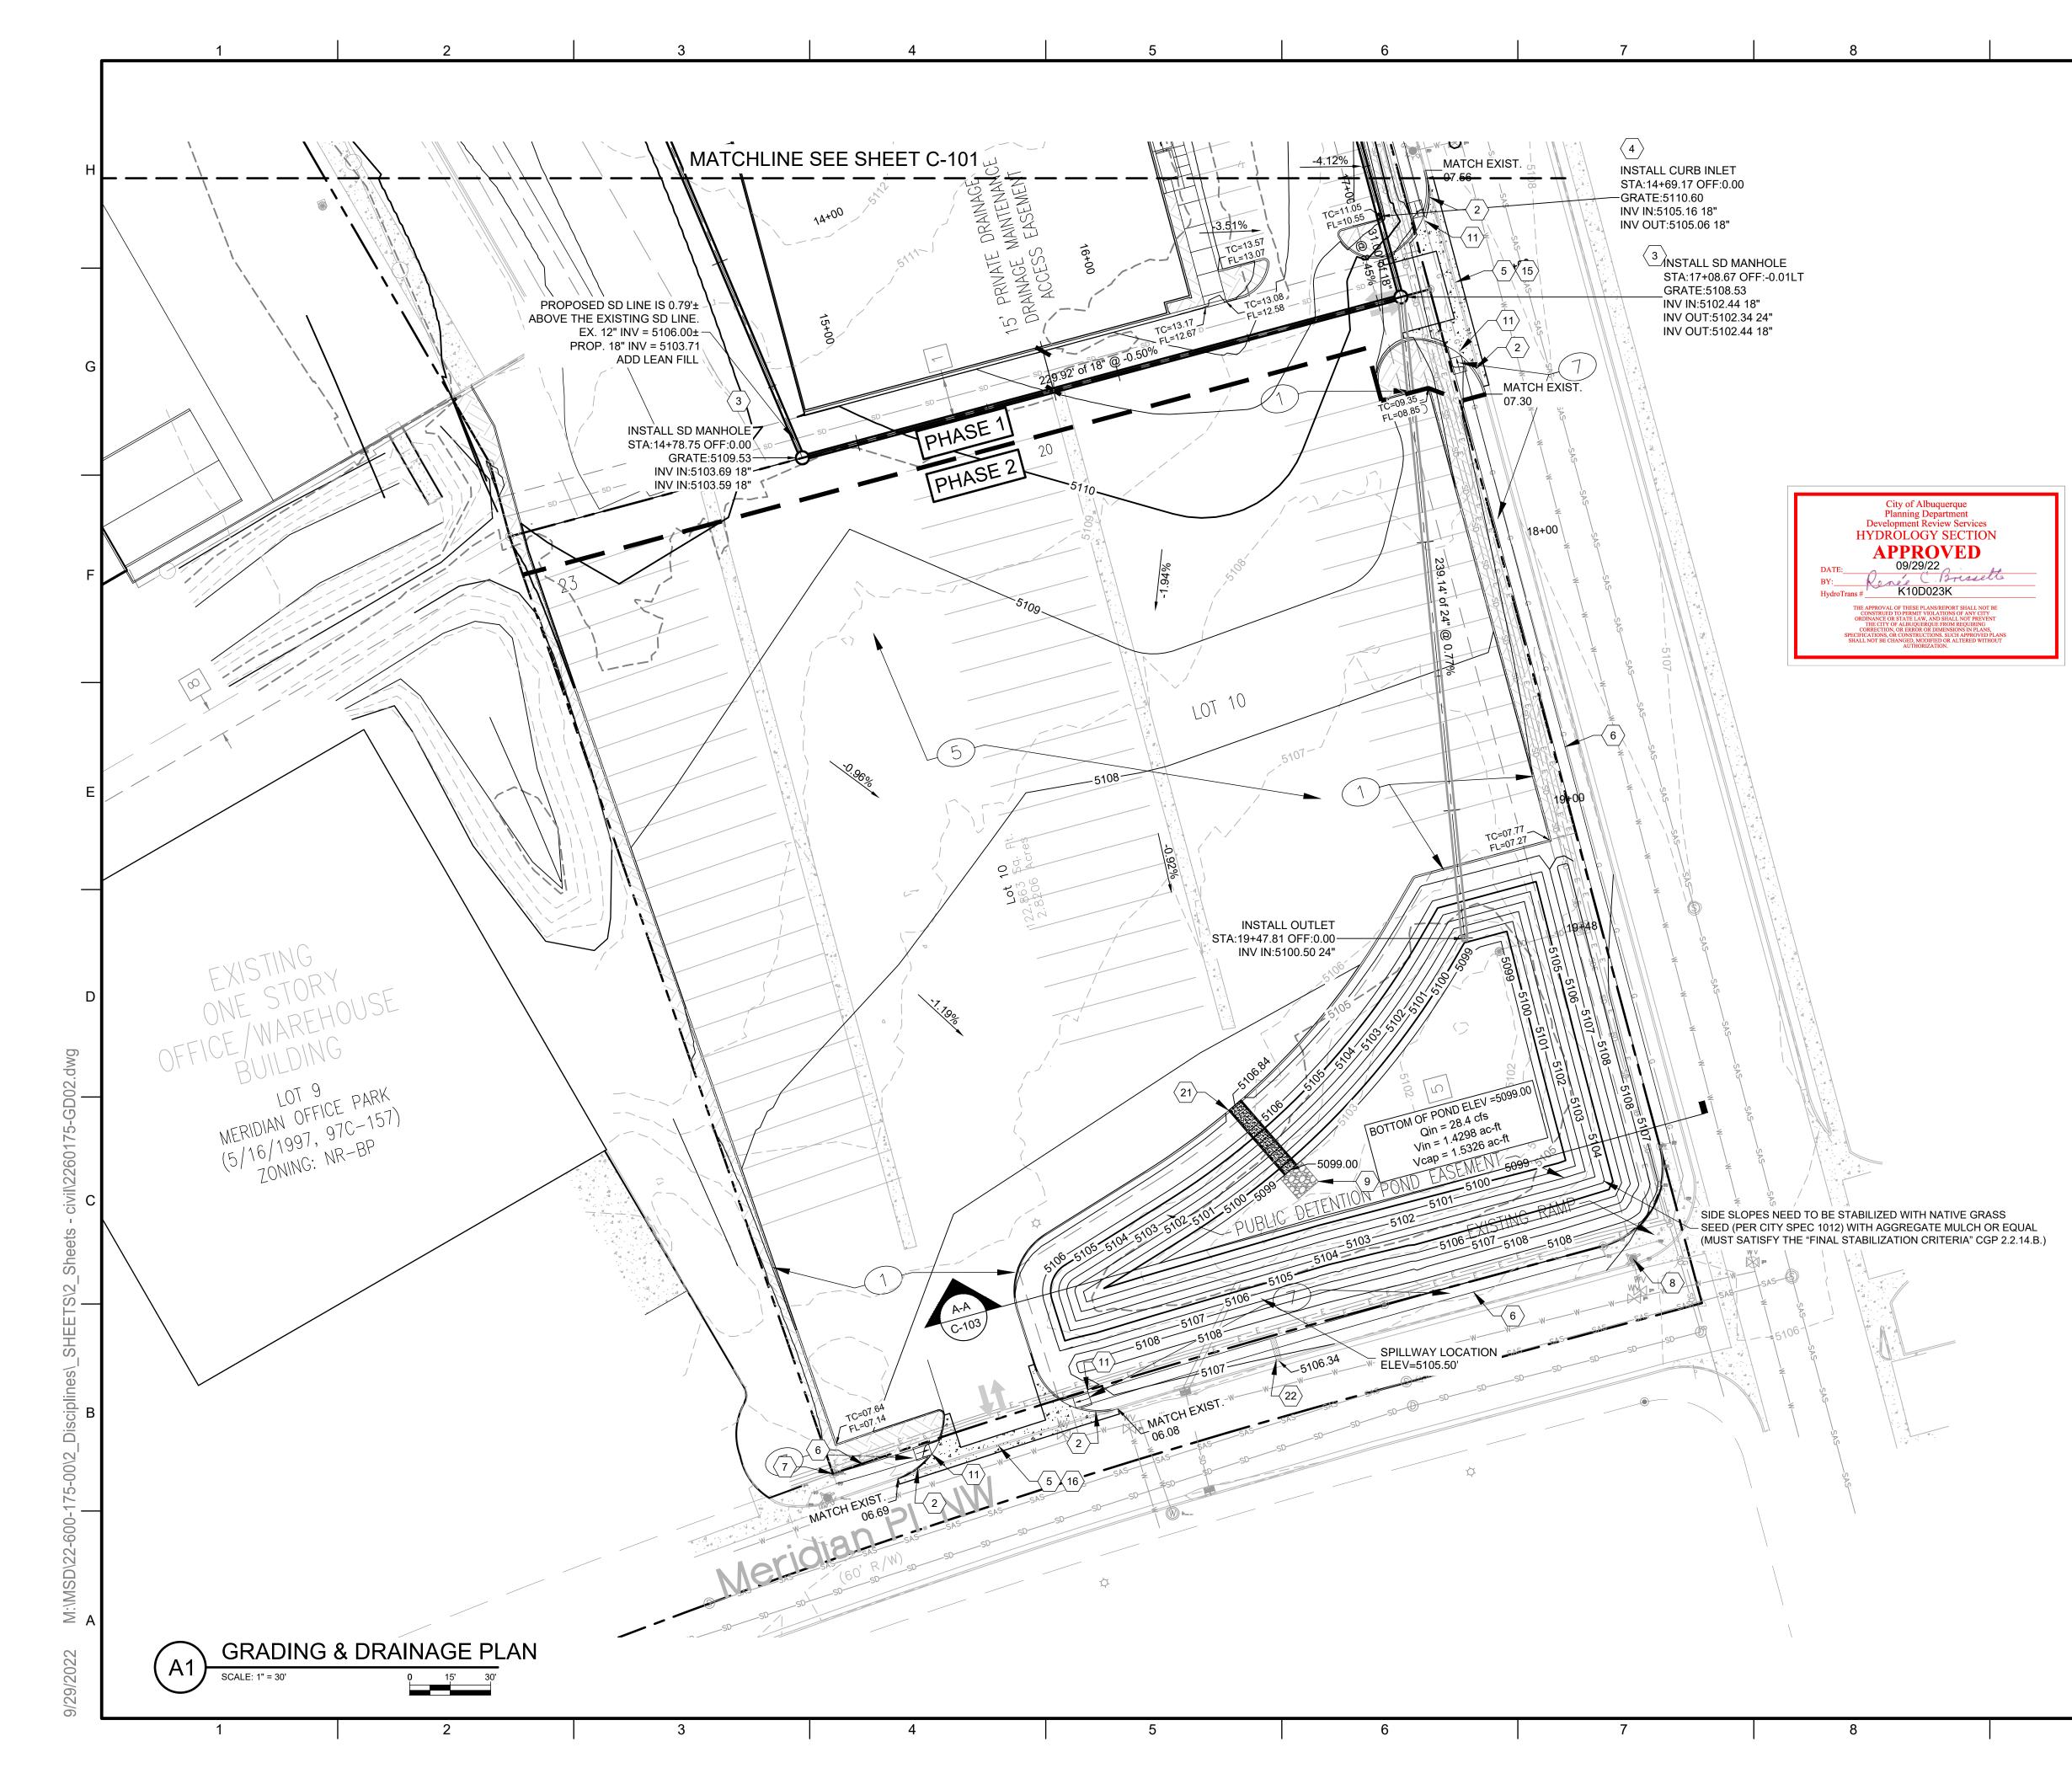

<u>9</u>   1RECORI	D DRAWINGS
GENERAL NOTES	
1. SIDEWALK AND CURB RAMPS SHALL COMPLY WITH THE CURRENT REQUIREMENTS OF THE AMERICANS WITH DISABILITIES ACT (ADA). THE CONTRACTOR SHALL CONTACT THE CITY STAFF TO SCHEDULE INSPECTIONS.	Adl Masthead St. NE., SUITE 150 PHONE: 505-348-4000 FAX: 505-348-4000 FAX: 505-348-4055 www.wilsonco.com
	AL AL
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#2415A.	
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3. CONSTRUCT 6' DIA. TYPE "C" MH PER COA STD DWG #2101.	
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5. CONSTRUCT DRIVE PAD PER COA STD DWG #2425.	LTANI
<ol> <li>CONSTRUCT NEW 4" PCC SIDEWALK PER DETAIL SHEET C-103.</li> </ol>	CONSULTANTS
7. MATCH EXIST. SIDEWALK. SAWCUT TO NEAREST JOINT.	ŏ
<ol> <li>EXISTING FIRE HYDRANT TO REMAIN. PROTECT IN PLACE.</li> <li>10'x10' RIP-RAP PAD.</li> </ol>	NES E. CON
<ol> <li>9. TO XTO RIP-RAP PAD.</li> <li>10. CONSTRUCT ADA RAMP DETAIL "A" PER COA STD DWG #2443.</li> </ol>	
11. CONSTRUCT ADA RAMP DETAIL "C" PER COA STD DWG #2443.	HNFE 9 59122 S
12. CONSTRUCT MODIFIED ADA RAMP DETAIL "A" PER COA STD DWG #2443.	S
13. SLOPE NOT TO EXCEED 2% IN ANY DIRECTION.	121 V 121
14. ENTRANCE "A" ELEVATIONS PER SHEET C-103.	NV NV NV
<ul><li>15. ENTRANCE "B" ELEVATIONS PER SHEET C-103.</li><li>16. ENTRANCE "C" ELEVATIONS PER SHEET C-103.</li></ul>	
17. ENTRANCE "D" ELEVATIONS PER SHEET C-103.	
18. ADA RAMP "E" ELEVATIONS PER SHEET C-103.	
19. ADA RAMP "F" ELEVATIONS PER SHEET C-103.	
20. ADA RAMP "G" ELEVATIONS PER SHEET C-103.	
21. 5-FOOT CONCRETE RUNDOWN.	
22. DRAINAGE SIDEWALK CULVERT WITH STEEL PLATE TOP PER COA STD DWG #2236.	CT NAME EVO BA1A LBUC
Private Drainage Facilities with City Right-of-Way Notice to Contractor	
(Special Order 19 ~ "SO-19) 1. Build sidewalk culvert per COA STD DWG 2236. Work is	DESCRIPTION
<ol> <li>Duild sidewalk curvert per COA STD DWG 2250. Work is permitted and inspected by DMD Construction Services Division.</li> <li>An Excavation permit will be required before beginning any work</li> </ol>	
<ul><li>with City Right-Of-Way.</li><li>3. All work on this project shall be performed in accordance with</li></ul>	
<ul><li>applicable federal, state and local laws, rules and regulations concerning construction safety and health.</li><li>4. Prior to any excavation, the contractor must contact New Mexico</li></ul>	
<b>One Call, dial "811"</b> [or (505) 260-1990] for the location of existing utilities.	DATE
5. Prior to construction, the contractor shall excavate and verify the locations of all obstructions. Should a conflict exist, the	DA
<ul><li>contractor shall notify the engineer so that the conflict can be resolved with a minimum amount of delay.</li><li>6. Backfill compaction shall be 95%.</li></ul>	
<ol><li>Maintenance of the facility shall be the responsibility of the owner of the property being served.</li></ol>	REV.
<ol> <li>8. Work on arterial streets may be required on a 24-hour basis.</li> <li>9. For excavation an barricading inspections, contact DMD Construction Services Division.</li> </ol>	PROJECT NO:22-600-175-00DESIGNED BY:JEL
	DRAWN BY: DY CHECKED BY: JEL
	DATE: JUNE 2022
	SHEET TITLE
	GRADING &
	DRAINAGE PLAN
	SHEET NO:
	C-102



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		CONSULTANTS
		MES E. CONN PROFESSIONAL ENSIGNATION 20
		PROJECT NAME NEW OFFICE/WAREHOUSE FOR BRUNACINI DEVELOPMENT 541 AIRPORT DRIVE, NW ALBUQUERQUE, NM 87121
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✓ WSE = 5105.44		DESCRIPTION
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OF POND = 5099.00		DATE
CTION A-A LE: 1" = 10'		REV.
Planning Development HYDROLC APPP DATE: 099/2 BY:	Albuquerque 3 Department 4 Review Services <b>OGY SECTION</b> <b>29/22</b> 29/22 C Brutte DD023K SPLANS/REPORT SHALL NOT BE FLANS/REPORT SHALL NOT BE FLANS/REPORT SHALL NOT BE IT VIOLATIONS OF ANY CITY AW, AND SHALL NOT PREVENT UEQTUE FRAM REQUIRINGS RI ORD INMENSIONS IN PLANS, WOLFITCHS. SUCH APPROVED PLANS WOLFITCHS.	PROJECT NO: 22-600-175-00 DESIGNED BY: JEL DRAWN BY: DY CHECKED BY: JEL DATE: JUNE 2022 SHEET TITLE GRADING & DRAINAGE DETAILS
		SHEET NO: C-103