

SCANNED BY PLANNING

# Golf Course Marketplace

# STREET IMPROVEMENTS

# CITY OF ALBUQUERQUE NEW MEXICO January 2006

### INDEX TO DRAWINGS

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201 3rd Street NW

OSP Engineering

MC: HQL11A22

5221 North O'Connor

Irving, Texas 75039

**GENUITY** 

(Bank of Alb), Suite 700

Albuquerque, NM 87102

- 1 TITLE SHEET
- 2 PLAT
- 3 GRADING PLAN A
- 4 GRADING PLAN B
- 5 GRADING PLAN C
- 6 DEMOLITION PLAN
- 7 IMPROVEMENT PLAN
- 8 STRIPING PLAN

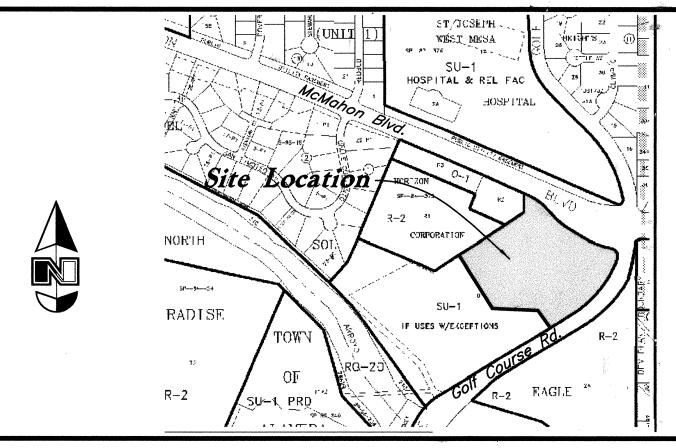
APPROVED AS RECORD DRAWINGS DESIGN REVIEW SECTION CITY CONSTRUCTION ENGINEER Pal Olm DATE: 10-09-2008

# Record Drawing

, Bret G. Wahlen, of the fim Great Basin Engineering — South, a registered professional engineer in the State of New Mexico, do hereby certify, to the best of my knowledge and belief, that the infrastructure installed as part of this project has been inspected by me or by a qualified person under my direct supervision and has been constructed accordance with the plans approved by the City Engineer and that the original design intent of the approved plans have been met, except as noted by me on the As-Built construction drawings. The certification based on site inspections by me or personnel under my direction. Survey infromation provided by Ronald L. Hibdon, NMPLS No. 7438, of the firm R2H and Associates.



Golf Course Road & McMahon Boulevard Albuquerque, New Mexico



### VICINITY MAP

### Zone Atlas Page: A-12-Z

### NOTICE TO CONTRACTORS

- ALL WORK DETAILED ON THESE PLANS TO BE PERFORMED UNDER CONTRACT SHALL, EXCEPT AS OTHERWISE STATED OR PROVIDED FOR HEREON, BE CONSTRUCTED IN ACCORDANCE WITH THE CITY OF ALBUQUERQUE STANDARD SPECIFICATIONS FOR PUBLIC WORK'S CONSTRUCTION, 1986 EDITION (UPDATE #7) INCLUDING AMENDMENT
- 2. TWO WORKING DAYS PRIOR TO ANY EXCAVATION, THE CONTRACTOR MUST CONTACT NEW MEXICO ONE CALL SYSTEM (260-1990) FOR LOCATION OF EXISTING UTILITIES.
- 3. ANY WORK AFFECTING AN ARTERIAL ROADWAY REQUIRES 24-HOUR CONSTRUCTION.
- 4. PRIOR TO CONSTRUCTION, THE CONTRACTOR SHALL EXCAVATE AND VERIFY THE HORIZONTAL AND VERTICAL LOCATIONS OF ALL OBSTRUCTIONS. SHOULD A CONFLICT EXIST, THE CONTRACTOR SHALL NOTIFY THE ENGINEER OR SURVEYOR IMMEDIATELY SO THAT THE CONFLICT CAN BE RESOLVED WITH A MINIMUM AMOUNT OF DELAY.
- 5. FIVE (5) WORKING DAYS PRIOR TO BEGINNING OF CONSTRUCTION, THE CONTRACTOR SHALL SUBMIT TO CONSTRUCTION COORDINATIONS DIVISION A DETAILED CONSTRUCTION SCHEDULE. TWO (2) WORKING DAYS PRIOR TO CONSTRUCTION, THE CONSTRUCTOR SHALL OBTAIN A BARRICADING PERMIT FROM THE CONST. COORDINATION DIVISION. CONTRACTOR SHALL NOTIFY BARRICADE ENGINEER (924-3400) PRIOR TO OCCUPYING AN INTERSECTION. REFER TO SECTION 19 OF THE STANDARD SPECIFICATIONS.
- 6. ALL STREET STRIPING ALTERED OR DESTROYED SHALL BE REPLACED WITH PLASTIC REFLECTORIZED PAVEMENT MARKINGS BY THE CONTRACTOR TO LOCATION AS EXISTING OR AS INDICATED BY THIS PLAN.
- 7. CONTRACTOR SHALL NOTIFY THE ENGINEER NOT LESS THAN SEVEN (7) DAYS PRIOR TO STARTING WORK IN ORDER THAT THE ENGINEER MAY TAKE NECESSARY MEASURES TO INSURE THE PRESERVATION OF SURVEY MONUMENTS. CONTRACTOR SHALL NOT DISTURB PERMANENT SURVEY MONUMENTS WITHOUT THE CONSENT OF THE ENGINEER AND SHALL NOTIFY THE ENGINEER AND BEAR THE EXPENSE OF REPLACING ANY THAT MAY BE DISTURBED WITHOUT PERMISSION. REPLACEMENT SHALL BE DONE ONLY BY THE CITY SURVEYOR. WHEN A CHANGE IS MADE IN THE FINISHED ELEVATIONS OF THE PAVEMENT OF ANY ROADWAY IN WHICH A PERMANENT SURVEY MONUMENT IS LOCATED, CONTRACTOR SHALL, AT HIS OWN EXPENSE, ADJUST THE MONUMENT COVER TO THE NEW GRADE UNLESS OTHERWISE SPECIFIED. REFER TO SECTION 4.4 OF THE GENERAL CONDITIONS OF THE STANDARD SPECIFICATIONS. ANY PERMANENT SURVEY MONUMENT LOCATED WITHIN 50' OF THIS PROJECT THAT IS NOT SHOWN ON THE PLAN AND IS DESTROYED DURING CONSTRUCTION WILL BE REPLACED AT THE DESIGNERS
- 8. FOR STORM DRAIN CONSTRUCTION, RCP PIPE JOINTS SHALL NOT BE GROUTED PRIOR TO FINAL INSPECTION. FINAL INSPECTION WILL DETERMINE JOINTS TO BE GROUTED FOR FINAL ACCEPTANCE OF THE CONSTRUCTION.
- 9. CONTRACTOR SHALL MAINTAIN A GRAFFITI FREE WORK SITE. CONTRACTOR SHALL PROMPTLY REMOVE ANY AND ALL GRAFFITI FROM EQUIPMENT, WHETHER PERMANENT OR TEMPORARY.
- 10. ALL EXCAVATION, TRENCHING, AND SHORING ACTIVITIES MUST BE CARRIED-OUT IN ACCORDANCE WITH OSHA
- 11. THE CONTRACTOR WILL BE RESPONSIBLE FOR DISPOSING OF ALL DEBRIS, INCLUDING, NOT LIMITED TO HAZARDOUS WASTE AT DISPOSAL SITES APPROVED BY GOVERNMENTAL AGENCIES REGULATING THE DISPOSAL
- 12. PERMANENT PAVING STRIPING AND MARKINGS WILL BE PLACED BY THE CONTRACTOR. THE ROAD SHALL NOT BE OPENED TO THE TRAFFIC UNTIL IT IS STRIPED. ALL STRIPING, PAVEMENT MARKINGS INCLUDING CROSSWALKS, ARROWS AND LINE MARKINGS ARE TO BE CONSTRUCTED OF HOT PLASTIC OR COLD PLASTIC IN ACCORDANCE WITH THE MANUAL OF UNIFORM TRAFFIC CONTROL DEVICES.
- THE FOLLOWING NOTES ALSO APPLY WHEN CHECKED
- 13. ALL WATER VALVE BOX MANHOLES IN THE STREET CONSTRUCTION ARE TO BE ADJUSTED TO FINISH GRADE AND WILL BE MEASURED AND PAID PER EACH. > CONSTRUCTION 14. CONTRACTOR WILL BE RESPONSIBLE FOR PROVIDING AND MAINTAINING ALL SIGNING UNTIL PROJECT HAS BEEN
- ACCEPTED BY THE CITY. THE FOLLOWING NOTES ALSO APPLY WHEN CHECKED ALL UTILITIES AND UTILITY SERVICE LINES SHALL BE INSTALLED

PRIOR TO PAVING BACKFILL COMPACTION SHALL BE ACCORDING TO SPECIFIED STREET USE.

SIDEWALKS AND WHEELCHAIR RAMPS WITHIN THE CURB RETURNS SHALL BE CONSTRUCTED WHEREVER A NEW CURB RETURN IS CONSTRUCTED.

ALL STORM DRAINAGE FACILITIES SHALL BE COMPLETED PRIOR TO FINAL ACCEPTANCE.

TACK COAT REQUIREMENTS SHALL BE DETERMINED BY THE ENGINEER.



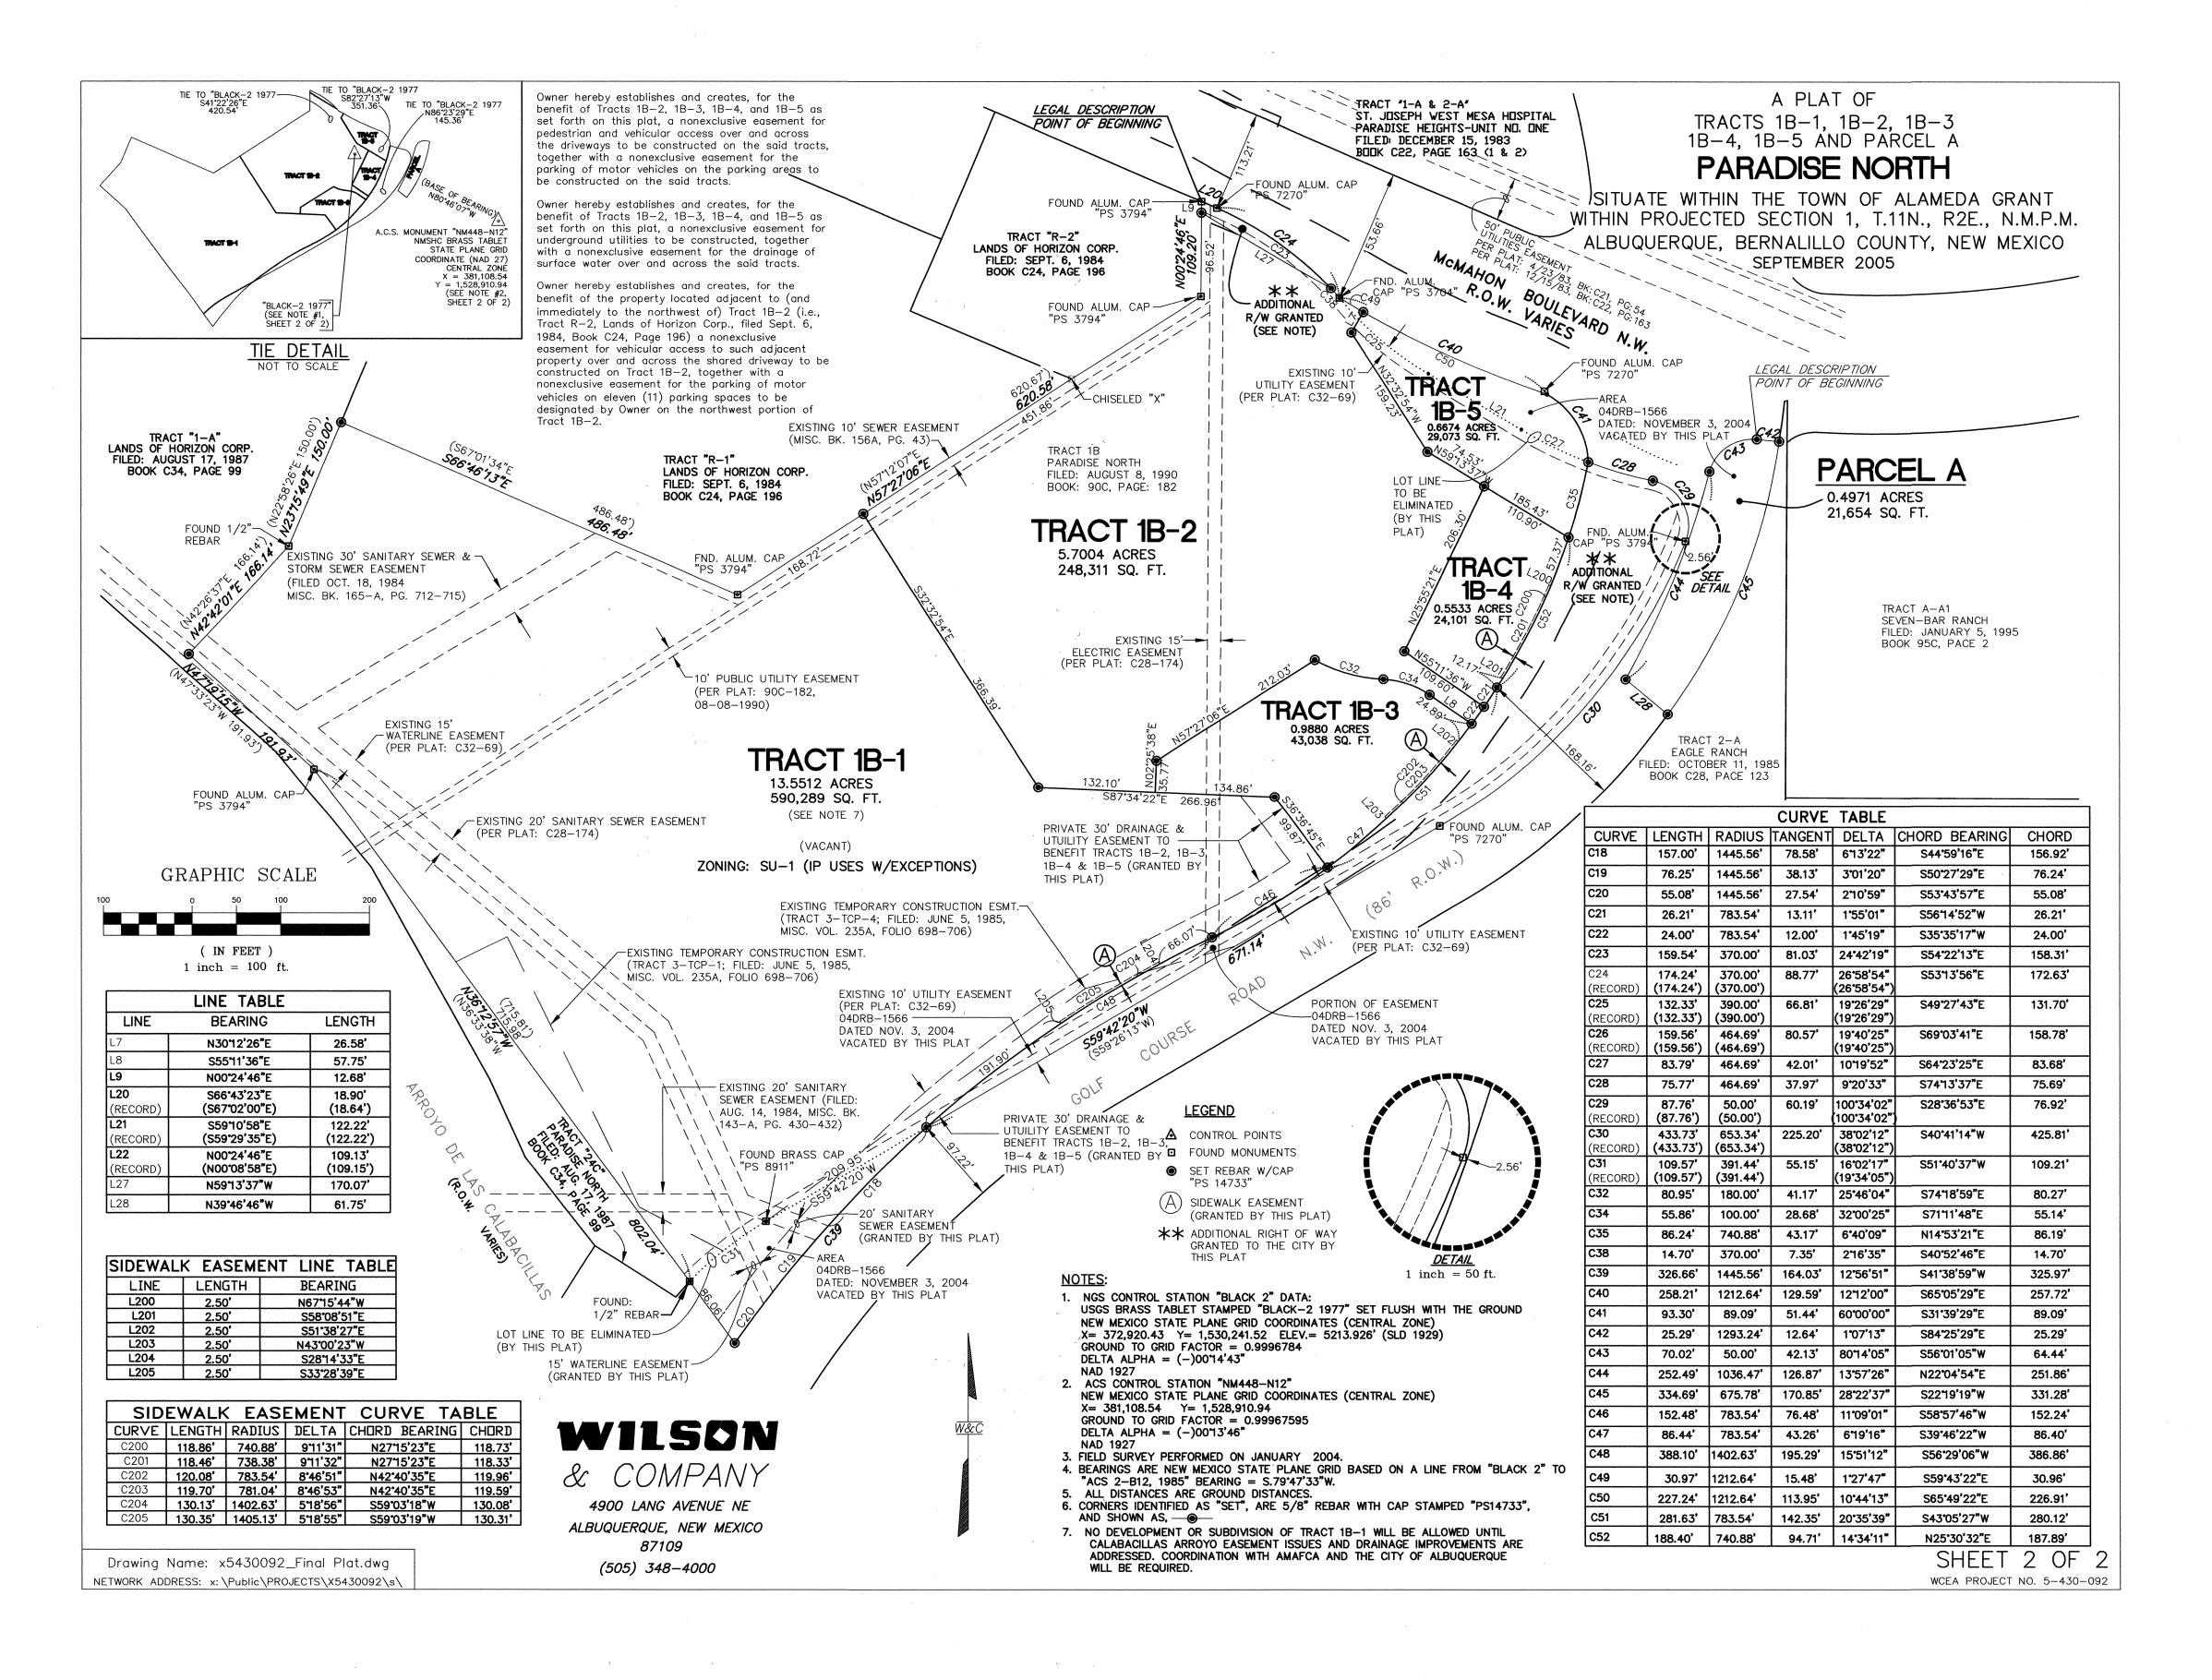
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Constr. Mngmt. Constr. Coord. CITY PROJECT NO.

City Engineer

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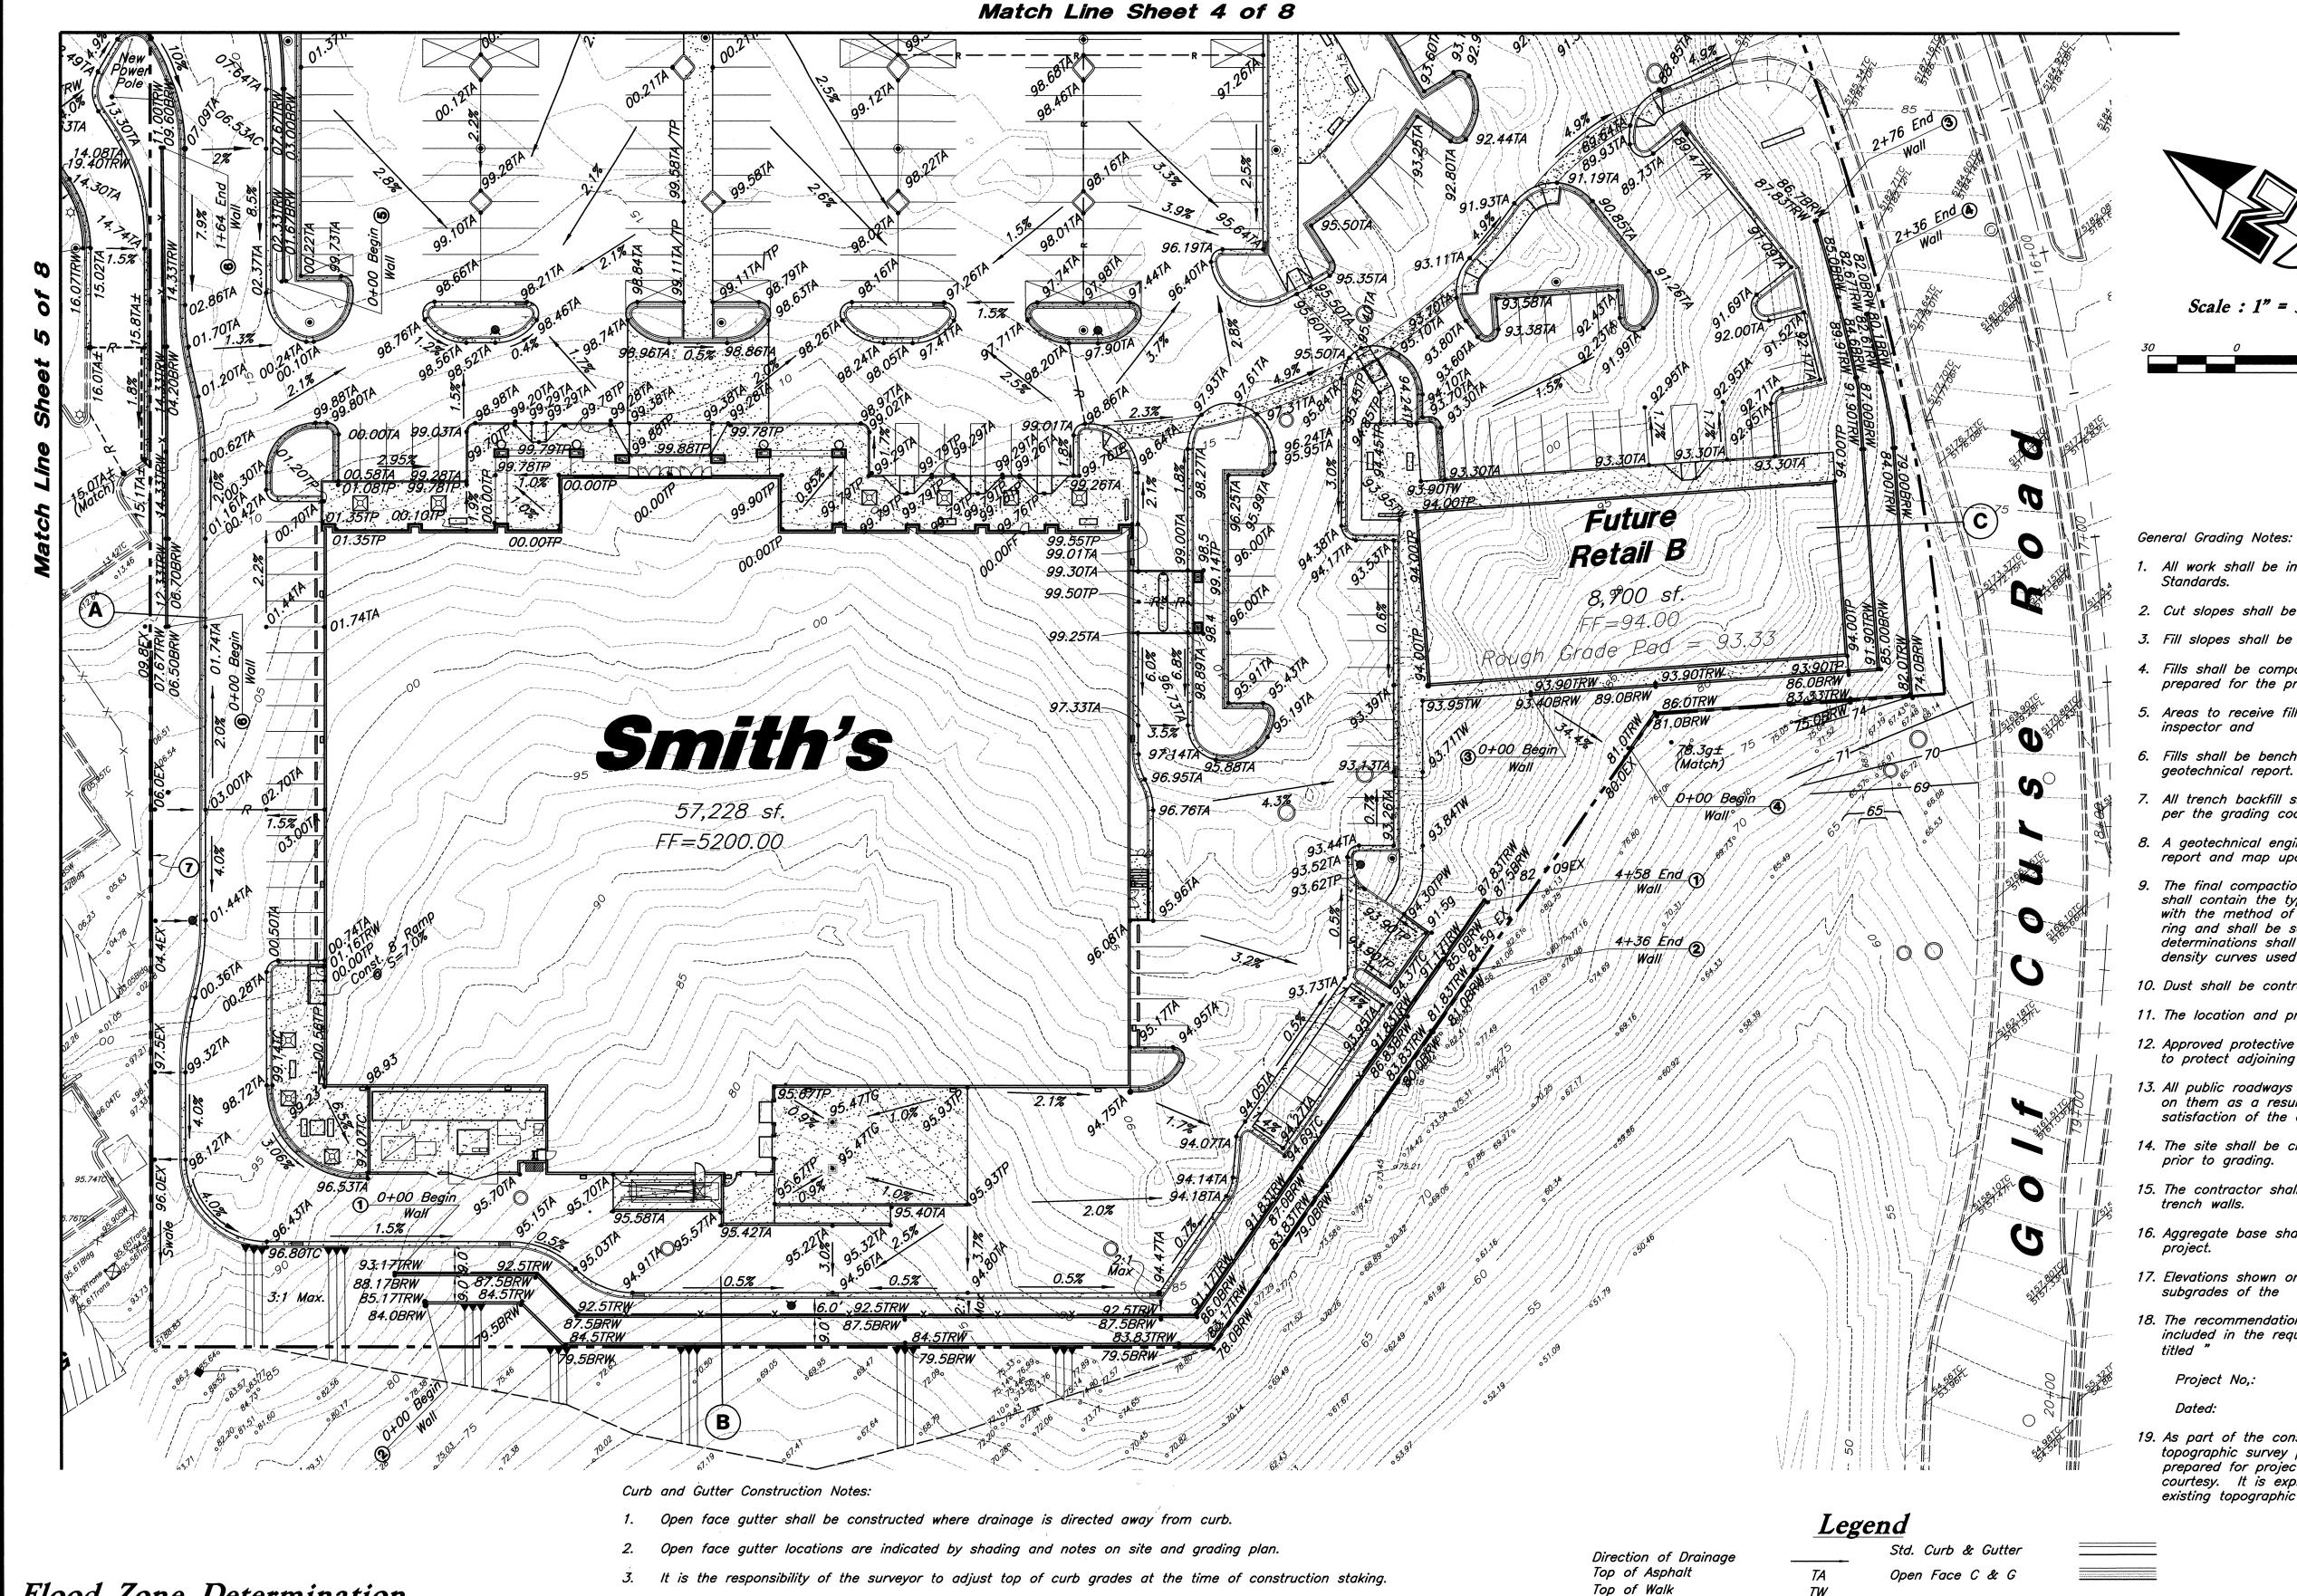


FOOD & DRUG STORES

#463

Golf Course Road & McMahon Boulevard Albuquerque, New Mexico

	AS BUILT									
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### Flood Zone Determination

The subject property (as shown hereon) lies within Zone "X" (areas determined to be outside 0.2 accordance with the National Flood Insurance Program Rate Map No. 35001C0108 E, Effective Date 11-19-03.

### Notice to Contractors

- An excavation/construction permit will be required before beginning any work within city right—of way. An approved copy of these plans must be submitted at the time of application for this permit.
- All work detailed on these plans to be performed, except as otherwise stated or provided hereon, shall be constructed in accordance with City of Albuquerque interim standard specifications for public works construction, 1986.
- Two working days prior to any excavation, contractor must contact New Mexico One Call System, 260–1990, for location of existing utilities.

- Refer to the typical details for a standard and open face curb and gutter for dimensions.
- Transitions between open face and standard curb and gutter are to be smooth. Hand Form these areas

# Erosion Control Plan and Pollution Prevention Notes:

- Contractor is responsible for obtaining a topsoil disturbance permit prior to beginning work.
- Contractor is responsible for cleaning all sediment out of existing right-of-way.
- Contractor is responsible for maintaining all storm run off
- Repair of damaged facilities and cleanup of sediment accumulation on adjacent properties and in public facilities is the responsibility of the contractor.
- 5. All exposed earth surfaces must be protected from wind and water erosion prior to final acceptance of any project.

### Legal Description

That certain parcel of land situate within the Town of Alameda Grant in projected Section 1, Township 11 North, Range 2 East, New Mexico Principal Meridian, City of Albuquerque, Bernalillo County, New Mexico, comprising a Northerly portion of Tract 1-B, Paradise North as the same is shown and designated on the plat entitled "VACATION AND REPLAT OF PARADISE NORTH SITUATE WITHIN THE TOWN OF ALBUQUERQUE GRANT IN PROJECTED SECTIONS 1.2 11 & 12. T 11 N. R 2 E. N.M.P.M., CITY OF ALBUQUERQUE, BERNALILLO COUNTY, NEW MEXICO" filed in the office of the County Clerk of Bernalillo County, New Mexico, on August 17, 1985, in Volume C34, Folio 99.

Edge of Asphalt

Top of Curb

Ridge line

Ground

Top of Grate

Top of Pavement

Flowline

Finish Grade -Top of Retaining Wall Finish Grade -Bottom of Retaining Wall Existing 5' Contour Existing 1' Contour

FOOD & DRUG STORES #463

Golf Course Road & McMahon Boulevard Albuquerque, New Mexico



1. All work shall be in accordance with the City of Albuquerque Public Works

Key Map

- 2. Cut slopes shall be no steeper than 2 horizontal to 1 vertical.
- 3. Fill slopes shall be no steeper than 2 horizontal to 1 vertical.
- 4. Fills shall be compacted per the recommendations of the geotechnical report prepared for the project and shall be certified by the geotechnical engineer.
- 5. Areas to receive fill shall be properly prepared and approved by the City inspector and Geotechnical Engineer prior to placing fill.
- 6. Fills shall be benched into competent material as per specifications and geotechnical report.
- 7. All trench backfill shall be tested and certified by the site geotechnical engineer per the grading code.
- 8. A geotechnical engineer shall perform periodic inspections and submit a complete report and map upon completion of the rough grading.
- 9. The final compaction report and certification from the geotechnical engineer shall contain the type of field testing performed. Each test shall be identified with the method of obtaining the in-place density, whether sand cone or drive ring and shall be so noted for each test. Sufficient maximum density determinations shall be performed to verify the accuracy of the maximum density curves used by the field technician.
- 10. Dust shall be controlled by watering.
- 11. The location and protection of all utilities is the responsibility of the permitee.
- 12. Approved protective measures and temporary drainage provisions must be used to protect adjoining properties during the grading project.
- 13. All public roadways must be cleared daily of all dirt, mud and debris deposited on them as a result of the grading operation. Cleaning is to be done to the satisfaction of the city engineer.
- 14. The site shall be cleared and grubbed of all vegetation and deleterious matter
- 15. The contractor shall provide shoring in accordance with OSHA requirements for
- 16. Aggregate base shall be compacted per the geotechnical report prepared for the
- 17. Elevations shown on this plan are finish grades. Rough grades are the improvements shown hereon.
- 18. The recommendations in the following Geotechnical Engineering Report by are included in the requirements of grading and site preparation. The report is

Project No.

19. As part of the construction documents, owner has provided contractor with a topographic survey performed by manual or aerial means. Such survey was prepared for project design purposed and is provided to the contractor as a courtesy. It is expressly understood that such survey may not accurately reflect existing topographic conditions.

> GREAT BASIN ENGINEERING - SOUTH CONSULTING ENGINEERS and LAND SURVEYORS 2010 North Redwood Road, P.O. Box 16747 Salt Lake City, Utah 84116 Salt Lake City (801)521-8529 Ogden (801)394-7288 Fax (801)521-9551 CITY OF ALBUQUERQUE

PUBLIC WORKS DEPARTMENT ENGINEERING GROUP

Grading Plan A

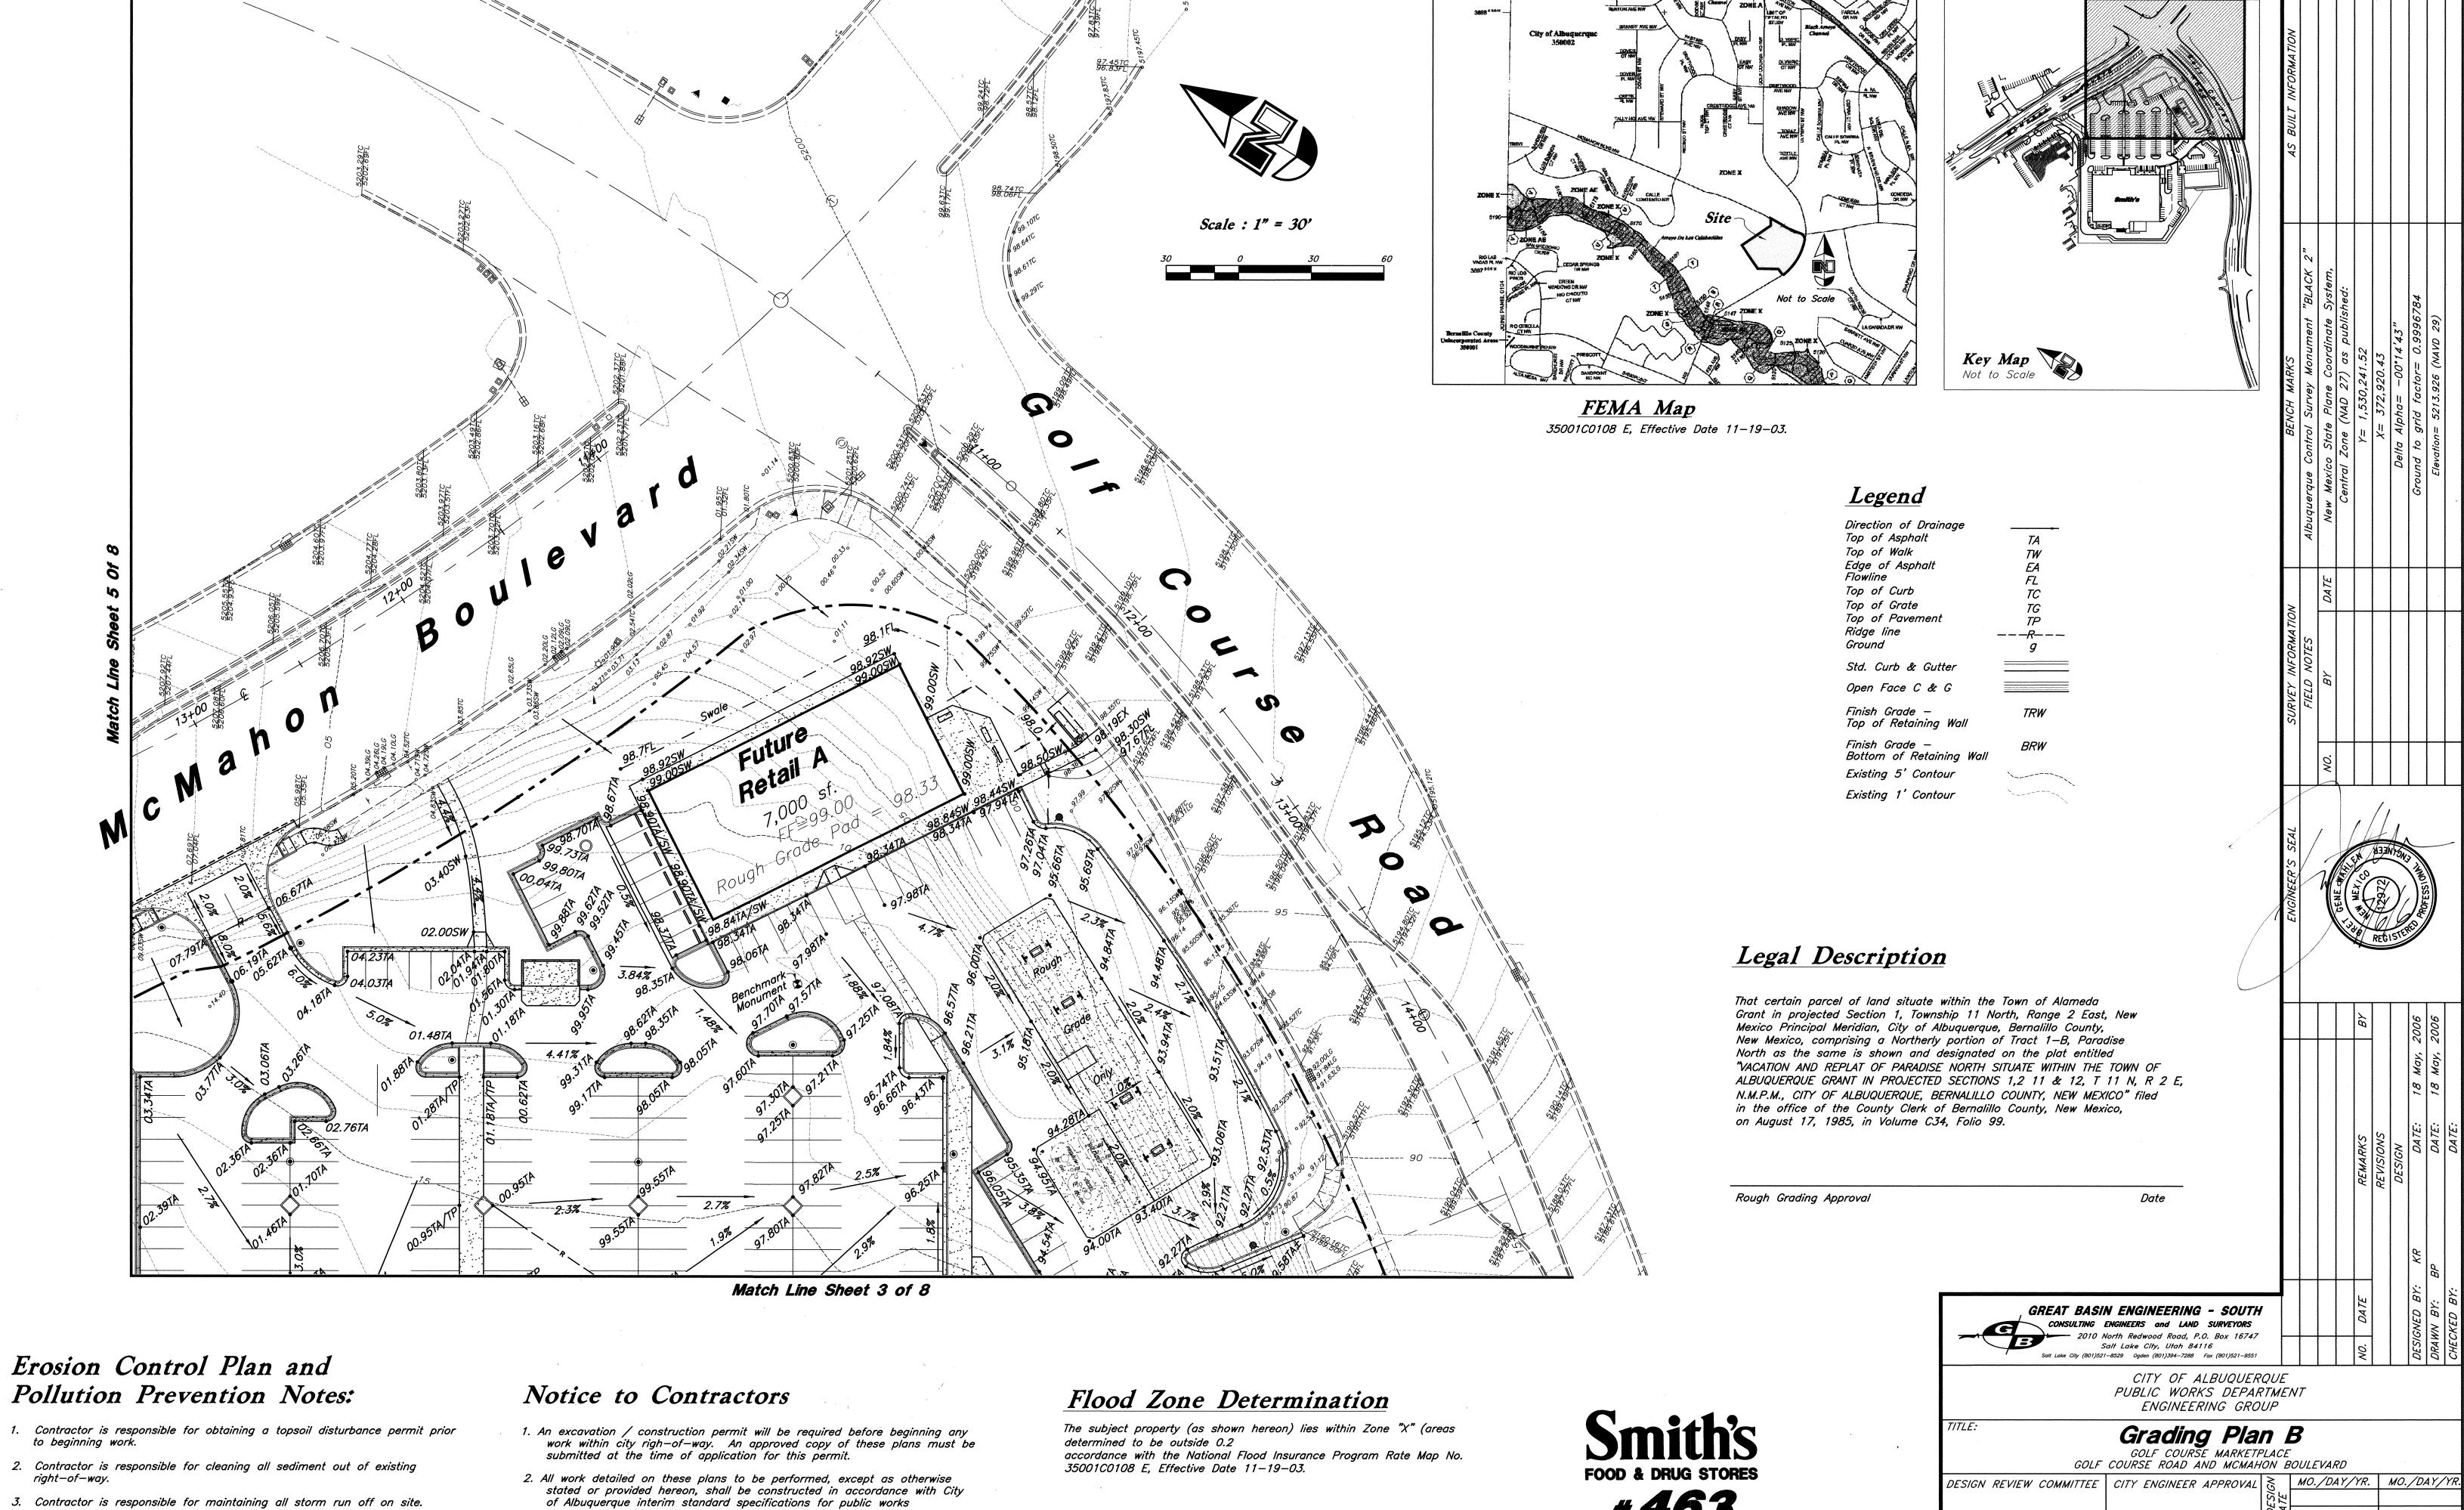
GOLF COURSE MARKETPLACE  GOLF COURSE ROAD AND MCMAHON BOULEVARD									
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5. All exposed earth surfaces must be protected from wind and water erosion prior to final acceptance of any project.

4. Repair of damaged facilities and cleanup of sediment accumulation on adjacent properties and in public facilities is the responsibility of the

- construction, 1986.
- 3. Two working days prior to any excavation, contractor must contact New Mexico One Call System, 260–1990, for location of existing utiliities.

#463

Golf Course Road & McMahon Boulevard Albuquerque, New Mexico

FOR INFORMATION ONLY SHEET NO.

ZONE MAP NO.

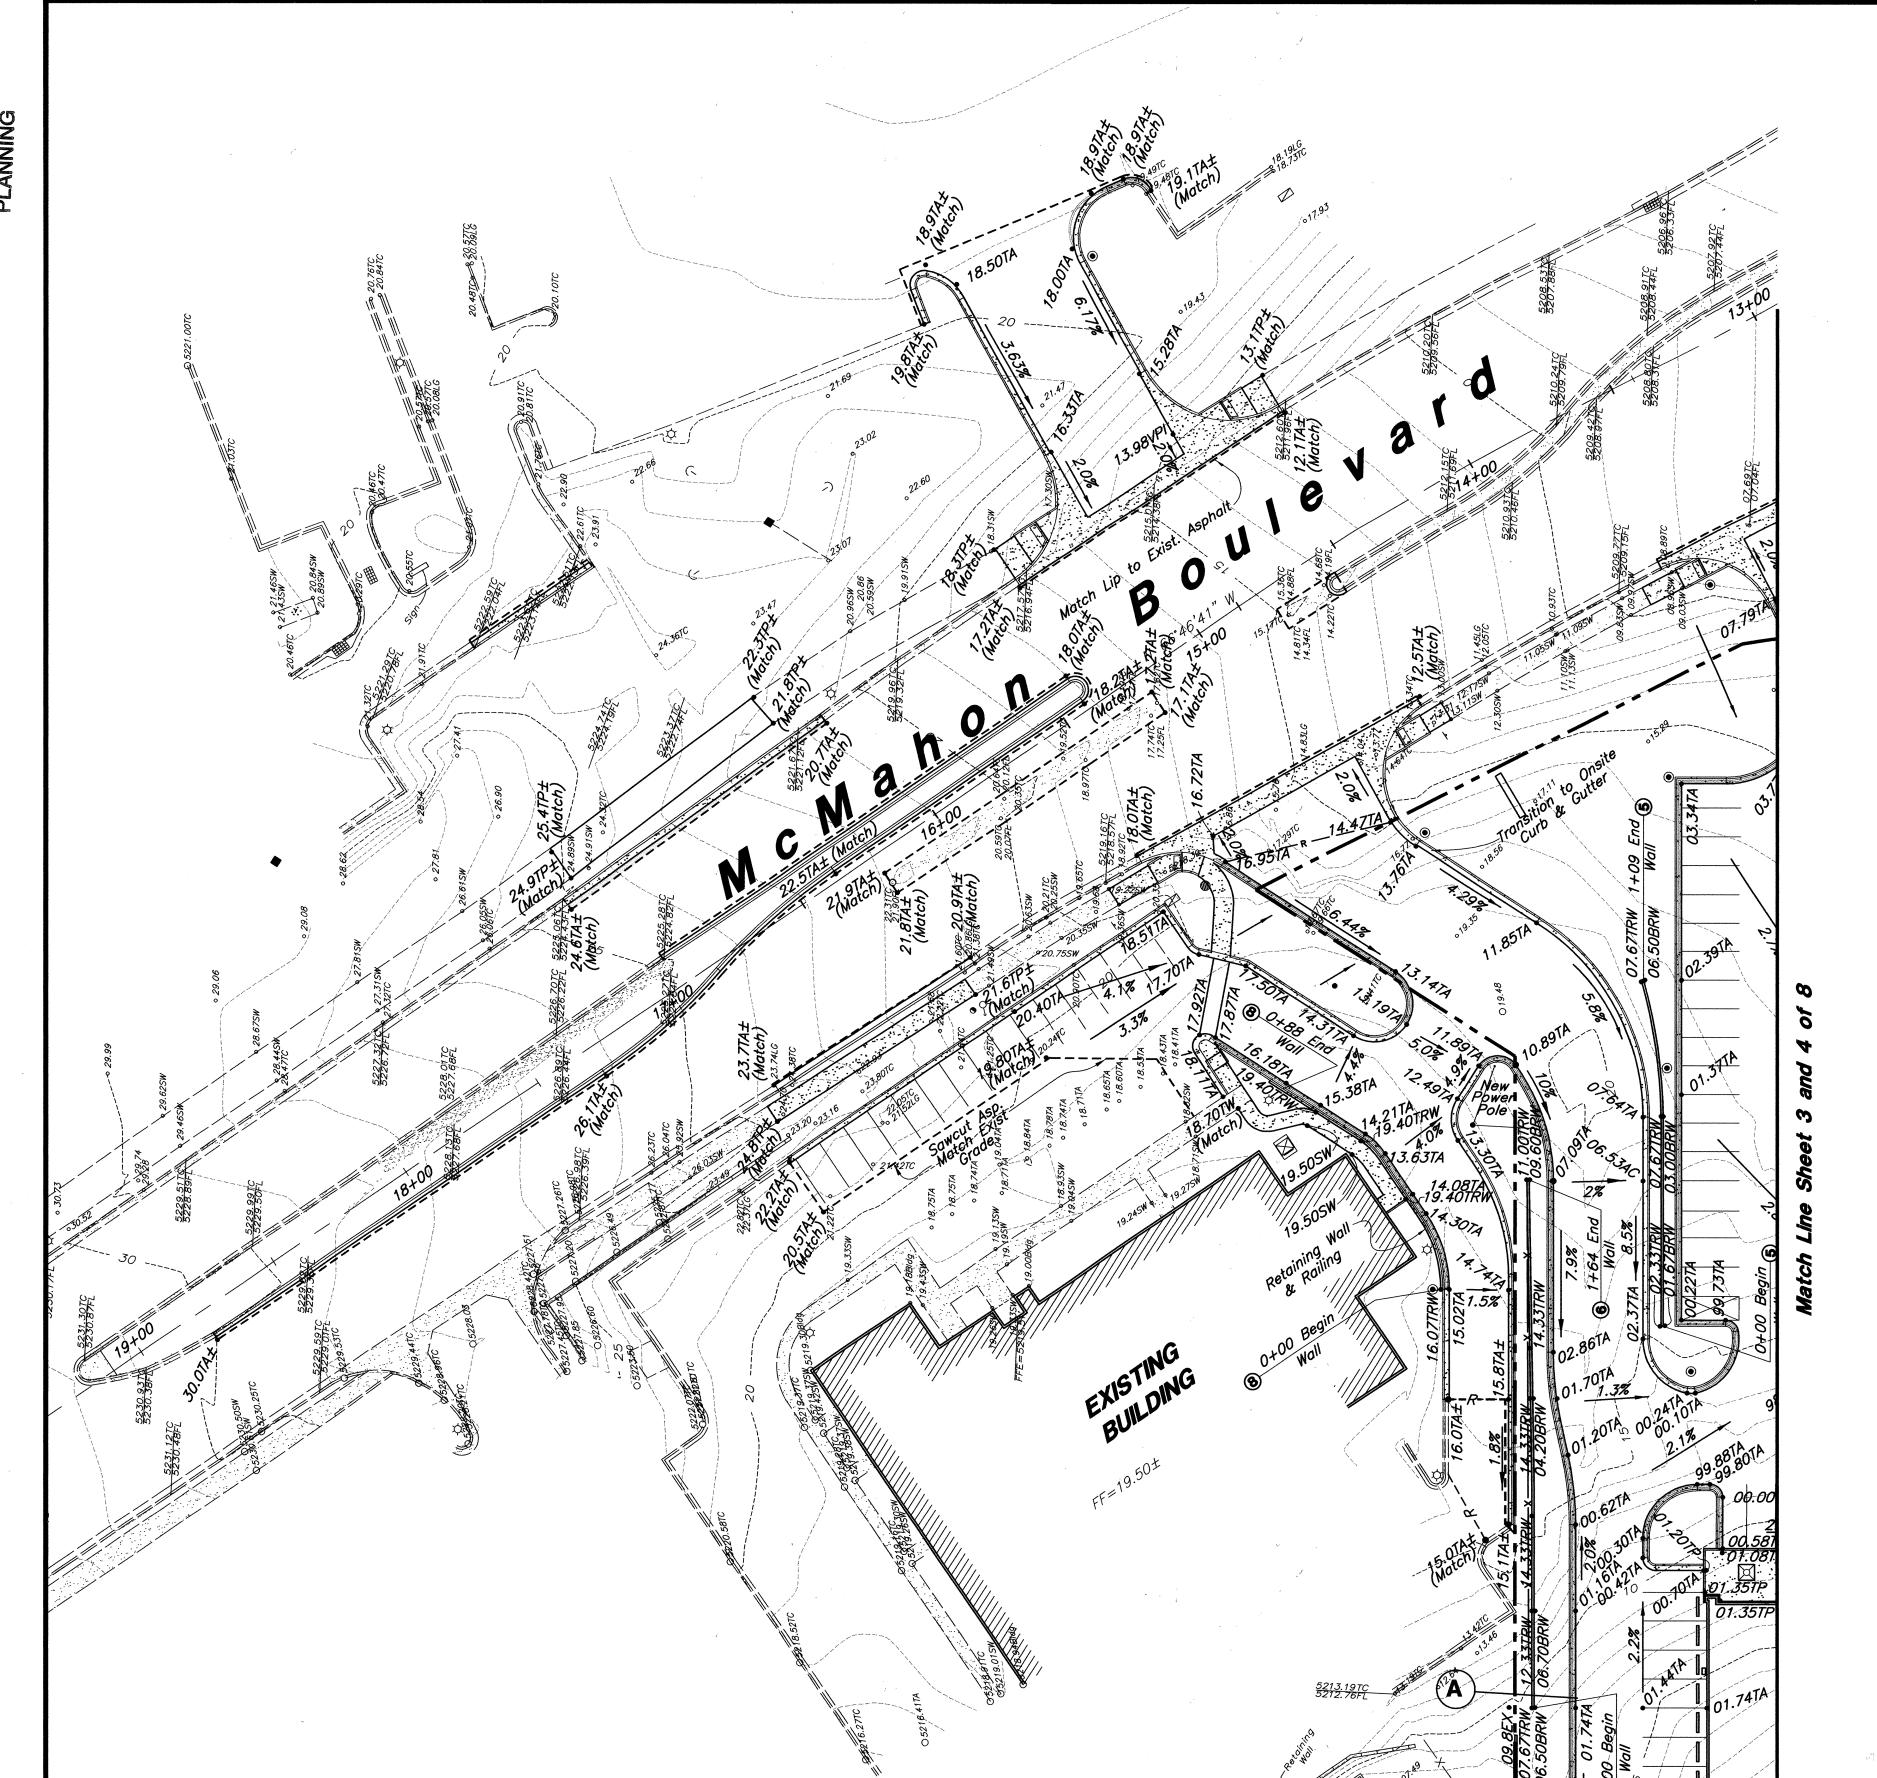
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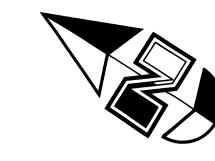
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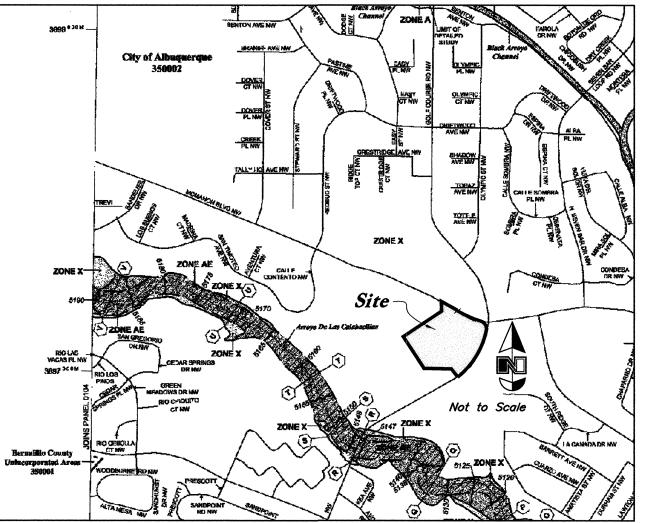
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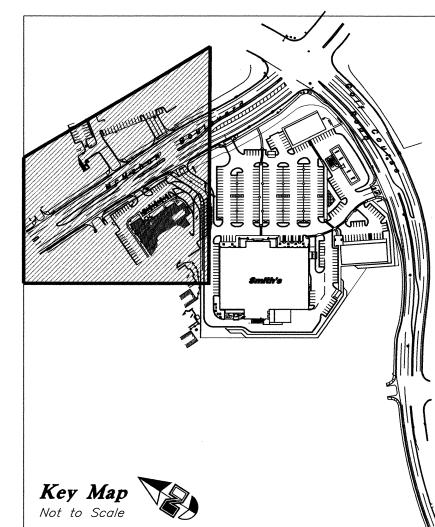




Scale : 1" = 30'

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FEMA Map

35001C0108 E, Effective Date 11-19-03.

### Legend

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Rough Grading Approval

# NO. DATE REMARKS REVISIONS DESIGNED BY: KR DATE: 18 N DRAWN BY: BP

# Erosion Control Plan and Pollution Prevention Notes:

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- 2. Contractor is responsible for cleaning all sediment out of existing right—of—way.
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Smith's FOOD & DRUG STORES # 463

Golf Course Road & McMahon Boulevard Albuquerque, New Mexico

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	l <b>t Lake City, Utah 84116</b> 3529 Ogden (801)394–7288 Fax (801)521–9551			\ \ \ \ \ \ \ \ \ \ \ \ \ \ \ \ \ \ \		DES	DR,	CHI
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are encountered, the surveyor shall immediately notify the

any construction staking.

engineer and resolve the discrepancies before proceeding with

EXISTING SANITARY SEWER MANHOLE =

Golf Course Road & McMahon Boulevard

Albuquerque, New Mexico

DESIGN REVIEW COMMITTEE

781781

CITY PROJECT NO.

SHEET NO.

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ZONE MAP NO.

A-12-Z

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SMC463DRC-SP2

negligence of the owner or the engineer.

