

JULY 2007

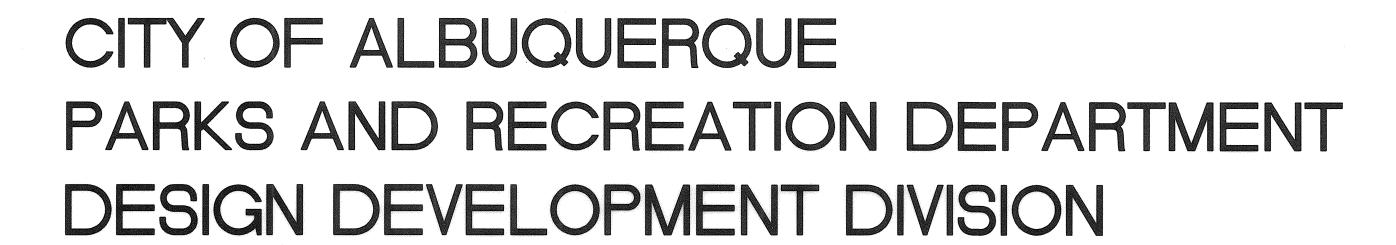

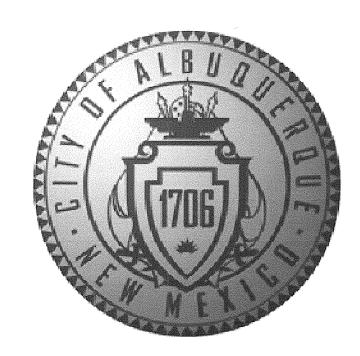

ON-CALL PROTOTYPE MEDIAN AND INTERSTATE LANDSCAPES FY-07A

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NOTE: INDIVIDUAL
MEDIAN PROJECTS WILL
BE IN VARIOUS
LOCATIONS THROUGHOUT
THE CITY — FINAL
LOCATIONS ARE YET TO
BE DETERMINED.

VICINITY MAP

GENERAL NOTES

- AN EXCAVATION/CONSTRUCTION PERMIT WILL BE REQUIRED BEFORE BEGINNING ANY WORK WITHIN CITY RIGHT—OF—WAY.
- ALL WORK DETAILED ON THESE PLANS TO BE PERFORMED UNDER CONTRACT SHALL, EXCEPT AS OTHERWISE STATED OR PROVIDED, FOR HEREON, BE CONSTRUCTED IN ACCORDANCE WITH THE CITY OF ALBUQUERQUE STANDARD SPECIFICATIONS FOR PUBLIC WORKS
- TWO WORKING DAYS PRIOR TO ANY EXCAVATION, THE CONTRACTOR SHALL CONTACT NEW MEXICO ONE CALL SYSTEM (260-1990) FOR LOCATION OF EXISTING UTILITIES.
- PRIOR TO CONSTRUCTION, THE CONTRACTOR SHALL EXCAVATE AND VERIFY THE HORZONTAL AND VERTICAL LOCATIONS OF ALL OBSTRUCTIONS. SHOULD A CONFLICT EXIST, THE CONTRACTOR SHAI NOTIFY THE ENGINEER OR SURVEYOR IMMEDIATELY SO THAT THE CONFLICT CAN BE RESOLVED WITH A MINIMUM AMOUNT OF DELAY.
- FIVE (5) WORKING DAYS PRIOR TO BEGINNING CONSTRUCTION, THE CONTRACTOR SHALL SUBMIT TO CONSTRUCTION COORDINATION DIVISION A DETAILED CONSTRUCTION SCHEDULE. TWO (2) WORKING DAYS PRIOR TO CONSTRUCTION, THE CONTRACTOR SHALL OBTAIN A BARRICADING PERMIT FROM THE CONST. COORDINATION DIVISION. CONTRACTOR SHALL NOTIFY BARRICADE ENGINEER (924–3400) PRIOR TO OCCUPYING AN INTERSECTION. REFER TO SECTION 19 OF THE GENERAL CONDITIONS OF THE STANDARD SPECIFICATIONS.
- ALL STREET STRIPING ALTERED OR DESTROYED SHALL BE REPLACED WITH PLASTIC REFLECTORIZED PAVEMENT MARKING BY CONTRACTOR TO LOCATION AS EXISTING OR AS INDICATED BY THIS PLAN SET.
- CONTRACTOR SHALL COORDINATE WITH WATER SYSTEMS DIVISION (857-8200) SEVEN WORKING DAYS IN ADVANCE OF ANY WORK THAT MAY AFFECT EXISTING PUBLIC WATER OR SEWER UTILITIES. EXISTING VALVES TO BE OPERATED BY CITY PERSONNEL ONLY. CONTRACTOR SHALL CONTACT THE WATER SYSTEMS DIVISION SEVEN DAYS PRIOR TO NEEDING VALVES TURNED ON OR OFF.
- CONTRACTOR SHALL RECORD DATA ON ALL UTILITY LINES AND ACCESSORIES AS REQUIRED BY THE CITY OF ALBUQUERQUE FOR THE PREPARATION OF "AS CONSTRUCTED" DRAWINGS. CONTRACTOR SHALL NOT COVER UTILITY LINES AND ACCESSORIES UNTIL ALL DATA HAS BEEN RECORDED.
- CONTRACTOR SHALL NOTIFY THE ENGINEER NOT LESS THAN SEVEN (7) DAYS PRIOR TO STARTING WORK, IN ORDER THAT THE ENGINEER MAY TAKE NECESSARY MEASURES TO INSURE THE PRESERVATION OF SURVEY MONUMENTS. CONTRACTOR SHALL NOT DISTURB PERMANENT SURVEY MONUMENTS WITHOUT THE CONSENT OF THE ENGINEER AND SHALL NOTIFY THE ENGINEER AND BEAR THE EXPENSE OF REPLACING ANY THAT MAY BE DISTURBED WITHOUT PERMISSION. REPLACEMENT SHALL BE DONE ONLY BY THE CITY OF ALBUQUERQUE SURVEY SECTION. WHEN A CHANGE IS MADE IN THE FINISH ELEVATION OF THE PAVEMENT OF ANY ROADWAY IN WHICH A PERMANENT SURVEY MONUMENT IS LOCATED, CONTRACTOR SHALL, AT HIS OWN EXPENSE, ADJUST THE MONUMENT COVER TO NEW GRADE, UNLESS OTHERWISE SPECIFIED.



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REV.	SHEETS	CITY EN	IGINEER	DATI	E USER DEPARTME	NT	DAT	E	USER	DEPAR	TMENT		DATE
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		_	TRANSPORTATION	ОИ	om	7/1	2/07						
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1 /			PARKS & REC	REATION			4		16	ليوم	<u></u>	7.	16.07
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GENERAL NOTES

- PRIOR TO STARTING CONSTRUCTION, CONTRACTOR SHALL VERIFY THE FOLLOWING WITH THE CITY PROJECT MANAGER:
- EXISTING WATER PRESSURE (SEE IRRIGATION NOTE #13).
- B. ELEVATION DIFFERENCE (SEE IRRIGATION NOTE #13). C. TYPE OF CONTROLLER TO BE INSTALLED.
- D. RESULTS OF SOIL TEST, IF ANY, TO DETERMINE PRESENCE OF SOIL
- STERILANTS. E. RESULTS OF BORING TESTS, IF ANY, TO DETERMINE PRESENCE OF
- SUBSURFACE DEBRIS. REQUIRED CLEAR ZONE AT BACK OF CURB (AREA FREE OF PLANTS AND
- OTHER IMPROVEMENTS) (SEE PLANTING NOTE *6). G. REQUIREMENT FOR CONSTRUCTION OF A DEDICATED PARKING AREA FOR MAINTENANCE VEHICLES. PARKING AREA, IF ANY, SHALL BE PER DETAIL A/3 OR B/3, AS DIRECTED BY THE PROJECT MANAGER.
- PROTOTYPE SELECTION AND LAYOUT.
- TYPE AND COLOR OF MULCH(ES) TO BE INSTALLED.
- TYPE OF PAYING TO BE CONSTRUCTED. OBTAIN A COPY OF THE WORK ORDER PLAN FOR USE IN PREPARATION OF
- RECORD DRAWINGS. L. QUANTITY OF PROJECT SIGNS.
- PRIOR TO STARTING CONSTRUCTION, CONTRACTOR SHALL PERFORM THE FOLLOWING:
- A. ONLY AS REUESTED BY THE OWNER, OBTAIN SOIL SAMPLES TO BE USED FOR TESTING FOR SOIL STERILANTS. EACH SAMPLE SHALL CONSIST OF SOIL TAKEN FROM THREE (3) TEST HOLES, HOLES SHALL BE MAX, 12" DEEP AND 12" DIAMETER SAMPLES SHALL BE SUBMITTED TO A LICENSED SOIL TESTING LAB. TESTS SHALL NOT BE FOR SPECIFIC CHEMICALS, BUT SHALL BE MADE BY SEEDING THE SAMPLE SOIL AND TESTING FOR SUCCESSFUL GERMINATION AND GROWTH.
- B ONLY AS REQUESTED BY THE OWNER, PERFORM POTHOLING TO A DEPTH OF 3' TO DETERMINE PRESENCE OF SUB-SURFACE PAVING OR DEBRIS.
- -1 INCH CONTRACTOR SHALL REMOVE EXISTING SOIL AS REQUIRED TO ENSURE TOP OF PROPOSED MULCH IS THE PURPOSES, BELOW TOP OF CURB. FOR BIDDING PURPOSES, IT SHALL BE ASSUMED THAT EXISTING FINISH GRADE WITHIN A PROTOTYPE POD IS FLUSH WITH TOP OF ADJACENT CURB. SOIL TO BE REMOVED WITHIN A POD THAT IS ABOVE TOP OF CURB SHALL BE REMOVED AND PAID FOR AS A UNIT TO BID ITEM.
- . CONTRACTOR SHALL REMOVE ANY EXISTING DEBRIS AND SUBSURFACE PAYING THAT MAY BE PRESENT TO A THREE FOOT DEPTH BELOW GRADE.
- . SOIL AND DEBRIS REMOVED FROM PROJECT SITE SHALL BE DISPOSED OF IN AN APPROVED WASTE MANAGEMENT SITE.
- . A 4" DEPTH OF MULCH WITH FILTER FABRIC UNDER SHALL BE INSTALLED THROUGHOUT NON-PAYED AREAS OF MEDIANS. FILTER FABRIC SHALL BE MINIMUM FOUR OUNCE WOVERN NEEDLE PUNCHED POLYPROPYLENE. OVERLAP ENDS 3". TURN DOWN EDGES 6". TOP OF MULCH SHALL BE 2" BELOW TOP OF CURB.
- MULCH FOR MEDIANS SHALL BE AS FOLLOWS:
- A. WHERE PLANTING PLANS SPECIFY 'CRUSHER FINES OR GRAVEL MULCH', CRUSHER FINES SHALL BE A WARM-TONE GRAVEL ('BUILDOLOGY BROWN' OR EQUAL) 1/4" MINUS. GRAVEL SHALL BE 3/4"-1" WARM-TONE GRAVEL ('BUILDOLOGY BROWN' OR EQUAL) SUBANGULAR GRAVEL.
- B. WHERE PLANTING PLANS SPECIFY 'COBBLE MULCH', MULCH SHALL BE 2"-4" WARM-TONE ('BUILDOLOGY BROWN' OR EQUAL) COBBLE.
- CONTRACTOR TO VERIFY MULCH TYPE AND COLOR WITH CITY PROJECT MANAGER.
- 3. MEDIAN NOSES SHALL BE PAVED PER DETAIL E/3. MEDIAN NOSE PAVING AND MEDIAN PAYING SHALL BE ONE OF THE FOLLOWING:
- A. STANDARD GRAY, BROOM FINISH CONCRETE
- B. COLORED. BROOM FINISH CONCRETE C. COLORED, STAMPED CONCRETE
- D. SPECIALTY SCORED PATTERN IN STANDARD GREY CONCRETE WITH
- E. SPECIALTY SCORED PATTERN IN COLORED CONCRETE WITH BROOM FINISH PAVING SHALL MATCH EXISTING PAVING IN ADJACENT AREAS, IF
- CONTRACTOR SHALL VERIFY PAVING TYPE AND COLOR WITH CITY PROJECT MANAGER. FOR BIDDING PURPOSES, COLOR SHALL BE DAVIS 'SAN DIEGO BUFF' OR EQUAL, 15 LBS PER 94 LB SACK OF CEMENT. CONCRETE MIX (INCLUDING CONCRETE WITH COLOR) SHALL BE IN ACCORDANCE WITH C.O.A. STANDARD MIX DESIGN AND SHALL BE CERTIFIED BY THE CITY OF ALBUQUERQUE PRIOR TO USE.
-). CONTRACTOR SHALL PAINT MEDIAN NOSE CURBS WITH TWO COATS YELLOW TRAFFIC PAINT TO 4' BEYOND POINT OF CURVATURE.
- 10. BOULDERS SHALL BE 18 CF TO 24 CF MOSS ROCK, GRANITE, OR EQUAL AS APPROVED BY THE CITY PROJECT MANAGER. CINDER BOULDERS WILL NOT BE ACCEPTABLE. BOULDERS SHALL BE INSTALLED PER DETAIL F/3.
- CONTRACTOR SHALL ADJUST EXISTING MANHOLES AND VALVE BOXES TO BE FLUSH WITH TOP OF MULCH OR TOP OF PAVING. CONTRACTOR SHALL FEATHER GRADE AT PULLBOXES AS REQUIRED FOR TOP OF MULCH TO BE FLUSH WITH TOP OF PULLBOX. SEE DETAIL F/4.
- 2. CONTRACTOR SHALL REPLACE ANY DAMAGED EXISTING PULLBOXES AND/OR VALVE BOXES TO REMAIN WITH NEW BOXES AND/OR COVERS AS REQUIRED TO REPLACE DAMAGED MATERIALS.
- 3. CONTRACTOR SHALL PROTECT EXISTING UTILITIES. INCLUDING LOOP DETECTORS. FROM DAMAGE DUE TO CONSTRUCTION OPERATIONS. CONTRACTOR SHALL REPAIR OR REPLACE UTILITIES DAMAGED BY CONSTRUCTION OPERATIONS AT NO ADDITIONAL EXPENSE TO THE OWNER.
- 4. PRIOR TO FINAL PROJECT ACCEPTANCE THE CONTRACTOR SHALL COMPLETE THE FOLLOWING:
- A. INSTALL ONE CONTROLLER CHART IN CONTROLLER ENCLOSURE. SUBMIT TWO CONTROLLER CHARTS TO PARK MANAGEMENT.
- B. HAVE BACKFLOW PREVENTER TESTED, INSPECTED AND TAGGED WITH
- C. PROVIDE A STATEMENT SHOWING THAT THE WATER BILL FOR THE PROJECT HAS BEEN PAID IN FULL BY THE CONTRACTOR.
- D. PROVIDE A BILLING STATEMENT FROM THE ELECTRICAL COMPANY SHOWING THAT THE ELECTRIC BILL FOR THE PROJECT HAS BEEN PAID IN FULL BY THE CONTRACTOR AND TRANSFERRED TO THE CITY.
- E. SUBMIT RECORD (AS-BUILT) DRAWINGS ON AUTOCADD (TWO ELECTRONIC COPIES ON CD AND ONE PAPER COPY) IN ACCORDANCE WITH THE C.O.A. D.P.M. CHAPTER 27.

 1. INCLUDE SQUARE FOOTAGE OF PROJECT.
- . INCLUDE LIST OF PLANTS INSTALLED AND QUANTITY OF EACH.
- 3. INCLUDE WATER METER ADDRESS.
- 4. INCLUDE ANY EASEMENTS THAT MAY HAVE BEEN CREATED FOR THE PROJECT (FOR IRRIGATION COMPONENTS OUTSIDE THE RIGHT-OF-WAY)
- F. PROVIDE KEYS FOR IRRIGATION COMPONENTS TO OWNER.
- 15. CONTRACTOR SHALL ENSURE COMPLIANCE WITH MAXIMUM HEIGHT OF HARD ELEMENTS PER DETAIL C/3.
- 16. CONTRACTOR SHALL ENSURE COMPLIANCE WITH MINUMUM HORIZONTAL CLEARANCE PER DETAIL D/3.
- 1. CONTRACTOR SHALL ENSURE COMPLIANCE WITH CLEAR SIGHT DISTANCES PER DETAILS G/3 AND H/3.
- IS. NEIGHBORHOOD SIGNS, IF ANY, SHALL BE APPROVED BY THE CITY PROJECT
- MANAGER AND PARK MANAGEMENT PRIOR TO MANUFACTURE AND INSTALLATION. 19. PRO RATED CHARGES SHALL BE PAID BY THE OWNER.
- 20. TRAFFIC CONTROL PLANS SHALL BE PER C.O.A. STANDARDS AND MUTCO (MANUAL OF UNIFORM TRAFFIC CONTROL DEVICES). LANE CLOSURES ON INTERSTATES SHALL OCCUR BETWEEN THE HOURS OF 9:00 PM. AND 5:00 AM. ONLY.
- CONTRACTOR SHALL PROVIDE AND IMPLEMENT A STORM WATER PROTECTION PLAN (SWPP) FOR INDIVIDUAL WORK ORDER PROJECTS THAT EXCEED ONE
- 22. CONTRACTOR SHALL OBTAIN A NMDOT PERMIT FOR WORK ON THE INTERSTATE.

IRRIGATION PERFORMANCE CRITERIA AND NOTES

- METER, BACKFLOW PREVENTER, MASTER VALVE, FLOW METER, AND CONTROLLER SHALL BE LOCATED IN THE MEDIAN. LOCATE ADJACENT TO MAINTENANCE VEHICLE PARKING AREA OR NEAR THE NOSE OF THE MEDIAN WHERE A PARKING AREA IS NOT PROVIDED. ELECTRIC METER SHALL BE LOCATED AS IDENTIFIED IN THE FIELD.
- NO TRENCHING SHALL OCCUR WITHIN ONE (1) FOOT OF BACK OF CURB.
- MAINLINE AND LATERALS SHALL BE LOCATED A MINIMUM OF FIVE (5) FEET AWAY FROM BASE OF TREES.
- A RAINBIRD 'AR' OR EQUAL AIR RELIEF VALVE SHALL BE INSTALLED AT HIGH POINT OF MAIN LINE PER COA STANDARD DWG. 2705.
- 5. VALVE BOXES SHALL BE LOCATED MINIMUM 6'-0" FROM EDGE OF TREE ROOT BALL.
- 6. A MINIMUM OF 36-INCHES SHALL BE PROVIDED BETWEEN ADJACENT VALVE BOXES.
- CONTRACTOR SHALL PROVIDE THREE (3) BUBBLERS PER TREE.
- 8. CONTRACTOR SHALL PROVIDE TWO (2) BUBBLERS PER VERTICAL SHRUB.
- 9. CONTRACTOR SHALL PROVIDE ONE (1) BUBBLER PER SHRUB (OTHER THAN VERTICAL SHRUBS) 10. BUBBLERS SHALL BE LOCATED THREE (3) FEET FROM TREE ROOT BALL, TRIANGULATED
- SHRUB HEADS AND TREE HEADS SHALL BE ZONED ON THE SAME VALVE.
- 12. BUBBLERS SHALL BE 1" ABOVE TOP OF MULCH.

AROUND THE ROOT BALL.

- 13. CONTRACTOR SHALL VERIFY EXISTING PRESSURE AND ELEVATION DIFFERENCE FROM POINT OF CONNECTION TO EACH END OF THE PROJECT WITH THE CITY PROJECT MANAGER AND SHALL ENSURE THAT THE IRRIGATION SYSTEM IS DESIGNED TO OPERATE PROPERLY WITHIN THE EXISTING PRESSURE, INCLUDING PRESSURE LOSS FROM TAP THROUGH BACKFLOW PREVENTER AND PRESSURE LOSS FROM ELEVATION CHANGE.
- CONTRACTOR SHALL INSTALL SLEEVES FOR ALL MAINLINE, LATERAL PIPING AND WIRING UNDER PAYED SURFACES, SLEEVES FOR IRRIGATION LINES SHALL BE CLASS 200 PVC. MINIMUM TWO SIZES LARGER THAN PIPE OR SIZE AS REQUIRED TO ACCOMODATE LENGTH OF RUN. SLEEVES FOR WIRE SHALL BE MIN. 2", OR SIZE AS REQUIRED TO ACCOMMODATE QUANTITY OF WIRE.
- CONTRACTOR SHALL INSTALL BOULDERS, BOLLARDS, OR OTHER HARD ELEMENT AROUND THE CONTROLLER AND BACKFLOW PREVENTER TO PROTECT THE IRRIGATION COMPONENTS FROM VEHICULAR DAMAGE, CITY PROJECT MANAGER WILL DETERMINE THE APPROPRIATE MATERIAL FOR THE HARD ELEMENT. SEE DETAILS A/2 AND B/2.
- 16. WATER METER AND SUPPLY LINE BETWEEN METER AND CITY MAIN SHALL BE SAME SIZE AS LARGEST PORTION OF IRRIGATION MAIN LINE.
- BACKFLOW PREVENTER SHALL BE THE SAME SIZE AS THE WATER METER AND SUPPLY LINE.
- 18. BACKFLOW PREVENTER SHALL BE A REDUCED PRESSURE PRINCIPLE BACKFLOW PREVENTION DEVICE.
- 19. BACKFLOW PREVENTER ENCLOSURE SHALL BE 'HOTROK' INSULATED ENCLOSURE WITH HINGED LID AND CLASP FOR LOCK (LOCK BY OWNER), CONTRACTOR SHALL ENSURE THAT CLASP IS OF ADECUATE LENGTH TO ACCOMMODATE LOCK.
- 20. CONTROLLER SHALL BE ONE OF THE FOLLOWING:
 - a. IF THERE IS AN EXISTING IRRINET WITHIN COMMUNICATION RANGE OF THE
 - PROJECT SITE, THE CONTROLLER SHALL BE A SCORPIO CONTROLLER. b. IF THERE IS NOT AN EXISTING IRRINET WITHIN COMMUNICATION RANGE OF THE PROJECT SITE, THE CONTROLLER SHALL BE AN IRRINET-XL CONTROLLER. CONTRACTOR SHALL PROVIDE ONE (1) MOTOROLA IS - XLDAL LAPTOP COMPUTER FOR PROGRAMMING THE IRRINET CONTROLLERS. CONTRACTOR SHALL BE RESPONSIBLE FOR PROGRAMMING THE CONTROLLERS.
- 21. CONTRACTOR SHALL VERIFY CONTROLLER TYPE WITH THE CITY PROJECT MANAGER.
- A CONTROLLER KEY PAD SHALL BE PROVIDED WITH EACH IRRINET CONTROLLER.
- 22. CONTRACTOR SHALL PROVIDE METER, METER PEDESTAL, POWER DROP, AND TWO 120-VOLT, 20 AMP CIRCUITS FROM CLOSEST ELECTRICAL SOURCE TO IRRIGATION CONTROLLER AND BACKFLOW PREVENTER ENCLOSURE (ONE TO EACH). ALL WORK AND MATERIALS SHALL MEET LOCAL CODES AND THE NATIONAL ELECTRIC CODE (N.E.C.) CONTRACTOR SHALL VERIFY ELECTRICAL SOURCE WITH CITY PROJECT MANAGER. ELECTRIC METER SHALL BE LOCATED AS DIRECTED IN FIELD. CONTRACTOR SHALL VERIFY LOCATION WITH CITY PROJECT MANAGER. POWER DROP SHALL BE PER DTL A/4. METER AND PEDESTAL SHALL BE PER PNM STD DWG. DS-19-77.1.
- 23. BACKFLOW PREVENTER SHALL BE TESTED BY A CERTIFIED REDUCED PRESSURE PRINCIPAL BACKFLOW PREVENTION DEVICE TESTER.
- 24. IRRIGATION LINE CROSSINGS BETWEEN MEDIANS SHALL BE PER DETAIL G/4.
- 25. A 2" CLEARANCE SHALL BE PROVIDED BETWEEN TOP OF GRAVEL IN VALVE BOX AND BOTTOM OF VALVE AND PIPE. DEPTH OF GRAVEL IN VALVE BOX SHALL BE 6".
- 26. BLOCKS AT BASE OF VALVE BOXES SHALL BE SOLID CMU 4"X8"X16"
- 27. MAIN LINE SHALL BE INSTALLED ON THE SIDE OF THE MEDIAN ADJACENT TO THE SIDE OF THE STREET WITH THE 7:00 AM LANE CLOSURE. CONTRACTOR SHALL VERIFY APPLICABLE STREET SIDE IN CONJUNCTION WITH THE APPLICATION FOR BARRICADING PERMIT.
- 28. CONTRACTOR SHALL INSTALL IN-LINE CHECK VALVES ON MAIN LINES WHERE THERE ARE SIGNIFICANT CHANGES IN ELEVATION ON THE MAIN LINE.
- 29. CONTRACTOR SHALL INSTALL AN AIR RELIEF VALVE AT EACH HIGH POINT ON MAIN LINE.
- 30. WHERE ELECTRICAL WIRE EXCEEDS 300' LENGTH, CONTRACTOR SHALL INSTALL PULLBOXES AT MINIMUM 300' O.C. PER COA DRAWING 2521.
- 31. CONTRACTOR SHALL DESIGN THE IRRIGATION SYSTEM FOR EACH WORK ORDER IN ACCORDANCE WITH THE IRRIGATION PERFORMANCE CRITERIA, THE IRRIGATION PLAN FOR EACH PROTOTYPE, AND THE VALVE, LINE, AND WIRE SIZING CHARTS. CONTRACTOR SHALL PROVIDE AN ELECTRONIC COPY OF THE IRRIGATION DESIGN ON AUTOCAD TO THE OWNER FOR REVIEW AND APPROVAL PRIOR TO PROCEEDING WITH THE WORK. THE OWNER WILL PROVIDE AN ELECTRONIC DRAWING FILE ON AUTOCAD TO THE CONTRACTOR ON WHICH THE CONTRACTOR SHALL PRODUCE THE IRRIGATION PLAN.

PLANTING NOTES

- TREES SHALL BE PLANTED PER DETAIL H/4. SHRUBS SHALL BE PLANTED PER DETAIL 1/4.
- IN CASE OF DISCREPANCY IN PLANT QUANTITIES SHOWN ON THE PLANT LIST AND THOSE SHOWN ON THE PLANTING PLAN, THE QUANTITIES SHOWN ON THE PLAN SHALL GOVERN. CONTRACTOR SHALL VERIFY ALL QUANTITIES PRIOR TO BID AND INSTALLATION. NO ADDITIONAL PAYMENT WILL BE MADE FOR ANY DISCREPANCIES IN QUANTITIES BETWEEN THE PLANTING PLAN AND THE PLANT LIST.
- IF THERE IS A DISCREPANCY IN THE FIELD OR NURSERY PLANTS BETWEEN THE CONTAINER SIZE CALLED OUT UNDER "REMARKS" AND HEIGHT & SPREAD CALLED OUT UNDER "SIZE", THE SPECIFIED PLANT MUST MEET HEIGHT & SPREAD REQUIREMENTS SPECIFIED UNDER "SIZE", EVEN IF THE LARGER CONTAINER SIZE IS REQUIRED TO MEET THESE SPECIFICATIONS AT NO ADDITIONAL COST TO THE OWNER.
- THE CONTRACTOR SHALL PRUNE LOWER BRANCHES OF DECIDUOUS TREES TO 6 FEET ABOVE FINISH GRADE.
- BALLED AND BURLAPPED TREES ARE AN ACCEPTABLE SUBSTITUTION FOR BOXED TREES IF PLANT MATERIAL SIZE MEETS THE CALIPER, HEIGHT, AND SPREAD REQUIREMENTS SPECIFIED ON THE PLANT LIST AND MEETS THE REQUIREMENTS OF SPECIFICATION SECTION 1005.
- UNLESS OTHERWISE SPECIFIED, CLEAR ZONE AT BACK OF CURB (AREA FREE OF PLANTS AND OTHER IMPROVEMENTS) SHALL BE 2'-0".
- MINIMUM DISTANCE BETWEEN SHRUBS AND BETWEEN ORNAMENTAL GRASSES SHALL BE 4' - 0".
- 8. MINIMUM DISTANCE BETWEEN A PLANT AND A MANHOLE SHALL BE 8'-0"

YALVE SIZING CHART VALVE SIZE 16-30 31-70 1 1/2" (MAXIMUM VALVE SIZE SHALL BE 2")

LINE	SIZING CHART
GPM	LINE SIZE
Ø-5	3/4"
> 5-12	1"
> 12-22	1 1/4"
> 22-30	1 1/2"
> 30-50	2"
> 50-70	2 1/2"
(MAXIMUM	PIPE SIZE SHALL BE 2 1/2")

WIRE SIZING CHART: 24 YOLT CONTROL WIRE LENGTH OF RUN WIRE SIZE 0-500 LF 12 GA **OVER 500 LF** 10 GA

	-BOULDERS PER DETAIL F/3 (TYP. OF 8) SEE DETAILS C/3 AND D/3 FOR LAYOUT CRITER!
RRIGATION C	ONTROLLER AND BFP

1/16" = 1'-0"

EXTENDED WARRANTY

BOULDERS 0

BOULDERSOIRRG.DWG

CONTRACTOR SHALL PROVIDE A TWO-YEAR WARRANTY ON THE PROJECT. WARRANTY SHALL BEGIN UPON FINAL ACCEPTANCE OF THE CONSTRUCTION OF EACH WORK ORDER AND SHALL CONTINUE FOR TWO YEARS.

WARRANTY ON IRRIGATION SYSTEM SHALL INCLUDE REPLACEMENT OF DEFECTIVE MATERIALS AND/OR WORKMANSHIP, REPAIR OF DAMAGE DUE TO LINE BREAKS CAUSED BY DEFECTIVE MATERIAL AND/OR WORKMANSHIP, SEASONAL PROGRAMMING OF THE CONTROLLER, ADJUSTMENT OF HEADS, REPAIR OF OF ANY SETTLEMENT OF TRENCHES, AND GENERAL MONITORING AND ADJUSTMENT OF THE SYSTEM AS REQUIRED TO INSURE HEALTH OF THE PLANTS. CONTRACTOR SHALL COMPLETE REPAIR OF DEFECTIVE MATERIAL WITHIN 24 HOURS OF THE SYSTEM FAILURE AND SHALL COMPLETE REPAIR OF DAMAGES DUE TO LINE BREAKS WITHIN 48 HOURS OF THE LINE BREAK.

WARRANTY ON PLANTS SHALL INCLUDE WATERING, WEEDING, CULTIVATING. REMOVAL AND REPLACEMENT OF DEAD MATERIAL, REMOVAL OF DEBRIS (INCLUDING REMOVAL OF GRAVEL MULCH THAT HAS BEEN DISPLACED FROM THE LANDSCAPE AREAS). RESETTING TREES TO AN UPRIGHT POSITION, RESTORATION OF EARTH BASING, RESTORATION OF DISTURBED MULCHED AREAS AND SUCH OTHER OPERATIONS AS MAY BE NECESSARY FOR THE HEALTH OF THE PLANTED STOCK AND THE GENERAL APPEARANCE OF THE PROJECT AREA. WEEDING AND REMOVAL OF DEBRIS SHALL BE PERFORMED ON A WEEKLY BASIS.


WARRANTY SHALL INCLUDE REPAIR OR REPLACEMENT OF IRRIGATION, PLANTS, AND/OR MULCH DAMAGED BY TRESPASS, EROSION (INCLUDING WATERING), WEATHER DISEASE AND THE LIKE. WARRANTY SHALL NOT INCLUDE REPAIR OR REPLACEMENT OF IRRIGATION MATERIALS OR PLANTS THAT ARE DAMAGED AS A RESULT OF VANDALISM. THE CONTRACTOR SHALL BE RESPONSIBLE FOR THE COST OF WATER AND ELECTRICITY DURING CONSTRUCTION AND DURING THE TWO YEAR WARRANTY.

COA SPEC. SECTION 10015.24, SYSTEM MAINTENANCE AND WARRANTY, SHALL BE DELETED IN ITS ENTIRETY.

COA SPEC. SECTION 10056, MAINTENANCE AND PROTECTION: FIRST PARAGRAPH, SHALL BE DELETED IN ITS ENTIRETY.

COA SPEC. SECTION 1005.6.2, WATER, SHALL BE DELETED IN ITS ENTIRETY.

PROJECTED WATER USE PROTOTYPE | STANDARD 16' WIDE MEDIAN WIDE (30') MEDIAN (INCHES / SQ. FT. / YEAR) (INCHES / SQ. FT. / YEAR) B 4.5 C 13.4 236 2.3

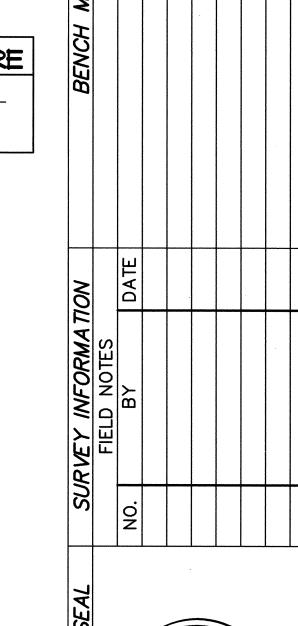

OF NEW

DATE DATE





CITY OF ALBUQUERQUE CAPITAL IMPLEMENTATION PROGRAM DEPARTMENT OF MUNICIPAL DEVELOPMENT


PROTOTYPE MEDIAN & INTERSTATE LANDSCAPES FY-07A NOTES AND DETAILS


Design Review Committee REVIEW COMMITTEE

City Engineer Approval CITY ENGINEER

Mo./Day/Yr. Mo./Day/Yr. Sheet

City Project No. 790300 Zone Map No. 2 OF 25

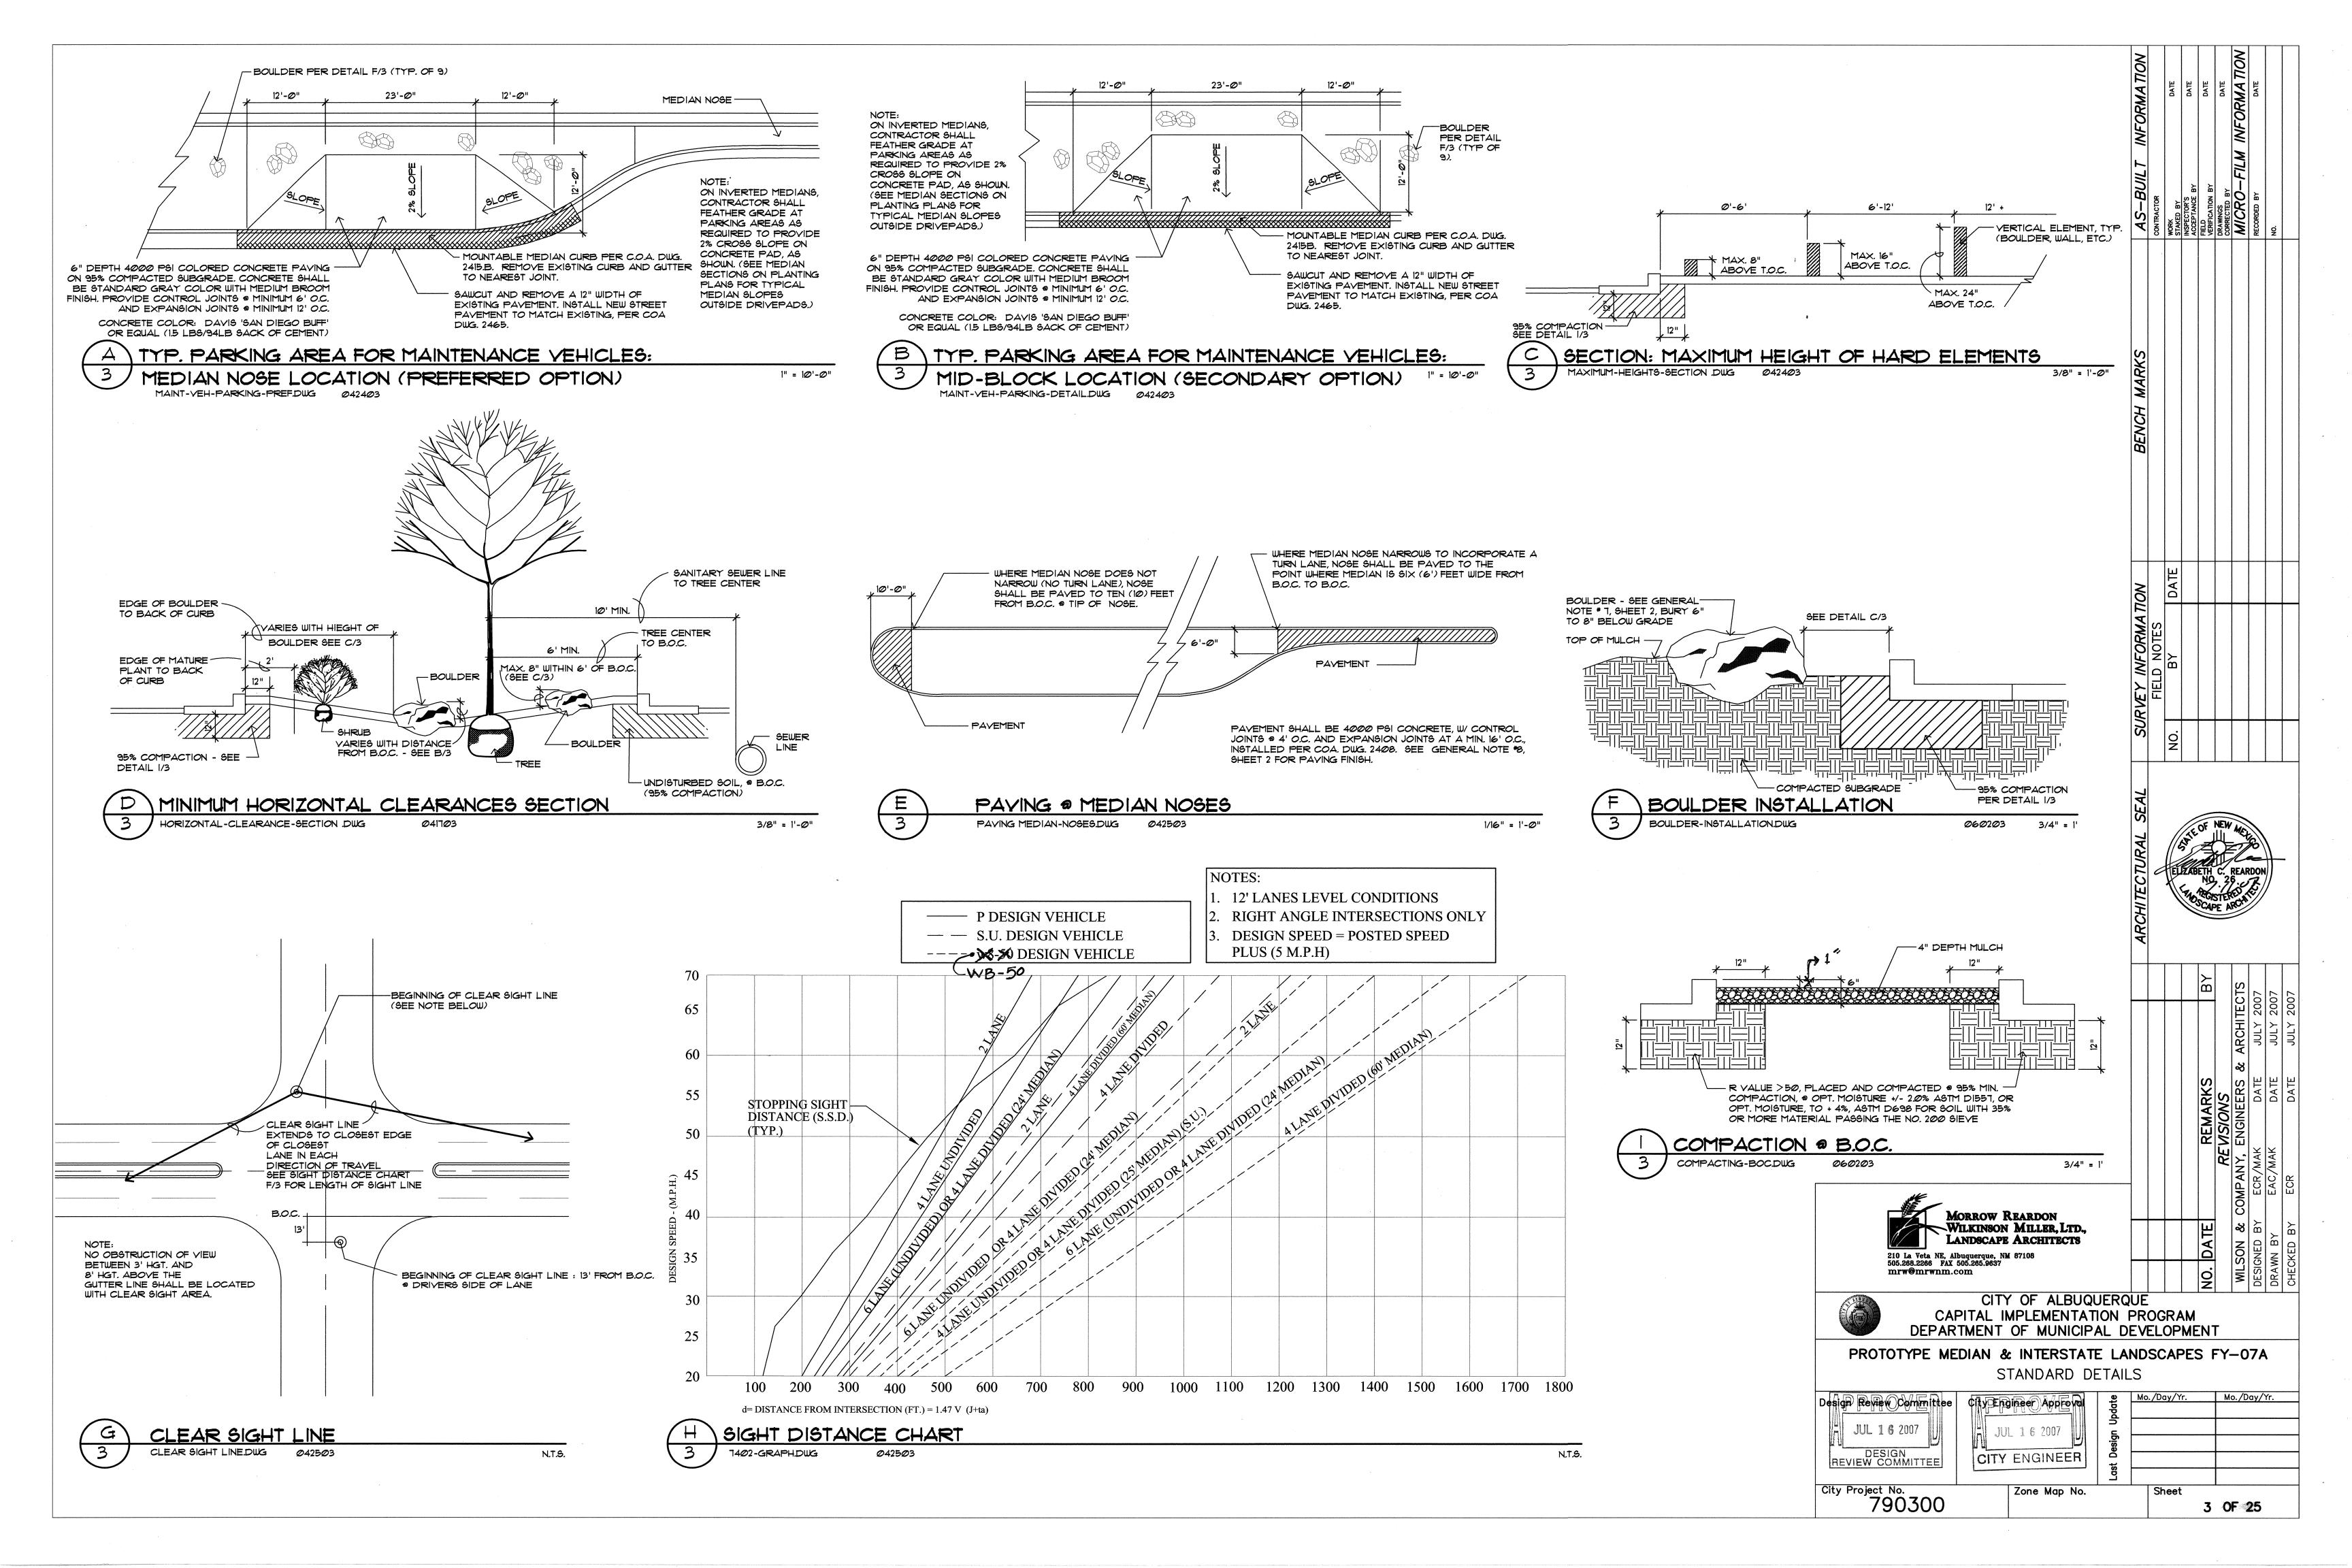


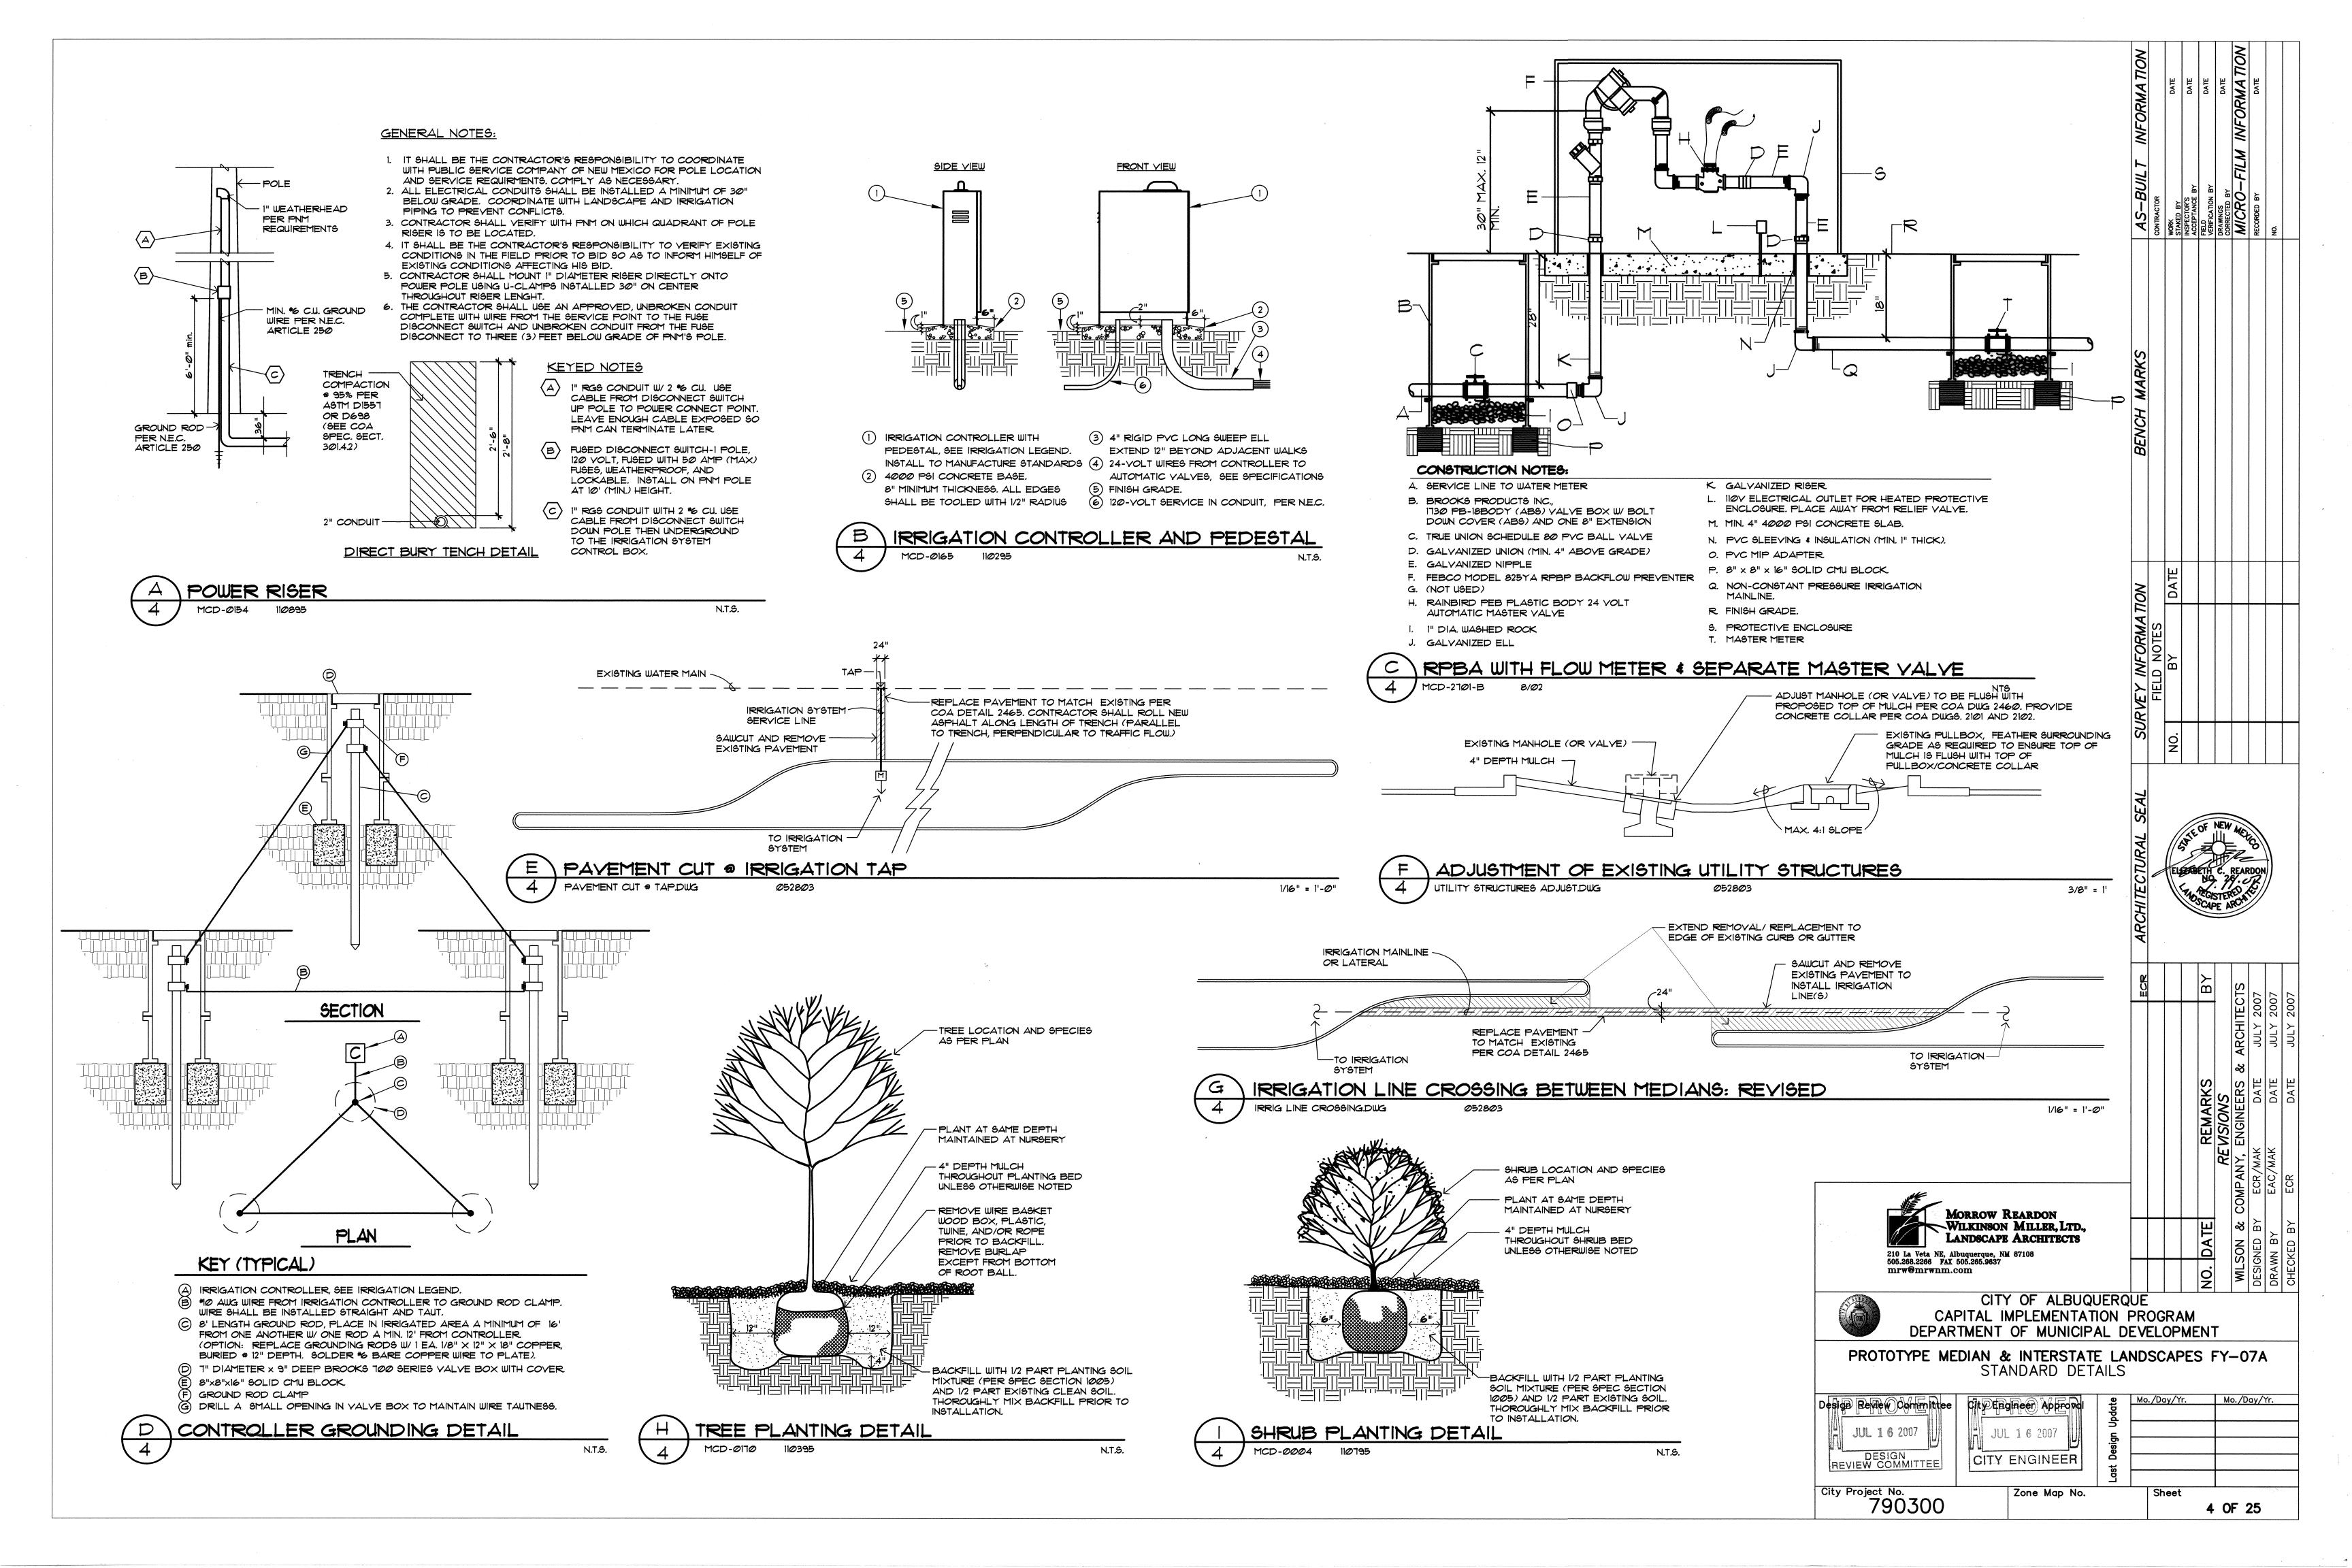


	ER PLANT LIST		SIZE				
KEY	COMMON NAME	BOTANICAL NAME	INSTALLED	MATURE	REMARKS	WATER USE	
HADE TE	<u>EES</u> Autumn Purple Ash	Fraxinus americana 'Autumn Purple'	2" cal., 12' - 14' ht.	40' ht., 25'spd.	30" Box	М	
AS	Arizona Sycamore	Plantanus wrightii	2" cal., 12' - 14' ht.	50' ht., 30' spd.	30" Box	M	
CP	Chinese Pistache	Pistacia chinensis	2-1/2" cal., 13' - 15' ht.	40' ht., 25' spd.	30" Box	М	
HL	Honey Locust	Gleditsia triacanthos inermis spp.	2" cal., 12' - 14' ht.	50' ht., 25' spd.	30" Box	M	
LB MA	Lacebark Elm Fraxinus velutina 'Modesto'	Ulmus parvifolia Modesto Ash	2" cal., 12' - 14' ht. 2" cal., 12' - 14' ht.	30' ht., 25' spd. 40' ht., 25' spd.	30" Box 30" Box	M M	
RA	Raywood Ash	Fraxinus oxycarpa 'Raywood'	2" cal., 12" - 14" ht.	30' ht., 25' spd.	30" Box		
W⊢	Western Hackberry	Celtis occidentalis	2" cal., 12' - 14' ht.	30' ht., 30' spd.		M	
	EN TREES		2 Oct., 12 11 110.	JD 116., JD 0PG.	30 BOA		
AP	Austrian Pine	Pinus nigra	5' - 7' ht.	30' ht., 20' spd.	30" Box	М	
LP	Limber Pine	Pinus flexilis	5' - 7' ht.	20' ht. \$ spd.	30" Box	M	
SP	Scotch Pine	Pinus sylvestris 'Albyn'	5' - 7' ht.	50' ht., 30' spd.	30" Box	M	
ACCENT	REES						
ВС	Bechtel Crabapple	Malus ioensis 'Bechtel'	2" cal., 10'-12' ht.	25' ht., 20' spd.	30" Box	M	
DW	Desert Willow	Chilopsis linearis	8' - 10' ht.	25' ht., 20' spd.	30" Box, Multi-Tr	runk M	
GO	Gambel Oak	Quercus gambelii	8' - 10' ht.	25' ht., 20' spd.	30" Box	L	
GRT	Goldenrain Tree	Goldenrain Tree	2" cal, 10'-12' ht.	25' ht., 20' spd.	30" Box		
OP			2" cal., 10-12' ht.	•		7. M M	
SH	Ornamental Pear Sunburst Honey Locust	Pyrus calleryana spp.	2" cal., 10'-12' ht.	25' ht., 20' spd.	30" Box 30" Box	M	
5 0	Shumard Oak	Gleditsia triacanthos inermis 'Sunburst' Quercus shumardii	2" cal., 12' - 14' ht.	25' ht., 20' spd.	30" Box 30" Box	1	
ST	Smoke Tree	Cotinus coggygria	6'-8' ht.	30' ht., 25' spd. 20' ht. & spd.	30" Box 24" Box	L M	
TH	Washington Hawthorn	Crataegus phaenopyrum	6 -6 nt. 2" cal., 10-12' ht.	20' ht., 20' spd.		M	
*			2 - Cal., 180-12 File.	2× 111., 2× 5pa.	JU DUX	. •	
	SHRUBS		No. Coll. L.			د،	
BB	Butterfly Bush	Buddleia davidii nanhoensis	Min. 18" ht.	6' ht. \$ spd.	5-Gal.	M	
FB	Fern Bush	Chamaebatieria millefolium	Min. 18" ht.	6' ht. \$ spd.	5-Gal.	M	
GC MM	Golden Currant Mountain Mahogany	Ribes aureum Cercocarpus montanus	Min. 18" ht. Min. 18" ht.	5' ht. & spd. 10' ht. & spd.	5-Gal. 5-Gal.	ı I L	
LLS	Littleleaf Sumac	Rhus microphylla	Min. 12" ht.	•		– L	
NMO	New Mexico Olive	Foresteria neomexicana	1911. 12" ht. 5' - 7' ht.	8' ht. \$ spd. 15' ht., 10' spd.	5-Gal.	ь М	
SB	Spanish Broom	Foresteria neomexicana Spartium junceum	5' - 1' ht. Min. 18" ht.	8' ht., 6' spd.	15-Gal. 5-Gal.	1	
VI	Vitex	Vitex agnus-castus		•		- i	
		The second of th	5' - 1' ht.	15' ht., 15' spd.	15-Gal.	L	
	RUBS/ORNAMENTAL GRASSES						
APL	Apache Plume	Fallugia paradoxa	Min. 18" ht.	5' ht. \$ spd.	5-Gal.	L	
AR	Arp Rosemary	Rosmarinus officinalis 'Arp'	Min. 18" ht.	4' ht., 3' spd.	5-Gal.	M	
BG	Bear Grass	Nolina texana	Min. 18" ht.	3' ht. \$ spd.	5-Gal.	<u>L</u>	
BM	Blue Mist	Caryopteris x clandonensis	Min. 18" ht.	4' ht. \$ spd.	5-Gal.	M	
MG	Maiden Grass	Miscanthus sinensis 'Gracillimus'	Min. 18" spd.	6' ht., 3' spd.	5-Gal.	M	
LB	Lena's Broom	Cystisus scoparius x dallimorei 'Lena'	Min. 12" spd.	4' ht. \$ spd.	5-Gal.	М	
R.	Rubber Rabbitbrush	Chrysothamnus nauseosus	Min. 18" ht.	6' ht. \$ spd.	5-Gal.	L	
RS	Russian Sage	Perovskia atriplicifolia	Min. 18" ht.	3' ht. \$ spd.	5-Gal.	L	
RY	Red Yucca	Hesperaloe parviflora	Min. 18" ht.	4' ht. \$ spd.	5-Gal.	L	
9	Sotol	Dasylirion wheeleri	Min. 18" ht.	4' ht. \$ spd.	5-Gal.	L	
SG.	Switchgrass	Panicum virgatum	Min. 12" ht.	4' ht., 3' spd.	5-Gal.	M	
TLS	Three-leaf Sumac	Rhus trilobata	Min. 18" ht.	5' ht. \$ spd.	5-Gal.	L	
	RUBS/ORNAMENTAL GRASSES		Min all lat	0 1 1	1 1	∟	
BA D RS	Blue Avena Dularf Russian Sage	Helictotrichon sempervirens Perovskia atriplicifloria 'Little Spires'	Min. 8" ht. Min. 6" ht	2' ht. \$ spd.	i-Gal. 5-Gal	M	
CS	Dwarf Russian Sage Cherry Sage	Perovskia atriplicifloria 'Little Spires' Salvia greggii	Min. 6" ht. Min. 12" spd.	3' ht. & spd. 3' ht. & spd.	5-Gal. 5-Gal.	⊢ M	
DR	Cherry Sage Dwarf Rabbitbrush	Salvia greggii Chrysothamnus nauseosus nauseosus	Min. 12" spa. Min. 8" ht.	2' ht. \$ spd.	5-Gal. 5-Gal.	1	
F	Feathergrass	Stipa capillata	Min. 8" ht. Min. 8" ht.	18" ht. 4 spd.	5-Gal. 5-Gal.	∟ M	
FG	Foerster's Grass	Calamagrostis arundinacea	Min. 8" spd.	15" ht. 4 spa. 2' ht. 4 spa.	5-Gal. 5-Gal.	M	
GLS	Gro-Low Sumac.	Rhus aromatica	Min. 12" spd.	18" ht., 3' spd.	5-Gal.	M	
LY	Lavender	Lavandula angustifolia spp.	Min. 6" ht.	2' ht. \$ spd.	1-Gal.	L.	
RM	Regal Mist	Muhlenbergia capillaris	Min. 10" spd.	3' ht. \$ spd.	5-Gal.	M 2	A CONTRACT OF THE CONTRACT OF
SC	Shrubby Cinquefoil	Potentilla fruticosa	Min. 12" ht.	3' ht. \$ spd.	5-Gal.	M M	
SBY	Softblade Yucca	Yucca recurvifolia	Min. 18" ht.	3' ht. \$ spd.	5-Gal.	L.	
ZG	Zebra Grass	Miscanthus sinensis 'Zebrinus'	Min. 12" spd.	·		- -	
			· ···· · · · · · · · · · · · · · · · ·	4' ht. \$ spd.	5-Gal.	М	
GROUNDO							
AJ 	Arcadia Juniper	Juniperus sabina 'Arcadia'	Min. 10" spd.	2' ht. \$ spd.	5-Gal.	М	
BF	Blue Fescue	Festuca ovina 'Glauca'	Min. 6" ht.	12" ht. \$ spd.	1-Gal.	L	
BJ	Buffalo Juniper	Juniperus sabina 'Buffalo'	Min. 12" spd.	12" ht., 6' spd.	5-Gal.	M	
PS	Prairie Sage	Artemesia ludoviciana	Min. 8" spd.	2' ht. \$ spd.	5-Gal.	L	
SJ	Scandia Juniper	Juniperus sabina 'Scandia'	Min. 10" spd.	12" ht., 6' spd.	5-Gal.	М	
CACTI							
BLC	Bailey's Lace Cactus	Echinocereus reichenbachii v. baileyi	Min. 2" ht.	6" ht. \$ spd.	1-Gal.	L	
CCC	Claret Cup Cactus	Echinocereus triglochidiatus	Min. 3" ht.	6" ht., 8" spd.	I-Gal.	L	
NRH	New Mexico Rainbow Hedgehog	Echinocereus dasycanthus	Min. 3" ht.	10" ht., 4" spd.	I-Gal.	L	
SH	Royal George Spiney Hedgehog	Echinocereus coccineus	Min. 3" ht.	12" ht., 18" spd.	1-Gal.	L	
PERENNI	<u>Ls</u>						
		Godyn tolologi w 14 15	Min. 6" ht.	ا ۱۵ نما ا	1_6=1	l	
AJS BP	Autumn Joy Sedum Bush Penstemon	Sedum telephium 'Autumn Joy'	Min. 6" ht.	2' ht. \$ spd.	1-Gal. 1-Gal.	⊢ 	
BM	Bush Menstemon Bowles Mauve	Penstemon ambiguus Erysimum 'Bowles Mauve'	Min. 10" ht.	2' ht. \$ spd. 2' ht. \$ spd		← I	
©M CM		•	Min. 10" ht. Min. 6" spd.	2' ht. \$ spd.	1-Gal. 1-Gal.	L M	
U	Catmint	Nepita faassenii Sobaeraleea munroana	Min. 6" spa. Min. 6" ht.	2' ht. \$ spd.		1	
CM	Globe Mallow	Sphaeralcea munroana		3' ht., 2' spd.	1-Gal.	L	
GM	Mexican Primrose	Oenothera speciosus 'Rosea' Pailostrophe tagetina	Min. 6" ht.	10" ht., 18" spd.	l-Gal.	M M	
MP	Danariana	Psilostrophe tagetina	Min. 6" ht.	12" ht., 2' spd.	1-Gal.	17 1 1 - 1 - 1 - 1 - 1 - 1 - 1 - 1 - 1 - 1 -	
MP PFL	Paperflower Dragon's Blood Sedum	Godin animium Managas Dissall	Min 6" and	ا- سند الات تسا الدي		The second secon	
MP PFL DBS	Dragon's Blood Sedum	Sedum spurium 'Dragons Blood' Knibhofia uvaria	Min. 6" spd. Min. 6" ht.	8" ht., 2' spd. 3' ht. \$ spd.	1-Gal.	#84.99* · · · · · · · · · · · · · · · · · ·	
MP PFL DBS RHP	Dragon's Blood Sedum Red Hot Poker	Kniphofia uvaria	Min. 6" ht.	3' ht. \$ spd.	I-Gal.	L M	
MP PFL DBS	Dragon's Blood Sedum		•				

AS-BUILT INFORMATIC CONTRACTOR WORK STAKED BY INSPECTOR'S ACCEPTANCE BY INSPECTOR'S ACCEPTANCE BY INSPECTOR'S ACCEPTANCE BY INSPECTOR'S ACCEPTANCE BY INSPECTOR BY AMICRO-FILM INFORMATIC RECORDED BY NO.
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SURVEY INFORMATION FIELD NOTES BY DATE
ARCHITECTURAL SEAL STATE OF THE
RCHITECTS JULY 2007 JULY 2007
MORROW REARDON WILKINSON MILER, LTD., LANDSCAPE ARCHITECTS 210 La Veta Ne, albuqueque, NM 67108 505.286.286 FAX 505.285.8837 mrw@mrwnm.com CITY OF ALBUQUERQUE CAPITAL IMPLEMENTATION PROGRAM DEPARTMENT OF MUNICIPAL DEVELOPMENT PROTOTYPE MEDIAN & INTERSTATE LANDSCAPES FY—07A
MASTER PLANT LIST Design Review Committee Civengine Approve # Bod Mo./Day/Yr. Mo.


TYPICAL FOR EACH TYPE OF MAINTENANCE DRIVE PAD LOCATION ON 16' MEDIAN

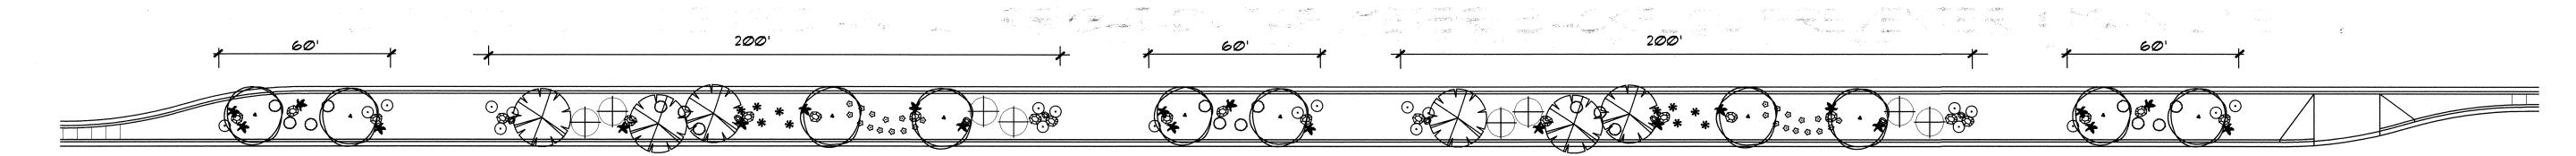

EXAMPLE LAYOUT FOR PODS (TYP. 16' MEDIAN) SCALE: 1"=30"

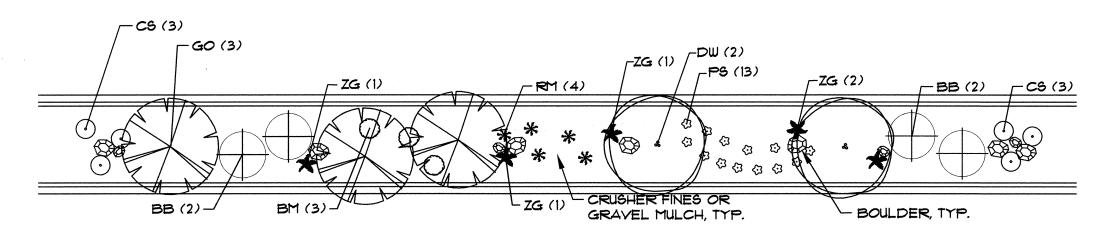


POD: TYP. 16' MEDIAN SCALE: 1"=20'

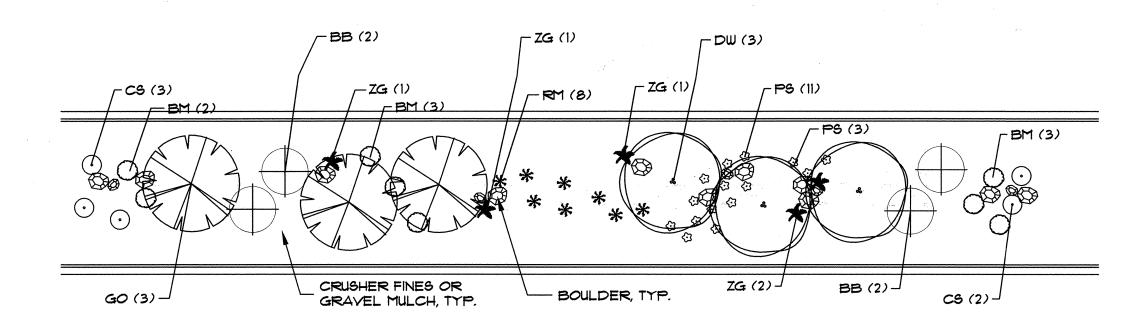


200' POD: WIDE MEDIAN ADAPTATION SCALE: 1"=20"

SYMBOL	COMMON NAME	ALTERNATIVE SPECIES	ALTERNATIVE SPECIES WIDE MEDIANS ONLY:	QTY. (200' POD)	QTY. (50' POD)	QTY. (WIDE 200' POD)	QTY. (WIDE 50 POD)
ACCENT T	REES						
DW .	Desert Willow	Shumard Oak Sunburst Honey Locust		2	2	3	2
GO	Gambel Oak	Thornless Hawthorn Goldenrain Tree	Austrian Pine Limber Pine	3	Ø		0
VERTICAL	SHRUBS						
BB	Butterfly Bush	New Mexico Olive Littleleaf Sumac		4	0	4	Ø
LARGE SH	RUB6						
APL	Apache Plume	Arp Rosemary Bear Grass		Ø	Ø	Ø	2
BM	Blue Mist	Sotol Russian Sage		3	. 4	8	5
SMALL SHE	NUBS						-
CS	Cherry Sage	Dwarf Rabbitbrush Lavender		6	3	5	3
ZG	Zebra Grass	Red Yucca Soapweed Yucca		5	4	5	3
RM	Regal Mist	Foerster's Grass Blue Avena		5	Ø	8	Ø
FOUNDCO	VERS/PERENNIALS						
PS	Prairie Sage	Soapwort Paperflower		13	Ø	14	Ø


*Trees designated as "alternate species - wide medians only" shall be installed only in medians of minimum 25' width and 100' length.

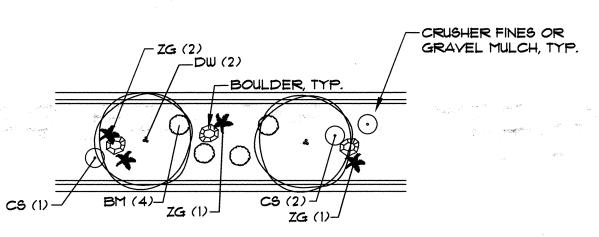

60' POD: TYP. 16' MEDIAN SCALE: 1"=20"

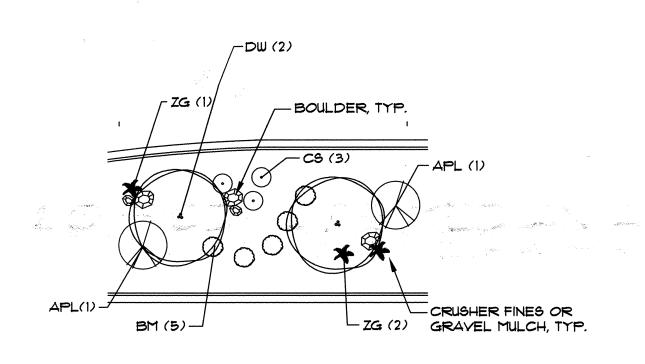



60' POD: WIDE MEDIAN ADAPTATION SCALE: 1"=20'

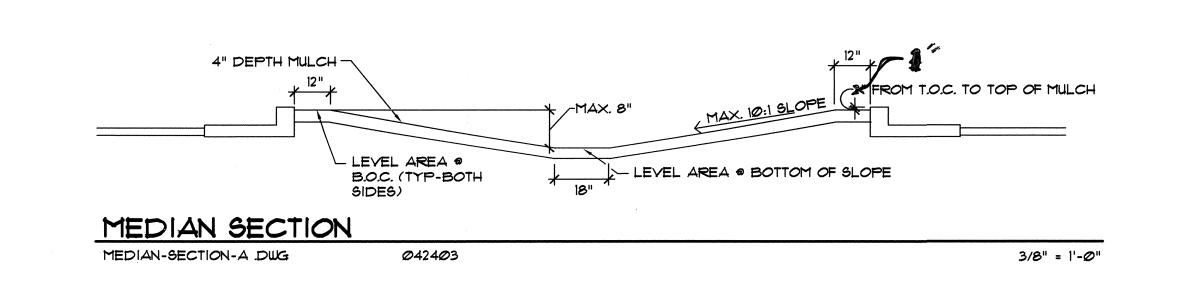




-MAINTENANCE PARKING AREA PER A/3 (PREFERRED OPTION)

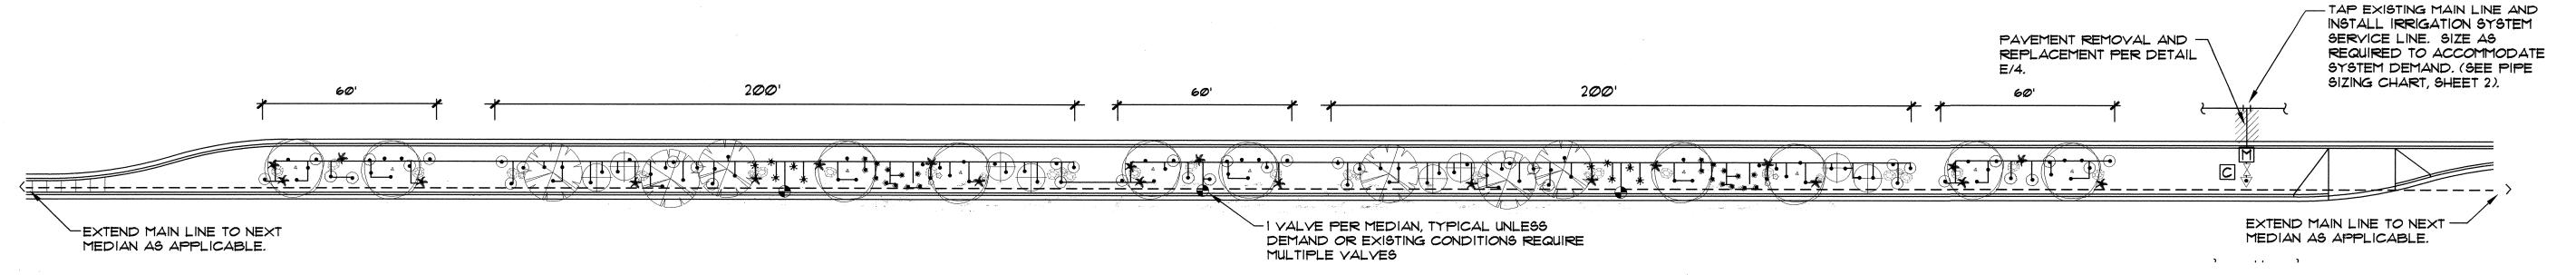


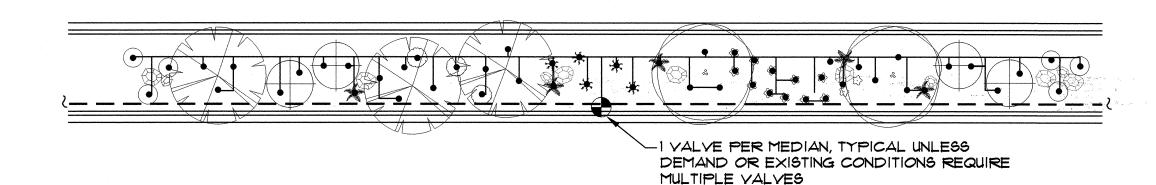


200' POD: TYP. 16' MEDIAN

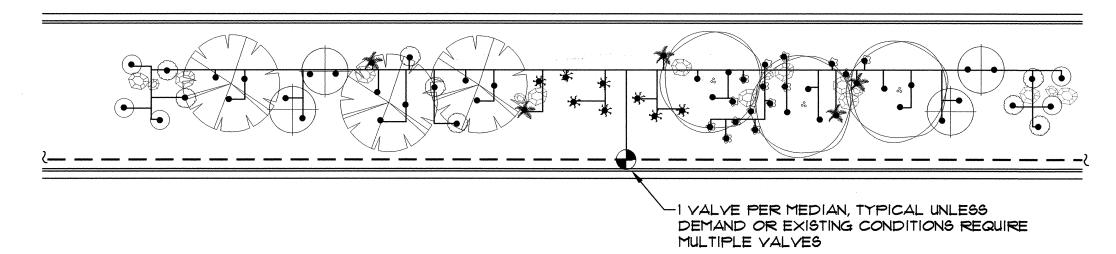

200' POD: WIDE MEDIAN ADAPTATION Scale: 1"=20'

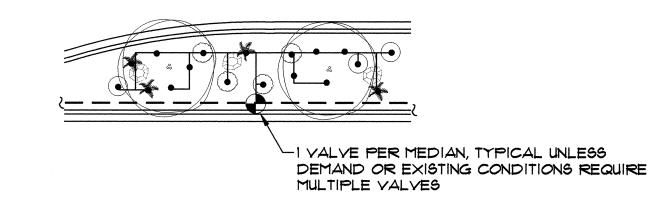

60' POD: TYP. 16' MEDIAN Scale: 1"=20'

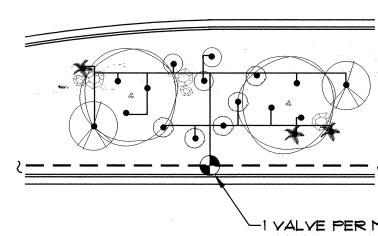

-1 VALVE PER MEDIAN, TYPICAL UNLESS DEMAND OR EXISTING CONDITIONS REQUIRE

60' POD: WIDE MEDIAN ADAPTATION Scale: 1"=20"

IRRIGATION LEGEND

M WATER METER PER COA DWG. 2362 OR 2363. SIZE PER METER SIZING CHART, SHEET 2.

--- IRRIGATION MAIN LINE, SCH 40 BELL END, SOLVENT WELD PVC. DEPTH OF SHALL BE BURY 28" FOR CONTINUOUS PRESSURE IRRIGATION MAIN LINE AND 18" DEPTH OF BURY FOR NON-CONTINUOUS PRESSURE. SIZE PER PIPE SIZING CHART, SHEET 2.

- LATERAL PIPING, SCH. 40, BELL END, SOLVENT WELD PVC. DEPTH OF BURY, 18"." SIZE PER PIPE SIZING CHART, SHEET 2.

- M ISOLATION VALVE ASSEMBLY, SIZE PER VALVE SIZING CHART, SHEET 2. INSTALL PER C.O.A. DRAWING NO. 2707.
- FEBCO 825YA REDUCED PRESSURE PRINCIPAL BACKFLOW PREVENTER AND MASTER VALVE ASSEMBLY WITH BALL VALVES, INSTALLED IN HEATED AND INSULATED ENCLOSURE AND MASTER METER INSTALLED IN VALVE BOX PER DETAIL C/4. SIZE OF RP, MASTER VALVE, AND MASTER METER SHALL BE SAME AS LINE SIZE. ENCLOSURE SHALL BE SIZED TO ACCOMMODATE SIZE OF RP AND MASTER VALVE ASSEMBLY.
- REMOTE CONTROL VALVE ASSEMBLY, RAINBIRD PEB PLASTIC BODY 24-VOLT AUTOMATIC VALVE, SIZE, PER VALVE SIZING CHART, SHEET 2. INSTALL PER C.O.A. DRAWING NO. 2703. (SIMILAR - SEE IRRIGATION NOTES #25 AND #26, SHEET 2.)
- SOLVENT WELD CAP, SCH. 40 PVC, LINE SIZE.

PRESSURE COMPENSATING BUBBLER ASSEMBLIES, RAIN BIRD 1400 SERIES, AS FOLLOWS: INSTALL PER C.O.A. DRAWING NUMBERS 2710, 2711, 2711-A AND 2712.


C IRRINET AC, IRRINET DC, SCORPIO AC, OR SCORPIO DC, CONTROLLER WITH INTERSPEC ENCLOSURE AND DOMED ANTENNA. UNIT SHALL COMMUNICATE ON C.O.A. RADIO FREQUENCY (WIDE BAND). INSTALL PER DETAILS B/4 AND D/4. COORDINATE WITH CITY PROJECT MANAGER FOR TYPE OF CONTROLLER. SIZE AS REQUIRED TO ACCOMMODATE QUANTITY OF REMOTE CONTROL VALVES AND MASTER VALVE.

PROTOTYPE A GPM

STANDARD 200' POD: STANDARD 50' POD: WIDE MEDIAN 200' POD: WIDE MEDIAN 50' POD:

IRRIGATION NOTES


- SEE SHEET 2 FOR GENERAL IRRIGATION NOTES.
- CONTRACTOR SHALL SIZE THE IRRIGATION COMPONENTS IN ACCORDANCE WITH THE IRRIGATION SIZING CRITERIA, SHEET 2.
- BUBBLERS ARE SHOWN DIRECTLY ON TOP OF SHRUBS FOR CLARITY OF DESIGN ONLY. BUBBLERS SHALL BE LOCATED 12" FROM THE SHRUB ROOT BALL.
- UNIT PRICE BID ITEM FOR EACH POD INCLUDES BUBBLERS AND RELATED INCIDENTAL COMPONENTS ONLY. BALANCE OF IRRIGATION COMPONENTS (MAIN LINE, WIRE, BACKFLOW PREVENTER, GATE VALVE, METER, TAP, SERVICE LINE, CONTROL VALVES & LATERAL LINES) ARE BID AS SEPARATE UNIT BID ITEMS. FITTINGS AND OTHER IRRIGATION COMPONENTS REQUIRED TO INSTALL INDIVIDUAL BID ITEMS SHALL BE INCIDENTAL TO THE WORK AND INCLUDED AT NO ADDITIONAL COST TO THE OWNER.

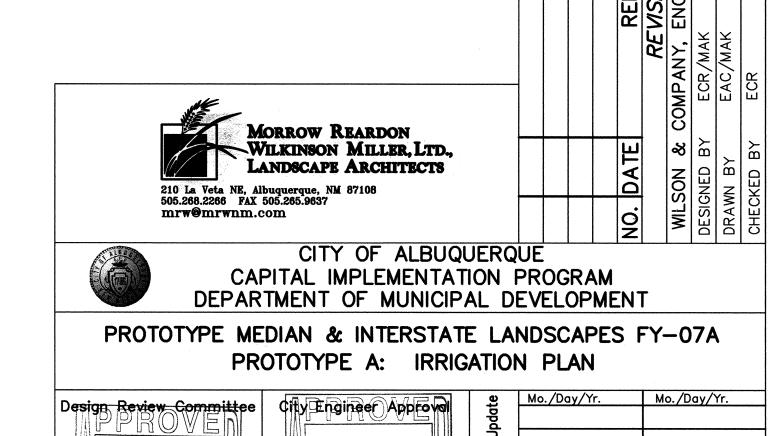



JUL 1 6 2007 CITY ENGINEER DESIGN REVIEW COMMITTEE City Project No. Zone Map No.

790300


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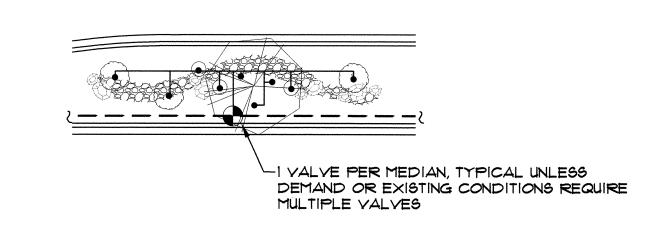


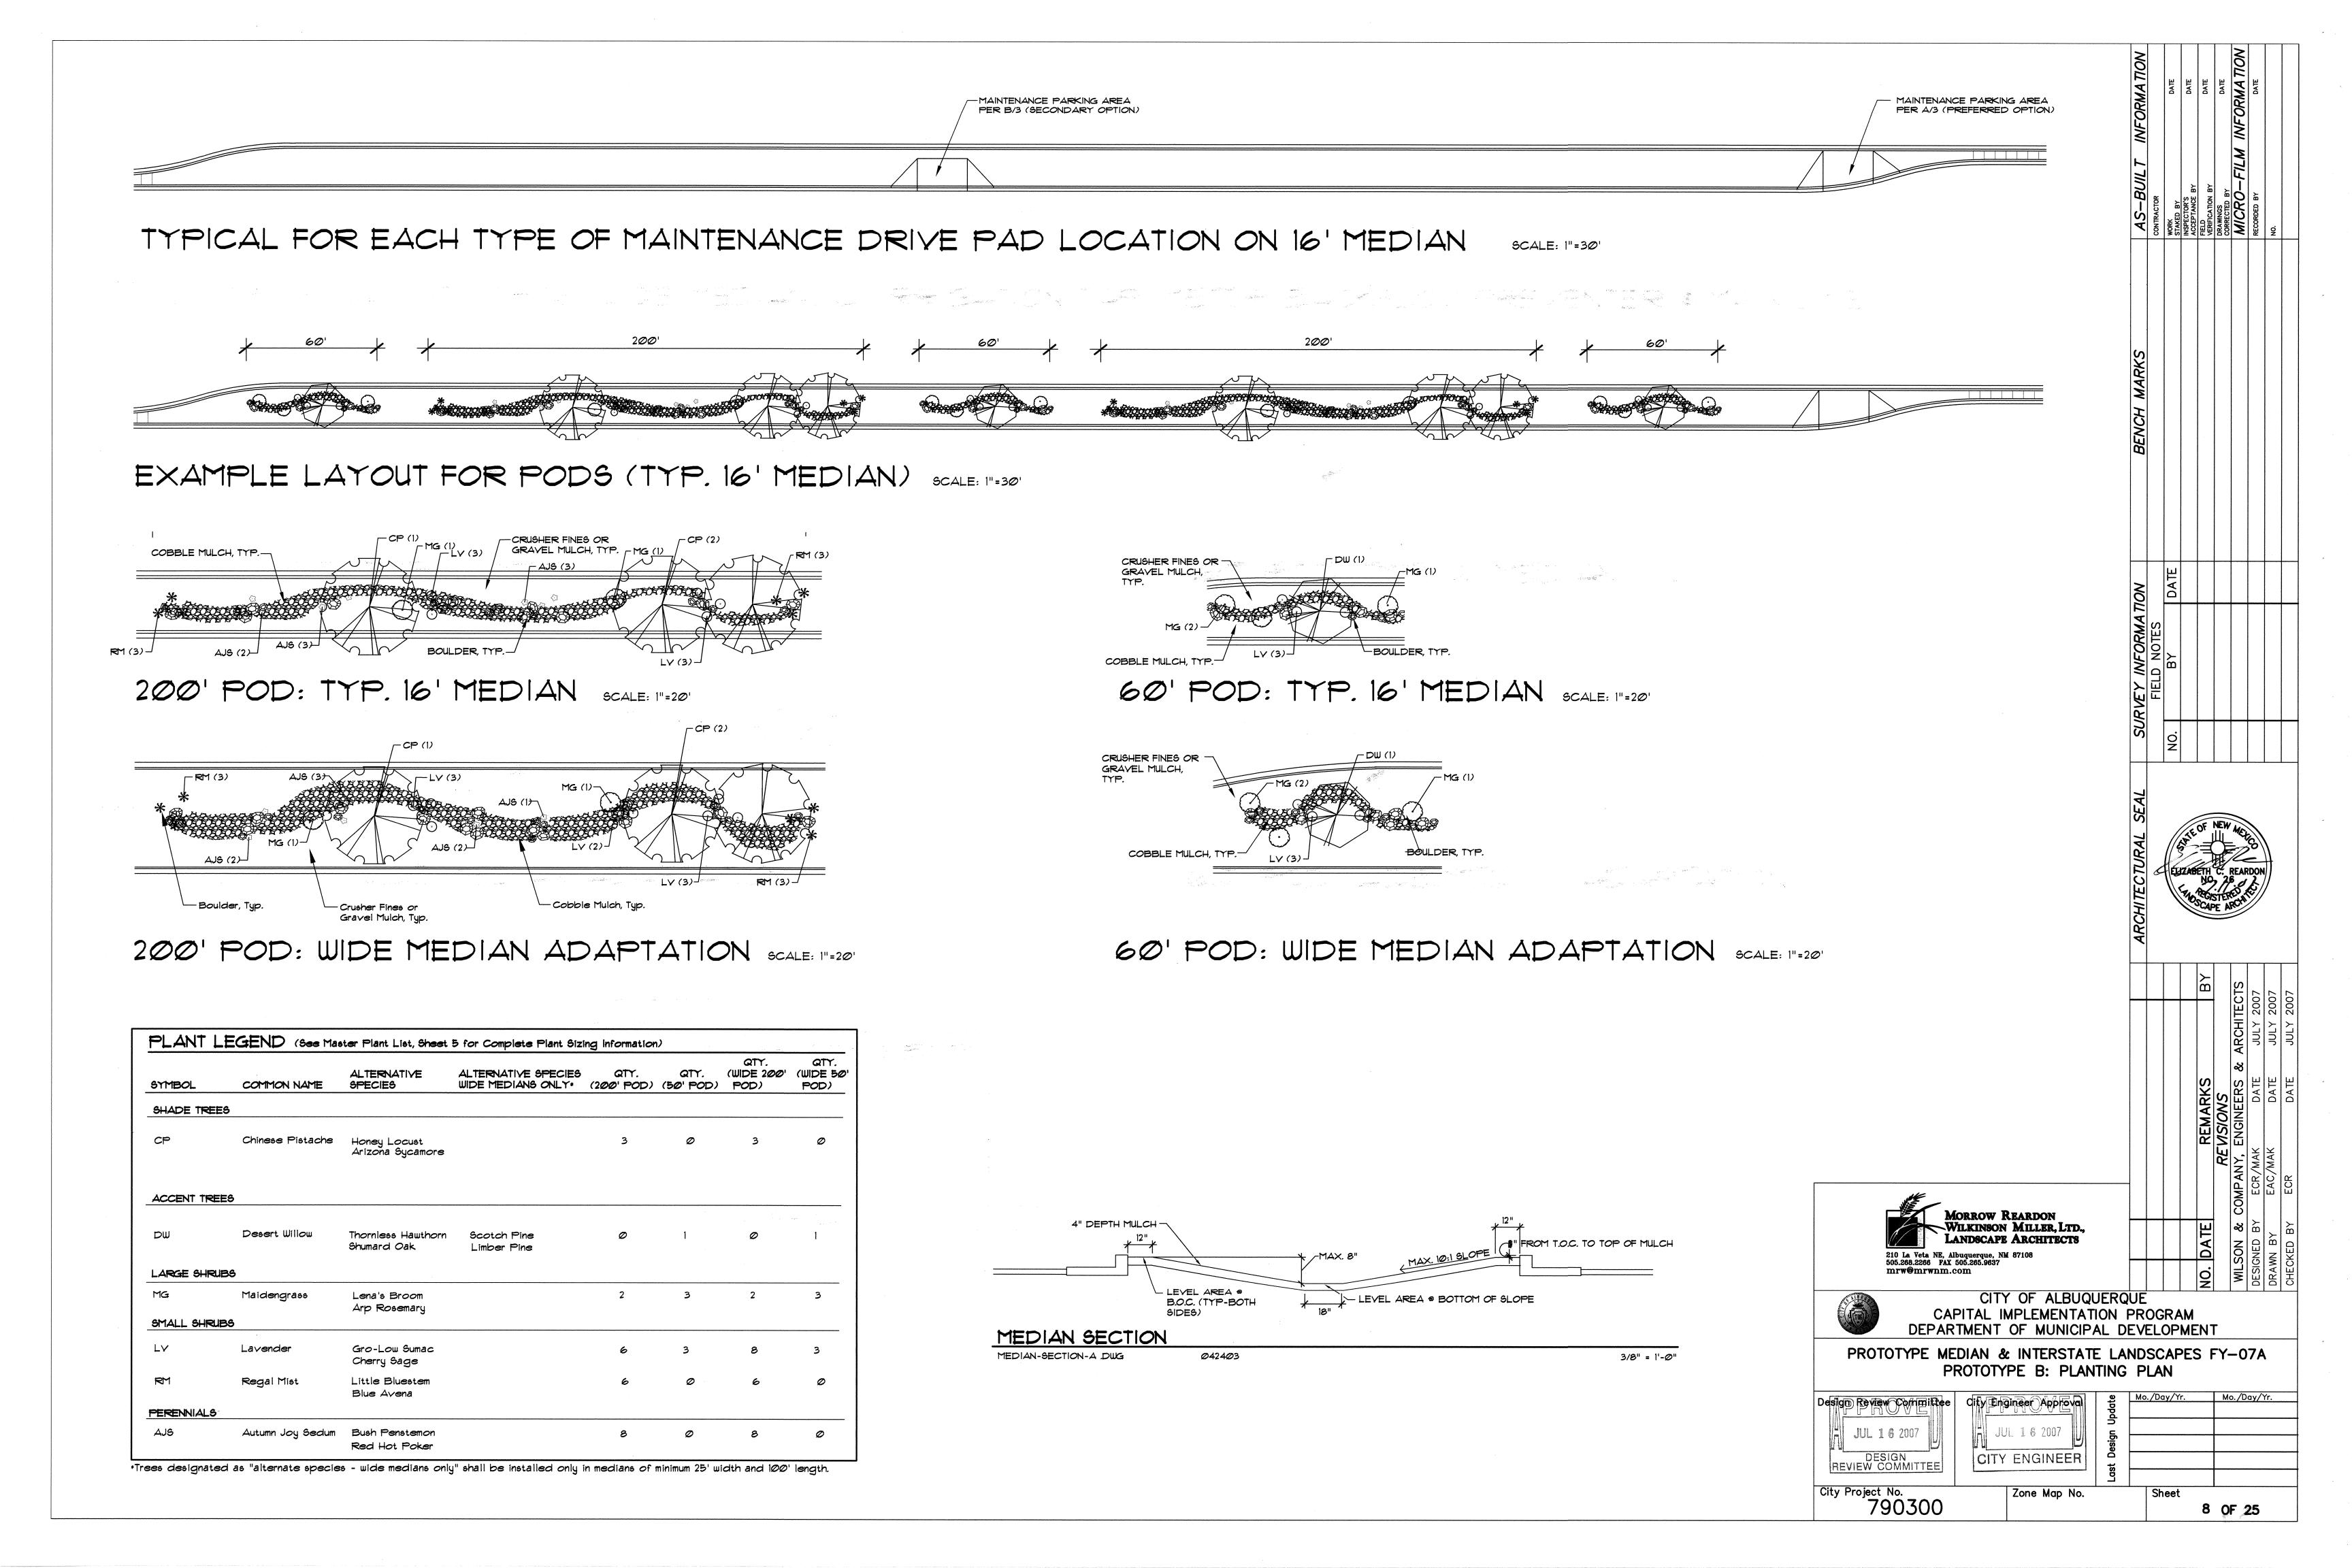

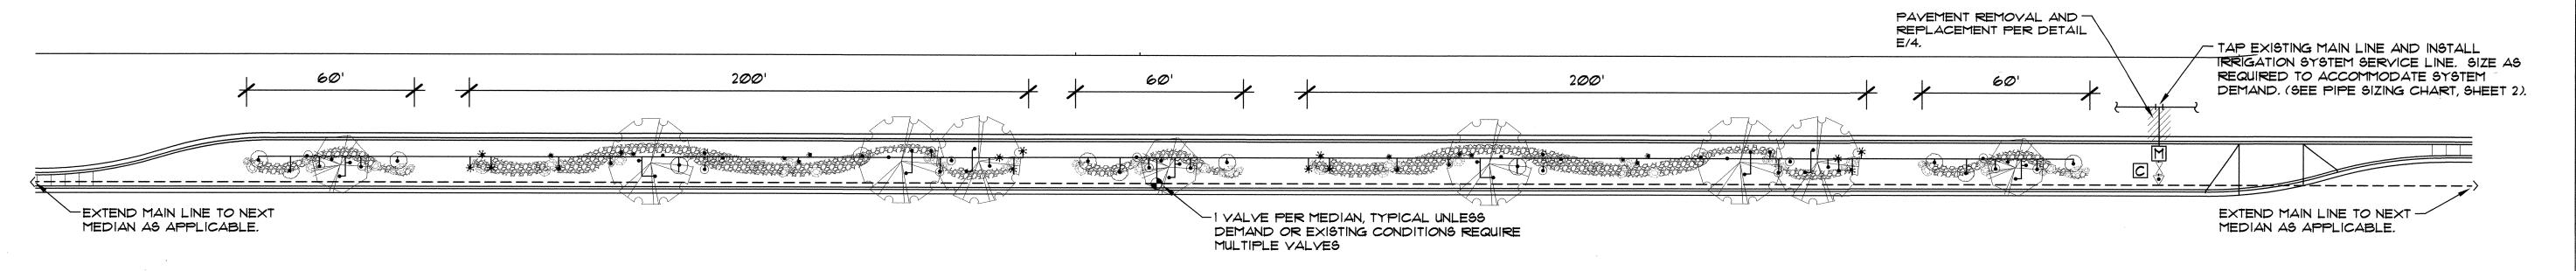
200' POD: TYP. 16' MEDIAN Scale: 1"=20'

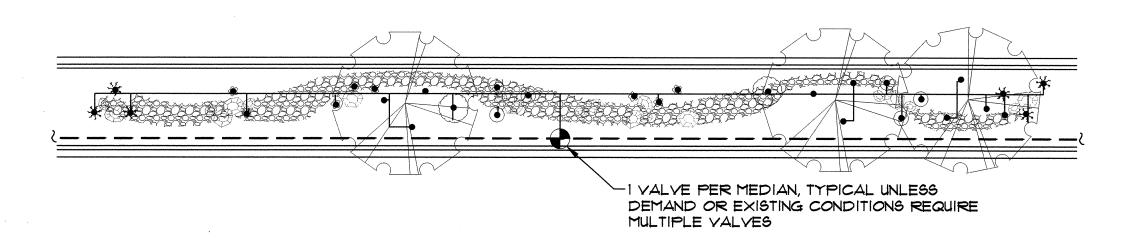

200' POD: WIDE MEDIAN ADAPTATION Scale: 1"=20"

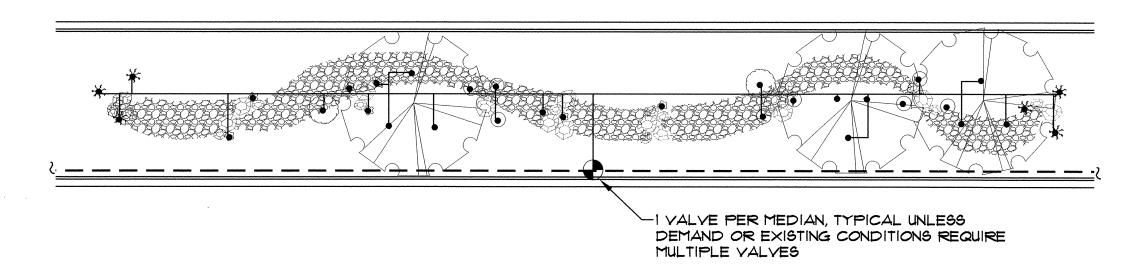

60' POD: TYP. 16' MEDIAN Scale: 1"=20'

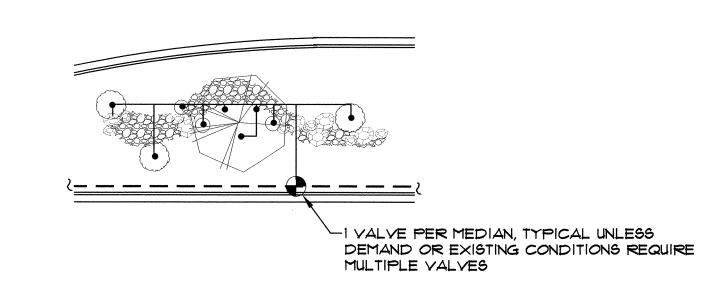

60' POD: WIDE MEDIAN ADAPTATION



IRRIGATION LEGEND

--- LATERAL PIPING, SCH. 40, BELL END, SOLVENT WELD PVC. DEPTH OF BURY, 18". SIZE PER PIPE SIZING CHART, SHEET 2.

- M ISOLATION VALVE ASSEMBLY, SIZE PER VALVE SIZING CHART, SHEET 2. INSTALL PER C.O.A. DRAWING NO. 2707.
- FEBCO 825YA REDUCED PRESSURE PRINCIPAL BACKFLOW PREVENTER AND MASTER VALVE ASSEMBLY WITH BALL VALVES, INSTALLED IN HEATED AND INSULATED ENCLOSURE AND MASTER METER INSTALLED IN VALVE BOX PER DETAIL C/4. SIZE OF RP, MASTER VALVE, AND MASTER METER SHALL BE SAME AS LINE SIZE. ENCLOSURE SHALL BE SIZED TO ACCOMMODATE SIZE OF RP AND MASTER VALVE ASSEMBLY.
- REMOTE CONTROL VALVE ASSEMBLY, RAINBIRD PEB PLASTIC BODY 24-VOLT
 AUTOMATIC VALVE, SIZE, PER VALVE SIZING CHART, SHEET 2. INSTALL PER C.O.A.
 DRAWING NO. 27∅3. (SIMILAR SEE IRRIGATION NOTES *25 AND *26, SHEET 2.)
- 50LVENT WELD CAP, SCH. 40 PVC, LINE SIZE.

PRESSURE COMPENSATING BUBBLER ASSEMBLIES, RAIN BIRD 1400 SERIES,
AS FOLLOWS: INSTALL PER C.O.A. DRAWING NUMBERS 2710, 2711, 2711-A AND 2712.

MODEL NO. GPM PSI

IRRINET AC, IRRINET DC, SCORPIO AC, OR SCORPIO DC, CONTROLLER WITH INTERSPEC ENCLOSURE AND DOMED ANTENNA. UNIT SHALL COMMUNICATE ON C.O.A. RADIO FREQUENCY (WIDE BAND). INSTALL PER DETAILS B/4 AND D/4. COORDINATE WITH CITY PROJECT MANAGER FOR TYPE OF CONTROLLER. SIZE AS REQUIRED TO ACCOMMODATE QUANTITY OF REMOTE CONTROL VALVES AND MASTER VALVE.

PROTOTYPE B GPM


 STANDARD 200' POD:
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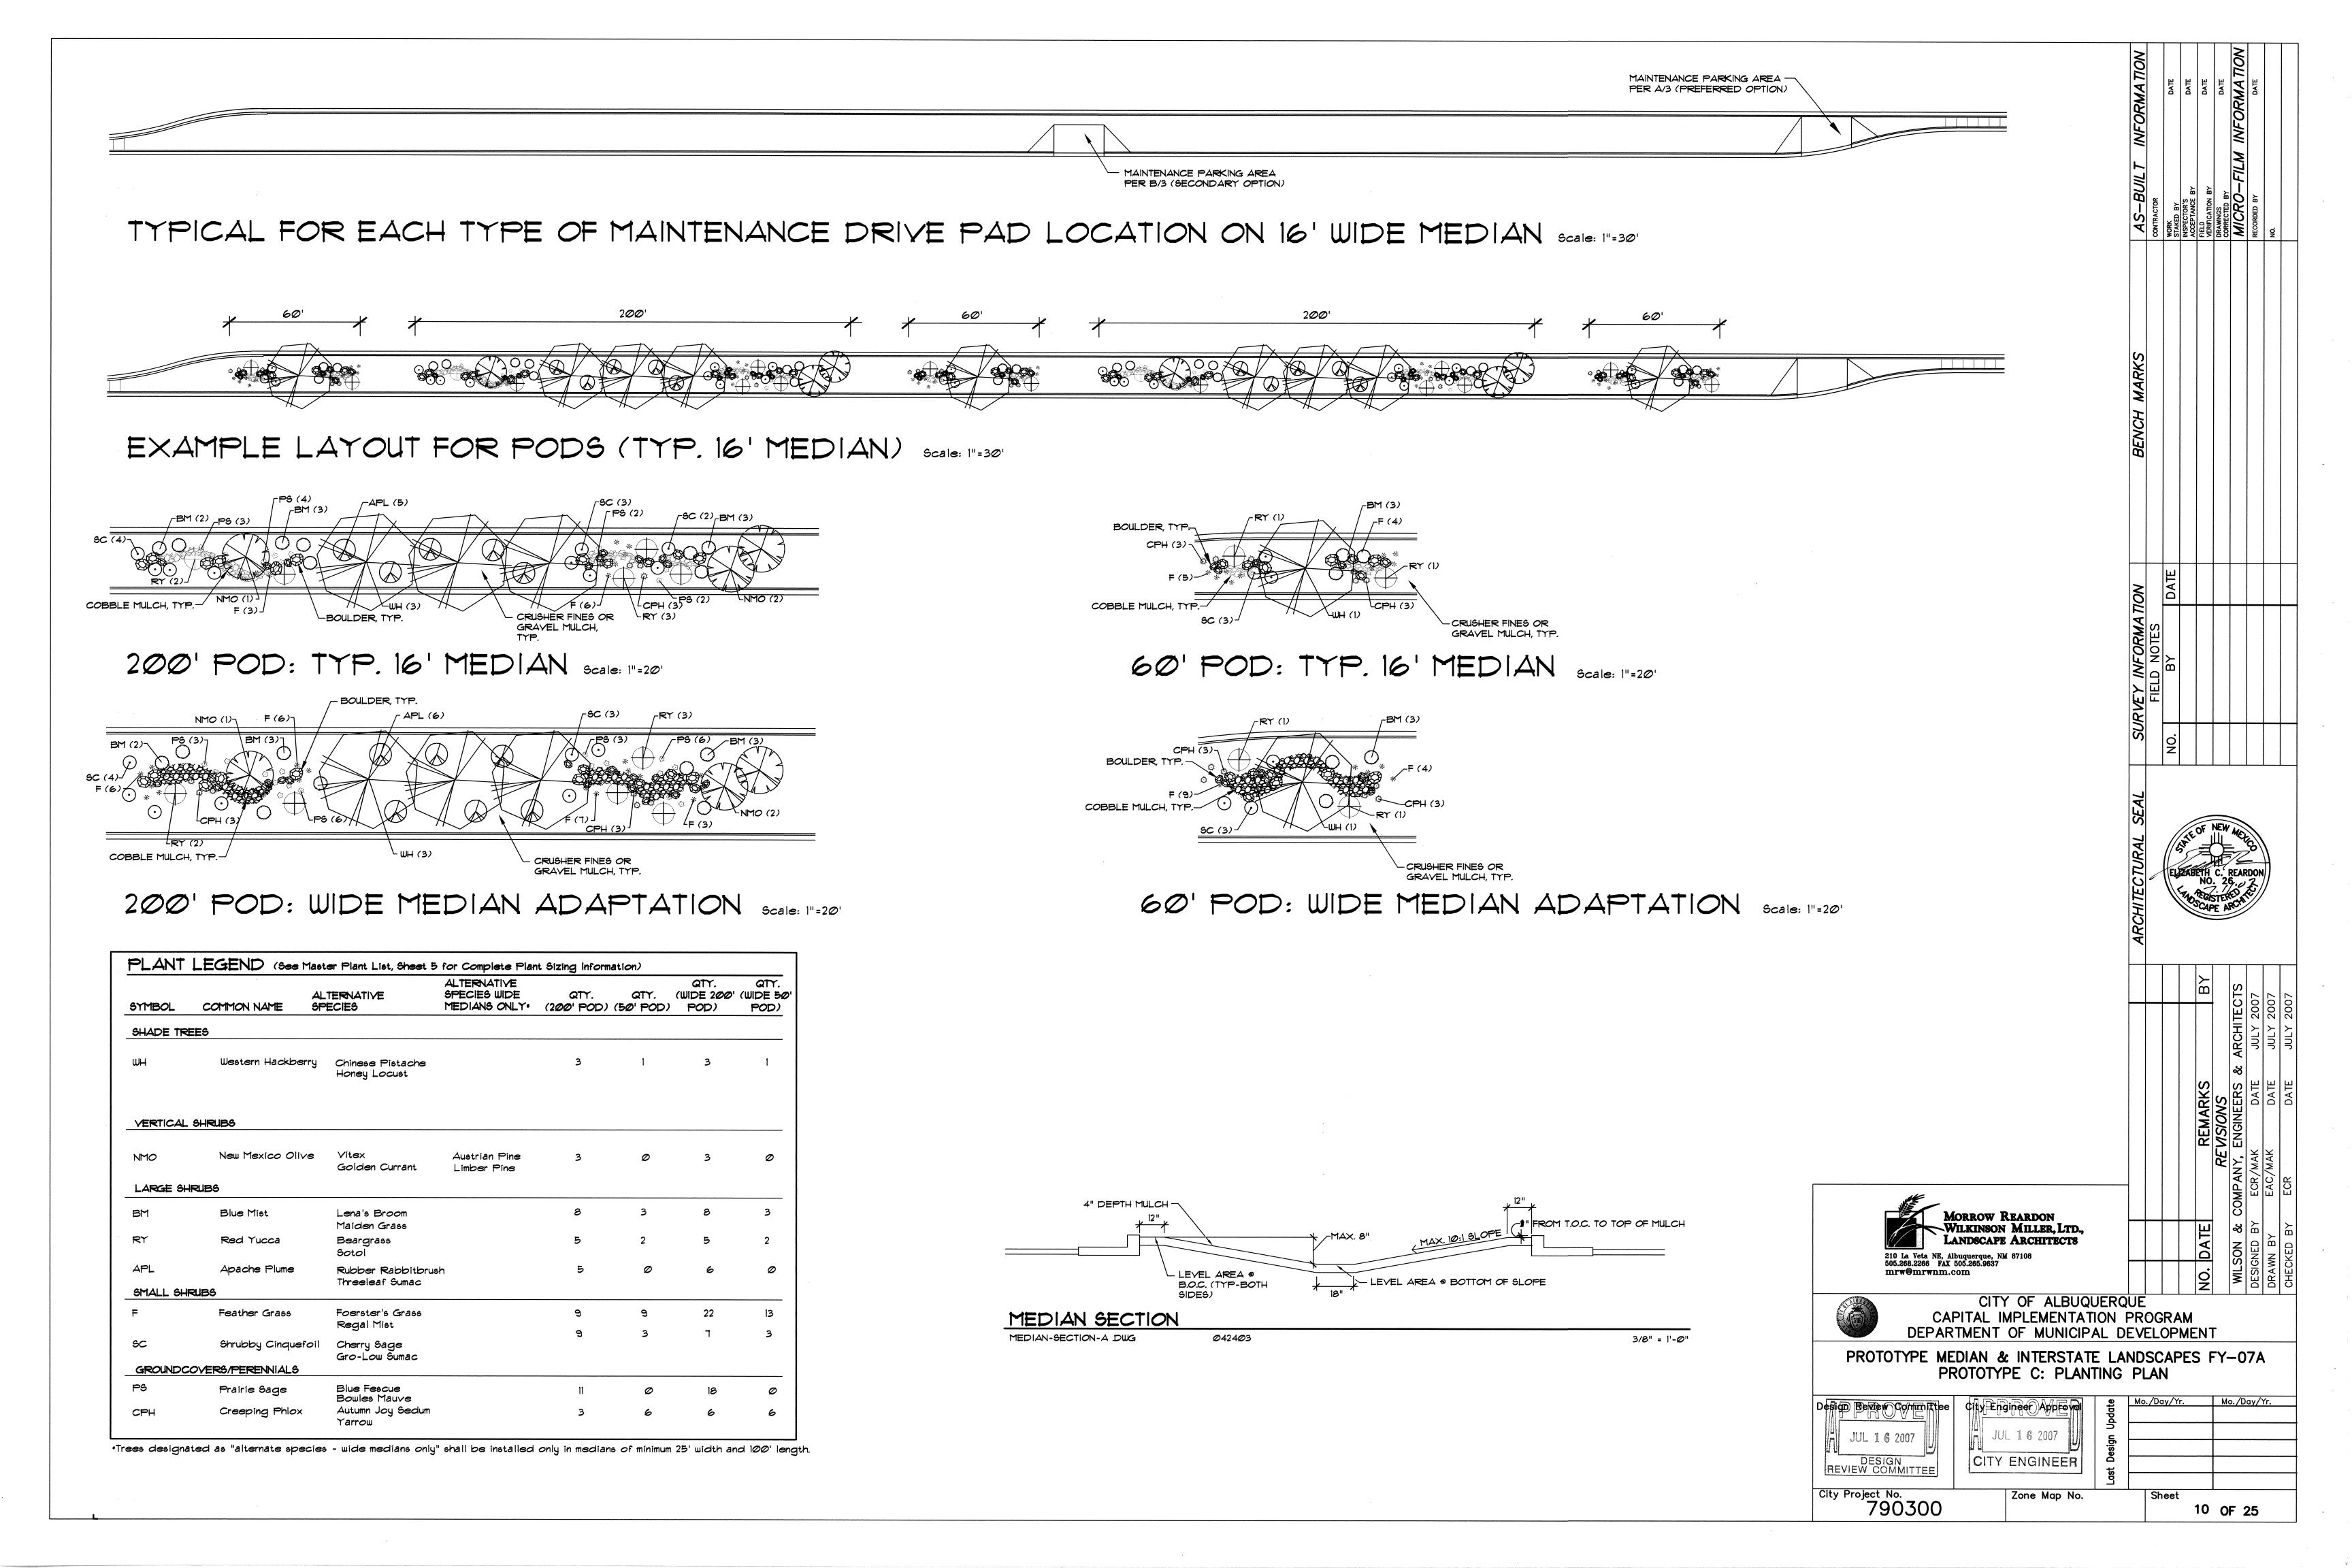
 STANDARD 50' POD:
 3


 WIDE MEDIAN 200' POD:
 9


WIDE MEDIAN 50' POD:

- SEE SHEET 2 FOR GENERAL IRRIGATION NOTES.
- 2. CONTRACTOR SHALL SIZE THE IRRIGATION COMPONENTS IN ACCORDANCE WITH THE IRRIGATION SIZING CRITERIA, SHEET 2.
- BUBBLERS ARE SHOWN DIRECTLY ON TOP OF SHRUBS FOR CLARITY OF DESIGN ONLY. BUBBLERS SHALL BE LOCATED 12" FROM THE SHRUB ROOT BALL.
- UNIT PRICE BID ITEM FOR EACH POD INCLUDES BUBBLERS AND RELATED INCIDENTAL COMPONENTS ONLY. BALANCE OF IRRIGATION COMPONENTS (MAIN LINE, WIRE, BACKFLOW PREVENTER, GATE VALVE, METER, TAP, SERVICE LINE, CONTROL VALVES & LATERAL LINES) ARE BID AS SEPARATE UNIT BID ITEMS. FITTINGS AND OTHER IRRIGATION COMPONENTS REQUIRED TO INSTALL INDIVIDUAL BID ITEMS SHALL BE INCIDENTAL TO THE WORK AND INCLUDED AT NO ADDITIONAL COST TO THE OWNER.




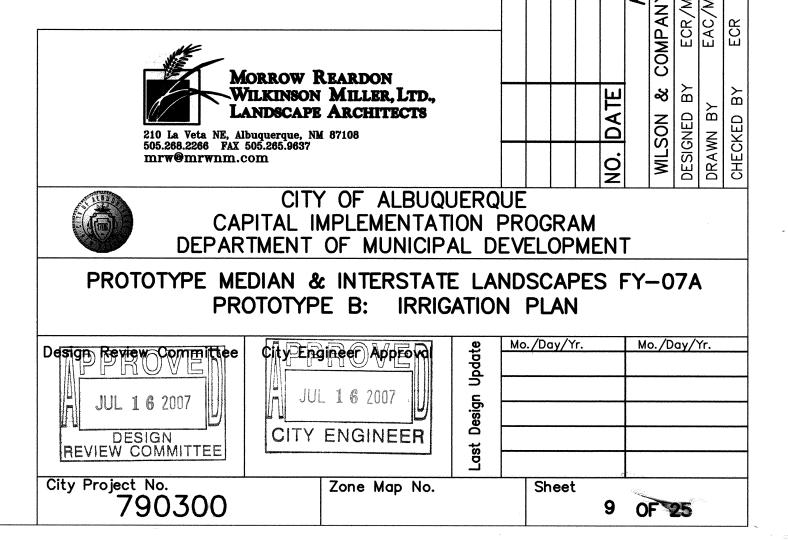

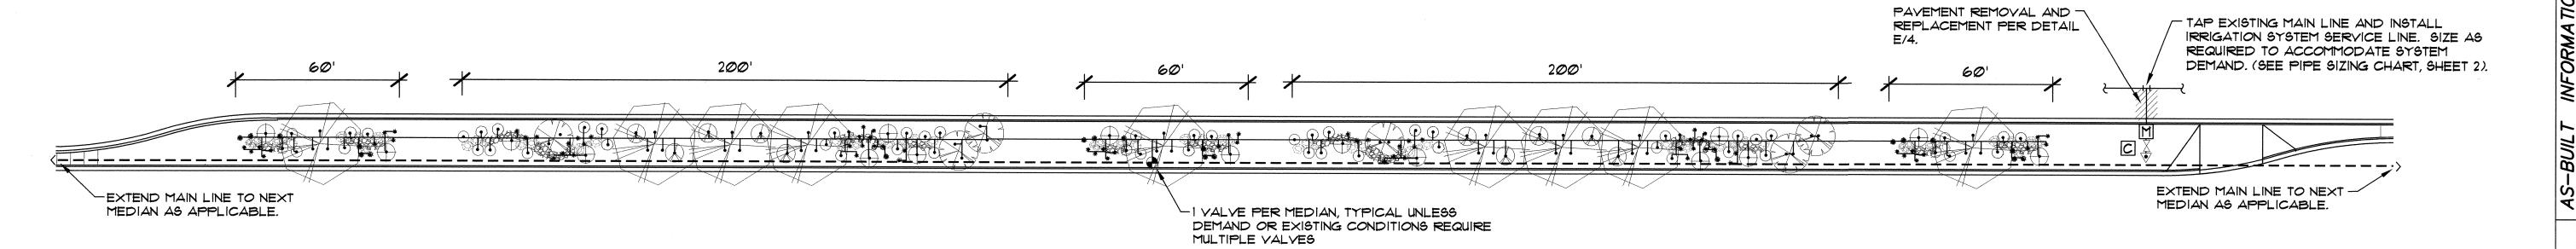


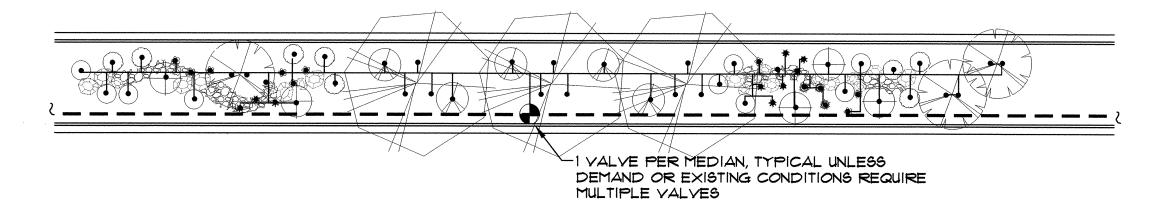

200' POD: TYP. 16' MEDIAN Scale: 1"=20'

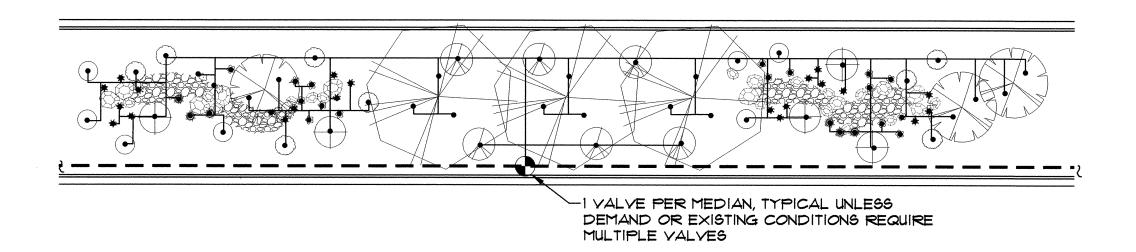


200' POD: WIDE MEDIAN ADAPTATION Scale: 1"=20"

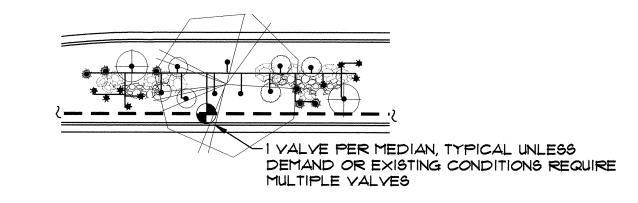

60' POD: TYP. 16' MEDIAN ...

Scale: 1"=20

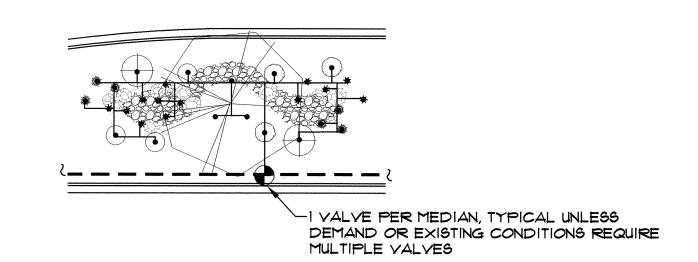

60' POD: WIDE MEDIAN ADAPTATION

Scale: 1"=2

IRRIGATION LEGEND

- M WATER METER PER COA DWG. 2362 OR 2363. SIZE PER METER SIZING CHART, SHEET 2.

 IRRIGATION MAIN LINE, SCH 40 BELL END, SOLVENT WELD PVC. DEPTH OF SHALL BE BURY 28" FOR CONTINUOUS PRESSURE IRRIGATION MAIN LINE AND 18" DEPTH OF BURY FOR NON-CONTINUOUS PRESSURE. SIZE PER PIPE SIZING CHART, SHEET 2.
- M ISOLATION VALVE ASSEMBLY, SIZE PER VALVE SIZING CHART, SHEET 2. INSTALL PER C.O.A. DRAWING NO. 2707.
- FEBCO 825YA REDUCED PRESSURE PRINCIPAL BACKFLOW PREVENTER AND MASTER VALVE ASSEMBLY WITH BALL VALVES, INSTALLED IN HEATED AND INSULATED ENCLOSURE AND MASTER METER INSTALLED IN VALVE BOX PER DETAIL C/4. SIZE OF RP, MASTER VALVE, AND MASTER METER SHALL BE SAME AS LINE SIZE. ENCLOSURE SHALL BE SIZED TO ACCOMMODATE SIZE OF RP AND MASTER VALVE ASSEMBLY.
- REMOTE CONTROL VALVE ASSEMBLY, RAINBIRD PEB PLASTIC BODY 24-VOLT
 AUTOMATIC VALVE, SIZE, PER VALVE SIZING CHART, SHEET 2. INSTALL PER C.O.A.
 DRAWING NO. 2703. (SIMILAR SEE IRRIGATION NOTES #25 AND #26, SHEET 2.)
- BOLVENT WELD CAP, SCH. 40 PVC, LINE SIZE.

PRESSURE COMPENSATING BUBBLER ASSEMBLIES, RAIN BIRD 1400 SERIES, AS FOLLOWS: INSTALL PER C.O.A. DRAWING NUMBERS 2710, 2711, 2711-A AND 2712.

MODEL NO. GPM PSI

IRRINET AC, IRRINET DC, SCORPIO AC, OR SCORPIO DC, CONTROLLER WITH INTERSPEC ENCLOSURE AND DOMED ANTENNA. UNIT SHALL COMMUNICATE ON C.O.A. RADIO FREQUENCY (WIDE BAND). INSTALL PER DETAILS B/4 AND D/4. COORDINATE WITH CITY PROJECT MANAGER FOR TYPE OF CONTROLLER. SIZE AS REQUIRED TO ACCOMMODATE QUANTITY OF REMOTE CONTROL VALVES AND MASTER VALVE.

PROTOTYPE C GPM


STANDARD 200' POD: 19
STANDARD 50' POD: 1


WIDE MEDIAN 200' POD: 20


WIDE MEDIAN 50' POD:

- SEE SHEET 2 FOR GENERAL IRRIGATION NOTES.
- CONTRACTOR SHALL SIZE THE IRRIGATION COMPONENTS IN ACCORDANCE WITH THE IRRIGATION SIZING CRITERIA, SHEET 2.
- 3. BUBBLERS ARE SHOWN DIRECTLY ON TOP OF SHRUBS FOR CLARITY OF DESIGN ONLY. BUBBLERS SHALL BE LOCATED 12" FROM THE SHRUB ROOT BALL.
- 4. UNIT PRICE BID ITEM FOR EACH POD INCLUDES BUBBLERS AND RELATED INCIDENTAL COMPONENTS ONLY. BALANCE OF IRRIGATION COMPONENTS (MAIN LINE, WIRE, BACKFLOW PREVENTER, GATE VALVE, METER, TAP, SERVICE LINE, CONTROL VALVES & LATERAL LINES) ARE BID AS SEPARATE UNIT BID ITEMS. FITTINGS AND OTHER IRRIGATION COMPONENTS REQUIRED TO INSTALL INDIVIDUAL BID ITEMS SHALL BE INCIDENTAL TO THE WORK AND INCLUDED AT NO ADDITIONAL COST TO THE OWNER.



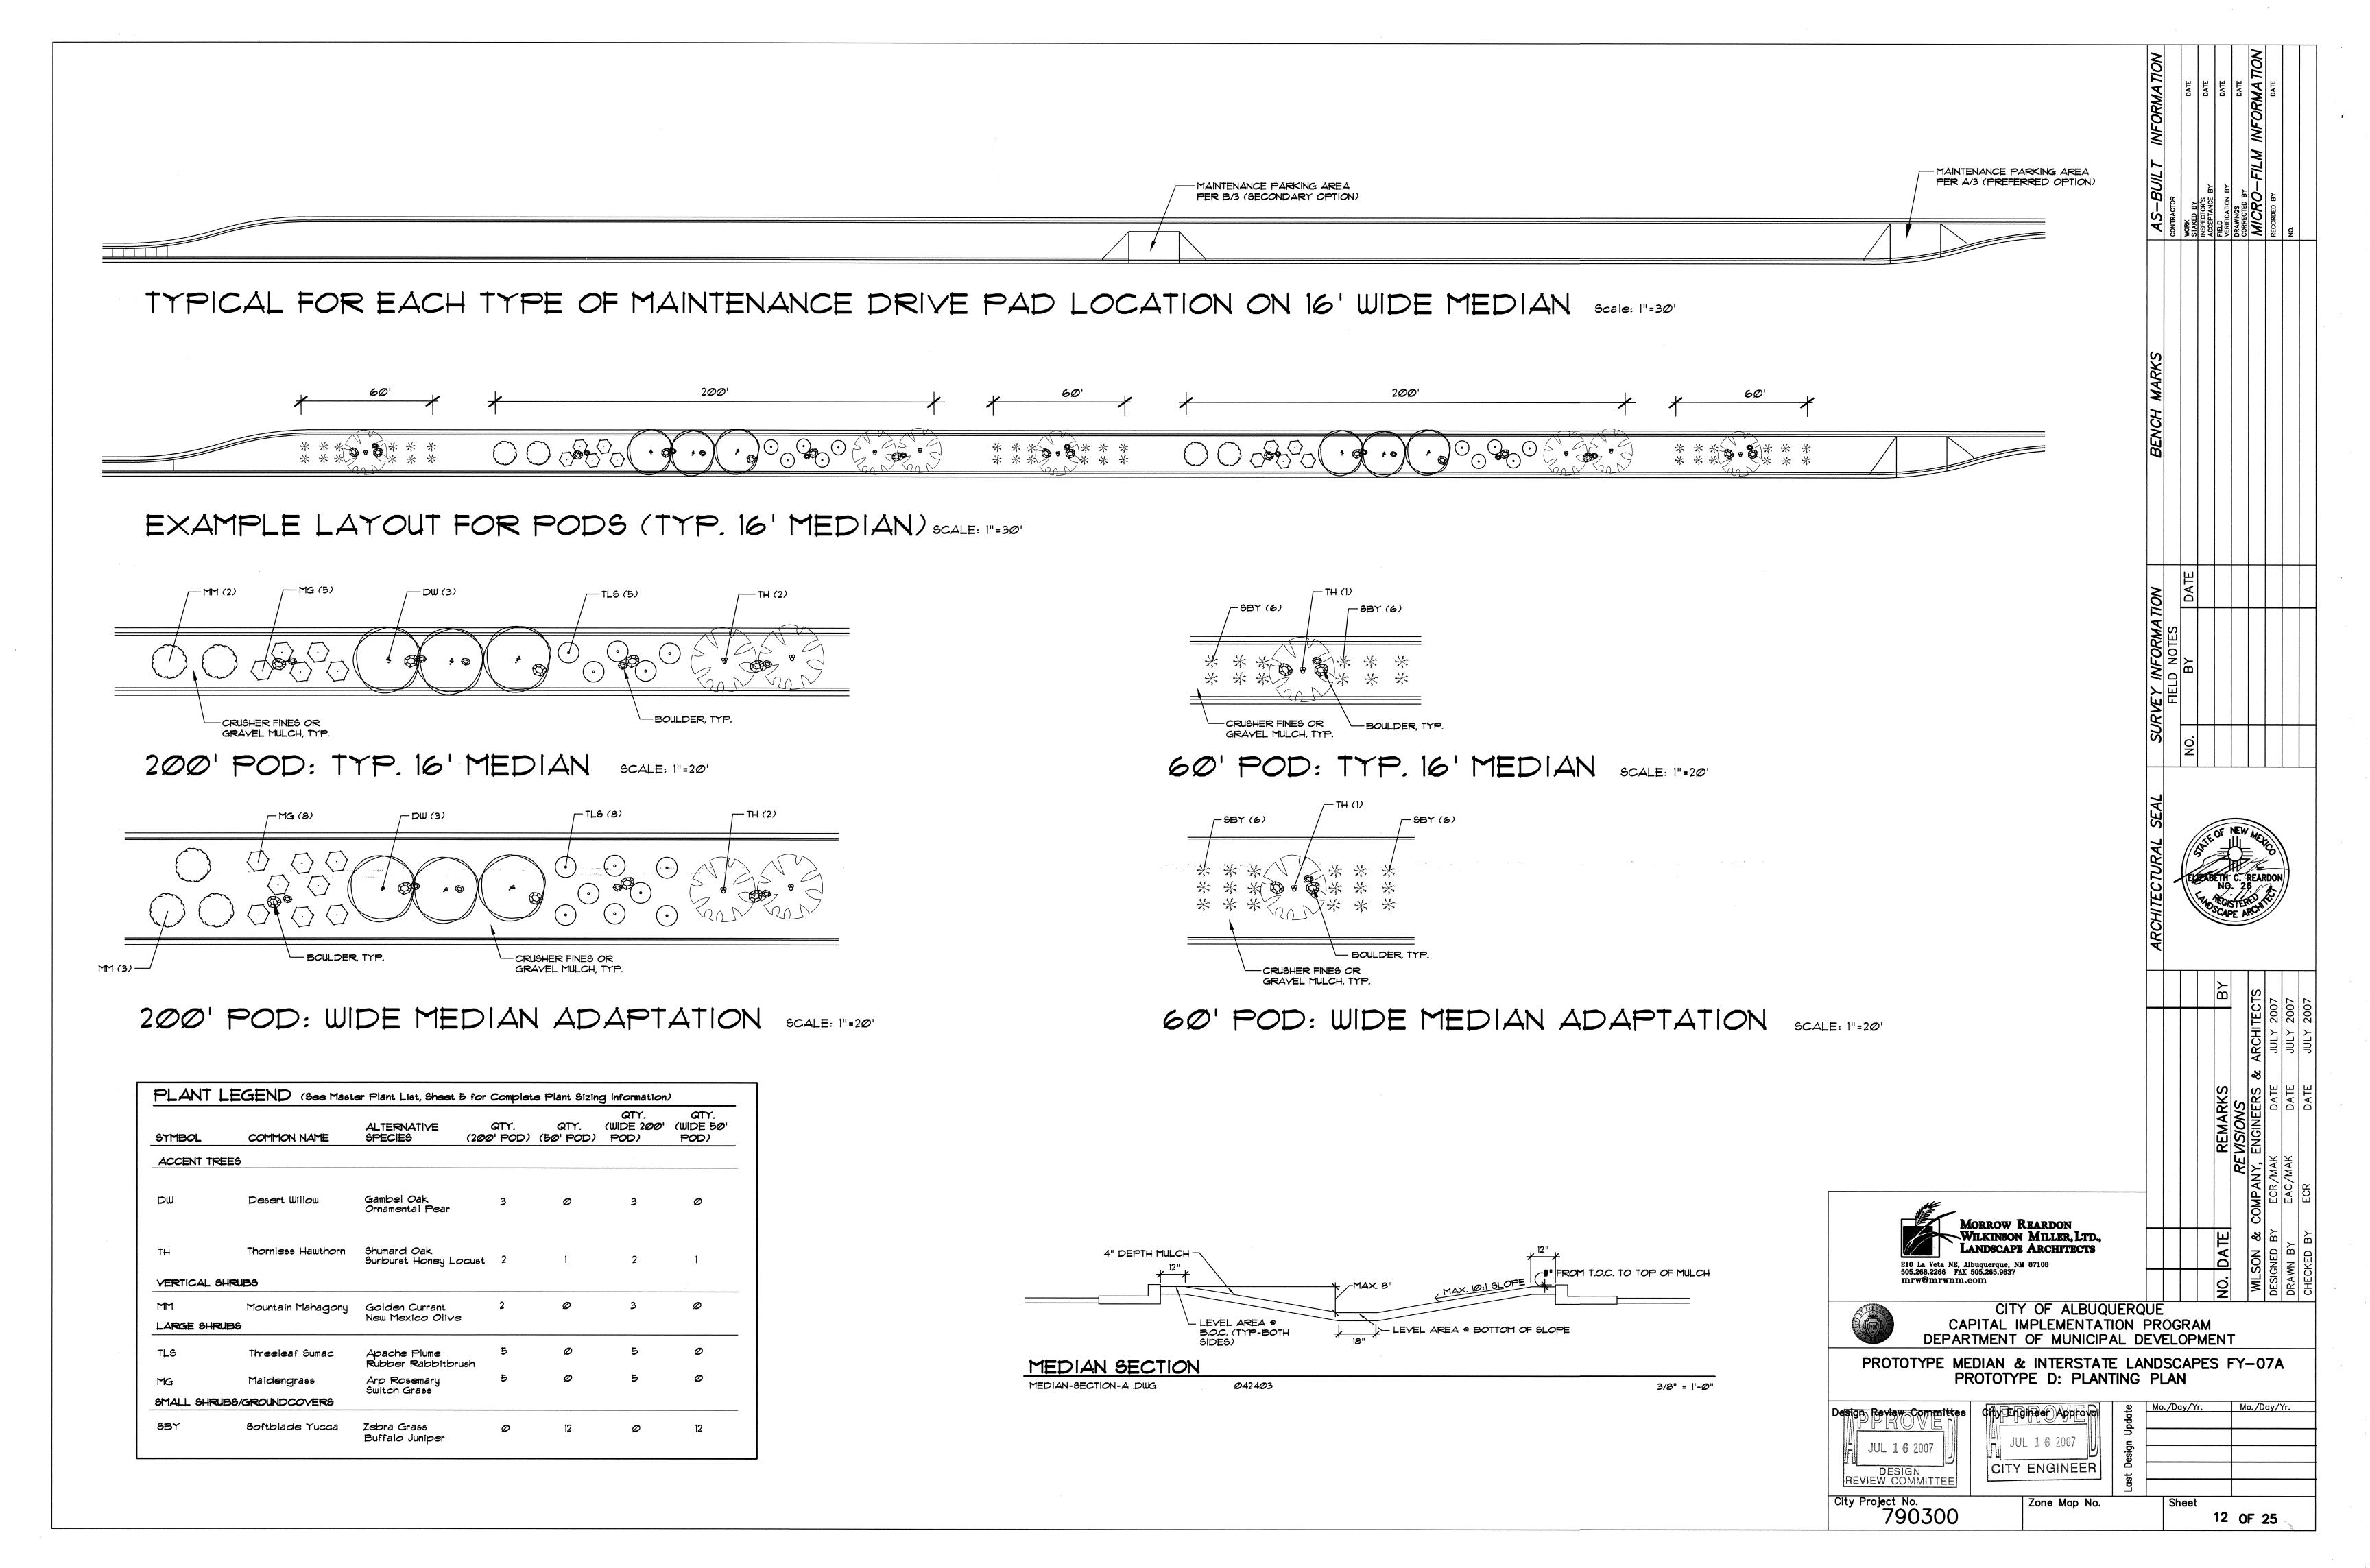


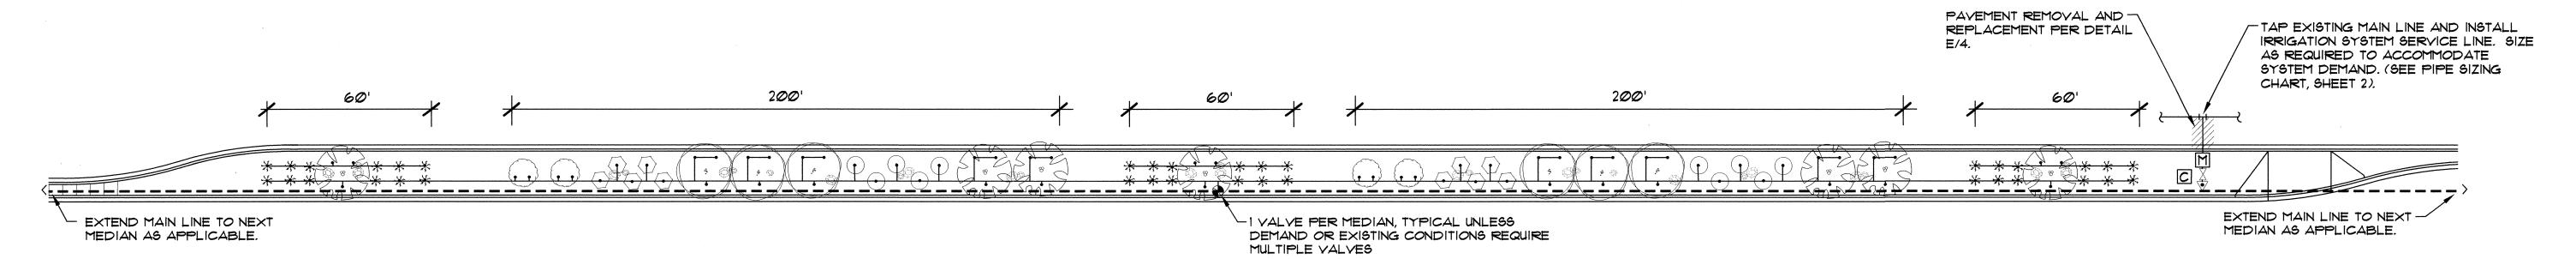

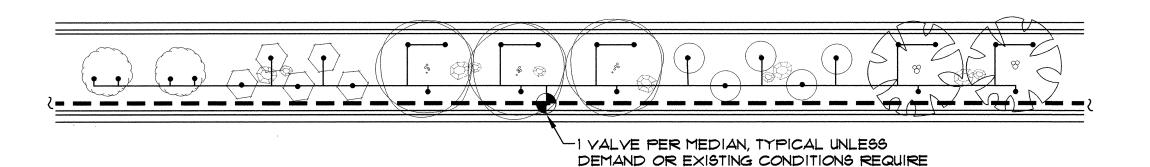


MULTIPLE VALVES

200' POD: TYP. 16' MEDIAN Scale: 1"=20'

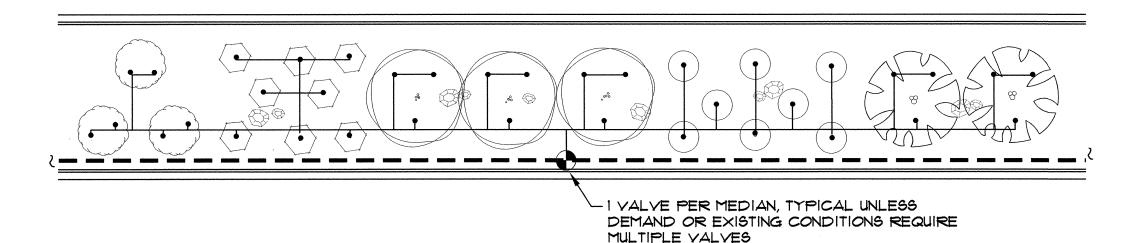


200' POD: WIDE MEDIAN ADAPTATION Scale: 1"=20"

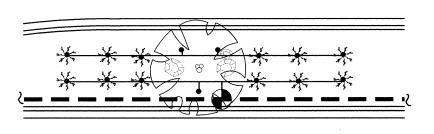

I VALVE PER MEDIAN, TYPICAL UNLESS DEMAND OR EXISTING CONDITIONS REQUIRE MULTIPLE VALVES

60' POD: TYP. 16' MEDIAN Scale: 1"=20"

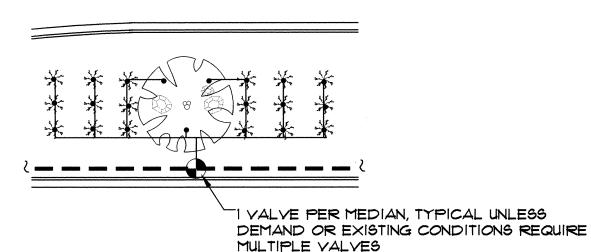

60' POD: WIDE MEDIAN ADAPTATION Scale: 1"=20"

ARCHITECTURAL SEAL SEAL NO. 28. C. REALDON NO. 28. C. S. C.

IRRIGATION LEGEND

- M WATER METER PER COA DWG. 2362 OR 2363. SIZE PER METER SIZING CHART, SHEET 2.

 IRRIGATION MAIN LINE, SCH 40 BELL END, SOLVENT WELD PVC. DEPTH OF SHALL BE BURY
 28" FOR CONTINUOUS PRESSURE IRRIGATION MAIN LINE AND 18" DEPTH OF BURY FOR

NON-CONTINUOUS PRESSURE. SIZE PER PIPE SIZING CHART, SHEET 2.

- ISOLATION VALVE ASSEMBLY, SIZE PER VALVE SIZING CHART, SHEET 2. INSTALL PER C.O.A. DRAWING NO. 2707.
- FEBCO 825YA REDUCED PRESSURE PRINCIPAL BACKFLOW PREVENTER AND MASTER VALVE ASSEMBLY WITH BALL VALVES, INSTALLED IN HEATED AND INSULATED ENCLOSURE AND MASTER METER INSTALLED IN VALVE BOX PER DETAIL C/4. SIZE OF RP, MASTER VALVE, AND MASTER METER SHALL BE SAME AS LINE SIZE. ENCLOSURE SHALL BE SIZED TO ACCOMMODATE SIZE OF RP AND MASTER VALVE ASSEMBLY.
- REMOTE CONTROL VALVE ASSEMBLY, RAINBIRD PEB PLASTIC BODY 24-VOLT
 AUTOMATIC VALVE, SIZE, PER VALVE SIZING CHART, SHEET 2. INSTALL PER C.O.A.
 DRAWING NO. 2703. (SIMILAR SEE IRRIGATION NOTES ★25 AND ★26, SHEET 2.)
- 50LVENT WELD CAP, SCH. 40 PVC, LINE SIZE.

PRESSURE COMPENSATING BUBBLER ASSEMBLIES, RAIN BIRD 1400 SERIES, AS FOLLOWS: INSTALL PER C.O.A. DRAWING NUMBERS 2710, 2711, 2711-A AND 2712.

MODEL NO. GPM PSI

IRRINET AC, IRRINET DC, SCORPIO AC, OR SCORPIO DC, CONTROLLER WITH INTERSPEC ENCLOSURE AND DOMED ANTENNA. UNIT SHALL COMMUNICATE ON C.O.A. RADIO FREQUENCY (WIDE BAND). INSTALL PER DETAILS B/4 AND D/4. COORDINATE WITH CITY PROJECT MANAGER FOR TYPE OF CONTROLLER. SIZE AS REQUIRED TO ACCOMMODATE QUANTITY OF REMOTE CONTROL VALVES AND MASTER VALVE.

PROTOTYPE D GPM

STANDARD 200' POD: 8


STANDARD 50' POD: 4

WIDE MEDIAN 200' POD: 10

WIDE MEDIAN 50' POD: 6

IRRIGATION NOTES

- SEE SHEET 2 FOR GENERAL IRRIGATION NOTES.
- 2. CONTRACTOR SHALL SIZE THE IRRIGATION COMPONENTS IN ACCORDANCE WITH THE IRRIGATION SIZING CRITERIA, SHEET 2.
- 3. BUBBLERS ARE SHOWN DIRECTLY ON TOP OF SHRUBS FOR CLARITY OF DESIGN ONLY. BUBBLERS SHALL BE LOCATED 12" FROM THE SHRUB ROOT BALL.
- 4. UNIT PRICE BID ITEM FOR EACH POD INCLUDES BUBBLERS AND RELATED INCIDENTAL COMPONENTS ONLY. BALANCE OF IRRIGATION COMPONENTS (MAIN LINE, WIRE, BACKFLOW PREVENTER, GATE VALVE, METER, TAP, SERVICE LINE, CONTROL VALVES & LATERAL LINES) ARE BID AS SEPARATE UNIT BID ITEMS. FITTINGS AND OTHER IRRIGATION COMPONENTS REQUIRED TO INSTALL INDIVIDUAL BID ITEMS SHALL BE INCIDENTAL TO THE WORK AND INCLUDED AT NO ADDITIONAL COST TO THE OWNER.

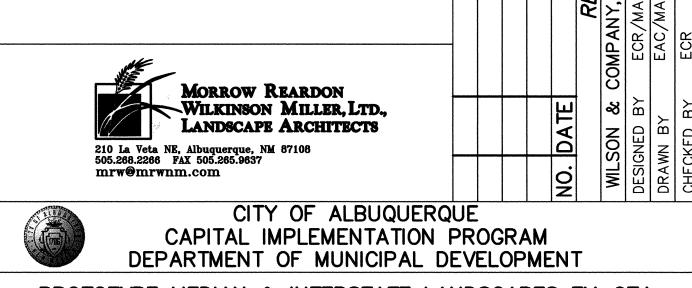

PROTOTYPE MEDIAN & INTERSTATE LANDSCAPES FY-07A PROTOTYPE D: IRRIGATION PLAN

JUL 1 6 2007

DESIGN
REVIEW COMMITTEE

JUL 1 6 2007


CITY ENGINEER


Mo./Day/Yr. Mo./Day/Yr.


City Project No. 790300

Zone Map No.


13 OF 25

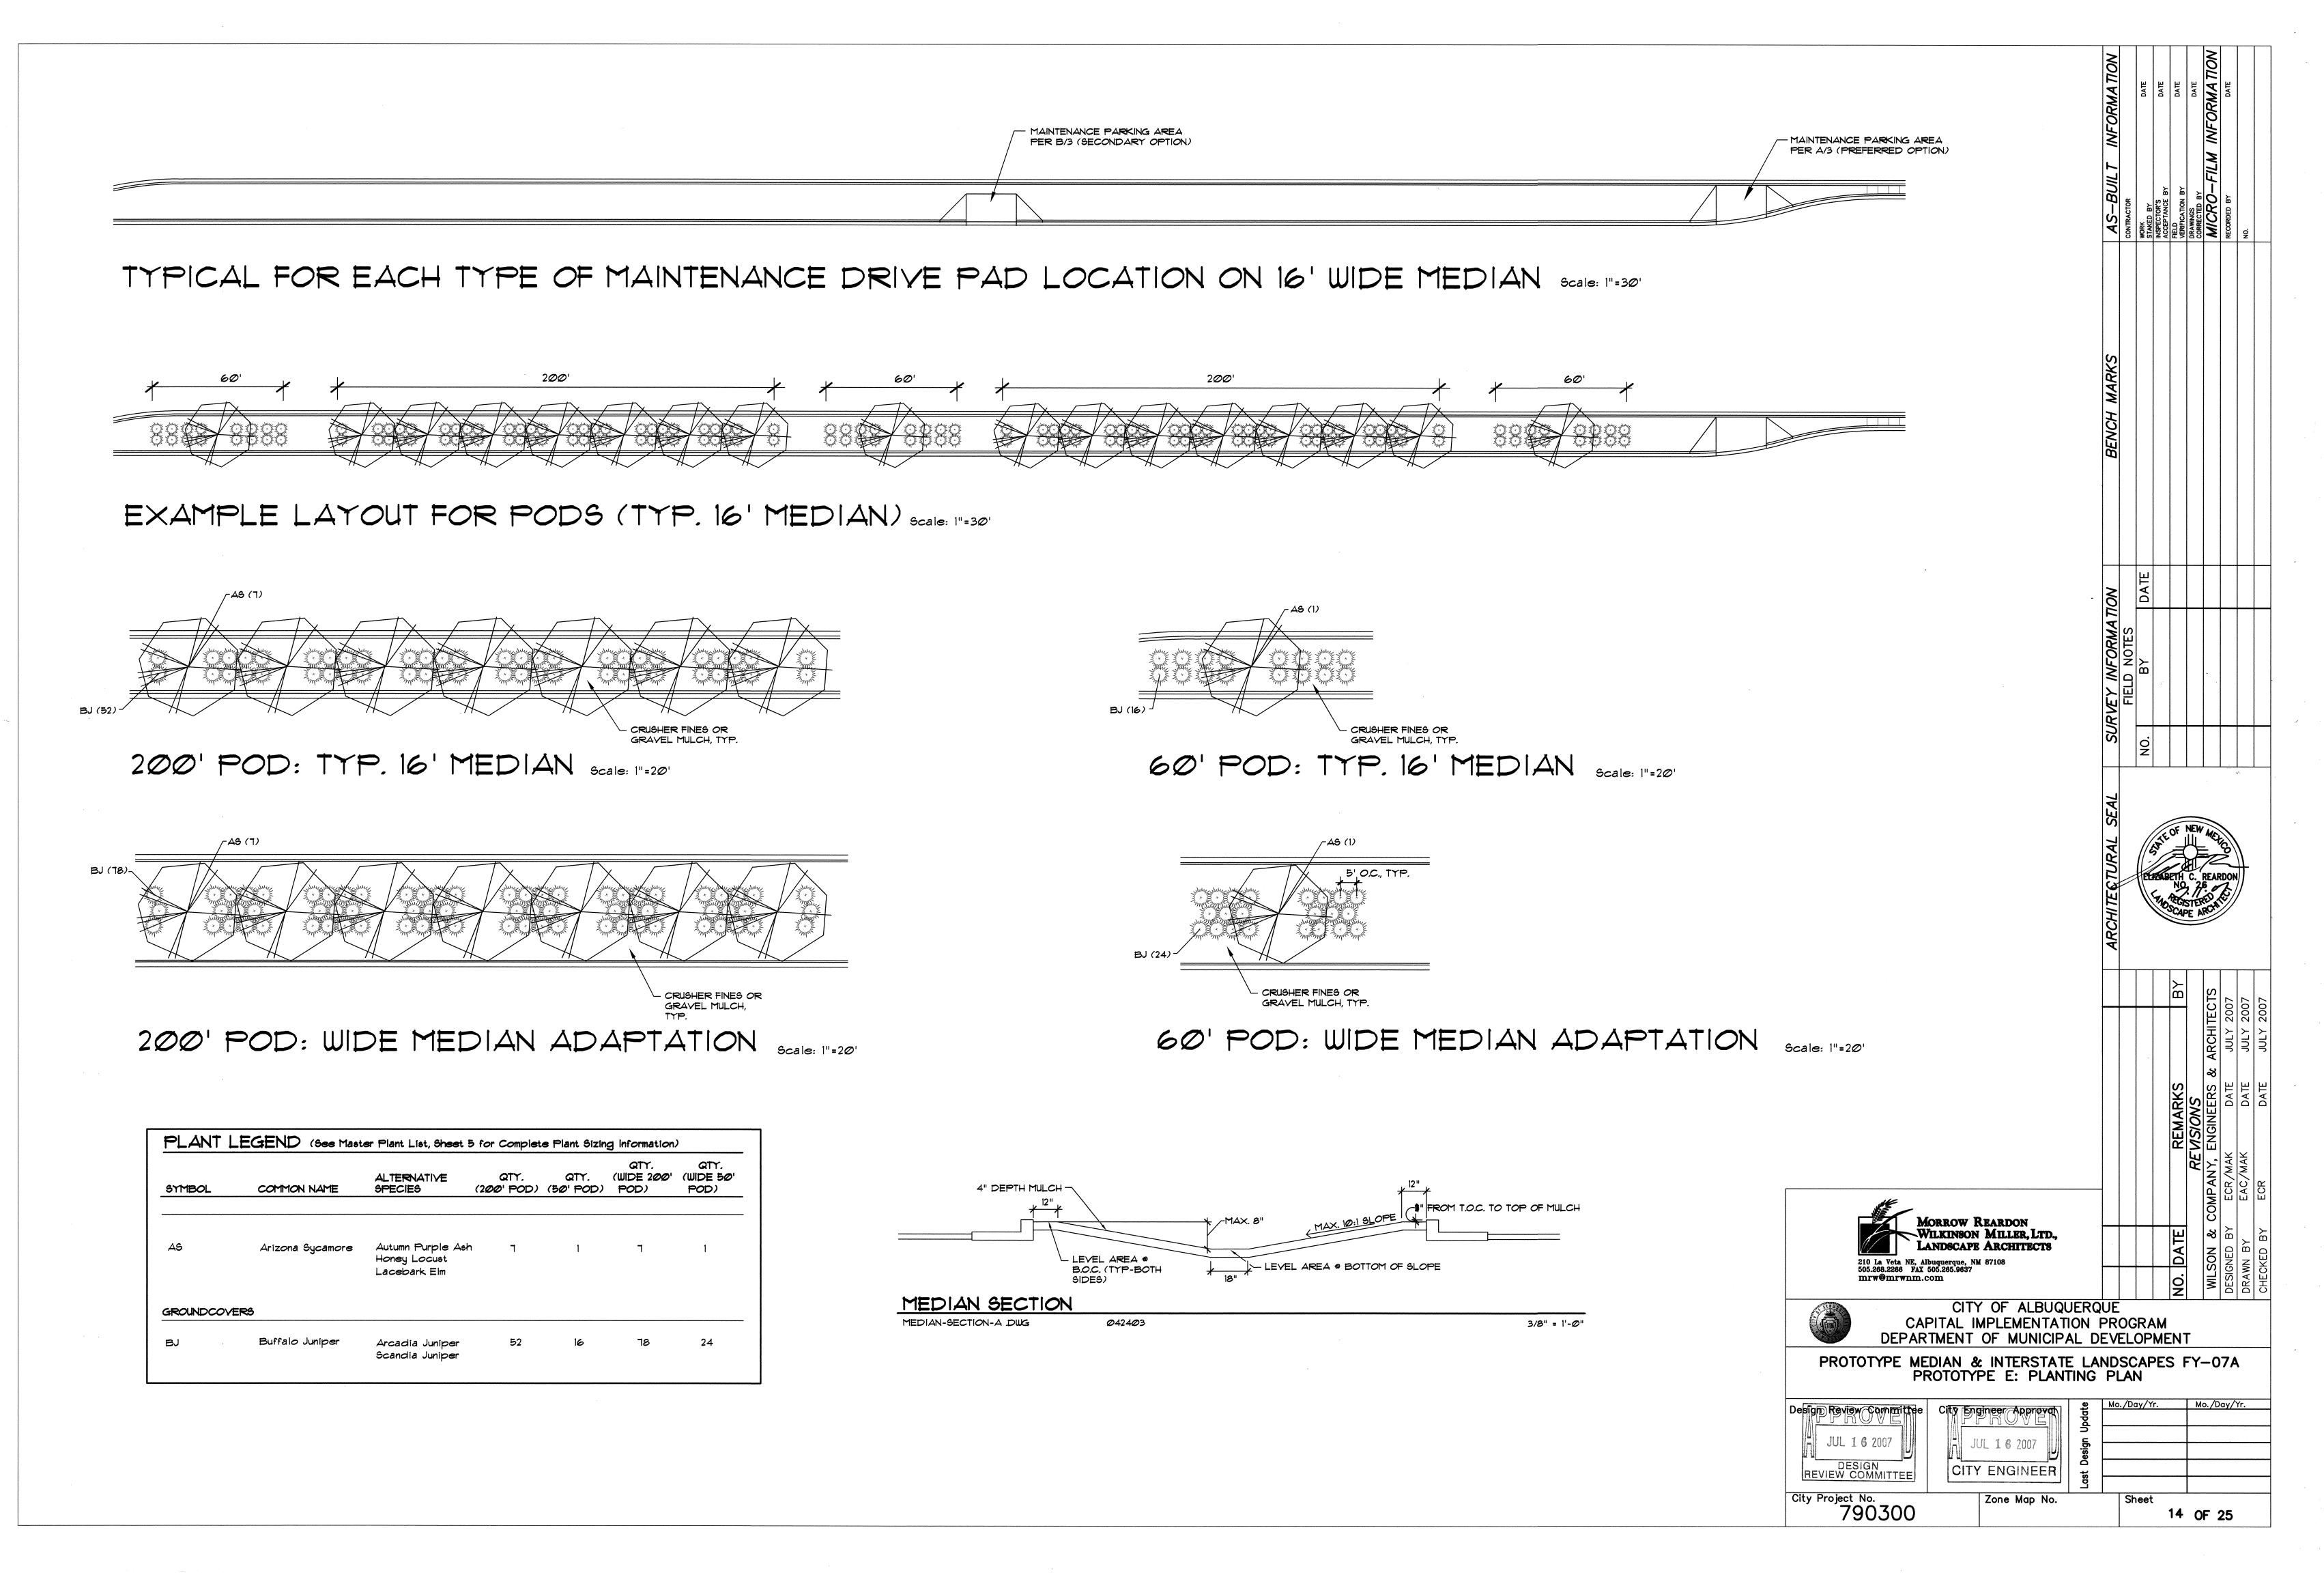

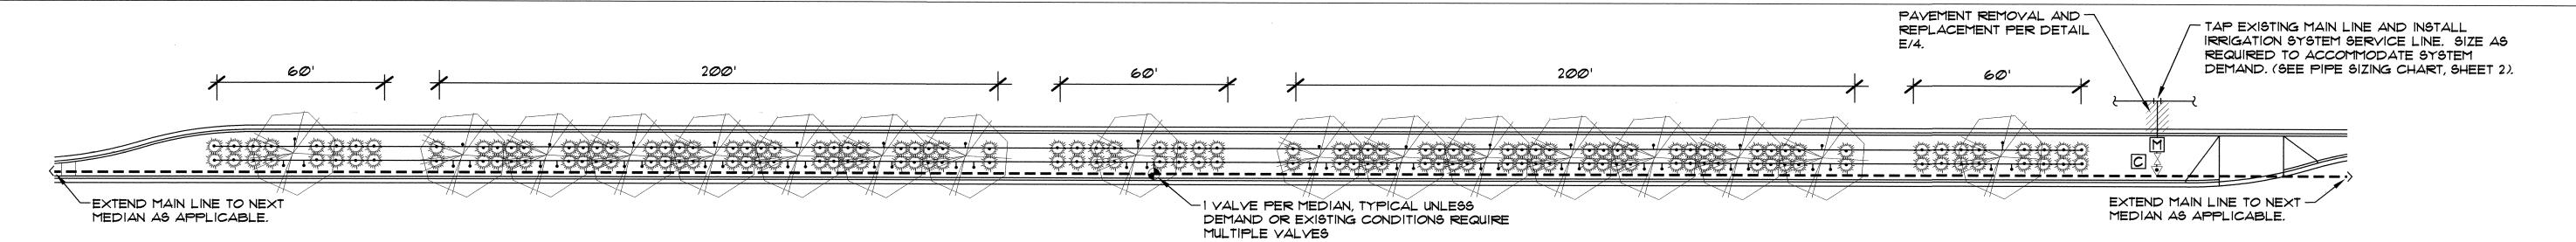


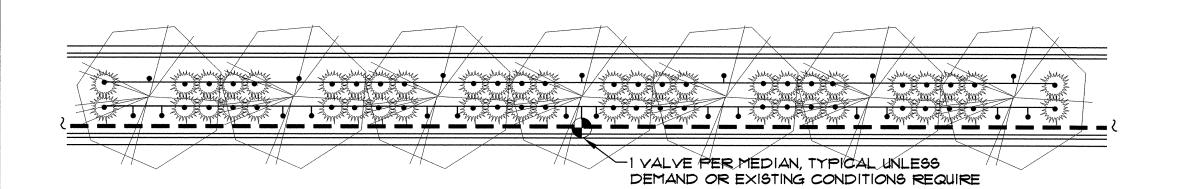

200' POD: TYP. 16' MEDIAN Scale: 1"=20'

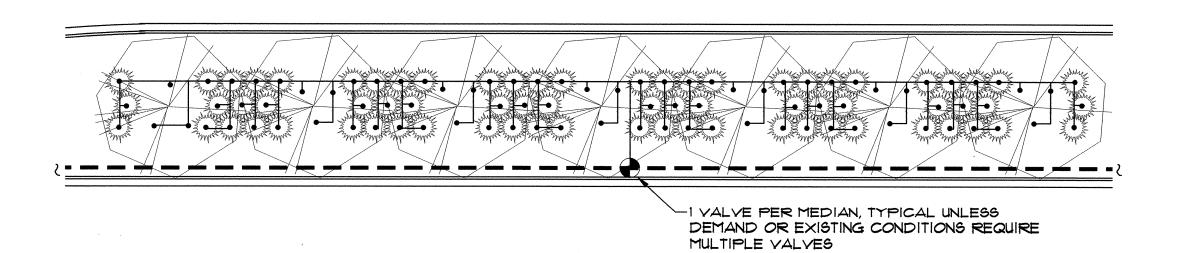


200' POD: WIDE MEDIAN ADAPTATION Scale: 1"=20"

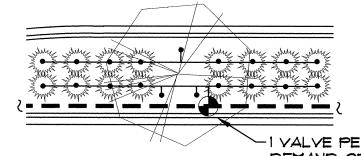

-1 VALVE PER MEDIAN, TYPICAL UNLESS DEMAND OR EXISTING CONDITIONS REQUIRE MULTIPLE VALVES

60' POD: TYP. 16' MEDIAN Scale: 1"=20'

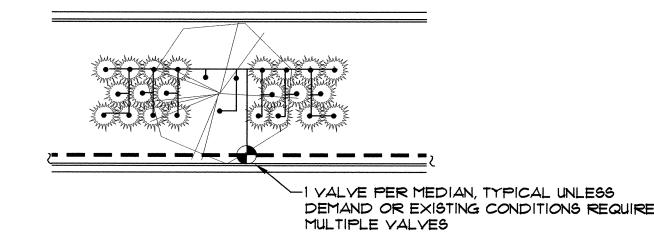

60' POD: WIDE MEDIAN ADAPTATION Scale: 1"=20'

IRRIGATION LEGEND

M WATER METER PER COA DWG. 2362 OR 2363. SIZE PER METER SIZING CHART, SHEET 2.

IRRIGATION MAIN LINE, SCH 40 BELL END, SOLVENT WELD PVC. DEPTH OF SHALL BE BURY 28" FOR CONTINUOUS PRESSURE IRRIGATION MAIN LINE AND 18" DEPTH OF BURY FOR NON-CONTINUOUS PRESSURE. SIZE PER PIPE SIZING CHART, SHEET 2.

--- LATERAL PIPING, SCH. 40, BELL END, SOLVENT WELD PVC. DEPTH OF BURY, 18". SIZE PER PIPE SIZING CHART, SHEET 2.

- M ISOLATION VALVE ASSEMBLY, SIZE PER VALVE SIZING CHART, SHEET 2. INSTALL PER C.O.A. DRAWING NO. 2707.
- FEBCO 825YA REDUCED PRESSURE PRINCIPAL BACKFLOW PREVENTER AND MASTER VALVE ASSEMBLY WITH BALL VALVES, INSTALLED IN HEATED AND INSULATED ENCLOSURE AND MASTER METER INSTALLED IN VALVE BOX PER DETAIL C/4. SIZE OF RP, MASTER VALVE, AND MASTER METER SHALL BE SAME AS LINE SIZE. ENCLOSURE SHALL BE SIZED TO ACCOMMODATE SIZE OF RP AND MASTER VALVE ASSEMBLY.
- REMOTE CONTROL VALVE ASSEMBLY, RAINBIRD PEB PLASTIC BODY 24-VOLT AUTOMATIC VALVE, SIZE, PER VALVE SIZING CHART, SHEET 2. INSTALL PER C.O.A. DRAWING NO. 2703. (SIMILAR SEE IRRIGATION NOTES *25 AND *26, SHEET 2.)
- SOLVENT WELD CAP, SCH. 40 PVC, LINE SIZE.

PRESSURE COMPENSATING BUBBLER ASSEMBLIES, RAIN BIRD 1400 SERIES, AS FOLLOWS: INSTALL PER C.O.A. DRAWING NUMBERS 2710, 2711, 2711-A AND 2712.

MODEL NO. GPM PSI

1401 25 30


IRRINET AC, IRRINET DC, SCORPIO AC, OR SCORPIO DC, CONTROLLER WITH INTERSPEC ENCLOSURE AND DOMED ANTENNA. UNIT SHALL COMMUNICATE ON C.O.A. RADIO FREQUENCY (WIDE BAND). INSTALL PER DETAILS B/4 AND D/4. COORDINATE WITH CITY PROJECT MANAGER FOR TYPE OF CONTROLLER. SIZE AS REQUIRED TO ACCOMMODATE QUANTITY OF REMOTE CONTROL VALVES AND MASTER VALVE.


PROTOTYPE E GPM


STANDARD 200' POD: 19
STANDARD 50' POD: 5
WIDE MEDIAN 200' POD: 25


WIDE MEDIAN 50' POD:

- SEE SHEET 2 FOR GENERAL IRRIGATION NOTES.
- CONTRACTOR SHALL SIZE THE IRRIGATION COMPONENTS IN ACCORDANCE WITH THE IRRIGATION SIZING CRITERIA, SHEET 2.
- BUBBLERS ARE SHOWN DIRECTLY ON TOP OF SHRUBS FOR CLARITY OF DESIGN ONLY. BUBBLERS SHALL BE LOCATED 12" FROM THE SHRUB ROOT BALL.
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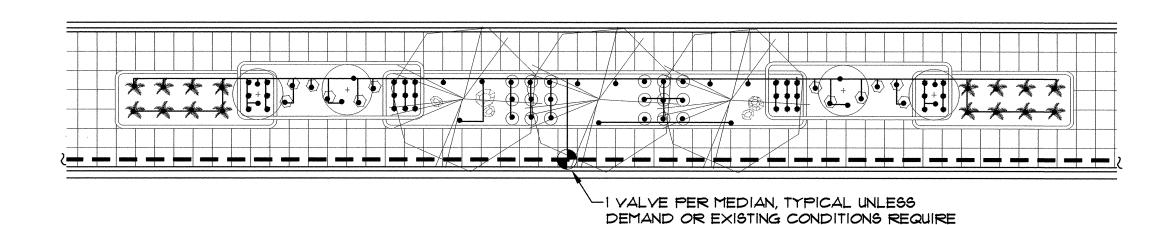


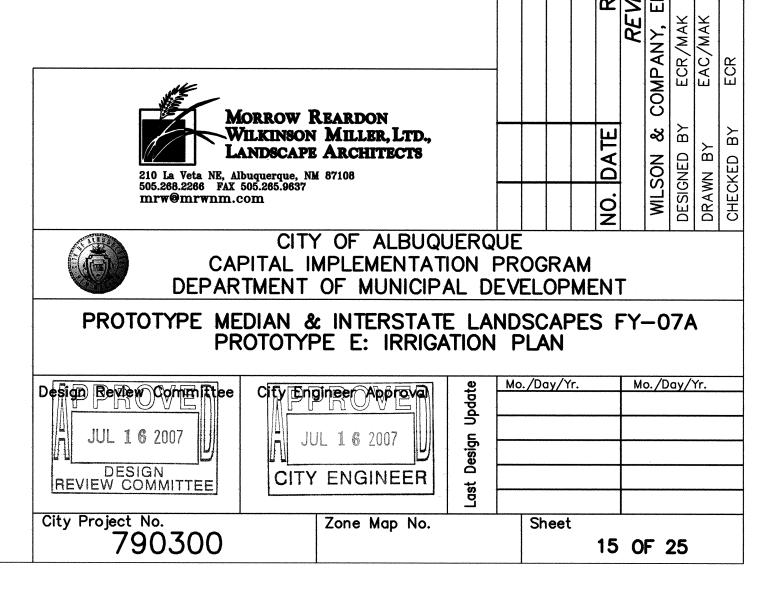

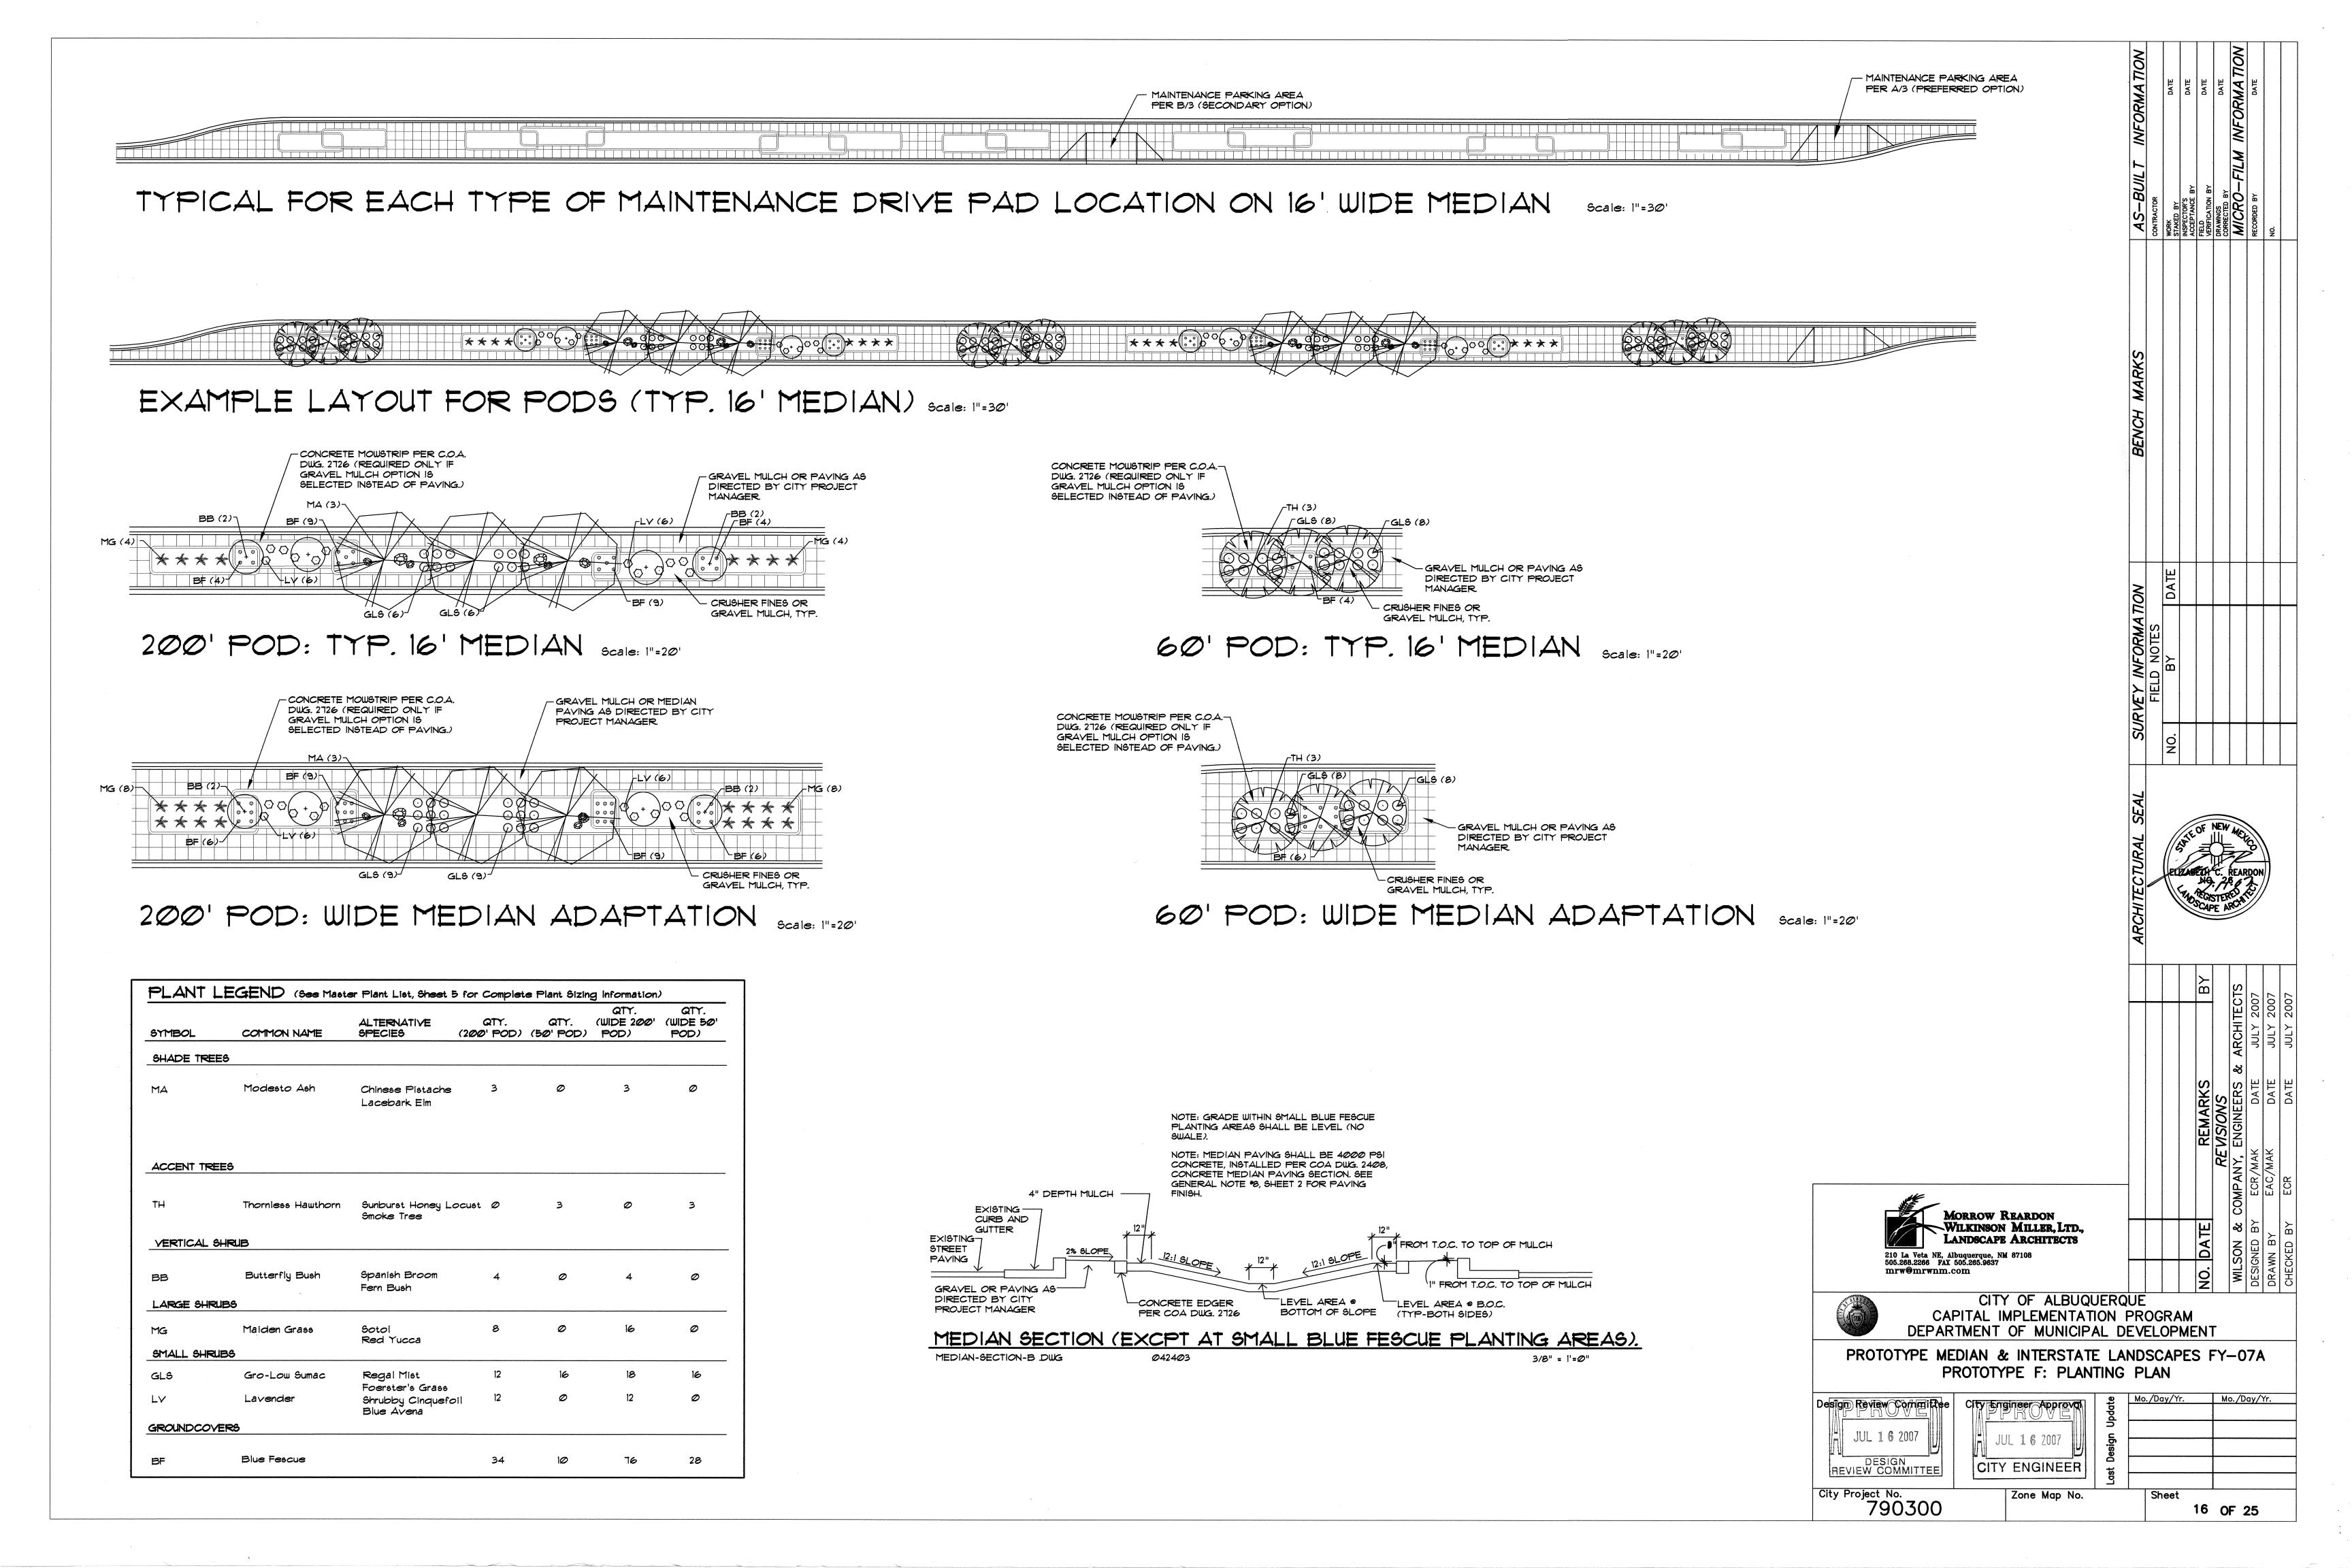

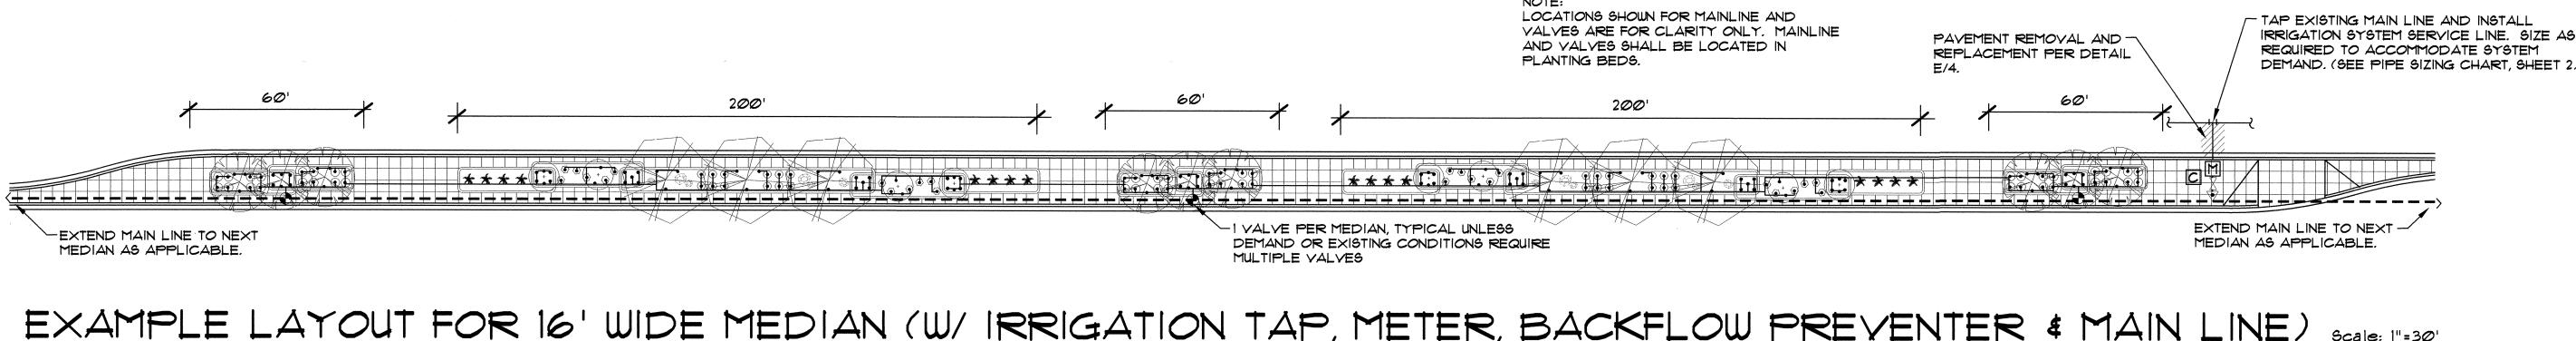


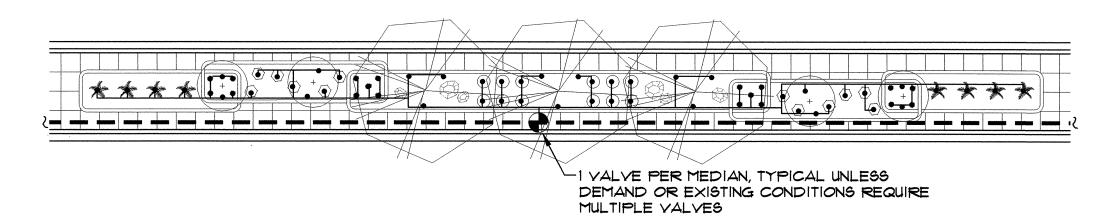200' POD: TYP. 16' MEDIAN




200' POD: WIDE MEDIAN ADAPTATION Scale: 1"=20'


MULTIPLE VALVES

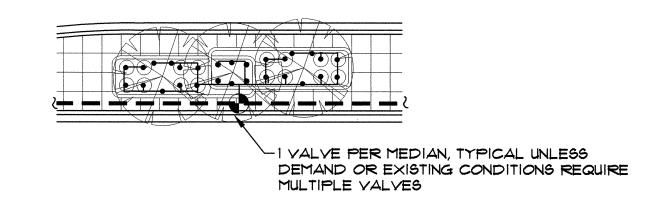

60' POD: TYP. 16' MEDIAN Scale: 1"=20'

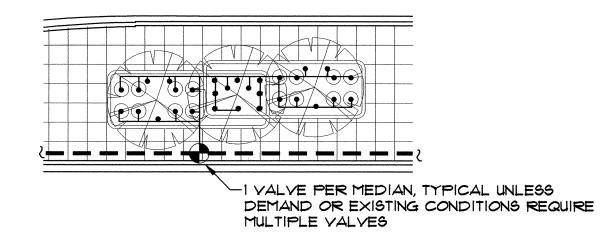

60' POD: WIDE MEDIAN ADAPTATION Scale: 1"=20"

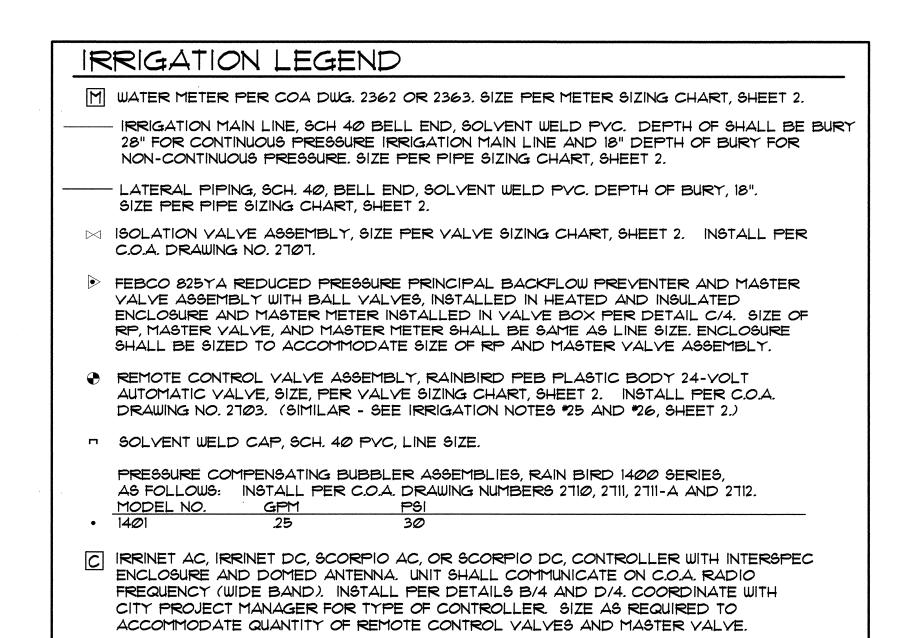


WIDE	MEDIAN 200' POD: 36
WIDE	MEDIAN 50' POD: 14
IRF	RIGATION NOTES
•	
1.	SEE SHEET 2 FOR GENERAL IRRIGATION NOTES.
2.	CONTRACTOR SHALL SIZE THE IRRIGATION COMPONENTS IN ACCORDANCE WITH THE IRRIGATION SIZING CRITERIA, SHEET 2.
3.	BUBBLERS ARE SHOWN DIRECTLY ON TOP OF SHRUBS FOR CLARITY OF DESIGN ONLY. BUBBLERS SHALL BE LOCATED 12" FROM THE SHRUB ROOT BALL.
4.	UNIT PRICE BID ITEM FOR EACH POD INCLUDES BUBBLERS AND RELATED INCIDENTAL COMPONENTS ONLY. BALANCE OF IRRIGATION COMPONENTS (MAIN LINE, WIRE, BACKFLOW PREVENTER, GATE VALVE, METER, TAP, SERVICE LINE, CONTROL VALVES & LATERAL LINES) ARE BID AS SEPARATE UNIT BID ITEMS. FITTINGS AND OTHER IRRIGATION COMPONENTS REQUIRED TO INSTALL INDIVIDUAL BID ITEMS SHALL BE INCIDENTAL TO THE WORK AND INCLUDED AT NO ADDITIONAL COST TO THE OWNER.


PROTOTYPE F GPM

STANDARD 200' POD:


STANDARD 50' POD:

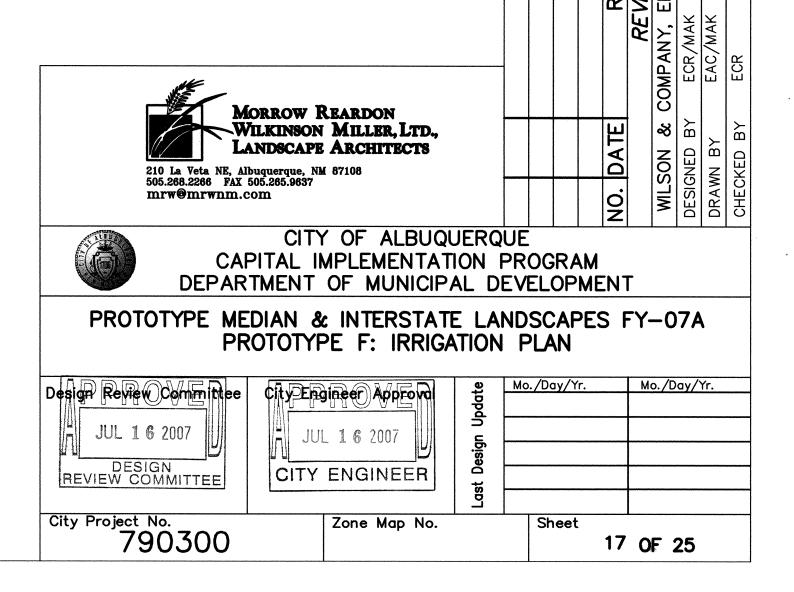


- MAINTENANCE PARKING AREA PER B/3 (SECONDARY OPTION) TYPICAL FOR EACH TYPE OF MAINTENANCE DRIVE PAD LOCATION ON 16' MEDIAN SCALE: 1"=30' EXAMPLE LAYOUT FOR PODS (TYP. 16' MEDIAN) SCALE: 1"=30" 200' POD: TYP. 16' MEDIAN SCALE: 1"=20' 60' POD: TYP. 16' MEDIAN SCALE: 1"=20' CRUSHER FINES OR GRAVEL MULCH, TYP. BOULDER, TYP.-200' POD: WIDE MEDIAN ADAPTATION SCALE: 1"=20" 60' POD: WIDE MEDIAN ADAPTATION SCALE: 1"=20" TOOLED EDGE(TYP.) PLANT LEGEND (See Master Plant List, Sheet 5 for Complete Plant Sizing Information) ALTERNATIVE ALTERNATIVE SPECIES: (WIDE 200' (WIDE 50' WIDE MEDIANS ONLY: (200' POD) (50' POD) POD) ABBREVIATION COMMON NAME SHADE TREES Raywood Ash Chinese Pistache Honey Locust 4000 PSI CONCRETE W/-ACCENT TREES EXPANSION JOINTS @ 20' O.C. Thornless Hawthorn Desert Willow AND CONTROL JOINTS @ 5' O.C. Ornamental Pear 95% COMPACTED-GO Shumard Oak Austrian Pine SUBGRADE - SEE Bechtel Crabapple Dwarf Scotch Pine DETAIL 1/3 VERTICAL SHRUBS NOTE: SEE DETAIL Butterfly Bush Pampas Grass B/3 FOR HEIGHT Fern Bush LIMITATIONS OF WALL LARGE SHRUBS Arp Rosemary A LANDSCAPE WALL SECTION Russian Sage Switchgrass Lena's Broom MG Maiden Grass Morrow Reardon Wilkinson Miller, Ltd., 1" = 1'-0" Threeleaf Sumac Red Yucca LANDSCAPE ARCHITECTS Apache Plume SMALL SHRUBS 210 La Veta NE, Albuquerque, NM 87108 505.268.2266 FAX 505.265.9637 Dwarf Rabbitbrush Lavender Shrubby Cinquefoil CITY OF ALBUQUERQUE Cherry Sage Dwarf Russian Sage Gro-Low Sumac VARIES EXISTING ---CAPITAL IMPLEMENTATION PROGRAM CURB AND DEPARTMENT OF MUNICIPAL DEVELOPMENT Regal Mist Blue Avena FROM T.O.C. TO TOP OF MULCH GUTTER Foerster's Grass Feathergrass EXISTING PROTOTYPE MEDIAN & INTERSTATE LANDSCAPES FY-07A STREET PROTOTYPE G: PLANTING PLAN PAVING Mexican Primrose Dragon's Blood Sedum City Engineer Approval Mo./Day/Yr. COBBLE OR GRAVEL PER-CITY PROJECT MANAGER 4" DEPTH CRUSHER FINES OR GRAVEL MULCH, PER CITY PROJECT MANAGER 9 BOTTOM *Trees designated as "alternate species - wide medians only" shall be installed only in medians of minimum 25' width and -CONCRETE WALL PER DETAIL THIS OF SLOPE JUL 1 6 2007 CITY ENGINEER MEDIAN SECTION: PROTOTYPE G DESIGN REVIEW COMMITTEE *0*424*0*3 3/8" = 1'=0" City Project No. 790300 Zone Map No. 18 OF 25

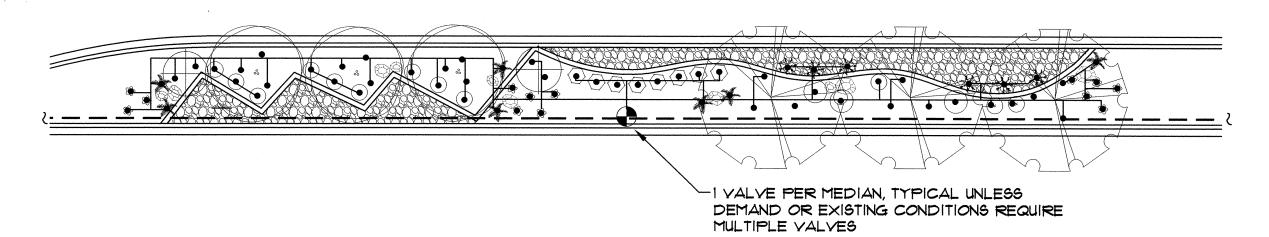


200' POD: TYP. 16' MEDIAN Scale: 1"=20'

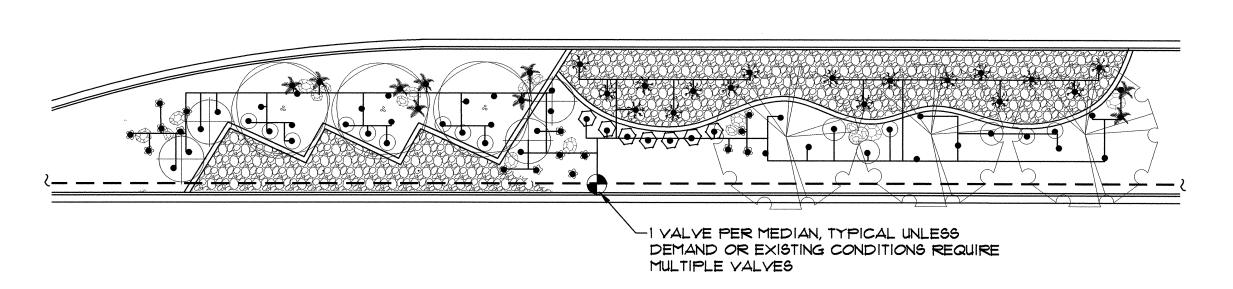

200' POD: WIDE MEDIAN ADAPTATION Scale: 1"=20'

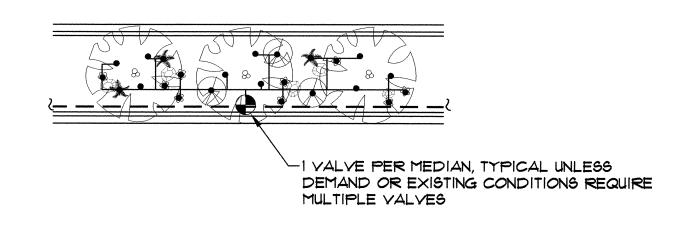

60' POD: TYP. 16' MEDIAN Scale: 1"=20'

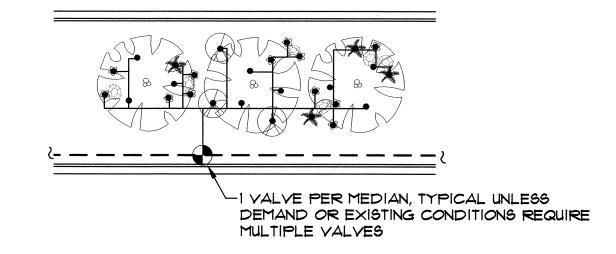

60' POD: WIDE MEDIAN ADAPTATION Scale: 1"=20"

IRRIGATION LEGEND

- M ISOLATION VALVE ASSEMBLY, SIZE PER VALVE SIZING CHART, SHEET 2. INSTALL PER C.O.A. DRAWING NO. 2707.
- FEBCO 825YA REDUCED PRESSURE PRINCIPAL BACKFLOW PREVENTER AND MASTER VALVE ASSEMBLY WITH BALL VALVES, INSTALLED IN HEATED AND INSULATED ENCLOSURE AND MASTER METER INSTALLED IN VALVE BOX PER DETAIL C/4. SIZE OF RP, MASTER VALVE, AND MASTER METER SHALL BE SAME AS LINE SIZE. ENCLOSURE SHALL BE SIZED TO ACCOMMODATE SIZE OF RP AND MASTER VALVE ASSEMBLY.
- → REMOTE CONTROL VALVE ASSEMBLY, RAINBIRD PEB PLASTIC BODY 24-VOLT
 AUTOMATIC VALVE, SIZE, PER VALVE SIZING CHART, SHEET 2. INSTALL PER C.O.A.
 DRAWING NO. 2703. (SIMILAR SEE IRRIGATION NOTES *25 AND *26, SHEET 2.)
- SOLVENT WELD CAP, SCH. 40 PVC, LINE SIZE.

PRESSURE COMPENSATING BUBBLER ASSEMBLIES, RAIN BIRD 1400 SERIES, AS FOLLOWS: INSTALL PER C.O.A. DRAWING NUMBERS 2710, 2711, 2711-A AND 2712.

MODEL NO. GPM PSI

[C] IRRINET AC, IRRINET DC, SCORPIO AC, OR SCORPIO DC, CONTROLLER WITH INTERSPEC ENCLOSURE AND DOMED ANTENNA. UNIT SHALL COMMUNICATE ON C.O.A. RADIO FREQUENCY (WIDE BAND). INSTALL PER DETAILS B/4 AND D/4. COORDINATE WITH CITY PROJECT MANAGER FOR TYPE OF CONTROLLER. SIZE AS REQUIRED TO ACCOMMODATE QUANTITY OF REMOTE CONTROL VALVES AND MASTER VALVE.

PROTOTYPE G GPM

STANDARD 200' POD: 2
STANDARD 50' POD: 6

WIDE MEDIAN 50' POD:

WIDE MEDIAN 200' POD: 26

IRRIGATION NOTES


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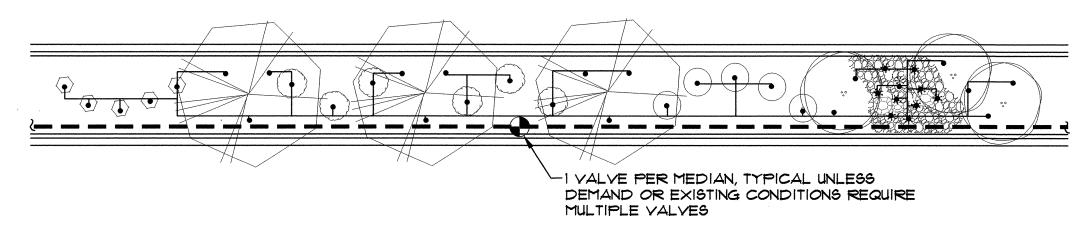


Zone Map No.


19 OF 25

City Project No. 790300




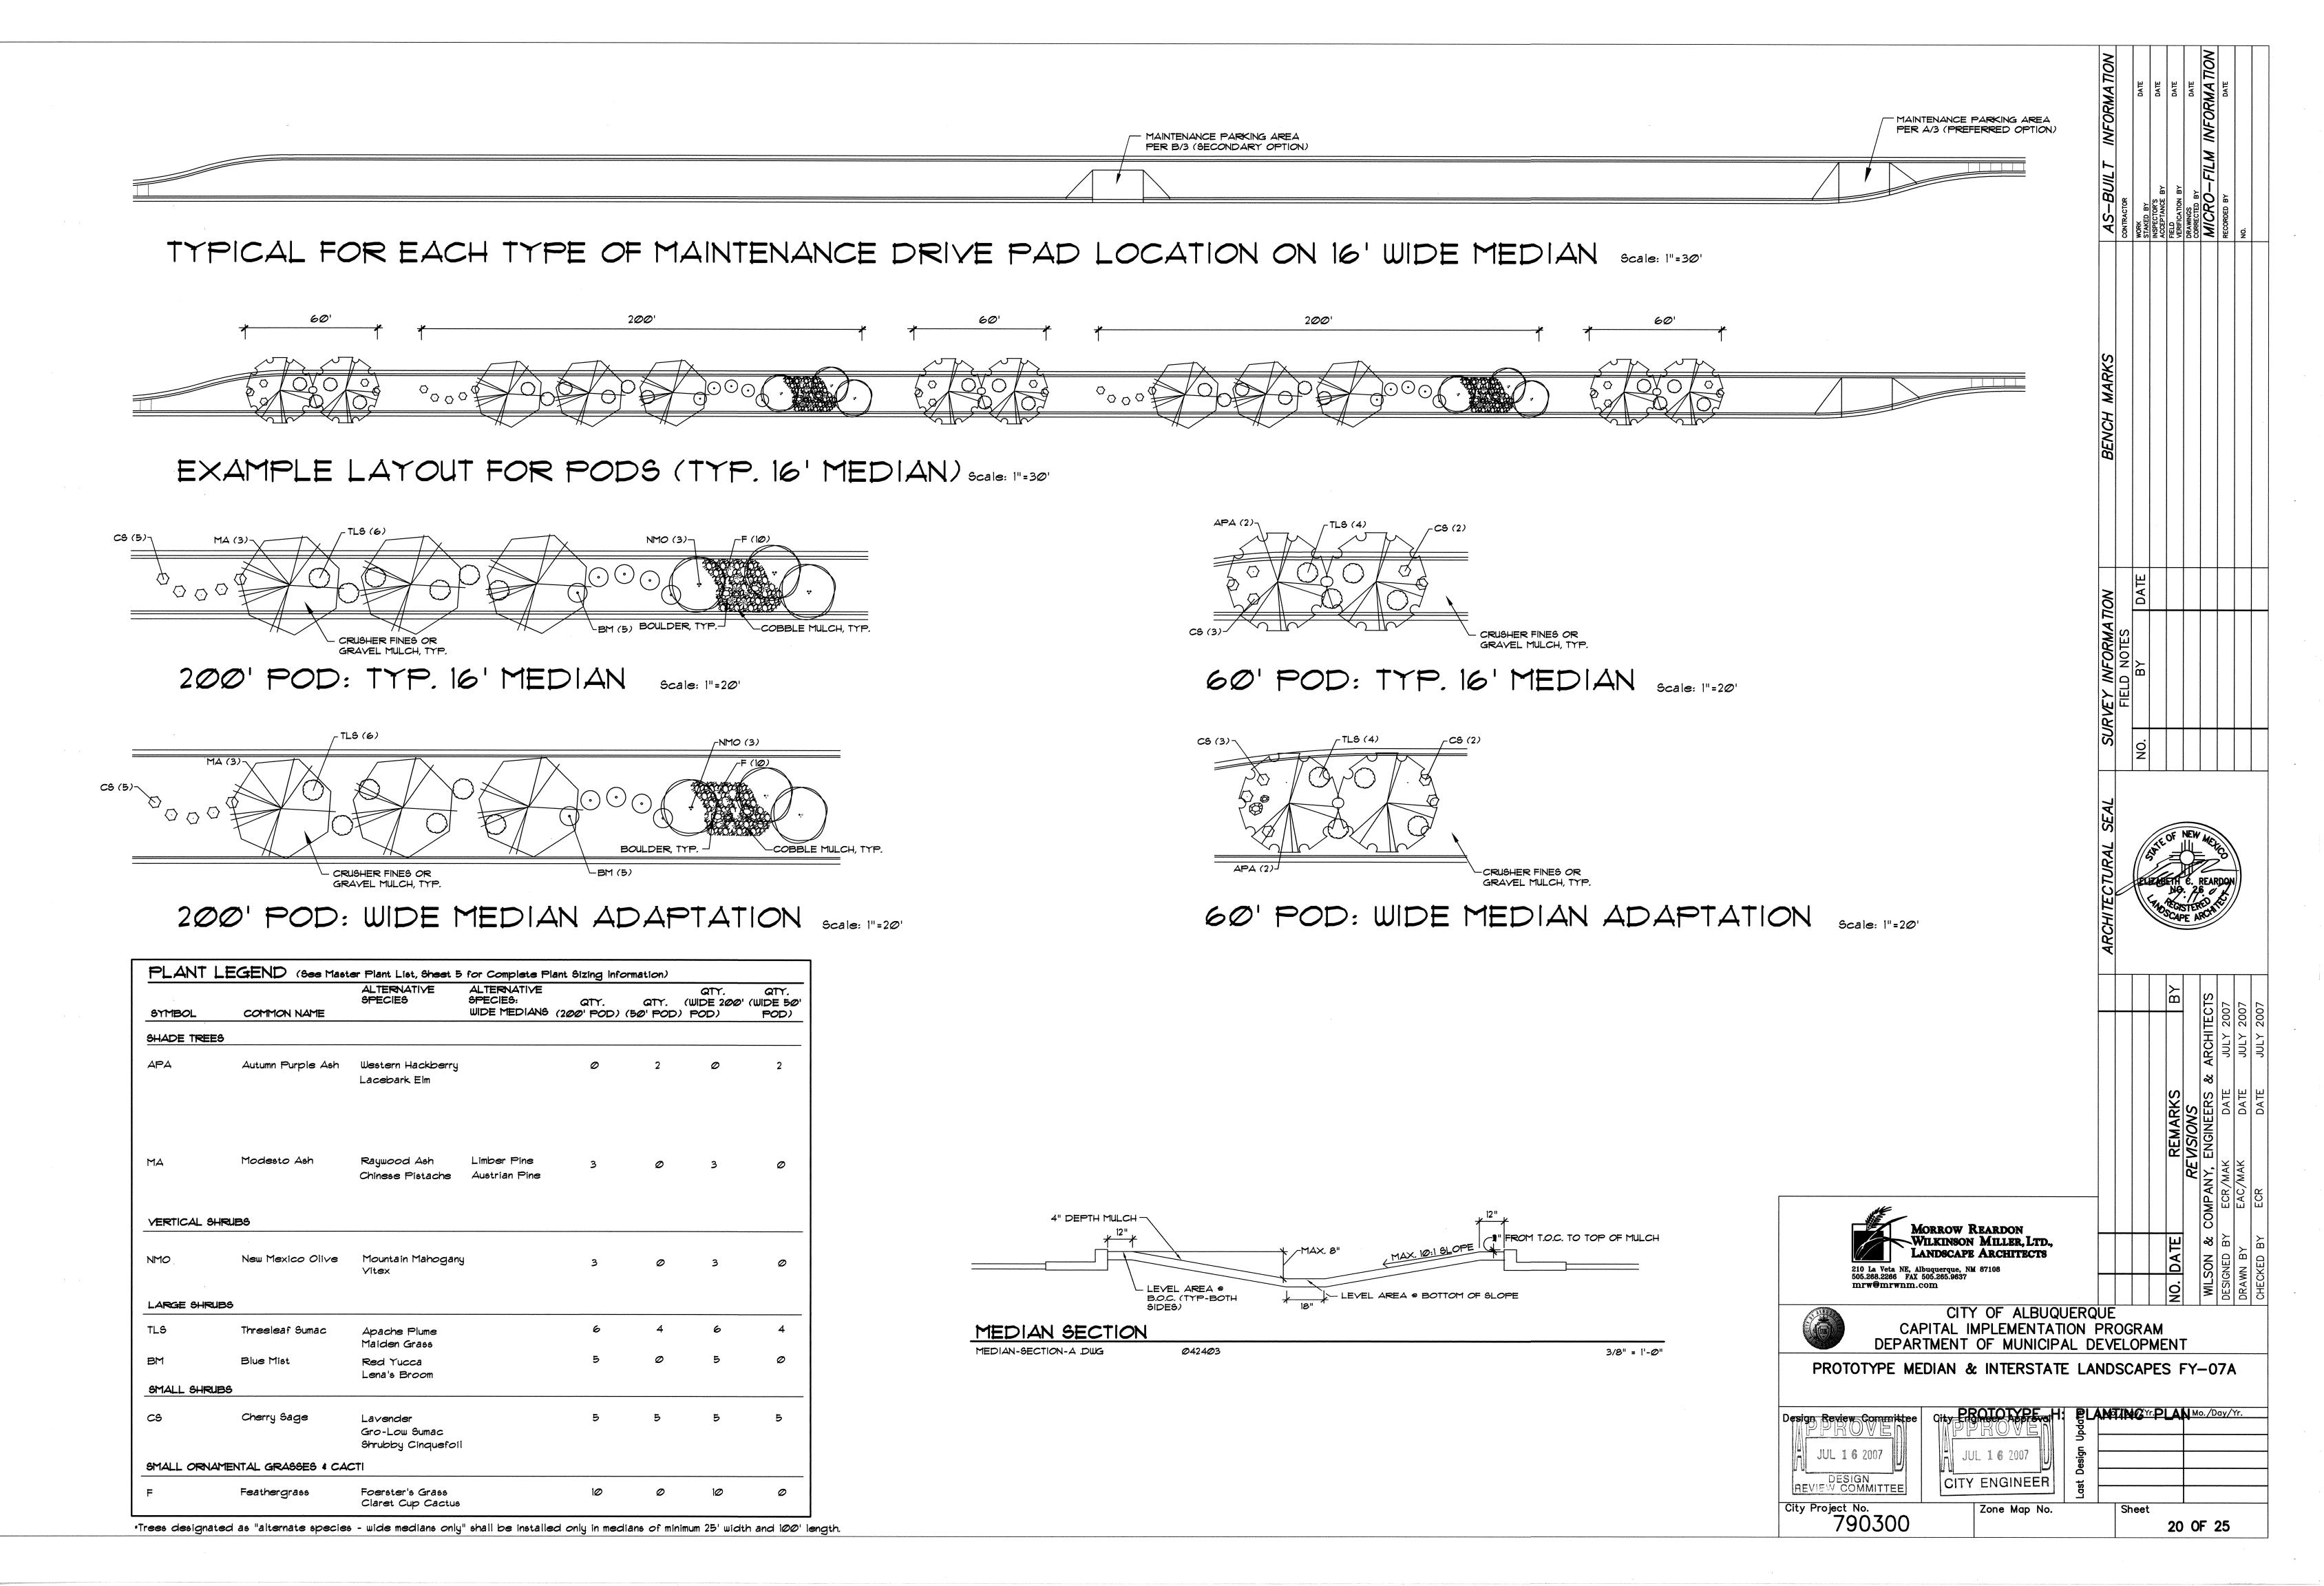


200' POD: TYP. 16' MEDIAN Scale: 1"=20"

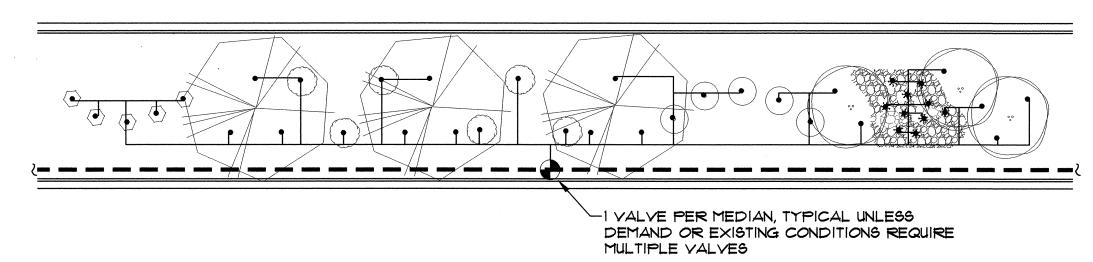


200' POD: WIDE MEDIAN ADAPTATION Scale: 1"=20"

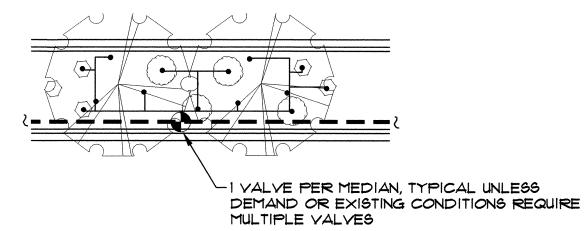

60' POD: TYP. 16' MEDIAN Scale: 1"=20"

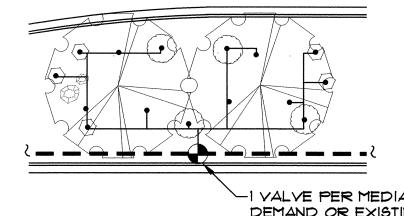

60' POD: WIDE MEDIAN ADAPTATION Scale: 1"=20"

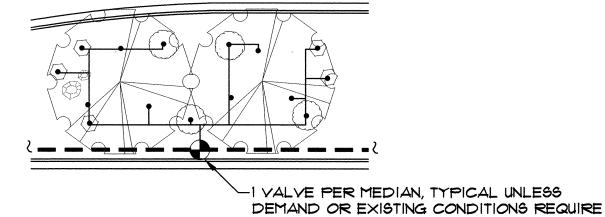

MULTIPLE VALVES

IRRIGATION LEGEND

M WATER METER PER COA DWG. 2362 OR 2363. SIZE PER METER SIZING CHART, SHEET 2 IRRIGATION MAIN LINE, SCH 40 BELL END, SOLVENT WELD PVC. DEPTH OF SHALL BE BURY 28" FOR CONTINUOUS PRESSURE IRRIGATION MAIN LINE AND 18" DEPTH OF BURY FOR NON-CONTINUOUS PRESSURE. SIZE PER PIPE SIZING CHART, SHEET 2.

— LATERAL PIPING, SCH. 40, BELL END, SOLVENT WELD PVC. DEPTH OF BURY, 18". SIZE PER PIPE SIZING CHART, SHEET 2.

- M ISOLATION VALVE ASSEMBLY, SIZE PER VALVE SIZING CHART, SHEET 2. INSTALL PER C.O.A. DRAWING NO. 2707.
- FEBCO 825YA REDUCED PRESSURE PRINCIPAL BACKFLOW PREVENTER AND MASTER VALVE ASSEMBLY WITH BALL VALVES, INSTALLED IN HEATED AND INSULATED ENCLOSURE AND MASTER METER INSTALLED IN VALVE BOX PER DETAIL C/4. SIZE OF RP. MASTER VALVE, AND MASTER METER SHALL BE SAME AS LINE SIZE, ENCLOSURE SHALL BE SIZED TO ACCOMMODATE SIZE OF RP AND MASTER VALVE ASSEMBLY.
- REMOTE CONTROL VALVE ASSEMBLY, RAINBIRD PEB PLASTIC BODY 24-VOLT AUTOMATIC VALVE, SIZE, PER VALVE SIZING CHART, SHEET 2. INSTALL PER C.O.A. DRAWING NO. 2703. (SIMILAR - SEE IRRIGATION NOTES #25 AND #26, SHEET 2.)
- GOLVENT WELD CAP, SCH. 40 PVC, LINE SIZE.

PRESSURE COMPENSATING BUBBLER ASSEMBLIES, RAIN BIRD 1400 SERIES, AS FOLLOWS: INSTALL PER C.O.A. DRAWING NUMBERS 2710, 2711, 2711-A AND 2712.

C IRRINET AC, IRRINET DC, SCORPIO AC, OR SCORPIO DC, CONTROLLER WITH INTERSPEC ENCLOSURE AND DOMED ANTENNA. UNIT SHALL COMMUNICATE ON C.O.A. RADIO FREQUENCY (WIDE BAND). INSTALL PER DETAILS B/4 AND D/4. COORDINATE WITH CITY PROJECT MANAGER FOR TYPE OF CONTROLLER. SIZE AS REQUIRED TO ACCOMMODATE QUANTITY OF REMOTE CONTROL VALVES AND MASTER VALVE.

PROTOTYPE H GPM


STANDARD 200' POD:


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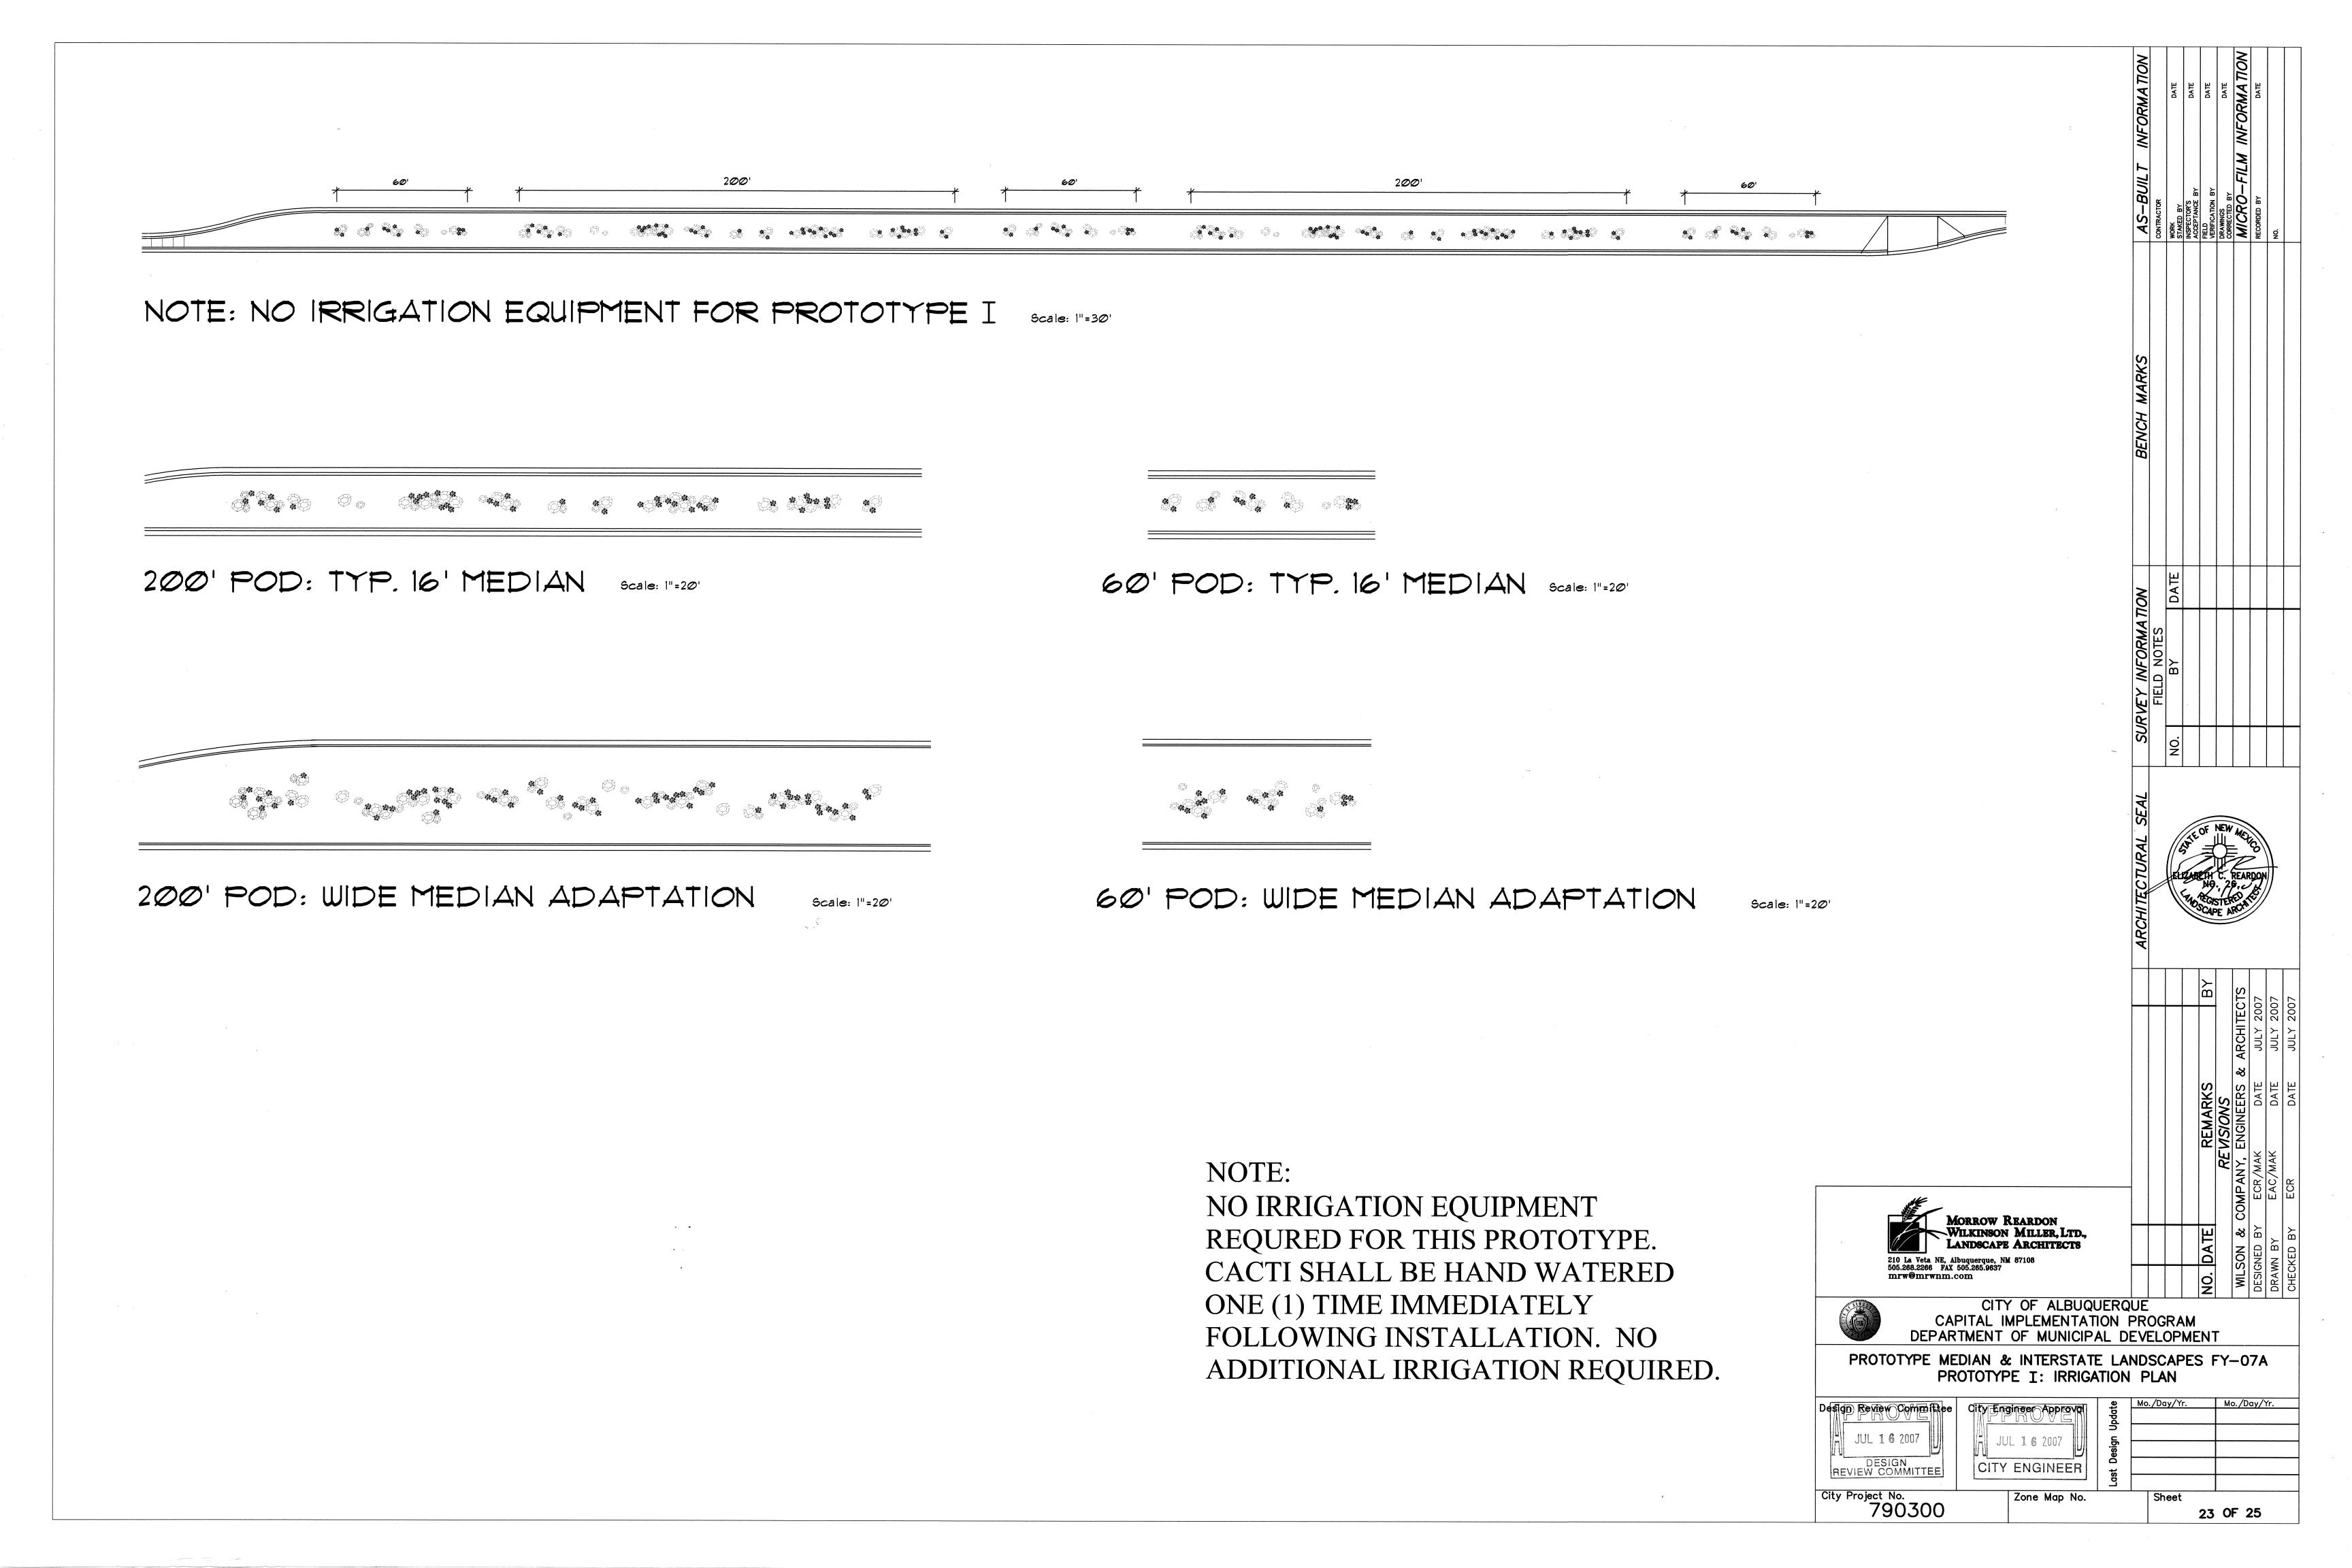
WIDE MEDIAN 200' POD:


WIDE MEDIAN 50' POD:


- SEE SHEET 2 FOR GENERAL IRRIGATION NOTES.
- CONTRACTOR SHALL SIZE THE IRRIGATION COMPONENTS IN ACCORDANCE WITH THE IRRIGATION SIZING CRITERIA, SHEET 2.
- BUBBLERS ARE SHOWN DIRECTLY ON TOP OF SHRUBS FOR CLARITY OF DESIGN ONLY. BUBBLERS SHALL BE LOCATED 12" FROM THE SHRUB ROOT BALL.
- UNIT PRICE BID ITEM FOR EACH POD INCLUDES BUBBLERS AND RELATED INCIDENTAL COMPONENTS ONLY. BALANCE OF IRRIGATION COMPONENTS (MAIN LINE, WIRE, BACKFLOW PREVENTER, GATE VALVE, METER, TAP, SERVICE LINE, CONTROL VALVES & LATERAL LINES) ARE BID AS SEPARATE UNIT BID ITEMS. FITTINGS AND OTHER IRRIGATION COMPONENTS REQUIRED TO INSTALL INDIVIDUAL BID ITEMS SHALL BE INCIDENTAL TO THE WORK AND INCLUDED AT NO ADDITIONAL COST TO THE OWNER.
- IF CACTI ARE SPECIFIED FOR THE WORK ORDER, BUBBLERS SHALL BE DELETED AT CACTI. CONTRACTOR SHALL HAND WATER CACTI ONE (1) TIME IMMEDIATELY FOLLOWING INSTALLATION. NO ADDITIONAL IRRIGATION OF CACTI WILL BE REQUIRED.



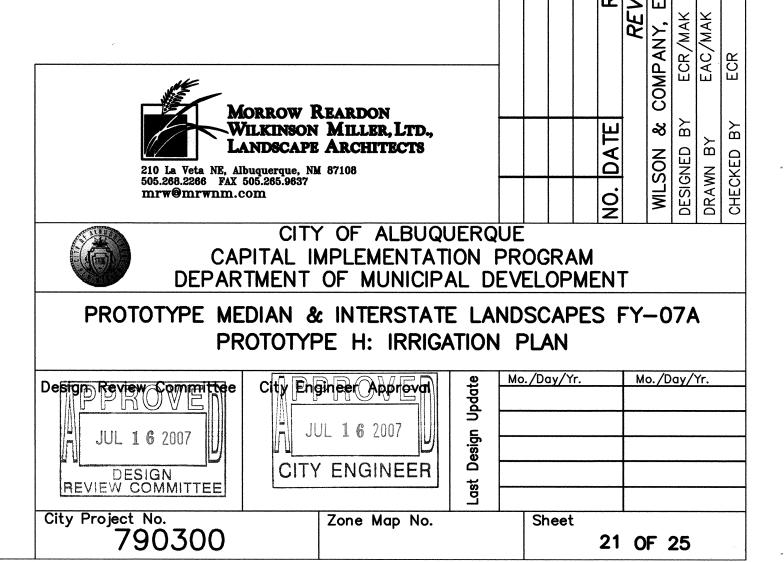


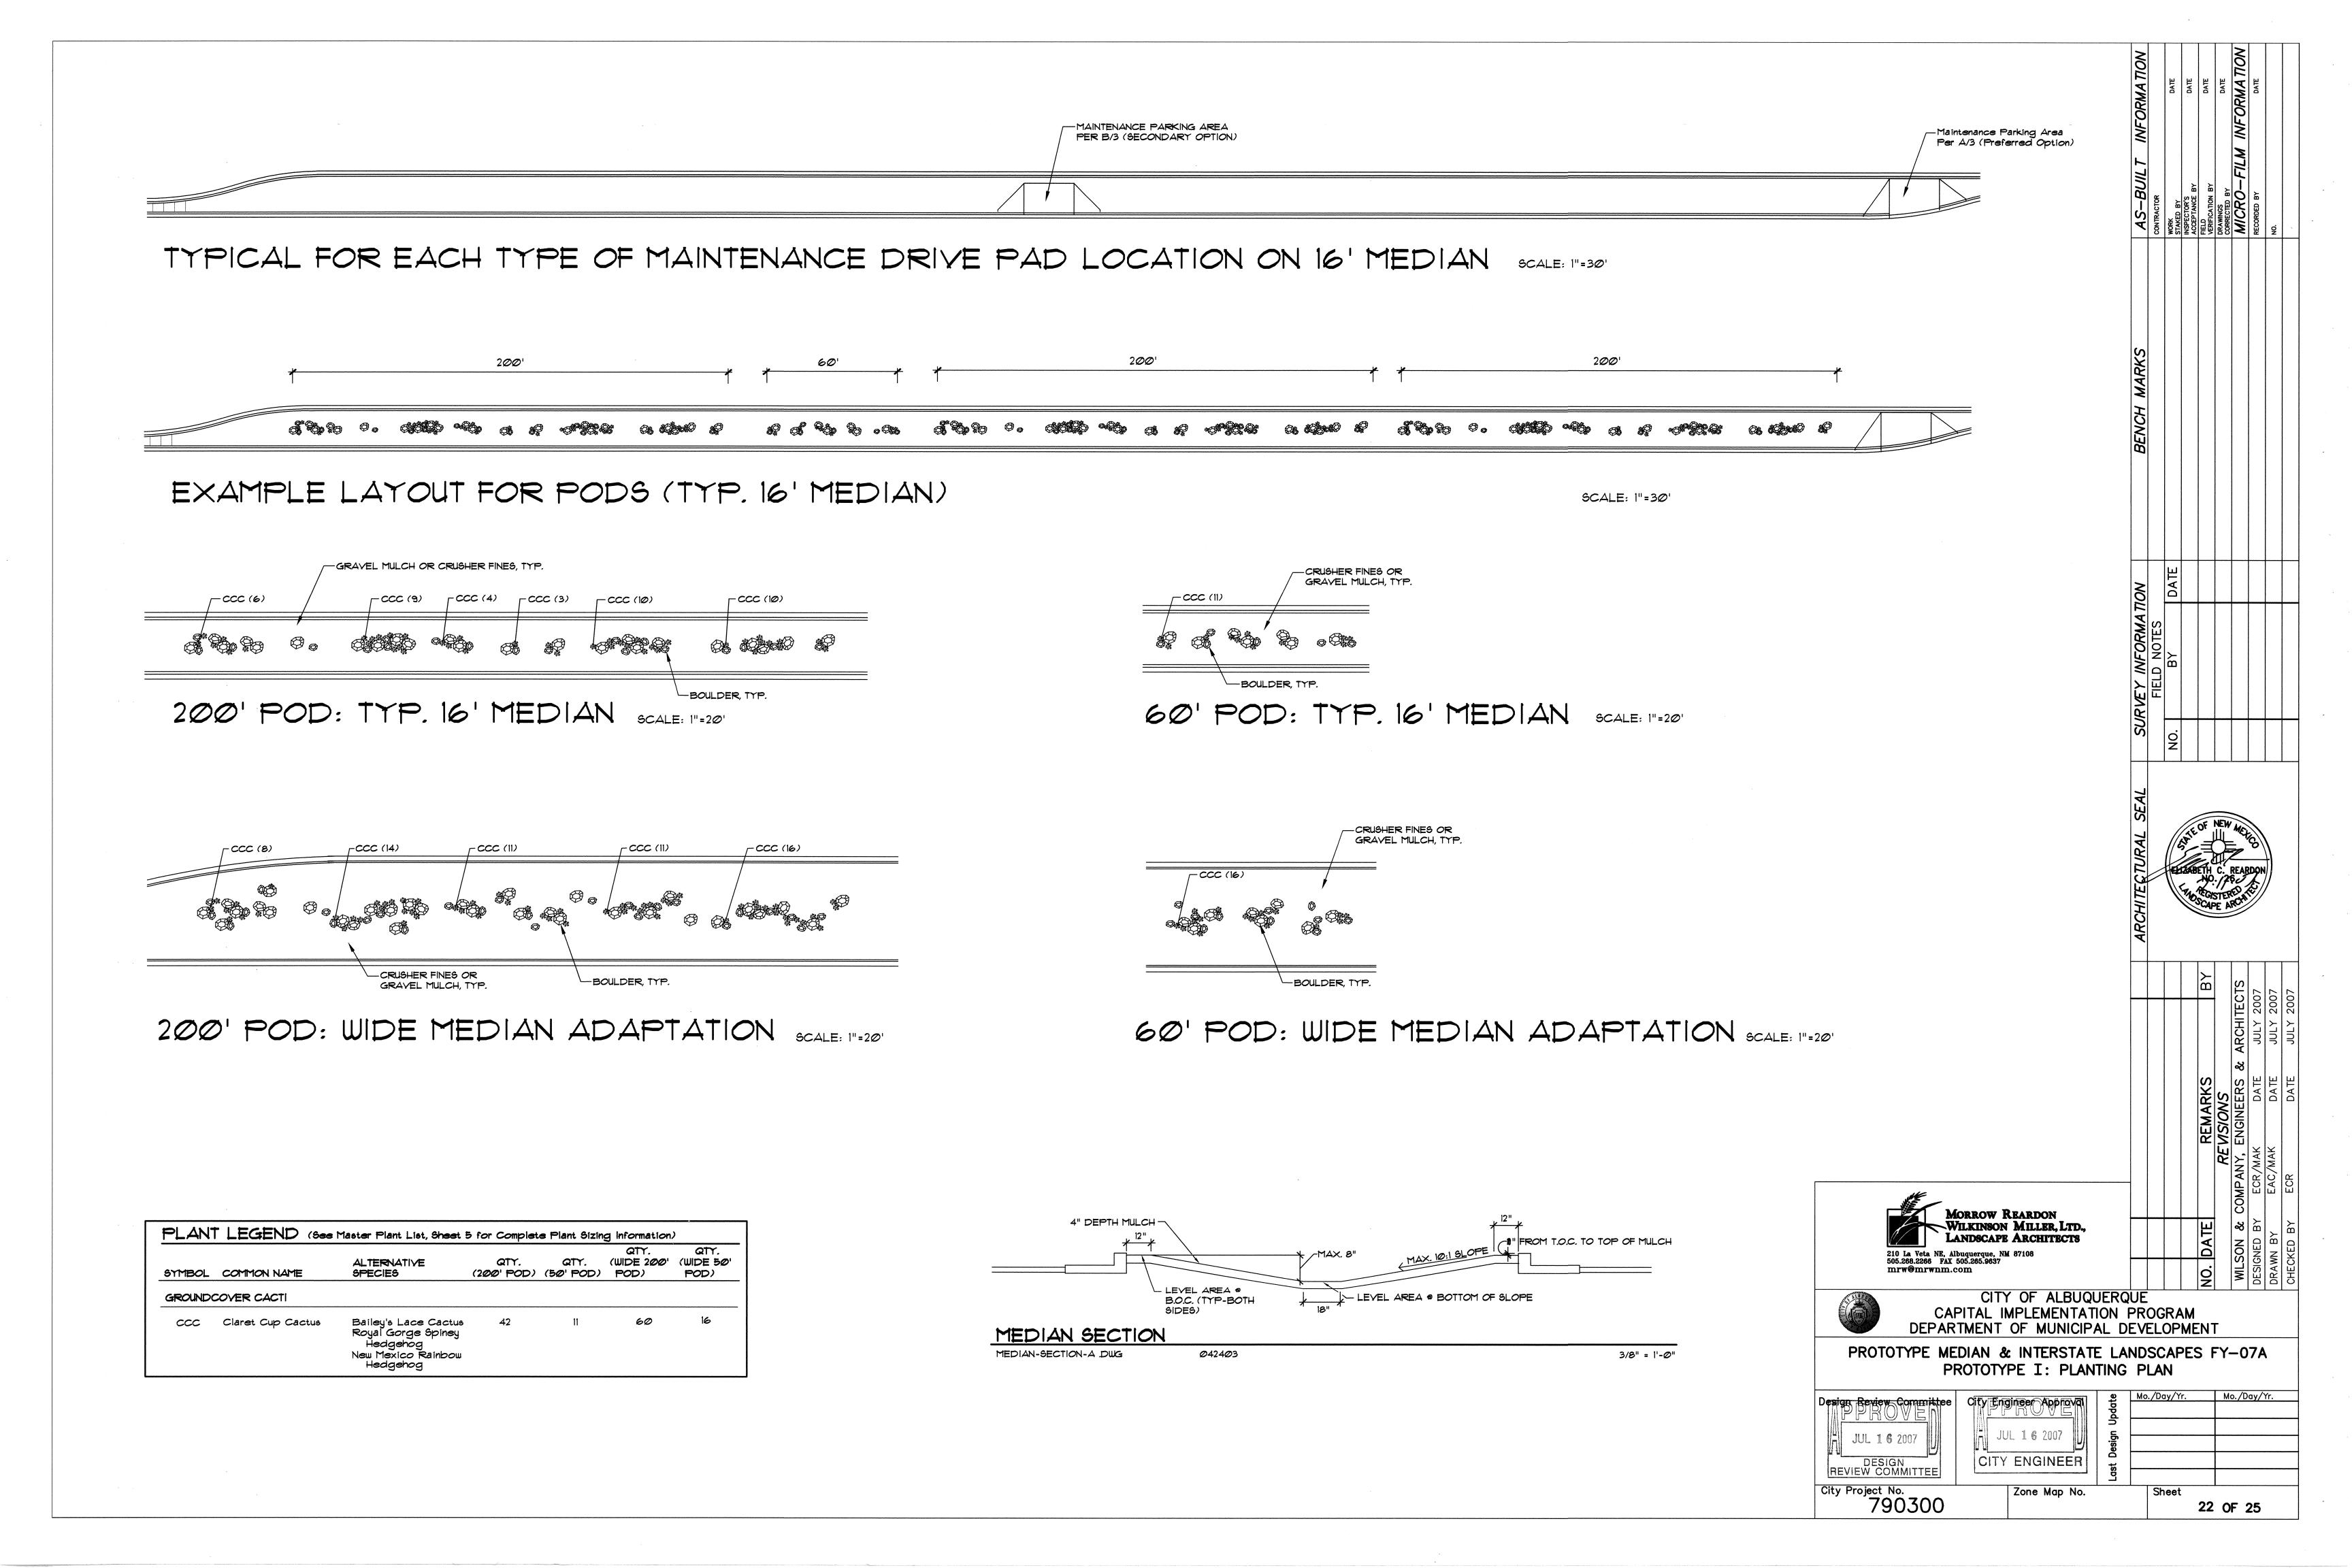

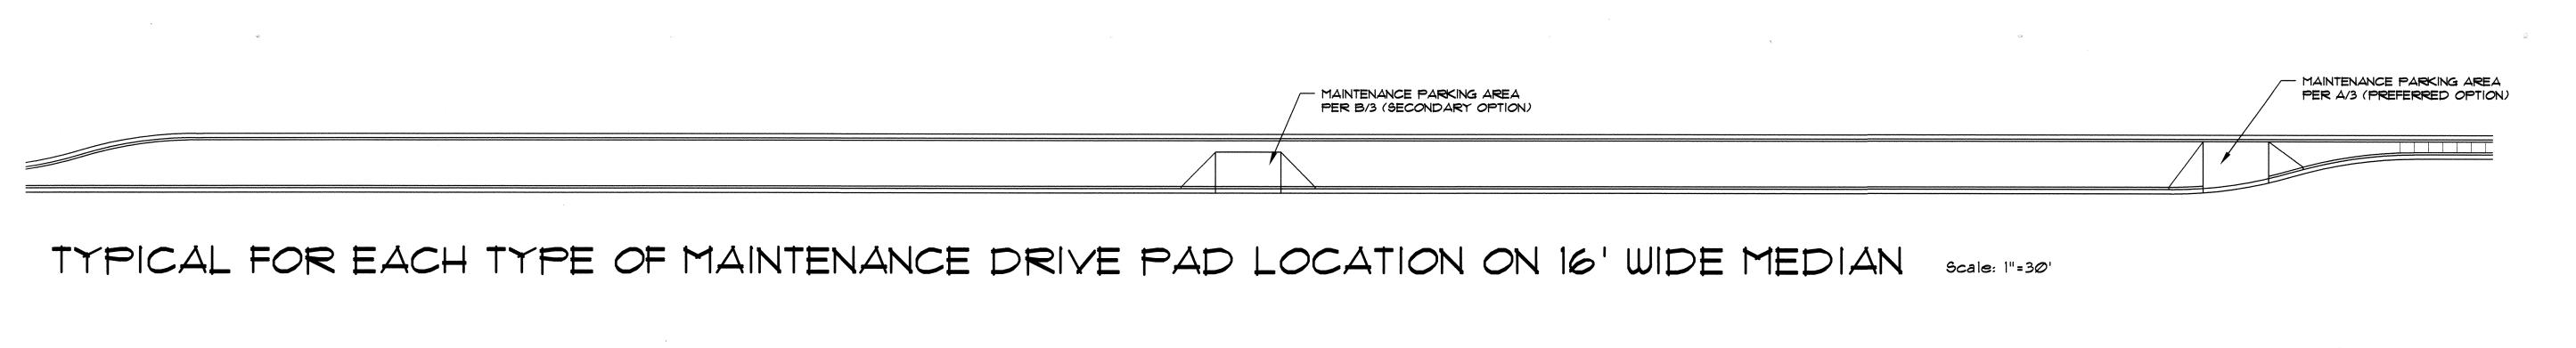


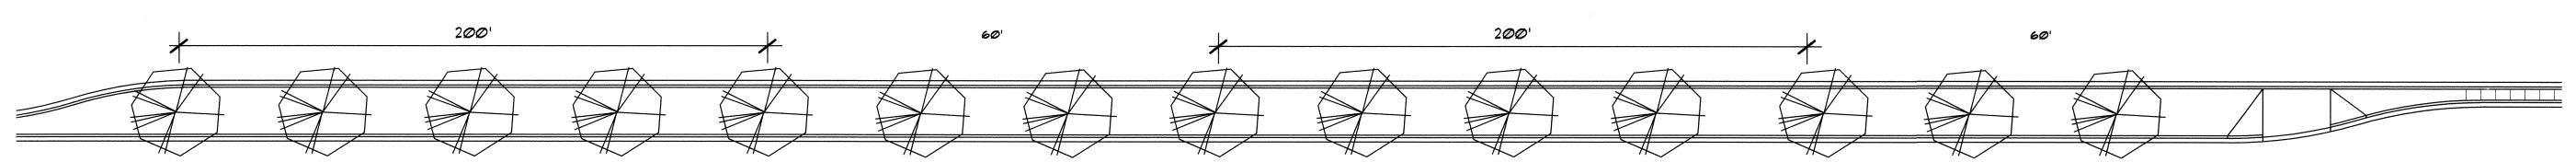


EXAMPLE LAYOUT FOR PODS (TYP. 16' MEDIAN) Scale: 1"=30"

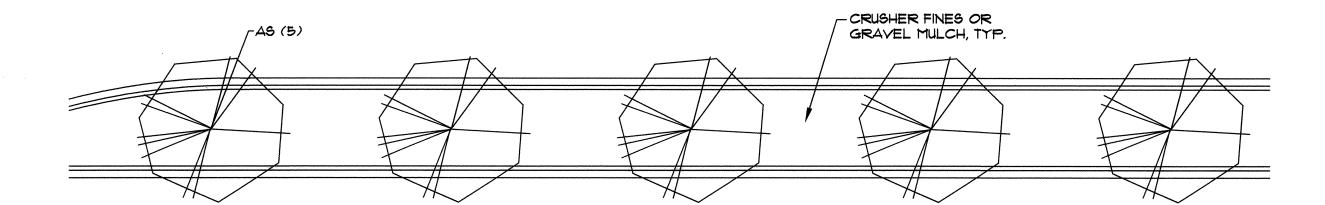


200' POD: TYP. 16' MEDIAN Scale: 1"=20'

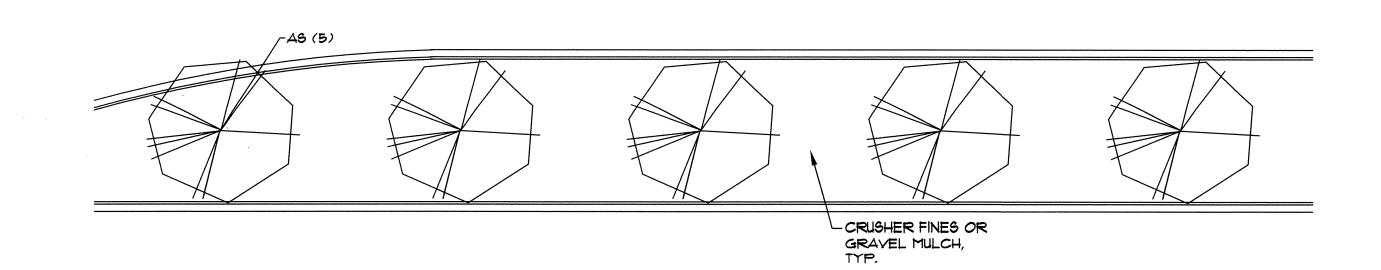

200' POD: WIDE MEDIAN ADAPTATION Scale: 1"=20'

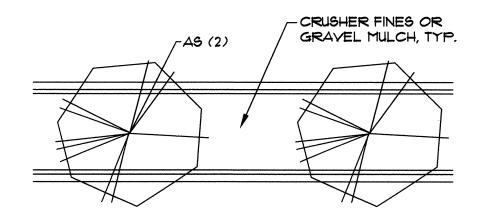


60' POD: TYP. 16' MEDIAN Scale: 1"=20'

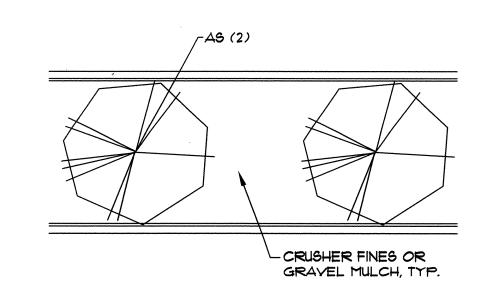


60' POD: WIDE MEDIAN ADAPTATION Scale: 1"=20"


SYMBOL	COMMON NAME	ALTERNATIVE SPECIES	QTY. (200' POD)	QTY. (50' POD)	QTY. (WIDE 200' POD)	QTY. (WIDE 50' POD)
SHADE TRE	E6					
AS	Arizona Sycamore	Autumn Purple Ash Honey Locust Lacebark Elm	5	2	5	2

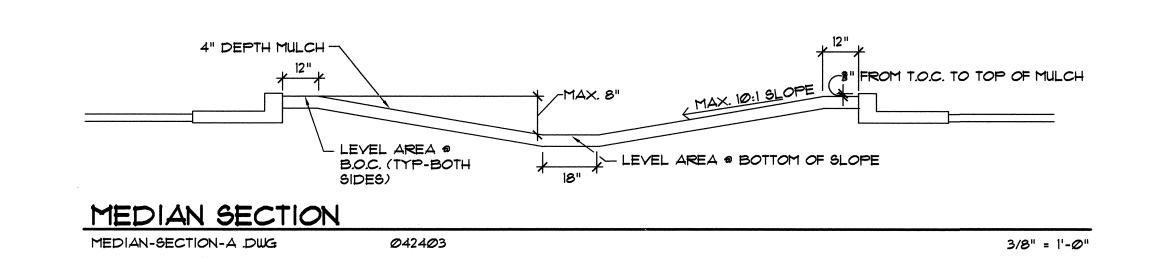




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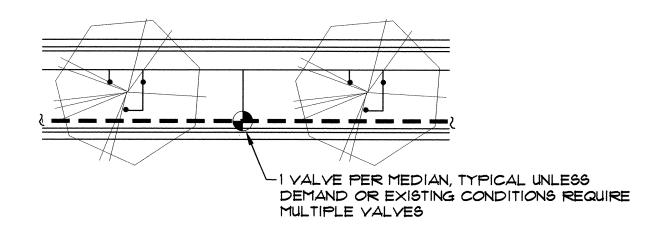


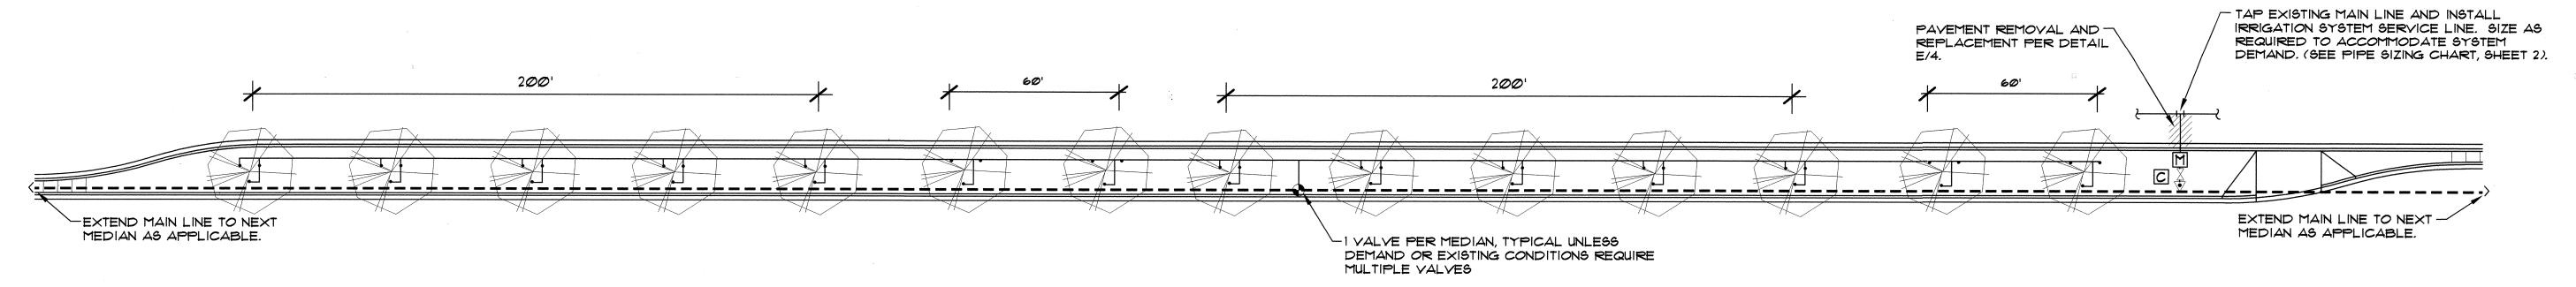

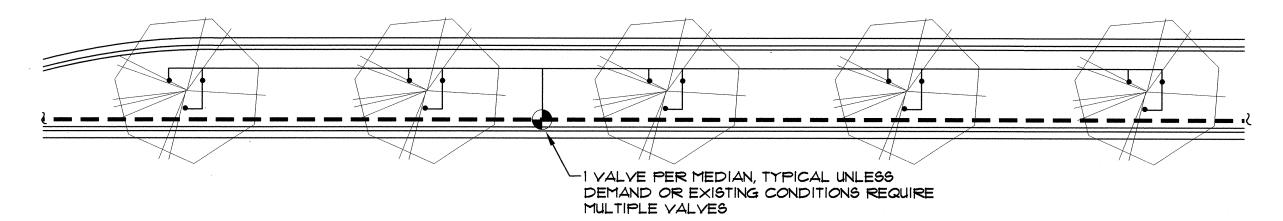
200' POD: TYP. 16' MEDIAN Scale: 1"=20"

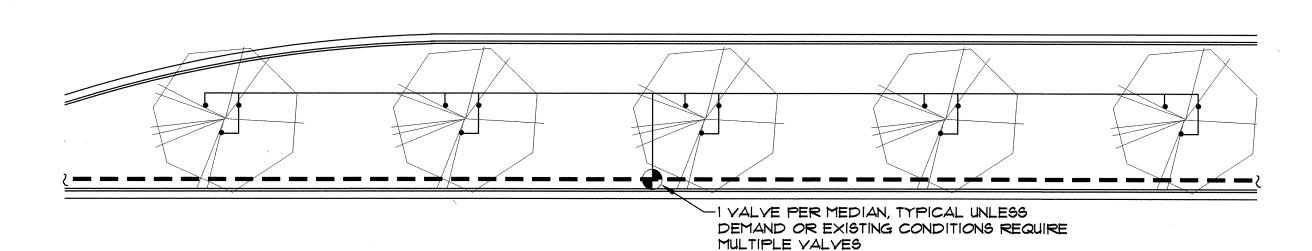

200' POD: WIDE MEDIAN ADAPTATION Scale: 1"=20"



60' POD: TYP. 16' MEDIAN Scale: 1"=20"

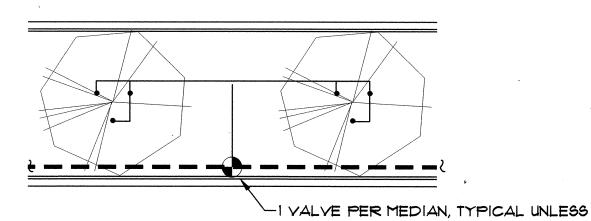

DEMAND OR EXISTING CONDITIONS REQUIRE MULTIPLE VALVES

60' POD: WIDE MEDIAN ADAPTATION Scale: 1"=20"

IRRIGATION LEGEND

M WATER METER PER COA DWG. 2362 OR 2363. SIZE PER METER SIZING CHART, SHEET 2. IRRIGATION MAIN LINE, SCH 40 BELL END, SOLVENT WELD PYC. DEPTH OF SHALL BE BURY 28" FOR CONTINUOUS PRESSURE IRRIGATION MAIN LINE AND 18" DEPTH OF BURY FOR NON-CONTINUOUS PRESSURE. SIZE PER PIPE SIZING CHART, SHEET 2.

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- SOLVENT WELD CAP, SCH. 40 PVC, LINE SIZE.

PRESSURE COMPENSATING BUBBLER ASSEMBLIES, RAIN BIRD 1400 SERIES, AS FOLLOWS: INSTALL PER C.O.A. DRAWING NUMBERS 2710, 2711, 2711-A AND 2712. MODEL NO.

[C] IRRINET AC, IRRINET DC, SCORPIO AC, OR SCORPIO DC, CONTROLLER WITH INTERSPEC ENCLOSURE AND DOMED ANTENNA. UNIT SHALL COMMUNICATE ON C.O.A. RADIO FREQUENCY (WIDE BAND). INSTALL PER DETAILS B/4 AND D/4. COORDINATE WITH CITY PROJECT MANAGER FOR TYPE OF CONTROLLER. SIZE AS REQUIRED TO ACCOMMODATE QUANTITY OF REMOTE CONTROL VALVES AND MASTER VALVE.

PROTOTYPE J GPM

STANDARD 200' POD:

STANDARD 50' POD:

WIDE MEDIAN 200' POD:

WIDE MEDIAN 50' POD:

IRRIGATION NOTES

- SEE SHEET 2 FOR GENERAL IRRIGATION NOTES.
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Zone Map No.

25 OF 25

City Project No.

790300