### PUBLIC IMPROVEMENT PLANS FOR

## COORS BLVD & TUCSON RD RETAIL SHOPS

ALBUQUERQUE, NEW MEXICO

MARCH

PREPARED FOR: COORS & TUCSON, LLC 6801 JEFFERSON NE, SUITE 300 ALBUQUERQUE, NM 87109

PREPARED BY: ISAACSON & ARFMAN, P.A. 128 MONROE ST. NE ALBUQUERQUE, NM 87108

INDEX TO DRAWINGS			
Sheet Number	Sheet Title		
. 1	COVER SHEET		
2	SURVEY		
3	GRADING & DRAINAGE PLAN		
4	EROSION & SEDIMENT CONTROL PLAN		
5	MASTER PAVING & UTILITY PLAN		
6	TUCSON ROAD NW PLAN		
7	ALLEY PLAN & PROFILE		
8	COORS BLVD UTILITY PLAN		

#### **GENERAL NOTES**

- PERFORMED UNDER CONTRACT SHALL, EXCEPT AS OTHERWISE STATED OR PROVIDED FOR HEREON, BE CONSTRUCTED IN ACCORDANCE WITH THE CITY OF ALBUQUERQUE STANDARD SPECIFICATIONS FOR PUBLIC WORKS CONSTRUCTION 1986 EDITION AS AMENDED WITH 11.
- 2. ALL WORK ON THIS PROJECT SHALL BE PERFORMED IN ACCORDANCE WITH APPLICABLE FEDERAL, STATE, AND LOCAL LAWS, RULES, AND REGULATIONS CONCERNING CONSTRUCTION SAFETY AND HEALTH.
- PRIOR TO CONSTRUCTION, THE CONTRACTOR SHALL EXCAVATE & VERIFY THE HORIZONTAL AND VERTICAL LOCATIONS OF ALL OBSTRUCTIONS. SHOULD A CONFLICT EXIST, THE CONTRACTOR SHALL NOTIFY THE ENGINEER SO THAT THE CONFLICT CAN BE RESOLVED WITH MINIMUM DELAY.
- 4. TWO (2) WORKING DAYS PRIOR TO ANY EXCAVATION, CONTRACTOR MUST CONTACT LINE LOCATING SERVICE, NM 811, FOR LOCATION OF EXISTING UTILITIES.
- 5. CONTRACTOR SHALL CONDUCT HIS OPERATIONS IN A MANNER WHICH WILL MINIMIZE INTERFERENCE WITH LOCAL TRAFFIC. CONTRACTOR SHALL COMPLY WITH ALL APPLICABLE LAWS, ORDINANCES, RULES, REGULATIONS, AND ORDERS OF ANY PUBLIC BODY HAVING JURISDICTION FOR THE SAFETY OF PERSONS OR PROPERTY, AND TO PROTECT THEM FROM DAMAGE, INJURY, OR LOSS. CONTRACTOR SHALL ERECT AND MAINTAIN, AS REQUIRED BY THE CONDITIONS AND PROGRESS OF THE WORK, ALL NECESSARY SAFEGUARDS FOR SAFETY CONTRACTOR SHALL ADHERE TO SECTION 19 OF THE GENERAL CONDITIONS OF THE CITY OF ALBUQUERQUE STANDARD SPECIFICATIONS FOR PUBLIC WORKS CONSTRUCTION, 1986, AS AMENDED WITH UPDATE #8.
- THE CONTRACTOR AGREES THAT HE SHALL ASSUME THE SOLE AND COMPLETE RESPONSIBILITY FOR THE JOB SITE 16. CONDITIONS DURING THE COURSE OF CONSTRUCTION OF THIS PROJECT, INCLUDING SAFETY OF ALL PERSONS AND PROPERTY: THAT THIS REQUIREMENT SHALL APPLY CONTINUOUSLY AND NOT BE LIMITED TO NORMAL WORKING HOURS; AND THAT THE CONTRACTOR SHALL DEFEND, INDEMNIFY, AND HOLD HARMLESS THE OWNER & ENGINEER FROM ANY AND ALL LIABILITY REAL OR ALLEGED. IN CONNECTION WITH THE PERFORMANCE OF WORK ON THIS PROJECT, EXCEPTING LIABILITY ARISING FROM THE SOLE NEGLIGENCE OF THE OWNER OR ENGINEER.
- 7. TRAFFIC CONTROL: SEVEN (7) WORKING DAYS PRIOR TO BEGINNING CONSTRUCTION THE CONTRACTOR SHALL SUBMIT TO THE CONSTRUCTION COORDINATION DIVISION A DETAILED CONSTRUCTION SCHEDULE. TWO (2) WORKING DAYS PRIOR TO CONSTRUCTION, THE CONTRACTOR SHALL OBTAIN A BARRICADING PERMIT FROM THE CONSTRUCTION COORDINATION DIVISION. CONTRACTOR SHALL NOTIFY CONSTRUCTION COORDINATION ENGINEER (924-3400) PRIOR TO OCCUPYING AN INTERSECTION. SEE SECTION 19 OF THE SPECIFICATIONS. ALL STREET STRIPING ALTERED OR DESTROYED SHALL BE REPLACED WITH PRE-FORMED THERMOPLASTIC REFLECTORIZED PAVEMENT MARKINGS BY CONTRACTOR TO LOCATION AS EXISTING OR AS SHOWN IN THIS PLAN SET.
- 8. WHEN ABUTTING EXISTING PAVEMENT TO NEW, SAWCUT EXISTING PAVEMENT TO A STRAIGHT EDGE AND AT A RIGHT ANGLE. OR AS APPROVED BY THE FIELD ENGINEER. REMOVAL OF BROKEN OR CRACKED PAVEMENT WILL ALSO BE REQUIRED.
- EXISTING CURB AND GUTTER NOT TO BE REMOVED UNDER THE CONTRACT WHICH IS DAMAGED OR DISPLACED BY THE CONTRACTOR SHALL BE REMOVED AND REPLACED BY THE CONTRACTOR AT HIS EXPENSE PER COA STD DWG #2415A

- 10. SUPPLEMENTAL SPECIFICATION: ALL BACKFILL FOR WATER LINE AND SANITARY SEWER LINE TRENCHES SHALL BE COMPACTED TO A MINIMUM 95% MAXIMUM DENSITY PER ASTM D-1557.
- THE CONTRACTOR SHALL PROMPTLY CLEAN UP ANY MATERIAL EXCAVATED WITHIN THE PUBLIC RIGHT-OF-WAY OR PRIVATE ROADWAY EASEMENTS SO THAT THE EXCAVATED MATERIAL IS NOT SUSCEPTIBLE TO 21. BEING WASHED DOWN THE STREET OR INTO ANY PUBLIC DRAINAGE FACILITY.
- 12. PROPOSED WATERLINE MATERIALS SHALL BE EITHER PVC PIPE MEETING AWWA C900 DR-18 REQUIREMENTS (6"-12") OR DUCTILE IRON PIPE, THICKNESS CLASS 50
- ALL SANITARY SEWER LINE MATERIALS SHALL BE PVC
- 14. ALL FITTINGS ON WATERLINES SHALL HAVE RESTRAINED JOINTS AS NOTED ON PLANS.
- 15. THE CONTRACTOR SHALL NOTIFY THE ENGINEER NOT LESS THAN SEVEN (7) DAYS PRIOR TO STARTING WORK IN ORDER THAT THE CITY SURVEYOR MAY TAKE NECESSARY MEASURES TO ENSURE THE PRESERVATION 24. OF SURVEY MONUMENTS. CONTRACTOR SHALL NOT DISTURB PERMANENT SURVEY MONUMENTS WITHOUT THE CONSENT OF THE CITY SURVEYOR AND SHALL NOTIFY THE CITY SURVEYOR AND BEAR THE EXPENSE OF REPLACING ANY THAT MAY BE DISTURBED WITHOUT PERMISSION. REPLACEMENT SHALL BE DONE ONLY BY THE CITY SURVEYOR. WHEN A CHANGE IS MADE IN THE FINISHED ELEVATIONS OF THE PAVEMENT OF ANY ROADWAY IN WHICH A PERMANENT SURVEY MONUMENT IS26. THE CONTRACTOR SHALL COORDINATE WITH THE WATER LOCATED, CONTRACTOR SHALL, AT HIS OWN EXPENSE, ADJUST THE MONUMENT COVER TO THE NEW GRADE UNLESS OTHERWISE SPECIFIED. REFER TO SECTION 4.4 OF THE GENERAL CONDITIONS OF THE STANDARD SPECIFICATIONS UPDATE #9.
- PNM WILL PROVIDE AT NO COST TO THE CITY OR THE CONTRACTOR THE REQUIRED PERSONNEL FOR INSPECTION OR OBSERVATION DEEMED NECESSARY BY PNM WHILE THE CONTRACTOR IS EXPOSING PNM'S CABLES. HOWEVER, THE CONTRACTOR SHALL BE CHARGED THE TOTAL COST ASSOCIATED WITH REPAIRS TO ANY DAMAGED CABLES OR FOR ANY COST ASSOCIATED WITH SUPPORTING OR RELOCATING THE POLES AND CABLES DURING CONSTRUCTION.
- WARNING--EXISTING UTILITY LINE LOCATIONS ARE SHOWN IN AN APPROXIMATE MANNER ONLY, AND SUCH LINES MAY EXIST WHERE NONE ARE SHOWN. THE LOCATION OF 28. CONTRACTOR SHALL ASSIST THE ENGINEER/INSPECTOR IN ANY SUCH EXISTING LINES IS BASED UPON INFORMATION PROVIDED BY THE UTILITY COMPANY, THE OWNER, OR BY OTHERS, AND THE INFORMATION MAY BE INCOMPLETE OR MAY BE OBSOLETE BY THE TIME CONSTRUCTION COMMENCES. THE ENGINEER HAS UNDERTAKEN NO FIELD VERIFICATION OF THE LOCATION, DEPTH, SIZE, OR TYPE OF EXISTING UNDERGROUND UTILITY LINES, MAKES NO REPRESENTATION PERTAINING THERETO, AND ASSUMES 29. CONTRACTOR SHALL BE RESPONSIBLE FOR PROVIDING NO RESPONSIBILITY OR LIABILITY THEREFOR. THE CONTRACTOR SHALL INFORM ITSELF OF THE LOCATION OF ANY UTILITY LINE IN OR NEAR THE AREA OF THE WORK IN ADVANCE OF AND DURING EXCAVATION WORK. THE CONTRACTOR IS FULLY RESPONSIBLE FOR ANY AND ALL DAMAGE CAUSED BY ITS FAILURE TO LOCATE, IDENTIFY, AND PRESERVE ANY AND ALL EXISTING UTILITIES. THE CONTRACTOR SHALL COMPLY WITH STATE STATUTES. MUNICIPAL AND LOCAL ORDINANCES, RULES AND REGULATIONS PERTAINING TO THE LOCATION OF THESE LINES AND FACILITIES, IN PLANNING AND CONDUCTING EXCAVATION, WHETHER BY CALLING OR NOTIFYING THE UTILITIES, COMPLYING WITH "BLUE STAKES" PROCEDURES, OR OTHERWISE.
- 18. ANY WORK OCCURRING WITHIN A FULLY DEVELOPED ARTERIAL ROADWAY REQUIRES 24 HR. CONSTRUCTION AS ALLOWED BY THE CITY.

- MUST BE ACCOMPLISHED IN ACCORDANCE WITH OSHA 29CFR 1926.650 SUBPART
- 20. CONTRACTOR SHALL MAINTAIN A GRAFFITI-FREE WORK SITE. CONTRACTOR SHALL PROMPTLY REMOVE ANY AND


1"=750'±

- THE CONTRACTOR WILL BE RESPONSIBLE FOR DISPOSING OF ALL DEBRIS, INCLUDING, BUT NOT LIMITED TO HAZARDOUS WASTE AT DISPOSAL SITES APPROVED BY 34. GOVERNMENTAL AGENCIES REGULATING THE DISPOSAL OF SUCH MATERIALS.
- 22. TACK COAT FOR SURFACE COURSE REQUIREMENTS WILL BE DETERMINED BY THE ENGINEER.
- 23. PERMANENT PAVEMENT STRIPING AND MARKINGS WILL BE PLACED BY THE CONTRACTOR. THE ROAD SHALL NOT BE 36. OPENED TO THE TRAFFIC UNTIL IT IS STRIPED. ALL STRIPING, PAVEMENT MARKINGS INCLUDING CROSSWALKS, ARROWS AND LINE MARKINGS ARE TO BE CONSTRUCTED OF PREFORMED THERMO-PLASTIC IN ACCORDANCE WITH THE MANUAL ON UNIFORM TRAFFIC CONTROL DEVICES.
- ELECTRONIC MARKING SPHERES (EMS) WILL BE PLACED ACCORDING TO SECTION 170 OF THE CITY OF ALBUQUERQUE SPECIFICATIONS FOR PUBLIC WORKS CONSTRUCTION, 1986 EDITION AS REVISED THROUGH
- ALL WATER VALVE BOXES AND MANHOLES IN THE STREET CONSTRUCTION ARE TO BE ADJUSTED TO FINISH GRADE AND WILL BE MEASURED AND PAID PER EACH.
- AUTHORITY SEVEN (7) DAYS IN ADVANCE OF PERFORMING WORK THAT WILL AFFECT THE PUBLIC WATER OR SANITARY SEWER INFRASTRUCTURE, WORK REQUIRING SHUTOFF OF FACILITIES DESIGNATED AS MASTER PLAN FACILITIES MUST BE COORDINATED WITH THE WATER AUTHORITY 14 DAYS IN ADVANCE OF PERFORMING SUCH WORK. ONLY WATER AUTHORITY CREWS ARE AUTHORIZED TO OPERATE PUBLIC VALVES. SHUTOFF REQUESTS MUST BE MADE ONLINE AT http://www.abcwua.org/
- Water\_Shut\_off\_and\_Turn\_on\_Procedures.aspx. 27. CONTRACTOR SHALL SUPPORT ALL EXISTING. UNDERGROUND UTILITY LINES WHICH BECOME EXPOSED DURING CONSTRUCTION. PAYMENT FOR SUPPORTING WORK SHALL BE INCIDENTAL TO WATERLINE AND/OR

SEWER LINE COSTS.

- THE RECORDING OF DATA ON ALL UTILITY LINES AND ACCESSORIES AS REQUIRED BY THE CITY OF ALBUQUERQUE FOR THE PREPARATION OF RECORD DRAWINGS. CONTRACTOR SHALL NOT COVER UTILITY LINES AND ACCESSORIES UNTIL ALL DATA HAS BEEN RECORDED.
- AND MAINTAINING ALL CONSTRUCTION SIGNING UNTIL PROJECT HAS BEEN ACCEPTED BY THE CITY.
- THE CONTRACTOR SHALL NOTIFY THE ALBUQUERQUE TRAFFIC ENGINEERING DIVISION THRU DRC CHAIR THREE (3) WORKING DAYS IN ADVANCE OF ANY WORK THAT REMOVES, RELOCATES, OR REINSTALLS ANY EXISTING REGULATORY SIGNS.
- 31. RCP PIPE JOINTS SHALL BE INSTALLED SO THAT THE JOINT GAP AT THE HOME POSITION SHALL CONFORM TO THE APPROVED MANUFACTURER'S RECOMMENDATIONS. MANUFACTURER'S RECOMMENDED JOINT GAP TOLERANCES FOR EACH PIPE SIZE AND TYPE SHALL BE SUBMITTED TO THE ENGINEER FOR APPROVAL PRIOR TO PLACEMENT OF PIPE. RCP JOINTS SHALL NOT BE GROUTED UNLESS DIRECTED BY THE ENGINEER AFTER CITY APPROVAL

- 19. ALL EXCAVATION, TRENCHING AND SHORING ACTIVITIES 32. IF A PAVEMENT DROP-OFF IS CREATED DURING CONSTRUCTION, THE CONTRACTOR SHALL INITIATE PROTECTIVE MEASURES TO PREVENT ABRUPT PAVEMENT CHANGES. THIS WORK SHALL BE CONSIDERED INCIDENTAL TO CONSTRUCTION.
  - ALL GRAFFITI FROM EQUIPMENT, WHETHER PERMANENT 33. CONTRACTOR SHALL REPLACE IN KIND ANY EXISTING STRIPING OR ANY OTHER PAVEMENT MARKINGS IMPACTED BY THE WORK. THIS WORK SHALL BE CONSIDERED INCIDENTAL TO CONSTRUCTION.
    - THE CONTRACTOR SHALL MAINTAIN EXISTING PEDESTRIAN AND ADA PATHWAYS DURING CONSTRUCTION OR PROVIDE AN ALTERNATE ROUTE OR PROVIDE "SIDEWALK CLOSED"
    - 35. CONTRACTOR SHALL REPAIR OR REPLACE DISTURBED UTILITIES IMMEDIATELY AND WITHOUT DELAY.
    - IMPACT THE PROPOSED PROJECT WILL HAVE ON THE TRANSIT SYSTEM SUCH AS CAUSING A DETOUR, OR CAUSE THE CLOSING OR RELOCATION OF A BUS STOP THE CONTACT PERSON IS SHABIH RIZVI, OFFICE PHONE 505-724-3134, CELL PHONE 505-331-0253, AND EMAIL SRIZVI@CABQ.GOV AND/OR DOUGLAS GOFF, OFFICE PHONE 505-724-3137, CEL PHONE 505-206-0151, AND EMAIL DGOFF@CABQ.GOV.

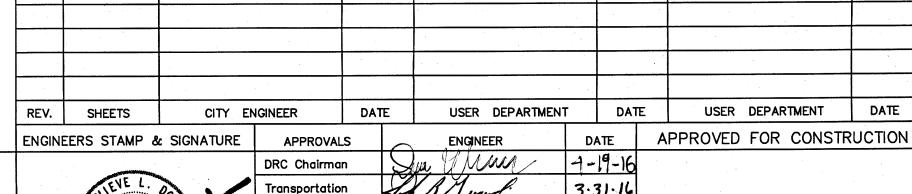

800780

DRB NO. NA Know what's **below**. Call before you dig.

ISAACSON & ARFMAN, P.A. **Consulting Engineering Associates** 


> 128 Monroe Street N.E. Albuquerque, New Mexico 87108 Ph. 505-268-8828 www.iacivil.com

2137 CC-001.dwg

Mar 31,2016

Transportation Tim Cynora Hydrology Constr. Mngmt. Constr. Coord. City Project No.

3.31.16 3.31.10 City Engineer

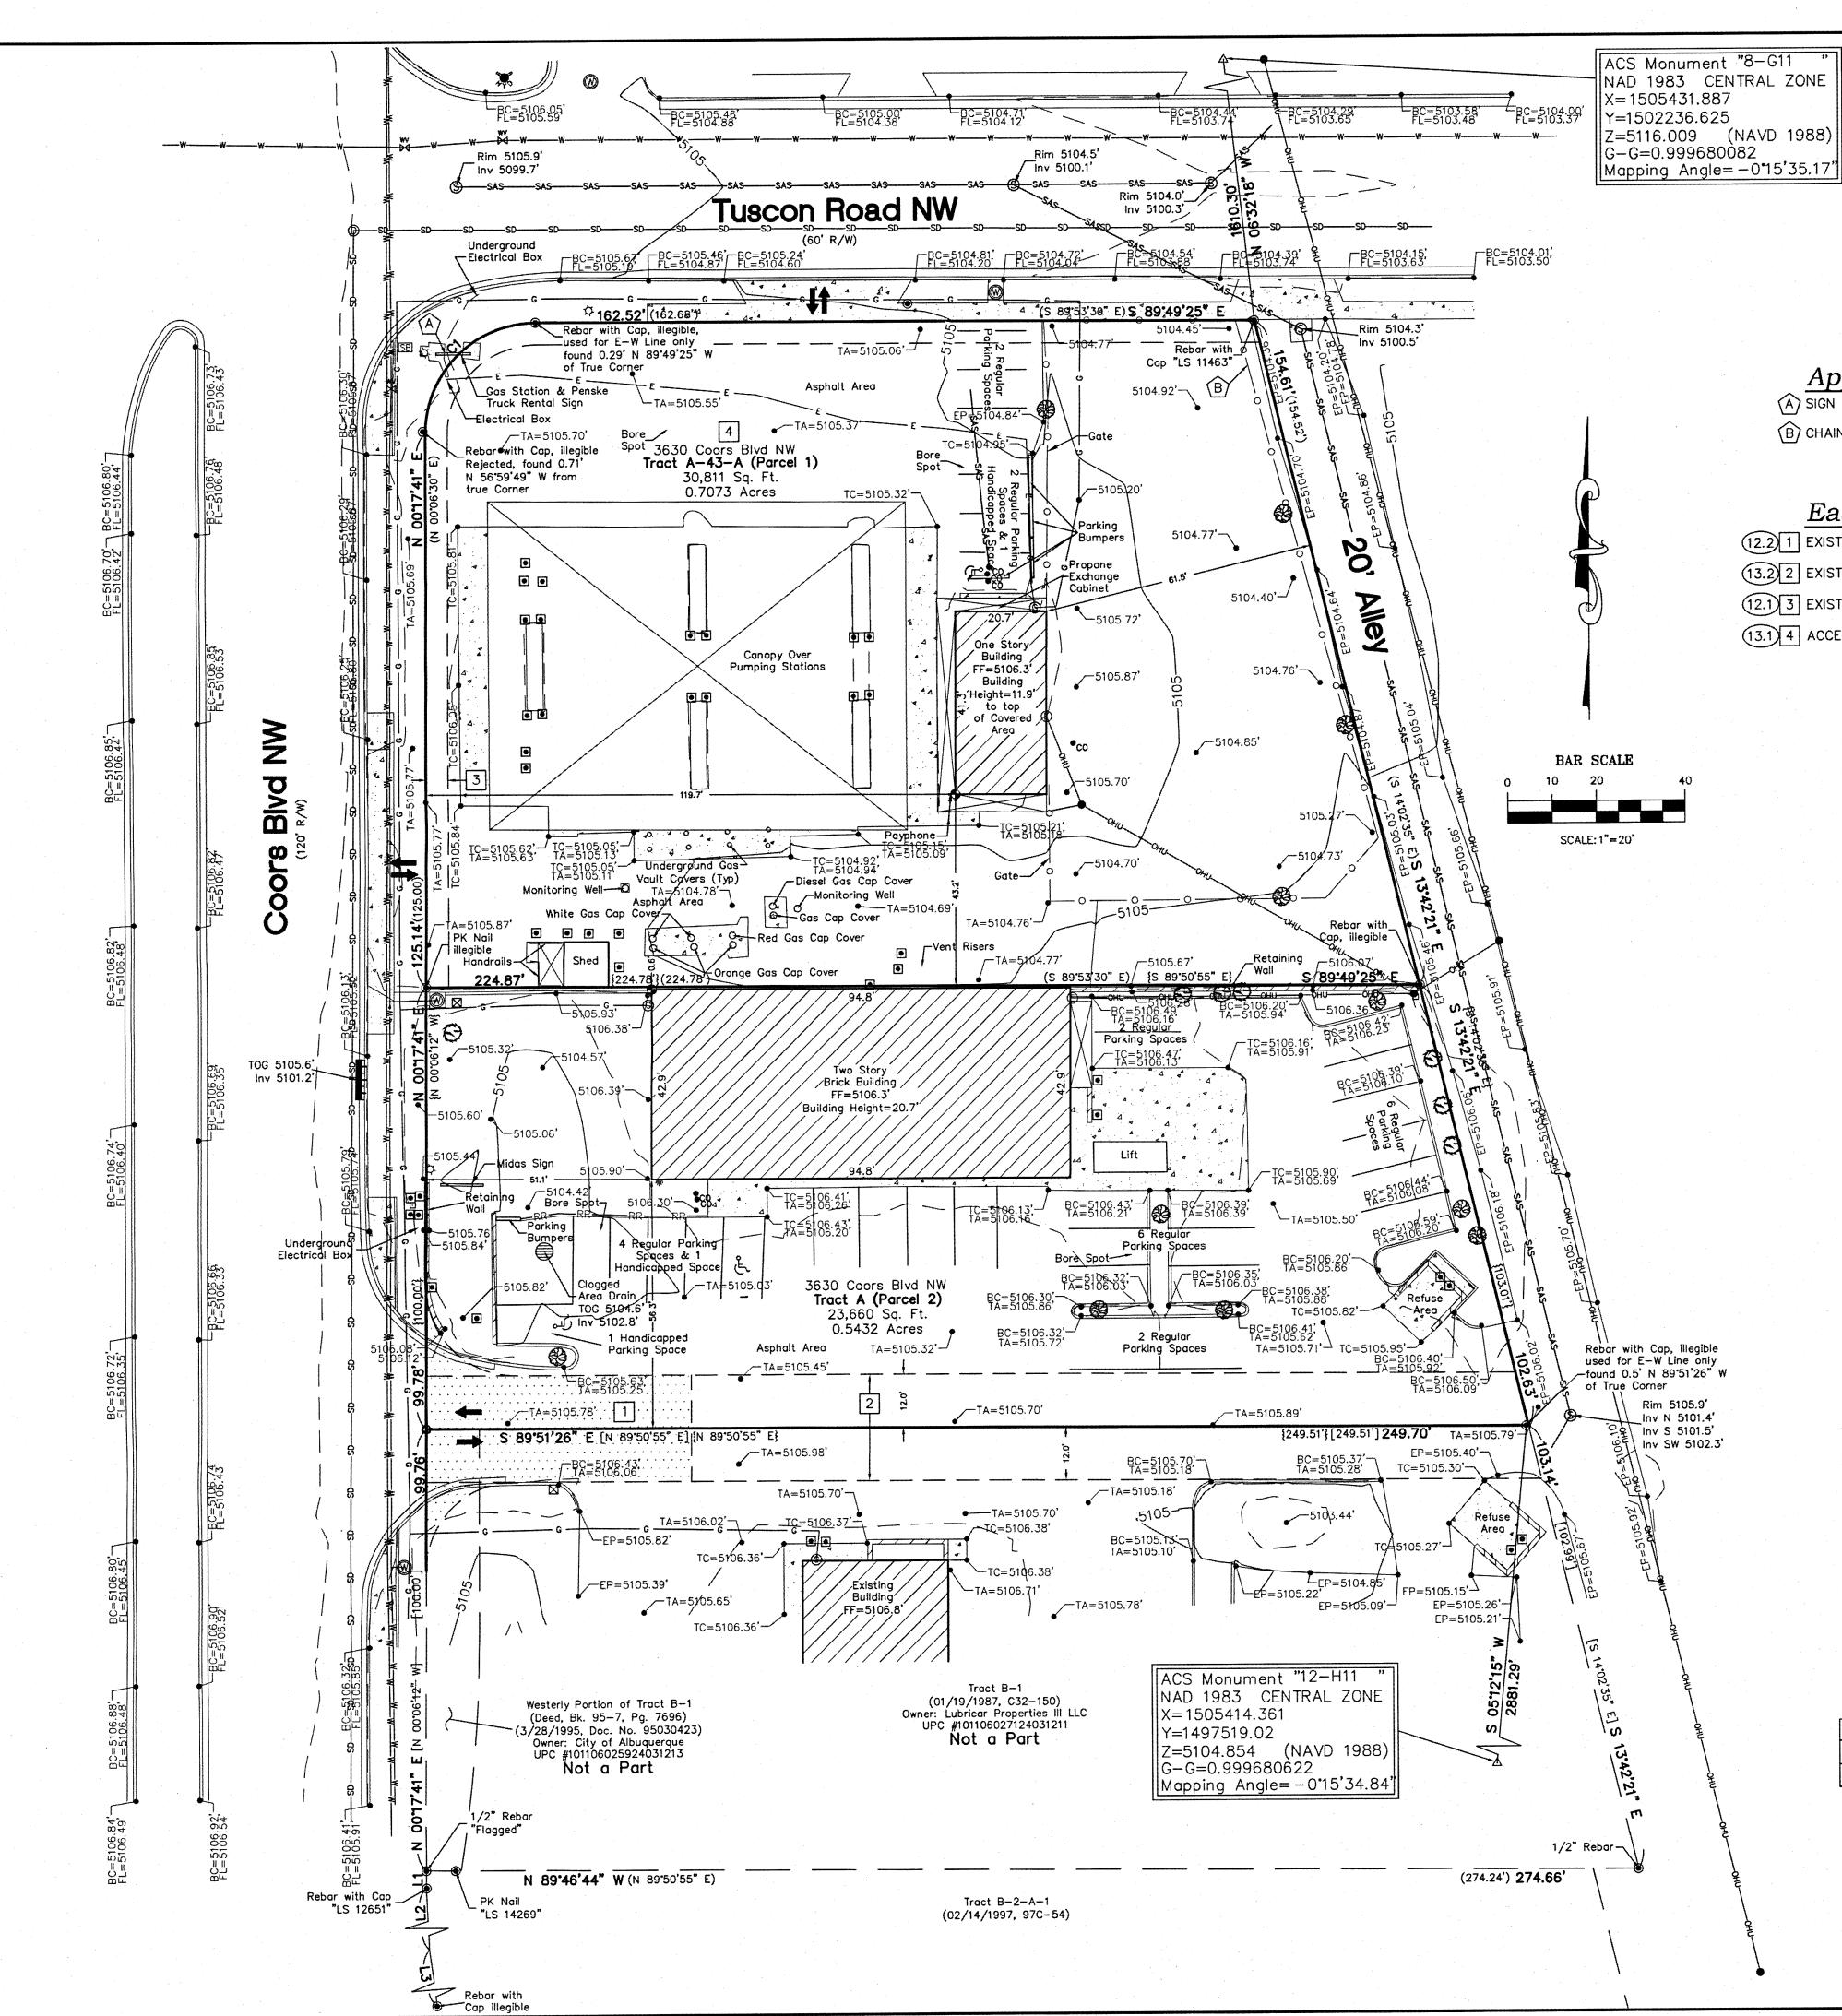

- Apparent Encroachments

  (A) SIGN INTO RIGHT-OF-WAY BY AS MUCH AS 3.9 FEET.
- (B) CHAINLINK FENCE ANGLES INTO SUBJECT PROPERTY BY AS MUCH AS 4.2 FEET.

#### Easement Notes

- 12.2 1 EXISTING 24' COMMON ACCESS EASEMENT (1/19/87, C32-150)
- (13.2) 2 EXISTING 24' ACCESS AND ROADWAY INTERCHANGE EASEMENT (2/4/87, BK. MISC. 449-A, PG. 120)
- 12.1 3 EXISTING 5' UTILITY EASEMENT (4/19/79, A7-54)
- (13.1) 4 ACCESS AGREEMENT (1/2/09, DOC. NO. 2009000189)

Boundary Survey Plat
and
ALTA/ACSM Land Title Survey
for
Tract "A"
Town of Atrisco Grant
Northeast Unit
City of Albuquerous

City of Albuquerque Bernalillo County, New Mexico July 2015

T		
10	MI	317
LAC	$\simeq$ $\iota$	2n

	<u>Legend</u>	
	N 90'00'00" E	MEASURED BEARINGS AND DISTANCES
	(N 90°00'00" E)	RECORD BEARINGS AND DISTANCES (A7-54)
	[N 90°00'00" E]	RECORD BEARINGS AND DISTANCES (C32-150)
	{N 90.00,00, E}	RECORD BEARINGS AND DISTANCES (C25-194)
	((N 90°00'00" E))	RECORD BEARINGS AND DISTANCES (97C-54)
	•	FOUND MONUMENT AS INDICATED
	0	SET PK NAIL WITH TAG "LS 14271" UNLESS OTHERWISE NOTED
		COVERED AREA
		CONCRETE
		BLOCK WALL
	<del></del> o	CHAINLINK FENCE WITH BARBED WIRE
	•	BOLLARD
	OHU	OVERHEAD UTILITY LINE
	•	UTILITY POLE
	❖	LIGHT POLE
	Ē	ELECTRIC METER
	SB	SIGNAL BOX
	©	GAS METER
	w∨ ⊠	WATER VALVE
•	<b>8</b>	WATER METER
	*	FIRE HYDRANT
	<b>S</b>	SANITARY SEWER MANHOLE
	•∞	SAS CLEANOUT
		IRRIGATION BOX
		STORM DRAIN INLET
	0	STORM DRAIN MANHOLE
	<b>\$</b>	CURB CUT/INDICATION OF ACCESS TO ROADWAY
	<b>⊗</b>	DECIDUOUS TREE
	€	SHRUB
	•	LOCATION OF COLLECTED BUILDING HEIGHT
	5075.50	SPOT ELEVATION
	BC 5075.50	BACK OF CURB ELEVATION
	FL 5075.50	FLOW LINE ELEVATION
	EP 5075.50	EDGE OF PAVEMENT ELEVATION
	TA 5075.50	TOP OF ASPHALT ELEVATION
	TC 5075.50	TOP OF CONCRETE ELEVATION


Line Table				
Line #	Direction	Length		
L1	N 0017'41" E ((N 0013'04" E))	3.95' ((3.93'))		
L2	N 02°36'51" W ((N 02°35'04" W))	70.28' ((70.36'))		
L3	N 06'49'00" W ((N 06'47'13" W))	68.16' ((68.23'))		

Curve Table						
Curve #	Length	Radius	Delta	Chord Length	Chord Direction	
C1	39.22'(37.27')	25.00' (25.00')	89*52'54"	35.32	S 45"14'08" W	


CARTESIAN SURVEYS INC.

P.O. BOX 44414 RIO RANCHO, N.M. 87174 Phone (505) 896 - 3050 Fax (505) 891 - 0244

Sheet 2 of 2

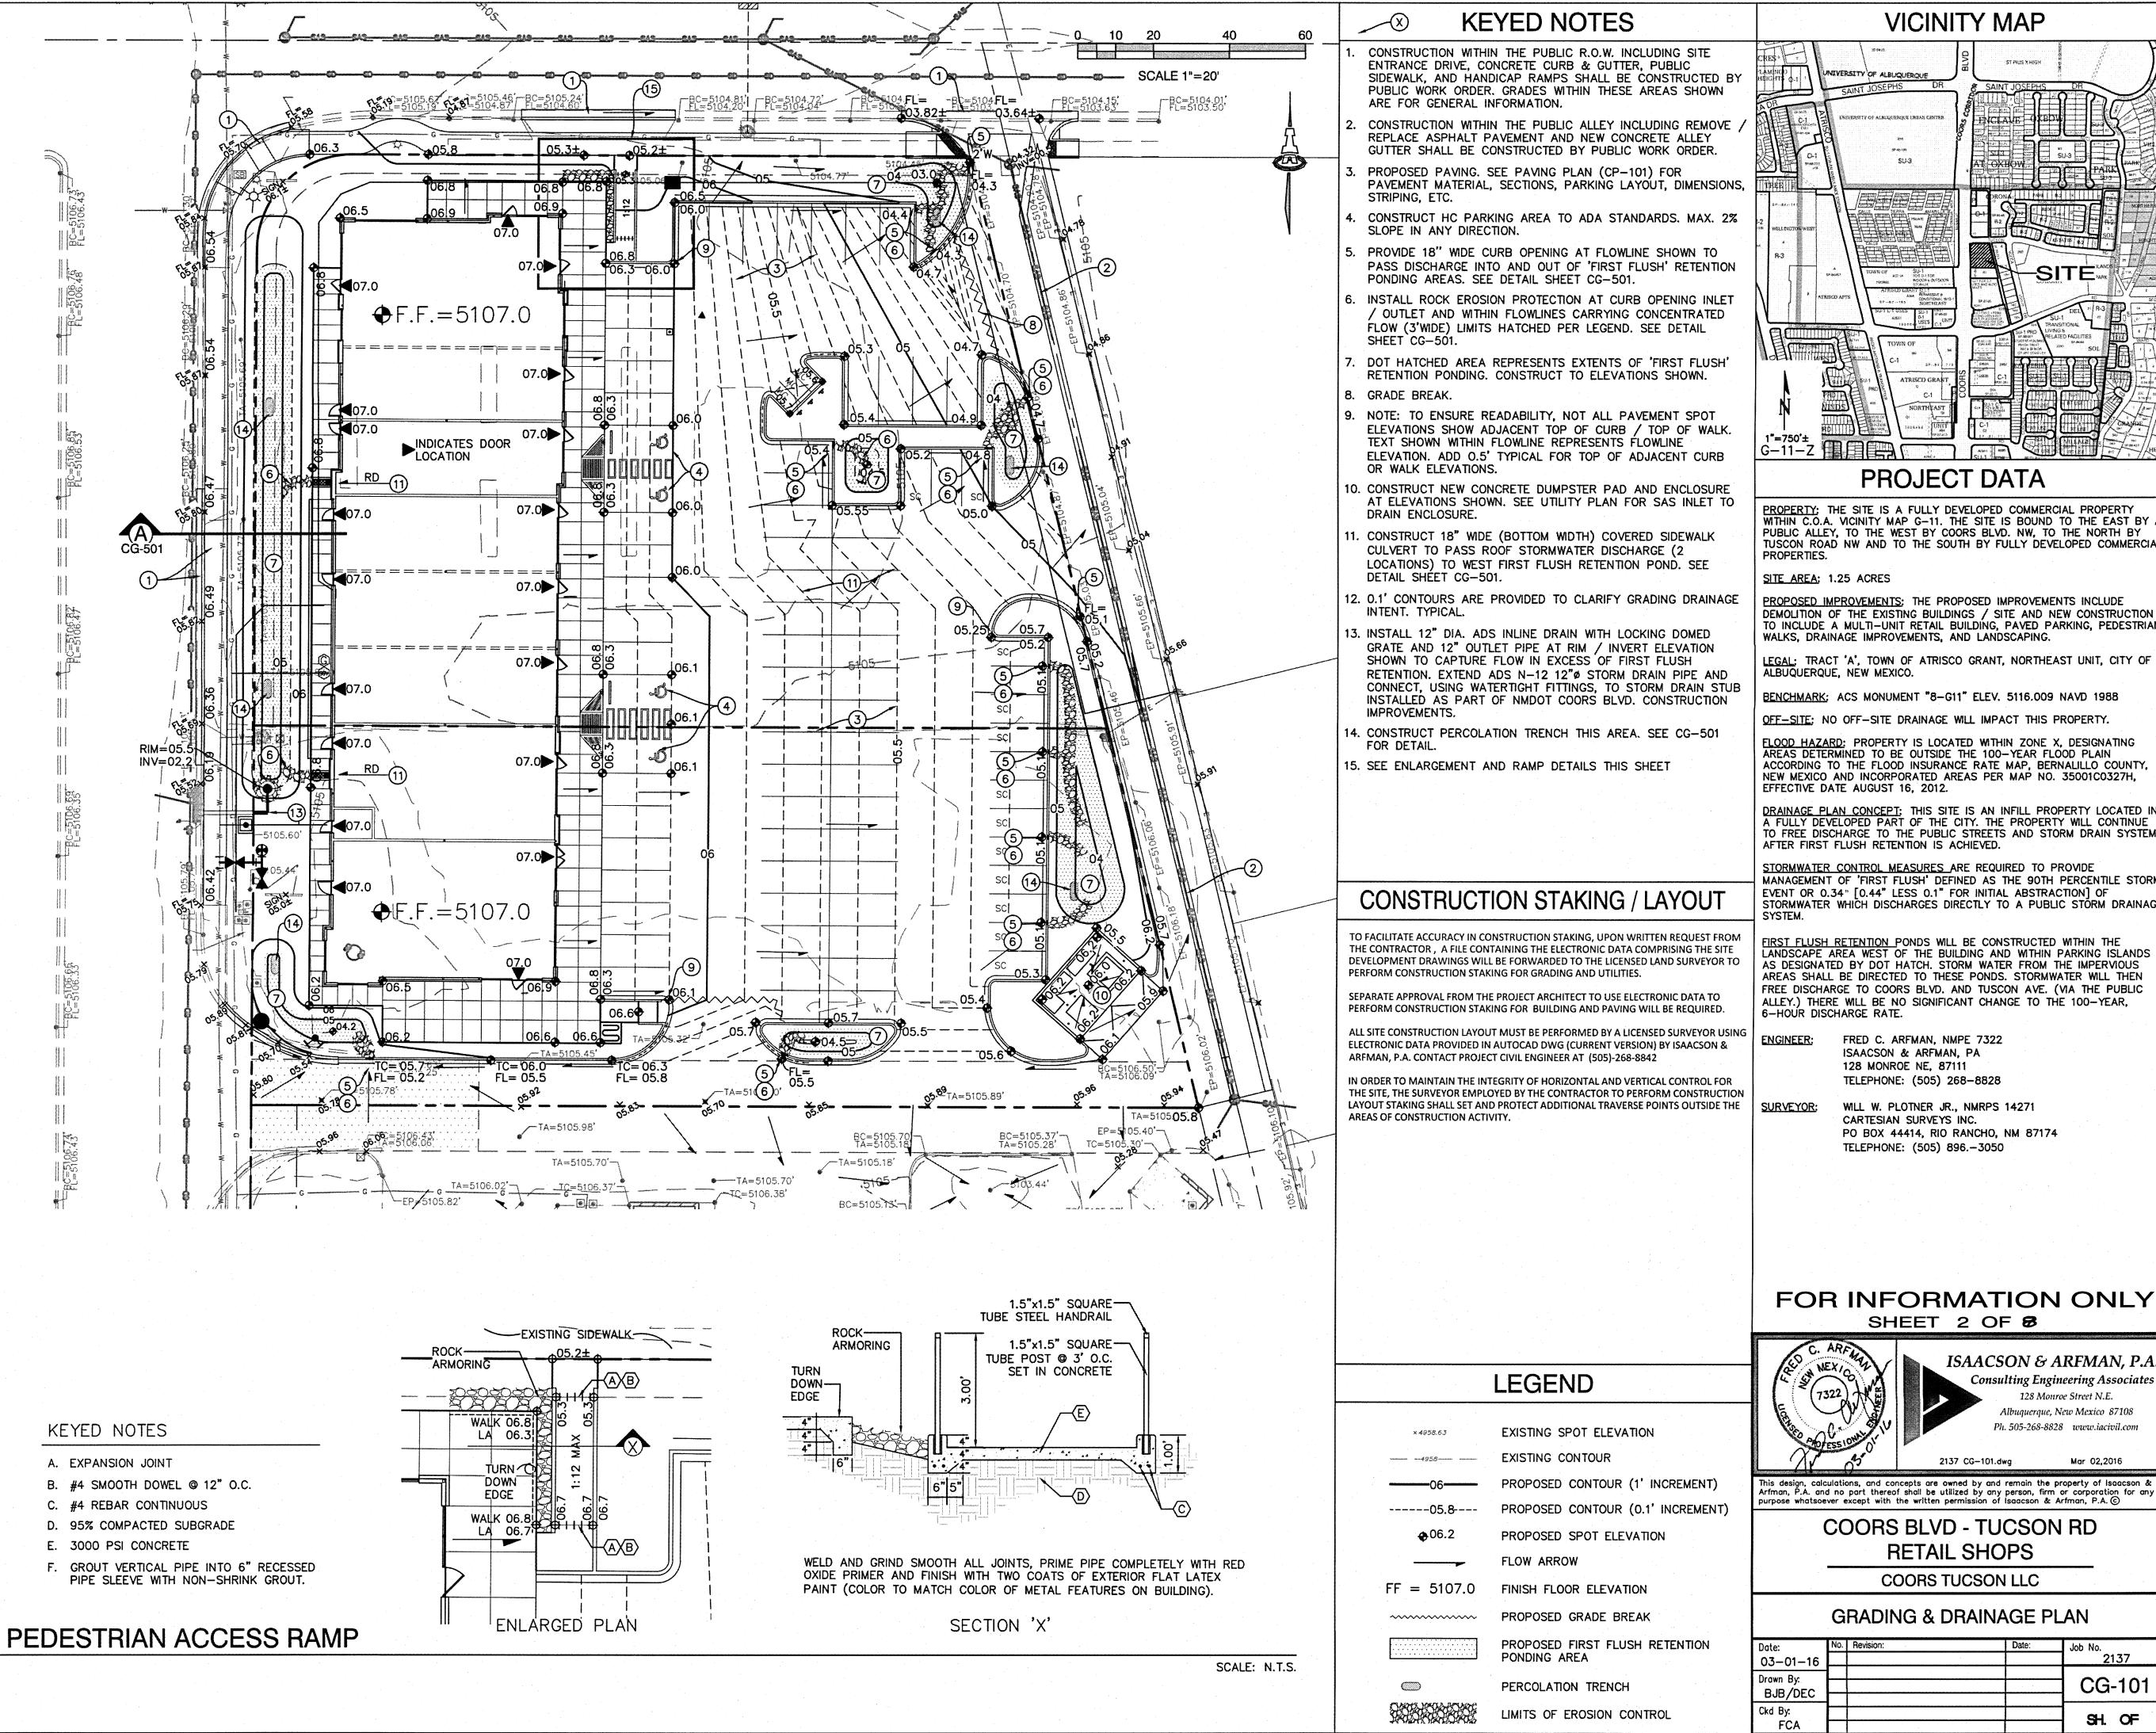

**VICINITY MAP** 

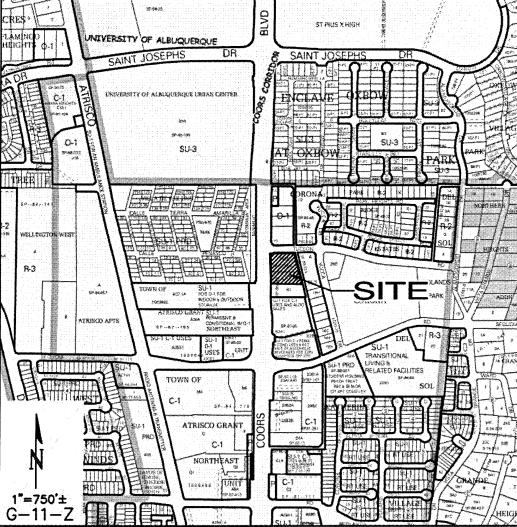

#### PROJECT DATA

PROPERTY: THE SITE IS A FULLY DEVELOPED COMMERCIAL PROPERTY WITHIN C.O.A. VICINITY MAP G-11. THE SITE IS BOUND TO THE EAST BY A PUBLIC ALLEY, TO THE WEST BY COORS BLVD. NW, TO THE NORTH BY TUSCON ROAD NW AND TO THE SOUTH BY FULLY DEVELOPED COMMERCIAL PROPERTIES.

SITE AREA: 1.25 ACRES

PROPOSED IMPROVEMENTS: THE PROPOSED IMPROVEMENTS INCLUDE DEMOLITION OF THE EXISTING BUILDINGS / SITE AND NEW CONSTRUCTION TO INCLUDE A MULTI-UNIT RETAIL BUILDING, PAVED PARKING, PEDESTRIAN WALKS, DRAINAGE IMPROVEMENTS, AND LANDSCAPING.

LEGAL: TRACT 'A', TOWN OF ATRISCO GRANT, NORTHEAST UNIT, CITY OF ALBUQUERQUE, NEW MEXICO.

BENCHMARK: ACS MONUMENT "8-G11" ELEV. 5116.009 NAVD 1988

OFF-SITE: NO OFF-SITE DRAINAGE WILL IMPACT THIS PROPERTY.

FLOOD HAZARD: PROPERTY IS LOCATED WITHIN ZONE X, DESIGNATING AREAS DETERMINED TO BE OUTSIDE THE 100-YEAR FLOOD PLAIN ACCORDING TO THE FLOOD INSURANCE RATE MAP, BERNALILLO COUNTY, NEW MEXICO AND INCORPORATED AREAS PER MAP NO. 35001C0327H, EFFECTIVE DATE AUGUST 16, 2012.

DRAINAGE PLAN CONCEPT: THIS SITE IS AN INFILL PROPERTY LOCATED IN A FULLY DEVELOPED PART OF THE CITY. THE PROPERTY WILL CONTINUE TO FREE DISCHARGE TO THE PUBLIC STREETS AND STORM DRAIN SYSTEM AFTER FIRST FLUSH RETENTION IS ACHIEVED.


STORMWATER CONTROL MEASURES ARE REQUIRED TO PROVIDE MANAGEMENT OF 'FIRST FLUSH' DEFINED AS THE 90TH PERCENTILE STORM EVENT OR 0.34" [0.44" LESS 0.1" FOR INITIAL ABSTRACTION] OF STORMWATER WHICH DISCHARGES DIRECTLY TO A PUBLIC STORM DRAINAGE

FIRST FLUSH RETENTION PONDS WILL BE CONSTRUCTED WITHIN THE LANDSCAPE AREA WEST OF THE BUILDING AND WITHIN PARKING ISLANDS AS DESIGNATED BY DOT HATCH. STORM WATER FROM THE IMPERVIOUS AREAS SHALL BE DIRECTED TO THESE PONDS. STORMWATER WILL THEN FREE DISCHARGE TO COORS BLVD. AND TUSCON AVE. (VIA THE PUBLIC ALLEY.) THERE WILL BE NO SIGNIFICANT CHANGE TO THE 100-YEAR, 6-HOUR DISCHARGE RATE.

FRED C. ARFMAN, NMPE 7322 ISAACSON & ARFMAN, PA 128 MONROE NE, 87111 TELEPHONE: (505) 268-8828

WLL W. PLOTNER JR., NMRPS 14271 CARTESIAN SURVEYS INC. PO BOX 44414, RIO RANCHO, NM 87174 TELEPHONE: (505) 896.-3050

#### FOR INFORMATION ONLY SHEET 2 OF 8

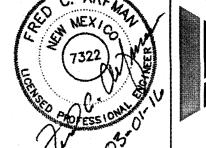

# ISAACSON & ARFMAN, P.A.

Consulting Engineering Associates 128 Monroe Street N.E. Albuquerque, New Mexico 87108 Ph. 505-268-8828 www.iacivil.com

2137 CG-101.dwg Mar 02,2016

Arfman, P.A. and no part thereof shall be utilized by any person, firm or corporation for any purpose whatsoever except with the written permission of Isaacson & Arfman, P.A. ©

**COORS BLVD - TUCSON RD RETAIL SHOPS** COORS TUCSON LLC

**GRADING & DRAINAGE PLAN** 

Job No. 2137 CG-101 BJB/DEC SH. OF FCA

