

tied to 1/2" polypipe with flush caps at each end

Run time per each drip valve will be approximately 15 minutes per. day, to be adjusted according to the season.

Point of connection for irrigation system is unknown at current time and will be coordinated in the field.

Irrigation will be operated by automatic controller. Location of controller to be field determined and power source for controller to be provided by others.

Irrigation maintenance shall be the responsibility of the Property Owner. conservation Landscaping and waste water ordinance, planting restriction approach.

Approval of this plan does not constitute or imply exemption from water waste provisions of the water conservation landscaping and water waste ordinance. Water management is the sole responsibility of the Property Owner.

All landscaping will be in conformance with the City of Albuquerque Zoning Code, Street Tree ordinance, Pollen Ordinance, and Water Conservation Landscaping and Water Waste ordinance. In general, water conservative, environmentally sound landscape principles will be followed in design and installation.

Plant beds shall achieve 75% live ground cover at Maturity.

3/4" Santa Fe Brown Gravel over Filter Fabric shall be placed in all landscape areas which are not designated to recieve native seed.


Albuquerque, NM 87184 Ph. (505) 898-9690 Fax (505) 898-7737 it@hilltoplandscaping.com


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THE HILLTOP


		554444
ENGINEER'S SEAL	ALBUQUERQUE SAM'S	DRAWN BY BDG
	EXPANSION, NM: 6672	DATE
		7-07-00
·	LANDSCAPE PLAN	9929LP-DC.DWG
		SHEET #
	TIERRA WEST, LLC 8509 JEFFERSON NE ALBUQUERQUE, NEW MEXICO 87113	4
RONALD R. BOHANNAN P.E. #7868	(505)858–3100	JOB # 990029


SCALE: 1"=50'




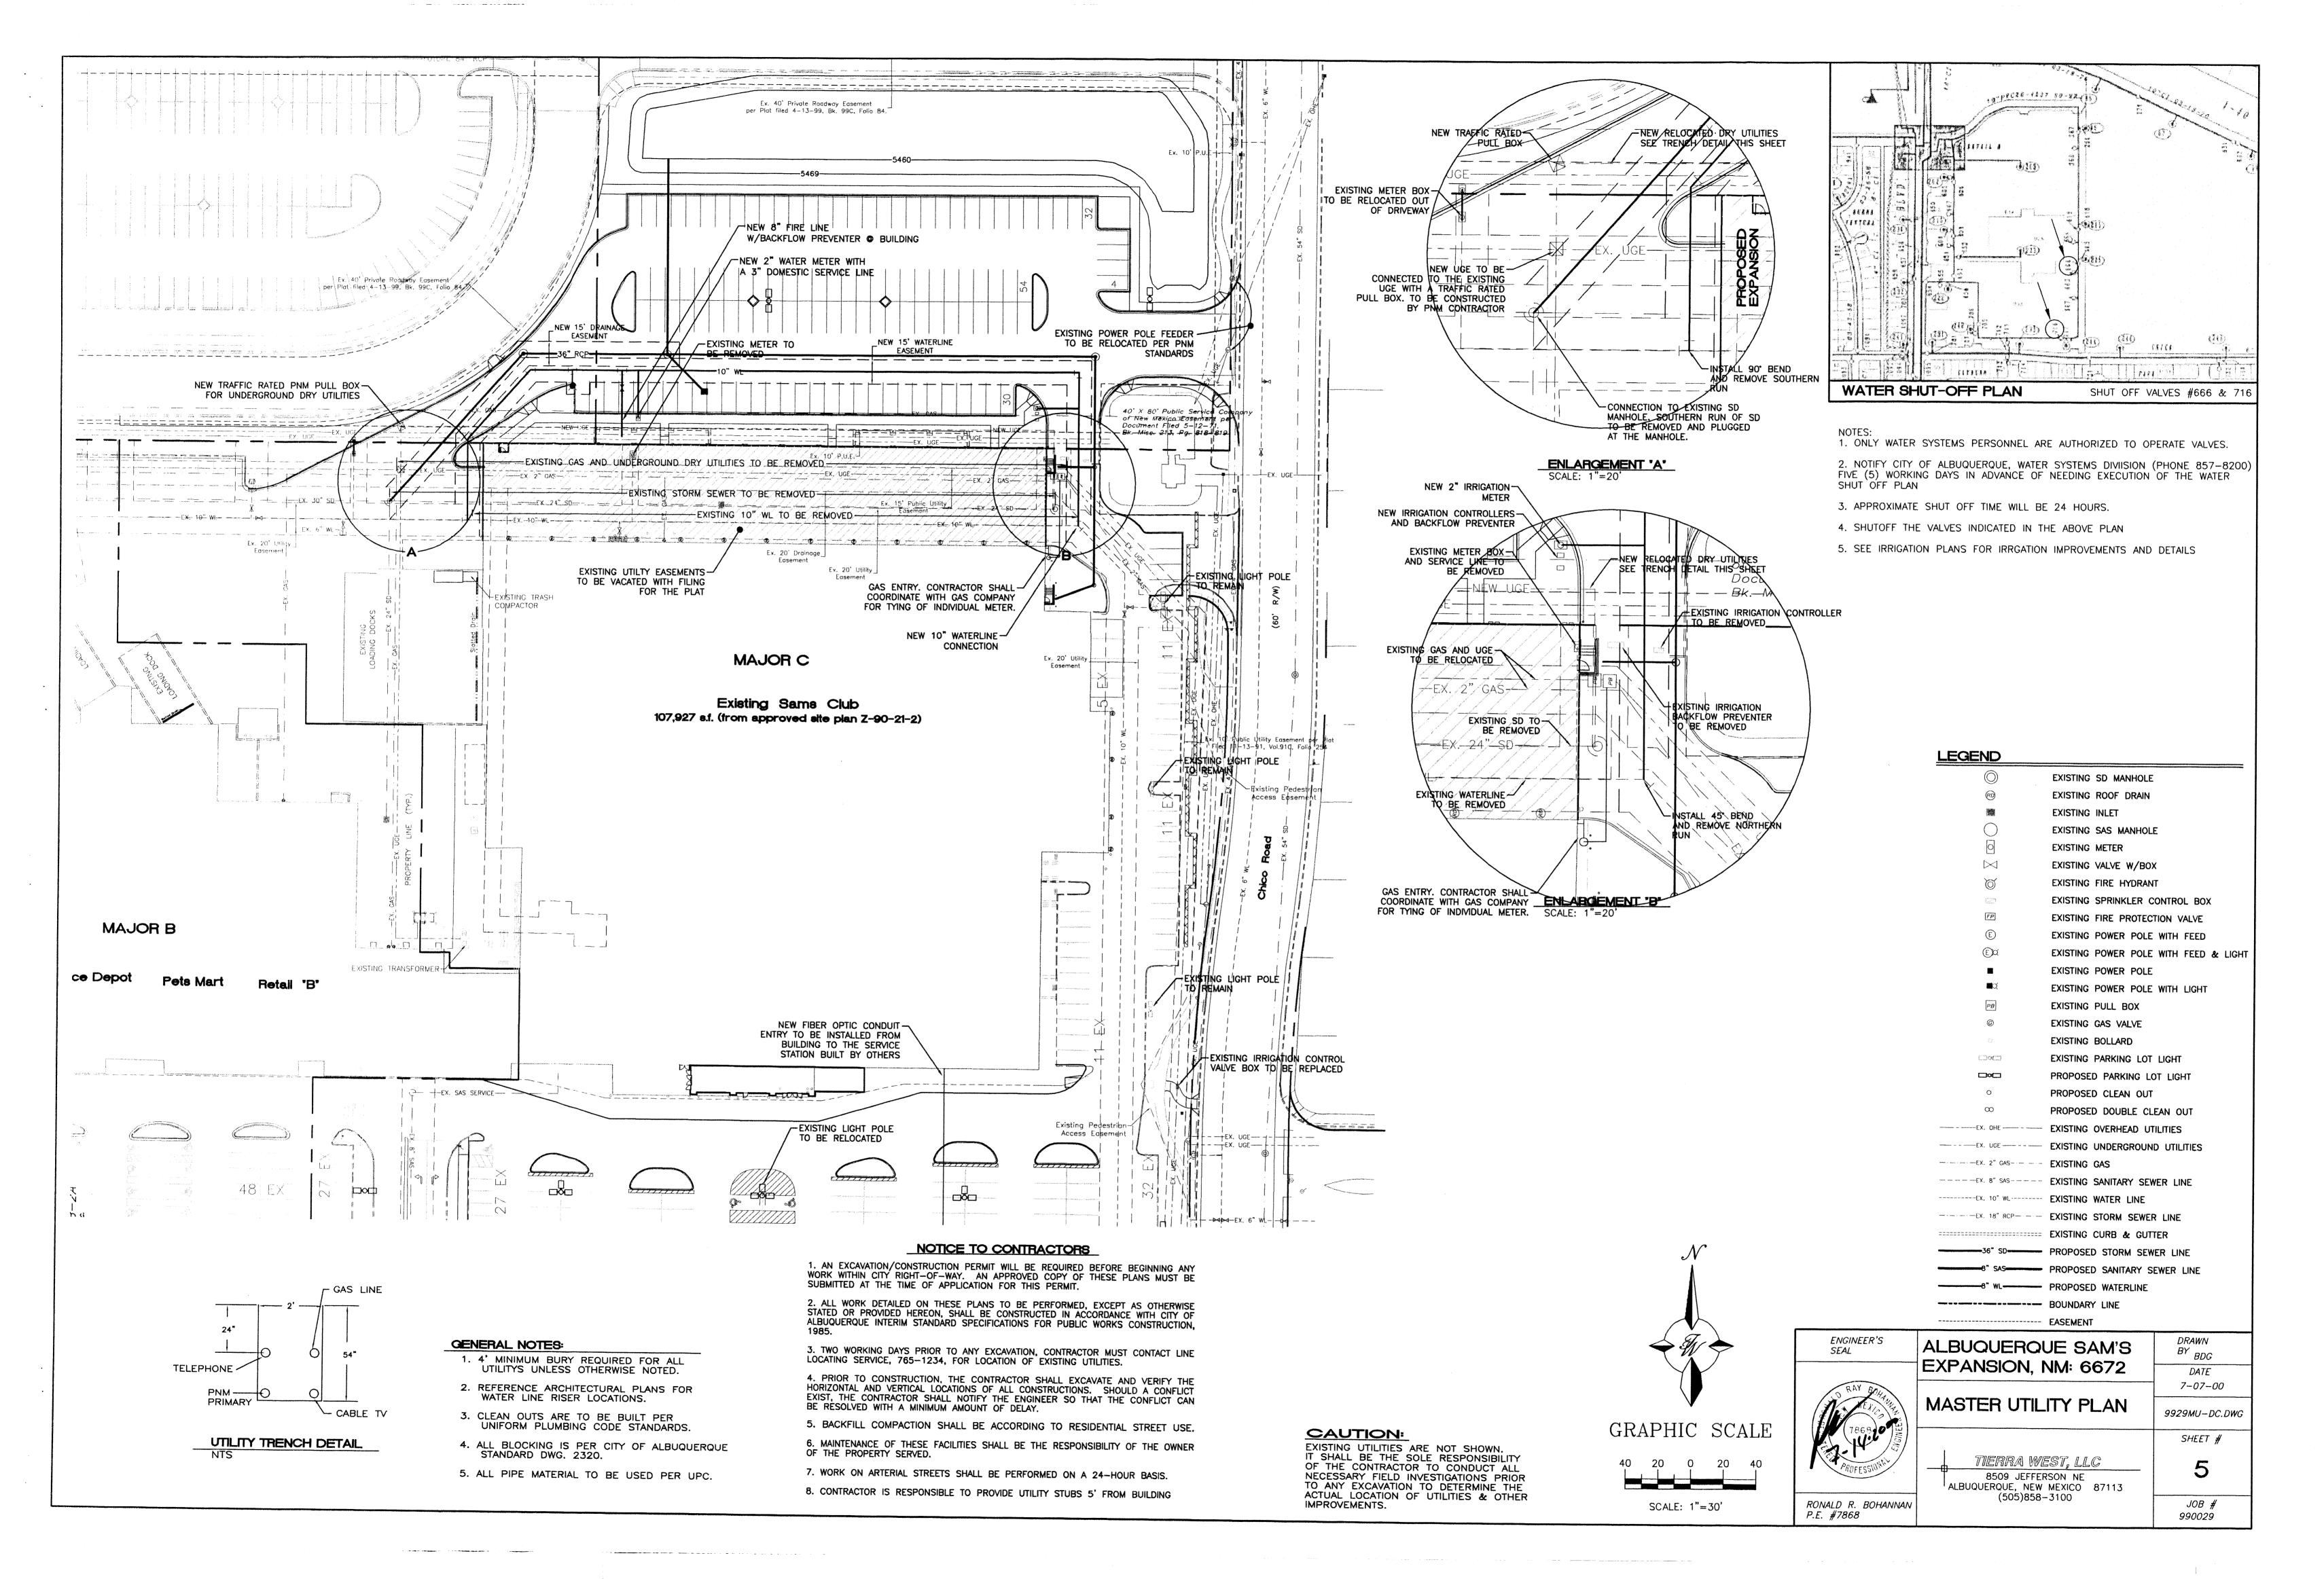


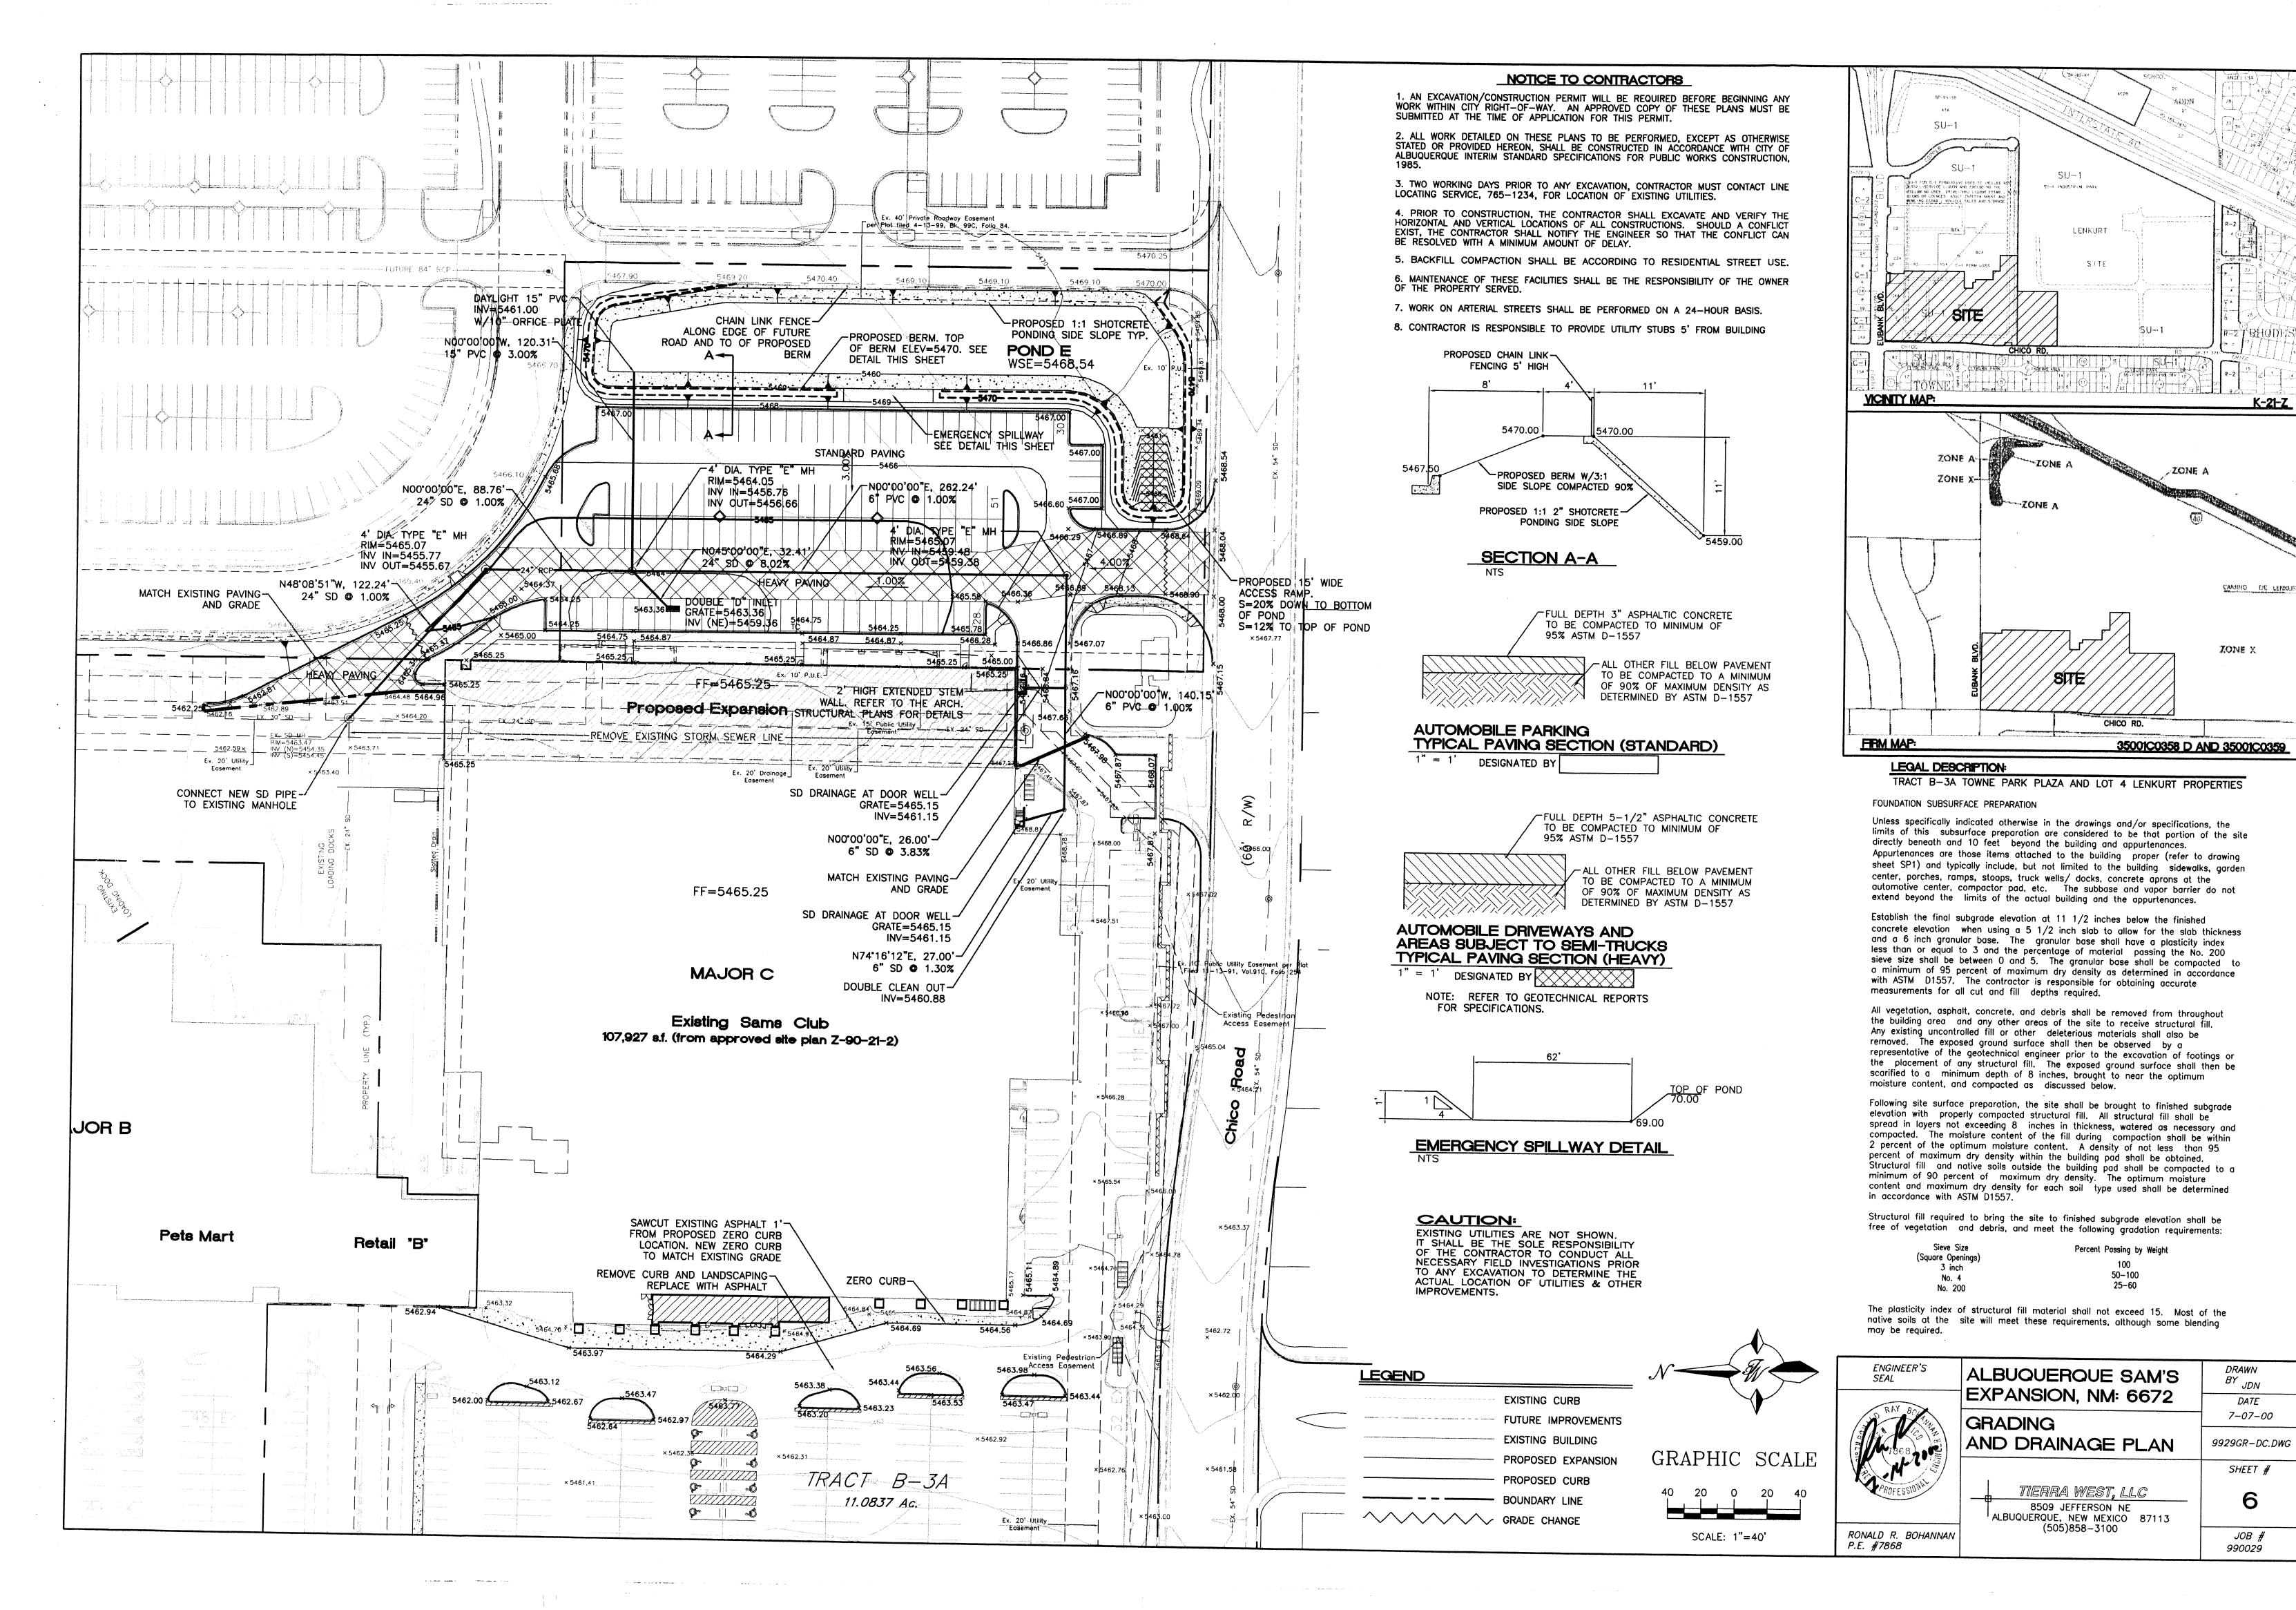K-21-Z

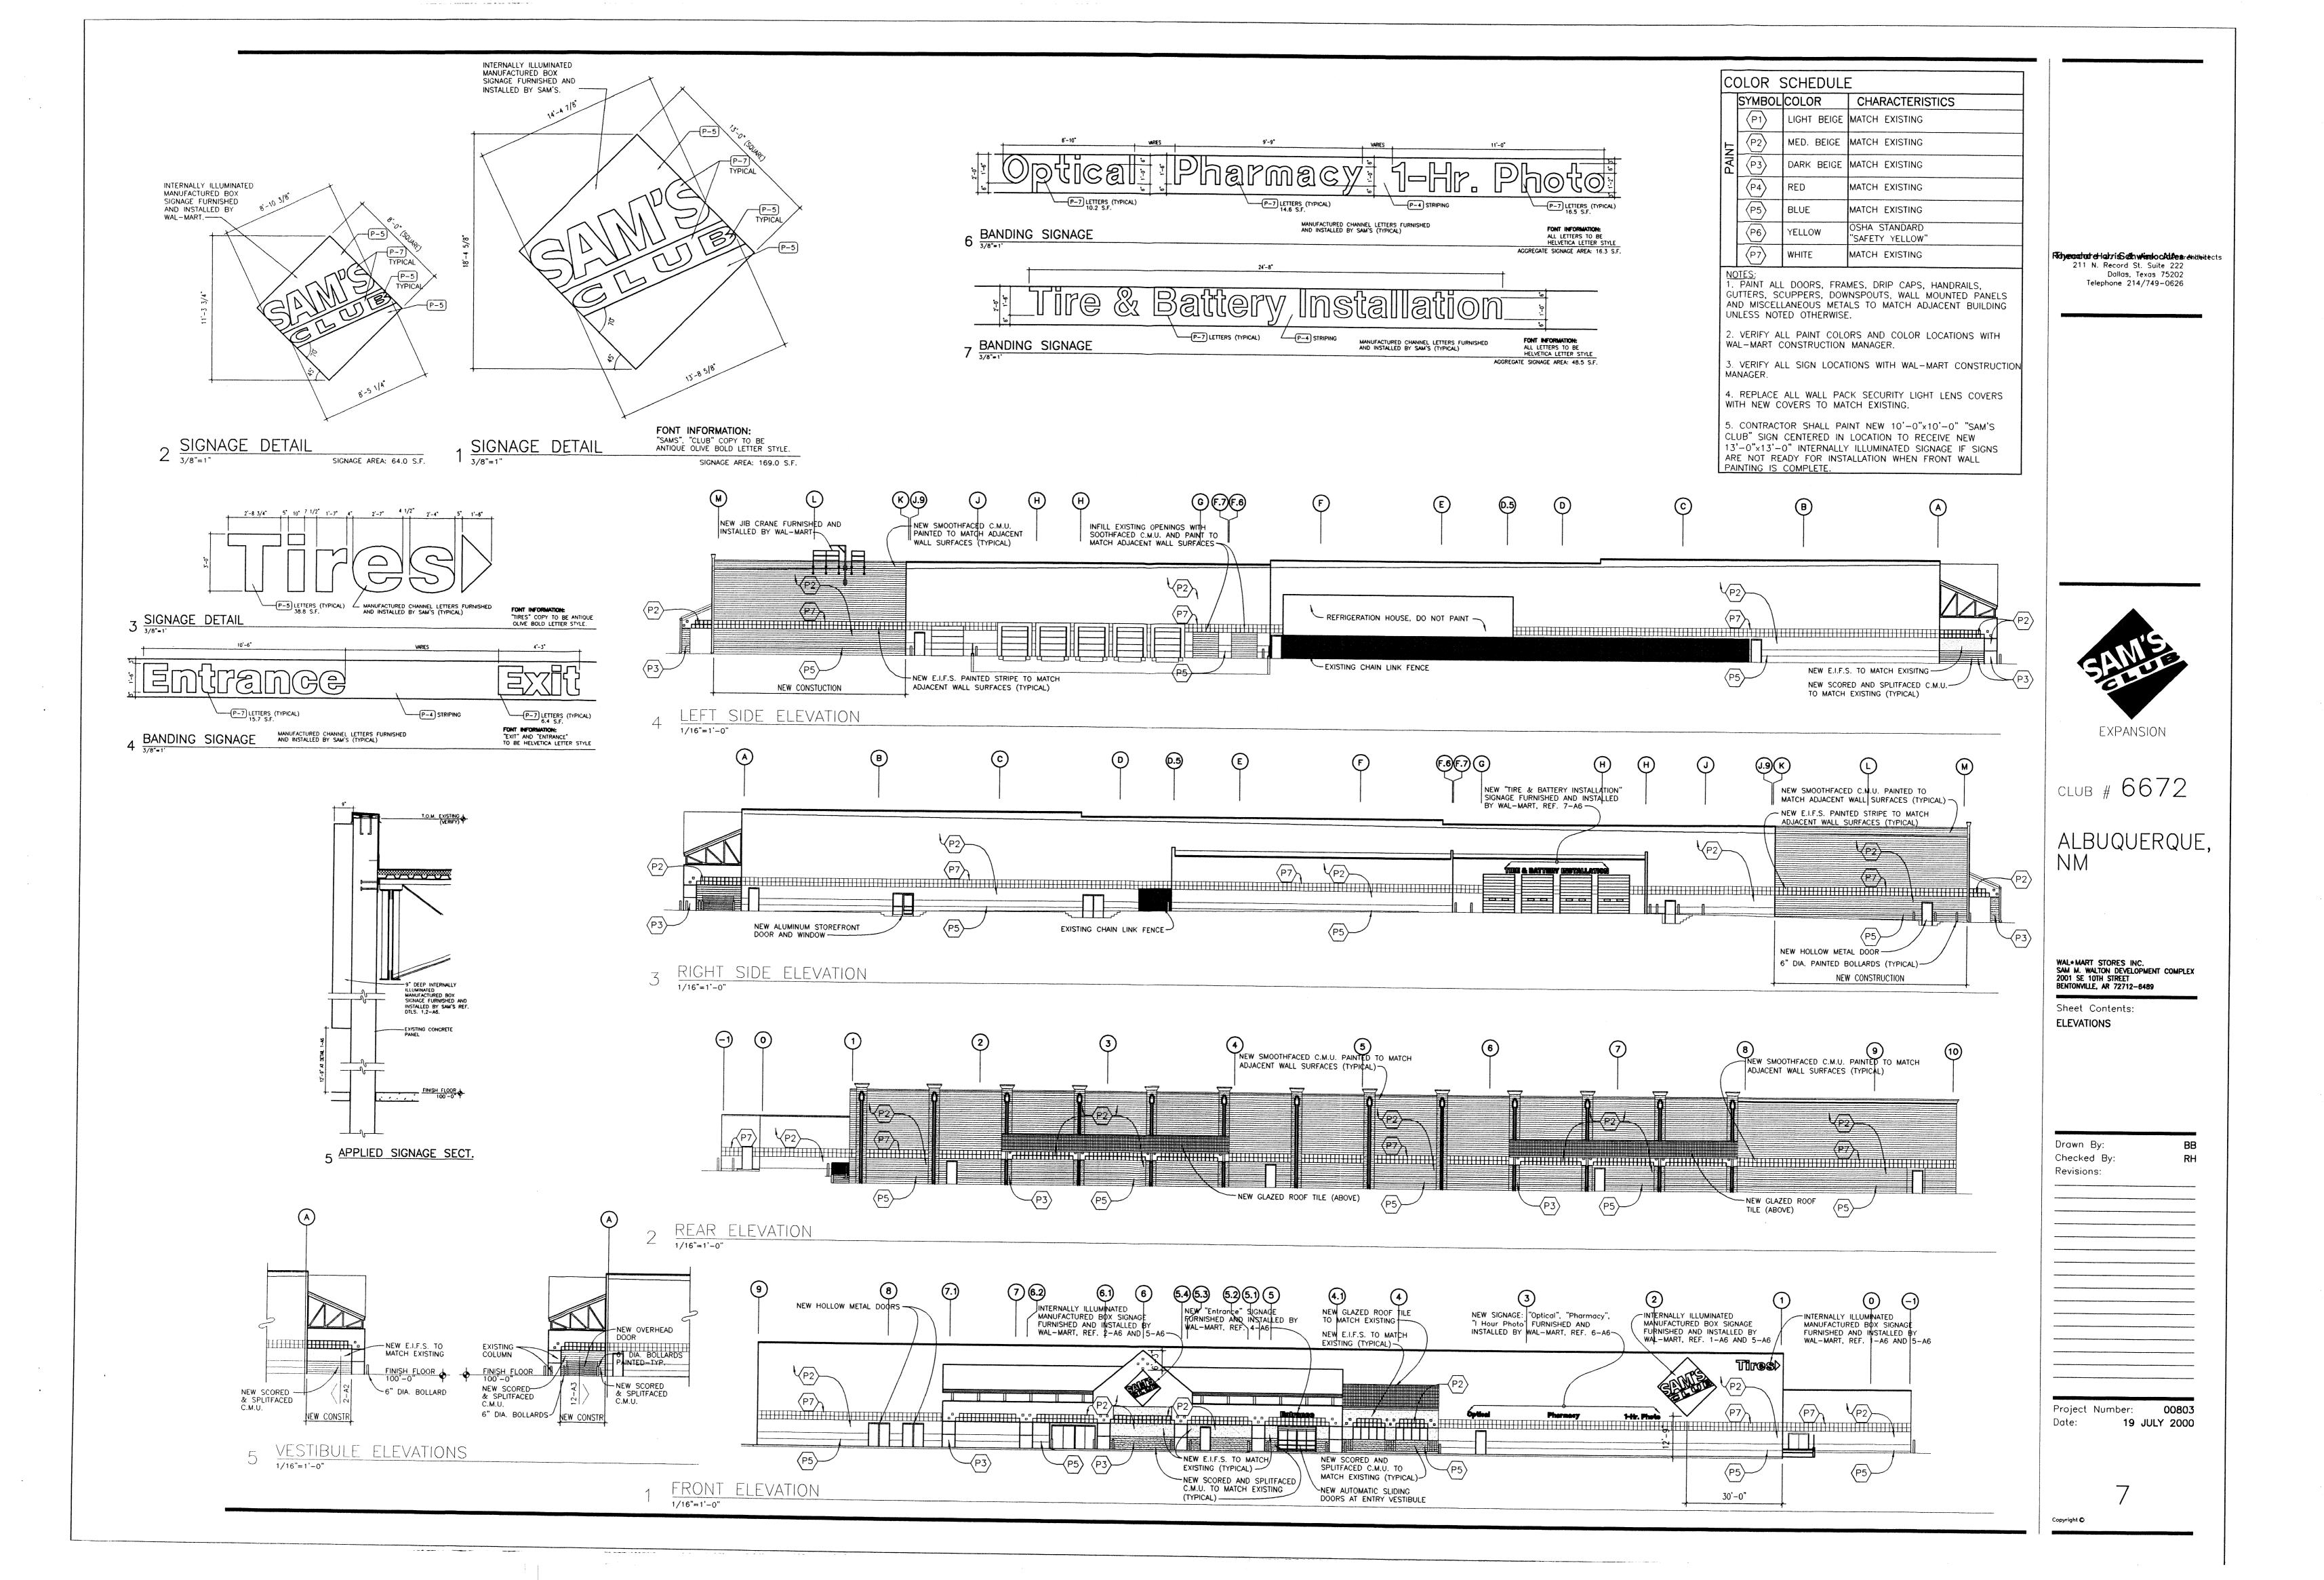

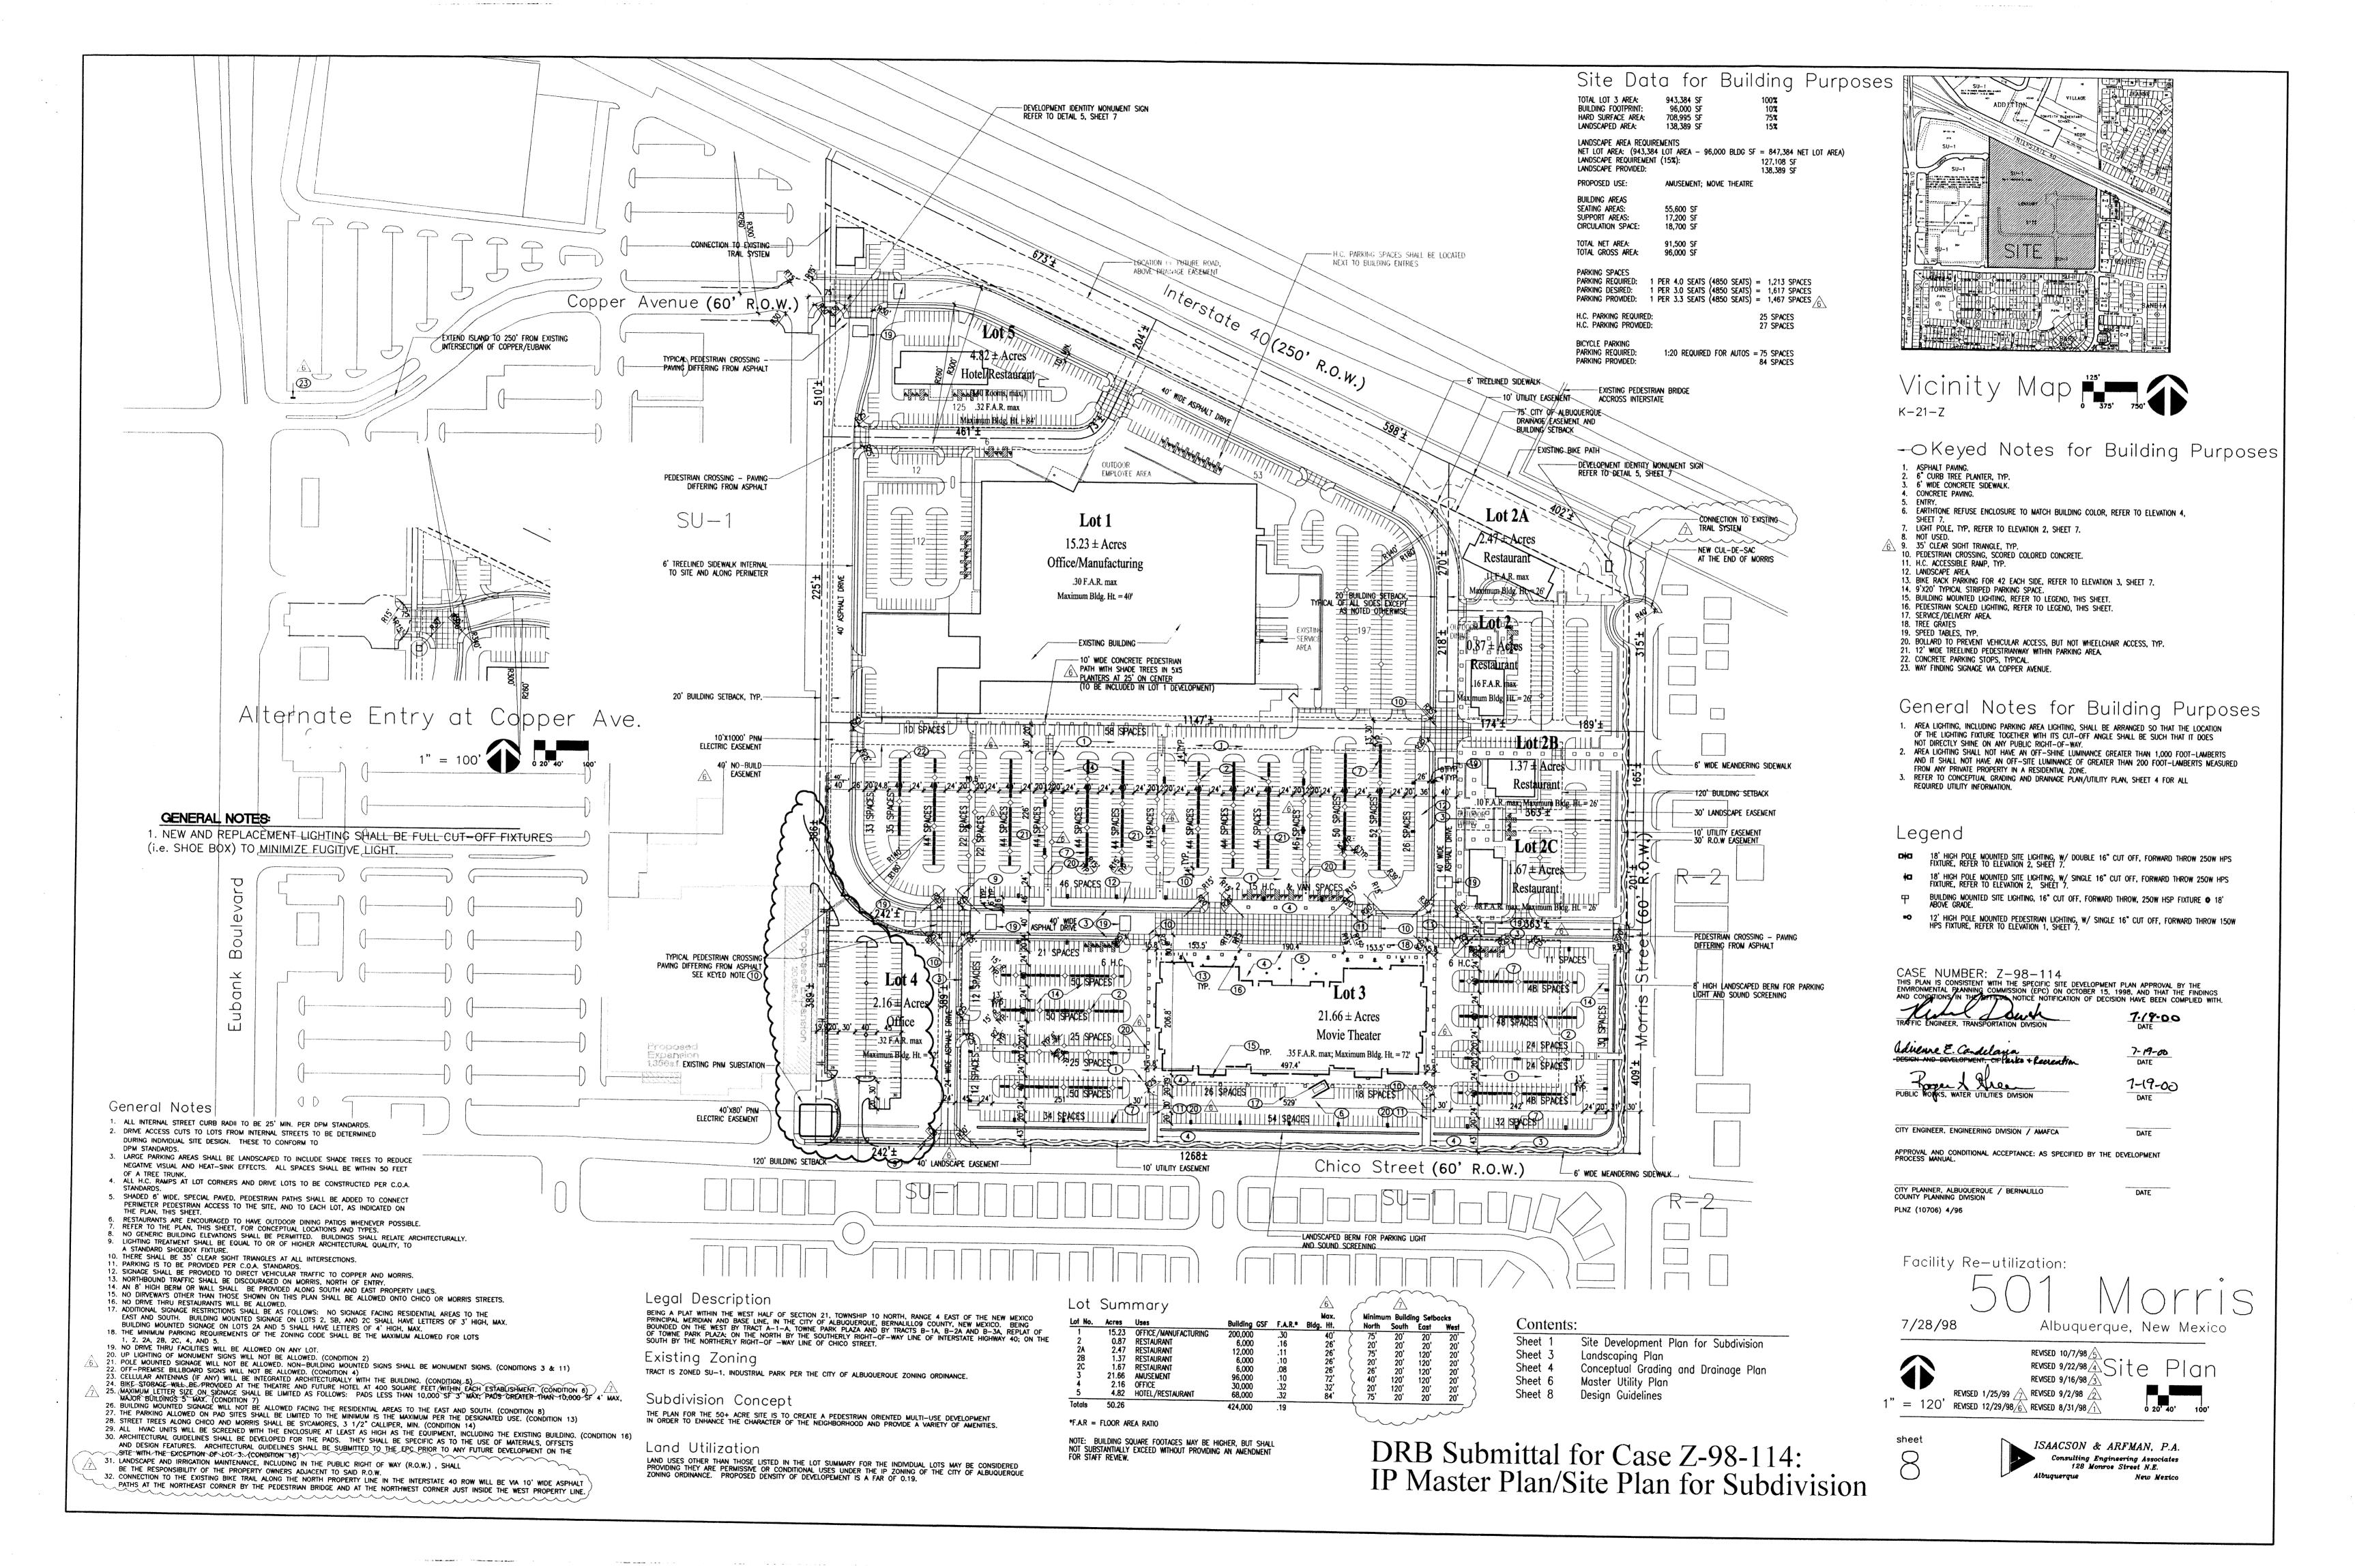

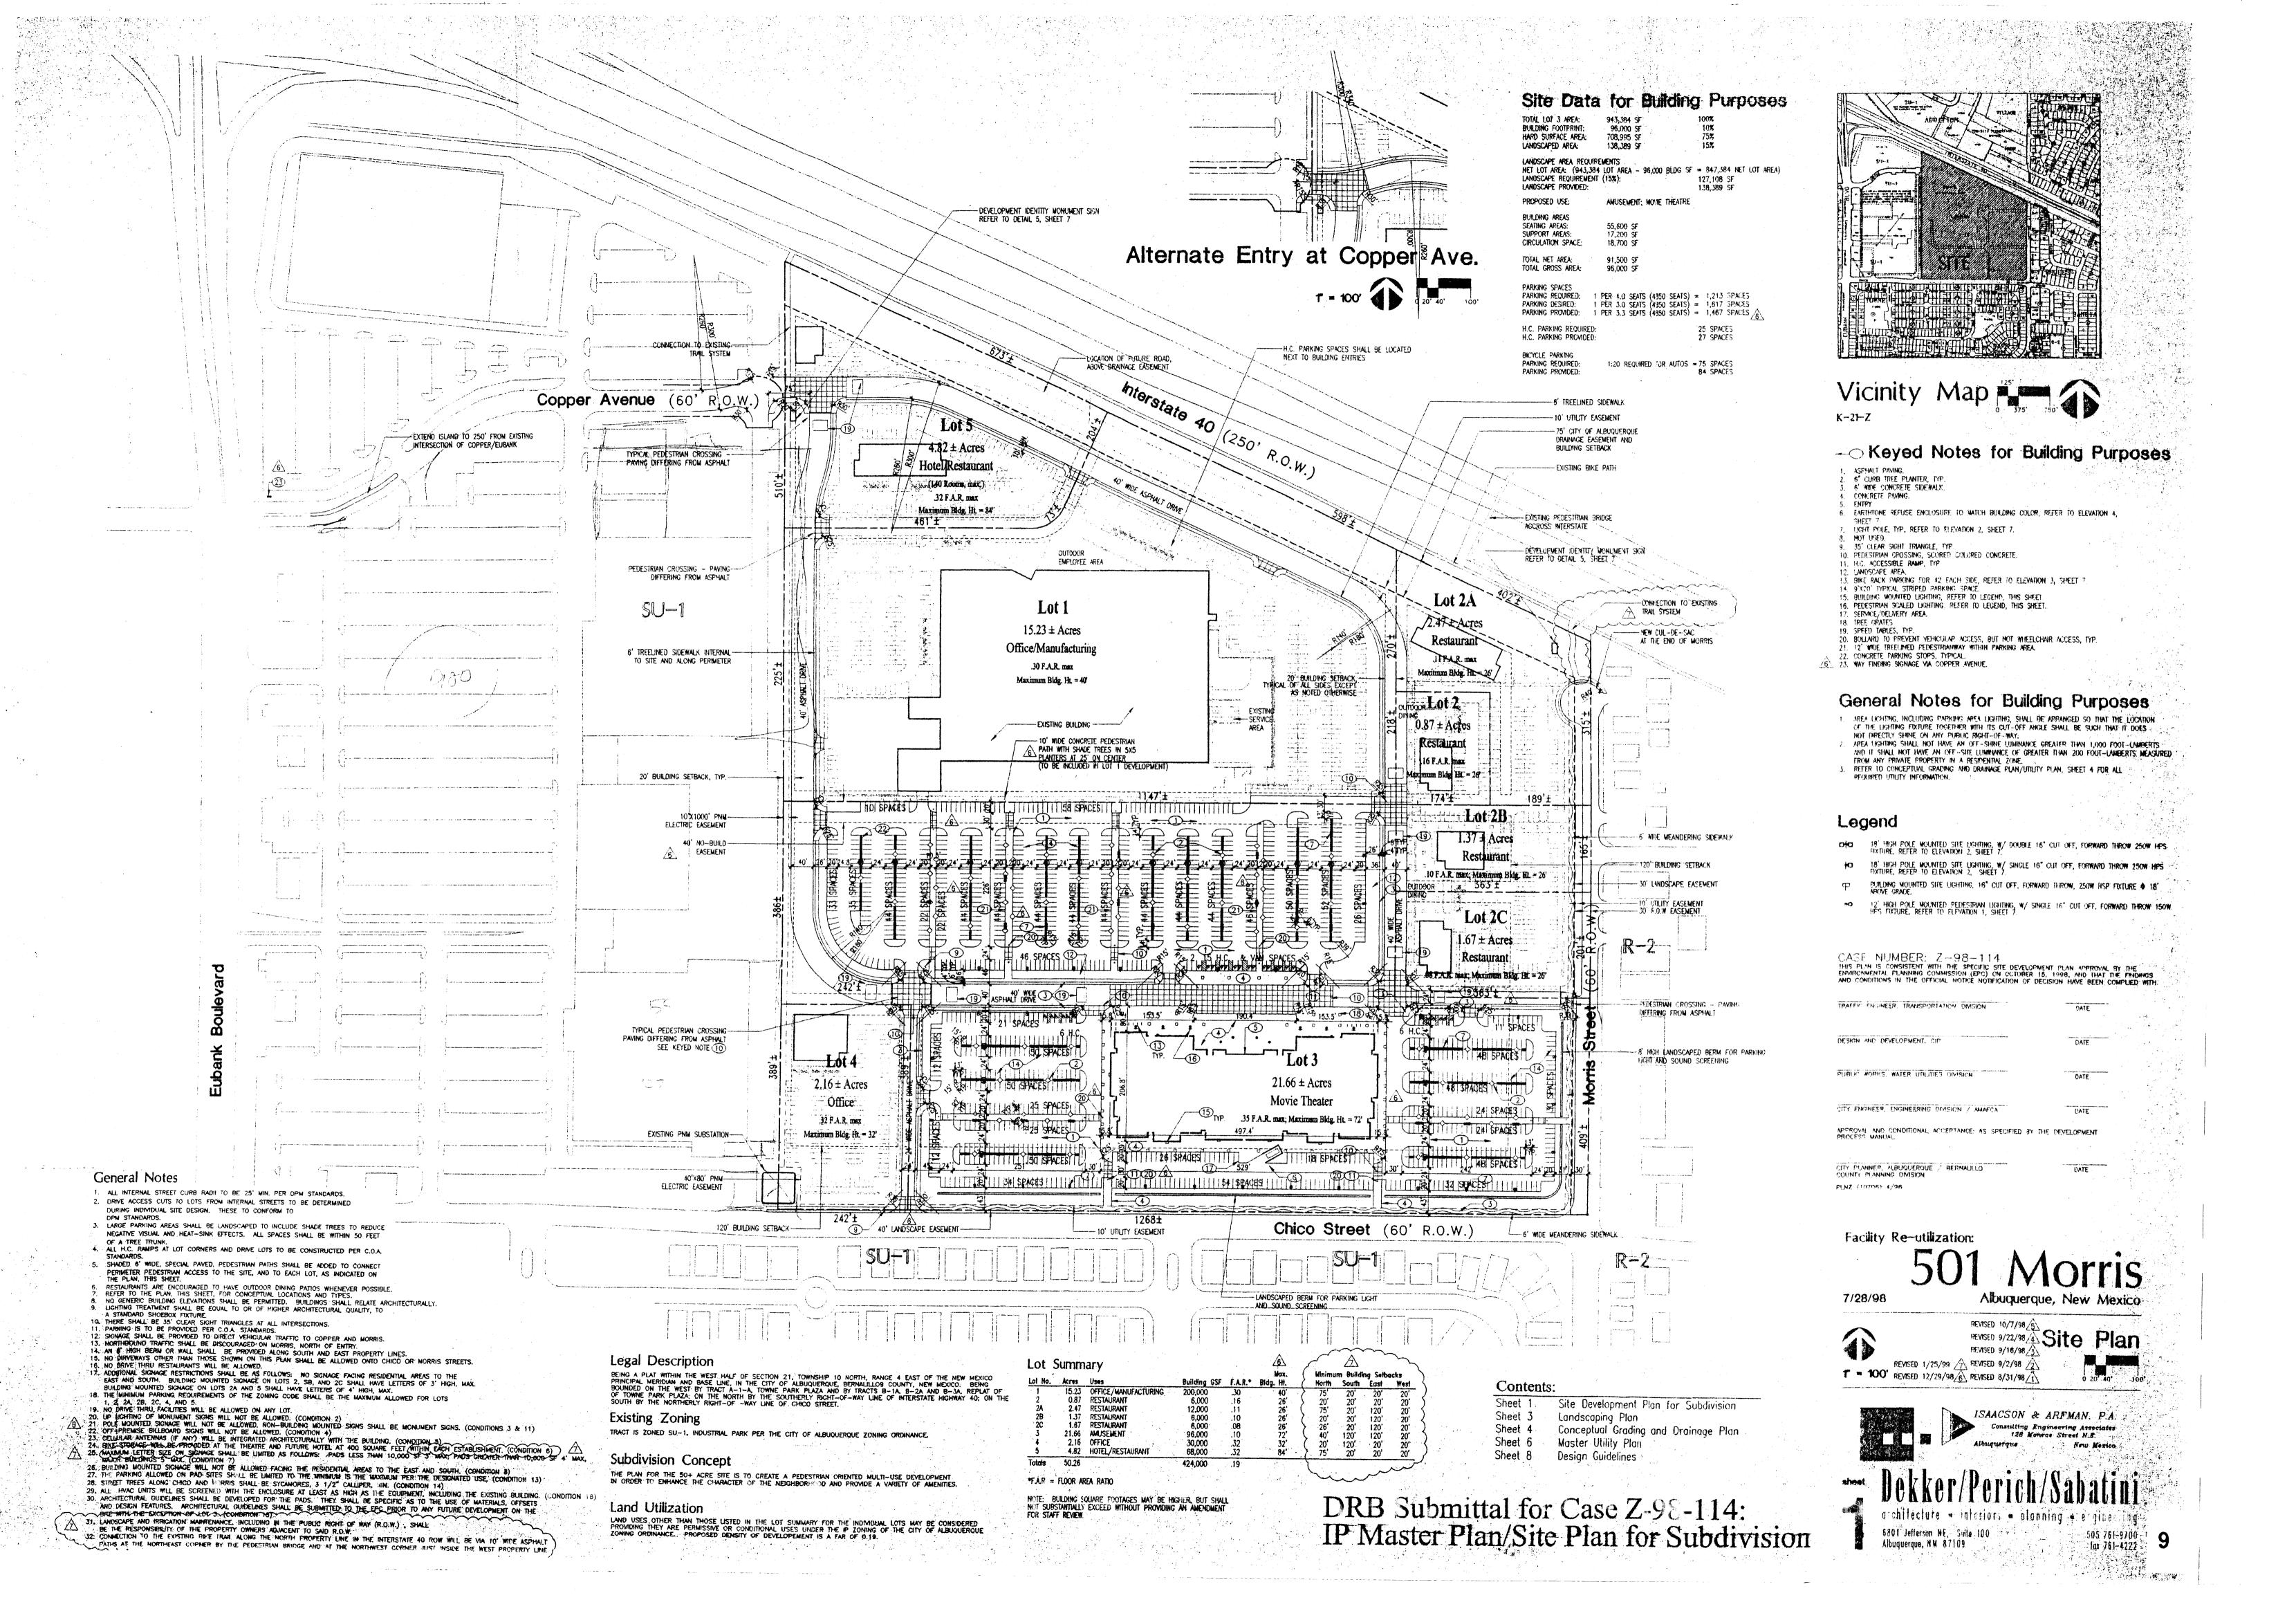

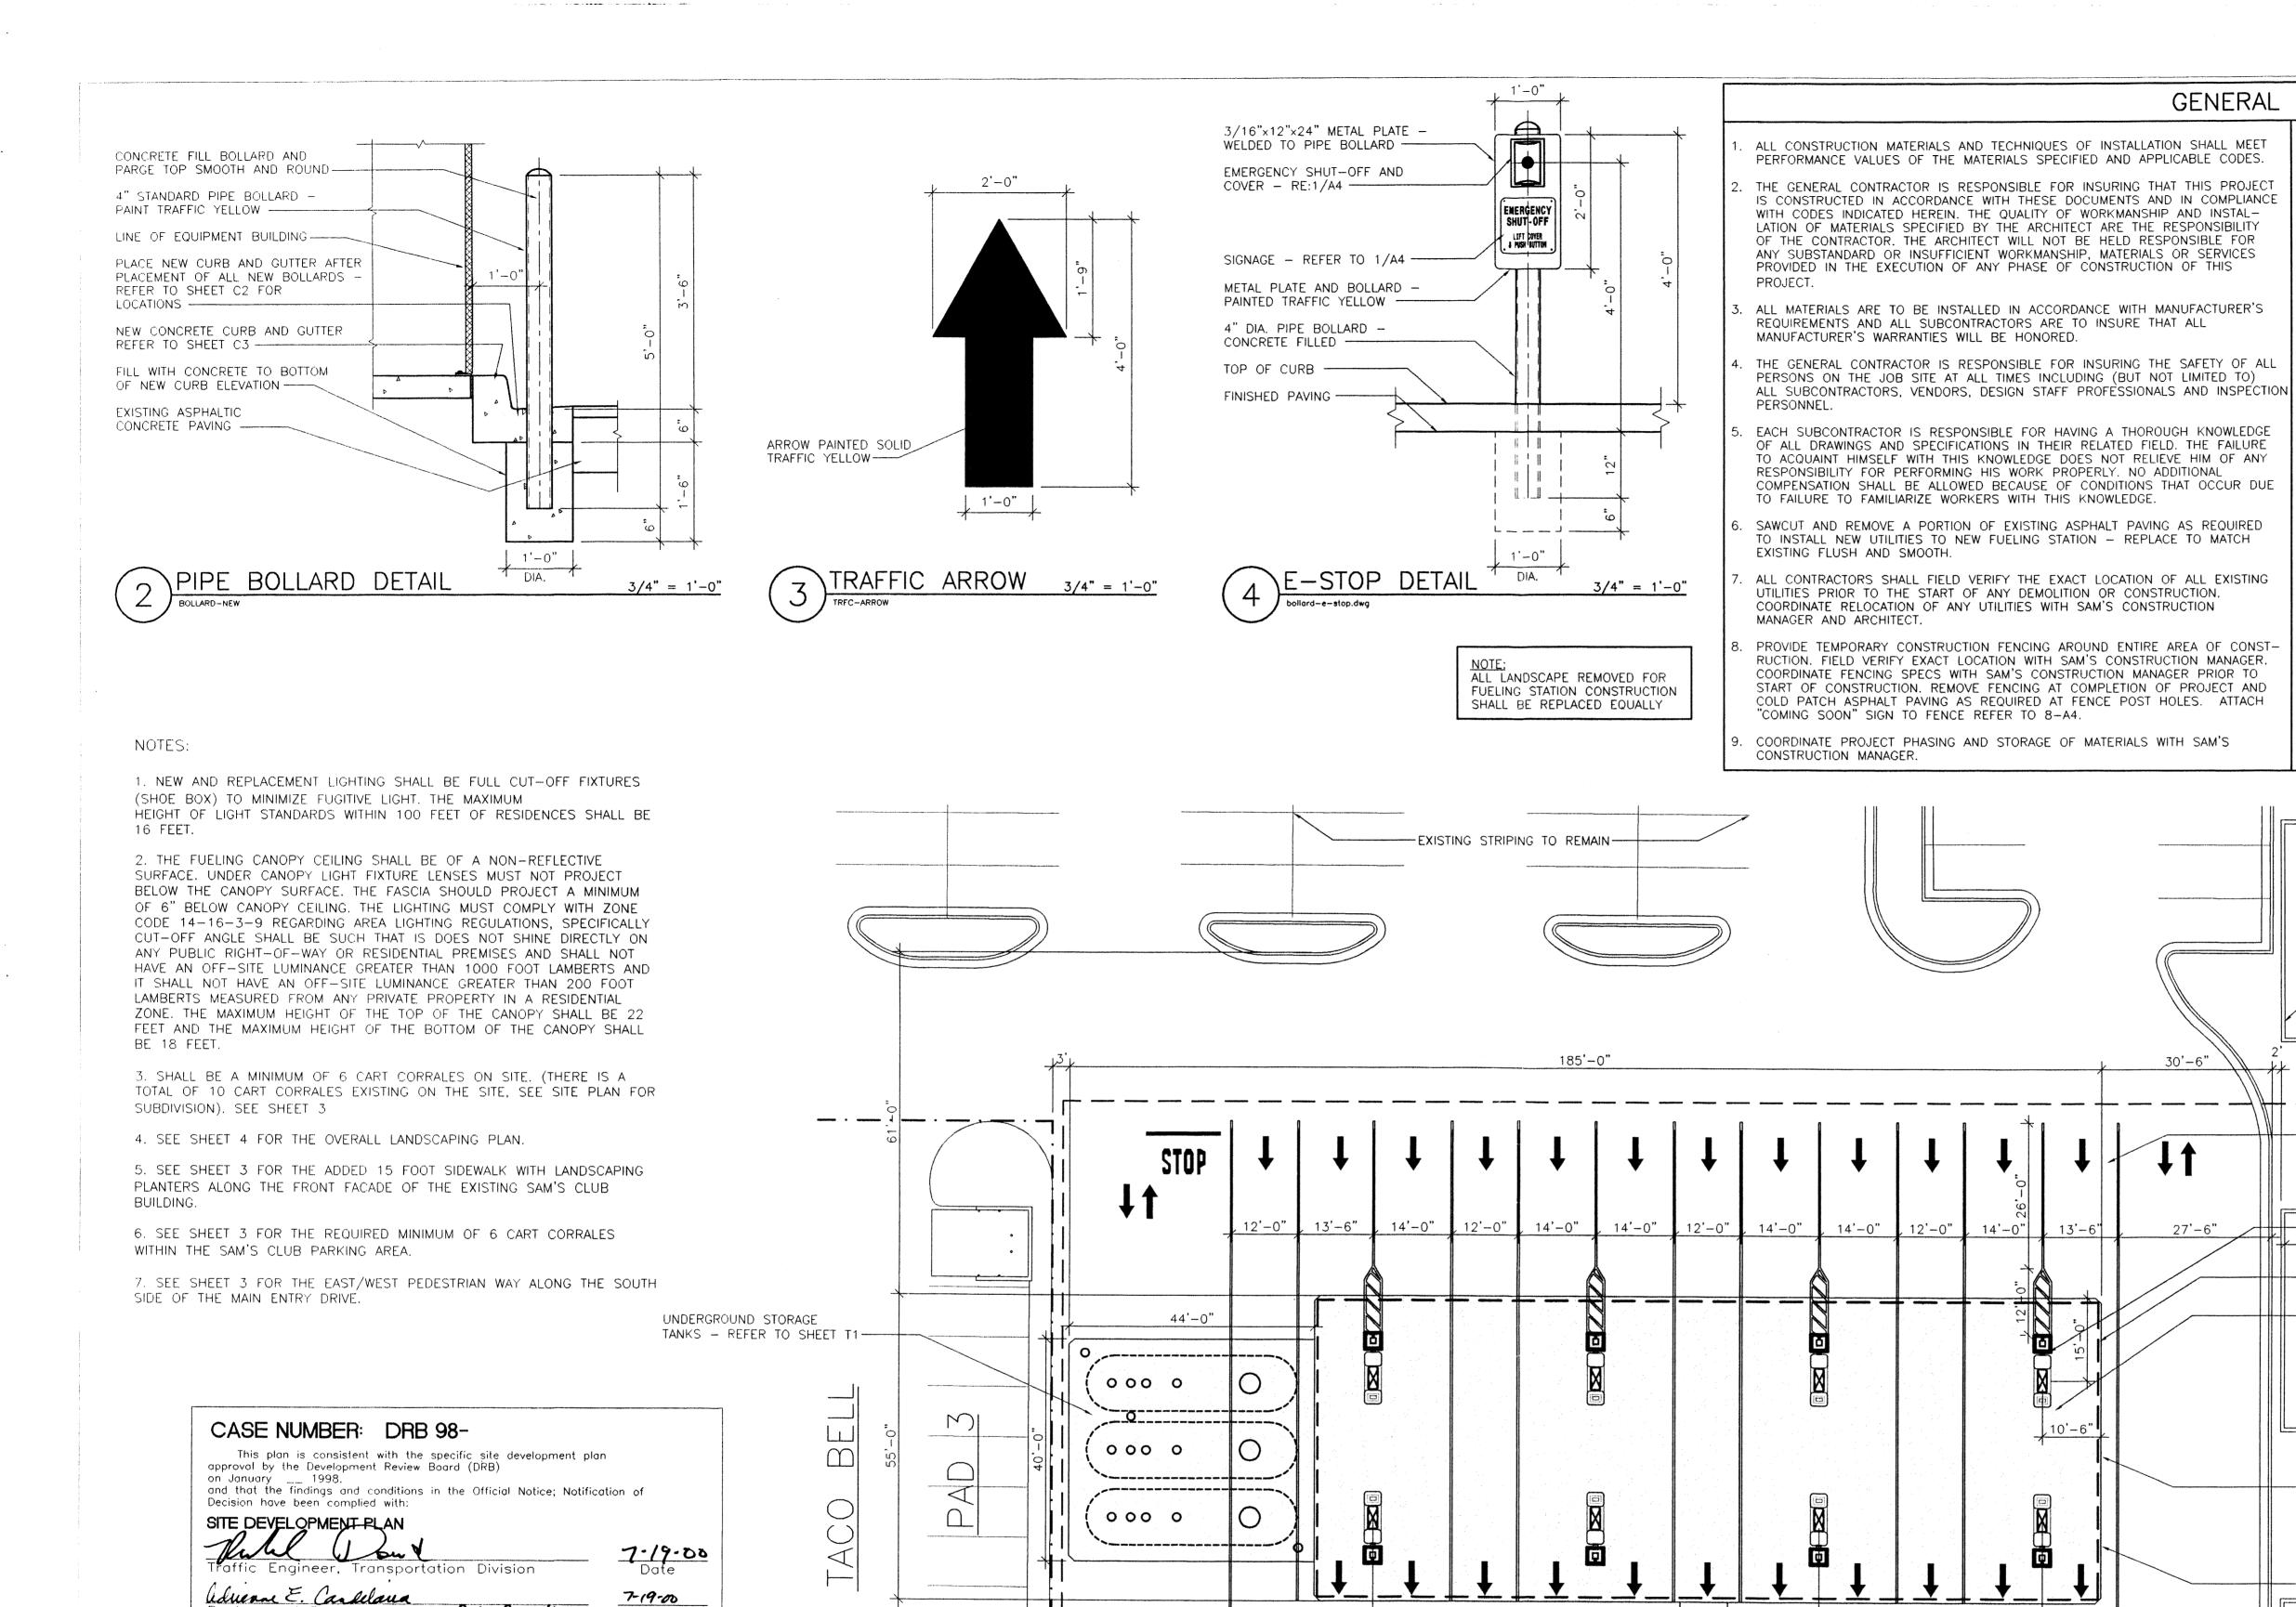

4" WIDE PAINTED YELLOW

STRIPING-TYPICAL-

-NEW E-STOP BOLLARD

NEW $8'-6" \times 15'-0"$ SERVICE

BUILDING - REFER TO SHEET A2-

RE: 4-C2

-TRAFFIC ARROWS REFER TO 3/C3

8'-6"

16'-4"

GENERAL NOTES 10. THE GENERAL CONTRACTOR SHALL BE RESPONSIBLE FOR KEEPING THE AREA CLEAN AND FREE OF DEBRIS AT ALL TIMES DURING CONSTRUCTION. THE GENERAL CONTRACTOR SHALL POWER WASH ENTIRE FUELING STATION CONSTRUCTION AREA PRIOR TO TURNOVER TO SAM'S.

11. GENERAL CONTRACTOR SHALL FIELD VERIFY ALL EXISTING AND PROPOSED GRADES PRIOR TO THE START OF CONSTRUCTION ANY DISCREPANCIES SHALL BE SUBMITTED TO THE ARCHITECT FOR REVIEW.

12. THE PROPOSED CANOPY COLUMN FOOTINGS SHALL BE PROVIDED BY AND INSTALLED BY THE GENERAL CONTRACTOR. THE GENERAL CONTRACTOR IS RESPONSIBLE FOR COORDINATING TOP OF FOOTING ELEVATIONS TO ACCOMMODATE ALL NEW UNDERGROUND PIPING AND DISPENSER SUMPS. IT IS THE CONTRACTOR'S RESPONSIBILITY TO INSURE THAT THE CANOPY COLUMN ANCHOR BOLTS ARE STRAIGHT, CLEAN AND CORRECTLY LOCATED PRIOR TO THE ARRIVAL OF THE CANOPY INSTALLATION CREW.

13. SALVAGE RIGHTS FOR DEMOLISHED LIGHT POLES SHALL BE OFFERED FIRST TO CLUB MANAGER THEN TO THE GENERAL CONTRACTOR. IF THE CLUB MANAGER REFUSES SALVAGE RIGHTS THEN IT BECOMES THE RESPONSIBILITY OF THE GENERAL CONTRACTOR TO REMOVE ALL DEMOLISHED LIGHT POLES FROM THE SITE. IF THE PLANS INDICATE LIGHT POLES TO BE REMOVED AND POWER IS INTERRUPTED TO OTHER POLES IN THE PROCESS, THE OTHER POLES MUST BE REENERGIZED THE SAME DAY.

14. GENERAL CONTRACTOR SHALL HAVE ALL EXISTING PUBLIC AND PRIVATE UTILITIES LOCATED PRIOR TO THE START OF ANY DEMOLITION OR CONSTRUCTION. THIS INCLUDES ALL IRRIGATION PIPING AND LIGHT POLE CONDUITS.

15. THE GENERAL CONTRACTOR SHALL SEED AND STRAW ALL AREAS OF DISTURBED SOIL AND IS RESPONSIBLE FOR ESTABLISHING TURF. FIELD VERIFY THESE AREAS WITH SAM'S CONSTRUCTION MANAGER.

16. USE OF WOODEN BLOCKS ARE ACCEPTABLE TO LEVEL DISPENSER ISLAND; ALL WOOD MUST BE REMOVED PRIOR TO FINAL PLACEMENT OF CONCRETE.

17. AREAS OF EXISTING DAMAGED ASPHALT THAT IS REMOVED AND REPLACED SHALL BE SAW CUT THEN REMOVED AND REPLACED.

18. EXISTING PAVING THAT WILL REMAIN AFTER CONSTRUCTION TO BE PROTECTED FROM EXCAVATING EQUIPMENT STABILIZER, BUCKET AND TRACK DAMAGE.

PROPOSED 3' HIGH SCREEN

WALL. TYP.

27'-6"

HARRISON FRENCH ARCHITECTURE

502 S.W. A Street Bentonville, Arkansas 72712 Telephone 501/273-7780

SAM'S SAM'S CLUB FUELING STATION CLUB # 6672 ALBUQ-UERQUE, NEW MEXICO SAM'S CLUB 608 S.W. 8TH STREET BENTONVILLE, AR 72712

Sheet Contents:

SITE PLAN -DIMENSIONS

Drawn By: KLF Checked By: TWP Revisions:

Project Number: Date:

2 OF 4 SHEETS

07-03-00

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-APPROXIMATE LINE OF TEMPORARY CONSTRUCTION FENCING - REFER TO GENERAL NOTE #8 -SEAL ALL ASPHALT AREA LOCATED INSIDE 4" WHITE STRIPE WITH BLACK ASPHALTIC SEALER - TYPE JENNITE NJ-52 CONTACT AT 1-800-543-7077 OR APPROVED EQUAL. -REFER TO 5/A1 FOR EXACT CANOPY COLUMN AND DISPENSER ISLAND DIMENSIONS -LINE OF NEW CANOPY REFER TO 1/A1 ALL DISPENSERS SHALL BE ACCESSIBLE -GENERAL CONTRACTOR SHALL ENSURE THAT DISTANCE FROM FINISHED GRADE ADJACENT TO DISPENSER TO HIGHEST OPERATIONAL PORTION OF DISPENSER FOR TRANSACTION IS MAX 54" - REFER TO 2-A1 AND 5-A1 -FINISHED GRADE ADJACENT TO ALL DISPENSERS SHALL HAVE NO MORE TO ALL THAN 2% GRADE IN ANY DIRECTION - REFER TO GRADING PLAN SHEET C3 SAWCUT AND REMOVE A PORTION OF EXISTING ASPHALT PAVING AS REQUIRED TO CONSTRUCT NEW CONCRETE PAVED AREA FOR FUELING STATION - JOINT AT NEW CONCRETE PAVING AND EXISTING ASPHALT PAVING MUST BE STRAIGHT AND SMOOTH - SEAL JOINT AS REQUIRED ----LINE OF NEW CONCRETE PAVING SAWCUT AND REMOVE A PORTION OF EXISTING ASPHALT PAVING AS REQUIRED TO INSTALL CONDUIT TO EQUIPMENT BUILDING- REPLACE WITH ASPHALT TO MATCH EXISTING -FIELD VERIFY EXACT WIDTH OF TRENCH REQUIRED -NEW E-STOP BOLLARD RE: 4-C2

PLAN - DIMENSIONS

Public Warks, Water Utilities Division

City Planner, Albuquerque / Bernalillo

Development Process Manual.

County Planning Division

PLNZ (10706) 4/96

Solid Waste

City Engineer, Engineering Division / AMAFCA

APPROVAL AND CONDITIONAL ACCEPTANCE: as specified by the

7-19-00


7-19-00

Date

Date


-CIP Parks + Recreation

1/16" = 1'-0"

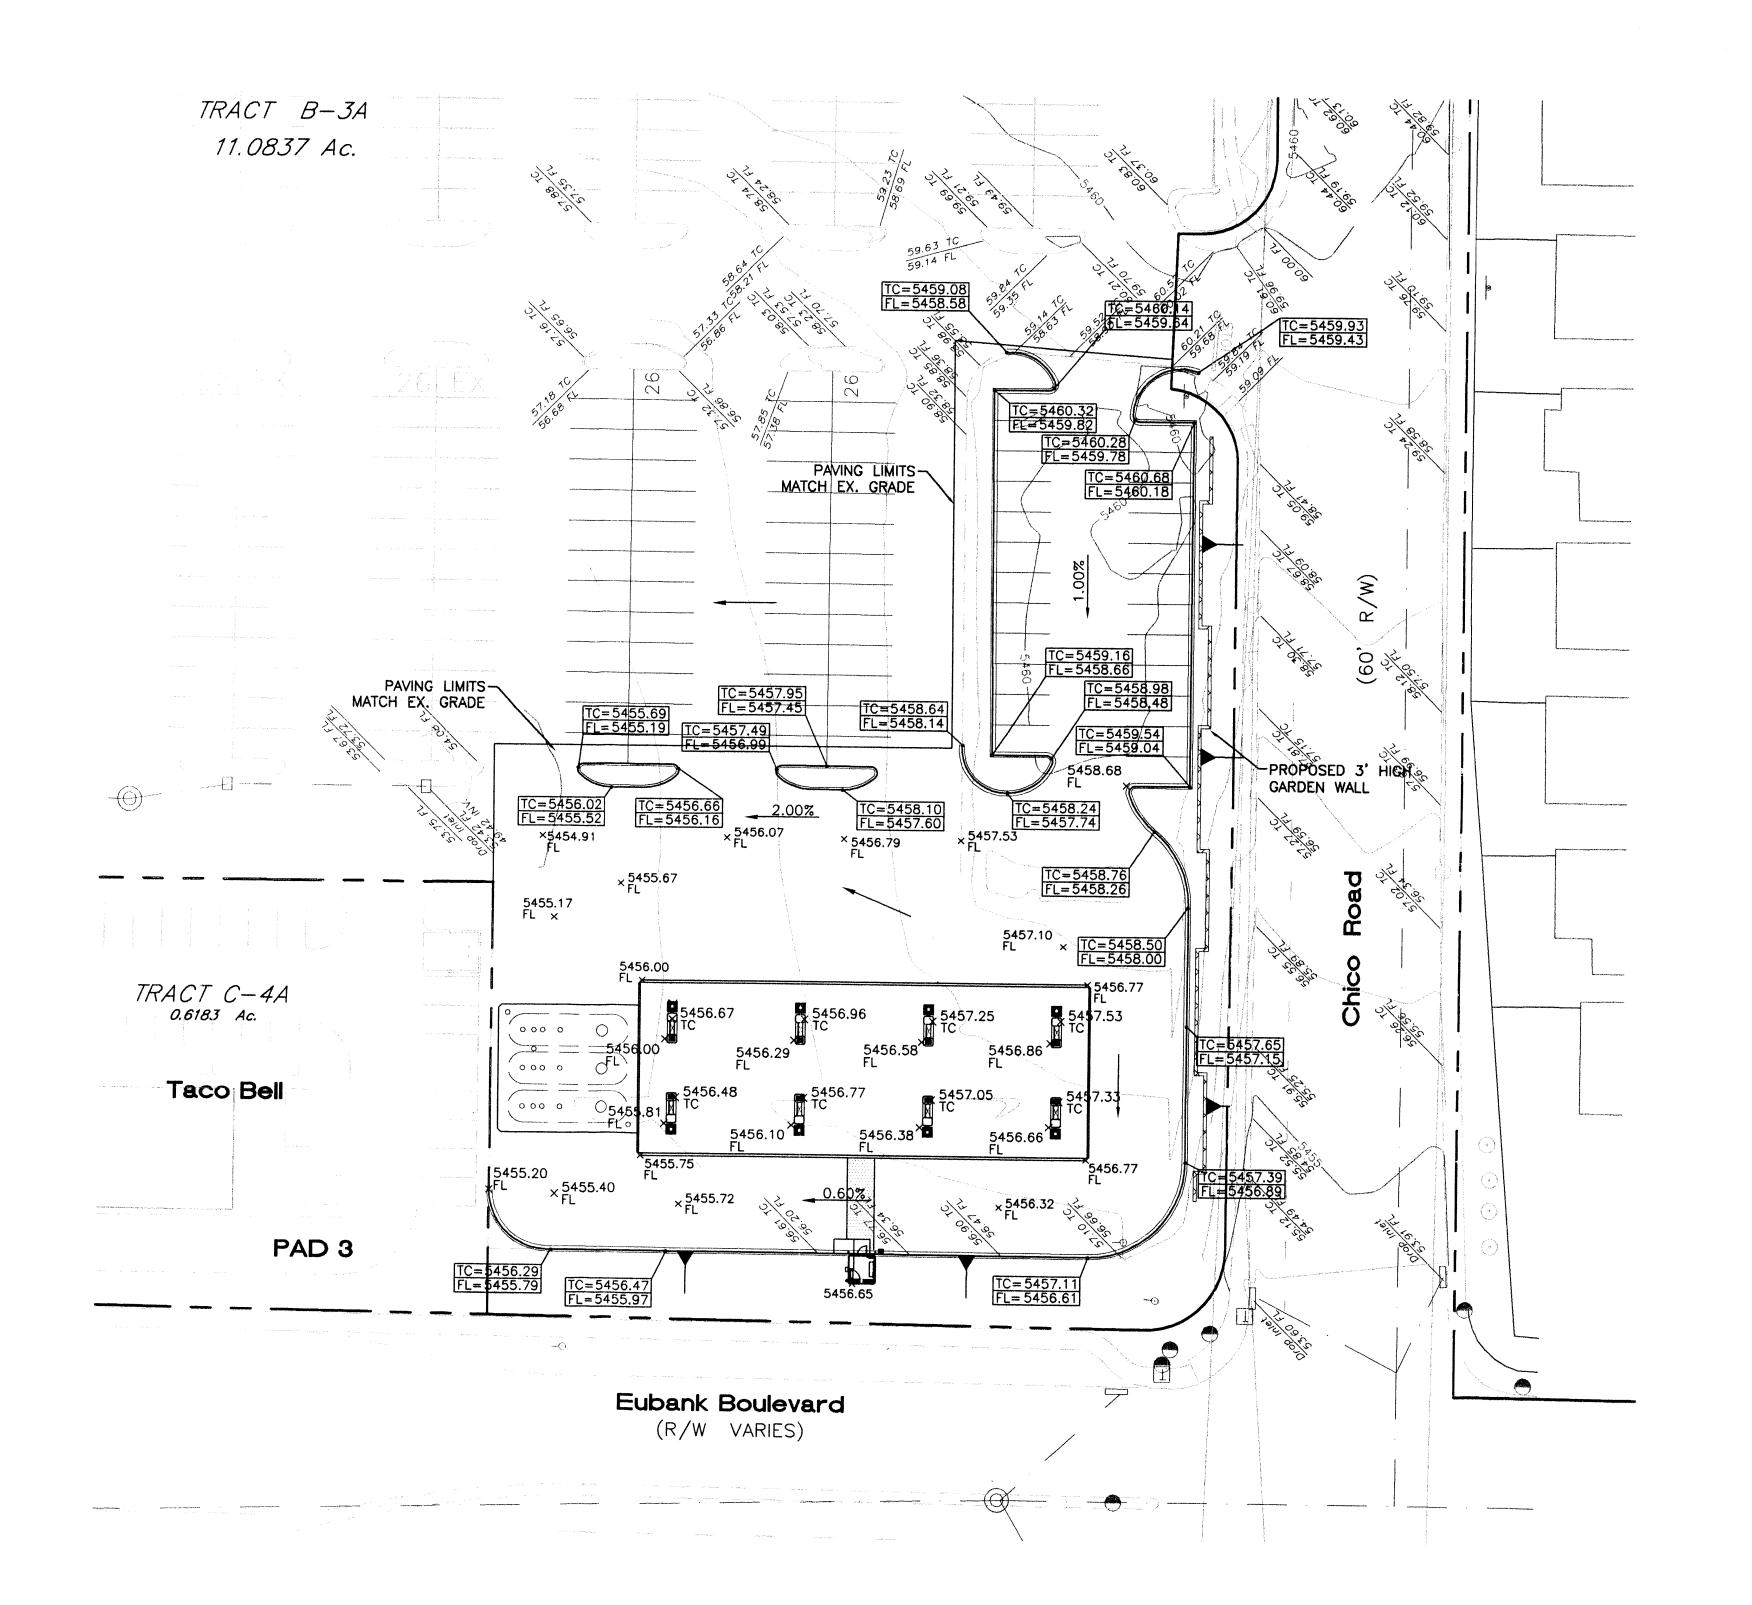

EROSION CONTROL NOTES:

- CONTRACTOR IS RESPONSIBLE FOR OBTAINING A TOPSOIL DISTURBANCE PERMIT PRIOR TO BEGINNING WORK.
- CONTRACTOR IS RESPONSIBLE FOR MAINTAINING RUN-OFF ON SITE DURING CONSTRUCTION.
- CONTRACTOR IS RESPONSIBLE FOR CLEANING ALL SEDIMENT THAT GETS INTO EXISTING RIGHT-OF-WAY.
- 4. REPAIR OF DAMAGED FACILITIES AND CLEANUP OF SEDIMENT ACCUMULATIONS ON ADJACENT PROPERTIES AND IN PUBLIC FACILITIES IS THE RESPONSIBILITY OF THE CONTRACTOR.
- 5. ALL EXPOSED EARTH SURFACES MUST BE PROTECTED FROM WIND AND WATER EROSION PRIOR TO FINAL (CITY) ACCEPTANCE OF ANY PROJECT.

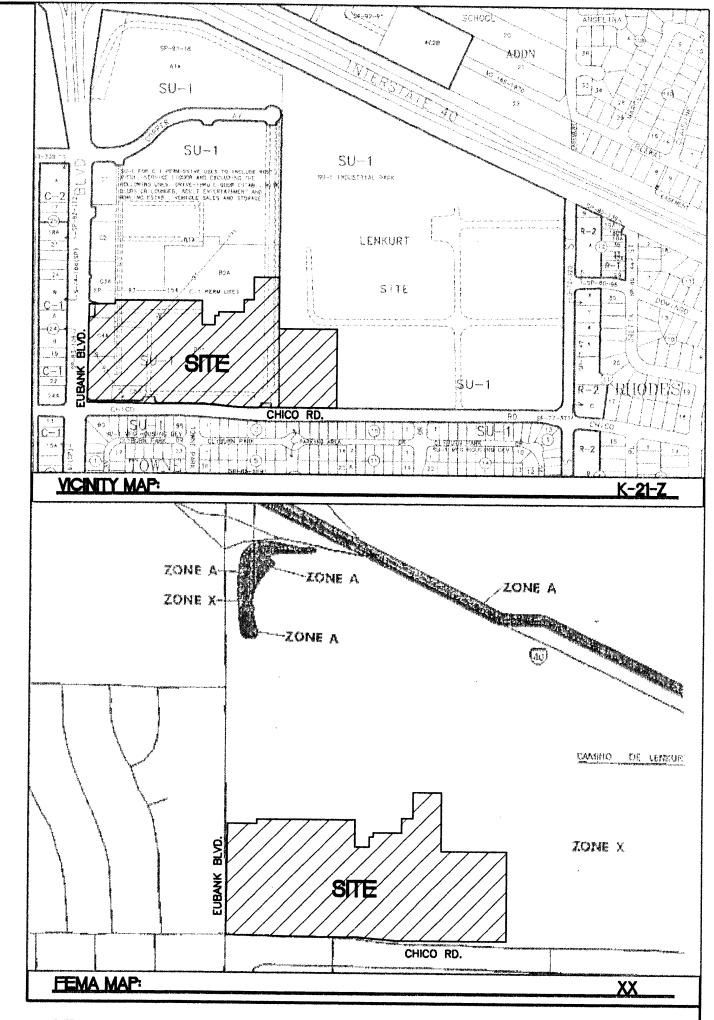

LEGAL DESCRIPTION:
TRACT B-3A LENKURT SITE

NOTES:


1. ALL SPOT ELEVATIONS REPRESENT FLOWLINE UNLESS OTHERWISE NOTED.

LEGEND

EXISTING CURB & GUTTER EXISTING CONTOUR (MAJOR)

EXISTING CONTOUR (MINOR)

- BOUNDARY LINE PROPOSED SIDEWALK

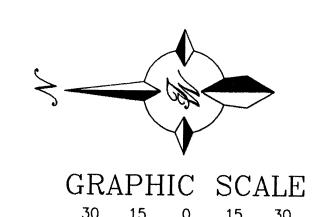

SCALE: 1"=30'

ENGINEER'S SEAL	
HE A PROFESSIONAL	

ENGINEER'S SEAL	ALBUQUERQUE SAM'S,	DRAWN BY BDG
HEXION BESSIONAL PROFESSIONAL P	NM: 4703 GAS STATION	DATE
	GRADING AND DRAINAGE PLAN	5-23-00
		9929GAS-GR.DWG
		SHEET #
	TIERRA WEST, LLC 8509 JEFFERSON NE ALBUQUERQUE, NEW MEXICO 87113	11
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