


TO MA TO CONTRACT CONTRACT AND CONTRACT OF TAXABLE IN THE PARTY OF THE PARTY OF THE PARTY OF TAXABLE IN THE PARTY OF TAXABLE I

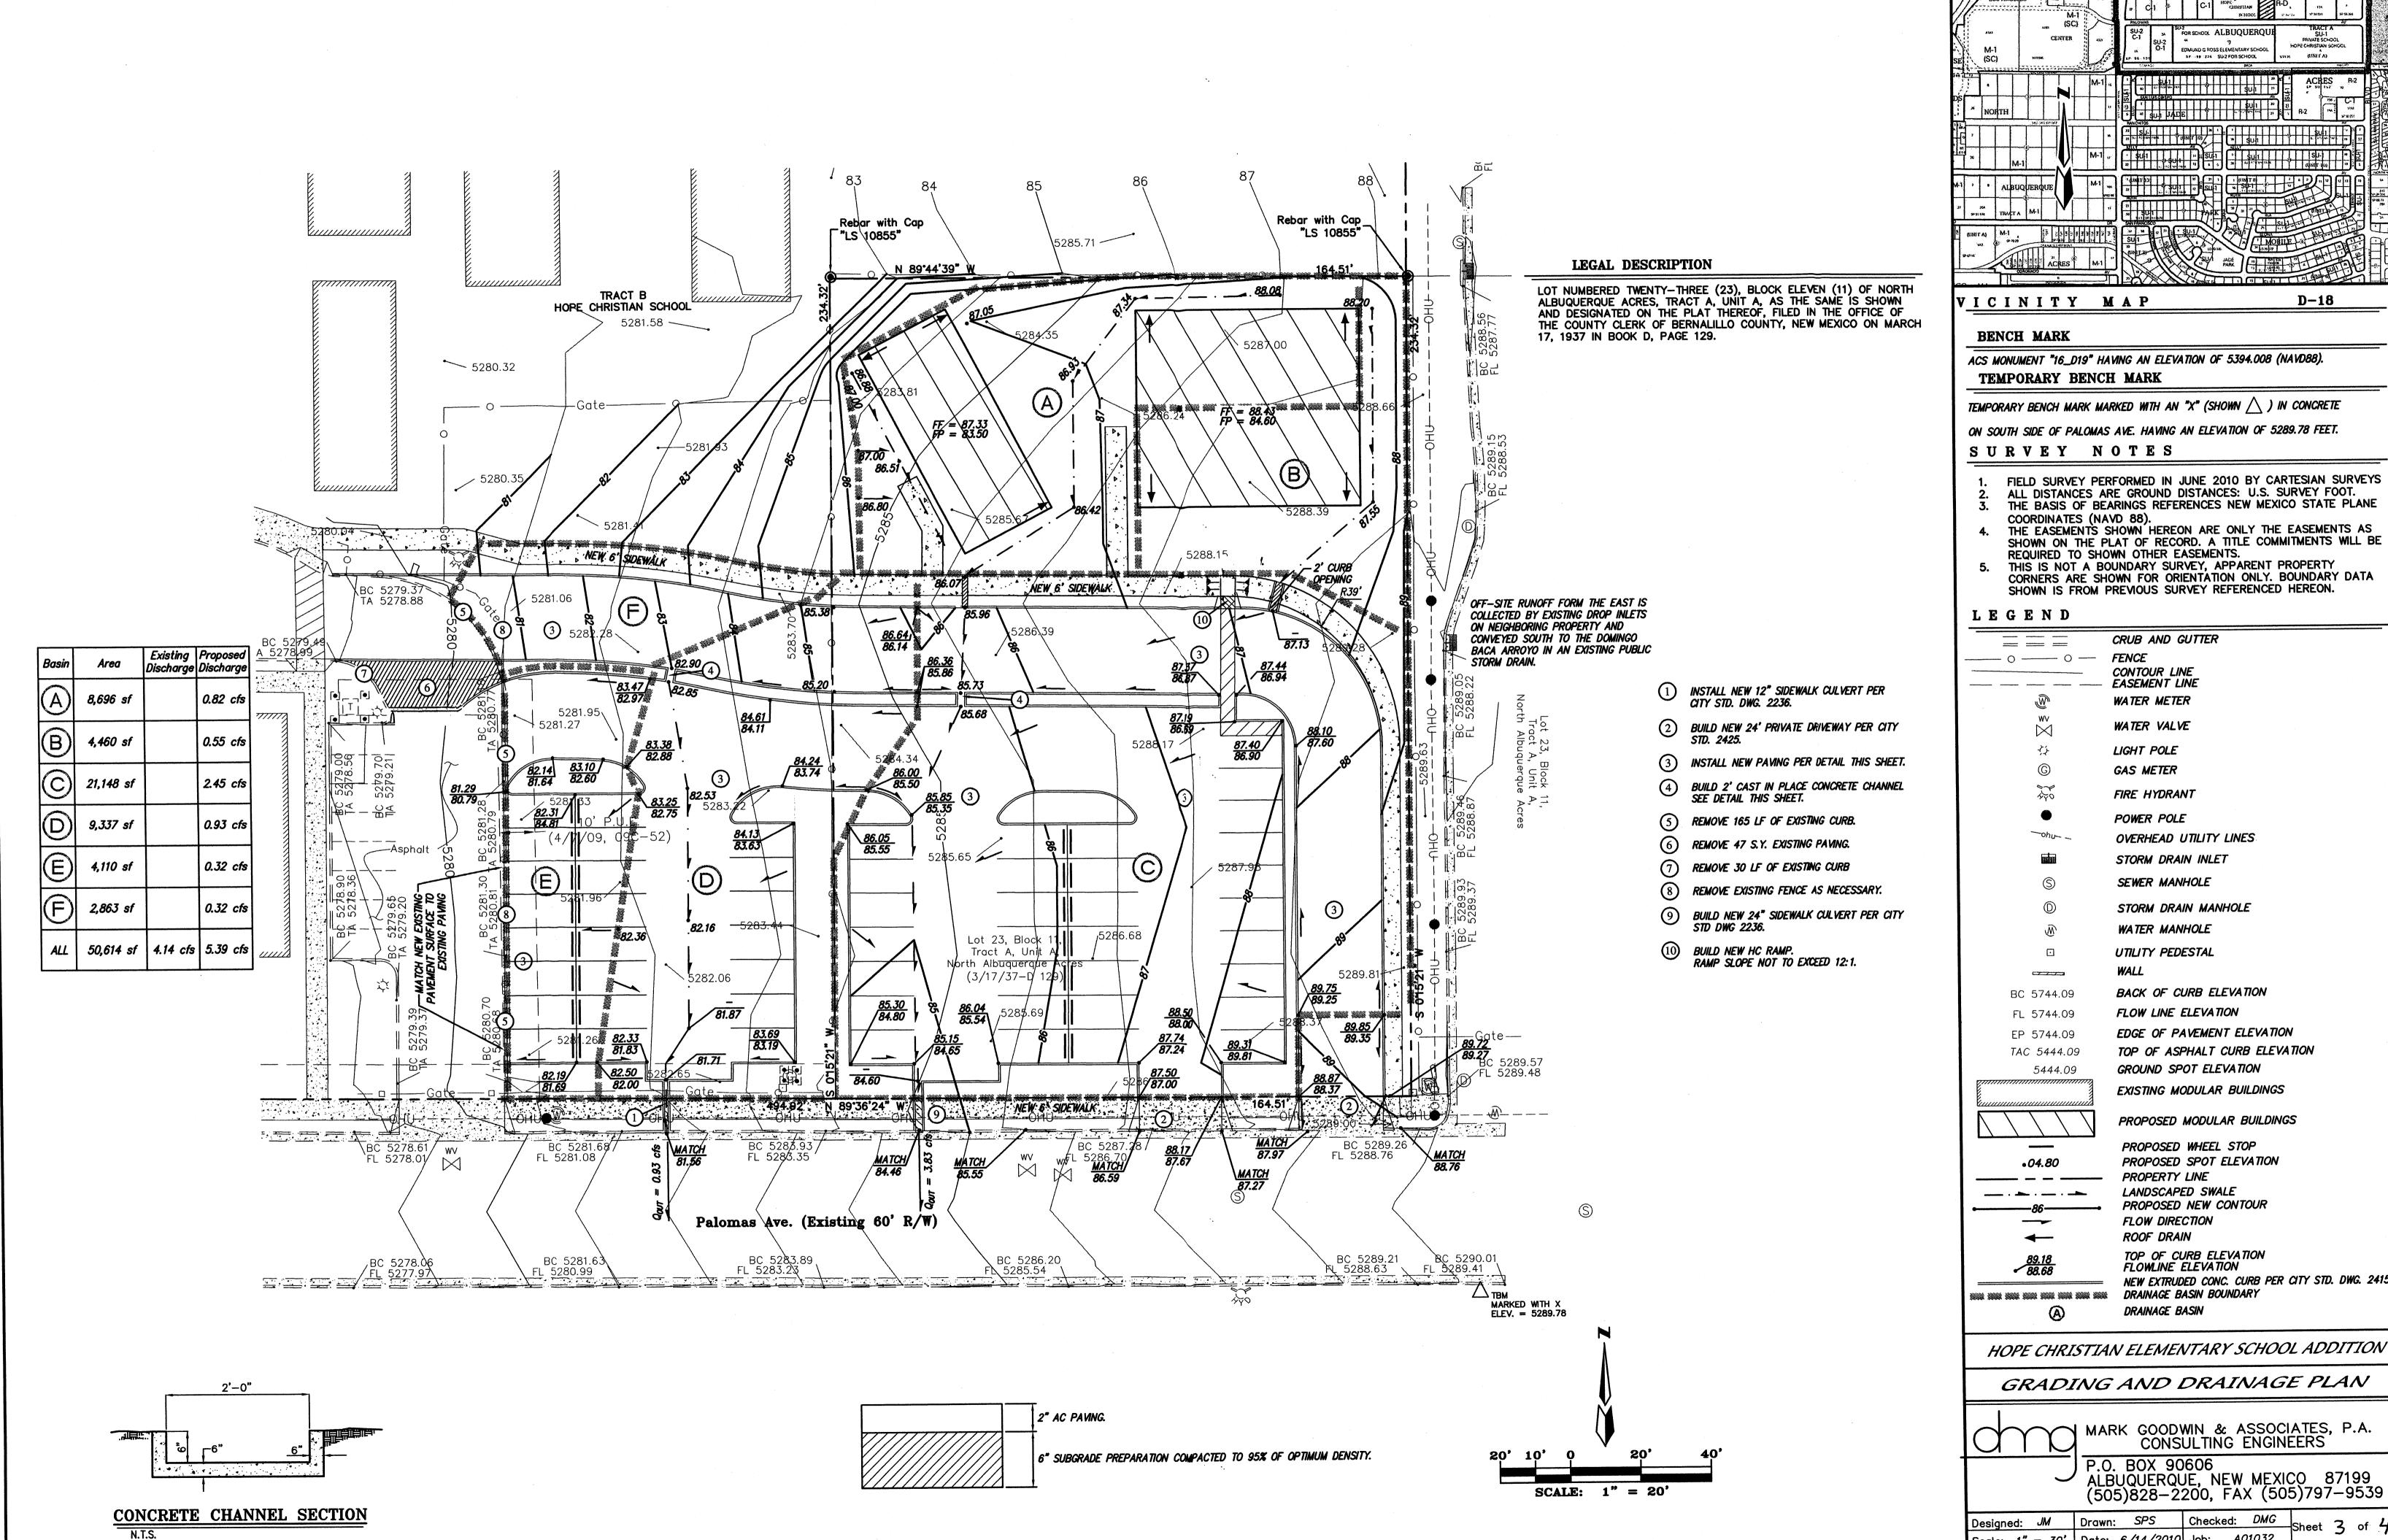



TEMPORARY BENCH MARK MARKED WITH AN "X" (SHOWN 🛆) IN CONCRETE

- FIELD SURVEY PERFORMED IN JUNE 2010 BY CARTESIAN SURVEYS ALL DISTANCES ARE GROUND DISTANCES: U.S. SURVEY FOOT. THE BASIS OF BEARINGS REFERENCES NEW MEXICO STATE PLANE
- THE EASEMENT'S SHOWN HEREON ARE ONLY THE EASEMENTS AS SHOWN ON THE PLAT OF RECORD. A TITLE COMMITMENTS WILL BE
- THIS IS NOT A BOUNDARY SURVEY, APPARENT PROPERTY CORNERS ARE SHOWN FOR ORIENTATION ONLY. BOUNDARY DATA

Specialization of the Confederation of the Confeder	CRUB AND GUTTER
	FENCE CONTOUR LINE
	CONTOUR LINE EASEMENT LINE
	WATER METER
w∨ ⊠	WATER VALVE
\$	LIGHT POLE
©	GAS METER
470	FIRE HYDRANT
•	POWER POLE
-ohu-	OVERHEAD UTILITY LINES
44401	STORM DRAIN INLET
S	SEWER MANHOLE
0	STORM DRAIN MANHOLE
®	WATER MANHOLE
<u> </u>	UTILITY PEDESTAL
	WALL
BC 5744.09	BACK OF CURB ELEVATION
FL 5744.09	FLOW LINE ELEVATION
EP 5744.09	EDGE OF PAVEMENT ELEVATION
TAC 5444.09	TOP OF ASPHALT CURB ELEVATION
5444.09 <i>çımınını</i>	GROUND SPOT ELEVATION
	EXISTING MODULAR BUILDINGS
	PROPOSED MODULAR BUILDINGS
	PROPOSED WHEEL STOP
•04.80	PROPOSED SPOT ELEVATION
	PROPERTY LINE LANDSCAPED SWALE
86	PROPOSED NEW CONTOUR
	FLOW DIRECTION ROOF DRAIN
20.40	ROOF DRAIN TOP OF CURB ELEVATION
89.18 88.68	FLOWLINE ELEVATION
	NEW EXTRUDED CONC. CURB PER CITY STD. DWG. 2415B DRAINAGE BASIN BOUNDARY
A	DRAINAGE BASIN

GRADING AND DRAINAGE PLAN

MARK GOODWIN & ASSOCIATES, P.A. CONSULTING ENGINEERS P.O. BOX 90606 ALBUQUERQUE, NEW MEXICO 87199 (505)828-2200, FAX (505)797-9539

Designed: JM Drawn: SPS Checked: DMG Sheet 3 of 4 Scale: 1'' = 30' Date: 6/14/2010 Job: A01032

LANDSCAPE NOTES: Landscape maintenance shall be the responsibility of the Property Owner. The Property Owner shall maintain street trees in a living, healthy, and attractive condition.

It is the intent of this plan to comply with the City Of Albuquerque Water Conservation Landscaping and Water Waste Ordinance planting restriction approach. Approval of this plan does not constitute or imply exemption from water waste provisions of the Water Conservation Landscaping and Water Waste Ordinance.

Mater management is the sole responsibility of the Property Owner. All landscaping will be in conformance with the City of Albuquerque Zoning Code, Street Tree Ordinance, Pollen Ordinance, and Mater Conservation Landscaping and Water Waste Ordinance. In general, water conservative, environmentally sound landscape principles will be followed in design and installation.

Plant beds shall achieve 75% live ground cover at maturity.

Grey Grayel over Filter Fabric to a minimum depth of 3" shall be placed in all landscape areas which are not designated to receive native seed.

IRRIGATION NOTES:

Irrigation shall be a complete underground system with Trees to receive 1 Netafim spiral (50' length) with 3 loops at a final radius of 4.5' from tree trunk, pinned in place. Netafim shall have emitters 12" o.c. with a flow of .6 gph. Shrubs to receive (2) 1.0 GPH Drip Emitters. Drip and Bubbler systems to be tied to 1/2" polypipe with flush caps at each end. Trees and shrubs shall be on separate valves.

Run time per each shrub drip valve will be approximately 15 minutes per day. Tree drip valve shall run 1.5 hours, 3 times per week. Run time will be adjusted according to the season.

Point of connection for irrigation system is unknown at current time and will be coordinated in the field. Irrigation will be operated by automatic controller.

Location of controller to be field determined and power source for controller to be provided by others.

Irrigation maintenance shall be the responsibility of the Property Owner.

Water and Power source shall be the responsibility of the Developer/Builder.


LANDSCAPE CALCULATIONS

quare feet
aquare feet
aquare feet
aquare feet
square feet
aquare feet
•
aquare feet
aquare feet
; ; ;

PARKING LOT TREE REQUIREMENTS - Minimum 2" Caliper

Shade trees required under the City Of Albuquerque Parking Lot Tree Ordinance are as follows:

1 Shade tree per 10 spaces Required 4 Provided 4

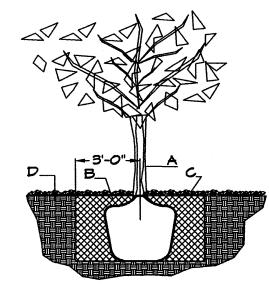

TREE PLANTING DETAIL

NTS

GENERAL NOTES:

1. ROOTBALL SHALL BE PLACED ON UNDISTURBED SOIL TO PREVENT TREE FROM SETTLING.

2. TOP OF ROOTCOLLAR INDICATED LEVEL AT WHICH TREE WAS GROWN AND DUG; THIS REPRESENTS THE LEVEL AT WHICH THE TREE SHOULD BE INSTALLED: THAT LEVEL MAY BE EXCEEDED BY ONLY A ONE INCH LAYER OF SOIL. 3. PRIOR TO BACKFILLLING TREE, ALL WIRE, ROPE AND SYNTHETIC MATERIALS SHALL BE REMOVED FROM THE TREE AND THE PLANTING PIT.

4. PRIOR TO BACKFILLING ALL BURLAP SHALL BE CUT AWAY EXCEPT FROM BOTTOM OF THE ROOTBALL.

CONSTRUCTION NOTES:

A. TREE

B. BACKFILL WITH EXISTING SOIL. C. 3" DEPTH OF GRAVEL MULCH.

D. UNDISTRUBED SOIL.

during the design process or the on-site grades differ from the Grading and Drainage plan received. The Hilltop reserves the right to apply slope stabilization materials where the specified gravel will not be suitable. Gravel smaller than 2-4" cobblestone will not stay on a slope greater than 3:1. If the grades are greater than what was to lay cobblestone or rip-rap, in lieu of the specified

RETENTION BASIN SHALL BE TWICE THE DIAMETER OF THE SHRUB PLANTING PIT.

D. 3" DEPTH OF GRAVEL MULCH.


E. FINISH GRADE.

IST. 10' P.U.E.

11111111

NOTE TO CLIENT: Should The Hilltop not receive a Grading and Drainage plan

originally designed, we will request an infield change-order gravel, to stabilize the slope. All vegetative material shall

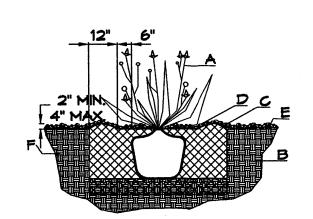

SHRUB PLANTING DETAIL

GENERAL NOTES:

1. THE OUTSIDE DIAMETER OF THE WATER

CONSTRUCTION NOTES:

B. BACKFILL WITH EXISTING SOIL.

C. EARTH BERM AROUND WATER RETENTION BASIN.

F. UNDISTURBED SOIL.

AUTOMATIC VALVE W/ ATMOSPHERIC VACUUM BREAKER

WIRE EXPANSION LOOPS

(17) GALVANIZED STREET ELL

VALVE BOX

FINISH GRADE

1 MAINLINE FITTING

CMU BLOCK

LATERAL PIPE

GRAVEL

REDUCER BUSHING


GALVANIZED NIPPLE

O GALVANIZED ELBOW

GALVANIZED NIPPLE

24" TO 36" GALVANIZED NIPPLE

AUTOMATIC VALVE (SEE LEGEND)

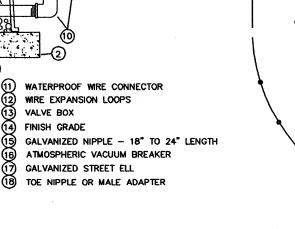

Netafim Spiral Detail

 \bowtie

EXISTING ELEMENTARY SCHOOL

CAMPUS

1821 SF

Palomas Avenue NE

(60' R/W)


Tree Trunk

Root Ball


Emitter-12" o.c.

PLANT LEGEND

All plants shall be sized per American Standard for Nursery Stock. Installation size shall indicate the greater of height or spread. In cases where Type O plants have been pruned for rejuvenation, measurement should be by spread of roots rather than by the height of the plant.

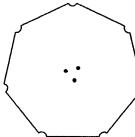

COMMON HACKBERRY 4 Celtis occidentalis 2" Cal., 12'-14' Inst./40' x 40' maturity Mater (M) Allergy (L) Osf

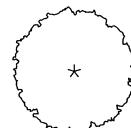

EASTERN REDBUD 5 Cercis canadensis 1-1/2" Cal., 8'-10' Inst./30' x 30' maturity Water (M) Allergy (L) Osf

SHRUBS/ORNAMENTAL GRASSES



* PARNEY COTONEASTER 2 Cotoneaster lacteus 5 Gal., 2'-4' Inst./8' x 12' maturity Water (M) Allergy (L) 144sf

GROUNDCOVERS



* BLUE CHIP JUNIPER 9 Juniperus horizontalis 'Blue Chip' 1 Gal., 24"-4' Inst./10" x 8' maturity Water (L+) Allergy (H) 64sf

* LADY BANK'S ROSE 8

Rosa bankslae



1 Gal., 24"-4' Inst./3' x 20' maturity Water (M) Allergy (L) 200sf Unstaked Groundcover

1 Gal., 6"-15" Inst./4' x 12' maturity Water (L+) Allergy (L) 144sf




Lonicera japonica 'Halliana' 1 Gal., 6"-15" Inst./3' x 12' maturity

HARDSCAPES




3/4" GRAY GRAVEL

* DENOTES EVERGREEN PLANT MATERIAL

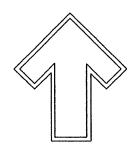

LANDSCAPE ARCHITECT'S

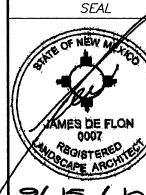

9/15/10

JAMES DE FLON #0007

 \triangleleft


MINTER JASMINE 10 Jasminum nudiflorum



* HONEYSUCKLE 4 Mater (M) Allergy (L) 144sf Unstaked-Groundcover




WITH FILTER FABRIC TO A MINIMUM 3" DEPTH

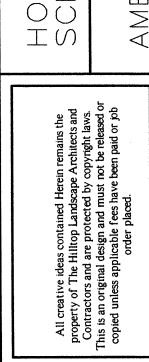

ШО



GRAPHIC SCALE

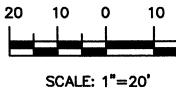

SHEET # 4 OF 4