

**GRADING & DRAINAGE PLAN** 

SCALE: 1'=20'-0'

NORTH

GRAPHIC SCALE
0 10 20

EXISTING CONTOUR NEW CONTOUR TOP OF CURB TOP OF ASPHAULT SPOT ELEVATION (NEW) FLOWLINE (NEW)

THE FOLLOWING ITEMS CONCERNING LOT 14 ALAMEDA BUSINESS PARK ARE CONTAINED HEREON:

2. DRAINAGE CALCULATIONS

TRI-STAR BUILDING AREA = 0.5134 ACRES ALAMEDA BUS. PARK

PRECIPITATION: 360 = 2.35 IN. 1440 = 2.75 IN. 10DA = 3.95 IN.

PEAK DISCHARGE: EXCESS PRECIPITATION: 1.56 CFS/AC. TREATMENT A 2.28 CFS/AC. 0.78 IN. TREATMENT B 3.14 CFS/AC. 4.70 CFS/AC. 1.13 IN. TREATMENT C 2.12 IN. TREATMENT D PROPOSED CONDITIONS: EXISTING CONDITIONS O AC. TREATMENT A 0 AC. 0.4406 AC. 0.0734 AC.

WEIGHTED E = 0.53 (0.00) + 0.78 (0.00) + 1.13 (2.01) + 2.12 (0.00) /2.01 AC.

V100 - 360 = 1.13 (2.01) / 12 = 0.183 ACFT. = 8244 CFS

0.514 AC.

TREATMENT B

TREATMENT C

TREATMENT D

Q100 = 1.58 (0.00) + 2.28 (0.00) + 3.14 (2.01) + 4.70 (0.00)= 6.311 CFS

PROPOSED EXCESS PRECIPITATION

WEIGHTED E = 0.53 (0.00) + 0.78 (0.00) + 1.13 (0.0734) + 2.12 (.4406) / 2.01 AC.

V100 - 360 = .506 (2.01) / 12 = 0.1301 ACFT = 8281 CFS

V100 -1440 = 0.19 + .0734 X (2.75 - 2.35) / 12 = 0.0024 ACFT = 206 CFS $V100 - 1440 = 0.19 + .0734 \times (3.85 - 2.35) / 12 = 0.0636 ACFT = 2771 CFS$ 

THE STATION IS LOCATED 0.35 MILES NORTH OF THE RICHFIELD ROAD BRIDGE OVER THE AMAFCA NORTH STATION IS AMAFCA BRASS TABLET STAMPED "NDC 7-1A,"
SET ON A CONCRETE POST PROJECTED 0.3 FEET ABOVE GROUND ELEVATION: 5053.10

EROSION CONTROL MEASURES

1. THE CONTRACTOR SHALL BE REPONSIBLE FOR MANAGEMENT OF STORM RUN-OFF DURING CONSTRUCTION, HE/SHE SHALL ASSURE THAT THE FOLLOWING MEASURES ARE TAKEN 1. ADJACENT PROPERTY SHALL BE PROTECTED AT ALL TIMES BY TEMPORARY BERMS, DIKES, SWALES, AND OTHER TEMPORARY GRADING AS REQUIRED TO PREVENT STORM RUN-OFF FROM LEAVING THE SITE AND ENTERING ADJACENT

2. ADJACENT PUBLIC RIGHT-OF-WAY SHALL BE PROTECTED AT ALL TIMES FROM STORM WATER RUN-OFF FROM THE SITE. NO SEDIMENT BEARING WATER SHALL BE PERMITTED TO ENTER THE PUBLIC STREETS.

EXISTING CONDITIONS


AS SHOWN BY THE VICINITY MAP, THE SITE CONTAINS 0.5134 ACRES AND IS LOCATED SOUTH OF VISTA ALAMEDA BLVD., ONE LOT EAST OF EDITH BOULEVARD. THE SITE HAS BEEN GRADED TO DRAIN FROM SOUTH TO NORTH. ACCORDING TO THE FLOOD INSURANCE RATE MAP PANEL 0136D, DATED SEPTEMBER 20, 1996, THE SITE IS NOT LOCATED WITHIN A DESIGNATED FLOOD ZONE.

PROPOSED CONDITIONS

AS SHOWN BY THE GRADING/DRAINAGE PLAN, THE PROJECT WILL CONSIST OF ONE OFFICE/WAREHOUSE BUILDING TOTALLING 5,600 SQ. FT. ALONG WITH ASSOCIATED PAVED PARKING AND LANDSCAPED AREAS. A MASTER DRAINAGE PLAN WAS PREPARED BY BOHANNAN-HOUSTON IN FEBRUARY OF 1999. ON-SITE RUN-OFF WILL TRAVEL ON VISTA ALAMEDA AND INTO INLETS WHICH DRAIN INTO A COMMOM POND PROVIDED BY THE MASTER DRAINAGE PLAN (TRACT A). THE CALCULATIONS WHICH APPEAR HEREON, ANALYZE THE EXISTING AND PROPOSED CONDITIONS FOR THE 100-YEAR, 6-HOUR EVENT. THE PROCEDURE FOR 40 ACRES AND SMALLER BASINS, AS SET FORTH IN THE REVISION OF SECTION 22.2 HYDROLOGY OF THE DEVELOPMENT PROCESS MANUAL VOLUME II, DESIGN CRITERIA DATED 1997, HAS BEEN USED TO QUANTIFY THE PEAK RATE OF DISCHARGE AND VOLUME OF RUN-OFF GENERATED.

DOWN STREAM CONDITIONS

PER THE APPROVED MASTER DRAINAGE PLAN, FREE DISCHARGE HAS BEEN ALLOWED INTO A COMMON POND PROVIDED BY THE ALAMEDA BUSINESS PARK MASTER DRAINAGE PLAN.

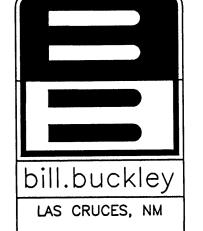





DESIGN COLLABORATIVE THE ART AND SCIENCE OF MODERN BUILDINGS

> 8/24/00 DRAWN BY



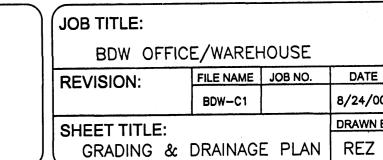



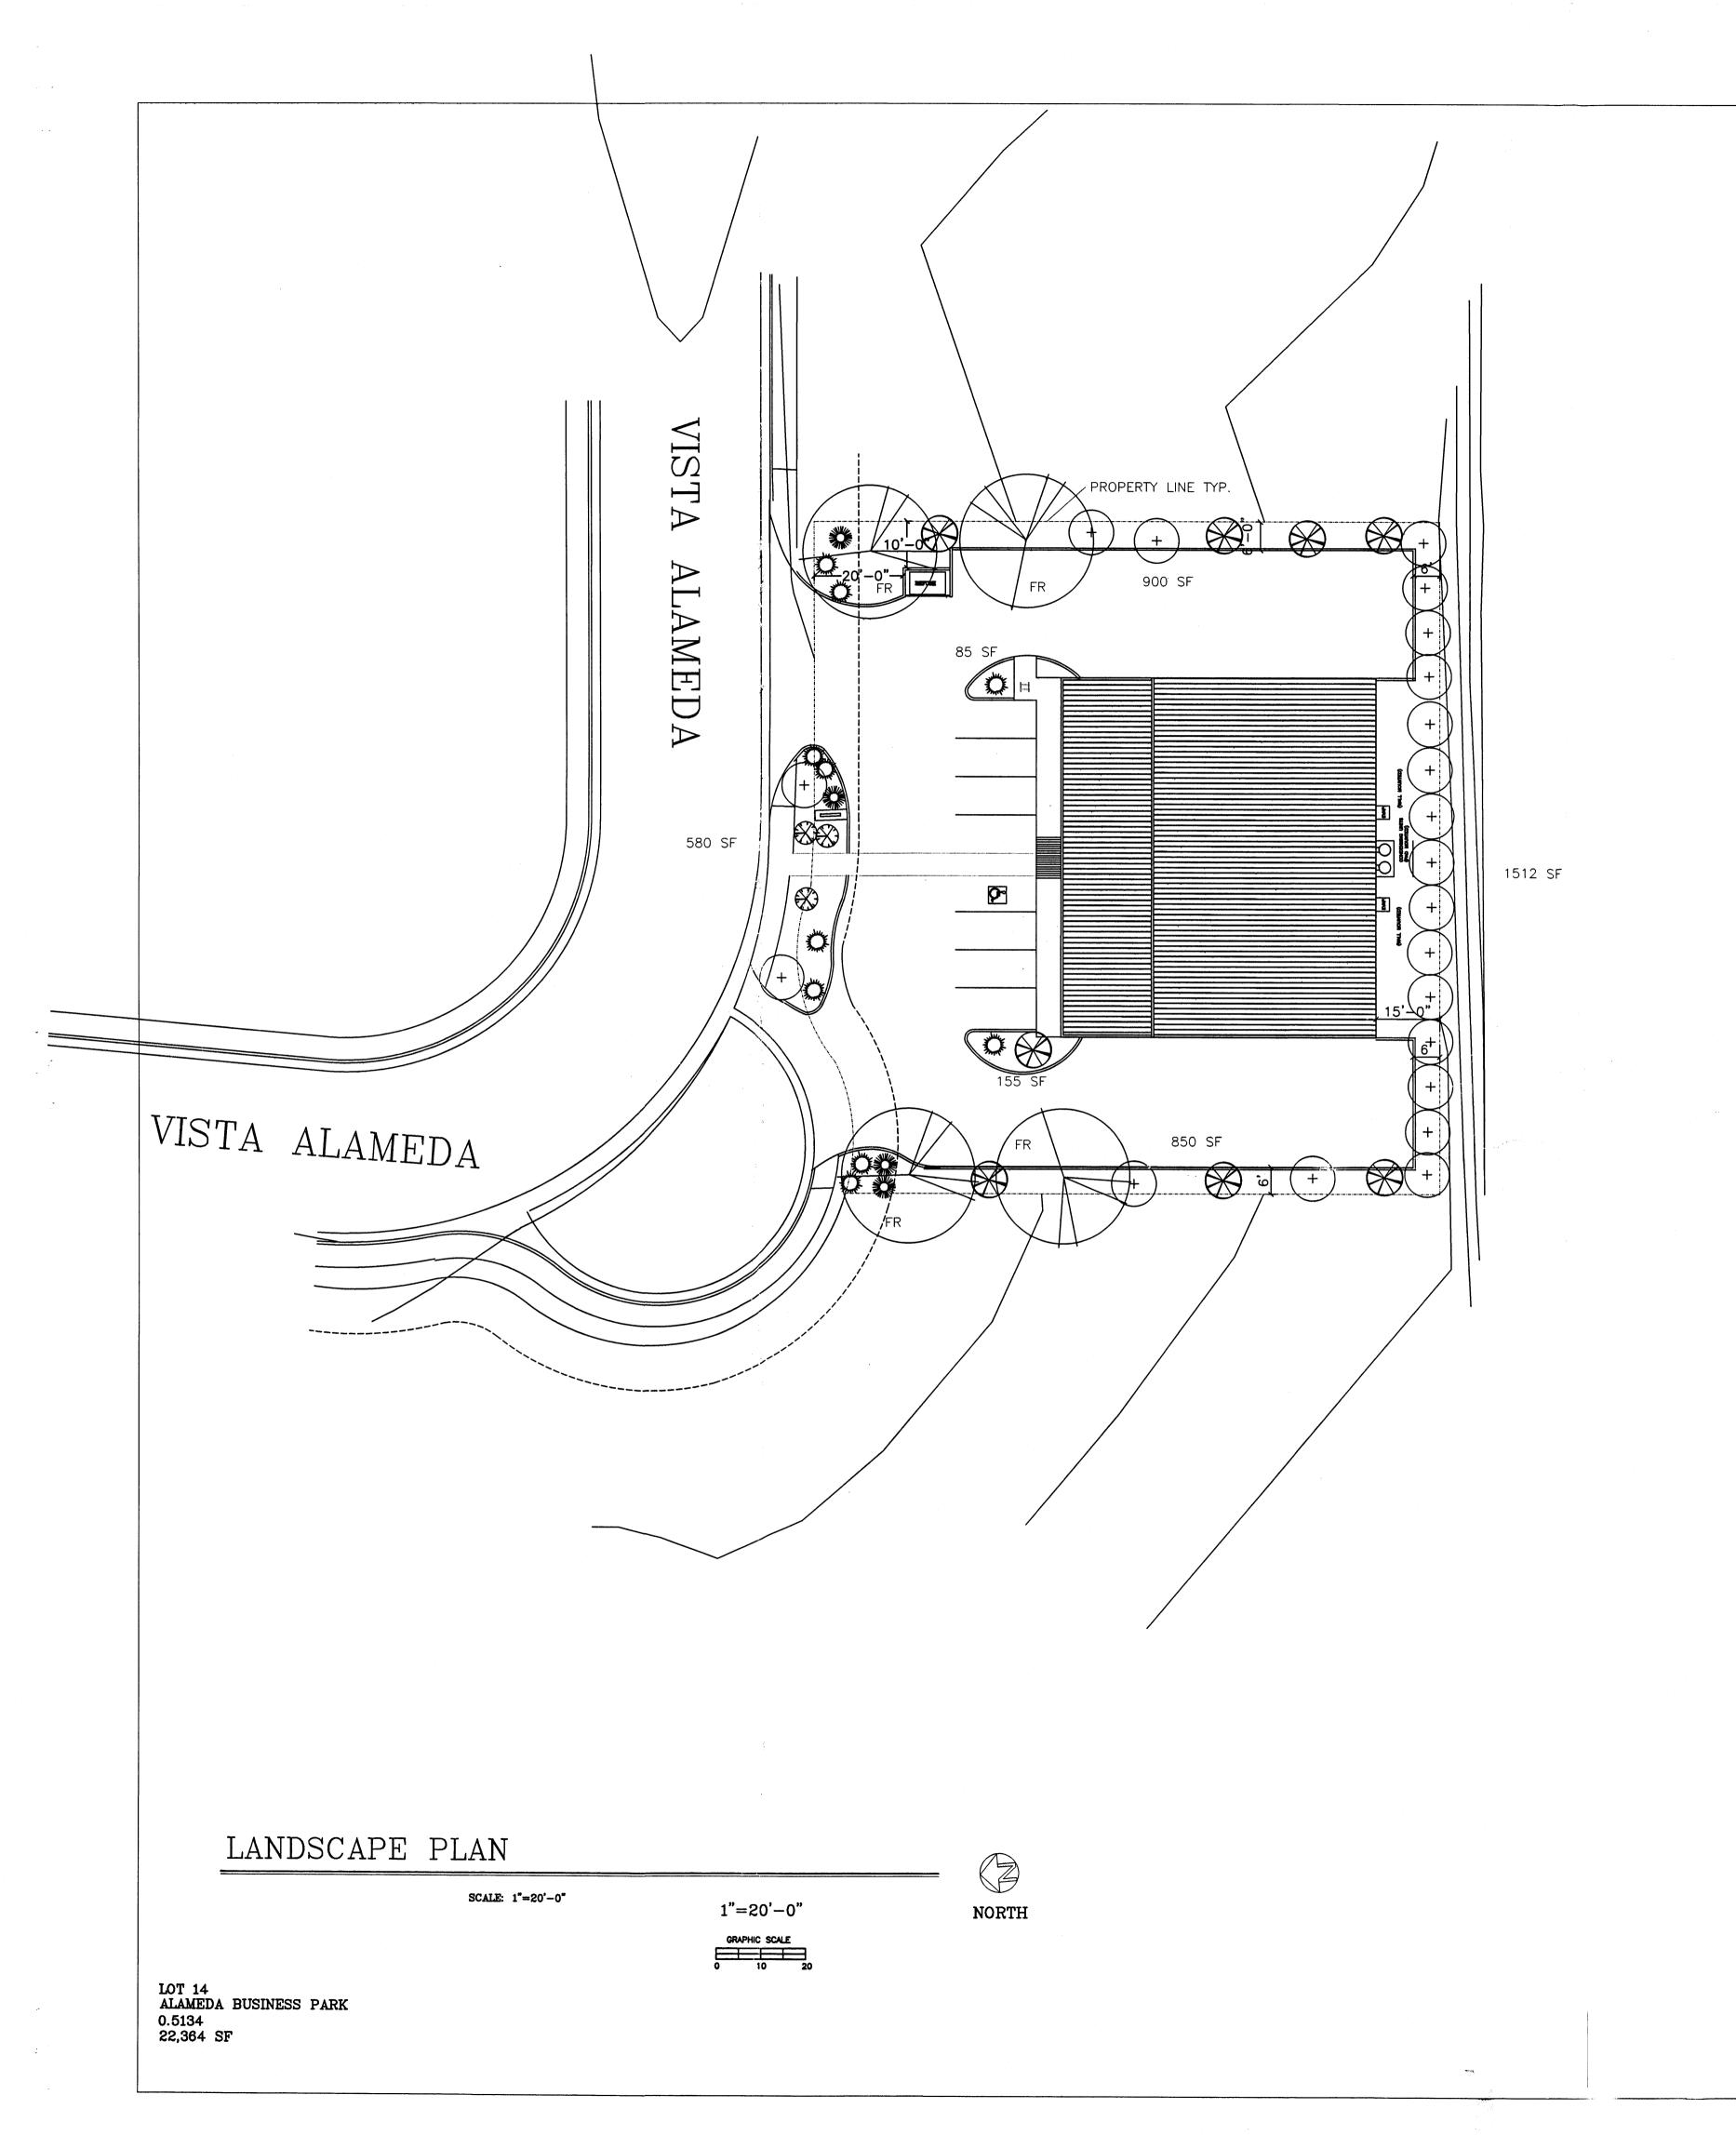



SYMBOL QTY. BOTANICAL NAME COMMON NAME SIZE 4 FRAXINUS 2" CAL 21 ELAEAGNUS PUNGENS SILVERBERRY 5 GAL 11 JUNIPERUS SABINA BUFFALO JUNIPER 7 BUDDLEIA DAVIDII BUTTERFLY BUSH CARYOPTERIS X CLADONENSIS BLUE MIST ROSMARINUS OFFICINALIS ROSEMARY MISCANTHUS SINENSIS

MAIDEN GRASS

## SITE DATA

22,364 SF 5,600 SF GROSS LOT AREA LESS BUILDING 16,734 SF NET LOT AREA REQUIRED LANDSCAPE 2,510 SF 15% OF NET LOT AREA PROPOSED LANDSCAPE 4,062 SF PERCENT OF NET LOT AREA 22%

REQUIRED STREET TREES PROVIDED AT 30' 0.0. SPACING ALONG STREET FRONTAGE

## NOTE

MAINTENANCE OF LANDSCAPE PROVIDED BY OWNER

PLANTINGS TO BE WATERED BY AUTO. DRIP IRRIGATION SYSTEM

WATER MANAGEMENT IS THE SOLE RESPONSIBILITY OF THE PROPERTY OWNER

THIS PLAN IS TO COMPLY WITH C.O.A. LANDSCAPE AND WATER WASTE ORDINANCE


IT IS THE INTENT OF THIS PLAN TO PROVIDE MIN. 75% LIVE GROUNDCOVER OF LANDSCAPE AREAS AT MATURITY

PLANTING AREAS TO BE MULCHED WITH 3" LAVER OF 1-1/2" SANTA ANA TAN GRAVEL OVER FILTER FABRIC PER ALAMEDA BUSINESS PARK MASTER PLAN.

TREES SHALL NOT BE PLANTED IN 10' PUBLIC UTILITY EASEMENT ALONG FRONT OF PROPERTY.


## SPECIAL NOTE:

APPROACH USED FOR LANDSCAPE CALCULATIONS IS THE PLANTING RESTRICTIONS APPROACH PER WATER CONSERVATION LANDSCAPING AND WATER WASTE ORDINANCE (ARTICLE 6-1-1).

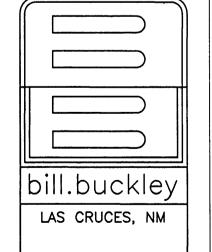




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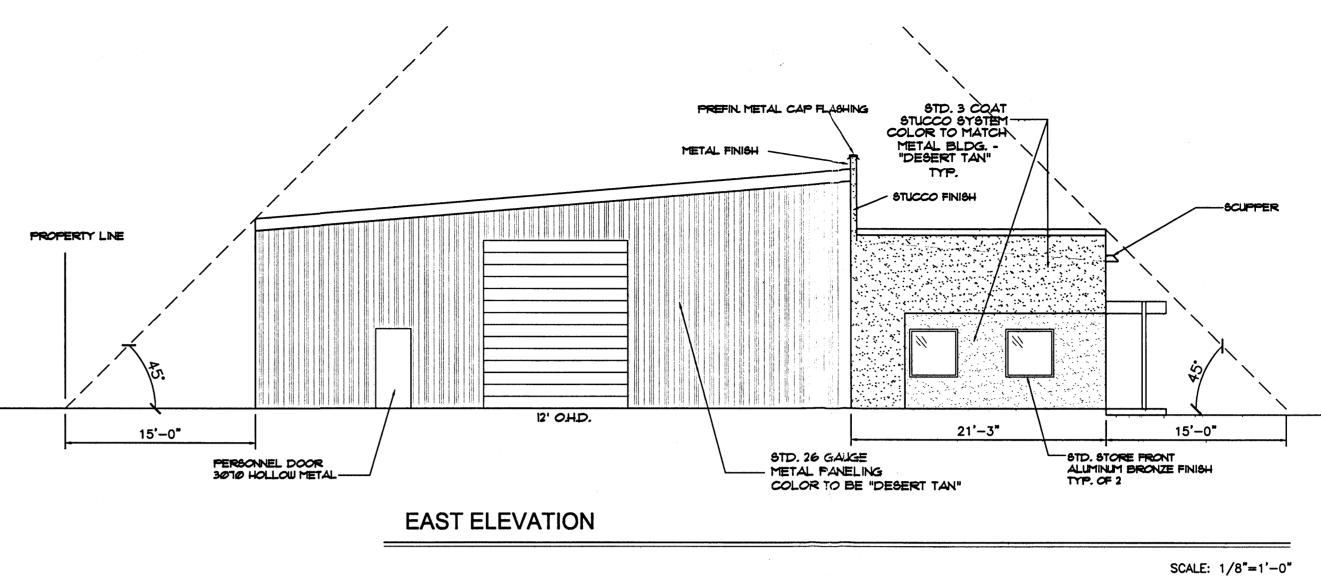
JOB TITLE:					
BDW OFFICE/WAREHOUSE					
REVISION: 8/3/00	FILE NAME	JOB NO.	DATE		
	BDW-A1		8/24/00		
SHEET TITLE:			DRAWN B		
LANDSCAPE PLAN			JRC		

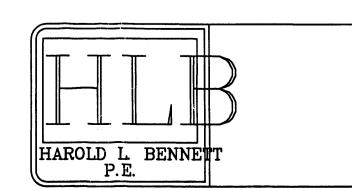







SCALE: 1/8"=1'-0"

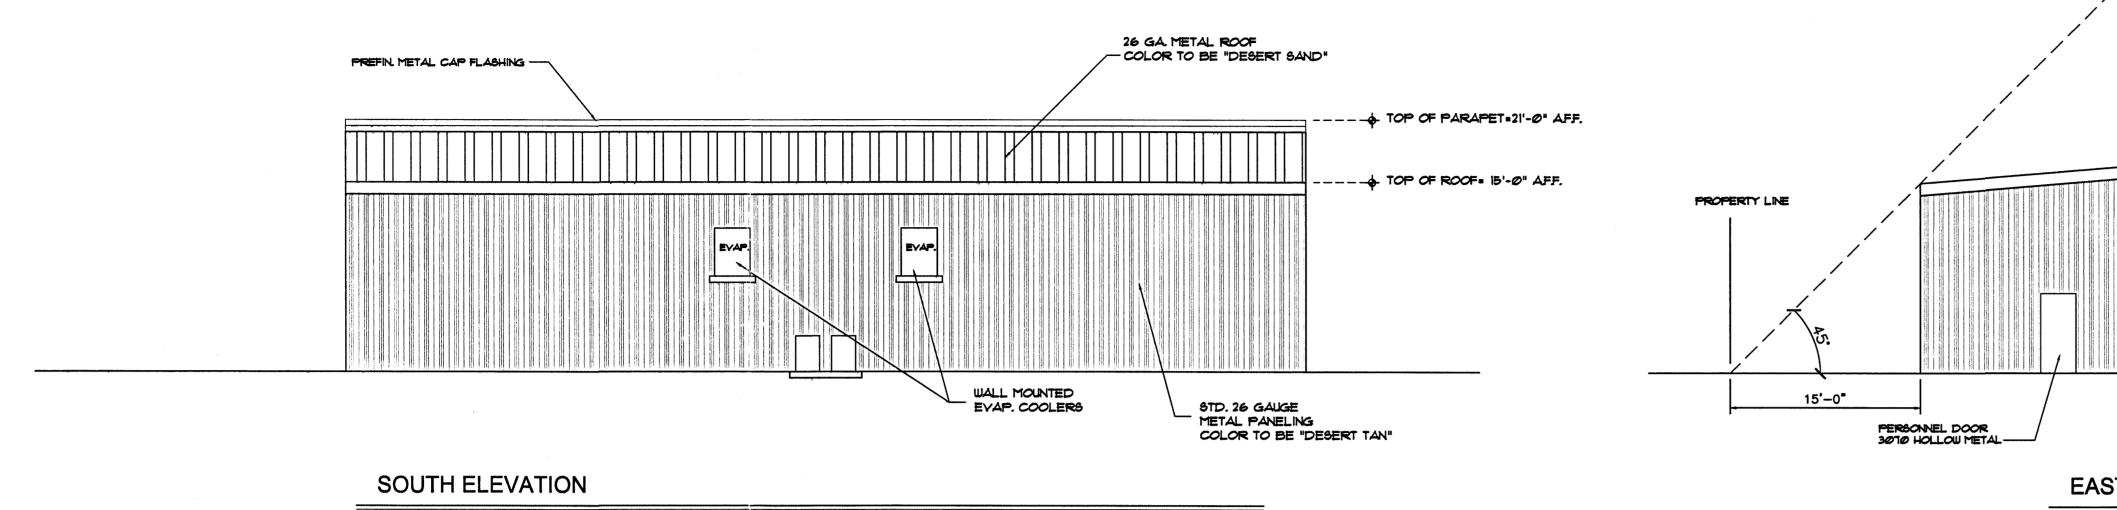


NOTE: STUCCO COLOR TO BE "DESERT TAN"

TYP. AT ALL STUCCO LOCATIONS.

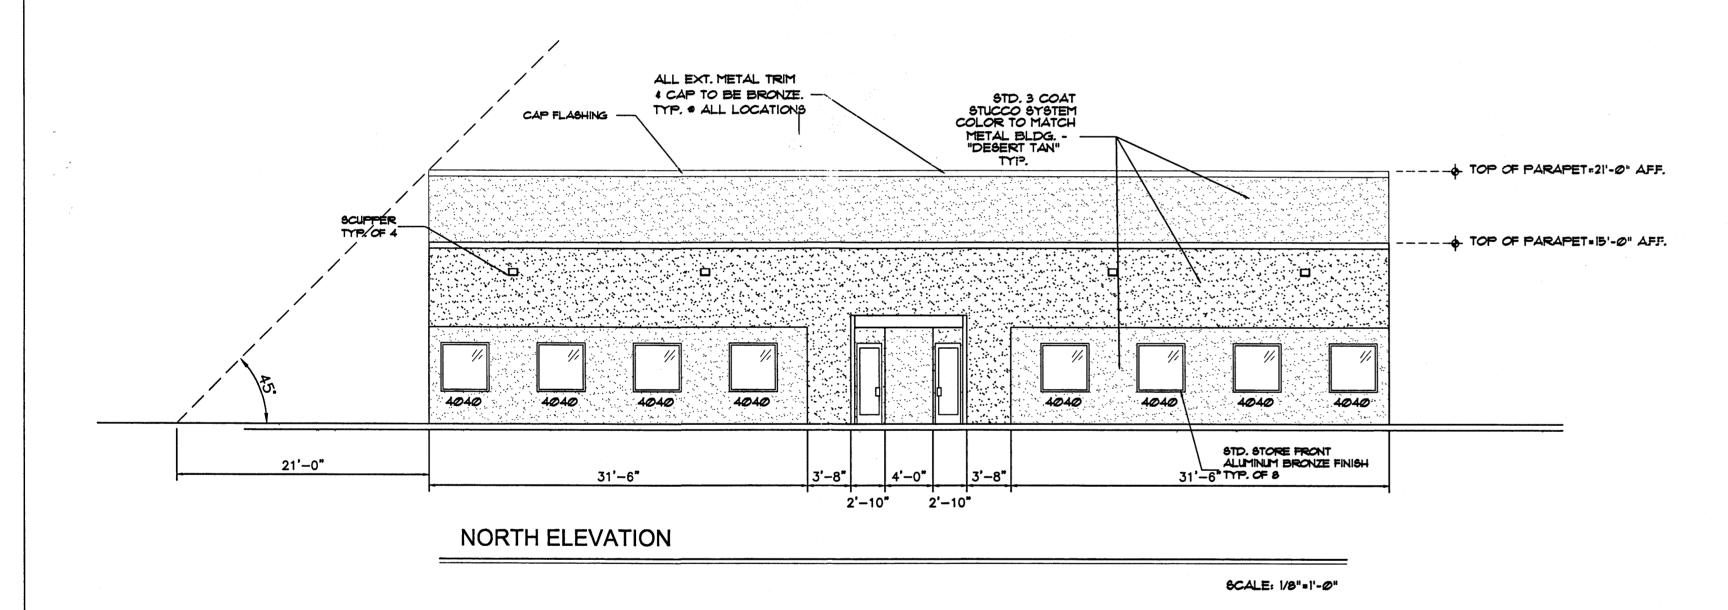

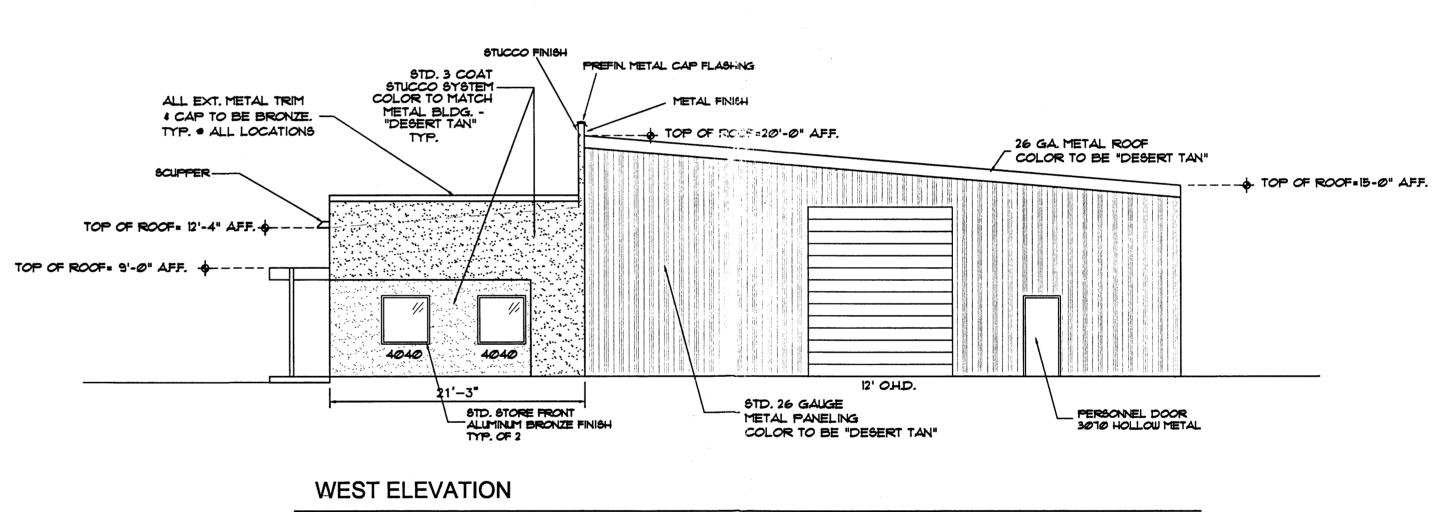

SCALE: 1/8"=1'-0"

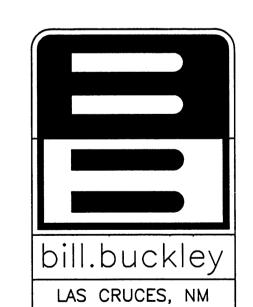



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	JOB TITLE:					
į	BDW WAREHOUSE					
	REVISION:	FILE NAME	JOB NO.	DATE		
		BDW-A3		8/24/00		
İ	SHEET TITLE:	DRAWN BY				
	ELEVATIONS			REZ		

