

LANDSCAPE NOTES:

Landscape maintenance shall be the responsibility of the Property Owner.

It is the intent of this plan to comply with the City Of Albuquerque, Water Conservation Landscaping and Water Waste Ordinance, planting restriction approach.

Approval of this plan does not constitute or imply exemption from water waste provisions of the Water Conservation Landscaping and Water Waste Ordinance. Water management is the sole responsibility of the Property Owner.

All landscaping will be in conformance with the City of Albuquerque Zoning Code, Street Tree Ordinance, Pollen Ordinance, and Water Conservation Landscaping, and Water Waste Ordinance. In general, water conservative, environmentally sound landscape principles will be followed in design and installation.

Plant beds shall achieve 75% live ground cover at maturity.

Santa Fe Brown Crusher Fines over Filter Fabric shall be placed in all landscape areas which are not designated to receive native seed.

25 SQ FT OVERSIZE GRAVEL WILL BE PLACED AT THE BASE OF EVERY ROOF DRAIN.

#### IRRIGATION NOTES:

Irrigation shall be a complete underground system with Trees to receive (5) 1.0 GPH Drip Emitters and Shrubs to receive (2) 1.0 GPH Drip Emitters. Drip and Bubbler systems to be tied to 1/2" polypipe with flush caps at each end.

Run time per each drip valve will be approximately 15 minutes per day, to be adjusted according to the season.

Point of connection for irrigation system is unknown at current time and will be coordinated in the field.

Irrigation will be operated by automatic controller.

Location of controller to be field determined
and power source for controller to be provided
by others.

Irrigation maintenance shall be the responsibility of the Property Owner.



GRAPHIC SCALE


20 10 0 20

SCALE: 1"=20'

# PLANT LEGEND

Forestiera neomexicana

15 gal.

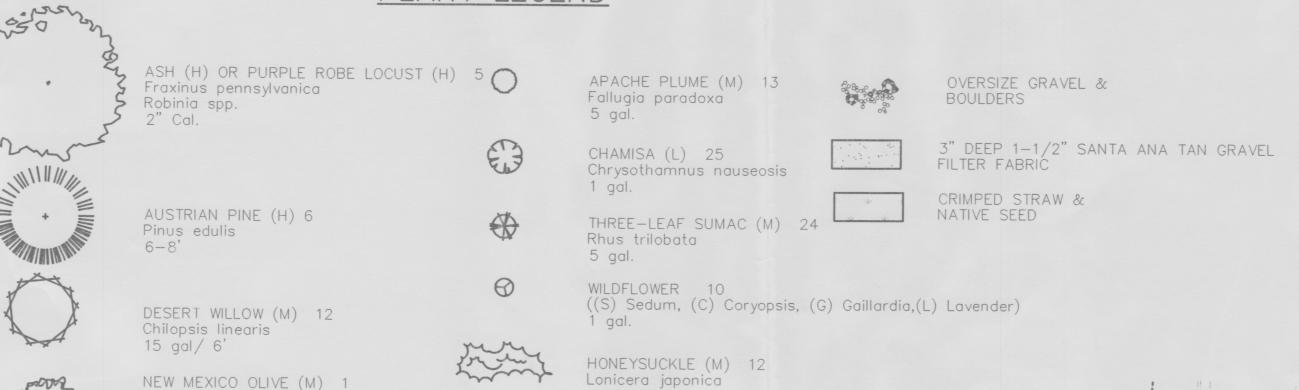


5 gal

# LANDSCAPE CALCULATIONS

### NET LANDSCAPE AREA

TOTAL LOT AREA	48201	square	feet
TOTAL BUILDINGS AREA	10280	square	feet
OFFSITE AREA	0	square	feet
NET LOT AREA	37921	square	feet
LANDSCAPE REQUIREMENT	15%		
TOTAL LANDSCAPE REQUIREMENT	5688	square	feet
TOTAL			
TOTAL LANDSCAPE PROVIDED	18054 (48%)	square	feet
TOTAL BED PROVIDED	6889	square	feet
TOTAL SOD PROVIDED	0	square	feet
TOTAL NATIVE SEED PROVIDED	11165	square	feet

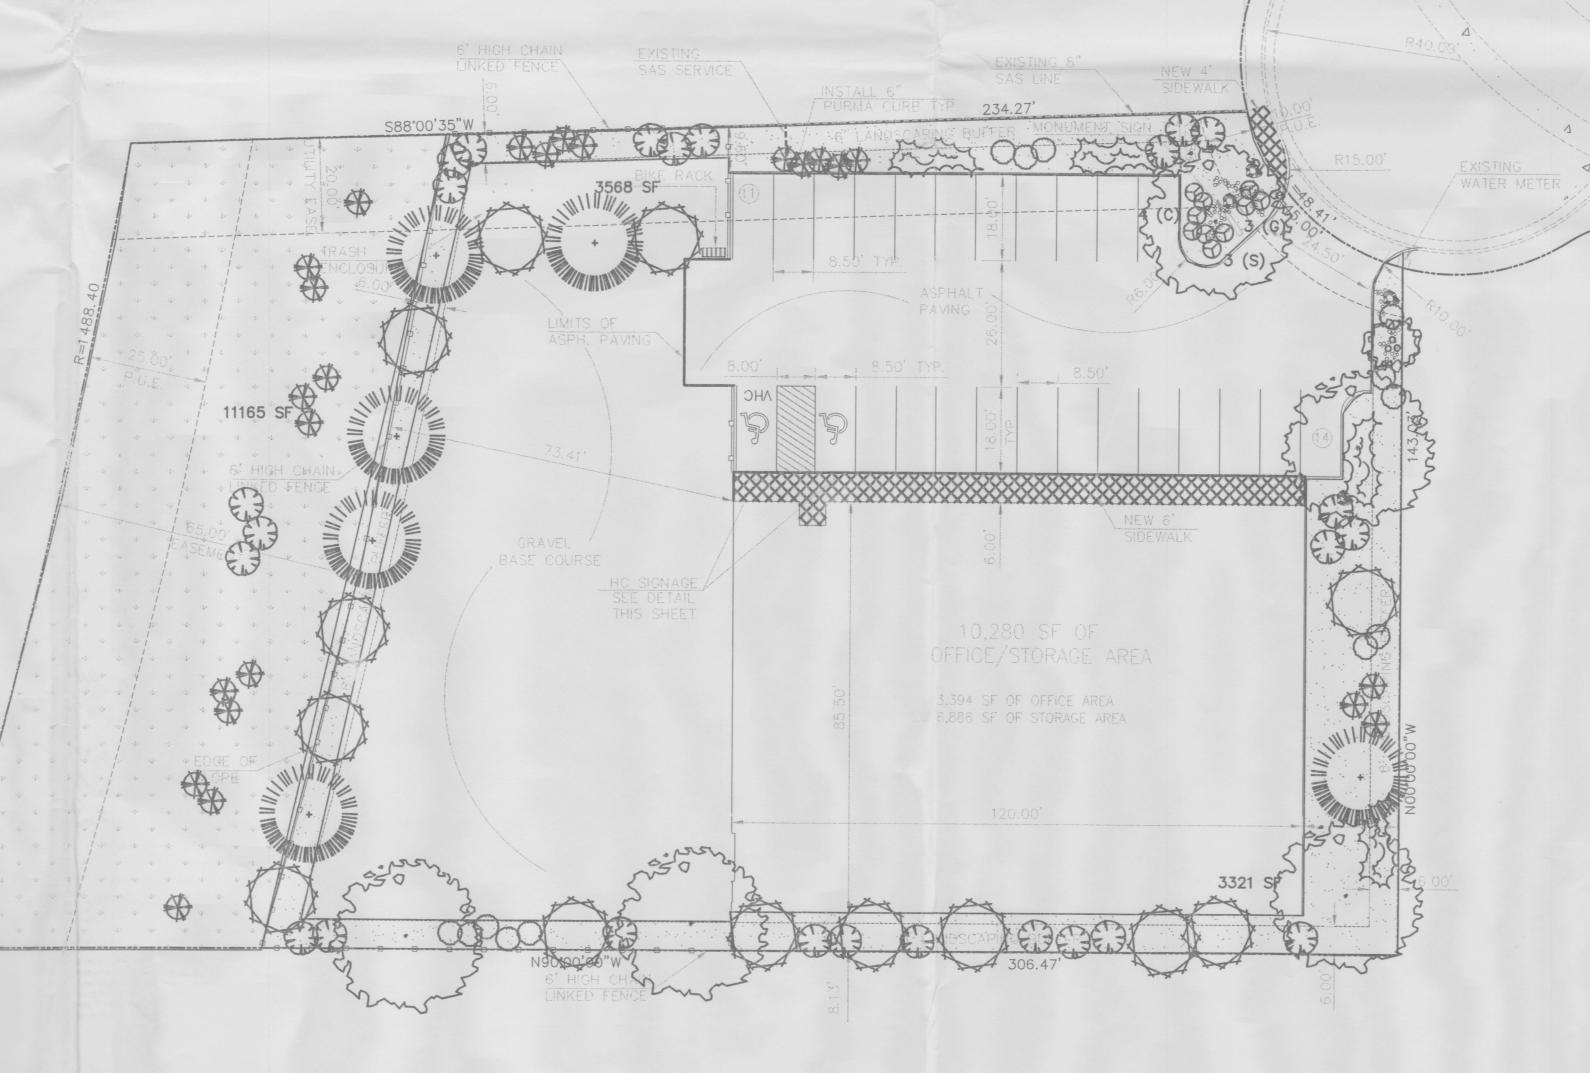

LANDSCAPE ARCHITECTS & CONTRACTORS

Cont. Lic. #26458
7909 Edith N.E.

Albuquerque, NM 87184
Ph. (505) 898–9690
Fax (505) 898–7737
it@hilltoplandscaping.com

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SHAHAB BIAZAR P.E. #13479 10205 SNOWFLAKE CT., NW ALBUQUERQUE, NEW MEXICO 87114 (505)899-5570


SHEET#

2 OF 4

HB CONSTRUCTION LANDSCAPE PLAN

DRAWING: DRAWN BY: DATE:


06-04-01

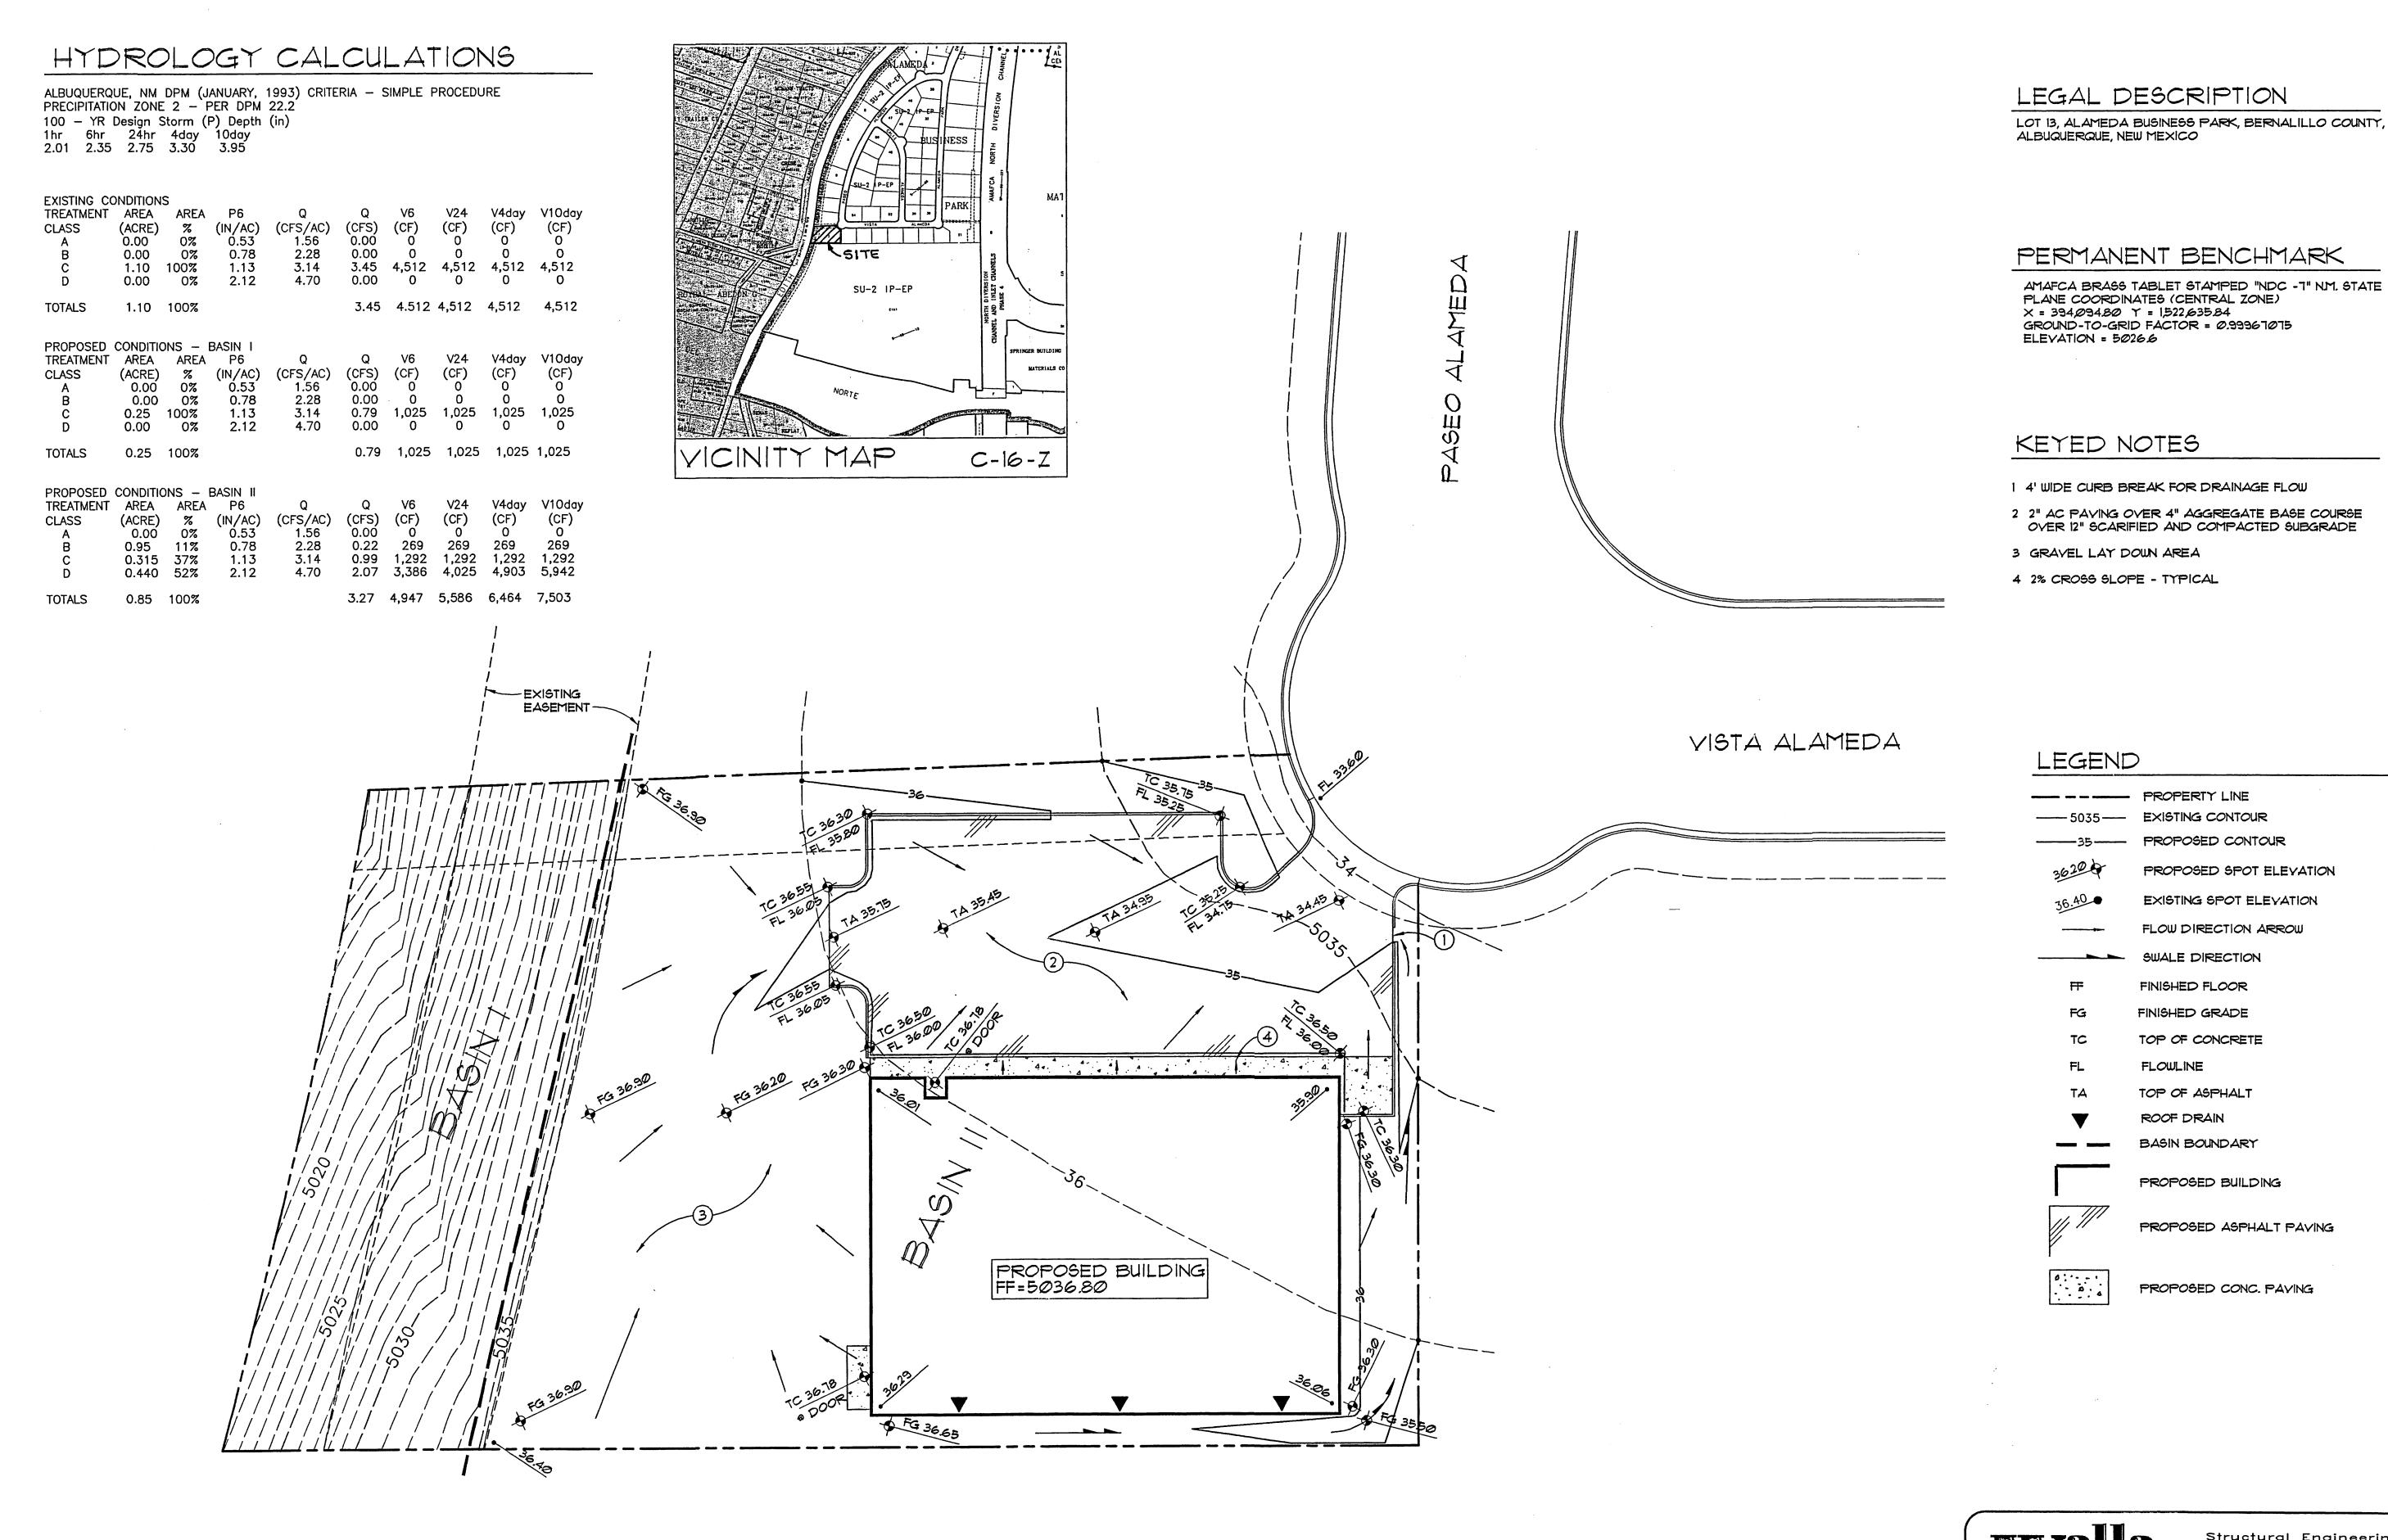

GRADING and DRAINAGE PLAN





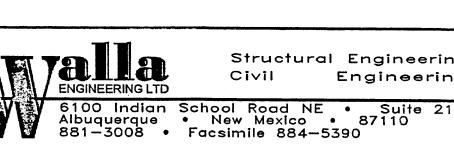

**HB** Construction Office GRADING and DRAINAGE PLAN

3 OF 4

PROJECT NO.: H11-0101
SHEET#

DRAWN: LEK

LEGEND

----- 5035 --- EXISTING CONTOUR

----35 ---- PROPOSED CONTOUR

PROPOSED SPOT ELEVATION

EXISTING SPOT ELEVATION

FLOW DIRECTION ARROW

SWALE DIRECTION

FINISHED FLOOR

FINISHED GRADE

TOP OF CONCRETE

TOP OF ASPHALT

BASIN BOUNDARY


PROPOSED BUILDING


PROPOSED ASPHALT PAVING

PROPOSED CONC. PAYING

ROOF DRAIN

FLOWLINE

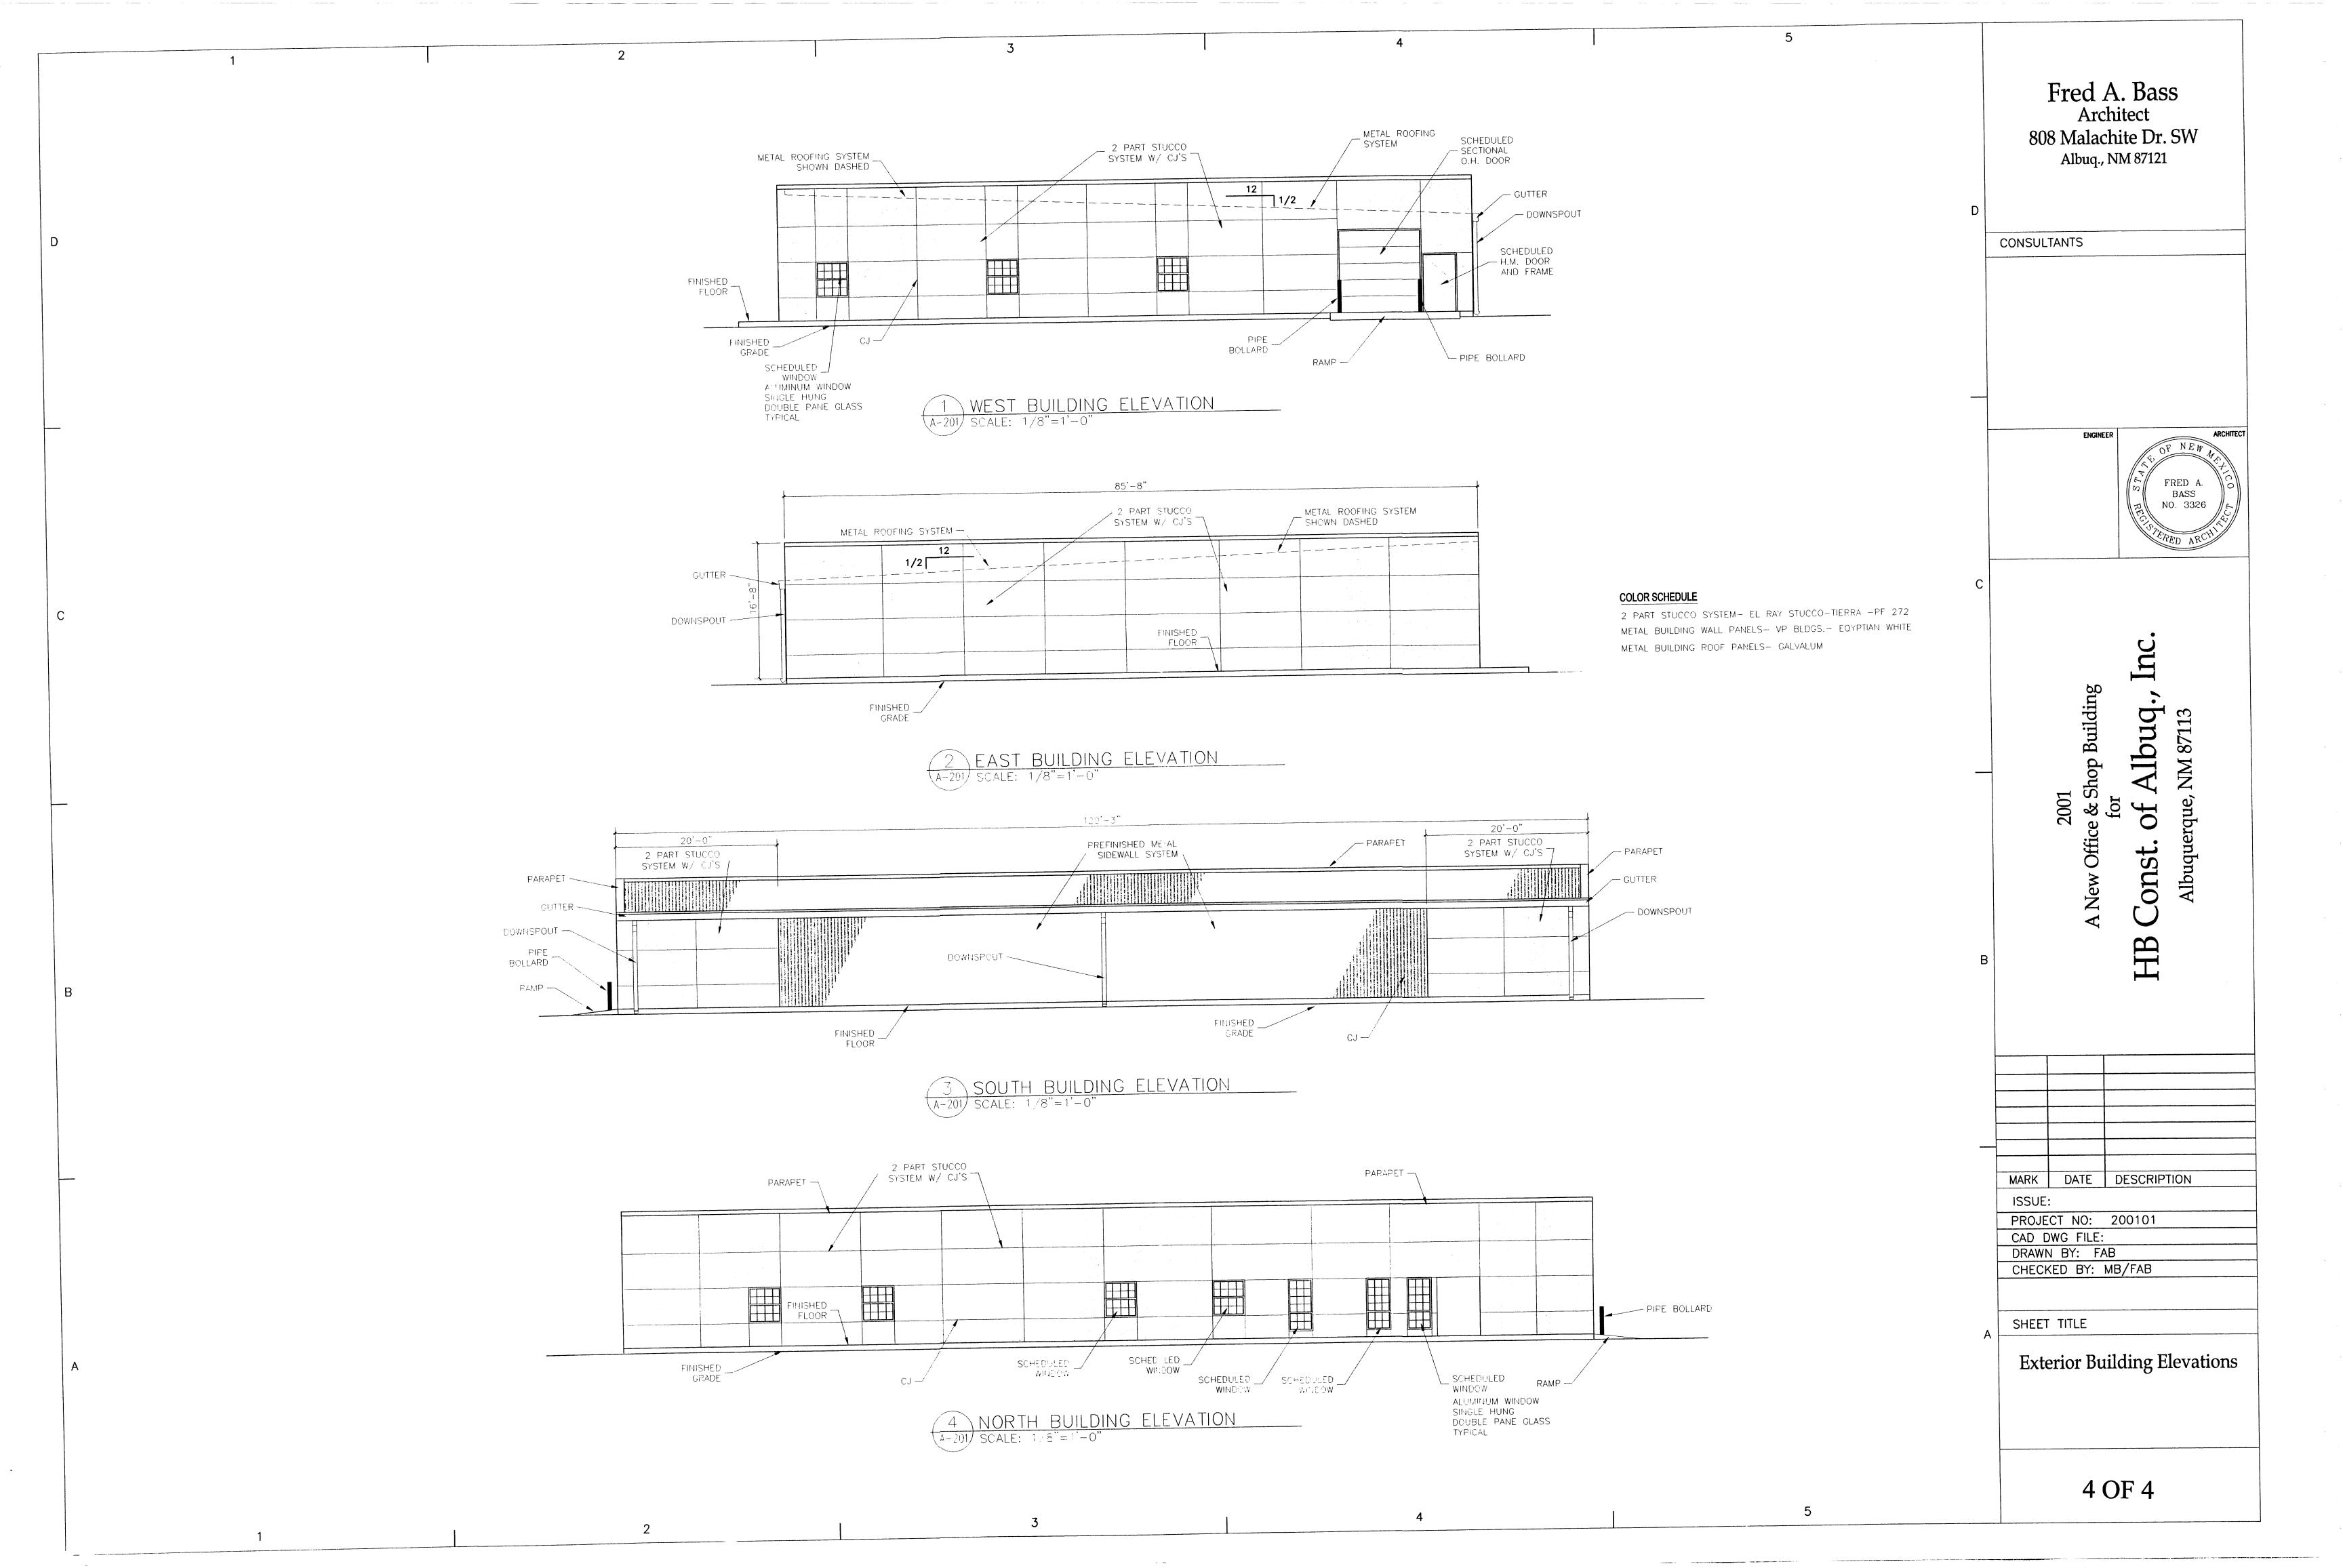

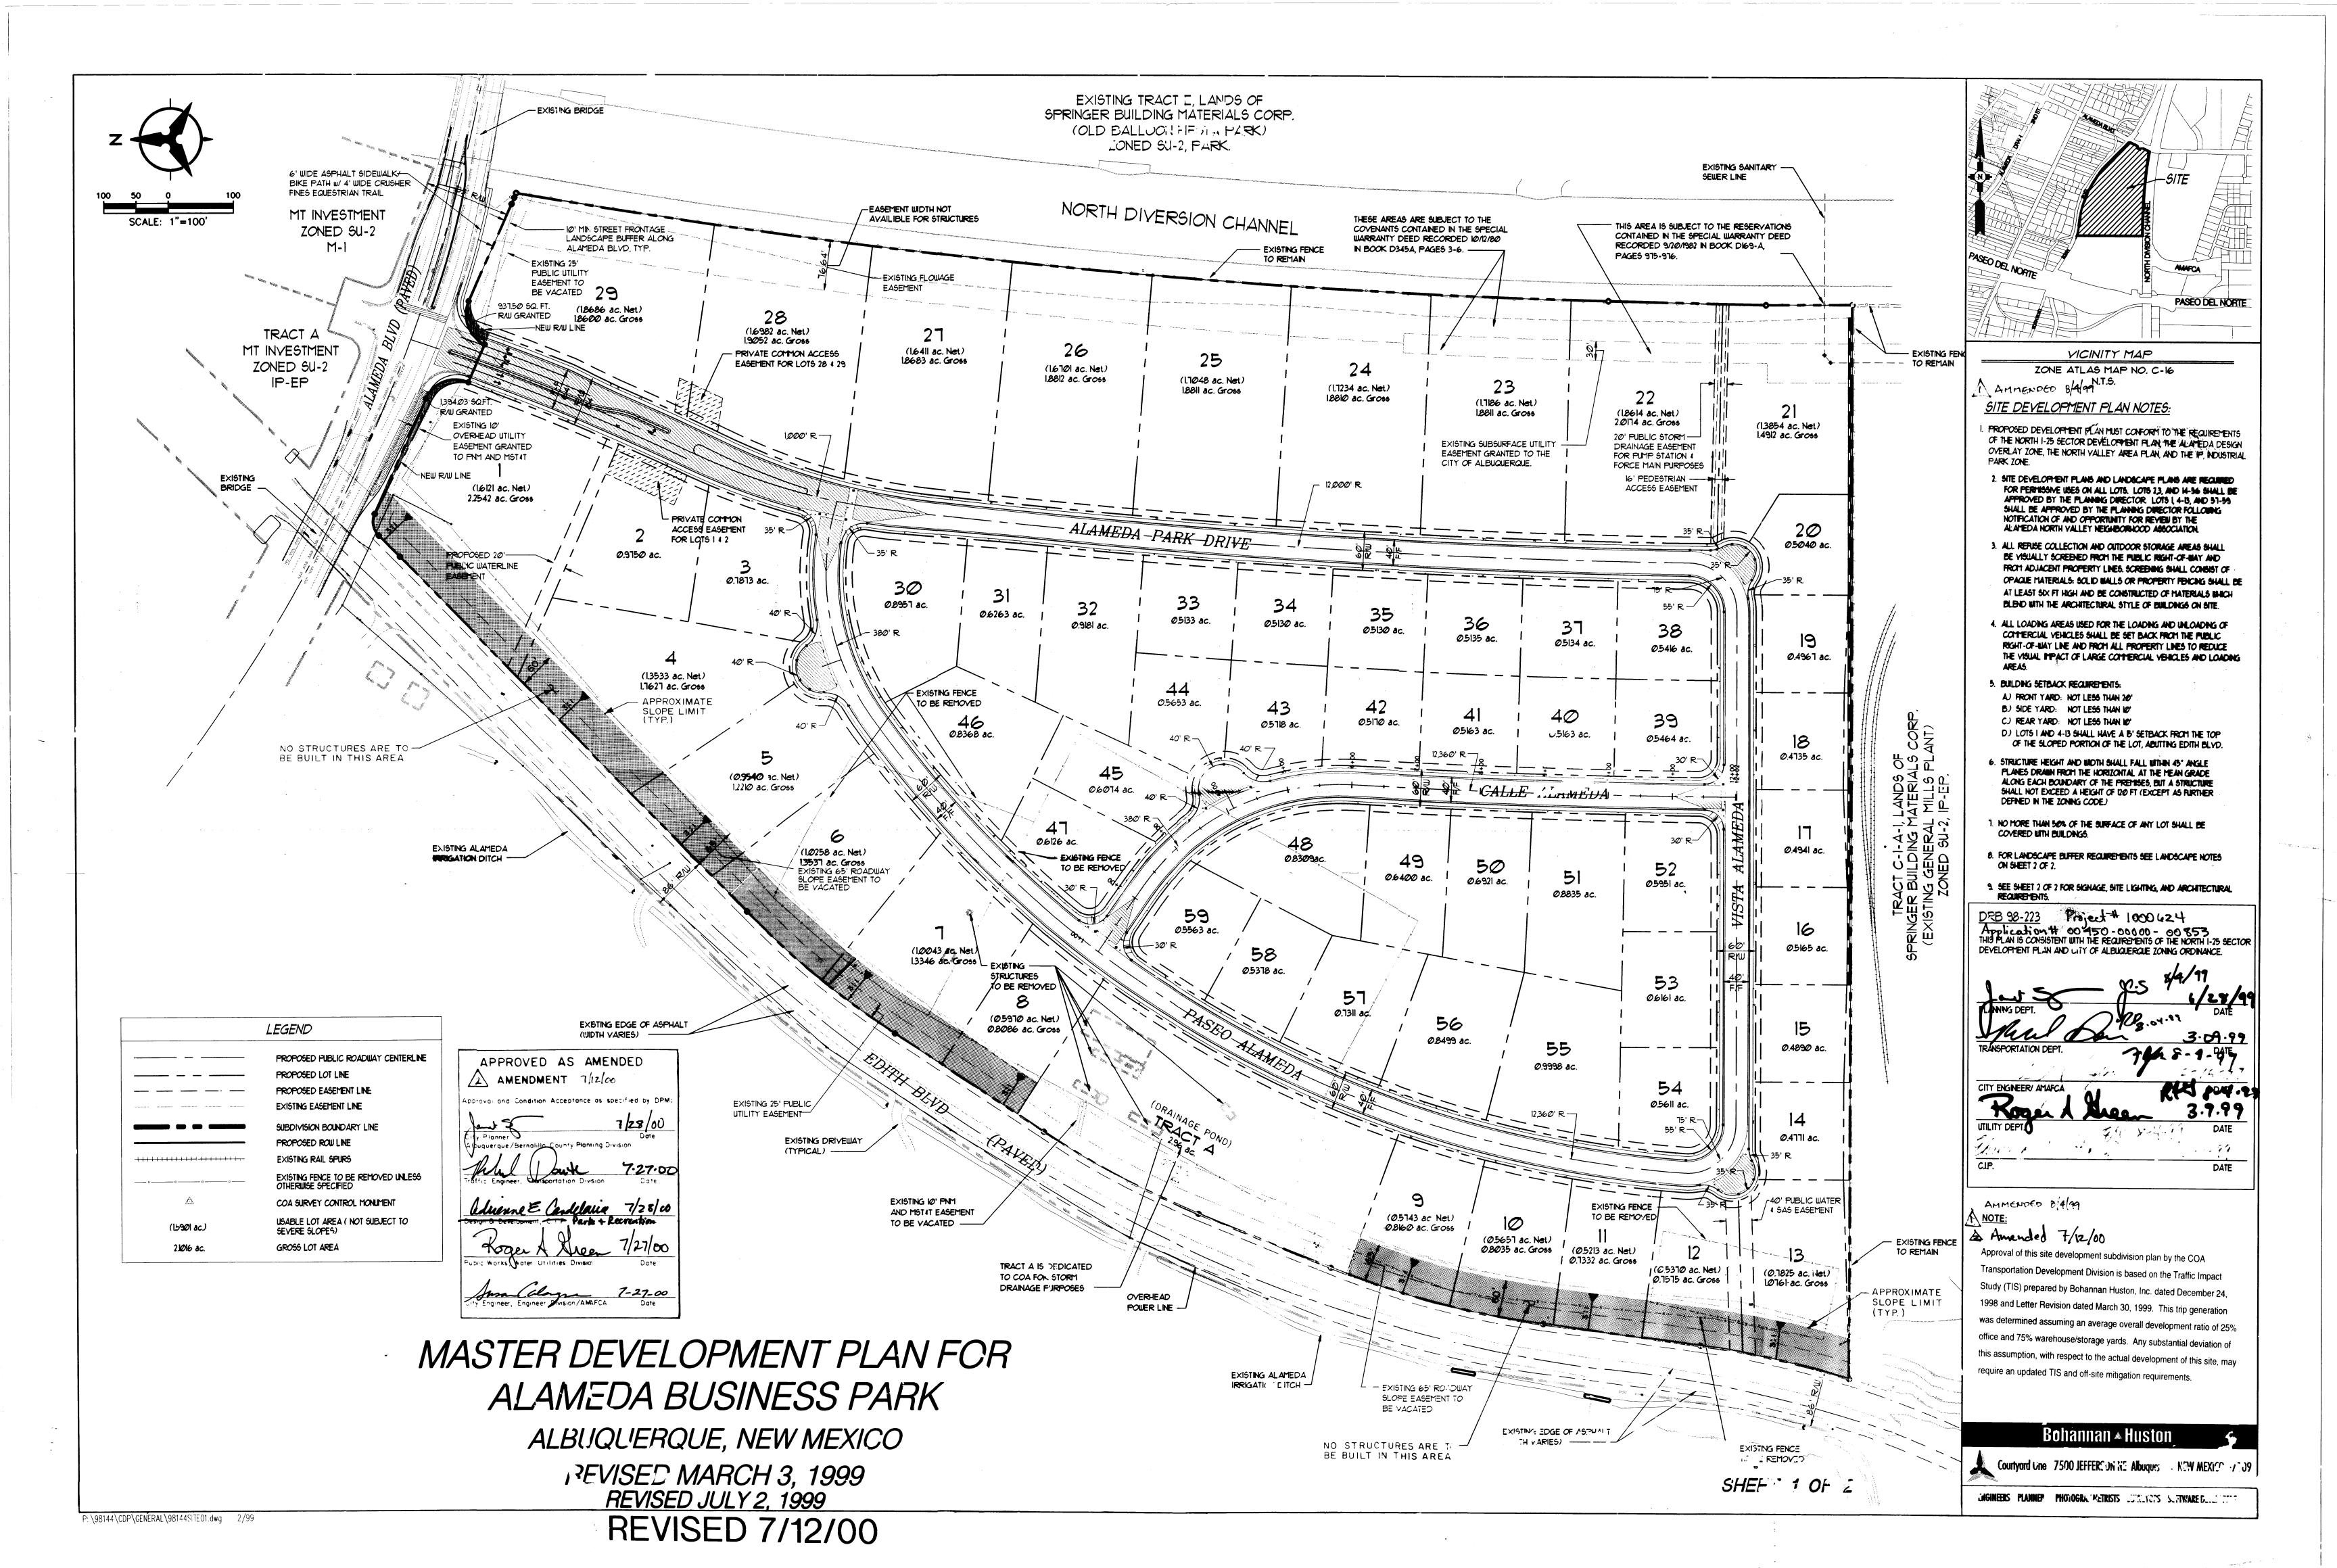

## LANDSCAPE DEVELOPMENT NOTES:

- I. PROPOSED DEVELOPMENT PLAN MUST CONFORM TO THE REQUIREMENTS OF THE NORTH I-25 SECTOR DEVELOPMENT PLAN, AND THE CITY OF ALBUQUERQUE COMPREHENSIVE ZONING CODE.
- 2. LANDSCAPING BUFFER AREAS SHALL BE REQUIRED ON EACH LOT
  - A. FRONT YARD: 10 FT LANDSCAPING BUFFER
  - B. SIDE YARD: 6 FT MIN. LANDSCAPING BUFFER, EXCEPT AS FOLLOWS:
    - 1.) LOTS WITH SIDE YARDS ABUTTING ALAMEDA BLVD. SHALL HAVE A 10 FT SIDE YARD LANDSCAPING BUFFER REQUIRED ON THE ABUTTING SIDE.
  - C. REAR YARD: 6' REAR LANDSCAPING BUFFER IS RÉQUIRED, EXCEPT AS FOLLOUS:
    - 1.) LOTS WITH REAR YARDS ABUTTING ALAMEDA BLVD.
      SHALL HAVE A 10 FT REAR YARD LANDSCAPING BUFFER REQUIRED
      ON THE ABUTTING SIDE.

2) IF NOT REQUIRED BY COA ZONING ENFORCEMENT STAFF, THIS DUFFER SHALL NOT BE REQUIRED.

3.) LOTS I AND 4-13 SHALL HAVE A 6' REAR YARD LANDSCAPING BUFFER AT THE TOP OF THE SLOPE. NO ADDITIONAL REAR YARD LANDSCAPING BUFFER SHALL BE REQUIRED AT THE REAR PROPERTY LINE (EDITH BLVD. RAW) HOWEVER, EACH LOT SHALL BE REQUIRED TO PLANT, IRRIGATE, UNTIL SELF SUSTAINING, AND MAINTAIN A MINIMUM OF SIX (6) NATIVE PLANT SHRUBS ON THE SIXTY FOOT (60') WIDE SLOPED AREA OF THE LOT (ABUTTING EDITH BLVD.) THE NATIVE SHRUBS SHALL BE SELECTED FROM THE FOLLOWING SPECIES:

CHRYSOTHAMNUS NAUSEOSUS ATRIPLEX CANESCENS FALLUGIA PARADOXA RHUS TRILOBATA

CHAMISA
FOUR WING SALTBUSH
APACHE PLUME
THREE LEAF SUMAC

THESE PLANTS SHALL BE RANDOMLY PLANTED ON THE HILL, AND SPACED A MINIMUM OF 10' O.C. FROM OTHER PLANTS.

- 3. SLOPED PORTIONS OF LOTS ADJACENT TO EDITH BLVD. SHALL BE SEEDED FER C.O.A. SPECS. NO BUILDING SHALL BE CONSTRUCTED WITHIN THIS S'XTY FOOT (60") WIDE SLOPED AREA.
- 4. LOTS ABUTTING ALAMEDA BLVD. SHALL PLANT STREET
  TREES IN ACCORDANCE WITH THE C.O.A. STREET TREE ORDINANCE.
  TREES SHALL BE PLANTED AT TWENTY FEET (20") O.C. AT THE TOP OF THE
  SLOPED PORTION OF LOTS I AND 4-13 ON THE EDITH ABUTTING SIDE,
  AT LEAST 50% OF WHICH SHALL BE EVERGREEN TREES. THE DECIDUOUS TREES SHALL SE:

POBINIA AMBIGUA
HISTACHIA CHINENSIS
CHILOPSIS LINEARS
FRAXINUS VELUNTINA
QUERCUS SHUMARDI

PURPLE ROBE LOCUST
CHINESE PISTACHE
DESERT WILLOW
ARIZONA ASH
SHUMARDS RED OAK

THE EVERGREEN TREES SHALL BE:

CUPRESSOCYPARIS LEYLANDII LEYLAND CYPRESS
JUNIPERUS MONOSPERMA (FEMALE VARIETY ONLY) ONE SEED JUNIPER
PINUS ELDARICA AFGHAN PINE
PINUS NIGRA AUSTRIAN PINE
PINUS SYLVESTRIS SCOTCH PINE

THESE TREES SHALL FORM AN OPAQUE VISUAL BUFFER TO TWENTY FEET (20') IN HEIGHT MINIMUM IN A 10-15 YEAR GROWING PERIOD. NO ADDITIONAL STREET TREE PLANTING WILL BE REQUIRED FOR THESE LOTS, EXCEPT LOT 1, WHICH MUST CONFORM TO THE COA STREET TREE ORDINANCE ON ALAMEDA BLVD.

- 5. ALL AREAS USED FOR OFF-STREET PARKING SHALL BE DESIGNED AND LANDSCAPED TO REDUCE THE VISUAL IMPACT OF PARKED CARS.
  LANDSCAPING SHALL BE IN ACCORDANCE WITH THE OFF-STREET PARKING LANDSCAPING REGULATIONS OF THE C.O.A. COMPREHENSIVE ZONING CODE WITH THE FOLLOWING EXCEPTIONS:
  - A. ALL AREAS OF PARKING LOTS NOT USED FOR PARKING OR AUTO CIRCULATION MUST BE LANDSCAPED.
  - B. NO PARKING SPACE MAY BE MORE THAN 50 FT FROM A TREE.
- 6. TREES, SHRUBS, AND VEGETATIVE GROUND COVER SHALL BE SELECTED FROM PLANT LEGEND ON THIS PAGE.
- 7. PLANTINGS SHALL BE PLACED ON SITE TO PROVIDE SHADE FOR ALL PEDESTRIAN AREAS AND BUILDINGS DURING SUMMER MONTHS.
- 8. LANDSCAPING SHALL CONFORM TO TO COLAIS WATER CONSERVATION POLICIES.


- 9. PLANTINGS SHALL BE LOCATED WITH RESPECT TO THE CLEAR SIGHT TRIANGLE REQUIREMENTS.
- 10. TREES SHALL NOT BE PLANTED IN PUBLIC UTILITY EASEMENTS.
- 11. ALL PLANTING BEDS SHALL BE MULCHED WITH A 3" LAYER OF 1-1/2" SANTA ANA TAN GRAVEL. ALL GRAVEL SHALL BE UNDERLINED WITH DE WITT PRO 5, 28 MIL. FILTER FABRIC OR APPROVED EQUAL. EXCLUDE FILTER FABRIC IN GROUND COVER AND PERENNIAL AREAS.
- 12. RESPONSIBILITY FOR LANDSCAPE MAINTENANCE ON THE SITE SHALL LIE WITH THE LOT OWNER.
- 13. AN UNDERGROUND AUTOMATIC IRRIGATION SYSTEM IS TO BE DESIGNED AND CONSTRUCTED FOR ALL INSTALLED PLANT MATERIALS. GRASS AREAS SHALL BE SPRAY IRRIGATED, TREES SHALL BE IRRIGATED WITH A LOW FLOW BUBBLER SYSTEM, SHRUBS AND GROUND COVERS SHALL BE IRRIGATED WITH A DRIP EMITTER SYSTEM.
- 14. LOTS I AND 4-13 SHALL CONSTRUCT A SIX FOOT (6') HIGH FENCE CAPABLE OF SUPPORTING A CLIMBING VINE VEGETATIVE SCREENING AT THE TOP OF THE SLOPED AREA OF THE LOT ABUTTING EDITH BLVD. CLIMBING VINES SHALL BE PLANTED AT A SPACING WHICH WILL RESULT IN COMPLETE COVERAGE OF THE FENCE, AND SHALL BE SELECTED FROM THE FOLLOWING:

CAMPSIS RADICANS
LONICERA JAPONICA HALLIANA
LONICERA SEMPERVIRENS
PARTHENOCISSUS INSERTA
ROSA BANKSIAE

TRUMPET VINE
HALL'S HONEYSUCKLE
CORAL HONEYSUCKLE
WOODBINE
ROSE LADY BANKS

Fencing and landscaping along Edith Blvd. shall be maintained in perpetuity.

15. PLANTS AND TREES WHICH ARE PERMITTED INCLUDE ALL SPECIES ALLOWED BY THE CITY OF ALBUQUERQUE'S WATER CONSERVATION AND POLLEN ORDINANCES, AND MUST BE PLANTED IN ACCORDANCE WITH THE COMPREHENSIVE ZONING CODE'THE NORTH 1-25 SECTOR DEVELOPMENT PLAN, AND OTHER REGULATIONS CONTAINED IN THIS DOCUMENT.

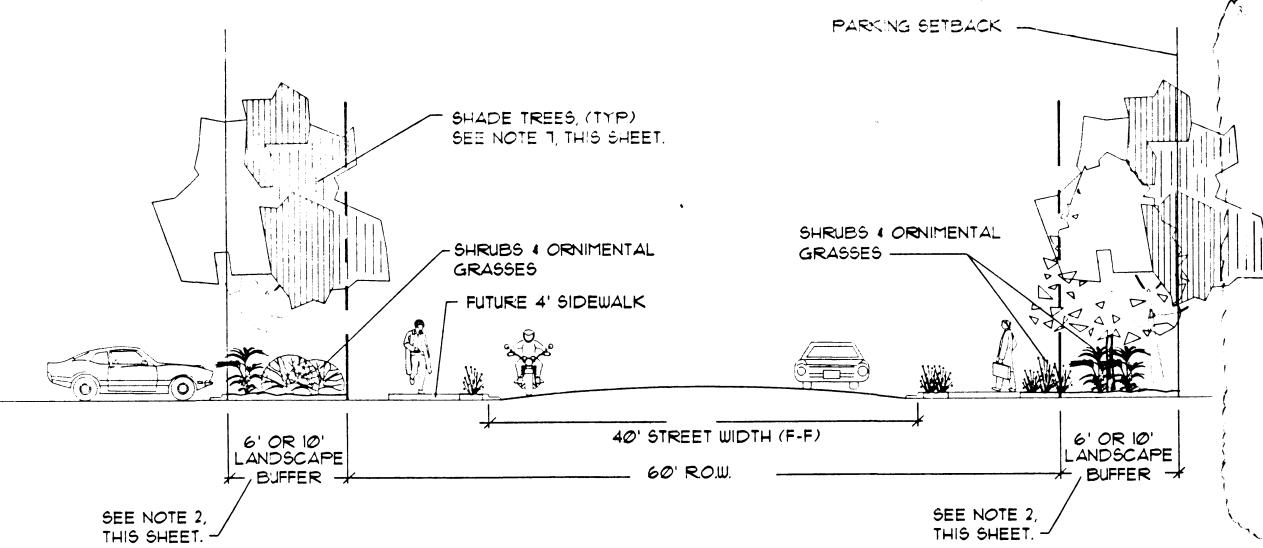

STREETSCAPE TYPICAL SECTION

## Site Signage

- Signage on each lot shall comply with the City of Albuquerque Comprehensive Zoning Code and the following:
- A. Lot developments shall be allowed the following:
- 1) A maximum of one building mounted sign per tenant.

  Total building mounted signage area per building shall not exceed 15% of the area of the facade.
- 2) A maximum of one site monument sign.
- 3) Building mounted signage area will not exceed 15% of the area of the facade on which it is mounted.
- 2. Projecting signs and roof signs are not allowed.

### Site Lighting

- I. In addition to lighting regulations in the Zoning Code, and the Alameda Design Overlay Zone, the following shall apply:
- A. Site lighting of parking lots, drives, plazas and entries will be provided to insure adequate lighting for both vehicular and pedestrian traffic after dark
- B. Site parking lot lighting fixtures will not exceed 24'-0" in height. For lots I and 4-13 on the side abutting Edith Blvd., site and building mounted lighting shall be no higher than sixteen feet (16') when located between the west side of the building and the top of the sloped area of the site. Pole mounted lighting shall be placed a minimum distance of thirty feet (30') from the top of the sloped area of the lot.
- C. Light fixtures for walkways and plazas will be located between 8'-0" and 16'-0" in height.
- D. All parking lot lighting will be high pressure sodium type fixtures.
- E. Site and exterior area lighting pole mounted fixtures will be of the "shoebox" type with full cut-off features to avoid lights from interfering with local or adjacent traffic and nearby residential development. Finish of poles and fixtures are to be consistent with the colors of the building.

F. The use of landscape and building exterior lighting is encouraged to accent building feature and highlight site and landscape areas.

Opaque exterior building materials used will be consistent with commonly used materials in Albuquerque, New Mexico. These include stucco, exterior finish and insulation system (EIFS) with synthetic stucco finishes, brick and stone masonry or veneer, concrete masonry with architectural exterior treatment, pre-cast architectural concrete, and metal paneling subject to the terms of the succeeding sentence. Smooth face concrete masonry, metal paneling, ceramic file veneer or reflective glass shall not be allowed. on the front façades for interior lots and on the front façade and the side façade facing the street for corner lots. The front façade building materials for metal buildings shall wrap around to the sides of the building for a depth of approximately twenty feet (20°). Metal building surfaces shall be natural environment and earth tone colors (tans, browns, sand, green, white) bright or garish colors will not be allowed. Other colors will be allowed as accent colors which would not comprise more than 10% of the building surfaces.

The rear facades of Lots 1 and 4-13, the south façade of the lot located north of the Drainage Pond and the north façade of the lot located south of the Drainage Pond may not be metal paneling, smooth face concrete masonry, or ceramic tile veneer, if visible from Edith Boulevard taking into consideration the landscaped fence to be constructed at the top of the slope, as determined by the approving official upon site plan review

### Architectural Design Criteria

#### l. General

DEVELOPMENT REQUIREMENTS

- A. Architectural Design Criteria are established to promote a visual and aesthetic consistency within the development and to avoid incompatible design schemes and elements harmful to the overall and individual developments.
- 2. Building Heights
- A. Structure height and width shall fall within a 45-degree angle drawn from the horizontal at the mean grade along each boundary of the premises, but a structure shall not exceed 120 feet, except as further defined in the Zoning Code, and clarified for specific lots as follows:

  For lots I and 4-13, structure placement is encouraged to be on the eastern side of the lot. In no case however, shall structure height on these lots exceed 26' and it's width and
- Opaque exterior building materials used will be consistent with commonly used materials in Albuquerque and New Mexico. These include stucco, exterior finish and insulation system (EIFS) with synthetic stucco finishes, brick and stone mesonry or veneer, concrete masonry with architectural extends reatment and pre-cast architectural concrete. Materials not allowed as

height shall fall within a 45 degree angle drawn from the

horizontal at the mean grade along the north, south, and east

the predominant sacades sinishes include a both sace concrete masonry, metal paneling, ceramic tile vendoor reflective glass.

Windows and storesronts are to have tinted glass and are to be in anodized aluminum or pre-finished total frames. Glass colors are to be compatible with the object color scheme of the building. Glass curtainwalls are limited to building entries and should not exceed 25% of the area of the building sacade of which they are part. Glass curtainwal may have reflective glass of a color compatible with other glass used in windows and storesronts. Glass installed in the westerly sacing sacades shall be of a type which reduces light reflectance. Mirrored glass and/or highly reflective glass shall not be installed in westerly sacing sacades.

Accent walls or accent elements introduced to the building design to give it detailing may utilize any of the allowable materials above as well as painted or pre-finished metal, stainless steel, ceramic tile veneer or colored concrets.

- 4. Building Colors of major facades are to be muted or pastel rather than bright or brilliant. The use of primary colors for major building walls is prohibited. Architectural accent walls, detached entry walls or colonnades or attached accent elements (entry canopies, window shading devices, medallions, window transoms) may be primary or bright colors.
- a perimeter parapet which at no point will be lower than any portion of the roof it surrounds. Pitched roofs are to be of either concrete tiles, clay tiles or pre-finished ribbed metal.

  Tile and metal roof colors are to be consistent with the building colors are not to have a highly reflective surface.

  Metal buildings having a pre-finished metal roof with a pitch of at least by to 12' shall not require a parapet. Metal roofs may not be bright, garish colors or reflective metal surfaces. Roofs may be tan, brown, sand, green, blue, non-reflective white and grey
- A. Mechanical equipment on roofs is to be screened from public view as much as practical. Roof equipment screens are to be at least as high as the highest part of the equipment. Roof screens are to be architecturally compatible with the building.
- Building mounted signage will conform to the zoning ordinance and the following:
- A. Dimensional height of any portion of the signs shall not exceed 3'-6".
- B. No portion of the sign shall protrude more than 6" from the building face on which it is mounted.
- 8. Direct lot access to Edith Blvd. and/or Alameda Blvd. is not permitted.

LANDSCAPING DEVELOPMENT REQUIREMENTS FOR ALAMEDA BUSINESS PARK

> ALBUQUERQUE, NEW MEXICO REVISED MARCH 3, 1999 REVISED JULY 2, 1999

> > **REVISED 7/12/00**

1/2/ec
America 8/4/99

Bohannan Huston

Courtyard One 7500 JEFFERSON NE Albuquerque NEW MEXICO 8710

SHEET 2 OF 2

NEERS PLANNERS PHOTOGRAMMETRISTS SURVEYORS SOFTWARE DEVELOPERS