

#### **KEYED NOTES**

- (1) UNDIRECTIONAL HC RAMP (SEE DETAIL SHEET C4)
- 2 HC PARKING PER ADA STANDARD WITH CURB STOPS & SIGNAGE (DETAIL PER SHEET C5)
- 3 6" CURB PER COA STD DWG 2415A

- (5) TRANSITION TO ZERO CURB
- 6 CONCRETE SIDEWALK, WIDTH AS SHOWN ON PLAN
- 7 DUMPSTER/TRASH COMPACTOR/ RECYCLE
- 9 EXISTING SIDEWALK, WIDTH VARIES
- 10 MONUMENT SIGN
- (1) EXISTING ACCESSIBLE RAMP
- (12) TAPERED HC RAMP (SEE DETAIL SHEET C5)
- (15) 6' WIDE PEDESTRIAN PATHWAY (STAMPED CONCRETE)
- (16) SAWCUT 291 LF
- (18) MOTORCYCLE SIGN (SEE DETAIL SHEET C5)
- 19 PEDESTRIAN CROSSING SIGN (SEE DETAIL SHEET C5)
- 20 CROSSWALK STRIPING (SEE DETAIL SHEET C5)

1. VEHICULAR ACCESS TO THE PROPERTY WILL BE FROM WITHIN THE HOME DEPOT DEVELOPMENT OVER EXISTING CROSS ACCESS EASEMENTS WITH NO CHANGES RESULTING TO THE EXISTING CIRCULATION OR PARKING SPACES ON THE HOME DEPOT LOT.

2. A PEDESTRIAN CONNECTION TO THE EXISTING PUBLIC SIDEWALK ON ALEXANDER BLVD IS PROPOSED TO BE ADA COMPLIANT. A CROSSWALK CONNECTION TO THE EXISTING PEDESTRIAN WALKWAY WITHIN THE HOME DEPOT LOT TO THE SOUTH IS ALSO PROPOSED.

#### NOTICE TO CONTRACTOR

1. NO CONSTRUCTION VEHICLES ALLOWED ACROSS HOME DEPOT'S FRONT DRIVE. DRIVE SHALL REMAIN OPEN AT ALL TIMES.

2. STAGING AND EQUIPMENT STORAGE AREAS SHALL BE CONFINED TO THE PROJECT BOUNDARY OF TRACT 2B-2. THE HOME DEPOT PARKING AREA SHALL BE KEPT CLEAR OF CONSTRUCTION EQUIPMENT.

SU-1 FOR C-2 USES

PROPOSED USAGE: DENTAL CLINIC

49,083 SF (1.1268) ACRE)

BUILDING AREA:

4,688 SF

5 SPACES (1 SPACE PER DOCTOR-1 DOCTOR) PARKING REQUIRED:

PARKING PROVIDED: 46 SPACES

HC PARKING PROVIDED: 2 SPACES

1 SPACE VAN ACCESSIBLE


MC PARKING REQUIRED: 2 SPACES

BICYCLE PARKING REQUIRED: 2 SPACES BICYCLE PARKING PROVIDED: 5 SPACES

LANDSCAPE AREA REQUIRED: 6,659 SF

INDEX TO DRAWINGS C1. SITE PLAN FOR BUILDING PERMIT C2. MASTER UTILITY PLAN C3. GRADING AND DRAINAGE PLAN C4. DETAIL SHEET C5. DETAIL SHEET

L1. LANDSCAPING PLAN ARCHITECTURAL ELEVATIONS A2. ARCHITECTURAL ELEVATIONS A3. ARCHITECTURAL SIGN DETAILS

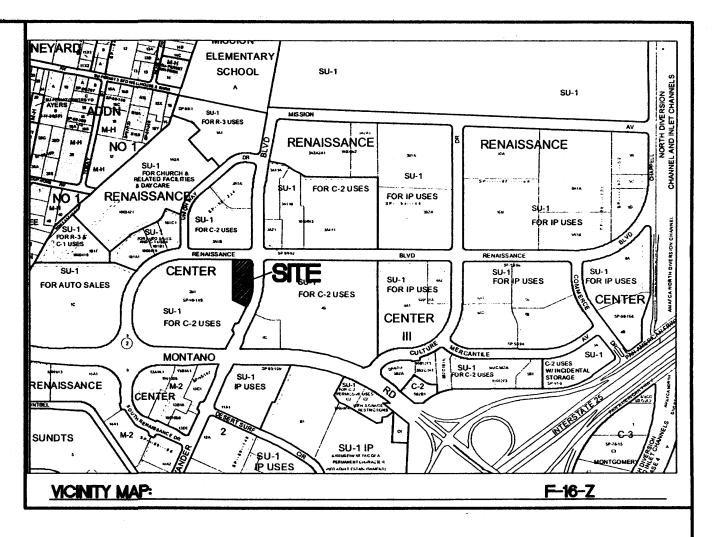

#### LEGAL DESCRIPTION


TRACT 2B-2 OF THE RENAISSANCE CENTER

**LEGEND** CURB & GUTTER **BOUNDARY LINE** EASEMENT CENTERLINE RIGHT-OF-WAY BUILDING SIDEWALK  $\Theta\Box$ STREET LIGHTS **EXISTING CURB & GUTTER EXISTING BOUNDARY LINE** EXISTING SIDEWALK EXISTING LANE **EXISTING STRIPING** 

---- SAWCUT

PROJECT NUMBER: 1000662	
APPLICATION NUMBER:	
This plan is consistent with the specific Site Development Plan app Environmental Planning Commission (EPC), dated, and t and Conditions in the Official Notification of Decision are satisfied.	roved by the the Findings
Is an Infrastructure List required? ( ) Yes ( ) No If Yes, of approved DRC plans with a work order is required for any construction. Public Right—of—Way or for construction of public improvements.	then a set on within
DAB SITE DEVELOPMENT PLAN SIGNOFF APPROVAL:	
	7-20-1/
Traffic Engineer, Transportation Division	)7-20-1/ Date
allantata	07 kolii
Water Utility Development	<b> Date</b>
Candoral	7/20/11
Parks & Recreation Department	Date
Center G. Chan	7
City Engineer /	7-20-11 Date
only anguinos.	Date
* Facing and about 11 and 12 a	
* Environmental Health Department (conditional)	Date
(Many 1)	12.12.11
Solid Waster Management	Date
God Chal	9-11-11
DBB Chairperson, Planning Department	Date
* Environmental Health, if necessary	

Environmental Health, if necessary		
ENGINEER'S SEAL	AFFORDABLE DENTURES 4821 ALEXANDER BLVD NE	<i>DRAWN BY</i> pm
		<i>DATE</i> 7–13–11
	SITE PLAN FOR BUILDING PERMIT	<i>DRAWING</i> 2011038-SPB.DWG
	TIERRA WEST, LLC  5571 MIDWAY PARK PL NE ALBUQUERQUE, NEW MEXICO 87109	SHEET #
RONALD R. BOHANNAN P.E. <b>#</b> 7868	(505) 858-3100 www.tierrawestllc.com	<i>JOB ∦</i> 2011038

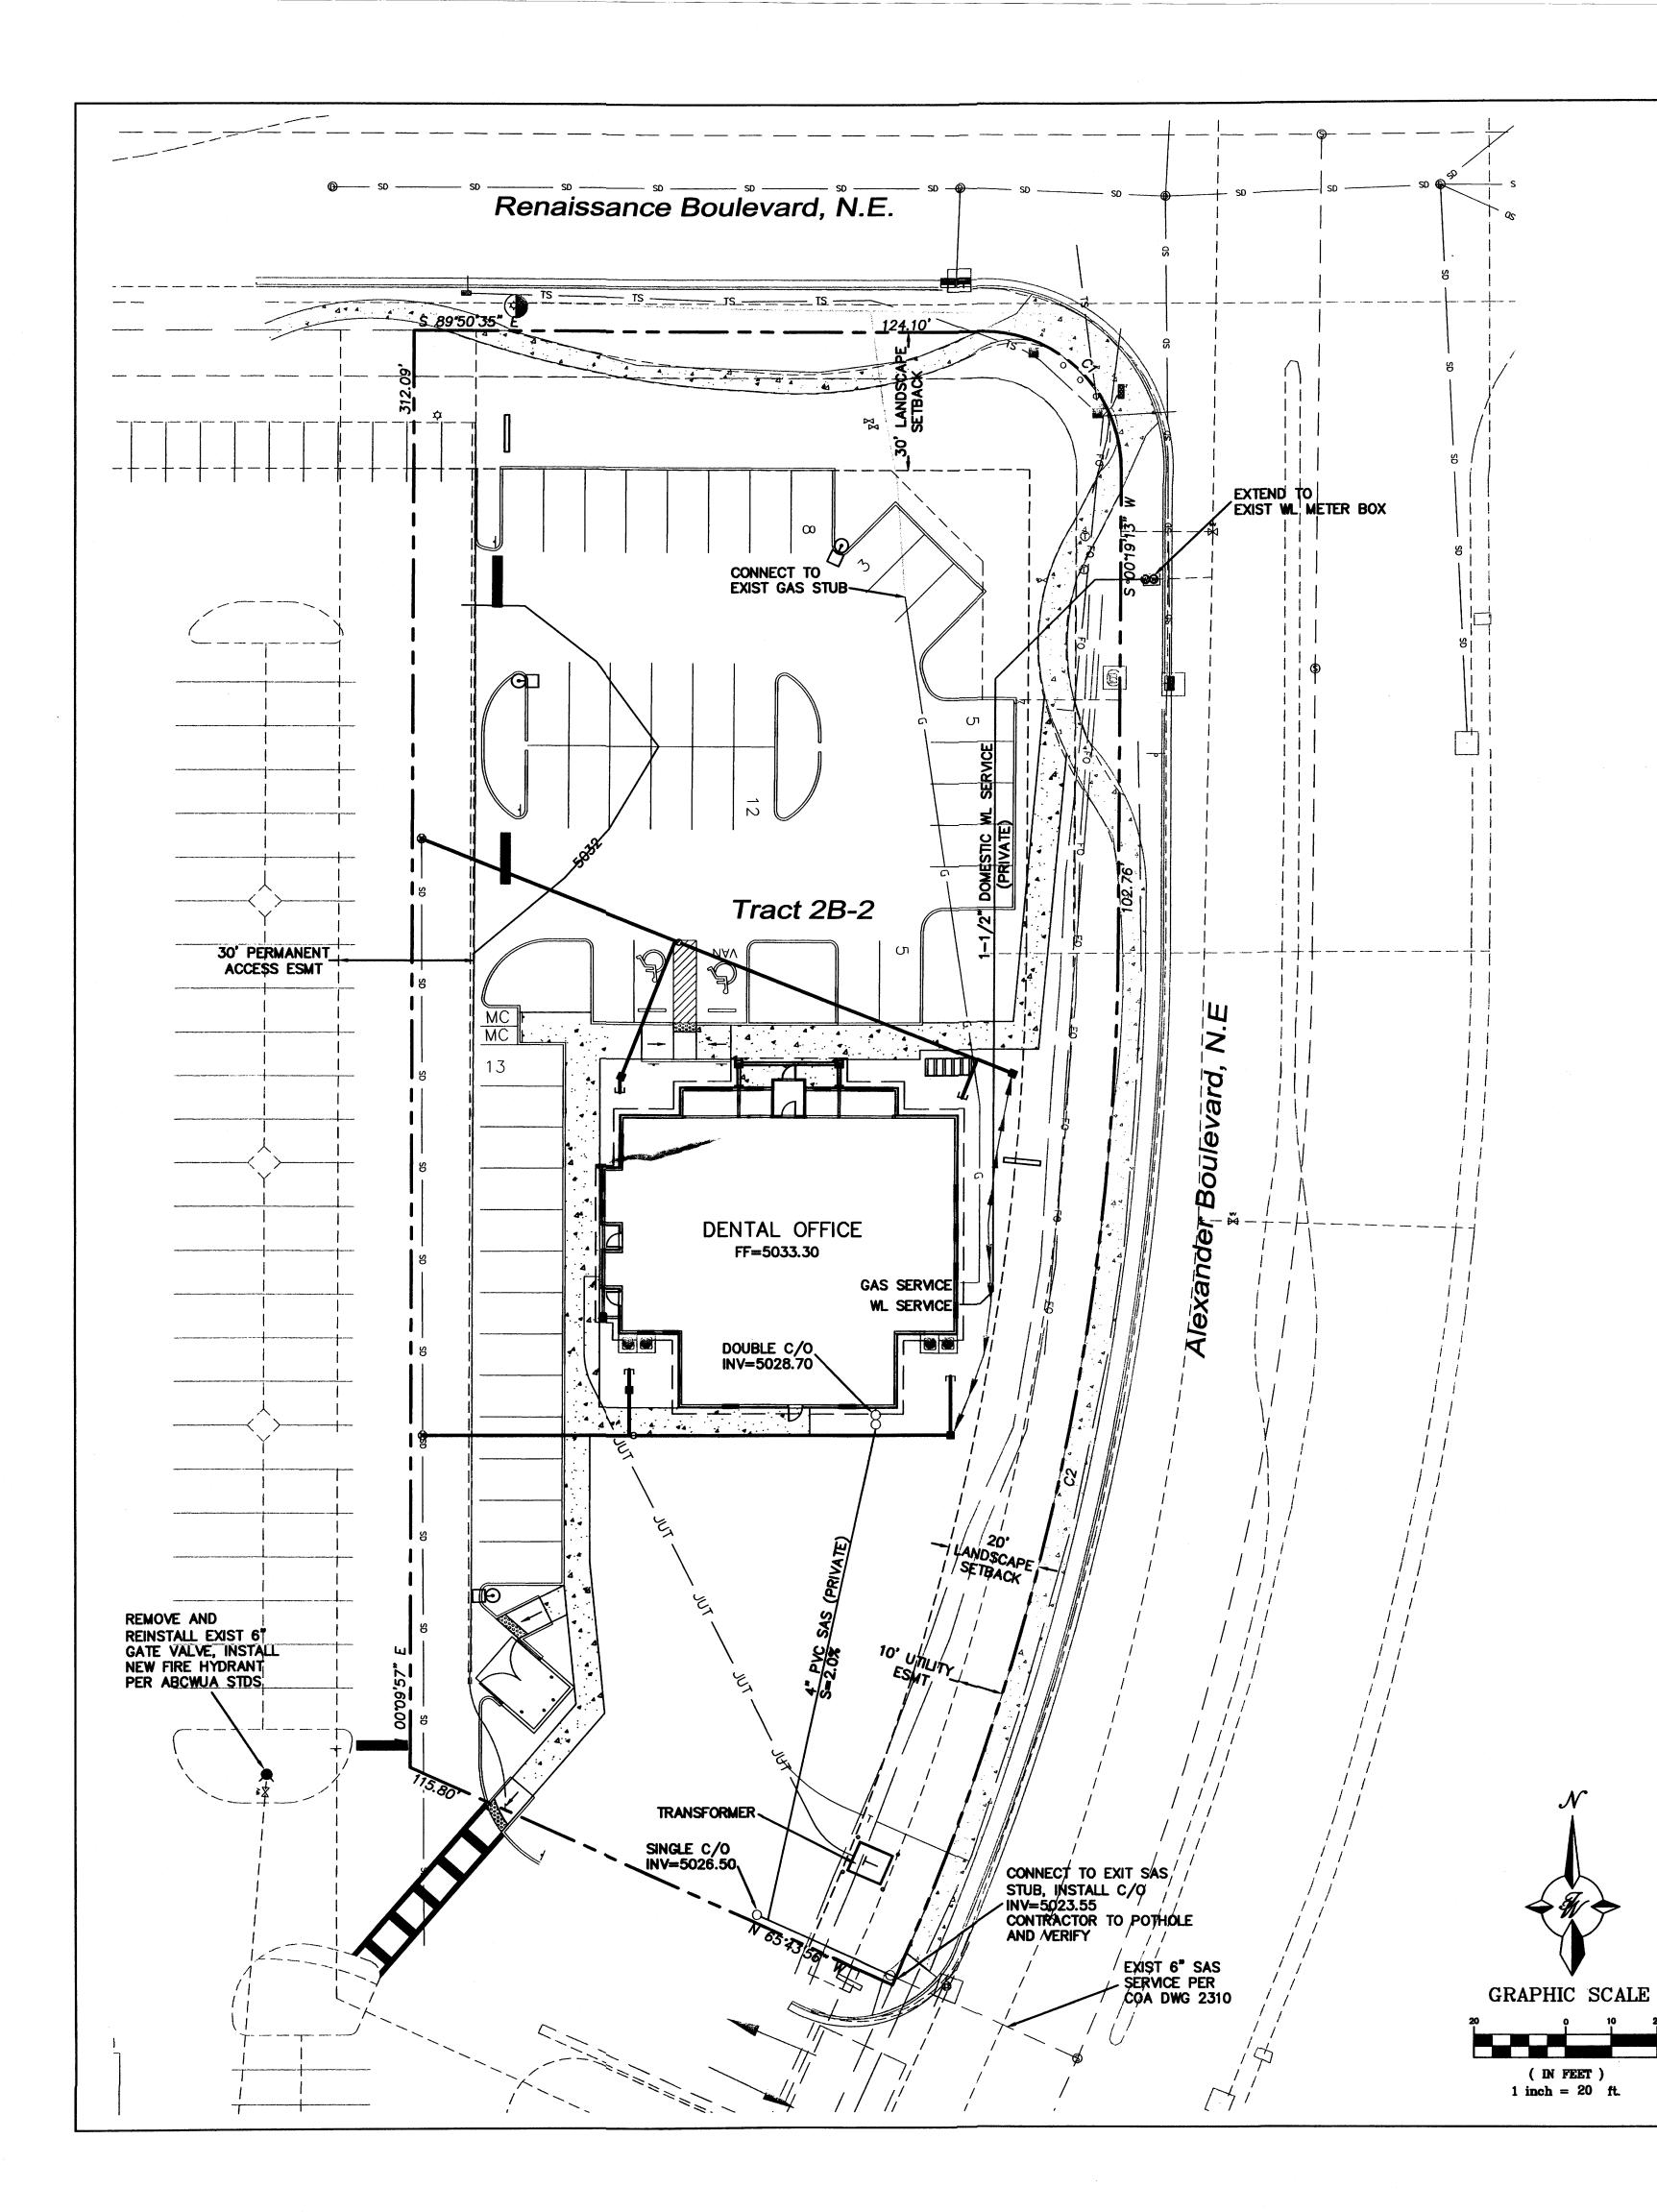

#### GENERAL UTILITY NOTES:

- 1. ALL WATER AND SEWER UTILITY WORK TO BE DONE IN ACCORDANCE WITH COA STANDARDS AND SPECIFICATIONS LATEST EDITION.
- 2. 4' MINIMUM BURY REQUIRED FOR ALL UTILITIES UNLESS OTHERWISE NOTED.
- 3. REFERENCE ARCHITECTURAL PLANS FOR WATER LINE RISER LOCATIONS.
- 4. CLEAN OUTS ARE TO BE BUILT PER UNIFORM PLUMBING CODE STANDARDS.
- 5. ALL PLUMBING PIPE MATERIAL TO BE USED PER UPC.
- 6. FIRE LINE AND DOMESTIC WATERLINE MUST HAVE BACKFLOW PREVENTORS PER UPC. IF BACKFLOW PREVENTOR IS INSTALLED EXTERIOR OF BUILDING A HOT BOX SHALL BE INSTALLED AND USED.
- 7. ALL EX. SD INLETS AND MH SHALL HAVE CONCRETE COLLARS POURED AND BE ADJUSTED TO FINISHED GRADE.
- 8. ALL EXCAVATION, TRENCHING AND SHORING ACTIMITIES MUST BE CARRIED-OUT IN ACCORDANCE WITH OSHA 29 CFR 1926.650 SUBPART P.
- 9. ALL UTILITY DISTANCES SHOWN ARE FOR REFERENCE ONLY.
- 10. PNM HAS NUMEROUS ELECTRIC FACILITIES AT THIS SITE CURRENTLY SERVING EXISTING CUSTOMERS. THE APPLICANT SHALL COORDINATE WITH PNM REGARDING THESE EXISTING FACILITIES. ANY RELOCATION, CHANGES OR REALIGNMENT OF EXISTING ELECTRIC UTILITIES WILL BE THE DEVELOPER EXPENSE. IN SOME CASES, RELOCATION OR CHANGES TO EXISTING FACILITIES MAY NOT BE FEASIBLE DUE TO PHYSICAL, USE OR SAFETY CLEARANCE CONSTRAINTS.
- 11. PNM WILL REVIEW ALL TECHNICAL NEEDS, ISSUES AND SAFETY CLEARANCES FOR ITS ELECTRIC POWER SYSTEMS. ANY EXISTING AND PROPOSED PUBLIC UTILITY EASEMENTS SHALL BE INDICATED ON THE SITE PLAN UTILITY SHEET PRIOR TO DRB REVIEW. PNM'S STANDARD FOR PUBLIC UTILITY EASEMENTS IS 10 FEET IN WIDTH TO ENSURE ADEQUATE, SAFE CLEARANCES.
- 12. SCREENING SHALL BE DESIGNED TO ALLOW FOR ACCESS TO UTILITY FACILITIES. IT IS NECESSARY TO PROVIDE ADEQUATE CLEARANCE OF TEN FEET SURROUNDING ALL GROUND-MOUNTED UTILITIES FOR SAFE OPERATION, MAINTENANCE AND REPAIR PURPOSES.


### LEGEND


CURB & GUTTER  BOUNDARY LINE  EASEMENT  CENTERLINE  RIGHT—OF—WAY  BUILDING  SIDEWALK  EXISTING CURB & GUTTER  S' SAS——SANITARY SEWER LINE  WATERLINE  SINGLE CLEAN OUT  DOUBLE CLEAN OUT  EXISTING SD MANHOLE  EXISTING INLET  EXISTING FIRE HYDRANT  EXISTING FIRE HYDRANT  EXISTING WATER METER  EXISTING GAS VALVE  EXISTING OVERHEAD UTILITIES  EXISTING OVERHEAD UTILITIES  EXISTING OVERHEAD UTILITIES  EXISTING GAS  EXISTING GAS  EXISTING GAS  EXISTING SANITARY SEWER LINE  EXISTING SANITARY SEWER LINE  EXISTING WATER LINE  EXISTING WATER LINE  EXISTING WATER LINE  EXISTING STORM SEWER LINE  PROPOSED TELEPHONE LINE  PROPOSED POWER		
EASEMENT  CENTERLINE  RIGHT—OF—WAY  BUILDING  SIDEWALK  EXISTING CURB & GUTTER  8" SAS SANITARY SEWER LINE  WATERLINE  SINGLE CLEAN OUT  DOUBLE CLEAN OUT  EXISTING SD MANHOLE  EXISTING INLET  EXISTING FIRE HYDRANT  EXISTING FIRE HYDRANT  EXISTING WATER METER  EXISTING GAS VALVE  EXISTING GAS VALVE  EXISTING OVERHEAD UTILITIES  EXISTING GAS  EXISTING SANITARY SEWER LINE  EXISTING WATER LINE  EXISTING STORM SEWER LINE  PROPOSED TELEPHONE LINE		CURB & GUTTER
CENTERLINE  RIGHT—OF—WAY  BUILDING  SIDEWALK  EXISTING CURB & GUTTER  SANITARY SEWER LINE  WATERLINE  SINGLE CLEAN OUT  DOUBLE CLEAN OUT  EXISTING SD MANHOLE  EXISTING INLET  EXISTING FIRE HYDRANT  EXISTING WATER METER  EXISTING POWER POLE  EXISTING GAS VALVE  EXISTING OVERHEAD UTILITIES  EXISTING UNDERGROUND UTILITIES  EXISTING GAS  EX		BOUNDARY LINE
BUILDING  BUILDING  SIDEWALK  EXISTING CURB & GUTTER  SANITARY SEWER LINE  WATERLINE  SINGLE CLEAN OUT  DOUBLE CLEAN OUT  EXISTING SD MANHOLE  EXISTING INLET  EXISTING FIRE HYDRANT  EXISTING FIRE HYDRANT  EXISTING WATER METER  EXISTING POWER POLE  EXISTING OVERHEAD UTILITIES  EXISTING UNDERGROUND UTILITIES  EXISTING GAS  EXISTING GAS  EXISTING GAS  EXISTING GAS  EXISTING SANITARY SEWER LINE  EXISTING WATER LINE  EXISTING WATER LINE  EXISTING WATER LINE  EXISTING STORM SEWER LINE  EXISTING STORM SEWER LINE  PROPOSED TELEPHONE LINE		EASEMENT
BUILDING  SIDEWALK  EXISTING CURB & GUTTER  SANITARY SEWER LINE  WATERLINE  SINGLE CLEAN OUT  DOUBLE CLEAN OUT  EXISTING SD MANHOLE  EXISTING INLET  EXISTING FIRE HYDRANT  EXISTING FIRE HYDRANT  EXISTING WATER METER  EXISTING POWER POLE  EXISTING GAS VALVE  EXISTING OVERHEAD UTILITIES  EXISTING UNDERGROUND UTILITIES  EXISTING GAS  EXISTING SANITARY SEWER LINE  EXISTING WATER LINE  EXISTING WATER LINE  EXISTING WATER LINE  EXISTING WATER LINE  EXISTING STORM SEWER LINE  PROPOSED TELEPHONE LINE		CENTERLINE
SIDEWALK  EXISTING CURB & GUTTER  SAS SANITARY SEWER LINE  WATERLINE  SINGLE CLEAN OUT  DOUBLE CLEAN OUT  EXISTING SD MANHOLE  EXISTING INLET  EXISTING FIRE HYDRANT  EXISTING WATER METER  EXISTING POWER POLE  EXISTING GAS VALVE  EXISTING OVERHEAD UTILITIES  EXISTING UNDERGROUND UTILITIES  EXISTING GAS  EXISTING GAS  EXISTING GAS  EXISTING SANITARY SEWER LINE  EXISTING WATER LINE  EXISTING WATER LINE  EXISTING STORM SEWER LINE  PROPOSED TELEPHONE LINE		RIGHT-OF-WAY
EXISTING CURB & GUTTER  SANITARY SEWER LINE  WATERLINE  SINGLE CLEAN OUT  DOUBLE CLEAN OUT  EXISTING SD MANHOLE  EXISTING INLET  EXISTING SAS MANHOLE  EXISTING FIRE HYDRANT  EXISTING WATER METER  EXISTING POWER POLE  EXISTING GAS VALVE  EXISTING OVERHEAD UTILITIES  EXISTING UNDERGROUND UTILITIES  EXISTING GAS  EXISTING GAS  EXISTING GAS  EXISTING SANITARY SEWER LINE  EXISTING WATER LINE  EXISTING WATER LINE  EXISTING STORM SEWER LINE  EXISTING STORM SEWER LINE  PROPOSED TELEPHONE LINE		BUILDING
SASSONITARY SEWER LINE  WATERLINE  SINGLE CLEAN OUT  DOUBLE CLEAN OUT  EXISTING SD MANHOLE  EXISTING INLET  EXISTING FIRE HYDRANT  EXISTING FIRE HYDRANT  EXISTING WATER METER  EXISTING POWER POLE  EXISTING OVERHEAD UTILITIES  EXISTING OVERHEAD UTILITIES  EXISTING GAS  EXISTING GAS  EXISTING GAS  EXISTING GAS  EXISTING SANITARY SEWER LINE  EXISTING WATER LINE  EXISTING WATER LINE  EXISTING STORM SEWER LINE  EXISTING STORM SEWER LINE  PROPOSED TELEPHONE LINE		SIDEWALK
SINGLE CLEAN OUT  DOUBLE CLEAN OUT  EXISTING SD MANHOLE  EXISTING INLET  EXISTING SAS MANHOLE  EXISTING FIRE HYDRANT  EXISTING WATER METER  EXISTING POWER POLE  EXISTING GAS VALVE  EXISTING OVERHEAD UTILITIES  EXISTING UNDERGROUND UTILITIES  EXISTING GAS  EXISTING GAS  EXISTING SANITARY SEWER LINE  EXISTING WATER LINE  EXISTING STORM SEWER LINE  PROPOSED TELEPHONE LINE	MATRICE MATRICE MATRICE MATRICE	EXISTING CURB & GUTTER
DOUBLE CLEAN OUT  EXISTING SD MANHOLE  EXISTING INLET  EXISTING SAS MANHOLE  EXISTING FIRE HYDRANT  EXISTING WATER METER  EXISTING POWER POLE  EXISTING GAS VALVE  EXISTING OVERHEAD UTILITIES  EXISTING UNDERGROUND UTILITIES  EXISTING GAS  EXISTING GAS  EXISTING GAS  EXISTING GAS  EXISTING WATER LINE  EXISTING WATER LINE  EXISTING STORM SEWER LINE  PROPOSED TELEPHONE LINE	8* SAS	SANITARY SEWER LINE
EXISTING SD MANHOLE  EXISTING INLET  EXISTING SAS MANHOLE  EXISTING SAS MANHOLE  EXISTING FIRE HYDRANT  EXISTING WATER METER  EXISTING POWER POLE  EXISTING GAS VALVE  EXISTING OVERHEAD UTILITIES  EXISTING UNDERGROUND UTILITIES  EXISTING GAS  EXISTING GAS  EXISTING GAS  EXISTING SANITARY SEWER LINE  EXISTING WATER LINE  EXISTING STORM SEWER LINE  PROPOSED TELEPHONE LINE	8" WL	WATERLINE
EXISTING SD MANHOLE  EXISTING INLET  EXISTING SAS MANHOLE  EXISTING FIRE HYDRANT  EXISTING WATER METER  EXISTING POWER POLE  EXISTING GAS VALVE  EXISTING OVERHEAD UTILITIES  EXISTING UNDERGROUND UTILITIES  EXISTING GAS  EXISTING GAS  EXISTING SANITARY SEWER LINE  EXISTING WATER LINE  EXISTING STORM SEWER LINE  PROPOSED TELEPHONE LINE	•	SINGLE CLEAN OUT
EXISTING INLET  S EXISTING SAS MANHOLE EXISTING FIRE HYDRANT EXISTING WATER METER EXISTING POWER POLE EXISTING GAS VALVE EXISTING OVERHEAD UTILITIES EXISTING UNDERGROUND UTILITIES EXISTING GAS EXISTING GAS EXISTING SANITARY SEWER LINE EXISTING WATER LINE EXISTING WATER LINE EXISTING STORM SEWER LINE PROPOSED TELEPHONE LINE	<b>©</b>	DOUBLE CLEAN OUT
EXISTING SAS MANHOLE  EXISTING FIRE HYDRANT  EXISTING WATER METER  EXISTING POWER POLE  EXISTING GAS VALVE  EXISTING OVERHEAD UTILITIES  EXISTING UNDERGROUND UTILITIES  EXISTING GAS  EXISTING GAS  EXISTING GAS  EXISTING GAS  EXISTING SANITARY SEWER LINE  EXISTING WATER LINE  EXISTING STORM SEWER LINE  PROPOSED TELEPHONE LINE	0	EXISTING SD MANHOLE
EXISTING FIRE HYDRANT  EXISTING WATER METER  EXISTING POWER POLE  EXISTING GAS VALVE  EXISTING OVERHEAD UTILITIES  EXISTING UNDERGROUND UTILITIES  EXISTING GAS  EXISTING GAS  EXISTING GAS  EXISTING GAS  EXISTING SANITARY SEWER LINE  EXISTING WATER LINE  EXISTING STORM SEWER LINE  PROPOSED TELEPHONE LINE		EXISTING INLET
EXISTING FIRE HYDRANT  EXISTING WATER METER  EXISTING POWER POLE  EXISTING GAS VALVE  EXISTING OVERHEAD UTILITIES  EXISTING UNDERGROUND UTILITIES  EXISTING GAS  EXISTING GAS  EXISTING GAS  EXISTING GAS  EXISTING SANITARY SEWER LINE  EXISTING WATER LINE  EXISTING STORM SEWER LINE  PROPOSED TELEPHONE LINE	S	EXISTING SAS MANHOLE
EXISTING WATER METER  EXISTING POWER POLE  EXISTING GAS VALVE  EXISTING OVERHEAD UTILITIES  EXISTING UNDERGROUND UTILITIES  EXISTING GAS  EXISTING GAS  EXISTING GAS  EXISTING GAS  EXISTING SANITARY SEWER LINE  EXISTING WATER LINE  EXISTING STORM SEWER LINE  PROPOSED TELEPHONE LINE		EXISTING FIRE HYDRANT
EXISTING GAS VALVE  EXISTING OVERHEAD UTILITIES  EXISTING UNDERGROUND UTILITIES  EXISTING GAS  EXISTING GAS  EXISTING SANITARY SEWER LINE  EXISTING WATER LINE  EXISTING STORM SEWER LINE  PROPOSED TELEPHONE LINE		EXISTING WATER METER
EXISTING OVERHEAD UTILITIES	<b>t</b> io	EXISTING POWER POLE
EXISTING UNDERGROUND UTILITIES	<i>હે</i> '	EXISTING GAS VALVE
EXISTING GAS  EXISTING GAS  EXISTING SANITARY SEWER LINE  EXISTING WATER LINE  EXISTING STORM SEWER LINE  PROPOSED TELEPHONE LINE	OHE	EXISTING OVERHEAD UTILITIES
EX. 8" SAS	— — — EX. UOE — — —	EXISTING UNDERGROUND UTILITIES
EX. WL EXISTING WATER LINE	EX. 2" GAS	EXISTING GAS
	EX. 8" SAS	EXISTING SANITARY SEWER LINE
PROPOSED TELEPHONE LINE	EX. WL	EXISTING WATER LINE
	— — EX. RCP— —	EXISTING STORM SEWER LINE
PROPOSED POWER		PROPOSED TELEPHONE LINE
	JUT	PROPOSED POWER


#### CAUTION


ALL EXISTING UTILITIES SHOWN WERE OBTAINED FROM RESEARCH, AS—BUILTS, SURVEYS OR INFORMATION PROVIDED BY OTHERS. IT SHALL BE THE SOLE RESPONSIBILITY OF THE CONTRACTOR TO CONDUCT ALL NECESSARY FIELD INVESTIGATIONS PRIOR TO AND INCLUDING ANY EXCAVATION, TO DETERMINE THE ACTUAL LOCATION OF UTILITIES AND OTHER IMPROVEMENTS, PRIOR TO STARTING THE WORK. ANY CHANGES FROM THIS PLAN SHALL BE COORDINATED WITH AND APPROVED BY THE ENGINEER.


ENGINEER'S SEAL	AFFORDABLE DENTURES 4821 ALEXANDER BLVD NE	<i>DRAWN BY</i> pm
	MASTER UTILITY	<i>DATE</i> 5–13–11
	PLAN	SHEET #
	TIERRA WEST, LLC  5571 MIDWAY PARK PL NE ALBUQUERQUE, NEW MEXICO 87109	C2
RONALD R. BOHANNAN P.E. <b>#</b> 7868	(505) 858-3100 www.tierrawestllc.com	<i>JOB ∦</i> 2011038

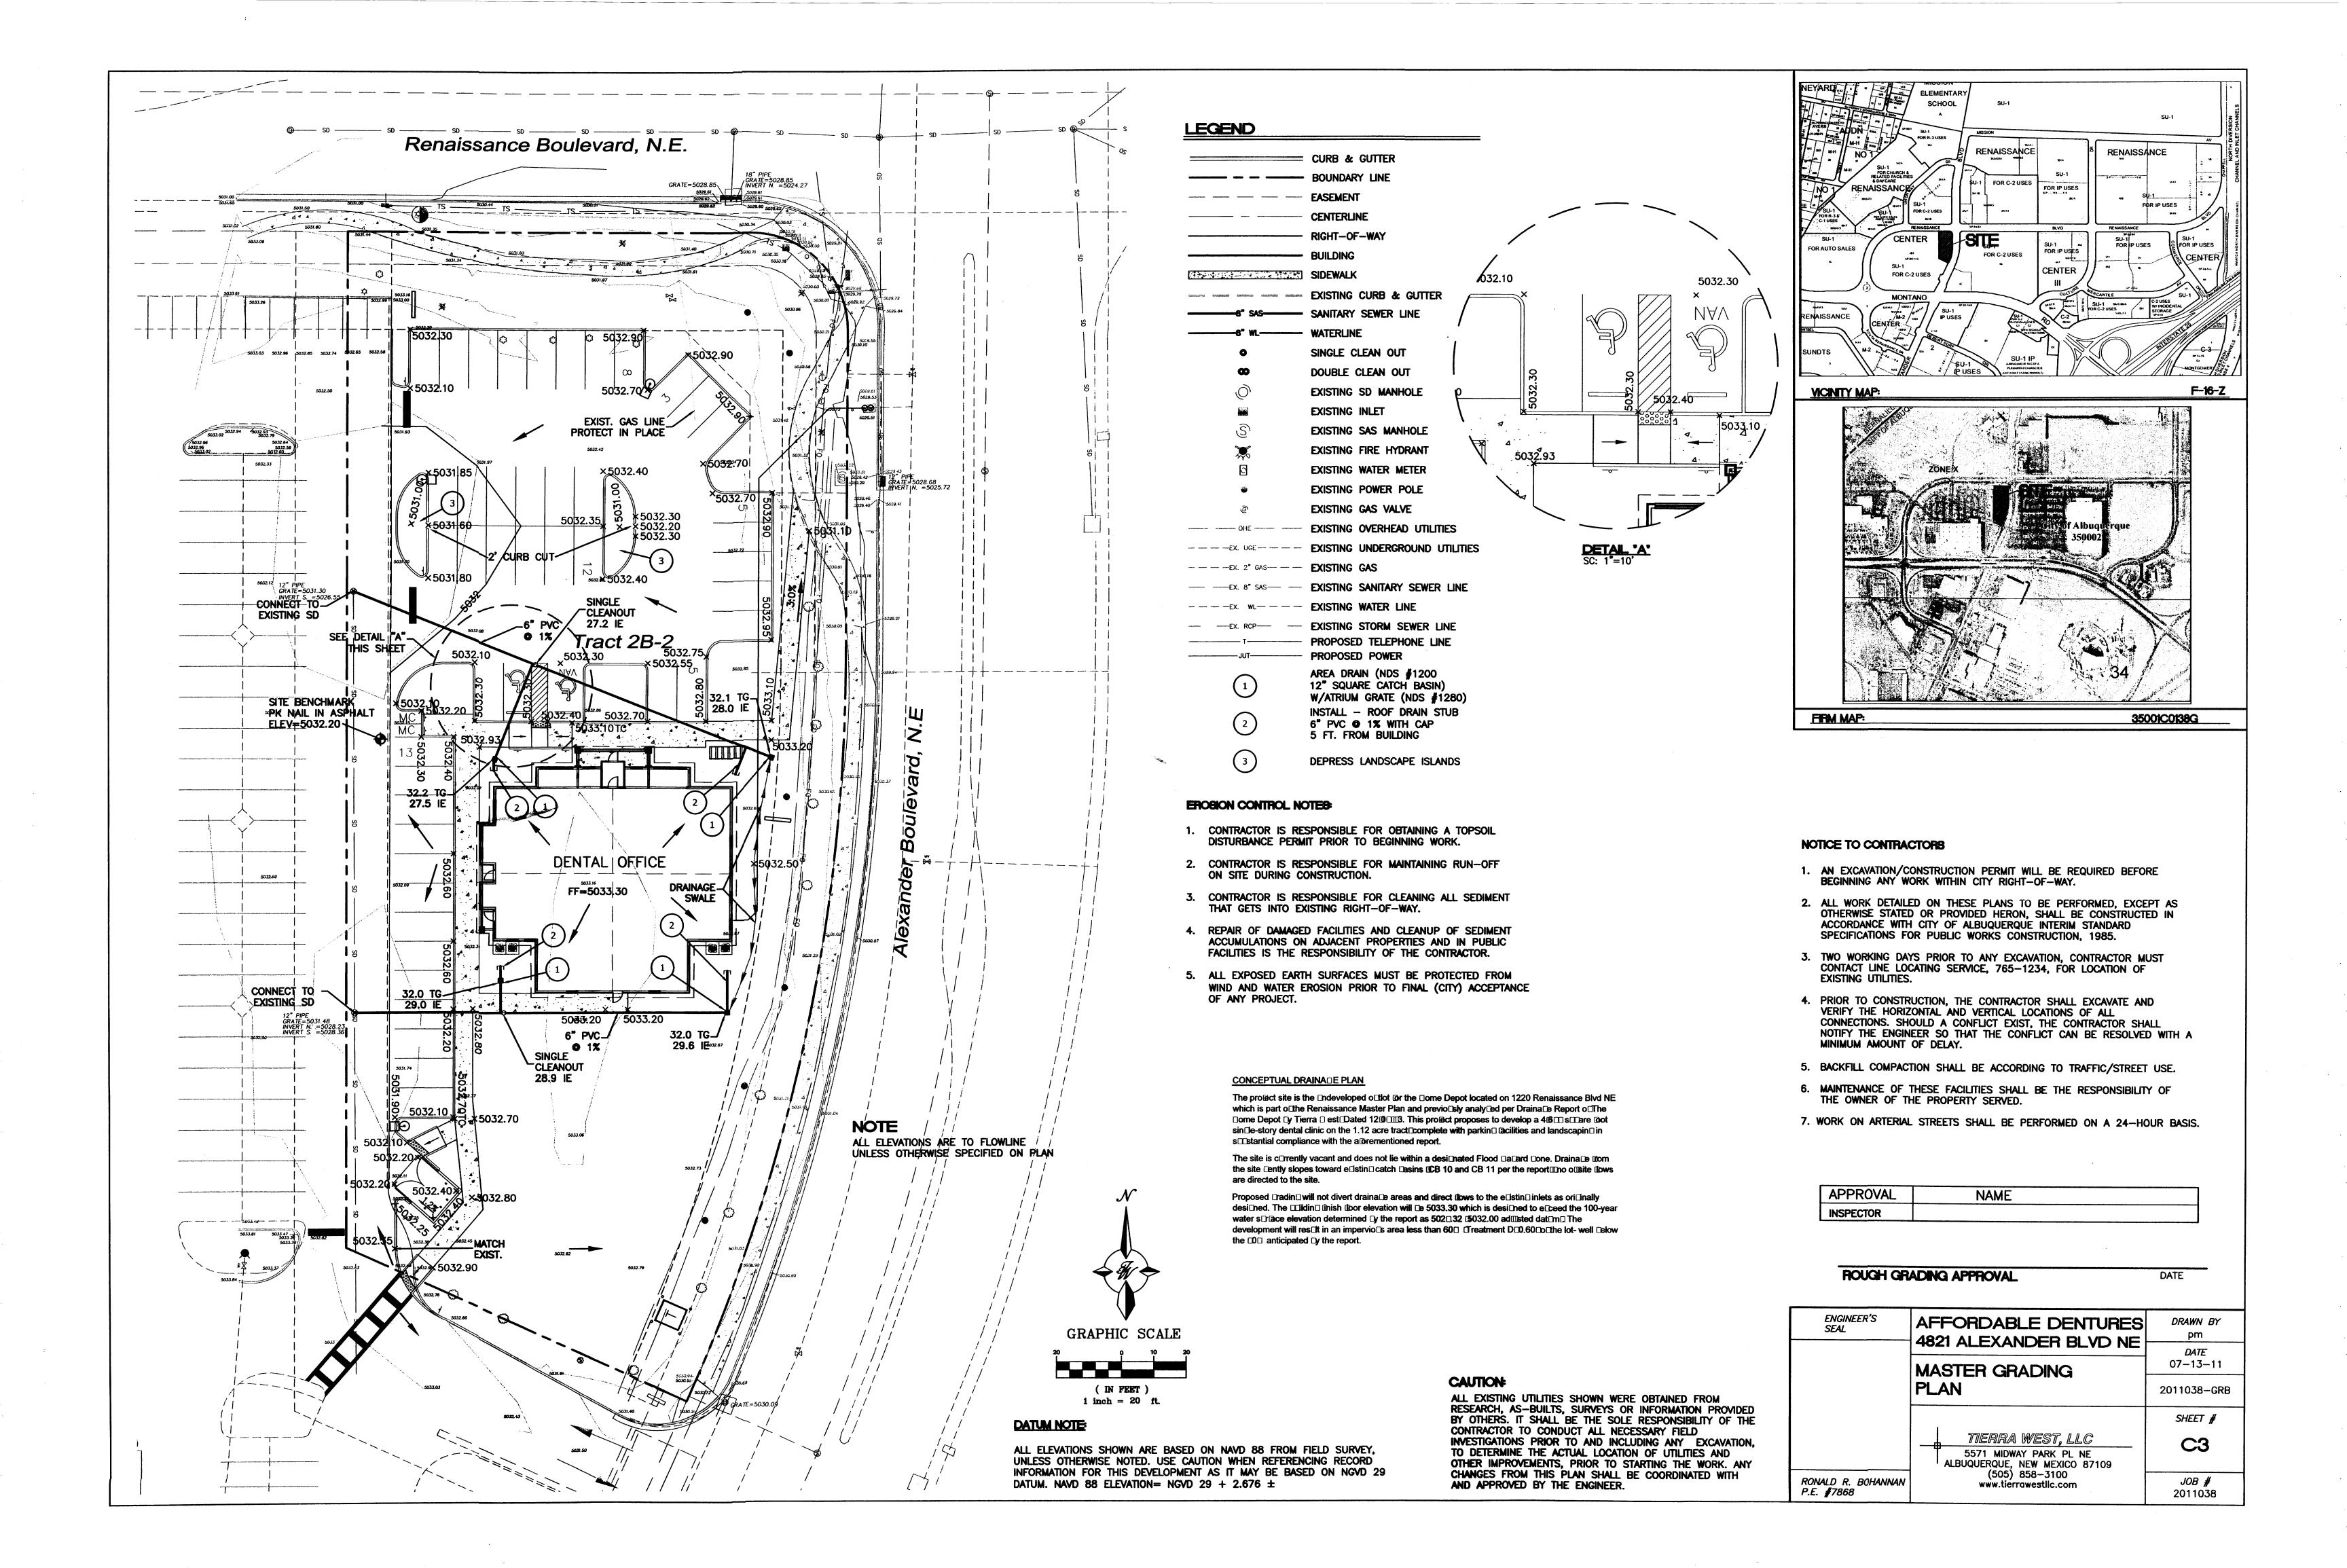

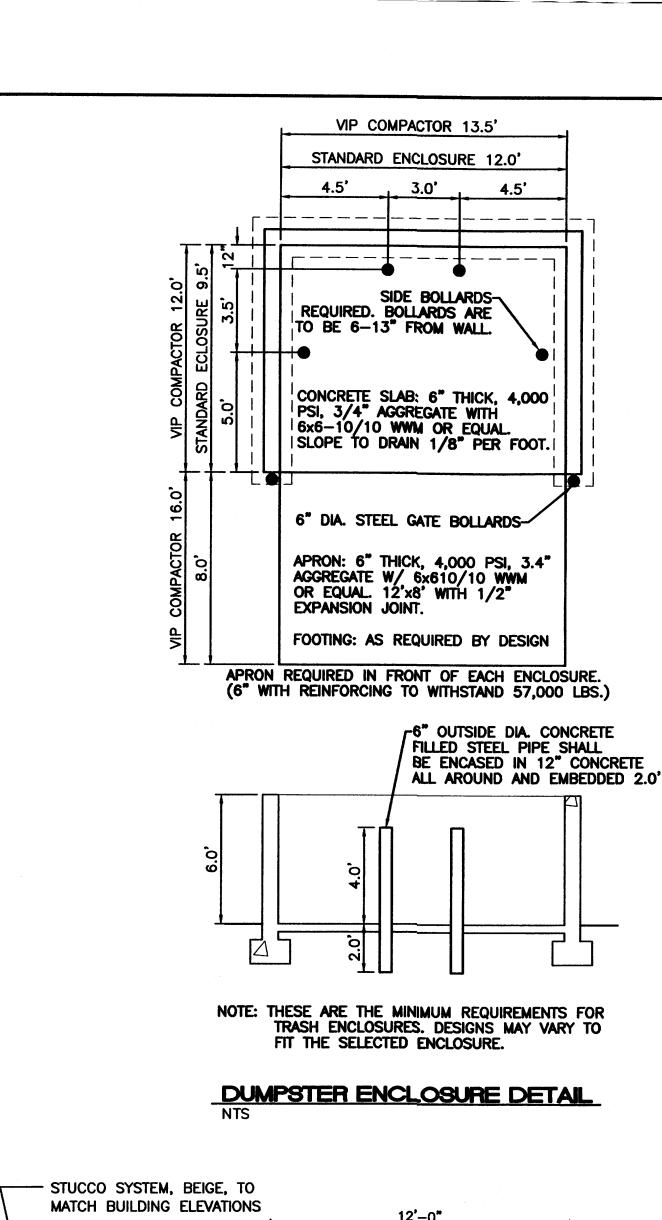


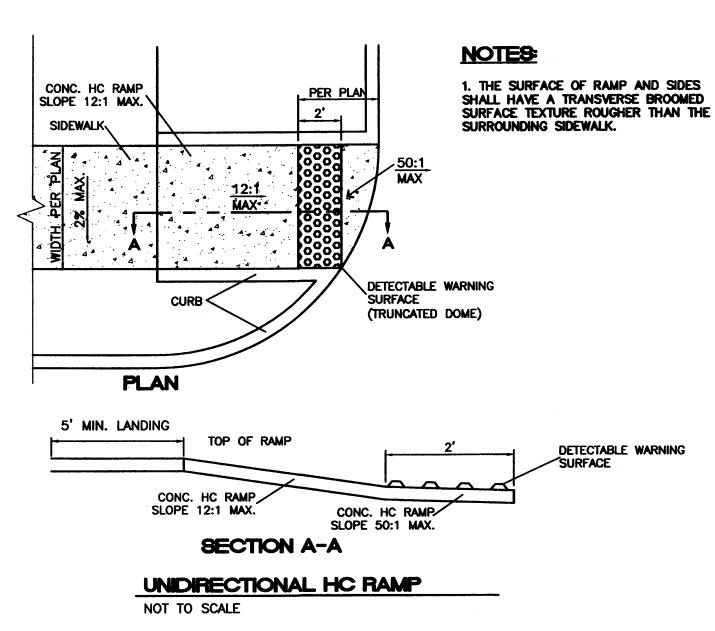

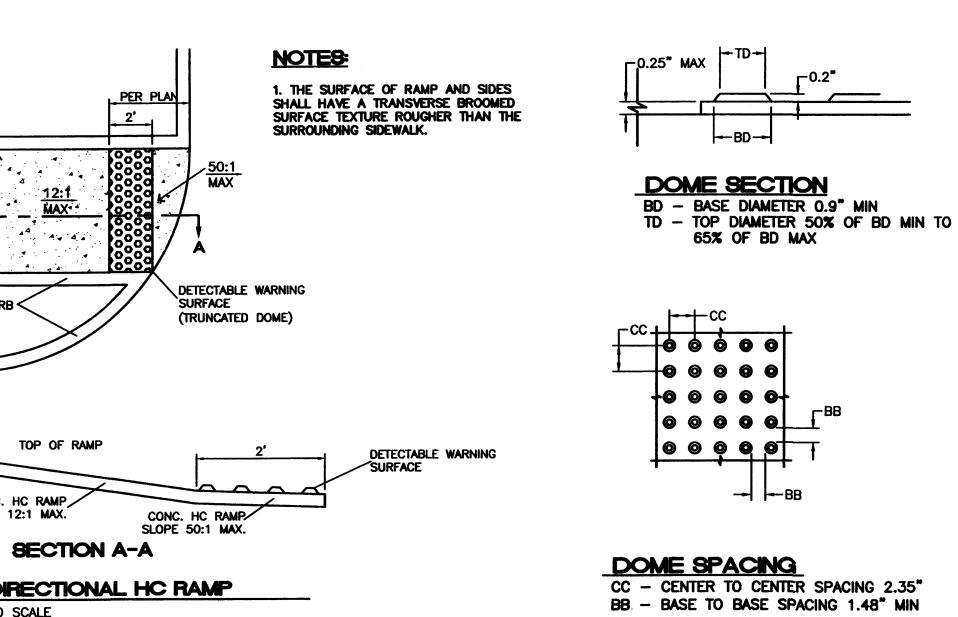


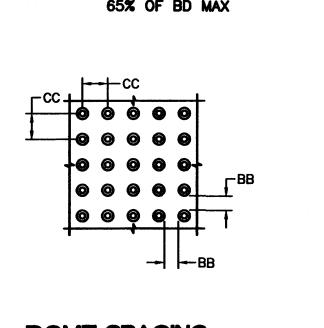




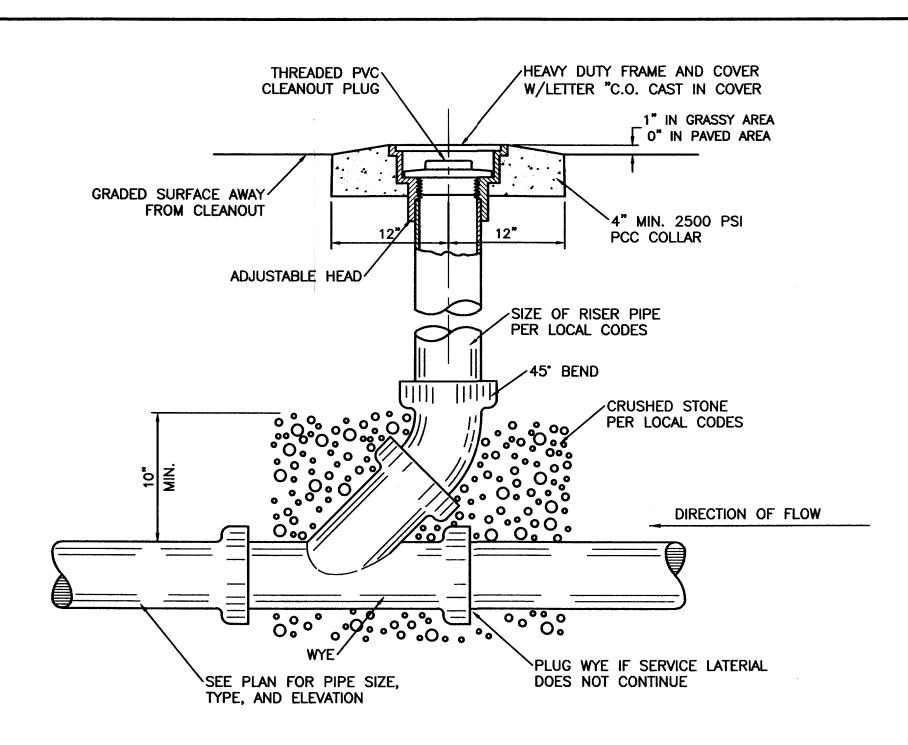


# SANITARY SEWER CLEAN-OUT

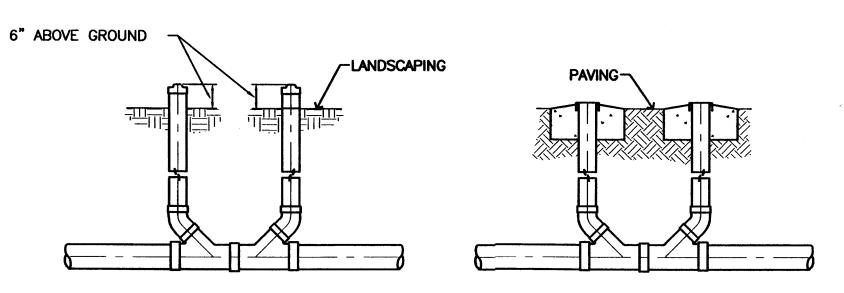


# O.D. 12"MIN 12"MIN.

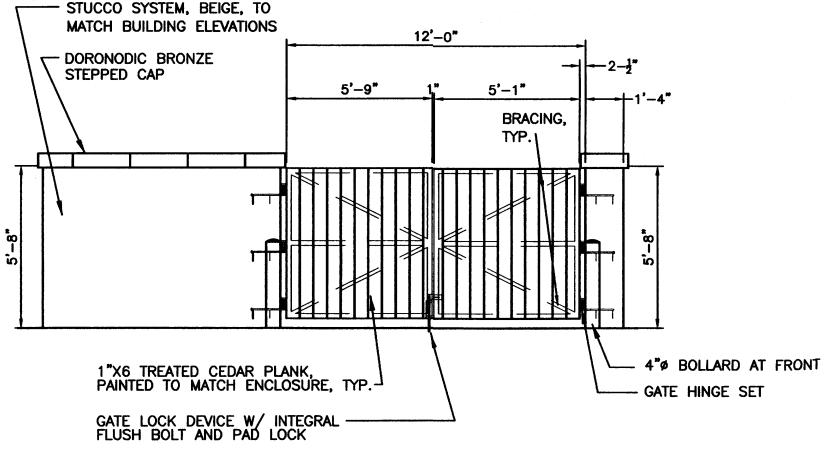



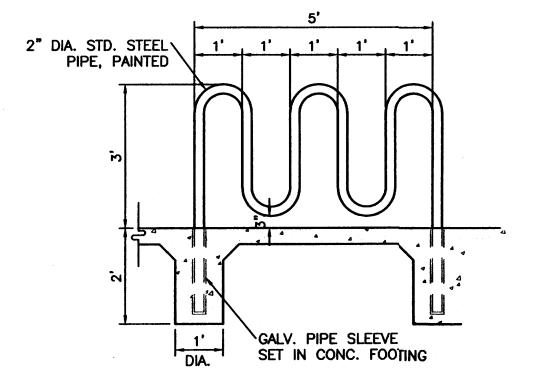

**BIKE RACK DETAIL** SCALE: 1/2"=1'-0"

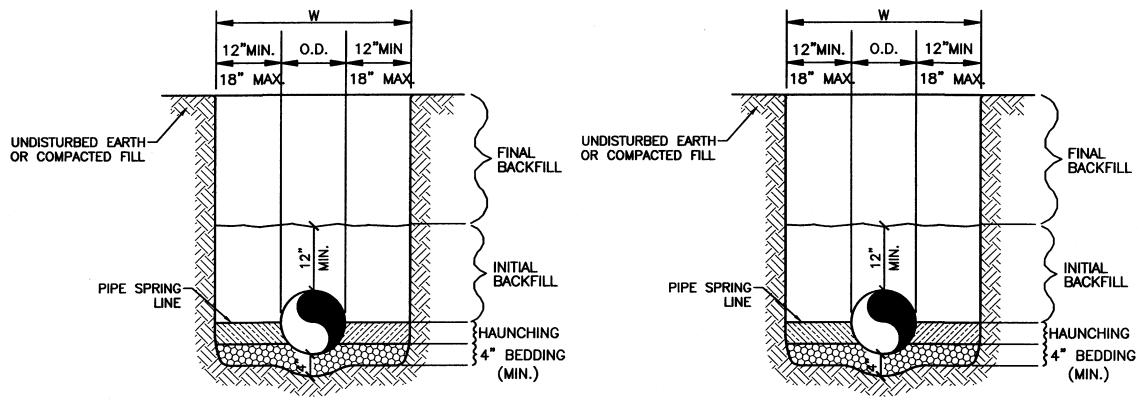

UTILITY TRENCH AND BEDDING DETAIL

#### WATER LINE

#### **GENERAL NOTES**


- BEDDING SHALL BE CLASS I—A WORKED BY HAND. IF GROUNDWATER IS ANTICIPATED, THEN BEDDING SHALL BE CLASS I-B COMPACTED TO 85% STANDARD PROCTOR. (SEE SPECIFICATIONS FOR GRADATION)
- HAUNCHING SHALL BE WORKED AROUND THE PIPE BY HAND TO ELIMINATE VOIDS AND SHALL BE CLASS I-A OR CLASS I-B OR CLASS II COMPACTED TO 85% PROCTOR.
- INITIAL BACKFILL SHALL BE CLASS I—A WORKED BY HAND, OR CLASS I—B OR CLASS II COMPACTED TO 85% STANDARD PROCTOR.
- INITIAL BACKFILL NOT UNDER PAVED AREAS CAN BE CLASS III COMPACTED TO 90% STANDARD PROCTOR.
- FINAL BACKFILL SHALL BE CLASS I, II, OR III COMPACTED AS NOTED IN NOTES 3. AND

BE CLASS IV-A COMPACTED TO 95% STANDARD

SANITARY SEWER

- ACCORDANCE WITH ASTM D 2321-89.
- WITH ASTM D 698. CLASS III AND IV-A MATERIALS SHALL BE COMPACTED NEAR OPTIMUM MOISTURE CONTENT.
- FREE OF DEBRIS, ORGANICS AND ROCKS LARGER THAN 3".
- 10. ALL TRENCH EXCAVATIONS SHALL BE SLOPED, SUPPORTED IN COMPLIANCE WITH OSHA SPECIFICATIONS)

# SANITARY SEWER DOUBLE CLEAN-OUTS

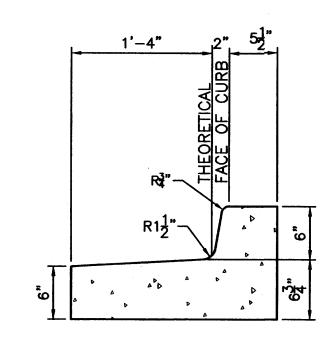



**CURB GENERAL NOTES:** 1. ALL CURBS TO BE CONSTRUCTED OF PORTLAND CEMENT CONCRETE, PER WAL-MART SPECIFICATIONS. 2. PROVIDE CONTRACTION JTS. 12' MAX., SPACING, 1/2" EXP. JTS. AT CURB RETURNS AND AT A MAX. SPACING OF 120' BETWEEN CURB RETURNS AND EACH SIDE OF SEPARATELY CONSTRUCTED DRIVEWAYS. CONTRACTION JTS., SHALL BE EITHER SAWED OR TOOLED A MINIMUM OF 1" DEEP AT FINISHED FACES. 3. ALL EDGES SHALL BE EDGED WITH A 3/8" RADUIS EDGING TOOL. 4. 1/4" ISOLATION JOINT SHALL BE PLACED BETWEEN SIDEWALK AND CURB WHEN CAST ADJACENT TO EACH


#### STANDARD CURB / GUTTER


ENGINEER'S SEAL	AFFORDABLE DENTURES 4821 ALEXANDER BLVD NE	<i>DRAWN BY</i> pm
		<i>DATE</i> 7–11–11
	CONSTRUCTION	7-11-11
	DETAILS	
		SHEET #
	TIERRA WEST, LLC  5571 MIDWAY PARK PL NE ALBUQUERQUE, NEW MEXICO 87109	C4
RONALD R. BOHAN P.E. #7868	(505) 858-3100 RONALD R. BOHANNAN www.tierrawestllc.com P.E. #7868	<i>JOB                                    </i>


- 6. FINAL BACKFILL NOT UNDER PAVED AREAS CAN PROCTOR.
- 7. ALL MATERIALS ARE CLASSIFIED IN
- ALL MATERIALS SHALL BE INSTALLED IN MAXIMUM 8" LOOSE LIFTS IN ACCORDANCE
- FILL SALVAGED FROM EXCAVATION SHALL BE
- SHORED, SHEETED, BRACED, OR OTHERWISE REGULATIONS AND LOCAL ORDINANCES. (SEE

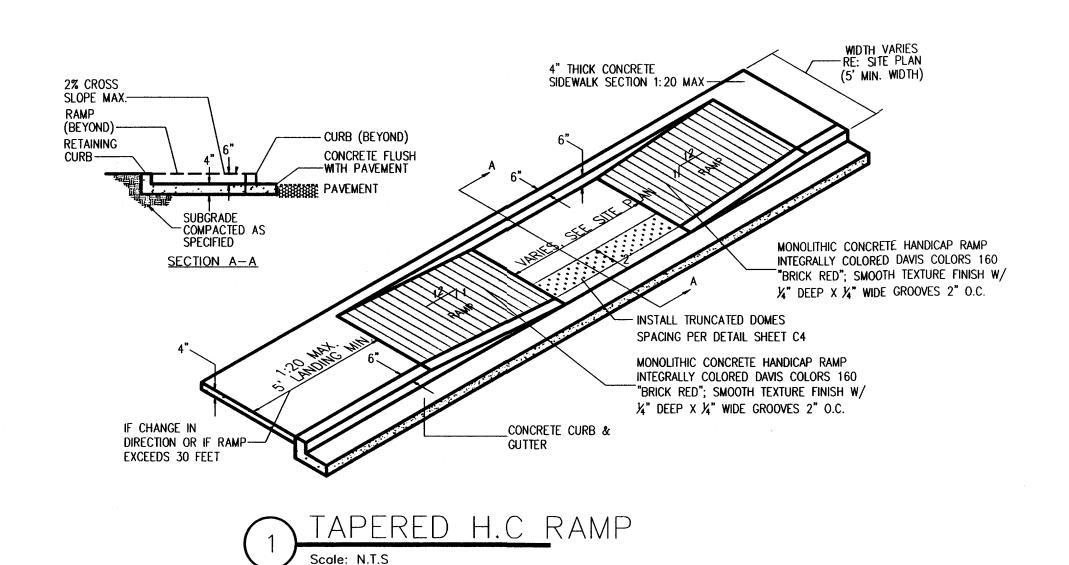

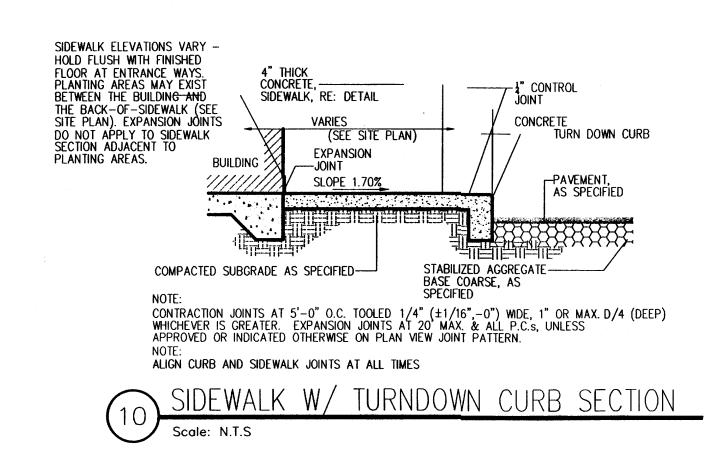

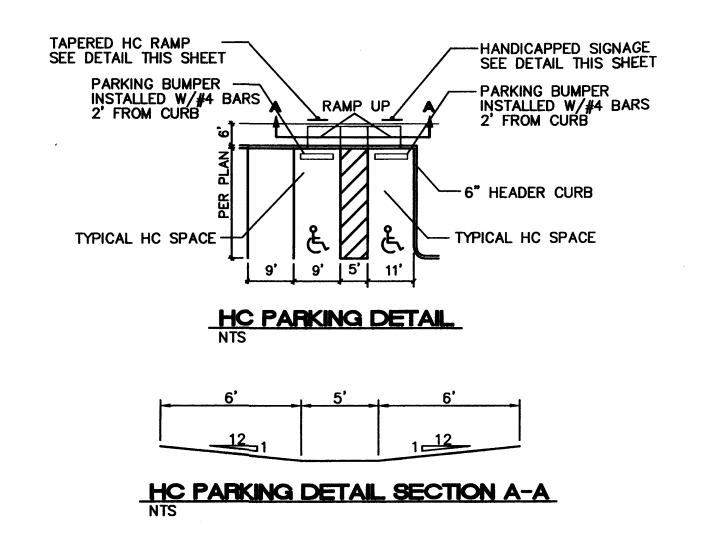

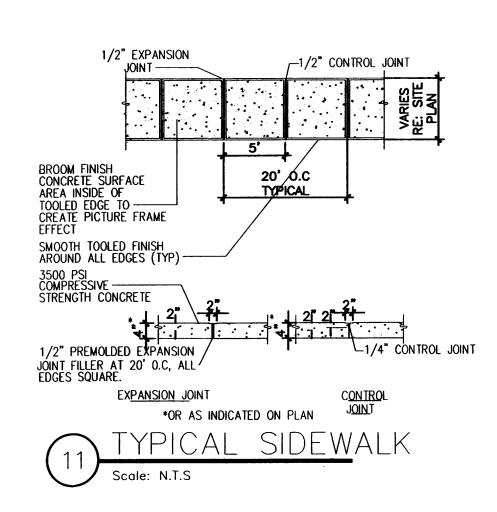


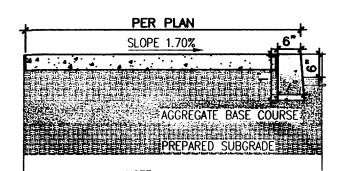


RE: SITEPLAN FOR LOCATIONS OF PAVEMENT SECTION
DESIGN PER THE GEOTECHNICAL INVESTIGATION

HEADER CURB W/ SIDEWALK (6' MIN., WIDTH PER PLAN)

Section N.T.S.

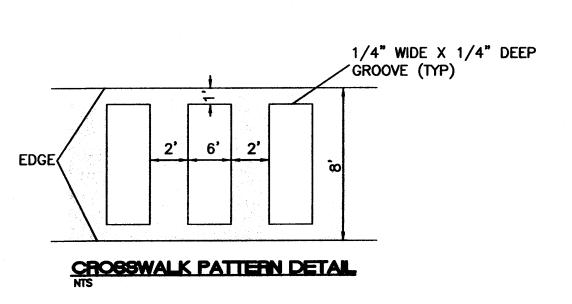


# SIGN KEY:

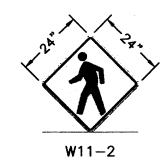


\* SIGN FACES SHOWN FOR REFERENCE; CONTRACTOR SHALL VERIFY DIRECTION OF ARROW TO CORRELATE WITH INSTALLATION LOCATION AND TRAFFIC MOVEMENTS.

\*\* CONTRACTOR SHALL COORDINATE WITH TRAFFIC OPERATIONS PRIOR SIGNING AND STRIPING

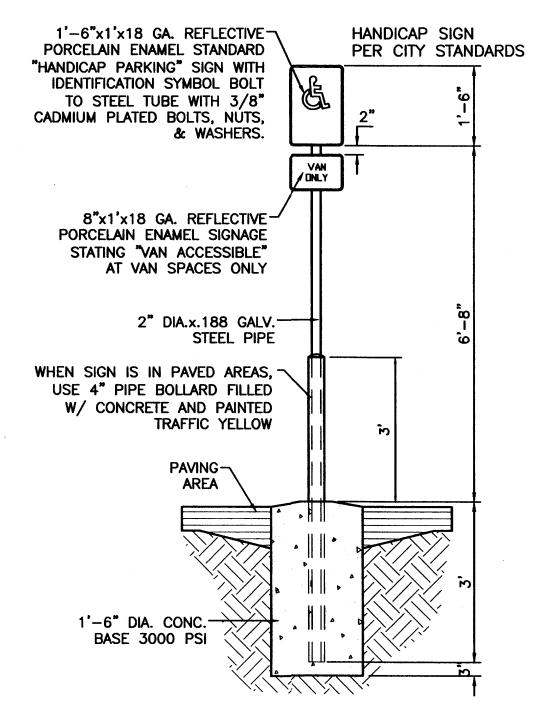


HANDICAP SIGN

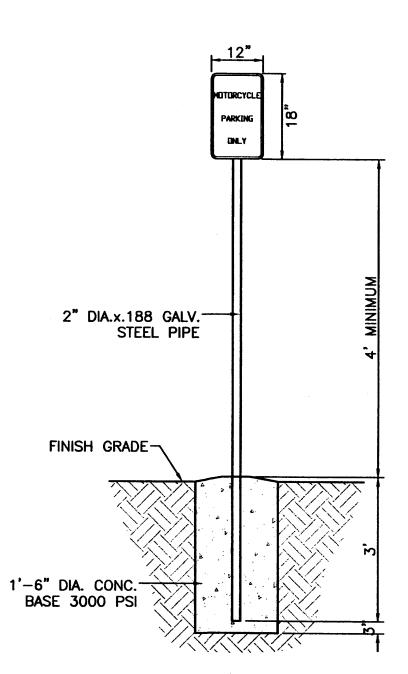

MOTORCYCLE PARKING SIGN

ENGINEER'S SEAL	AFFORDABLE DENTURES 4821 ALEXANDER BLVD NE	DY
	CONSTRUCTION	<i>DATE</i> 7-11-11
	DETAILS	<i>DRAWING</i> 2011038-DET2
		SHEET #
	TIERRA WEST, LLC  5571 MIDWAY PARK PL NE ALBUQUERQUE, NEW MEXICO 87109	C5
RONALD R. BOHANNAN P.E. #7868	(505) 858-3100 www.tierrawestllc.com	<i>JOB ∦</i> 2011038

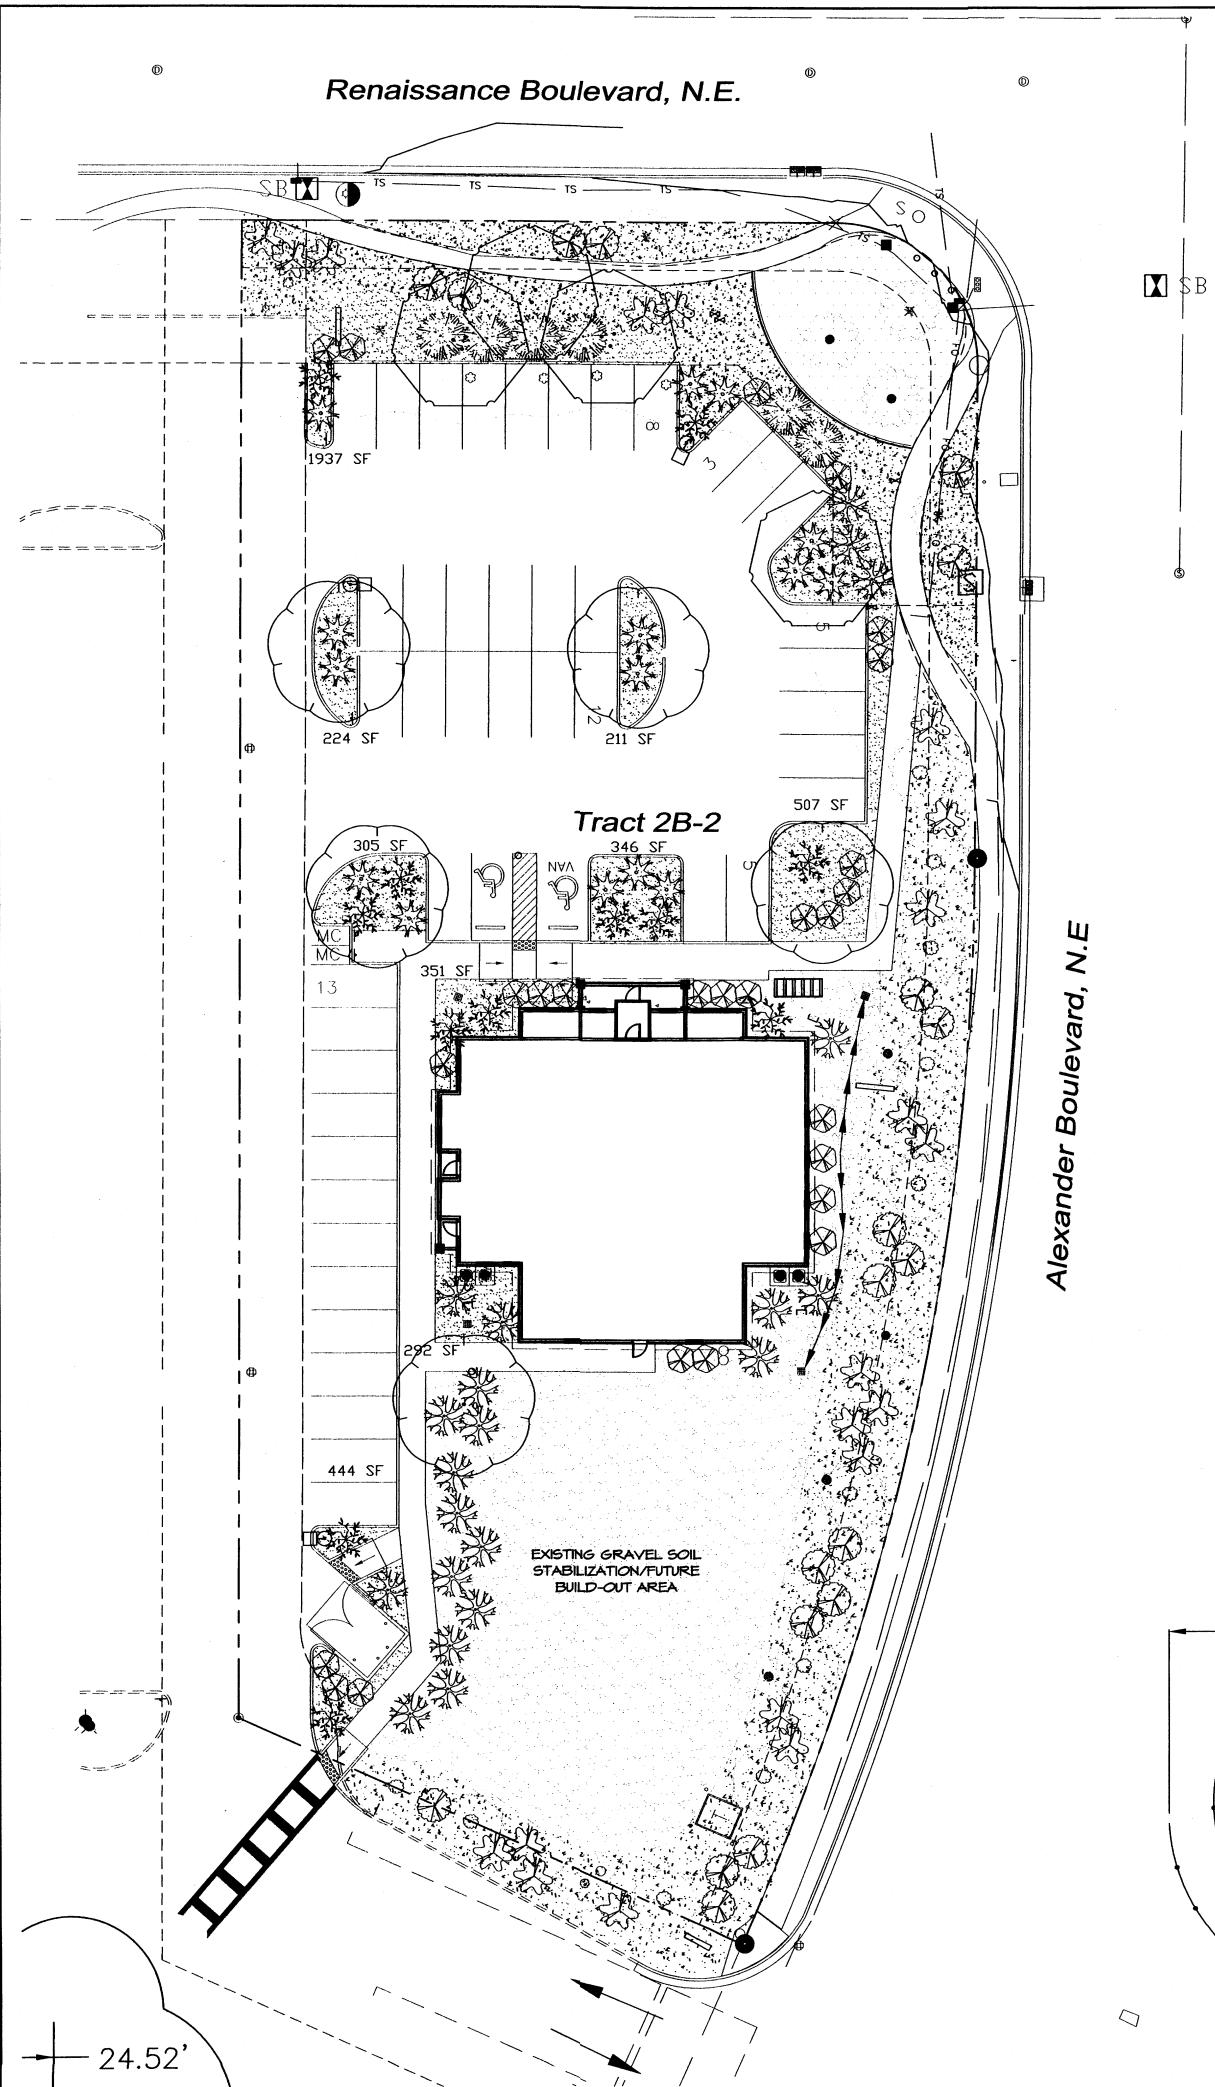

#### PLANT LEGEND

All plants shall be sized per American Standard for Nursery Stock. Installation size shall indicate the greater of height or spread. In cases where Type O plants have been pruned for rejuvenation, measurement should be by spread of roots rather than by the height of the plant.

AUTUMN PURPLE ASH 5
Fraxinus americana
2" Cal., 12'-14' Inst./60' x 60' maturity
Water (M) Allergy (H) Osf

COMMON HACKBERRY 4
Celtis occidentalis
2" Cal., 12'-14' Inst./40' x 40' maturity
Water (M) Allergy (L) Osf

Cotoneaster salicilifolius
5 Gal., 2'-4' Inst./6' x 10' maturity
Water (M) Allergy (L) 100sf

\* PHOTINIA 21
Photinia fraseri

\* WILLOWLEAF COTONEASTER 6

5 Gal., 2'-4' Inst./8' x 8' maturity Water (M+) Allergy (L) 64sf

Raphiolepis indica

5 Gal., 18"-3' Inst./6' x 6' maturity
Mater (M) Allergy (L) 36sf

\* GREYLEAF COTONEASTER 12
Cotoneaster glaucophyllus

\* INDIAN HAWTHORN 26

5 Gal., 24"-4' Inst./2' x 9' maturity Mater (M) Allergy (L) 81sf

\* LADY BANK'S ROSE 15
Rosa banksiae
5 Gal., 24"-4' Inst./3' x 20' maturity
Water (M) Allergy (L) 400sf

Unstaked Groundcover

MINTER JASMINE 20
Jasminum nudiflorum
1 Gal., 6"-15" Inst./4' x 12' maturity
Water (L+) Allergy (L) 144sf

\* HONEYSUCKLE 19
Lonicera japonica 'Halliana'

1 Gal., 6"-15" Inst./3' x 12' maturity

Mater (M) Allergy (L) 144sf
Unstaked-Groundcover

HARDSCAPES

EXISTING SOD EDGE

COMMERCIAL GRADE STEEL EDGING

EXISTING GRAVEL TO REMAIN

SANTA FE BROWN GRAVEL WITH FILTER FABRIC TO A MINIMUM 3" DEPTH


EXISTING TURF TO REMAIN

EXISTING TURF DEMO/ NEW
SANTA FE BROWN GRAVEL

WITH FILTER FABRIC

TO A MINIMUM 3" DEPTH

COBBGLESTONE FLOWLINE STABILIZATION

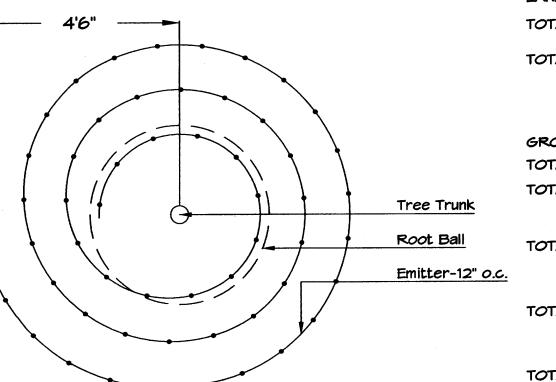

Netafim Spiral Detail

#### ANDSCAPE NOTES

Landscape maintenance shall be the responsibility of the Property Owner. The Property Owner shall maintain street trees in a living, healthy, and attractive condition.

It is the intent of this plan to comply with the City Of Albuquerque Water Conservation Landscaping and Water Waste Ordinance planting restriction approach. Approval of this plan does not constitute or imply exemption from water waste provisions of the Water Conservation Landscaping and Water Waste Ordinance.

Mater management is the sole responsibility of the Property Owner. All landscaping will be in conformance with the City of Albuquerque Zoning Code, Street Tree Ordinance, Pollen Ordinance, and Water Conservation Landscaping and Water Waste Ordinance. In general, water conservative, environmentally sound landscape principles will be followed in design and installation.

Plant beds shall achieve 75% live ground cover at maturity.

Brown Gravel over Filter Fabric to a minimum depth of 3" shall be placed in all landscape areas which are not designated to receive new lawn, or preserve existing lawn or existing grey gravel.

#### IRRIGATION NOTES:

Irrigation shall be a complete underground system with new Trees not in lawn area to receive 1 Netafim spiral (50' length) with 3 loops at a final radius of 4.5' from tree trunk, pinned in place. Netafim shall have emitters 12" o.c. with a flow of .6 gph. Shrubs to receive (2) 1.0 GPH Drip Emitters. Drip and Bubbler systems to be tied to 1/2" polypipe with flush caps at each end. Trees and shrubs shall be on separate valves.

Lawn irrigation shall be capped at property line and retrofitted to run off new irrigation system solely for this property.

Run time per each shrub drip valve will be approximately 15 minutes per day. Tree drip valve shall run 1.5 hours, 3 times per week. Run time will be adjusted according to the season.

Point of connection for irrigation system is unknown at current time and will be coordinated in the field. Irrigation will be operated by automatic controller.

Location of controller to be field determined and power source for controller to be provided by others.

Irrigation maintenance shall be the responsibility of the Property Owner.

Mater and Power source shall be the responsibility of the Developer/Builder.

#### NOTE TO CLIENT:

Should The Hilltop not receive a Grading and Drainage plan during the design process or the on-site grades differ from the Grading and Drainage plan received. The Hilltop reserves the right to apply slope stabilization materials where the specified gravel will not be suitable. Gravel smaller than 2-4" cobblestone will not stay on a slope greater than 3:1. If the grades are greater than what was originally designed, we will request an infield change-order to lay cobblestone or rip-rap, in lieu of the specified gravel, to stabilize the slope. All vegetative material shall remain per plan.



EXISTING TREES TO REMAIN

DAX 222-11

**ZONING ENFORCEMENT** 

### LANDSCAPE CALCULATIONS

	TOTAL LOT AREA	49026	square feet	
	TOTAL BUILDINGS AREA	4570	square feet	
	NET LOT AREA	44456	square feet	
	LANDSCAPE REQUIREMENT	15%	_	
	TOTAL LANDSCAPE REQUIREMENT	6668	square feet	
	TOTAL BED PROVIDED	15538.0000	square feet	
	TOTAL NEW BED PROVIDED	4617	square feet	
	TOTAL EXISTING GRAVEL BED AREA	2179	square feet	
	TOTAL EXISTING SOD DEMO/ NEW BED	8742	square feet	
	GROUNDCOVER REQ.	75%	square feet	
	TOTAL GROUNDCOVER REQUIREMENT	11653	square feet	
	TOTAL GROUNDCOVER PROVIDED	11744 (75%)	square feet	
	TOTAL EXISTING SOD TO REMAIN	1419 (8%)	square feet	
<u>.c.</u>	TOTAL LANDSCAPE PROVIDED	16950.0000	square feet	
	TOTAL EXISTING TEMPORARY GRAVEL AREA	6346	square feet	

3. PRIOR TO BACKFILLLING TREE, ALL WIRE, ROPE AND SYNTHETIC MATERIALS SHALL BE REMOVED FROM THE TREE AND THE PLANTING PIT.

4. PRIOR TO BACKFILLING ALL BURLAP SHALL BE CUT AWAY EXCEPT FROM BOTTOM OF THE ROOTBALL.

CONSTRUCTION NOTES:

A. TREE

B. BACKFILL WITH EXISTING SOIL.

C. 3" DEPTH OF GRAVEL MULCH.

D. UNDISTRUBED SOIL.

TO PREVENT TREE FROM SETTLING.

TREE PLANTING DETAIL

1. ROOTBALL SHALL BE PLACED ON UNDISTURBED SOIL

TREE WAS GROWN AND DUG; THIS REPRESENTS THE LEVEL

2. TOP OF ROOTCOLLAR INDICATED LEVEL AT WHICH

AT WHICH THE TREE SHOULD BE INSTALLED: THAT LEVEL

MAY BE EXCEEDED BY ONLY A ONE INCH LAYER OF SOIL.

SHRUB PLANTING DETAIL

RETENTION BASIN SHALL BE TWICE THE DIAMETER

C. EARTH BERM AROUND WATER RETENTION BASIN.

1. THE OUTSIDE DIAMETER OF THE WATER

GENERAL NOTES:

E. FINISH GRADE.

GENERAL NOTES:


F. UNDISTURBED SOIL.

OF THE SHRUB PLANTING PIT.

B. BACKFILL WITH EXISTING SOIL.

D. 3" DEPTH OF GRAVEL MULCH.

CONSTRUCTION NOTES:

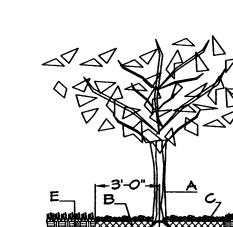

TREE PLANTING DETAIL

NTS

#### GENERAL NOTES:

1. ROOTBALL SHALL BE PLACED ON UNDISTURBED SOIL TO PREVENT TREE FROM SETTLING.
2. TOP OF ROOTCOLLAR INDICATED LEVEL AT WHICH TREE WAS GROWN AND DUG; THIS REPRESENTS THE LEVEL AT WHICH THE TREE SHOULD BE INSTALLED; THAT LEVEL MAY BE EXCEEDED BY ONLY A ONE INCH LAYER OF SOIL

3. PRIOR TO BACKFILLLING TREE, ALL WIRE, ROPE AND SYNTHETIC MATERIALS SHALL BE REMOVED FROM THE TREE AND THE PLANTING PIT.

4. PRIOR TO BACKFILLING ALL BURLAP SHALL BE CUT AWAY EXCEPT FROM BOTTOM OF THE ROOTBALL.

## CONSTRUCTION NOTES:

E. UNDISTURBED SOIL.


A TREE

A. TREE
B. BACKFILL WITH EXISTING SOIL.
C. 3" DEPTH OF GRAVEL MULCH.
D. TURF AT FINISH GRADE.

GRAPHIC SCALE

20 10 0 10 20

SCALE: 1"=20'

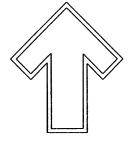

ont. Lic. #26458 909 Edith N.E. Ibuquerque, NM 87184 h. (505) 898-9690 ax (505) 898-7737 mj@hilltoplandscaping.con

> LANDSCAPE ARCHITECT'S SEAL



CARE

creative ideas contained Herein remains the erty of The Hilltop Landscape Architects and ractors and are protected by copyright laws. an original design and must not be released or d unless applicable fees have been paid or job

All creative property of Contractors This is an orth copied unless

DRAWN BY


cmj


REVISION #


3/4-19-11

DATE


SHEET #

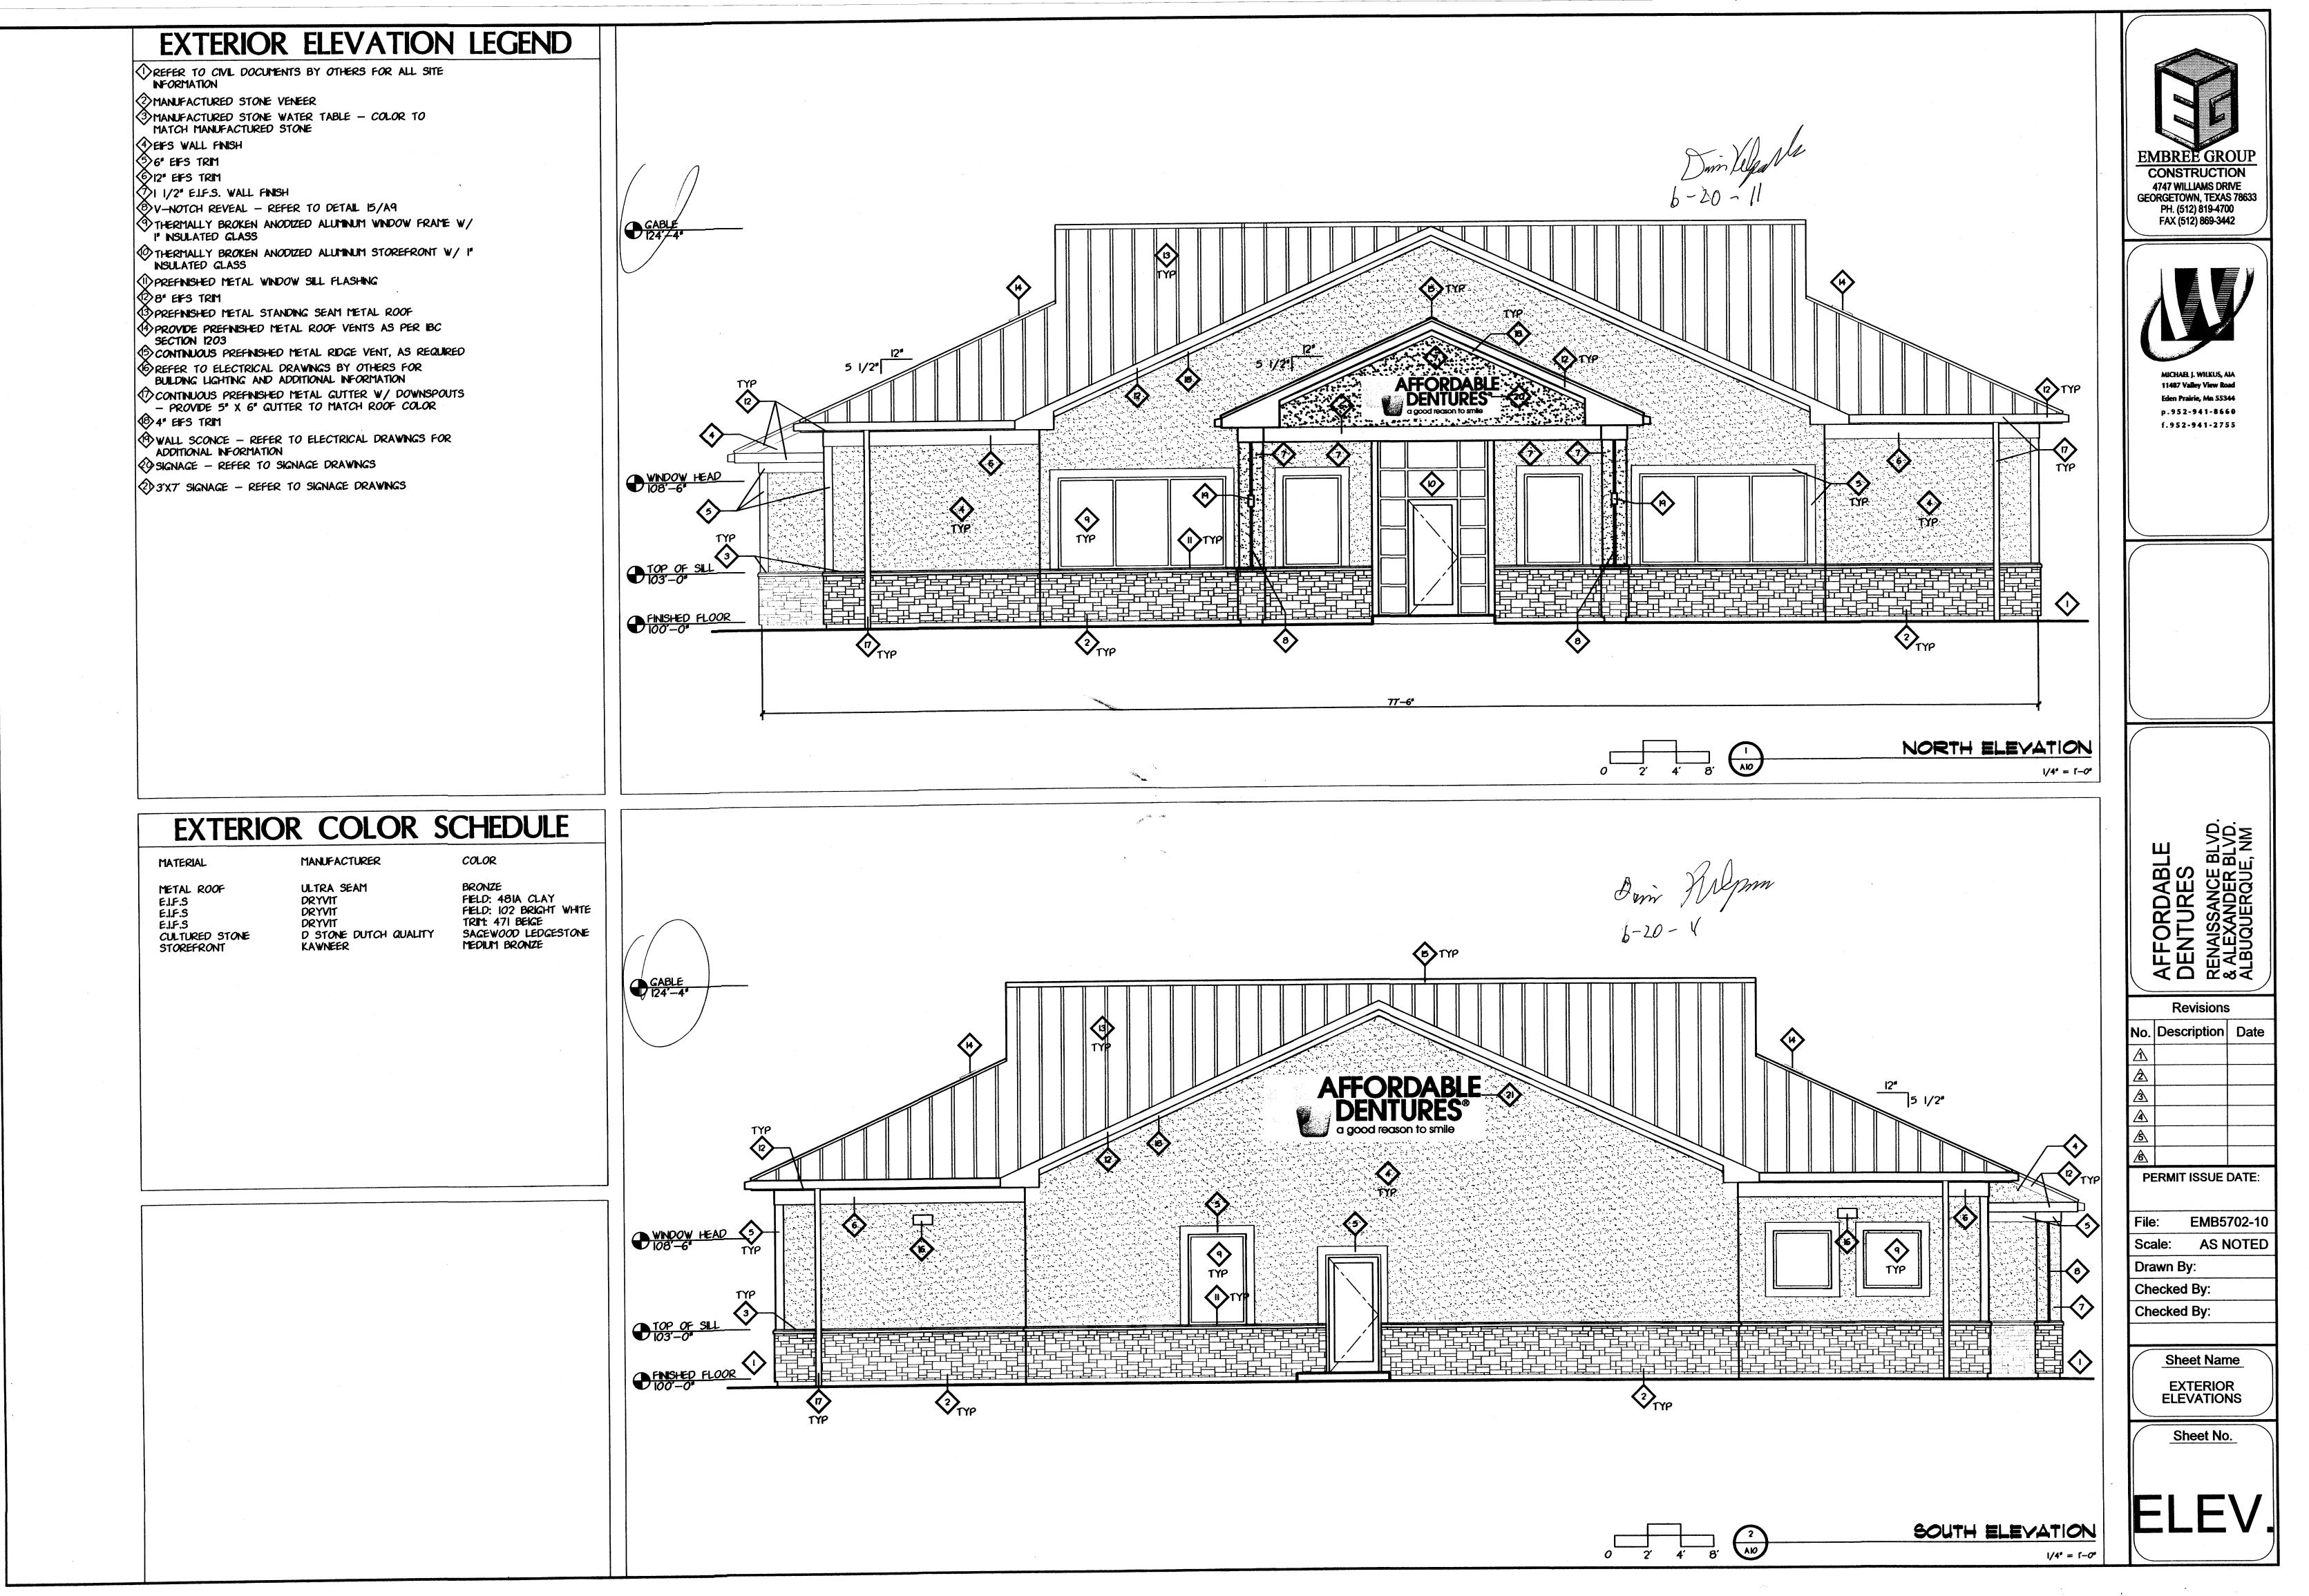

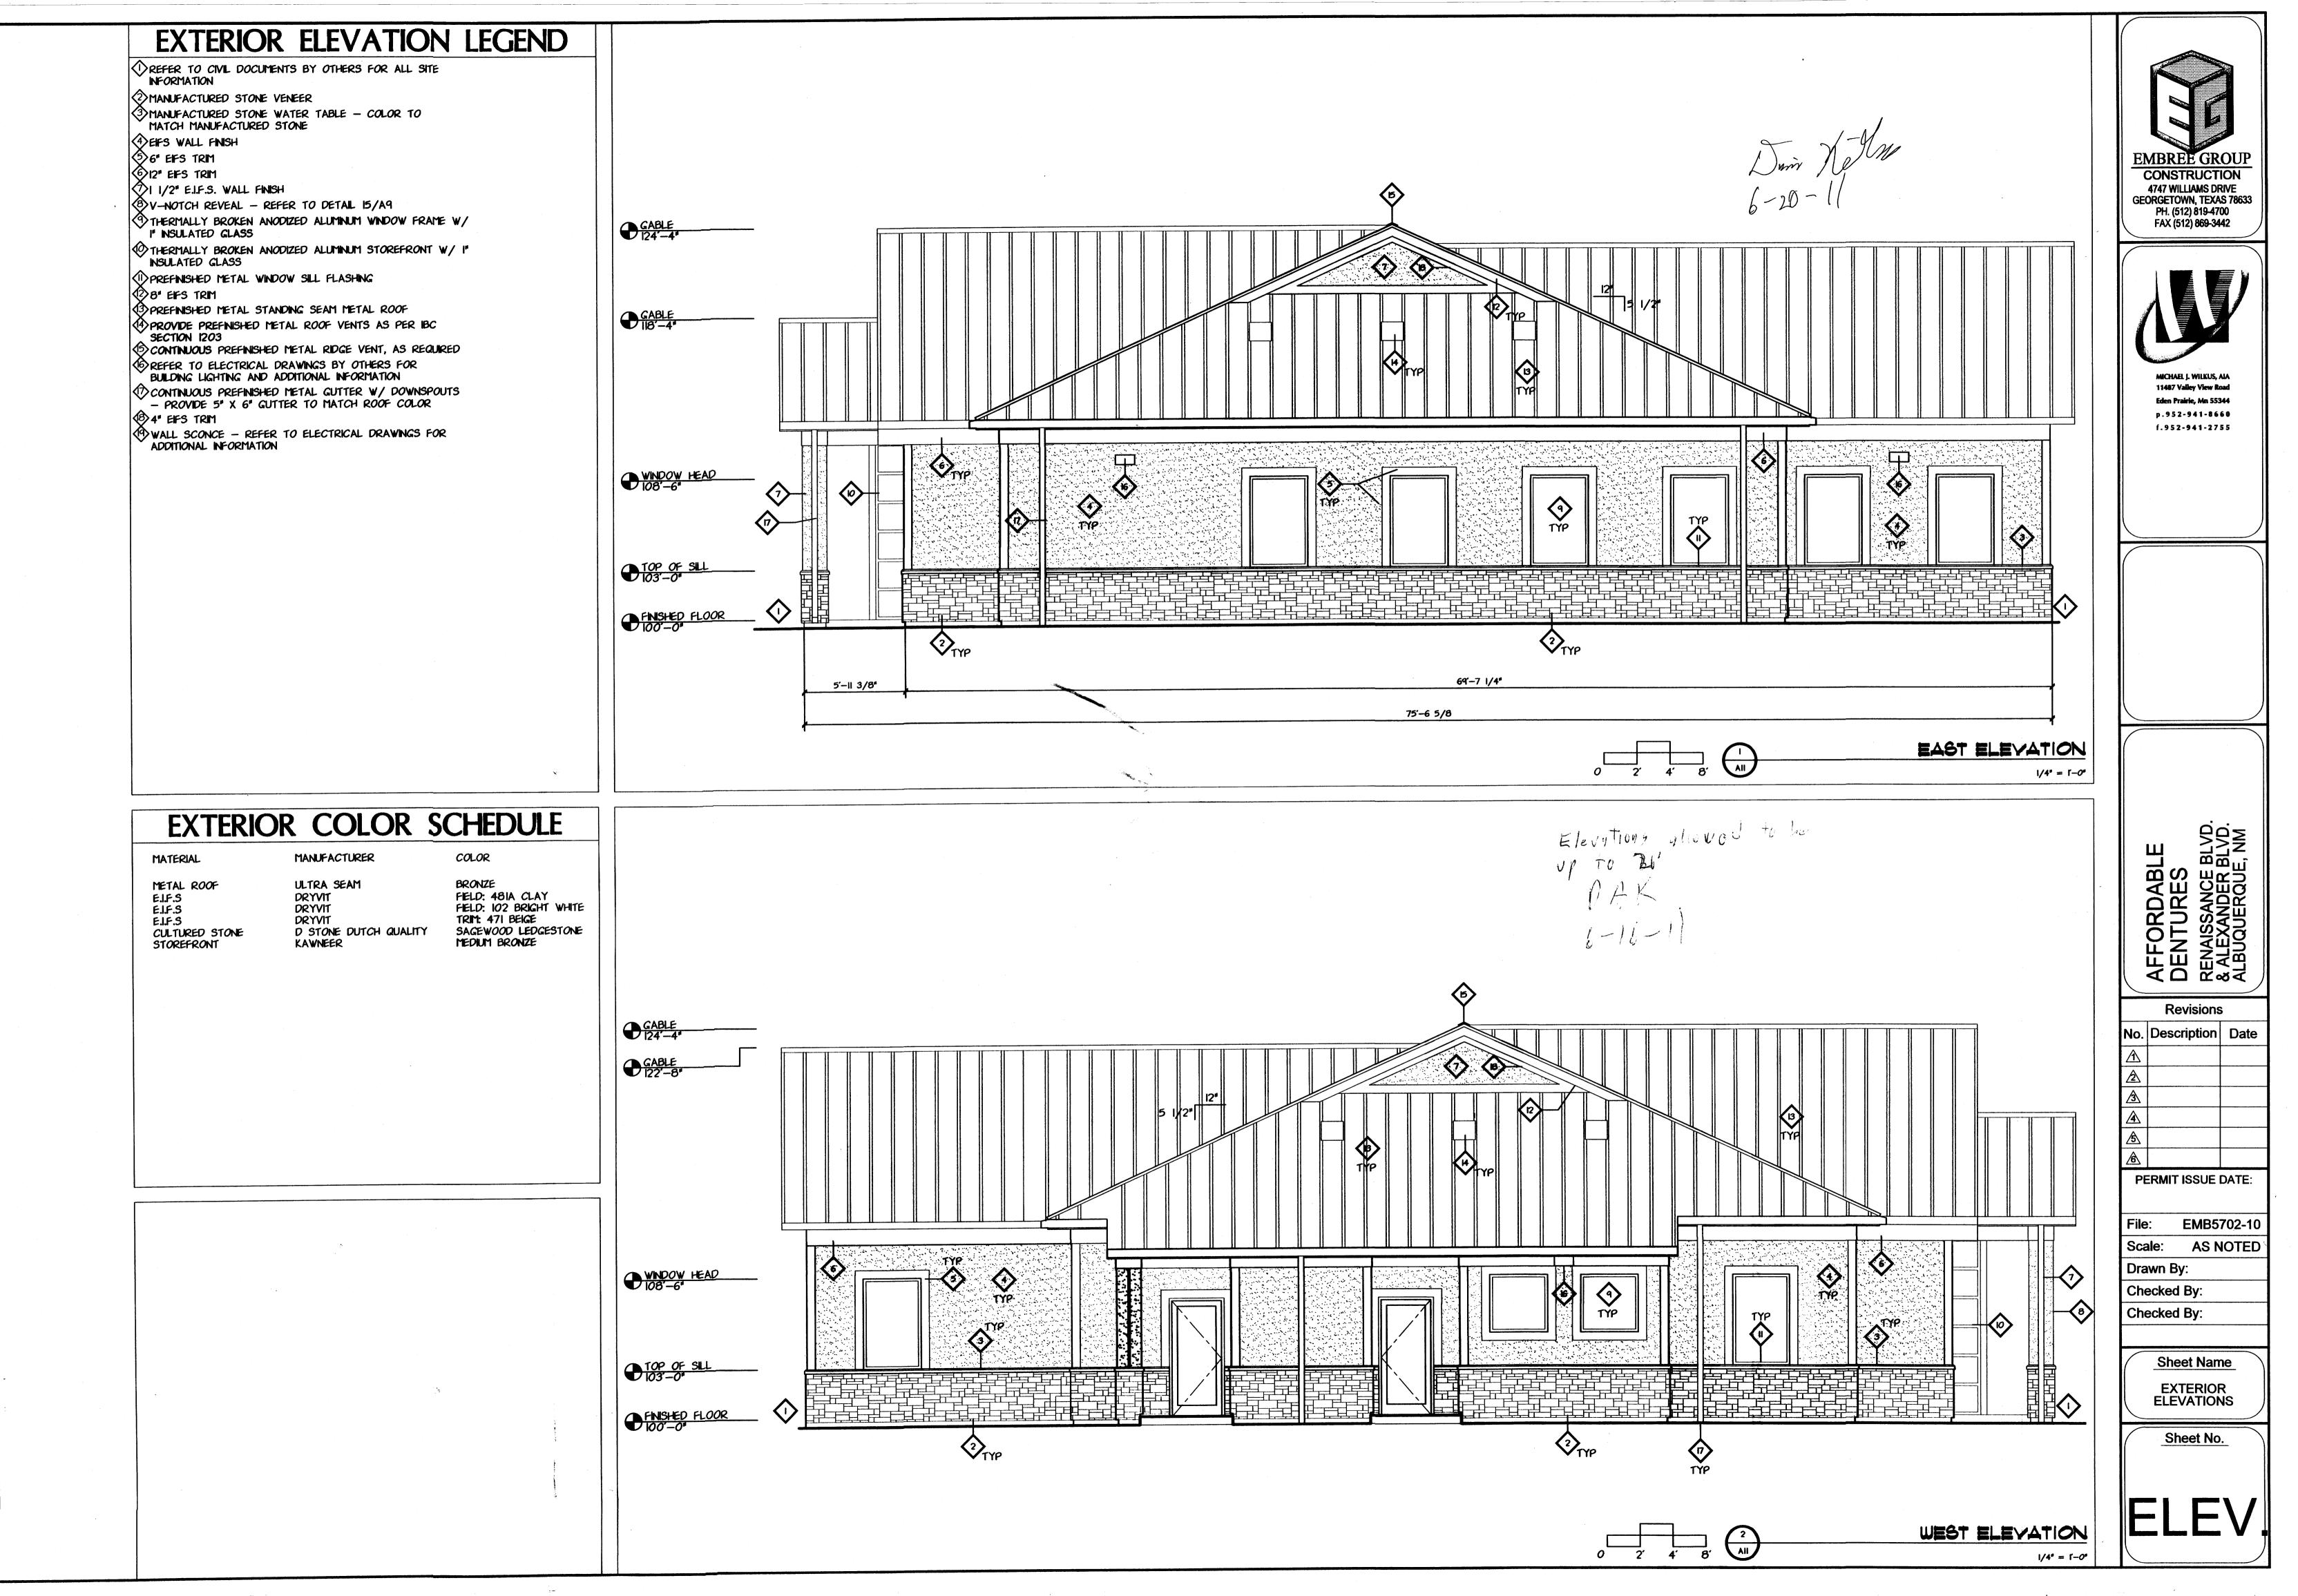

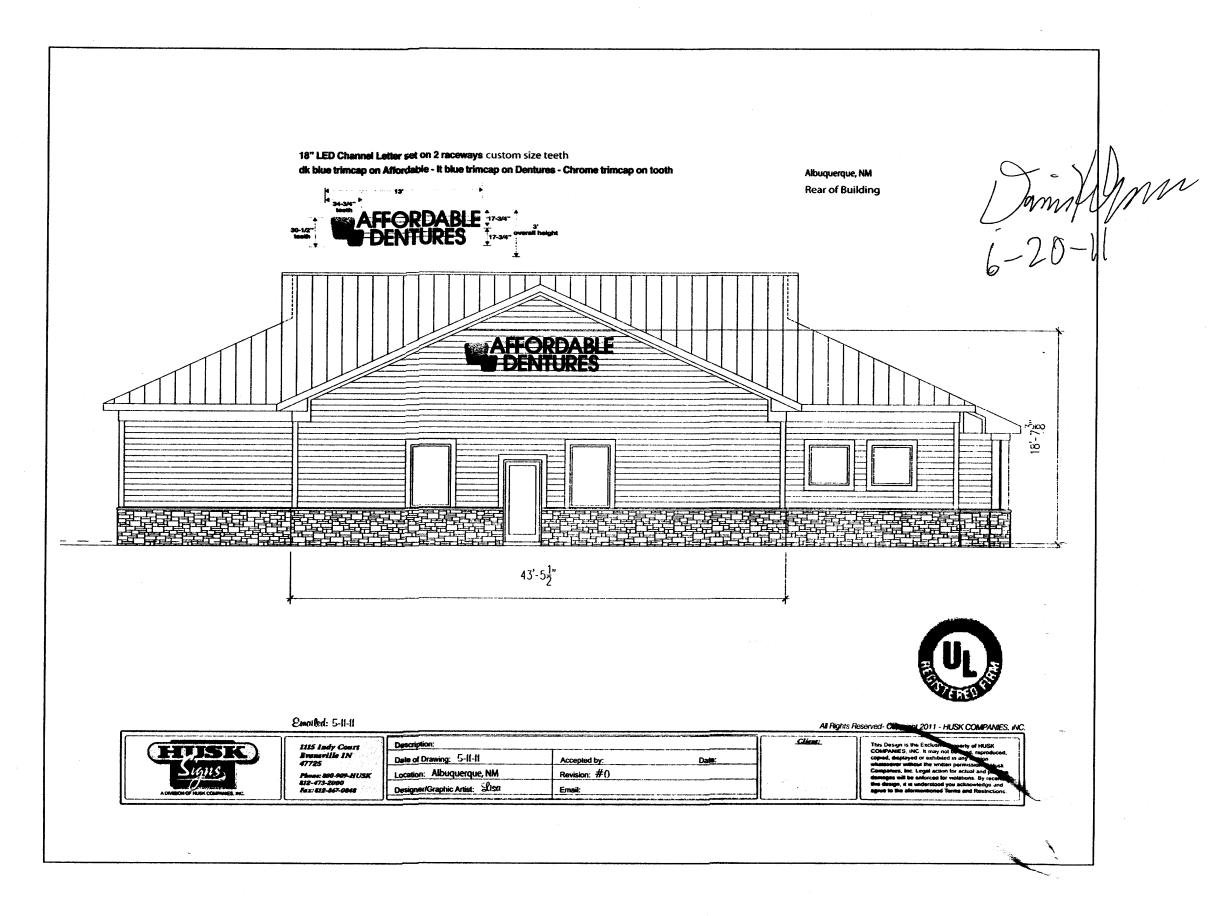



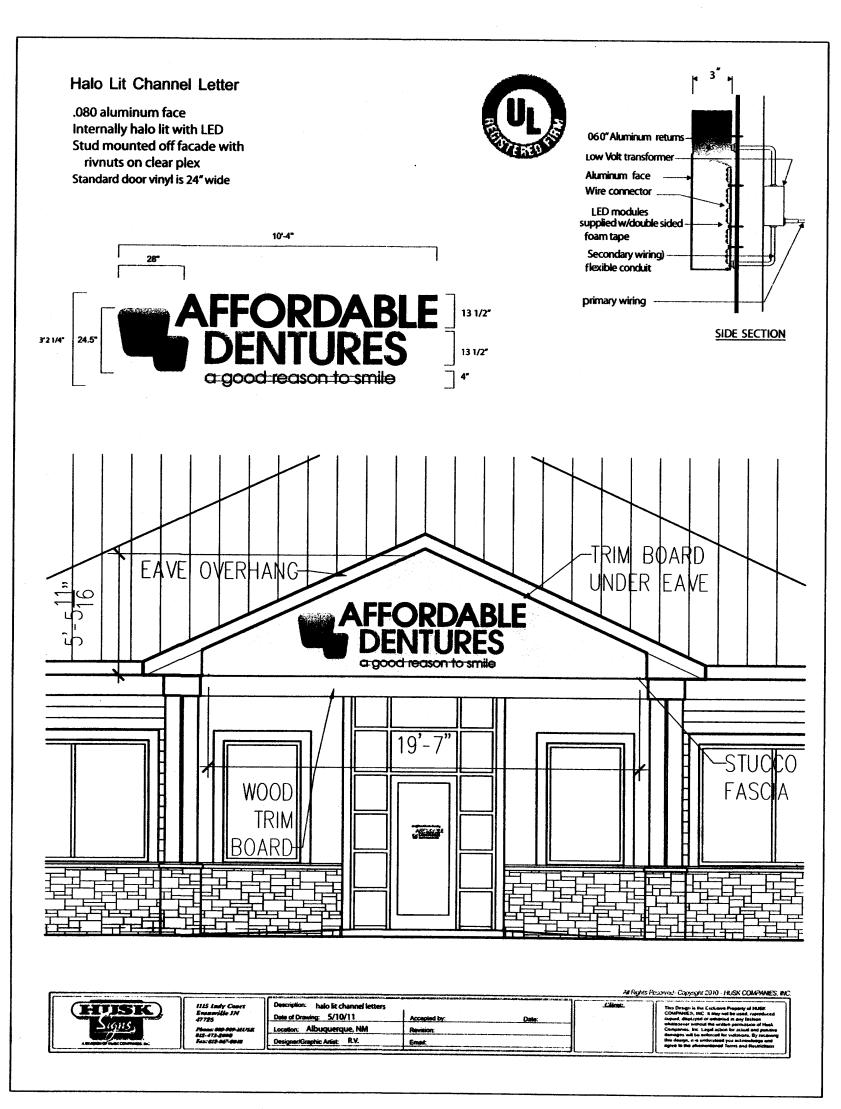

ENGINEER'S SEAL	AFFORDABLE DENTURES 4821 ALEXANDER BLVD NE	<i>DRAWN BY</i> pm
		DATE
	SIGNAGE ELEVATIONS/	5-13-11
	DETAILS	
		SHEET #
	TIERRA WEST, LLC  5571 MIDWAY PARK PL NE ALBUQUERQUE, NEW MEXICO 87109	<b>A3</b>
RONALD R. BOHANNAN P.E. <b>∦</b> 7868	(505) 858-3100 www.tierrawestlic.com	<i>JOB ∦</i> 2011038