



PROJECT LOCATION

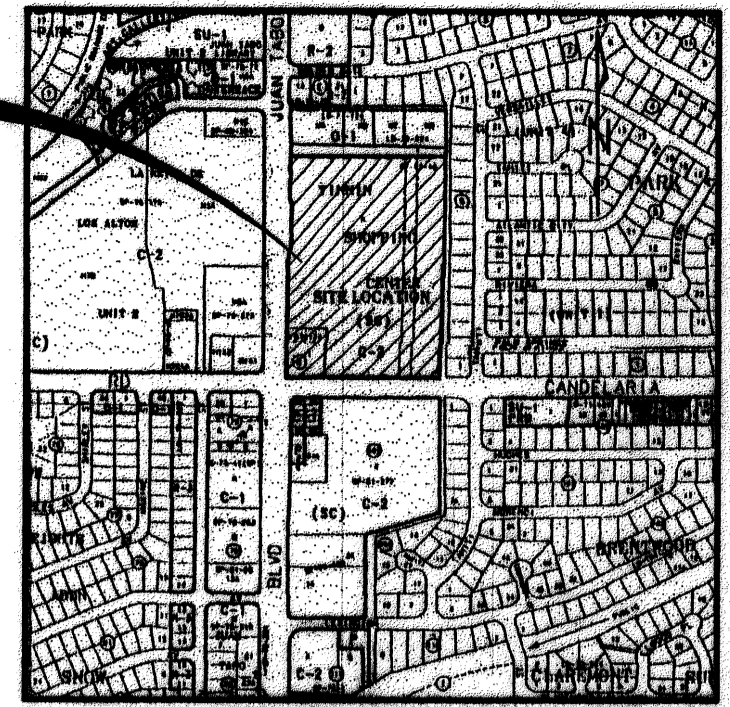

LOCATION MAP
ZONE ATLAS MAP NO. G-22

<p>MH-11 STORM N RIM ELEV = 5632.97' NE INV ELEV = 5627.38' (18") SE INV ELEV = 5628.15' (18") W INV ELEV = 5626.78' (24")</p>	<p>MH-17 STORM N RIM ELEV = 5617.82' E INV ELEV = 5610.06' (48") SW INV ELEV = 5613.80' (18") W INV ELEV = 5609.98' (48") W TOP OF PIPE ELEV = 5614.43'</p>
<p>MH-12 STORM N RIM ELEV = 5632.05' E INV ELEV = 5625.80' (24") SE INV ELEV = 5627.74' (18") W INV ELEV = 5625.76' (24")</p>	<p>MH-18 STORM N RIM ELEV = 5618.32' NE INV ELEV = 5613.65' (18") S INV ELEV = 5613.47' (18") NW INV ELEV = 5614.83' (18")</p>
<p>MH-13 STORM N RIM ELEV = 5629.56' NE INV ELEV = 5623.34' (18") E INV ELEV = 5623.15' (24") SE INV ELEV = 5624.91' (18") W INV ELEV = 5622.83' (30")</p>	<p>MH-20 STORM N RIM ELEV = 5617.24' N INV ELEV = 5608.58' (4') S INV ELEV = 5607.68' W INV ELEV = 5611.84' (18") W INV ELEV = 5611.08' (18")</p>
<p>MH-15 STORM N RIM ELEV = 5626.20' NE INV ELEV = 5620.58' (18") E INV ELEV = 5619.70' (30") S INV ELEV = 5621.29' (18") W INV ELEV = 5619.16' (30")</p>	<p>MH-21 STORM N RIM ELEV = 5617.45' E INV ELEV = 5609.41' (4') S INV ELEV = 5608.65' (4')</p>
	<p>MH-23 STORM N RIM ELEV = 5618.01' NE INV ELEV = 5615.03' (18") NW INV ELEV = 5615.10' (18")</p>

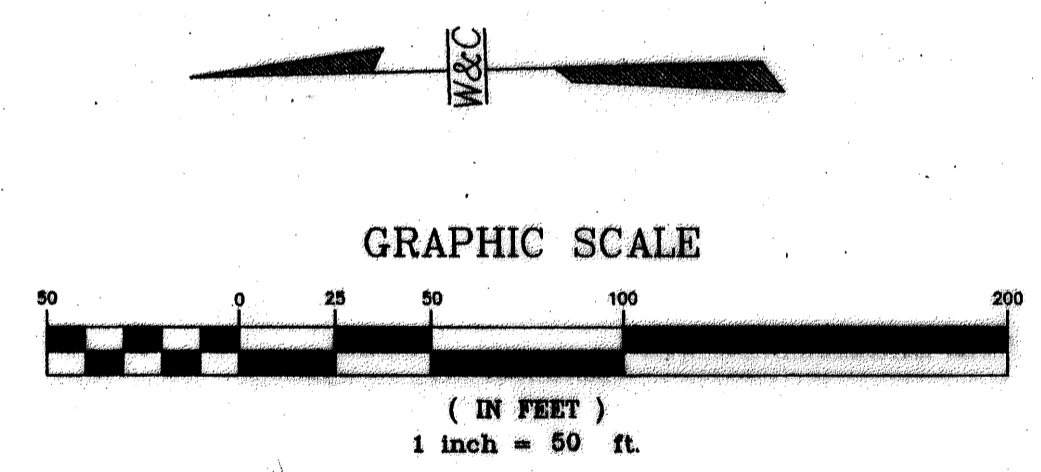

LEGAL DESCRIPTION

A CERTAIN PARCEL OF LAND SITUATE IN THE SOUTHEAST QUARTER (SW 1/4) OF SECTION 3, TOWNSHIP 10 NORTH, RANGE 3 EAST, NEW MEXICO PRINCIPAL MERIDIAN, CITY OF ALBUQUERQUE, BERNALILLO COUNTY, NEW MEXICO, AND COMPRISING ALL OF "R.P. TINNIN LAND" AS IS SHOWN ON THE "AMENDED AND CORRECTED PLAT OF THE REDIVISION OF TINNIN SHOPPING CENTER" AS FILED WITH THE BERNALILLO COUNTY CLERK ON JUNE 20, 1972 IN VOLUME B6 FOLIO 173.

BENCH MARK

THE STATION IS LOCATED 8.3 MILES NORTHEAST OF DOWNTOWN ALBUQUERQUE AT THE INTERSECTION OF JUAN TABO BLVD. N.E. & COMANCHE RD. N.E. TO REACH THE STATION FROM THE INTERCHANGE AT I-40 AND JUAN TABO BLVD., GO NORTH ON JUAN TABO 3.2 MILES TO THE STATION ON THE MALL. THE STATION MARK IS A STANDARD ACS BRASS TABLET STAMPED "ACS 2-G21-A 1978", DRILLED INTO THE TOP OF THE CONCRETE CURB. ELEVATION 5666.13

LEGEND

--- EX. 12" SAS ---	SANITARY SEWER	o	MANHOLE
--- EX. SD ---	STORM DRAIN	OT	TELE. MANHOLE
--- EX. 16" WL ---	WATER LINE	CC	CLEANOUT
--- GAS ---	GAS LINE	WV	WATER VALVE
--- UGE ---	UNDERGROUND ELECTRIC LINE	WM	WATER METER
--- T ---	TELEPHONE LINE LINE	o	JUNIPER BUSH
--- OHPL ---	OVERHEAD POWER	B	BUSH
o	FIRE HYDRANT	ET	ELM TREE, LESS THAN 6" DIAM.
o	GREASE TRAP	DT	DECIDUOUS TREE, LESS THAN 6" DIAM.
		OT	OAK TREE, 10-15" DIAM.

REVISIONS	
DATE	DESCRIPTION

LOWE'S HOME CENTERS, INC.
12/00 COPYRIGHT
ALL RIGHTS RESERVED




LOWE'S

P. O. Box 1111 N. Wilkesboro, N. C. 28666

EXISTING CONDITIONS SITE PLAN

LOWE'S
JUAN TABO AND CANDELARIA
ALBUQUERQUE, NEW MEXICO



DRAWN BY MDG	 2600 THE AMERICAN ROAD SE, SUITE 100 RIO RANCHO, NEW MEXICO 87124 (505) 898-8021	DATE DECEMBER 2000	SHEET 4 OF 11
DESIGN BMS		FILE NO. X0218001	
CHECKED BY LBS		SHEET NO. 1 of 1	

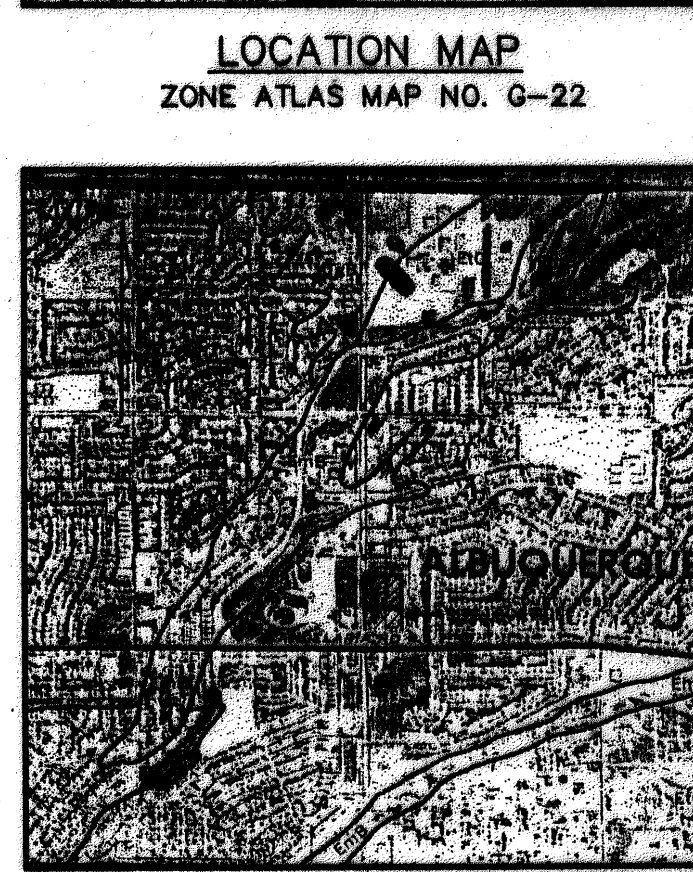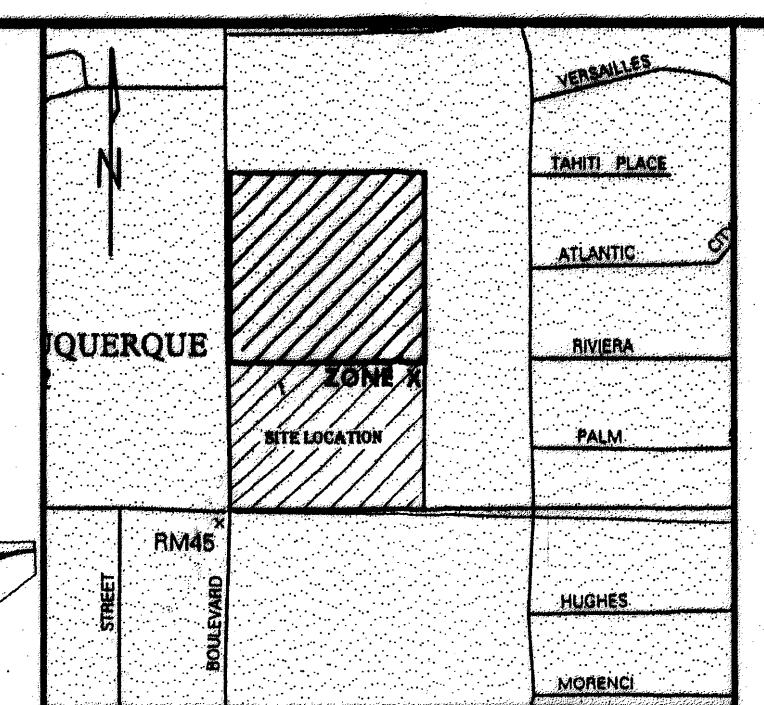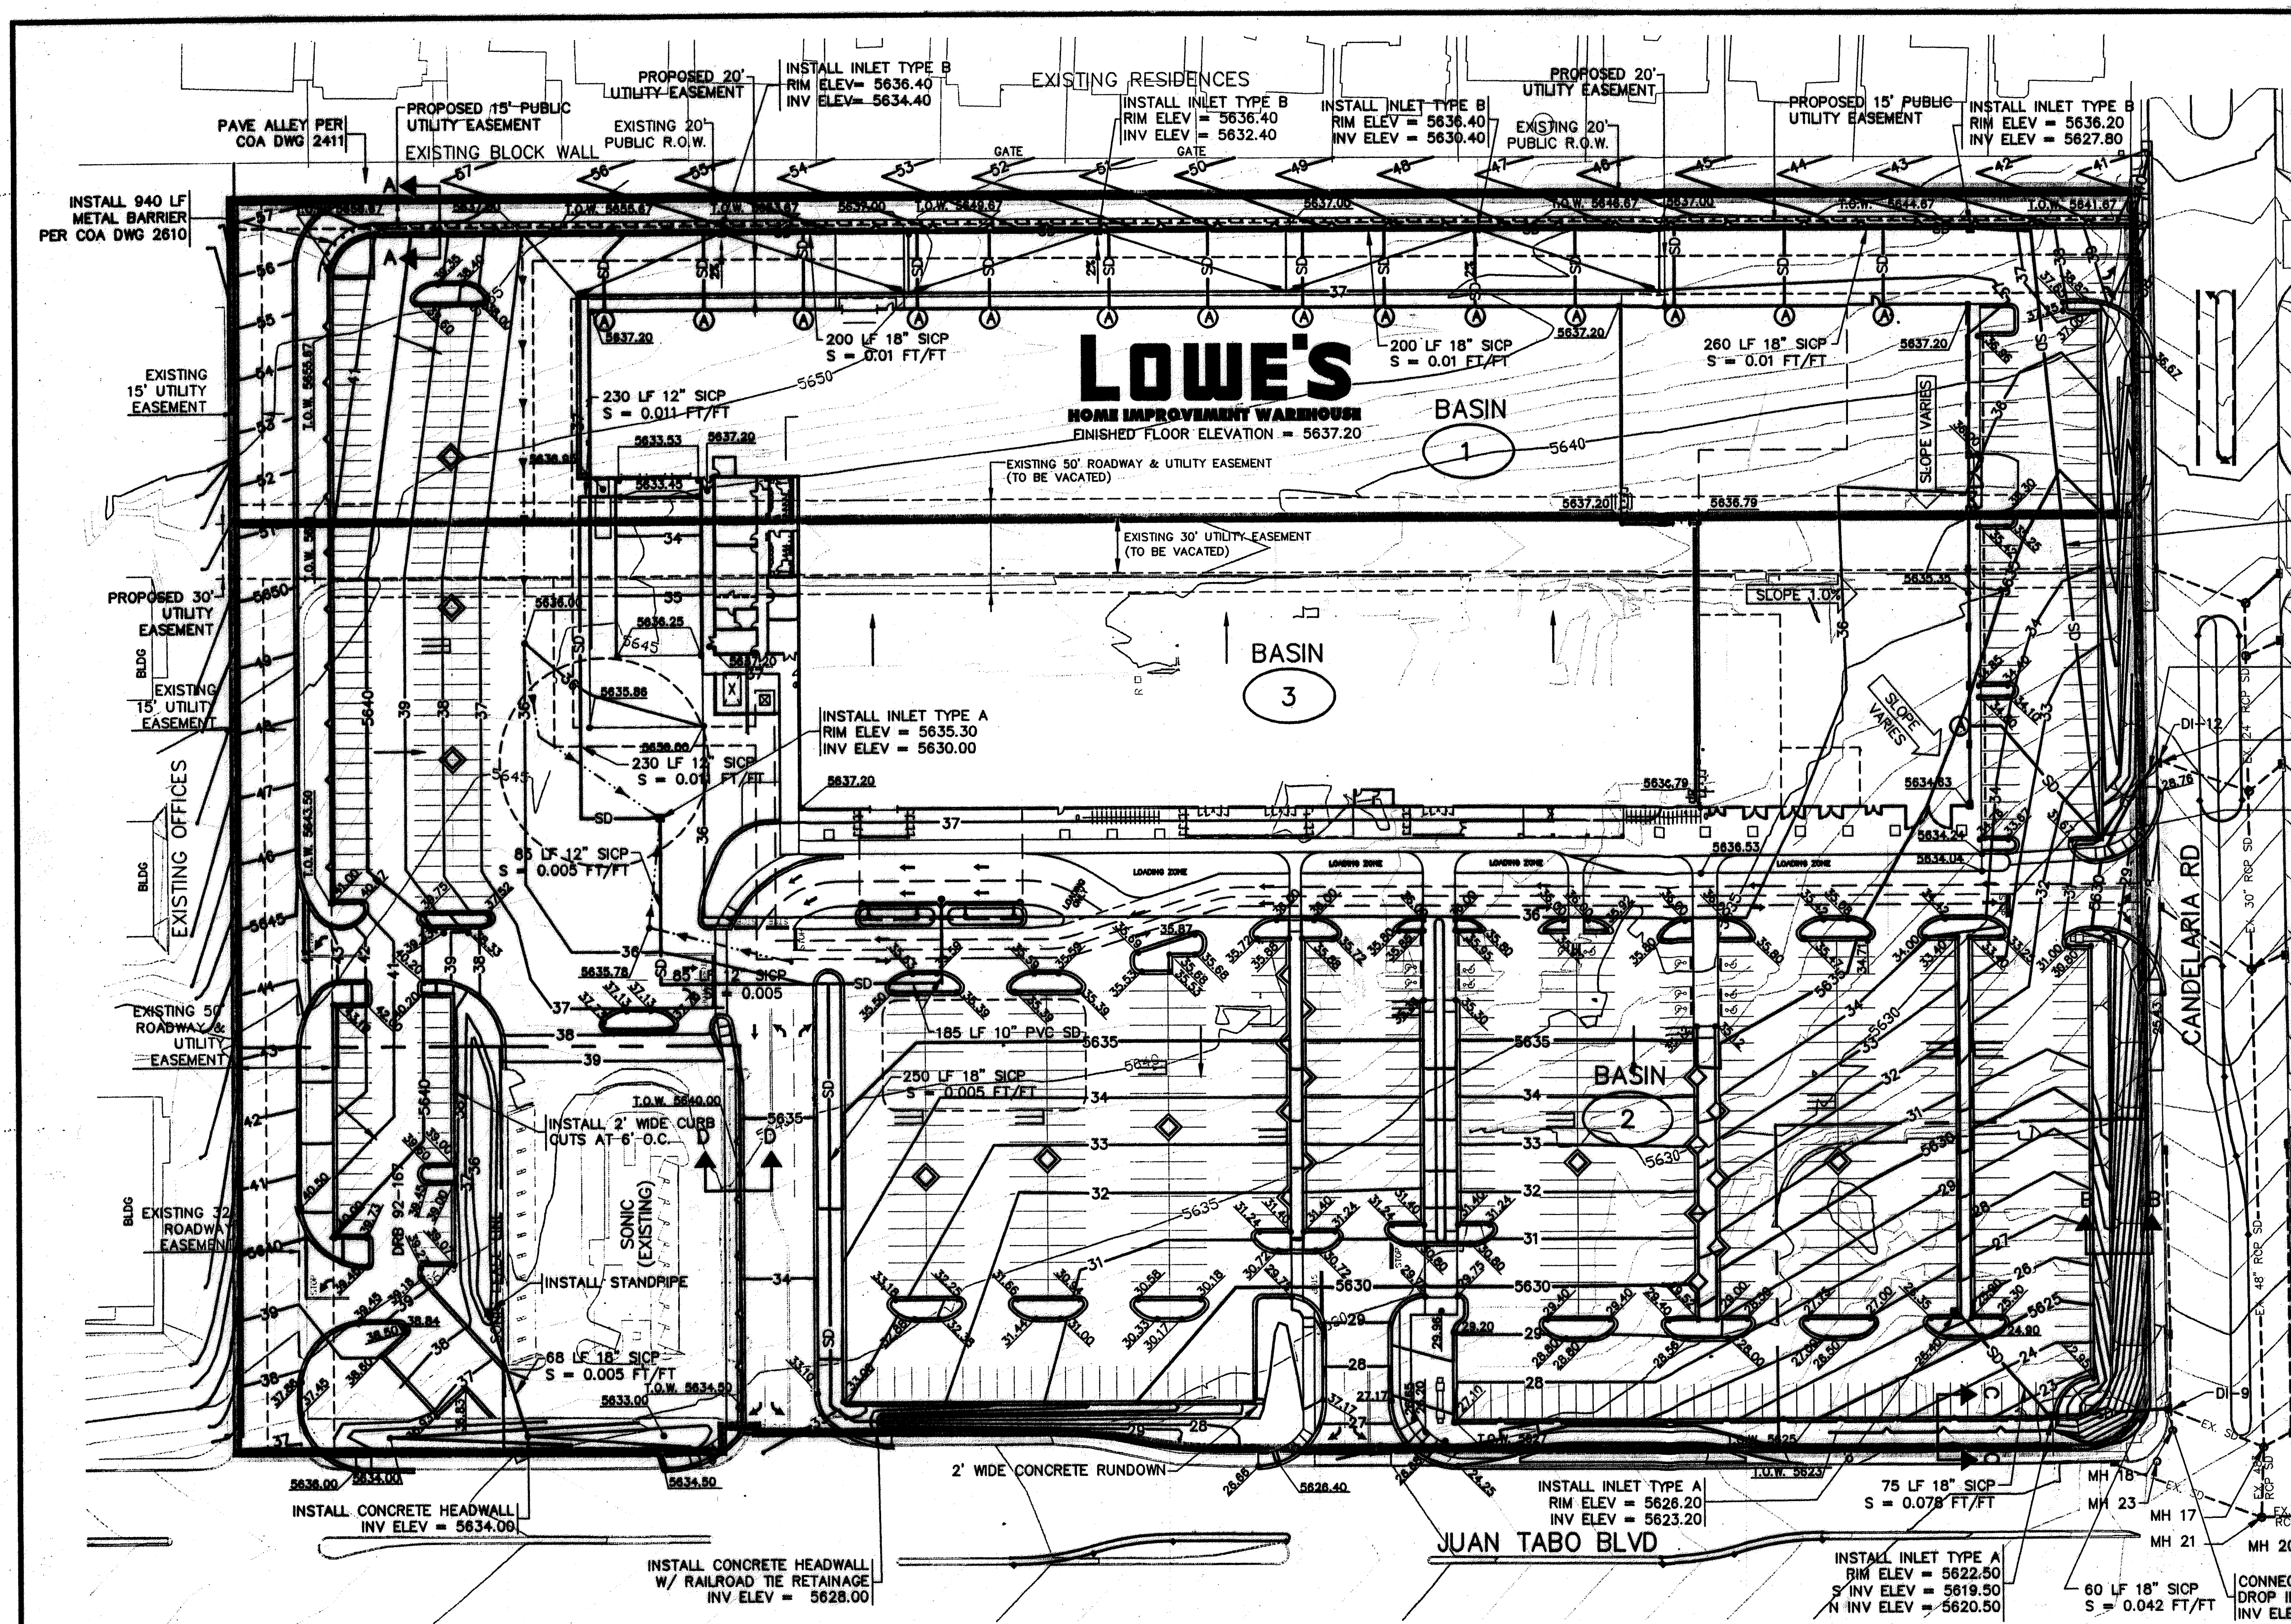

SOILS MAP
SCS BERNALILLO COUNTY SOIL SURVEY
SHEET NO. 22


BENCH MARK
THE STATION IS LOCATED 8.3 MILES NORTHEAST OF DOWNTOWN ALBUQUERQUE AT THE INTERSECTION OF JUAN TABO BLVD. N.E. & COMANCHE RD. N.E. TO REACH THE STATION FROM THE INTERCHANGE AT I-40 AND JUAN TABO BLVD., GO NORTH ON JUAN TABO 3.2 MILES TO THE STATION ON THE MALL. THE STATION MARK IS A STANDARD ACS BRASS TABLET STAMPED "ACS 2-G21-A 1978", DRILLED INTO THE TOP OF THE CONCRETE CURB. ELEVATION 5666.13

LEGAL DESCRIPTION
A CERTAIN PARCEL OF LAND SITUATE IN THE SOUTHEAST QUARTER (SW 1/4) OF SECTION 3, TOWNSHIP 10 NORTH, RANGE 3 EAST, NEW MEXICO PRINCIPAL MERIDIAN, CITY OF ALBUQUERQUE, BERNALILLO COUNTY, NEW MEXICO, AND COMPRISING ALL OF "R.P. TINNIN LAND" AS IS SHOWN ON THE "AMENDED AND CORRECTED" PLAN OF THE REDIVISION OF TINNIN SHOPPING CENTER" AS FILED WITH THE BERNALILLO COUNTY CLERK ON JUNE 20, 1972 IN VOLUME 86 FOLIO 173.

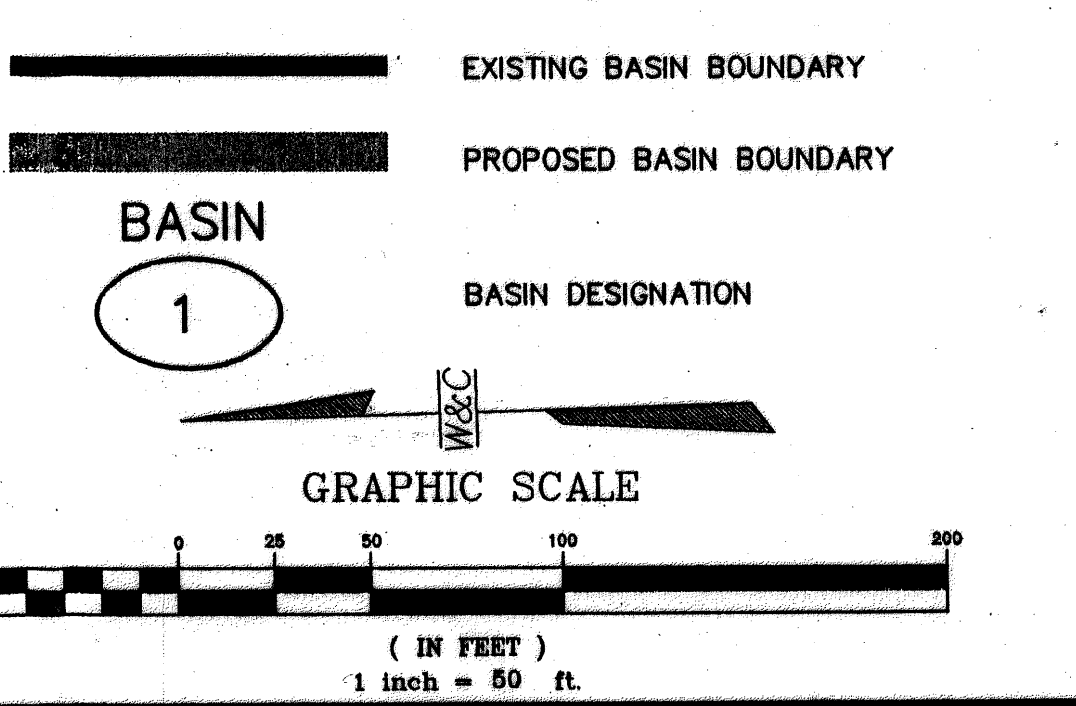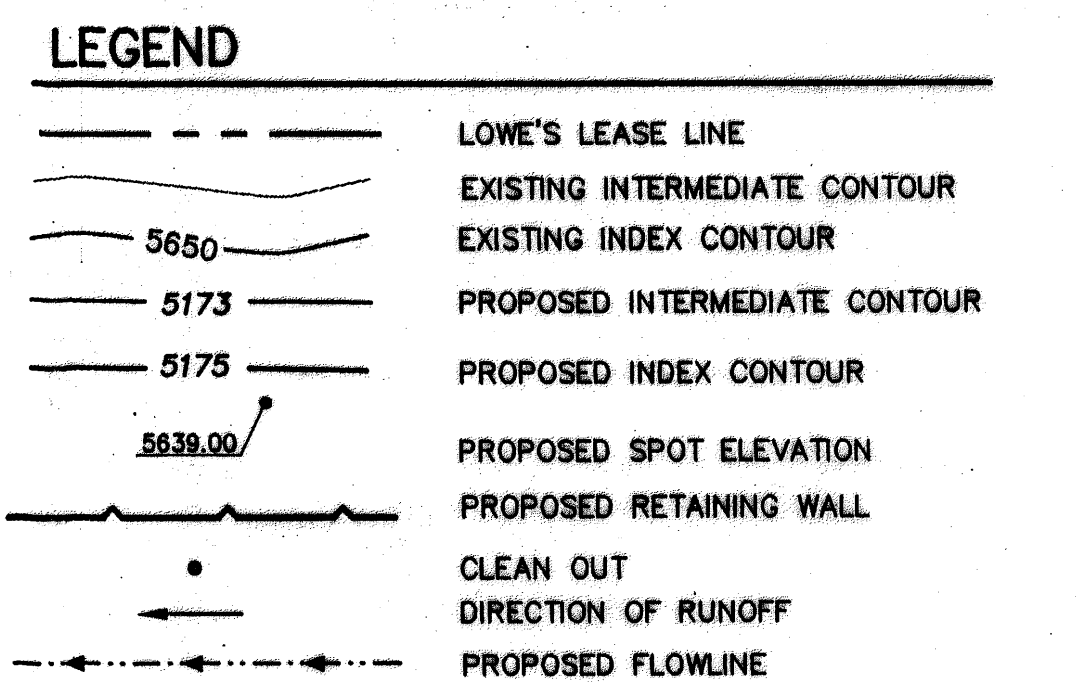

REVISIONS

DATE	DESCRIPTION
3/20/00	Revised Downspouts
4/20/00	D-downs, Tel, Irrigation
5/28/00	Hy Duty Conn Pmt, Bldg
	Limbs, Gen'l Revisions

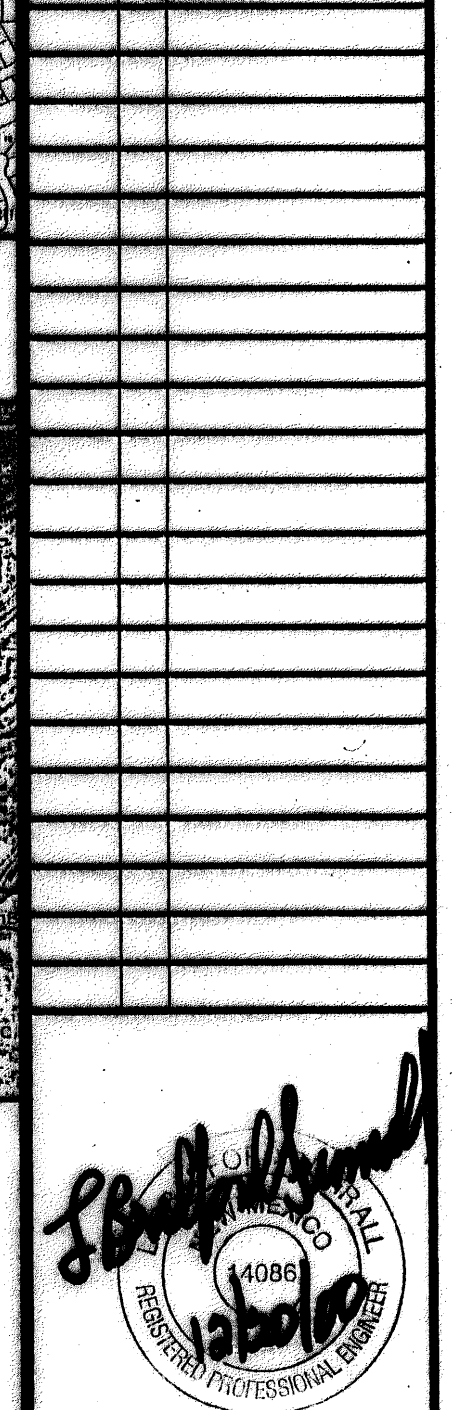

LOWE'S HOME CENTERS, INC.
12/00 COPYRIGHT
ALL RIGHTS RESERVED

LOWE'S

GRADING AND DRAINAGE PLAN
LOWE'S
JUAN TABO AND CANDELARIA
ALBUQUERQUE, NEW MEXICO

NOTES:

- CONSTRUCTION NOTES AND DETAILS ARE SHOWN ON SHEETS 2 OF 3 AND 3 OF 3.
- 10" SICP PIPE, CONNECT TO DOWNSPOUTS

EXISTING CONDITIONS

THE PROJECT SITE COVERS APPROXIMATELY 15.2 ACRES. SEVENTY PERCENT OF WHICH IS CURRENTLY DEVELOPED. THE SITE IS BOUNDED BY COMMERCIAL DEVELOPMENT TO THE NORTH, RESIDENTIAL TO THE EAST, JUAN TABO BLVD. TO THE WEST AND CANDELARIA RD. TO THE SOUTH. CURRENTLY THE SITE DRAINS SOUTHWESTERLY AS SURFACE FLOW AND ENTERS THE EXISTING STORM DRAINAGE SYSTEM AT THE INTERSECTION OF JUAN TABO AND CANDELARIA. NO OFF-SITE FLOWS CONTRIBUTE TO THE SITE. THE TABLE ALBUQUERQUE DPM SECTION 22.2 METHODOLOGY.

DEVELOPED CONDITIONS

ALL EXISTING STRUCTURES, EXCEPT SONIC, WILL BE DEMOLISHED AND REPLACED WITH AN APPROXIMATELY 124,000 SQUARE FOOT COMMERCIAL BUILDING WITH ASSOCIATED PARKING LOT AND LANDSCAPED AREAS. ALL RUNOFF FROM THE SITE WILL CONTINUE TO DISCHARGE TO THE INTERSECTION OF JUAN TABO AND CANDELARIA. TOTAL PEAK DISCHARGE INCREASES ONLY SLIGHTLY (3.63 CFS FOR 100 YEAR STORM) AS DOES TOTAL DISCHARGE VOLUME (0.34 AC-FT). SITE PEAK DISCHARGE IS EXPECTED TO ENTER THE STORM DRAINAGE SYSTEM WELL AHEAD OF THE PEAK EXPECTED FOR THE ENTIRE BASIN AND NOT ADVERSELY AFFECT CAPACITY WITHIN THE SYSTEM.

INPUT DATA

PRECIP. ZONE	RAINFALL DEPTHS (INCHES) AT 100-YEAR STORM				
	1 HOUR	6 HOUR	24 HOUR	4 DAY	10 DAY
4	2.23	2.90	3.65	4.70	5.95

HYDROLOGY SUMMARY

PROJECT NAME	JOB NUMBER	AREA (acres)	LAND TREATMENTS				2 YEAR		10 YEAR		100 YEAR				
			A	B	C	D	Q (cfs)	Q (cfs)	Q (cfs)	Q (cfs)					
LOWE'S EAST ALBUQUERQUE	X0218001	4.3900	0.0%	70.0%	30.0%	0.0%	2.46	0.0573	0.0573	7.36	0.1981	0.1981	13.76	0.4328	0.4328
EXISTING	LOWE'S E ABQ SITE	11.0000	0.0%	0.0%	3.0%	97.0%	23.48	0.9055	1.1949	38.84	1.5228	1.9678	57.25	2.3878	3.0844
PROPOSED	LOWE'S E ABQ SITE	15.3500	0.0%	15.0%	2.5%	82.5%	28.74	1.0956	1.4391	49.42	1.8951	2.4250	74.64	3.0399	3.8314

STORM DATA:

- MH-15 STORM: RIM ELEV = 5626.20', NE INV ELEV = 5620.58' (18"), E INV ELEV = 5619.70' (30"), S INV ELEV = 5621.29' (18"), W INV ELEV = 5619.16' (30")
- MH-21 STORM: RIM ELEV = 5617.45', E INV ELEV = 5609.41' (4"), S INV ELEV = 5608.65' (4")
- MH-23 STORM: RIM ELEV = 5618.01', NE INV ELEV = 5615.03' (18"), NW INV ELEV = 5615.10' (18")
- MH-17 STORM: N RIM ELEV = 5617.82', E INV ELEV = 5610.06' (48"), SW INV ELEV = 5613.80' (18"), W INV ELEV = 5609.96' (48"), W TOP OF PIPE ELEV = 5614.43'
- MH-18 STORM: RIM ELEV = 5618.32', NE INV ELEV = 5613.65' (18"), S INV ELEV = 5613.47' (18"), NW INV ELEV = 5614.83' (18")
- MH-20 STORM: RIM ELEV = 5617.24', N INV ELEV = 5608.58' (4"), S INV ELEV = 5607.68', SW INV ELEV = 5611.64' (18"), W INV ELEV = 5611.08' (18")
- MH-9: RIM ELEV = 5619.39', INV ELEV = 5614.73'
- MH-12: RIM ELEV = 5629.20', INV ELEV = 5624.51'

NOTICE TO CONTRACTOR

- AN EXCAVATION/ CONSTRUCTION PERMIT WILL BE REQUIRED BEFORE BEGINNING ANY WORK WITHIN CITY RIGHT-OF-WAY.
- ALL WORK DETAILED ON THESE PLANS TO BE PERFORMED, EXCEPT AS OTHERWISE STATED OR PROVIDED HEREON, SHALL BE CONSTRUCTED IN ACCORDANCE WITH CITY OF ALBUQUERQUE INTERIM STANDARD SPECIFICATIONS FOR PUBLIC WORKS CONSTRUCTION, 1985.
- TWO WORKING DAYS PRIOR TO ANY EXCAVATION, CONTRACTOR MUST CONTACT LINE LOCATING SERVICE, 765-1234, FOR LOCATION OF EXISTING UTILITIES.
- PRIOR TO CONSTRUCTION, THE CONTRACTOR SHALL EXCAVATE AND VERIFY THE HORIZONTAL AND VERTICAL LOCATIONS OF ALL CONSTRUCTIONS. SHOULD A CONFLICT EXIST, THE CONTRACTOR SHALL NOTIFY THE ENGINEER, SO THAT THE CONFLICT CAN BE RESOLVED WITH A MINIMUM AMOUNT OF DELAY.
- BACKFILL COMPACTION SHALL BE ACCORDING TO TRAFFIC/STREET USE.
- MAINTENANCE OF THESE FACILITIES SHALL BE THE RESPONSIBILITY OF THE OWNER OF THE PROPERTY SERVED.
- WORK ON ARTERIAL STREETS SHALL BE PERFORMED ON A 24-HOUR BASIS.

APPROVALS

NAME	DATE
WILSON & COMPANY	
HYDROLOGIST	
INSPECTOR	
WCEA # X0218001	

LOWE'S EAST ALBUQUERQUE
MAP NO. G-22

WILSON & COMPANY
2600 THE AMERICAN ROAD SE, SUITE 100
RIO RANCHO, NEW MEXICO 87124
(505) 898-8021

DATE
DECEMBER 2000

FILE NO.
X0218001

SHEET NO.
1 of 3

DRAWN BY
MDG

DESIGN
BMS

CHECKED BY
LBS



DATE
DECEMBER 2000

PERMIT SET ISSUE DATE
DECEMBER 2000

CONTRACT SET ISSUE DATE
DECEMBER 2000

SHEET
5 OF 11

T:\PUBLIC\PROJECTS\X0218001\ASHEETS\X0218001.DWG 12-14-00 MDG

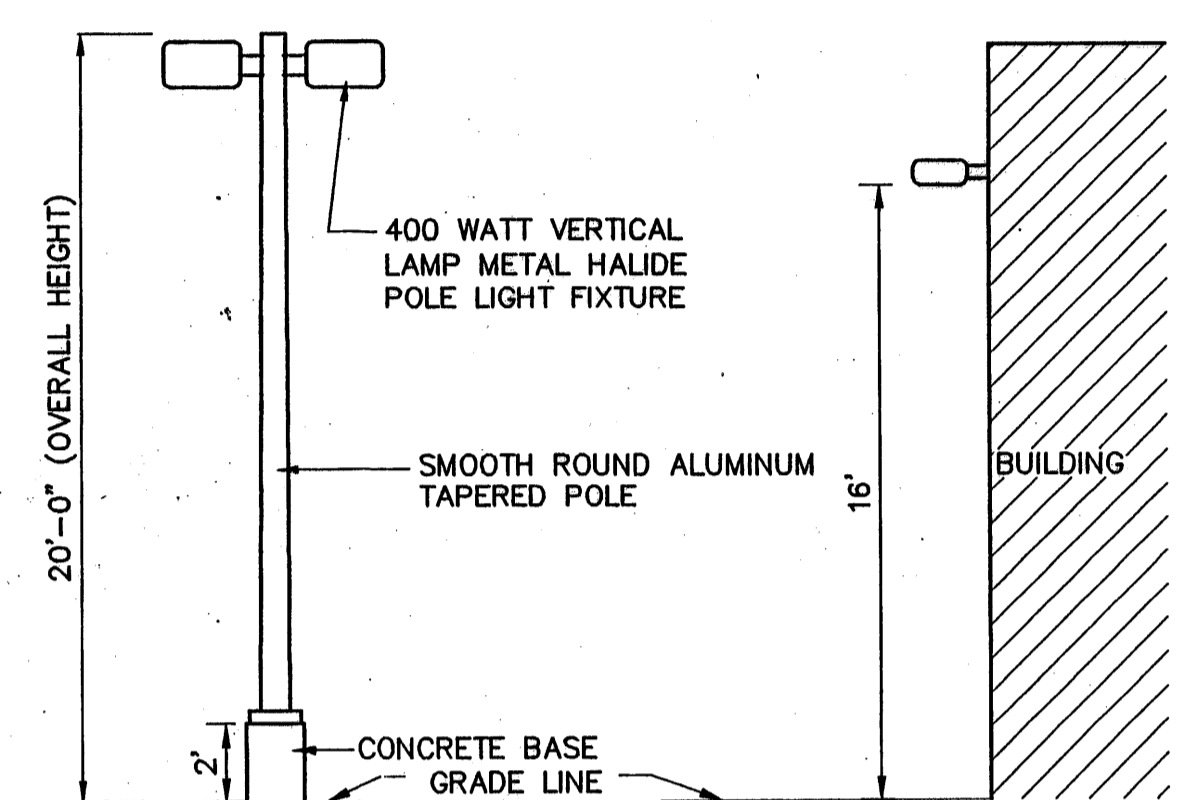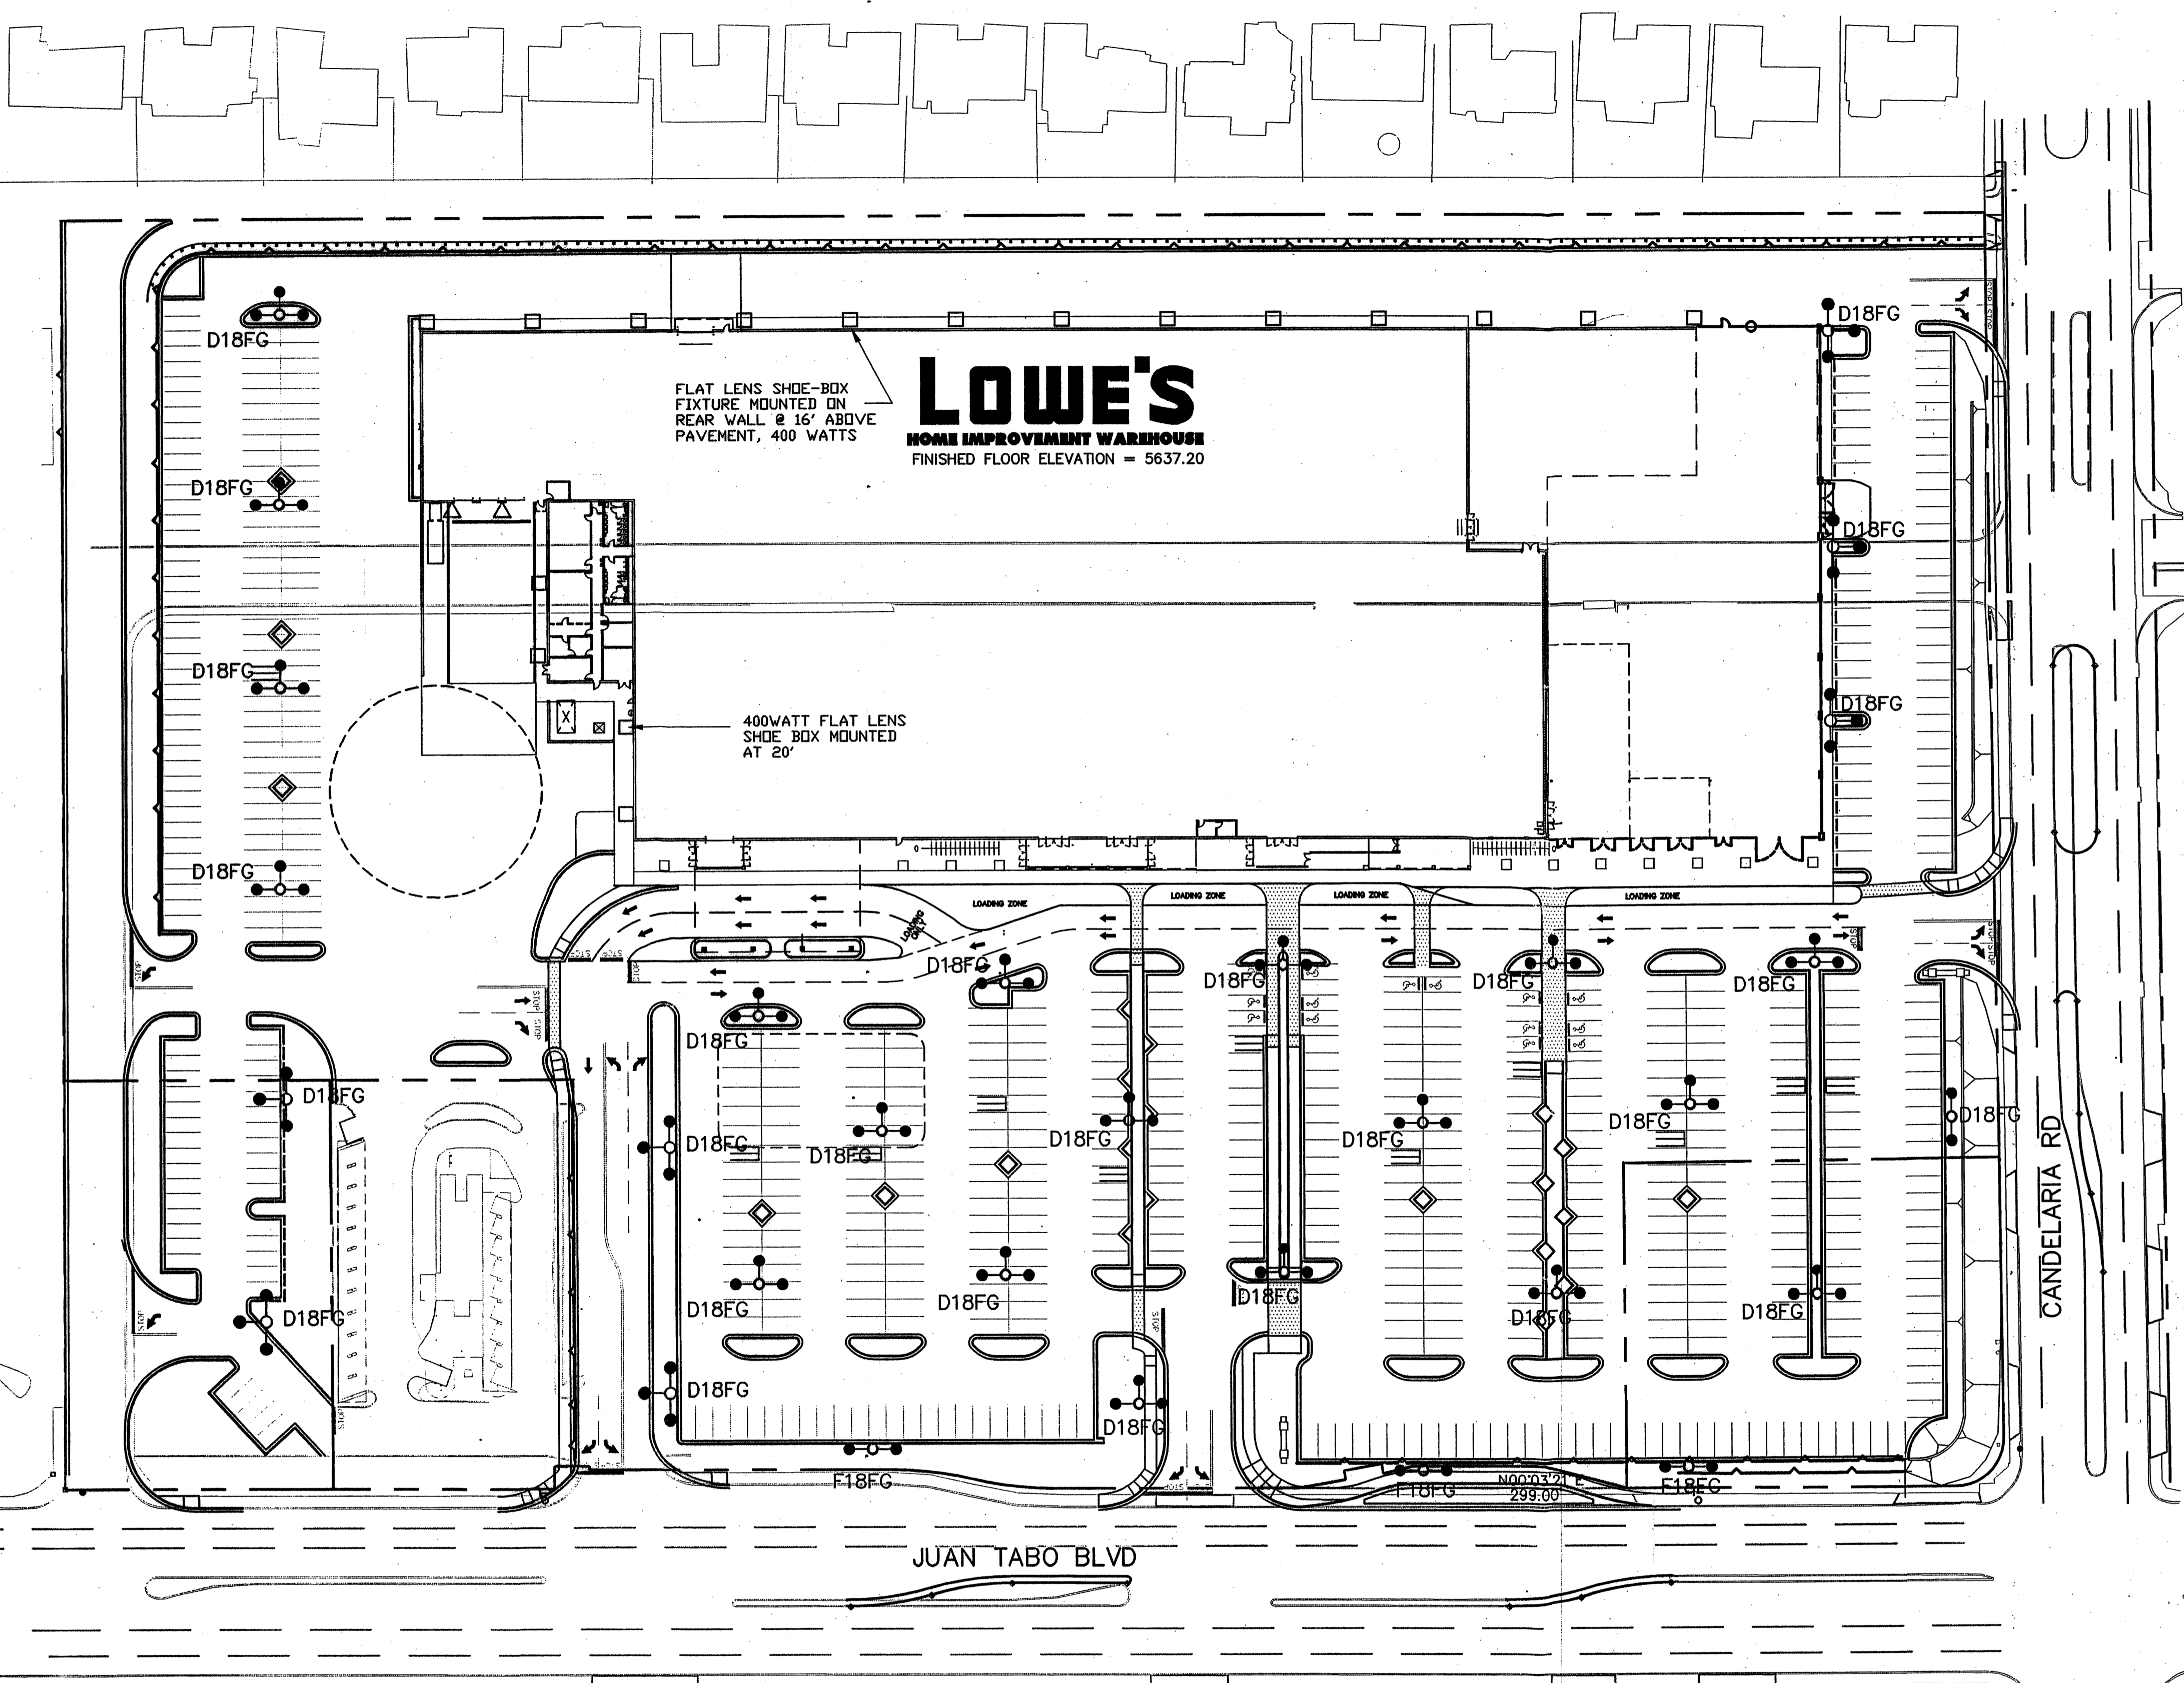


TYPICAL LIGHT POLE (1-3 LUMINAIRES)
SCALE: 1" = 5'

WALL MOUNTED LIGHT
SCALE: 1" = 5'

NOTE:
ALL LIGHT FIXTURES SHALL BE FULLY SHIELDED CUT-OFF HORIZONTAL LAMPS WITH LENSES NOT PROJECTING BELOW THE FIXTURE SURFACE.

ALL LIGHT POLES ARE 20' TOTAL HEIGHT WITH 400WATT FIXTURES FLAT LENS

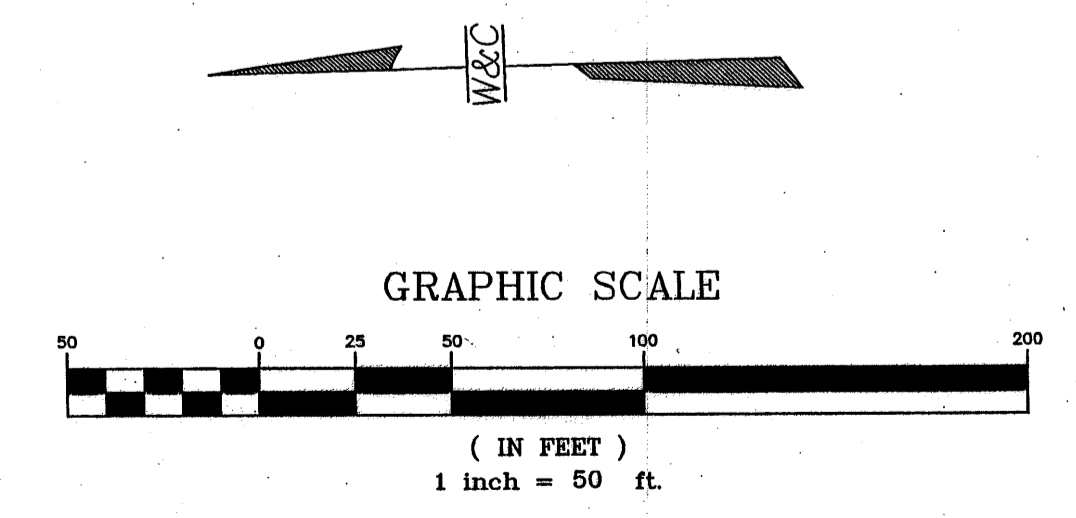

REVISIONS	
DATE	DESCRIPTION
3/30/00	Revised Downspouts
4/20/00	D-spouts, Tel. Irrigation
5/25/00	Hwy Duty Conc Pmt, Bldg Limits, Gen'l Revisions

LOWE'S HOME CENTERS, INC.
12/00 COPYRIGHT
ALL RIGHTS RESERVED

LOWE'S


P. O. Box 1111 N. Wilkesboro, N. C. 28656

SITE LIGHTING PLAN

LOWE'S
JUAN TABO AND CANDELARIA
ALBUQUERQUE, NEW MEXICO

DRAWN MDG	WILSON & COMPANY 2600 THE AMERICAN ROAD SE, SUITE 100 RIO RANCHO, NEW MEXICO 87124 (505) 898-8021	DATE DECEMBER 2000	DRAWN BY MDG
DESIGN BMS		FILE NO. X0218001	CHECKED LBS
CHECKED BY LBS	SHEET NO. 1 of 1	SHEET 9 of 11	PERMIT SET ISSUE DATE
			CONTRACT SET ISSUE DATE

T:\PUBLIC\PROJECTS\X0218001\AS\SHETS\8001LT.DWG(12-14-00)MDS

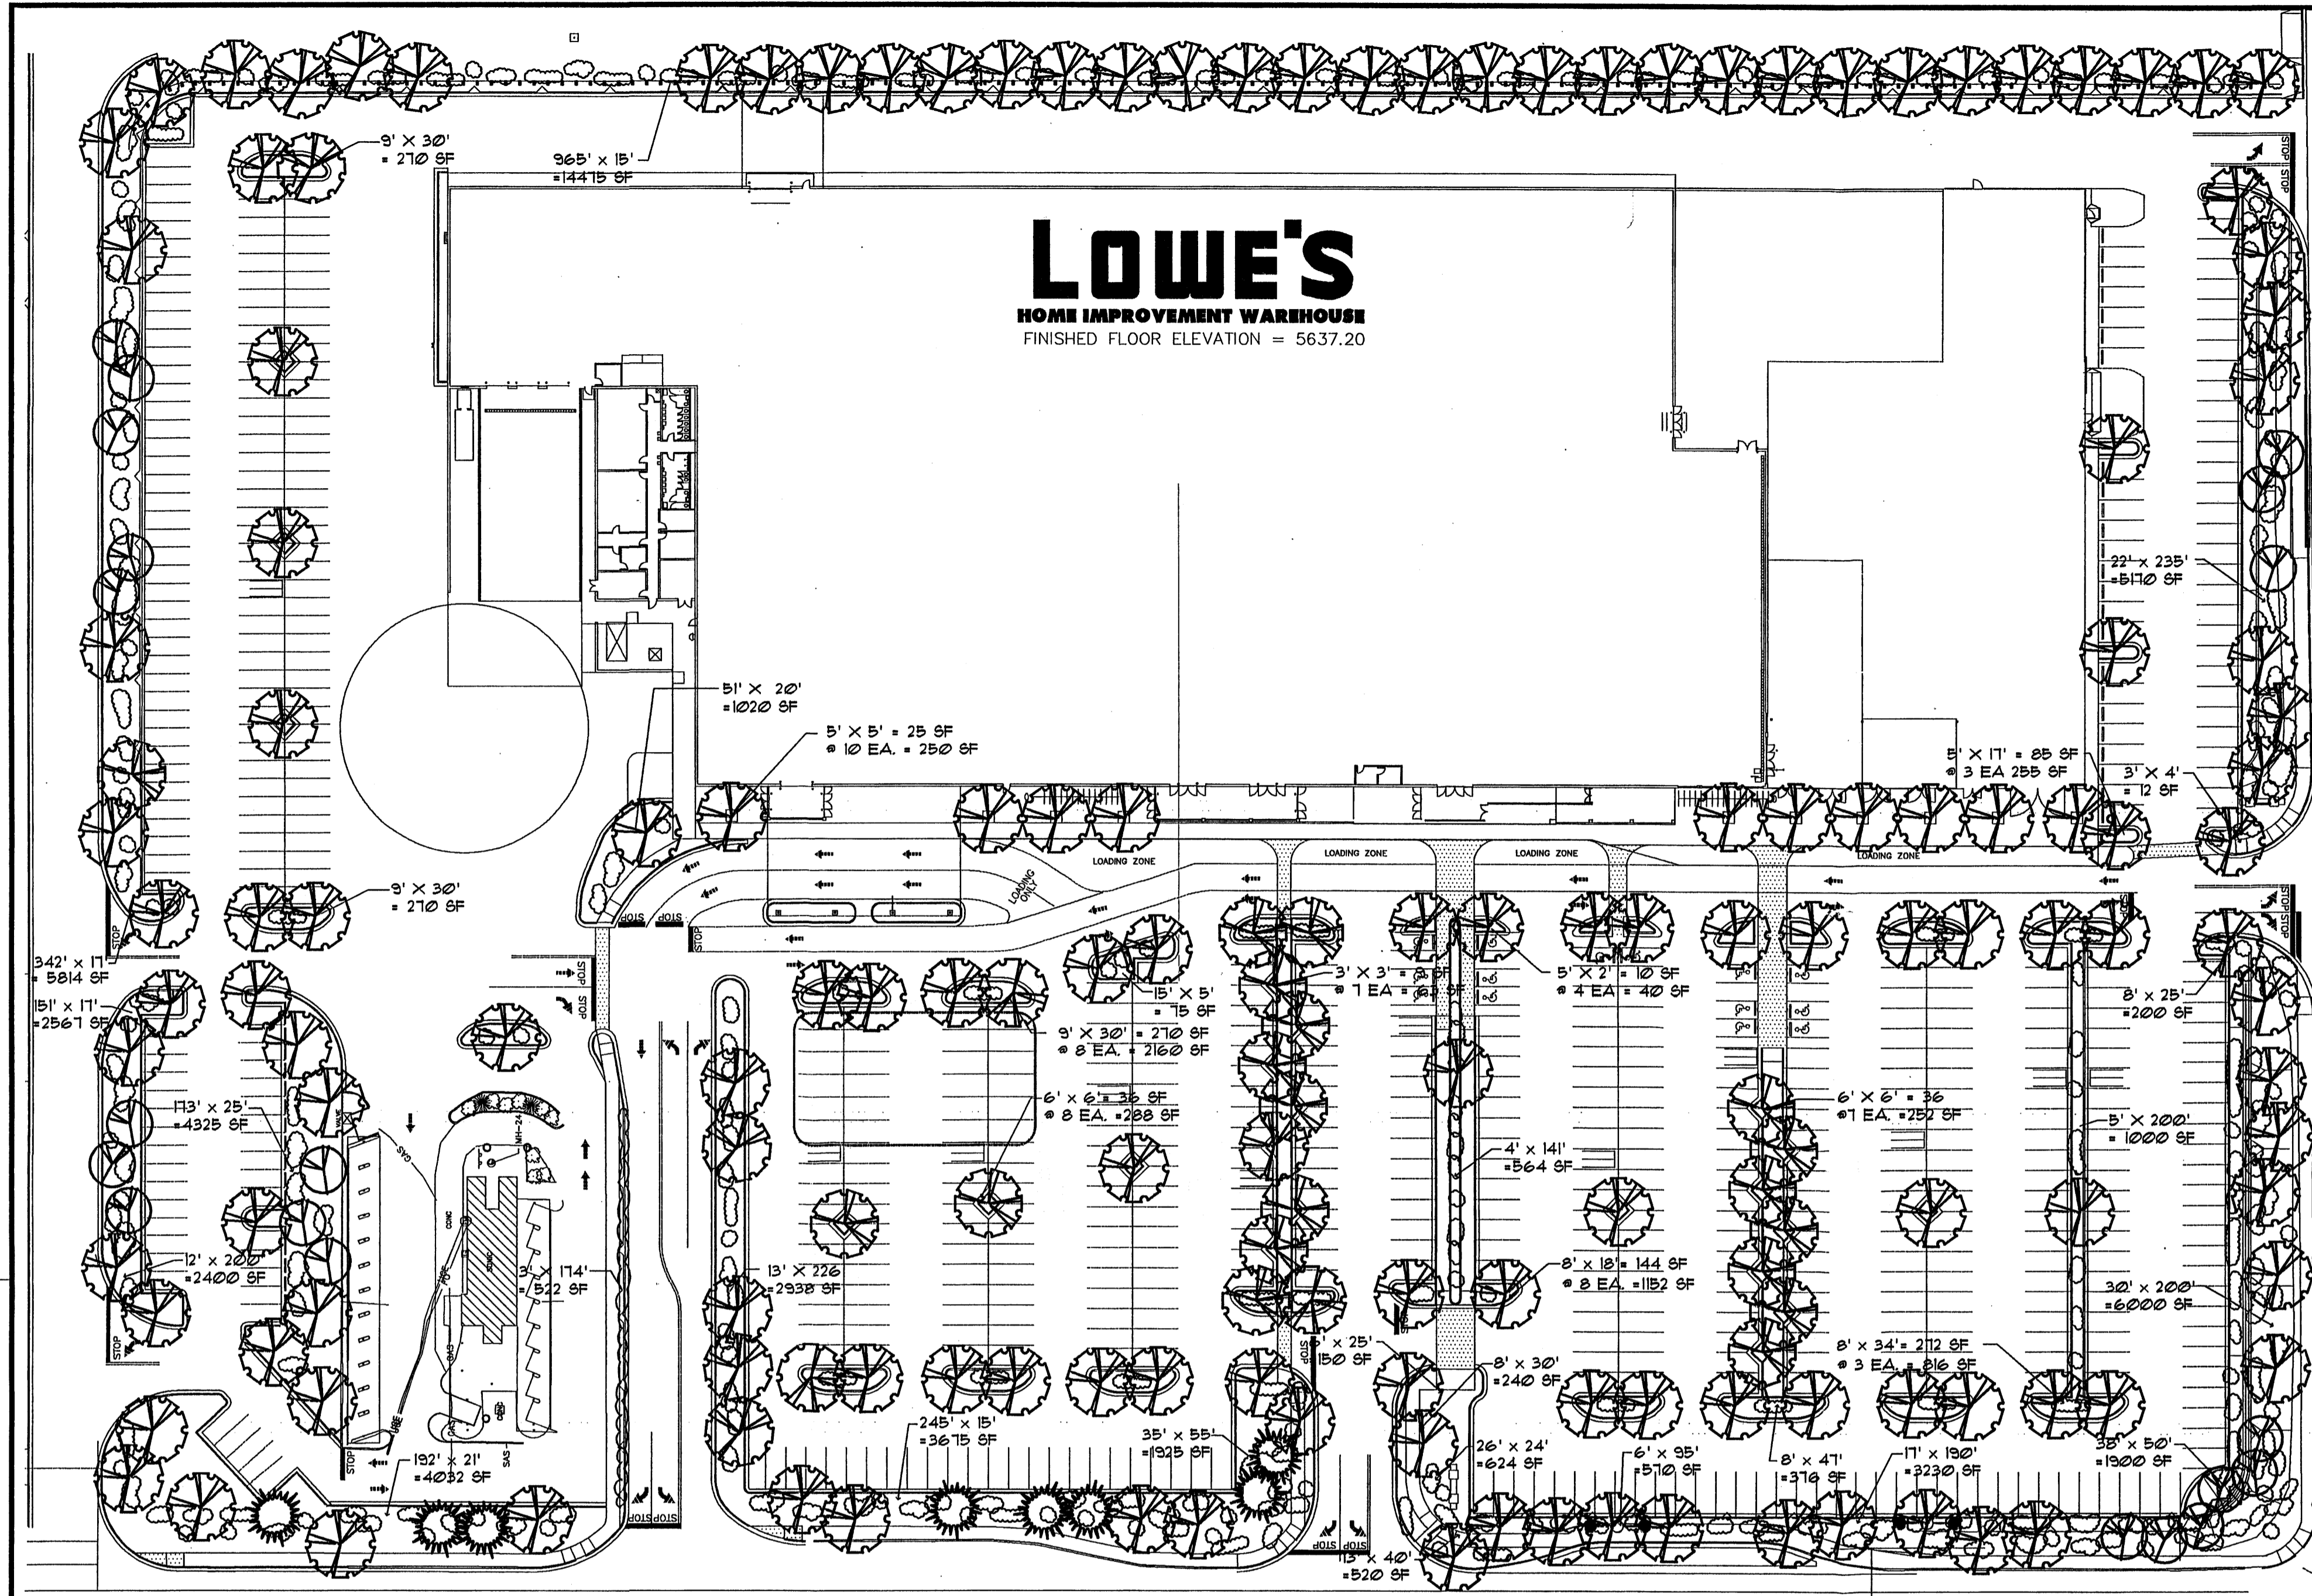

LOWE'S
HOME IMPROVEMENT WAREHOUSE
FINISHED FLOOR ELEVATION = 5637.20

- LANDSCAPING NOTES**
- THIS PLAN IS IN COMPLIANCE WITH THE CITY OF ALBUQUERQUE WATER AND CONSERVATION LANDSCAPING AND WATER WASTE ORDINANCE, ENACTMENT NO. 18-1995.
 - THIS PLAN IS IN COMPLIANCE WITH THE CITY OF ALBUQUERQUE STREET TREE ORDINANCE.
 - LANDSCAPE REQUIREMENT**
A. NET LOT AREA: 499,000 SF
B. LANDSCAPE AREA REQUIRED: (15% OF NET) 69,850 SF
C. LANDSCAPE AREA PROVIDED: 69,620 SF (15% OF NET)
 - AN AUTOMATIC DRIP OR BUBBLER IRRIGATION SYSTEM WILL BE PROVIDED.
 - THE OWNER WILL ASSUME RESPONSIBILITY FOR THE MAINTENANCE OF THE LANDSCAPE.
 - A 3" DEPTH OF 3/4" CRUSHED GRAVEL MULCH SHALL BE INSTALLED THROUGHOUT ALL PLANTING BEDS. COLOR SHALL BE MOUNTAIN ROSE.
 - AT MATURITY, PLANTS (SHRUBS AND GROUNDCOVERS) SHALL COVER A MINIMUM OF 15% OF THE PLANTING BEDS.

PLANT LIST


SYMBOL	COMMON NAME	BOTANICAL NAME	QUANTITY	SIZE	
				INSTALLED	MATURE
SHADE TREES (2" GAL.)			154		
☉	Autumn Purple Ash	Fraxinus americana 'Autumn Purple'		12'-14" ht. 2" cal.	40' ht. 30" epd.
☉	Chinese Pistache	Pistacia chinensis		12'-14" ht. 2" cal.	40' ht. 30" epd.
☉	Honey Locust	Gleditsia triacanthos 'Imperial'		12'-14" ht. 2" cal.	40' ht. 30" epd.
☉	Littleleaf Linden	Tilia cordata		12'-14" ht. 2" cal.	40' ht. 25' epd.
ACCENT TREES (2" GAL.)			23		
☉	Desert Willow	Chilopsis linearis		8'-10" ht.	25' ht. 20" epd.
☉	Goldenrain Tree	Koeleria paniculata		2" cal. 8'-10" ht.	25' ht. 20" epd.
☉	Washington Hawthorn	Crataegus phaeopyrum		8'-10" ht.	20' ht. 20" epd.
EVERGREEN TREES (4'-6" ht.)			8		
☉	Afghan Pine	Pinus eiderica		4'-6" ht.	40' ht. 20" epd.
☉	Leyland False Cypress	Cupressocyprip leylandii		4'-6" ht.	30' ht. 20" epd.
ACCENT SHRUBS			12		
☉	New Mexico Olive	Forestiera neomexicana		4'-6" ht. 15 gal.	15' ht. 15' epd.
SHRUBS/GROUNDCOVERS (1 gal.)			400		
☉	Apache Plume	Fallugia paradoxa		8"-12" ht. 1 gal.	5' ht. 4' epd.
☉	Bearberry Cotoneaster	Cotoneaster dameri		12" min. epd. 1 gal.	24" ht. 6" epd.
☉	Bird of Paradise	Cassipoula gilliesii		18" min. ht. 1 gal.	18" ht. 4' epd.
☉	Buffalo Juniper	Juniperus exoni 'Buffalo'		12" min. epd. 1 gal.	10" ht. 6' epd.
☉	Butterfly Bush	Buddleia davidii		18" min. ht. 1 gal.	6' ht. 4' epd.
☉	Maiden Grass	Miscanthus sinensis 'Gracillimus'		min. 12" ht. 1 gal.	6' ht. 5' epd.
☉	New Mexico Olive	Forestiera neomexicana		4'-6" ht. 1 gal.	13' ht. 10' epd.
☉	Regal Mist	Muhlenbergia 'Regal Mist'		min. 10" ht. 1 gal.	2' ht. 4' epd.
☉	Rosemary	Rosmarinus officinalis		12" min. epd. 1 gal.	3' ht. 4' epd.
☉	Rubber Rabbitbrush	Potentilla fruticosa		12" min. ht. 1 gal.	5' ht. 4' epd.
☉	Shrubby Cinquefoil	Chrysothamnus nauseosus		12" min. ht. 1 gal.	3' ht. 4' epd.
☉	Three Leaf Sumac	Rhus trilobata		18" min. ht. 1 gal.	5' ht. 4' epd.
☉	Yucca	Yucca glauca		min. 12" ht. 1 gal.	12" ht. 10" epd.
☉	Zebra Grass	Miscanthus sinensis 'Zabrinus'		min. 12" ht. 1 gal.	4' ht. 3' epd.

REVISIONS

DATE	DESCRIPTION
3/30/00	Revised Downspouts
4/26/00	D-spouts, Tel, Irrigation
5/26/00	Hy Duty Conc Pmnt, Bldg Limits, Gen'l Revisions


LOWE'S COMPANIES, INC.
MAY, 1999 COPYRIGHT
ALL RIGHTS RESERVED

LOWE'S
Companies, Inc.
P. O. Box 11111 N. Wilkesboro, N. C. 28665

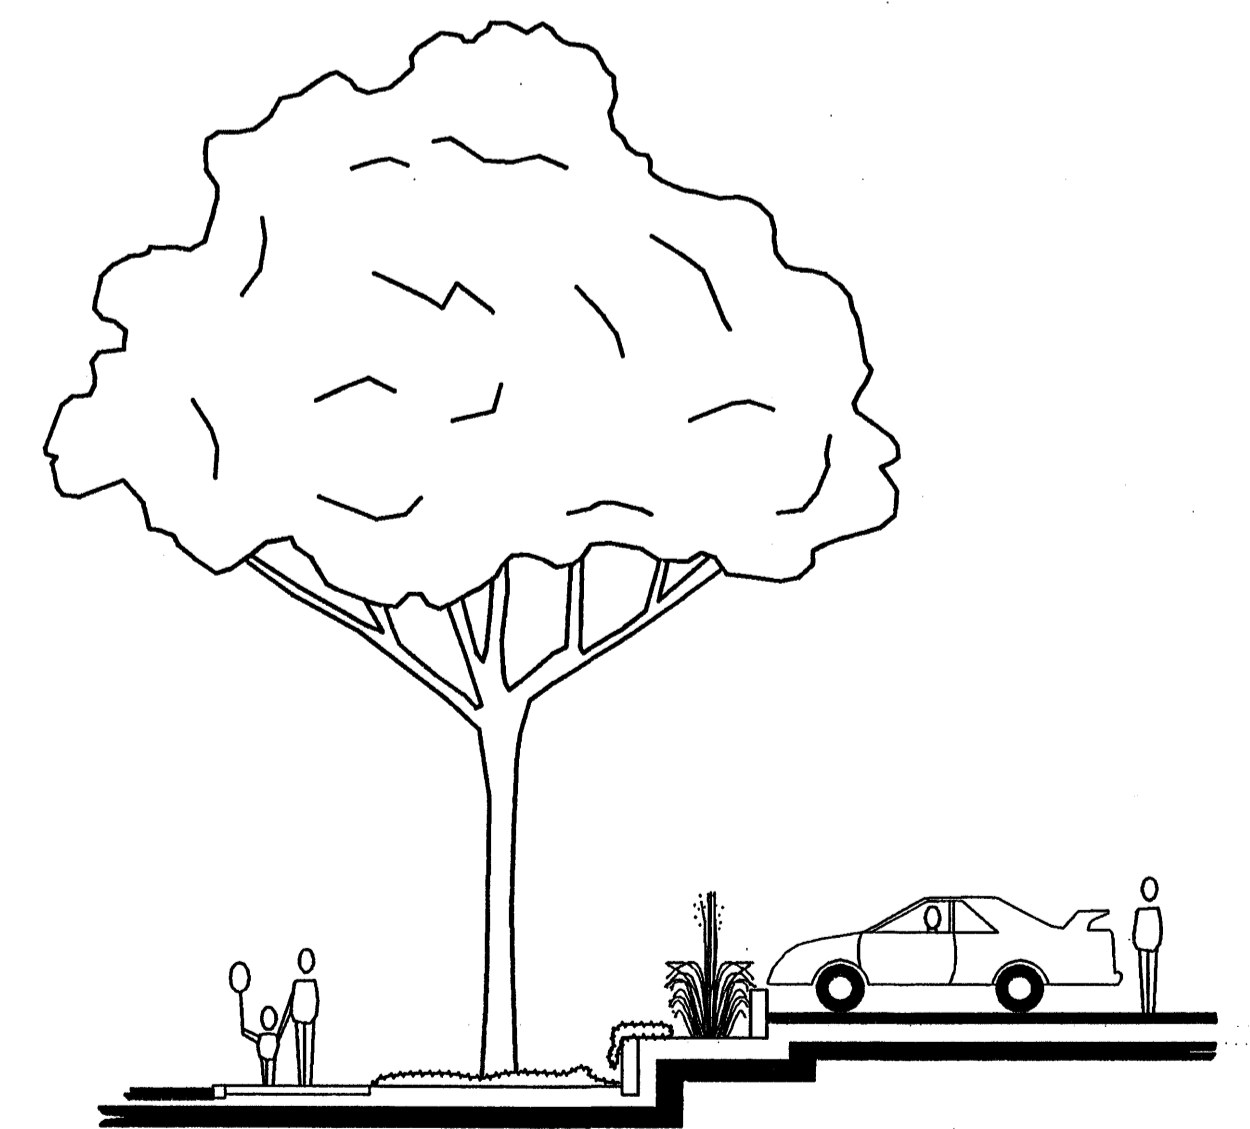

SECTION

SCALE: 1/8"=1'-0"


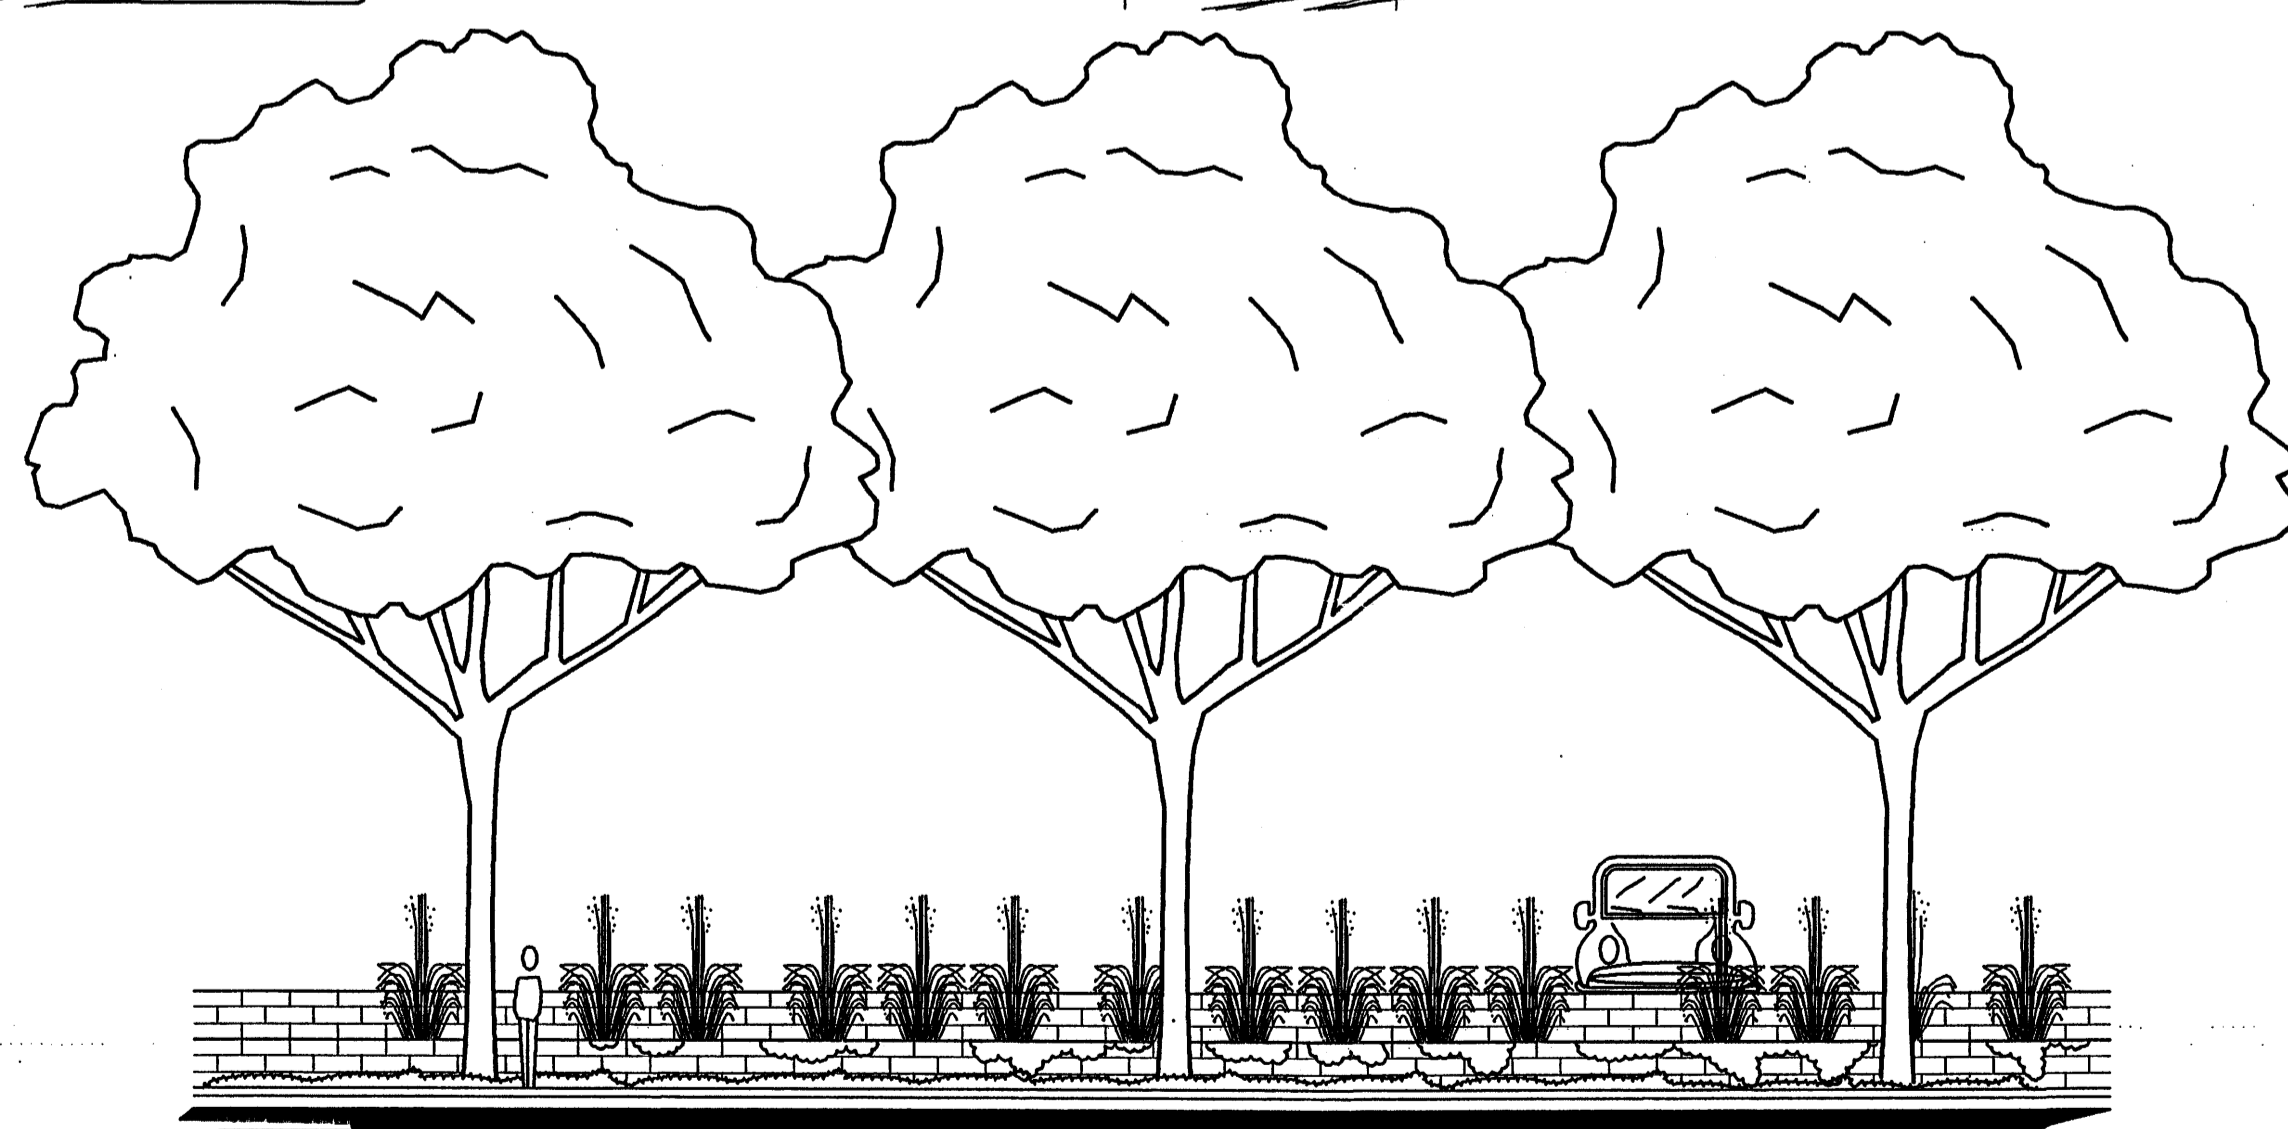


ELEVATION

SCALE: 1/8"=1'-0"

LANDSCAPE / RETAINING WALL @ SOUTHWEST CORNER


MORROW READON WILKINSON LTD.
LANDSCAPE ARCHITECTS
210 La Vista NE, Albuquerque, NM 87108
505.266.2266 FAX 505.265.9637
morrow.co@integrity.com

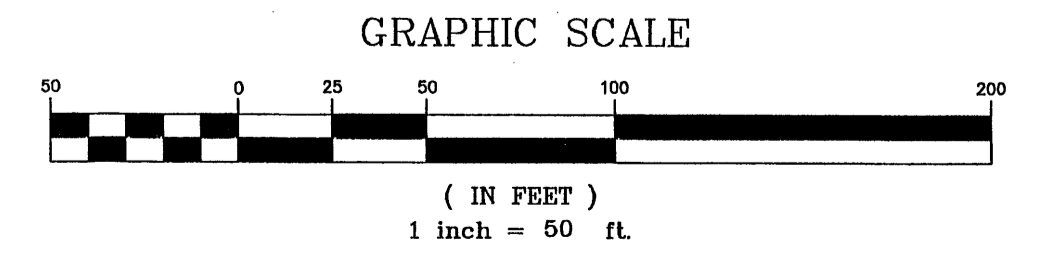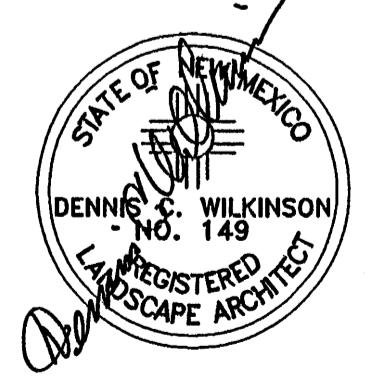


LANDSCAPE PLAN
LOWE'S
JUAN TABO AND CANDELARIA
ALBUQUERQUE, NEW MEXICO

DRAWN BY	JSP
CHECKED	ERC
PERMIT SET	
ISSUE DATE	12/2000
CONTRACT SET	
ISSUE DATE	


SHEET
10
OF 11

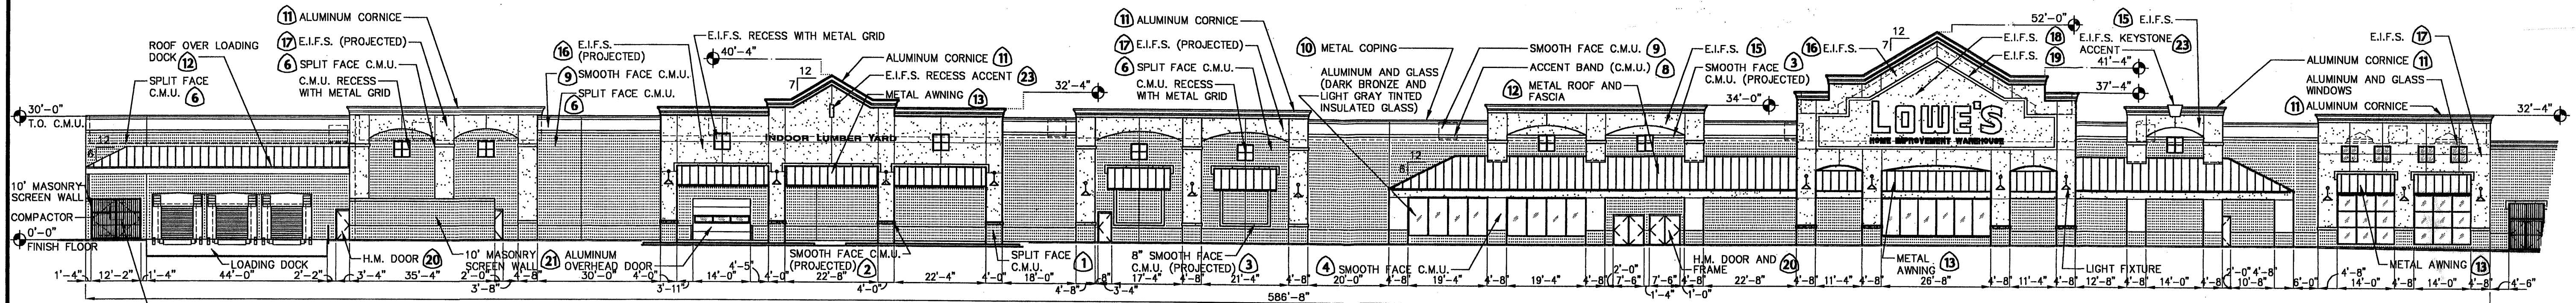


WEST ELEVATION
SCALE: 1" = 20'-0"

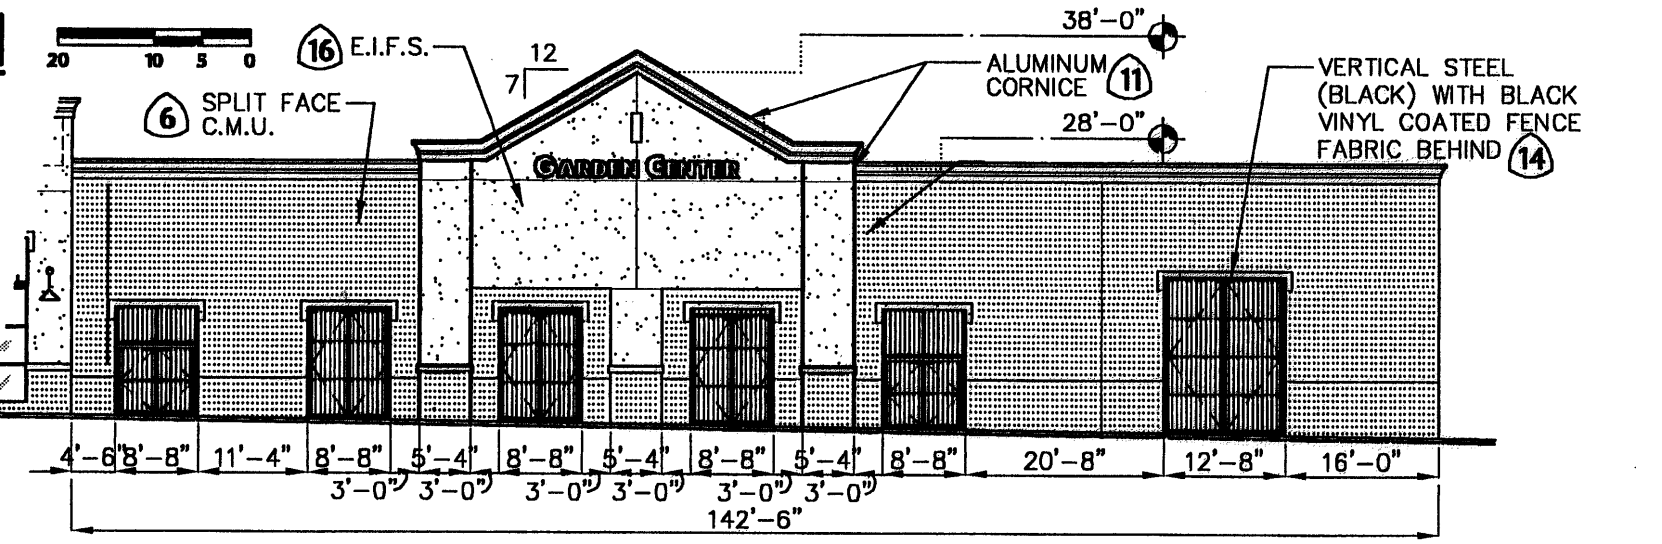

WEST ELEVATION
SCALE: 1" = 20'-0"

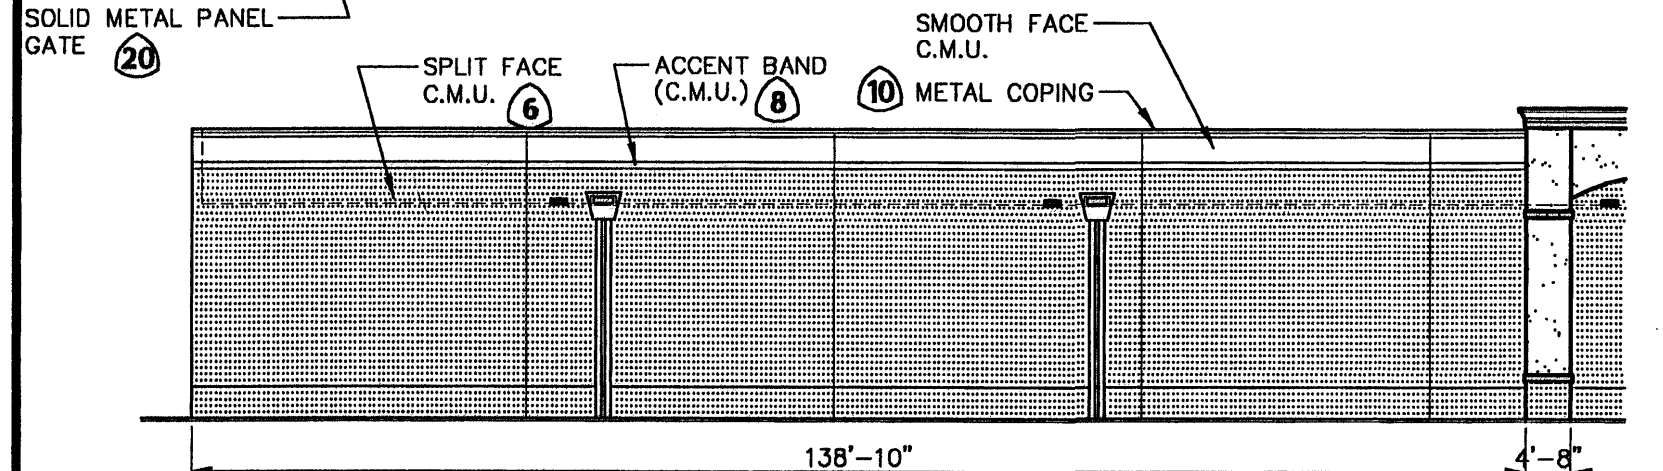


EAST ELEVATION
SCALE: 1" = 20'-0"

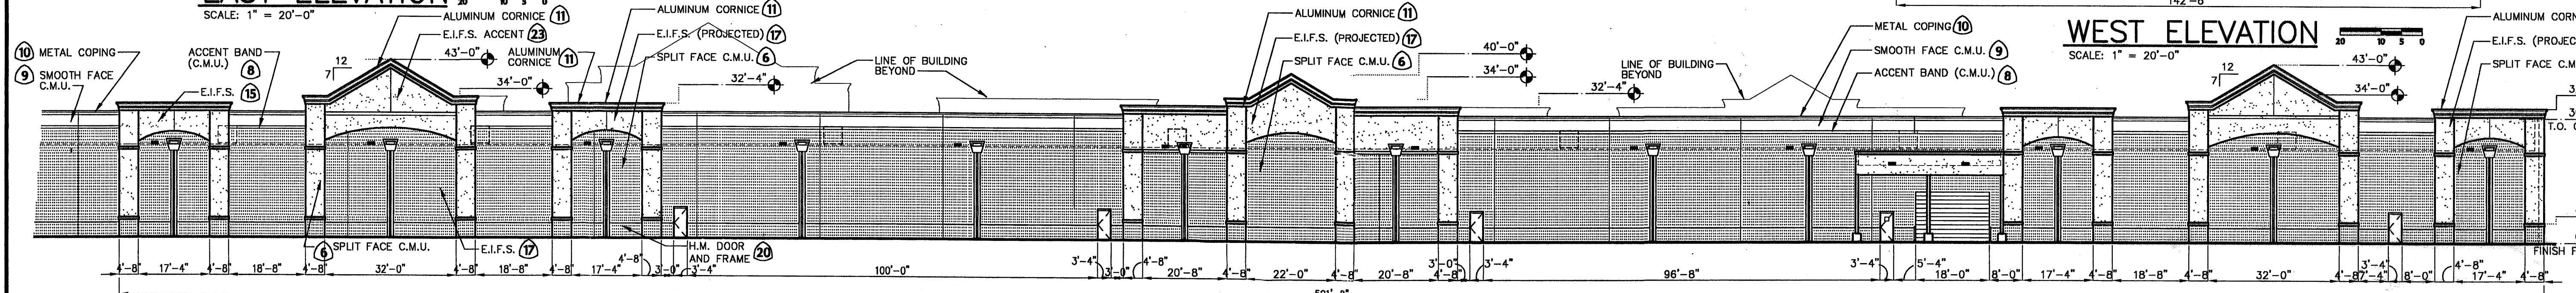


EAST ELEVATION
SCALE: 1" = 20'-0"


#	DESCRIPTION	LOCATION	COLOR SELECTION
1	Split face CMU at the base of the masonry columns.	Finish Floor to +4'-0" AFF	COFFEE HOUSE
2	Smooth face CMU projections (8" high) at CMU columns.	+4'-0" AFF	COFFEE HOUSE
3	Smooth face CMU projections (8" high) at CMU columns.	+20'-0" AFF	SOMBRERO
4	Smooth face CMU at CMU columns.	+4'-8" AFF to Canopy Fascia.	BEACH HOUSE
5	Split face CMU walnoot at the main building.	Finish Floor to +3'-4" AFF	COFFEE HOUSE
6	Split face CMU in the field above the walnoot and below the accent band.	+3'-4" AFF to +28'-0" AFF	TERRAIN TAN
7	Smooth face CMU in the field above the walnoot and below the accent band.	+3'-4" AFF to +28'-0" AFF	TERRAIN TAN
8	Accent band, 1 course of smooth face CMU	+28'-0" AFF to +28'-8" AFF	LOWE'S RED
9	Smooth face CMU in the field above the accent band and below the metal coping.	+28'-8" AFF to +30'-0" AFF	LOWE'S GRAY
10	Metal Coping.	Top of CMU parapet, +30'-0" AFF	LOWE'S BLUE
11	Aluminum Cornice	Top of E.I.F.S. parapets at various heights AFF	WHITE
12	Metal Roof and Fascia	As Shown	LOWE'S BLUE
13	Metal Awning	As Shown	LOWE'S BLUE
14	Vertical Steel Fencing at Garden Center and Staging Area.	As Shown	BLACK
15	E.I.F.S. in the field.	As Shown	BEACH HOUSE
16	E.I.F.S. in the field.	As Shown	VILLA WHITE
17	E.I.F.S. in the field.	As Shown	ATELIER TAN
18	E.I.F.S. background to the LOWE'S sign.	As Shown	LOWE'S BLUE
19	E.I.F.S. accent band around the LOWE'S sign background.	As Shown	LOWE'S RED
20	H.M. Doors and Frames	As Shown	TERRAIN TAN
21	Aluminum Overhead Doors	As Shown	TERRAIN TAN
22	Tile Accent	As Shown	WHITE
23	E.I.F.S. Accent	As Shown	SOMBRERO
24	E.I.F.S. Accent	As Shown	SOMBRERO
25	Metal Roof	As Shown	SOMBRERO

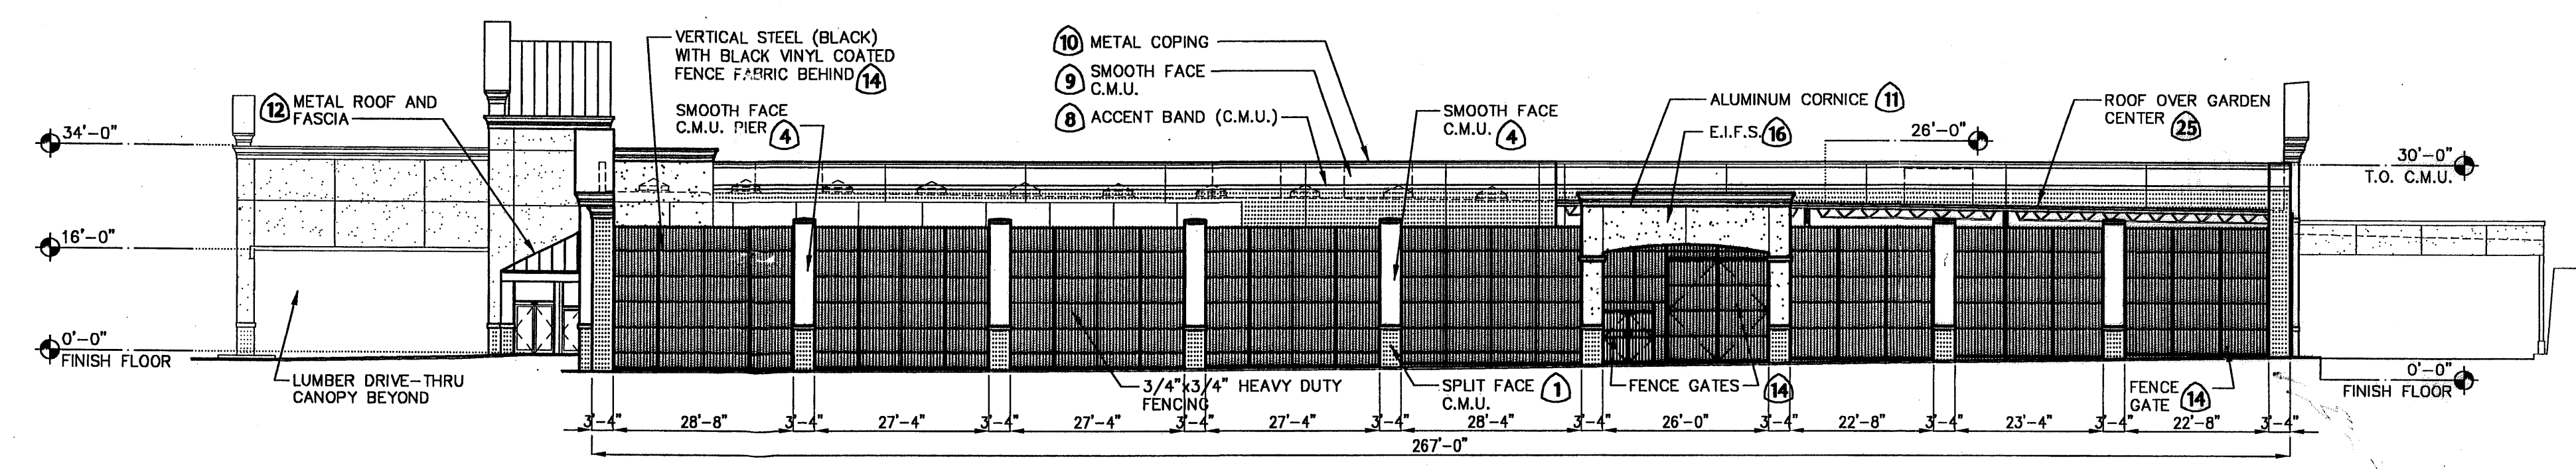

SOUTH ELEVATION
SCALE: 1" = 20'-0"

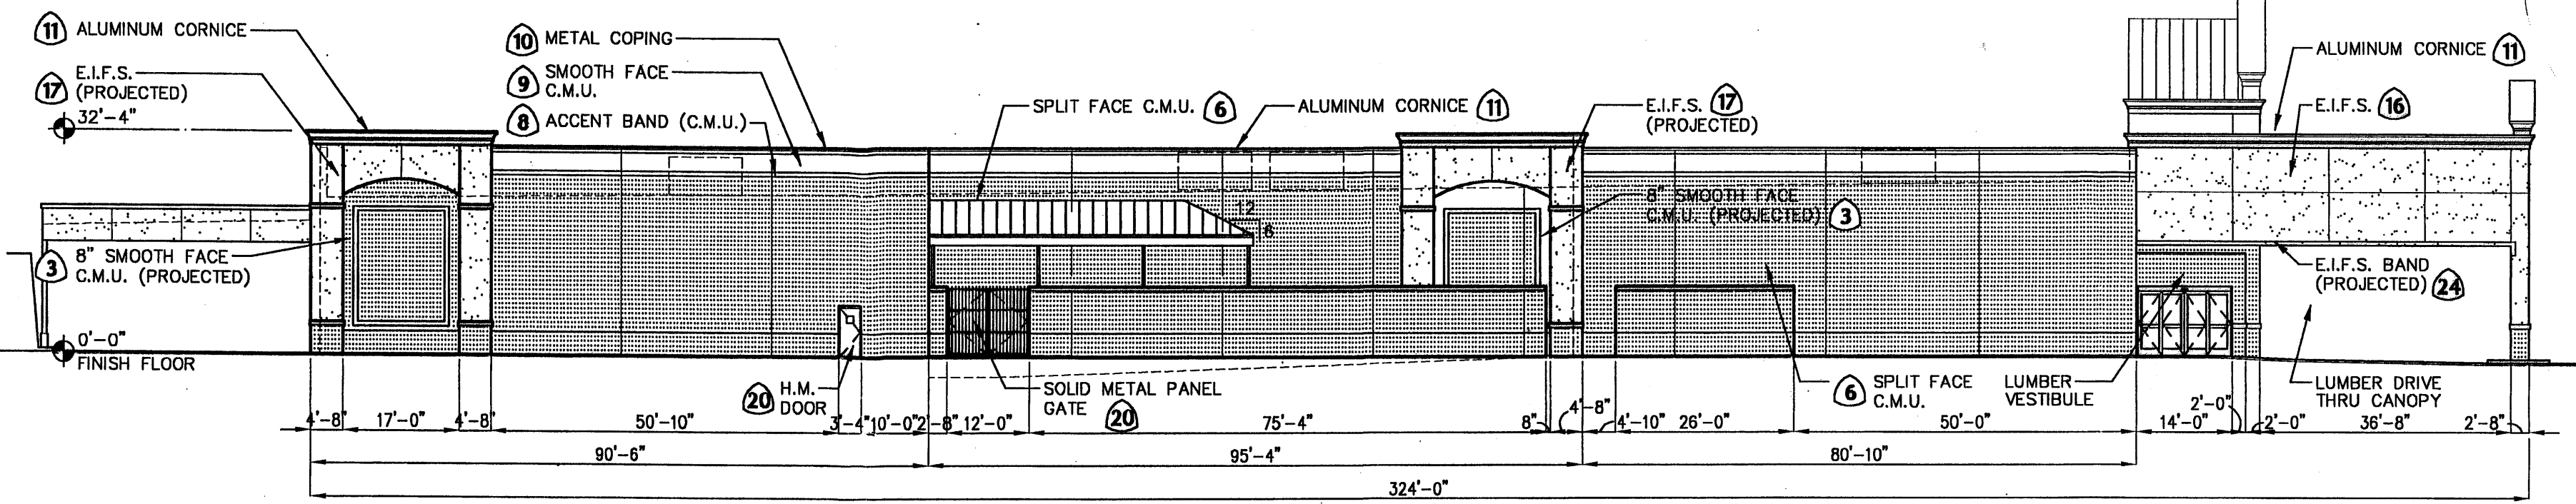


NORTH ELEVATION
SCALE: 1" = 20'-0"

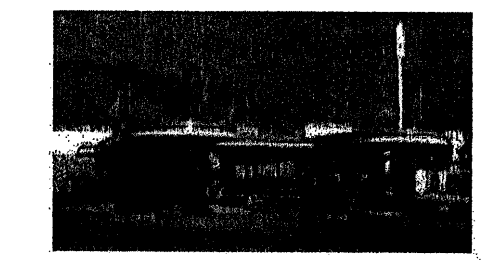


Front View



View from Back

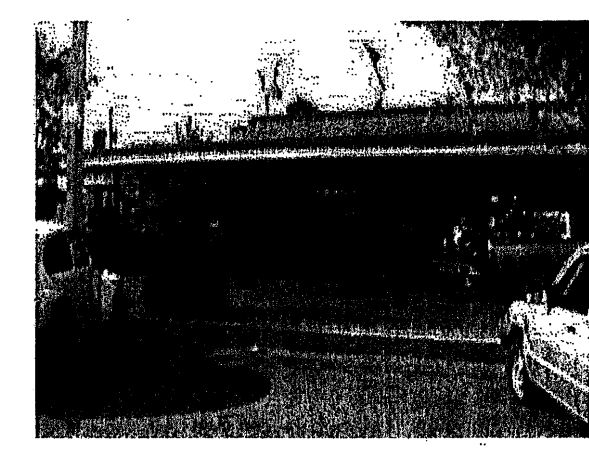

View from North

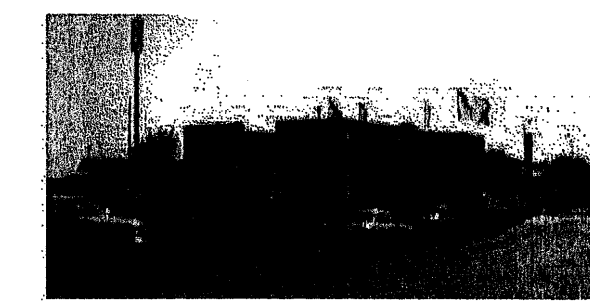

View from South


SONIC ELEVATIONS
SCALE: NONE

LDRA
KURT D. REED ASSOCIATES, INC.
7400 EAST MCDONALD DRIVE • SUITE 101 • SCOTTSDALE, AZ 85250
Phone: (480) 941-1440 Fax: (480) 941-1055 www.kdra.com

NO.	DATE	REVISIONS
1		
2		
3		
4		
5		
6		
7		
8		
9		
10		
11		
12		
13		
14		
15		
16		
17		
18		
19		
20		
21		
22		
23		
24		
25		

LOWE'S COMPANIES, INC.
AUGUST 2000 COPYRIGHT
ALL RIGHTS RESERVED

LOWE'S
Companies, Inc.
LOWE'S OF EAST ALBUQUERQUE, NM

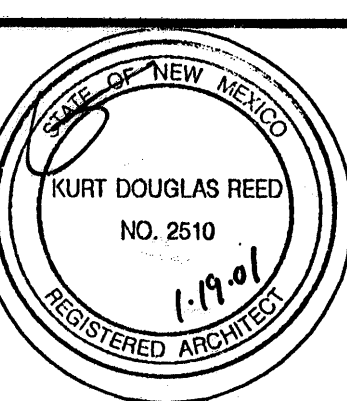

EXTERIOR ELEVATIONS
Job No: 001472
Date: 18 JAN 01
Scale: SEE PLAN
Drawn: ABH
Checked: JS
Sheet No: A5
LOSS PREVENTION CODE= 5

THU 18 JAN 2001 08:18AM ANDY_LK_1\LOWE\001472\C7Z-AS.DWG
THU 18 JAN 2001 08:43AM ANDY_LK_1\LAST-ARCHIVED_2\NOVA_0008\001472\CTY_SET_1\WRC1\C7Z-AS.PLT