



9330 BALBOA AVENUE
SAN DIEGO, CA 92123

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DATES

ASE: FEBRUARY 24, 20

REVISIONS

CLOUDED AREAS
INDICATE MAY

2011 MODIFICATIONS
REQUIRED TO ADDRES
EPC CONDITIONS

OF APPROVAL

ST FOOD KESTAUKANT
DEVELOPMENT
AVALON & 98th ST.
UQUERQUE, NEW MEXICO

OCIATES lite # 105

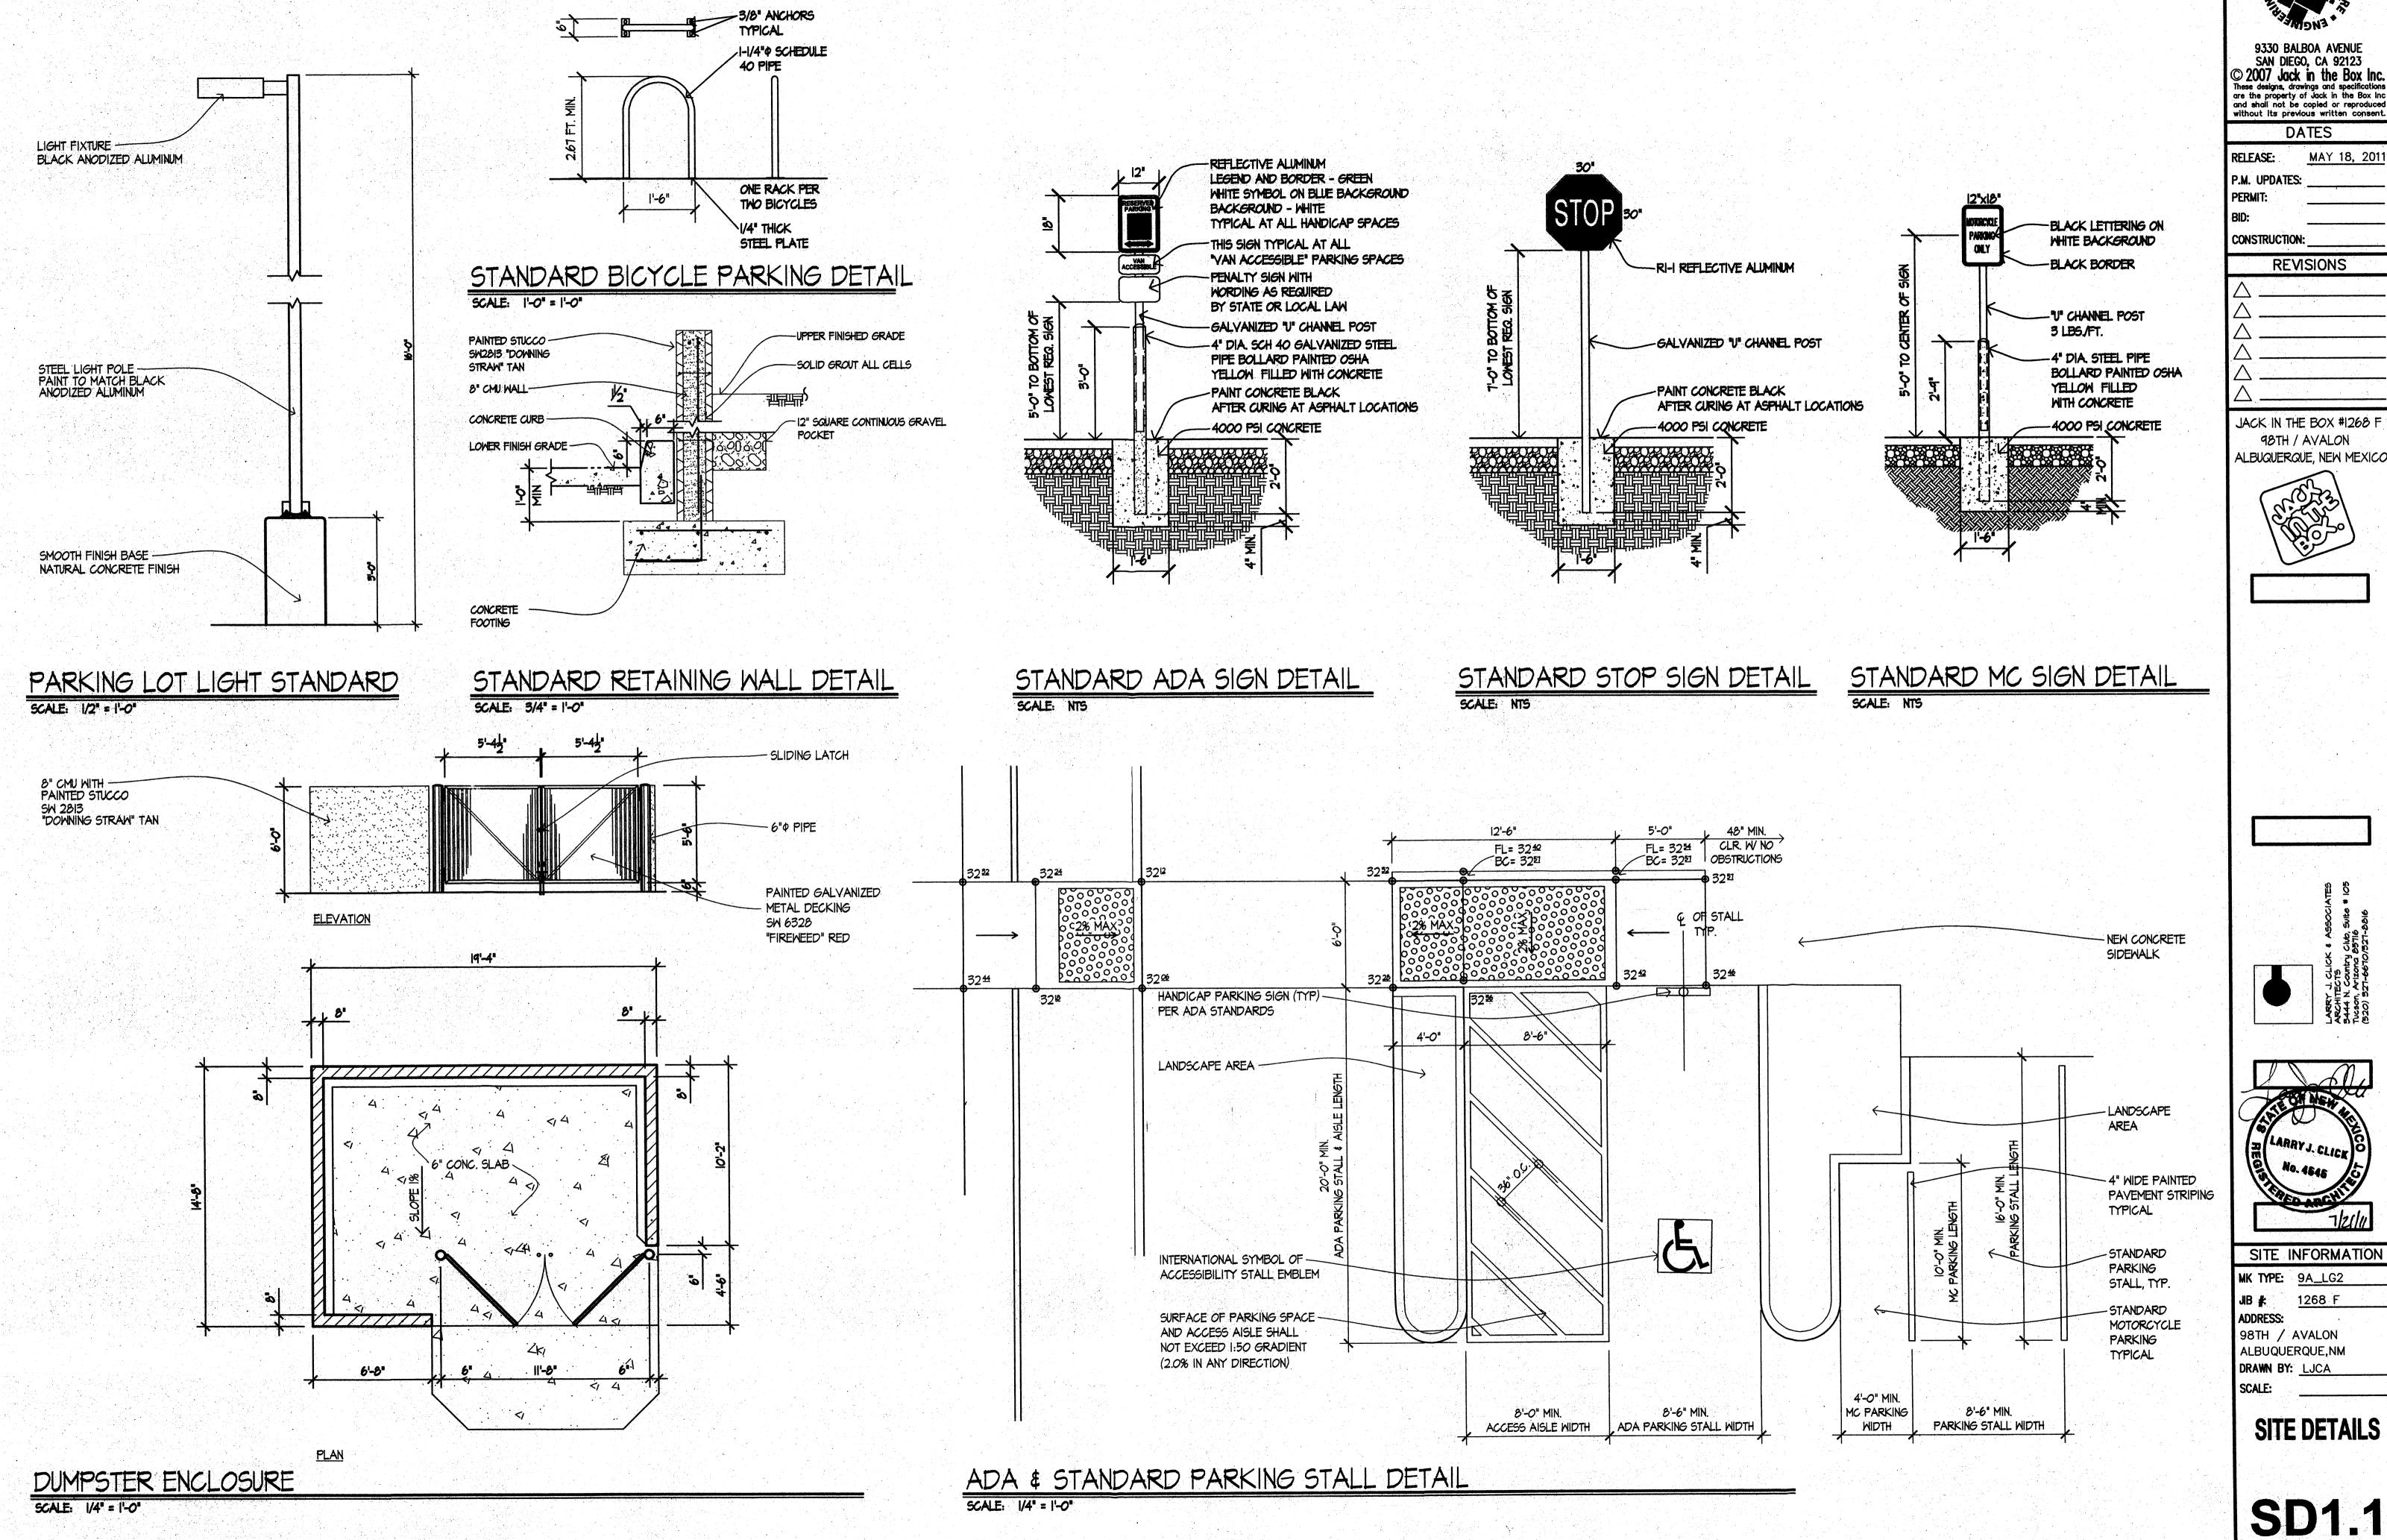
LARRY J. CLICK & ASS ARCHITECTS 3444 N. Country Club, St. Tucson, Arizona Ø57196

LARRY J. CLICK O


DRAWN BY: LJCA

SCALE: AS NOTED

SITE PLAN
FOR
BUILDING PERMIT
SD1.0



9330 BALBOA AVENUE SAN DIEGO, CA 92123 © 2007 Jack in the Box Inc. These designs, drawings and specifications are the property of Jack in the Box Inc and shall not be copied or reproduced without its previous written consent. DATES RELEASE: MAY 18, 201 P.M. UPDATES: **CONSTRUCTION:** REVISIONS JACK IN THE BOX #1268 F 98TH / AVALON ALBUQUERQUE, NEW MEXICO No. 4646 SITE INFORMATION MK TYPE: 9A\_LG2 1268 F JIB # ADDRESS: 98TH / AVALON ALBUQUERQUE,NM DRAWN BY: LJCA

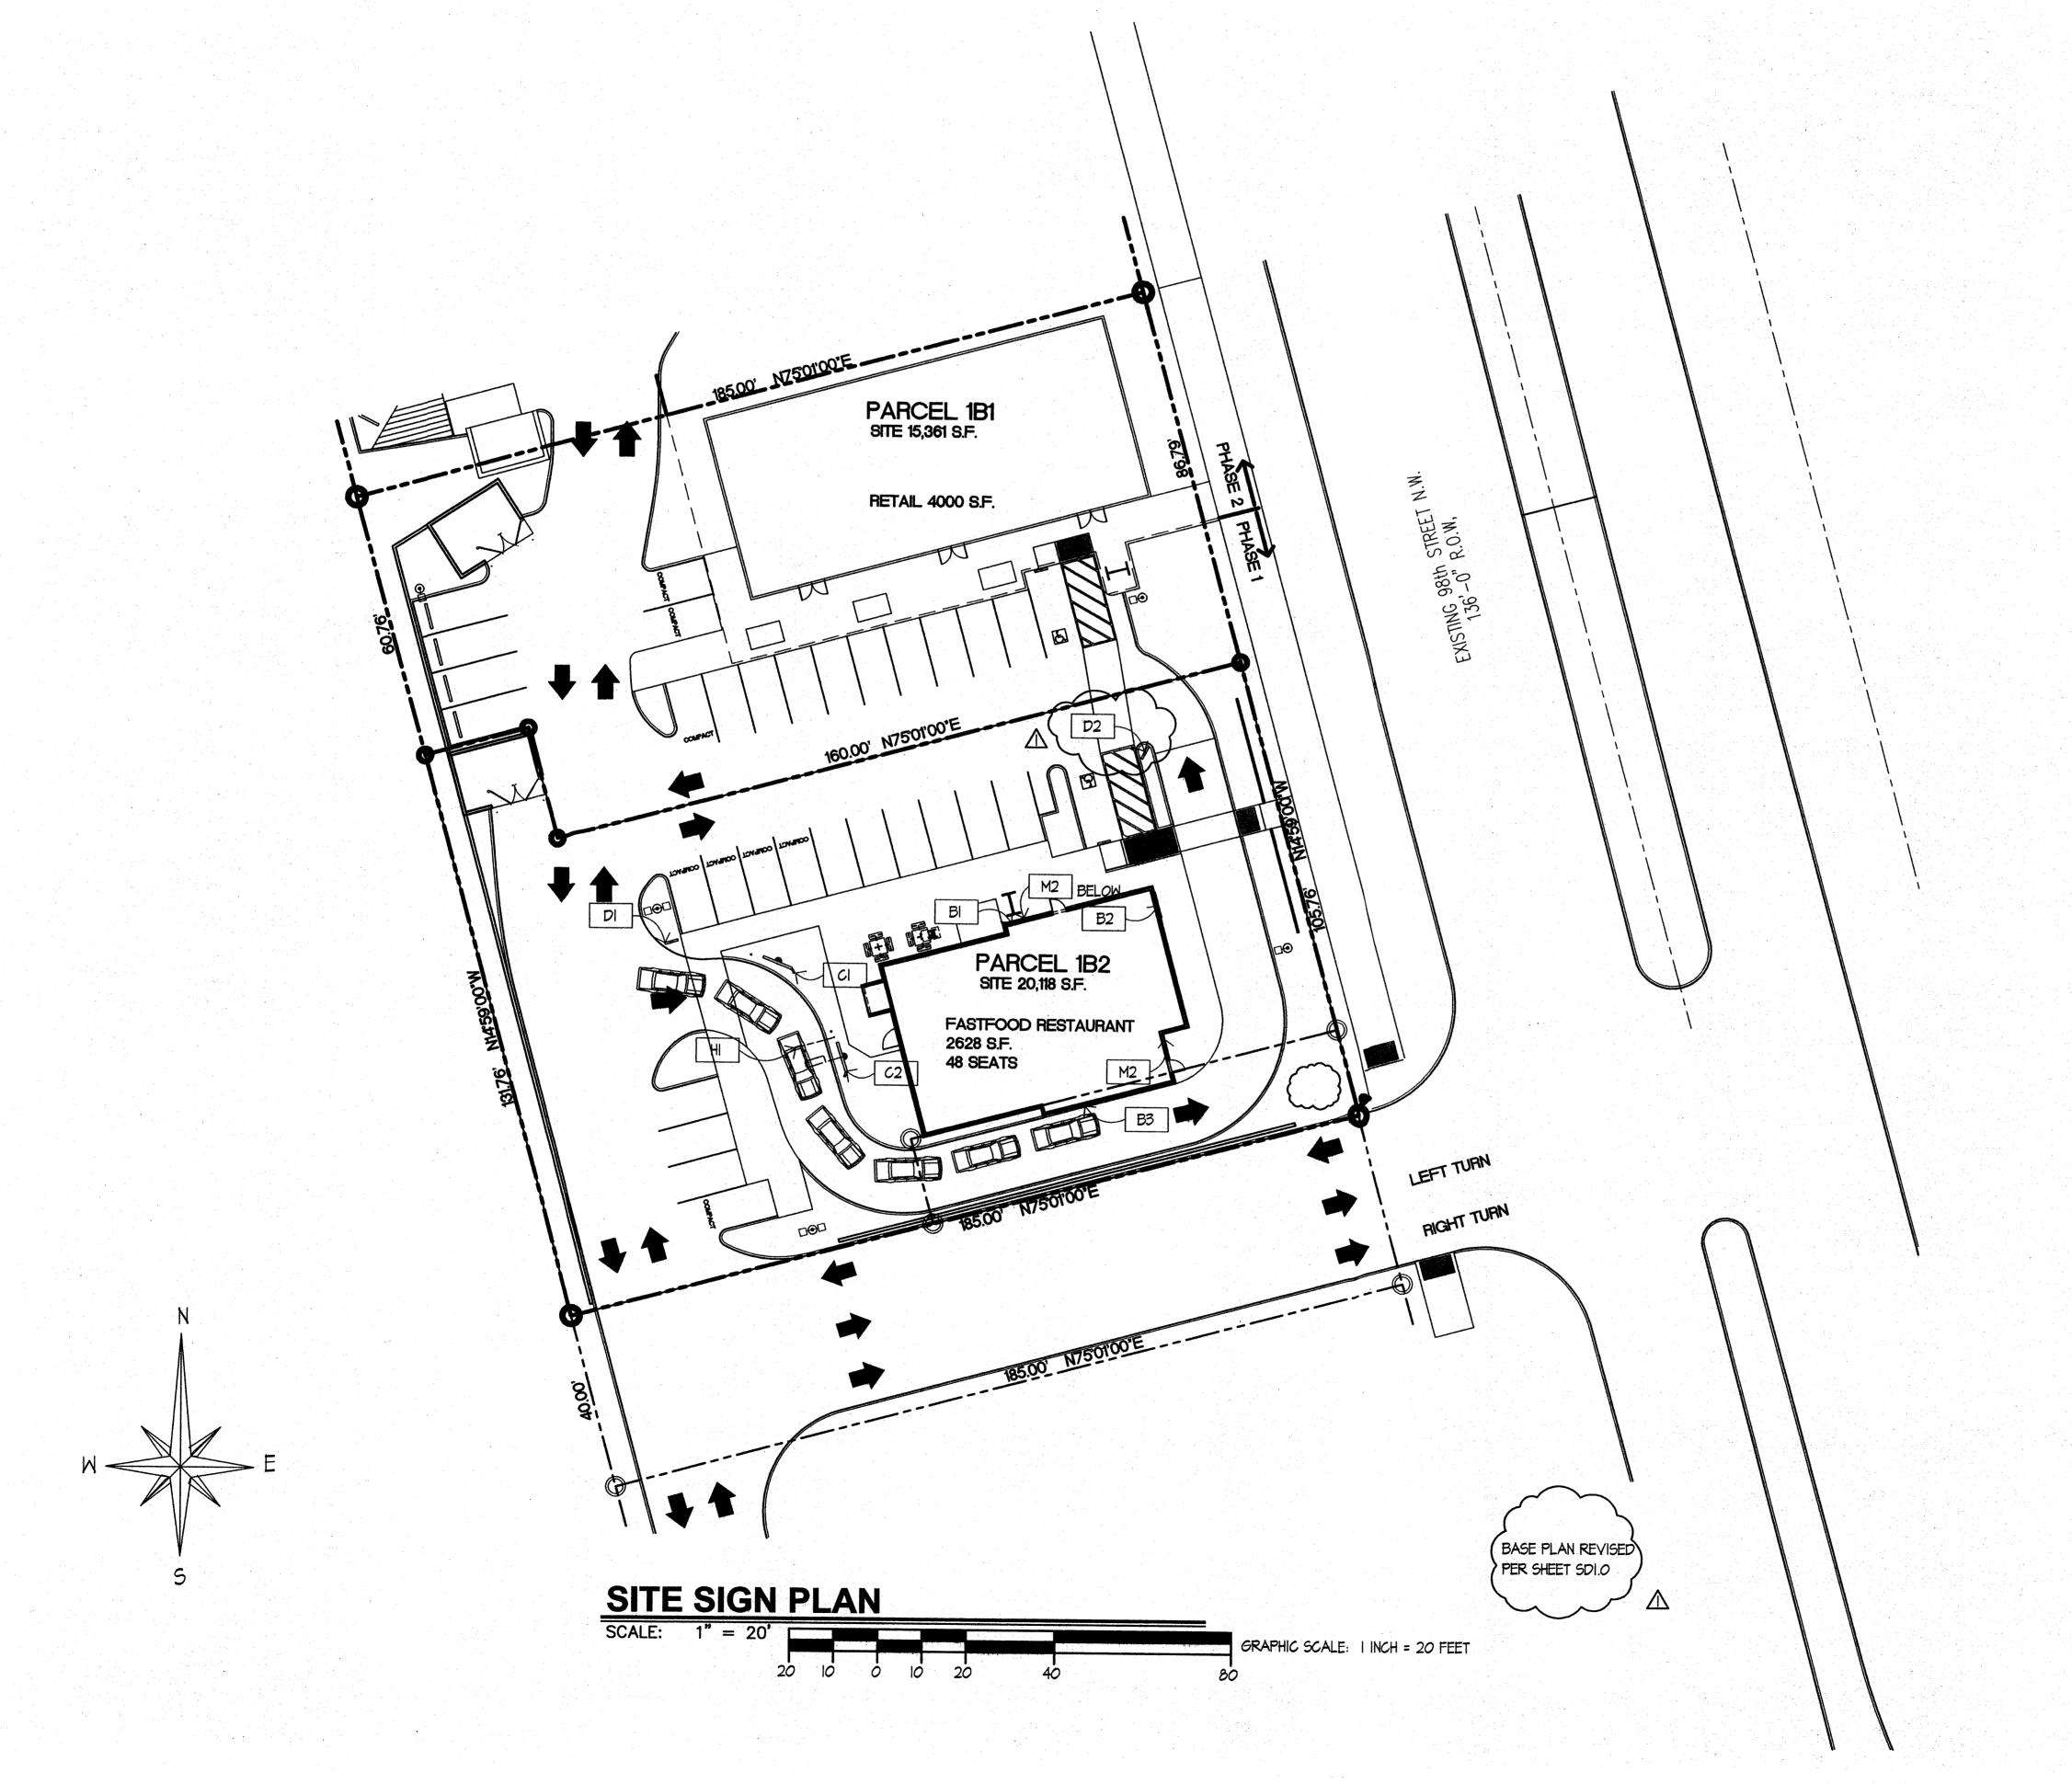

# SITE SIGN PLAN KEY NOTES

BI		INTERNA	LLY ILLUM	INATED	BIIII	DING	SIGN	NOPT
	_							

INTERNALLY ILLUMINATED BUILDING SIGN- EAST

INTERNALLY ILLUMINATED BUILDING SIGN- SOUTH

INTERNALLY ILLUMINATED BUILDING SIGN- WEST

INTERNALLY ILLUMINATED PREVIEW MENU BOARD

INTERNALLY ILLUMINATED ORDER MENU BOARD

INTERNALLY ILLUMINATED DIRECTIONAL SIGN- "DRIVE THRU"

INTERNALLY ILLUMINATED DIRECTIONAL SIGN- "THANK YOU"

NON ILLUMINATED MARQUEE PANEL



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RELEASE:

REVISIONS

JACK IN THE BOX #1268 F 98TH / AVALON ALBUQUERQUE, NEW MEXICO



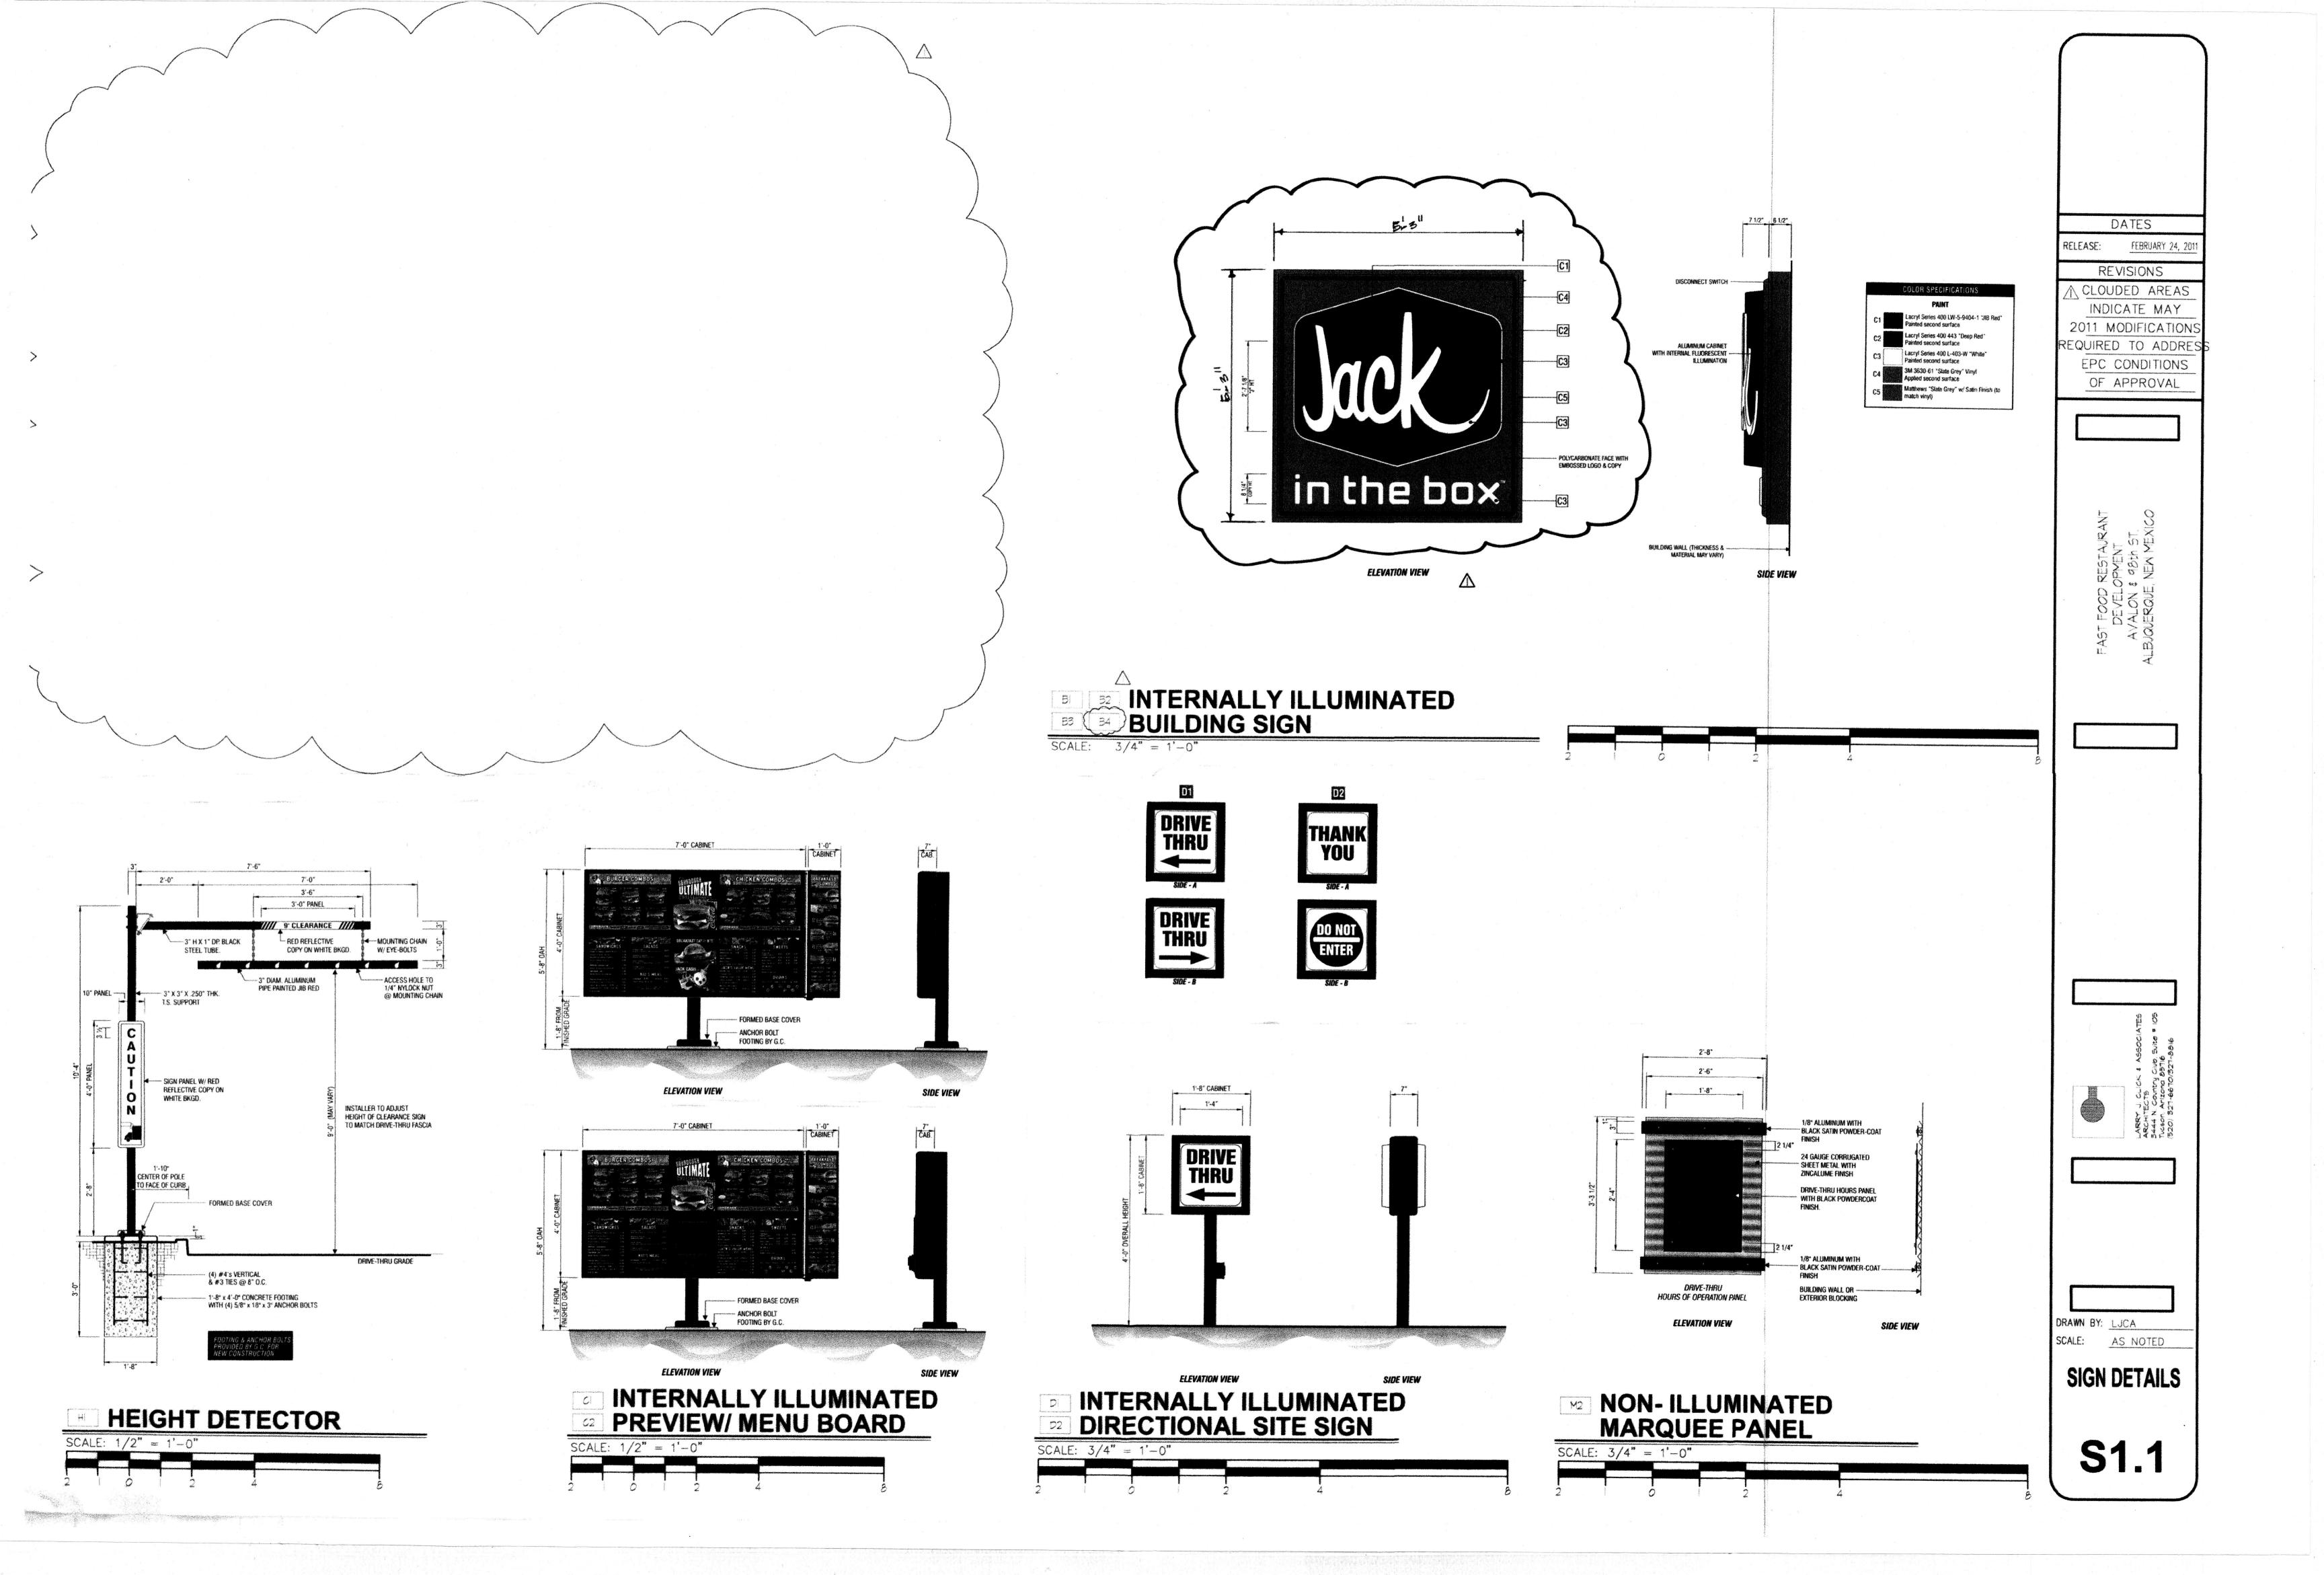
SITE INFORMATION

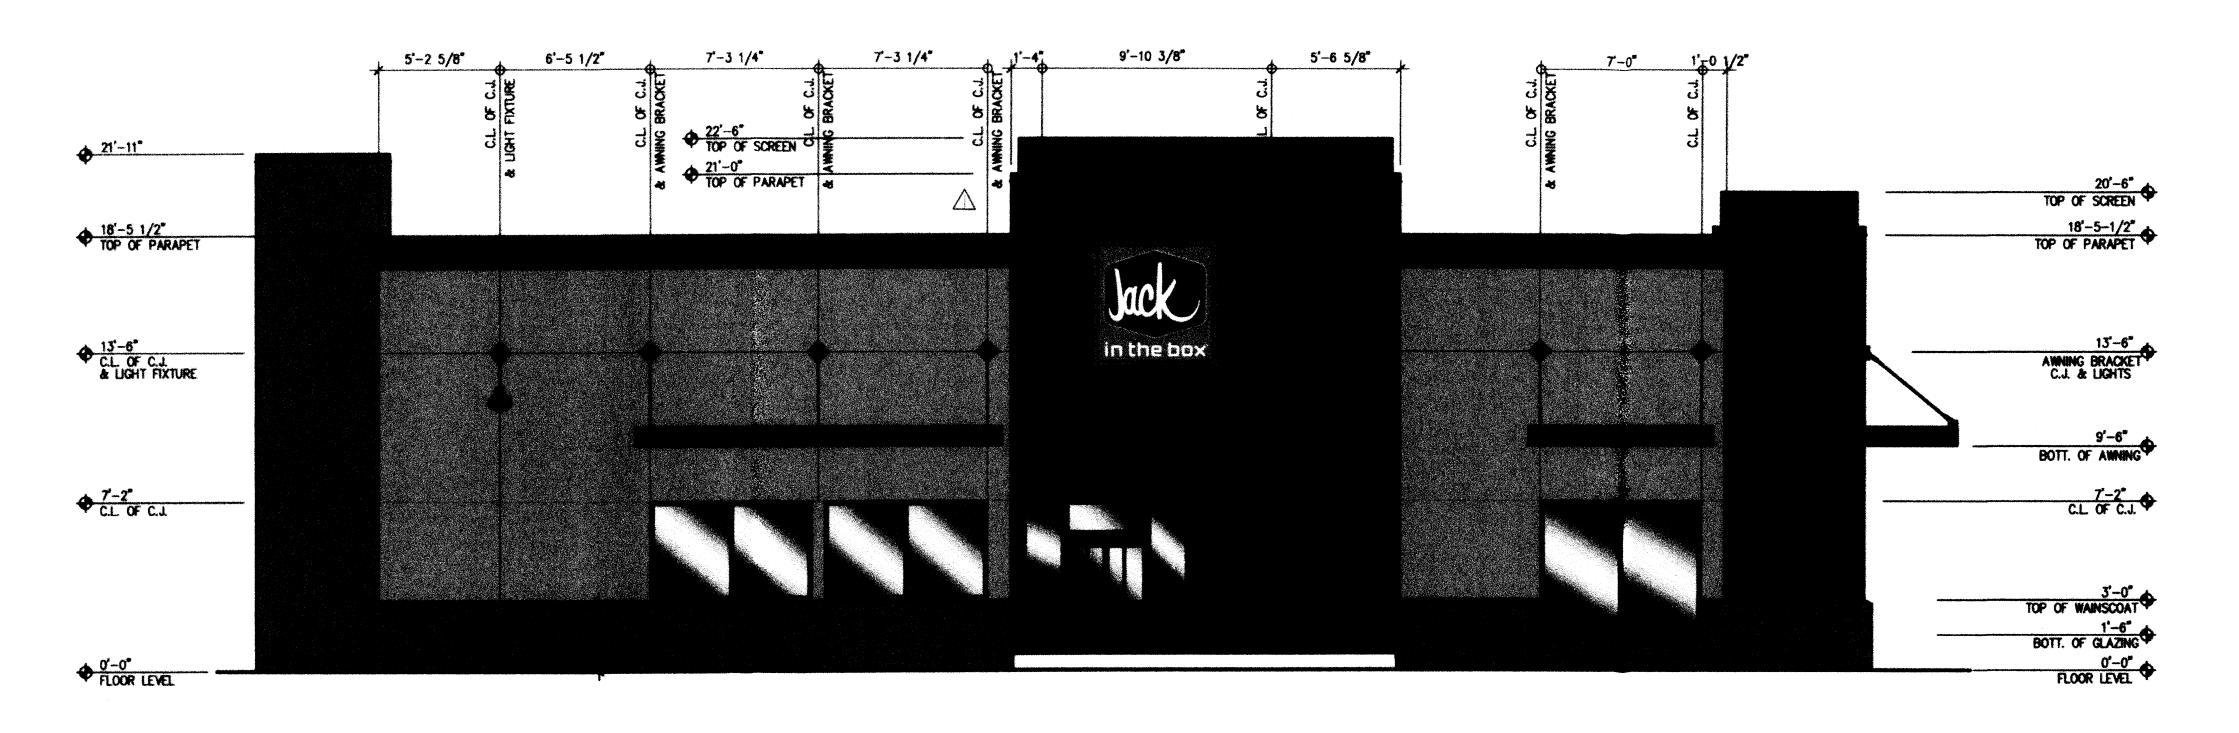
MK TYPE: 9A\_LG2

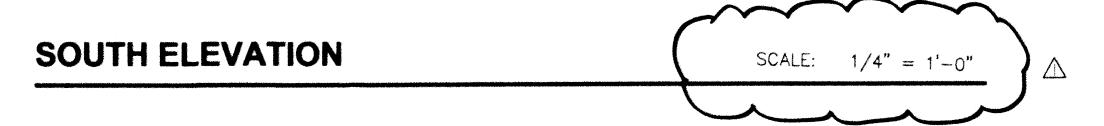
JIB #: 1268 F
ADDRESS:
98TH / AVALON
ALBUQUERQUE,NM DRAWN BY: LJCA

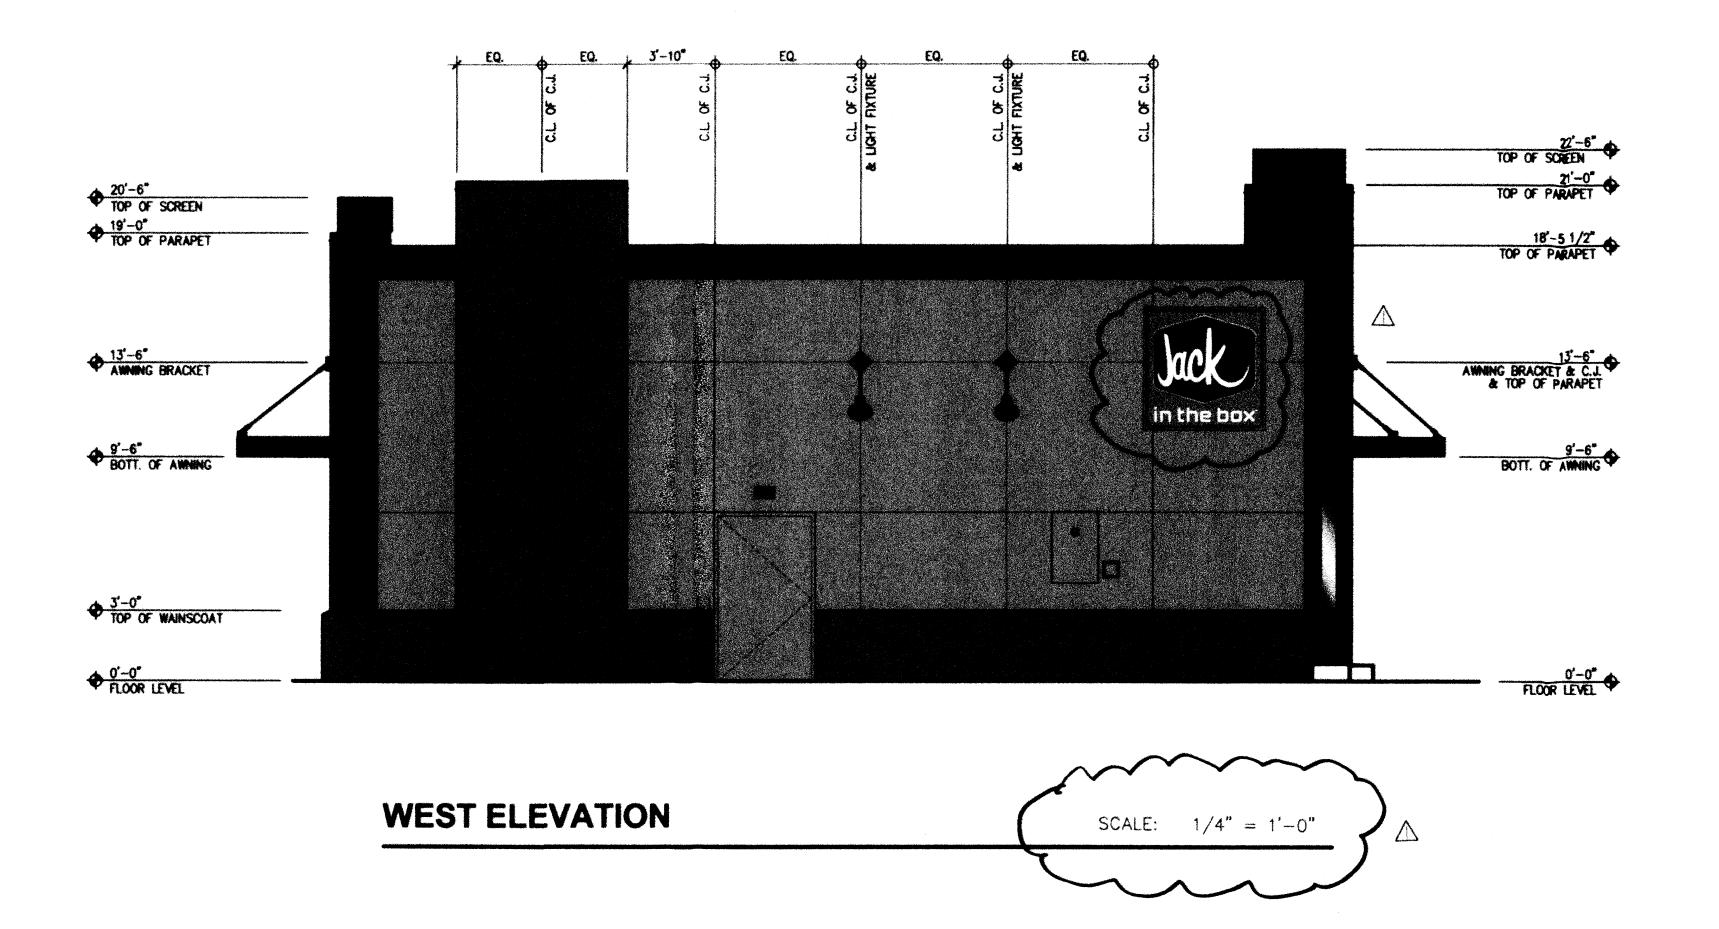
SITE SIGN PLAN

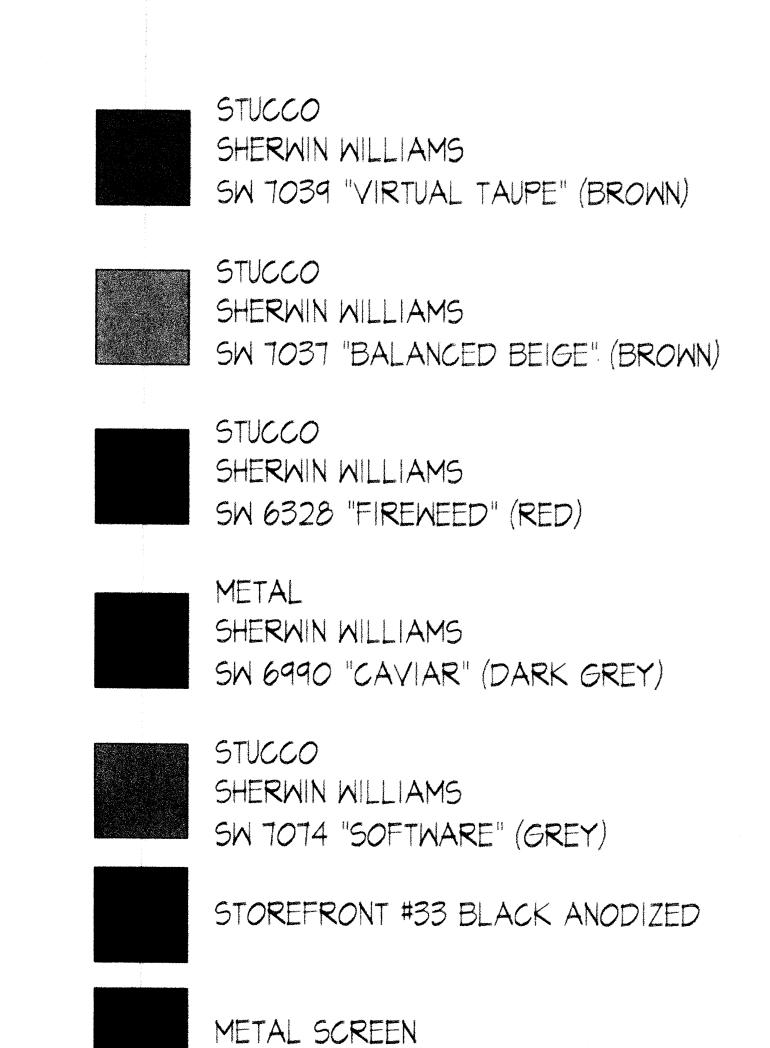
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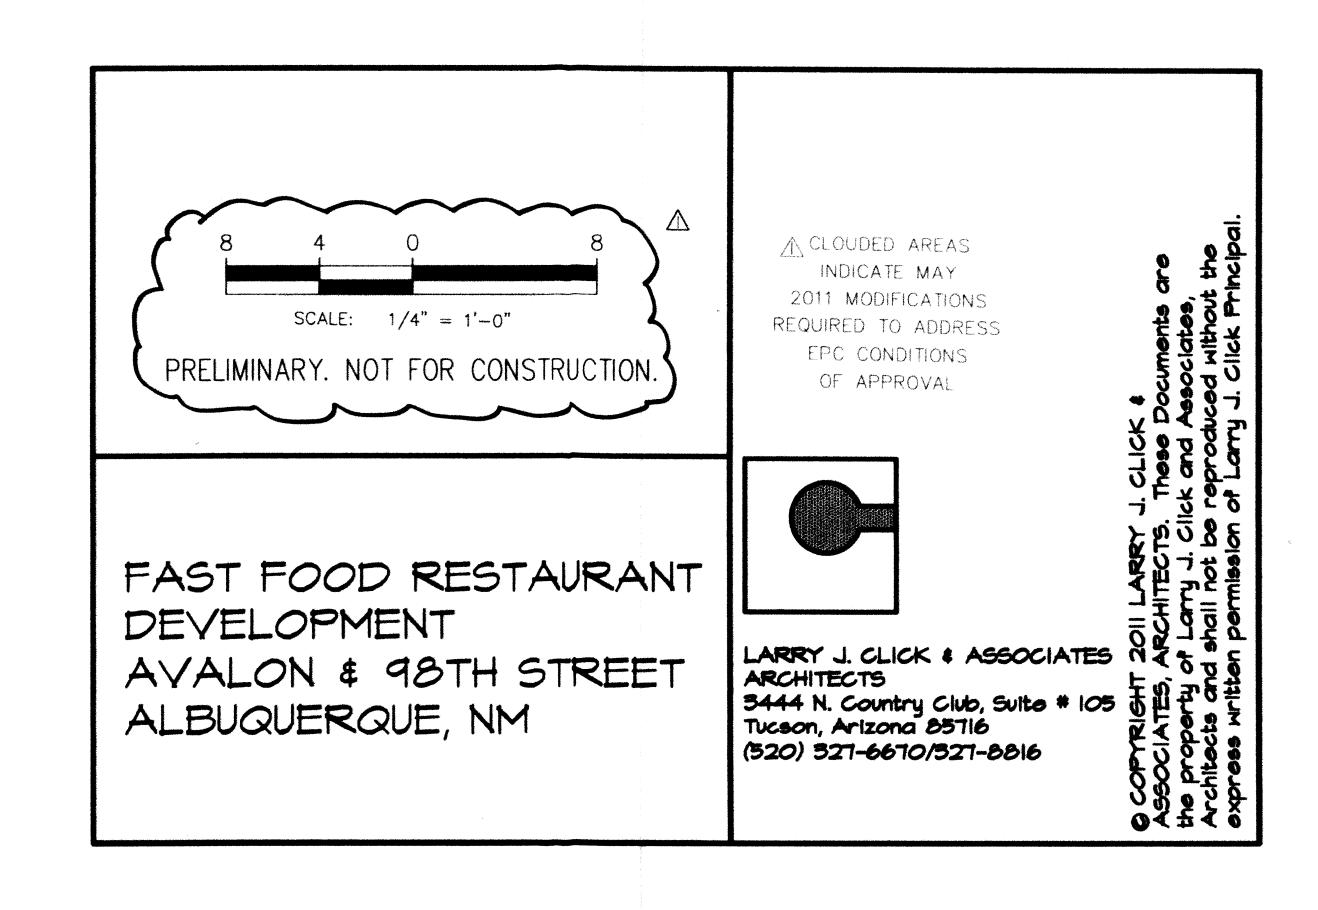








DARK GREY GALVANIZED FINISH



BASIN	AREA			% LAND T	REATMEN			DISCHAF	RGE (CFS
I.D.	(AC)		A	В	C	D		10 YR*	100YR*
HYDROLO	GICAL	VOLL	IMETRIC 8	DISCHAR	GE DATA	(EXISTING	CALC	ULATED)	
EXISTING BASIN	0.99		50.0%	50.0%	0.0%	0.0%		0.50	1.63
TOTAL	0.99							0.50	1.63
				DEVELOP	ED				
DEVELOPED BASIN	0.99		0.0%	5.0%	5.0%	90.0%		2.68	4.14
TOTAL	0.99							2.68	4.14

# GRADING AND DEAINAGE NARRATIVE

THE PURPOSE OF THIS SUBMITTAL IS TO PRESENT A GRADING AND DRAINAGE PLAN FOR A PROPOSED JACK-IN-THE-BOX DEVELOPMENT IN SW ALBUQUERQUE. THE SITE IS LOCATED AT THE SOUTHWEST CORNER OF THE 98TH AVENUE AND AVALON ROAD, THE PROJECT WILL INCLUDE A JACK-IN-THE-BOX RESTAURANT AND RETAIL BUILDING WITH PEDESTRIAN ACCESS, PARKING, AND LANDSCAPING ON APPROXIMATELY 0.93 ACRES.

THE SITE IS LOCATED WITHIN ZONE ATLAS MAP K-9-Z. THE PROJECT IS BOUNDED ALONG THE EAST BY 98TH AVENUE, ALONG THE WEST BY A DEVELOPED HOTEL SITE, ALONG THE NORTH BY A RETAIL BUILDING AND ALONG THE SOUTH BY UNDEVELOPED PROPERTY.

III. EXISTING HYDROLOGIC CONDITIONS THE SITE ENCOMPASSES APPROXIMATELY 0.99 ACRES AND IS UNDEVELOPED. SLOPES FOR THE SITE RANGE BETWEEN 3 TO 4% TO THE SOUTHEAST AND THERE IS LIMITED VESETATION COVER. CURRENTLY, THE SITE DRAINS VIA SURFACE FLOW TOWARD A SWALE ON THE WEST SIDE OF 98TH AVENUE. THE RUNOFF, 1.63 CFS, FLOWS SOUTH ALONG 98TH AVENUE, ENTERING THE EXISTING INLET AT THE NORTHWEST CORNER OF VOLCANO ROAD AND 98TH AVENUE.

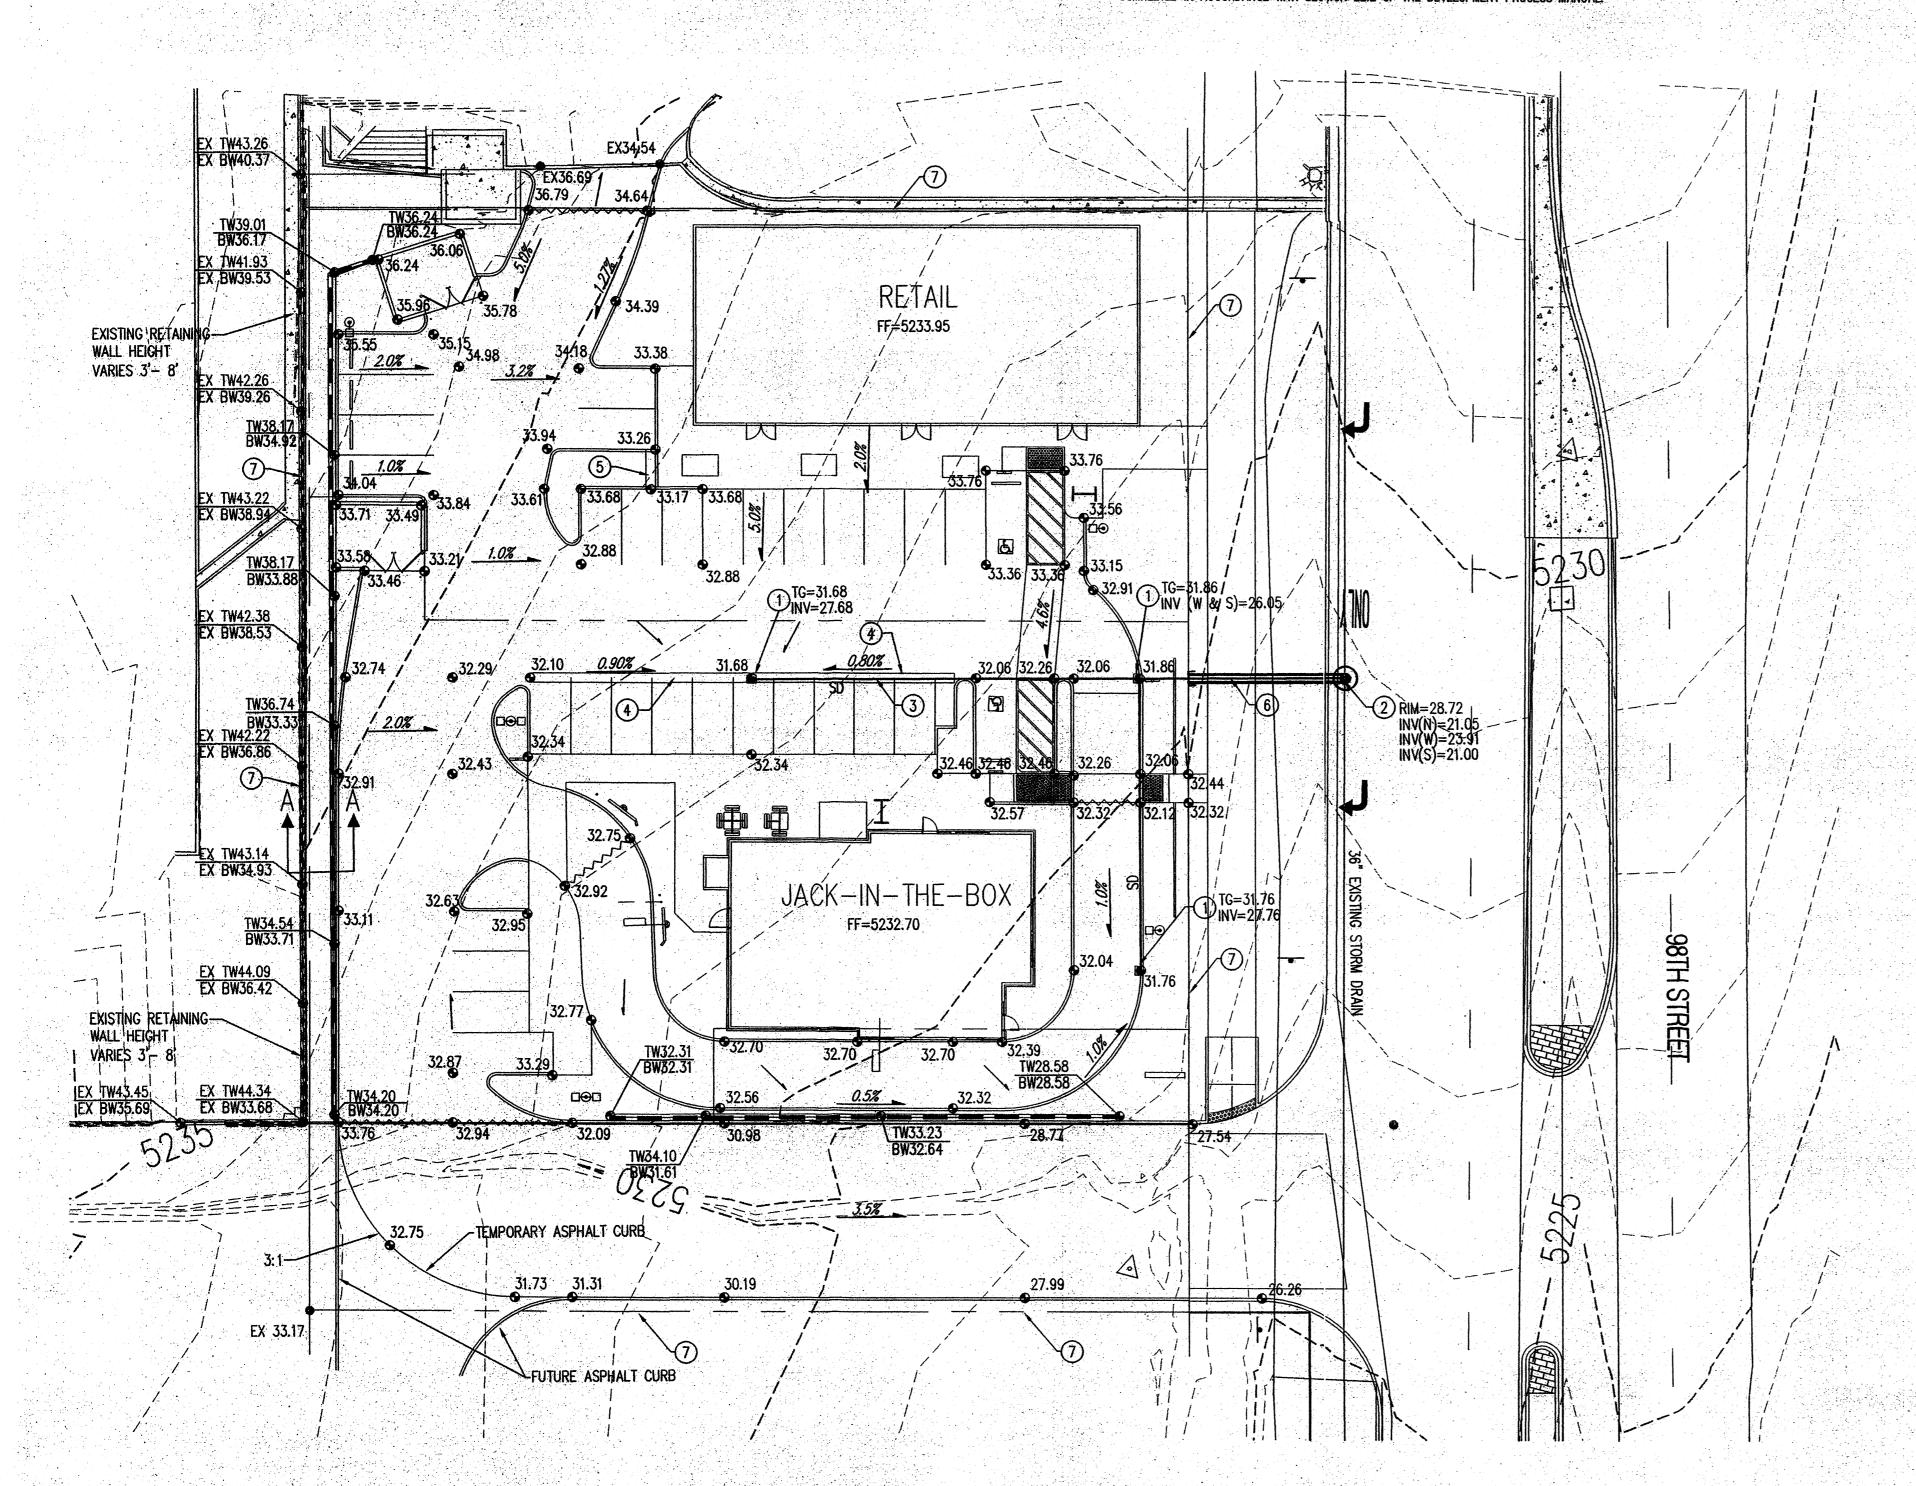
#### IV OFFSITE DRAINAGE

THERE IS LIMITED OFFSITE FLOW ENTERING THE SITE. THE HOTEL SITE TO THE WEST CONTAINS ITS FLOWS ON SITE, DRAINING NORTH TO AVALON AVENUE. FLOW FROM THE PROPERTY TO THE NORTH IS INTERCEPTED BY A CONCRETE SWALE AT THE PROPERTY LINE, DRAINING TO 98TH STREET. THE JACK-IN-THE-BOX SITE IS HIGHER THAN THE 98TH AVENUE RIGHT-OF-WAY AND THE UNDEVELOPED PROPERTY TO THE SOUTH.

#### IV. PROPOSED HYDROLOGIC CONDITIONS

THE PROPOSED SITE RUNOFF, 4.14 CFS, DRAINS WITH A PORTION OF THE SITE ENTERING INLETS IN THE PARKING AREA AND AN INLET IN THE DRIVE-THRU. THE REMAING PORTION DISCHARGING OFFSITE VIA PROPOSED CURB & GUTTER. THE ON-SITE STORM DRAIN SYSTEM WILL DISCHARGE TO THE EXISTING STORM DRAIN IN 98TH AVENUE. THE SURFACE RUNOFF DISCHARGING OFFSITE WILL FLOW EXISTING HYDROLOGIC CONDITIONS AND BE CONVEYED BY THE EXISTING SWALE ON THE WEST SIDE OF 98TH AVENUE AND ENTER THE EXISTING INLET AT THE NORTHWEST CORNER OF VOLCANO ROAD AND 98TH AVENUE.

THE GRADING AND DRAINAGE PLAN FOR THE JACK-IN-THE-BOX SITE IS CONSISTENT WITH THE APPROVED DRAINAGE MANAGEMENT PLAN. THE PLAN IS CAPABLE OF SAFILY PASSING THE 100 YEAR STORM AND MEETS CITY REQUIREMENTS. ALL ANALYSIS WAS COMPLETED IN ACCORDANCE WITH SECTION 22.2 OF THE DEVELOPMENT PROCESS MANUAL



### **GENERAL NOTES**

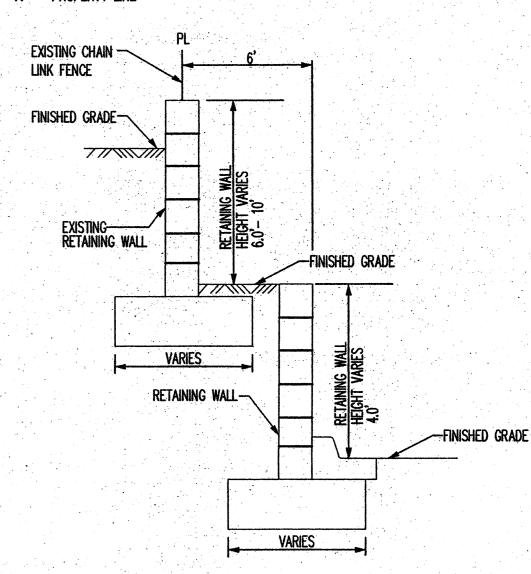
- 1. ALL WORK DETAILED ON THESE PLANS AND PERFORMED UNDER THIS CONTRACT SHALL BE CONSTRUCTED IN ACCORDANCE WITH THE PROJECT SPECIFICATIONS AND THE PROJECT GEOTECHNICAL REPORT. WHERE APPLICABLE, CITY OF ALBUQUERQUE PUBLIC WORKS STANDARDS SHALL APPLY.
- 2. THE CONTRACTOR SHALL ABIDE BY ALL LOCAL, STATE, AND FEDERAL LAWS, RULES AND REGULATIONS WHICH APPLY TO THE CONSTRUCTION OF THESE IMPROVEMENTS, INCLUDING EPA REQUIREMENTS WITH RESPECT TO STORM WATER DISCHARGE.
- 3. PRIOR TO CONSTRUCTION, THE CONTRACTOR SHALL FIELD VERIFY THE HORIZONTAL AND VERTICAL LOCATIONS OF ALL POTENTIAL OBSTRUCTIONS INCLUDING ALL UNDERGROUND UTILITIES. SHOULD A CONFLICT EXIST, THE CONTRACTOR SHALL NOTIFY THE CONSTRUCTION OBSERVER OR ENGINEER SO THAT THE CONFLICT CAN BE RESOLVED WITH A MINIMUM AMOUNT OF DELAY.
- 4. TWO (2) WORKING DAYS PRIOR TO ANY EXCAVATION, THE CONTRACTOR SHALL CONTACT LINE LOCATING SERVICE FOR LOCATION OF EXISTING UTILITIES.
- 5. ALL ELECTRICAL, TELEPHONE, CABLE TV, GAS AND OTHER UTILITY LINES, CABLES, AND APPURTENANCES ENCOUNTERED DURING CONSTRUCTION THAT REQUIRE RELOCATION, SHALL BE COORDINATED WITH THAT UTILITY. THE CONTRACTOR SHALL BE RESPONSIBLE FOR COORDINATION OF ALL NECESSARY UTILITY ADJUSTMENTS. NO ADDITIONAL COMPENSATION WILL BE ALLOWED FOR DELAYS OR INCONVENIENCES CAUSED BY UTILITY COMPANY WORK CREWS. THE CONTRACTOR MAY BE REQUIRED TO RESCHEDULE HIS ACTIVITIES TO ALLOW UTILITY CREWS TO PERFORM THEIR REQUIRED WORK.
- 6. THE CONTRACTOR IS RESPONSIBLE FOR VERIFYING LOCATION & ELEVATION OF ALL EXISTING UTILITIES PRIOR TO CONSTRUCTION. THE CONTRACTOR IS ALSO RESPONSIBLE FOR PROTECTING ALL EXISTING UTILITY LINES WITHIN THE CONSTRUCTION AREA. ANY DAMAGE TO EXISTING FACILITIES CAUSED BY CONSTRUCTION ACTIVITY SHALL BE REPAIRED OR REPLACED AT THE CONTRACTOR'S EXPENSE AND APPROVED BY THE CONSTRUCTION OBSERVER.
- CONSTRUCTION ACTIVITY SHALL BE LIMITED TO THE PROPERTY AND/OR PROJECT LIMITS. ANY DAMAGE TO ADJACENT PROPERTIES RESULTING FROM THE CONSTRUCTION PROCESS SHALL BE REPAIRED OR REPLACED AT THE CONTRACTOR'S EXPENSE.
- 8. OVERNIGHT PARKING OF CONSTRUCTION EQUIPMENT SHALL NOT OBSTRUCT DRIVEWAYS OR DESIGNATED TRAFFIC LANES. THE CONTRACTOR SHALL NOT STORE ANY EQUIPMENT OR MATERIAL WITHIN THE PUBLIC RIGHT-OF-WAY.
- 9. THE CONTRACTOR SHALL OBTAIN ALL THE NECESSARY PERMITS FOR THE PROJECT PRIOR TO COMMENCING CONSTRUCTION (I.E., BARRICADING, TOPSOIL DISTURBANCE, EXCAVATION PERMITS, EPA STORM WATER PERMITS, ETC.).
- 10. ALL PROPERTY CORNERS DESTROYED DURING CONSTRUCTION SHALL BE REPLACED AT THE CONTRACTOR'S EXPENSE. ALL PROPERTY CORNERS MUST BE RESET BY A REGISTERED LAND SURVEYOR.
- 11. ALL BARRICADES AND CONSTRUCTION SIGNING SHALL CONFORM TO APPLICABLE SECTIONS OF THE "MANUAL ON UNIFORM TRAFFIC CONTROL DEVICES" (MUTCD), US DEPARTMENT OF TRANSPORTATION, LATEST EDITION.
- 12. THE CONTRACTOR SHALL MAINTAIN ALL CONSTRUCTION BARRICADES AND SIGNING AT ALL TIMES. THE CONTRACTOR SHALL VERIFY THE PROPER LOCATION OF ALL BARRICADING AT THE END AND BEGINNING OF EACH DAY.
- 13. THE CONTRACTOR SHALL TAKE ALL STEPS NECESSARY TO CONFORM WITH EPA REQUIREMENTS, INCLUDING COMPLIANCE WITH NPDES PHASE 2 REQUIREMENTS.
- 14. THE CONTRACTOR IS RESPONSIBLE FOR SWPPP COMPLIANCE AND IMPLEMENTATION.

### **GRADING NOTES**

- 1. EXCEPT AS PROVIDED HEREIN, GRADING SHALL BE PERFORMED AT THE ELEVATIONS AND IN ACCORDANCE WITH THE DETAILS SHOWN ON THIS PLAN.
- 2. ALL WORK RELATIVE TO FOUNDATION CONSTRUCTION, SITE PREPARATION, AND PAVEMENT INSTALLATION, AS SHOWN ON THIS PLAN, SHALL BE CONSTRUCTED IN ACCORDANCE WITH THE "GEOTECHNICAL INVESTIGATION," AS PROVIDED BY THE ARCHITECT OR OWNER. ALL OTHER WORK SHALL, UNLESS OTHERWISE STATED OR PROVIDED FOR HEREON, BE CONSTRUCTED IN ACCORDANCE WITH THE CITY OF ALBUQUERQUE STANDARD SPECIFICATIONS FOR PUBLIC WORKS.
- 3. EARTH SLOPES SHALL NOT EXCEED 3 HORIZONTAL TO 1 VERTICAL UNLESS SHOWN OTHERWISE.
- 4. IT IS THE INTENT OF THESE PLANS THAT THIS CONTRACTOR SHALL NOT PERFORM ANY WORK OUTSIDE OF THE PROPERTY BOUNDARIES EXCEPT AS REQUIRED BY THIS PLAN.
- 5. THE CONTRACTOR IS TO ENSURE THAT NO SOIL ERODES FROM THE SITE ONTO ADJACENT PROPERTY OR PUBLIC RIGHT-OF-WAY. THIS SHOULD BE ACHIEVED BY CONSTRUCTING TEMPORARY BERMS OR SILT FENCE AT THE PROPERTY LINES AND WETTING THE SOIL TO PROTECT IT FROM WIND EROSION. THE COST FOR REQUIRED CONSTRUCTION DUST AND EROSION CONTROL MEASURES SHALL BE INCIDENTAL TO THE PROJECT COST.
- 6. A DISPOSAL SITE FOR ANY & ALL EXCESS EXCAVATION MATERIAL, AND UNSUITABLE MATERIAL AND/OR A BORROW SITE CONTAINING ACCEPTABLE FILL MATERIAL SHALL BE OBTAINED BY THE CONTRACTOR IN COMPLIANCE WITH APPLICABLE ENVIRONMENTAL REGULATIONS AND APPROVED BY THE OBSERVER. ALL COSTS INCURRED IN OBTAINING A DISPOSAL OR BORROW SITE AND HAUL TO OR FROM SHALL BE CONSIDERED INCIDENTAL TO THE PROJECT AND NO SEPARATE MEASUREMENT OR PAYMENT SHALL BE MADE.
- 7. VERIFY ALL ELEVATIONS SHOWN ON PLAN FROM BASIS OF ELEVATION CONTROL STATION PRIOR TO BEGINNING CONSTRUCTION.
- 8. ALL ELEVATIONS ARE TAKEN AT THE TOP OF ASPHALT UNLESS OTHERWISE
- 9. ALL CURB IS 6" MEDIAN CURB UNLESS OTHERWISE NOTED. ALL ELEVATIONS SHOWN ALONG MEDIAN CURB ARE AT FLOWLINE UNLESS OTHERWISE INDICATED.
- 10. PAVING AND ROADWAY GRADES SHALL BE  $\pm/-$  0.1' FROM PLAN ELEVATIONS. PAD ELEVATION SHALL BE +/- 0.05' FROM BUILDING PLAN ELEVATION.


### KEYED NOTES


- INSTALL 24" NYLOPLAST CURB INLET STRUCTURE WITH 2'x2' STEEL BAR RECTANGULAR GRATE H-20 RATED (OR APPROVED EQUAL)
- CONNECT TO EXISTING STORM DRAIN WITH NEW 4' MANHOLE, TYPE C OR E
- INSTALL 12" HDPE (N-12WT OR APPROVED EQUAL) STORM DRAIN
- INSTALL 2' WIDE CONCRETE VALLEY GUTTER PER COA STD. DWG 2420.
- 5. INSTALL 2' WIDE SIDEWALK CULVERT PER COA STD. DWG 2236.
- 6. INSTALL 18" RCP STORM DRAIN.
- 7. PROPERTY LINE



# SECTION A-A RETAINING WALL DETAIL

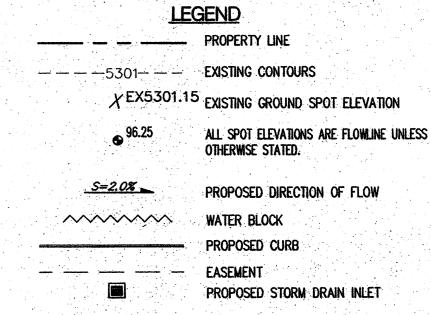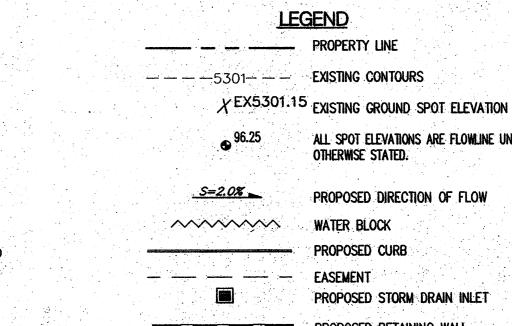NOT TO SCALE (retaining height is taken to be difference in finished grades.)







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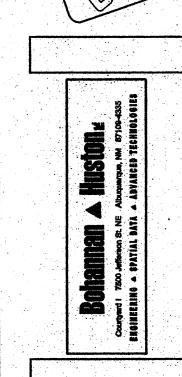
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CONSTRUCTION:

	REVISIONS	
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JACK IN THE BOX #1268 F 98TH / AVALON







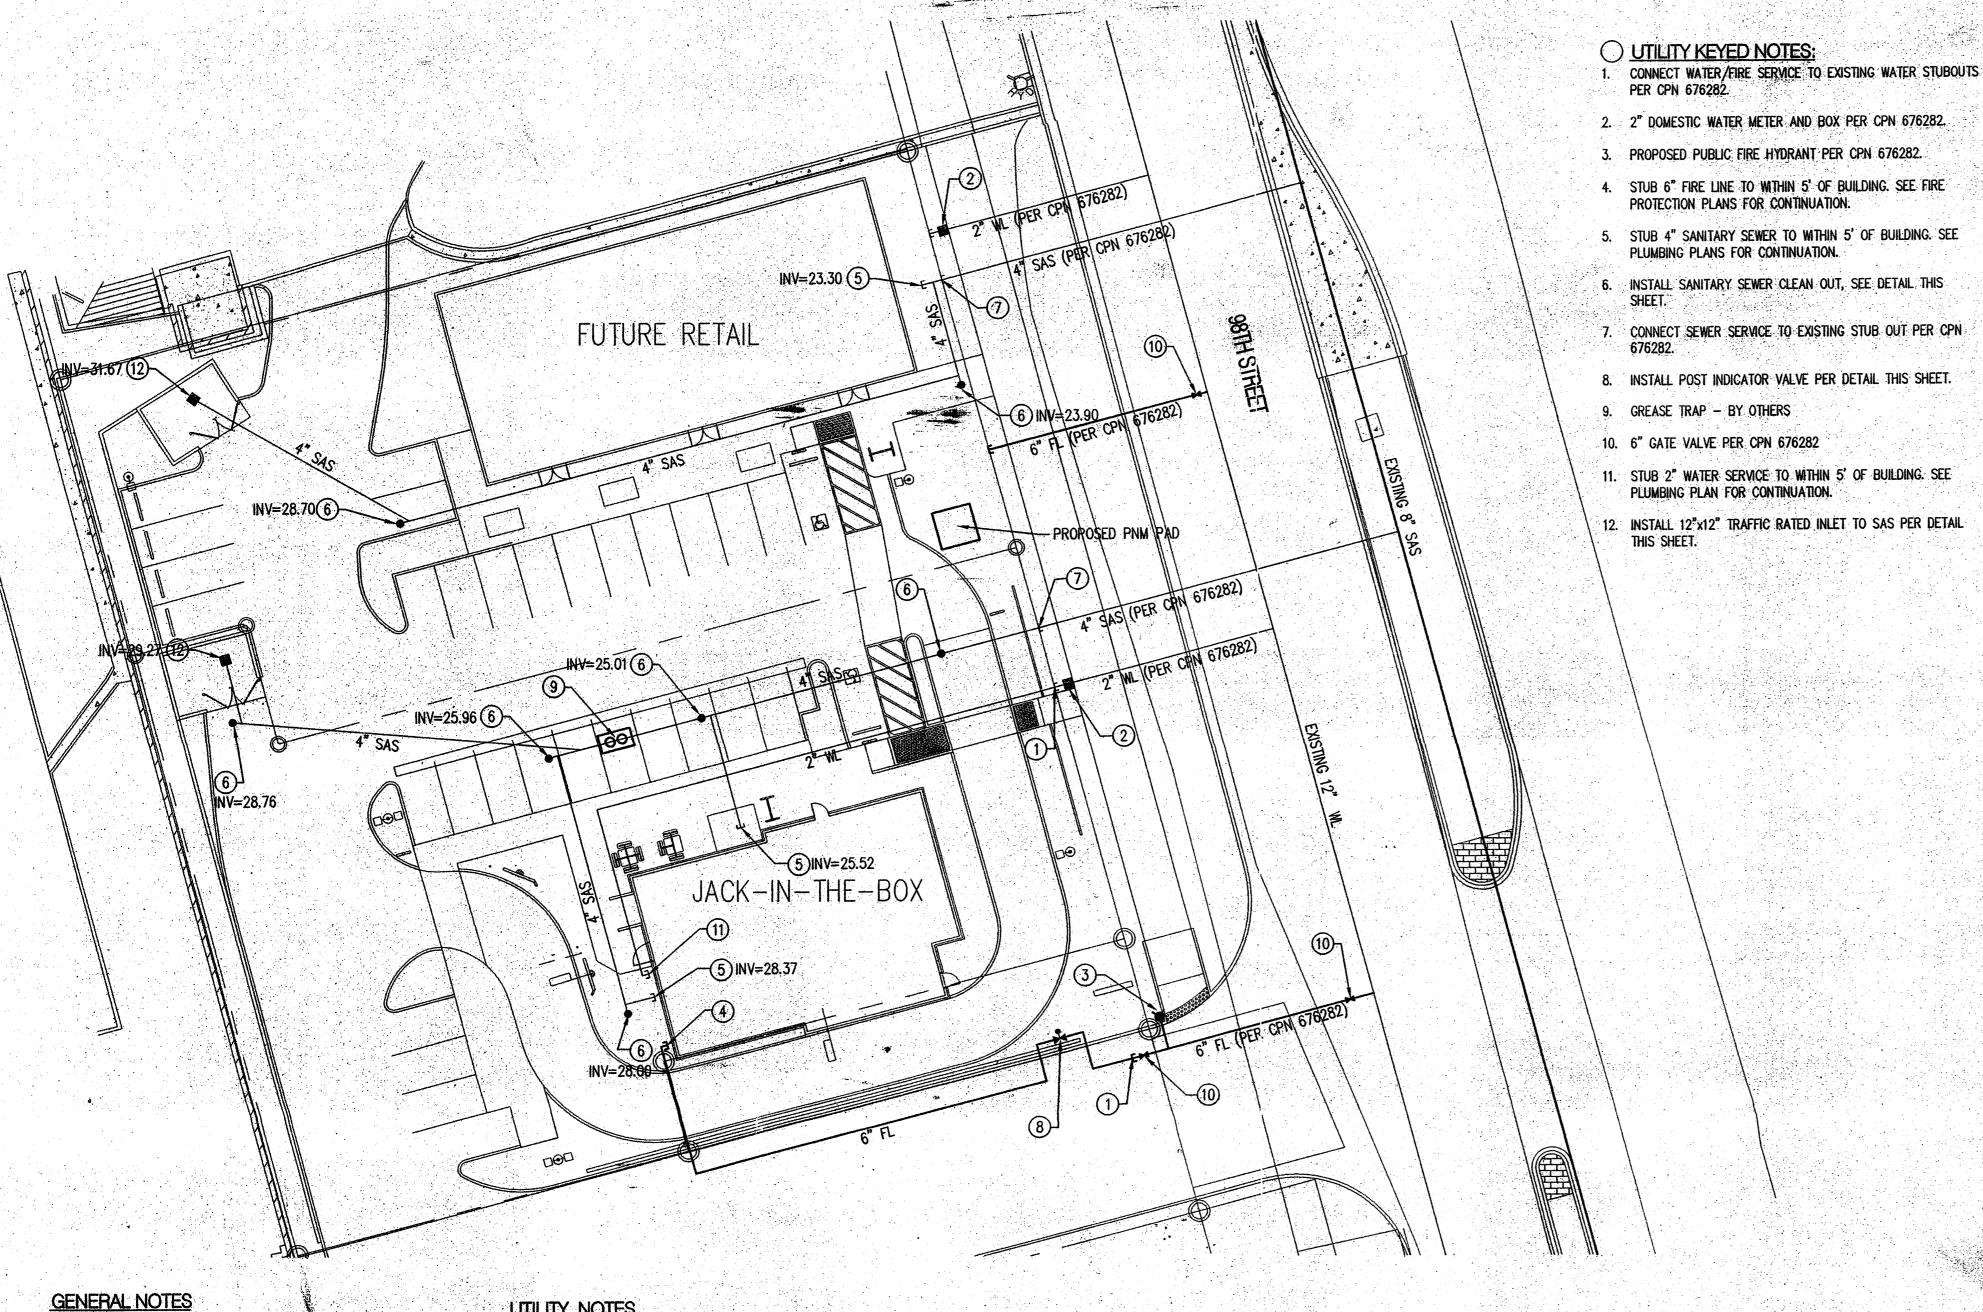


SITE INFORMATION

MK TYPE: 9A\_LG2 1268 F ADDRESS: 98TH / AVALON

ALBUQUERQUE, NM DRAWN BY: LJCA SCALE:

> GRADING PLAN



- 1. THE CONTRACTOR SHALL FIELD VERIFY ALL EXISTING UTILITY LOCATIONS AND NOTIFY THE ENGINEER IMMEDIATELY OF ANY DISCREPANCIES.
- 2. ALL CURVE DATA AND DIMENSIONS ARE CALCULATED FROM CENTERLINE OF PIPE OR MANHOLE, ALL SAS SLOPES ARE CALCULATED TO TRUE PIPE
- 3. GRADE ELEVATIONS, WHERE NOTED, ARE FOR FLOWLINE OF CURB UNLESS OTHERWISE SPECIFIED.
- 4. CONTRACTOR IS TO INSTALL A 4" X 4" X 5' POST AND END AT THE END OF EACH SANITARY SEWER SERVICE.
- 5. CONTRACTOR IS RESPONSIBLE FOR REPAIR AND/OR REPLACEMENT OF ALL UTILITY CONDUITS AND EXISTING LINES.
- 6. CONTRACTOR SHALL PROVIDE THE INSPECTORS WITH THE PROPOSED TESTING PLAN, THE PLAN MUST BE APPROVED BEFORE TESTING OPERATIONS BEGIN.
- 7. CONTRACTOR SHALL PARK EQUIPMENT AND VEHICLES AS NOT TO INTERFERE WITH NORMAL ACTIVITIES OF RESIDENTS OR OTHER CONTRACTORS ON SITE
- 8. ANY DAMAGE TO THE EXISTING FACILITIES (CURB & GUTTER, PAVEMENT, CONDUITS, LANDSCAPING, UTILITY LINES, ETC.) DURING CONSTRUCTION SHALL BE REPLACED AT THE CONTRACTORS' EXPENSE.
- 9. MH RIMS & CATCH BASIN INLET ELEVATIONS, VALVE BOXES, ARV, FIRE HYDRANT & FLANCE ELEVATIONS ARE APPROXIMATE. CONTRACTOR SHALL FIELD VERIFY AND ADJUST TO FINAL PAVEMENT GRADES.
- 10. ALL EXCAVATION, TRENCHING AND SHORING ACTIVITIES MUST BE CARRIED-OUT
- 11. NO TREES MAY BE LOCATED WITHIN 10' OF A SEWER OR WATER LINE.

IN ACCORDANCE WITH OSHA 29 CFR 1926.650 SUBPART P.

12. CONTRACTOR IS RESPONSIBLE FOR OBTAINING ALL PERMITS REQUIRED FOR ANY WORK PERFORMED WITHIN THE CITY OF ALBUQUERQUE RIGHT OF WAY OR WATER AUTHORITY EASEMENTS.

# **UTILITY NOTES**

. THIS CONTRACTOR SHALL BE RESPONSIBLE FOR THE COMPLETE INSTALLATION OF ALL WORK RELATED TO MECHANICAL UTILITIES AS SHOWN ON THIS PLAN INCLUDING: TRENCHING, BACKFILL, SUPPORTS, CLEANOUT PADS, SERVICE STOPS AND BOXES, SERVICE LINES, TESTING, CLEANING, AND STERILIZING. ANY WORK NOT ACCEPTED BY THE ARCHITECT OR ENGINEER DUE TO IMPROPER WORKMANSHIP OR LACK OF PROPER COORDINATION SHALL BE REMOVED AND CORRECTLY INSTALLED AT THE CONTRACTOR'S EXPENSE, AS DIRECTED.

2. MINIMUM DEPTHS OF COVER SHALL BE: 36" FOR WATERLINES, 48" FOR SEWER AND 18" FOR SERVICE LINES

APPROVED FOR FIRE SERVICE.

3. ALL WORK DETAILED ON THESE PLANS TO BE PERFORMED UNDER CONTRACT SHALL, EXCEPT AS OTHERWISE STATED OR PROVIDED OF HEREON, BE CONSTRUCTED IN ACCORDANCE WITH THE IAPMO UNIFORM PLUMBING CODE, LATEST EDITION.

4. UTILITY LINES SHALL BE INSTALLED PRIOR TO PAVEMENT, CURB AND GUTTER, AND/OR SIDEWALK, AS APPLICABLE.

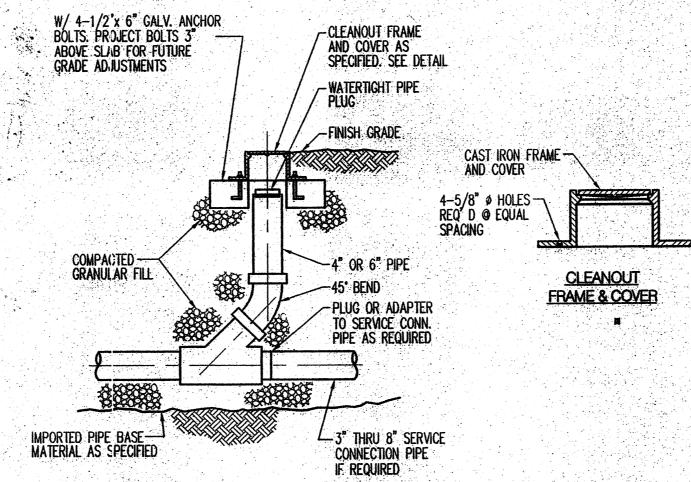
5. ROUGH GRADING OF SITE (±0.5') SHALL BE COMPLETED PRIOR TO INSTALLATION OF UTILITY

6. CONTRACTOR WILL BE RESPONSIBLE FOR CONNECTIONS TO BUILDING DRAIN LINES AND ALL 7. ALL WATERLINE FITTINGS, VALVES, BENDS, TEES & CROSSES SHALL BE RESTRAINED USING


MECHANICAL RESTRAINED JOINTS UNLESSS OTHERWISE NOTED ON PLANS. 8. FIRE LINES SHALL USE PIPE MATERIALS UNDERWRITERS LABORATORIES LISTED AND

9. CONTRACTOR SHALL BE RESPONSIBLE FOR ALL WATER METER, FIRE LINE, AND SEWER HOOKUP FEES FOR INSTALLATIONS. OWNER SHALL BE RESPONSIBLE FOR UTILITY EXPANSION CHARGES, PRORATA AND OTHER SPECIAL ASSESSMENTS.

10. CONTRACTOR SHALL VERIFY INVERTS AND LOCATIONS OF EXISTING WATER/SAS LINES PRIOR TO BEGINNING WORK. ALL CONFLICTS SHALL BE BROUGHT TO ATTENTION OF THE ENGINEER AND RESOLVED PRIOR TO BEGINNING WORK.





SANITARY SEWER CLEAN OUT NOT TO SCALE

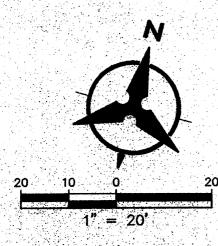


MATERIALS: SAS LINE: SDR-35 PVC WATER LINE: C900-PVC

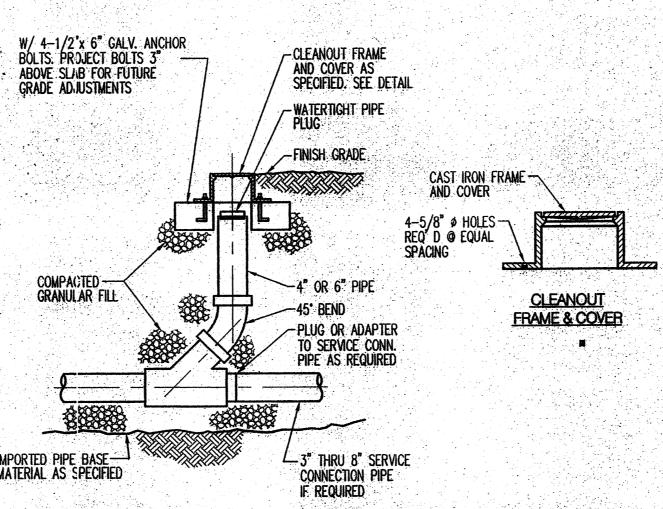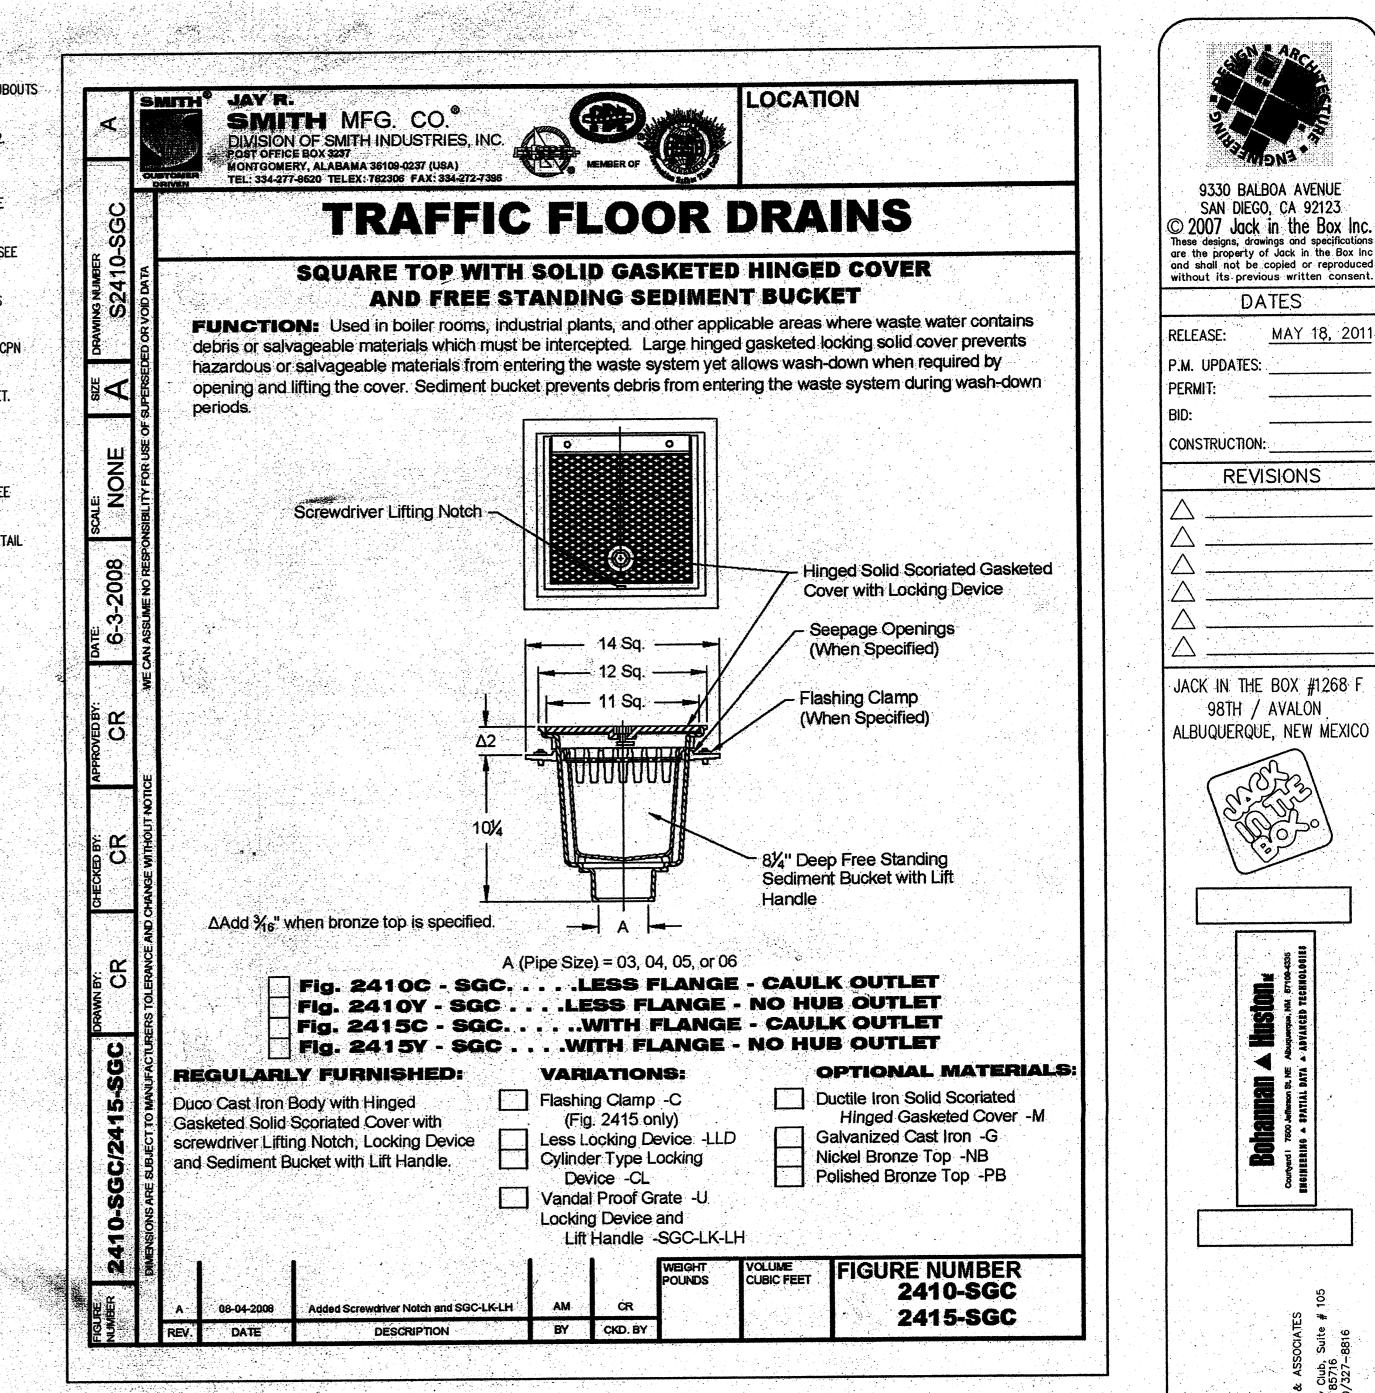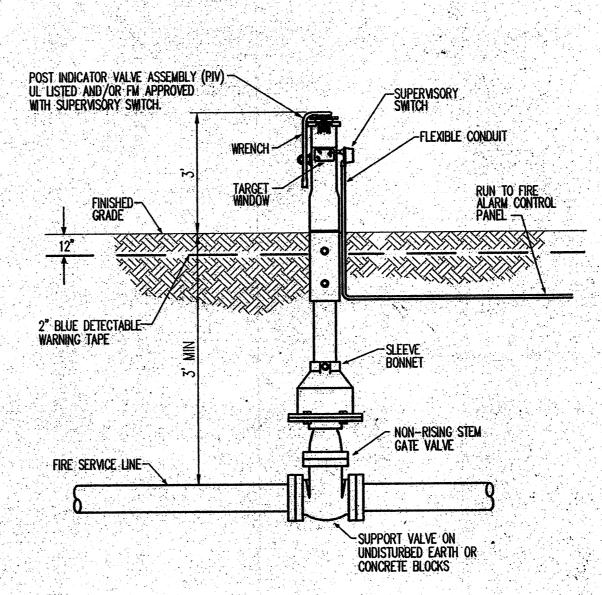
NOTE: CONTRACTOR SHALL VERIFY DEPTH AND LOCATIONS OF ALL EXISTING UTILITIES AND CONTACT ENGINEER IMMEDIATELY WITH ANY DISCREPANCIES.







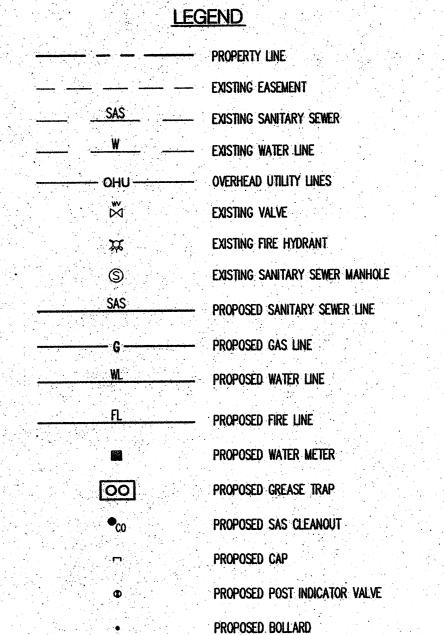POST INDICATOR VALVE DETAIL
NOT TO SCALE



UTILITY

SITE INFORMATION

1268 F

MK TYPE: 9A\_LG2

98TH / AVALON

DRAWN BY: LJCA

ALBUQUERQUE,NM

ADDRESS:

SCALE:

9330 BALBOA AVENUE

SAN DIEGO, CA 92123

2007 Jack in the Box Inc

DATES

**REVISIONS** 

JACK IN THE BOX #1268 F

ALBUQUERQUE, NEW MEXICO

98TH / AVALON

RELEASE:

P.M. UPDATES:

CONSTRUCTION

MAY 18, 2011

# LANDSCAPE NOTES: -Landscape maintenance shall be the responsibility of the Property Owner. The Property Owner shall maintain street trees in a living, healthy, and attractive condition. -It is the intent of this plan to comply with the City Of Albuquerque Water Conservation Landscaping and Water Waste Ordinance planting restriction approach. Approval of this plan does not constitute or imply exemption from water waste provisions of the Water Conservation Landscaping and Water Waste Ordinance. -Water management is the sole responsibility of the Property Owner. All landscaping will be in conformance with the City of Albuquerque Zoning Code, Street Tree Ordinance, Pollen Ordinance, and Water Conservation Landscaping and Mater Maste Ordinance. In general, water conservative, environmentally sound landscape principles will be followed in design and installation. -Plant beds shall achieve 75% live ground cover at maturity. -Santa Fe Brown Gravel over Filter Fabric to a minimum depth of 3" shall be placed in all landscape areas which are not designated to receive native seed. IRRIGATION NOTES: Irrigation shall be a complete underground system with Trees to receive 1 Netafim spiral (50' length) with 3 loops at a final radius of 4.5' from tree trunk, pinned in place. Netafim shall have emitters 12" o.c. with a flow of 6 gph. \$hrubs to receive (2) 1.0 GPH Drip Emitters. Drip and Bubbler systems to be tied to 1/2" polypipe with flush caps at each end. Trees and shrubs shall be on separate valves. Run time per each shrub drip valve will be approximately 15 minutes per day. Tree drip yalve shall run 1.5 hours, 3 times per week. Run time will be adjusted according to the season. Point of connection for irrigation system is unknown at current time and will be coordinated in the field. Irrigation will be operated by automatic controller. Location of controller to be field determined and power source for controller to be provided by others. irrigation maintenance shall be the responsibility of the Property Owner. -Mater and Power source shall be the responsibility of the Developer/Builder. GRAPHIC SCALE SCALE: 1"=10' 1500 sf 748 sf 36 sf 36 sf 453 sf 102 sf 112 sf ww

# I ANDSCAPE CALCULATIONS

TOTAL LOT AREA	35475	square feet
TOTAL BUILDINGS AREA	6692	square feet
NET LOT AREA	28783	square feet
LANDSCAPE REQUIREMENT	15%	
TOTAL LANDSCAPE REQUIREMENT	4317	square feet
TOTAL BED PROVIDED	9396	square feet
GROUNDCOVER REQ.	75%	square feet
TOTAL GROUNDCOVER REQUIREMENT	7239	square feet
TOTAL GROUNDCOVER PROVIDED _	8362 (89%)	square feet
B. & B. & & B. & B. & B. & B. & B. & B.		
TOTAL PONDING AREA	0	square feet
TOTAL SOD AREA	0	square feet
(max. 20% of landscape required)		
TOTAL NATIVE SEED AREA	0	square feet
TOTAL LANDSCAPE PROVIDED _	9396 (32%)	square feet

# STREET TREE REQUIREMENTS

Street trees required under the COA Street Tree Ordinance are as follows:

Name of Street: 98th Required 7 Provided 7

remain per plan.

1 Shade tree per 10 spaces

Required 4 Provided 4

PARKING LOT TREE REQUIREMENTS

Shade trees required under the COA

Parking Lot Tree Ordinance are as follows:

Should The Hilltop not receive a Grading and Drainage plan during the design process or the on-site grades differ from the Grading and Drainage plan received. The Hilltop reserves the right to apply slope stabilization materials where the specified gravel will not be suitable. Gravel smaller than 2-4" cobblestone will not stay on a slope greater than 3:1. If the grades are greater than what was originally designed, we will request an infield change-order to lay cobblestone or rip-rap, in lieu of the specified gravel, to stabilize the slope. All vegetative material shall

# PLANT LEGEND

All plants shall be sized per American Standard for Nursery Stock

# TREES: SHADE, ORNAMENTAL AND EVERGREEN

Water (M) Allergy (L) Osf

COMMON HACKBERRY 2 JAPANESE PAGODA TREE Sophora japonica 2" Cal., 12'-14' Inst./35' x 35' maturity Celtis occidentalis 2" Cal., 12'-14' Inst./40' x 40' maturity Water (M) Allergy (L) Osf Mater (M) Allergy (L) Osf CHITALPA 3 Chilopsis x Catalpa 2" Cal., 12'-14' Inst./ 30' x 30' maturity

Lonicera japonica

Tree Trunk

Root Ball

Emitter-12" o.c.

PURPLE-LEAF PLUM 1 Prunus cerastifera 1 1/2" Cal., 10'-12' Inst./20' x 20x maturity Water (M) Allergy (L) Osf \* WESTERN RED CEDAR 2 Thuja plicata 'Green Giant' 15 Gal., 4'-10' Inst./40' x 15' maturity Water (M) Allergy (L) 225sf

### GROUNDCOVERS/VINES

LADY BANK'S ROSE (M) 2 Rosa banksiae 5 Gal. 400sf Unstaked Groundcover

HARDSCAPES SANTA FE BROWN GRAVEL WITH FILTER FABRIC TO A MINIMUM 3" DEPTH

Netafim Spiral Detai

OVERSIZED GRAVEL # BOULDERS

HONEYSUCKLE (M) 16 PALM YUCCA (L) O Unstaked-Groundcover MUGO PINE (M) 4

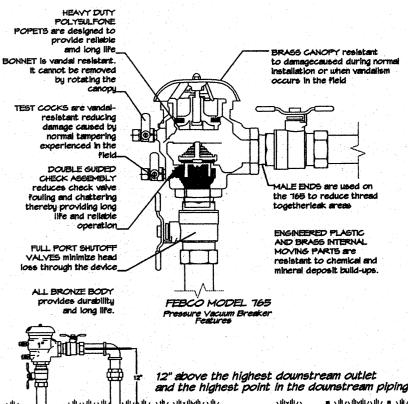
Pinus mugo 5 Gal. 95f

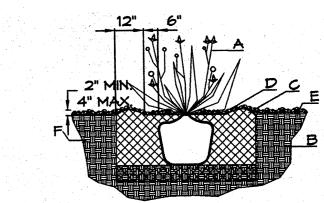
5 Gal. 16sf

5 Gal.

REGAL MIST (M) 14

OCOTILLO (L) Fouquieria splendens






# SHRUB PLANTING DETAIL

#### GENERAL NOTES:

1. THE OUTSIDE DIAMETER OF THE WATER RETENTION BASIN SHALL BE TWICE THE DIAMETER OF THE SHRUB PLANTING PIT.

### CONSTRUCTION NOTES:

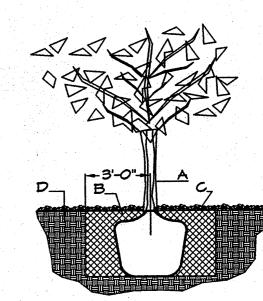- B. BACKFILL WITH EXISTING SOIL. C. EARTH BERM AROUND WATER RETENTION BASIN.
- D. 3" DEPTH OF GRAVEL MULCH. E. FINISH GRADE.
- F. UNDISTURBED SOIL.



# TREE PLANTING DETAIL

#### GENERAL NOTES:

I. ROOTBALL SHALL BE PLACED ON UNDISTURBED SOIL TO PREVENT TREE FROM SETTLING.

2. TOP OF ROOTCOLLAR INDICATED LEVEL AT WHICH TREE WAS GROWN AND DUG; THIS REPRESENTS THE LEVEL AT WHICH THE TREE SHOULD BE INSTALLED; THAT LEVEL MAY BE EXCEEDED BY ONLY A ONE INCH LAYER OF SOIL. 3. PRIOR TO BACKFILLLING TREE, ALL WIRE, ROPE AND SYNTHETIC MATERIALS SHALL BE REMOVED FROM THE TREE AND THE PLANTING PIT.

4. PRIOR TO BACKFILLING ALL BURLAP SHALL BE CUT AWAY EXCEPT FROM BOTTOM OF THE ROOTBALL.

### CONSTRUCTION NOTES:

- A. TREE B. BACKFILL WITH EXISTING SOIL C. 3" DEPTH OF GRAVEL MULCH.
- D. UNDISTRUBED SOIL.

# SHRUBS/ORNAMENTAL GRASSES

\* RED TIP PHOTINIA 8 Photinia fraseri \* PARNEY COTONEASTER 974 Cotoneaster lacteus \$ . } 5 Gal., 64sf 5 Gal., 144sf CATMINT (M) 25 MAIDENGRASS (M) 3 Nepeta mussini Miscanthus sinensis 1 Gal. 4sf, 1' H x 2' W

THREADGRASS (M) 6 SCOTCH BROOM (M) 4 Stipa tennuisima Cytisus scoparius 1 Gal. 4sf

> WILDFLOWER 21 1 Gal.

Muhlenbergia capillaris DESERT ACCENTS

> AGAVE (L) 5 Agave spp. 16 sf

RED YUCCA (L) 6 Hesperaloe parviflora 5 Gal. 9sf

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9330 BALBOA AVENUE

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DATES

REVISIONS

5 5-5-11 cm COA comments

1-26-11 cmj client comments

1 1-25-11 cmj revised site plan

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**DCTOBER 18, 2010** 

RELEASE

P.M. UPDATES

CONSTRUCTION:

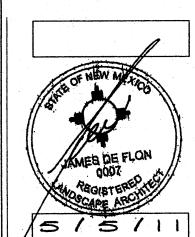
4 2-28-11 cmj

3 1-27-11 cmj

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for Nursery Stock.




SITE INFORMATION MK TYPE 9A\_LG

xxxx F

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FEBCO MODEL 765 Pressure Vacuum Breaker

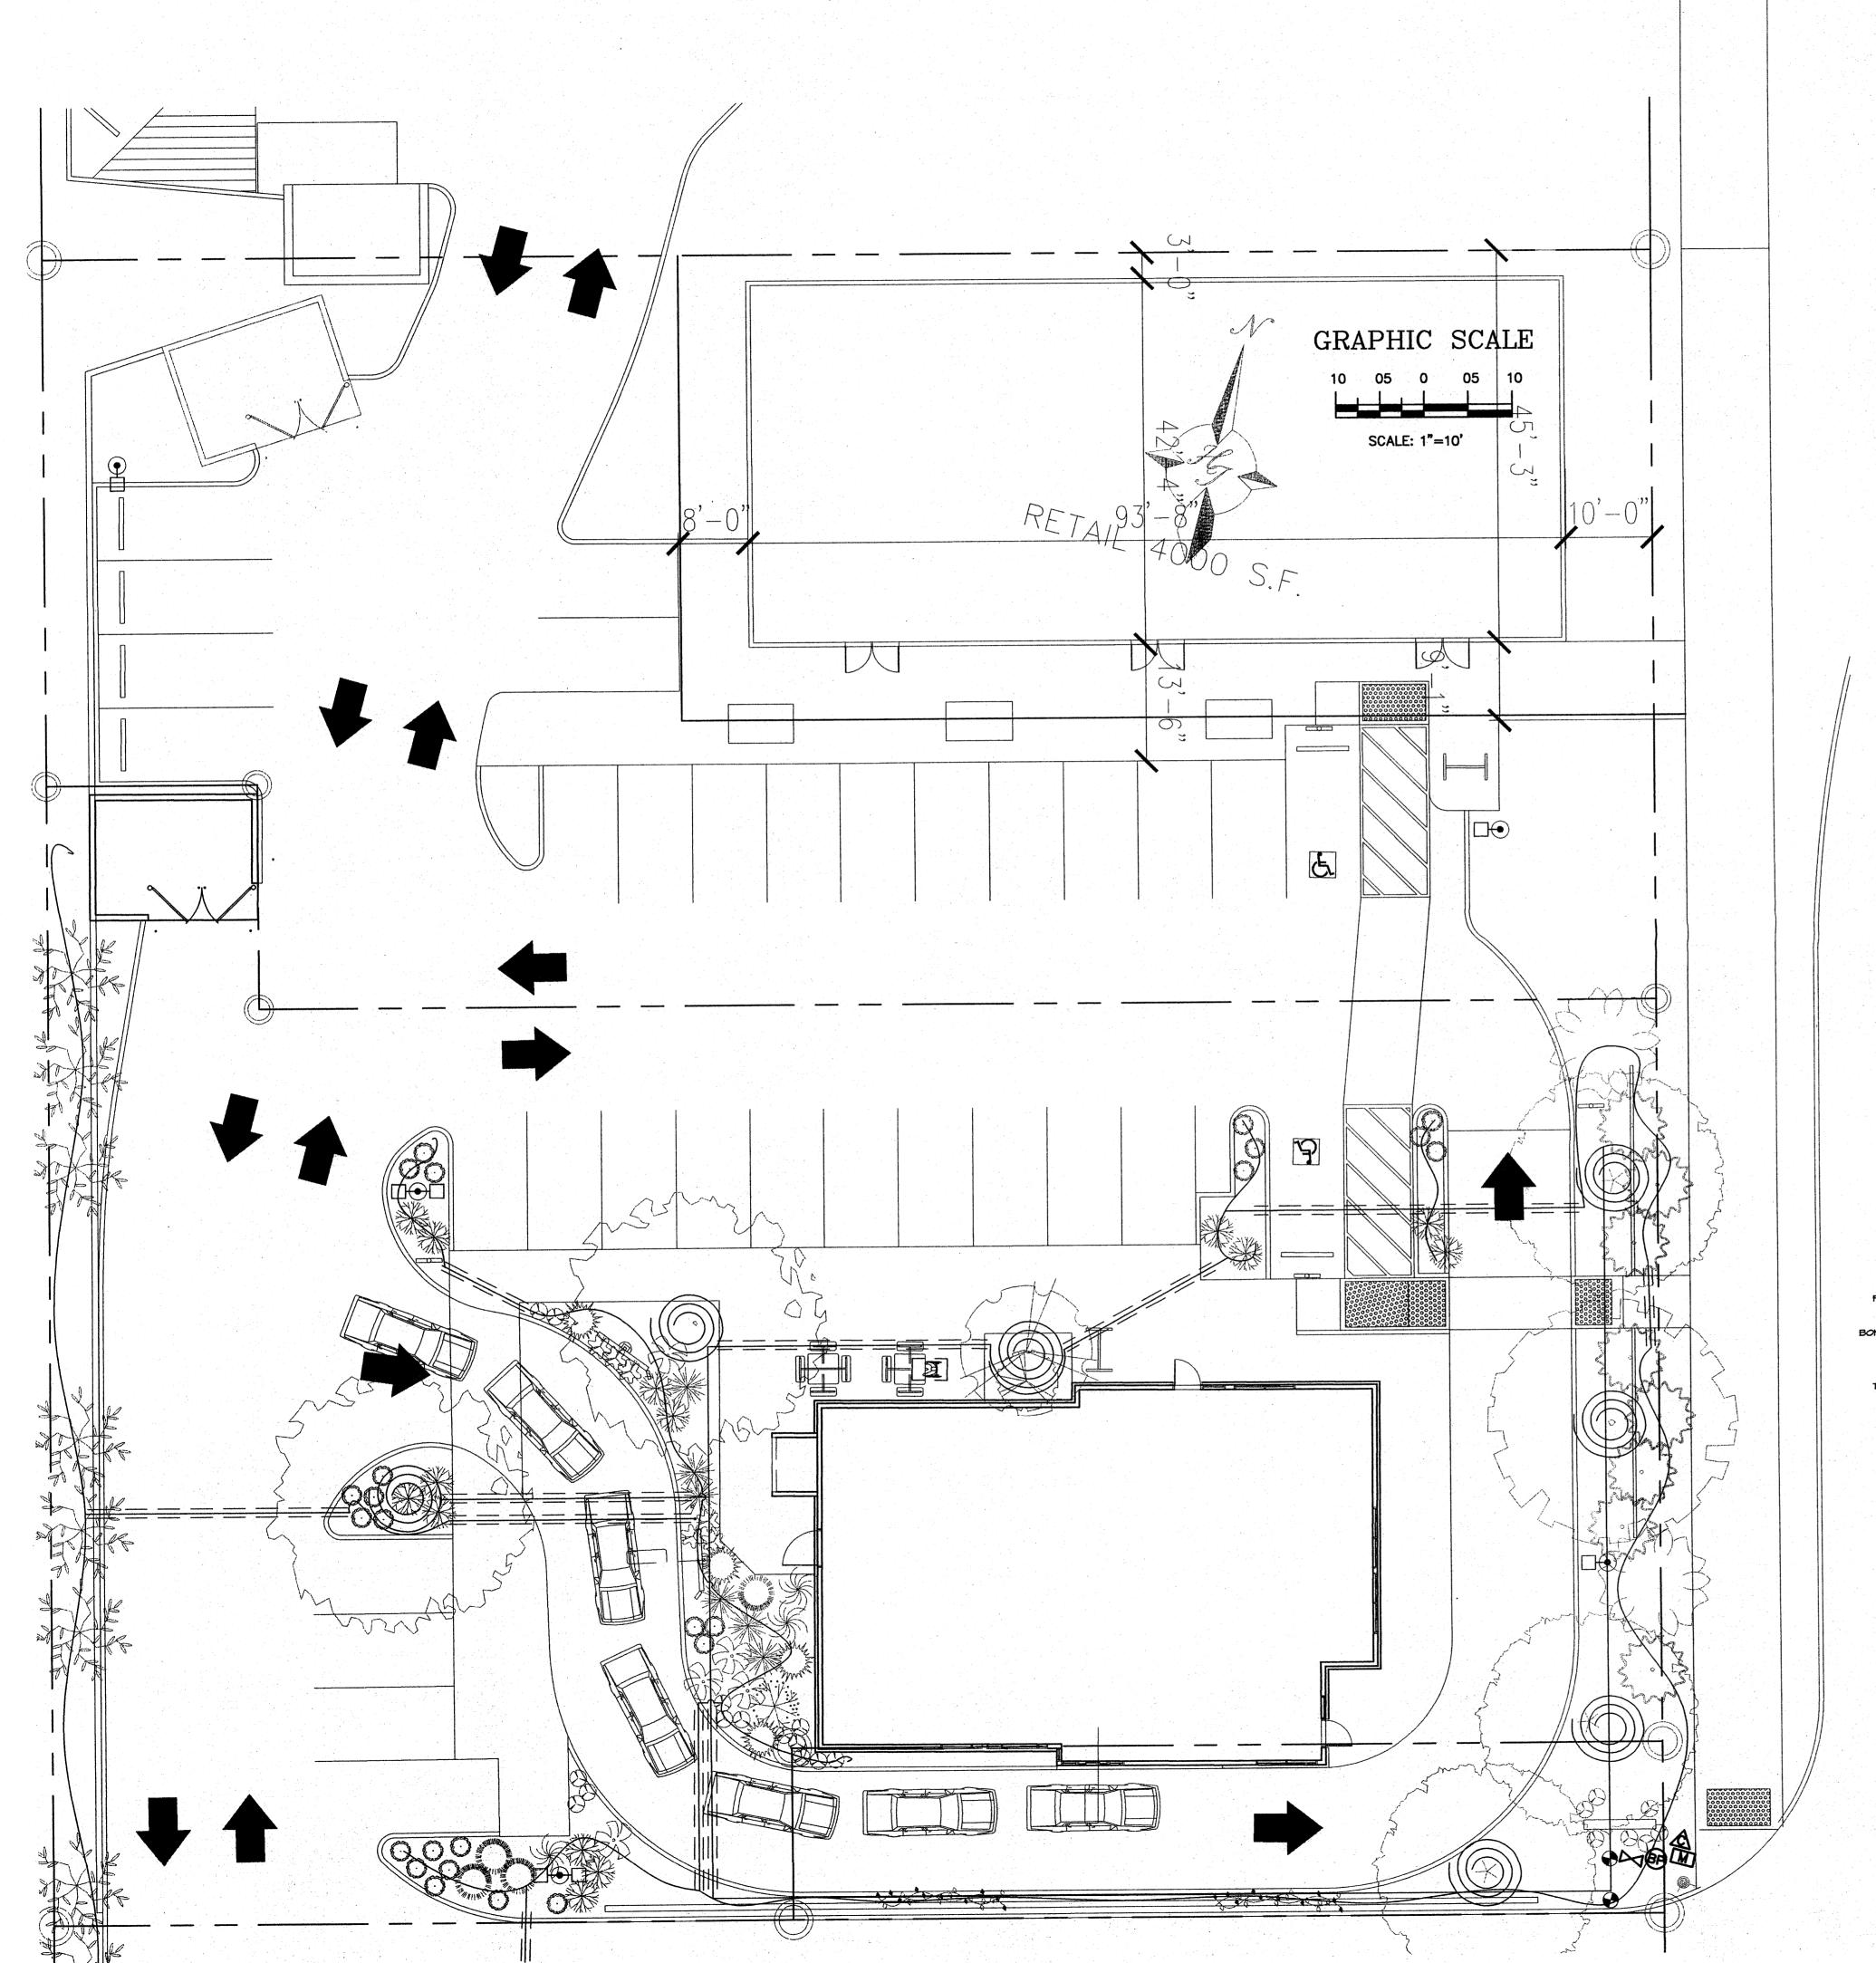

# IRRIGATION LEGEND

BACKFLOW PREVENTOR

CONTROLLER

WATER METER- 1" By Others

MASTER VALVE

LATERAL, SIZE PER PLAN (UNSIZED PIPE TO BE 3/4").

DRIP LINE, SIZE PER PLAN (UNSIZED DRIP LINE TO BE 1/2").

SLEEVE, 2X PIPE TO BE SLEEVED.



Netafim Spiral Detail

IRRIGATION NOTES:

Irrigation shall be a complete underground system with Trees to receive 1 Netafim spiral (50' length) with 3 loops at a final radius of 4.5' from tree trunk, pinned in place. Netafim shall have emitters 12" o.c. with a flow of .6 gph. Shrubs to receive (2) 1.0 GPH Drip Emitters. Drip and Bubbler systems to be tied to 1/2" polypipe with flush caps at each end. Trees and shrubs shall be on separate valves.

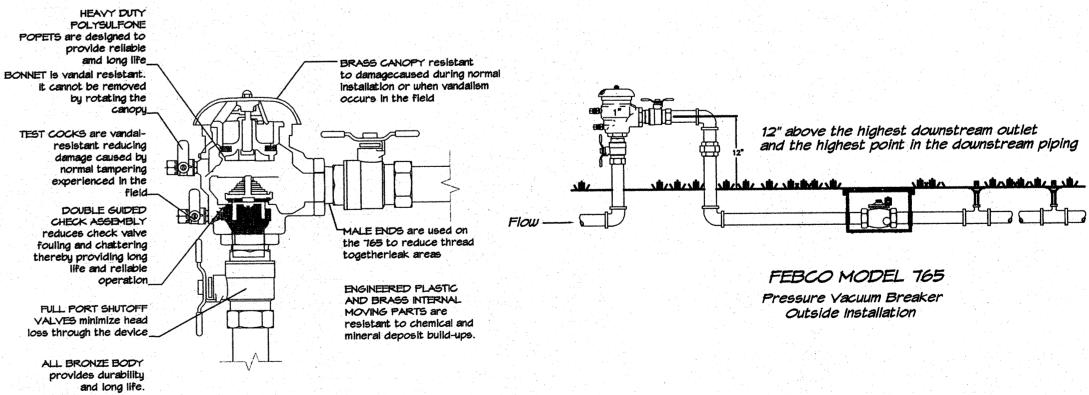
Run time per each shrub drip valve will be approximately 15 minutes per day. Tree drip valve shall run 1.5 hours, 3 times per week. Run time will be adjusted according to the season.

Point of connection for irrigation system is unknown at current time and will be coordinated in the field. Irrigation will be operated by automatic controller.

Location of controller to be field determined and power source for controller to be provided by others.

Irrigation maintenance shall be the responsibility of the Property Owner.

Water and Power source shall be the responsibility of the Developer/Builder.







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DATES **DCTUBER 18, 2010** RELEASE:

CONSTRUCTION:\_

REVISIONS

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Tree Trunk

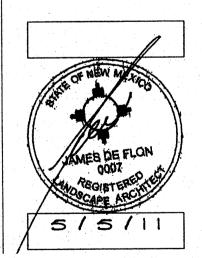
Root Ball

Emitter-12" o.c.

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