

LEGAL DEBCRETTION

TRACTS "B" & "C" OF RENAISSANCE III, REPLAT OF LOTS 3 AND 4. BLOCK 4. AND TRACT 6-A OF SUNDT'S INDUSTRIAL CENTER

SU-1 FOR C-2 PERMISSIVE USES ONLY

SHEET INDEX

- 1. SITE PLAN FOR SUBDIMISION
- 2. SITE PLAN FOR BUILDING PERMIT
- 3. GRADING AND DRAINAGE PLAN
- 4. MASTER UTILITY PLAN
- 5. LANDSCAPE PLAN
- 6. MCDONALD'S ELEVATIONS
- 7. GAS STATION ELEVATIONS - 8. STARBUCK'S ELEVATIONS

LEGEND

EXISTING SAS MANHOLE EXISTING METER

EXISTING VALVE W/BOX

EXISTING FIRE HYDRANT

EXISTING AIR RELEASE VALVE

EXISTING REDUCER

---EX. 8" SAS--- EXISTING SANITARY SEWER LINE

EXISTING WATER LINE

PROPOSED SIDEWALK

01450-00000-00132 2.99.116

PROJECT NUMBER 1000874

7/20/01 Date 4-11-01 Date

City Engineer, Engineering Division / AMAFCA APPROVAL AND CONDITIONAL ACCEPTANCE: as specified by the

8/10/01 Date


Michael Holton ON condition will comply Solid Waste with all Bolid Vacte spaces


PLNZ (10706) 4/96


ENGINEER'S SEAL
RAY BOAR BOAR BOAR BOAR BOAR BOAR BOAR BOAR
RONALD R. BOHANNAN P.E. #7868

MONTANO PADS		
	DATE	
SITE PLAN	7-10-01	
FOR SUBDIVISION	9997SPSILII	
	SHEET #	
TIERRA WEST, LLC	10F	
8509 JEFFERSON NE ALBUQUERQUE, NEW MEXICO 87113 (505)858-3100		
(505)858-3100	JOB #	
	1	

990097

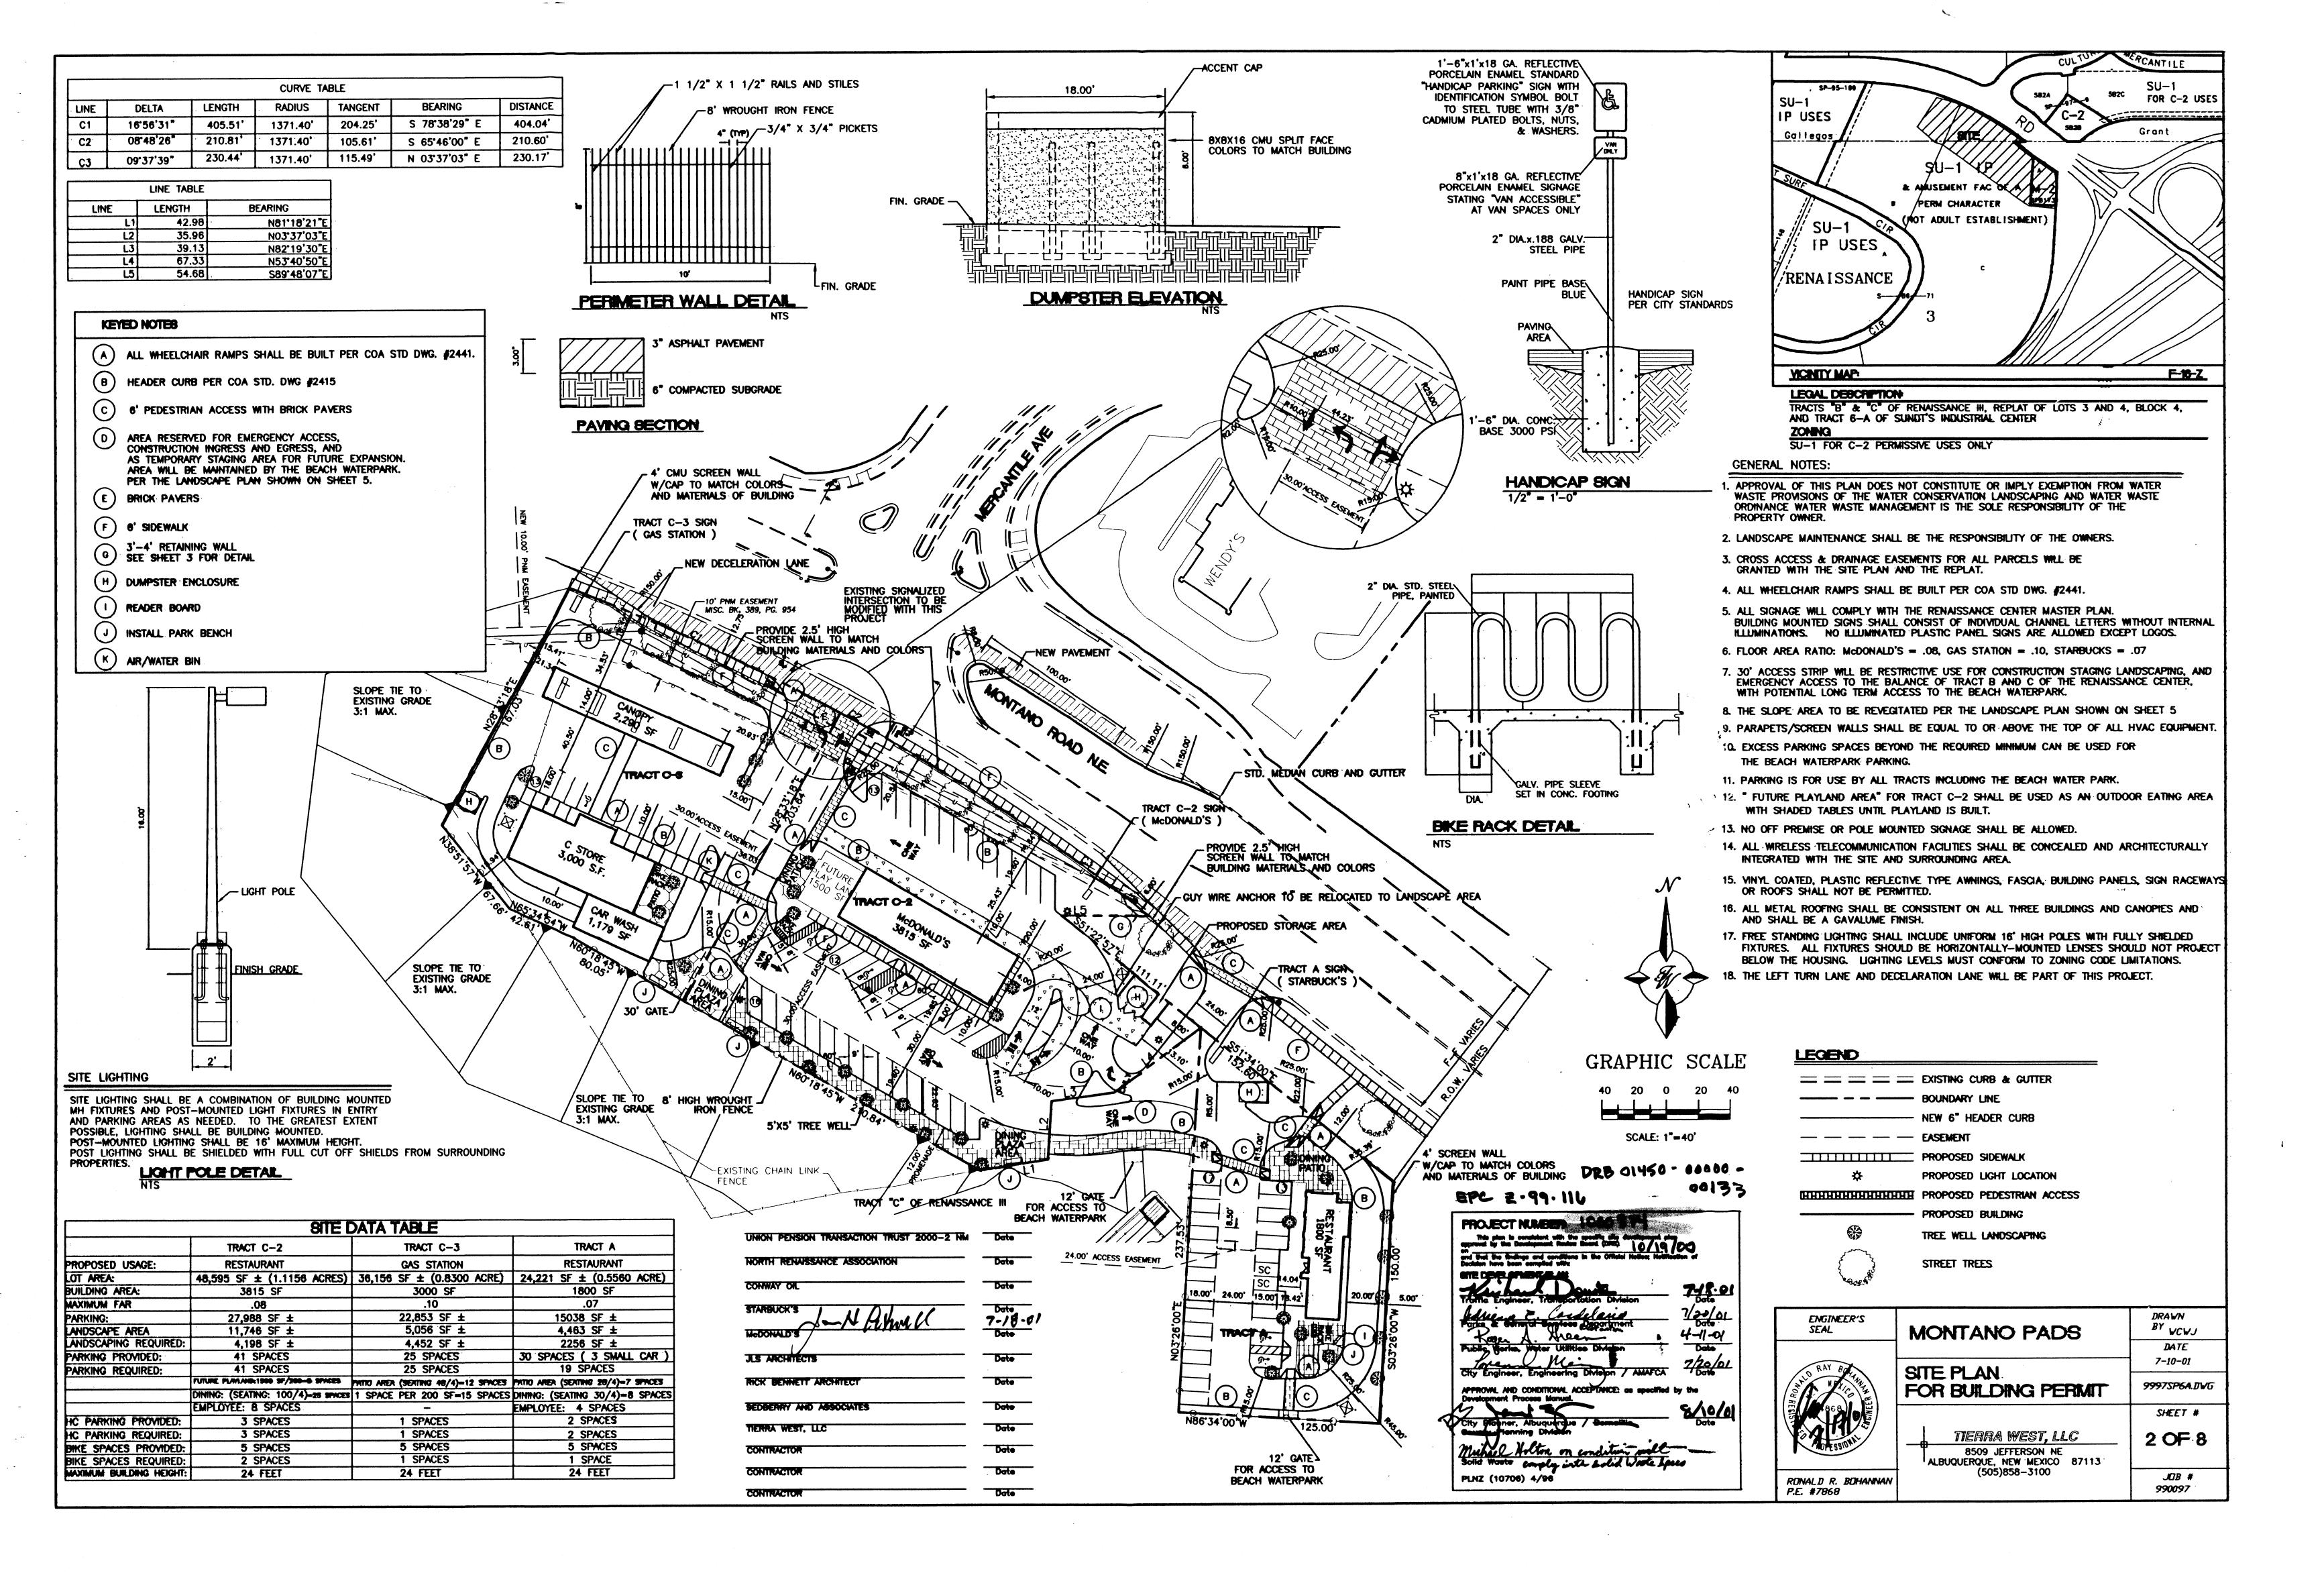

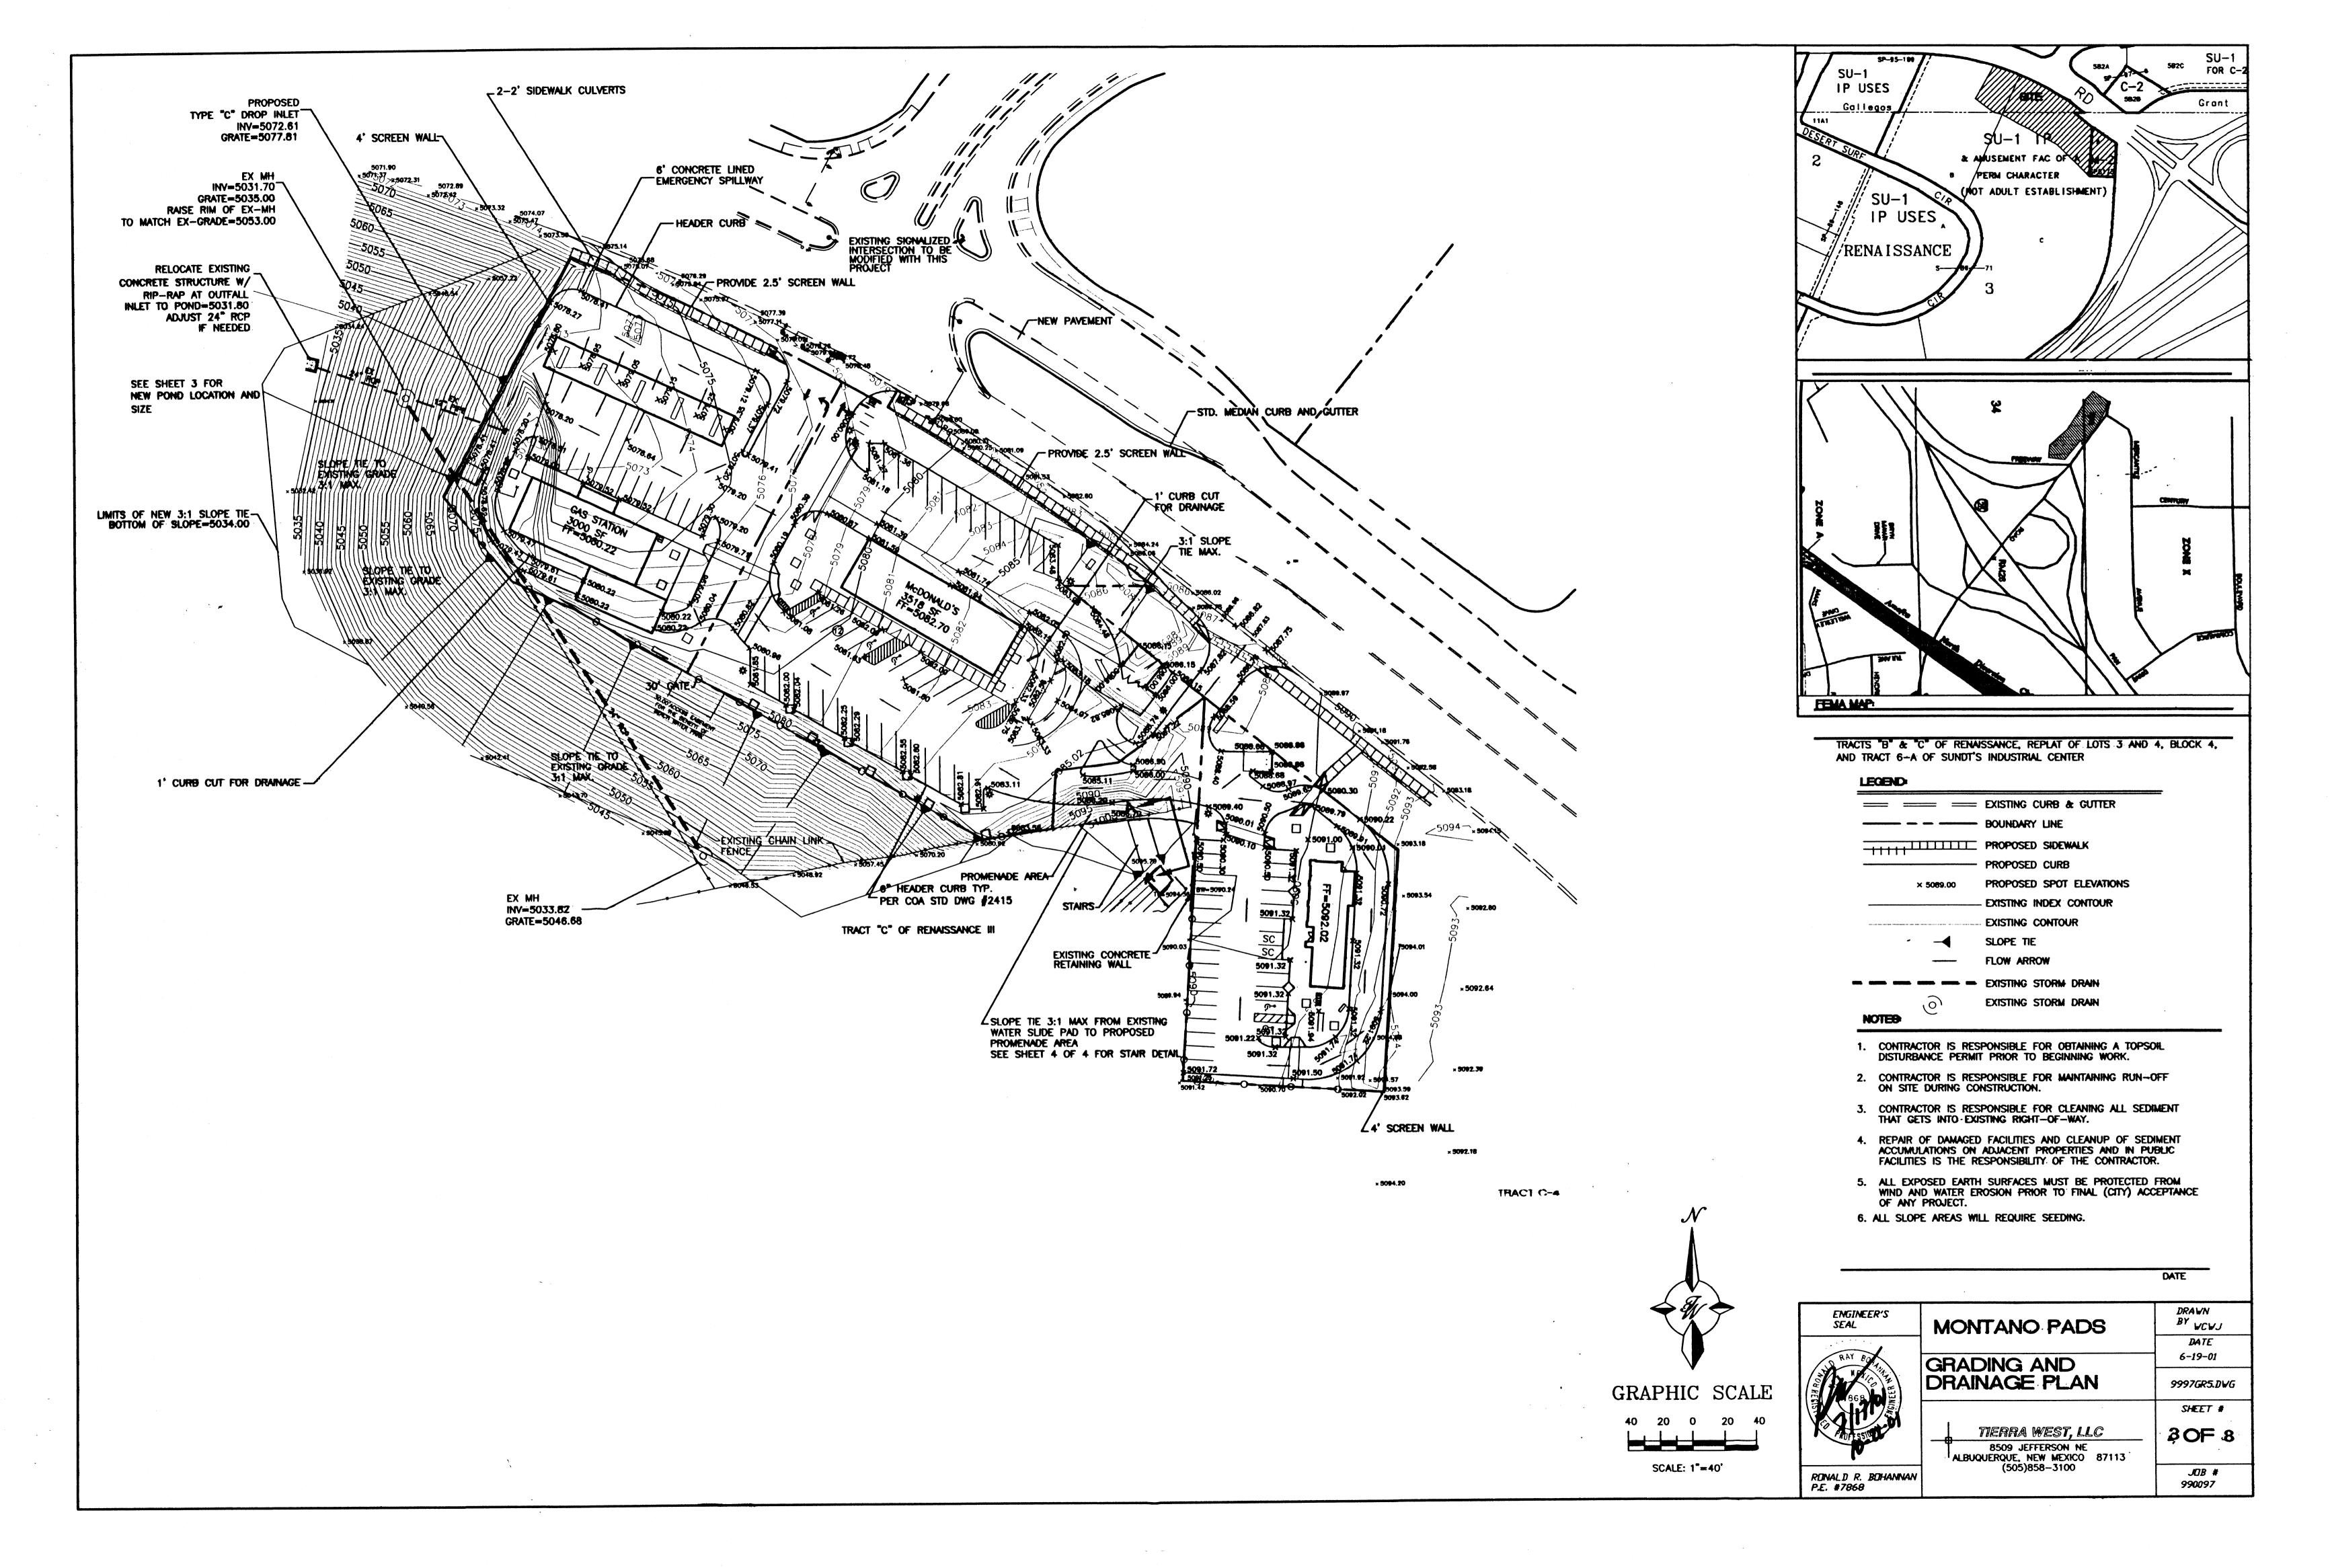

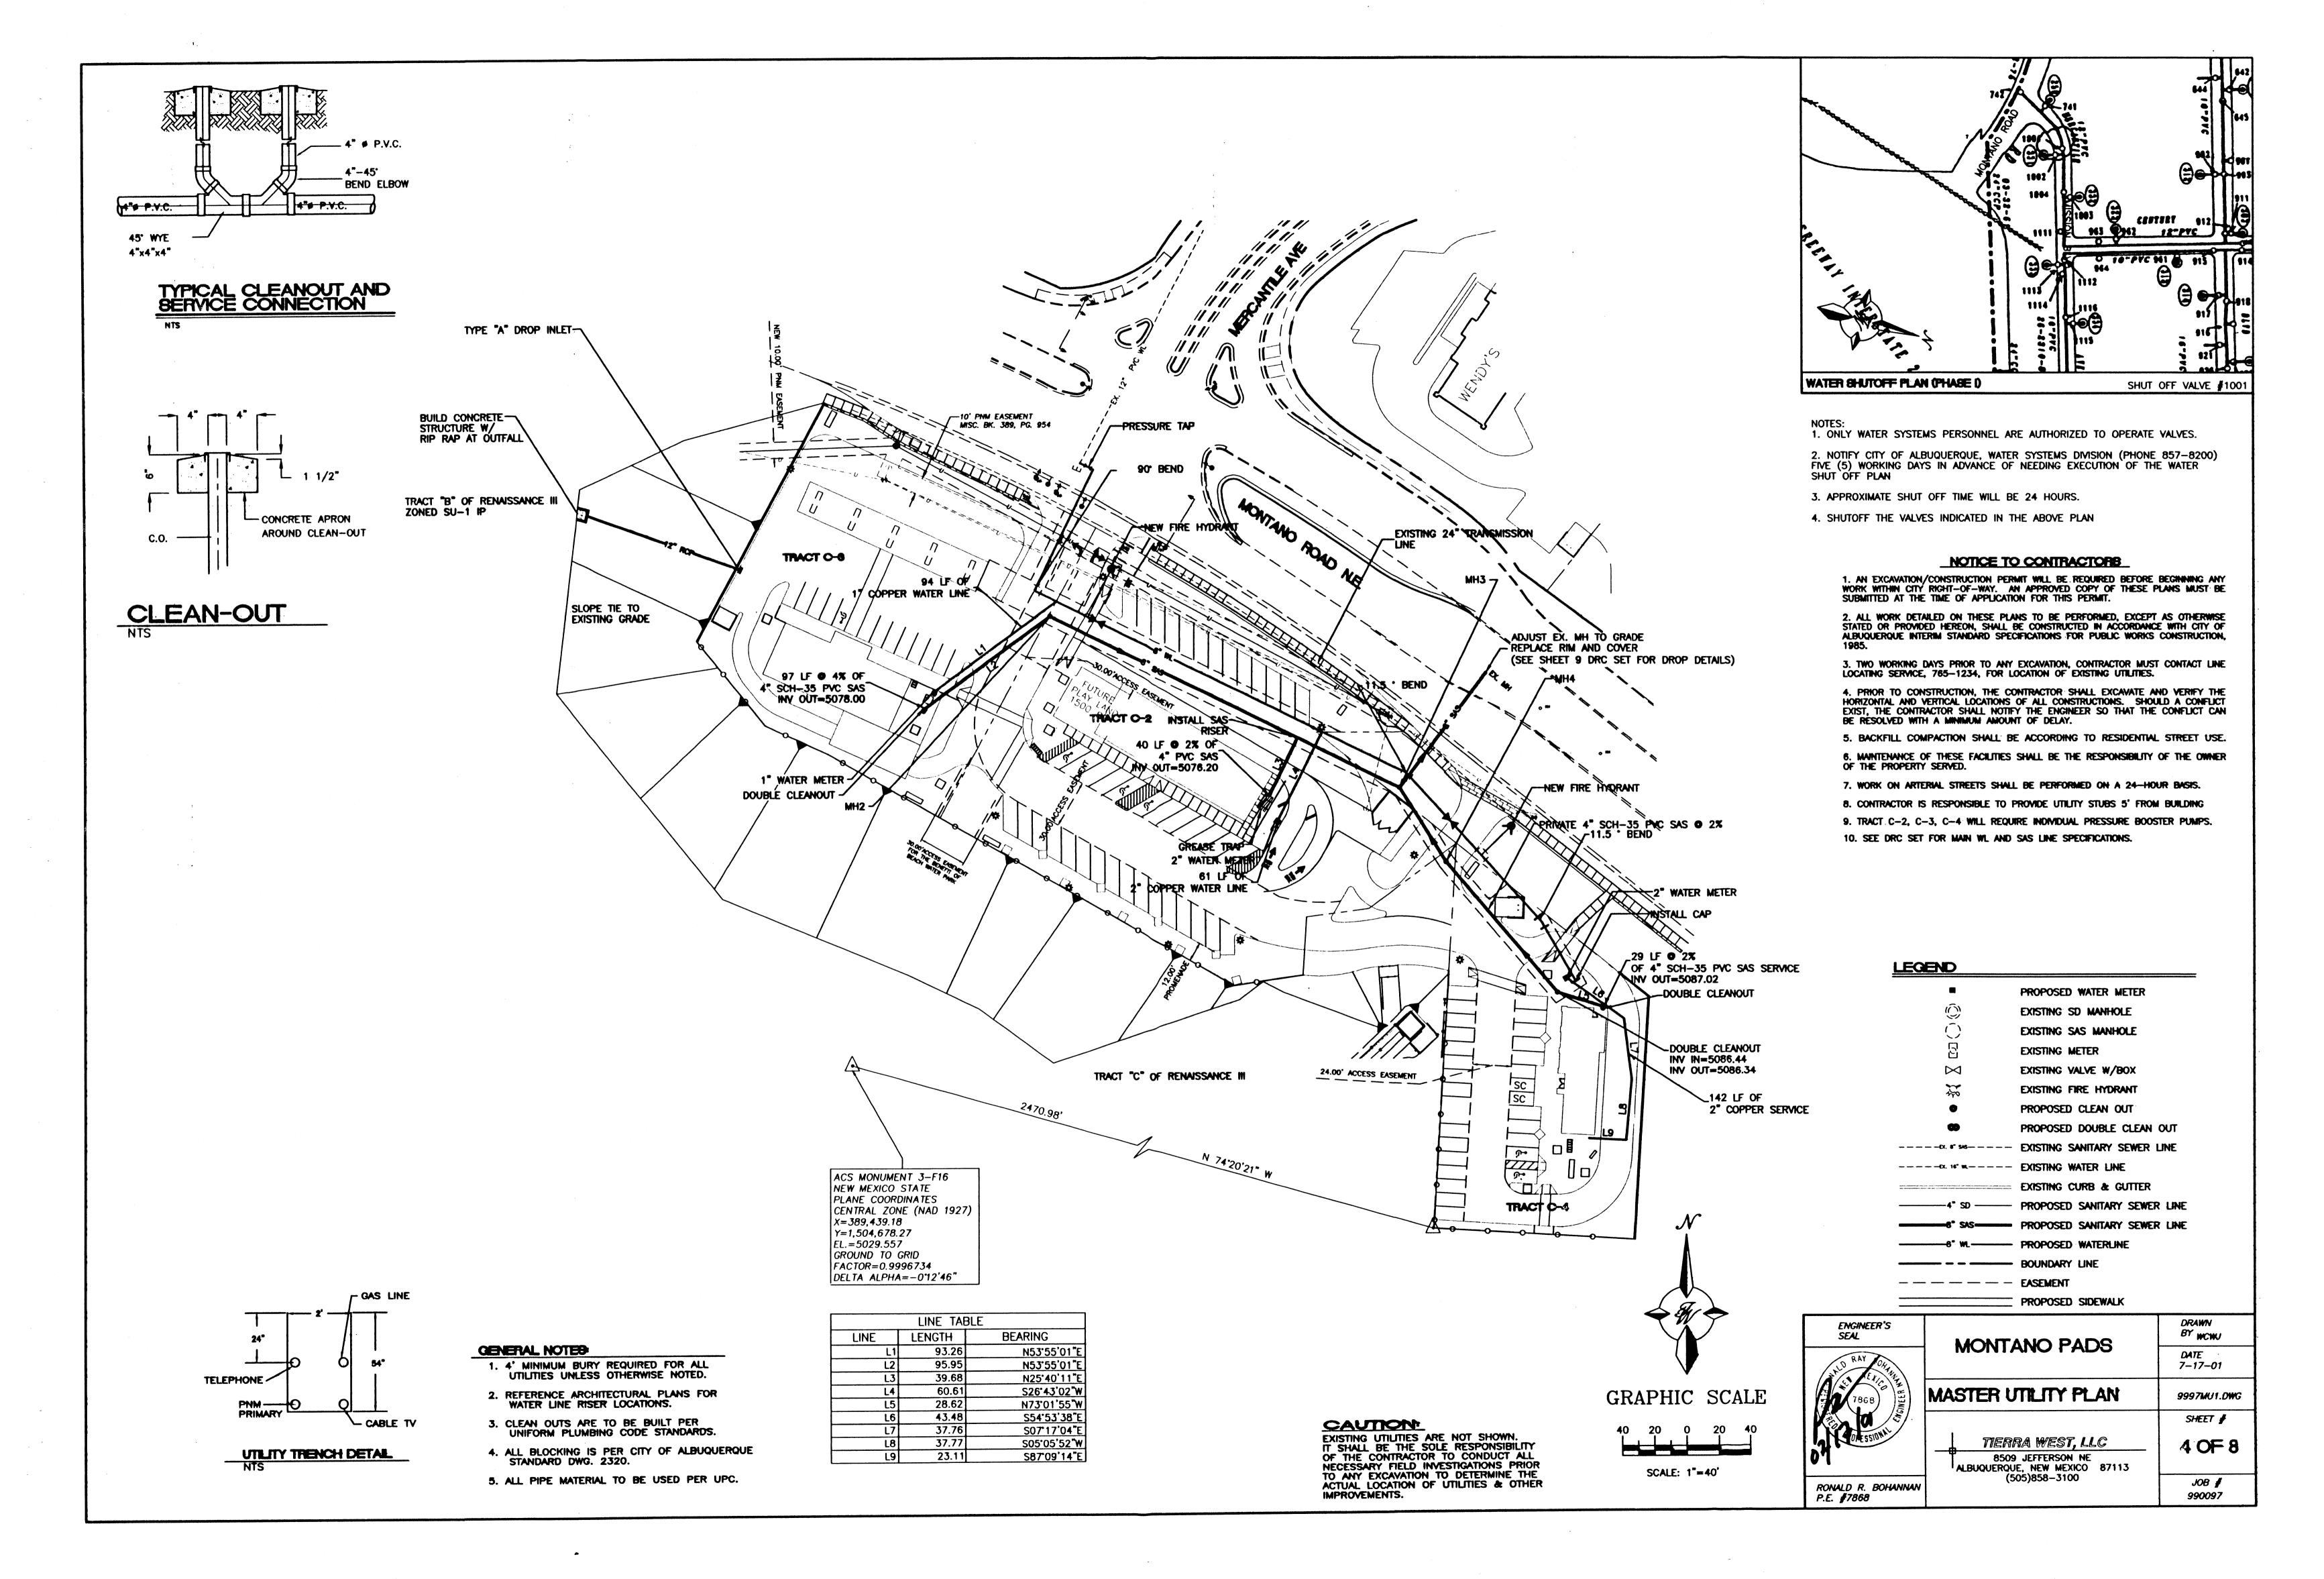

LANDSCAPE NOTES:

Landscape maintenance shall be the responsibility of the Property Owner.

It is the intent of this plan to comply with the City Of Albuquerque, Water Conservation Landscaping and Water Waste Ordinance, planting restriction approach.

Approval of this plan does not constitute or imply exemption from water waste provisions of the Water Conservation Landscaping and Water Waste Ordinance. Water management is the sole responsibility of the Property Owner.

All landscaping will be in conformance with the City of Albuquerque Zoning Code, Street Tree Ordinance, Pollen Ordinance, and Water Conservation Landscaping, and Water Waste Ordinance. In general, water conservative, environmentally sound landscape principles will be followed in design and installation.

Plant beds shall achieve 75% live ground cover at maturity.

3/4" Santa Ana Tan Gravel over Filter Fabric shall be placed in all landscape areas which are not designated to recieve native seed.

IRRIGATION NOTES:

irrigation shall be a complete underground system with Trees to receive (5) 1.0 GPH Drip Emitters and Shrubs to receive (2) 1.0 GPH Drip Emitters. Drip and Bubbler systems to be tied to 1/2" polypipe with flush caps at each end.

Run time per each drip valve will be approximately 15 minutes per day, to be adjusted according to the season.

Point of connection for irrigation system is unknown at current time and will be coordinated in the field.

Irrigation will be operated by automatic controller. Location of controller to be field determined and power source for controller to be provided by others.

SLOPE TIE TO 8' HIGH WROUGHT EXISTING GRADE IRON FENCE
3:1 MAX.

5'X5' TREE

-EXISTING CHAIN LINK


2" DIA. STD. STEELY Irrigation maintenance shall be the responsibility of the Property Owner. - 4' CMU SCREEN WALL W/CAP TO MATCH COLORS
AND MATERIALS OF BUILDING TRACT C-3 SIGN GALV. PIPE SLEEVE (GAS STATION) SET IN CONC. FOOTING NEW DECELERATION LANE BIKE RACK DETAIL -10' PNM EASEMENT

FOR ACCESS TO BEACH WATERPARK

24.00' ACCESS EASEMENT

12' GATE

FOR ACCESS TO BEACH WATERPARK

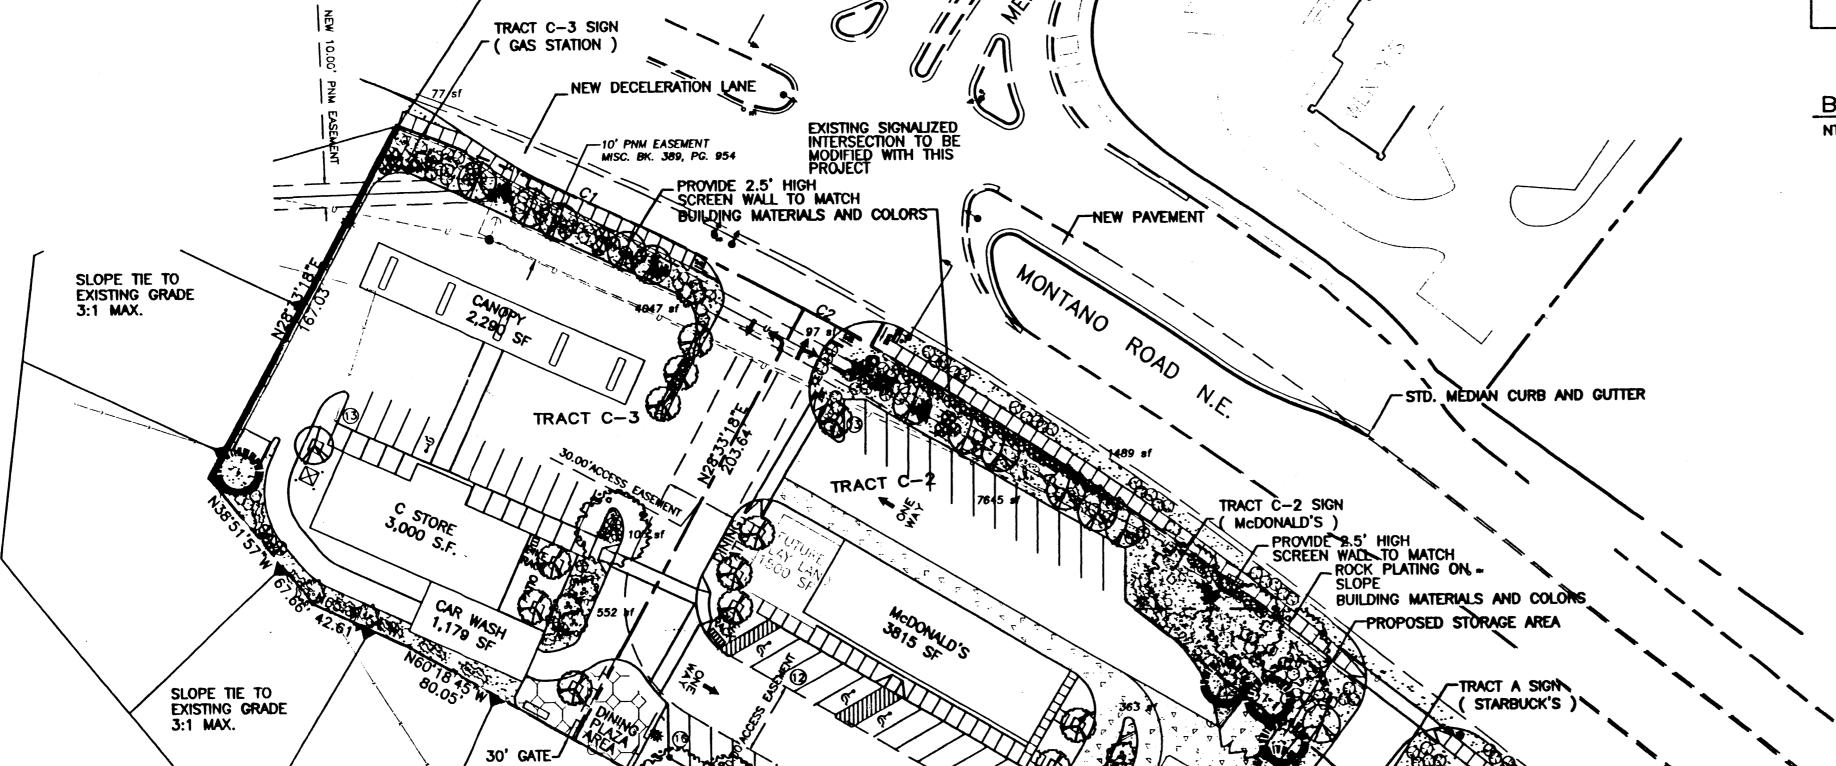



GRAPHIC SCALE

SCALE: 1"=40'

SCREEN WALL
W/CAP TO MATCH COLORS AND MATERIALS OF BUILDING

> Cont. Lic. #26458 7909 Edith N.E. Albuquerque, NM 87184 Ph. (505) 898-9690 Fox (505) 898-7737 it@hilltoplandscaping.com


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PLANT LEGEND



ASH (H) OR HONEY LOCUST (H) 30
Fraxinus pennsylvanica
Gleditsia triacanthos
2 1/2" Cal.

WASHINGTON HAWTHORN (H) 7 Crataegus phaenopyrum 2" Cal.

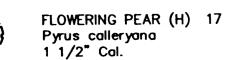

NEW MEXICO OLIVE (M) 16 Forestiera neomexicana



PALM YUCCA (L) 2

INDIAN HAWTHORN (M) 51 Raphiolepis indica

BANK'S ROSE (M) 11 Rosa banksii

RUSSIAN SAGE (M) 35 Perovskia atriplicifolia

MAIDEN GRASS (M) 15 Miscanthus sinensis

APACHE PLUME (L) 20

TAM JUNIPER (M) 60 Juniperus sabina

AUTUMN SAGE (M) 61 Salvia greggii

WILDFLOWER 78



OVERSIZED GRAVEL & BOULDERS 5





3/4" SANTA ANA TAN GRAVEL W/ FILTER FABRIC

LANDSCAPE CALCULATIONS

NET LANDSCAPE AREA

TOTAL LOT AREA	111,636	square feet
TOTAL BUILDINGS AREA	10,491	square feet
OFFSITE AREA	5,510	square feet
NET LOT AREA	95,635	square feet
LANDSCAPE REQUIREMENT	.15	percent
TOTAL LANDSCAPE REQUIREMENT	14,345	square feet
TOTAL LANDSCAPE PROVIDED	25,765	square feet
TOTAL BED PROVIDED	25,765	square feet
TOTAL SOD PROVIDED	0	square feet
TOTAL NATIVE SEED PROVIDED	0	square feet

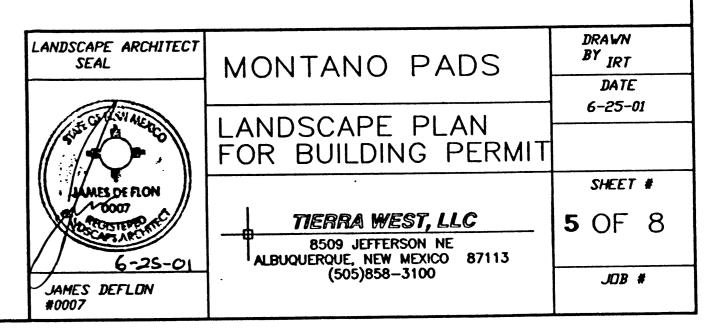

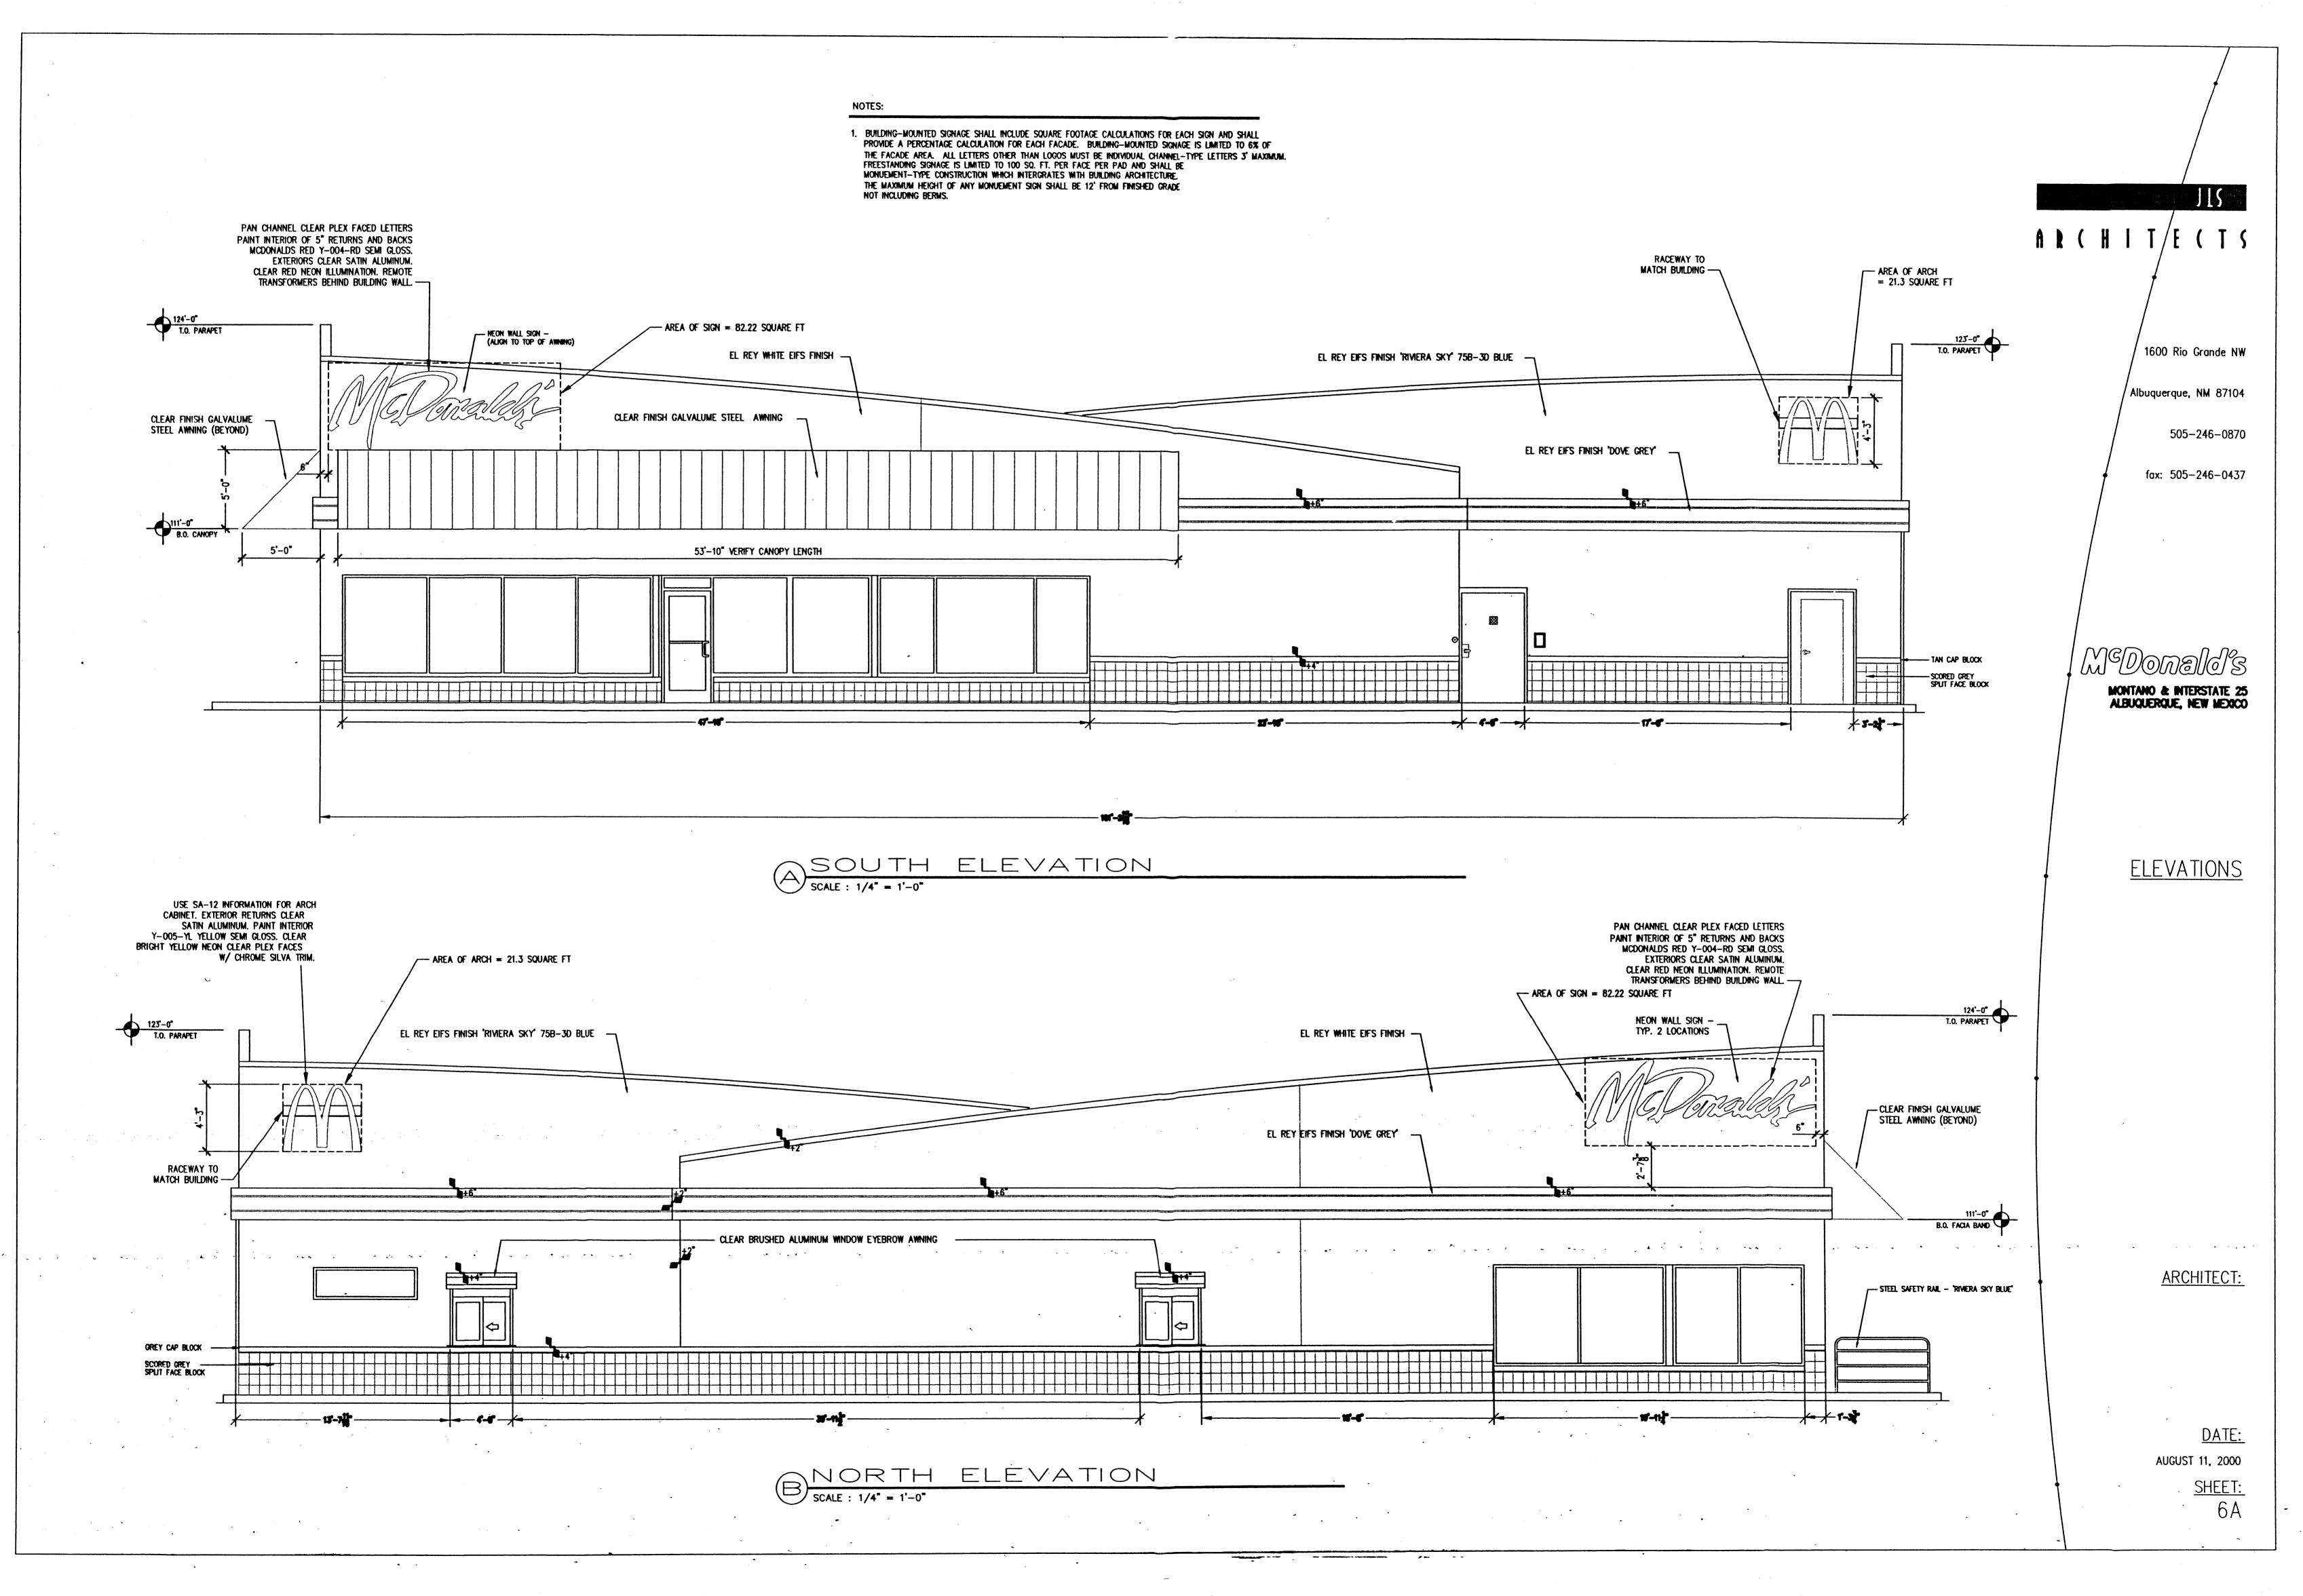

AR (HIT/E (TS

1600 Rio Grande NW

Albuquerque, NM 87104


505-246-0870

fax: 505-246-0437

GRADE SCORED CREY
SPLIT FACE BLOCK

MONUMENT SIGN

SCALE: 1/4" = 1'-0" SEE SHEET 3 OF 3 DETAILS

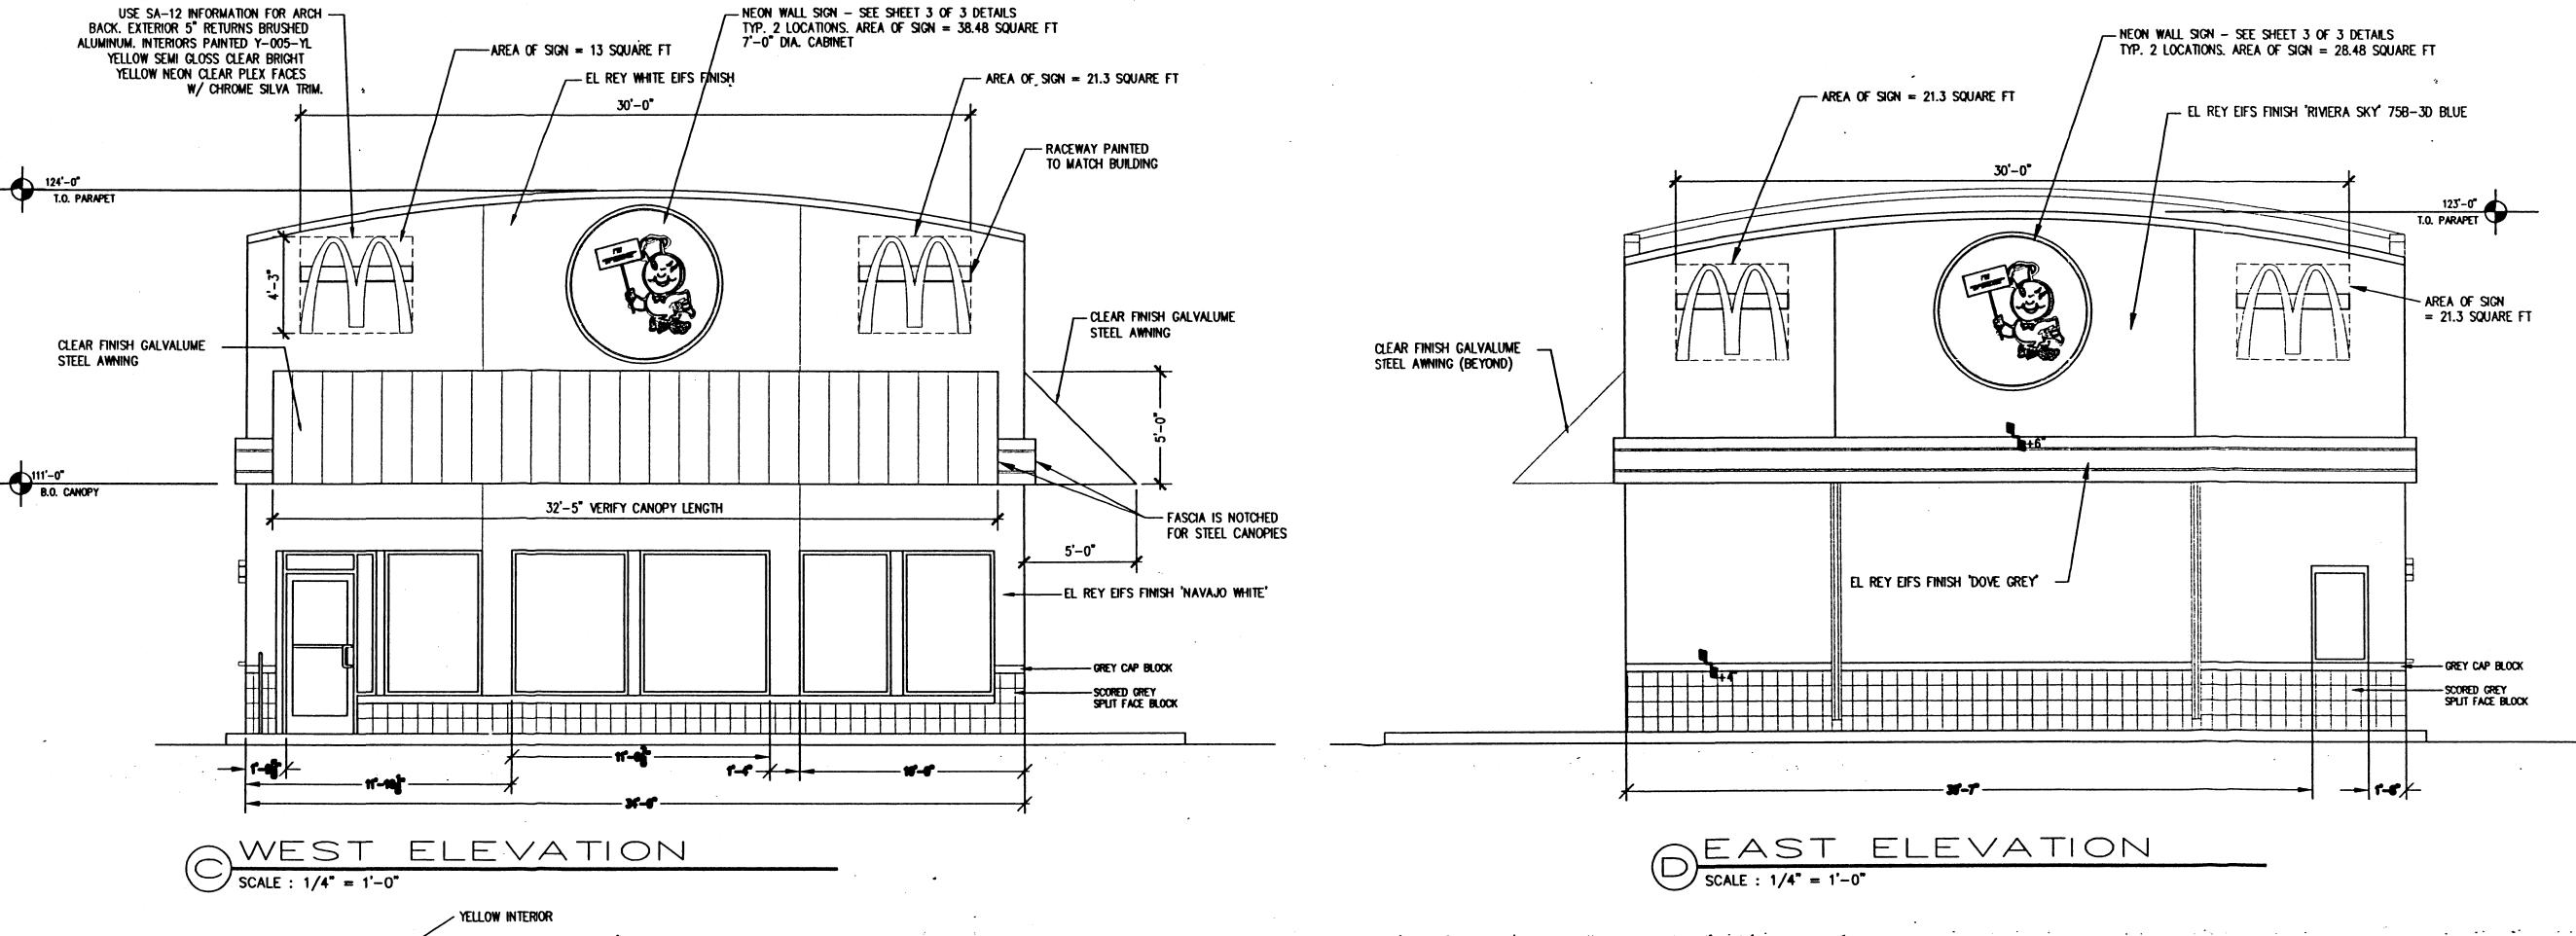

SATIN ALUMINUM FINISH

BOTTOM OF RACEWAY

SCALE 1/2"=1'-0"

ARCH RACEWAY SIGN

SCALE: 1/2" = 1'-0"

ARCH NOTES

CONSTRUCTION:

PROVIDE ALUMINUM ARCH LOGOS ON RACEWAY (6) REQUIRED.

FINISHES:
ARCH EXTERIORS TO BE CLEAR SATIN ALUMINUM.
PAINT ARCH INTERIORS Y-005-YL YELLOW SEMI-GLOSS.
RACEWAY COLOR TO MATCH ALUMINUM OF ARCH RETURNS.
FACES & DECORATION:

FACES & DECORATION:
FLAT CLEAR PLEX FACES
W/1" CHROME SILVATRIM
ILLUMINATION:

NEON AS NOTED:
ARCHES TO BE 15 MM BRIGHT YELLOW NEON INSTALLATION:

MOUNT TO BRACKETS PROVIDED BY CONTRACTOR

NOTES:

1. BUILDING-MOUNTED SIGNAGE SHALL INCLUDE SQUARE FOOTAGE CALCULATIONS FOR EACH SIGN AND SHALL PROVIDE A PERCENTAGE CALCULATION FOR EACH FACADE. BUILDING-MOUNTED SIGNAGE IS LIMITED TO 6% OF THE FACADE AREA. ALL LETTERS OTHER THAN LOGOS MUST BE INDIVIDUAL CHANNEL-TYPE LETTERS 3' MAXIMUM. FREESTANDING SIGNAGE IS LIMITED TO 100 SQ. FT. PER FACE PER PAD AND SHALL BE MONUEMENT-TYPE CONSTRUCTION WHICH INTERGRATES WITH BUILDING ARCHITECTURE. THE MAXIMUM HEIGHT OF ANY MONUEMENT SIGN SHALL BE 12' FROM FINISHED GRADE NOT INCLUDING BERMS.


MONTANO & INTERSTATE 25 ALBUQUERQUE, NEW MEXICO


ELEVATIONS


ARCHITECT:

<u>DATE:</u> AUGUST 11, 2000

SHEET:

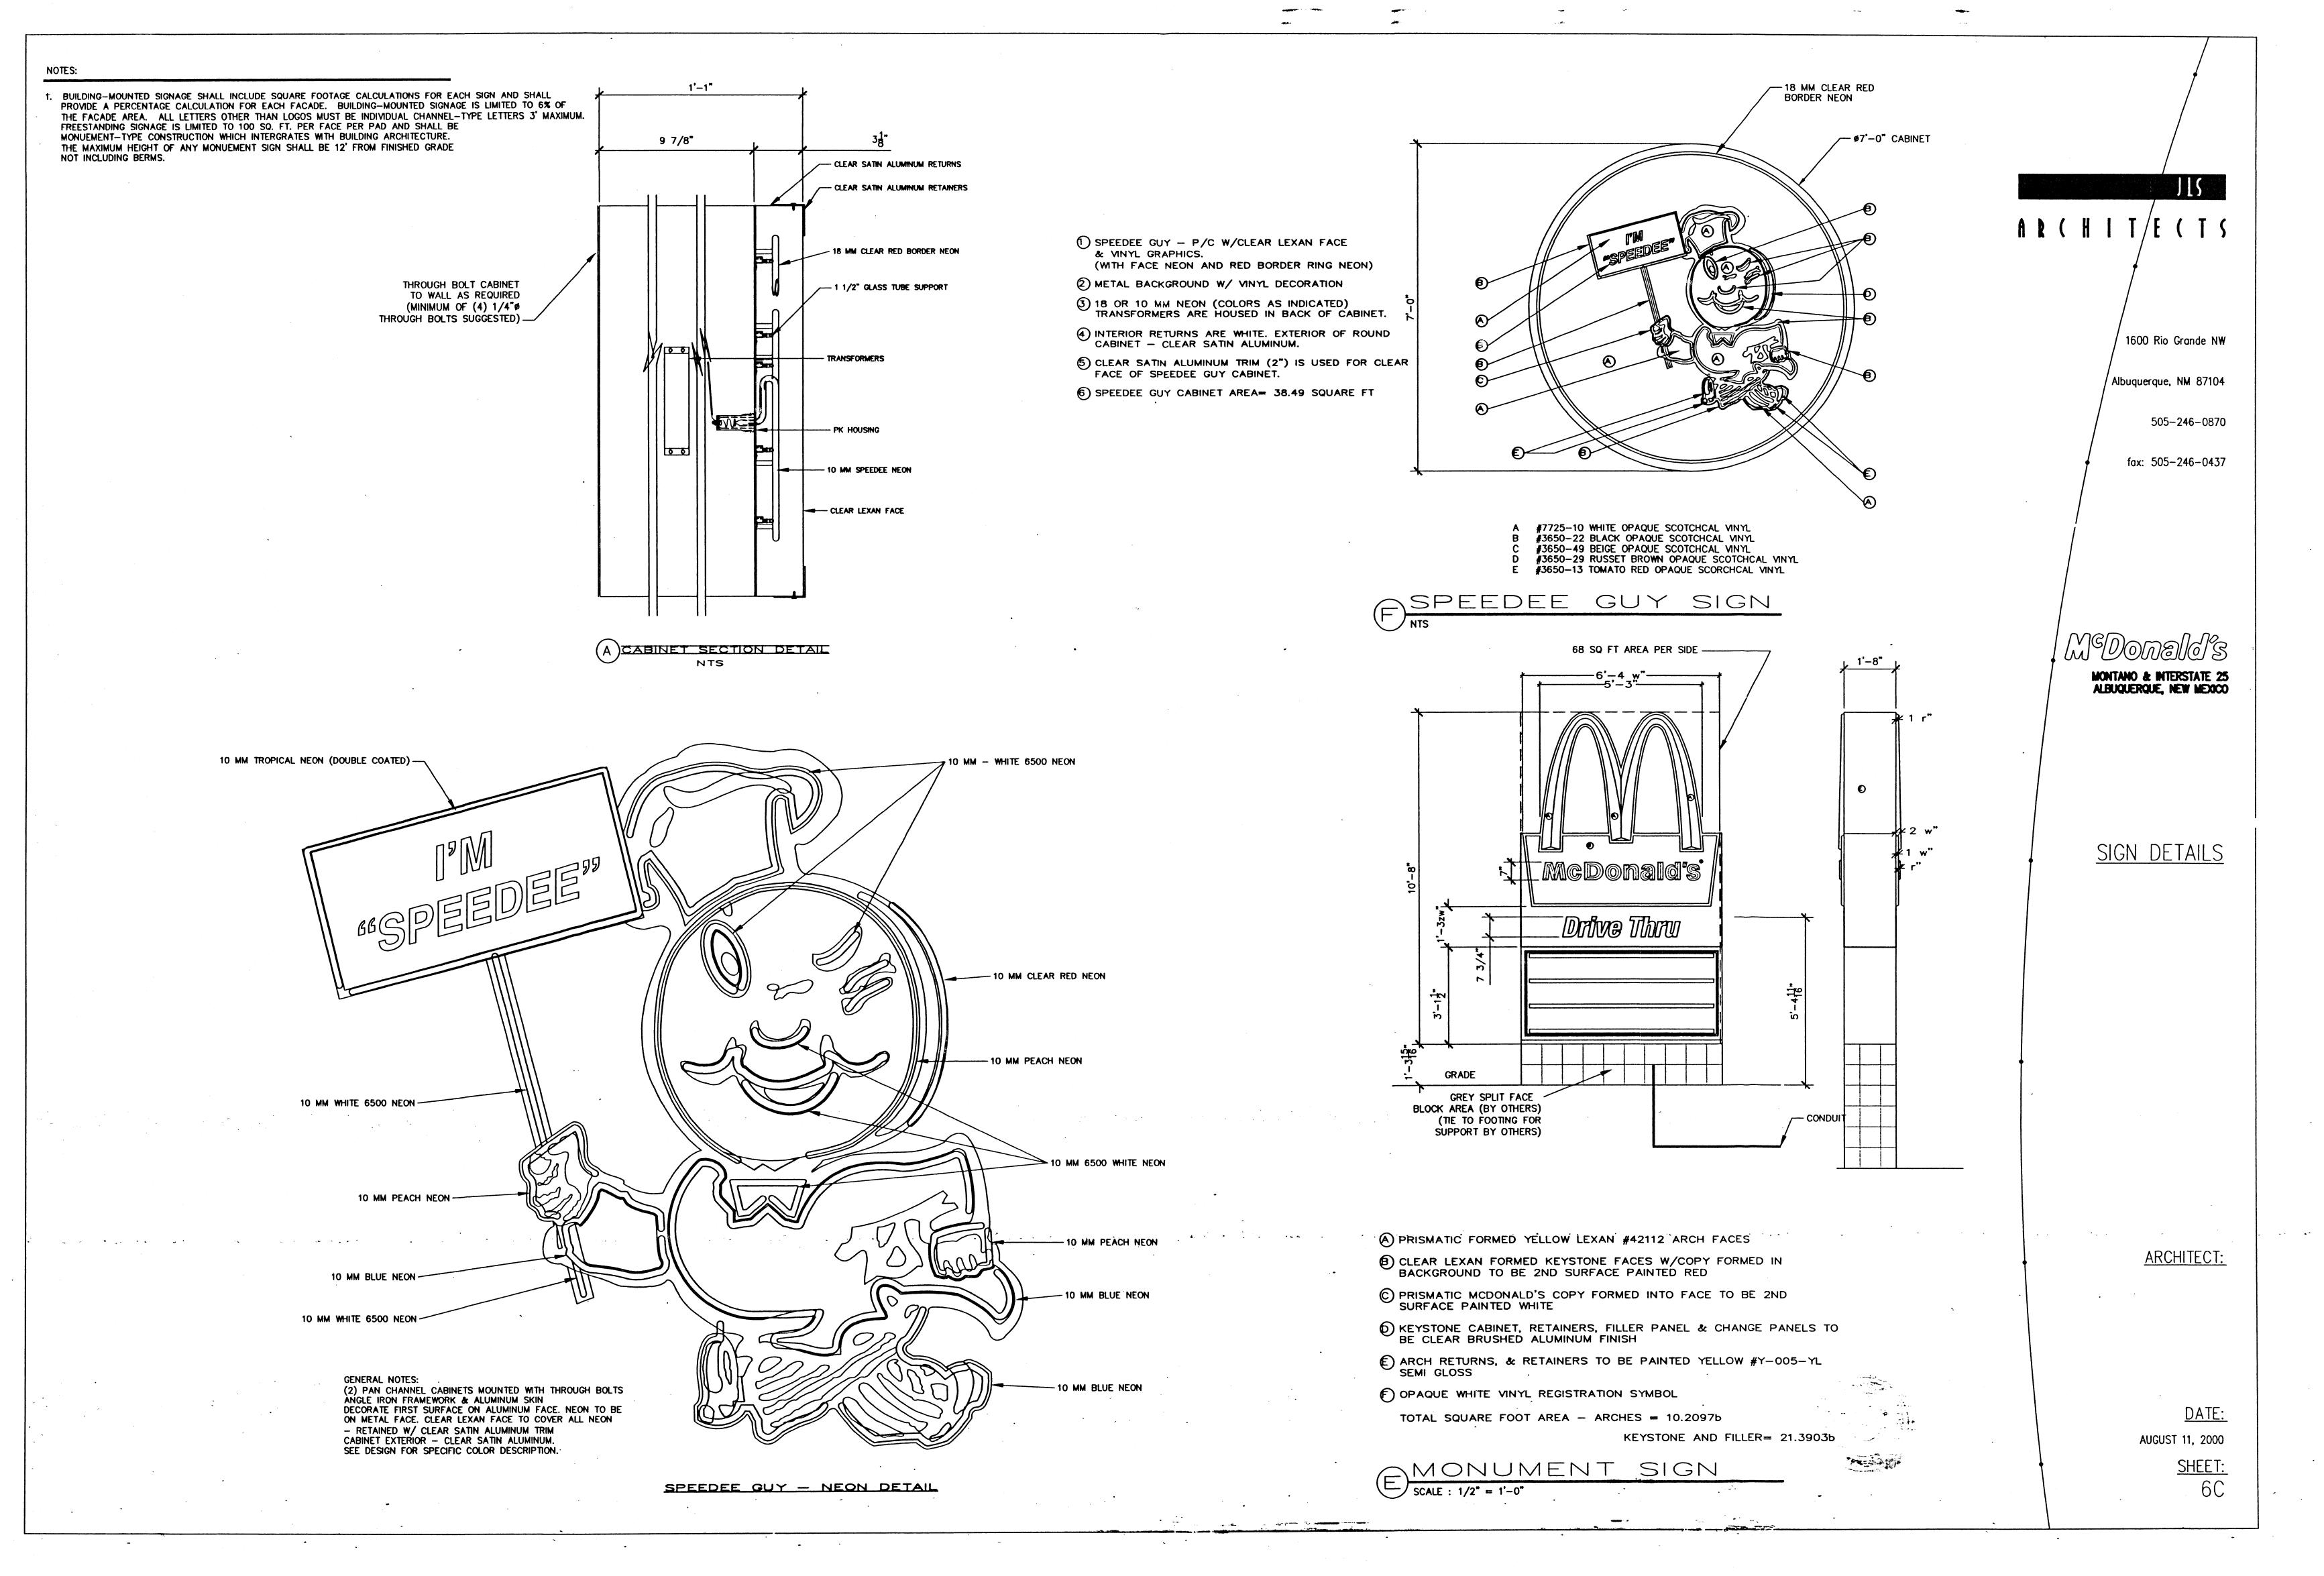

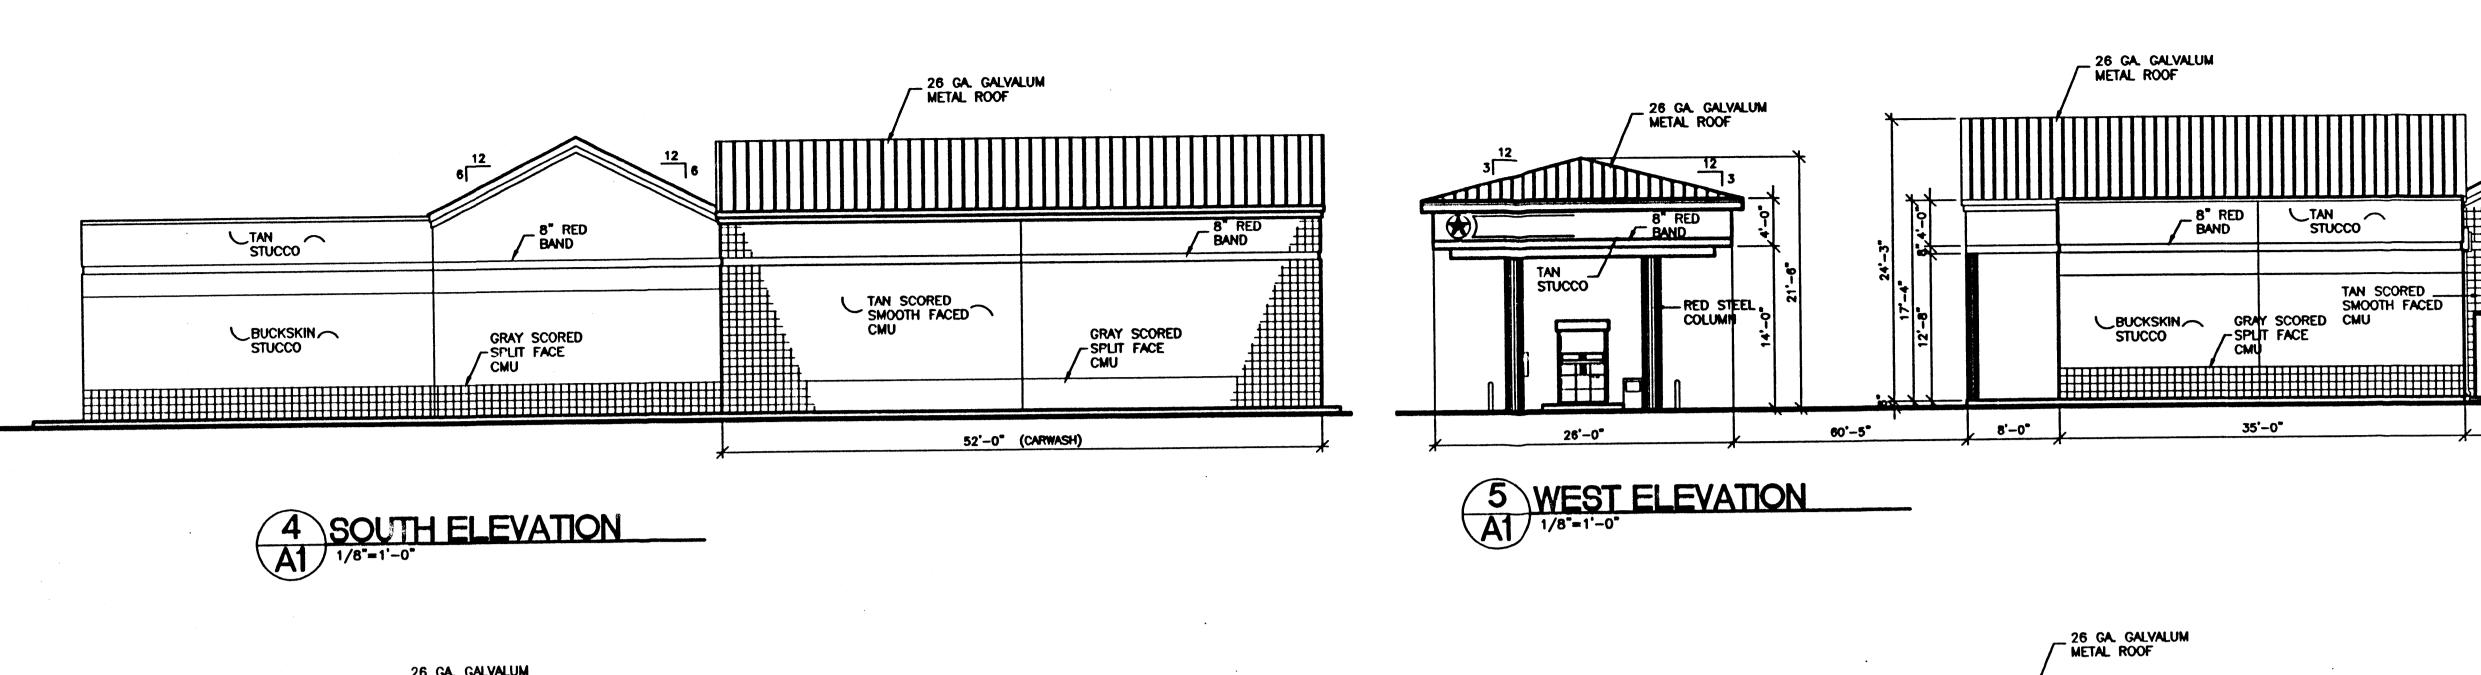


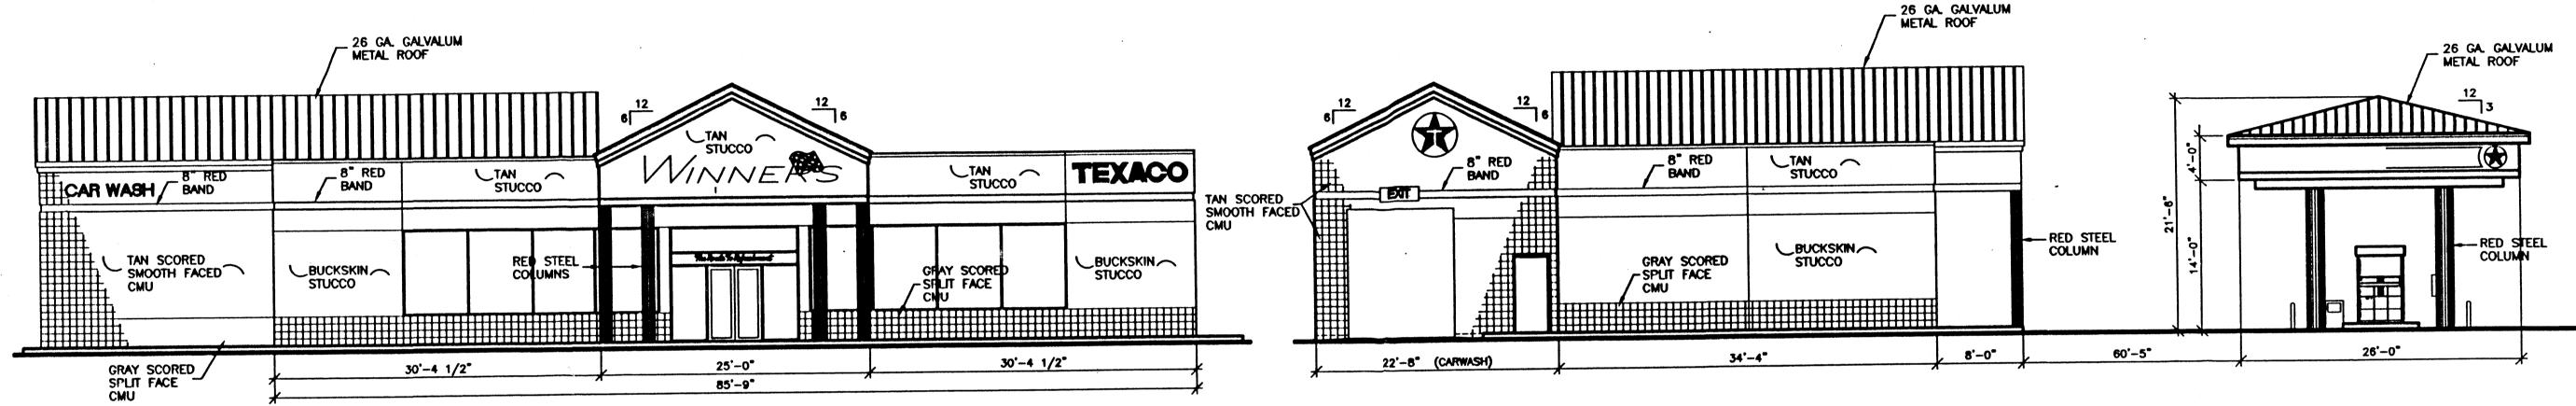






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GENERAL NOTES:

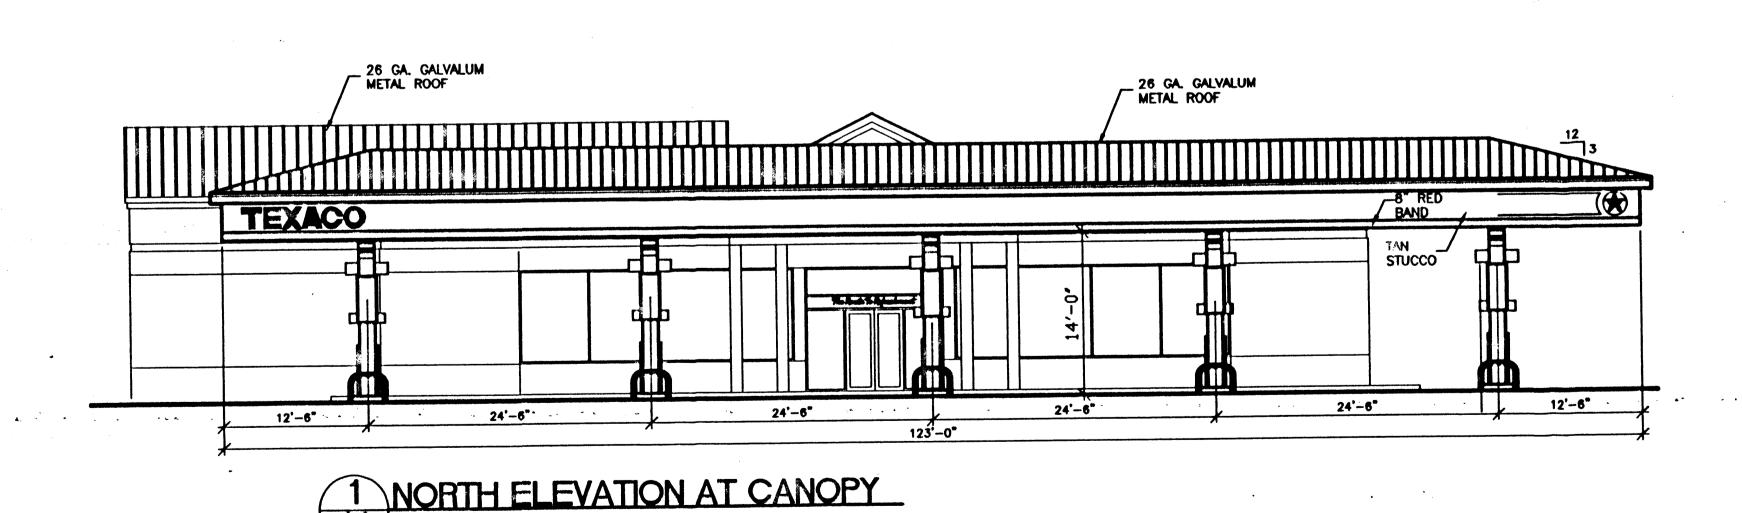A

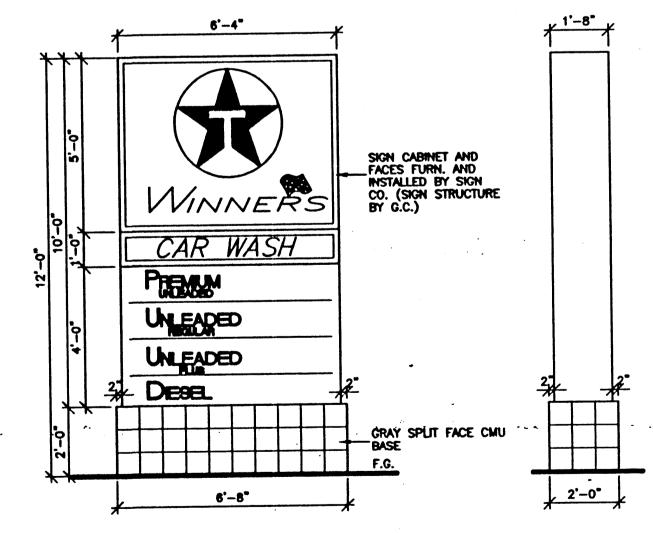CAR WASH

22'-0"

GRAY SCORED
SPLIT FACE
CMU

STUCCO ←


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INDIVIDUAL CHANNEL-TYPE LETTERS 3' MAXIMUM.
FREESTANDING SIGNAGE IS LIMITED TO 100 SQ. FT. PER FACE PER PAD AND SHALL BE MONUEMENT-TYPE CONSTRUCTION WHICH INTERGRATES WITH

BUILDING ARCHITECTURE. THE MAXIMUM HEIGHT OF ANY MONUEMENT SIGN SHALL BE 12' FROM FINISHED GRADE NOT INCLUDING BERMS.




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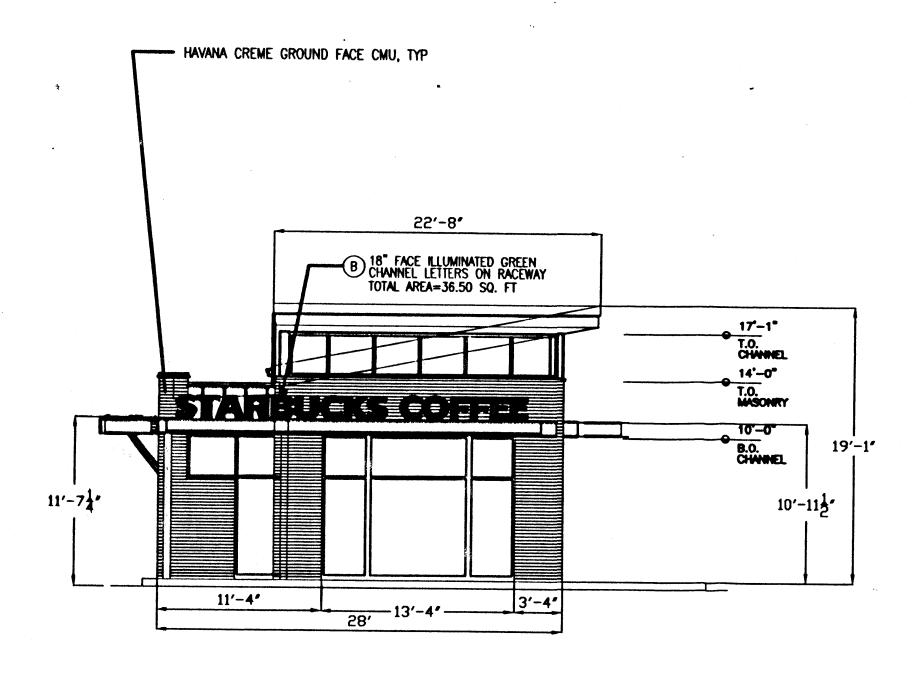
IEER'S	MONTANO PADS	DRAWN BY WCWJ
	·	DATE
		11-10-00
	ELEVATIONS	TEXELEV.DW
		SHEET #
MU-	TIERRA WEST, LLC 8509 JEFFERSON NE ALBUQUERQUE, NEW MEXICO 87113	7 OF
ROHANNAN	ALBUQUERQUE, NEW MEXICO 87113 (505)858-3100	JOB #

990097

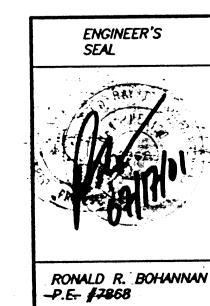SCALE: 1"=100"



WEST ELEVATION

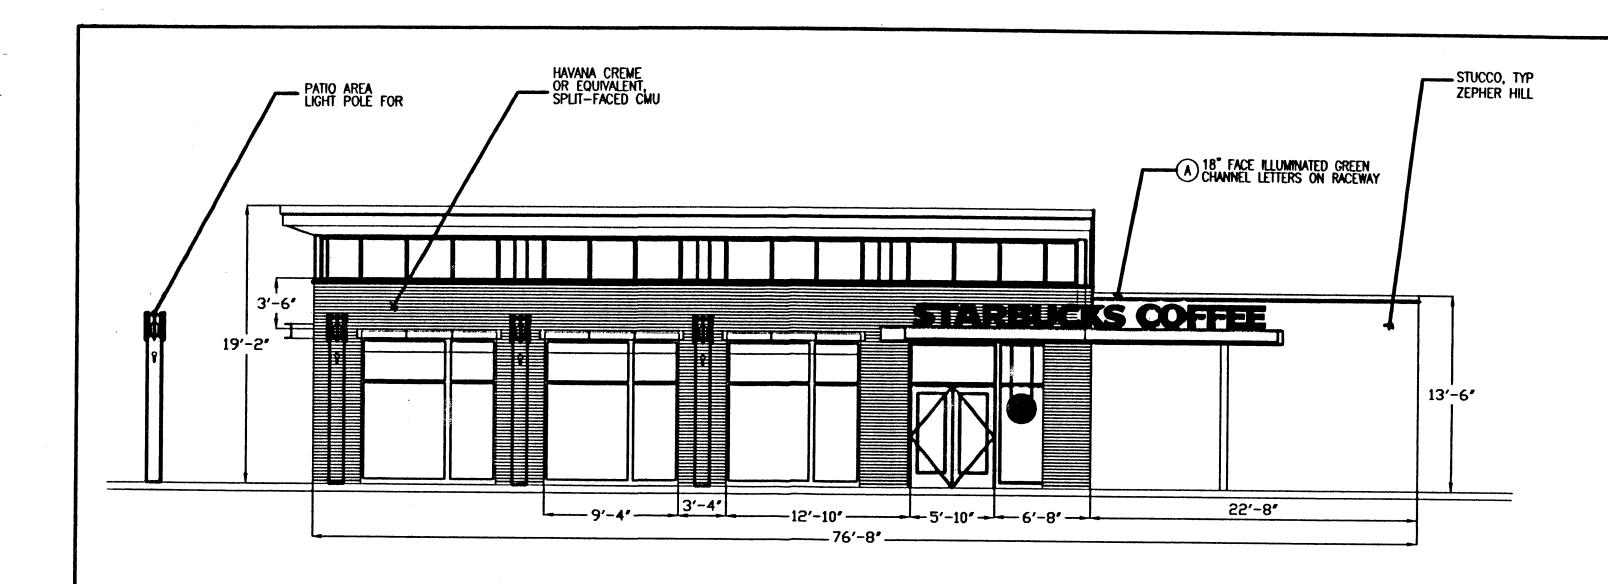



GENERAL NOTES:


NOT INCLUDING BERMS.

5′-7¹/2**′** 1. BUILDING-MOUNTED SIGNAGE SHALL INCLUDE SQUARE FOOTAGE CALCULATIONS FOR EACH SIGN AND SHALL PROVIDE A PERCENTAGE CALCULATION FOR EACH FACADE. BUILDING-MOUNTED SIGNAGE IS LIMITED TO 6% OF THE FACADE AREA. ALL LETTERS OTHER THAN LOGOS MUST BE INDIVIDUAL CHANNEL-TYPE LETTERS 3' MAXIMUM. FREESTANDING SIGNAGE IS LIMITED TO 100 SQ. FT. PER FACE PER PAD AND SHALL BE MONUEMENT-TYPE CONSTRUCTION WHICH INTERGRATES WITH BUILDING ARCHITECTURE:

THE MAXIMUM HEIGHT OF ANY MONUEMENT SIGN SHALL BE 12' FROM FINISHED GRADE

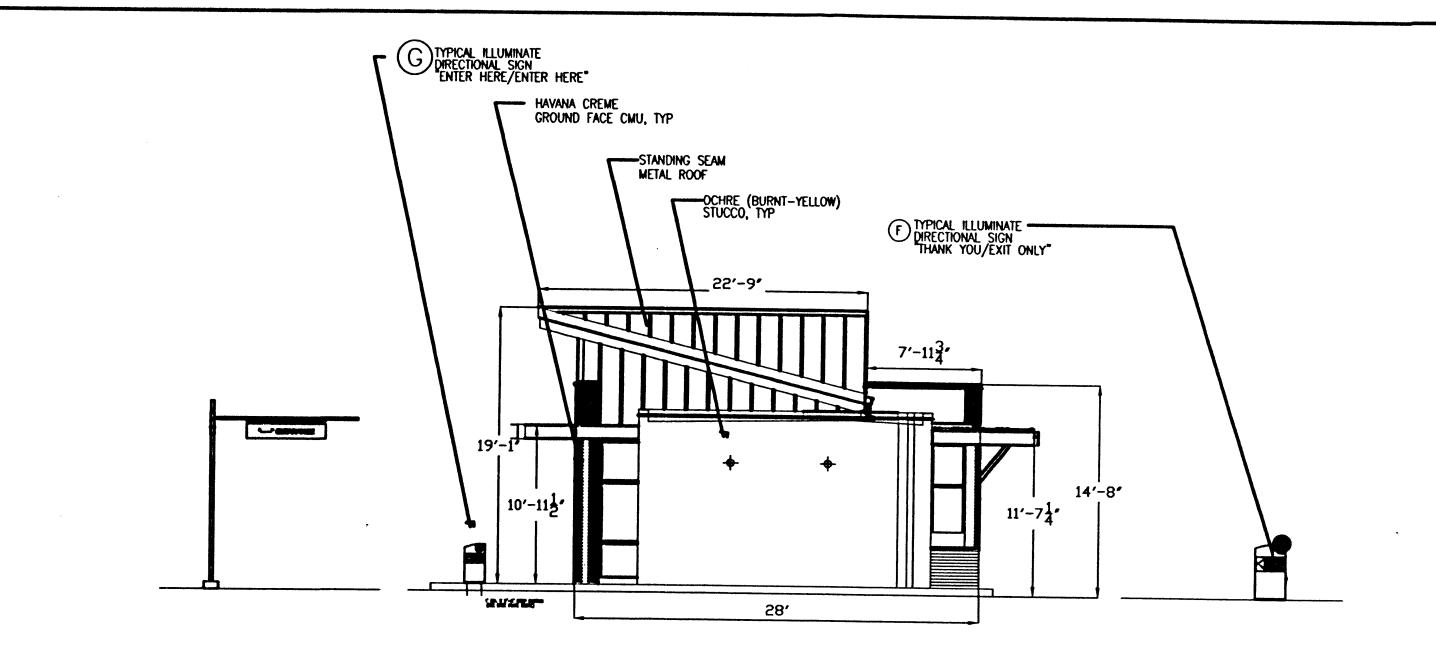

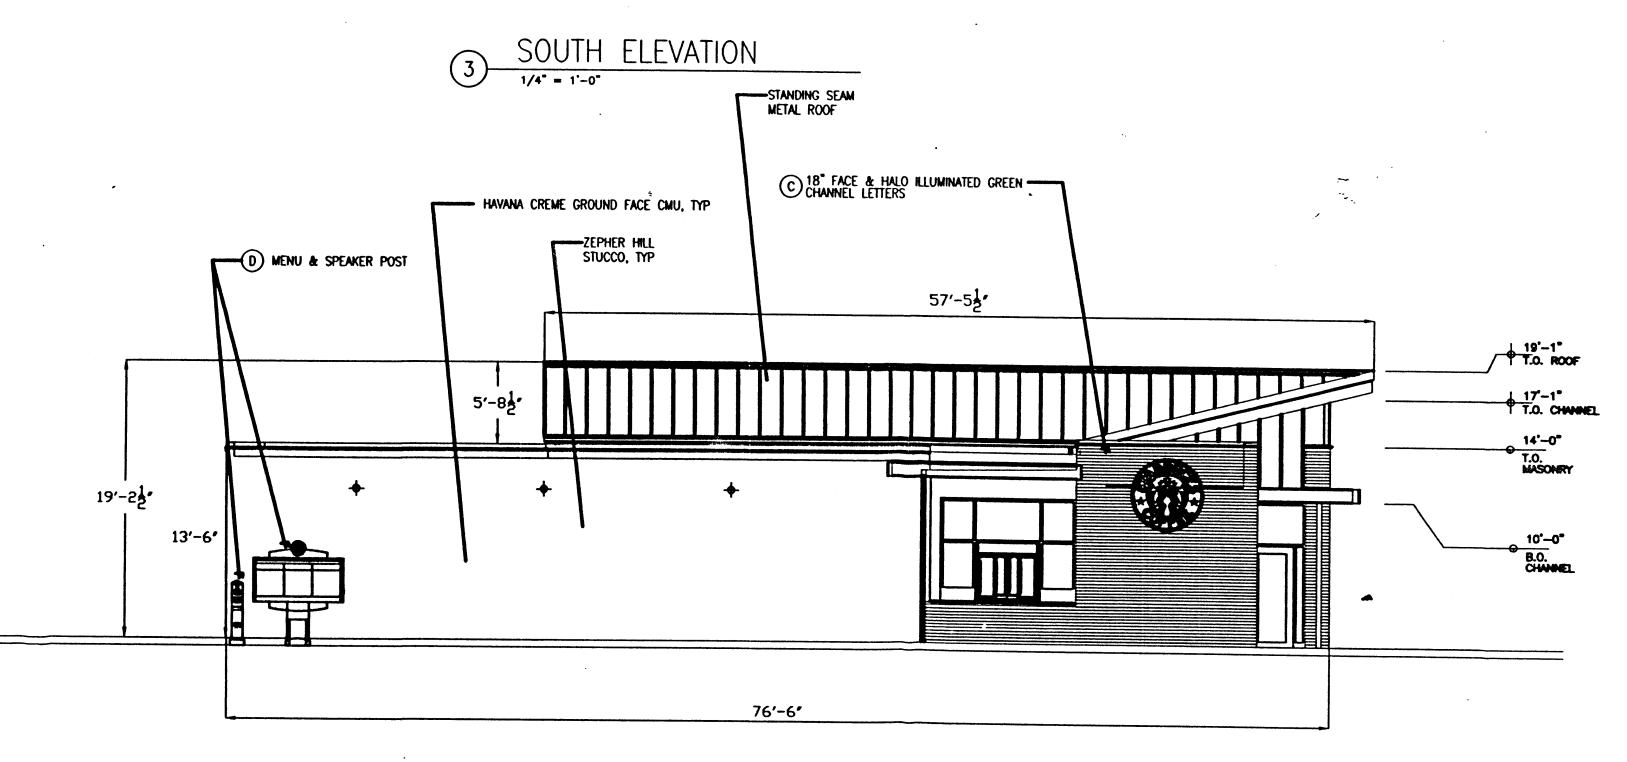

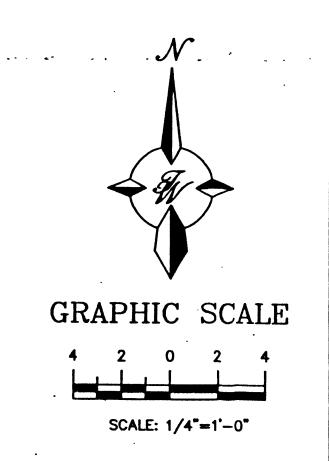

	•	
ENGINEER'S SEAL	MONTANO PADS	DRAWN BY WCWJ
	STARBUCKS	DATE 11-20-00
	ELEVATIONS	STARELEV.DWG
	TIERRA WEST, LLC 8509 JEFFERSON NE ALBUQUERQUE, NEW MEXICO 87113	SHEET; #
RONALD R. BOHANNAN P.E. #7868	(505)858–3100	JOB # 990097