

CURB & GUTTER
BOUNDARY LINE
EASEMENT
CENTERLINE
RIGHT-OF-WAY
BUILDING
SIDEWALK
SCREEN WALL
RETAINING WALL
STREET LIGHTS
LANE
STRIPING
LANDSCAPING
EXISTING CURB & GUTTER
EXISTING BOUNDARY LINE
EXISTING SIDEWALK
EXISTING SIDEWALK
EXISTING LANE

EXISTING STRIPING

SU-1 FOR C-2 USES

R3 PERMISSIVE USES

R3 PERMISSIVE USES

BU-1 FOR PRD

LOWES

SU-1 FOR PRD

LOWES

SU-1 FOR PRD

LOWES

SU-1 FOR PRD

LOWES

SU-1 FOR PRD

SU-1 FOR PRD

LOWES

SU-1 FOR PRD

SU-1 F

LOT 5, LOWES SUBDIVISION

PROJECT NUMBER: 1001275

APPLICATION NUMBER: 08 DRB-701

DRB SITE DEVELOPMENT PLAN SIGNOFF APPROVAL:

Traffic Engineer, Transportation Division

DRB Chairperson, Planning Department

\* Environmental Health, if necessary

L1. LANDSCAPING PLAN

Michael Holton

Solid Waste Management

is an infrastructure List required? ( ) Yes ( ) No if Yes, then a set of approved DRC plans with a work order is required for any construction within Public Right—of—Way or for construction of public improvements.

\* Environmental Health Department (conditional) Date

5-7-08

6/26/08

Date

8-15-08

Date

SITE DATA

PROPOSED USAGE: LOT AREA:

FIRESTONE
37500 SF (0.86) ACRE)

BUILDING AREA:

CUSTOMER SEATING: 1063 SF SERVICE AREA: 4281 SF INVENTORY: 2243 SF

USED INVENTORY: 247 SF
329 SF

OTHER: <u>329 SF</u> TOTAL

PARKING REQUIRED: 30 SPACES (5900 SF/1 SPACE PER 200 SF)
PARKING REQUIRED: 2 SPACES (2243 SF/1 SPACE PER 2000 SF)
MINUS: 10 SPACES (SERVICE BAYS)

8143 SF

TOTAL PARKING REQUIRED: 22 SPACES

PARKING PROVIDED: 24 SPACES


HC PARKING REQUIRED: 2 SPACES
HC PARKING PROVIDED: 2 SPACES

1 SPACE VAN ACCESSIBLE


MC PARKING REQUIRED: 2 SPACES
MC PARKING PROVIDED: 3 SPACES

BICYCLE PARKING REQUIRED: 2 SPACES
BICYCLE PARKING PROVIDED: 5 SPACES

LANDSCAPE AREA REQUIRED: 4426 SF LANDSCAPE AREA PROVIDED: 12083 SF

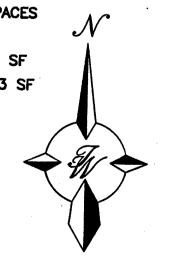

GRAPHIC SCALE

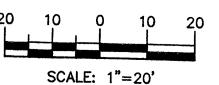


INDEX TO DRAWINGS
C1. SITE PLAN FOR BUILDING PERMIT
C2. APPROVED SITE PLAN FOR SUBDIVISION
C3. GRADING PLAN
C4. MASTER UTILITY PLAN
C5. DETAIL SHEET
A4. BUILDING ELEVATIONS


ENGINEER'S SEAL	FIRESTONE	DRAWN BY BJF
RAY BOHA	COORS AND OLD AIRPORT ROAD SITE PLAN FOR	<i>DATE</i> 04/22/08
Tees Taes	BUILDING PERMIT	2770-SPB
	1	SHEET #
DAESSIUNAL	TIERRA WEST, LLC  5571 MIDWAY PARK PLACE NE ALBUQUERQUE, NM 87109	C1
RONALD R. BOHANNAN P.E. #7868	(505)858–3100	JOB # 27070


# LOWE'S OF NW ALBUQUERQUE ALBUQUERQUE, NEW MEXICO DRB SUBMITTAL


# INDEX


SHEET NO.	DESCRIPTION
<b>C1</b>	COVER SHEET
°C2	SITE PLAN FOR SUBDIVISION
- <b>93</b> -	SITE PLAN FOR BUILDING PERMIT
<b>C4</b>	GRADING AND DRAINAGE PLAN
<b>C5</b>	GRADING AND DRAINAGE PLAN
<b>C6</b>	GRADING AND DRAINAGE PLAN DETAILS
67 18 G8 18/01	SITE UTILITIES PLAN
GS Willer	SITE PLAN DETAILS
<b>69</b>	SITE PLAN DETAILS
-41-	LANDSCAPING PLAN
<b>A1</b>	FXTERIOR FLEVATIONS

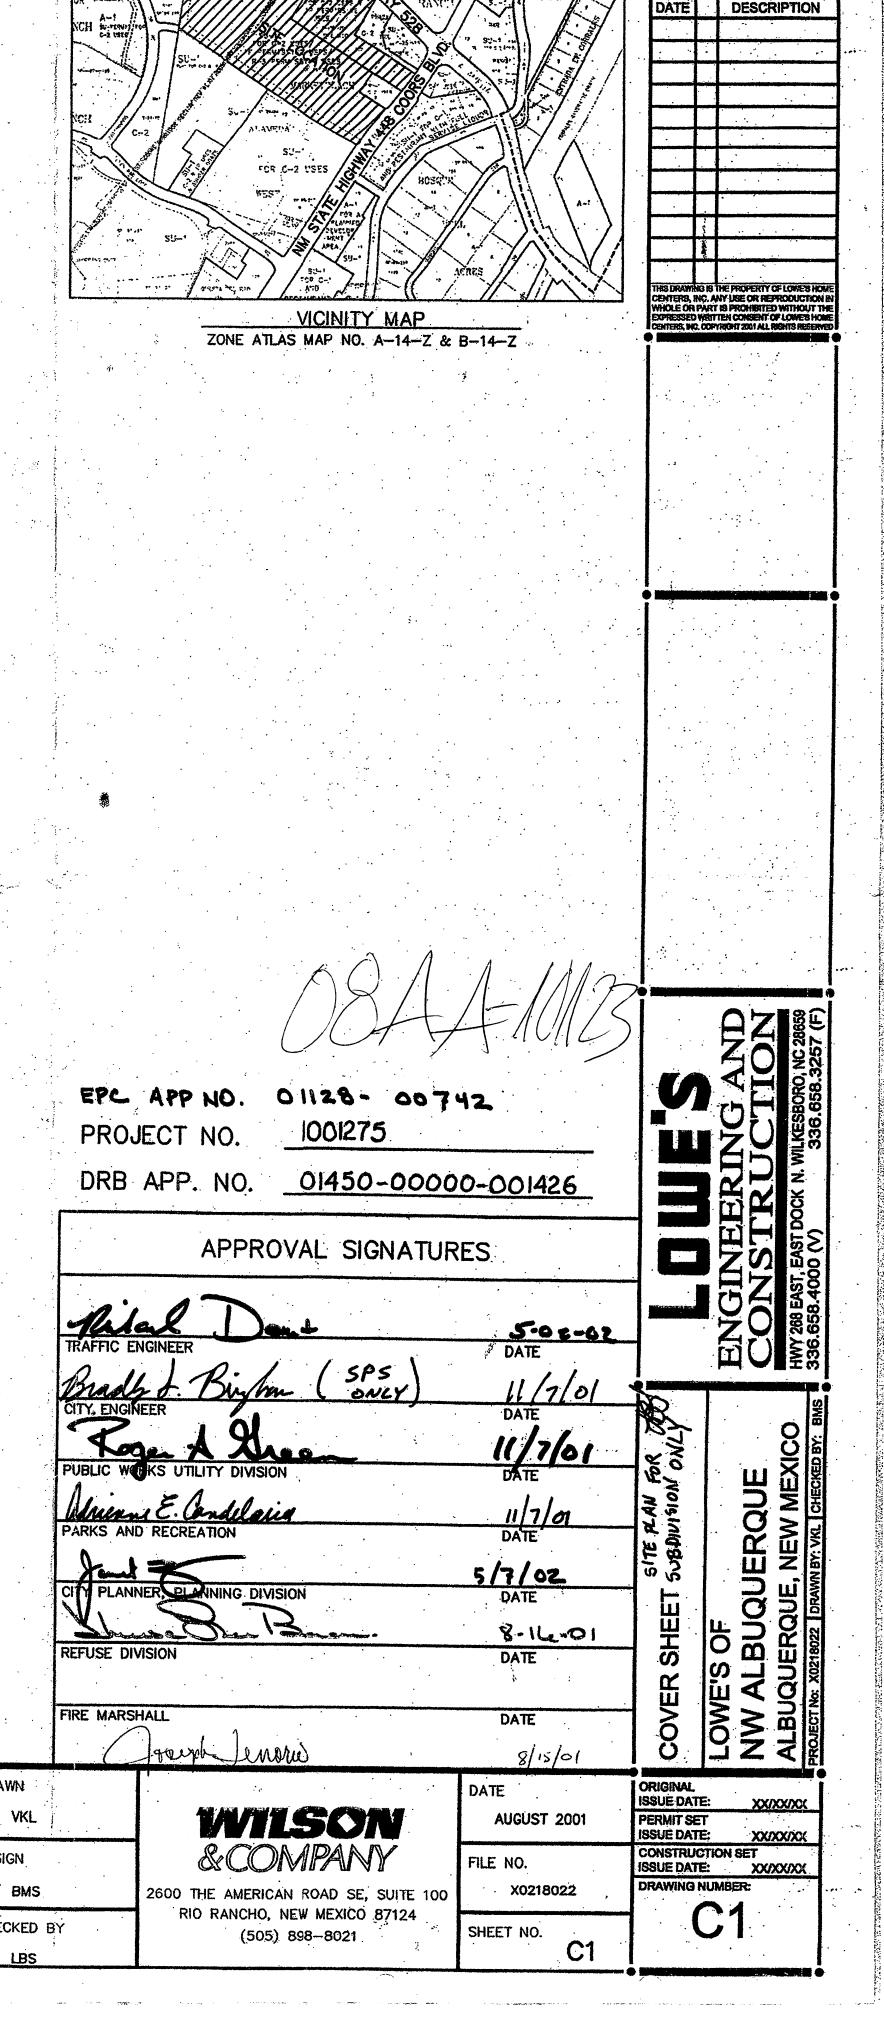


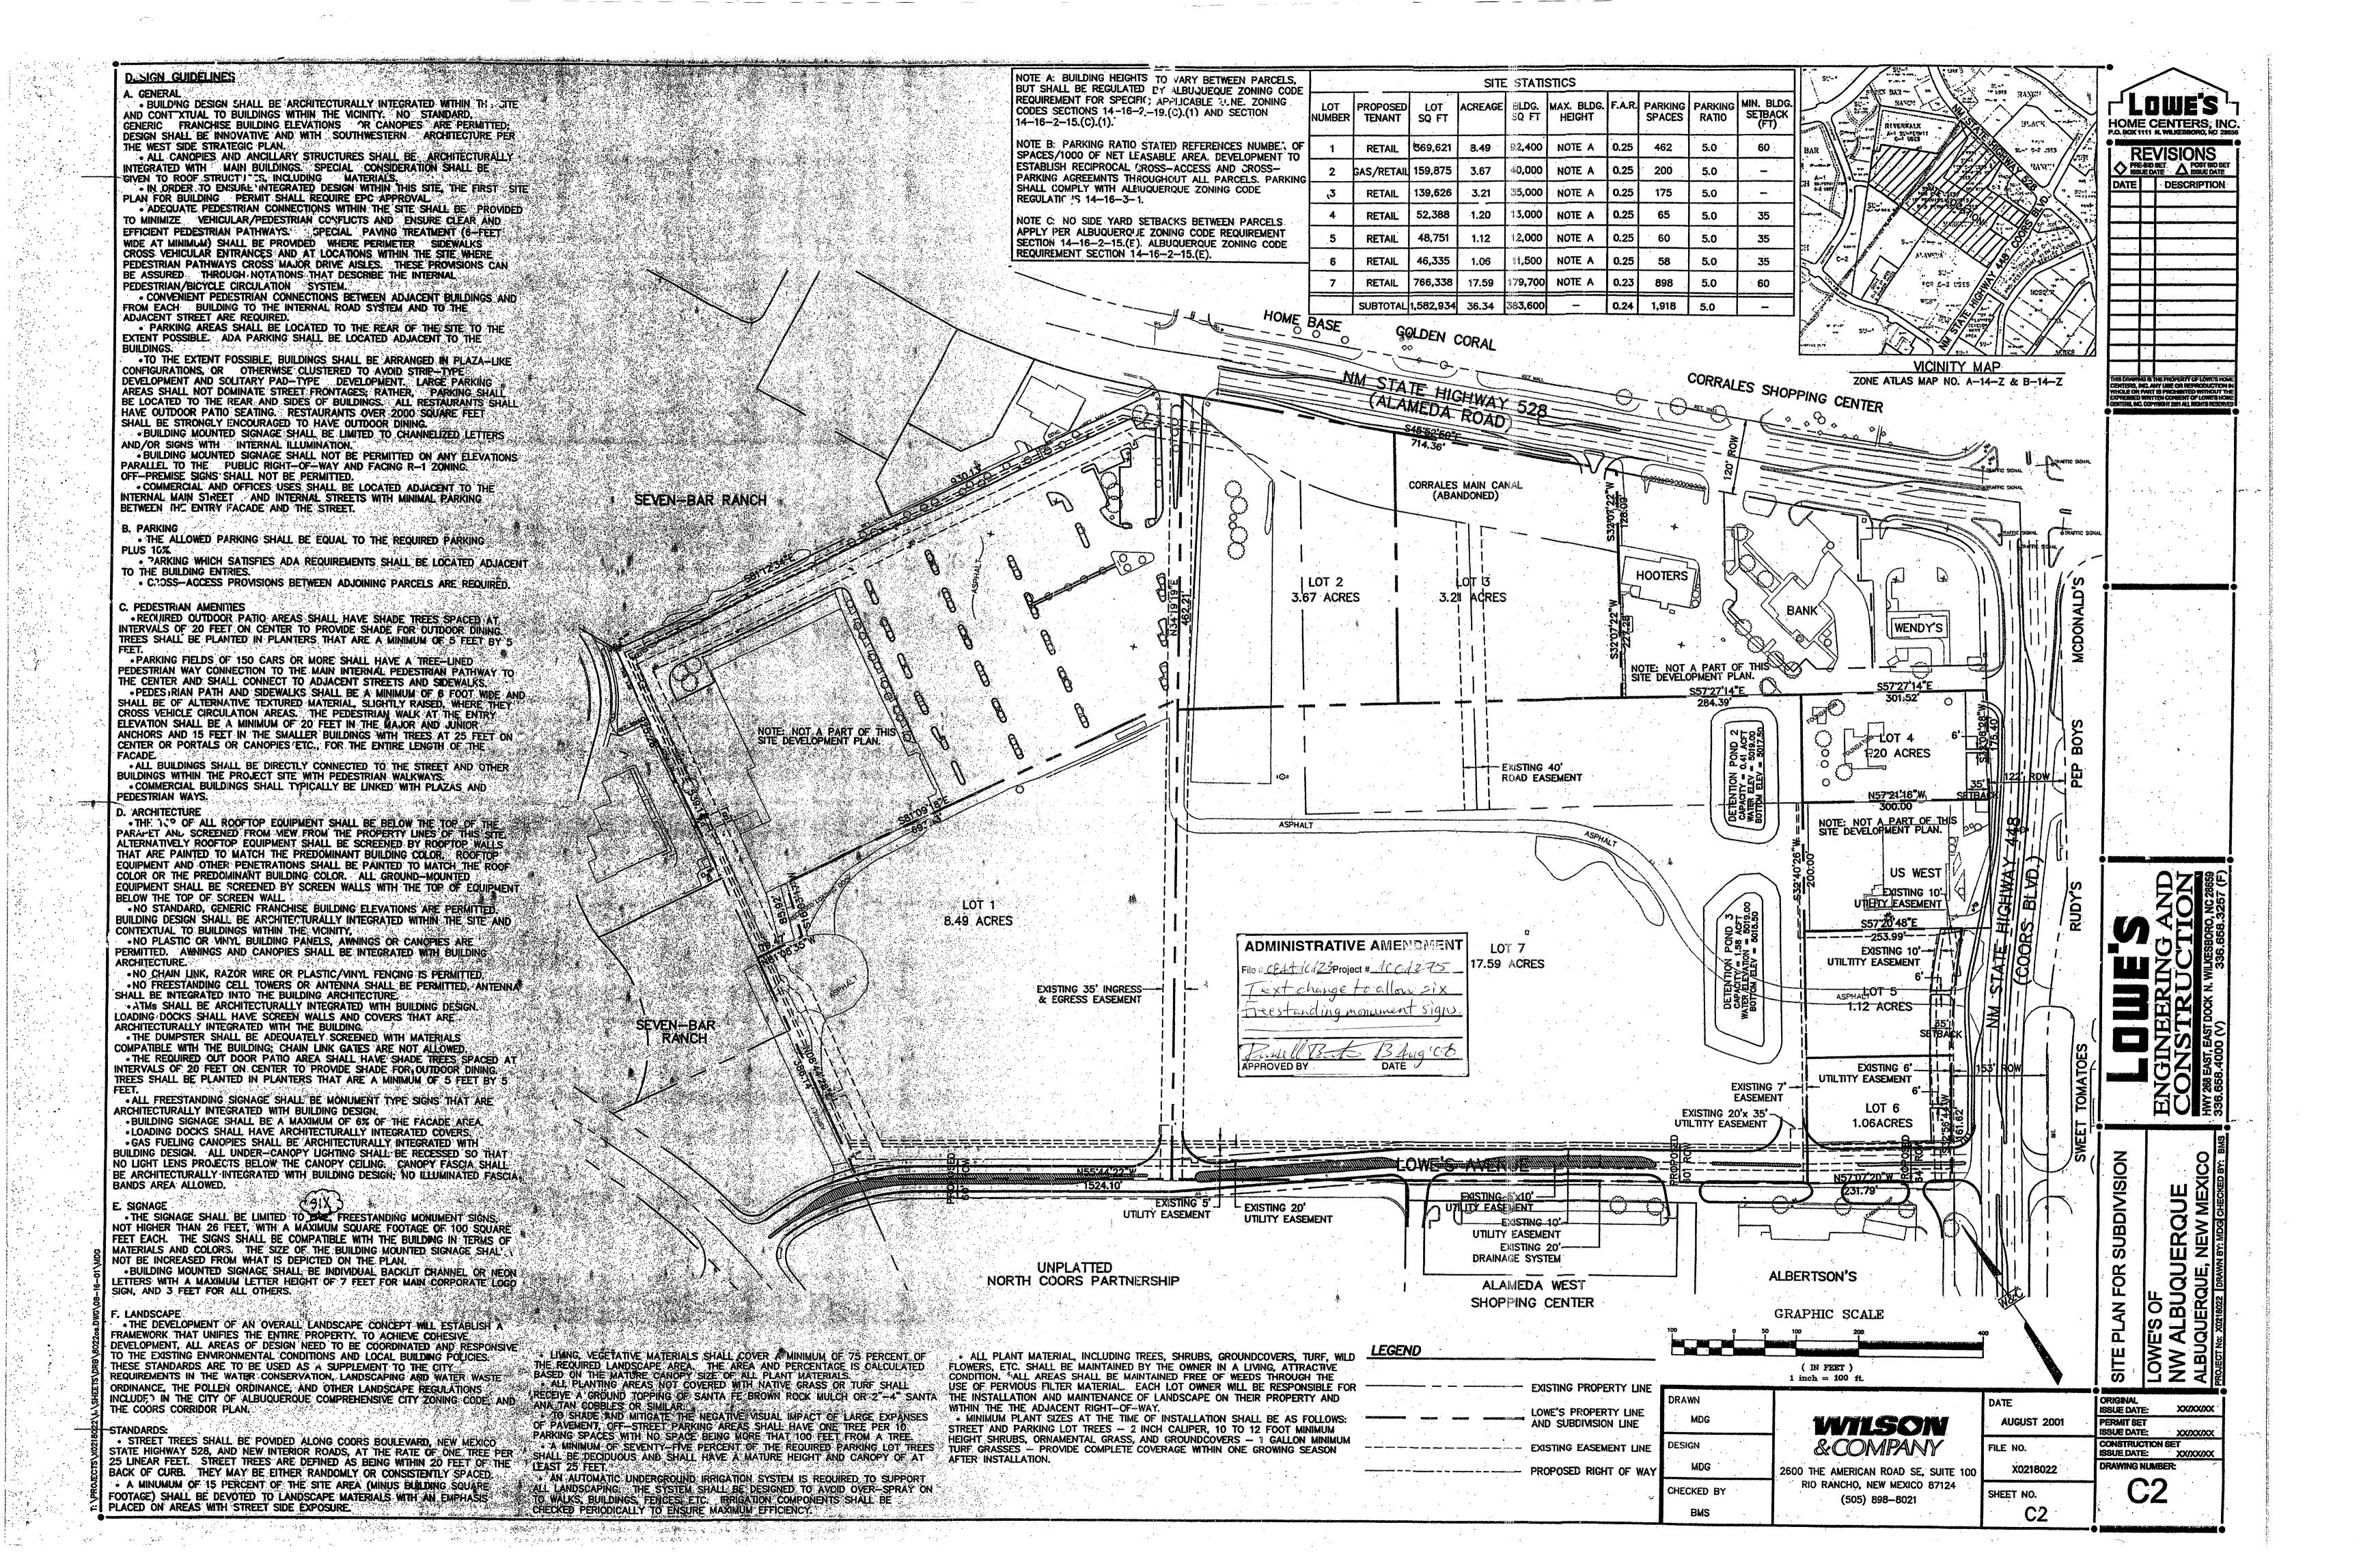


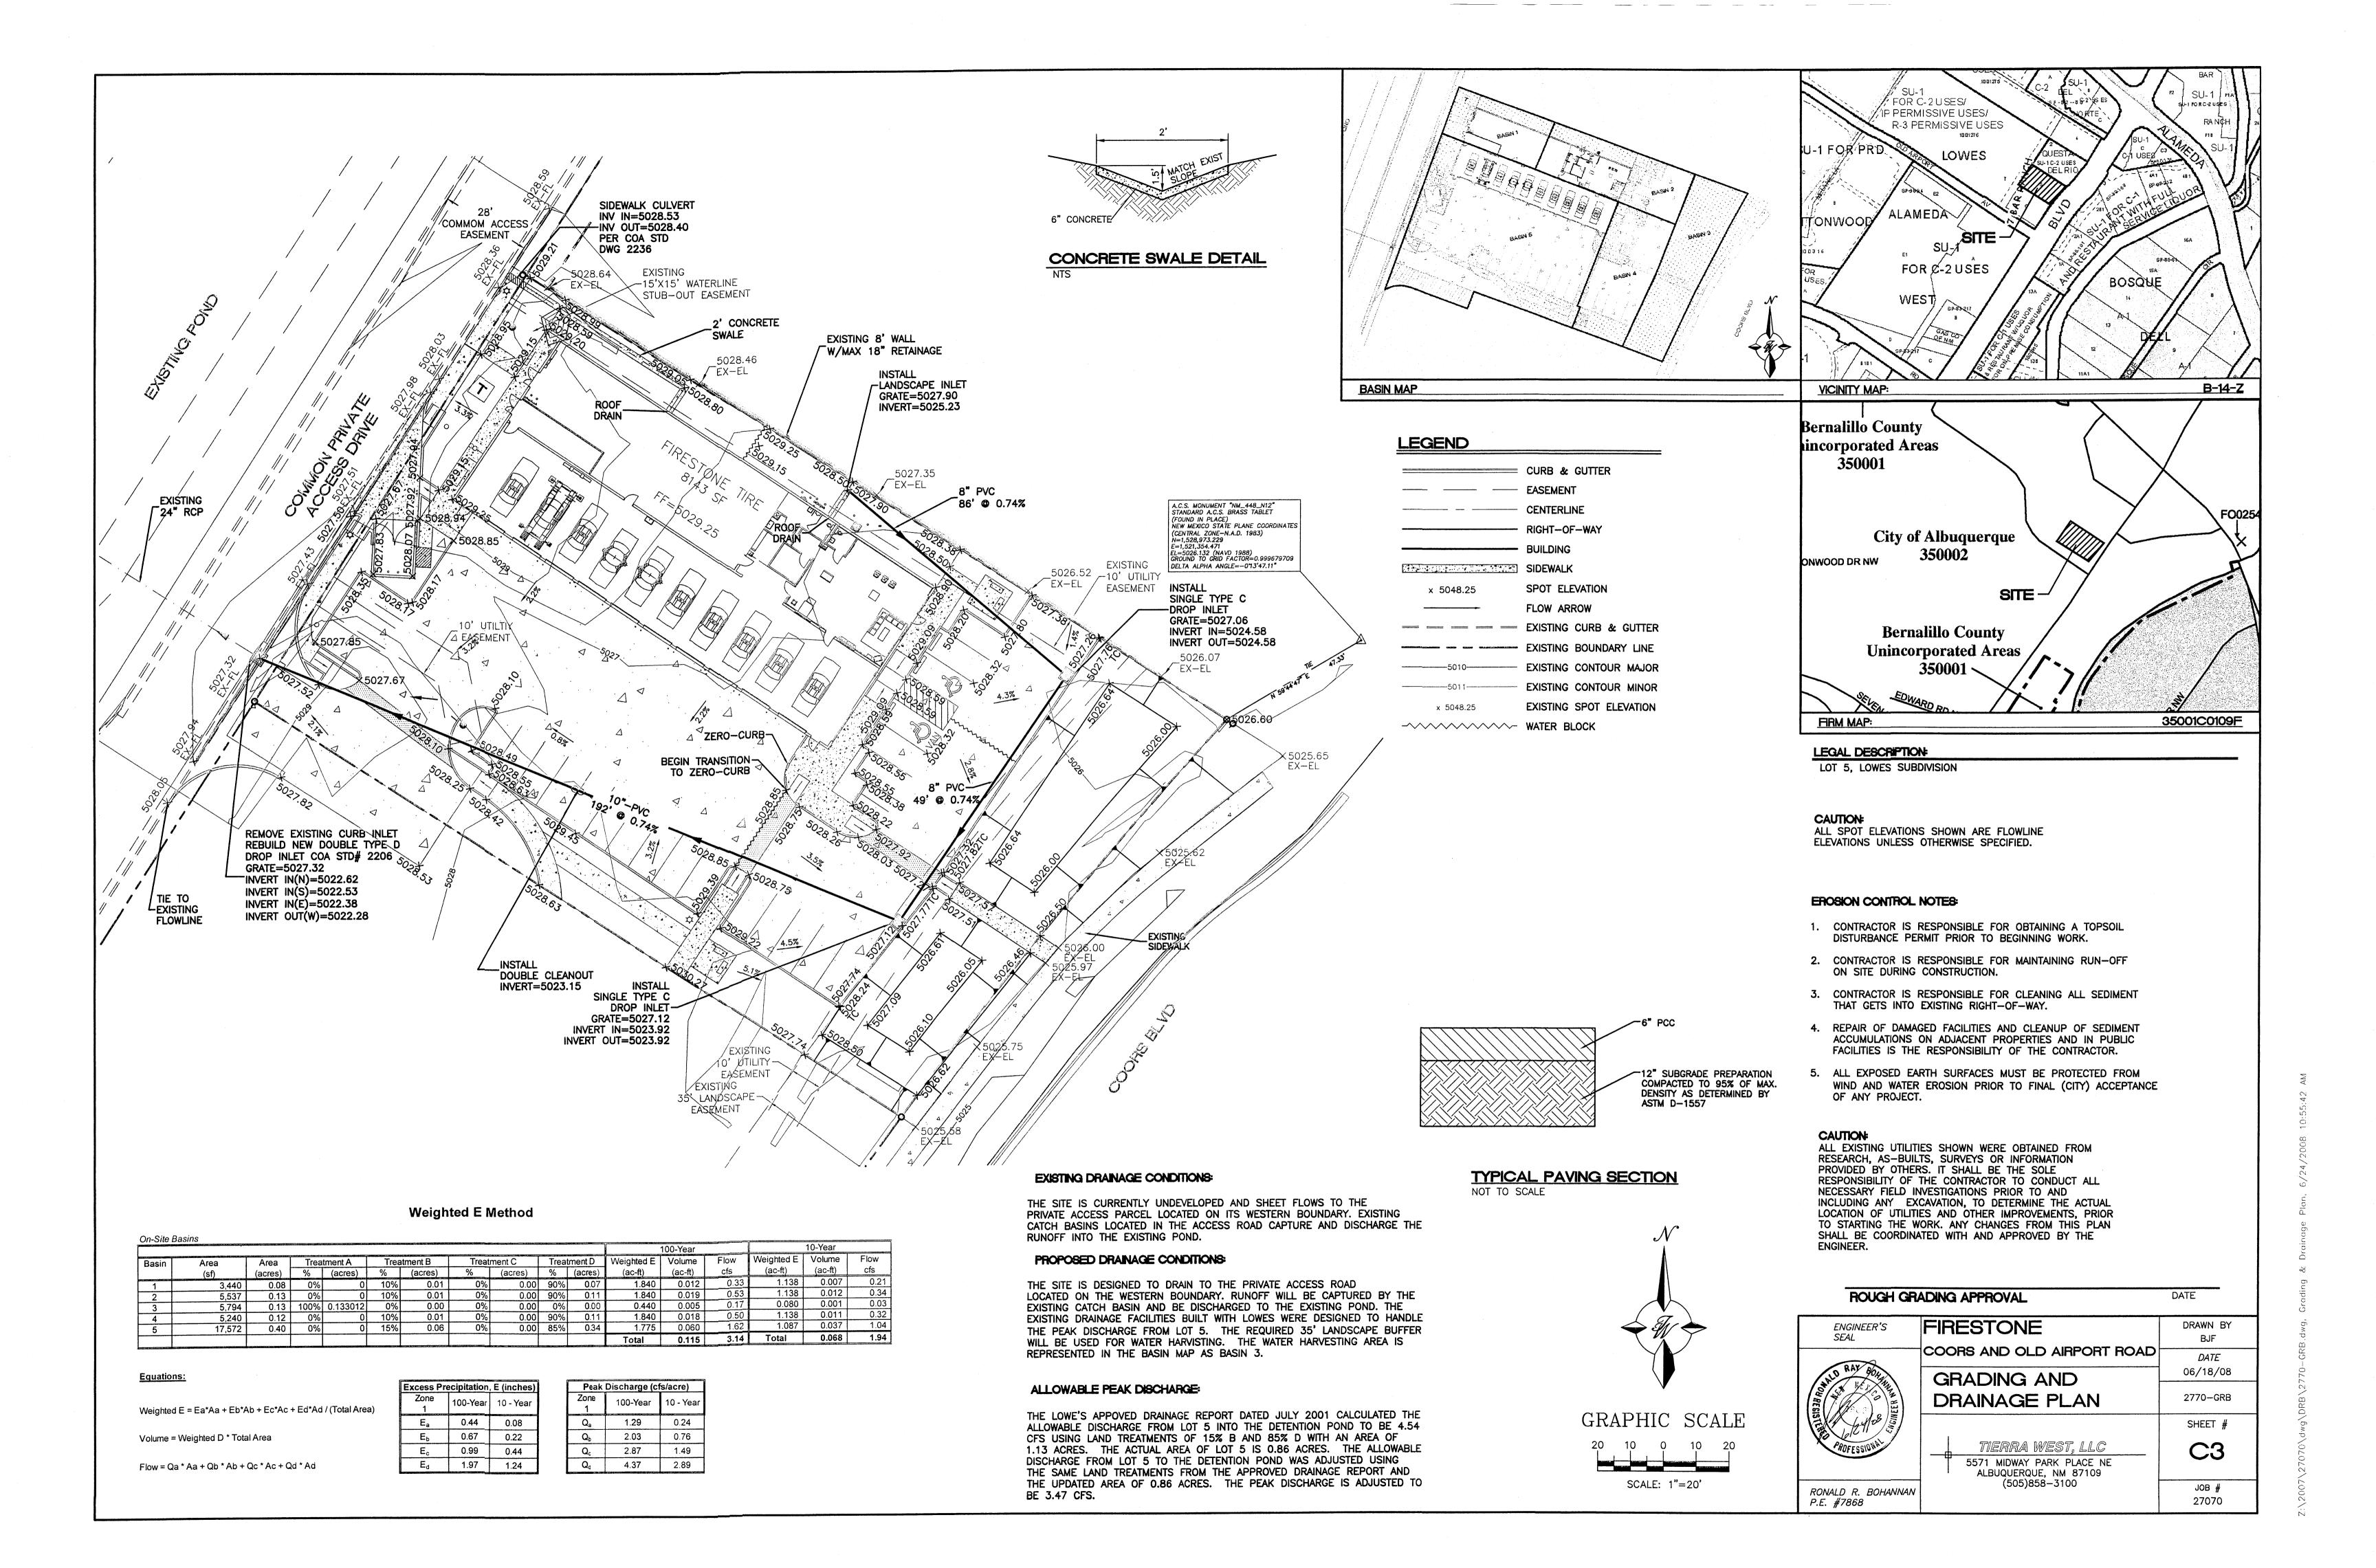

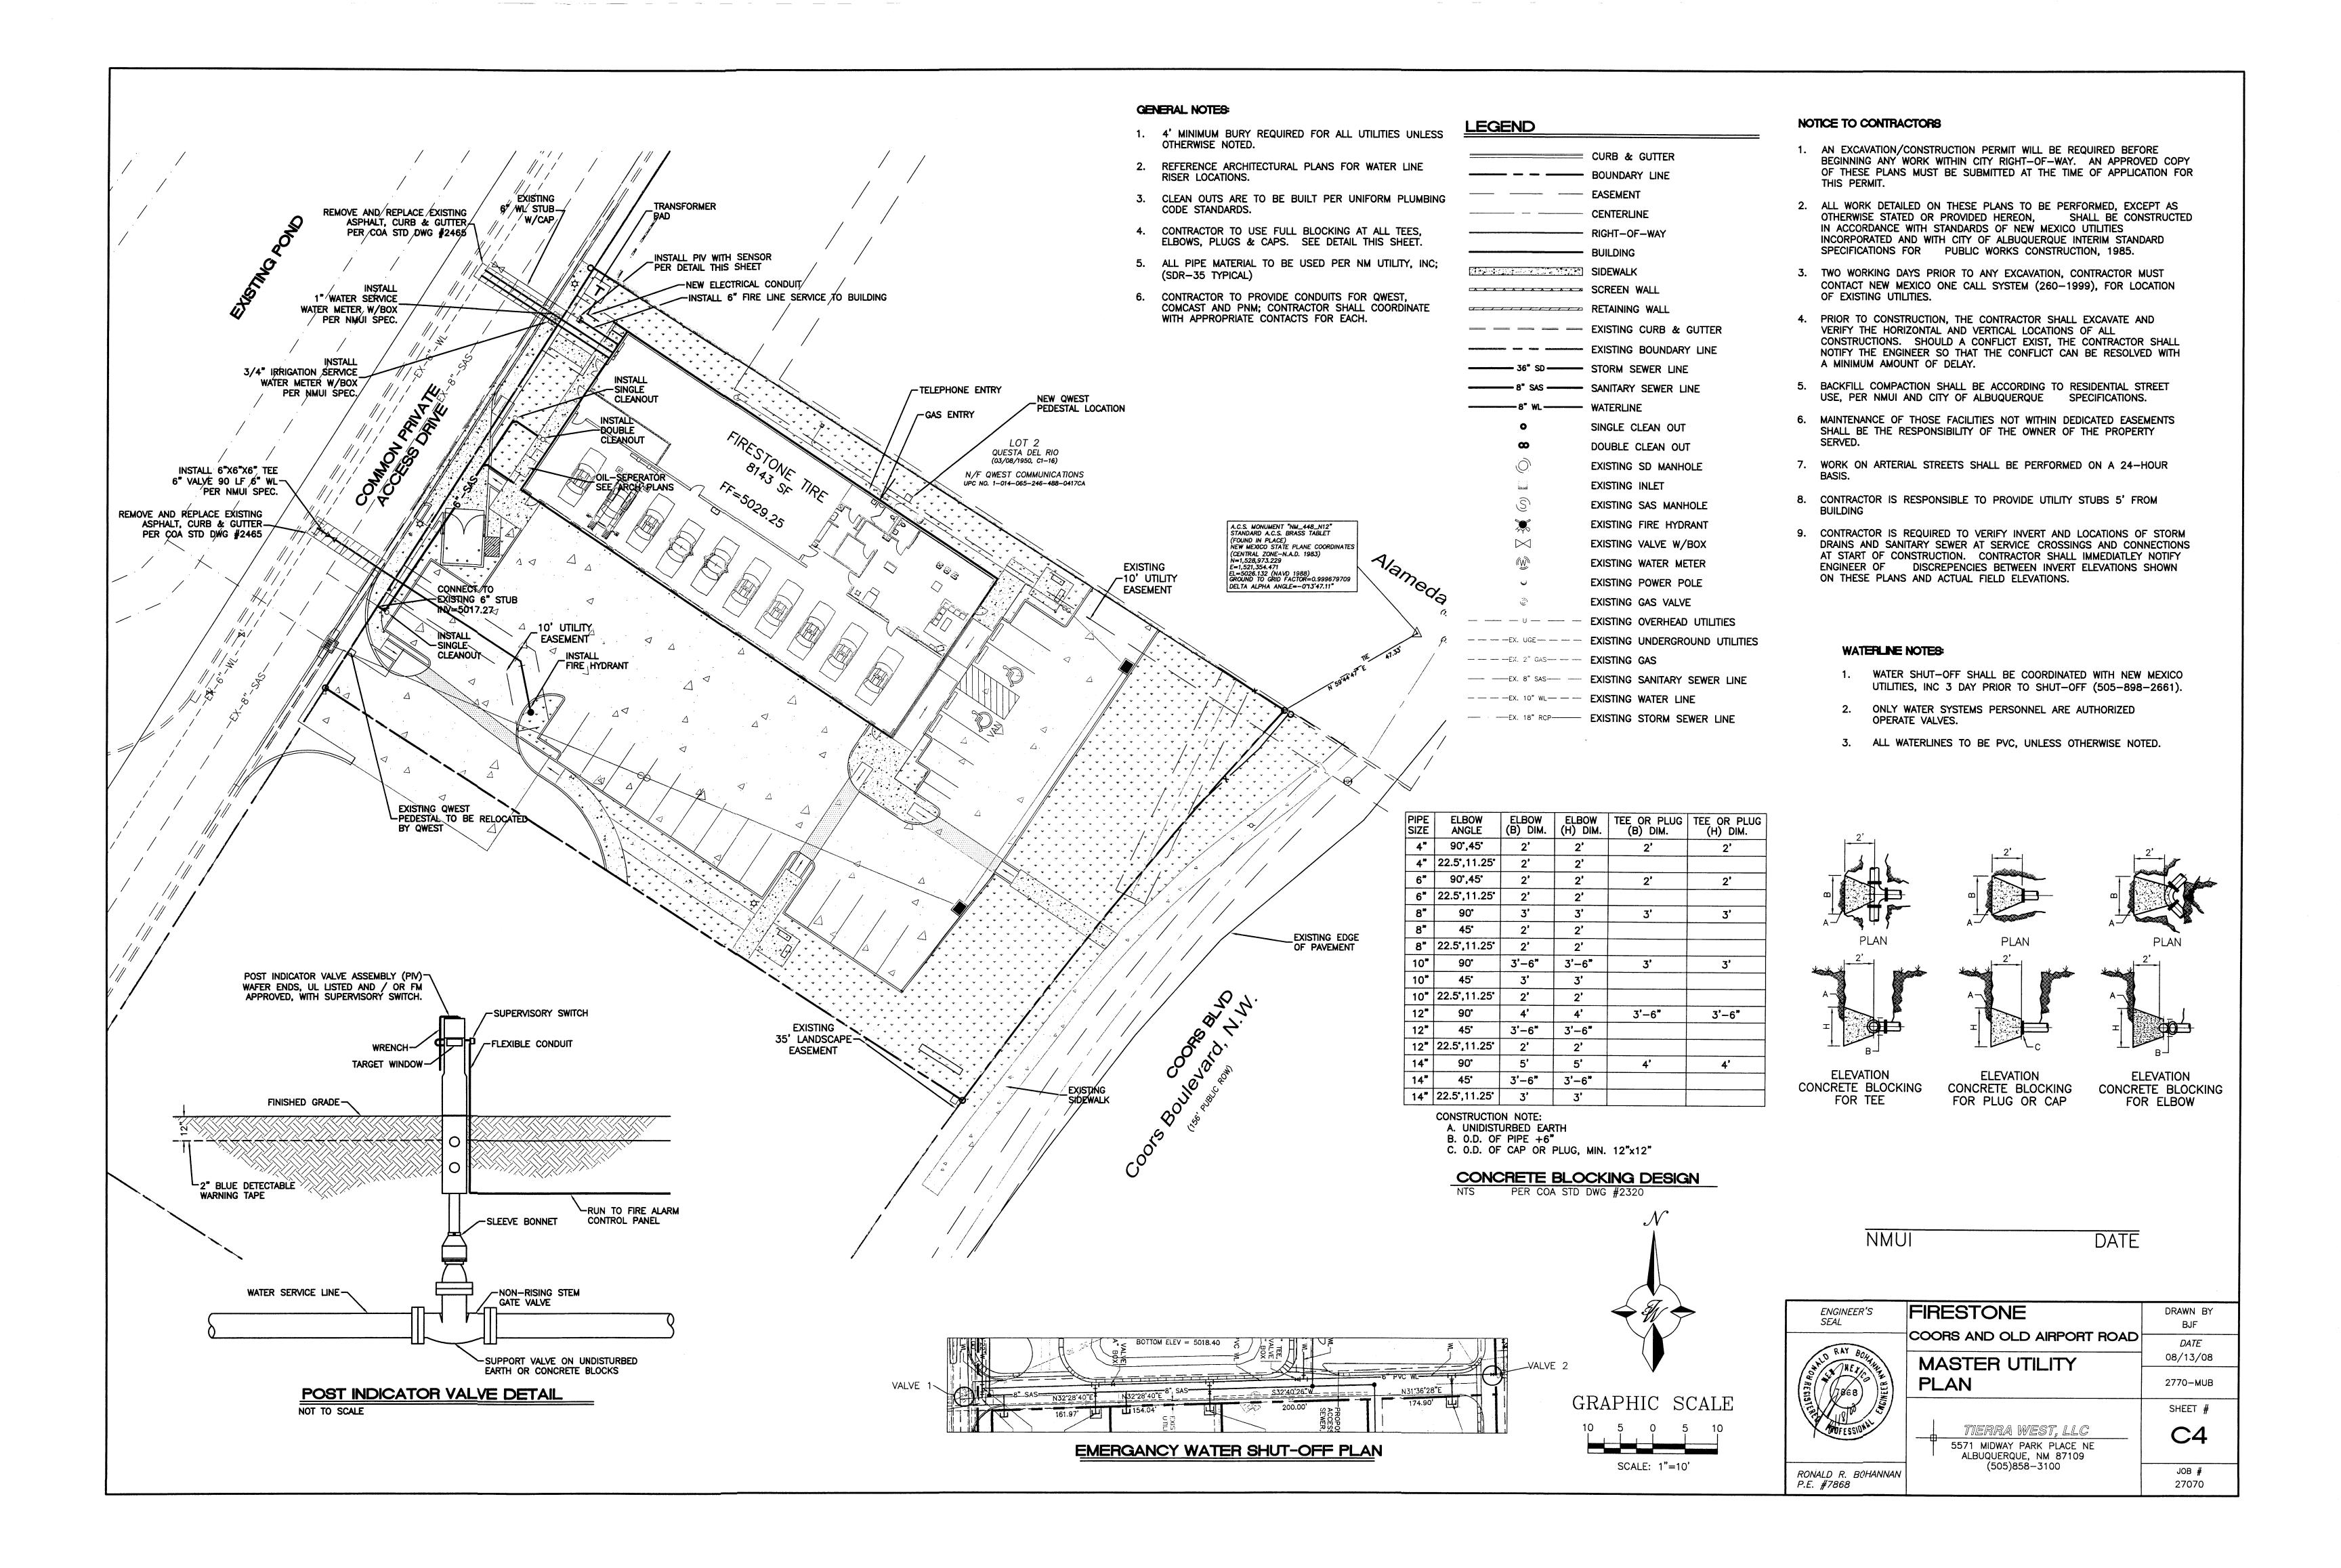

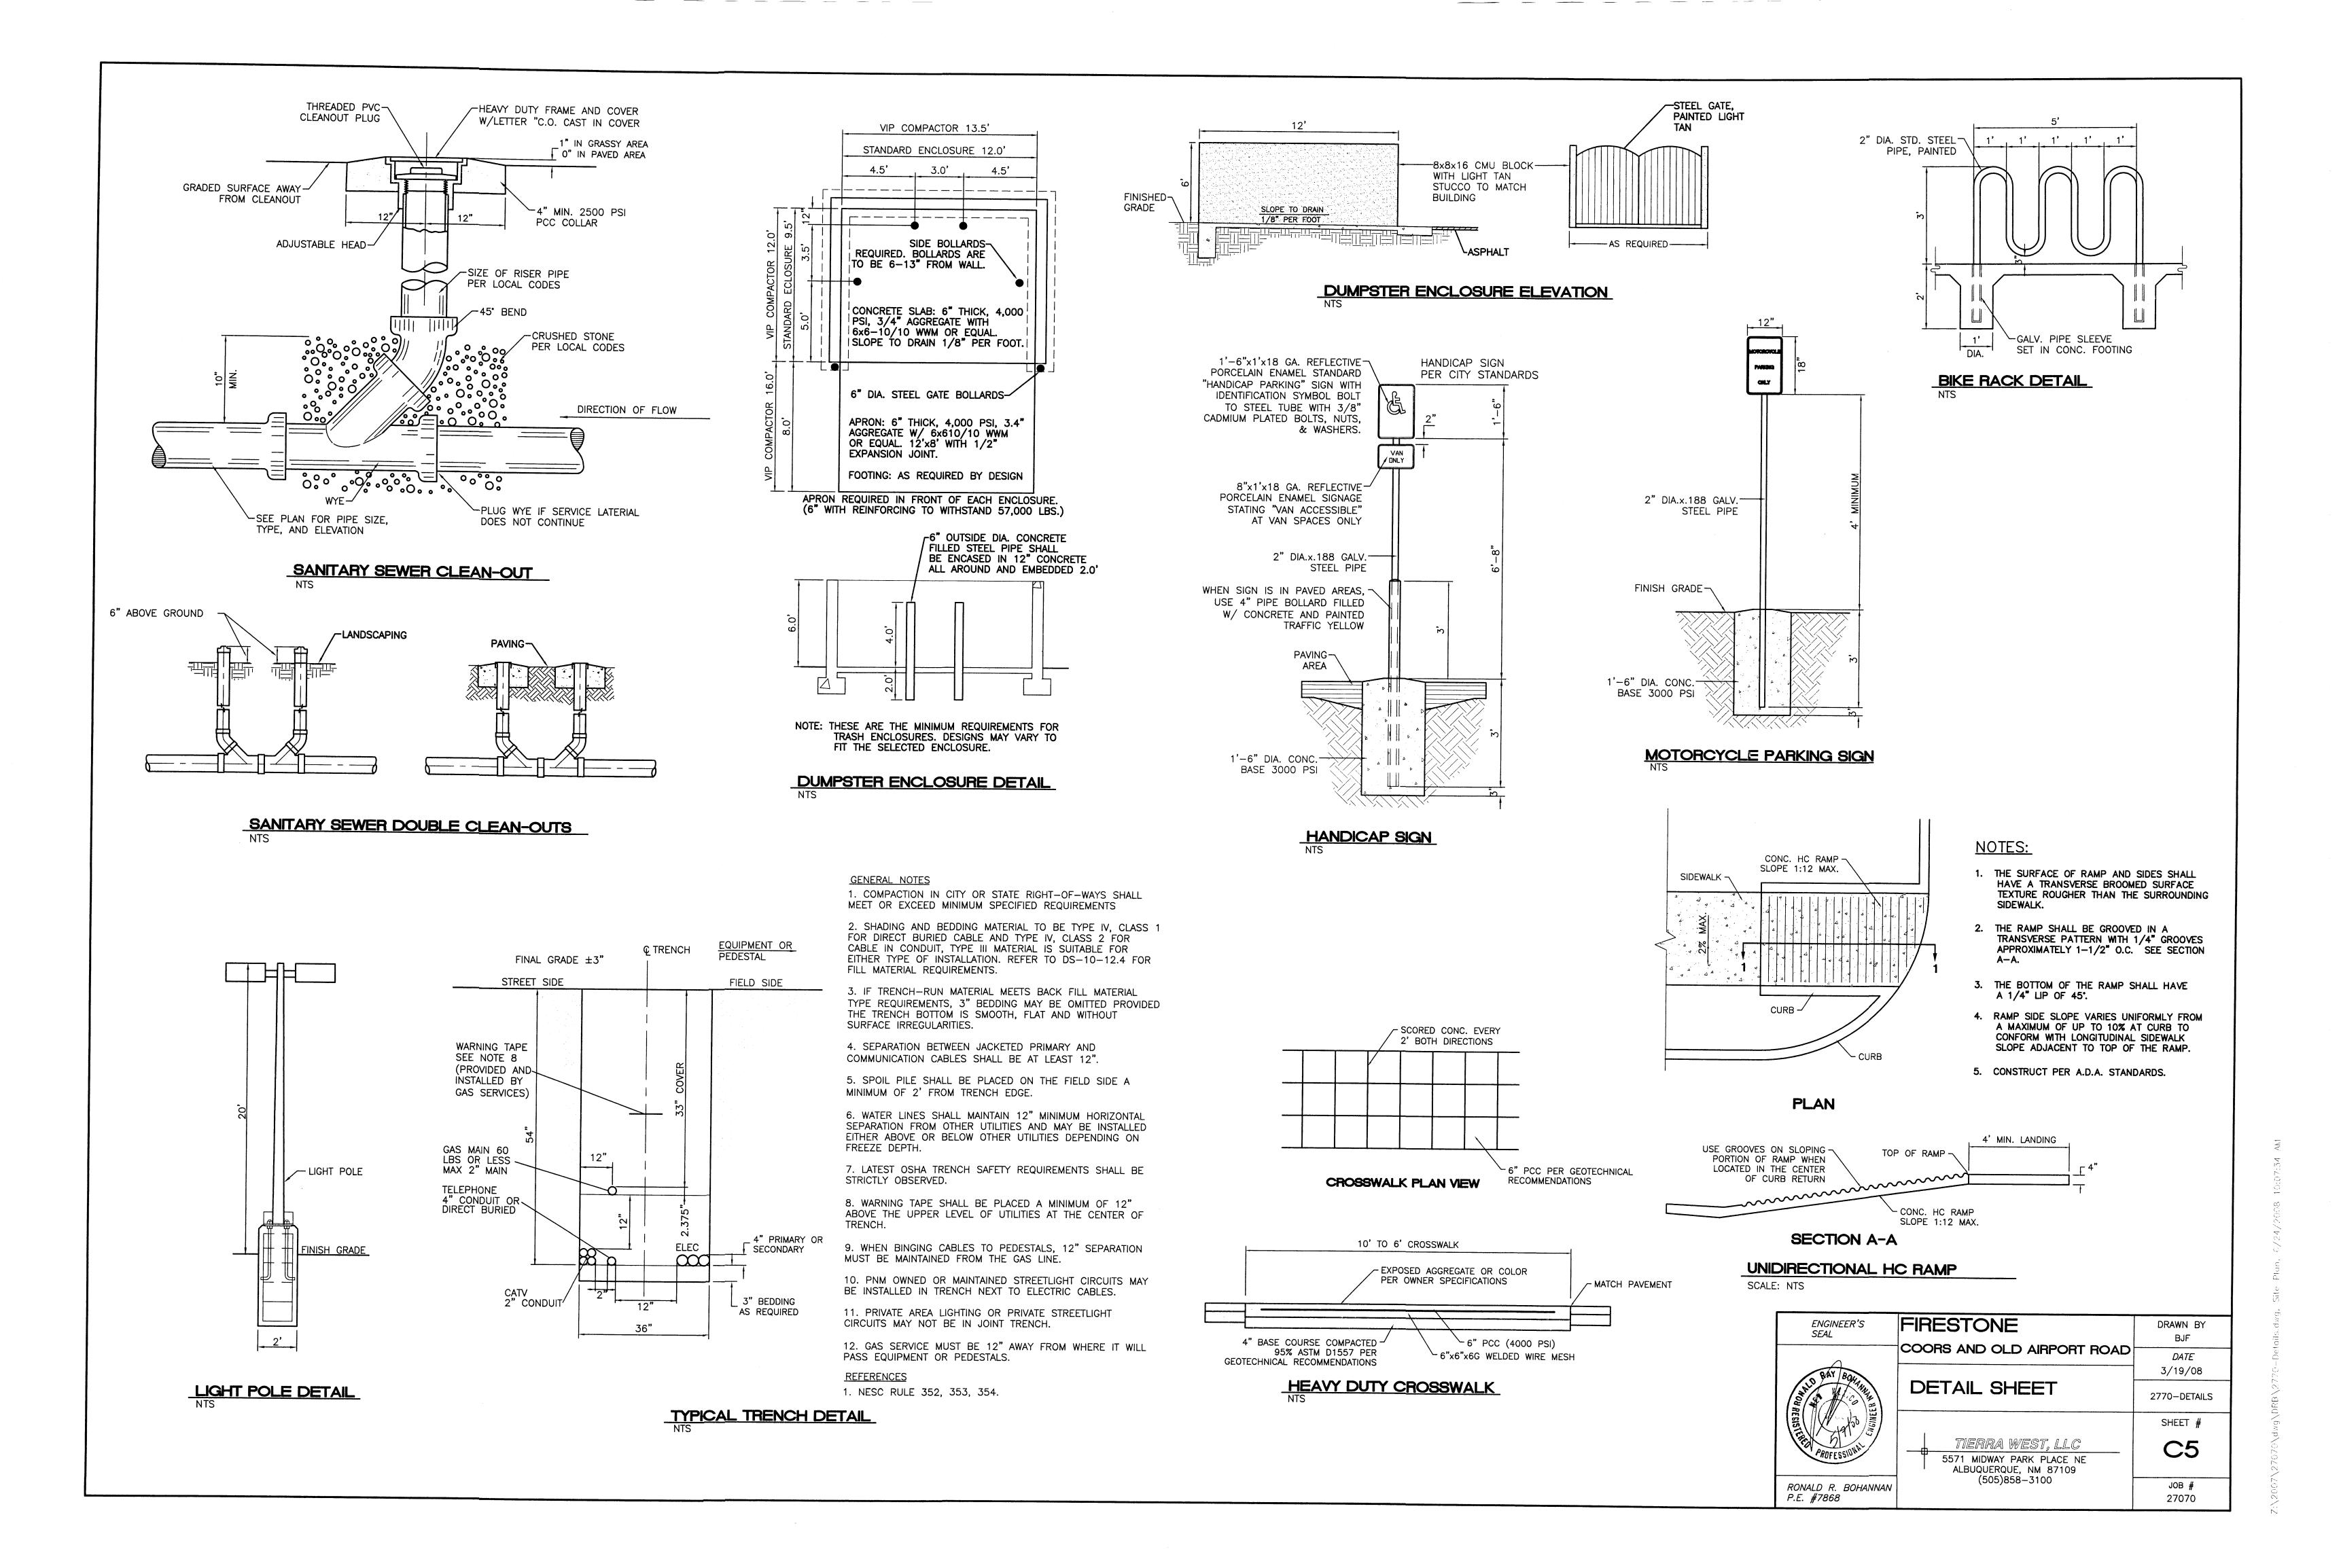

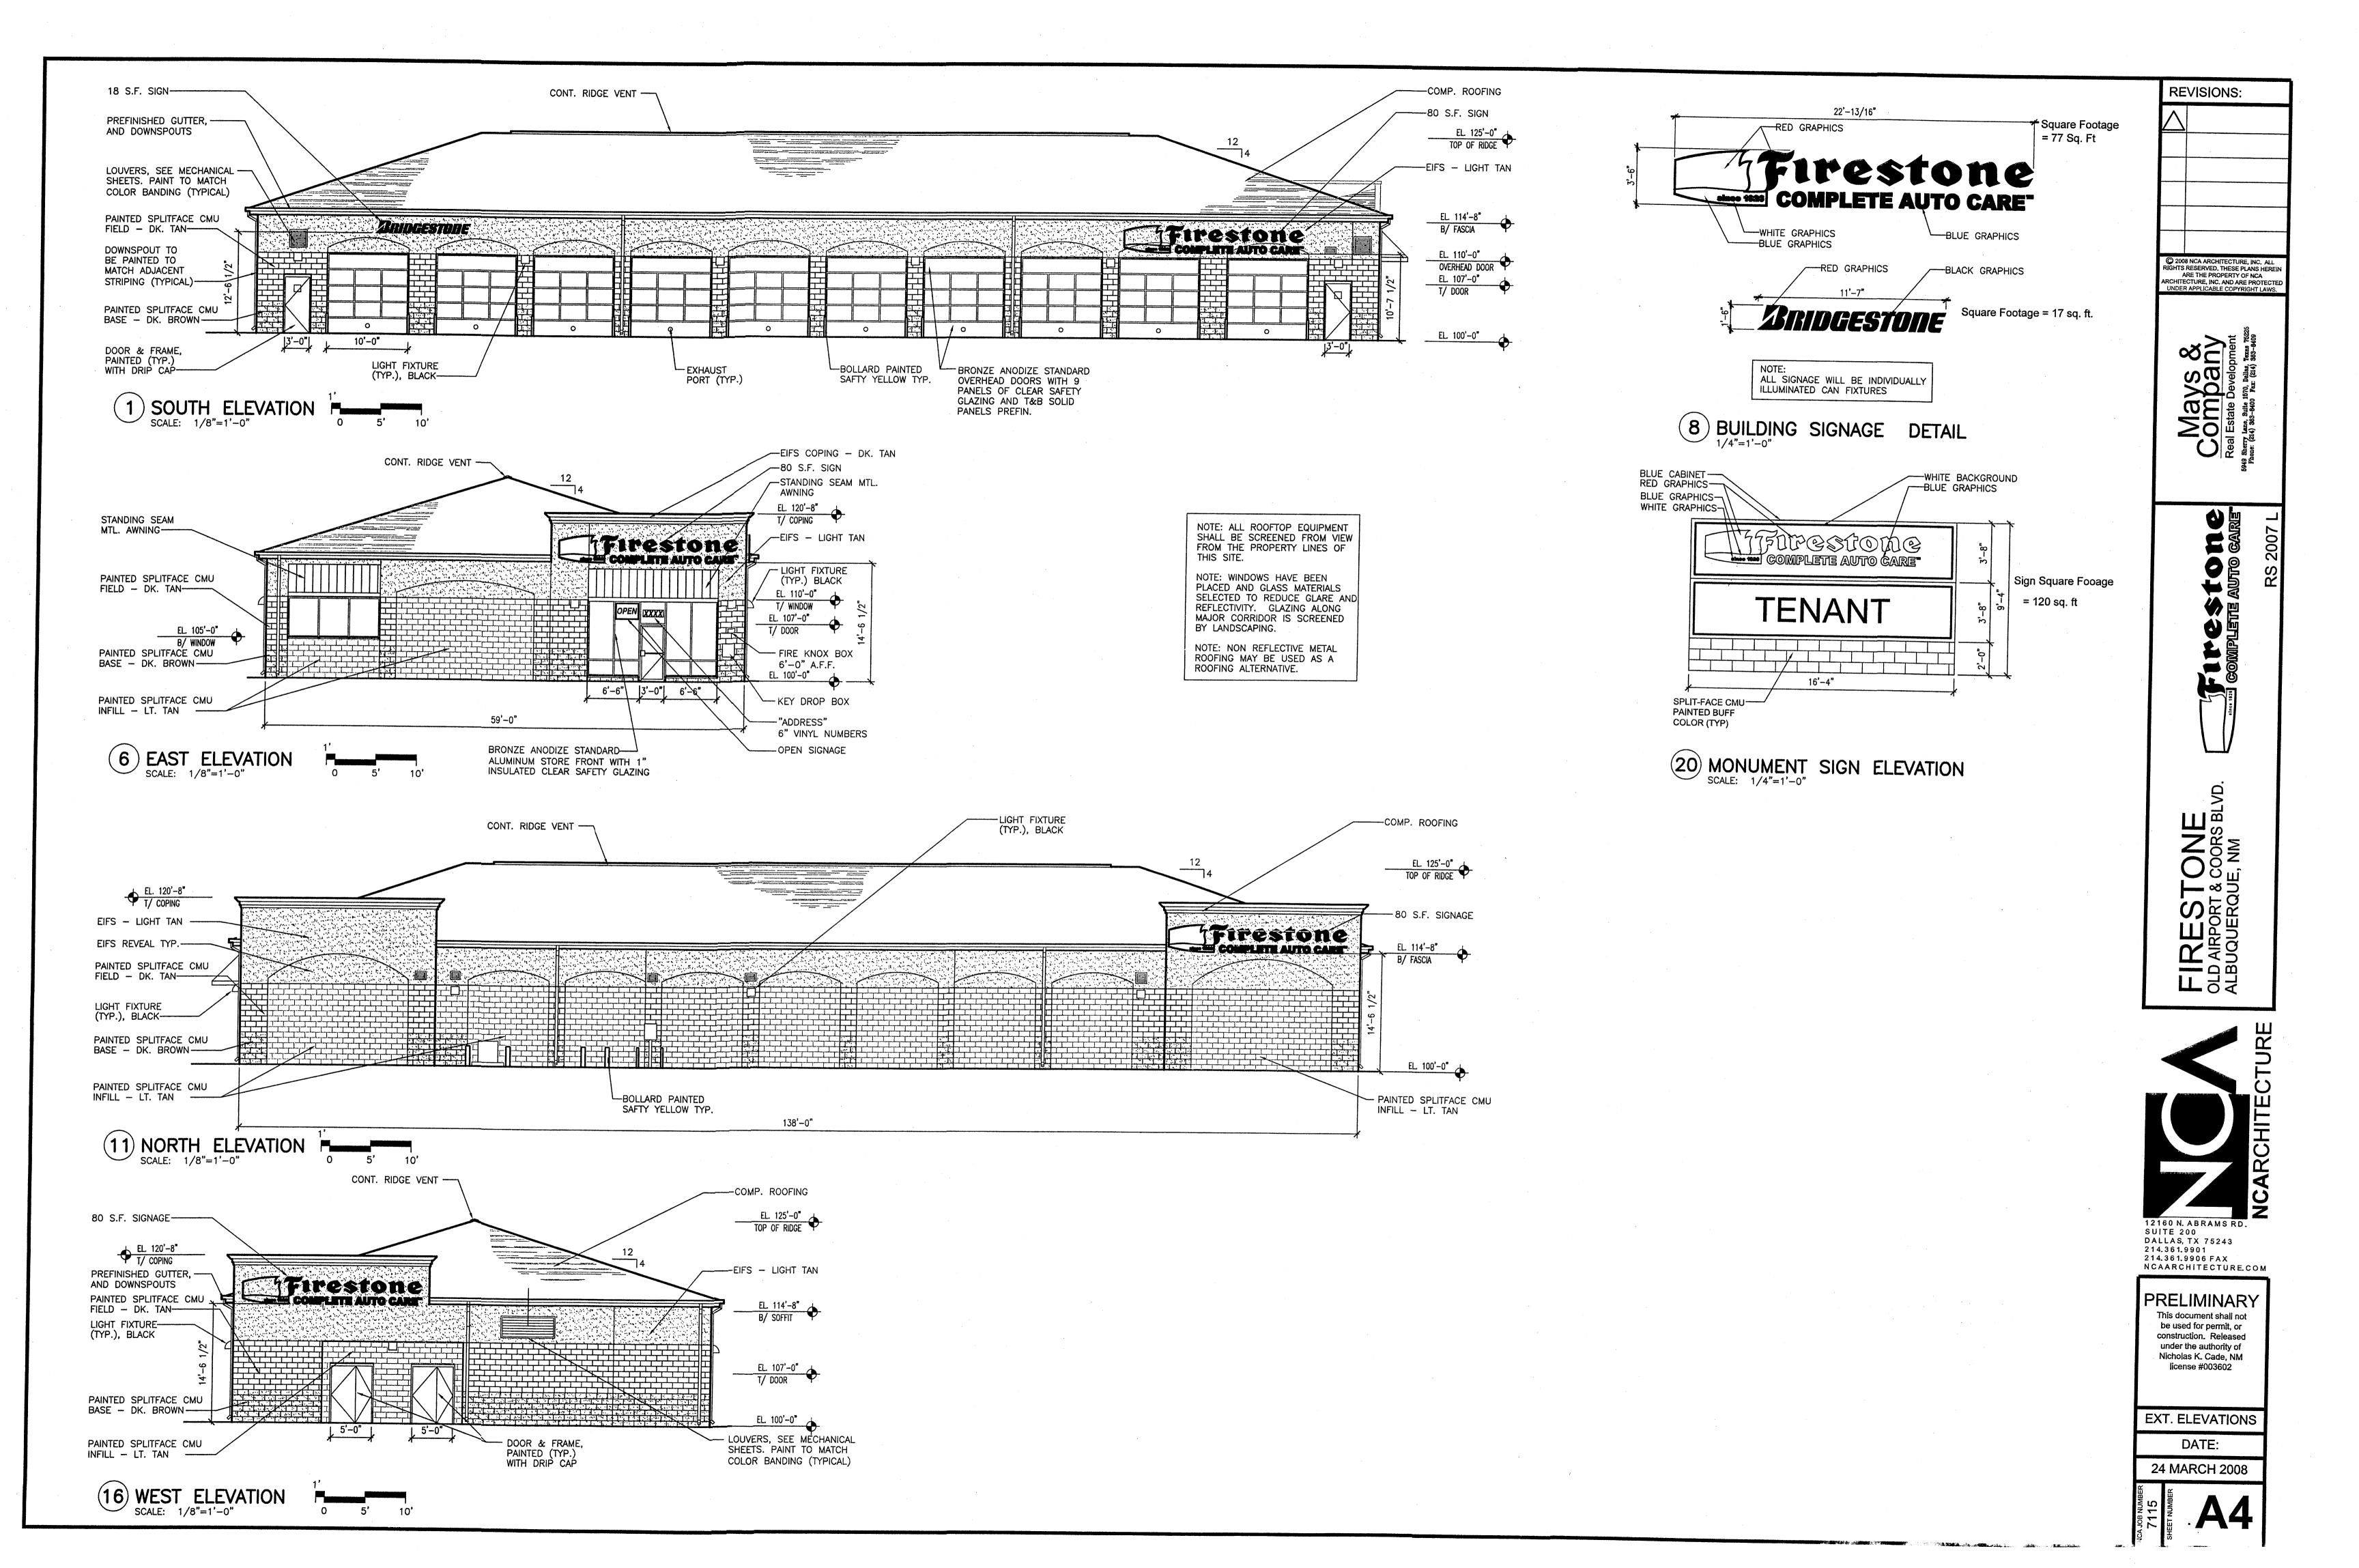

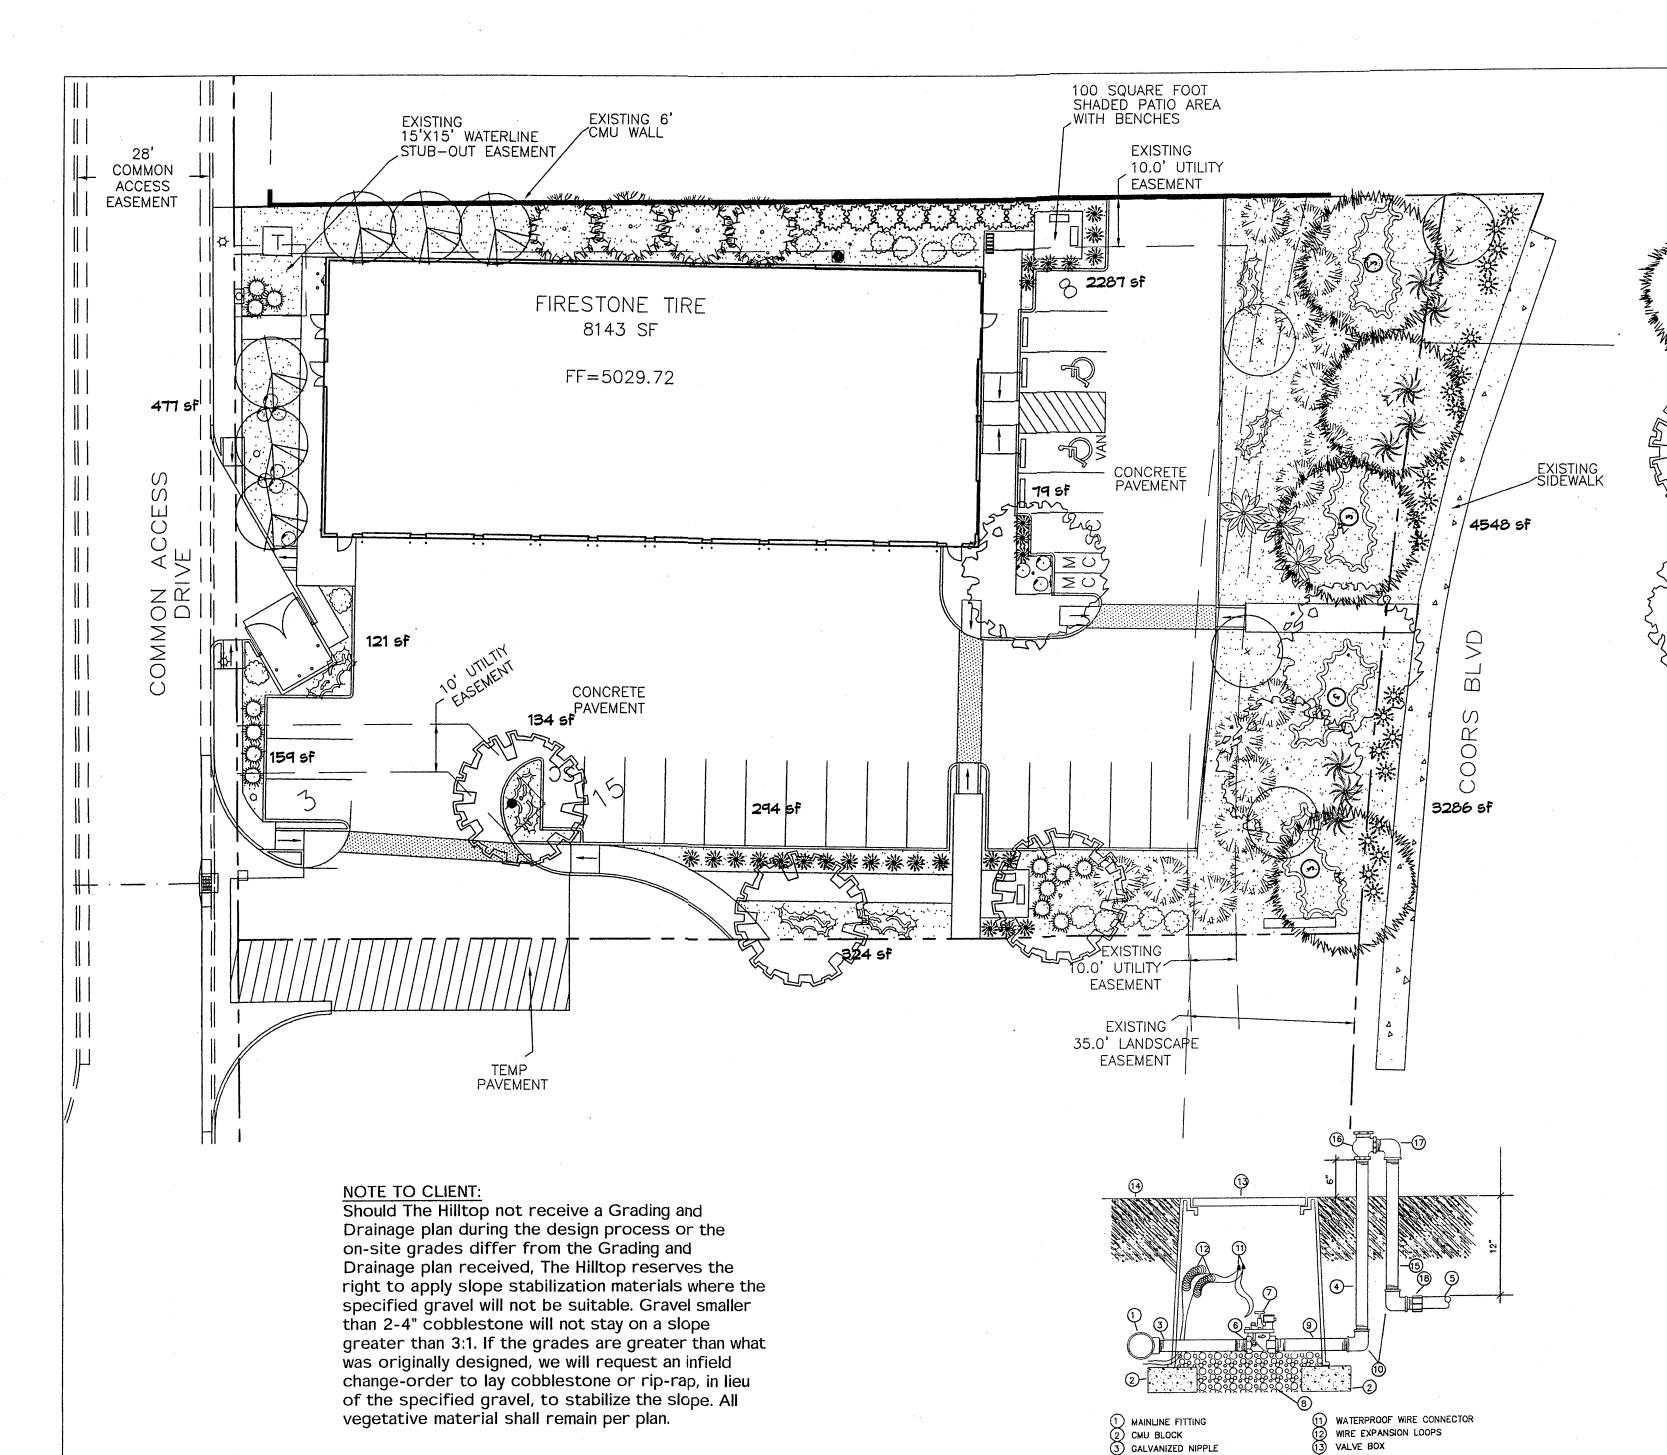

LANDSCAPE NOTES: Landscape maintenance shall be the responsibility of the Property Owner. The Property Owner shall maintain street trees in a living, healthy, and

attractive condition.

It is the intent of this plan to comply with the City Of Albuquerque Mater Conservation Landscaping and Water Waste Ordinance planting restriction approach. Approval of this plan does not constitute or imply exemption from water waste provisions of the Water Conservation Landscaping and Water Waste Ordinance.

Mater management is the sole responsibility of the Property Owner. All landscaping will be in conformance with the City of Albuquerque Zoning Code, Street Tree Ordinance, Pollen Ordinance, and Water Conservation Landscaping and Water Waste Ordinance. In general, water conservative, environmentally sound landscape principles will be followed in design and installation.

Plant beds shall achieve 75% live ground cover at maturity.

Santa Fe Brown Gravel over Filter Fabric to a minimum depth of 3" shall be placed in all landscape areas which are not designated to receive native seed.

IRRIGATION NOTES: Irrigation shall be a complete underground system with Trees to receive 1 Netafim spiral (50' length) with 3 loops at a final radius of 4.5' from tree trunk, pinned in place. Netafim shall have emitters 12" o.c. with a flow of .6 gph. Shrubs to receive (2) 1.0 GPH Drip Emitters. Drip and Bubbler systems to be tied to 1/2" polypipe with flush caps at each end. Trees and shrubs shall be on separate valves.

Run time per each shrub drip valve will be approximately 15 minutes per day. Tree drip valve shall run 1.5 hours, 3 times per week. Run time will be adjusted according to the season.


Point of connection for irrigation system is unknown at current time and will be coordinated in the field. Irrigation will be operated by automatic controller.

Location of controller to be field determined and power source for controller to be provided by others.

Irrigation maintenance shall be the responsibility of the Property Owner.

Water and Power source shall be the responsibility of the Developer/Builder.

# PLANT LEGEND

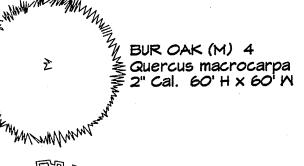

CHITALPA (M) 3 Chilopsis x Catalpa 2" Cal., 30' H x 30' W

Thuja plicata 'Green Giant'
15 Gal. 225sf, 40' H x 15' W NEW MEXICO OLIVE (L) 4 Forestiera neomexicana

15 Gal. 225sf, 15' H x 15' W WASHINGTON HAWTHORN (M+) 4 Crataegus phaenopyrum 15 Gal. 225sf, 15' H x 15' W

WESTERN RED CEDAR (M) 6

### DESERT ACCENTS

COMMON HACKBERRY (M) 3 Celtis occidentalis 52" Cal., 40' H x 40' W

\* BANANA YUCCA (L) 9 Yucca baccata 25 sf, 4' H x 5' W

### SHRUBS/ORNAMENTAL GRASSES ONE GAL .

### SHRUBS/ORNAMENTAL GRASSES FIVE GAL.

\* WILLOWLEAF COTONEASTER Cotoneaster salicilifolius 5 Gal. 100sf, 6' H x 10' W

MOCK ORANGE (M) 3 Philadelphus cultivars 5 Gal. 100sf, 10' H × 10' M

SNOWBERRY (M) 9 Symphoricarpos albus 5 Gal. 36sf, 6' H x 6' M

\* SCOTCH BROOM (M) 13 Cytisus scoparius 5 Gal. 16sf, 4' H x 4' M

\* OREGON GRAPE (M) 10 Mahonia aquifolium 5 Gal. 9sf, 2' H x 3' W

\* DENOTES EVERGREEN PLANT MATERIAL

# GROUNDCOYERS

**HARDSCAPES** 

\* GREYLEAF COTONEASTER (M) 12 Cotoneaster buxifolius 5 Gal. 81sf, 2' H x 9' M Symbol indicates 3 plants

WINTER JASMINE (L+) 6 Jasminum nudiflorum 1 Gal. 144sf, 4' H x 12' W

\* POWIS CASTLE SAGE (L+) 12

BLUE AVENA/OAT GRASS (M) 24

Helictotrichon sempervirens 1 Gal. 9sf, 2' H x 3' M

Artemisia X Powis Castle 1 Gal. 25sf, 2' H x 5' M

DEER GRASS (M) 28

Muhlenbergia rigens 1 Gal. 16sf, 4' H x 4' W

NATURAL EDGE

WITH FILTER FABRIC TO A MINIMUM 3" DEPTH

# I ANDSCAPE CALCULATIONS

L/MD30/11 L O/1LOOL/1110/10					
TOTAL LOT AREA	37650	square feet			
TOTAL BUILDINGS AREA	8141	square feet			
NET LOT AREA	29509	square feet			
LANDSCAPE REQUIREMENT	15%				
TOTAL LANDSCAPE REQUIREMENT	4426	square feet			
TOTAL BED PROVIDED	11709	square feet			
GROUNDCOVER REQ.	75%	square feet			
TOTAL GROUNDCOVER REQUIREMENT	8781	square feet			
TOTAL GROUNDCOVER PROVIDED _	8814 (75%)	square feet			
TOTAL SOD AREA	0	square feet			
(max. 20% of landscape required)		·			
TOTAL LANDSCAPE PROVIDED	11630	square feet			

# STREET TREE REQUIREMENTS


Street trees required under the City Of Albuquerque Street Tree Ordinance are as follows:

Name of Street: Coors Blvd. Required # 6 Provided # 6

### PARKING LOT TREE REQUIREMENTS

Shade trees required under the City Of Albuquerque Parking Lot Tree Ordinance are as follows:

1 Shade tree per 10 spaces Required # 3 Provided # 3

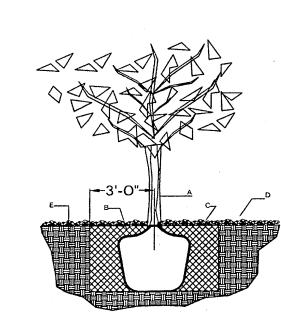

# TREE PLANTING DETAIL

# **GENERAL NOTES:**

VALVE BOX

AUTOMATIC VALVE W/ ATMOSPHERIC

SHRUB PLANTING DETAIL

1. THE OUTSIDE DIAMETER OF THE WATER RETENTION

BASIN SHALL BE TWICE THE DIAMETER OF THE SHRUB

C. EARTH BERM AROUND WATER RETENTION BASIN.

FINISH GRADE

GALVANIZED NIPPLE - 18" TO 24" LENGTH

ATMOSPHERIC VACUUM BREAKER

8) TOE NIPPLE OR MALE ADAPTER

GALVANIZED STREET ELL

24" TO 36" GALVANIZED NIPPLE

AUTOMATIC VALVE (SEE LEGEND)

4" MAX.

GENERAL NOTES:

CONSTRUCTION NOTES:

B. BACKFILL WITH EXISTING SOIL.

D. 3" DEPTH OF GRAVEL MULCH.

PLANTING PIT.

E. FINISH GRADE.

F. UNDISTURBED SOIL.

A. SHRUB.

VACUUM BREAKER

LATERAL PIPE

GRAVEL

NTS

REDUCER BUSHING

9) GALVANIZED NIPPLE

(10) GALVANIZED ELBOW

1. ROOTBALL SHALL BE PLACED ON UNDISTURBED SOIL TO PREVENT TREE FROM SETTLING.


2. TOP OF ROOTBALL INDICATED LEVEL AT WHICH TREE WAS GROWN AND DUG; THIS REPRESENTS THE LEVEL AT WHICH THE TREE SHOULD BE INSTALLED; THAT LEVEL MAY BE EXCEEDED BY ONLY A ONE INCH LAYER OF SOIL. 3. PRIOR TO BACKFILLLING TREE, ALL WIRE, ROPE AND SYNTHETIC MATERIALS SHALL BE REMOVED FROM THE TREE AND THE PLANTING PIT.

AWAY EXCEPT FROM BOTTOM OF THE ROOTBALL.


# **CONSTRUCTION NOTES:**

B. BACKFILL WITH EXISTING SOIL.

GRAPHIC SCALE SCALE: 1"=20'

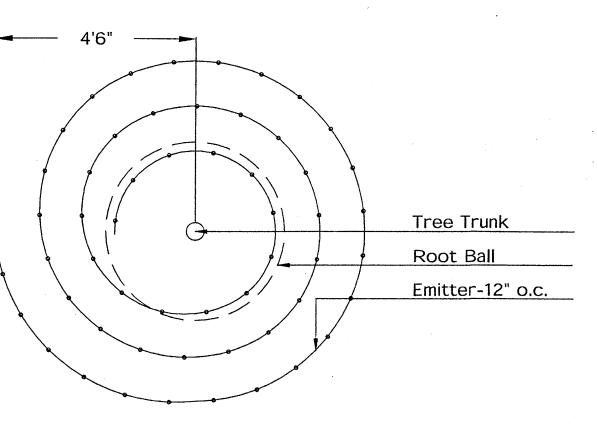


# Netafim Spiral Detail

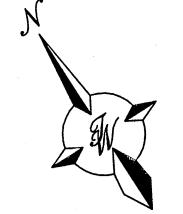

3-12-08 Site revision rmm 1-29-08 Site revision rmm

1-9-08 Easements labeled rmm

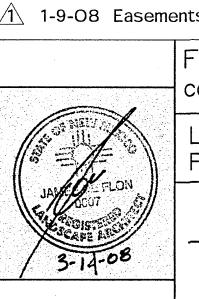

Albuquerque, NM 87184 Ph. (505) 898-9690 Fax (505) 898-7737 cm j@hilltoplandscaping.com All creative ideas contained Herein remains the property of The Hilltop Landscape Architects and Contractors and are protected by copyright laws. This is an original design and must not be released or copied

ANDSCAPE ARCHITECTS & CONTRACTORS

Cont. Lic. #26458

7909 Edith N.E.

1-9-00 Lasements labeled Thin					
	FIRESTONE	DRAWN BY RMM			
G 30 31511/2/	COORS AND OLD AIRPORT ROAD	<i>DATE</i> 12/18/07			
	LANDSCAPE PLAN FOR BUILDING PERMIT	2770-SPE			
JAMES FLON		SHEET #			
3-14-08	TIERRA WEST, LLC 5571 MIDWAY PARK PLACE NE ALBUQUERQUE, NM 87109	L1			
	(505)858-3100	JOB # 27070			

4. PRIOR TO BACKFILLING ALL BURLAP SHALL BE CUT

A. TREE

C. 3" DEPTH OF GRAVEL MULCH. D. UNDISTRUBED SOIL.