

LANDSCAPE NOTES: Landscape maintenance shall be the responsibility of the Property Owner.

It is the intent of this plan to comply with the City Of Albuquerque Water Conservation Landscaping and Water Waste Ordinance planting restriction approach.

Approval of this plan does not constitute or imply exemption from water waste provisions of the Water Conservation Landscaping and Water Waste Ordinance. Water management is the sole responsibility of the Property Owner.

All landscaping will be in conformance with the City of Albuquerque Zoning Code, Street Tree Ordinance, Pollen Ordinance, and Water Conservation Landscaping and Water Waste Ordinance. In general, water conservative, environmentally sound landscape principles will be followed in design and installation.

Plant beds shall achieve 75% live ground cover at maturity.

Santa Fe Brown Gravel over Filter Fabric shall be placed in all landscape areas which are not designated to receive native seed.

IRRIGATION NOTES:

Irrigation shall be a complete underground system with Trees to receive (5) 1.0 GPH Drip Emitters and Shrubs to receive (2) 1.0 GPH Drip Emitters. Drip and Bubbler systems to be tied to 1/2" polypipe with flush caps at each end.

Run time per each drip valve will be approximately 15 minutes per day, to be adjusted according to the season.

Point of connection for irrigation system is unknown at current time and will be coordinated in the field.

Irrigation will be operated by automatic controller. Location of controller to be field determined and power source for controller to be provided by others.


Irrigation maintenance shall be the responsibility of the Property Owner.

STREET TREE REQUIREMENTS


Street trees required under the City Of Albuquerque Street Tree Ordinance are as follows:

Montano Road

Provided 4 Required 3

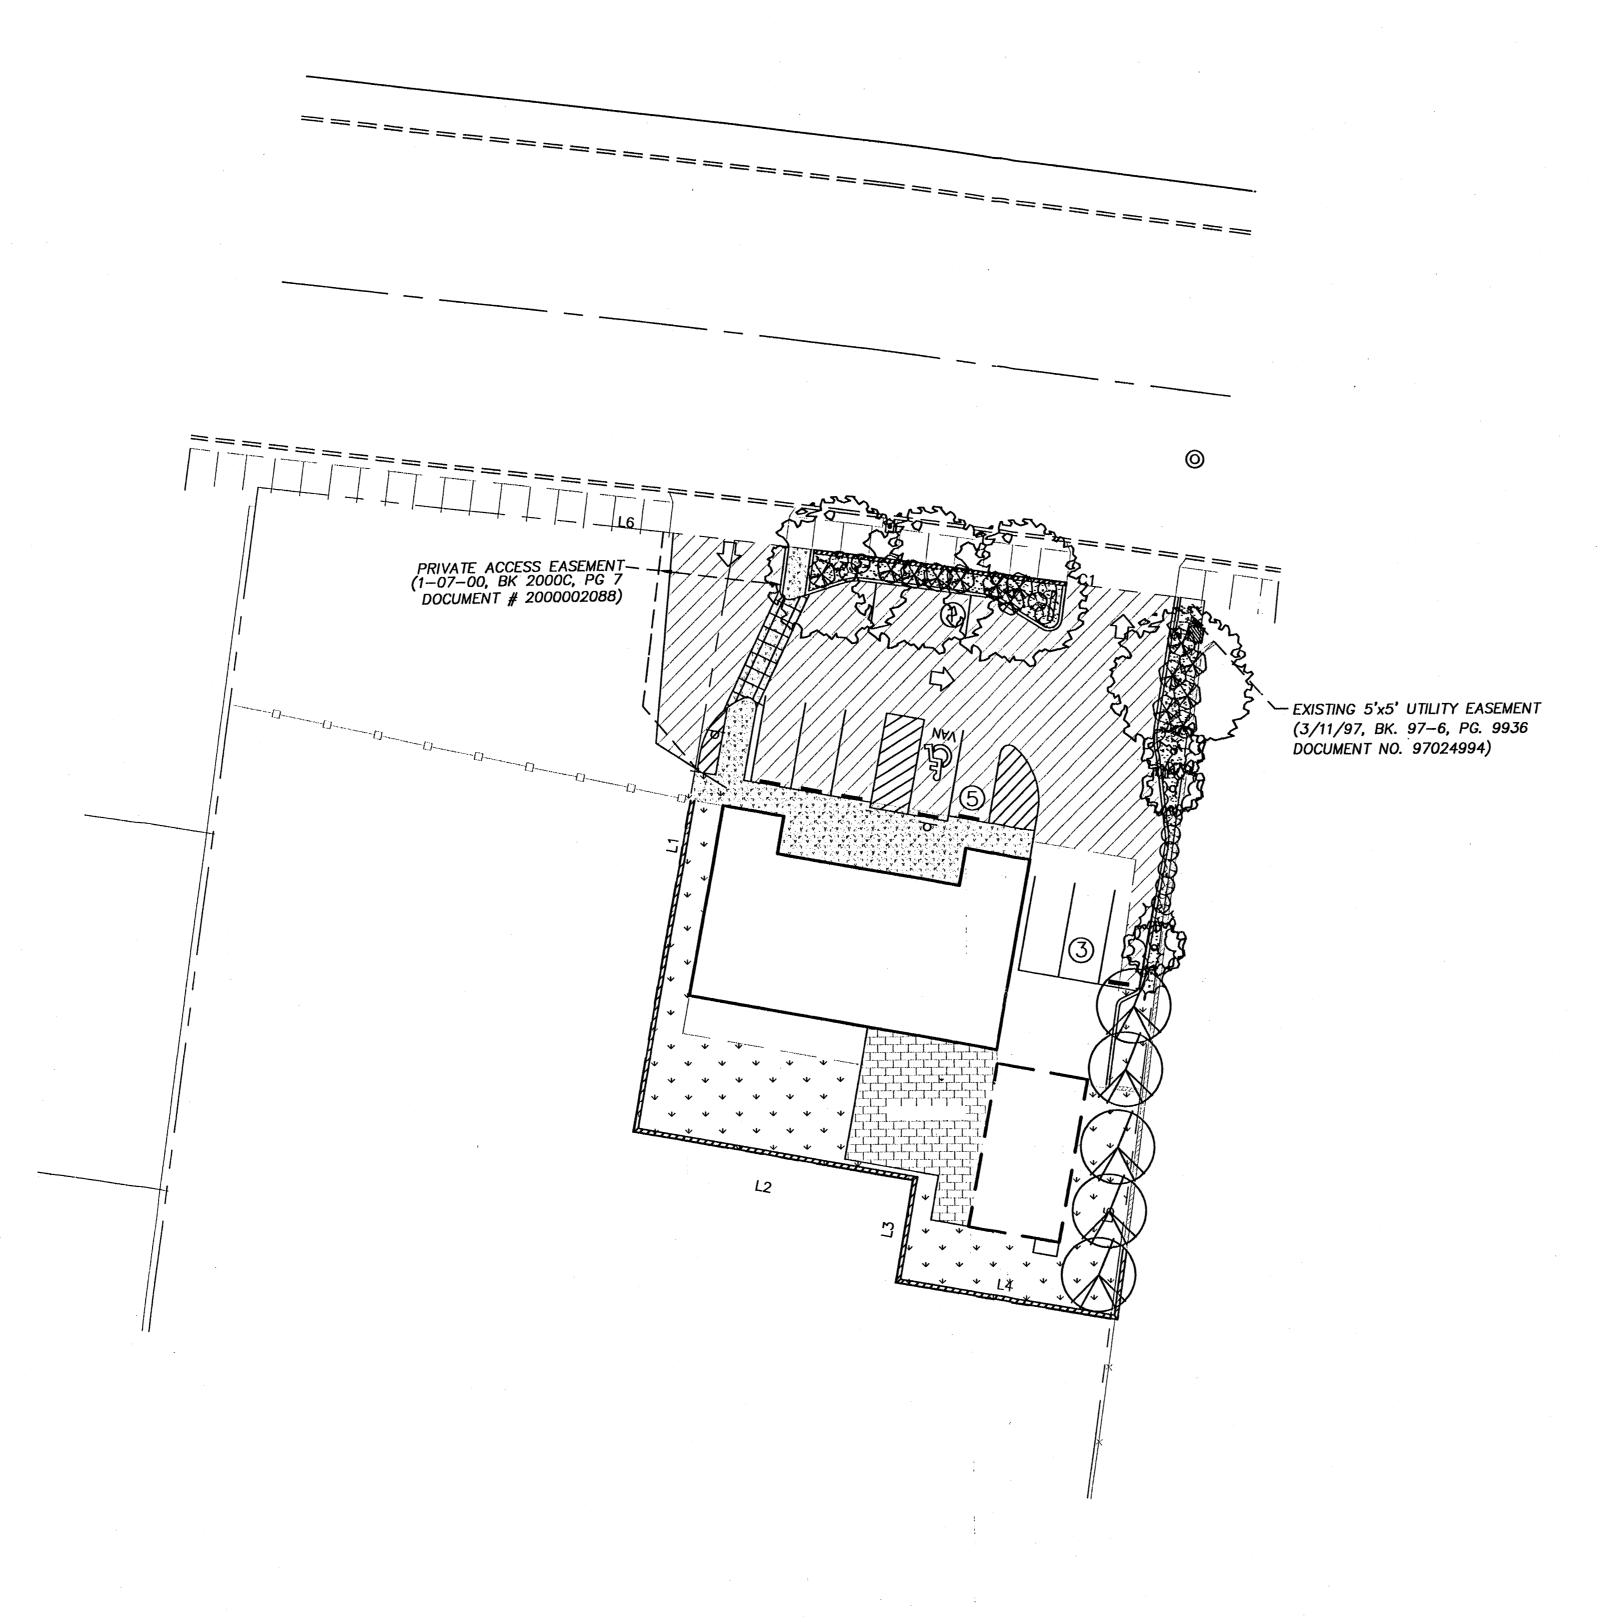



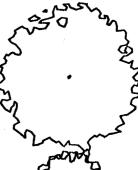

ASH (H) OR HONEY LOCUST (H)
Fraxinus pennsylvanica
Gleditsia triacanthos
2" Cal.

PURPLE-LEAF PLUM (M) Prunus spp. 1 1/2" Cal.

FLOWERING PEAR (H) Pyrus calleryana 2° Cal.

INDIAN HAWTHORN (M) Raphiolepis indica 5 Gal.

1 Gal. 4sf TAM JUNIPER (M) Juniperus sabina 5 Gal. 225sf

WILDFLOWER


SANTA FE BROWN GRAVEL WITH FILTER FABRIC

EXISTING LANDSCAPING TO REMAIN

LANDSCAPE CALCULATIONS


NET LANDSCAPE AREA

TOTAL LOT AREA	14,013	_ square	feet
TOTAL BUILDINGS AREA	3,014	_ square	feet
OFFSITE AREA	0	square	feet
NET LOT AREA	10,999	_ square	feet
LANDSCAPE REQUIREMENT	15%		
TOTAL LANDSCAPE REQUIREMENT	1,649	_ square	feet
TOTAL LANDCOARE DROVINED	7 0 4 0		faak
TOTAL LANDSCAPE PROVIDED	3,248	_ square	ieet
NEW LANDSCAPE PROVIDED	548	_ square	feet
EXISTING LANDSCAPE PROVIDED	2,700	_ square	feet

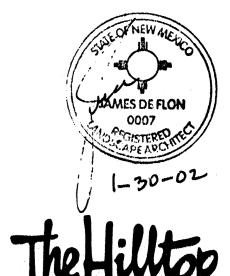

Cont. Lic. #26458 7909 Edith N.E. Albuquerque, NM 87184 Ph. (505) 898-9690 Fax (505) 898-7737 it@hilltoplandscaping.com


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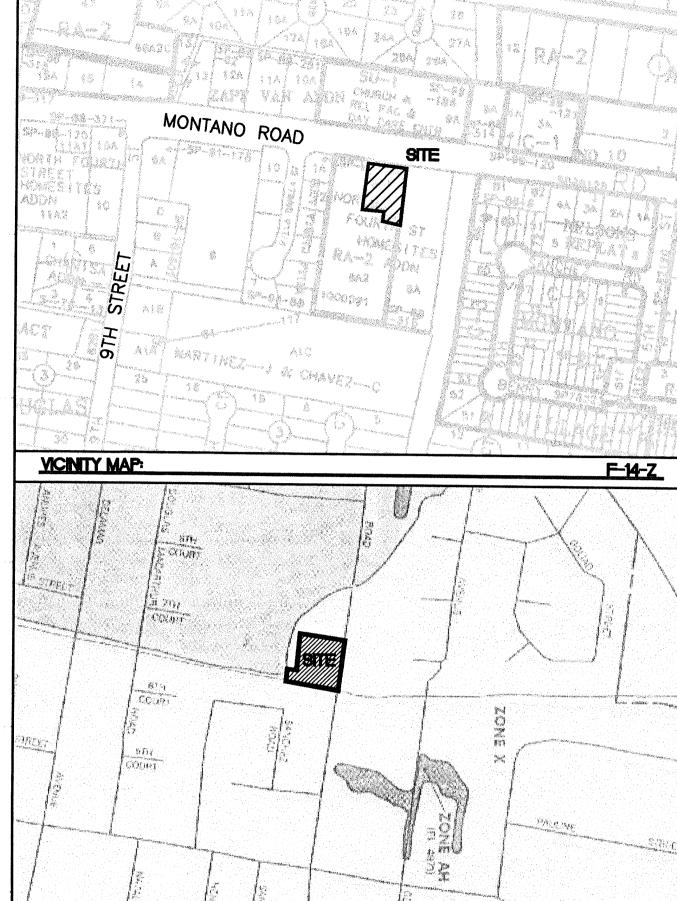


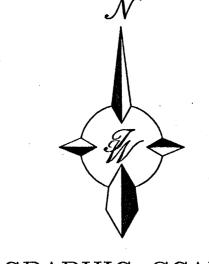GRAPHIC SCALE



_			
	LANDSCAPE ARCHITECT SEAL	700 MONTANO ROAD,	DRAWN N W IRW
		ŕ	DATE
		LANDSCAPE PLAN	01-25-02
		FOR BUILDING PERMIT	
·			SHEET #
		TIERRA WEST, LLC 8509 JEFFERSON NE ALBUQUERQUE, NEW MEXICO 87113	2 OF 5
	JAMES DE FLON #0007	(505)858-3100	JOB #



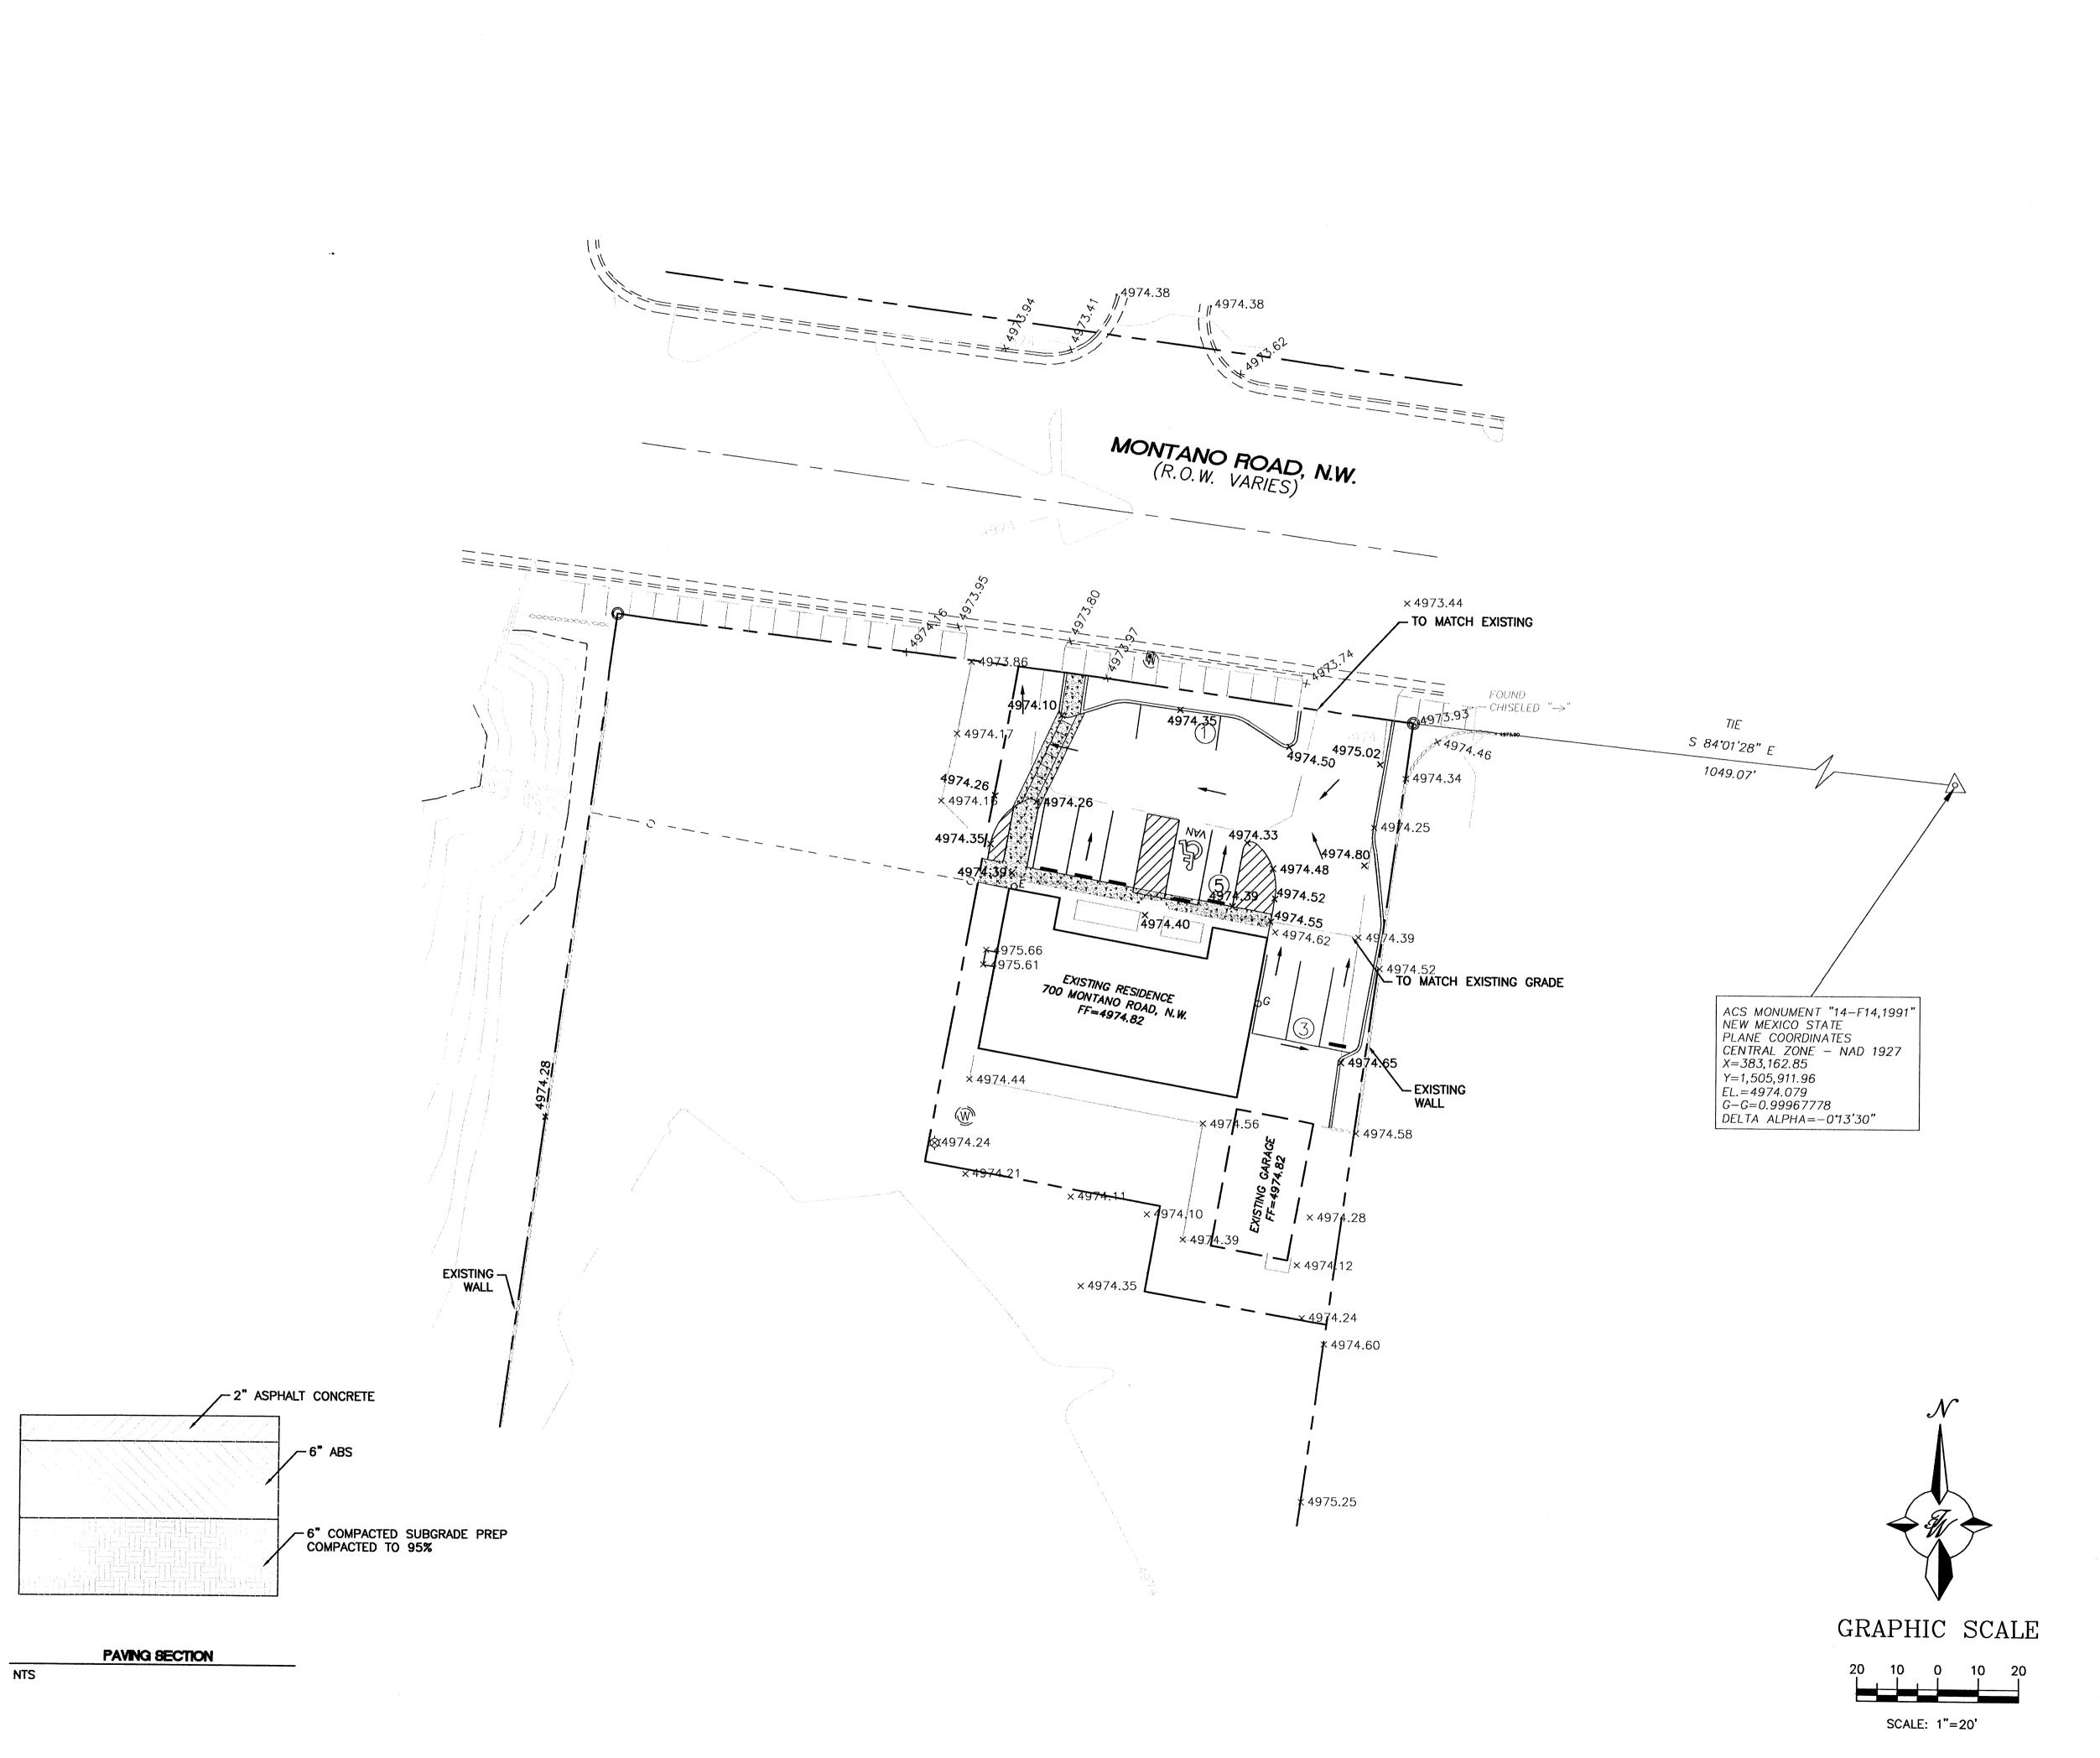

LOT 6A, N. FOURTH STREET HOMESITE ADDITION

FIRM MAP:

1. ALL SPOT ELEVATIONS ARE FLOWLINE UNLESS OTHERWISE NOTED.

35001C0119 D

2. THE SITE CURRENTLY DRAINS TO MONTANO ROW, WHERE THE FLOW IS COLLECTED BY COA 60" RCP STORM DRAIN. THIS STORM DRAIN COLLECTS THE FLOW AND DISCHARGES TO THE RIO GRANDE


3. THE FLOW FROM THE SITE IS HISTORIC AND THE PROPOSED CHANGES DO NOT INCREASE ANY RUNOFF FROM THIS SITE. (THE GRAVEL PAVEMENT IS IMPERVIOUS)

LEGEND


---x--x--x--x--x EXISTING FENCE PROPOSED CURB & GUTTER — — BOUNDARY LINE EASEMENT PROPOSED SIDEWALK EXISTING PERIMETER WALL EXISTING CONTOUR EXISTING INDEX CONTOUR PROPOSED CONTOUR PROPOSED INDEX CONTOUR FLOW ARROW SLOPE TIE EXISTING SPOT ELEVATION × 5048.25 × 5048.25 PROPOSED SPOT ELEVATION

ROUGH GRADING APPROVAL


	IDING AT THOVAL	
ENGINEER'S SEAL	700 MONTANO ROAD, NW	DRAWN BY BMP
		DATE
RAY BOHANNA	GRADING AND	02-19-02
7868 (1868)	DRAINAGE PLAN	2156GR.DWG
THE STATE OF THE S		SHEET #
POFESSION R	TIERRA WEST, LLC 8509 JEFFERSON NE ALBUQUERQUE, NEW MEXICO 87113	1
RONALD R. BOHANNAN P.E. #7868	(505)858-3100	JOB # 21056

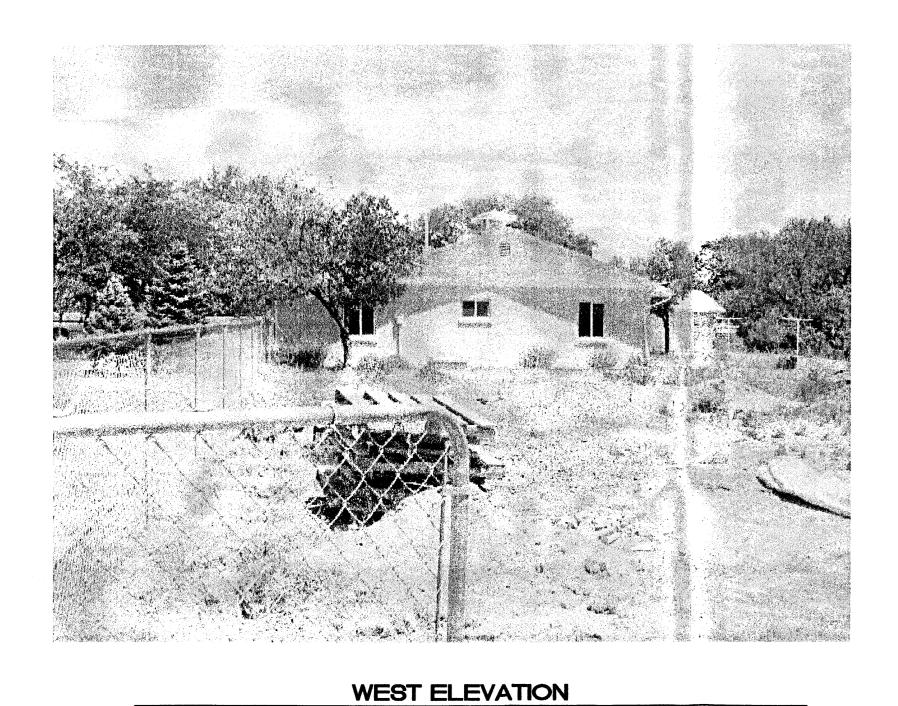



SCALE: 1"=10'

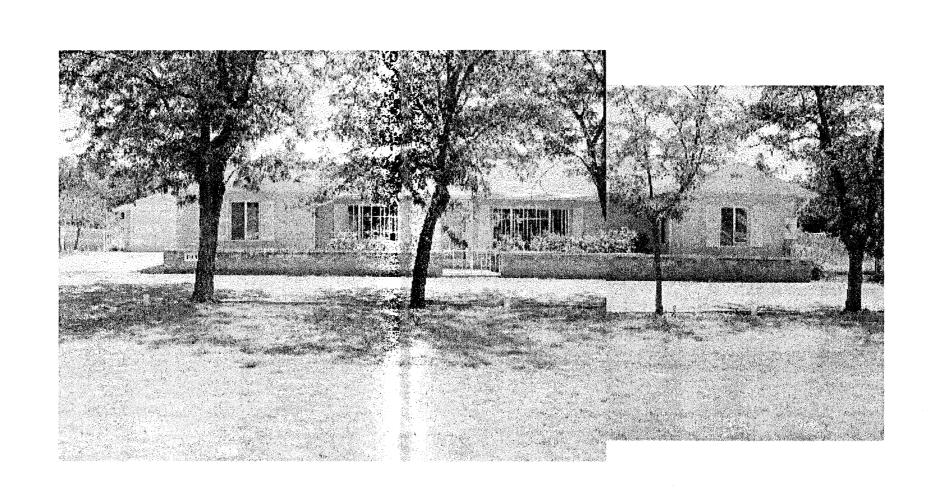



NORTH ELEVATION

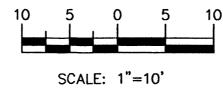


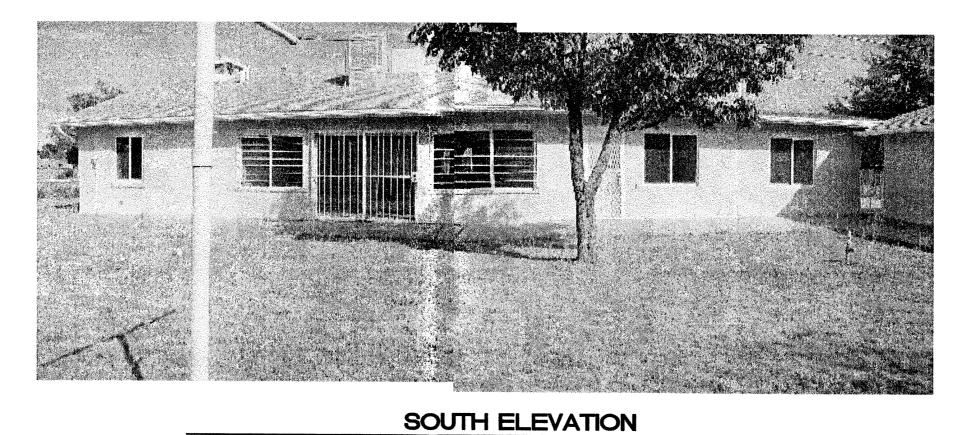


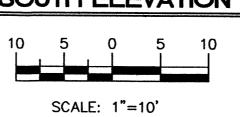

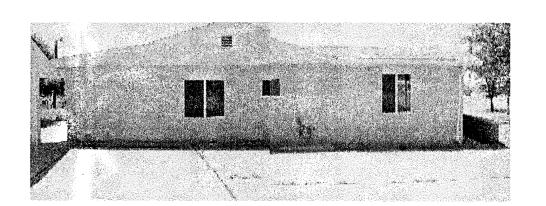


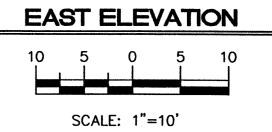

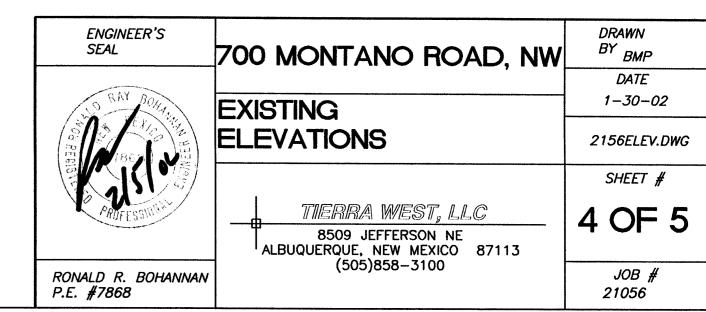


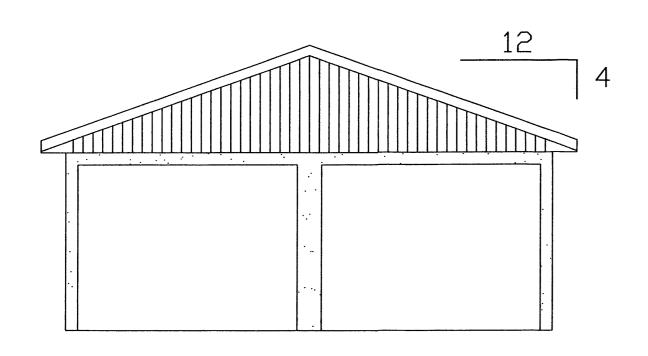



NORTH ELEVATION

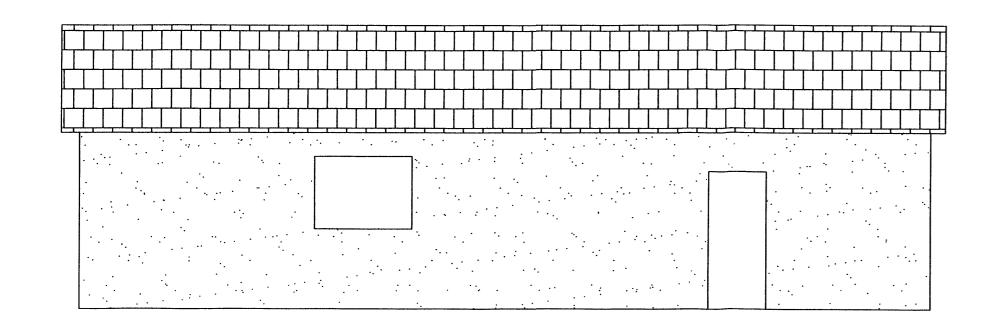



WEST ELEVATION

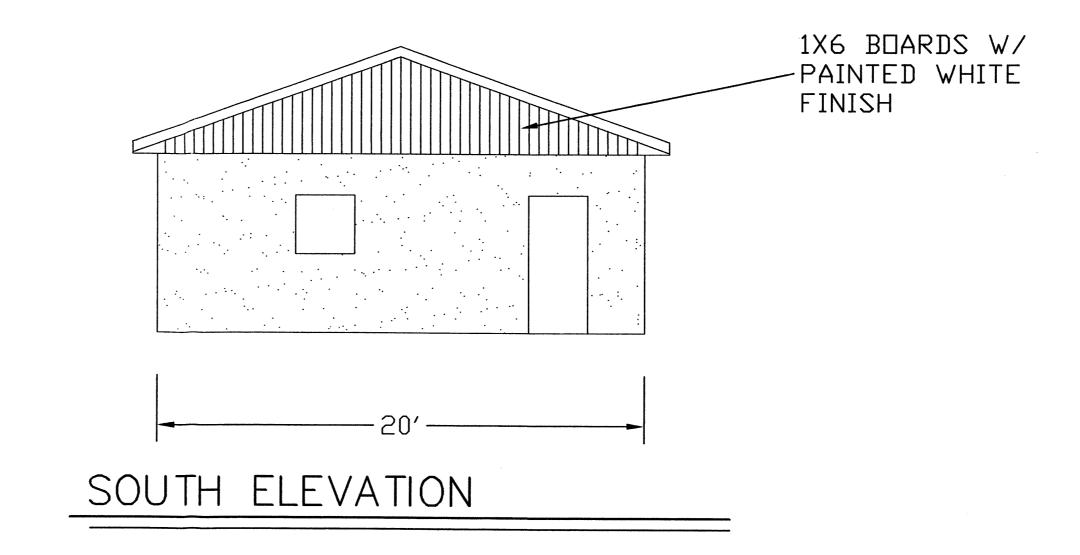

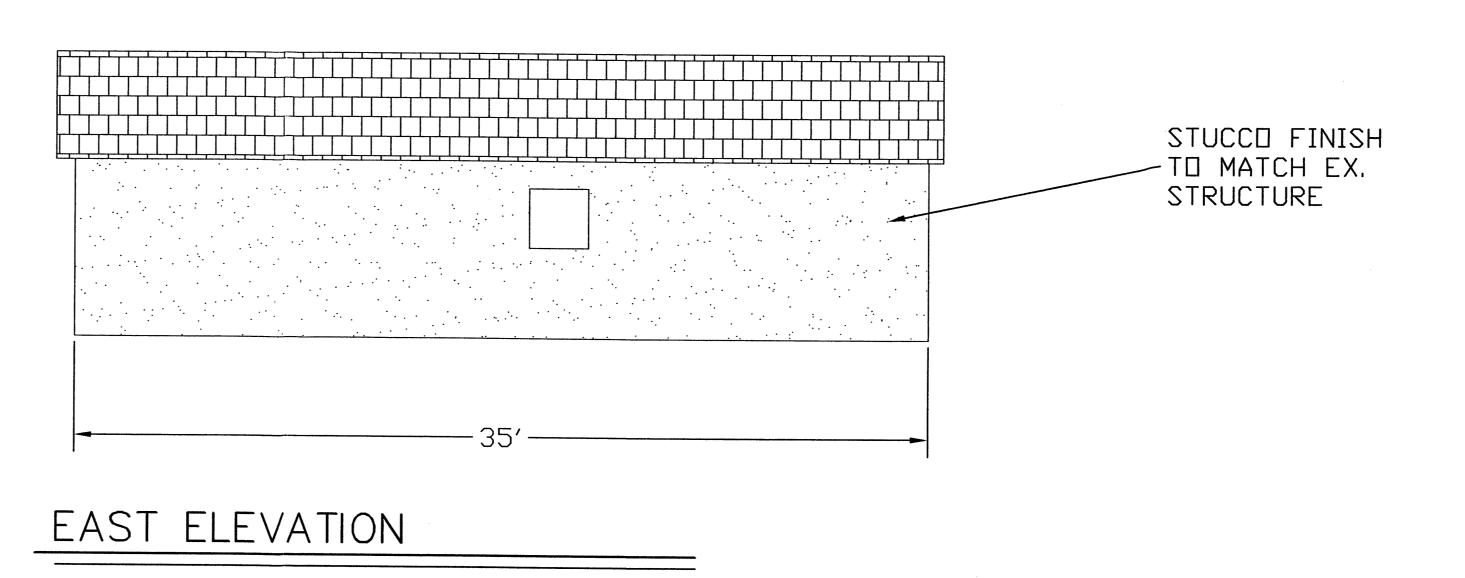


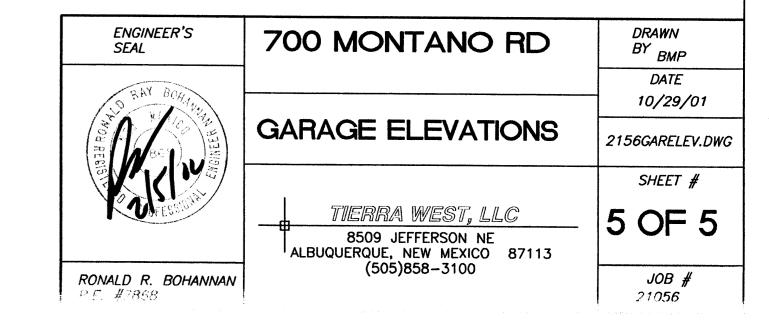


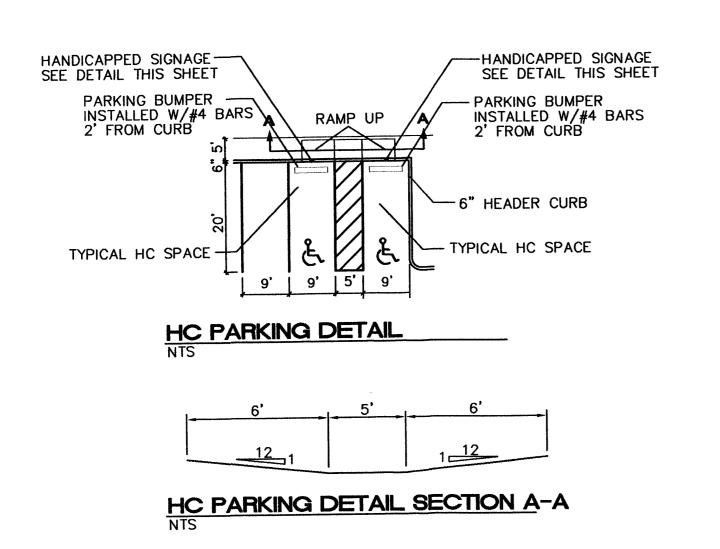


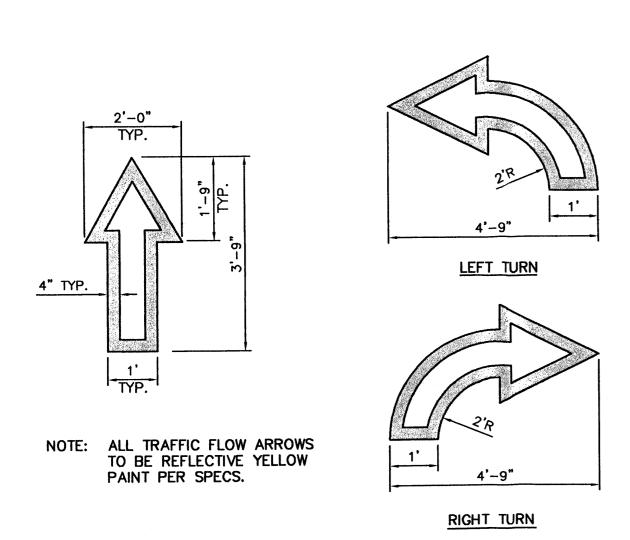



TRAFFIC ARROW DETAIL

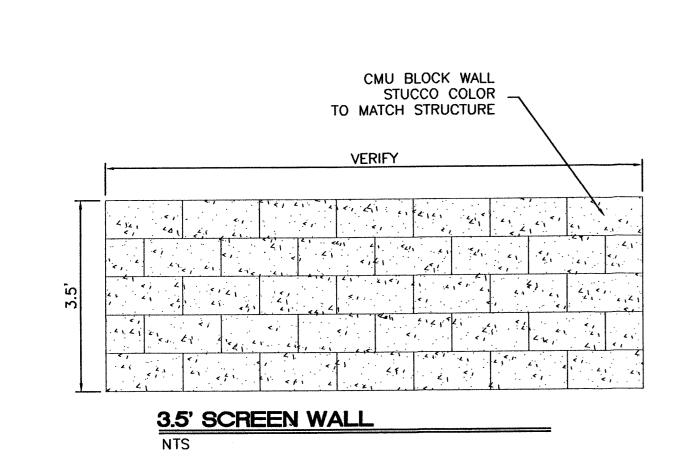

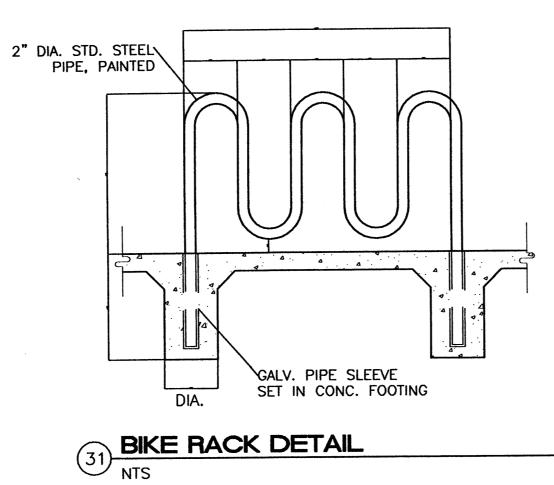


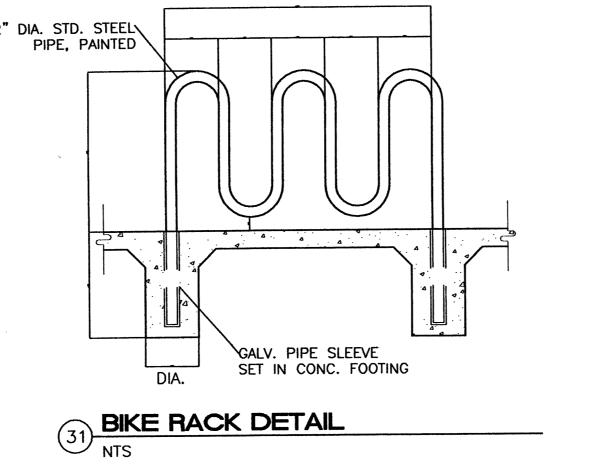


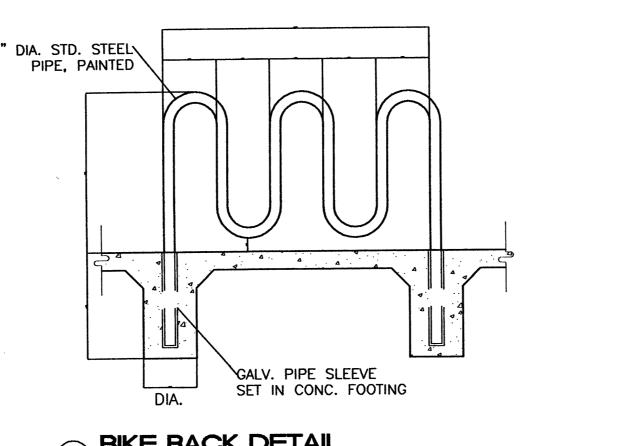

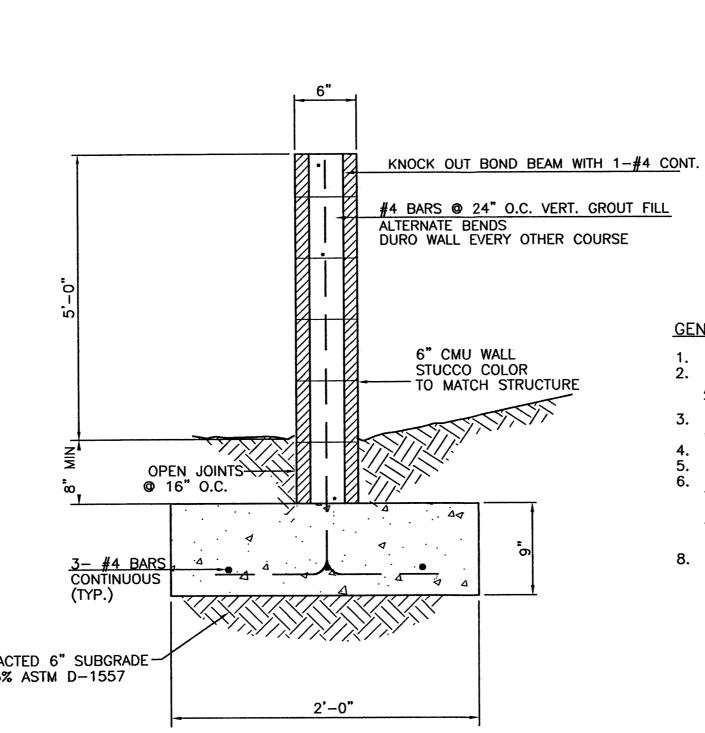


5' PERIMETER WALL SECTION
NTS

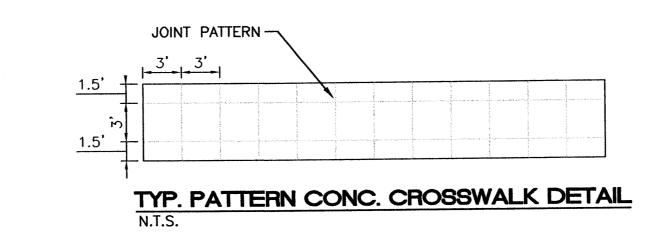


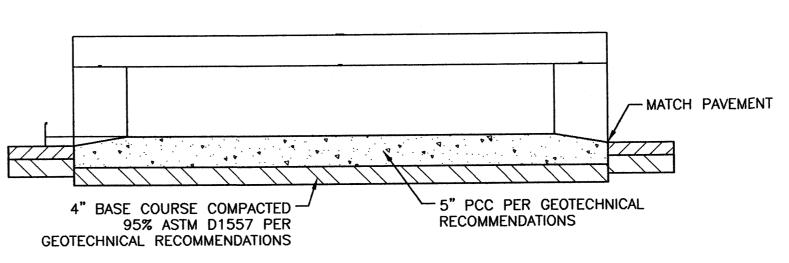

RAISED CROSSWALK


NTS

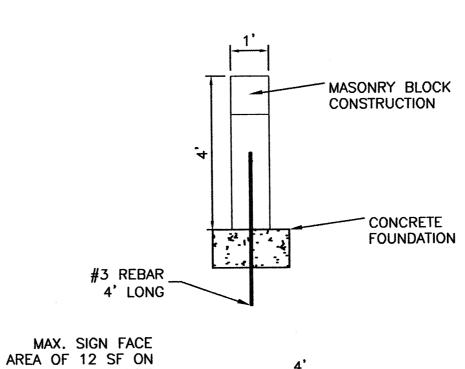


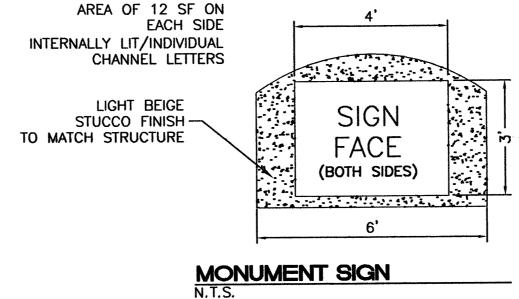

GENERAL NOTES:

- ALL CONCRETE IS TO BE 3000 PSI @ 28 DAYS. MINIMUM COMPACTION UNDER FOOTINGS IS TO BE 95% PER ASTM. D 1557 FOR A DEPTH OF 12" MOISTURE CONTENT IS TO BE \pm 2.0%.
- 3. BACK FILL AGAINST WALLS IS TO BE HAND-PLACED AND COMPACTED.
- 4. ALL BARS ARE TO BE GRADE 60, ASTM 615.
 5. TRUSS TYPE DUR-O-WALL EVERY OTHER COURSE.
 6. DOWELS SHALL BE AT LEAST EQUAL IN SIZE AND SPACING TO V-BARS, SHALL PROJECT A MINIMUM OF 30 BAR DIA. INTO THE FILLED BLOCK CORES, AND SHALL EXTEND TO THE TOE OF THE FOOTING.
- 8. USE EITHER EXPANSION JOINTS ON 20' CENTERS OR PILASTERS EVERY 16'.

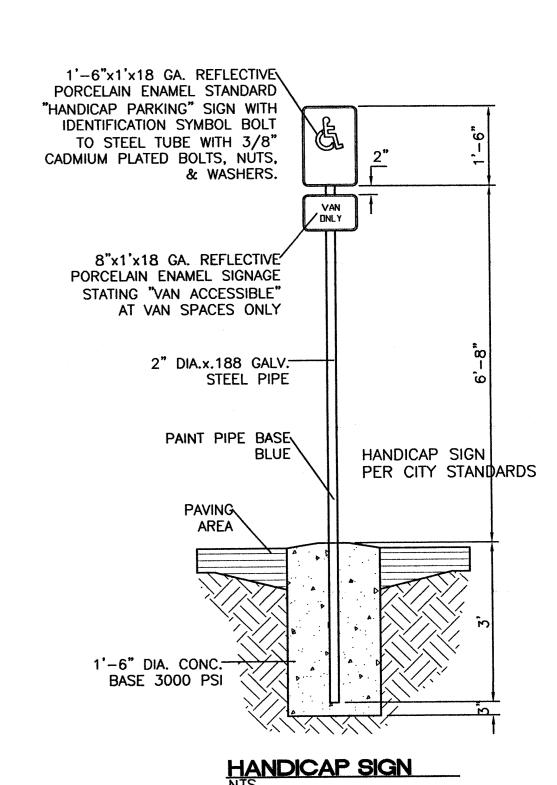

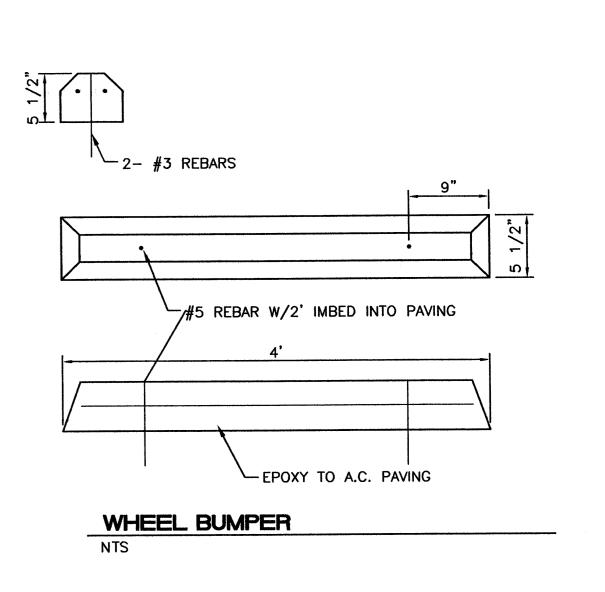

ENGINEER'S SEAL	700 MONTANO RD.	DRAWN BY BMP
DETAIL SHEET TIERRA WEST, LLC 8509 JEFFERSON NE ALBUQUERQUE, NEW MEXICO 87113 (505)858-3100 NALD R. BOHANNAN E. #7868		DATE 01/07/02
	DETAIL SHEET	2156.DWG
		SHEET #
	8509 JEFFERSON NE	5A
	JOB # 21056	

