



- 1. ALL WORK DETAILED ON THESE PLANS AND PERFORMED UNDER THIS CONTRACT SHALL BE CONSTRUCTED IN ACCORDANCE WITH THE PROJECT SPECIFICATIONS AND THE PROJECT GEOTECHNICAL REPORT. WHERE APPLICABLE, CITY OF
- 2. THE CONTRACTOR SHALL ABIDE BY ALL LOCAL, STATE, AND FEDERAL LAWS, RULES AND REGULATIONS WHICH APPLY TO THE CONSTRUCTION OF THESE IMPROVEMENTS, INCLUDING EPA REQUIREMENTS WITH RESPECT TO STORM WATER
- 3. PRIOR TO CONSTRUCTION, THE CONTRACTOR SHALL FIELD VERIFY THE HORIZONTAL AND VERTICAL LOCATIONS OF ALL POTENTIAL OBSTRUCTIONS INCLUDING ALL UNDERGROUND UTILITIES. SHOULD A CONFLICT EXIST, THE CONTRACTOR SHALL NOTIFY THE CONSTRUCTION OBSERVER OR ENGINEER SO THAT THE CONFLICT CAN BE RESOLVED WITH A MINIMUM AMOUNT
- 4. TWO (2) WORKING DAYS PRIOR TO ANY EXCAVATION, THE CONTRACTOR SHALL CONTACT LINE LOCATING SERVICE FOR
- 5. ALL ELECTRICAL, TELEPHONE, CABLE TV, GAS AND OTHER UTILITY LINES, CABLES, AND APPURTENANCES ENCOUNTERED DURING CONSTRUCTION THAT REQUIRE RELOCATION, SHALL BE COORDINATED WITH THAT UTILITY. THE CONTRACTOR SHALL BE RESPONSIBLE FOR COORDINATION OF ALL NECESSARY UTILITY ADJUSTMENTS. NO ADDITIONAL COMPENSATION WILL BE ALLOWED FOR DELAYS OR INCONVENIENCES CAUSED BY UTILITY COMPANY WORK CREWS. THE CONTRACTOR MAY BE REQUIRED TO RESCHEDULE HIS ACTIVITIES TO ALLOW UTILITY CREWS TO PERFORM THEIR REQUIRED WORK.
- 6. THE CONTRACTOR IS RESPONSIBLE FOR PROTECTING ALL EXISTING UTILITY LINES WITHIN THE CONSTRUCTION AREA. ANY DAMAGE TO EXISTING FACILITIES CAUSED BY CONSTRUCTION ACTIVITY SHALL BE REPAIRED OR REPLACED AT THE CONTRACTOR'S EXPENSE AND APPROVED BY THE CONSTRUCTION OBSERVER.
- 7. CONSTRUCTION ACTIVITY SHALL BE LIMITED TO THE PROPERTY AND/OR PROJECT LIMITS. ANY DAMAGE TO ADJACENT PROPERTIES RESULTING FROM THE CONSTRUCTION PROCESS SHALL BE REPAIRED OR REPLACED AT THE CONTRACTOR'S
- 8. OVERNIGHT PARKING OF CONSTRUCTION EQUIPMENT SHALL NOT OBSTRUCT DRIVEWAYS OR DESIGNATED TRAFFIC LANES. THE CONTRACTOR SHALL NOT STORE ANY EQUIPMENT OR MATERIAL WITHIN THE PUBLIC RIGHT-OF-WAY.
- 9. THE CONTRACTOR SHALL OBTAIN ALL THE NECESSARY PERMITS FOR THE PROJECT PRIOR TO COMMENCING CONSTRUCTION (I.E., BARRICADING, TOPSOIL DISTURBANCE, EXCAVATION PERMITS, EPA STORM WATER PERMITS, ETC.).
- 10. ALL PROPERTY CORNERS DESTROYED DURING CONSTRUCTION SHALL BE REPLACED AT THE CONTRACTOR'S EXPENSE. ALL PROPERTY CORNERS MUST BE RESET BY A REGISTERED LAND SURVEYOR.
- 11. THE CONTRACTOR SHALL PREPARE A CONSTRUCTION TRAFFIC CONTROL AND SIGNING PLAN AND OBTAIN APPROVAL OF SUCH PLAN FROM THE ADJACENT PROPERTY OWNER PRIOR TO BEGINNING ANY CONSTRUCTION WORK ON OR ADJACENT
- 12. ALL BARRICADES AND CONSTRUCTION SIGNING SHALL CONFORM TO APPLICABLE SECTIONS OF THE "MANUAL ON UNIFORM TRAFFIC CONTROL DEVICES" (MUTCD), US DEPARTMENT OF TRANSPORTATION, LATEST EDITION.
- 13. THE CONTRACTOR SHALL MAINTAIN ALL CONSTRUCTION BARRICADES AND SIGNING AT ALL TIMES. THE CONTRACTOR SHALL VERIFY THE PROPER LOCATION OF ALL BARRICADING AT THE END AND BEGINNING OF EACH DAY.
- 14. THE CONTRACTOR SHALL TAKE ALL STEPS NECESSARY TO CONFORM WITH EPA REQUIREMENTS, INCLUDING COMPLIANCE WITH NPDES PHASE 2 REQUIREMENTS.

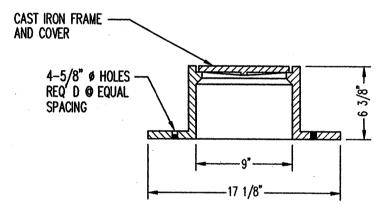

<u>CLEANOUT</u> FRAME & COVER

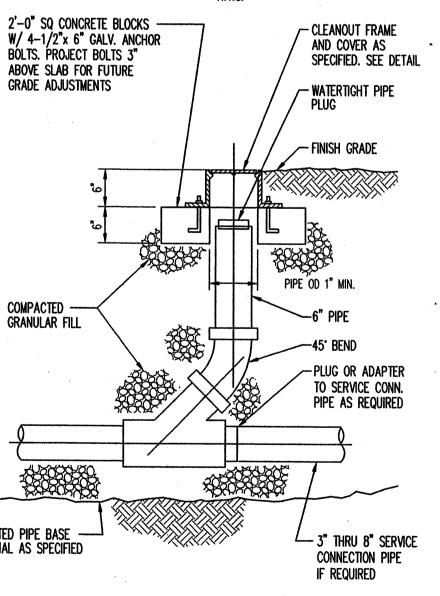

CLEANOUT

UTILITY NOTES

- 1. THE CONTRACTOR SHALL BE RESPONSIBLE FOR THE COMPLETE INSTALLATION OF ALL WORK RELATED TO MECHANICAL UTILITIES AS SHOWN ON THIS PLAN INCLUDING: TRENCHING, BACKFILL, SUPPORTS, CLEANOUT PADS, SERVICE STOPS AND BOXES, SERVICE LINES, TESTING, CLEANING, AND STERILIZING. ANY WORK NOT ACCEPTED BY THE ARCHITECT OR ENGINEER DUE TO IMPROPER WORKMANSHIP OR LACK OF PROPER COORDINATION SHALL BE REMOVED AND CORRECTLY INSTALLED AT THE CONTRACTOR'S EXPENSE, AS DIRECTED.
- 2. MINIMUM DEPTHS OF COVER SHALL BE: 36" FOR WATERLINES AND 48" FOR SEWER, EXCEPT AT BUILDING CONNECTION.
- 3. ALL WORK DETAILED ON THESE PLANS TO BE PERFORMED UNDER CONTRACT SHALL, EXCEPT AS OTHERWISE STATED OR PROVIDED OF HEREON, BE CONSTRUCTED IN ACCORDANCE WITH THE IAPMO UNIFORM PLUMBING CODE, LATEST EDITION.
- 4. UTILITY LINES SHALL BE INSTALLED PRIOR TO PAVEMENT, CURB AND GUTTER, AND/OR SIDEWALK, AS APPLICABLE.
- 5. ROUGH GRADING OF SITE (±0.5') SHALL BE COMPLETED PRIOR TO INSTALLATION OF UTILITY LINES.
- 6. CONTRACTOR WILL BE RESPONSIBLE FOR CONNECTIONS TO BUILDING DRAIN LINES AND ALL NECESSARY FITTINGS.
- 7. ALL VALVES SHALL BE ANCHORED PER COA STANDARD DWG. 2333.
- 8. FIRE LINES SHALL USE PIPE MATERIALS UNDERWRITERS LABORATORIES LISTED AND APPROVED FOR FIRE SERVICE.
- 9. CONTRACTOR SHALL BE RESPONSIBLE FOR ALL WATER METER, FIRE LINE, AND SEWER HOOKUP FEES FOR INSTALLATIONS. CONTRACTOR SHALL BE RESPONSIBLE FOR UTILITY EXPANSION CHARGES, PRORATA AND OTHER SPECIAL ASSESSMENTS.
- 10. CONTRACTOR SHALL VERIFY INVERTS AND LOCATIONS OF EXISTING WATER/SAS LINES PRIOR TO BEGINNING WORK. ALL CONFLICTS SHALL BE BROUGHT TO ATTENTION OF THE ENGINEER AND RESOLVED PRIOR TO BEGINNING
- 11. CONTRACTOR SHALL PREPARE ALL SUBMITTAL MATERIALS & PAY APPLICABLE FEES REQUIRED TO OBTAIN THE "MINI WORK ORDER" REQUIRED FOR CONNECTION TO THE EXISTING CITY WATER MAIN AND OTHER 'PUBLIC' WATER LINE CONSTRUCTION.

○ WATERLINE KEYED NOTES

- INSTALL 2" METERED DOMESTIC WATER SERVICE AS PER COA STD DWG 2363. CONTRACTOR SHALL PAY ALL CITY FEES ASSOCIATED WITH WATER SERVICE INSTALLATION. (SEE UTILITY NOTE #11)
- 2. INSTALL 1" METERED IRRIGATION WATER SERVICE AS PER COA STD DWG 2362. CONTRACTOR SHALL PAY ALL CITY FEES ASSOCIATED WITH WATER SERVICE INSTALLATION. VERIFY METER SIZE BACKFLOW PREVENTER INSTALLATION WITH LANDSCAPE/IRRIGATION PLANS. (SEE UTILITY NOTE #11). WALGREEN'S REQUIRES SEPARATE METER LOCATED INSIDE BUILDING (SEE PLUMBING PLANS).
- REFERENCE MEP PLANS FOR CONTINUATION OF 2" WATER LINE.
- 4. INSTALL 8": 8" TEE AND 8" GATE VALVE. GATE VALVE PER COA STD DWGS 2326 & 2328. (SEE UTILITY NOTE #11)
- 5. INSTALL 8" 45' BEND WITH BLOCKING.
- 6. INSTALL 8"x6" TEE, 6" GATE VALVE, FIRE HYDRANT, AND 8"x6" REDUCER PER COA STD DWGS. FH PER COA STD DWG 2340, WITH 4 FT BURY AND FULLY RESTRAINED. (SEE UTILITY NOTE #11)
- 7. INSTALL NEW 8" GATE VALVE ON EXISTING 8" WATER LINE. (SEE UTILITY NOTE #11)
- 8. REFERENCE MEP PLANS FOR CONTINUATION OF 6" FIRE LINE. BACKFLOW PREVENTION INSIDE BUILDING.
- 9. SAWCUT, REMOVE, AND REPLACE EXISTING PAVEMENT TO MEET OR EXCEED EXISTING CONDITIONS.

☐ SANITARY SEWER KEYED NOTES

- 1. TIE PROPOSED 6" SANITARY SEWER SERVICE INTO EXISTING 8" SANITARY SEWER LINE. INV=5212.00±.
- 2. INSTALL WYE AND CLEANOUT (SEE DETAIL THIS SHEET). INV=5212.69.
- INSTALL WYE AND CLEANOUT (SEE DETAIL THIS SHEET). INV=5216.23.
- 4. SEE MEP PLANS FOR CONTINUATION OF 6" SANITARY SEWER SERVICE. INV=5219.00± (VERIFY WITH MEP PLANS PRIOR TO CONSTRUCTION).

- UNDERGROUND ELECTRICAL SERVICE. REFER TO MECHANICAL, ELECTRICAL, OR PLUMBING (MEP) PLANS.
- 2. PAD MOUNTED TRANSFORMER AND METER PER LOCAL UTILITY COMPANY DESIGN STANDARDS. REFER TO MEP PLANS.
- UNDERGROUND TELEPHONE SERVICE. REFER TO MEP PLANS.
- 4. PROPOSED GAS SERVICE. REFER TO MEP PLANS.



ENGINEERING & SPATIAL DATA & ADVANCED TECHNOLOGIES

Walgreens

FACILITIES PLANNING AND DESIGN 200 WILMOT ROAD 708-940-2500

PROJECT TYPE

DRAWINGS/SPECIFICATIONS BY: ■ WALGREENS' CONSULTANT

LANDLORD'S CONSULTANT ALL CONSTRUCTION WORK, UNLESS NOTED OTHERWISE, BY:

☐ WALGREENS' CONTRACTOR

LANDLORDS'S CONTRACTOR (TURNKEY CONSTRUCTION) BUILDING


DEERFIELD, IL.

NEW SHELL ONLY ..

STORE REMODELING... EXISTING.... RELOCATION....

PROJECT INFOMATION

OTHERS.....

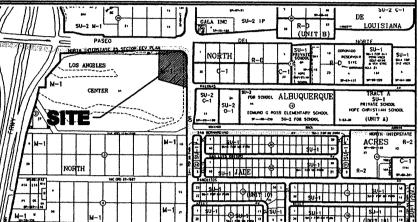

VICINITY MAP

LOS ANGELES CENTER, LOT A1, BLOCK 0000 6200 PASEO DEL NORTE NE

CITY OF ALBUQUERQUE PUBLIC WORKS DEPARTMENT

APPROVALS FOR:		NA	ME		D	ATE
DESIGN UTILITY DEVELO					,	
	RUCTION: RUCTION EER		-			
	TANCE: RUCTION CTOR			·		
City	Project No) .			• Мар —18	
8						
7						
6						
5						
4						

10/25/04 AOB UPDATED SITE/FORMAT 7/22/04 BJ ADD SITE INFO MPS | WIDEN DRIVE AISLSE TO 40' DESCRIPTION

REVISIONS

90/15/03

I HEREBY CERTIFY THAT THIS PLAN AND SPECIFI-

AM A DULY REGISTERED ARCHITECT OR ENGINEER

UNDER THE LAWS OF THE

STATE OF NEW MEXICO AS SIGNIFIED BY MY HAND

AND SEAL.

CATION WAS PREPARED B ME OR UNDER MY DIRECT SUPERVISION AND THAT I

NO. DATE

CERTIFICATION AND SEAL

CONST


PROJECT NAME **WALGREENS STORE** (SWC) SAN PEDRO AND PASEO DEL NORTE ALBUQUERQUE, NEW MEXICO

GEORGE RAINHART, ARCHITECT & ASSOCIATES P.C. 2325 SAN PEDRO NE., SUITE 2-B **ALBUQUERQUE, NEW MEXICO 87110** PHONE (505) 884-9110 FAX (505) 837-9877 www.gra-arch.com

> DRAWING TITLE **UTILITY PLAN**

DATE <u>02-15-05</u> STORE NO. SCALE: 1:30

DRAWING NO. RELEASED TO CONSTRUCTION:

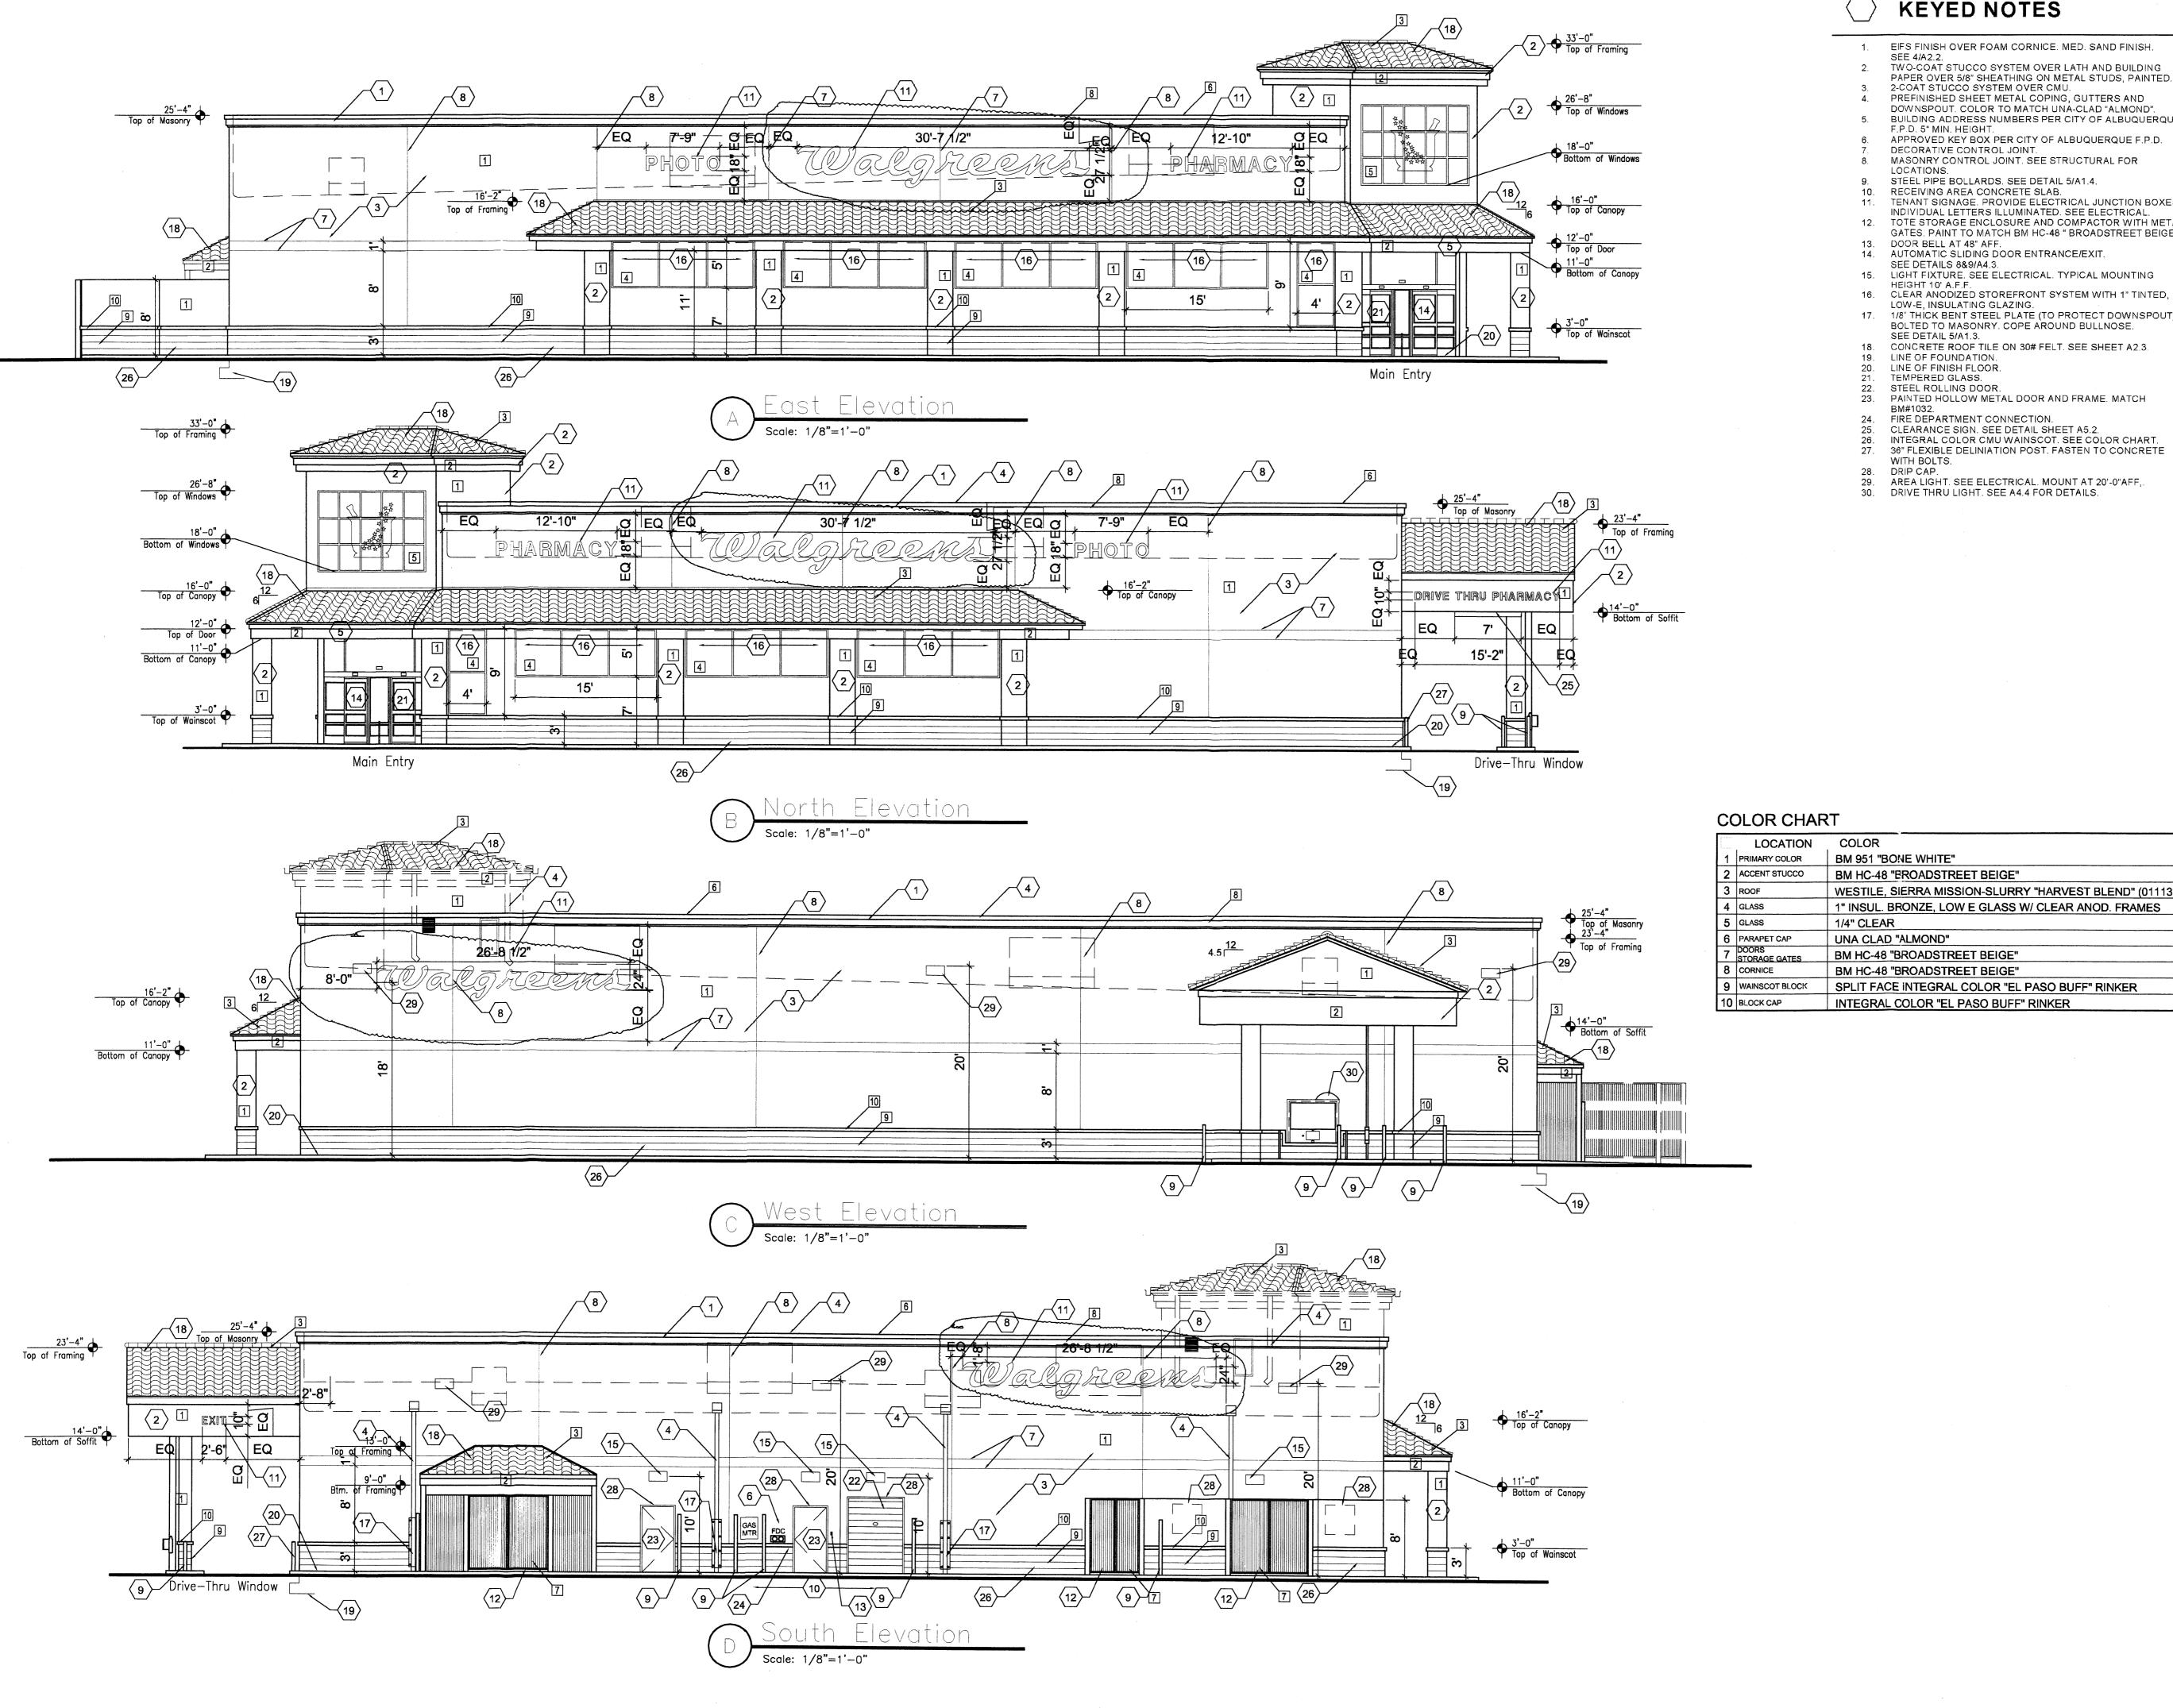

the state of the second st

KEYED NOTES

EIFS FINISH OVER FOAM CORNICE. MED. SAND FINISH. SEE 4/A2.2. TWO-COAT STUCCO SYSTEM OVER LATH AND BUILDING PAPER OVER 5/8" SHEATHING ON METAL STUDS, PAINTED. 2-COAT STUCCO SYSTEM OVER CMU. PREFINISHED SHEET METAL COPING, GUTTERS AND

DOWNSPOUT. COLOR TO MATCH UNA-CLAD "ALMOND". BUILDING ADDRESS NUMBERS PER CITY OF ALBUQUERQUE F.P.D. 5" MIN. HEIGHT.

APPROVED KEY BOX PER CITY OF ALBUQUERQUE F.P.D.
DECORATIVE CONTROL JOINT.
MASONRY CONTROL JOINT. SEE STRUCTURAL FOR LOCATIONS.

9. STEEL PIPE BOLLARDS. SEE DETAIL 5/A1.4.
10. RECEIVING AREA CONCRETE SLAB.
11. TENANT SIGNAGE. PROVIDE ELECTRICAL JUNCTION BOXES. INDIVIDUAL LETTERS ILLUMINATED. SEE ELECTRICAL. 12. TOTE STORAGE ENCLOSURE AND COMPACTOR WITH METAL GATES. PAINT TO MATCH BM HC-48 "BROADSTREET BEIGE". 13. DOOR BELL AT 48" AFF.

14. AUTOMATIC SLIDING DOOR ENTRANCE/EXIT. SEE DETAILS 8&9/A4.3.

15. LIGHT FIXTURE. SEE ELECTRICAL. TYPICAL MOUNTING HEIGHT 10' A.F.F.

LOW-E, INSULATING GLAZING. 1/8" THICK BENT STEEL PLATE (TO PROTECT DOWNSPOUT) BOLTED TO MASONRY. COPE AROUND BULLNOSE. SEE DETAIL 5/A1.3.

18. CONCRETE ROOF TILE ON 30# FELT. SEE SHEET A2.3. 19. LINE OF FOUNDATION.20. LINE OF FINISH FLOOR.

TEMPERED GLASS. STEEL ROLLING DOOR.

23. PAINTED HOLLOW METAL DOOR AND FRAME. MATCH BM#1032.

FIRE DEPARTMENT CONNECTION.

CLEARANCE SIGN. SEE DETAIL SHEET A5.2.
INTEGRAL COLOR CMU WAINSCOT. SEE COLOR CHART.
36" FLEXIBLE DELINIATION POST. FASTEN TO CONCRETE WITH BOLTS.

28. DRIP CAP.
29. AREA LIGHT. SEE ELECTRICAL. MOUNT AT 20'-0"AFF,.

30. DRIVE THRU LIGHT. SEE A4.4 FOR DETAILS.

	LOCATION	COLOR
1	PRIMARY COLOR	BM 951 "BONE WHITE"
2	ACCENT STUCCO	BM HC-48 "PROADSTREET BEIGE"
3	ROOF	WESTILE, SIERRA MISSION-SLURRY "HARVEST BLEND" (011133
4	GLASS	1" INSUL. BRONZE, LOW E GLASS W/ CLEAR ANOD. FRAMES
5	GLASS	1/4" CLEAR
6	PARAPET CAP	UNA CLAD "ALMOND"
7	DOORS STORAGE GATES	BM HC-48 "BROADSTREET BEIGE"
8	CORNICE	BM HC-48 "BROADSTREET BEIGE"
9	WAINSCOT BLOCK	SPLIT FACE INTEGRAL COLOR "EL PASO BUFF" RINKER
10	BLOCK CAP	INTEGRAL COLOR "EL PASO BUFF" RINKER

teletalea.

FACILITIES PLANNING AND DESIGN 200 WILMOT ROAD 708-940-2500

(TURNKEY CONSTRUCTION)

12.6 SF

2.1 SF

PROJECT TYPE

DRAWINGS/SPECIFICATIONS BY: □ WALGREENS' CONSULTANT

OTHERS....

LANDLORD'S CONSULTANT

ALL CONSTRUCTION WORK, UNLESS NOTED OTHERWISE, BY:

 □ WALGREENS' CONTRACTOR LANDLORDS'S CONTRACTOR

STORE BUILDING NEW ... REMODELING... EXISTING.... RELOCATION.... NEW SHELL ONLY ..

PROJECT INFOMATION

Wordgreens

EAST ELEVATION 30'-7 1/2""x 27 1/2" WALGREENS SCRIPT SIGN 18" PHARMACY 80.32 SF 19.20 SF 11.60 SF 18" PHOTO 111.12 SF SOUTH ELEVATION 26'-8 1/2" X 24" WALGREENS SCRIPT SIGN 55.79 SF NORTH ELEVATION 30'-7 1/2""x 27 1/2" WALGREENS SCRIPT SIGN 80.32 SF 18" PHARMACY 19.20 SF 18" PHOTO 11.60 SF 111.12 SF WEST ELEVATION 26'-8 1/2" X 24" WALGREENS SCRIPT SIGN 55.79 SF BUILDING TOTAL 333.82 SF UPPER CABINET 88.85 SF 23.11 SF LOWER CABINET 111.96 SF PYLON TOTAL 445.78 SF SIGNAGE TOTAL DIRECTIONAL SIGNS AT DRIVE THRU

WALGREENS: SEE SIGN ANALYSIS SHEET

10" DRIVE THRU PHARMACY 10" EXIT

SIGNAGE BY SEPARATE PERMIT

SIGN CODE SUMMARY ALBUQERQUE PERMIT OFFICIAL: NAME BUILDING SIGNAGE IS BASED ON A PERCENTAGE OF THE BUILDING FACE. SEE ATTACHED SIGN CODE SUMMARY.

8				
7				
6				
5				
4				
3				
2				
1	2/5/05	AOB	WALGREEN/CITY COMMENTS	
NO.	DATE	BY	DESCRIPTION	CONST

REVISIONS


CERTIFICATION AND SEAL

I HEREBY CERTIFY THAT THIS PLAN AND SPECIFI-CATION WAS PREPARED BY ME OR UNDER MY DIRECT SUPERVISION AND THAT I AM A DULY REGISTERED ARCHITECT OR ENGINEER UNDER THE LAWS OF THE

STATE OF NEW MEXICO AS SIGNIFIED BY MY HAND

AND SEAL.

REVIEWED

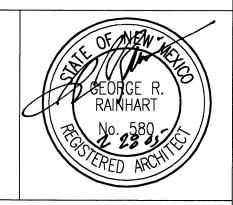

PROJECT NAME WALGREENS STORE (SWC) SAN PEDRO AND PASEO DEL NORTE ALBUQUERQUE, NEW MEXICO


GEORGE RAINHART, ARCHITECT & ASSOCIATES P.C. 2325 SAN PEDRO NE., SUITE 2-B ALBUQUERQUE, NEW MEXICO 87110 PHONE (505) 884-9110 FAX (505) 837-9877 www.gra-arch.com

> DRAWING TITLE **ELEVATIONS**

11/22/04 DATE STORE NO. DRAWING NO. SCALE: 1/8"=1'-0" DRAWN RELEASED TO

CONSTRUCTION:

GRAA#0339 JULY 2004

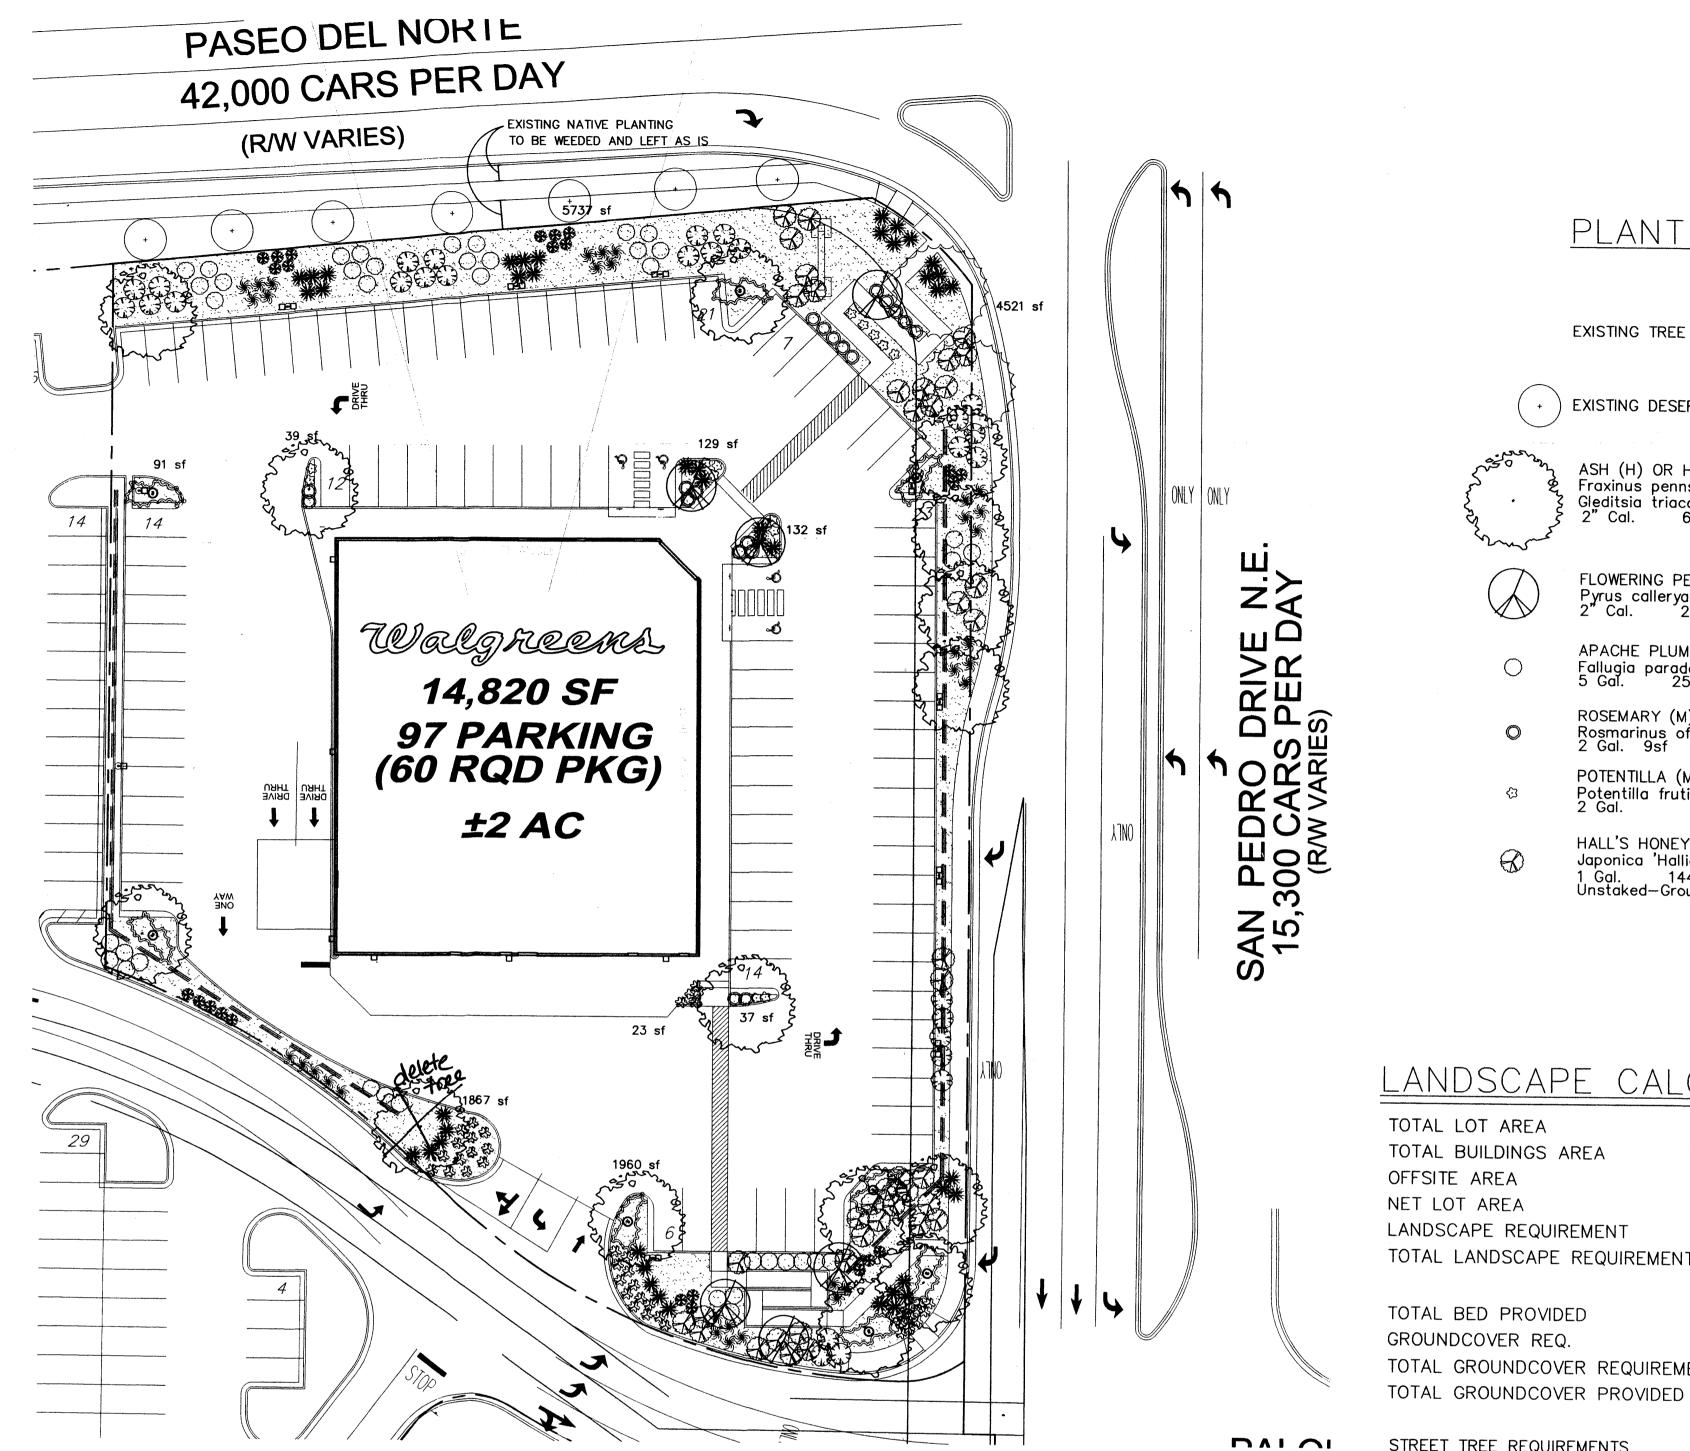

PLANT LEGEND

EXISTING TREE 2

 $\left(egin{array}{c} + \end{array}
ight)$ existing desert willow 7

ASH (H) OR HONEY LOCUST (M) 15 Fraxinus pennsylvanica Gleditsia triacanthos 2" Cal. 60' Tall , 60' Canopy

FLOWERING PEAR (M+) 6 Pyrus calleryana 2" Cal. 20—25' Tall , 10—15' Canopy

APACHE PLUME (L) 40 Fallugia paradoxa 5 Gal. 25sf

ROSEMARY (M) 20 Rosmarinus officianalis 2 Gal. 9sf

POTENTILLA (M) 18 Potentilla fruticosa 2 Gal.

HALL'S HONEYSUCKLE (M) 41 Japonica 'Halliana' 1 Gal. 144sf Unstaked—Groundcover

CHAMISA (L) 28

MAIDENGRASS (M) 33 Miscanthus sinènsis 5 Gal. 16sf

Muhlenbergia capillaris 5 Gal. 9sf

Stipa tennuisima 1 Gal. 4sf

RED YUCCA (L) 44 Hesperaloe parviflora 5 Gal. 9sf

Chrysothamnus nauseosus 1 Gal. 25sf

REGAL MIST (M) 24

THREADGRASS (M) 40

GREYLEAF COTONEASTER (M) 24 Cotoneaster buxifolius Symbol indicates 3 plants

NATURAL EDGE

3/4" GRAY GRAVEL WITH FILTER FABRIC

_ANDSCAPE CALCULATIONS

		-	
TOTAL LOT AREA	83169	square	feet
TOTAL BUILDINGS AREA	14820	square	
OFFSITE AREA	0	square	feet
NET LOT AREA	68349	square	
LANDSCAPE REQUIREMENT	15%	,	
TOTAL LANDSCAPE REQUIREMENT	10252	square	feet
		·	
TOTAL BED PROVIDED	14536	square	feet
GROUNDCOVER REQ.	75%	square	
TOTAL GROUNDCOVER REQUIREMENT	10902	sauare	

11100

square feet

STREET TREE REQUIREMENTS

Street trees required under the City Of Albuquerque Street Tree Ordinance are as follows:

Paseo del Norte Trees Required#7/Existing # 7

San Pedro Required#11/Existing # 2/Provided#9/Total#11

PARKING LOT TREE REQUIREMENTS

Parking Lot Trees required under the City Of Albuquerque Ordinance are as follows:

1 Shade Tree per 10 Spaces Trees Required#10/Trees Provided#10/Total#10



Cont. Lic. #26458 7909 Edith N.E. Albuquerque, NM 87184 Ph. (505) 898-9690 Fax (505) 898-7737 cmd@hilltoplandscaping.com All creative ideas contained Herein remains the property of The Hilltop Landscape Architects and Contractors and are protected by copyright laws. This is an original design and must not be released or copied unless applicable fees have been paid or job order

PROJECT NAME **WALGREENS STORE** (SWC) SAN PEDRO AND PASEO DEL NORTE ALBUQUERQUE, NEW MEXICO

DESCRIPTION

REVISIONS

CERTIFICATION AND SEAL

5

3

NO. DATE

I HEREBY CERTIFY THAT
THIS PLAN AND SPECIFICATION WAS PREPARED BY
ME OR UNDER MY DIRECT
SUPERVISION AND THAT I
AM A DULY REGISTERED
ARCHITECT OR ENGINEER
UNDER THE LAWS OF THE

STATE OF NEW MEXICO

AS SIGNIFIED BY MY HAND AND SEAL.

Walgreens

DEERFIELD, IL.

(TURNKEY CONSTRUCTION)

NEW SHELL ONLY ..

BUILDING

FACILITIES PLANNING AND DESIGN

PROJECT TYPE

ALL CONSTRUCTION WORK, UNLESS NOTED OTHERWISE, BY:

PROJECT INFOMATION

200 WILMOT ROAD

DRAWINGS/SPECIFICATIONS BY:

■ LANDLORD'S CONSULTANT

☐ WALGREENS' CONTRACTOR

LANDLORDS'S CONTRACTOR

STORE

REMODELING..

RELOCATION...

OTHERS.....

708-940-2500

GEORGE RAINHART, ARCHITECT & ASSOCIATES P.C. 2325 SAN PEDRO NE., SUITE 2-B ALBUQUERQUE, NEW MEXICO 87110 PHONE (505) 884-9110 FAX (505) 837-9877 www.gra-arch.com

DRAWING TITLE

LANDSCAPE PLAN 12-15-04 STORE NO. DATE DRAWING NO. DRAWN SCALE: 1:30 BY: RELEASED TO CONSTRUCTION: REVIEWED DWGS.

Plant beds shall achieve 75% live ground cover at maturity.

Gray Gravel over Filter Fabric shall be placed in all landscape areas as designated.

LANDSCAPE NOTES:

Landscape maintenance shall be the

responsibility of the Property Owner.

planting restriction approach.

It is the intent of this plan to comply with the City Of Albuquerque Water Conservation

Landscaping and Water Waste Ordinance

Approval of this plan does not constitute

of the Water Conservation Landscaping and

Water Waste Ordinance. Water management is the sole responsibility of the Property Owner.

or imply exemption from water waste provisions

All landscaping will be in conformance with the

Ordinance, Pollen Ordinance, and Water Conservation Landscaping and Water Waste Ordinance. In general,

water conservative, environmentally sound landscape principles will be followed in design and installation.

City of Albuquerque Zoning Code, Street Tree

GRAPHIC SCALE

SCALE: 1"=30"

