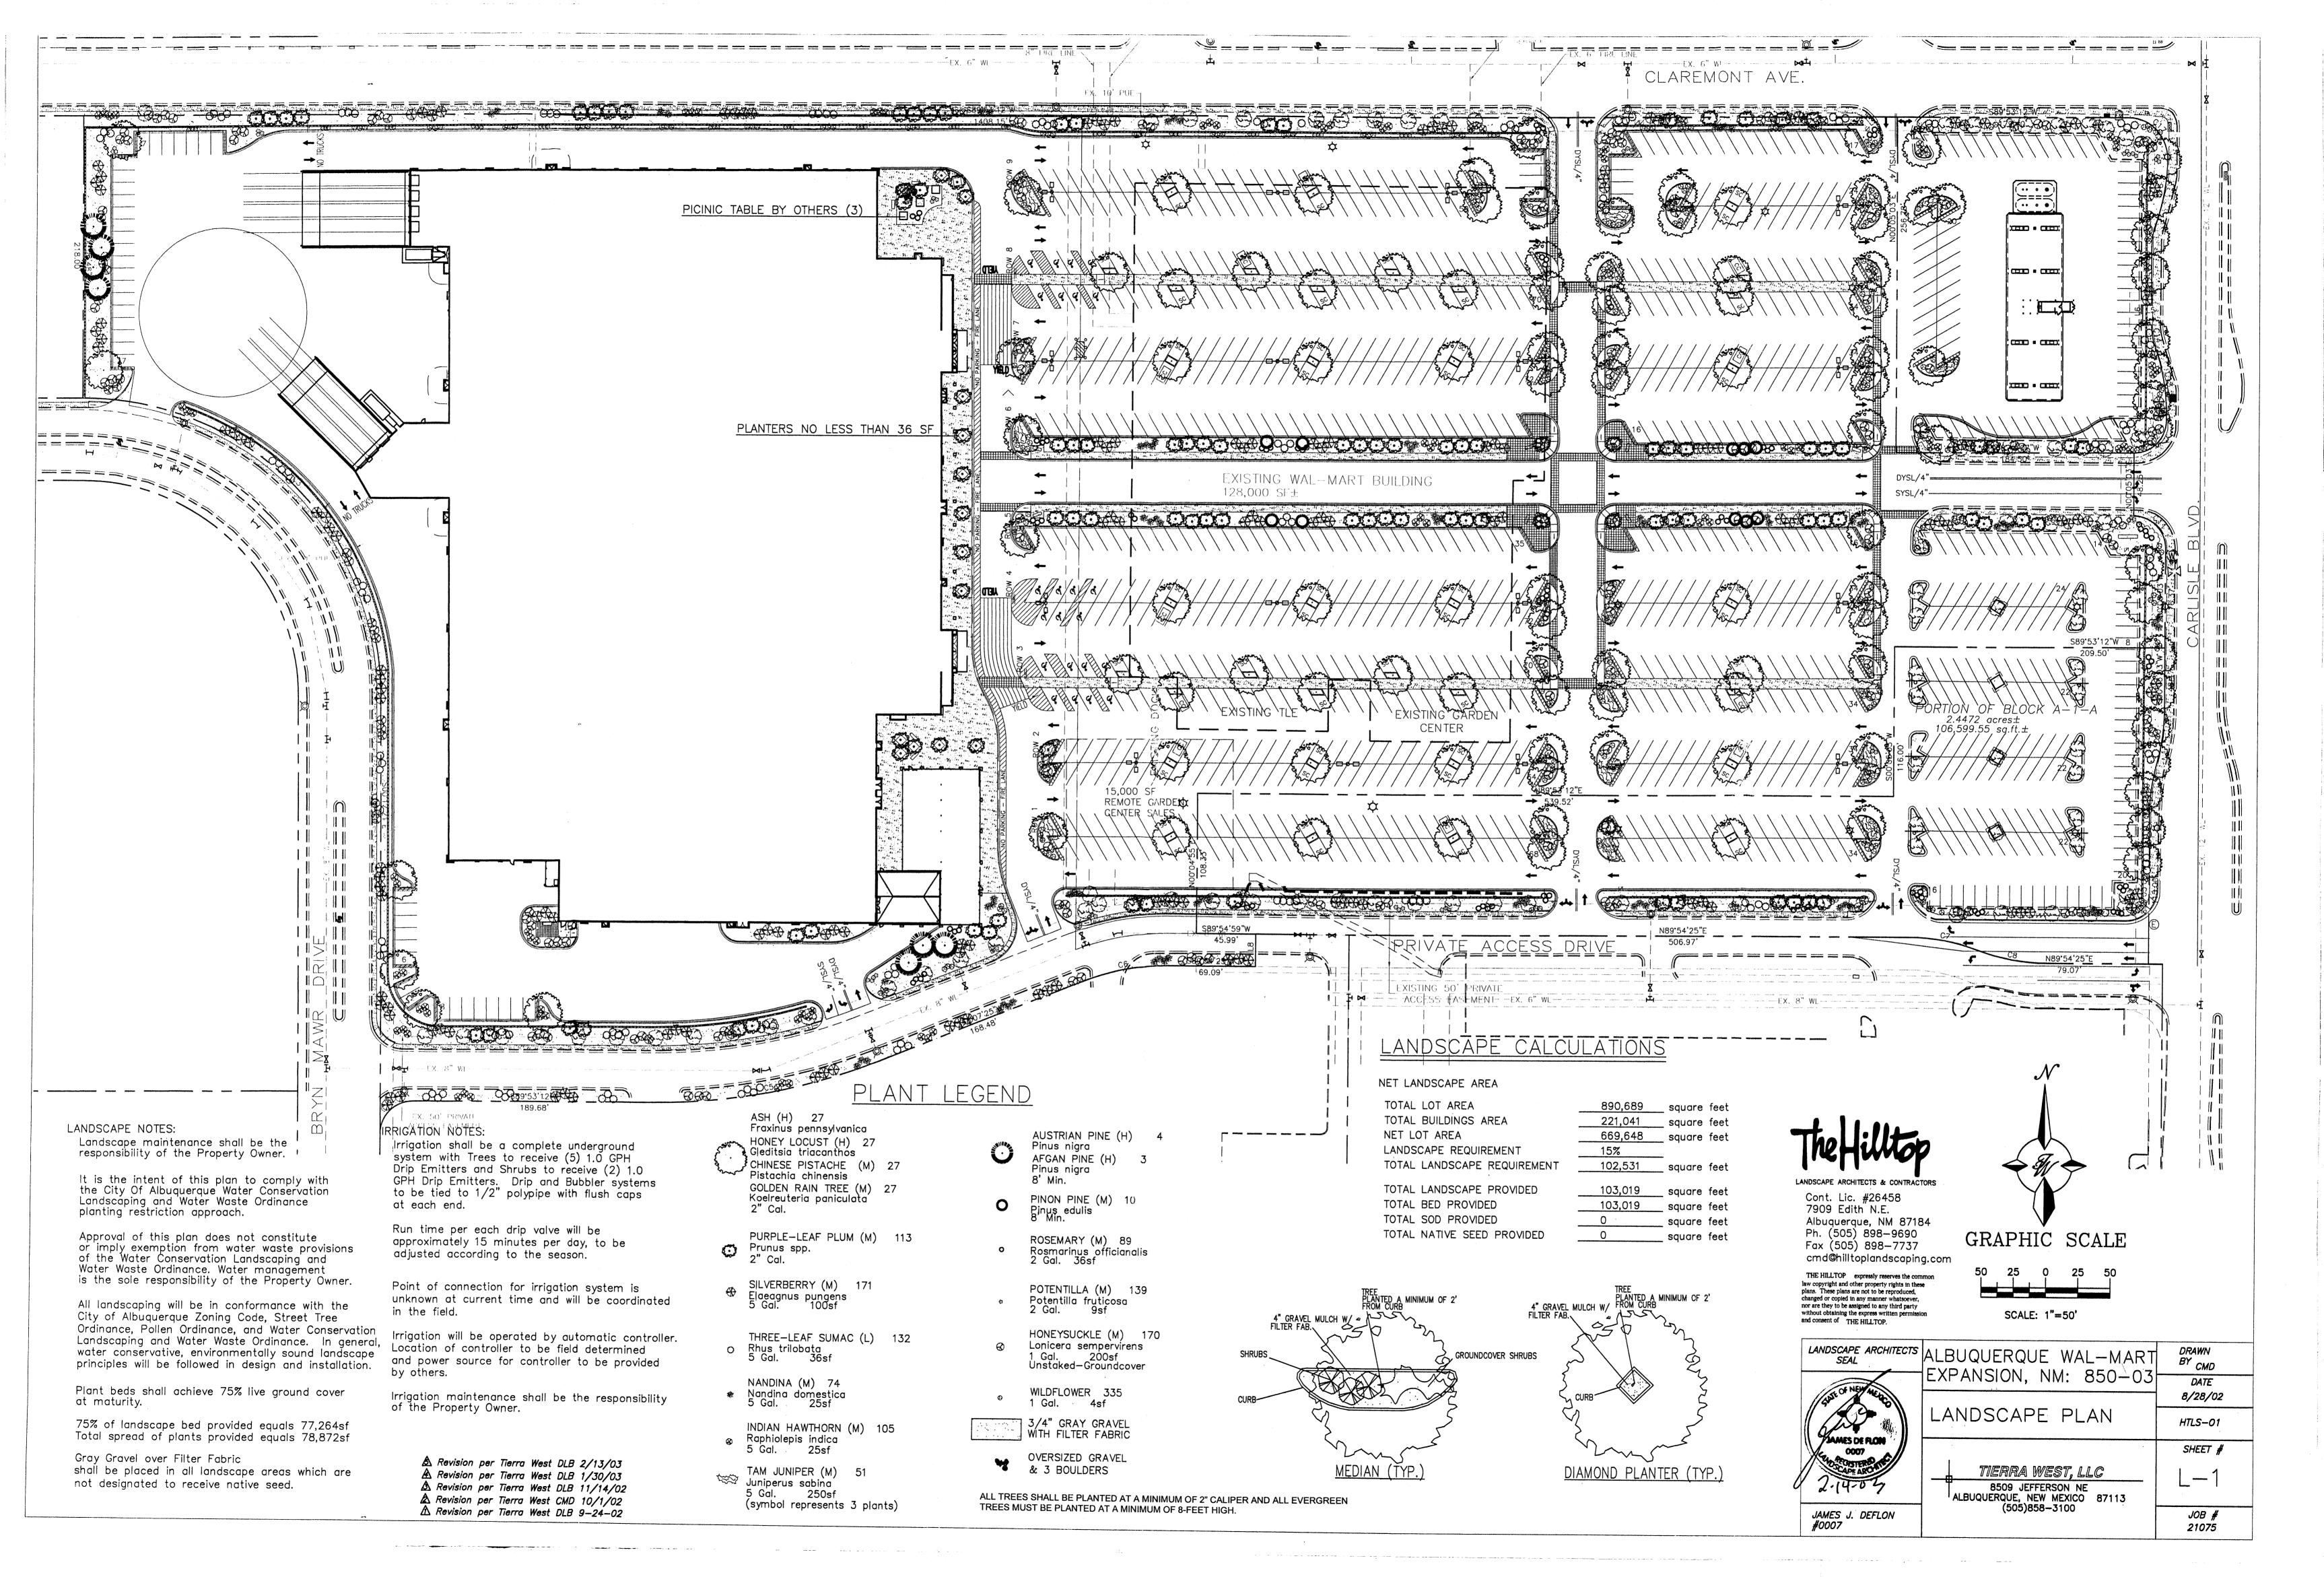
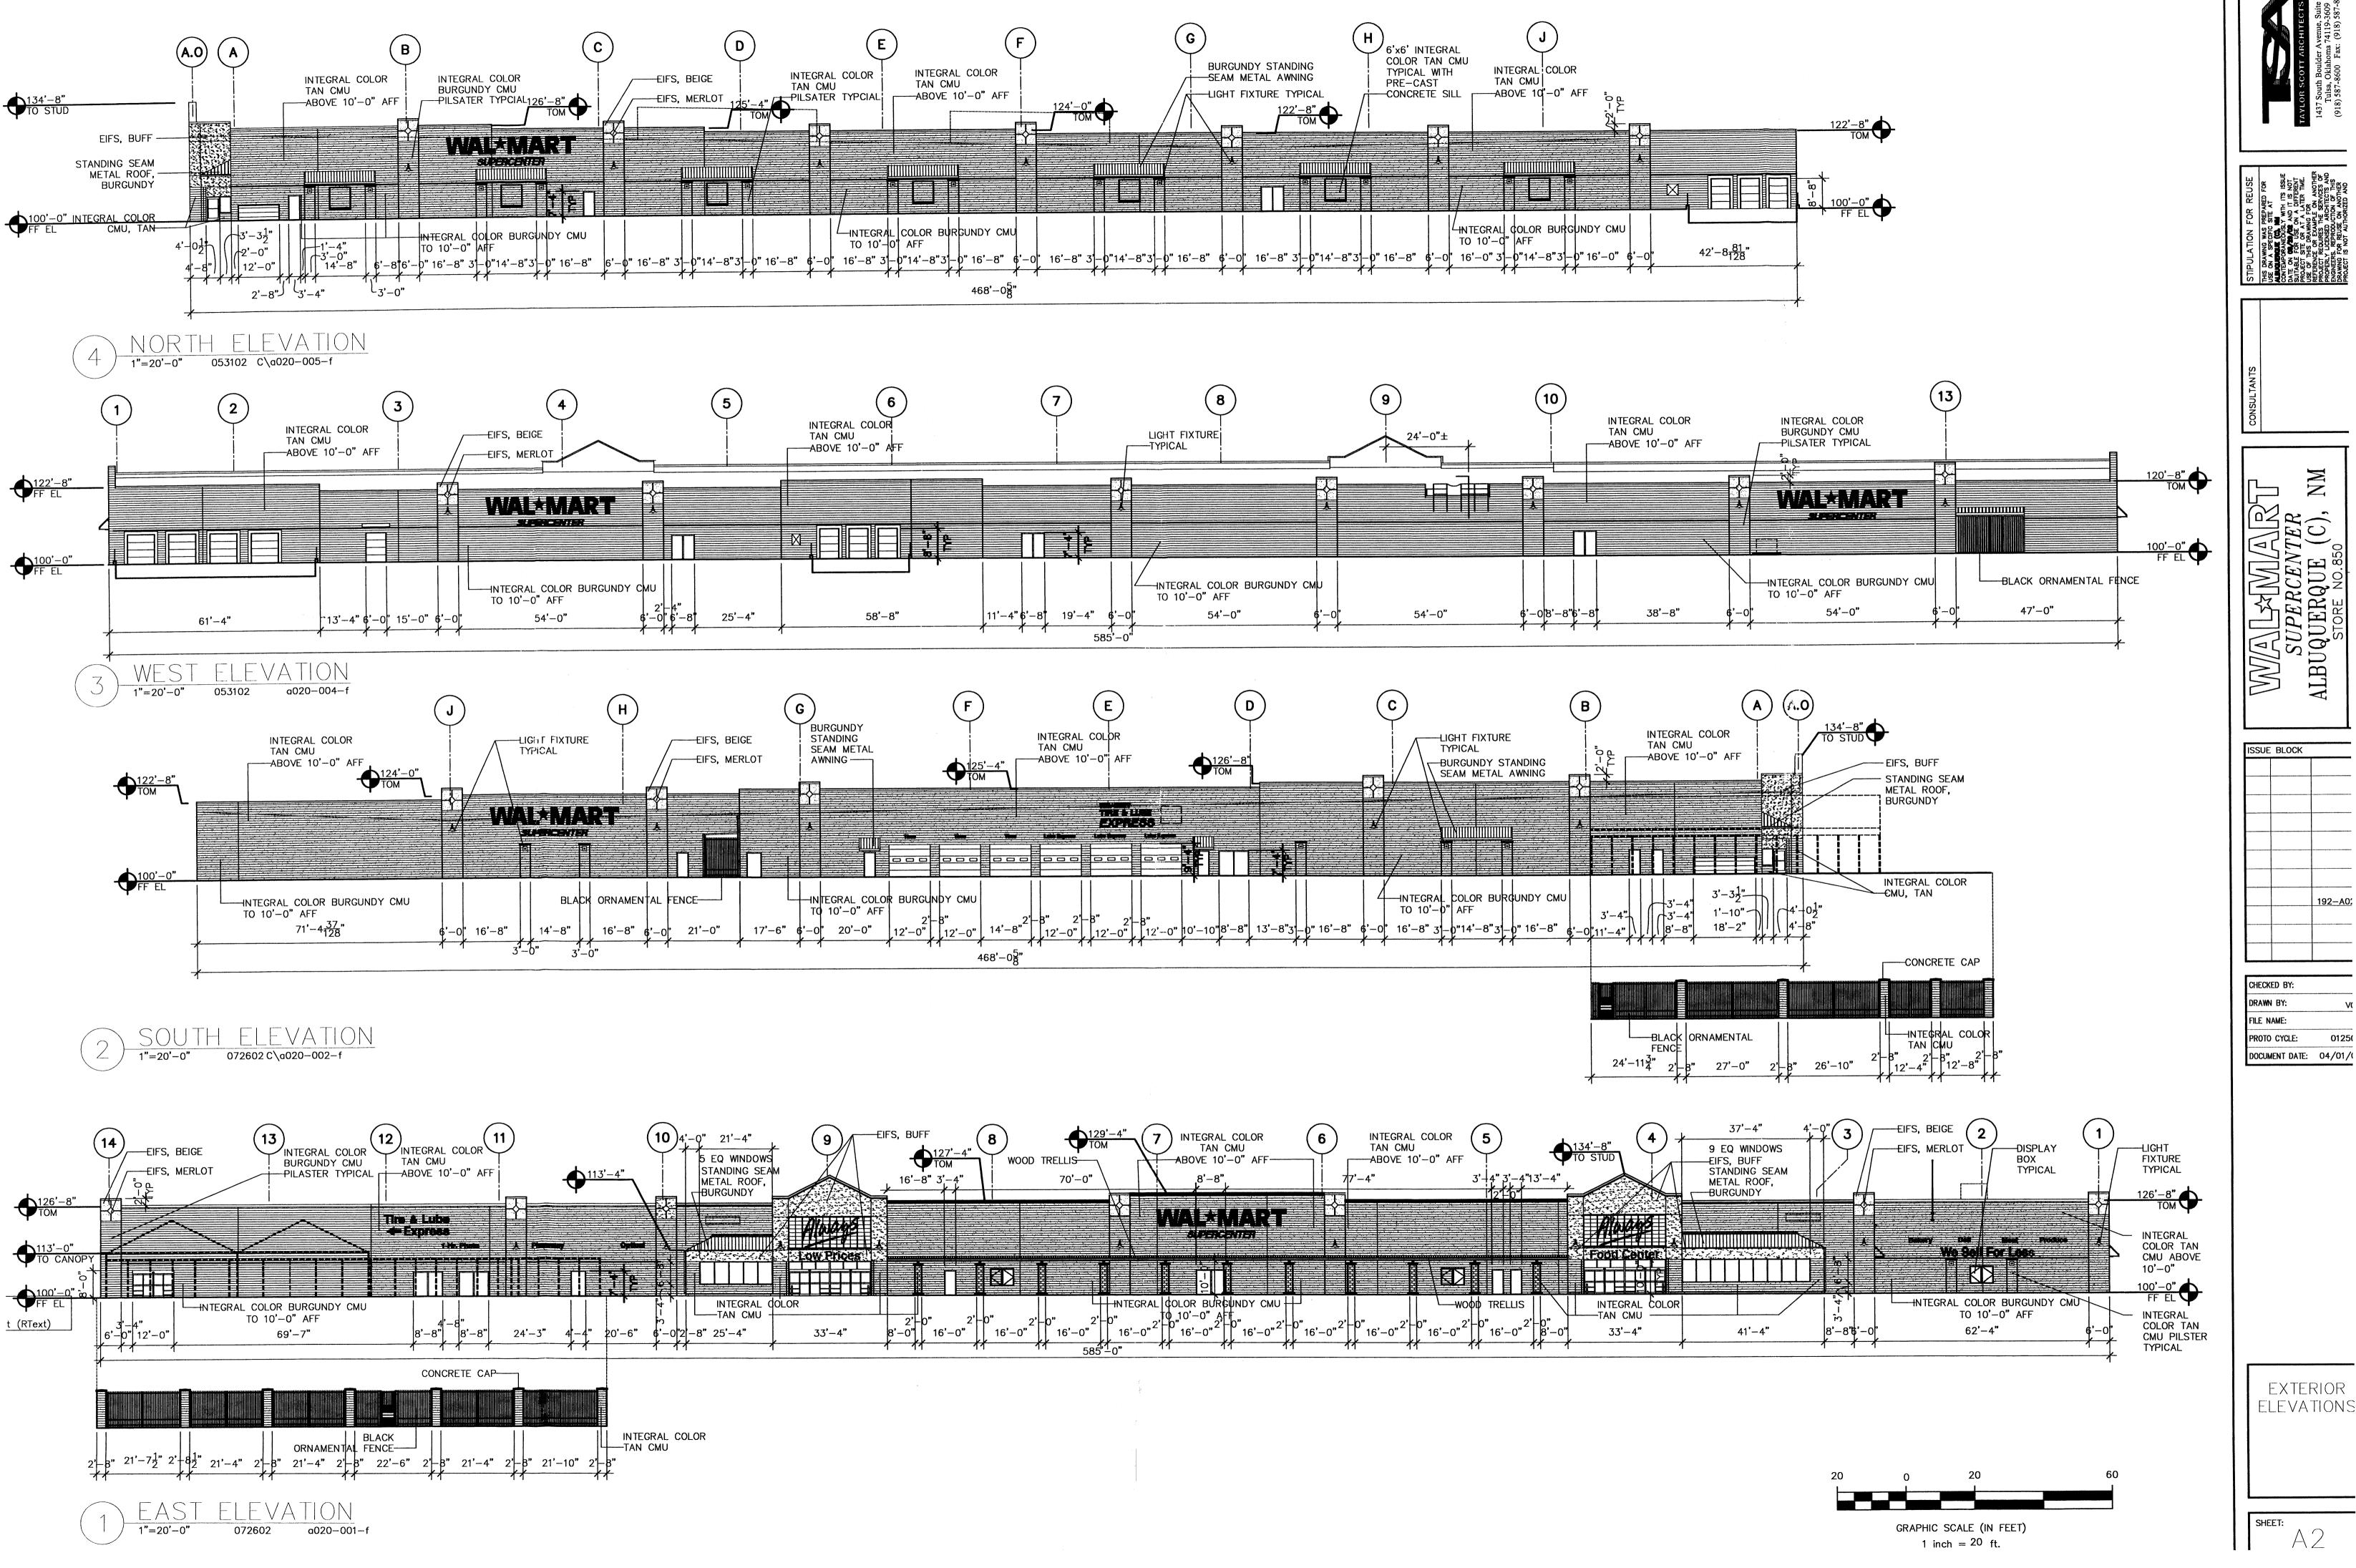


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192-A0:

Bakery


10.25 SQ. FT.

(17) SIGNAGE

ALL OTHERS: STA-TUFF ACRYLIC

				C	/A022-S	Ī
•	SIGNAGE S	SCHEDULE	Ξ			
FRONT SIGNAGE	QTY	COLOR	INDIVIDU AREA		TOTAL A	F
WAL*MART	5	RED	189	SF	945	-
SUPERCENTER	5	RED	39.17	SF	195.85	_
Always	2	RED	145.64	SF	291.28	_
Food Center	1	RED	50.47	SF	50.47	_
Low Prices	1	RED	44.38	SF	44.38	_
Produce	1	RED	11.88	SF	11.88	_
Meat	1	RED	6.84	SF	6.84	_
Deli	1	RED	5.30	SF	5.30	
Bakery	1	RED	10.25	SF	10.25	_
Optical	1	RED	10.26	SF	10.26	_
Pharmacy	1	RED	14.56	SF	14.56	_
1-Hour Photo	1	RED	16.50	SF	16.50	_
We Sell For Less	1	RED	68.20	SF	68.20	_
Tire & Lube	1	RED	47.70	SF	47.70	_
Express ==>	1	RED	32.88	SF	32.88	_
TOTAL FRONT SIGNAGE					1751.32	_

1437 South Boulder Avenue, Suite 800 Tulsa, Oklahoma 74119-3609 (918) 587-8600 Fax: (918) 587-8601
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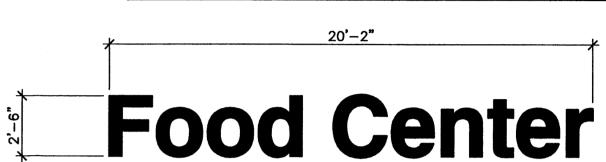
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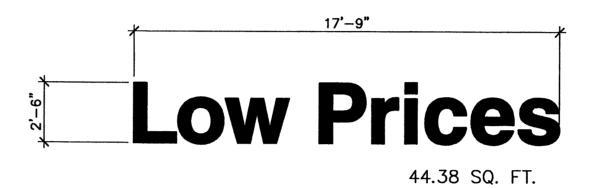
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RONT SIGNAGE	QTY	COLOR	INDIVIDU. AREA		TOTAL A	REA	
T	5	RED	189	SF	945	SF	
NTER	5	RED	39.17	SF	195.85	SF	
	2	RED	145.64	SF	291.28	SF	
nter	1	RED	50.47	SF	50.47	SF	
es	1	RED	44.38	SF	44.38	SF	
	1	RED	11.88	SF	11.88	SF	
	1	RED	6.84	SF	6.84	SF	
	1	RED	5.30	SF	5.30	SF	
	1	RED	10.25	SF	10.25	SF	
	1	RED	10.26	SF	10.26	SF	
у	1	RED	14.56	SF	14.56	SF	
Photo	1	RED	16.50	SF	16.50	SF	
or Less	1	RED	68.20	SF	68.20	SF	
ube	1	RED	47.70	SF	47.70	SF	
==>	1	RED	32.88	SF	32.88	SF	
RONT SIGNAGE					1751.32	SF	
NTER SIGNAGE							
Т	1	DED	11 15	CE	11 15	SE	

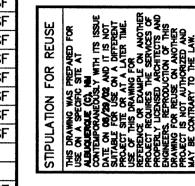
						<u> </u>	
AUTO CENTER SIGNAGE							
WAL*MART	1	RED	11.15	SF	11.15	SF	
TIRE & LUBE	1	RED	26.25	SF	26.25	SF	
EXPRESS	1	RED	39.71	SF	39.71	SF	
FUTURE OIL LOGO	1		30.00	SF	30.00	SF	
Tires	3	RED	3.26	SF	9.78	SF	
Lube Express	3	RED	8.96	SF	26.88	SF	
TOTAL AUTO CENTER SIGNAGE						SF	
TOTAL BUILDING SIGNAGE						SF	





(13) SIGNAGE




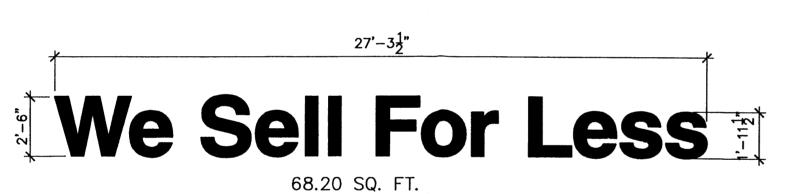

16) SIGNAGE

5.30 SQ. FT.



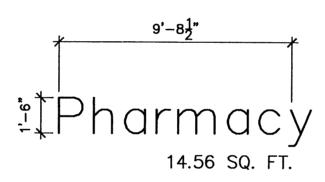

Meat :

SIGNAGE 1/4" = 1'-0"

Tire & Lube (47.70 SQ. FT. 47.70 SQ. FT. 32.88 SQ. FT.


6.84 SQ. FT.

Produce :


11.88 SQ. FT.

SIGNAGE 1/4" = 1'-0"




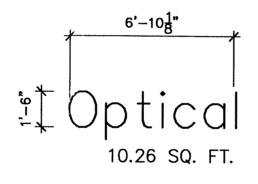



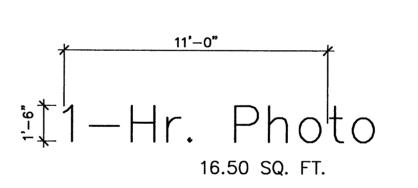



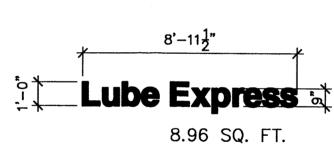


 $\frac{\text{SIGNAGE}}{1/4" = 1'-0"}$ 




Tires 🖫


3.26 SQ. FT.

50.47 SQ. FT.

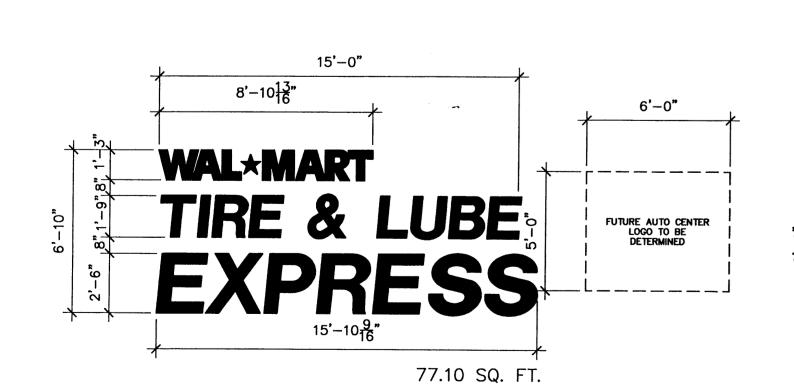




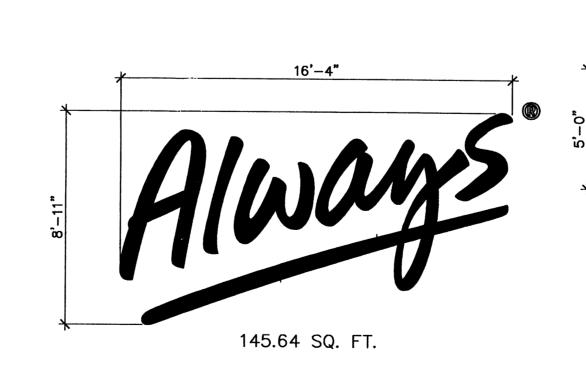

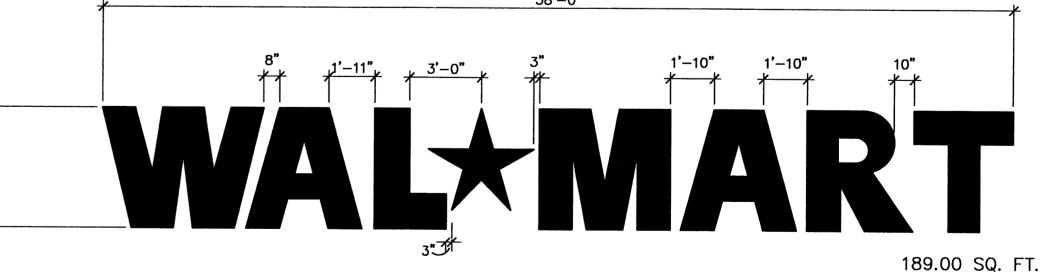

2) SIGNAGE 1/4" = 1'-0"

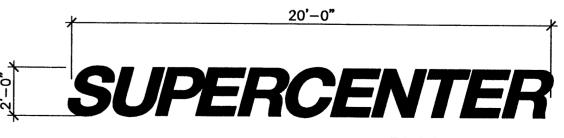

 $\frac{\text{SIGNAGE}}{1/4" = 1'-0"}$ 


39.17 SQ. FT.


SHEET: 5A


SIGNAGE


SIGNAGE 1/4" = 1'-0"




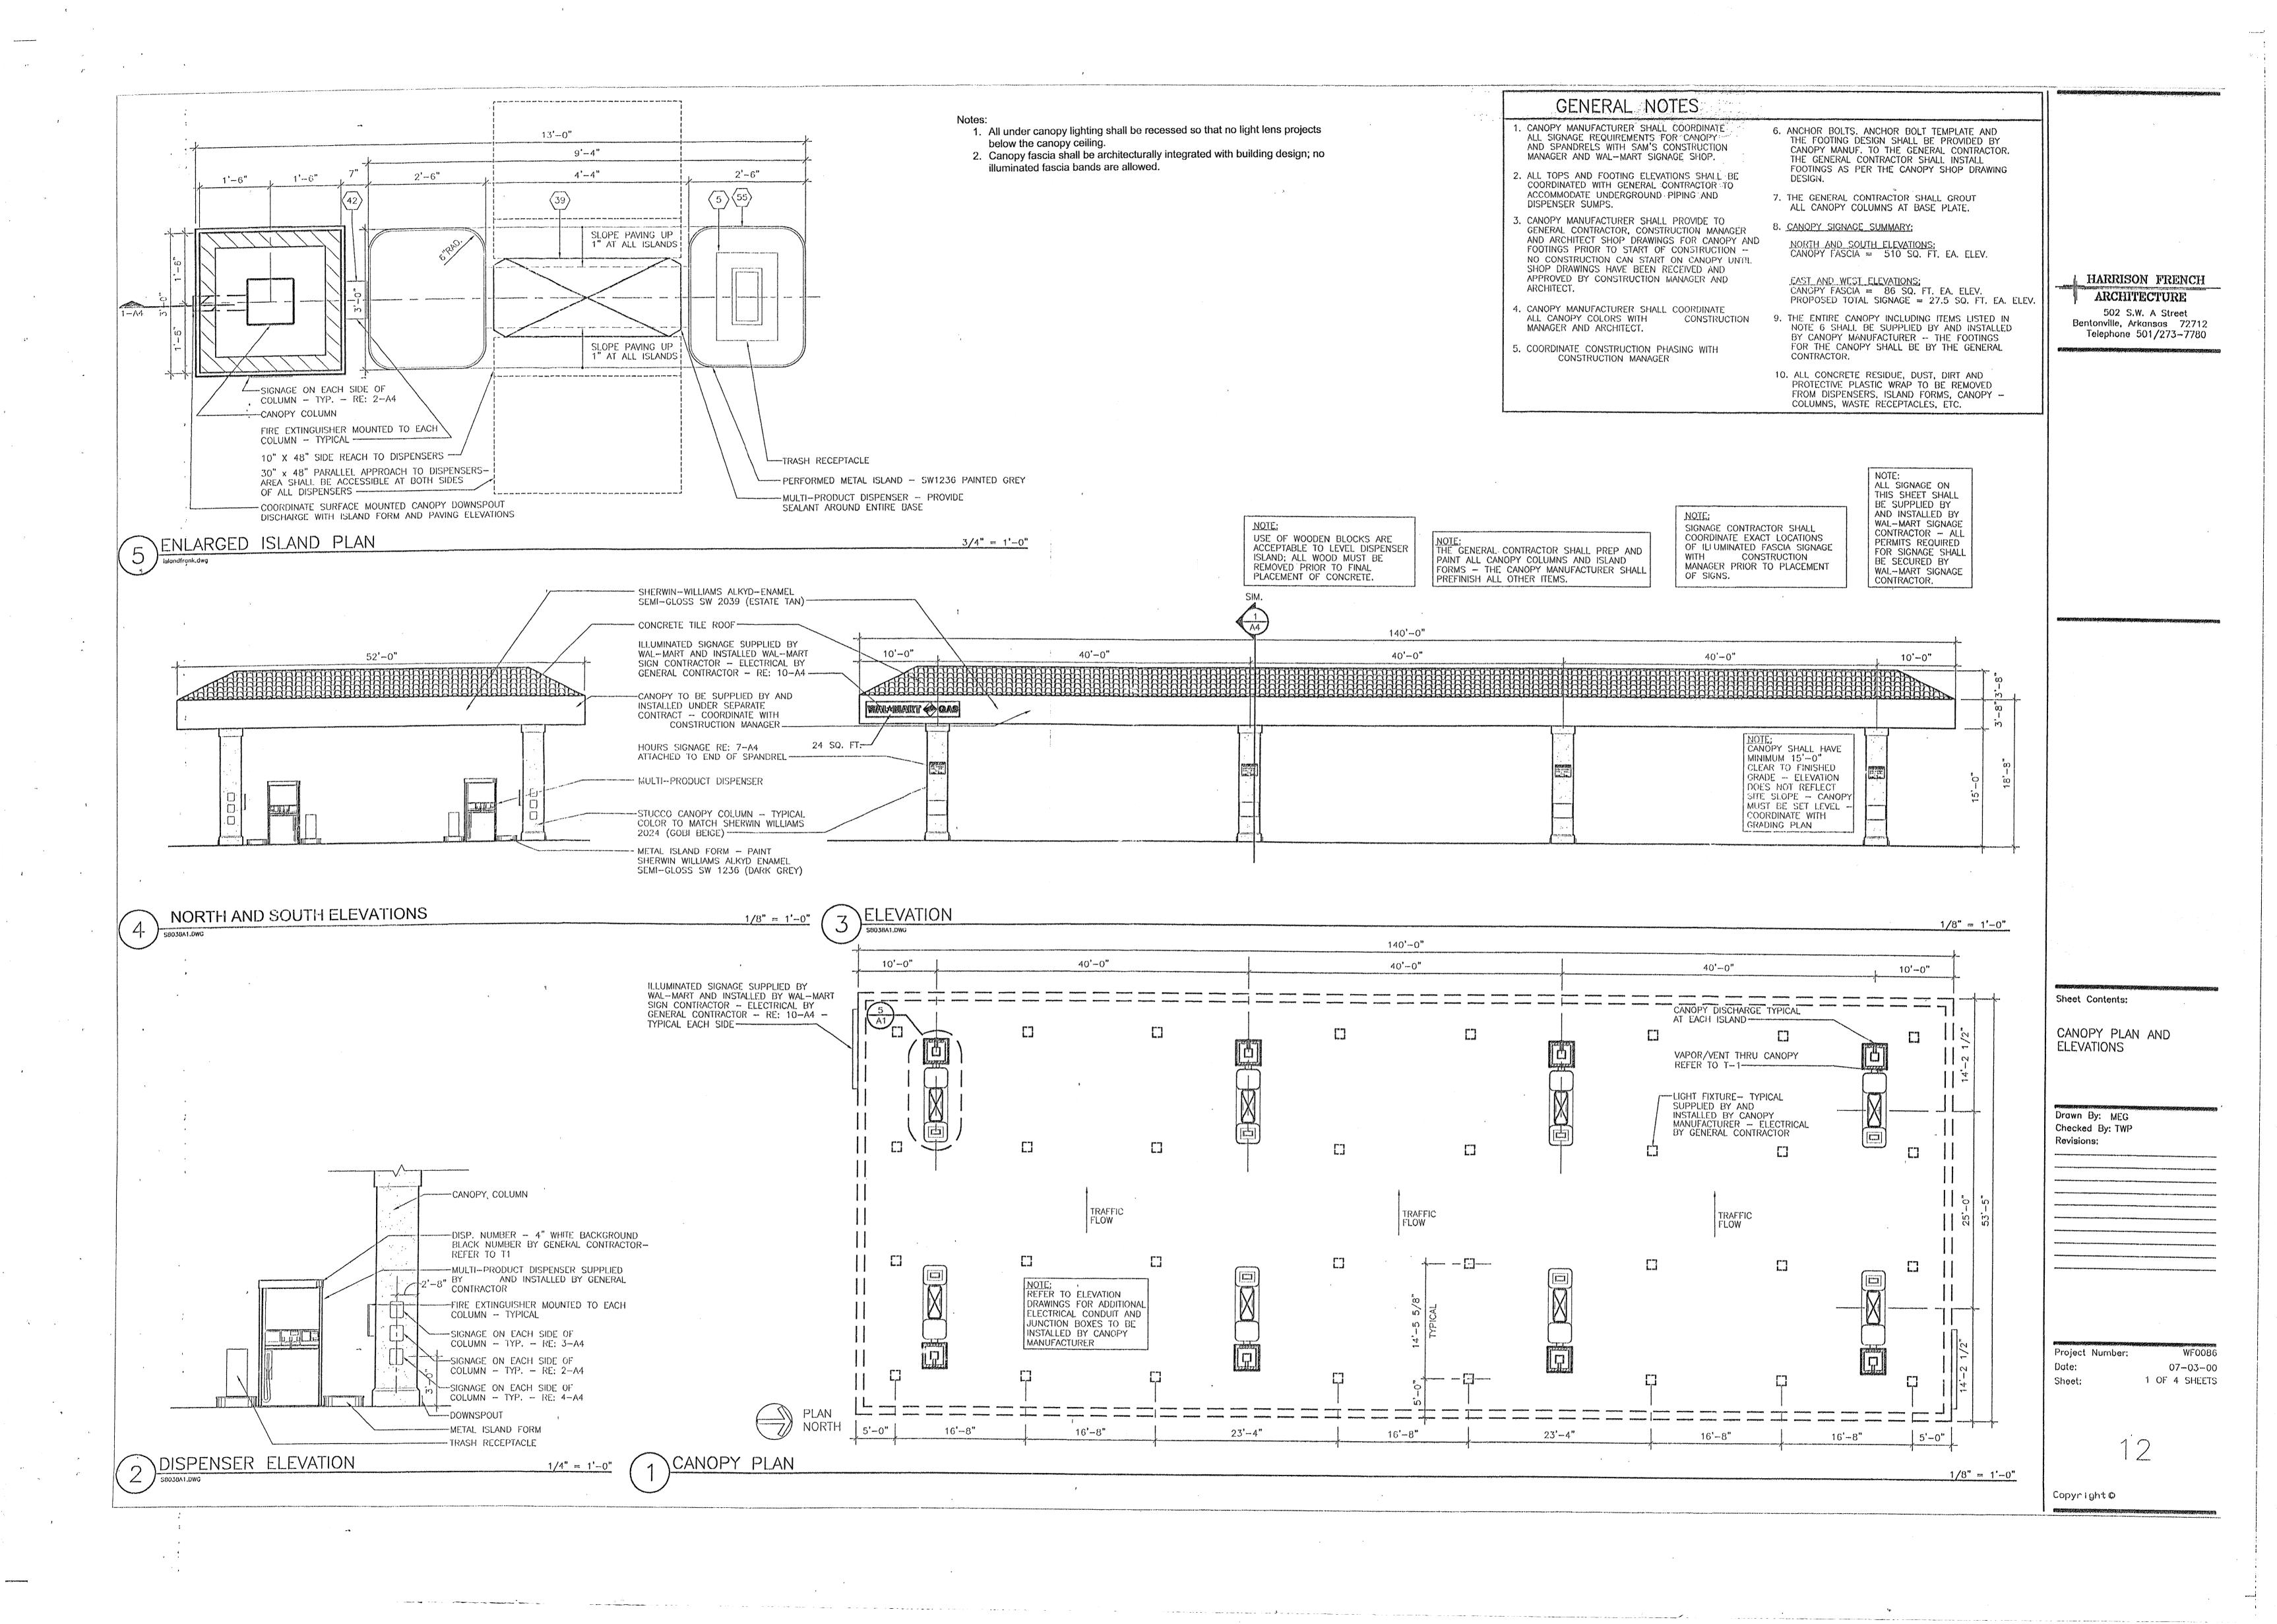


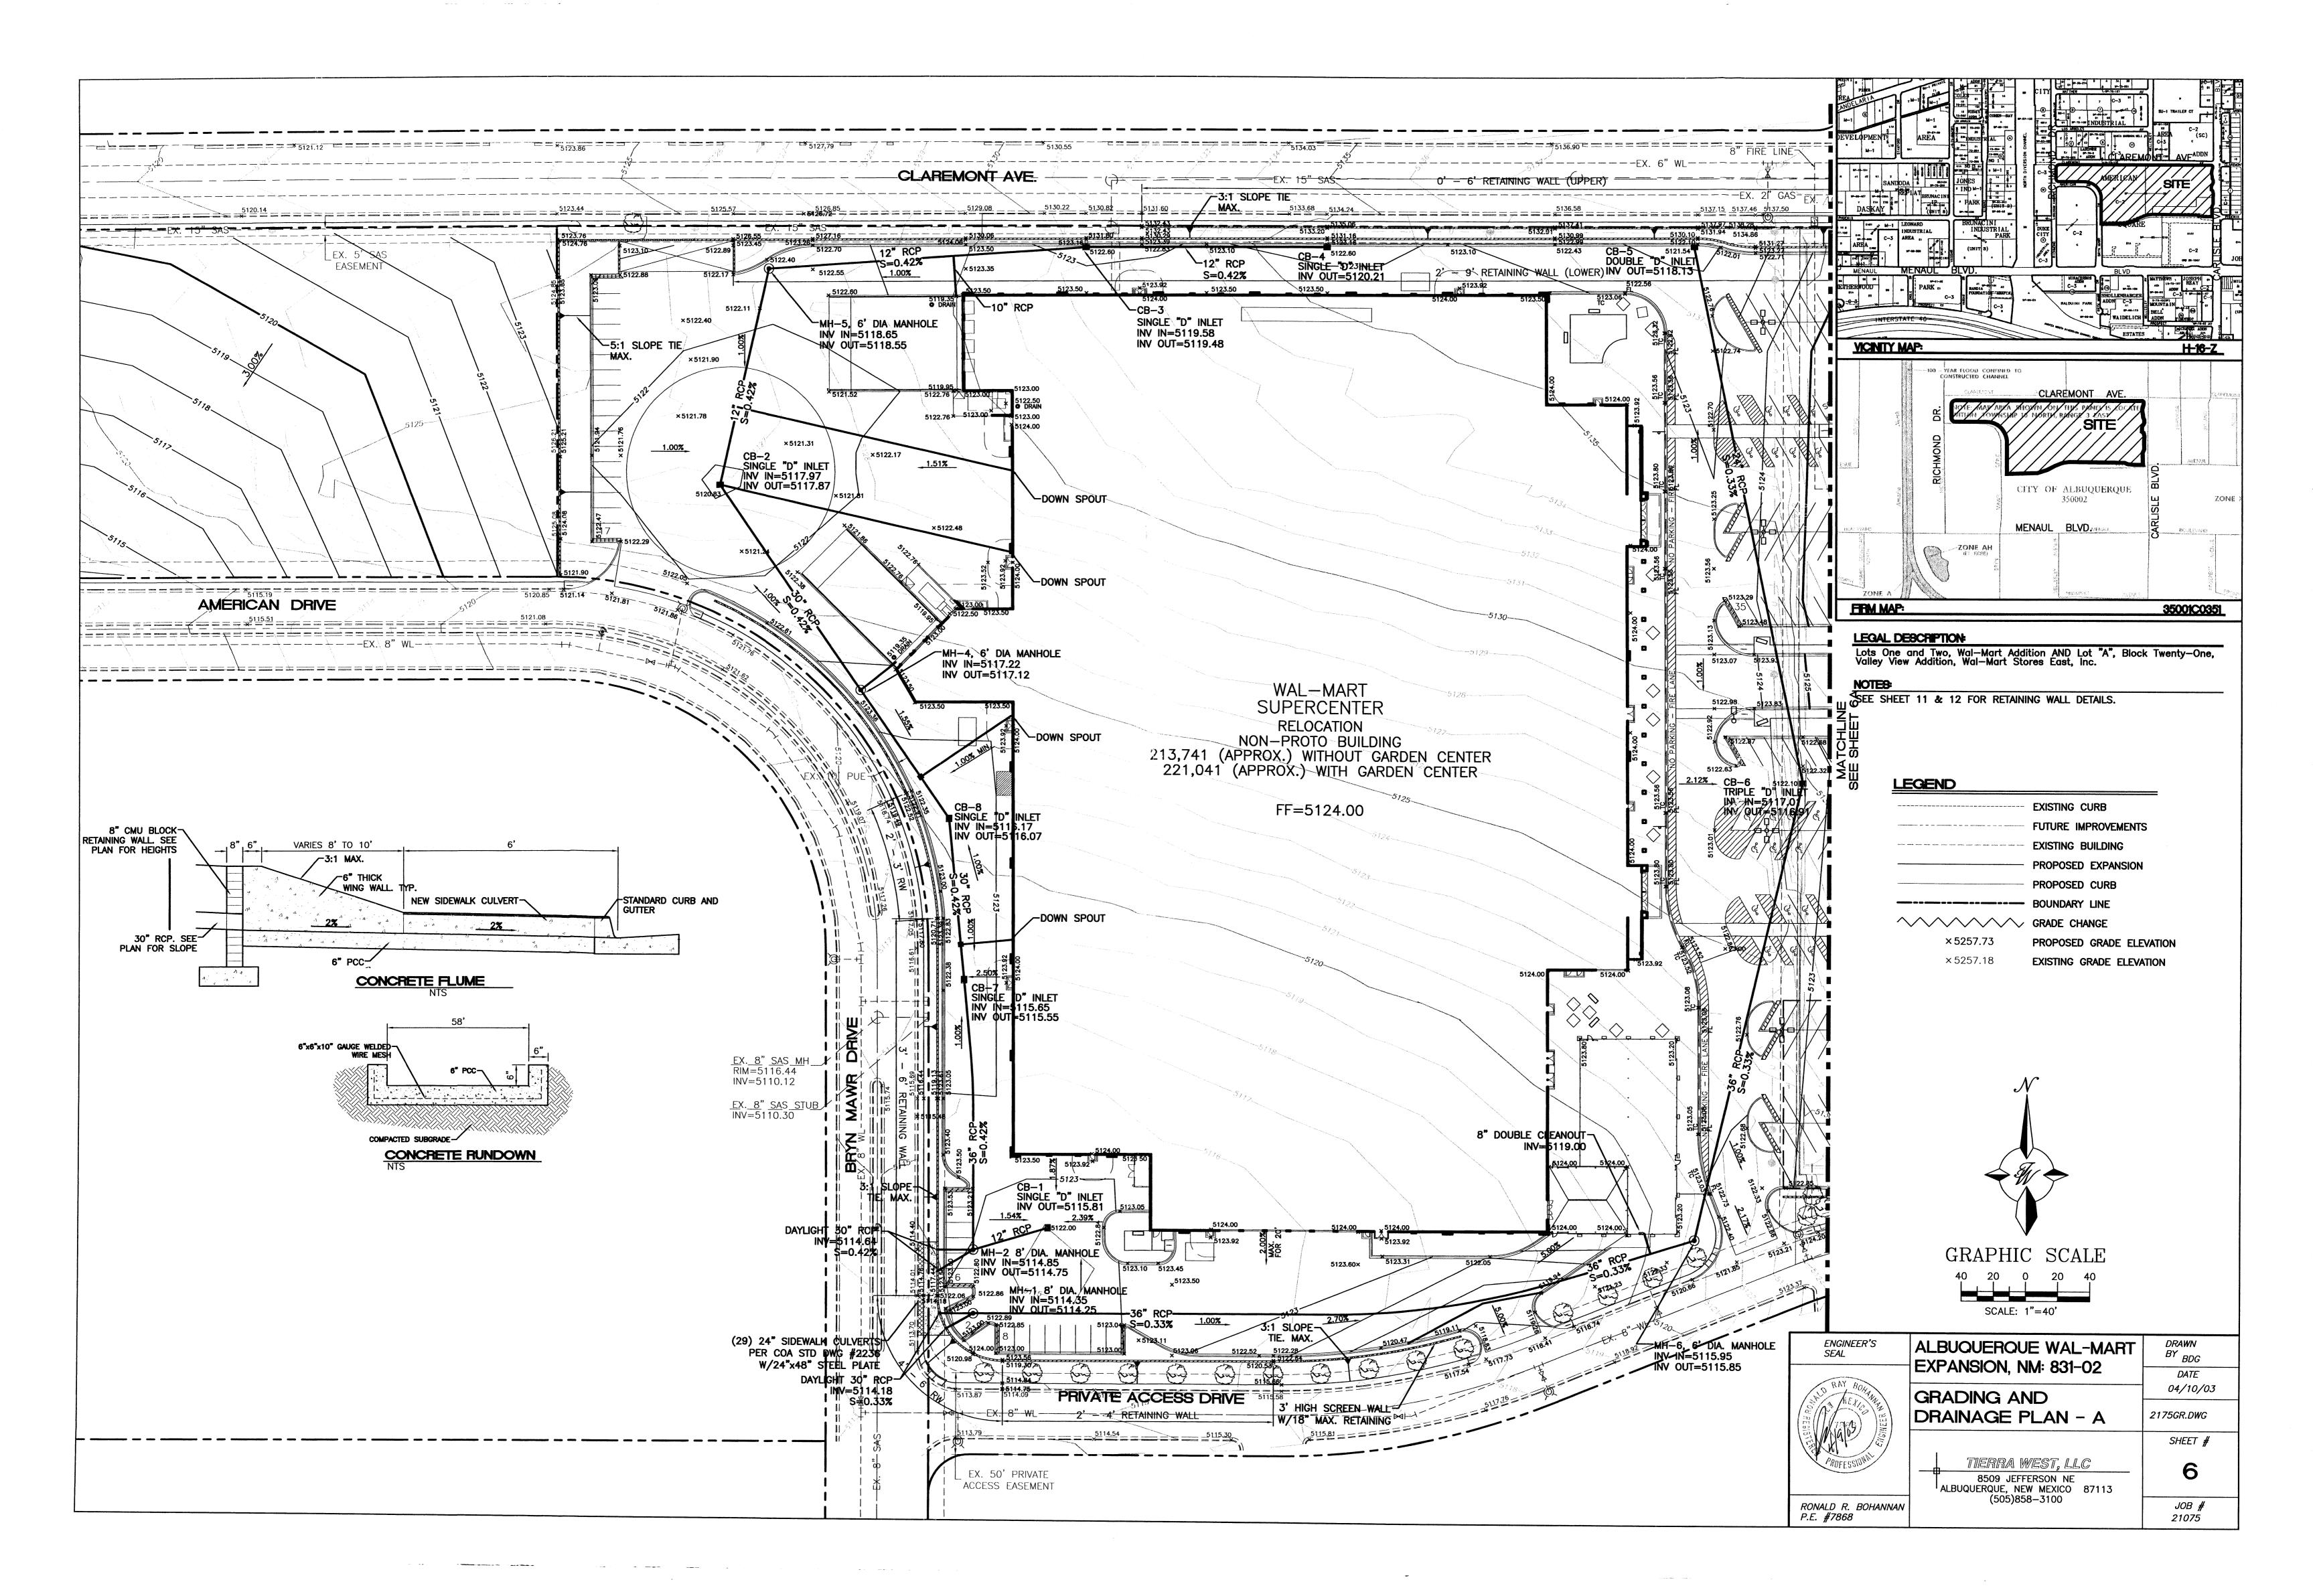

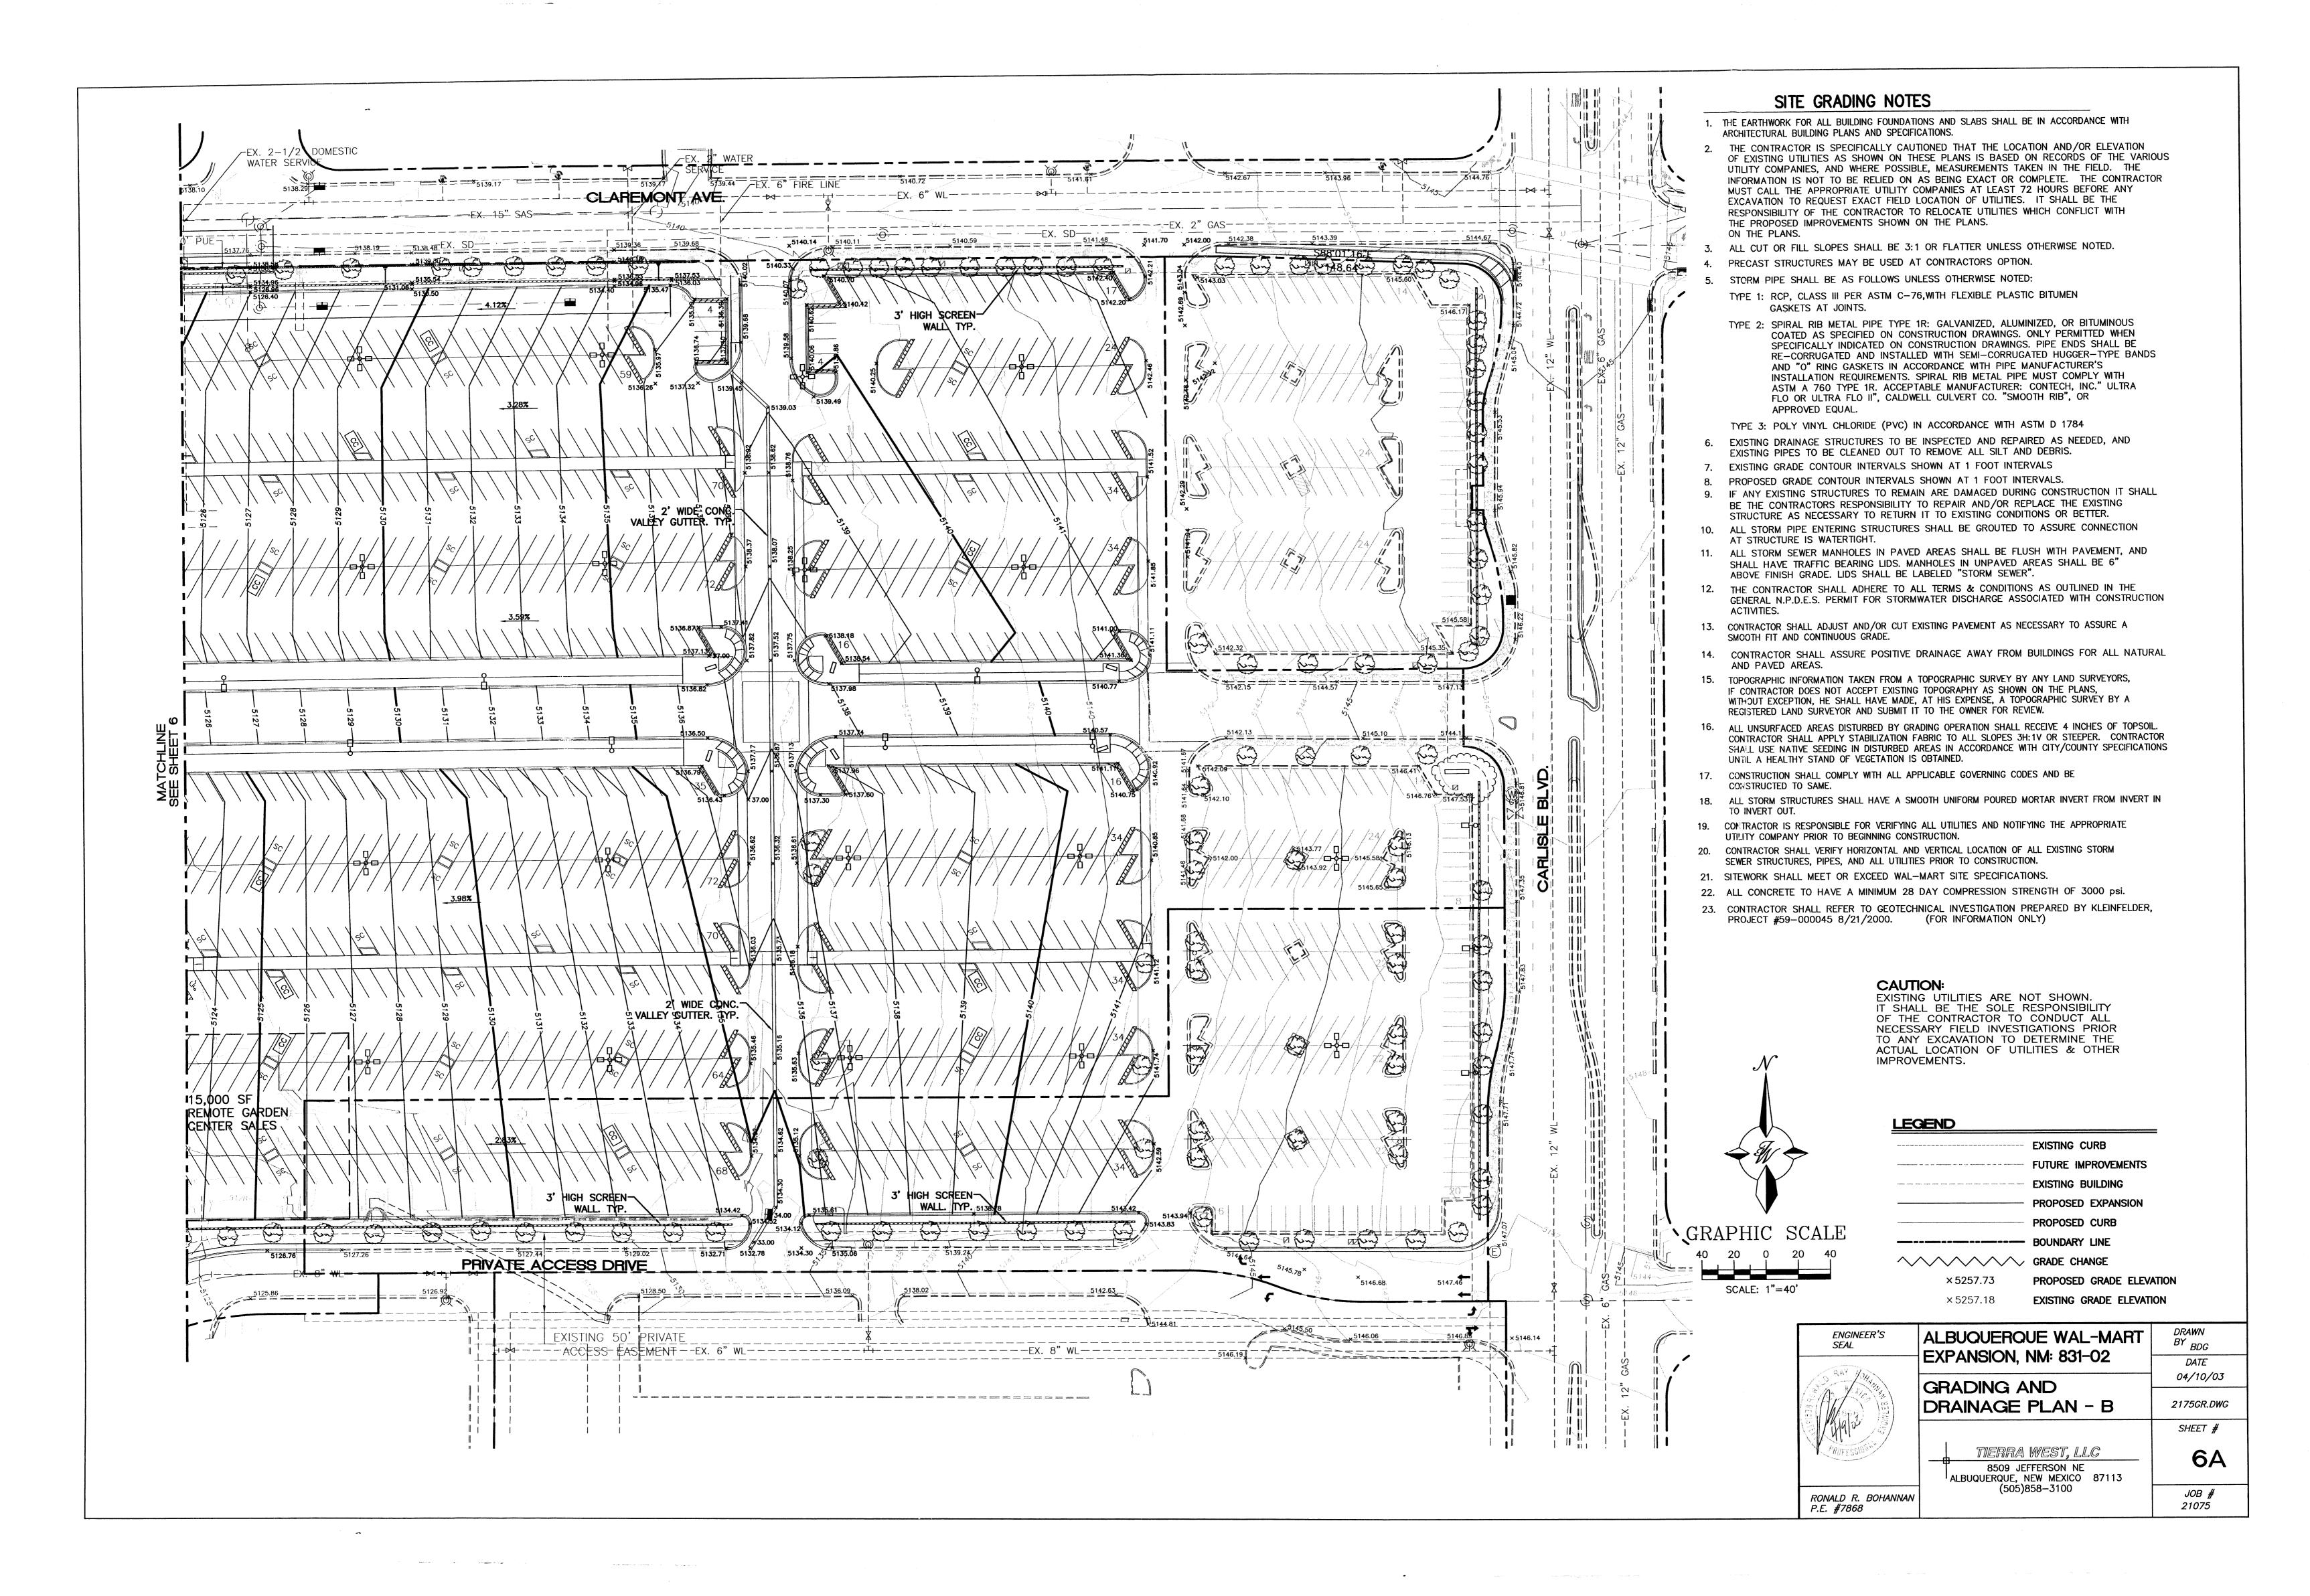


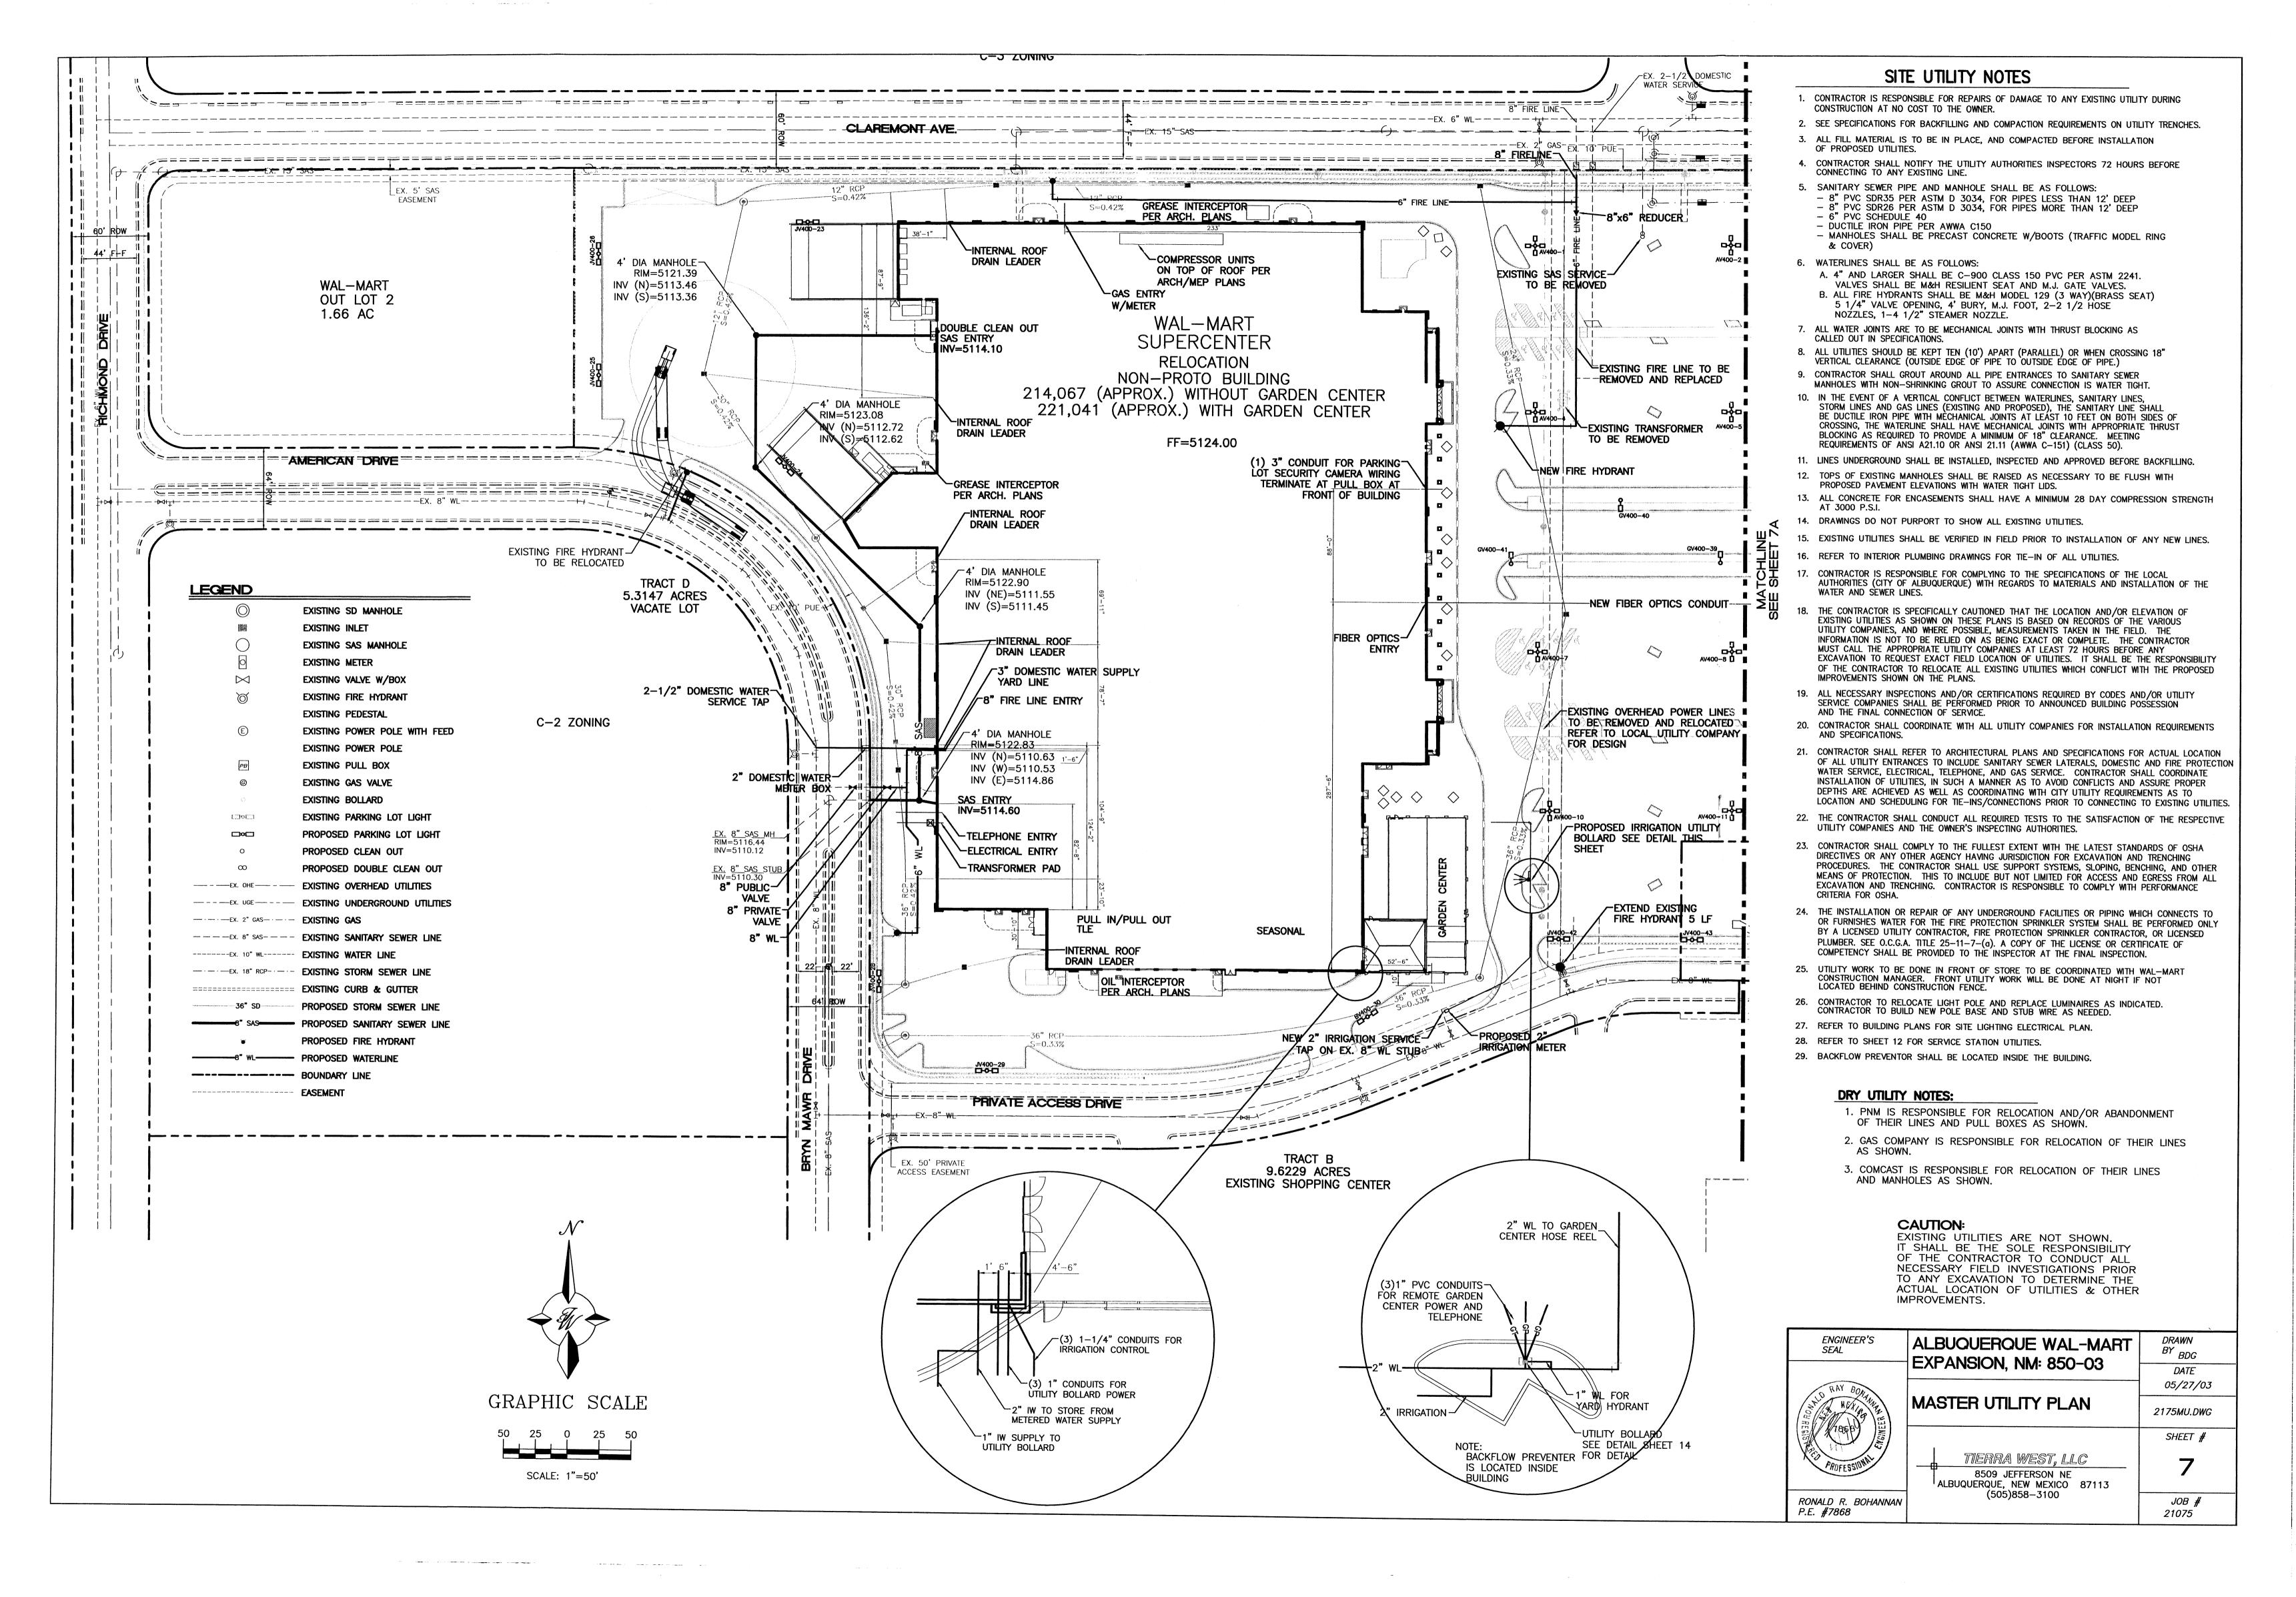

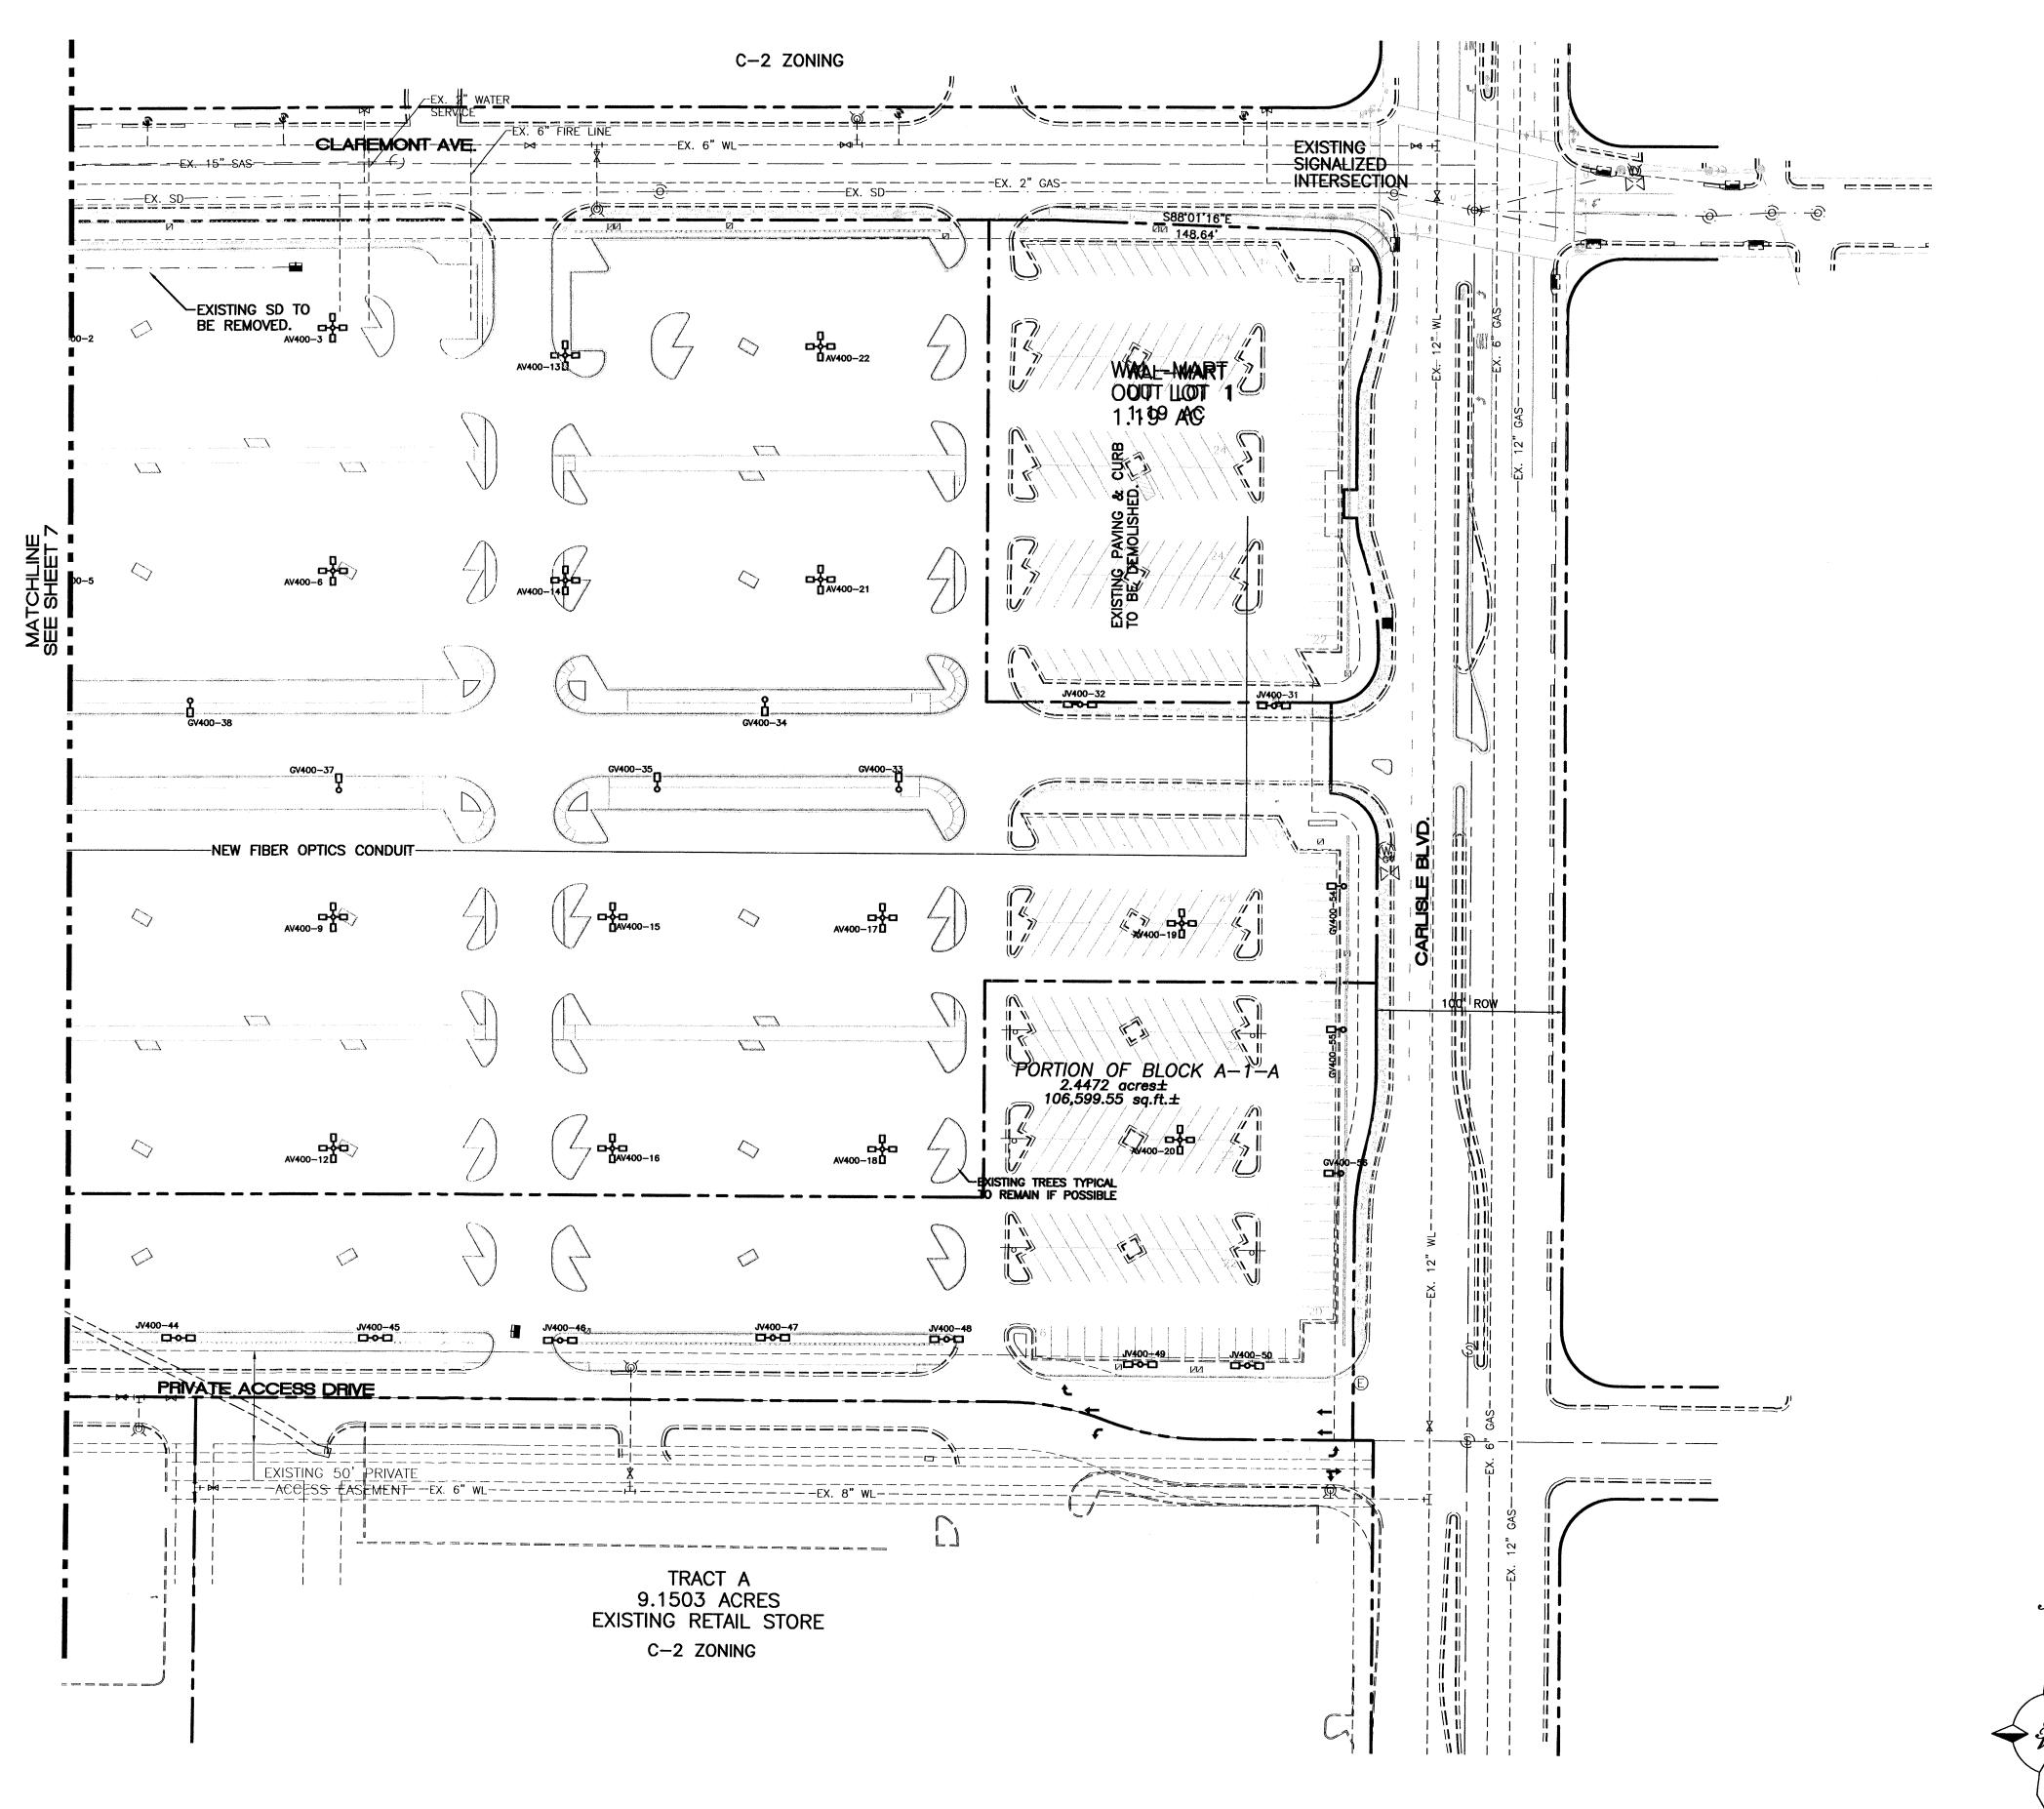

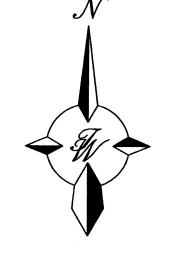

GRAPHIC SCALE

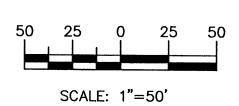



BEN BOWN BEN SEE	_
RONALD R. BOHANNAN P.E. #7868	

ENGINEER'S SEAL

ALBUQUERQUE WAL-MART EXPANSION, NM: 850-03	DRAWN BY BDG
LXI AINSICIN, INVI: 830-03	DATE
	04/10/03
MASTER UTILITY PLAN - B	2175SP.DWG
	SHEET #
TIERRA WEST, LLC 8509 JEFFERSON NF	<b>7</b> A

8509 JEFFERSON NE ALBUQUERQUE, NEW MEXICO 87113 (505)858-3100 JOB # 21075

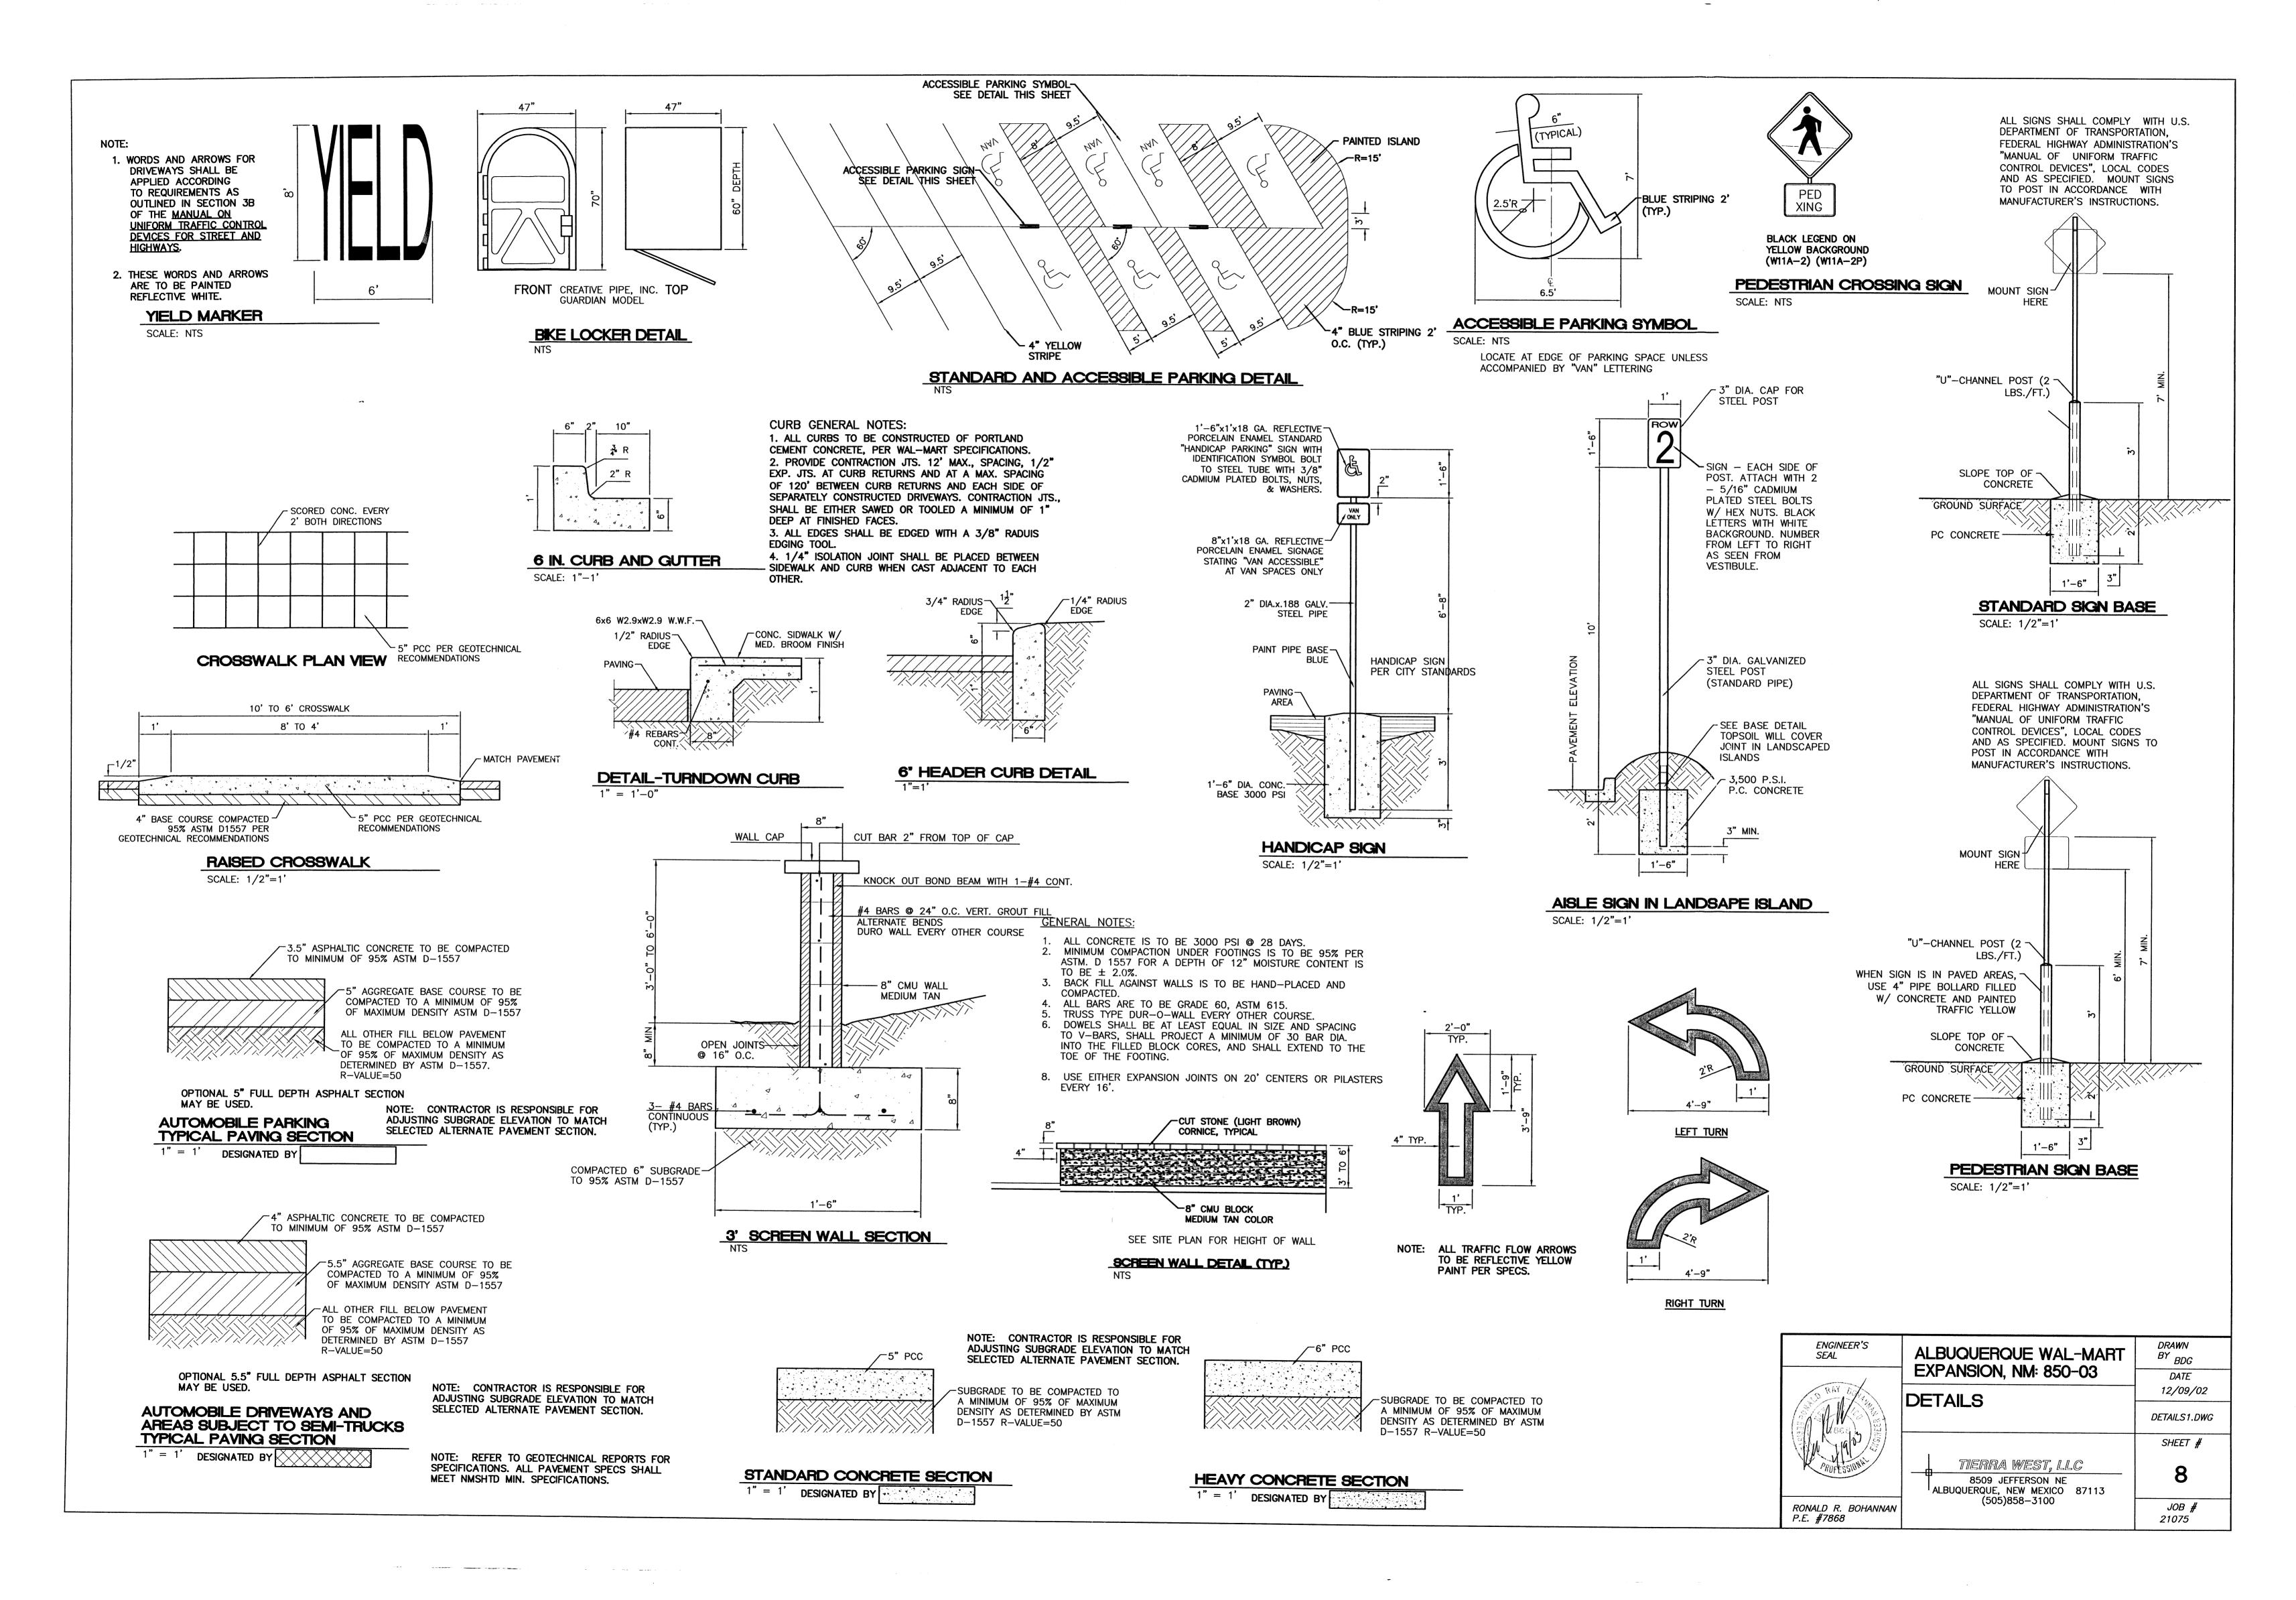

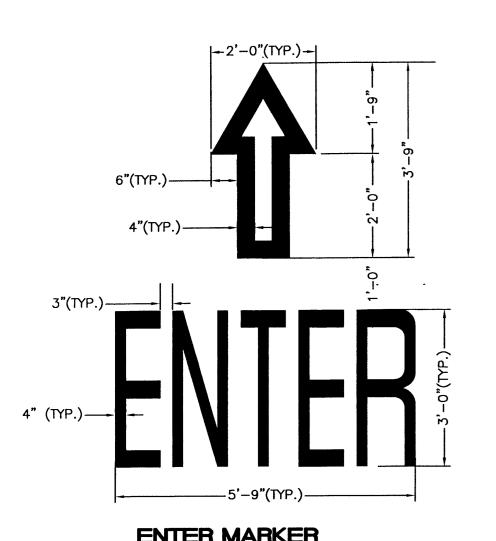

#### **ENTER MARKER**

SCALE: NTS

4" CONC. W/ #3's @ 18" O.C.E.W. ——

COMPACTED SELECT FILL.

95% PROCTOR DENSITY

 W
 R
 WR

 20'
 30'
 30'MIN.

 25'
 20'
 30'MIN.

30' 10' 30'MIN.

1/2" EXP. FILLER & SEALANT —

NOTE: ALL TRAFFIC FLOW ARROWS TO BE SOLID YELLOW REFLECTIVE TRAFFIC PAINT PER DIMENSIONS ABOVE.

PROTECTION BOARD OVER

WATERPROOF MEMBRANE

TO 2" BELOW CONC. CAP

ن نب ک<sup>ک</sup> سہ سے جنب

W = WIDTH (feet) OF FIRE LANE
R = RADIUS NECESSARY TO ACCOMODATE
FIRE VEHICLES
WR = TURNING RADIUS PAVEMENT WIDTH

NO PARKING FIRE LANE

NO PARKING FIRE


1" DIA. P.V.C.

SLEEVE FOR ELECT. LINE

3" DIA. P.V.C. SLEEVE

FOR IRRIGATION LINE-

STORE FRONT TREE PLANTER DETAIL

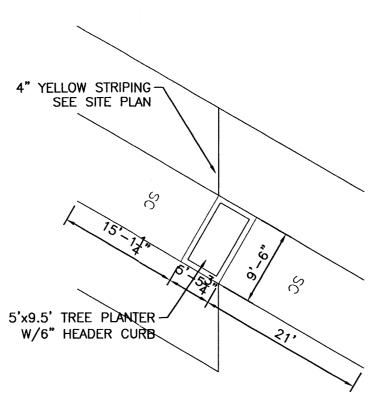

**ELONGATED TREE PLANTER** 

LIOST YCHAS LIOST LOSS - LOSS

SMOOTH-FACE

----

PVC DRAIN WITH

FILTER FABRIC


-4" GRAVEL FILL

BACKFÍLL

T.O.M.=

102'--4"

SCALE: NTS

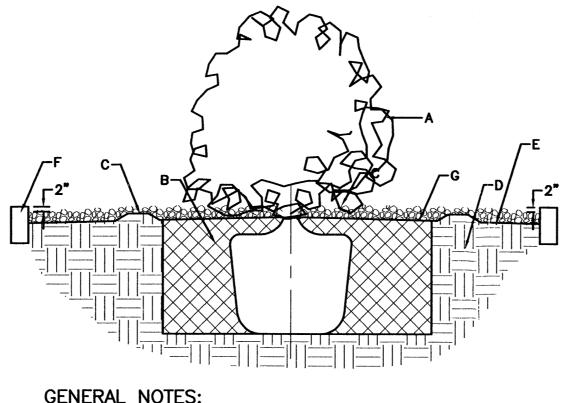

**GENERAL NOTES:** 1. ROOTBALL SHALL BE PLACED ON DISTURBED SOIL TO PREVENT TREE FROM SETTLING.

2. TOP OF ROOTBALL INDICATES LEVEL AT WHICH TREE WAS GROWN AND DUG, THIS REPRESENTS THE LEVEL AT WHICH THE TREE SHOULD BE INSTALLED, THAT LEVEL MAY BE EXCEEDED BY ONLY A ONE INLER LAYER OF SOIL.

3. PRIOR TO BACKFILL TREE, ALL WIRE, ROPE AND SYNTHETIC MATERIALS SHALL BE REMOVED FROM THE TREE AND THE PLANTING

4. PRIOR TO BACKFILLING ALL BURLAP SHALL BE CUT AWAY EXCEPT FROM BOTTOM OF THE ROOTBALL.

#### CONSTRUCTION NOTES:

A. SHRUB B. BACKFILL WITH EXISTING SOIL C. CREATE EARTH BERM TO FORM RETENTION BASIN


D. 4" DEEP 3/4" CRUSHED GREY GRAVEL E. FINISH GRADE 4" BELOW TOP OF CURB

F. UNDISTURBED SOIL G. FILTER FABRIC

H. STANDARD 6" CURB

#### SHRUB IN GRAVEL

SCALE: NTS

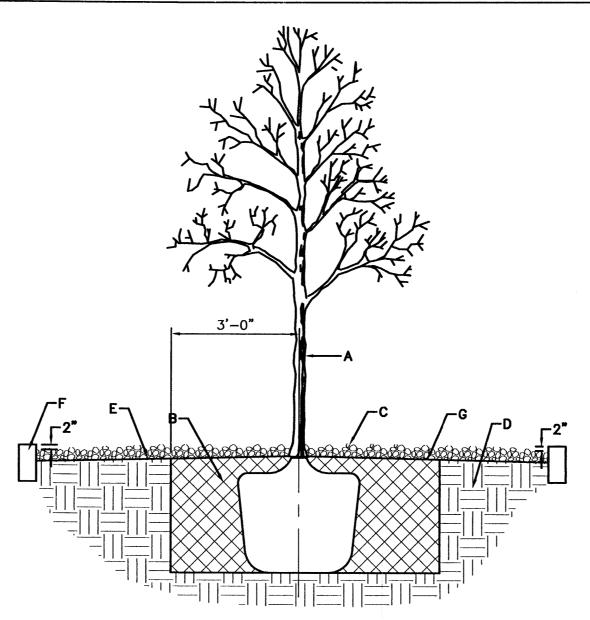

#### **GENERAL NOTES:**

1. ROOTBALL SHALL BE PLACED ON DISTURBED SOIL TO PREVENT TREE FROM SETTLING.

2. TOP OF ROOTBALL INDICATES LEVEL AT WHICH TREE WAS GROWN AND DUG, THIS REPRESENTS THE LEVEL AT WHICH THE TREE SHOULD BE INSTALLED, THAT LEVEL MAY BE EXCEEDED BY ONLY A ONE INLER LAYER OF SOIL.

3. PRIOR TO BACKFILL TREE, ALL WIRE, ROPE AND SYNTHETIC MATERIALS SHALL BE REMOVED FROM THE TREE AND THE PLANTING

4. PRIOR TO BACKFILLING ALL BURLAP SHALL BE CUT AWAY EXCEPT FROM BOTTOM OF THE ROOTBALL.

#### **CONSTRUCTION NOTES:**

B. BACKFILL WITH EXISTING SOIL

C. 4" DEEP 3/4" CRUSHED GREY GRAVEL D. UNDISTURBÉD SOIL

E. FILTER FABRIC F. STANDARD 6" CURB

EXISTING GROUND

CUT BACK SLOPE

A FLAT SURFACE

TO PROVIDE


FOR PLANTING

4" GRAVEL MULCH W/ FROM CURB

G. FINISH GRADE 4" BELOW TOP OF CURB

#### TREE PLANTING

SCALE: NTS

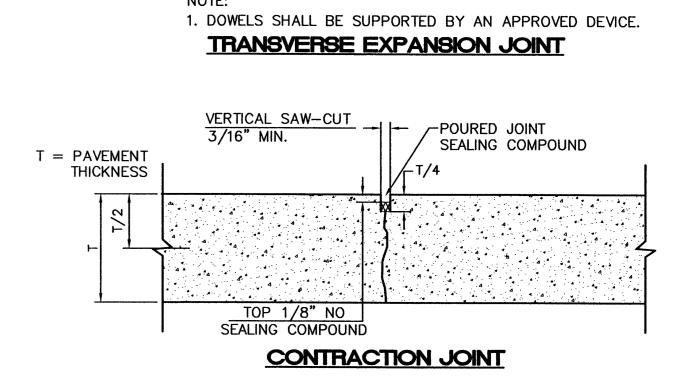

DOWEL DIAMETER = T/8 (IN)

POURED JOINT

2" MIN.: |---

LUBRICATED

SEALING COMPOUND

-DOWEL SLEEVE

(CLOSED END)

TO FIT DOWEL AND BE SECURED

1-1/4" MIN. CLÉARANCE

-----16" LONG SMOOTH DOWEL @ 18" O.C.----

VERTICAL SAW-CUT


TOP 1/8" NO SEALING COMPOUND

3/16" MIN. REDWOOD EXPANSION JOINT FILLER

3/16" MIN.


T = PAVEMENT

THICKNESS

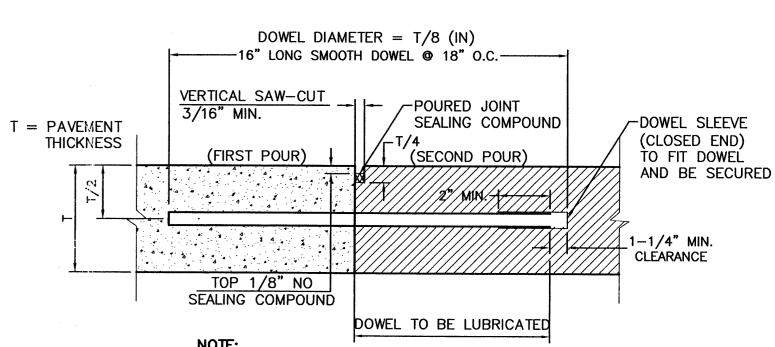

1. DOWELS SHALL BE SUPPORTED BY AN APPROVED DEVICE.

#### **CONSTRUCTION JOINT**

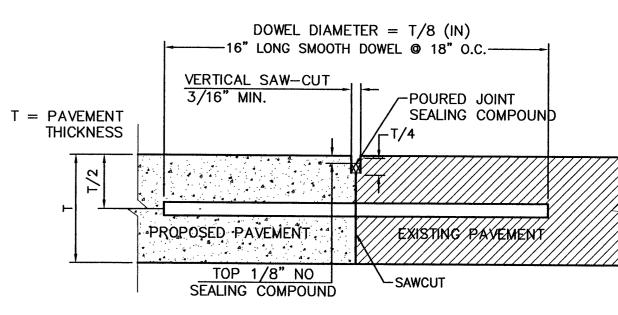

P.E. #7868

**PLAN** 

8" 2-PLY RUBBER HOSE

WHITE FLAGGING (TYP.)

TREE WRAP

- 4 INCHES MULCH

- BACKFILL MIX

— 4 INCH DEEP SAUCER

-UNDISTURBED SUBSOIL

REMOVE BURLAP & ROPE


- 8' STEEL TEE POST

DOUBLE STRAND 12 GAUGE WIRE


- 1. DOWEL BARS SHALL BE DRILLED INTO PAVEMENT HORIZONTALLY BY USE OF A MECHANICAL RIG.
- 2. DRILLING BY HAND IS NOT ACCEPTABLE, PUSHING DOWEL
- BARS INTO GREEN CONCRETE IS NOT ACCEPTABLE.


#### **BUTT JOINT**


## CONCRETE JOINT DETAILS

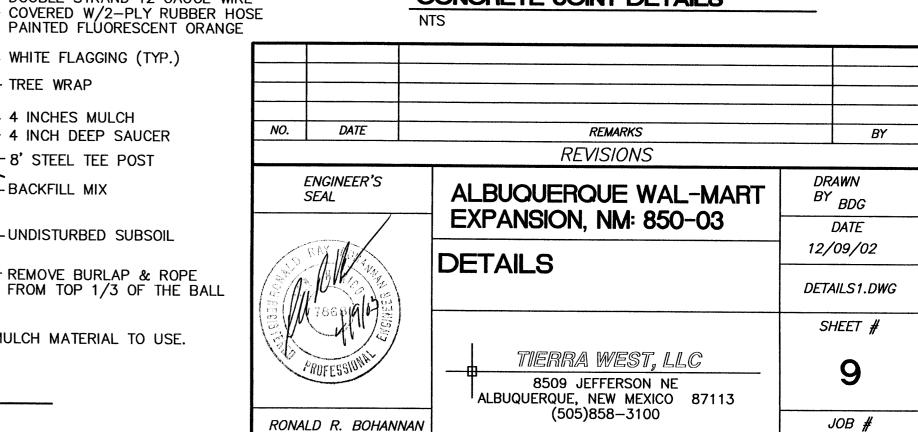



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NOTE: SEE LANDSCAPE NOTES FOR THE TYPE OF MULCH MATERIAL TO USE.

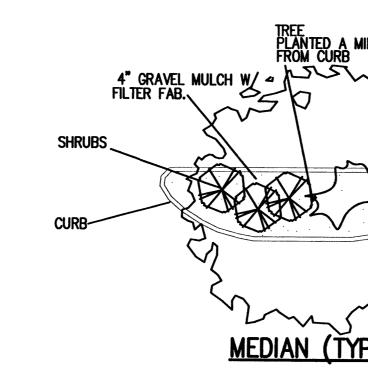TREE PLANTING

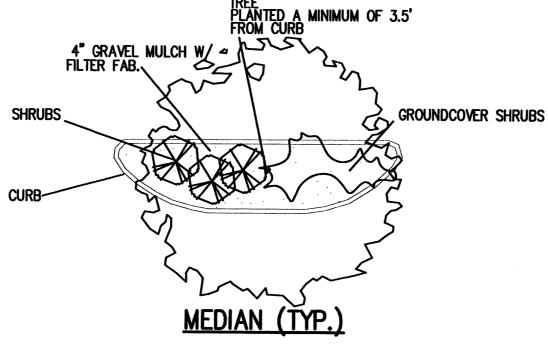'NO PARKING FIRE LANE' STRIPING ALONG FACE OF CURB

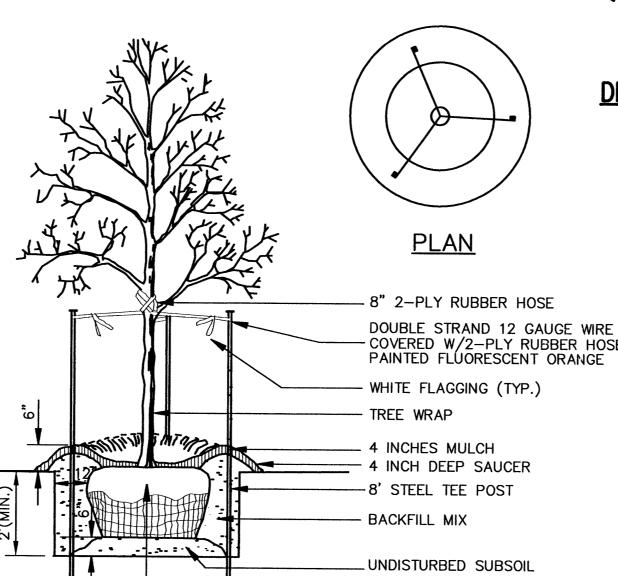FIRE LANE STRIPING SHALL BE 6" RED STRIPES WITH 4" INCH WHITE LETTERS READING "NO PARKING FIRE

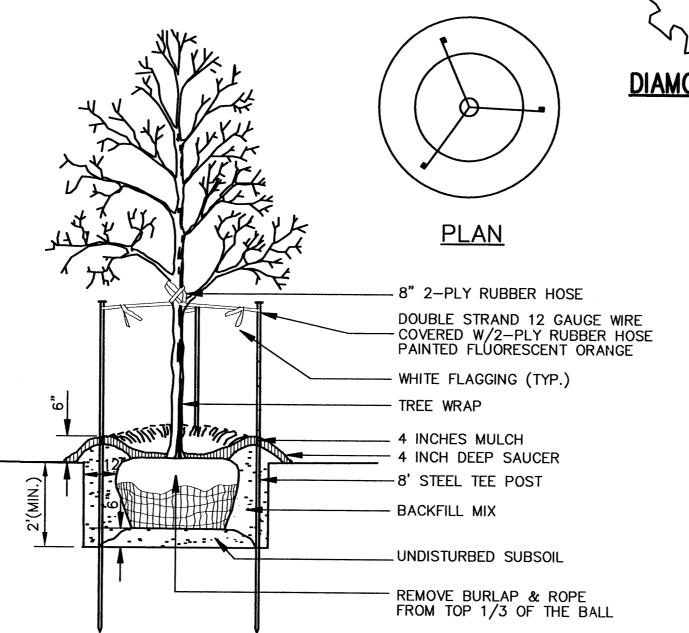LANE" STRIPING SHALL BE PLACED ON FACE OF

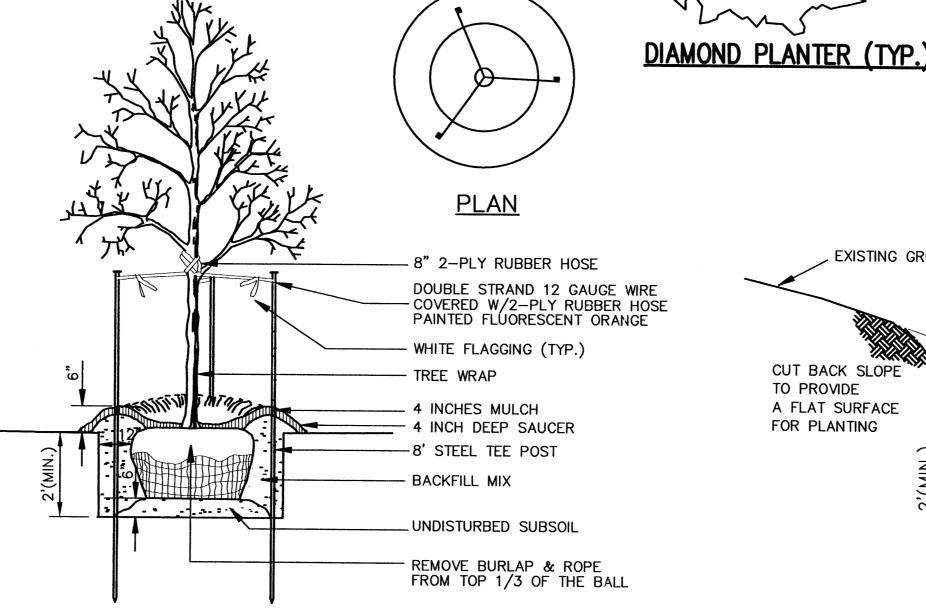CURB WHENEVER POSSIBLE, OR AS SPECIFIED


NOTE: SEE LANDSCAPE NOTES FOR THE TYPE OF MULCH MATERIAL TO USE. TREE PLANTING ON SLOPE SCALE: NTS


BY LOCAL CODES.

NO PARKING FIRE LANE

NO PARKING FIRE

SCALE: NTS

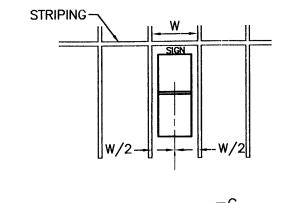

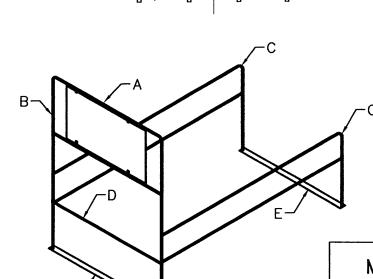

NOTE: CART CORRALS WILL BE PROVIDED BY WAL-MART. PER SPECIFICATIONS. TO BE ASSEMBLED AND INSTALLED BY THE CONTRACTOR. TOOLS REQUIRED


9" BOX WRENCH AND/OR SOCKET. HAMMER

**INSTALLATION INSTRUCTIONS:** 

- 1. Select level area in parking lot.
- 2. Lay bottom plates (E) approx. 15' apart parallel.
- 3. Attach side rails (C) to bottom plates (E). A tap with hammer may be required.
- 4. Attach stop bar (D) to inside of rail (C) with 6" bolt and lock nut (F).
- 5. Mount (B) into side rails (C) by sleeving the wedged pieces together. A slight tap may be required.
- 6. Mount cart corral sign (A) 8' from finish grade.


MODEL	DESCRIPTION	DIMENSIONS	APPX. CAP.	WEIGHT
102	2-BAY, 1 WAY ENTRY CORRAL W/2' x 4' UNDERHUNG SIGN	60"W x 10'D x 8'H	20 CARTS	150#
103	1-BAY, 1 WAY ENTRY CORRAL W/2' x 4' UNDERHUNG SIGN	36"W x 10'D x 8'H	10 CARTS	152#
104	3-BAY, 1 WAY ENTRY CORRAL W/2' x 4' UNDERHUNG SIGN	80"W x 10'D x 8'H	45 CARTS	250#

#### SINGLE CART CORRAL DETAIL

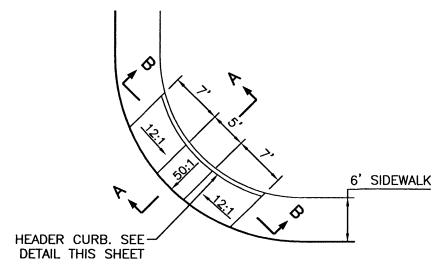


GENERAL NOTES: 1. SURFACE TEXTURE OF CURB ACCESS RAMPS SHALL BE OBTAINED BY HEAVY BROOMING, TRANSVERSE TO THE SLOPE OF THE RAMP. 2. GUITER FLOW LINE PROFILE SHALL BE MAINTAINED THROUGH THE AREA OF THE RAMP. 3. CONSTRUCT PER A.D.A. STANDARDS.

#### WHEELCHAIR RAMP DETAIL (TYP.)

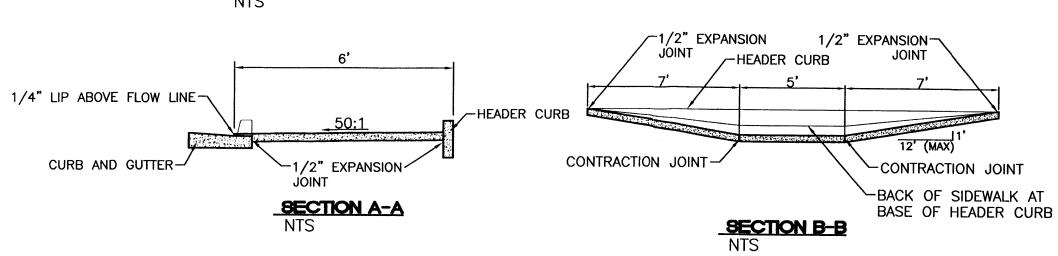


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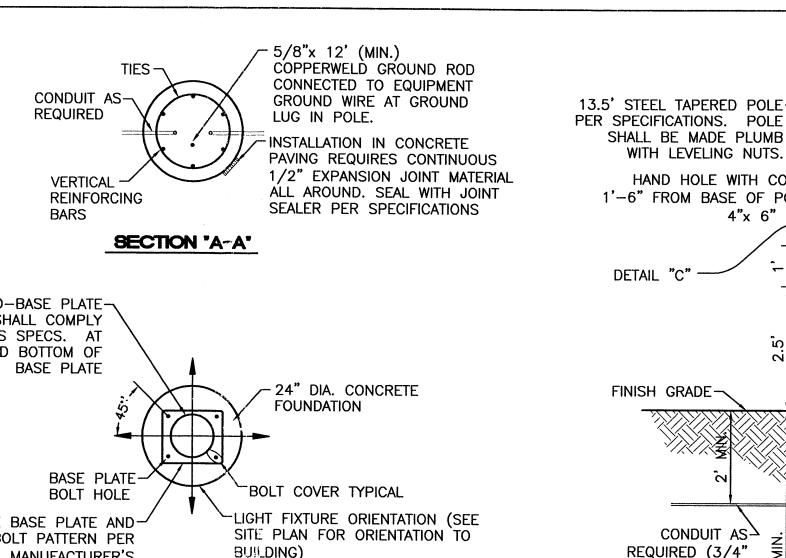
**BOLLARD DETAIL** 

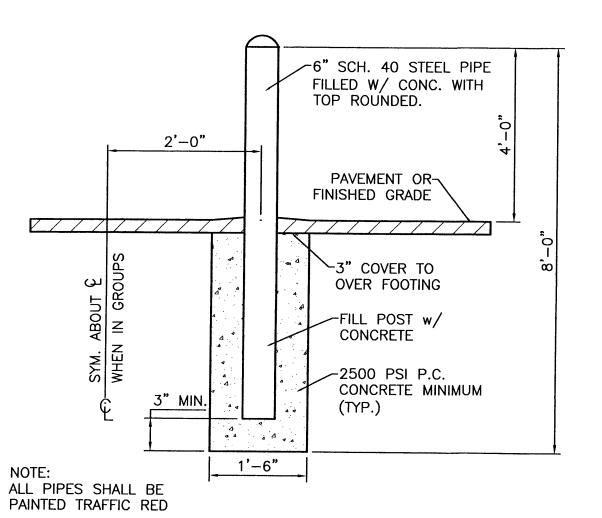
SCALE: NTS




**BIKE RACK DETAIL** 

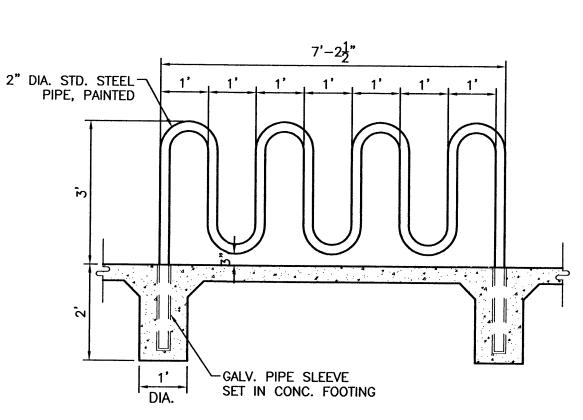SCALE: 1/2"=1'




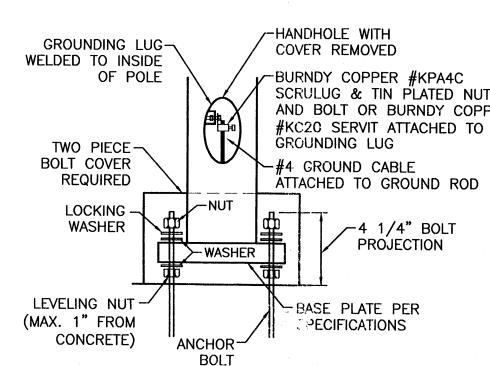

#### DETAIL 'C'

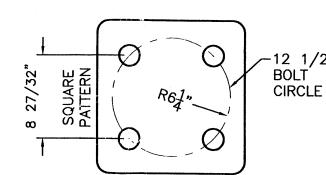

TYPICAL ANCHOR BOLT SPACING

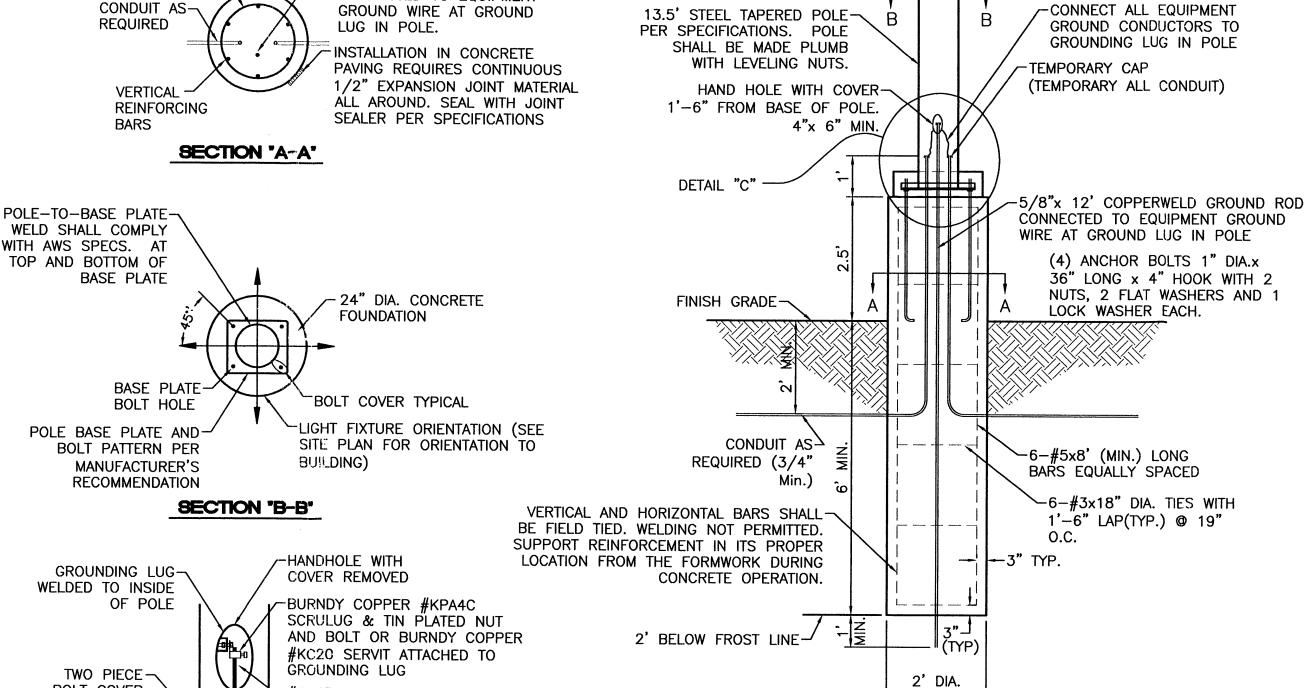

- 1. 3500 PSI MIN. 28 DAY COMPRESSIVE STRENGTH CONCRETE WITH GRADE 60 REINFORCING STEEL
- 2. IF WATER IS PRESENT IN HOLE, REMOVE BEFORE POURING CONCRETE. 3. FOUNDATION EXCAVATION SHALL BE BY 24" AUGER IN UNDISTURBED OR PROPERLY COMPACTED
- FILL PER SPECIFICATIONS. 4. FOUNDATION SHALL HAVE A MINIMUM ALLOWABLE END BEARING OF 2000 PSF.
- 5. FOUNDATION HAS BEEN DESIGNED FOR A COHESIVE SOIL BASED ON A MINIMUM COHESIVE
- VALUE OF 1000 PSF. 6. FOUNDATION HAS BEEN DESIGNED FOR A GRANULAR SOIL BASED ON A MINIMUM LATERAL SOIL PRESSURE OF 1000 PSF, UTILIZING AASHTO FIGURE 1.8.2C(4) OF "EMBEDMENT OF POSTS WITH OVERTURNING LOADS".
- 7. EXPOSED CONCRETE SHALL BE PAINTED TRAFFIC YELLOW.
- 8. DETAIL FOR 39' POLE WITH MAX. FIXTURE EPA 4.6 SQ.FT.

#### TYPICAL LIGHTING POLE BASE DETAIL


## NOTES: CONC. HC RAMP -

- 1. THE SURFACE OF RAMP AND SIDES SHALL HAVE A TRANSVERSE BROOMED SURFACE TEXTURE ROUGHER THAN THE SURROUNDING SIDEWALK.
- 2. THE RAMP SHALL BE GROOVED IN A TRANSVERSE PATTERN WITH 1/4" GROOVES APPROXIMATELY 1-1/2" O.C. SEE SECTION
- 3. THE BOTTOM OF THE RAMP SHALL HAVE A 1/4" LIP OF 45.
- 4. RAMP SIDE SLOPE VARIES UNIFORMLY FROM A MAXIMUM OF UP TO 10% AT CURB TO CONFORM WITH LONGITUDINAL SIDEWALK SLOPE ADJACENT TO TOP OF THE RAMP.
- 5. CONSTRUCT PER A.D.A. STANDARDS.

### **PLAN**

SLOPE 1:12 MAX.


CURB -

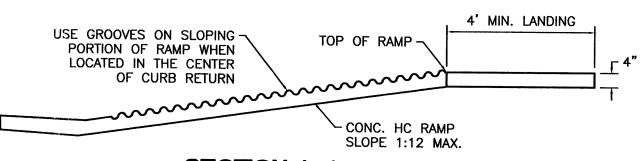

SECTION A-A

UNIDIRECTIONAL HC RAMP

SCALE: NTS

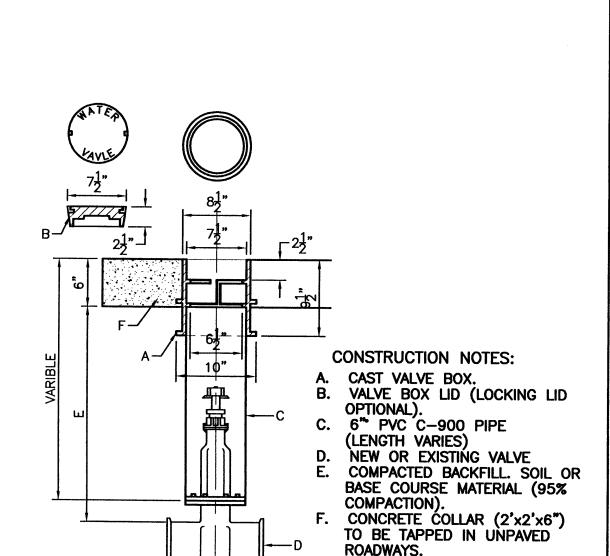

#### GATE VALVE DETAIL

PAINT COLOR TO

IDENTIFY UTILITY ..

#4 REBAR

(SEE BELOW)

WELD TO PLATE

3/16" x10"x10'

STEEL PLATE

UTILITY

SEWER

WATER

STORM DRAIN

**ELECTRICAL** 

TELCO/CATV

FUTURE SITE LIGHTING

FIBER OPTIC (GAS STATION)

TYPICAL UTILITY MARKER

TAG WITH SPECIFIC

REBAR IS TO BE CUT

TO PAVING

COLOR

**GREEN** 

BLUE

WHITE

RED

YELLOW

**ORANGE** 

PURPLE


USE AT CAPPED END OF ALL UTILITY SERVICE CONNECTIONS

TO/FROM SAM'S CLUB, WAL\*MART STORES & SUPERCENTERS

OFF 6" BELOW SUBGRADE AFTER UTILITY CONNECTION

IS COMPLETED AND PRIOR

UTILITY, SIZE, AND DEPTH TO INVERT

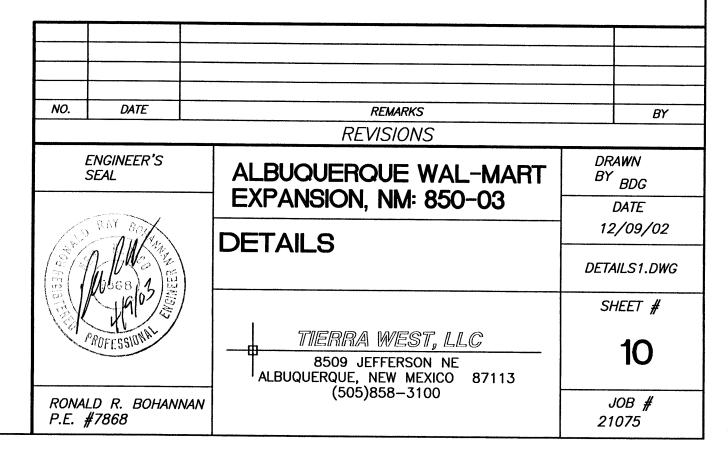

PIPE SIZE	ELBOW ANGLE	ELBOW (B) DIM.	ELBOW (H) DIM.	TEE OR PLUG (B) DIM.	TEE OR PLUG (H) DIM.	
4"	90°,45°	2'	2'	2'	2'	
4"	22.5°,11.25°	2'	2'			
6"	90°,45°	2'	2'	2'	2'	
6"	22.5°,11.25°	2'	2'			
8"	90.	3'	3'	3'	3'	
8"	45°	2'	2'			
8"	22.5°,11.25°	2'	2'			
10"	90°	3'-6"	3'-6"	3'	3'	
10"	45*	3'	3'			
10"	22.5°,11.25°	2'	2'			
12"	90°	4'	4'	3'-6"	3'-6"	
12"	45°	3'-6"	3'-6"			
12"	22.5°,11.25°	2'	2'			
14"	90°	5'	5'	4'	4'	
14"	45*	3'-6"	3'-6"			
14"	22.5,11.25	3'	3'			


CONSTRUCTION NOTE: A. UNIDISTURBED EARTH


B. O.D. OF PIPE +6"

C. O.D. OF CAP OR PLUG, MIN. 12"x12"


#### CONCRETE BLOCKING DESIGN


PER COA STD DWG #2320

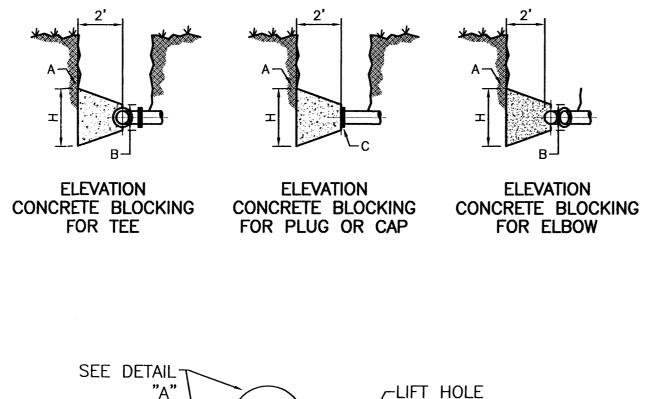

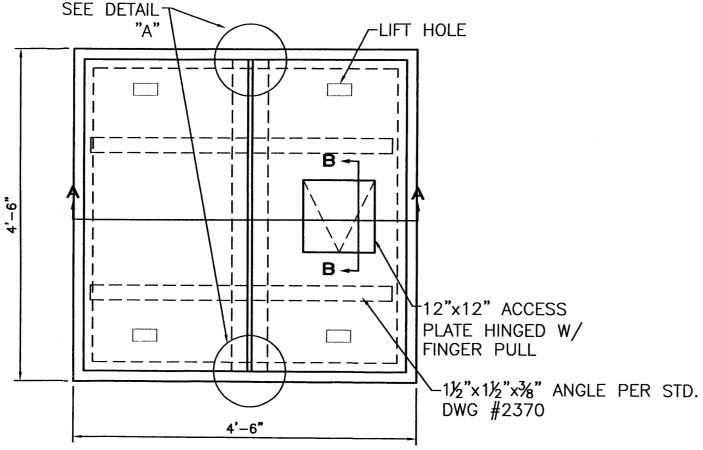



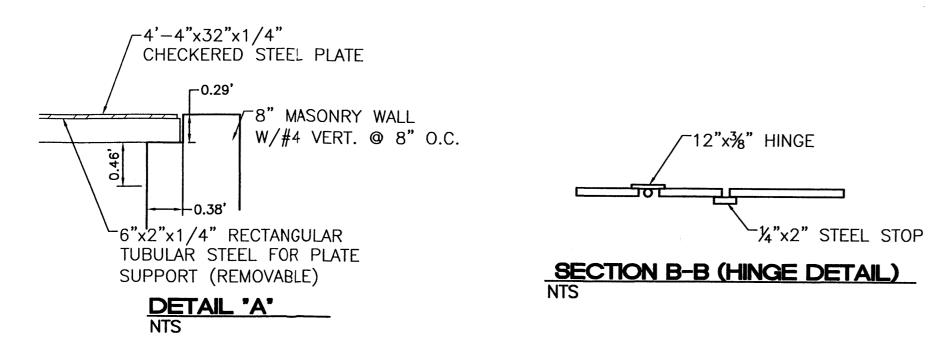

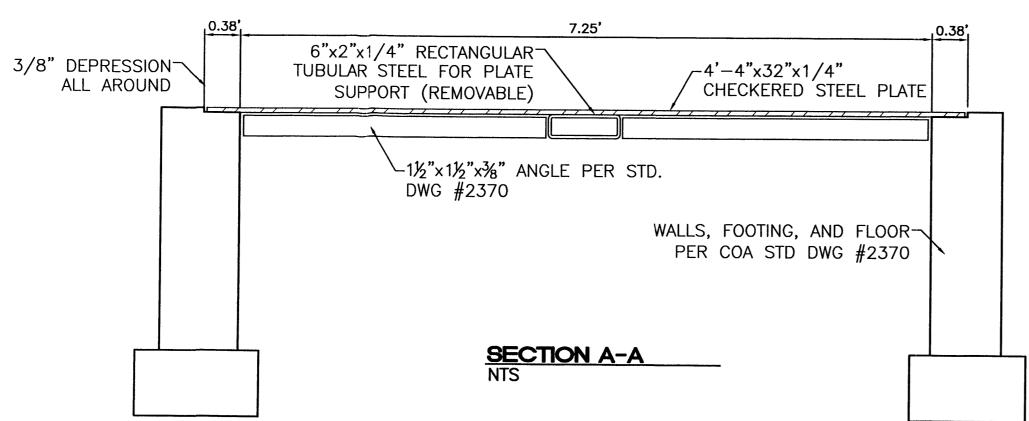


1. ALL EXPOSED STEEL WILL BE PAINTED WITH ONE SHOP COAT AND TWO


FINISH COATS OF ALUMINUM PAINT (AASHTO M 69). 2. STEEL PLATE WILL HAVE A CHECKERED, NON-SKID PATTERN.

3. COMPRESSIVE STRENGTH FOR ALL CONCRETE SHALL BE 3000 PSI.


3" METER PIT DETAIL

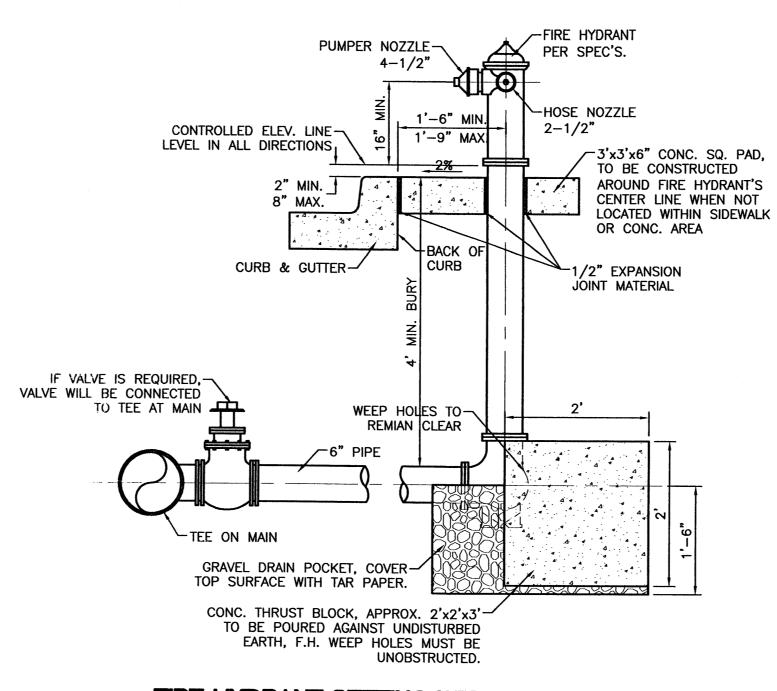


FIRE HYDRANT SETTING WITH BLOCKING DETAIL SCALE: 3/4"=1' PER COA STD DWG #2340

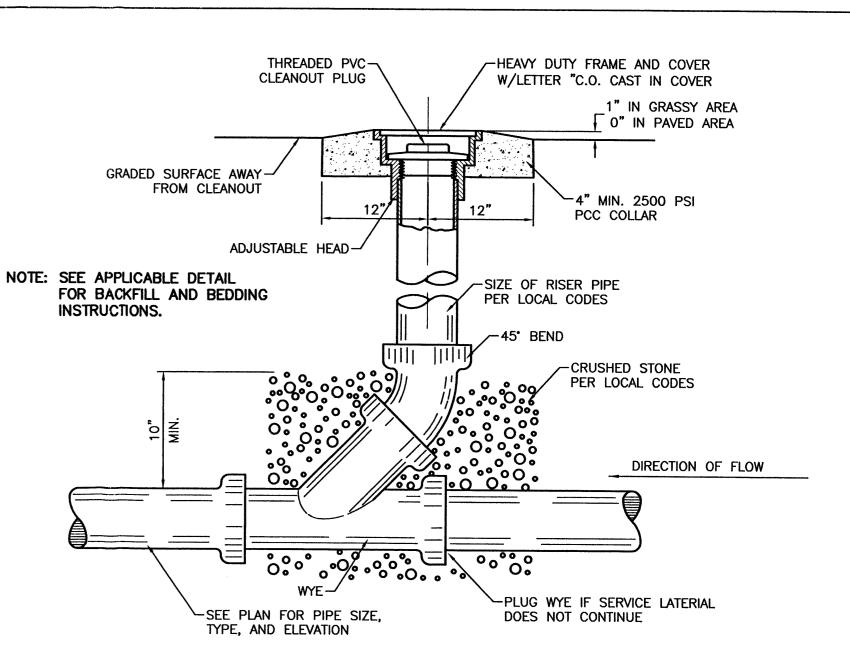



SANITARY SEWER CLEAN-OUT

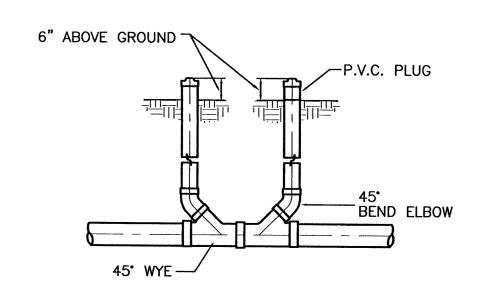

DOUBLE CLEAN-OUT

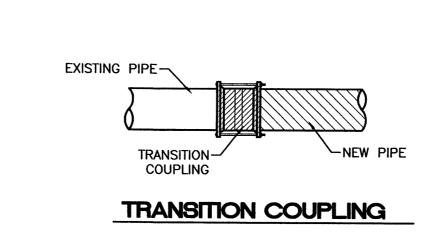

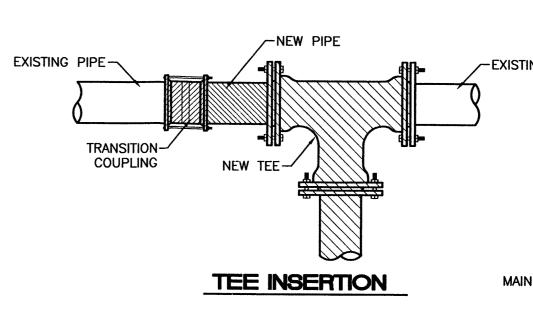


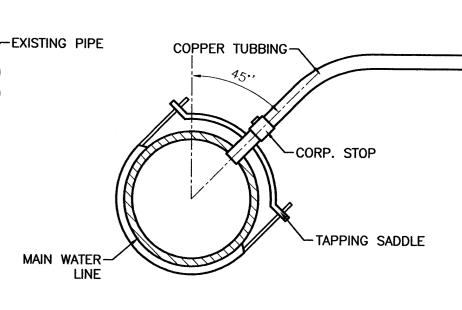



WATER CONNECTION DETAILS

SERVICE TAP CONNECTION

NO. DATE	REMARKS REVISIONS		BY	
ENGINEER'S SEAL	ALBUQUERQUE WAL-MART EXPANSION, NM: 850-03		DRAWN BY BDG	
RAY BAHANANA		DATE 12/09/02  DETAILS1.DWG		
REGISTAL STATE OF THE STATE OF			HEET #	
PROFESSIONAL	8509 JEFFERSON NE ALBUQUERQUE, NEW MEXICO 87113		11	
RONALD R. BOHANI P.E. <b>#</b> 7868	(505)858-3100 NAN		IOB # 1075	

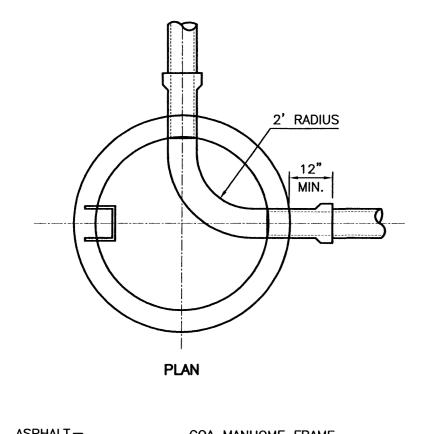

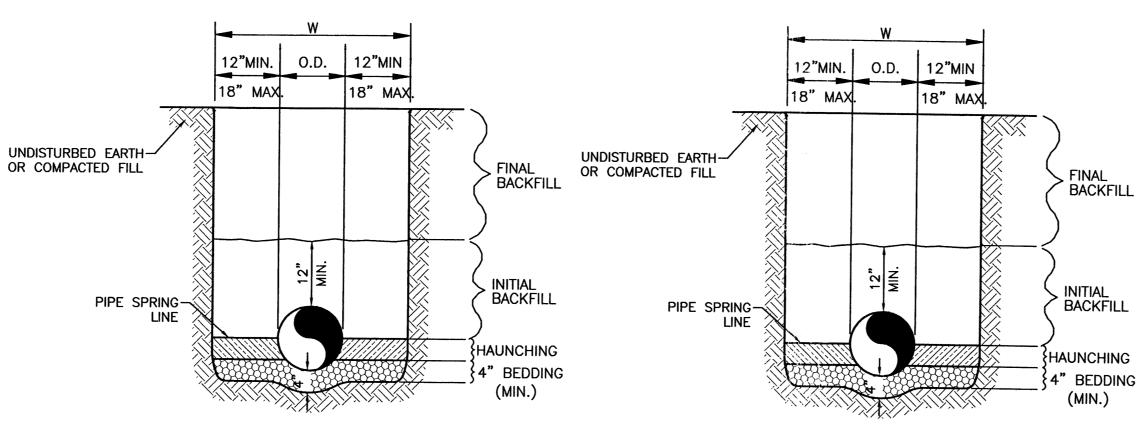

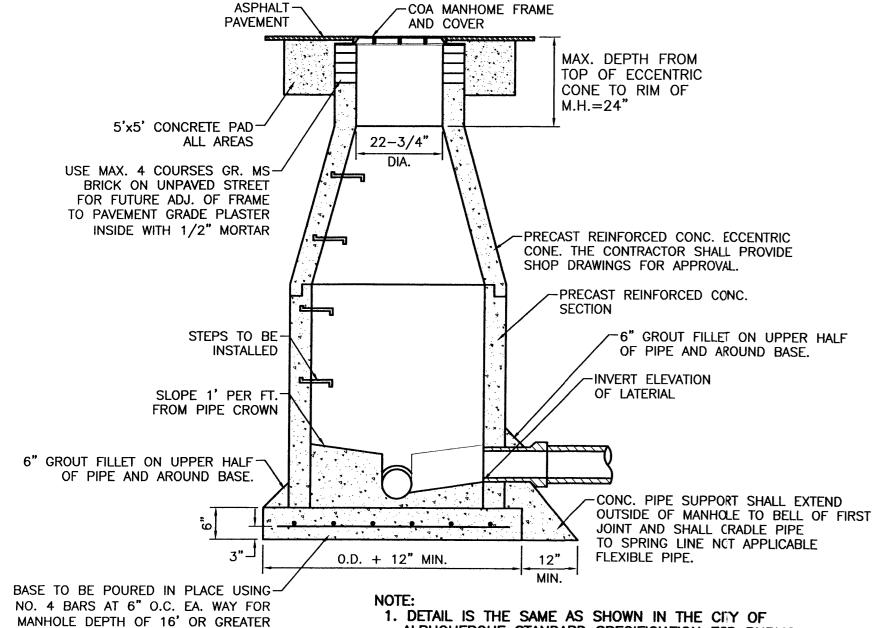

NO. 4 BARS AT 12" O.C. EA. WAY FOR

MANHOLE LESS THAN 16' DEEP.

WATER LINE


#### SANITARY SEWER

#### **GENERAL NOTES**

- 1. BEDDING SHALL BE CLASS I—A WORKED BY HAND. IF GROUNDWATER IS ANTICIPATED, THEN BEDDING SHALL BE CLASS I—B COMPACTED TO 85% STANDARD PROCTOR. (SEE SPECIFICATIONS FOR GRADATION)
- 2. HAUNCHING SHALL BE WORKED AROUND THE PIPE BY HAND TO ELIMINATE VOIDS AND SHALL BE CLASS I—A OR CLASS I—B OR CLASS II COMPACTED TO 85% PROCTOR.
- 3. INITIAL BACKFILL SHALL BE CLASS I—A WORKED BY HAND, OR CLASS I—B OR CLASS II COMPACTED TO 85% STANDARD PROCTOR.
- 4. INITIAL BACKFILL NOT UNDER PAVED AREAS CAN BE CLASS III COMPACTED TO 90% STANDARD PROCTOR.
- 5. FINAL BACKFILL SHALL BE CLASS I, II, OR III COMPACTED AS NOTED IN NOTES 3. AND

- FINAL BACKFILL NOT UNDER PAVED AREAS CAN BE CLASS IV-A COMPACTED TO 95% STANDARD PROCTOR.
- 7. ALL MATERIALS ARE CLASSIFIED IN ACCORDANCE WITH ASTM D 2321-89.
- MAXIMUM 8" LOOSE LIFTS IN ACCORDANCE WITH ASTM D 698. CLASS III AND IV—A MATERIALS SHALL BE COMPACTED NEAR OPTIMUM MOISTURE CONTENT.
- 9. FILL SALVAGED FROM EXCAVATION SHALL BE FREE OF DEBRIS, ORGANICS AND ROCKS LARGER THAN 3".
- 10. ALL TRENCH EXCAVATIONS SHALL BE SLOPED, SHORED, SHEETED, BRACED, OR OTHERWISE SUPPORTED IN COMPLIANCE WITH OSHA REGULATIONS AND LOCAL ORDINANCES. (SEE SPECIFICATIONS)

UTILITY TRENCH AND BEDDING DETAIL

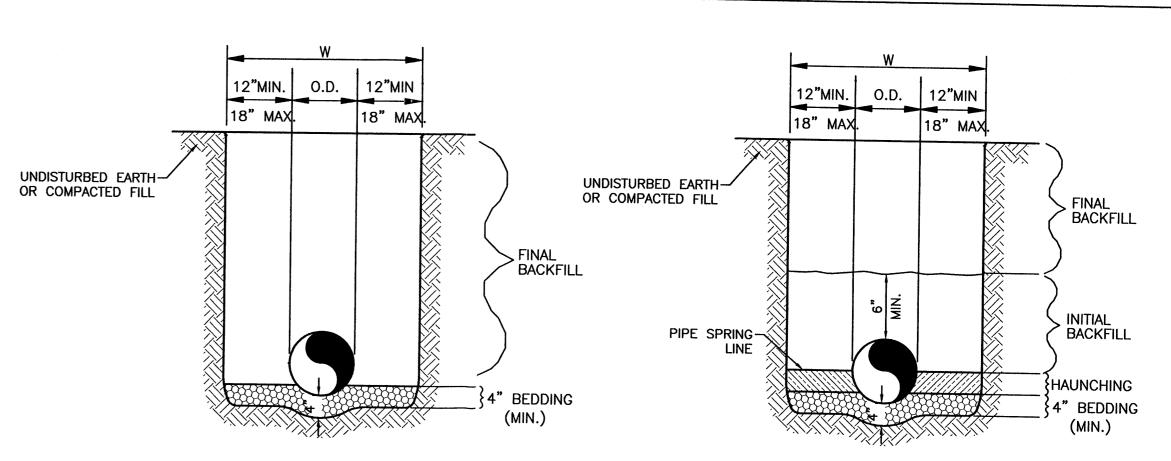

# REINFORCED CONCRETE PIPE (RCP) AND CONTECH SPIRAL RIB PIPE SMALLER THAN 60'

#### **GENERAL NOTES**

- 1. BEDDING SHALL BE CLASS I—A WORKED BY HAND. IF GROUNDWATER IS ANTICIPATED, THEN BEDDING SHALL BE CLASS I—B COMPACTED TO 85% STANDARD PROCTOR. (SEE SPECIFICATIONS FOR GRADATION)
- 2. HAUNCHING SHALL BE WORKED AROUND THE PIPE BY HAND TO ELIMINATE VOIDS AND SHALL BE CLASS I—A OR CLASS I—B OR CLASS II COMPACTED TO 85% PROCTOR.
- 3. INITIAL BACKFILL SHALL BE CLASS I—A WORKED BY HAND, OR CLASS I—B OR CLASS II COMPACTED TO 85% STANDARD PROCTOR.
- CAN BE CLASS III COMPACTED TO 90% STANDARD PROCTOR.

4. INITIAL BACKFILL NOT UNDER PAVED AREAS

5. FINAL BACKFILL SHALL BE CLASS I, II, OR III COMPACTED AS NOTED IN NOTES 3. AND 4.

- ALL OTHER PIPES INCLUDING CONTECH SPIRAL RIB PIPE 60' AND LARGER
- 6. FINAL BACKFILL NOT UNDER PAVED AREAS CAN BE CLASS IV—A COMPACTED TO 95% STANDARD PROCTOR.
- ALL MATERIALS ARE CLASSIFIED IN ACCORDANCE WITH ASTM D 2321—LATEST EDITION.
   ALL MATERIALS SHALL BE INSTALLED IN MAXIMUM 8" LOOSE LIFTS IN ACCORDANCE

WITH ASTM D 698. CLASS III AND IV-A


MATERIALS SHALL BE COMPACTED NEAR

9. FILL SALVAGED FROM EXCAVATION SHALL BE FREE OF DEBRIS, ORGANICS AND ROCKS

LARGER THAN 3".

10. ALL TRENCH EXCAVATIONS SHALL BE SLOPED, SHORED, SHEETED, BRACED, OR OTHERWISE SUPPORTED IN COMPLIANCE WITH OSHA REGULATIONS AND LOCAL ORDINANCES. (SEE SPECIFICATIONS)

STORM SEWER TRENCH AND BEDDING DETAIL

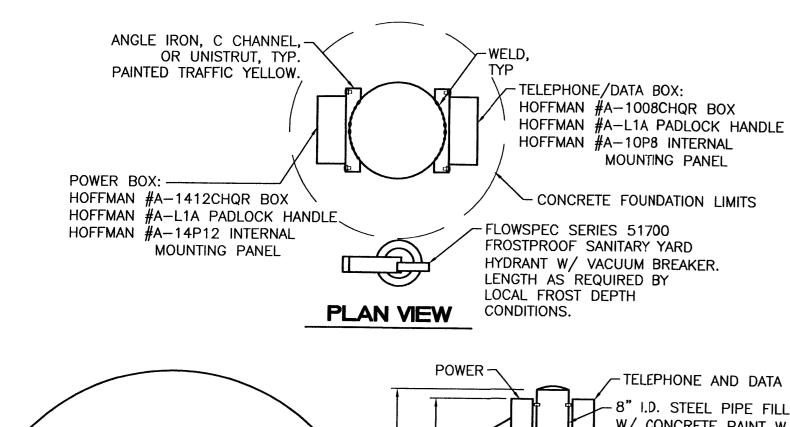

ALBUQUERQUE STANDARD SPECIFICIATION FOR PUBLIC

2. USE NON-SHRINK GROUT FOR JOINTS, FILLETS, AND


3. COMPACT ALL BACKFILL AROUND MANHOLES TO 95%.4. POSITION MANHOLE OPENING OVER THE UPSTREAM

WORKS DRAWING NO. 2102.

PIPE PENETRATIONS

SIDE OF MAIN LINE.

SEWER MANHOLE TYPE 'E' DETAIL

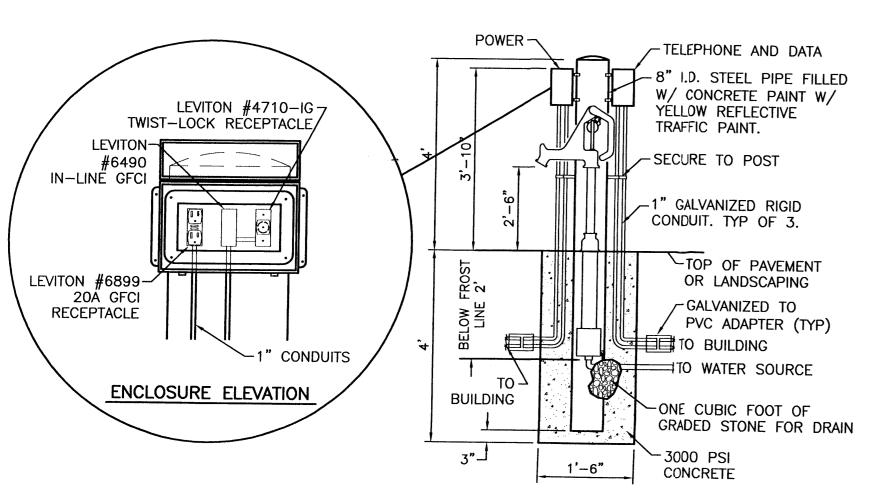

REMOTE GARDEN CENTER UTILITIES BOLLARD DETAIL

NO. DATE REMARKS
REVISIONS

ENGINEER'S SEAL

ALBUQUERQUE WAL-MART BY BDG
EXPANSION, NM:850-03

DATE
12/08/02

P.E. #7868

ENGINEER'S
SEAL

ALBUQUERQUE WAL-MART
EXPANSION, NM:850-03

DATE
12/09/02

DETAILS

DETAILS

DETAILS 1.DWG

SHEET #

12

RONALD R. BOHANNAN

RONALD R. BOHANNAN

ALBUQUERQUE, NEW MEXICO 87113
(505)858-3100

JOB #

21075