
DRB - AMENDED SITE PLAN FOR SUBDIVISION LOTS 2 & 3 JJ SUBDIVISTION

DRB - SITE PLAN FOR BUILDING PERMIT LOTS 2 & 3 JJ SUBDIVISTION

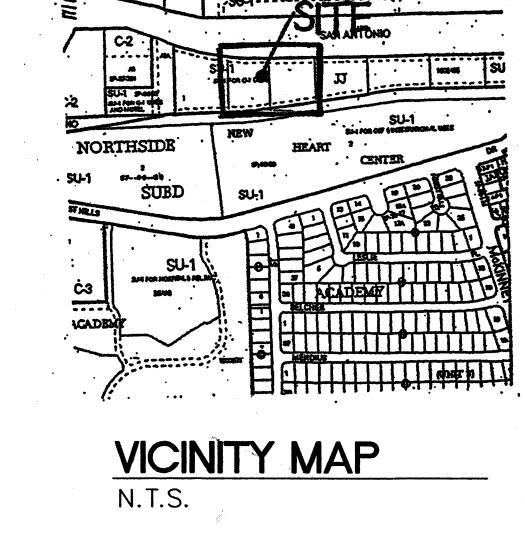



PROJECT LOCATION:

LOT 2 JJ SUBDIVISION
SAN ANTONIO DRIVE NE
ALBUQUERQUE, NEW MEXICO

LESSOR:

TIM OTT 5620 VENICE AVE NE, SUITE J ALBUQUERQUE, NEW MEXICO 87113

FOR:

NEW MEXICO OFFICE OF STATE ENGINEER 121 TIJERAS NE ALBUQUERQUE, NEW MEXICO 87502

ARCHITECT:

MIKE DEL MASTRO 5620 VENICE AVE NE, SUITE J ALBÜQUERQUE, NEW MEXICO 87113

CONTRACTOR:

ISBS, LLC 5620 VENICE AVE NE, SUITE J ALBUQUERQUE, NEW MEXICO 87113

INDEX TO DRAWINGS:

CS - COVER SHEET

SDP - AMENDED SITE DEVELOPMENT PLAN FOR SUBDIVISION LOTS 2 &3

SD-1 - PREVIOUSLY APPROVED 08 EPC-00147-EPC SDP-S

DRB SP - SITE PLAN FOR BUILDING PERMIT

DRB SPDS - SITE PLAN DETAIL SHEET FOR BUILDING PERMIT

DRB EVEL - BUILDING & STRUCTURAL ELEVATIONS

DRB LP - LANDSCAPING PLAN

DRB TLC - TRAFFIC CIRCULATION LAYOUT

CON GD — CONCEPTUAL GRADING PLAN

CON UP — CONCEPTUAL UTILITY PLAN 2

ENV-1 — LFG ABATEMENT SYSTEM PLAN

ENV-2 - LFG ABATEMENT SYSTEM ELEVATIONS & SECTION A
ENV-3 - LFG ABATEMENT SYSTEM DETAILS

DESIGN CRITERIA:

ZONING: SU-1 FOR C-1
TYPE OF OCCUPANCY: B
TYPE OF CONSTRUCTION: II-N

GROSS SQUARE FOOTAGE: 33,734 SQ. FT.

| DATE: 1 MAY 2008 | 02 JULY 2008 | 09 OCTOBER 2008 | 27 OCTOBER 2008 | 10 NOVEMBER 2008 | 24 NOVEMBER 2008 | 24 NOVEMBER 2008 | 25 OCTOBER 2008 | 26 OCTOBE

TIM OTT / DEVELOPER
5620 VENCE AVE NE, SUITE G
ALBUQUEROUE, NM. 57113
(505) 250-4675


MICHAEL DEL MASTIRO / ARCHITECT
7308 DELWOOD FD. NE/ (505) 883-4929
ALBUQUEROUE, NEW MEXICO 57110

Project Name

STATE ENGINEERING

ALBUQUERQUE BUILDING

DRB CS

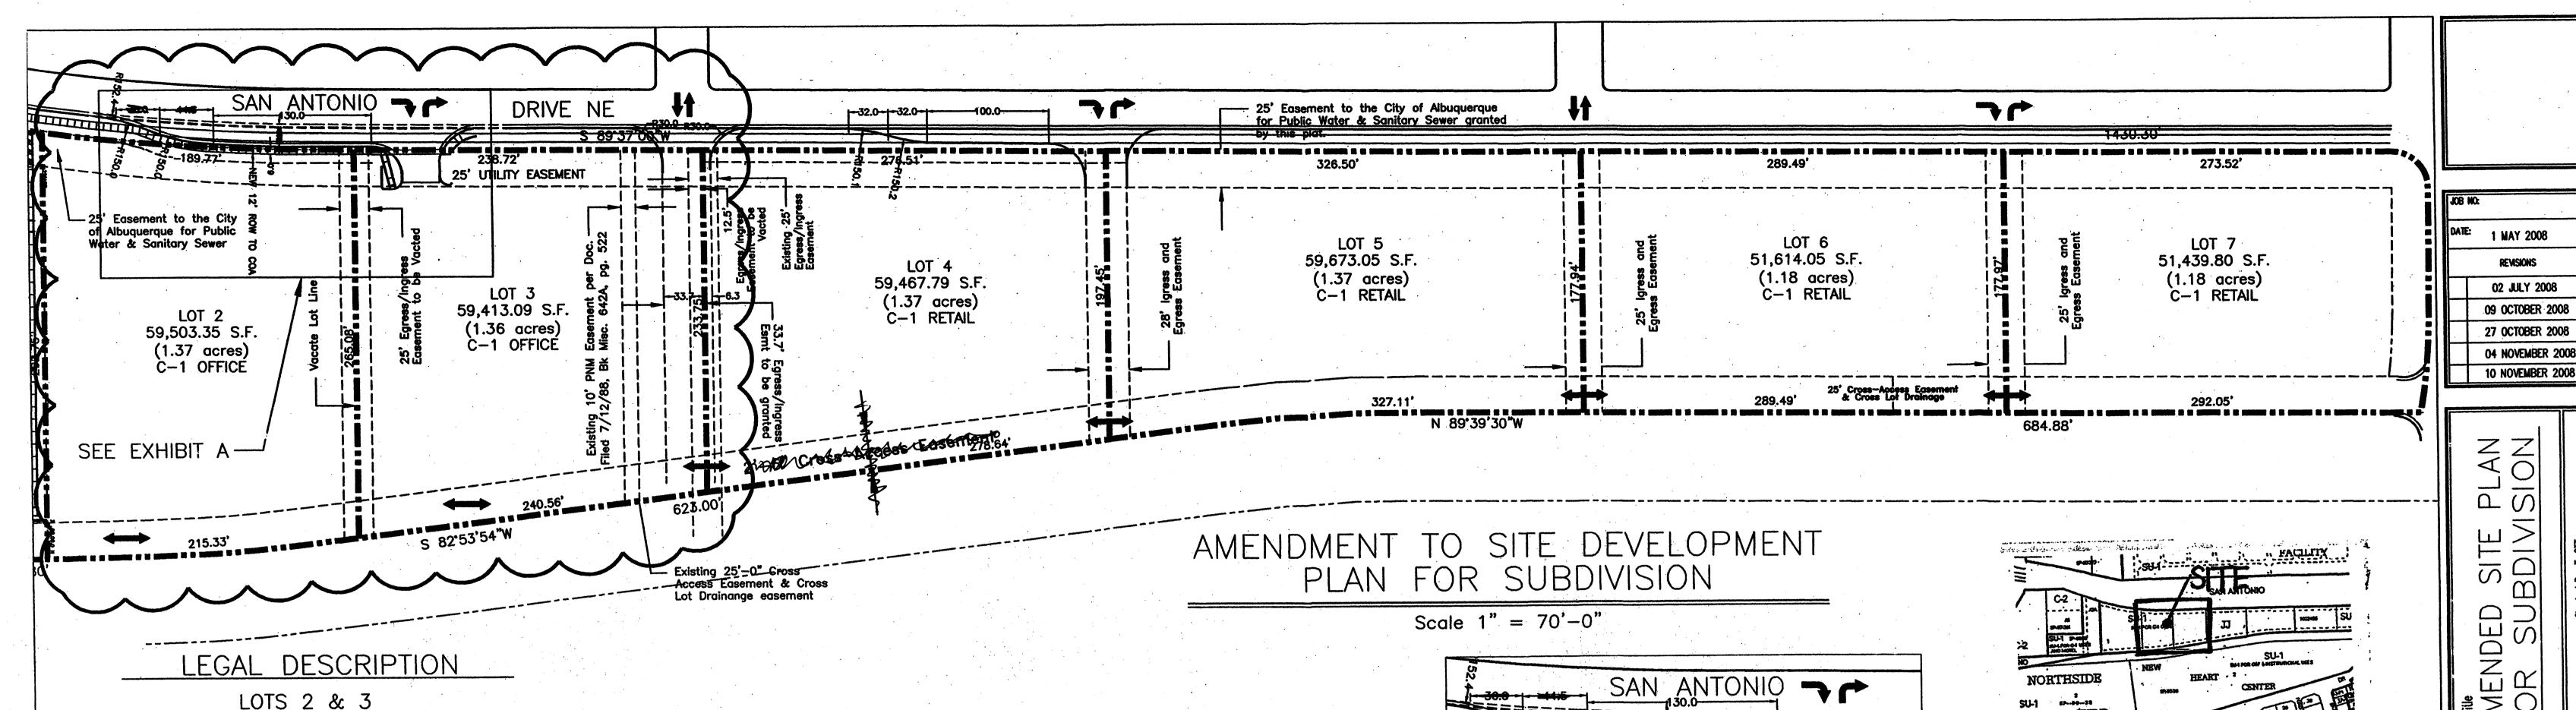

JJ SUBDIVISION

BEING A REPLAT OF TRACT A-3-B. J GROUP ADDITION, TRACT 1, NEW HEART CENTER & TRACT 1, NORTHSIDE SUBDIVISION

WITHIN PROJECTED SECTOIN 25 TOWNSHIP 11 NORTH, RANGE 3 EAST NEW MEXICO PRINCIPAL MERIDIAN ZONING: SU-1 FOR C-1 USES


> CITY OF ALBUQUERQUE BERNALILLO COUNTY **NEW MEXICO**

NOTES: LOTS 2 & 3 BUILDING HEIGHT NOT TO EXCEED 34 FT. MAXIMUM FLOOR-AREA RATIO: 30.0% BUILDING MINIMUM SETBACKS: 25.0 FT.

5.0 FT. **REAR:** 5.0 FT.

TRAFFIC FLOW NOTES

- TRAFFIC FLOW
- RIGHT TURN ONLY INTO LOT
- RIGHT TURN ONLY OUT OF LOT
- TWO WAY INTERIOR AND CROSS-LOT TRAFFIC FLOW

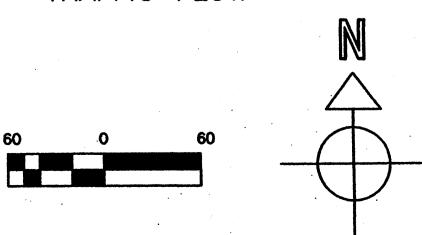


- 2. DESIGN OF BUILDING SHALL BE A COMPATIBLE STYLE, MATERIALS AND COLORS THROUGHOUT
- ENTRY. REQUIRED PARKING SHALL BE DISTRIBUTED ON AT LEAST TWO SIDES OF A
- 5. ALL SIDEWALKS SHALL HAVE A MINIMUM OF 6 FEET CLEAR WALKWAY AREA PROTECT BY PERMANENT CAR STOPS.
- 7. ALL STRUCTURES SHALL BE CONNECTED BY PEDESTRIAN PATHWAYS PER CITY OF
- 8. PATIO AREAS FOR EMPLOYEES SHALL BE PROVIDED AND SHADED.
- BICYCLE RACKS SHALL BE PROVIDED PER COA CODE.

 10. ALL LANDSCAPING SHALL BE PER COA CODE. NO GREATER THAN 20% OF LANDSCAPED AREA SHALL BE HIGH WATER USE AND ALL APPLICABLE WATER CONSERVATION MEASURES REQUIRED AT THE TIME OF BUILDING PERMIT APPLICATION SHALL BE ADHERED TO PLANTS SHALL BE CLUSTERED TO ALLOW WATER HARVESTING. CLUSTERING WILL CONCENTRATE GROUND COVERAGE IN PLANTED AREAS WITH DECORATIVE NON-PLANT GROUND COVER IN NON-PLANTED AREAS. ALL LANDSCAPING SHALL BE IN COMPLIANCE WITH THE LANDFILL GAS
- FROM VIEW OR PAINTED TO BLEND WITH SURROUNDING STRUCTURE'S COLOR. ALL ROOF PENETRATIONS SHALL MATCH STRUCTURE OR ROOF COLOR.
- PORTALS, AWNINGS, OR SHADE TREES PLANTED IN A MANNER TO SHADE THE ENTIRE FRONT FACADE OF THE STRUCTURE.
- 16. MONUMENT SIGNS ARCHITECTURALLY INTEGRATED WITH THE STRUCTURE DESIGN SHALL NOT
- EXCEED 10 FEET HIGH OR 75 SQUARE FEET PER SIGN.
- 18. SITE AND BUILDING LIGHTING SHALL BE FULLY SHIELDED AND COMPLY WITH SECTION 14-16-3-9 OF THE COA ZONING CODES AND WITH THE NM NIGHT SKY PROTECTION ACT.
- 19. 3'-0" HIGH BOLLARD ILLUMINATION (AT LEAST ONE) AT CURB RAMPS ENTERING A CROSSWALK, BE ONE DESIGN TYPE, FULLY SHIELDED.
- 20. ALL CROSSWALKS TO BE TEXTURED WITH COLORED CONCRETE OR BRICK PAVING.

GENERAL DESIGN CRITERIA:

- 1. ALL STRUCTURES ON LOTS SHALL BE LIMITED TO THE GENERAL CRITERIA DESCRIBED HEREIN.
- LOTS 2 -7. 3. PARKING SHALL NOT EXCEED THE REQUIRED PLUS 10%.
- 4. ACCESSIBLE (ADA) COMPLIANT PARKING SHALL BE LOCATED ADJACENT TO THE MAIN BUILDING BUILDING.
- 6. FRONT ENTRY SIDEWALK AREAS SHALL BE COVERED OR SHADED BY TREES.
- ALBUQUERQUE (COA) REQUIREMENTS AND THRU VEHICULAR AREAS.
- ABATEMENT PLAN.
- (11.) PERIMETER WALLS SHALL COMPLY WITH PLANNING DEPARTMENT GUIDELINES AT TIME OF BUILDING PERMIT APPLICATION NOT TO EXCEED 3'-4" HIGH.
- 12. ALL ROOF TOP OR GROUND LEVEL MECHANICAL UNITS WILL BE PHYSICALLY SCREENED
- 13. FRONT FACADES SHALL BE SHADED BY EITHER THE BUILDING STRUCTURE, CANOPIES,
- 14. LOADING DOCKS SHALL BE SCREENED BY WALLS, TREES, AND OR STRUCTURE ELEMENTS THAT ARE ARCHITECTURALLY INTEGRATED INTO THE STRUCTURE.
- 15. ALL REFUSE ENCLOSURES SHALL COMPLY WITH COA CODE AND SOLID WASTE REGULATIONS.
- 17. BUILDING SIGNS SHALL NOT EXCEED 6% OF THE FACADE AREA.
- MAXIMUM LIGHTPOLE HEIGHT SHELL BE 18'-0".

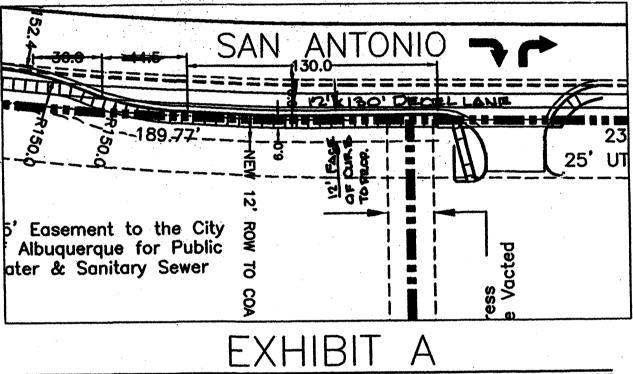

Scale 1" = 50'-0"

VICINITY MAP

"The developers of this site are required to follow the most current version of the City of Albuquerque Interim Guidelines for development within city designated landfill buffer zones. A review and approval of the Site Plan(s) is required. The proposed construction, design drawings, and a certification will be required by the Environmental Health Department (EHD),

Environmental Services Division.'

"The subject property is located on an existing landfill. Due to the subject property being on a landfill, certain precautionary measures may need to be taken to ensure the health and safety of the public. Recommendations made by a professional engineer with expertise in landfills and landfill gas issues (as required by the most current version of the "Interim Guidelines for Development within City - Designated Landfill Buffer Zones") shall be consulted prior to development of the site.


PROJECT NUMBER: <u>1002455</u> Application Number:

Is an Infrastrusture List required? (X) Yes (X) No If yes, then a set of approved DRC plans with a work order is required for any construction within Public Right—of—Way or for construction of public improvements.

DRB SITE DEVELOPMENT PLAN SIGNOFF APPROVAL:

16525	11-20-08
Traffic Engineering, Transportation Division	Date
Roger of Street	8-51-11
-Utilities Development ABCWUR	Date
Christina Sandoval Parks and Recreation Department	11/2/08
Parks and Recreation Department	Date
City Engineer	11-12-08
City Engineer	Date
Environmental Health Department	
Environmental Health Department	Date
N/A Solid Waste Management	
Solid Waste Management	Date
Joch Clark	04-01-09
DRB Chairperson, Planning Department	Date

SDP

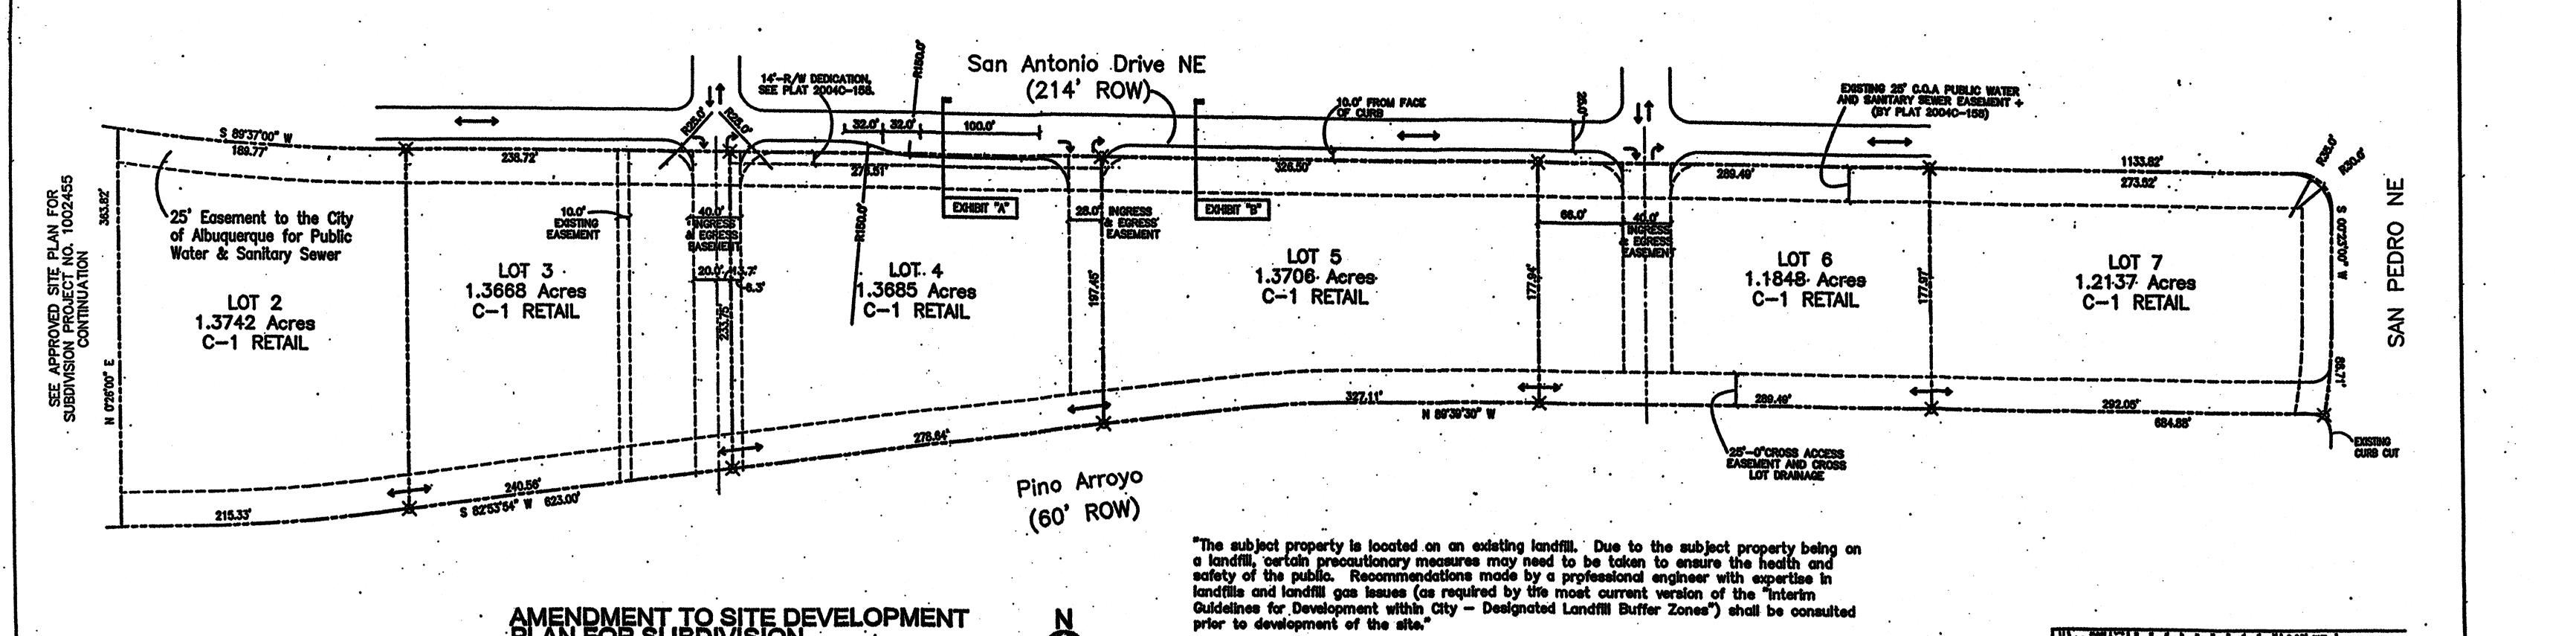

LEGAL DESCRIPTION

LOTS 2 THRU 7 JJ SUBDIVISION BEING A REPLAT OF TRACT A-3-B J GROUP ADDITION, TRACT 1, NEW HEART CENTER & TRACT 1, NORTHSIDE' SUBDIVISION"

WITHIN PROJECTED SECTION 25 TOWNSHIP 11 NORTH, RANGE 3 EAST NEW MEXICO PRINCIPAL MERIDIAN

> CITY OF ALBUQUERQUE. BERNALILLO COUNTY . **NEW MEXICO**

NOTES: LOTS 2 THRU 7

BUILDING HEIGHT NOT TO EXCEED 34 FT. MAXIMUM FLOOR-AREA RATION: 20.0% BUILDING MINIMUM SETBACKS: FRONT: 25.0 FT SIDE: 5.0 FT

TRAFFIC FLOW NOTES

REAR: 5.0 FT

-TWO WAY INGRESS AND EGRESS TRAFFIC FLOW

-RIGHT TURN ONLY INTO LOT

RIGHT TURN ONLY OUT OF LOT

-TWO WAY INTERIOR AND CROSS-LOT TRAFFIC FLOW

GENERAL DESIGN CRITERIA:

AMENDMENT TO SITE DEVELOPMENT PLAN FOR SUBDIVISION

- 1. ALL STRUCTURES ON LOTS WILL BE LIMITED TO THE GENERAL CRITERIA DESCRIBED HERFIN 2. DESIGN OF BUILDING SHALL BE A COMPATIBLE STYLE, MATERIALS AND COLORS THROUGHOUT LOTS 2-7.
- 3. PARKING WILL NOT EXCEED THE REQUIRED PLUS 10%.
- 4. ACCESSIBLE (ADA) COMPLIANT PARKING WILL BE LOCATED ADJACENT TO THE MAIN BUILDING ENTRY, AND REQUIRED PARKING SHALL BE DISTRIBLTED ON AT LEAST TWO SIDES. OF A BUILDING.
- 5. ALL SIDEWALKS WILL HAVE A MINIMUM OF 6 FEET CLEAN WALKWAY AREA PROTECTED BY PERMANENT CAR STOPS.
- 6. FRONT ENTRY SIDEWALK AREAS WILL BE COVERED OR SHADED BY TREES.
 7. ALL STRUCTURES SHALL BE CONNECTED BY PEDESTRIAN PATHWAYS PER CITY OF
- ALBUQUERQUE (COA) REQUIREMENTS AND THRU VEHICULAR AREAS.
 8. PATIO AREAS FOR EMPLOYEES WILL BE PROVIDED AND SHADED.
- 9. BICYCLE RACKS WILL BE PROVIDED PER COA CODE.
- 10. ALL LANDSCAPING WILL BE PER COA CODE. NO GREATER THAT 20% OF LANDSCAPED AREA WILL BE LOW WATER USE AND ALL APPLICABLE WATER CONSERVATIONS MEASURES REQUIRED AT THE TIME OF BUILDING PERMIT APPLICATION WILL BE ADHERED TO. 80% MINIMUM GROUND COVERAGE WITH LOW WATER USE OF NATIVE PLANTS.
- 11. SCREEN WALLS WILL NOT TO EXCEED 3'-4" HIGH, AND SHALL MATCH STUCCO COLOR OF BUILDINGS.
- 12. ALL ROOF TOP OR GROUND LEVEL MECHANICAL UNITS WILL BE PHYSICALLY SCREENED FROM VIEW OR PAINTED TO BLEND WITH SURROUNDING STRUCTURE'S COLOR. ALL ROOF PENETRATIONS WILL MATCH STRUCTURE OR ROOF COLOR.
- 13. FRONT FACADES WILL BE SHADED BY EITHER THE BUILDING STRUCTURE, CANOPIES, PORTALS, AWNINGS, OR SHADE TRESS PLANTED IN A MANNER TO SHADE THERE ENTIRE FRONT FACADE OF THE STRUCTURE.
- 14. LOADING DOCKS SHALL BE SCREENED BY WALLS, TREES, AND OR STRUCTURE ELEMENTS THAT ARE ARCHITECTURALLY INTEGRATED INTO THE STRUCTURE.
- 15. ALL REFUSE ENCLOSURES WILL COMPLY WITH COA CODE AND SOLID WASTE REGULATIONS.
 16. MONUMENT SIGNS ARCHITECTURALLY INTEGRATED WITH THE STRUCTURE DESIGN WILL NOT
- EXCEED 10 FEET HIGH OR 75 SQUARE FEET PER SIGN.
- 17. BUILDING SIGNS SHALL NOT EXCEED 6% OF THE FACADE AREA. 18. SITE AND BUILDING LIGHTING WILL COMPLY WITH COA CODES AND REGULATIONS, FULLY SHIELDED, ONE DESIGN TYPE, FOOTING SHALL MATCH STUCCO COLOR, AND 18'-0" HIGH MAXIMUM.
- 19. 3'-0" HIGH BOLLARD ILLUMINATION (AT LEAST ONE) AT CURB RAMPS ENTERING A CROSSWALK, BE ONE DESIGN TYPE, FULLY SHIELDED.
- 20. ALL CROSSWALKS TO BE TEXTURED WITH COLORED CONCRETE OR BRICK PAYING.

PROJECT NUMBER: 1002455 APPLICATION NUMER:

"THE DEVELOPERS OF THIS SITE ARE REQUIRED TO FOLLOW THE MOST CURRENT VERSION OF THE CITY OF ALBUQUERQUE INTERIM GUIDELINES FOR DEVELOPMENT WITHIN CITY DESIGNATED

LANDFILL BUFFER ZONES. A REVIEW AND APPROVAL OF THE SITE PLAN(S), THE PROPOSED

BY THE ENVIRONMENTAL HEALTH DEPARTMENT (EHD), ENVIRONMENTAL SERVICES DIVISION.

CONSTRUCTION, DESIGN DRAWINGS, AND A CERTIFICATION OF CONSTRUCTION WILL BE REQUIRED

THIS PLAN IS CONSISTENT WITH THE SPECIFIC SITE DEVELOPMENT PLAN APPROVED BY THE ENVIRONMENTAL PLANNING COMMISSION (EPC) DATE FINDING S AN CONDITIONS IN THE OFFICIAL NOTIFICATION OF DECISION ARE SATISFIED.

SITE LOCATION

DRB SITE DEVELOPMENT PLAN-SIGNOFF APPROVAL:

ILSA) 6-11-08 TRAFFIC ENGINEERING, TRANSPORTATION DIVISION DATE 6-11-08 UTILITITES DÉVELOPMENT DATE PARKS AND RECREATIONAL DEPARTMENT DATE enter. Cheme. 6-H-08 CITY ENGINEER DATE ENVRONMENTAL HEALTH DEPARTMENT DATE SOLID WASTE MANAGEMENT DATE 6-11-09 DRB/CHAIRPERSON, PLANNING DEPARTMENT DATE

GRAPHIC SCALE



LOCATION MAP ZONE ATLAS: E-18-Z



1"=60'-0"


AMENDMENT TO SITE DEVELOPMENT PLAN FOR SUBDIVISION

AFRA Construction & Design 2501 Yale Blvd. Suite 102 Albuquerque, New Mexico 87106 Tel 505.998.3128 Tel 505.998.3129

SAN ANTONIO OFFICE & RETAIL ALBUQUERQUE, NM

DATE DESCRIPTION APVD SD-1

6.9.08

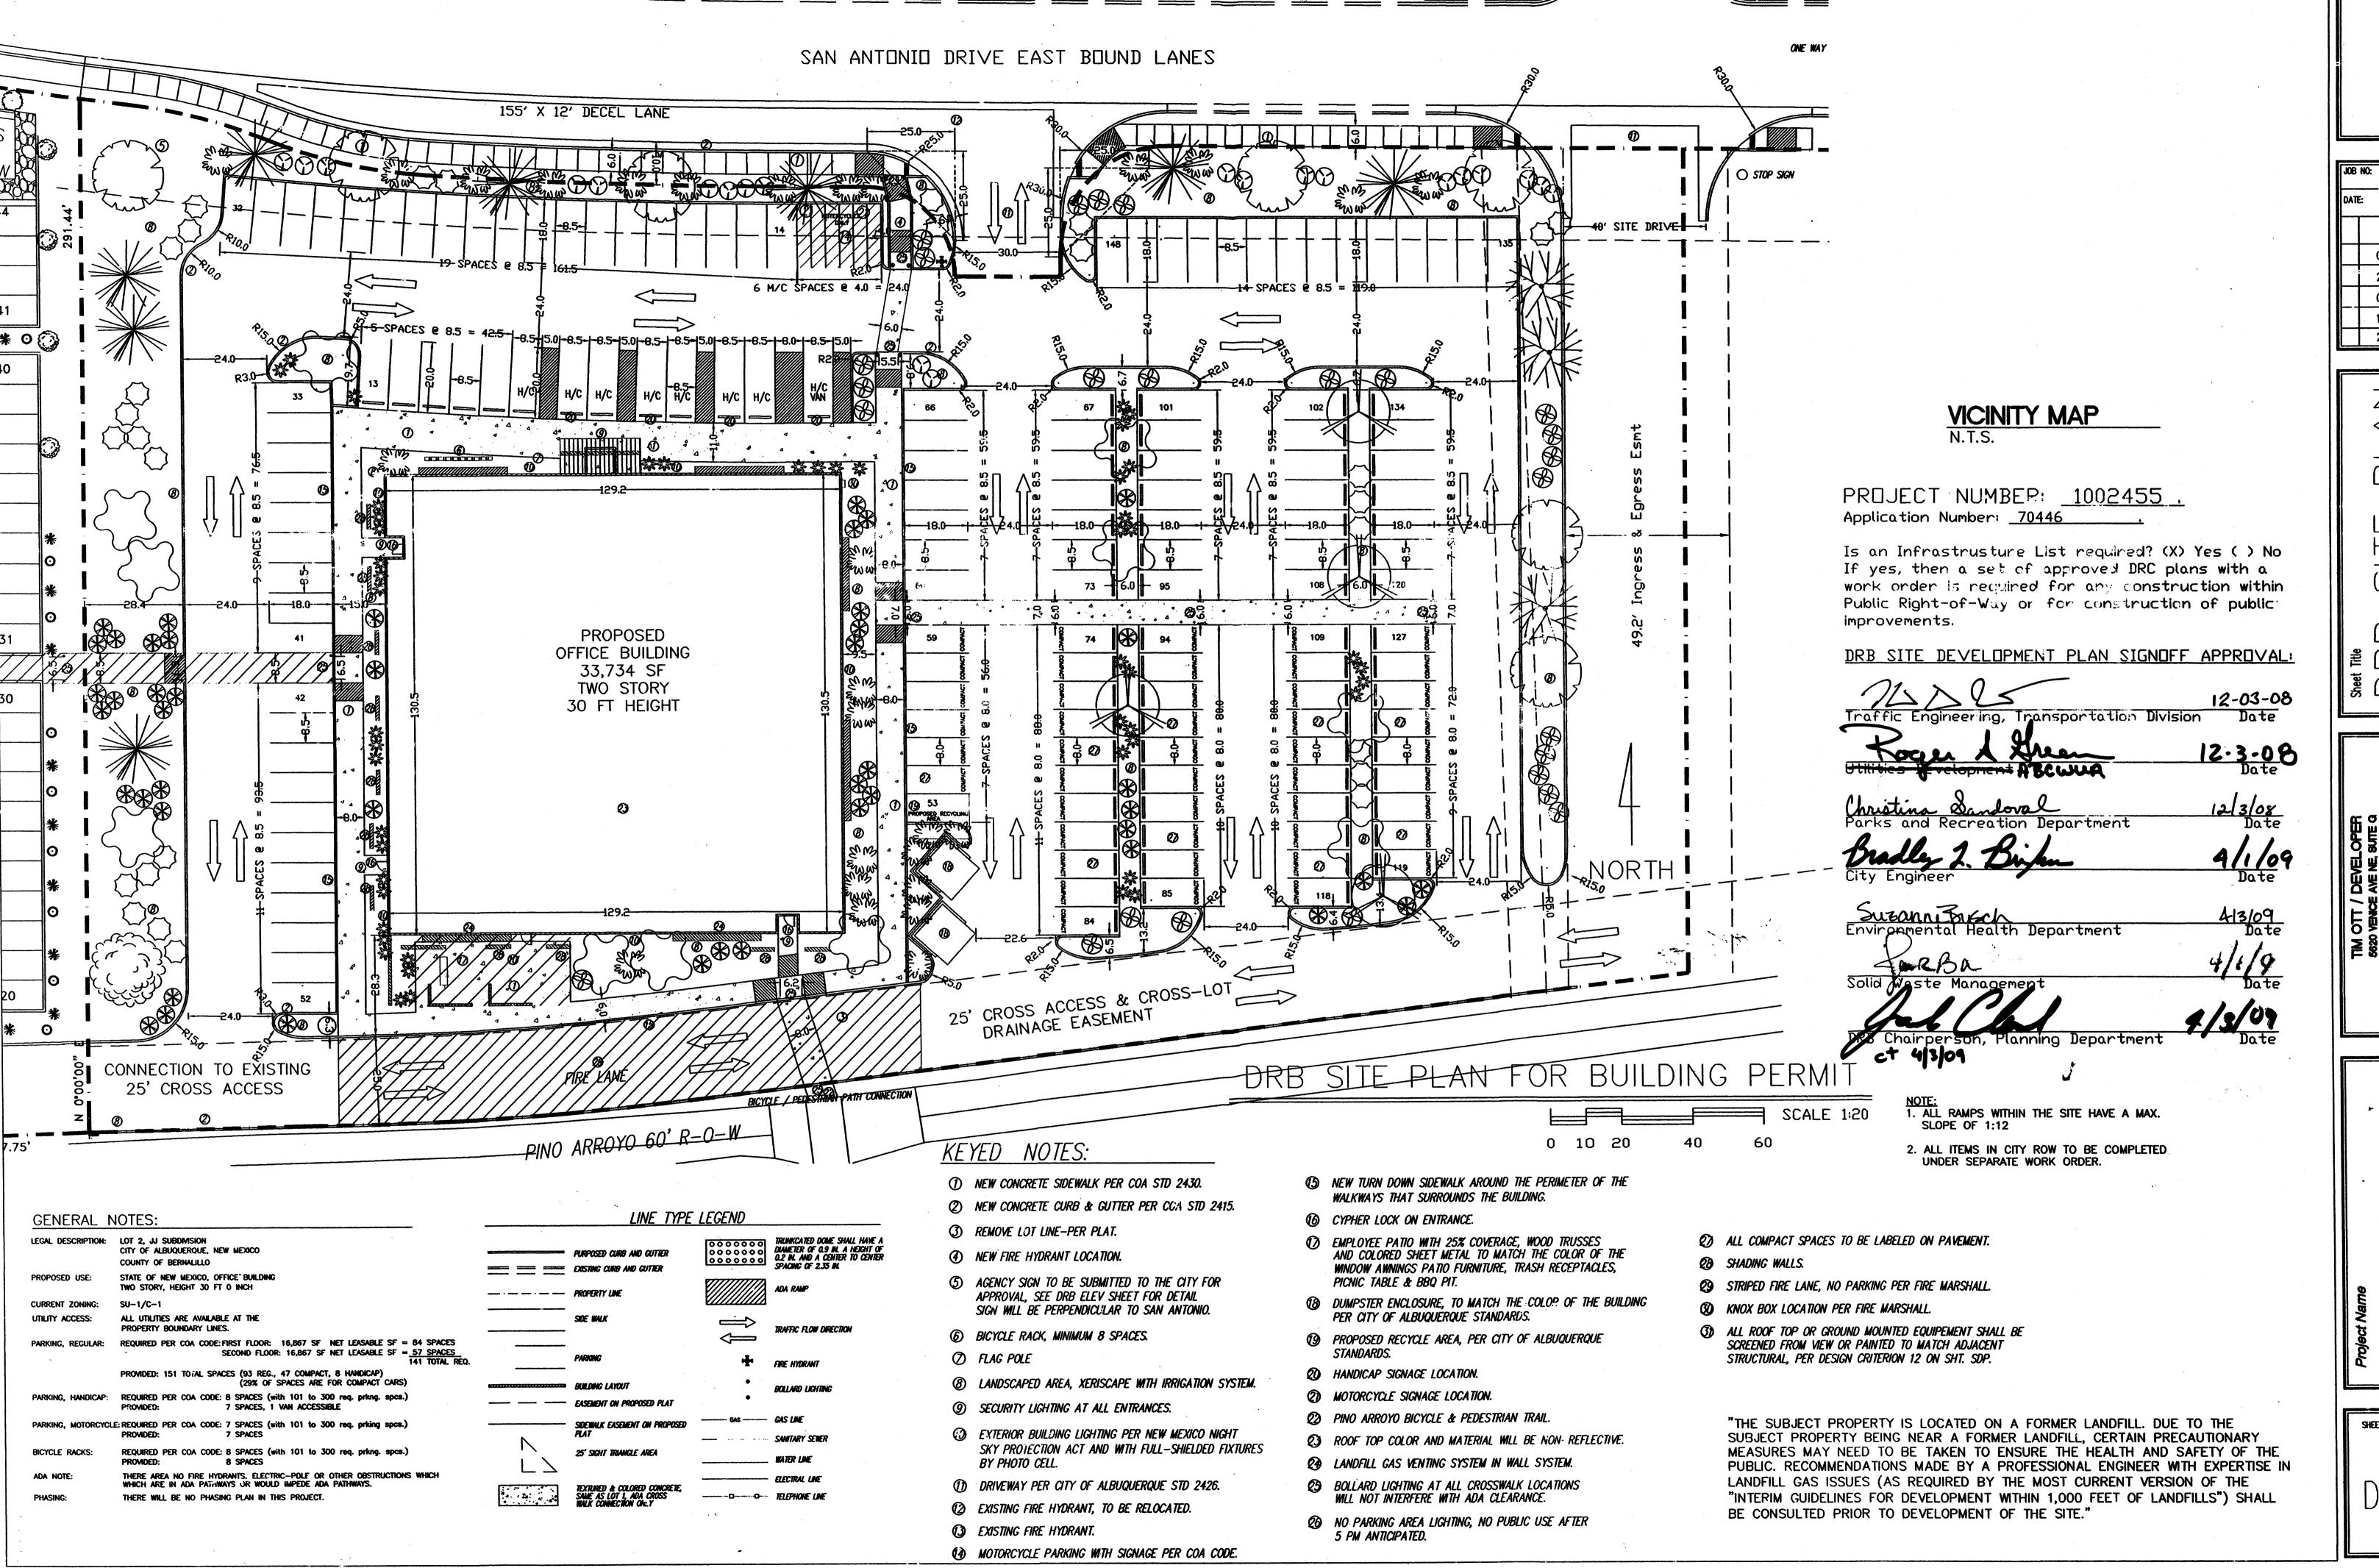

JOB NO:

DATE: 1 MAY 200^

02 JULY 2008

09 OCTOBER 2008

27 OCTOBER 2008

04 NOVEMBER 2008

10 NOVEMBER 2008

24 NOVEMBER 2008


FOR BUILDING PERMIT MAY PESHLAKAI, S.A. Ghecked By. T. OTT

5620 VENICE AVE NE, SUITE G
ALBUQUEROUE, NM. 8713
(505) 250-4675

MICHAEL DEL MASTRO / ARCHITECT
7308 DELWOOD RD. NE/ (505) 883-4828
ALBUQUEROUE, NEW MEXICO 6710

STATE ENGINEERING. ALBUQUERQUE BUILDING


חחח כו

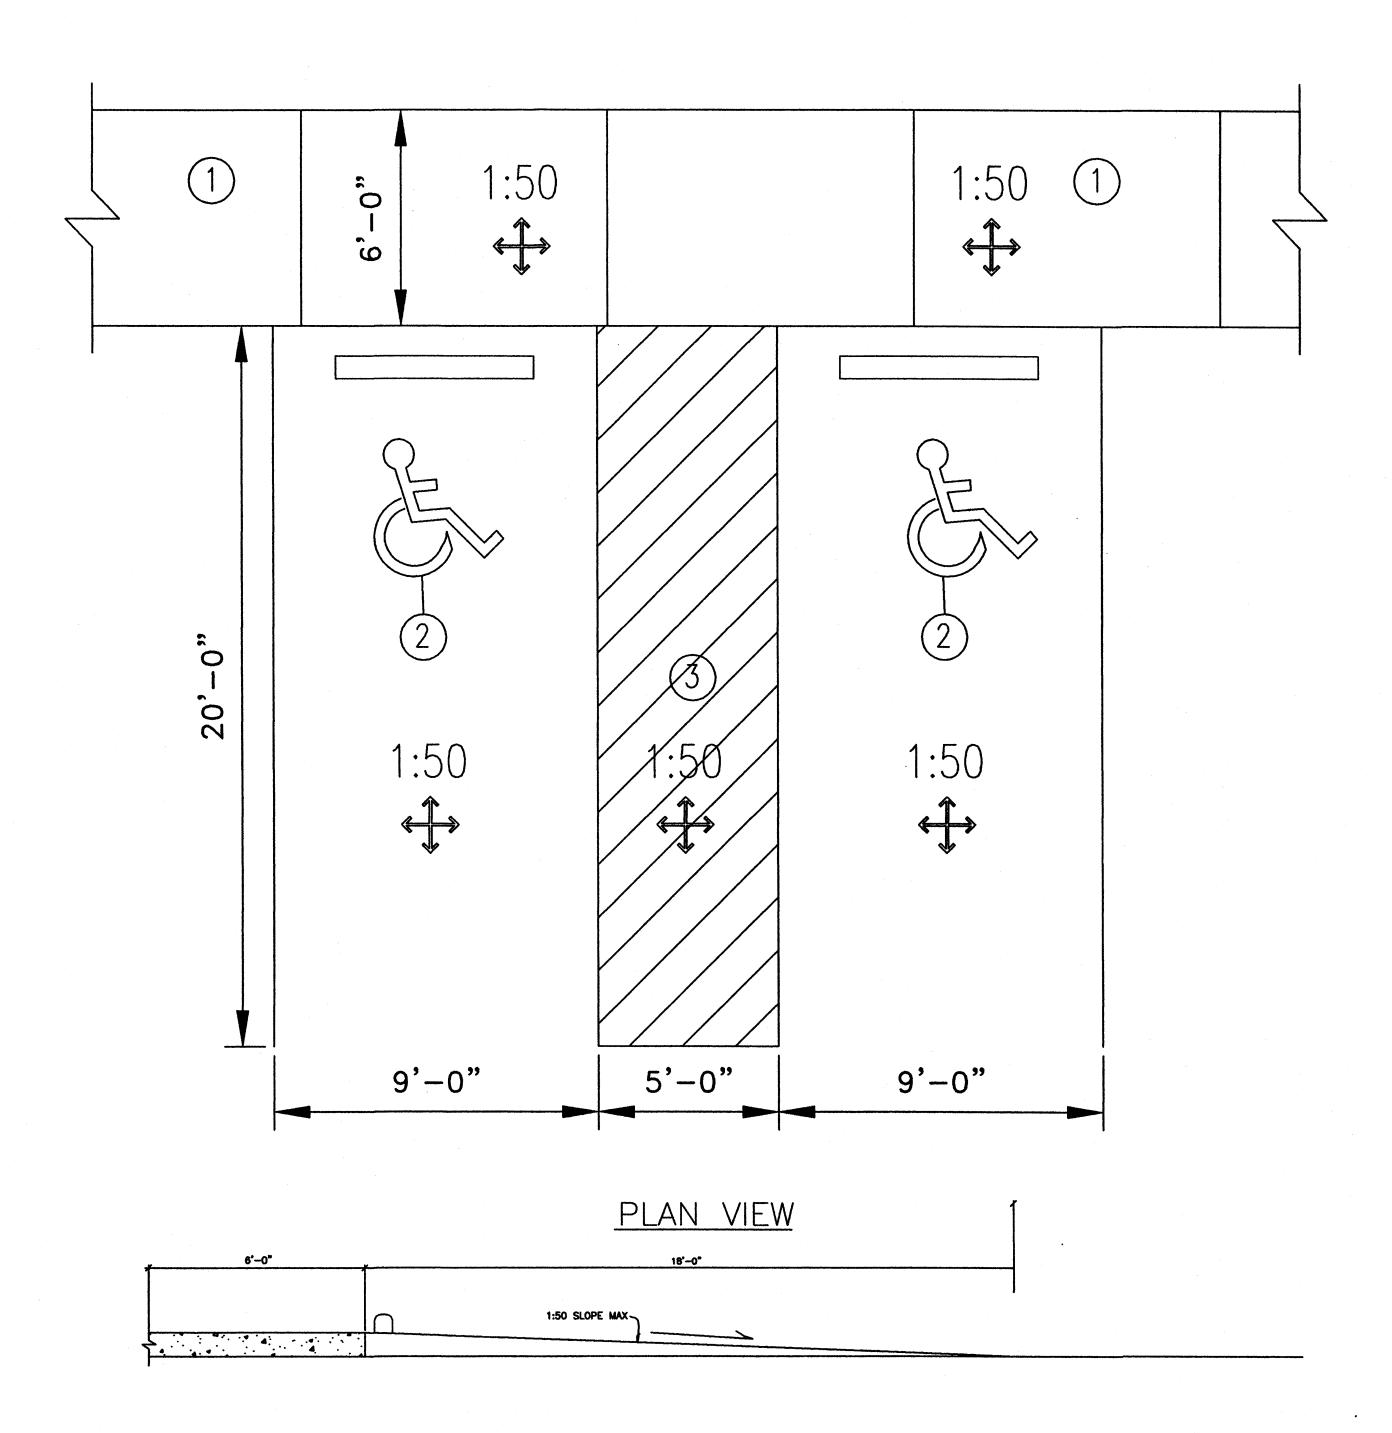


KEYED NOTES:

- 1. 6' SIDEWALK X 4" THK. WITH HEAVY BROOM FINISH.
- 2. ACCESSIBLE PARKING SYMBOL.
- 3. TYPICAL PAINTED PARKING SPACE LINE 4" WIDE.

ENLARGED ACCESSIBLE PARKING, TYPICAL SCALE: N.T.S.

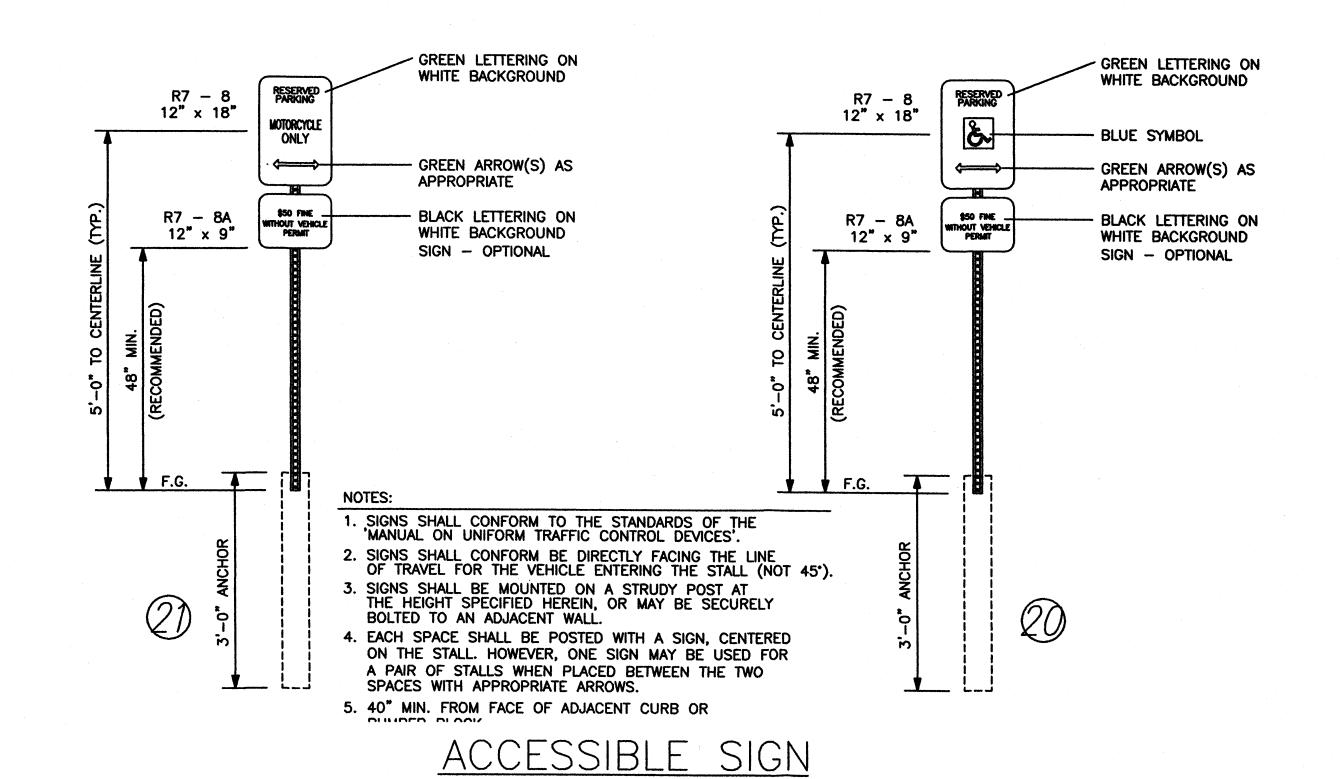


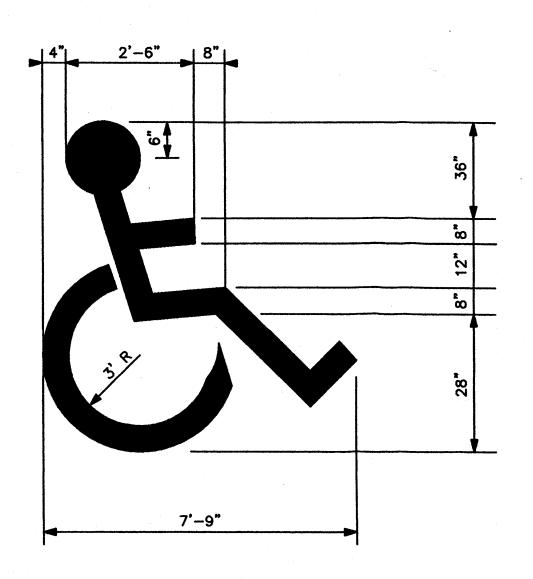

ACCESSIBLE PARKING SYMBOL

SCALE: N.T.S.

SCALE: N.T.S.

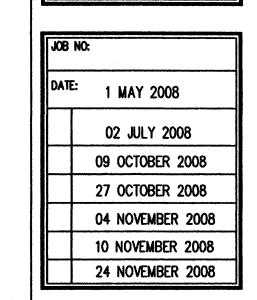

Sheet Title
DRB DETAILS SHEET
FOR BUILDING PERMIT


Morm By. PESHLKKI, S.A. Checked By. 1. 0T1


5620 VENCE AVE NE, 8UTE G
ALBUOUEROUE, N.M. 87113
(505) 250-4675
MCHAEL DEL MASTRO / ARCHITECT
7308 DELWOOD RD. NE/ (505) 883-4829
ALBUOUEROUE, NEW MEXICO 87110

ATE ENGINEERING
BUQUERQUE BUILDING


SHEET NO.

DRB DS

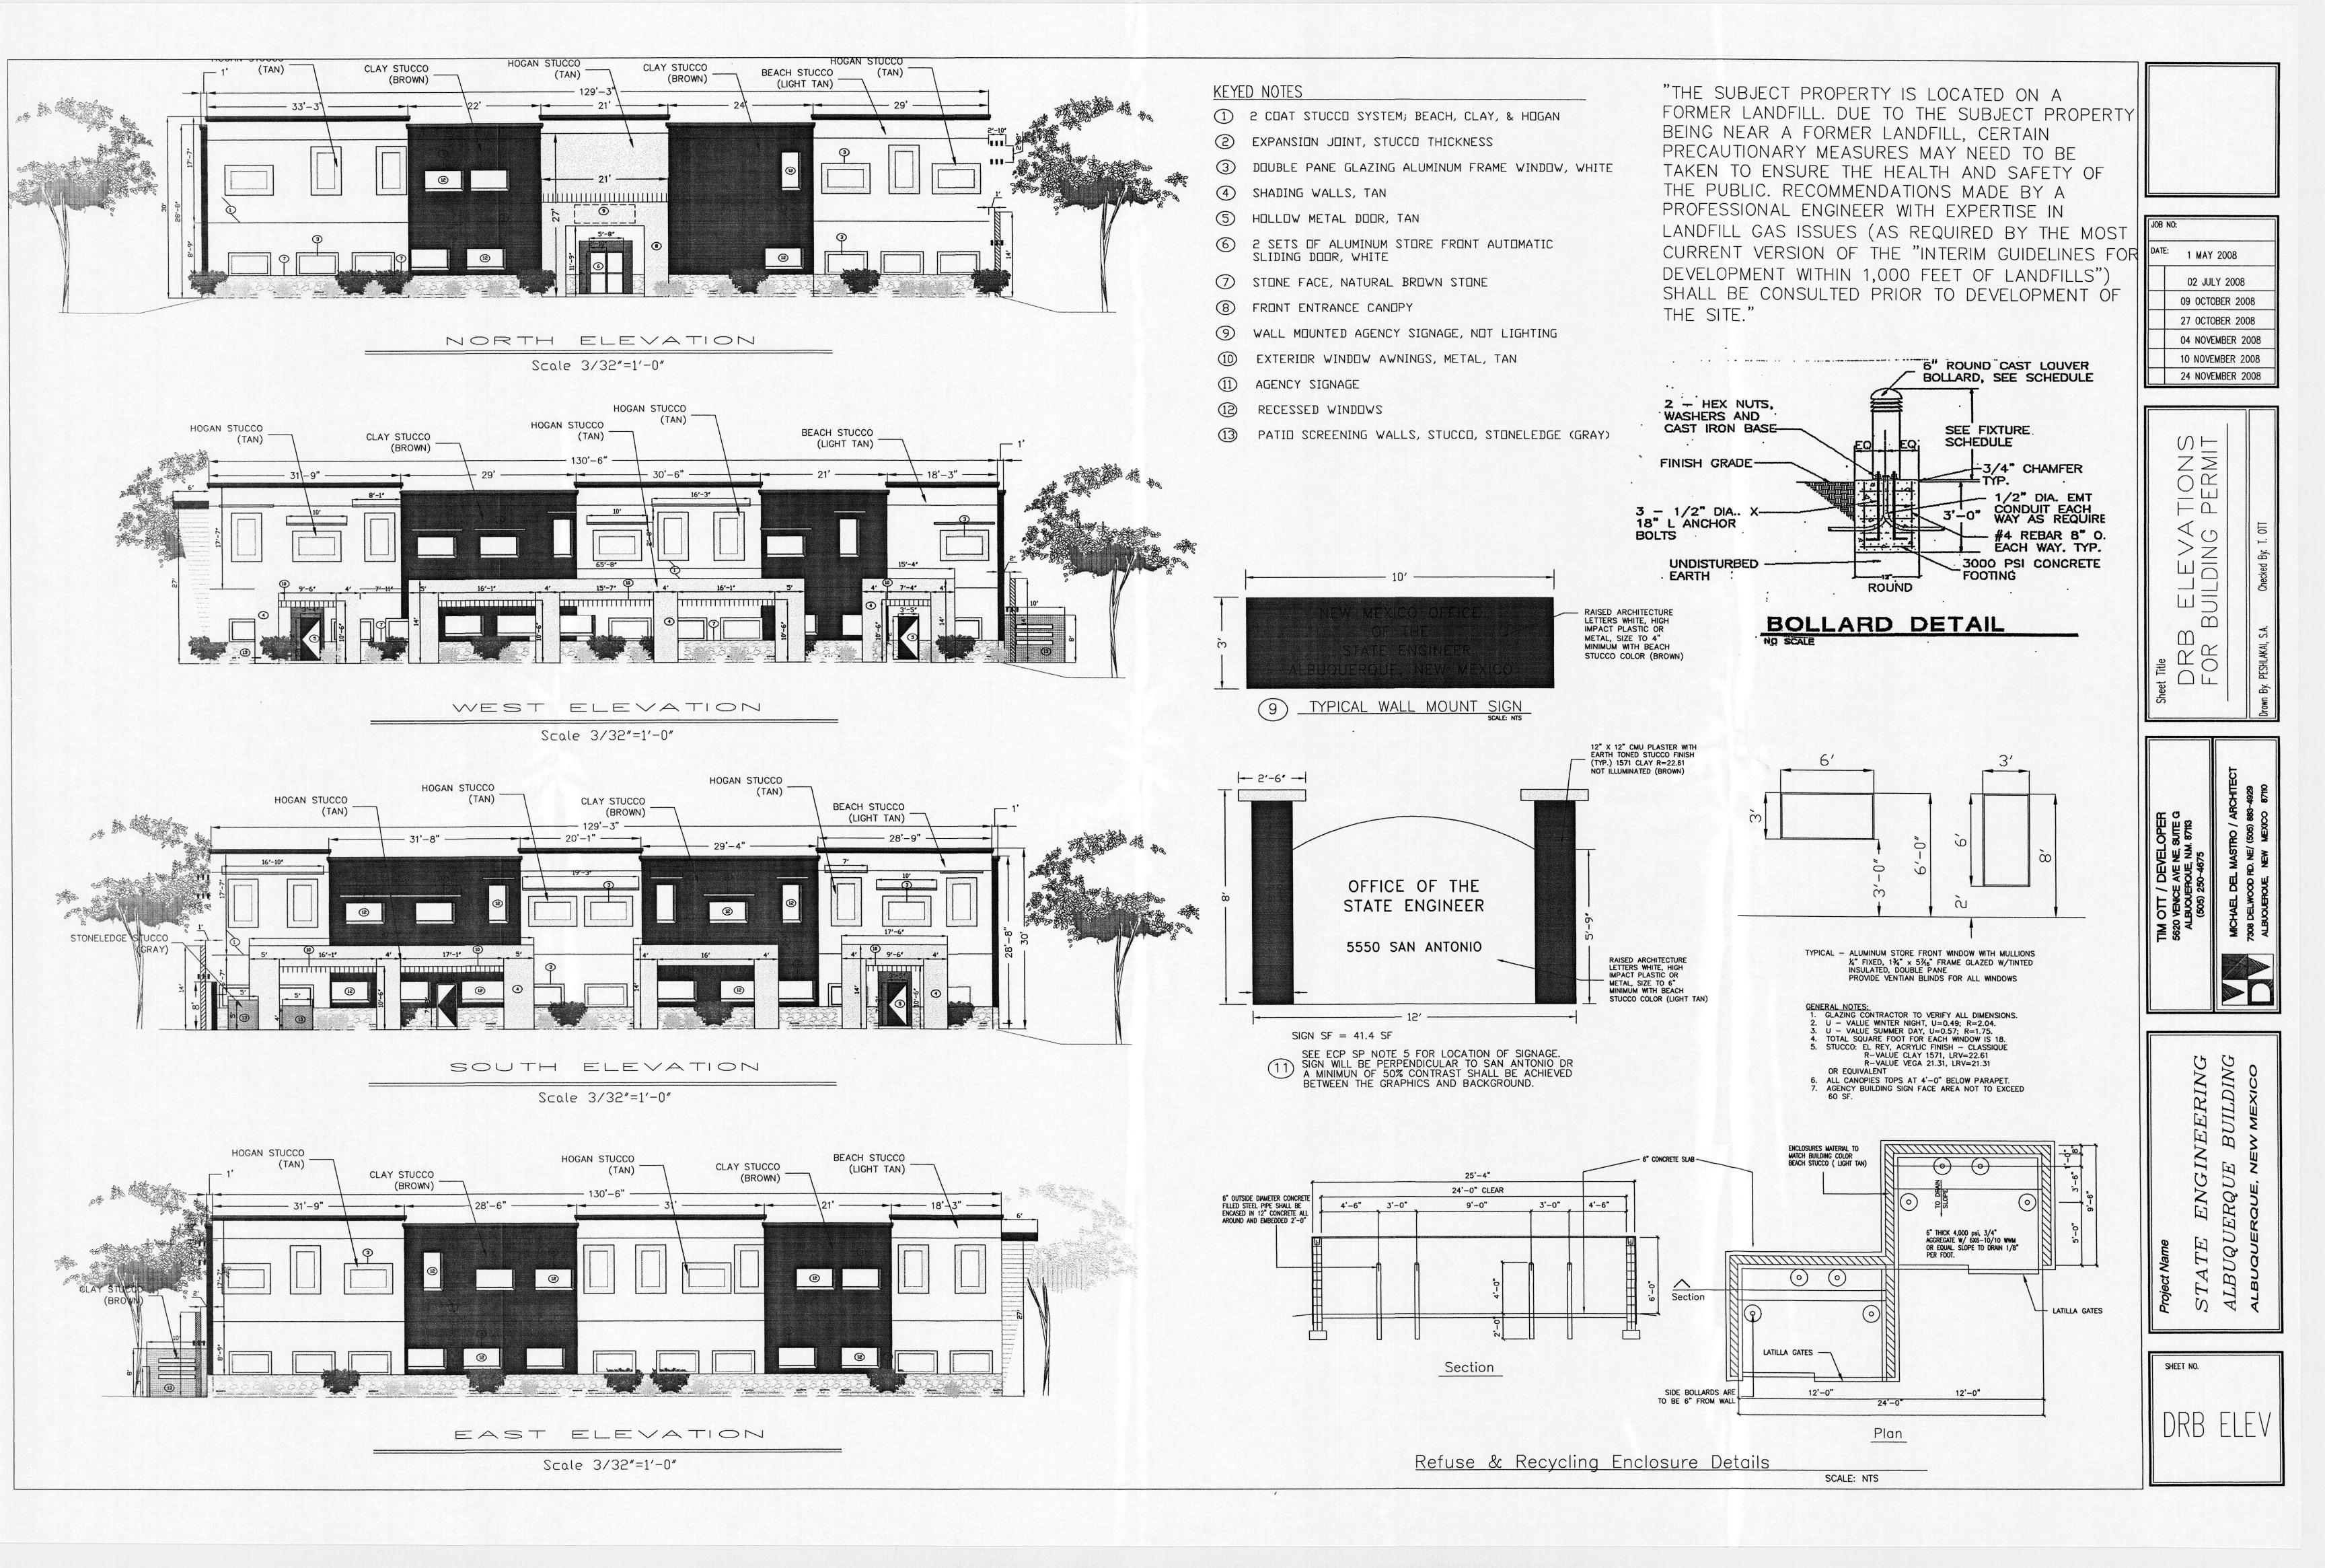

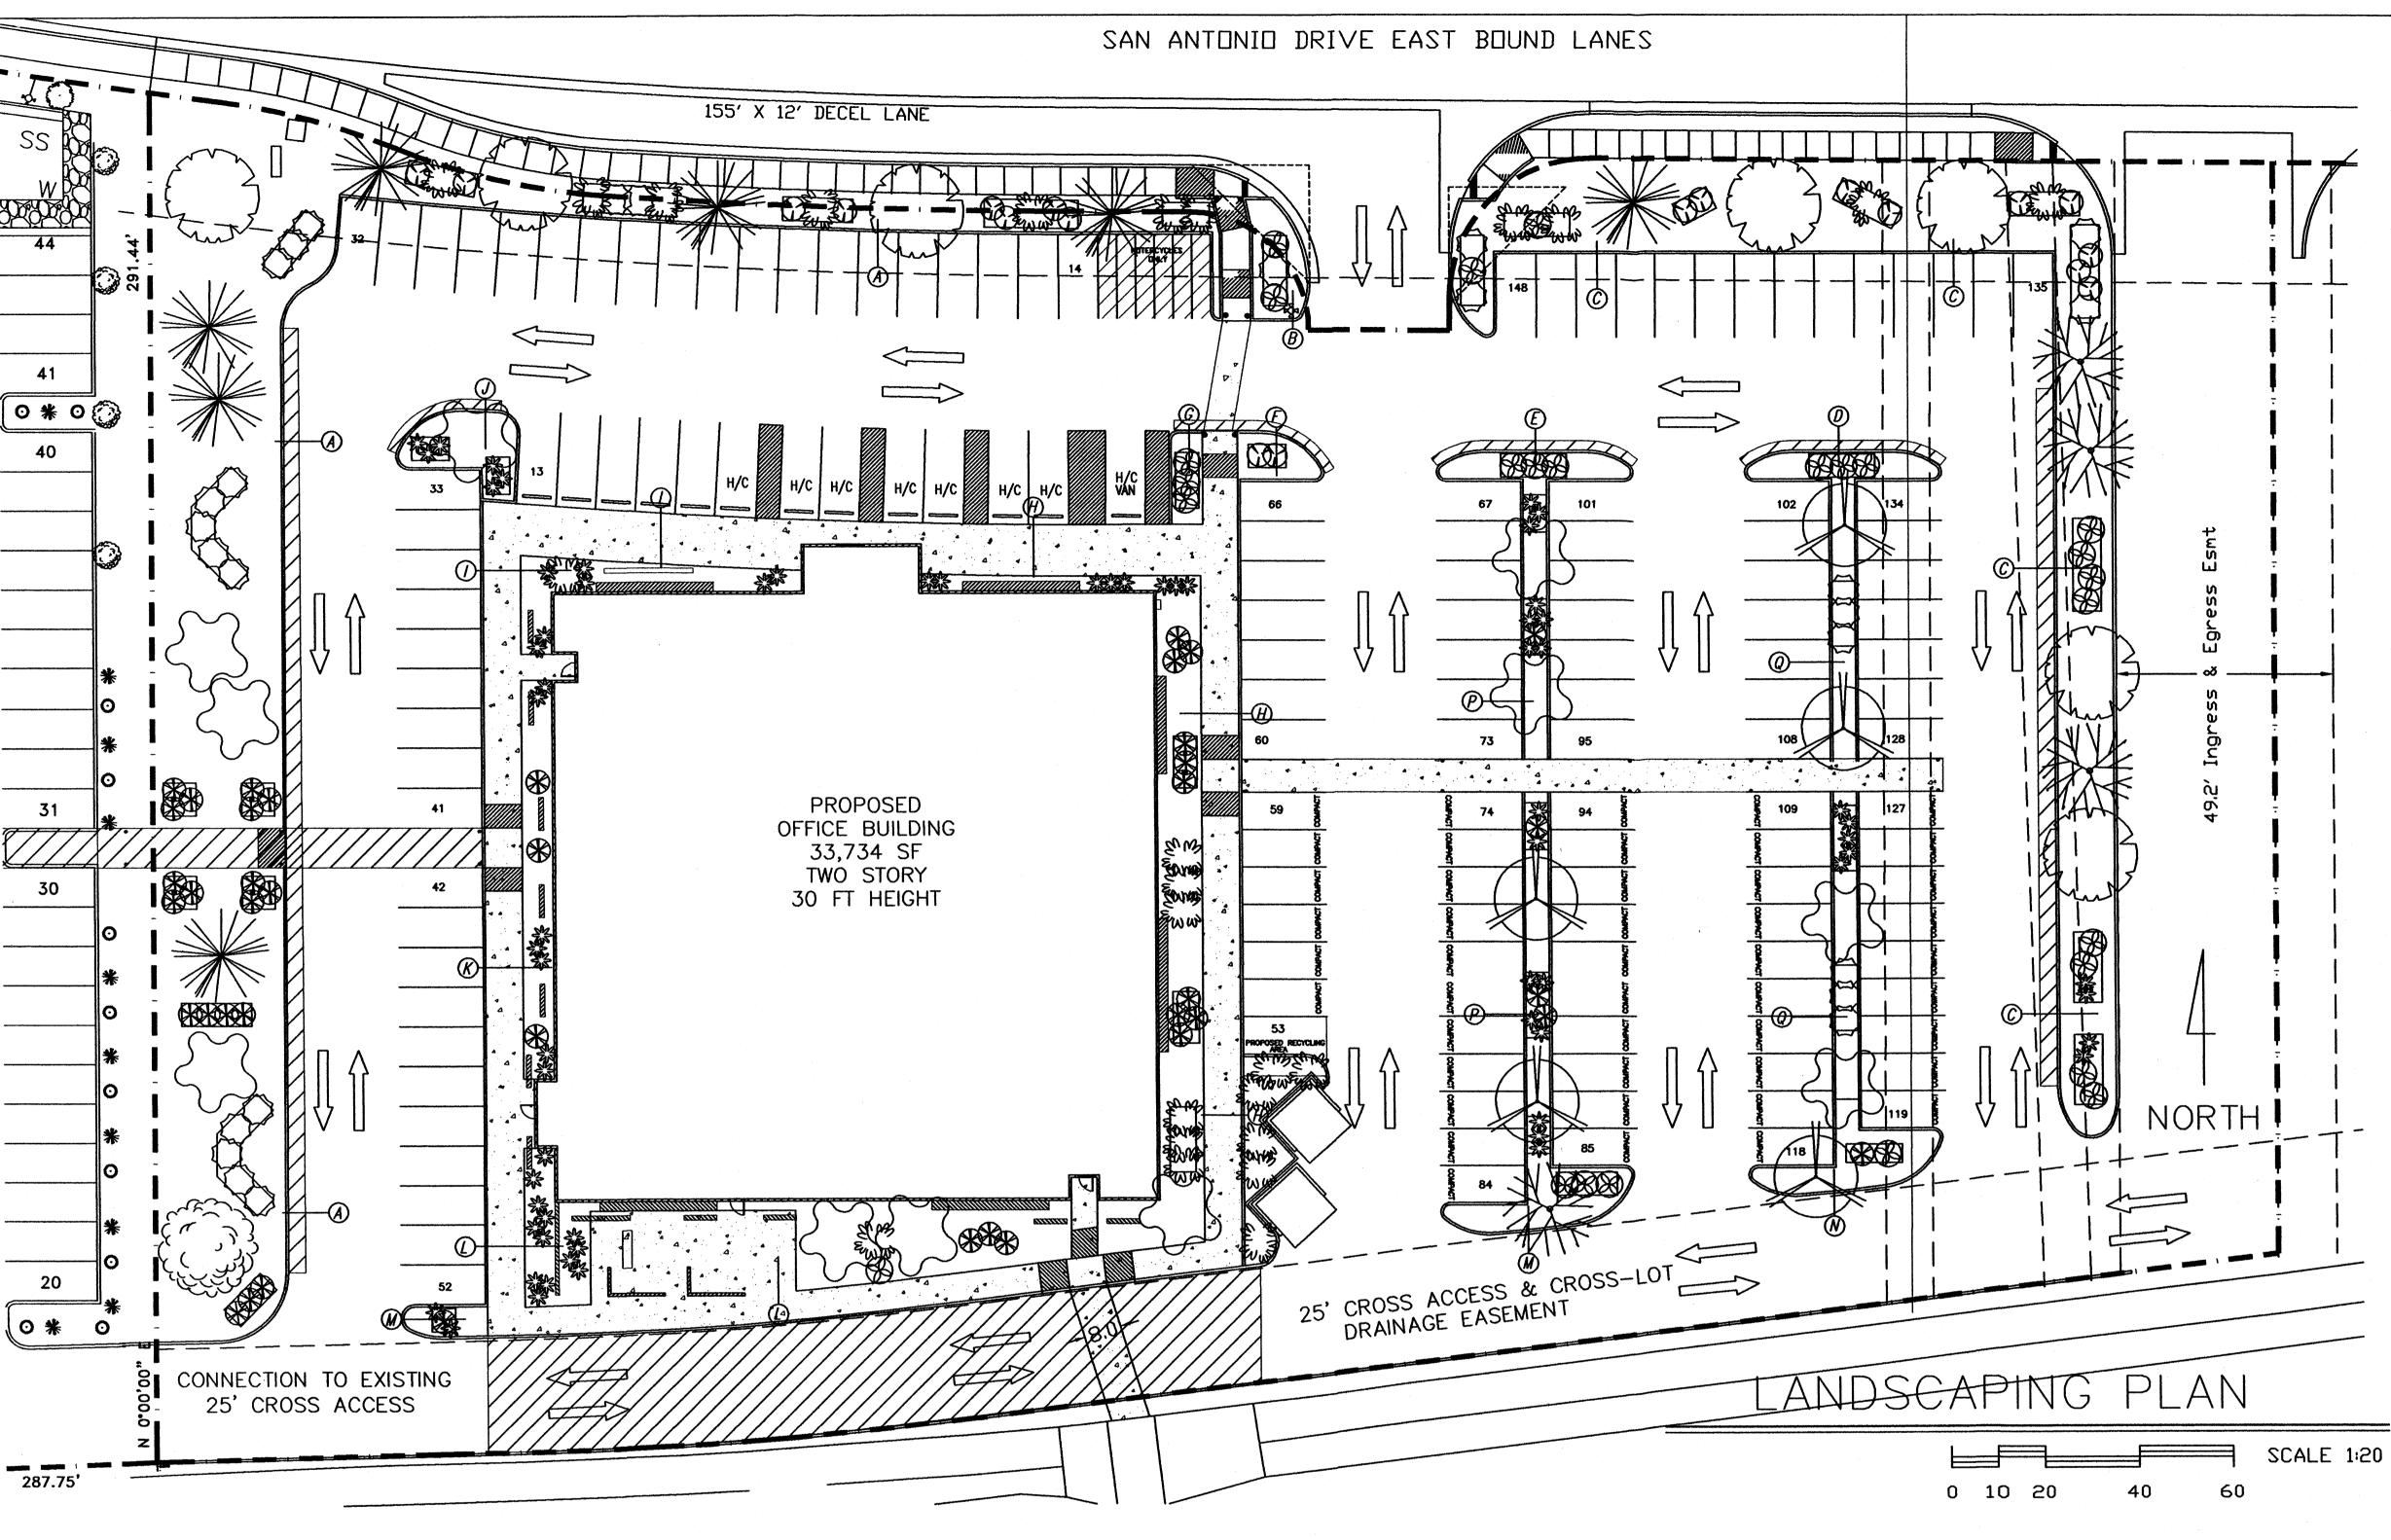


"THE SUBJECT PROPERTY IS LOCATED ON A FORMER LANDFILL. DUE TO THE SUBJECT PROPERTY BEING NEAR A FORMER LANDFILL, CERTAIN PRECAUTIONARY MEASURES MAY NEED TO BE TAKEN TO ENSURE THE HEALTH AND SAFETY OF THE PUBLIC. RECOMMENDATIONS MADE BY A PROFESSIONAL ENGINEER WITH EXPERTISE IN LANDFILL GAS ISSUES (AS REQUIRED BY THE MOST CURRENT VERSION OF THE "INTERIM GUIDELINES FOR DEVELOPMENT WITHIN 1,000 FEET OF LANDFILLS") SHALL BE CONSULTED PRIOR TO DEVELOPMENT OF THE SITE.'

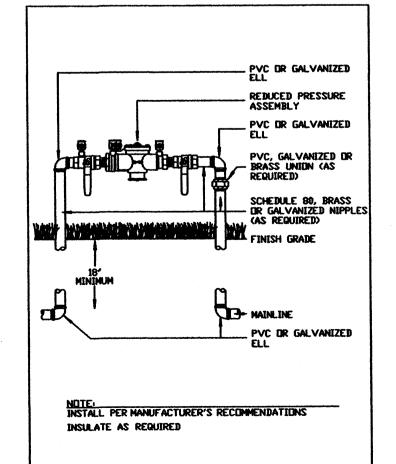

REDUCED PRESSURE & BACKFLOW PREVENTER ASSEMBLY

SYMBOL	KEY	COMMON NAME	BUTANICAL NAME	QUANTIT	INSTALLED	MATURE	CONDITION	USAGE	WATER USE	AREA CUVERAGE
مرتبهم	DECIDIOUS TRESS.									
روپو _د کی کا دوپود کی کا	HL.	HONEY LOCUST	GLEDITSIA TRIACANTHOS	2	5' - 7' HT.	20° HT. & SPD.	15 GAL. MULTI-TRUNK	SHADING	MEDIUM	628
	VR	VESTERN REDBUD	CERCIS OCCIDENTALIS	11	2 CAL., 12' - 14' HT.	20° HT. & SPD.	30° BOX	SCREENING	MEDIUM	3456
	HB	HACKBERRY	CELTIS OCCIDENTALIS	5	5′ – 10′ HT.	35° HT. & SPD.	30° BOX	SHADING	MEDIUM	2356
PLANT SCHEDULE										
SYMBOL	KEY	COMMON NAME	BOTANICAL NAME	QUANTIT Y	INSTALLED	MATURE	CONDITION	USAGE	WATER USE	AREA COVERAG
Server .	EVERGREEN TREES.									
41/2 3	SP	SCOTCH PINE	PINUS SYLVESTRIS	7	5' - 10' HT.	30' HT. & 25' SPD.	30' BOX	SCREENING	MEDIUM	3299
Jens I	PP	PINON PINE	PINUS EDULIS	4	7' - 10' HT.	30' HT. & 20' SPD.	30, BOX	SHADING	MEDIUM	2199
MIL	AC	ATLAS CEDAR	CEDRUS ATLANTICA	8	5' - 10' HT.	40' HT. & 30' SPD.	30° BOX	SHADING	HEDIUM	4398
	SHRUBS.									
Ø	APP	APACHE PLUHE	FALLUGIA PARADOXA	31	MIN. 24" HT	4' HT. & SPD.	5 - GAL	SCREENING / DRNAMENTAL	rav	389
*	sc	SHRUBBY CINQUEFUIL	POTENTILLA FRUTICOSA	58	MIN. 24" HT	3" HT. & SPD.	5 - GAL	SCREENING	HEDIUM	546
₩	DB	BUTTERFLY BUSH	BUDDLEIA DAVIDII	34	MIN 18" HT	5' HT. & SPD.	5 - GAL	ORNAMENTAL	rov	534
eme Eus	CL.	CLIFFROSE	COVANIA NEXICANA	15	NON 12" HT	5'-8' HT. & 6 2PD.	5 - GAL	SCREENING	rav	264
○ ⊗	TLS	BIG SAGE	ARTEMISIA TRIDENTATA	30	MIN. 8' SPD	4' HT. & SPD.	5 - GAL	SCREENING / DRNAMENTAL	rav	377
•	DY	BATIL YUCCA	YUCCA BACCATA	44	MDL 12° SPD	3' HT. & 4' SPD	5 - GAL	SCREENING	LOV	553
			TOTAL	246		<u> </u>			COVERAGE	18999

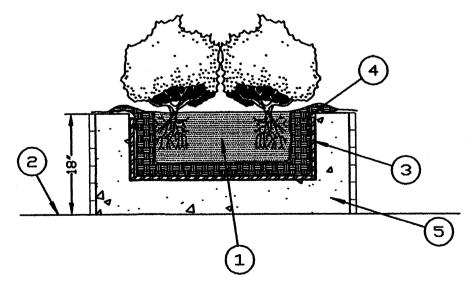

LINED SHRUB PLANTER DETAIL

LEGEND

- 1. SHRUB OR VINE 2. FINISH GRADE
- 3. PLANTER LINER, SEE ENV-3 FOR
- **DETAILS**
- 4. CLEAN SAND/SOIL
- 5. PLANTER ABOVE FINISH GRADE, 18" HIGH AND LENGTH MAY VARY WITH BRICK FINISH

GENERAL LANDSCAPE DATA:

1. TOTAL SITE AREA	119,257 S.
2. TOTAL BUILDING AREA (FOOTPRINT)	16,867 S.F.
3. NET LOT AREA	

LANDSCAPE REQUIREMENTS:

1. NET LOT AREA

1. NL1 LV1 ANLA	102,J3U 3.F.
2. LANDSCAPE AREA REQUIRED	•
NET LOT AREA X 15 %	<i>15,358 S.F</i> .
3. LANDSCAPE AREAS PROVIDED	
AREA A	11,263 S.F.
AREA B	219 S.F.
AREA C	6,050 S.F.
AREA D	155 S.F.
AREA E	155 S.F.
AREA F	124 S.F.
AREA G	120 S.F.
AREA H	1,773 S.F.
AREA /	
AREA J	194 S.F.
AREA K	
AREA L	
AREA M	•
AREA N	
AREA O	
ADEA D	007.05


102,390 S.F.


TOTAL LANDSCAPE AREA PROVIDED 24,682 S.F.

LAYOUT BY LANDSCAPE 4. IRRIGATION SYSTEM . LOW FLOW DRIP SYSTEM CONTRACTOR BUBBLIER SYSTEM

GENERAL NOTES:

- 1. ALL LANDSCAPING WILL BE COMPETED WITHIN 60 DAYS OF BUILDING OCCUPANCY.
- 2. THE LANDSCAPE CONTRACTOR SHALL DESIGN AND CONSTRUCT ANY IRRIGATION SYSTEM WHICH SHALL INCLUDE PIPING, CONTROLS, EQUIPMENT AND LABOR NECESSARY FOR A COMPLETE SYSTEM. SYSTEM SHALL INCLUDE AUTOMATIC VALVES AND TIMER.
- 3. THE LANDSCAPE CONTRACTOR SHALL COORDINATE WITH THE GENERAL CONTRACTOR TO FIELD VERIFY THE EXACT LOCATIONS OF ALL ON-SITE UTILITIES, TREES AND SHRUBS SHALL BE PLANTED NO LESS THAN 3 FEET FROM UTILITY LINES.
- 4. MAINTENANCE OF LANDSCAPING AND IRRIGATION SYSTEM TO BE THE RESPONSIBILITY OF THE OWNER.
- 5. WOOD CHIPS WITH FILTER FABRIC IN LANDSCAPING AREAS, 6. IRRIGATION SYSTEMS SHALL BE DESIGNED TO COMPLY WITH
- THE PROVISIONS OF THE CITY OF ALBUQUERQUE. 7. DEVELOPMENT WILL COMPLY WITH THE PROVISIONS OF THE COA ORDINANCE 6-1-1-1.
- 8. AREA A & C IS STREET TREE AREA. AREA TO CONFORM WITH COA 6-6-2-5. TREES WILL BE A MINIMUM OF 5 FT. FROM EDGE OF SIDEWALK AND SPACED PER LANDFILL RESTRICTIONS. 9. THERE IS NO ON SITE PONDING DUE TO FORMER LANDFILL
- 10. ALL AREAS OF THE LOT WITH THE EXCEPTION OF THE BUILDING IS UNDERLAY WITH WASTE.
- 11. XERISCAPE SHOULD USE 5 TO 20 GALLONS OF SUPPLEMENTAL WATER PER SQUARE FOOT OF ROOTING AREA (LINED PLANTING
- 12. 5 GALLONS @ 2 GPA EMITTER FOR EACH SHRUB AND 2 MICRO BUBBLES 6 GPA FOR EACH TREE WITH A RUNTIME OF AN
- 13. MAINTENANCE OF LANDSCAPING AND IRRIGATION SYSTEM TO BE THE RESPONSIBILITY OF THE OWNER AND SHALL COMPLY WITH THE PROVISIONS OF THE CITY OF ALBUQUERQUE.
- 14. ALL SHRUBS SHALL BE PLANTED IN PLANTER ABOVE FINISH GRADE, EXCEPT FOR TREES WHICH SHALL HAVE A MINIMUM 2' DEPTH OF ROOTING AREA ABOVE LINER.

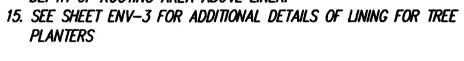

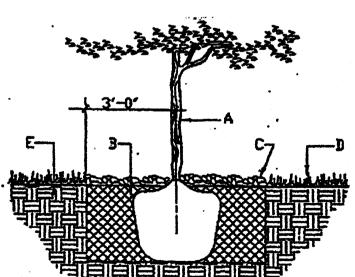


- 1. ROOTBALL SHALL BE PLACED ON UNDISTURBED SOIL TO PREVENT TREE FROM SETTLING.
- 2 TREE ROOT COLLAR SHALL BE AT GRADE; THIS REPRESENTS THE LEVEL AT WHICH THE TREE SHOULD BE INSTALLED, THAT LEVEL MAY BE EXCEEDED BY ONLY A ONE INCE LAYER OF SOIL THE PLANTING HOLE SHALL BE 2-5 TIMES AS WIDE AS THE ROOTBALL DEPENDING ON SURROUNDING SOIL COMPATION.
- 3. PRIOR TO BACKFILLING TREE, ALL WIRE, ROPE AND SYNTHETIC MATERIALS SHALL BE REMOVED FROM THE TREE AND THE PLANTING PIT.
- 4. PRIOR TO BACKFILLING ALL BURLAP SHALL BE CUT AWAY EXCEPT FROM BOTTOM OF THE ROOTBALL.

CONSTRUCTION NOTES:

- B. BACKFELL WITH EXISTING SOIL
- C. TDEPTH OF BARK MULCEL
- D. TURPAT FINESH GRADE. LIOC GERNTZIONU .2

DATE: 15 JANUARY 2009 REVISIONS

a C 50 P C C S A BI **型**〇

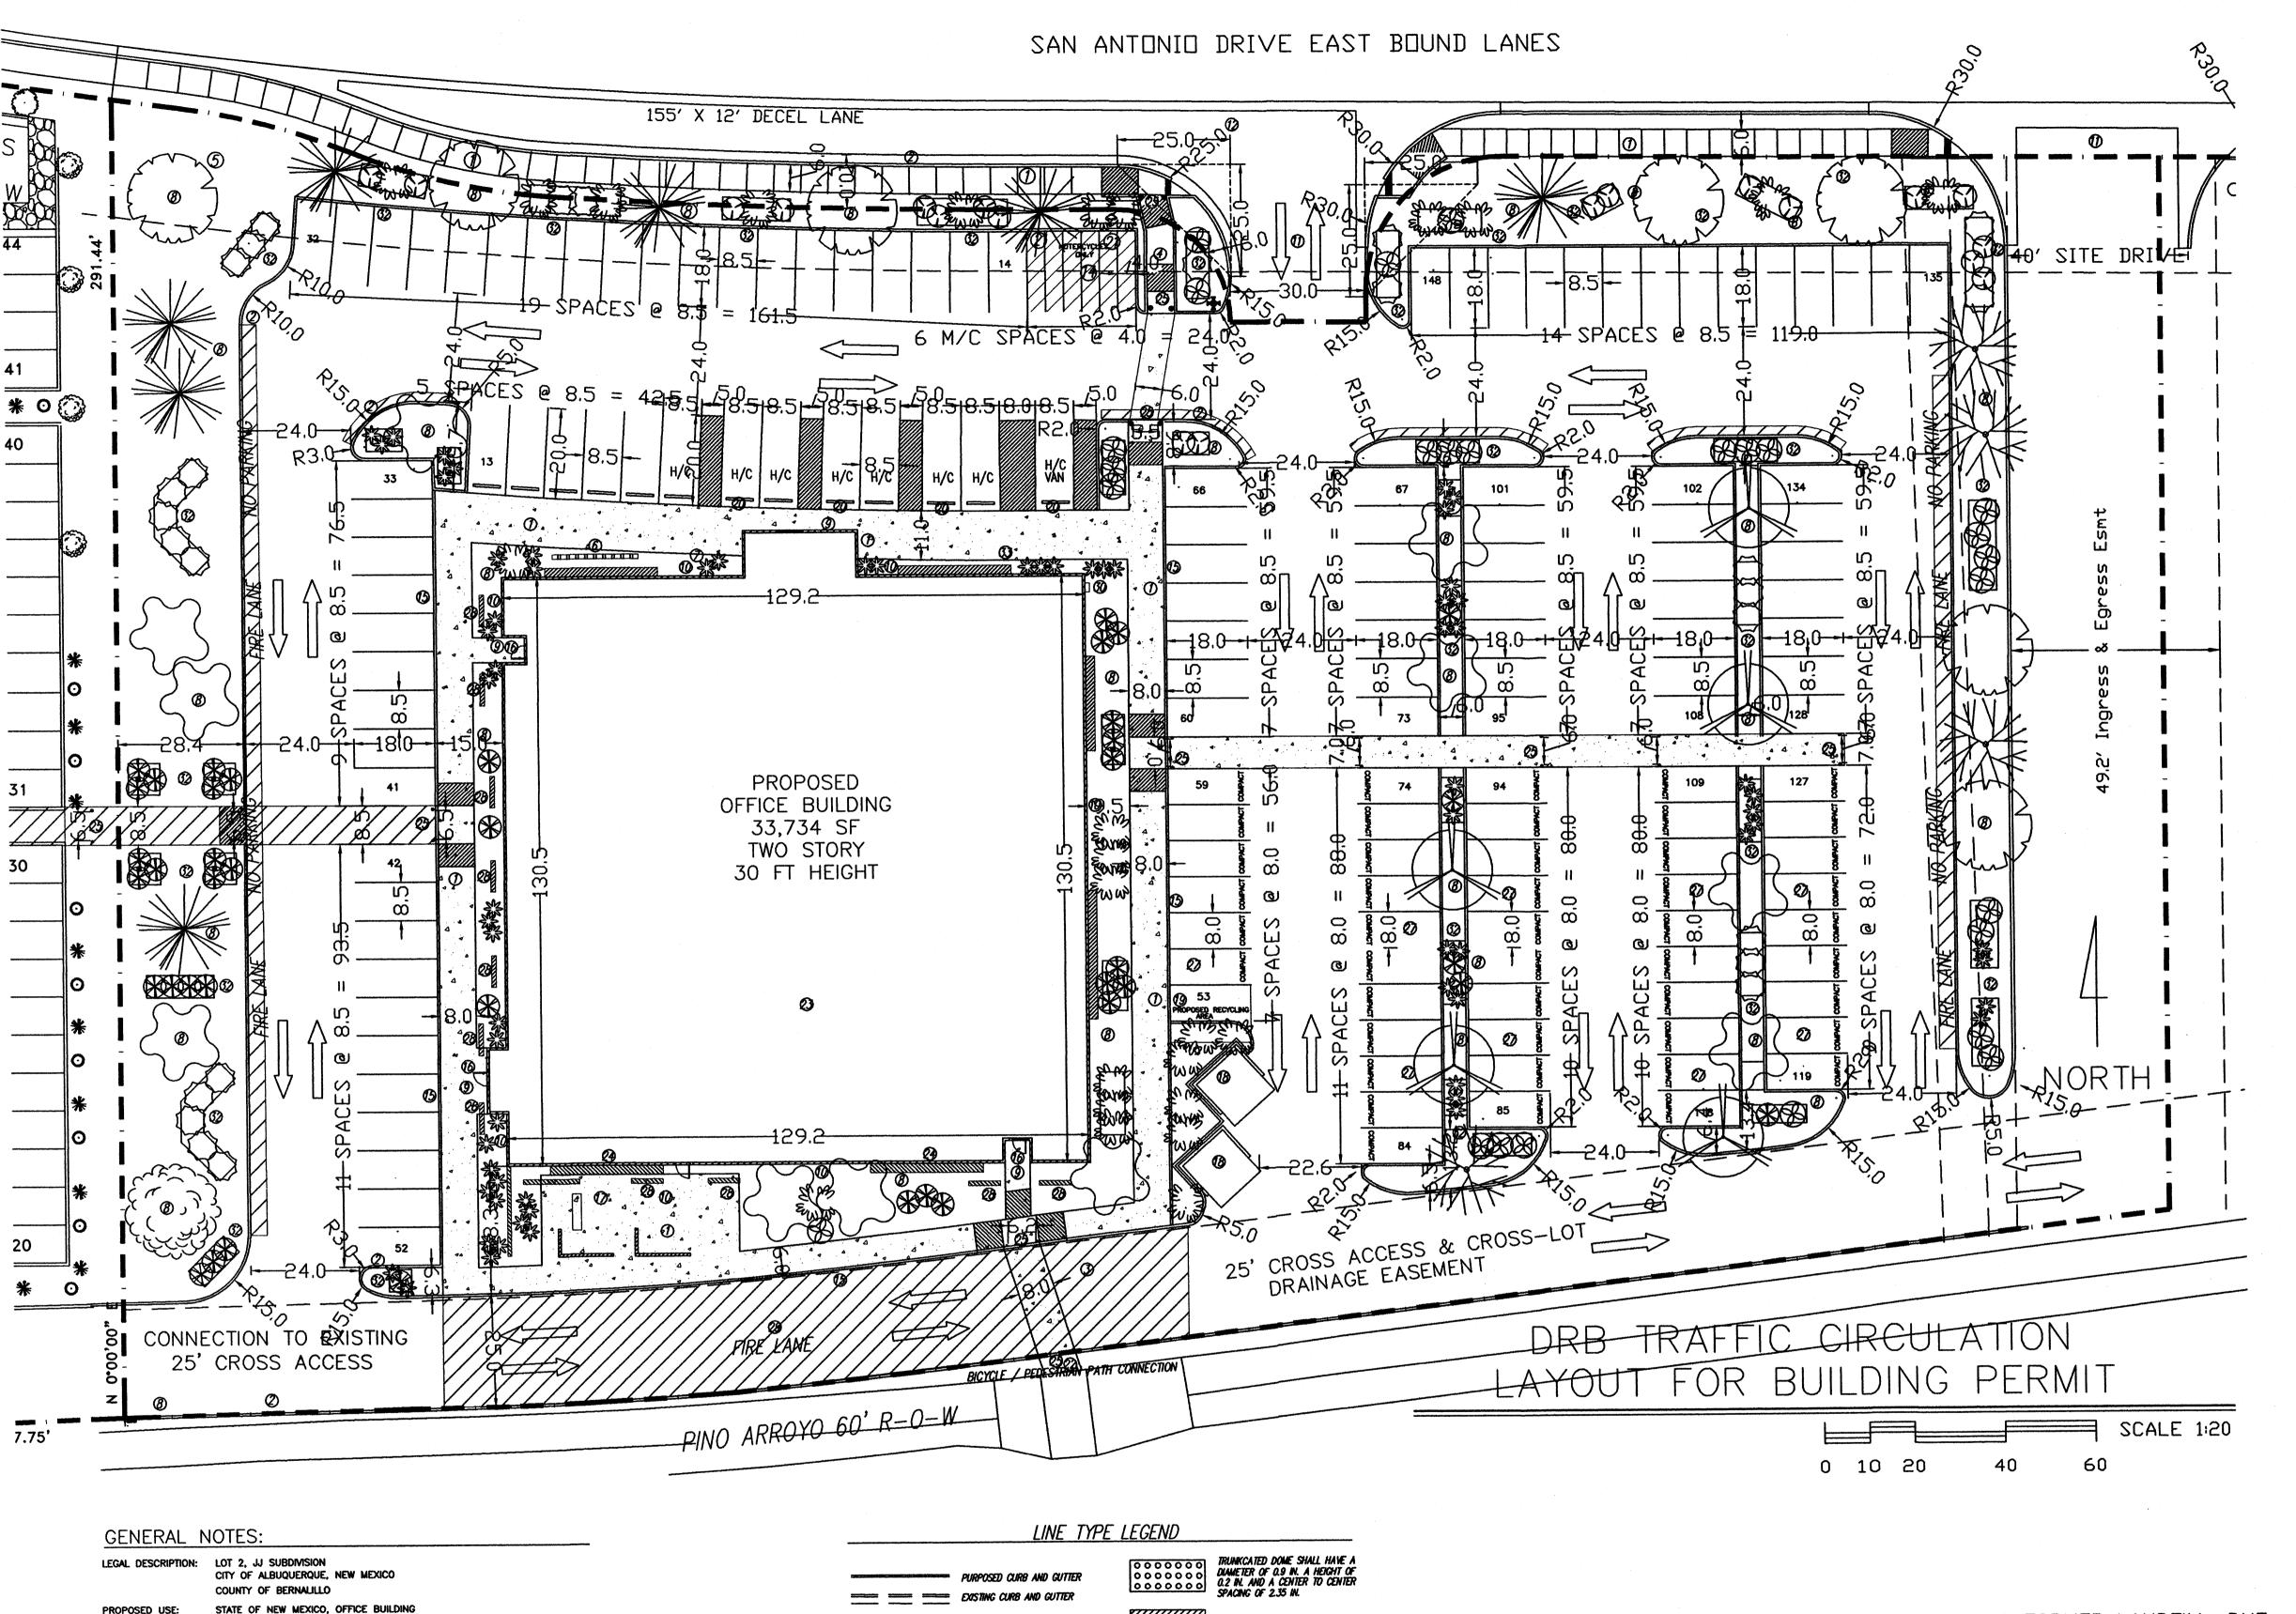

TRAFFIC FLOW DIRECTION

TWO STORY, HEIGHT 30 FT 0 INCH

ALL UTILITIES ARE AVAILABLE AT THE

PARKING, MOTORCYCLE: REQUIRED PER COA CODE: 7 SPACES (with 101 to 300 req. prking spcs.)

THERE WILL BE NO PHASING PLAN IN THIS PROJECT.

7 SPACES

REQUIRED PER COA CODE: 8 SPACES (with 101 to 300 req. prkng. spcs.)

REQUIRED PER COA CODE: FIRST FLOOR: 16,867 SF NET LEASABLE SF = 84 SPACES

OTAL SPACES (93 REG., 47 COMPACT, 8 HANDICAP)

7 SPACES, 1 VAN ACCESSIBLE

THERE AREA NO FIRE HYDRANTS, ELECTRIC-POLE OR OTHER OBSTRUCTIONS WHICH WHICH ARE IN ADA PATHWAYS OR WOULD IMPEDE ADA PATHWAYS.


SECOND FLOOR: 16,867 SF NET LEASABLE SF = 57 SPACES
141 TOTAL RE

(29% OF SPACES ARE FOR COMPACT CARS)

PROPERTY BOUNDARY LINES.


CURRENT ZONING:

"THE SUBJECT PROPERTY IS LOCATED ON A FORMER LANDFILL. DUE TO THE SUBJECT PROPERTY BEING NEAR A FORMER LANDFILL, CERTAIN PRECAUTIONARY MEASURES MAY NEED TO BE TAKEN TO ENSURE THE HEALTH AND SAFETY OF THE PUBLIC. RECOMMENDATIONS MADE BY A PROFESSIONAL ENGINEER WITH EXPERTISE IN LANDFILL GAS ISSUES (AS REQUIRED BY THE MOST CURRENT VERSION OF THE "INTERIM GUIDELINES FOR DEVELOPMENT WITHIN 1,000 FEET OF LANDFILLS") SHALL BE CONSULTED PRIOR TO DEVELOPMENT OF THE SITE."

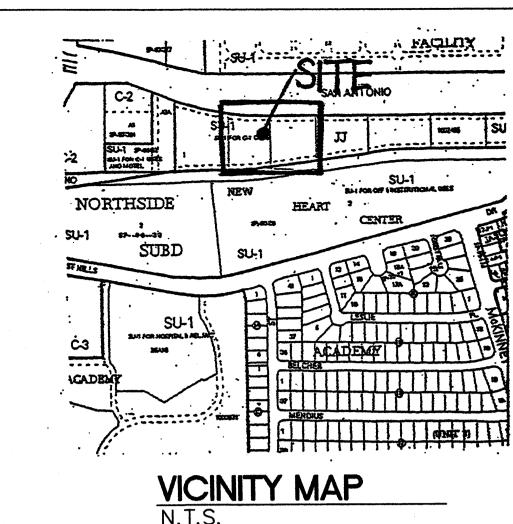

KEYED NOTES:

- ① NEW CONCRETE SIDEWALK PER COA STD 2430.
- ② NEW CONCRETE CURB & GUTTER PER COA STD 2415.
- ③ REMOVE LOT LINE-PER PLAT.
- **4** NEW FIRE HYDRANT LOCATION.
- (5) AGENCY SIGN TO BE SUBMITTED TO THE CITY FOR APPROVAL, SEE DRB ELEV SHEET FOR DETAIL SIGN WILL BE PERPENDICULAR TO SAN ANTONIO.
- 6 BICYCLE RACK, MINIMUM 8 SPACES.
- (7) FLAG POLE
- SECURITY LIGHTING AT ALL ENTRANCES.
- © EXTERIOR BUILDING LIGHTING PER NEW MEXICO NIGHT
 SKY PROTECTION ACT AND WITH FULL—SHIELDED FIXTURES
 BY PHOTO CELL.
- DRIVEWAY PER CITY OF ALBUQUERQUE STD 2426.
- (2) EXISTING FIRE HYDRANT, TO BE RELOCATED.
- (3) EXISTING FIRE HYDRANT.
- (4) MOTORCYCLE PARKING WITH SIGNAGE PER COA CODE.
- 15 NEW TURN DOWN SIDEWALK AROUND THE PERIMETER OF THE WALKWAYS THAT SURROUNDS THE BUILDING.
- **(b)** CYPHER LOCK ON ENTRANCE.
- (7) EMPLOYEE PATIO WITH 25% COVERAGE, WOOD TRUSSES AND COLORED SHEET METAL TO MATCH THE COLOR OF THE WINDOW AWNINGS PATIO FURNITURE, TRASH RECEPTACLES, PICNIC TABLE & BBQ PIT.
- 1 DUMPSTER ENCLOSURE, TO MATCH THE COLOR OF THE BUILDING PER CITY OF ALBUQUERQUE STANDARDS.
- 19 PROPOSED RECYCLE AREA, PER CITY OF ALBUQUERQUE STANDARDS.
- *Mandicap Signage Location.*
- ② MOTORCYCLE SIGNAGE LOCATION.
- 2) PINO ARROYO BICYCLE & PEDESTRIAN TRAIL.
- 83 ROOF TOP COLOR AND MATERIAL WILL BE NON-REFLECTIVE.
- 24 LANDFILL GAS VENTING SYSTEM IN WALL SYSTEM.
- BOLLARD LIGHTING AT ALL CROSSWALK LOCATIONS WILL NOT INTERFERE WITH ADA CLEARANCE.
- NO PARKING AREA LIGHTING, NO PUBLIC USE AFTER 5 PM ANTICIPATED.
- 2) ALL COMPACT SPACES TO BE LABELED ON PAVEMENT.
- 28 SHADING WALLS.
- 29 STRIPED FIRE LANE, NO PARKING PER FIRE MARSHALL.
- (1) KNOX BOX LOCATION PER FIRE MARSHALL.
- (3) ALL ROOF TOP OR GROUND MOUNTED EQUIPEMENT SHALL BE SCREENED FROM VIEW OR PAINTED TO MATCH ADJACENT STRUCTURAL, PER DESIGN CRITERION 12 ON SHT. SDP.
- 3 ALL SHRUBS PLANTED IN PLANTER

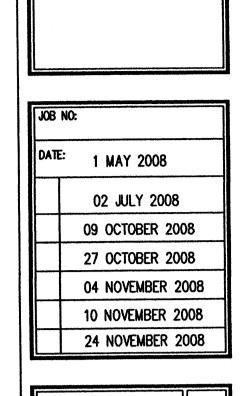


DRB TRAFFIC CIRCULATION LAYOU
FOR BUILDING PERMI


ALBUCUEROUE, N.M. 8713
(505) 250-4675
MICHAEL DEL MASTRO / ARCHITECT
7306 DELWOOD RD. NE/ (506) 883-4929
ALBUCUEROUE, NEW MEXICO 8710




SHEET NO.


DRB TCL

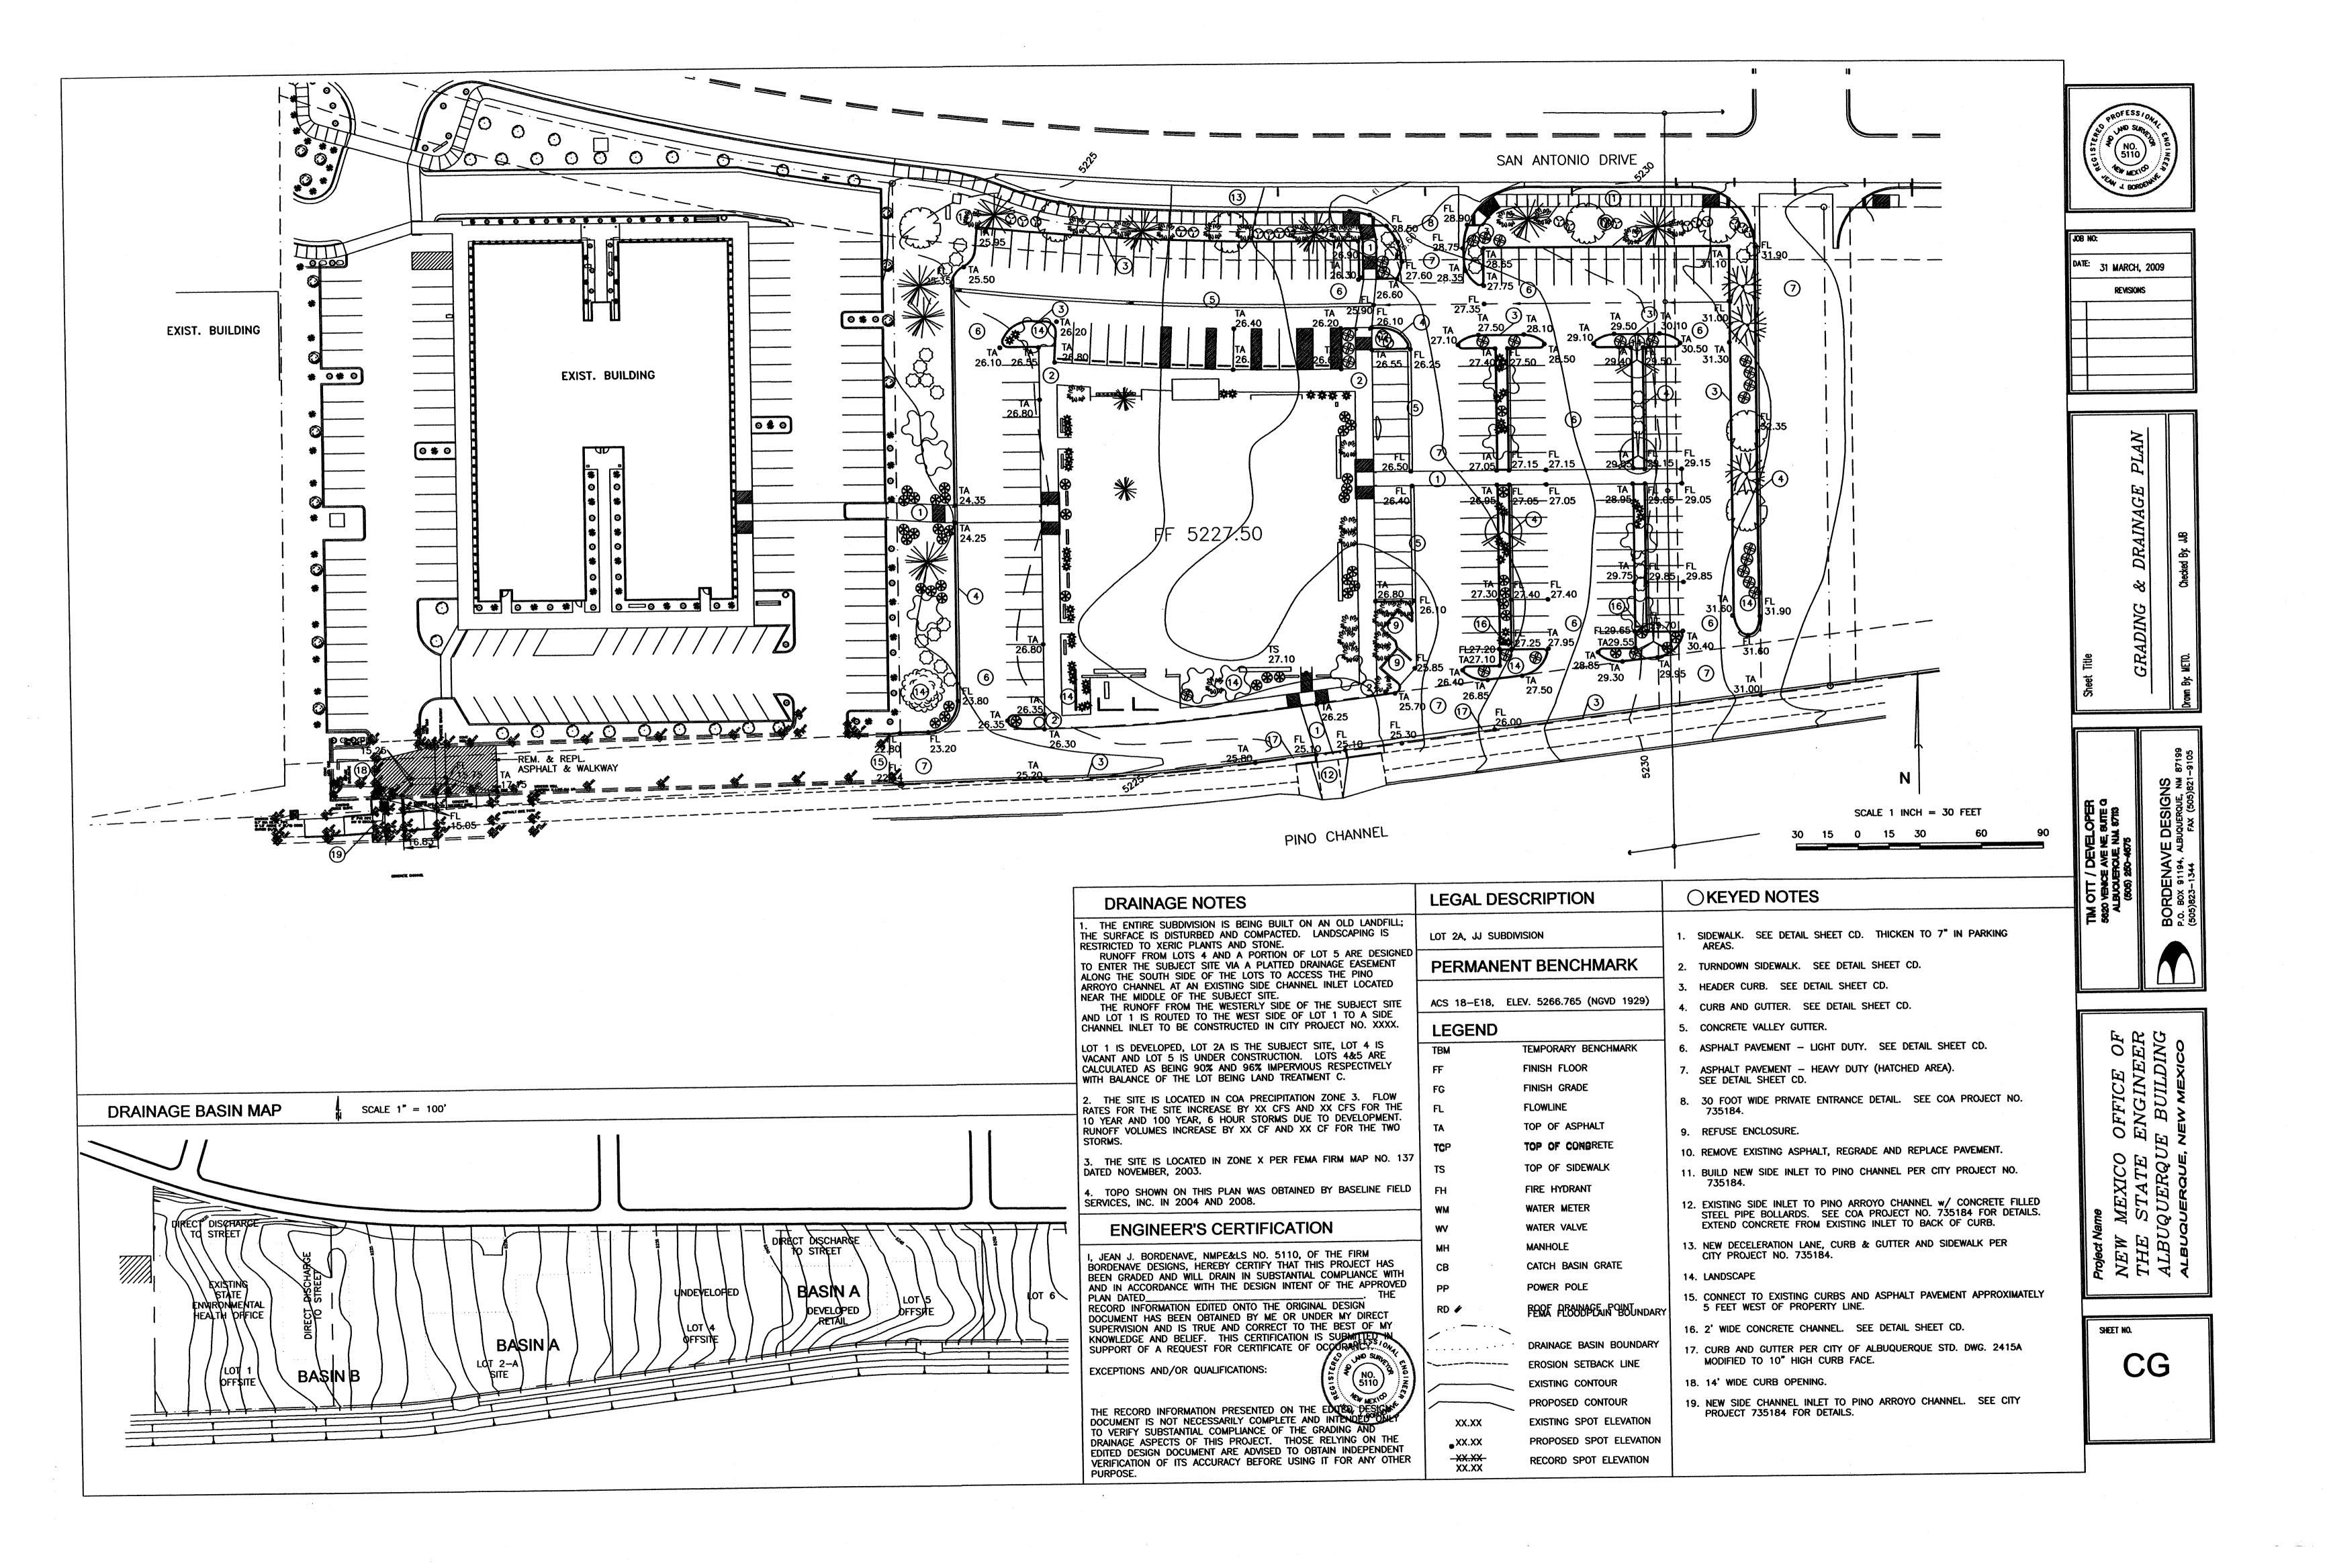


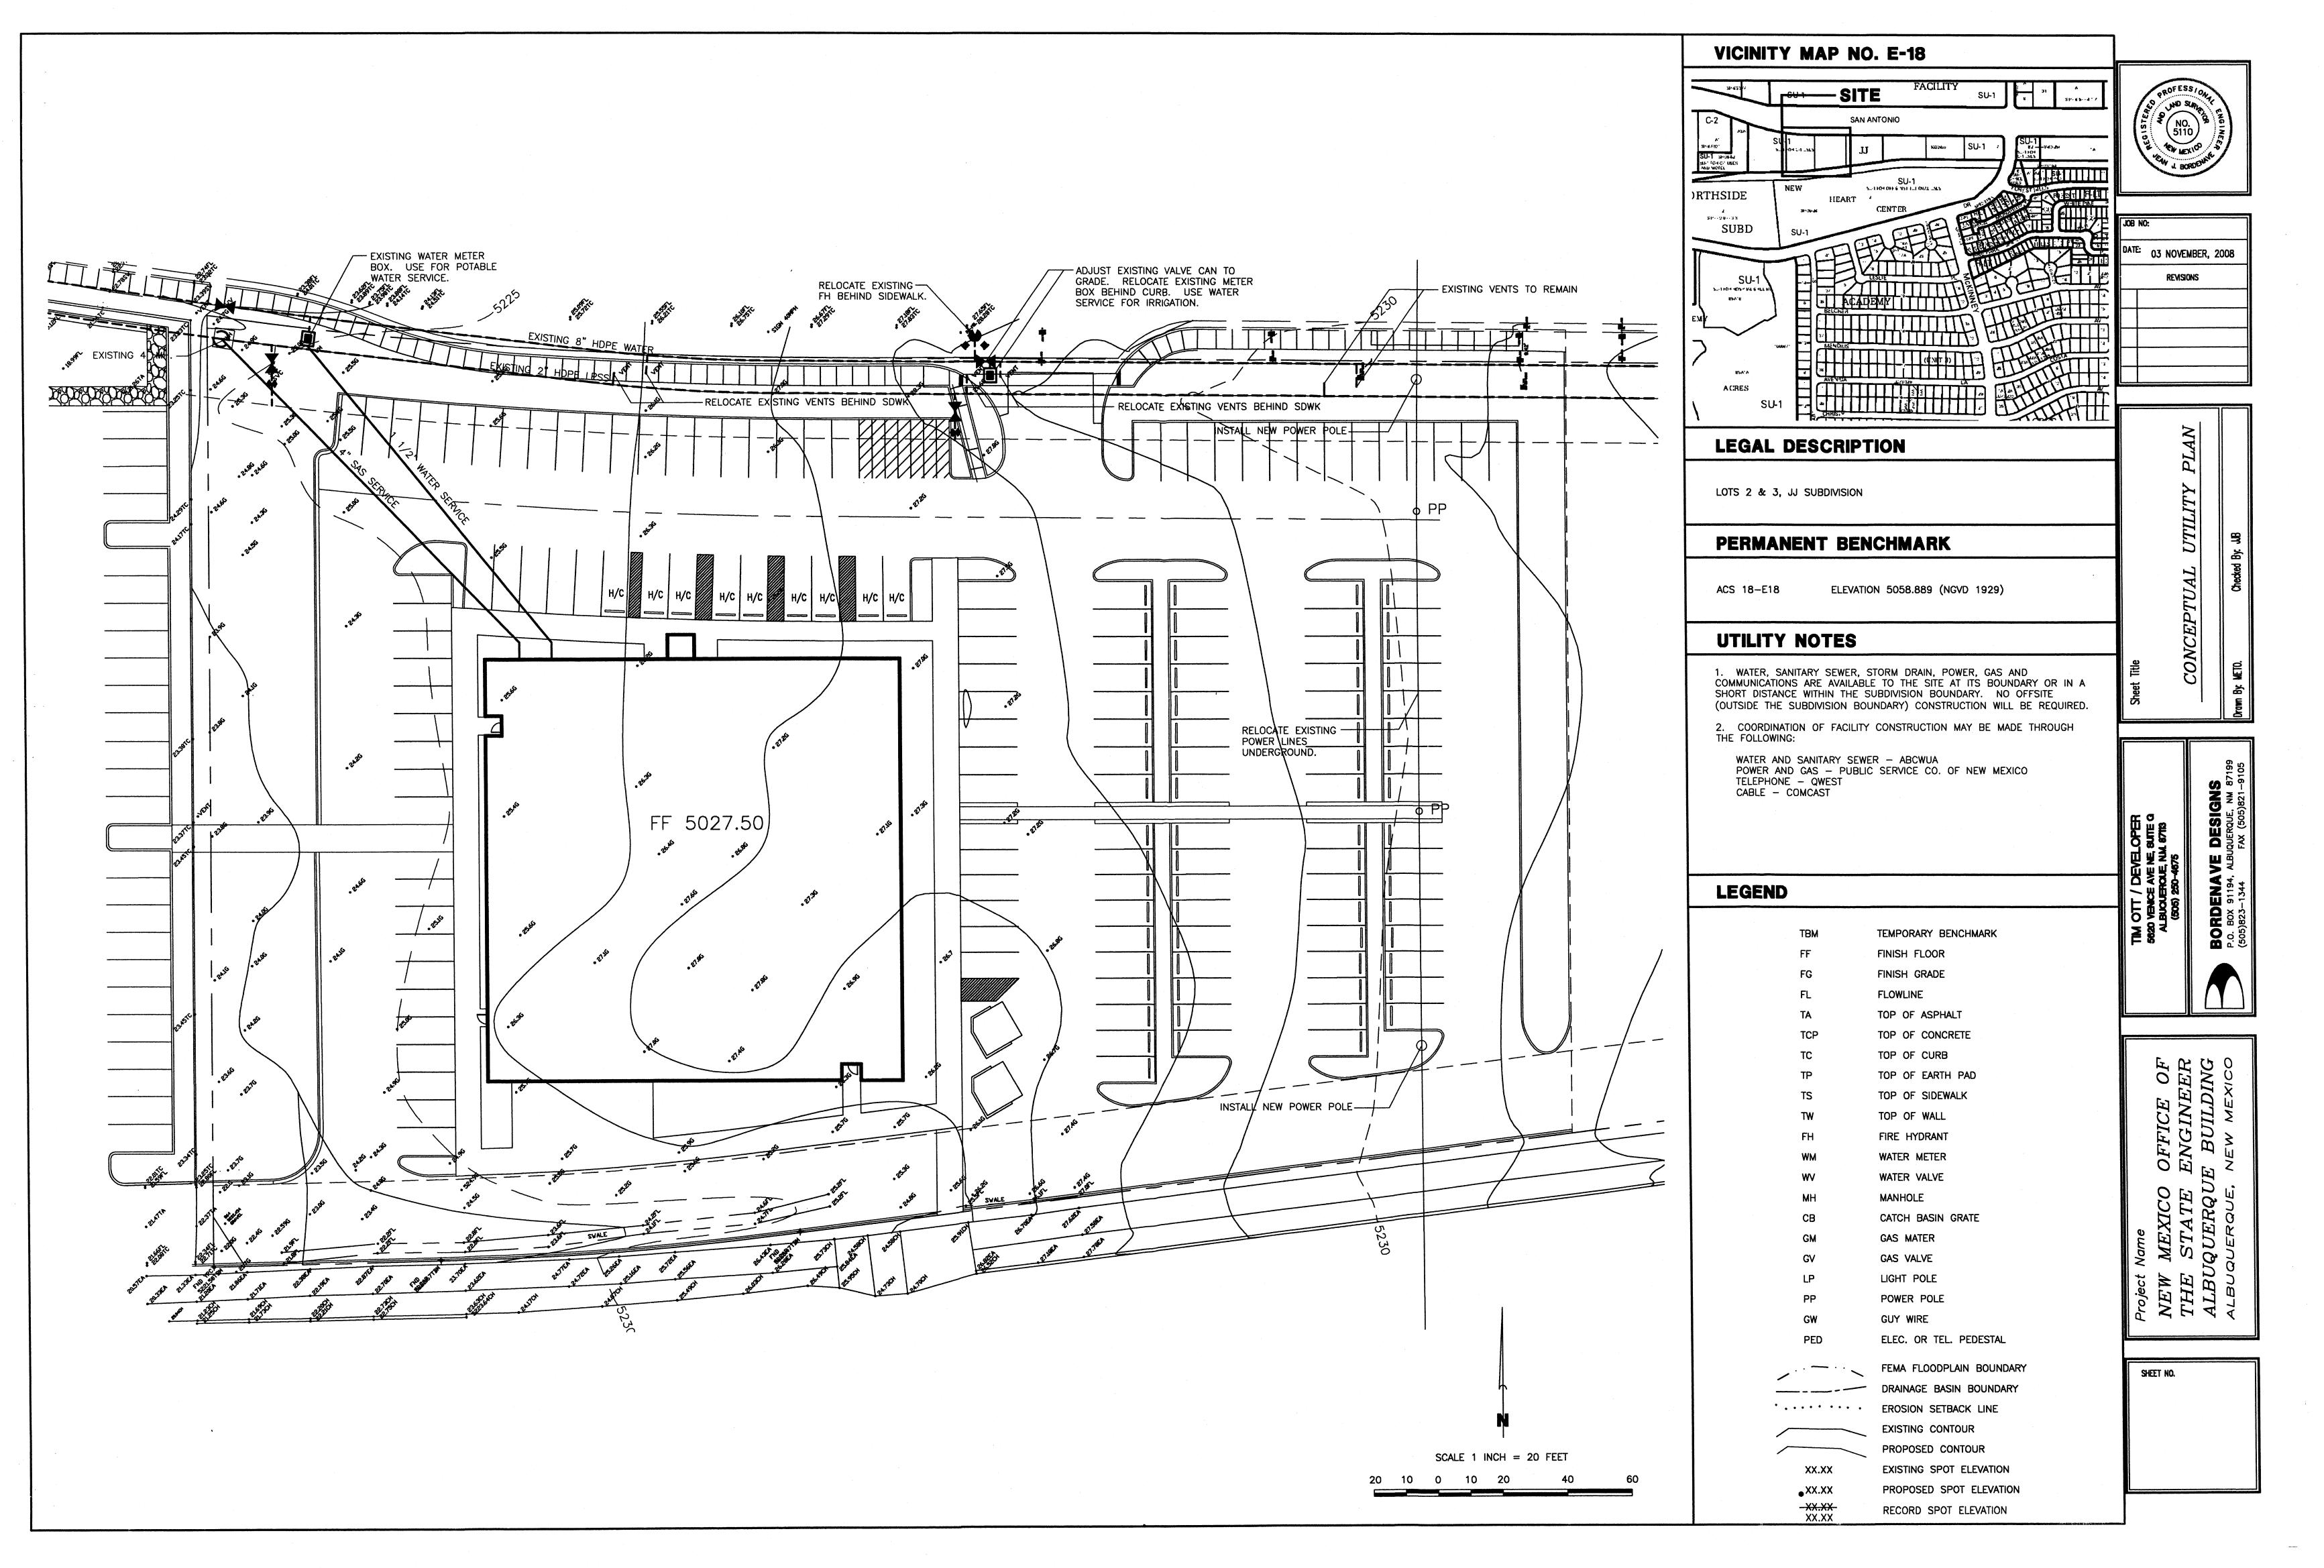


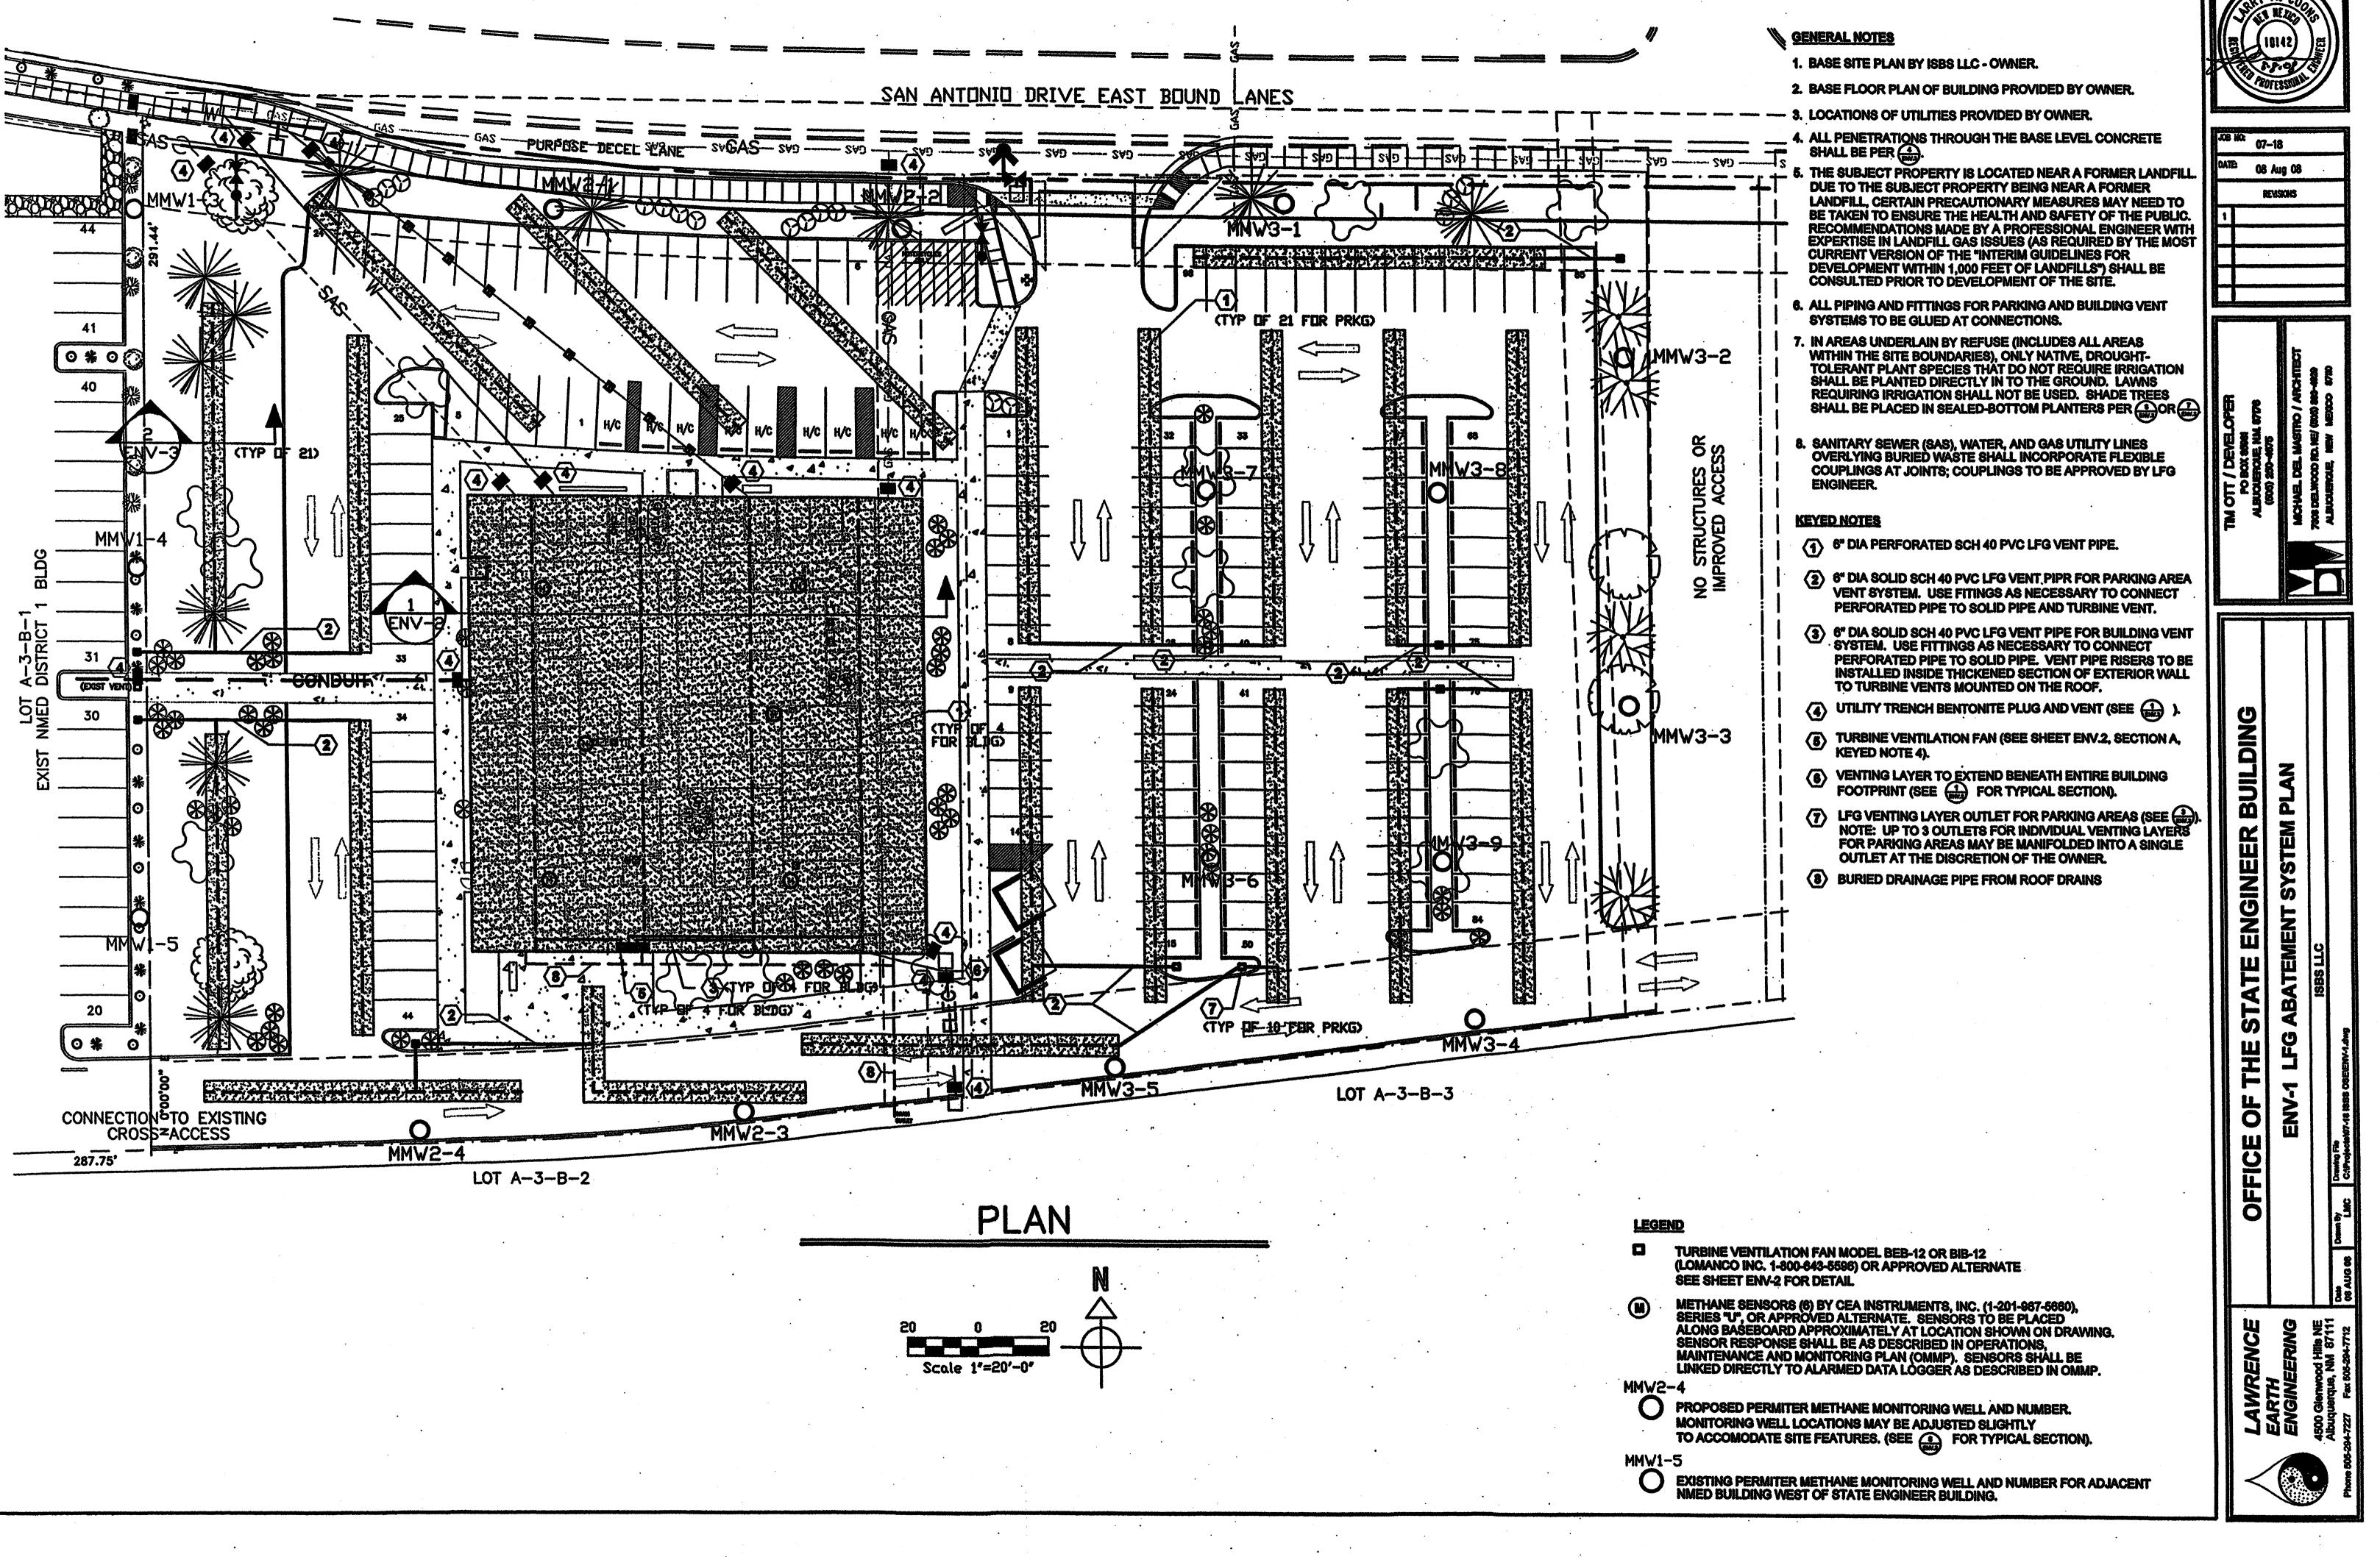



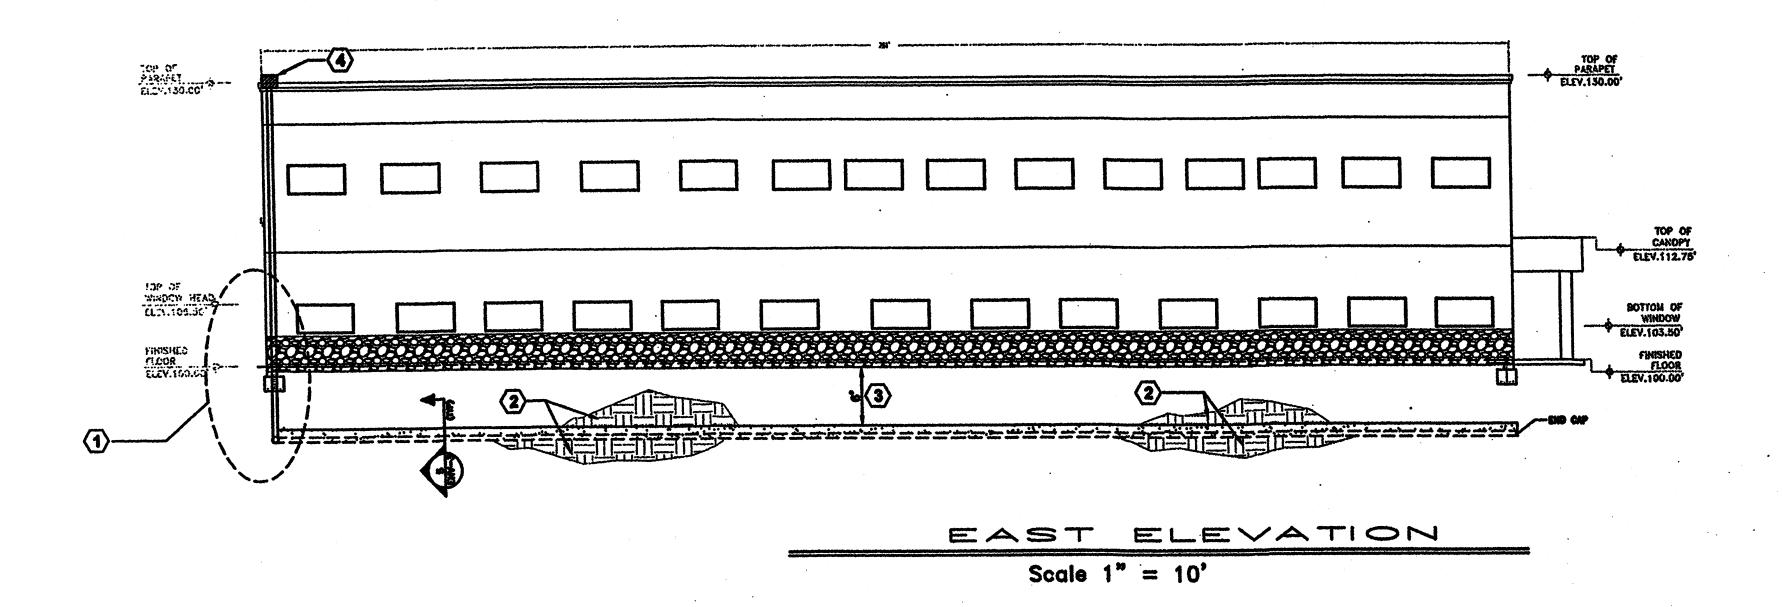

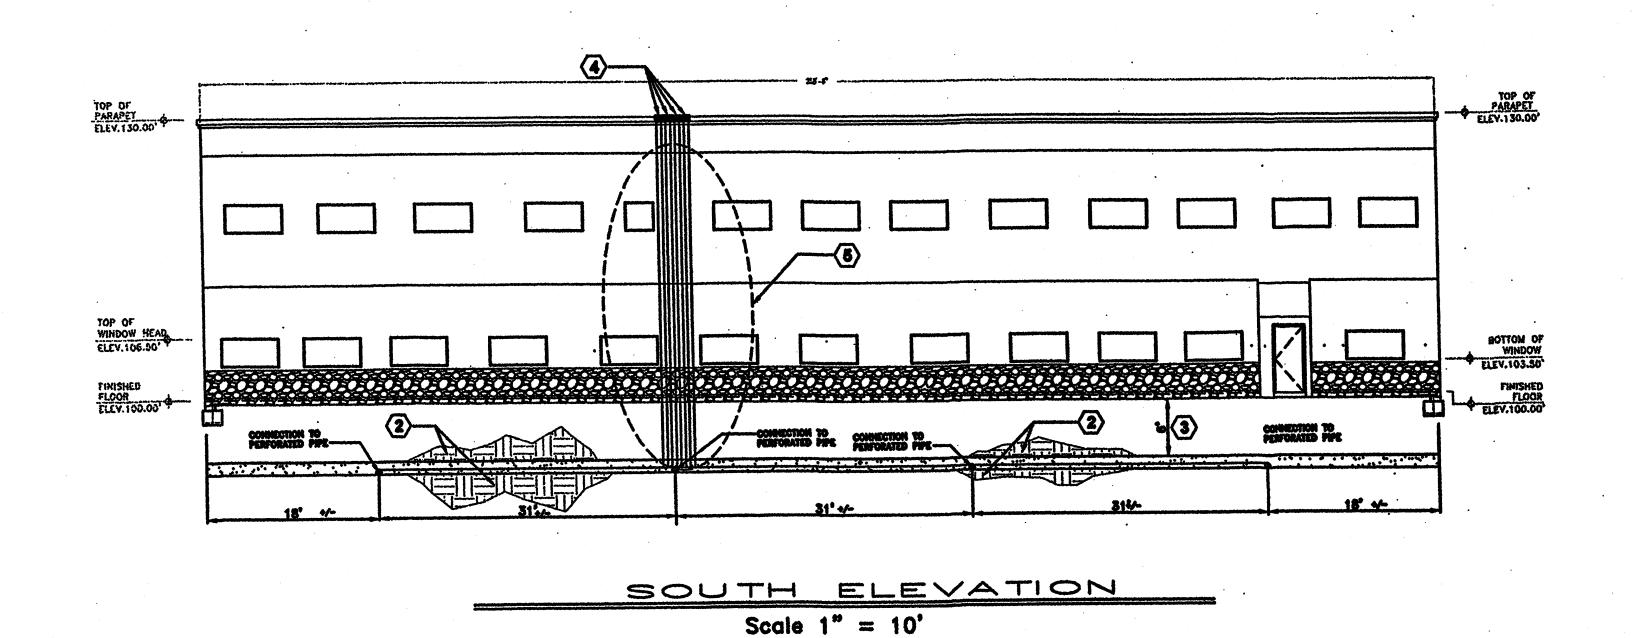

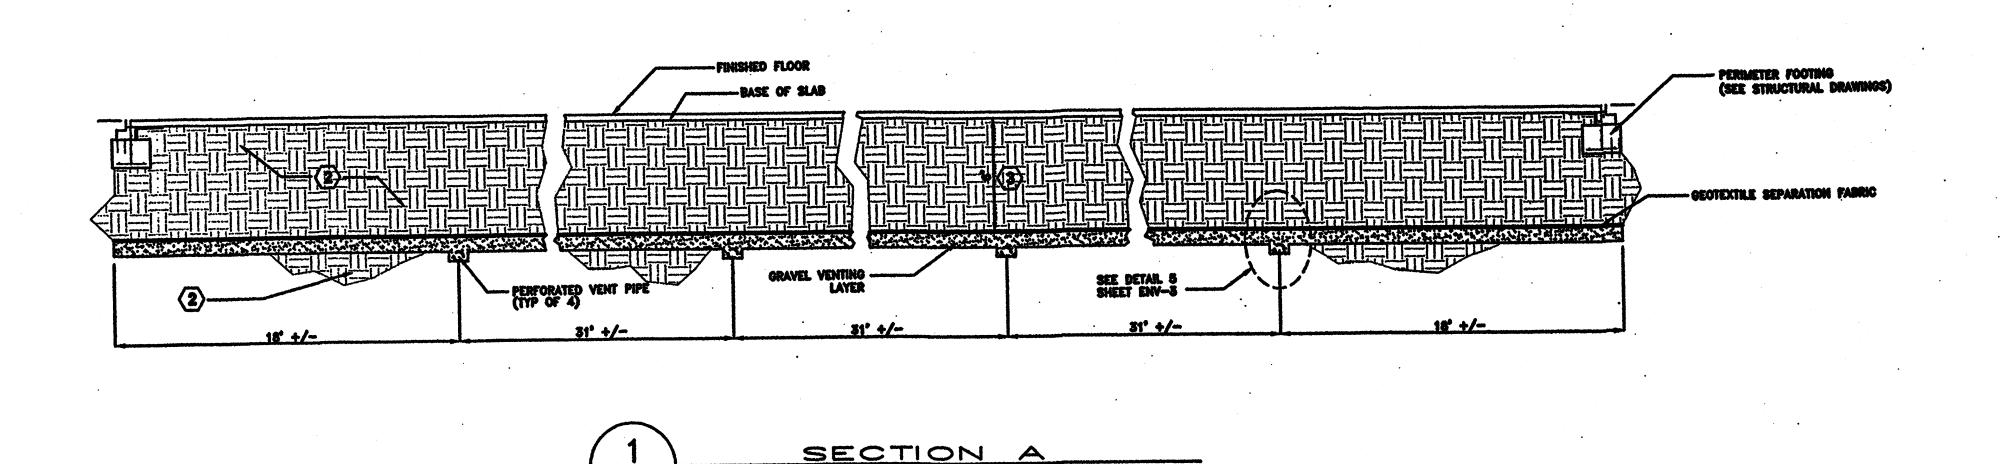

Scale 1" = 5'



۱.			
	J08 I	NO: 07-18	
	DATE	08 Aug 08	
		REVISIONS	
	1		

6' SEPARATION DISTANCE BETWEEN BASE OF SLAB AND TOP OF GRAVEL VENTING LAYER (GEOTEXTILE SEPARATION FABRIC).

GENERAL NOTES

KEYED NOTES

SHALL BE PER (1)

1. ELEVATION BASE BY ISBS LLC - OWNER.

SYSTEM TO BE GLUED AT CONNECTIONS.

STEMWALL AT PENETRATIONS.

2. ALL PENETRATIONS THROUGH THE BASE LEVEL CONCRETE

3. ALL PIPING AND FITTINGS FOR PARKING AND BUILDING VENT

USE FITTINGS AS REQUIRED TO CONNECT 6" PVC RISER

PENETRATIONS THROUGH FOOTINGS AND STEMWALL

SHALL BE SEALED SIMILAR TO (BN/A) . STRUCTURAL ENGINEER TO VERIFY INTEGRITY OF FOOTING AND

PLACE AND COMPACT FILL IN ACCORDANCE WITH SOILS

BETWEEN BASE OF WASTE EXCAVATION AND BASE OF

VENTING LAYER, AND BETWEEN TOP OF VENTING LAYER AND BASE OF SLAB.

REPORT. SOILS TO BE COMPACTED TO REQUIRED DENSITY AT 0 TO 2 PERCENT ABOVE OPTIMUM MOISUTRE CONTENT

PENETRATE CONCRETE FOOTING AND STEMWALL.


PIPES TO 6" PVC PERFORATED VENT PIPES. RISERS TO


TURBINE VENTILATION FAN MODEL BEB-12 OR BIB-12 (LOMANCO INC. 1-800-643-5596) OR APPROVED ALTERNATE. TOP OF VENTILATION FANS TO STICK UP MINIMUM OF 6 INCHES ABOVE TOP OF PARAPET. VENTILATION FANS TO BE SPACED MINIMUM OF 6 INCHES APART (EDGE TO EDGE). SEE SHEET A-18 FOR ROOF VENT DETIALS.


RISER PIPES INSIDE CHASE OR WALL SHALL BE PROTECTED FROM PUNCTURE BY NAILS OR SCREWS BY COVERING RISERS WITH MINIMUM 12 GAGE GALVANIZED METAL SHEETING. ALSO REFER TO (1). SEE SHEET A-18 FOR ROOF VENT DETIALS.


PO BOX 98 ALBUCUEROUE, (505) 250-46 MCHAEL DEL.M 7505 DELWOOD FD. ALBUCUEROUE, N	


SECTION DING ENGINEER BUIL ABATEMENT SYSTEM ELEVATIONS OFFICE OF

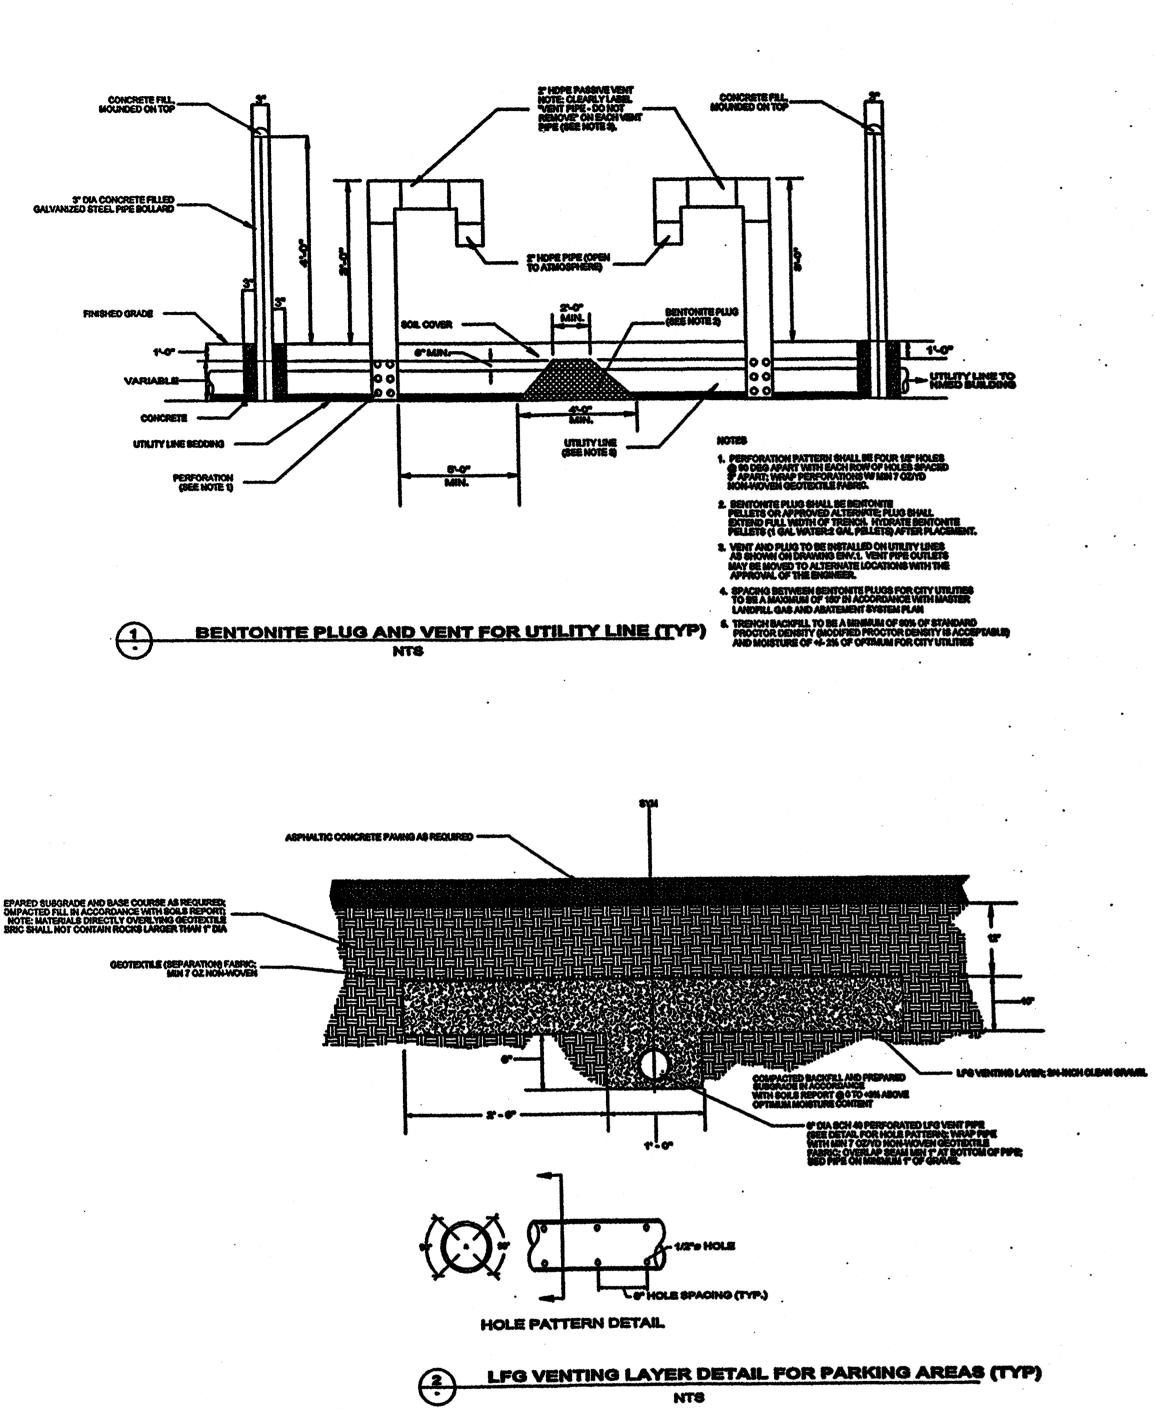

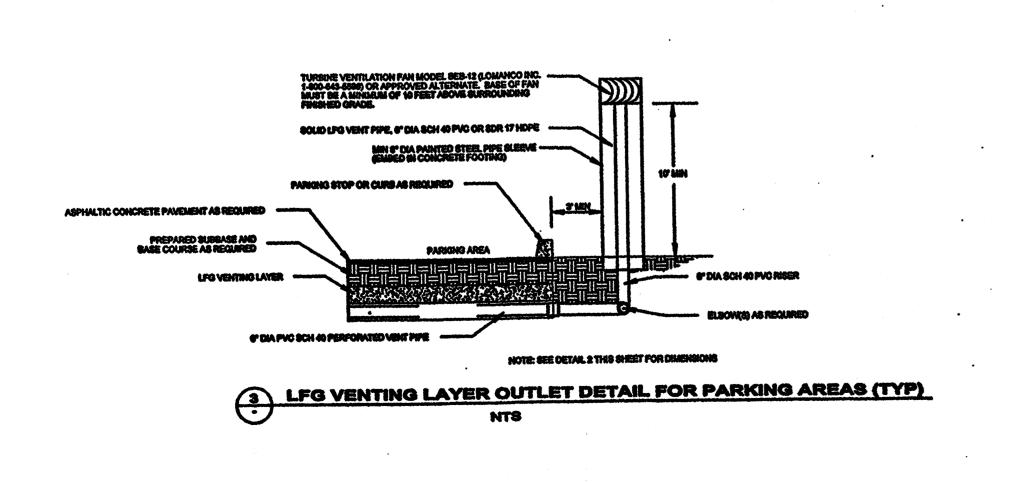


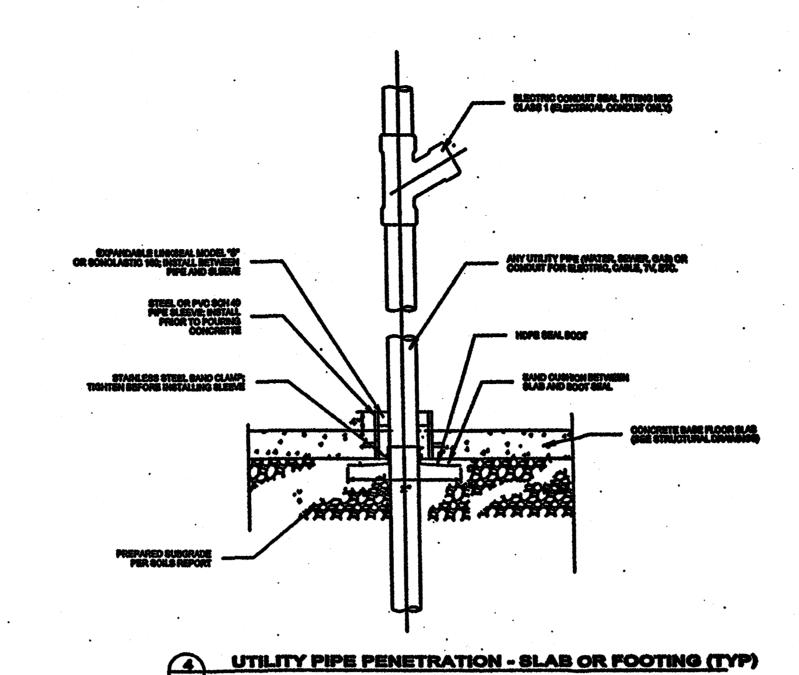

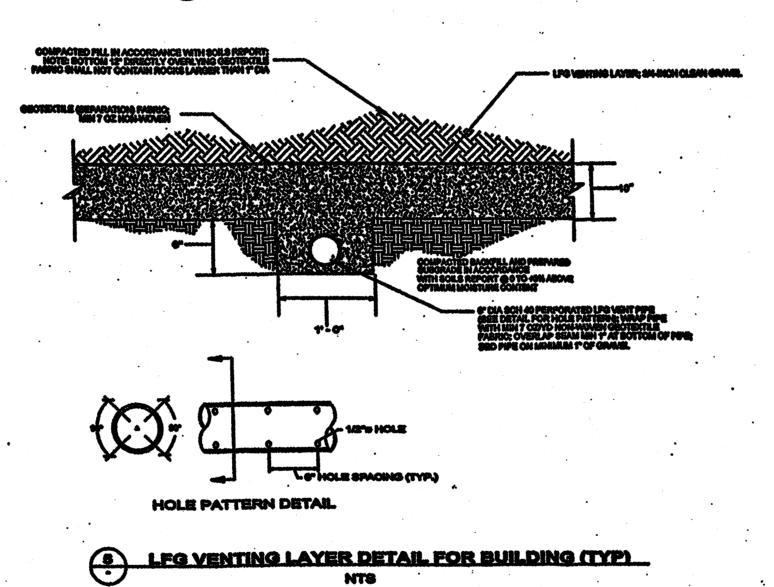


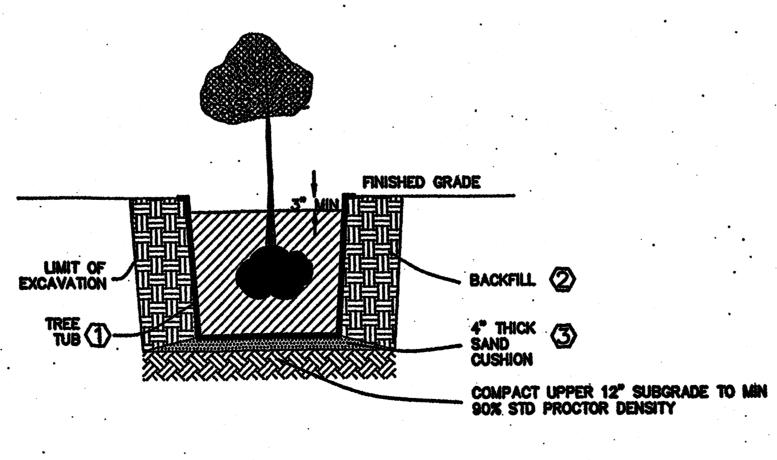


- KEYED NOTES:
- The big planters.com (1-800-262-3296) or approved equal. Size to be determined by landscape contractor/ professional.
- SELECT BACKFILL W/ NO ROCKS LARGER THAN 1" DIA.
 HAND TAMP BACKFILL FIRM IN LIFTS NO GREATER THAN
 6" LOOSE. BACKFILING SHALL NOT PROCEED AHEAD OF
 FILING INSIDE THE TREE TUB.
- 3- CLEAN SILICA SAND OR ROUNDED PEA GRAVEL

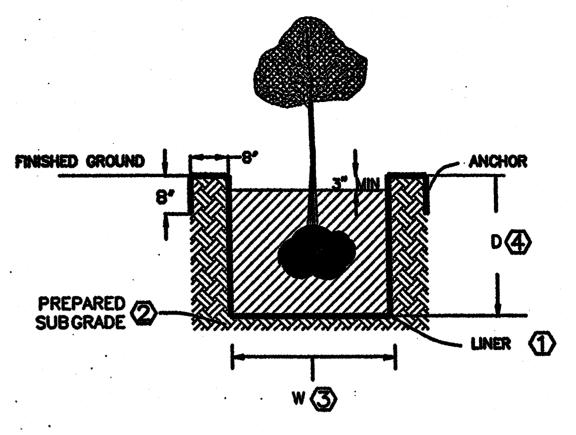

- PREPARE SUBGRADE BENEATH LINER BY COMPACTING UPPER 12° TO MIN SOX STD PROCTOR DENSITY. REMOVE ALL SHARP OBJECTS IN UPPER 6° AS IN (1) ABOVE OR PLACE 4° SAND CUSHION BETWEEN PREPARED SUBGRADE AND LINER (SAND CUSHION SHALL BE CLEAN SILICA SAND OR ROUNDED PEA GRAVEL).
- PLANTER WIDTH IS DETERMINED BY LANDSCAPE CONTRACTOR/ PROFESSIONAL, BUT NOT TO EXCEED 72 INCHES.

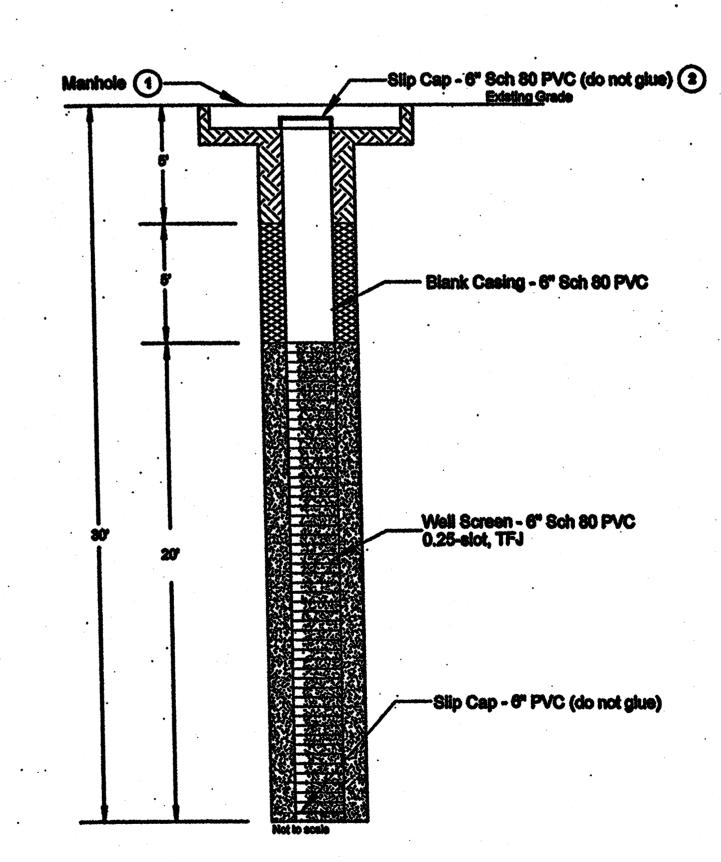

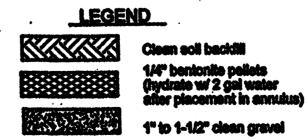

- Morrison MM418XA12X12 (12" x 12") Manhole
 Albuquerque Pipe (344-4646); Owner to supply keyed-ailke locks
 Owner to equip cap with quick-disconnect
 adapter Cole Parmer cet no. A-6359-81
 - Blank well casing shall be 6" 8ch 80 PVC TRJ Borehole-shall be minimum 24" diameter by drilling or trenching





80 guA 80 REVISIONS

BUILD DETAILS ENGINEER SYSTEM ENY-Ō

