

# NOTES: LOT A-3-B-1-7 BUILDING HEIGHT NOT TO EXCEED 26 FT. MAXIMUM FLOOR-AREA RATIO: 20.0% BUILDING MINIMUM SETBACKS: FRONT: 25.0 FT.


SIDE: 5.0 FT. REAR: 5.0 FT.

## TRAFFIC FLOW NOTES

- TRAFFIC FLOW
- RIGHT TURN ONLY INTO LOT
- RIGHT TURN ONLY OUT OF LOT

## PROPOSED GENERAL DESIGN CRITERIA:

- ALL STRUCTURES ON LOTS WILL BE LIMITED TO THE GENERAL CRITERIA DESCRIBED HEREIN.
- EXTERIOR APPEARANCE OF STRUCTURES WILL BE AS DEPICTED ON SHEET.
- PARKING WILL NOT EXCEED THE REQUIRED PLUS 10%.
- NO MORE THAN 25% OF THE REQUIRED PARKING WILL BE LOCATED IN FRONT OF THE BUILDING BETWEEN THE BUILDING AND THE STREET.
- ADA-COMPLIANT PARKING WILL BE LOCATED ADJACENT TO THE MAIN BUILDING ENTRY.
- ALL SIDEWALKS WILL HAVE A MINIMUM OF 6 FEET CLEAN TRAVEL AREA PROTECTED BY PERMANENT CAR STOPS.
- FRONT ENTRY SIDEWALK AREAS WILL BE COVERED OR SHADED BY TREES.
- ALL STRUCTURES SHALL BE CONNECTED BY PEDESTRIAN PATHWAYS PER CITY OF ALBUQUERQUE (COA) REQUIREMENTS.
- PATIO AREAS FOR EMPLOYEES WILL BE PROVIDED AND SHADED.
- BICYCLE RACKS WILL BE PROVIDED PER COA CODE.
- ALL LANDSCAPING WILL BE PER COA CODE. NO GREATER THAN 20% OF LANDSCAPED AREA WILL BE HIGH WATER USE AND ALL APPLICABLE WATER CONSERVATION MEASURES REQUIRED AT THE TIME OF BUILDING PERMIT APPLICATION WILL BE ADHERED TO.
- PERIMETER WALLS WILL COMPLY WITH PLANNING DEPARTMENT GUIDELINES AT TIME OF BUILDING PERMIT APPLICATION.
- ALL ROOFTOP OR GROUND LEVEL MECHANICAL UNITS WILL BE PHYSICALLY SCREENED FROM VIEW OR PAINTED TO BLEND WITH SURROUNDING STURCTURE'S COLOR. ALL ROOF PENETRATIONS WILL MATCH SRUCTURE OR ROOF COLOR.
- FRONT FACADES WILL BE SHADED BY EITHER THE BUILDING STRUCTURE, CANOPIES, PORTALS, AWNINGS, OR SHADE TREES PLANTED IN A MANNER TO SHADE THE ENTIRE FRONT FACADE OF THE STRUCTURE.
- LOADING DOCKS SHALL BE SCREENED BY WALLS, TREES, AND OR STRUCTURE ELEMENTS THAT ARE ARCHITECTURALLY INTEGRATED INTO THE STRUCTURE.
- ALL REFUSE ENCLOSURES WILL COMPLY WITH COA CODE AND SOLID WASTE REGULATIONS.
- BUILDING FRONTS WILL BE NO CLOSER THAN 12 FEET FROM THE FACE OF CURB TO THE STRUCTURE.
- MONUMENT SIGNS ARCHITECTURALLY INTEGRATED WITH THE STRUCTURE DESIGN WILL NOT EXCEED 10 FEET HIGH OR 75 SQUARE FEET PER SIGN.
- BUILDING SIGNS SHALL NOT EXCEED 6% OF THE FACADE AREA.
- SITE AND BUILDING LIGHTING WILL COMPLY WITH COA CODES AND REGULATIONS. IN NO INSTANCE SHALL LIGHT ESCAPE BEYOND THE PROPERTY LINE.

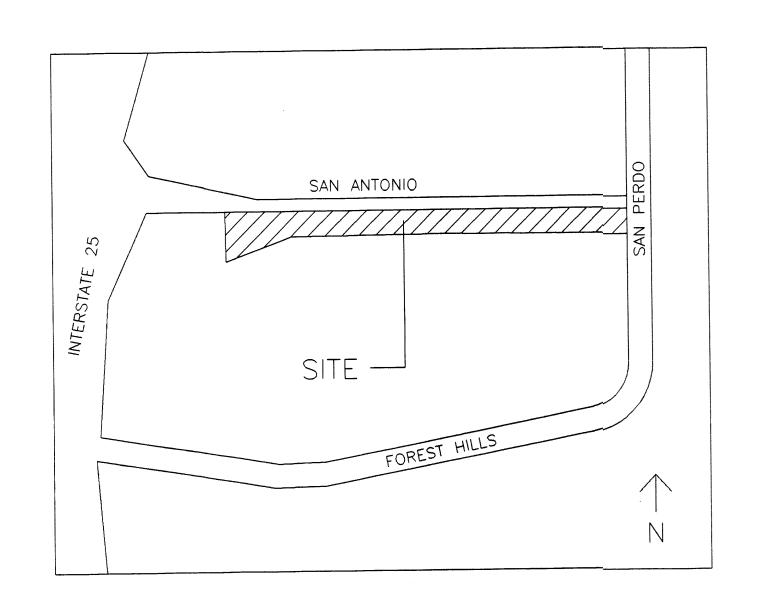


VICINITY MAP

PROJECT N	IUMBER:	1002455
Application Num	IDCI	

This plan is consistemt with the specific Site Development Plan approved by the Environmental Planning Commission (EPC). date <u>March 21, 2003</u> and the Findings and Conditions in the Official Notification of Decision are satisfied.

DRB SITE DEVELOPMENT PLAN SIGNOFF APPROVAL:

Traffic Engineering, Transportation Division	Date
Utilities Development	Date
Parks and Recreation Department	Date
City Engineer	Date
* Environmental Health Department (conditional)	Date
Solid Waste Management	Date
DRB Chairperson, Planning Department	 Date

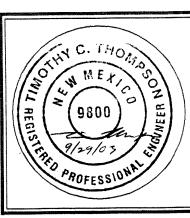

JOB NO:  DATE: 30 Seotember 2003  REVISIONS	f			•
30 Seotember 2003	JOB NO:			
REVISIONS	DATE:	30	Seotember	2003
		-	REVISIONS	

Sheet Title
SITE PLAN FOR SUBDIVISION

Drawn By. R.A.R. Checked By. M.D.M.


Project Name

J GROUP SUBDIVISION


ALBUQUERQUE, NEW MEXICO


SHEET NO.

SITE PLAN FOR SUBDIVISION

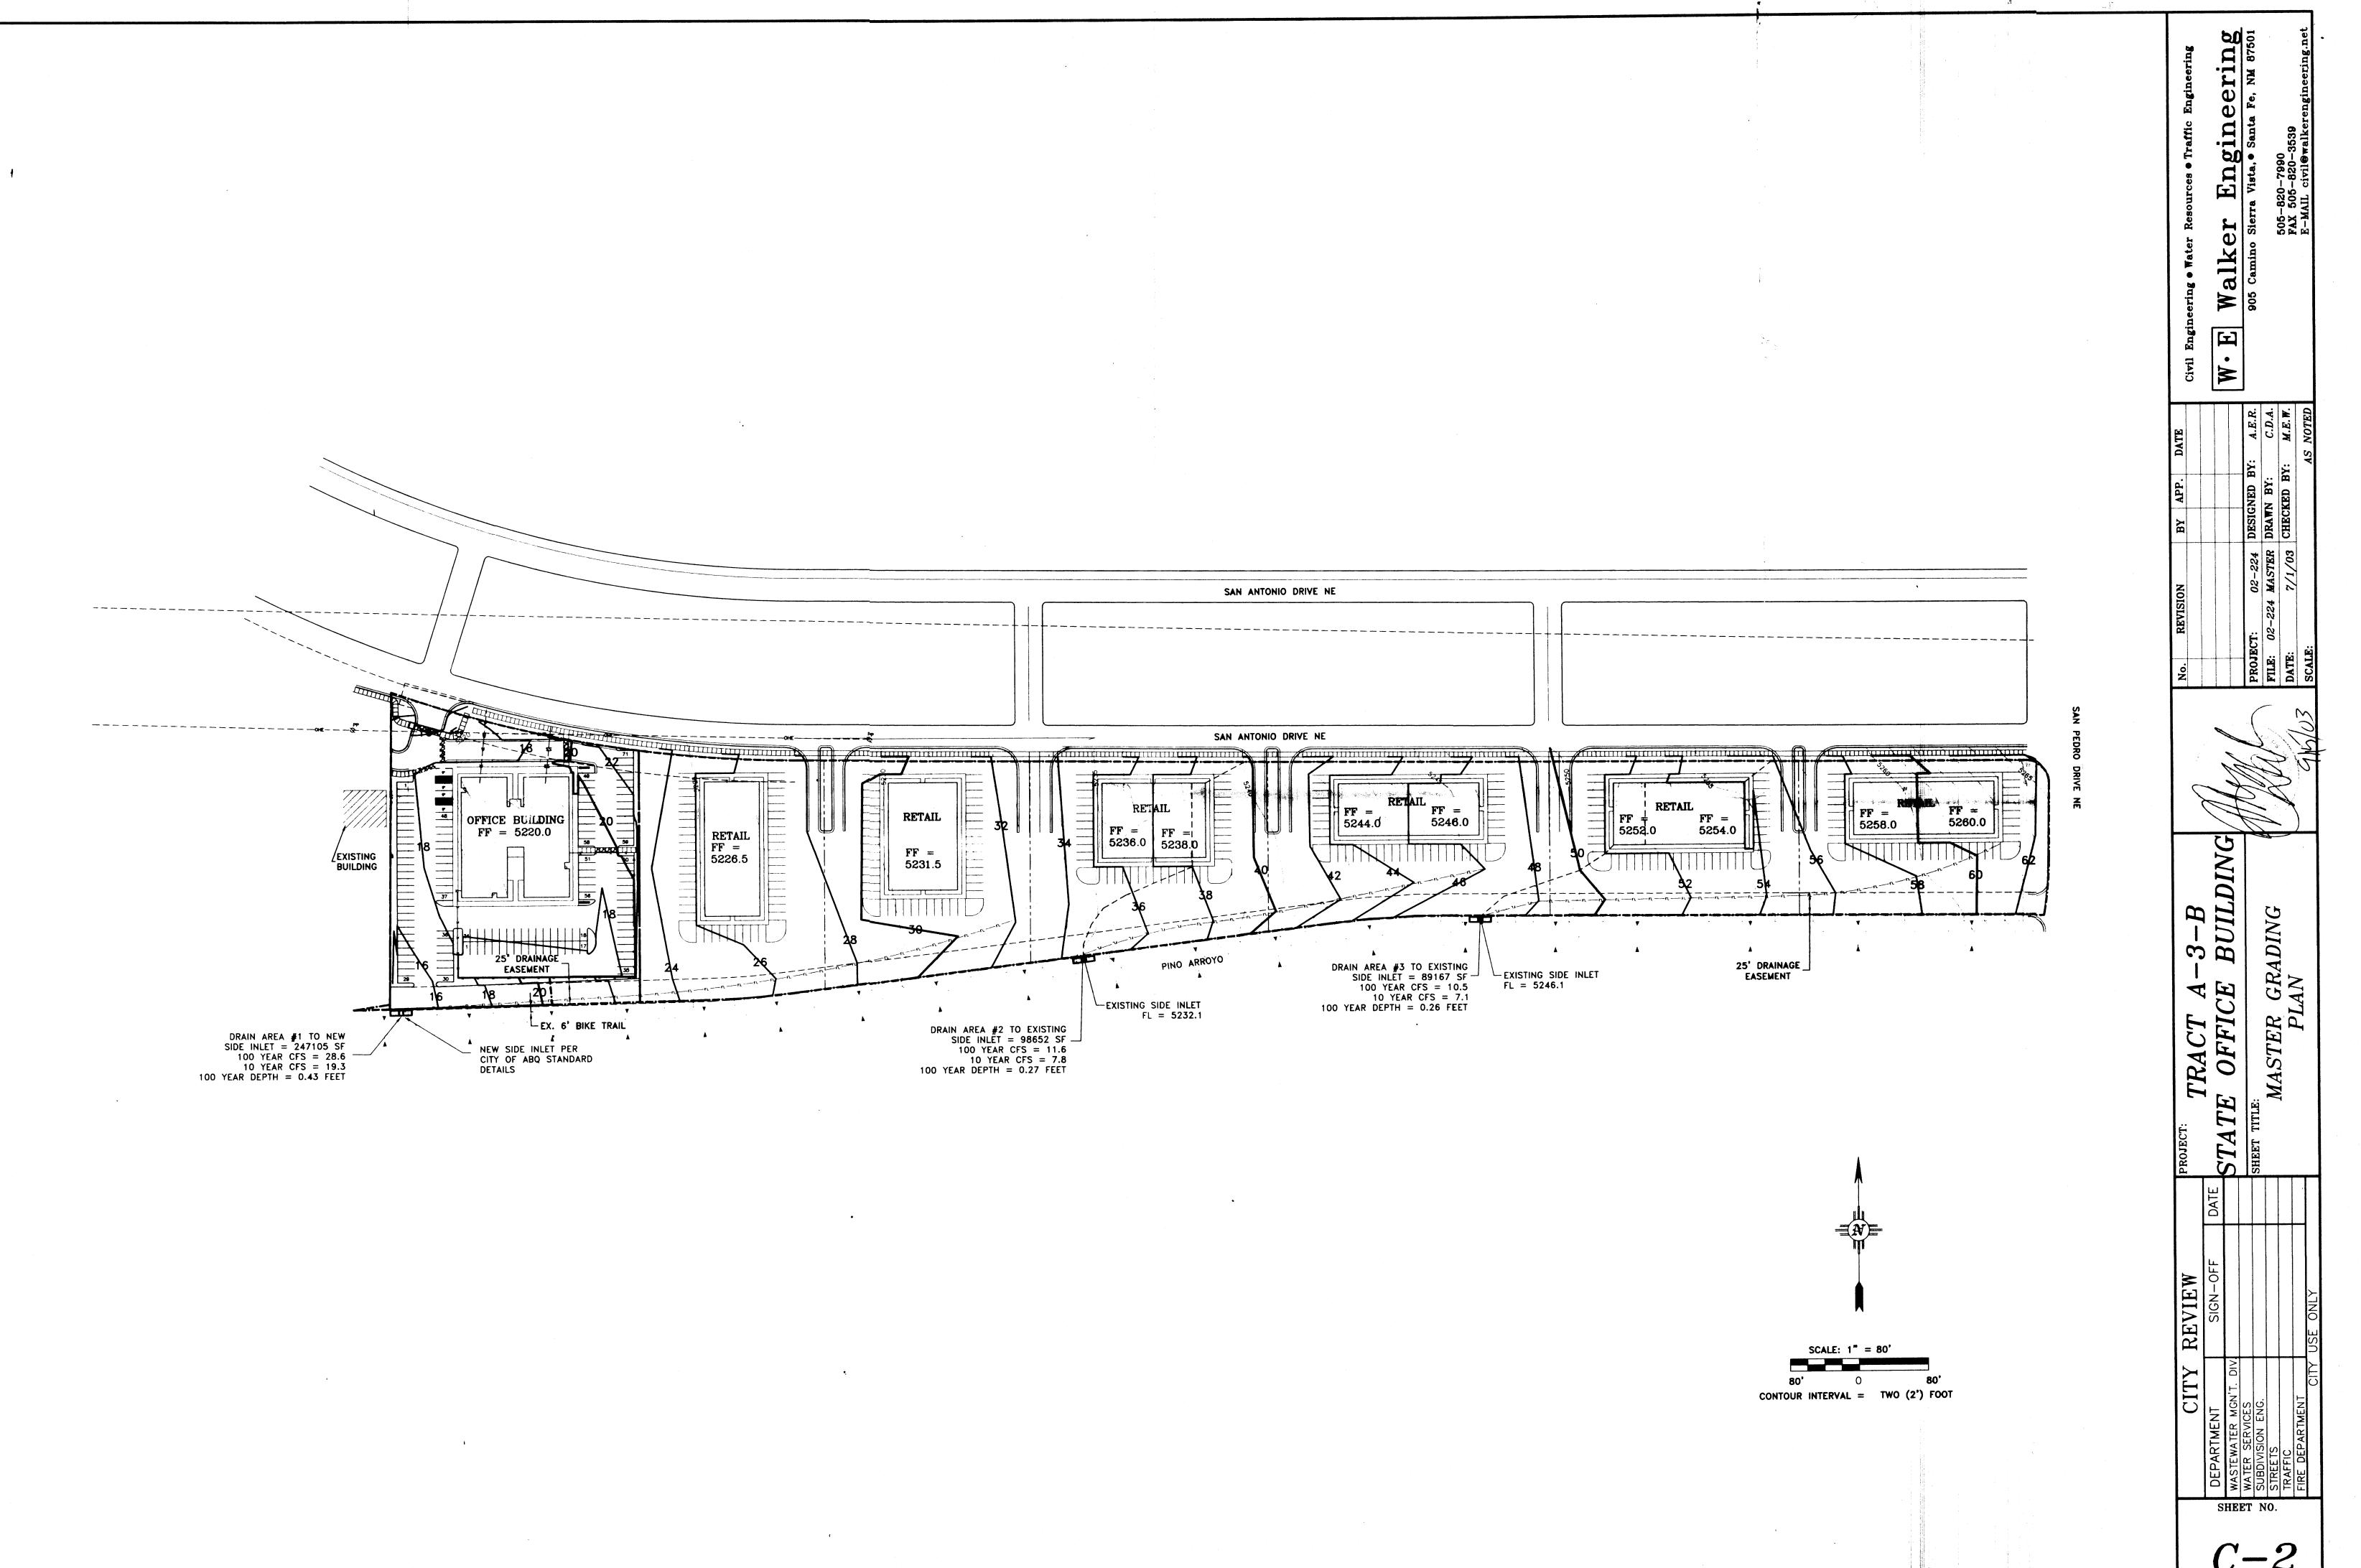

C-2

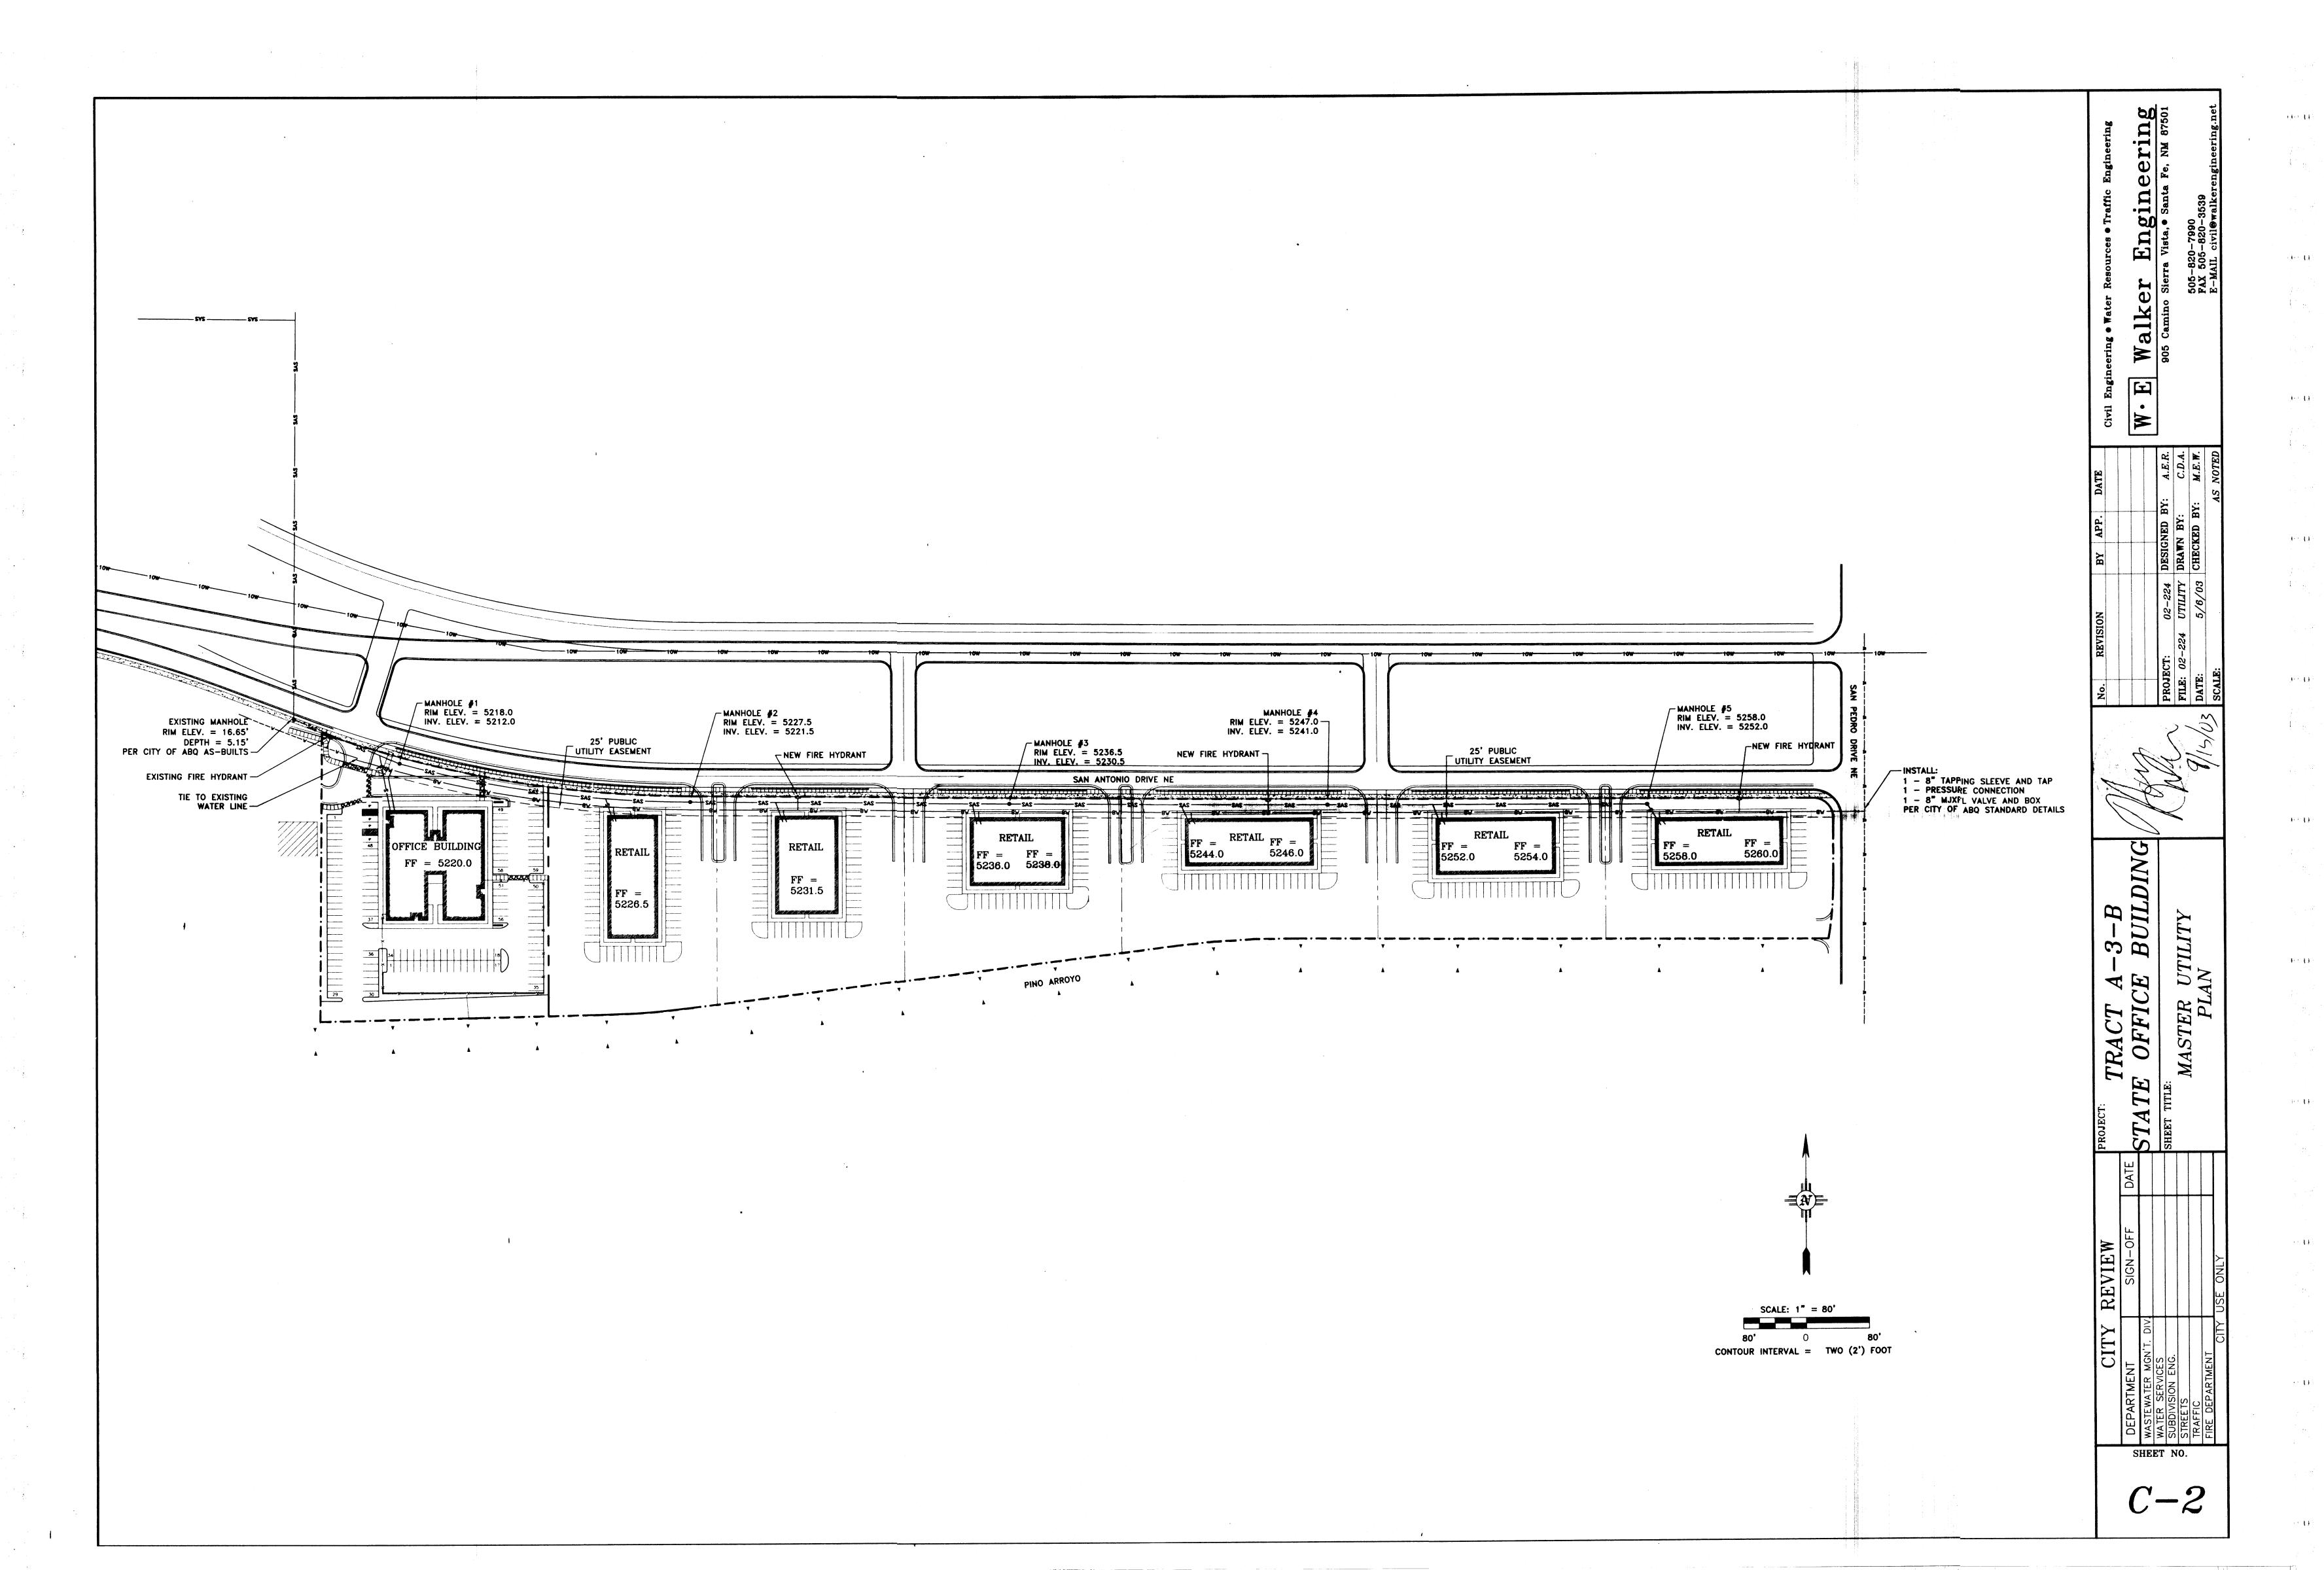

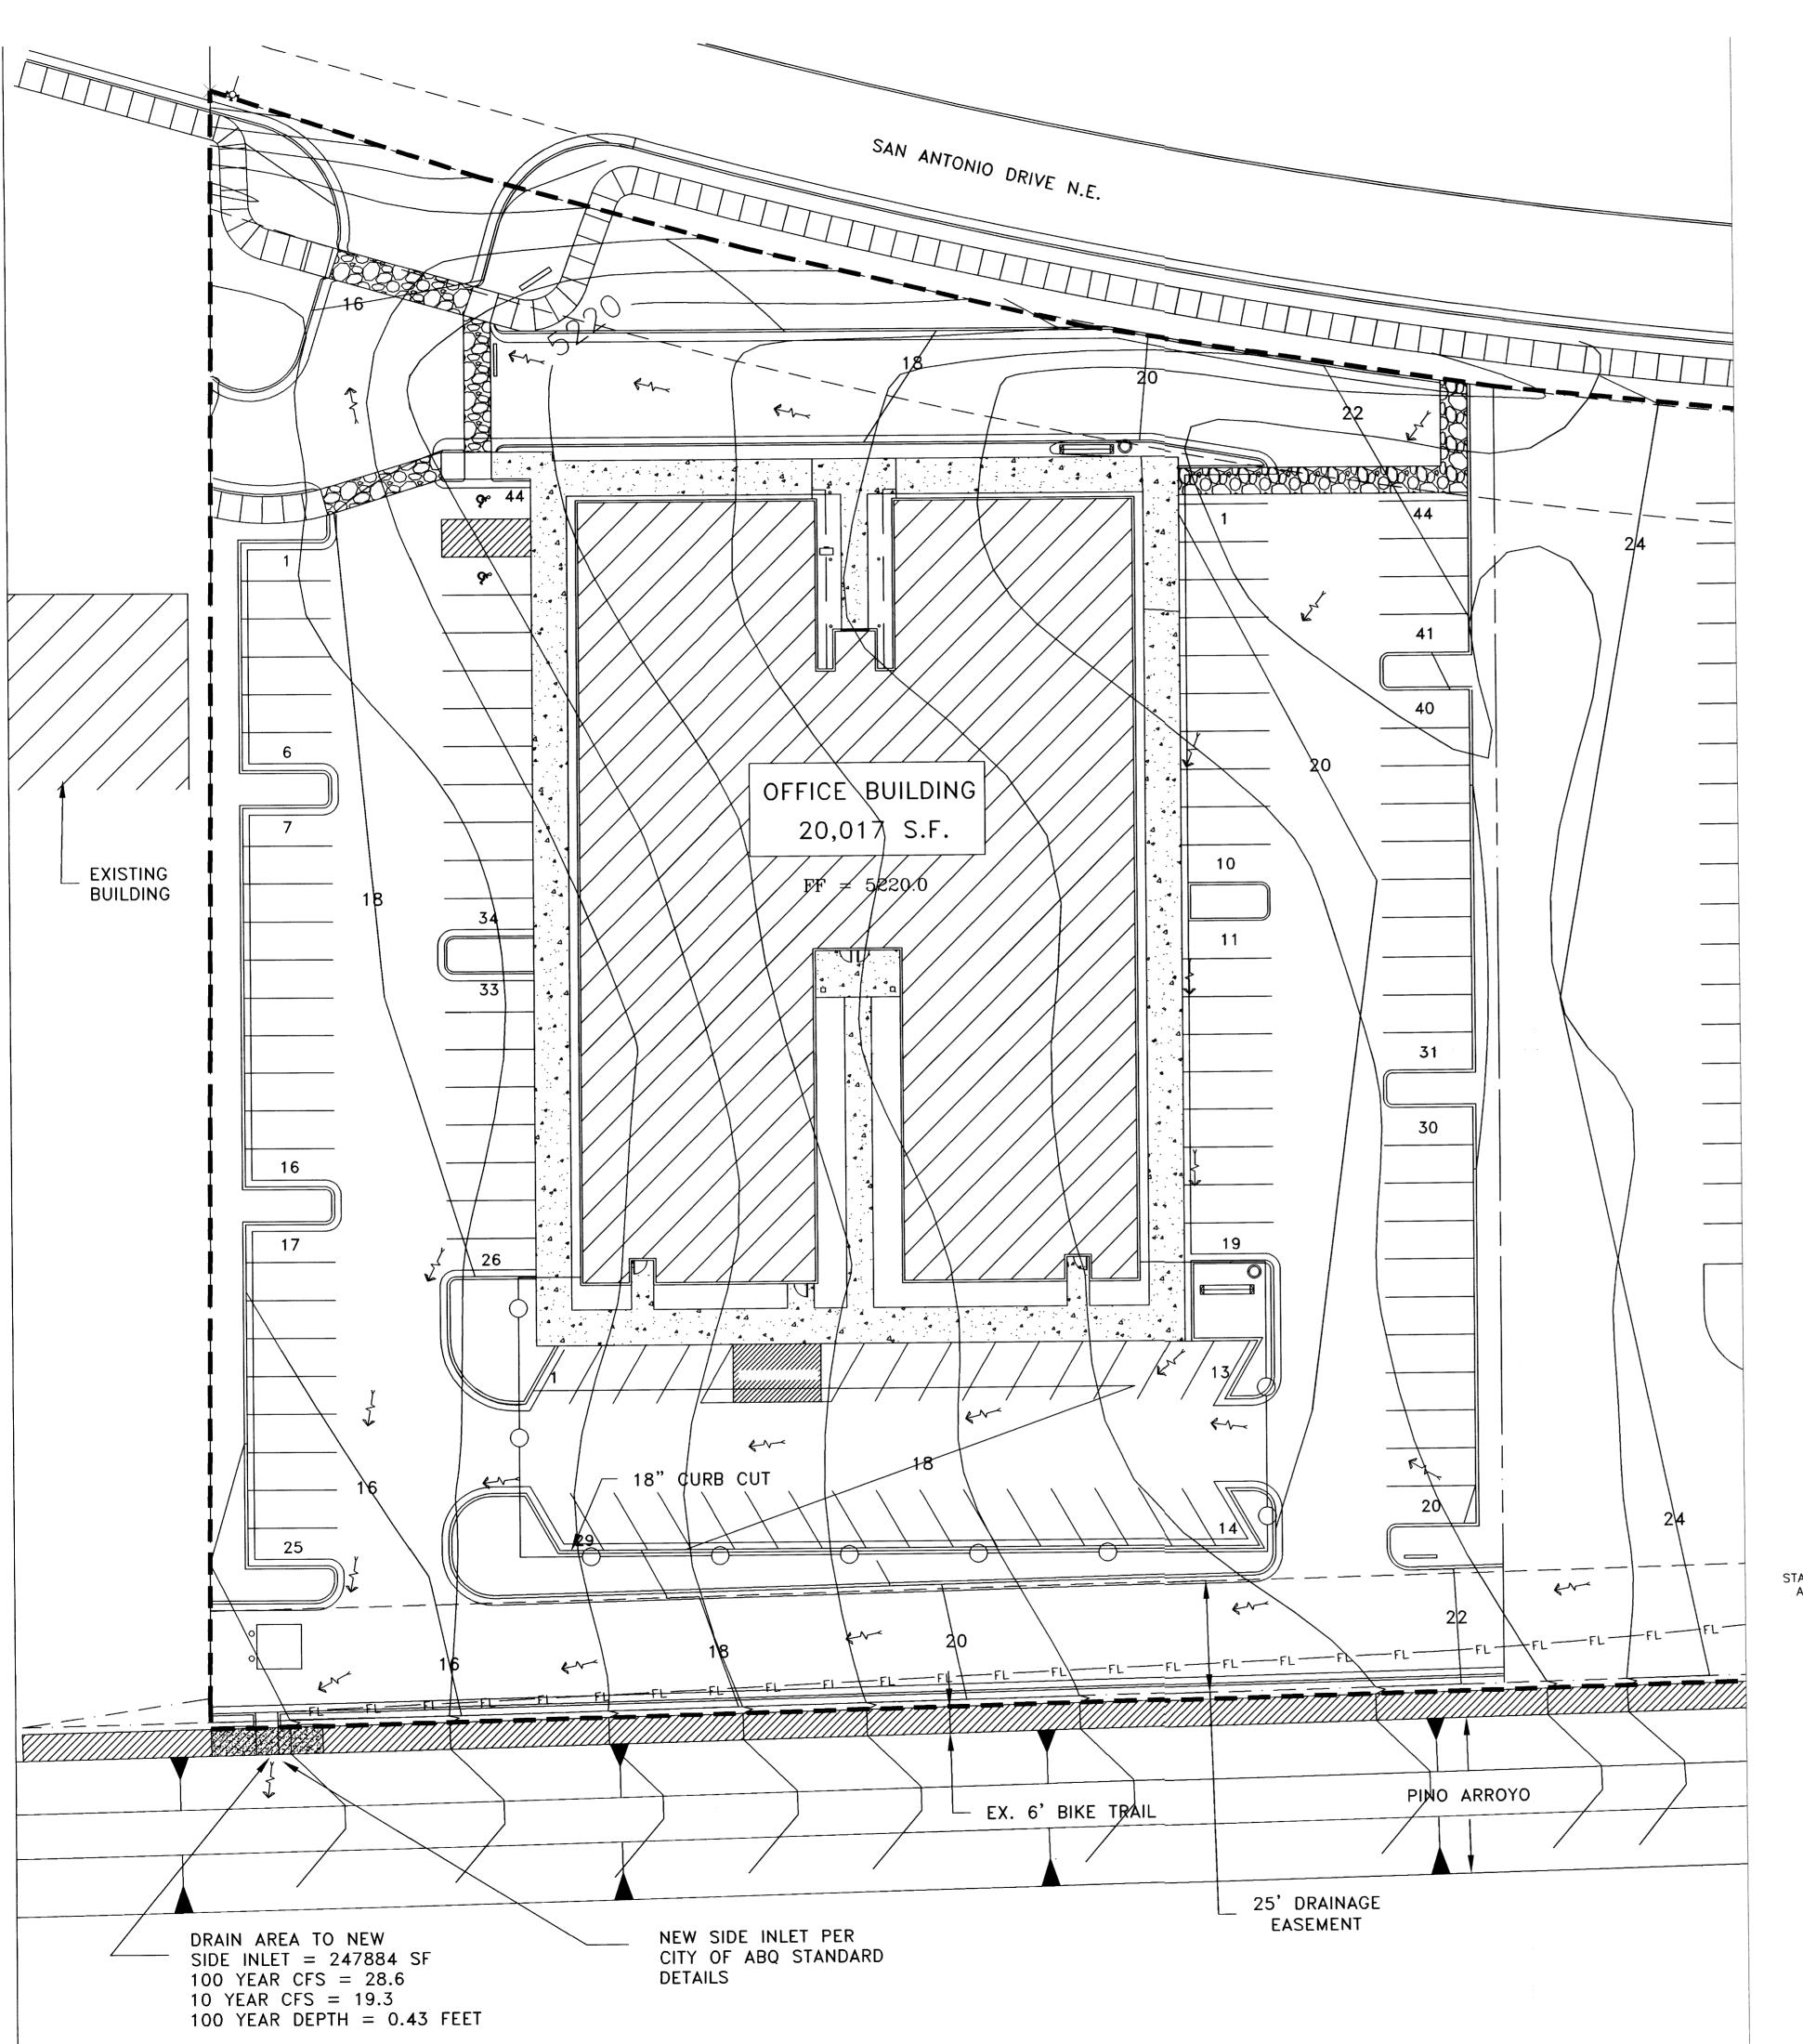

## STAKING NOTE

INFORMATION SHOWN IS FOR GRADING AND DRAINAGE ONLY AND IS NOT TO BE USED FOR STAKING PURPOSES. SEE SITE PLAN FOR ACTUAL LOCATION OF IMPROVEMENTS.


## TOPOGRAPHY NOTE


ALL EXISTING TOPOGRAPHIC SURVEY DATA SHOWN ON THESE PLANS HAS BEEN OBTAINED BY OTHERS. WALKER ENGINEERING HAS UNDERTAKEN NO FIELD VERIFICATION OF THIS INFORMATION, AND MAKES NO REPRESENTATION PERTAINING THERETO, AND ASSUMES NO RESPONSIBILITY OR LIABILITY THEREFOR.


## UTILITY NOTE

IF ANY UTILITY LINES, PIPELINES, OR UNDERGROUND UTILITY LINES ARE SHOWN ON THE DRAWING, THEY ARE SHOWN IN APPROXIMATE MANNER ONLY. UTILITY LINES MAY EXIST WHERE NONE ARE SHOWN. IF ANY SUCH EXISTING LINES ARE SHOWN, THE LOCATION IS BASED UPON INFORMATION PROVIDED BY THE UTILITY OR PIPELINE COMPANY, THE OWNER, OR BY OTHERS. THE INFORMATION MAY BE INCOMPLETE, OR MAY BE OBSOLETE BY THE TIME CONSTRUCTION COMMENCES.

THE ENGINEER HAS UNDERTAKEN NO FIELD VERIFICATION OF THE LOCATION, DEPTH, SIZE OR TYPE OF EXISTING ABOVE AND UNDERGROUND UTILITIES, OR EXISTING PIPELINES. THE ENGINEER MAKES NO REPRESENTATION PERTAINING THERETO, AND ASSUMES NO RESPONSIBILITY OR LIABILITY THEREFOR. THE CONTRACTOR SHALL INFORM HIMSELF OF THE LOCATION OF ANY EXISTING ABOVE AND UNDERGROUND UTILITIES, AND EXISTING PIPELINES, IN AND NEAR THE AREA OF THE WORK, IN ADVANCE OF AND DURING EXCAVATION WORK. THE CONTRACTOR IS FULLY RESPONSIBLE FOR ANY AND ALL DAMAGE CAUSED BY HIS FAILURE TO LOCATE, IDENTIFY AND PRESERVE ANY AND ALL EXISTING ABOVE AND UNDERGROUND UTILITIES, AND EXISTING PIPELINES. THE CONTRACTOR SHALL COMPLY WITH STATE STATUES PERTAINING TO THE LOCATION OF THESE LINES IN PLANNING AND CONDUCTING EXCAVATION WORK.

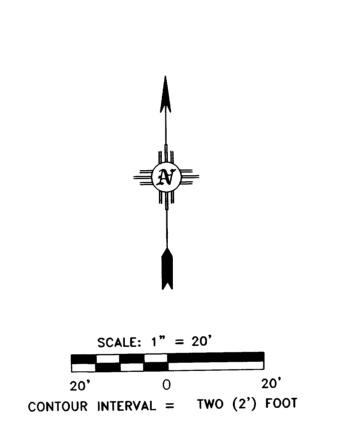

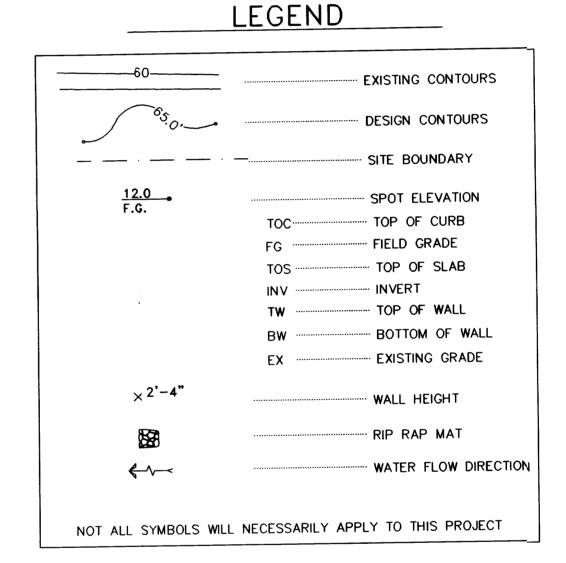

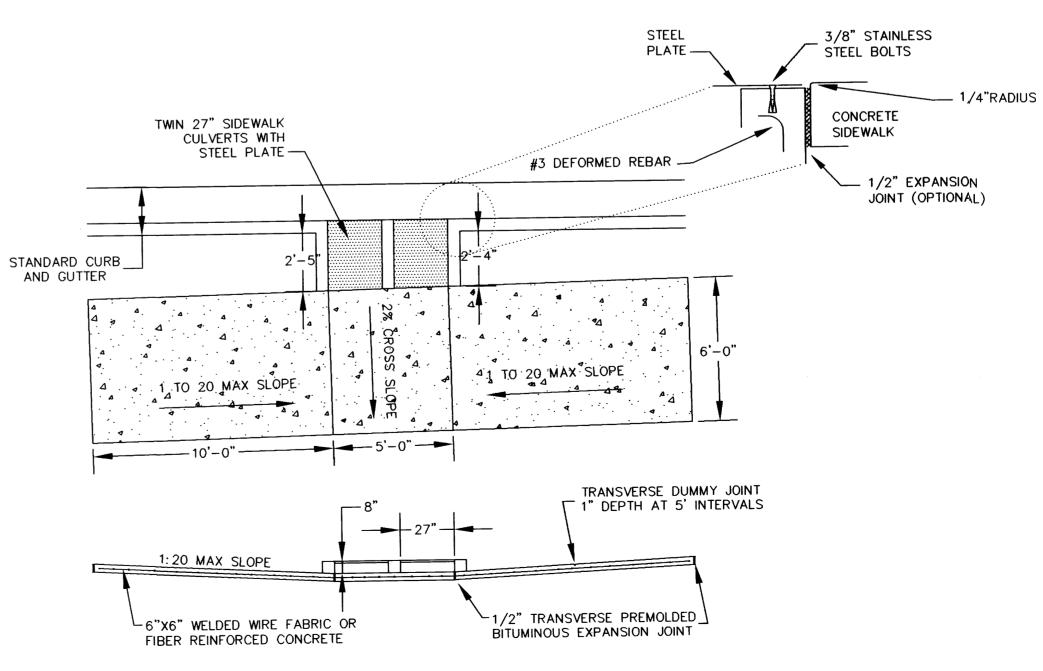

SIDE INLET DETAIL

- -H alk M H **X** -3-B BUILDING OFFIC TRACT

CITY REVIEW

PARTMENT

SIGN-OFF

DATE

SIGN-OFF

DATE

STATE OFFICE BUILL

SHEET TITLE:

GRADING AND

FICH

DATE


SHEET TITLE:

GRADING AND

DRAINAGE PLAN

C-1

SHEET NO.

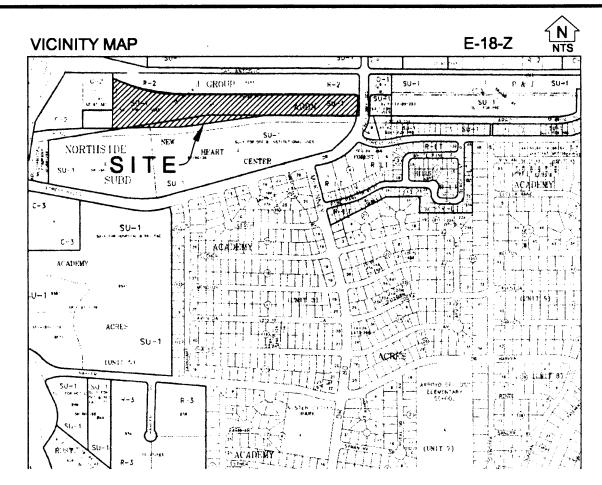

#### NOTES

- 1) The purpose of this plat is to create seven (7) commercial lots from three (3) existing tracts.
- 2) Bearings shown hereon are New Mexico State Plane Grid bearings, Central Zone (NAD 1927), All distances shown are ground.
- 3) Gross acreage = 10.0445 acres.

Existing tracts.....3.

Proposed tracts.....7.

- 4) Unless otherwise indicated, all property comers are monumented by a found rebar with cap stamped "LS 4071". Corners established by this plat are No. 5 rebar with cap stamped "NMRLS 7923".
- 5) City of Albuquerque water and sewer service is currently available to this property. Where applicable, availability should be coordinated with the Public Works Department.
- 6) This survey shows any easements apparent on the ground, as indicated by the plat of record, those disclosed by owners and those disclosed in a Title Binder prepared for this property by Fidelity National Title Co. (02-3007464-B-MD) dated 12/2/2002. No Title Search was performed by the
- Any underground structures not shown are not a part of this survey.
- B) There are no new rights of way created by this plat.
- Matters of zoning, property covenants and restrictions are not a part of this survey.
- Talos Log No. 2003380827.
- 11) See Master Landfill Gas Evaluation and Abatement System Plan note on sheet 2 regarding gas monitoring
- 12) The twenty-five (25) foot Ingress and egress easements as shown hereon are granted for the collective benefit of all owners of Lots 1 thru 7. Individual lot owner(s) are responsible for the maintenance of the portion of said easement lying within said owner(s) individual lot(s).

13) Current zoning is SU-1 For C-1 **UTILITY APPROVALS** Lend S. Mr. 15

David C. Muller 5-13-04

Rita Enclos - 5/6/04

#### **PUBLIC UTILITY EASEMENTS**

Public Utility Essements shown on this plat are for the common and joint use of

The PNM Electric Services for the installation, maintenance and service of overhead and underground electrical lines, transformers, poles and any other equipment, fixtures, structures and related facilities reasonably necessary to provide electrical services.

The PNM Gas Services for the installation, maintenance and service of natural gas lines, valves and other equipment and related facilities reasonably necessary to provide natural gas.

Qweet for the installation, maintenance and service of all buried and serial communication lines and other limited to, above ground pedestals and closures.

Comcest for the installetion, meintenance and service of such lines, cable and other related equipment and facilities reasonably necessary to provide Cable TV service.

Included is the right to build, rebuild, construct, reconstruct, locate, relocate, change, remove, modify, renew, operate and maintain facilities for the purposes described above, together with free access to, from and over said essements, including sufficient working area space for electric transformers, with the right and privilege to trim and remove trees, shrubs or bushes which interfere with the purposes set forth herein. No building, sign, pool (aboveground or subsurface), hot tub, concrete or wood pool decking or other structure shall be erected or constructed on said essements, nor shall any well be drilled or operated thereon. Property owners shall be solely responsible for correcting any violations of National Electric or Safety Code caused by construction or pools, decking of any structures adjacent to, within or near essements shown on this plat.

By approving this document, PNM does NOT waive or release any essements or essement rights which may have been granted by prior plat, replat or document, except those indicated on this plat.

#### LEGAL DESCRIPTION

A certain tract of land situate within Projected Section 25, Township 11 North, Range 3 East, N.M.P.M., in the Elena Gallegos Grant, City of Albuquerque, Bernalillo County, New Mexico, being and comprising all of Tract A-3-B, J GROUP ADDITION, filed in the Office of the Bernalillo County Clerk on 2/27/1996 in Plat Book 96C, Page 91, Tract 1, NEW HEART CENTER, filed in the Office of the Bernalillo County Clerk on 11/1/1991 in Plat Book 91C, Page 245, and Tract 1, NORTHSIDE SUBDIVISION, filed in the Office of the Bernalillo County Clerk on 3/14/1990 in Plat Book 90C, Page 72 and being more particularly described as follows:

BEGINNING at the Northwest corner of the Tract herein described, being the northwest corner of said Tract A-3-B, from whence the NMSHC Brass Cap monument "STA 1-25-14" bears N 18" 06' 08" W, a distance of 1446.60 feet; Thence, from said point of beginning,

Easterly, 486.25 feet along the arc of a curve bearing to the left having a radius of 1462.00 feet, a central angle of 19° 03' 22" and a chord which bears S 80° 05' 18" E, a distance of 484.01 feet along the southerly line of San Antonio Drive, N.E. to a point of tangency; Thence,

S 89° 37' 00" E, a distance of 1430.30 feet along said southerly line of San Antonio Drive N.E. to a point of curvature; Thence,

Southeasterly, a distance of 39.27 feet along the arc of a curve bearing to the right having a radius of 25.00 feet, a central angle of 90° 00' 00" and a chord which bears S 44° 37' 00" E, a distance of 35.36 feet to a point of tangency on the westerly line of San Pedro Drive, N.E.; Thence,

S 00° 23' 00" W, a distance of 86.71 feet along said westerly line of San Pedro Drive, N.E., to a point of

Southwesterly, a distance of 66.96 feet along the arc of a curve bearing to the right having a radius of 398.90 feet, a central angle of 09° 37' 04" and a chord which bears S 05° 11' 32" W, a distance of 66.87 feet to a non-tangent point on the north line of the right-of-way line for the Pino Arroyo; Thence,

N 89° 36' 30" W, a distance of 684.88 feet along said north line of the Pino Arroyo to a point of curvature; Thence, Westerly, a distance of 51.23 feet along the arc of a curve bearing to the left along said northern line of Pino Arroyo, having a radius of 1537.50 feet, a central angle of 01° 54' 33" and a chord which bears S 89° 26' 13" W, a distance of 51.23 feet to a point of compound curvature; Thence,

Westerly, a distance of 50.51 feet along the arc of a curve bearing to the left along said northern line of Pino Arroyo, having a radius of 787.50 feet, a central angle of 03° 40' 29" and a chord which bears S 86° 38' 41" W, a distance of 50.50 feet to a point of compound curvature; Thence,

Westerly, a distance of 51.23 feet along the arc of a curve bearing to the left along said northern line of Pino Arroyo, having a radius of 1537.50 feet, a central angle of 01° 54' 33" and a chord which bears S-83° 51' 10" W, a distance of 51.23 feet to a point of tangency; Thence,

S 82° 53' 54" W, a distance of 623.00 feet along said north line of the Pino Arroyo to a point of curvature; Thence, Westerly, a distance of 39.00 feet along the arc of a curve bearing to the right along said northern line of Pino Arroyo, having a radius of 1462.50 feet, a central angle of 01° 31' 40" and a chord which bears S 83° 39' 44" W, a distance of 39.00 feet to a point of compound curvature; Thence,

Westerly, a distance of 33.76 feet along the arc of a curve bearing to the right along said northern line of Pino Arroyo, having a radius of 712.50 feet, a central angle of 02° 42' 54" and a chord which bears S 85° 47' 01" W, a distance of 33.76 feet to a point of compound curvature; Thence,

Westerly, a distance of 39.00 feet along the arc of a curve bearing to the right along said northern line of Pino Arroyo, having a radius of 1462.50 feet, a central angle of 01° 31' 40" and a chord which bears S 87° 54' 18" W, a distance of 39.00 feet to a point of tangency; Thence,

S 88° 40' 08" W, a distance of 172.39 feet along said north line of the Pino Arroyo to an angle point; Thence, S 88° 39' 59" W, a distance of 230.80 feet along said north line of the Pino Arroyo to the southwest corner of the tract herein described; Thence,

N 81° 19' 52" E, a distance of 42.62 feet along said north line of said Tract 1, Northside Subdivision, to a point on the westerly line of said Tract A-3-B; Thence.

N 00° 26' 00" E, a distance of 363.82 feet along said westerly line of Tract A-3-B to the northwest corner and point of beginning of the tract herein described and containing 10.0445 acres, more or less.

## TREASURER'S CERTIFICATION

101806207848620119 This is to certify that taxes are current & paid on UPC # 1019062/5052720140, 101906213444620110 Property owners of record: The J Group, a New Mexico partnership & COTEUZZOLA, SOSEPH P.

Bernalillo County Treasurer's Office: Many Company Control of the Control of the

#### **FREE CONSENT**

The land described hereon, identified as LOTS 1 THRU 7, JJ SUBDIVISION is platted with the free consent and in accordance with the wishes and desires of the undersigned owner(s). Said owner(s) do hereby represent that they are so authorized to act.

## **ACKNOWLEDGMENT**

STATE OF NEW MEXICO

COUNTY OF BERNALINOSS

This instrument was acknowledged before me by Joseph P. Cotruzzola, partner for the J Group, a New Mexico Partnership, this 4th day of November, 2003.

By Landbo & Camble My Comnission Expires:

10-17-010

INDEXING INFORMATION FOR COUNTY CLERK

OWNERS: The J Group, a New Mexico **LOCATION: PROJECTED SECTION 25** TOWNSHIP 11 NORTH **RANGE 3 EAST** 

NAME: LOTS 1 THRU 7 JJ SUBDIVISION **PLAT OF** 

## LOTS 1 THRU 7 JJ SUBDIVISION

BEING A REPLAT OF TRACT A-3-B, J GROUP ADDITION, TRACT 1, NEW HEART CENTER & TRACT 1, NORTHSIDE SUBDIVISION

> WITHIN PROJECTED SECTION 25 **TOWNSHIP 11 NORTH, RANGE 3 EAST** NEW MEXICO PRINCIPAL MERIDIAN

> > CITY OF ALBUQUERQUE **BERNALILLO COUNTY NEW MEXICO**

> > > **NOVEMBER 2003**

SHEET 1 OF 2

#### **DISCLOSURE STATEMENT**

The purpose of this plat is to create seven (7) lots from three (3) existing tracts.



CITY APPROVALS

030RB.01899 DRB NO. 1001455

DRB Chairperson, Planning Department	5/19/04
A. Sold	
Gity Surveyor	//- 0 \( \tau - \tau 0 \) 3  Date
N/A	
Real Property Division	Date
Environmental Health Department	7/17, 200 Date

affic Engineer, Transposation Division	5.19.04
affic Engineer, Transposation Division	Date
Force & Diaco	5/20/04
ilities Development	Date
hristina Sandoval	5/19/04


5/20104


#### SURVEYOR'S CERTIFICATION

Parks and Recreation Department

I. Christopher J. Dehler, New Mexico Registered Land Surveyor No. 7923 hereby certify that the plat shown hereon was prepared by me or under my direct supervision from an actual field survey, shows all easements of record made known to me by the owners, utility companies and Fidelity National Title Co. (02-3007464-B-MD), meets the minimum requirements for monumentation and surveys of the Albuquerque Subdivision Ordinance, and the Minimum Standards for Land Surveys in New-Mexico and is true and correct to the best of my knowledge and belief.

11/03/03 Christopher J. Dehler N.M.R.L.S. No.7923

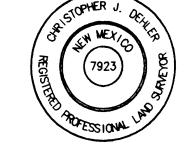

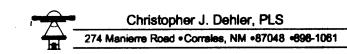

Job No. 1001403

MASTER LANDFILL GAS EVALUATION AND ABATEMENT SYSTEM PLAN NOTE

As a condition to this Subdivision Plat approval by the City, owner, its successors and assigns covenants and agrees to install a landfill gas monitoring well(s) and extraction system on the property, pursuant to that certain Master Landfill Gas Evaluation and Abatement System Plan for the proposed Subdivision at I-25 and San Antonio Boulevard. Lots A-3-B1 thru 7 (now known as Lots 1 thru 7, JJ Subdivision, Albuquerque, New Mexico, dated July 18, 2003 prepared by Lawrence Earth Engineering, Larry M. Coons, P.E. (the "Master Landfill Gas Evaluation and Abatement System Plan") and incorporated herein by reference. The landfill gas monitoring well (s) and extraction system shall be installed on a lot by lot basis as defined in the Master Landfill Gas Extraction and Abatement System Plan for any individual lot at the time of and as a condition to Site Development Plat approval, Design Review approval by the City's Design Review Committee or building permit approval, whichever occurs sooner.

The obligation of the owner, its successors and assigns of an individual lot to install landfill gas monitoring well (s) and extraction system shall include the obligation to monitor well(s) on a periodic basis as approved by the City as detailed in the Master Landfill Gas Evaluation and Abatement System Plan on file at the City's Environmental Health Department and incorporated herein by reference and initiating the start up, operation and maintenance of the extraction system, as required by the City as detailed in the Master Landfill Gas Evaluation and Abatement

This paragraph shall in its entirety constitute a covenant running with the title to each individual lot of the property as shown on this Plat shall be binding on the owner, its successors and assigns of each individual lot for the benefit of the City until terminated.

> - Former Tract 1 New Heart Center Filed 11/1/91 Bk. 91C, Pg. 245 Public Blanket Easement for Access and Utilities created by Subdivision & Dedication Plat

filed 11/1/1991 in Bk. 91C, Folio 245

(Above language by Assistant City Attorney, City of Albuquerque)

**PLAT OF** 

## LOTS 1 THRU 7 JJ SUBDIVISION

BEING A REPLAT OF TRACT A-3-B, J GROUP ADDITION, TRACT 1, NEW HEART CENTER & TRACT 1, NORTHSIDE SUBDIVISION

> WITHIN PROJECTED SECTION 25 TOWNSHIP 11 NORTH, RANGE 3 EAST NEW MEXICO PRINCIPAL MERIDAIN

> > CITY OF ALBUQUERQUE **BERNALILLO COUNTY NEW MEXICO**


> > > **NOVEMBER 2003**

SHEET 2 OF 2

DISCLOSURE STATEMENT

The purpose of this plat is to create seven (7) lots from three (3) existing tracts.



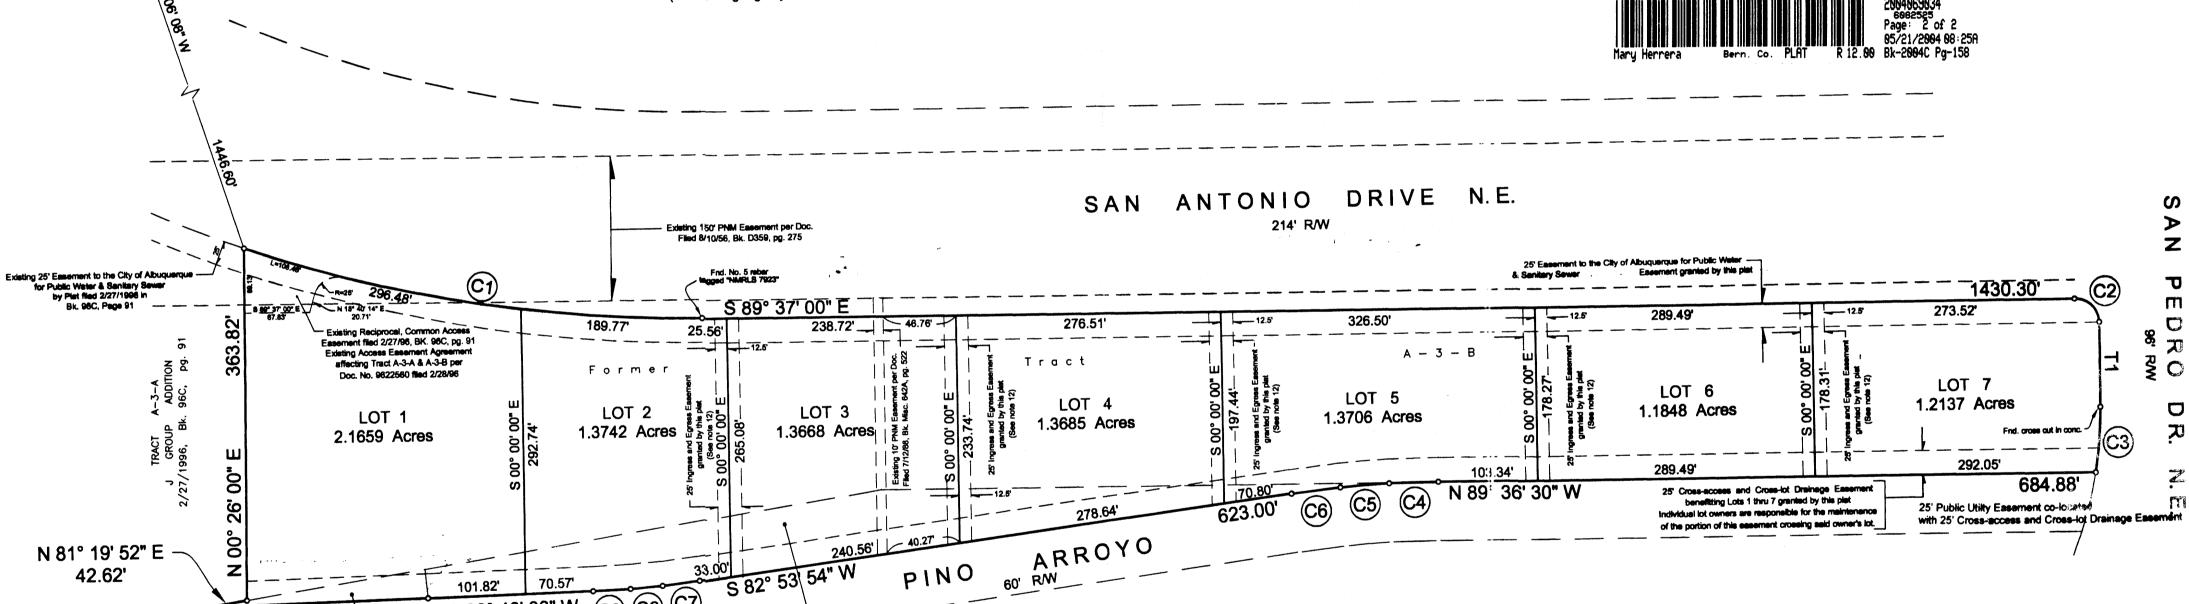

- Former Tract 1 NORTHSIDE SUBDIVISION Filed 3/14/90 Bk. 90C, Pg. 72

70.57

S 88° 40' 08" W ©9 ©8 ©7

"The subject property is located (near, on) a (former, existing) landfill. Due to the subject property

being (on, near), a former landfill, certain precautionary measures may need to be taken to ensure the health and safety of the public. Recommendations made by a professional engineer with

expertise in landfills and landfill gas issues (as required by the most current version of the "Interim

Guidelines for Development within 1000 Feet of Landfills") shall be consulted prior to development

S 88° 39' 59" W \230.80'

SCALE: 1" = 100'

NMSHC Brass Cap "Sta. I-25-14" NM State Plane Coordinates (Central Zone)

NAD 1927 X=399,828.26

Y=1,514,860.92

Gmd To Grid = 0.99966298 Delta Alpha = -00\* 11' 35"

of the site."

CURVE TABLE								
CURVE	LENGTH	RADIUS	DELTA	CHORD DIST.				
C1	486.25'	1462.00'	19° 03' 22"	484.01'				
C2	39.27	25.00'	90° 00' 00"	35.36'				
C3	66.96'	398.90'	09° 37' 04"	66.87'				
C4	51.23'	1537.50'	01° 54' 33"	51.23'				
C5	50.51'	787.50	03° 40' 29"	50.50'				
C6	51.23'	1537.50'	01° 54' 33"	51.23'				
C7	39.00'	1462.50'	01° 31' 40"	39.00'				
C8	33.76'	712.50'	02° 42' 54"	33.76'				
C9	39.00'	1462.50'	01° 31' 40"	39.00'				

**TANGENT TABLE** DISTANCE **BEARING TANGENT** S 00° 23' 00" W




## SURVEYOR'S CERTIFICATION

I, Christopher J. Dehler, New Mexico Registered Land Surveyor No. 7923 hereby certify that the plat shown hereon was prepared by me or under my direct supervision from an actual field survey, shows all easements of record made known to me by the owners, utility companies and Fidelity National Title Co. (02-3007464-B-MD), meets the minimum requirements for monumentation and surveys of the Albuquerque Subdivision Ordinance, and the Minimum Standards for Land Surveys in New Mexico and is true and correct to the best of my knowledge and belief.

Christopher J. Dehler N.M.R.L.S. No.7923

Christopher J. Dehler, PLS

Job No. 1001403

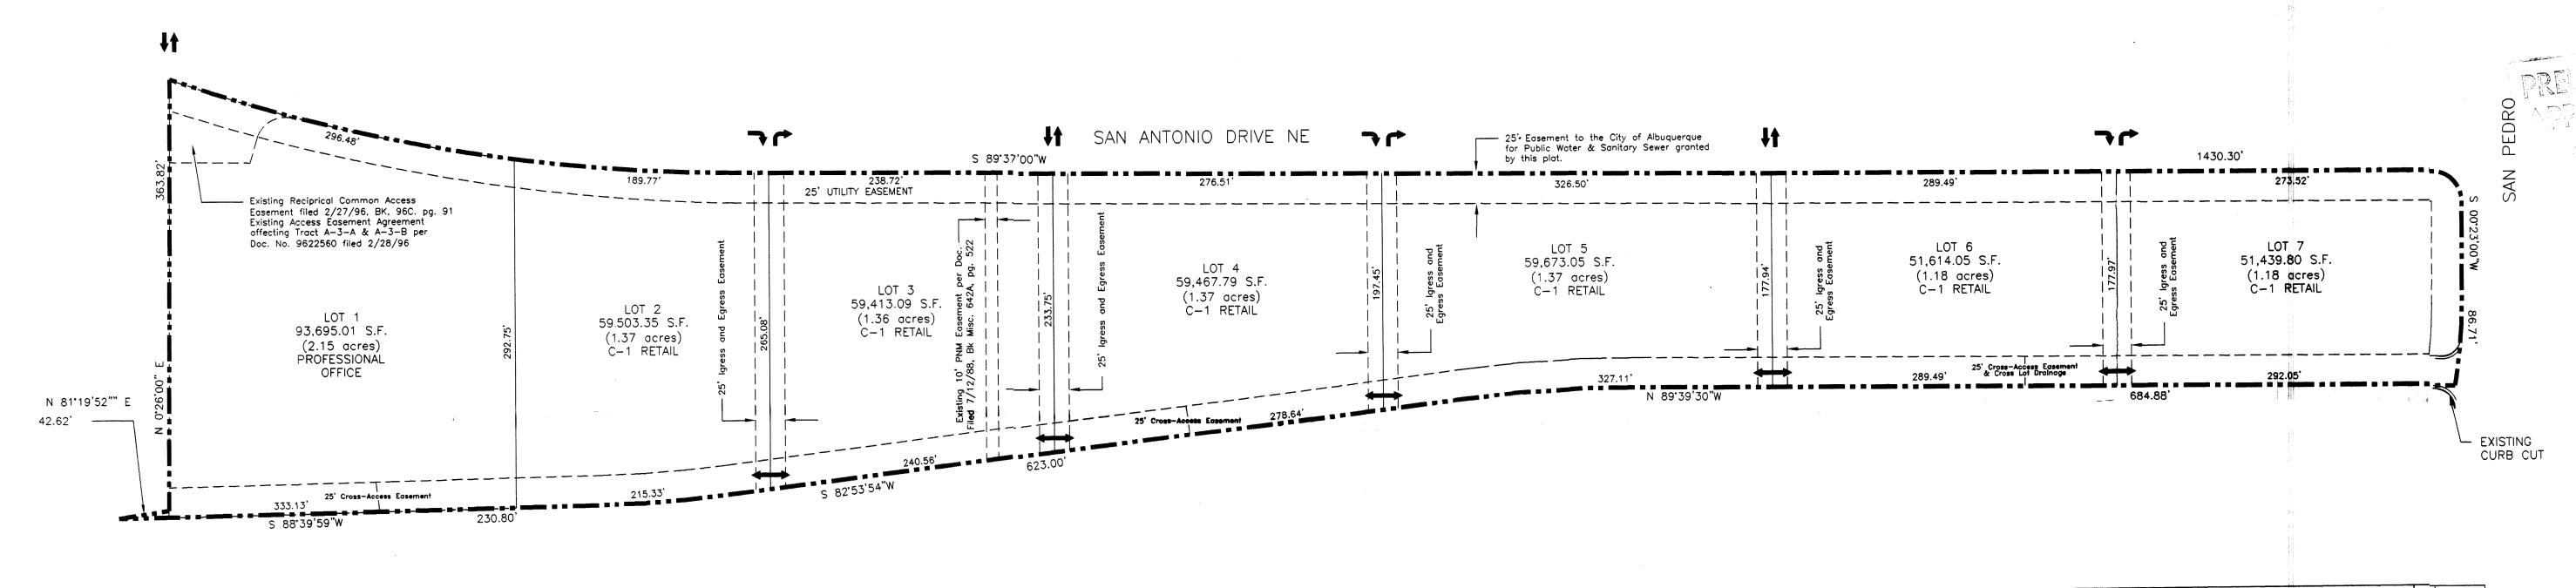

## LEGAL DESCRIPTION

LOTS 1 THRU 7 JJ SUBDIVISION

BEING A REPLAT OF TRACT A-3-B, J GROUP ADDITION, TRACT 1 NEW HEART CENTER & TRACT 1 NORTHSIDE SUBDIVISION

WITHIN PROJECTED SECTOIN 25 TOWNSHIP 11 NORTH, RANGE 3 EAST NEW MEXICO PRINCIPAL MERIDIAN

> CITY OF ALBUQUERQUE BERNALILLO COUNTY NEW MEXICO

## NOTES: LOTS 1 thru 7

BUILDING HEIGHT NOT TO EXCEED 26 FT. MAXIMUM FLOOR-AREA RATIO: 20.0% BUILDING MINIMUM SETBACKS: FRONT: 25.0 FT.


SIDE: 5.0 FT. REAR: 5.0 FT.

## TRAFFIC FLOW NOTES

- T TWO WAY INGRESS AND EGRESS TRAFFIC FLOW
- RIGHT TURN ONLY INTO LOT
- RIGHT TURN ONLY OUT OF LOT
- TWO WAY INTERIOR AND CROSS-LOT TRAFFIC FLOW

## PROPOSED GENERAL DESIGN CRITERIA:

- ALL STRUCTURES ON LOTS WILL BE LIMITED TO THE GENERAL CRITERIA DESCRIBED HEREIN.
- EXTERIOR APPEARANCE OF STRUCTURES WILL BE AS DEPICTED ON SHEET.
- PARKING WILL NOT EXCEED THE REQUIRED PLUS 10%.
- NO MORE THAN 25% OF THE REQUIRED PARKING WILL BE LOCATED IN FRONT OF THE
- ADA-COMPLIANT PARKING WILL BE LOCATED ADJACENT TO THE MAIN BUILDING ENTRY. - ALL SIDEWALKS WILL HAVE A MINIMUM OF 6 FEET CLEAN TRAVEL AREA PROTECTED BY PERMANENT CAR STOPS.
- FRONT ENTRY SIDEWALK AREAS WILL BE COVERED OR SHADED BY TREES.
- ALL STRUCTURES SHALL BE CONNECTED BY PEDESTRIAN PATHWAYS PER CITY OF ALBUQUERQUE (COA) REQUIREMENTS.
- PATIO AREAS FOR EMPLOYEES WILL BE PROVIDED AND SHADED.
- BICYCLE RACKS WILL BE PROVIDED PER COA CODE.
- ALL LANDSCAPING WILL BE PER COA CODE. NO GREATER THAN 20% OF LANDSCAPED AREA WILL BE HIGH WATER USE AND ALL APPLICABLE WATER CONSERVATION MEASURES REQUIRED AT THE TIME OF BUILDING PERMIT APPLICATION WILL BE ADHERED TO.
- PERIMETER WALLS WILL COMPLY WITH PLANNING DEPARTMENT GUIDELINES AT TIME OF BUILDING PERMIT APPLICATION.
- ALL ROOFTOP OR GROUND LEVEL MECHANICAL UNITS WILL BE PHYSICALLY SCREENED FROM VIEW OR PAINTED TO BLEND WITH SURROUNDING STURCTURE'S COLOR. ALL ROOF PENETRATIONS WILL MATCH SRUCTURE OR ROOF COLOR.
- FRONT FACADES WILL BE SHADED BY EITHER THE BUILDING STRUCTURE, CANOPIES, PORTALS, AWNINGS, OR SHADE TREES PLANTED IN A MANNER TO SHADE THE ENTIRE FRONT FACADE OF THE STRUCTURE.
- LOADING DOCKS SHALL BE SCREENED BY WALLS, TREES, AND OR STRUCTURE ELEMENTS THAT ARE ARCHITECTURALLY INTEGRATED INTO THE STRUCTURE.
- ALL REFUSE ENCLOSURES WILL COMPLY WITH COA CODE AND SOLID WASTE REGULATIONS.
- BUILDING FRONTS WILL BE NO CLOSER THAN 12 FEET FROM THE FACE OF CURB TO THE STRUCTURE.
- MONUMENT SIGNS ARCHITECTURALLY INTEGRATED WITH THE STRUCTURE DESIGN WILL NOT EXCEED 10 FEET HIGH OR 75 SQUARE FEET PER SIGN.
- BUILDING SIGNS SHALL NOT EXCEED 6% OF THE FACADE AREA.
- SITE AND BUILDING LIGHTING WILL COMPLY WITH COA CODES AND REGULATIONS. IN NO INSTANCE SHALL LIGHT ESCAPE BEYOND THE PROPERTY LINE.

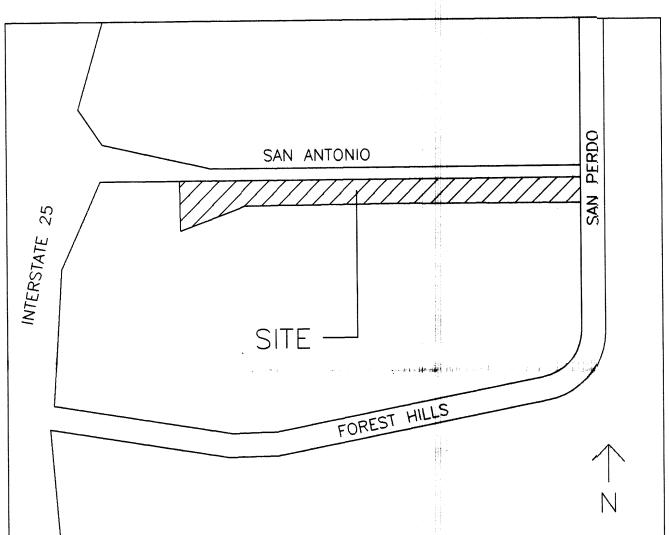

VICINITY MAP

PROJECT NUMBER: 1002455

This plan is consistemt with the specific Site Development Plan approved by the Environmental Planning Commission (EPC). date <u>March 21, 2003</u> and the Findings and Conditions in the Official Notification of Decision are satisfied.

DRB SITE DEVELOPMENT PLAN SIGNOFF APPROVAL:


Traffic Engineering, Transportation Division	Date
Utilities Development	Date
Parks and Recreation Department	Date
City Engineer	Date
Environmental Health Department	Date
Solid Waste Management	Date
DRB Chairperson, Planning Department	Date

SHARRON


SP

SITE PLAN FOR SUBDIVISION

Scale 1"=70'-0"

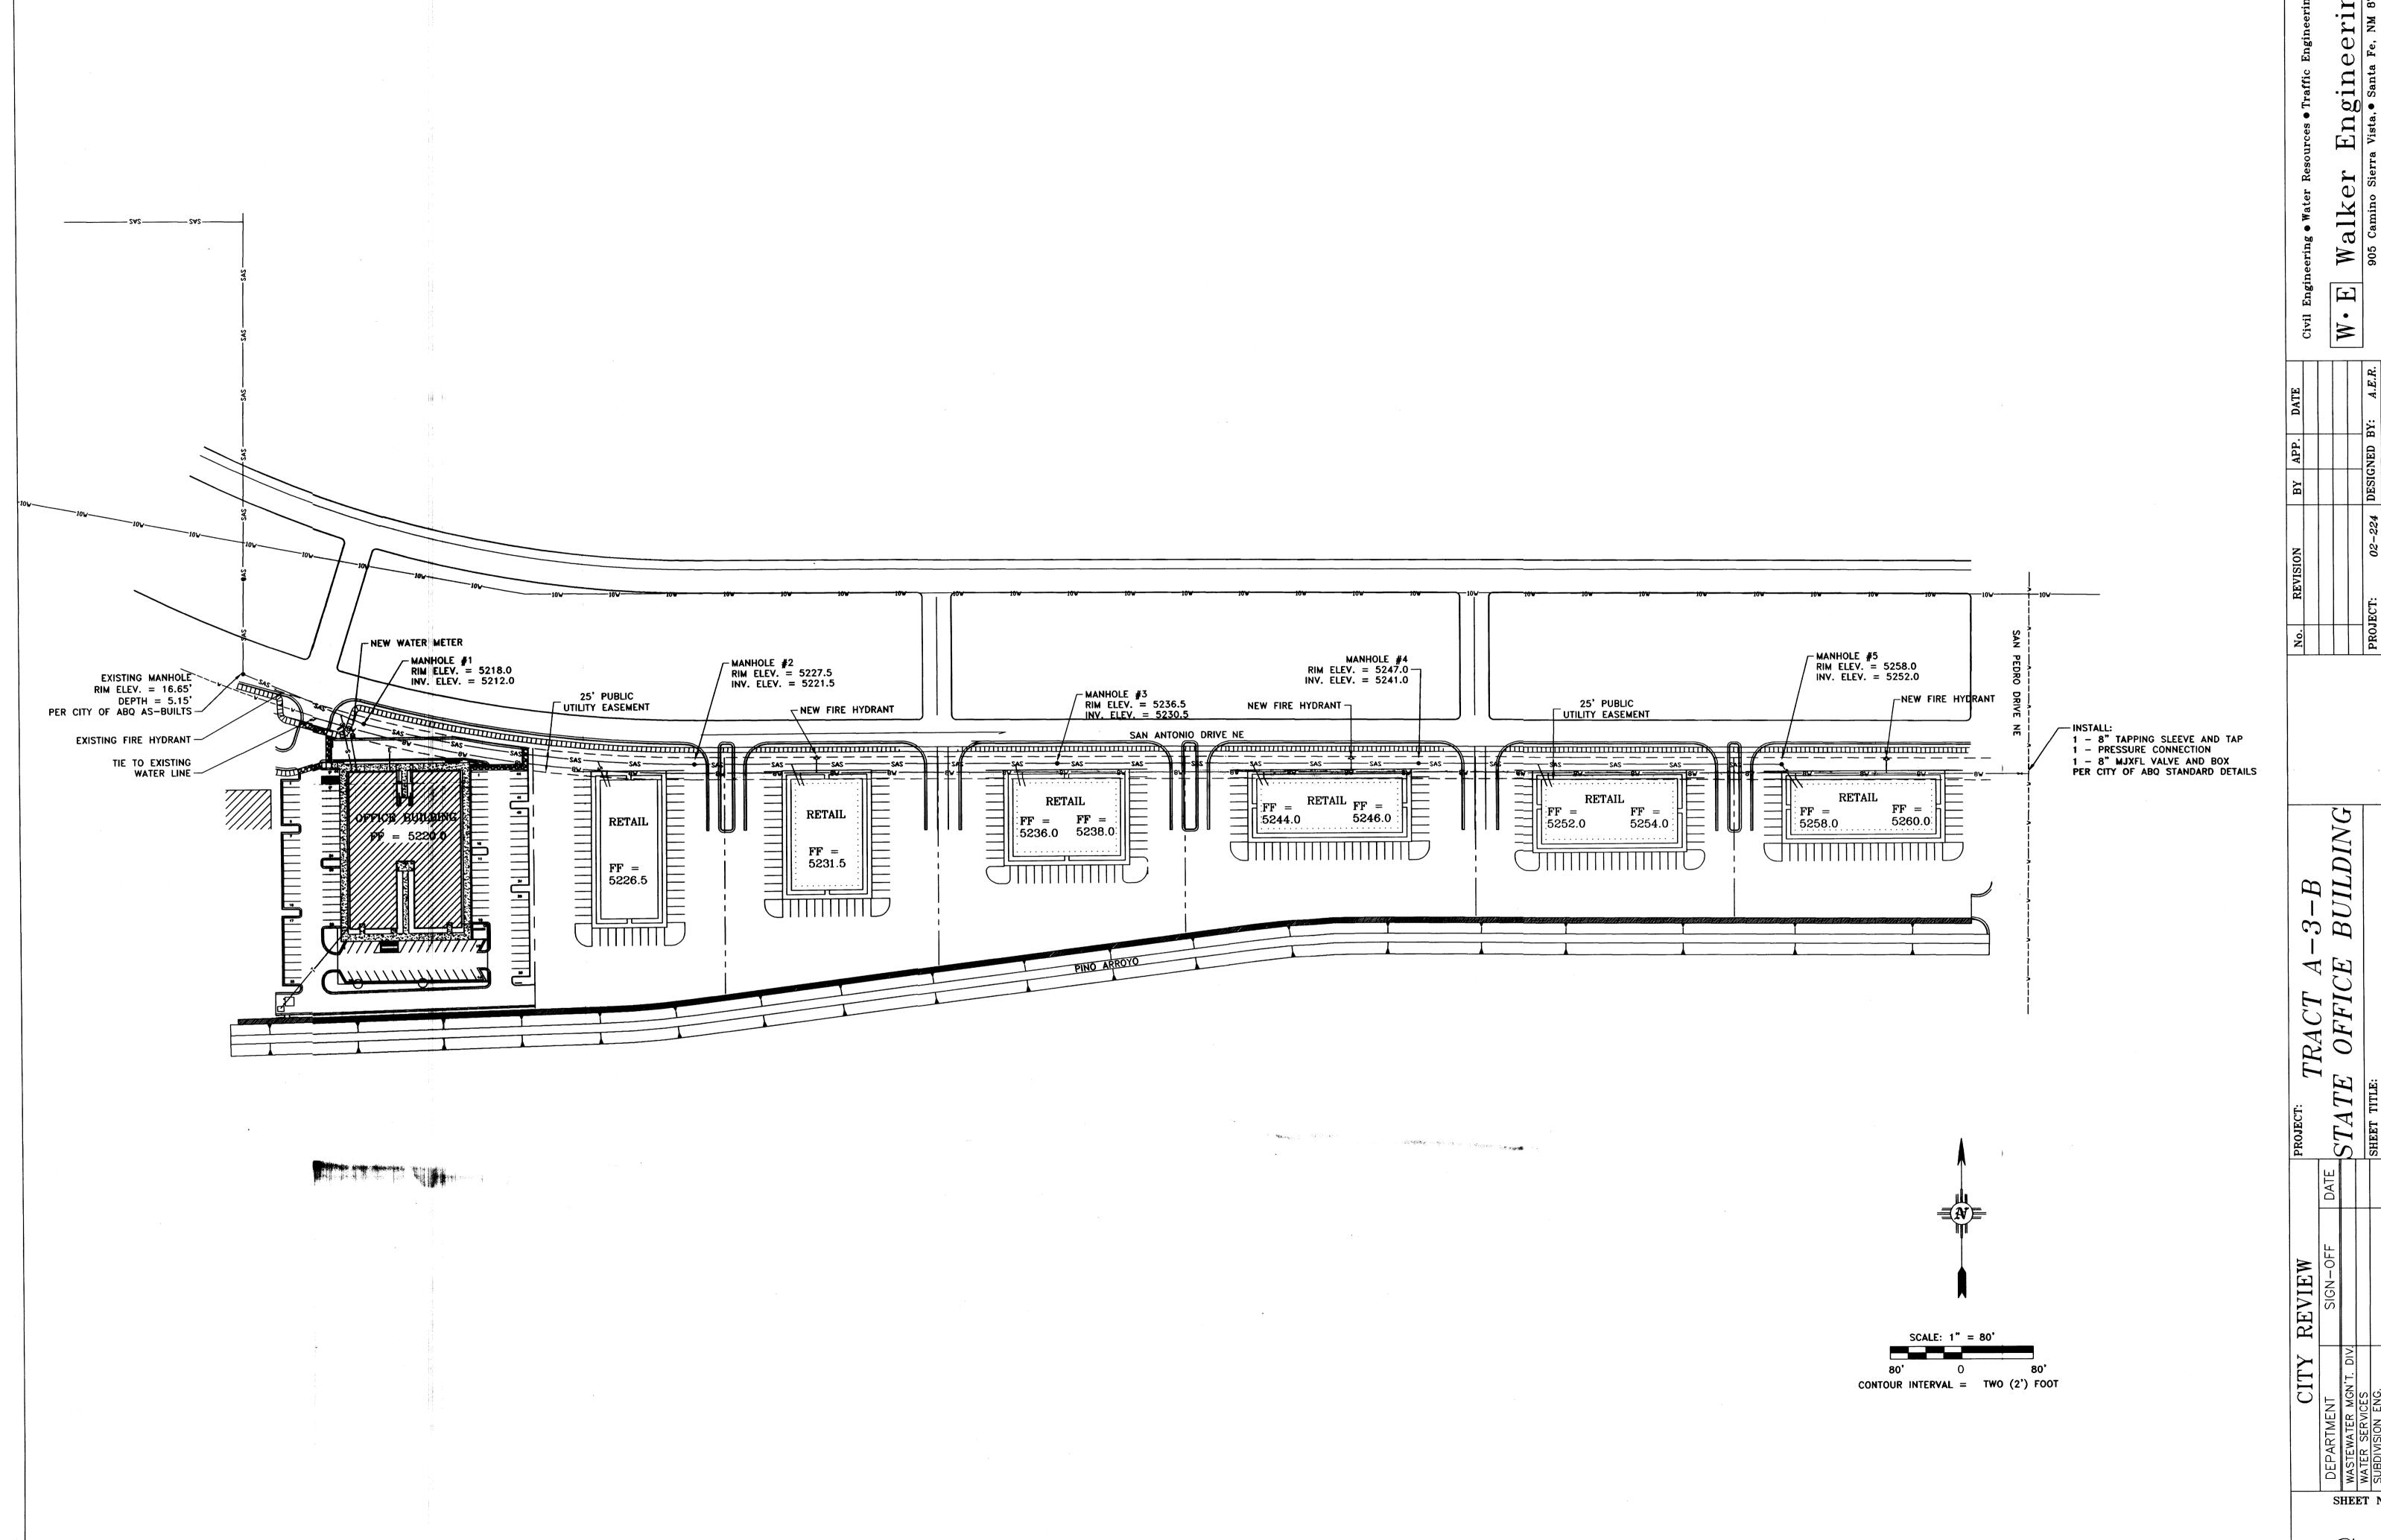

MASTER UTILITY PLAN C-2

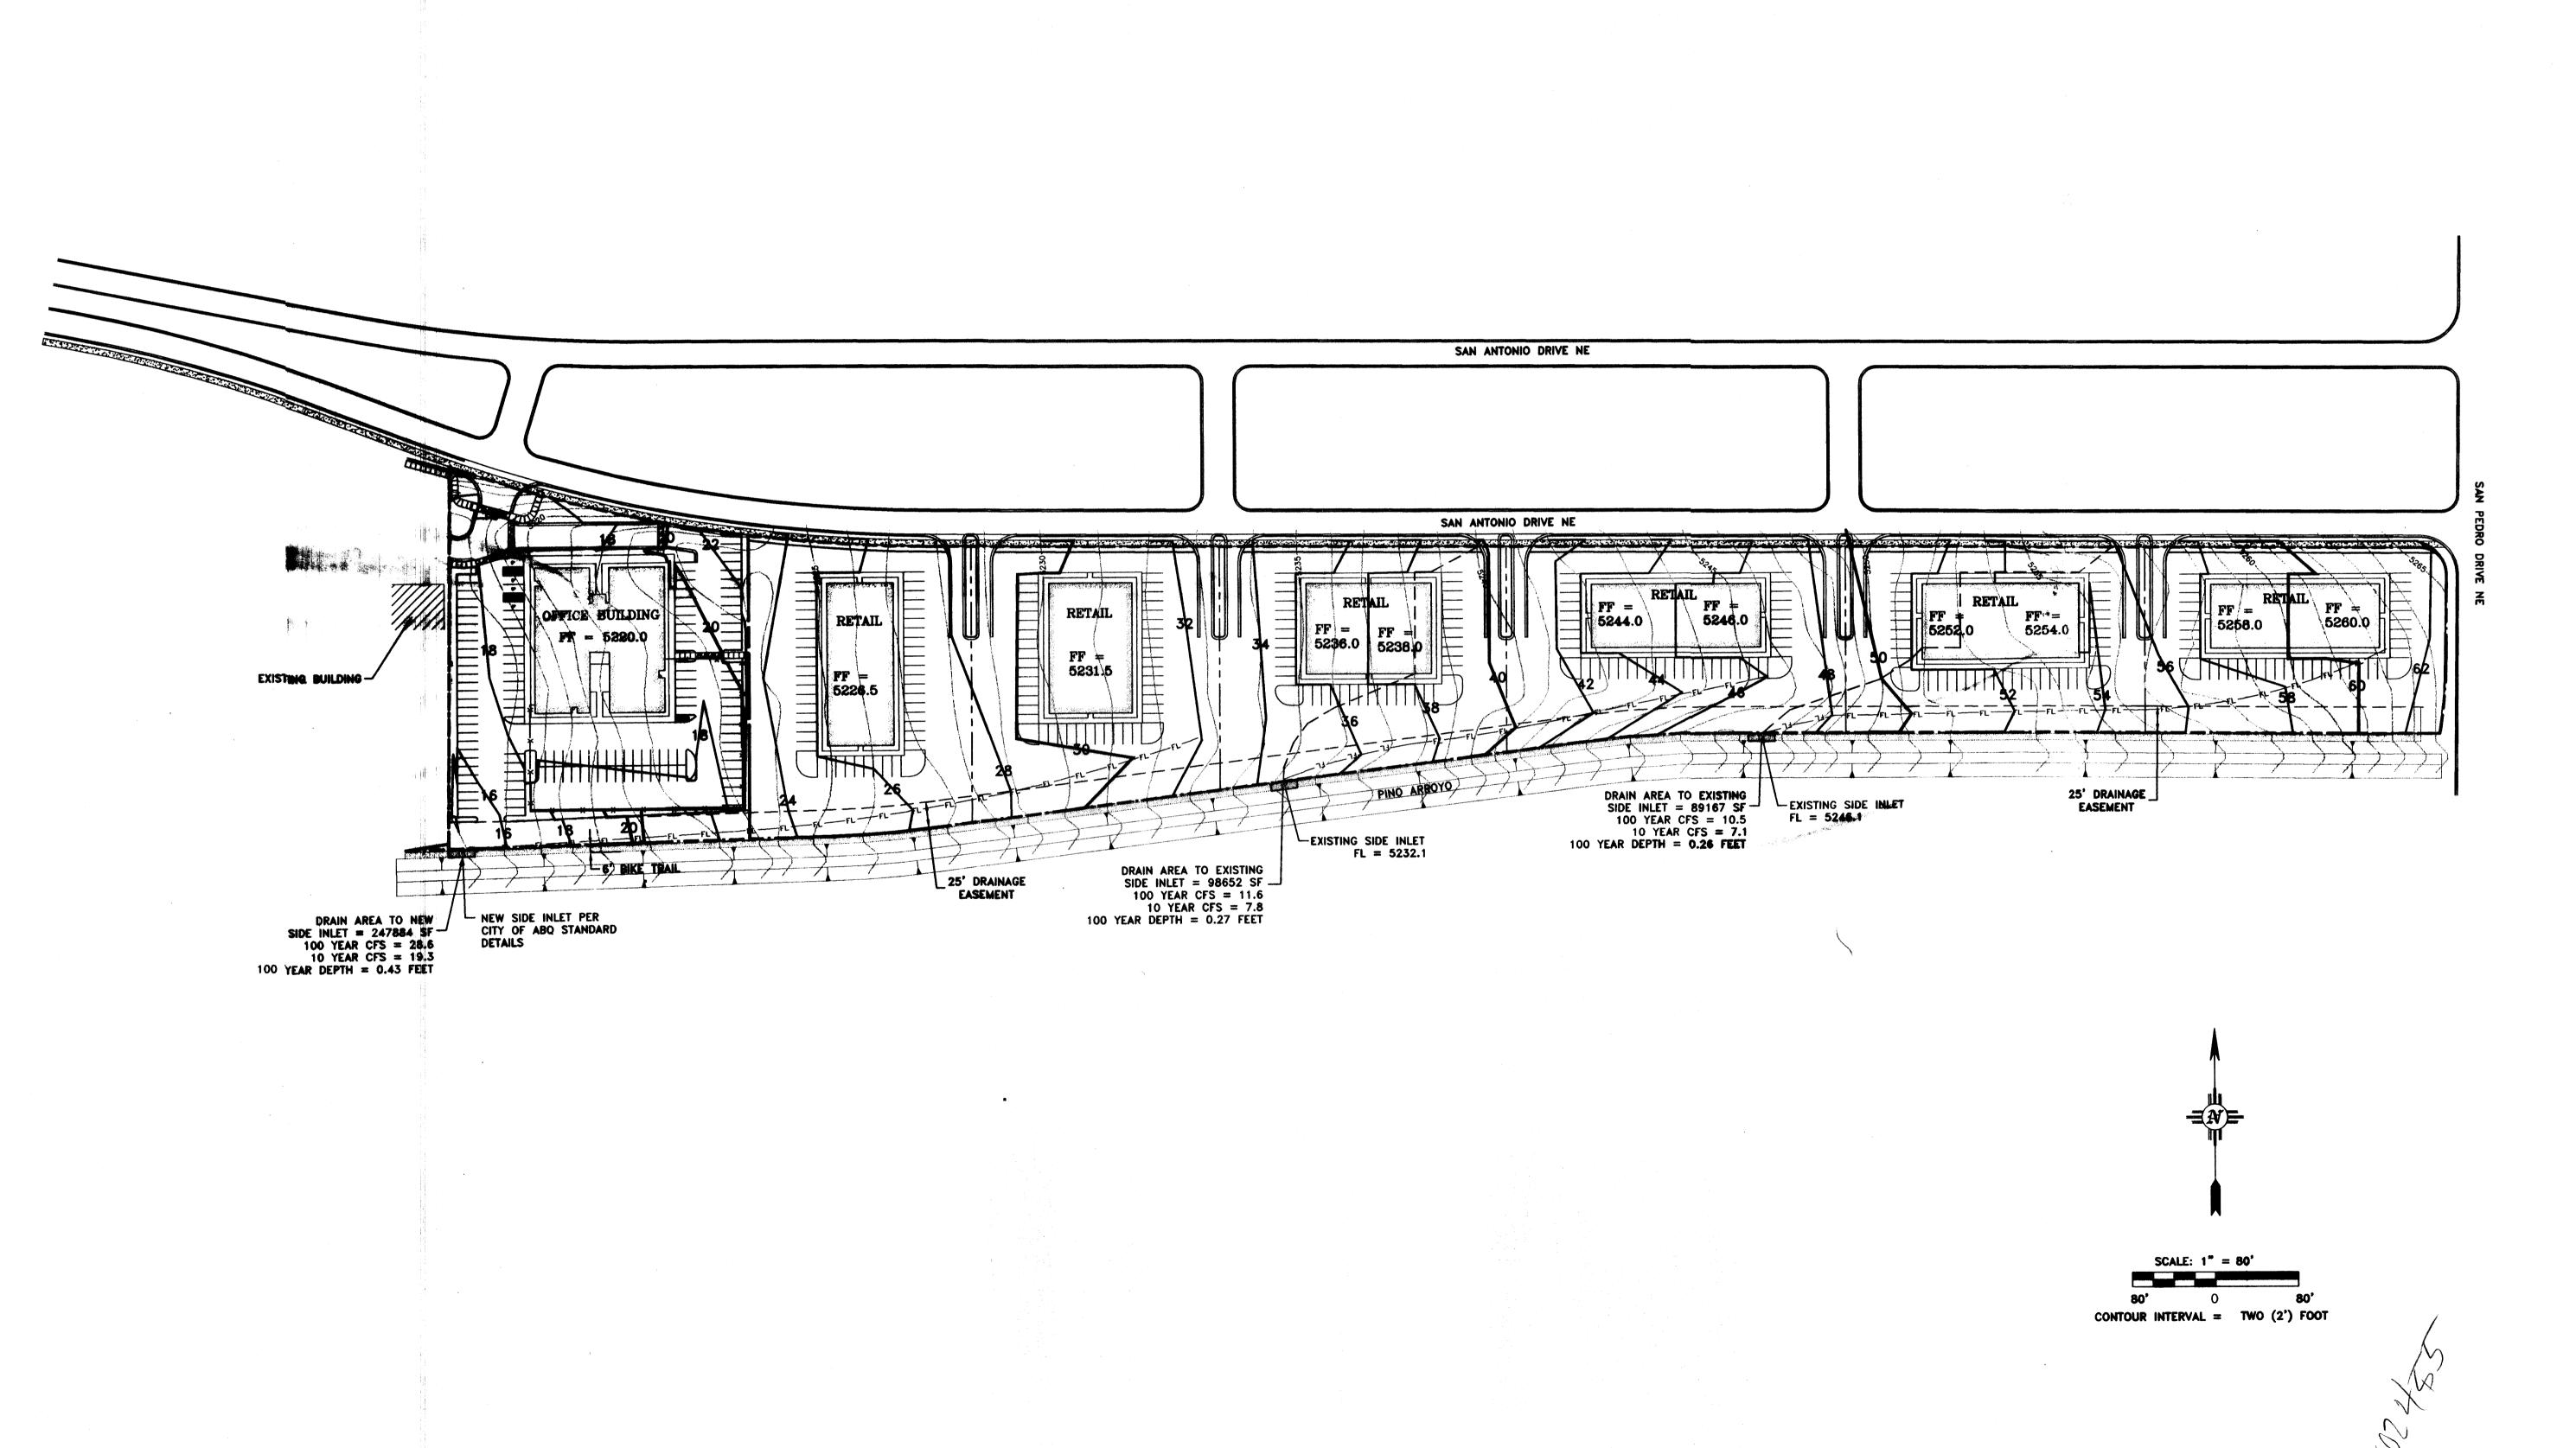

-3-B BUILDING MASTER GRADING PLAN STATE OFFICE REVIEW SHEET NO.

 VISION
 BY
 APP.
 DATE
 Civil Engineering • Water I

 02-224
 DESIGNED BY:
 A.E.R.

 5/6/03
 CHECKED BY:
 M.E.W.


 76/1
 Engineering • Water I

 BS1GNED BY:
 A.E.R.

 BS24 MASTER
 DRAWN BY:
 C.D.A.

 5/6/03
 CHECKED BY:
 M.E.W.

SHEET NO.

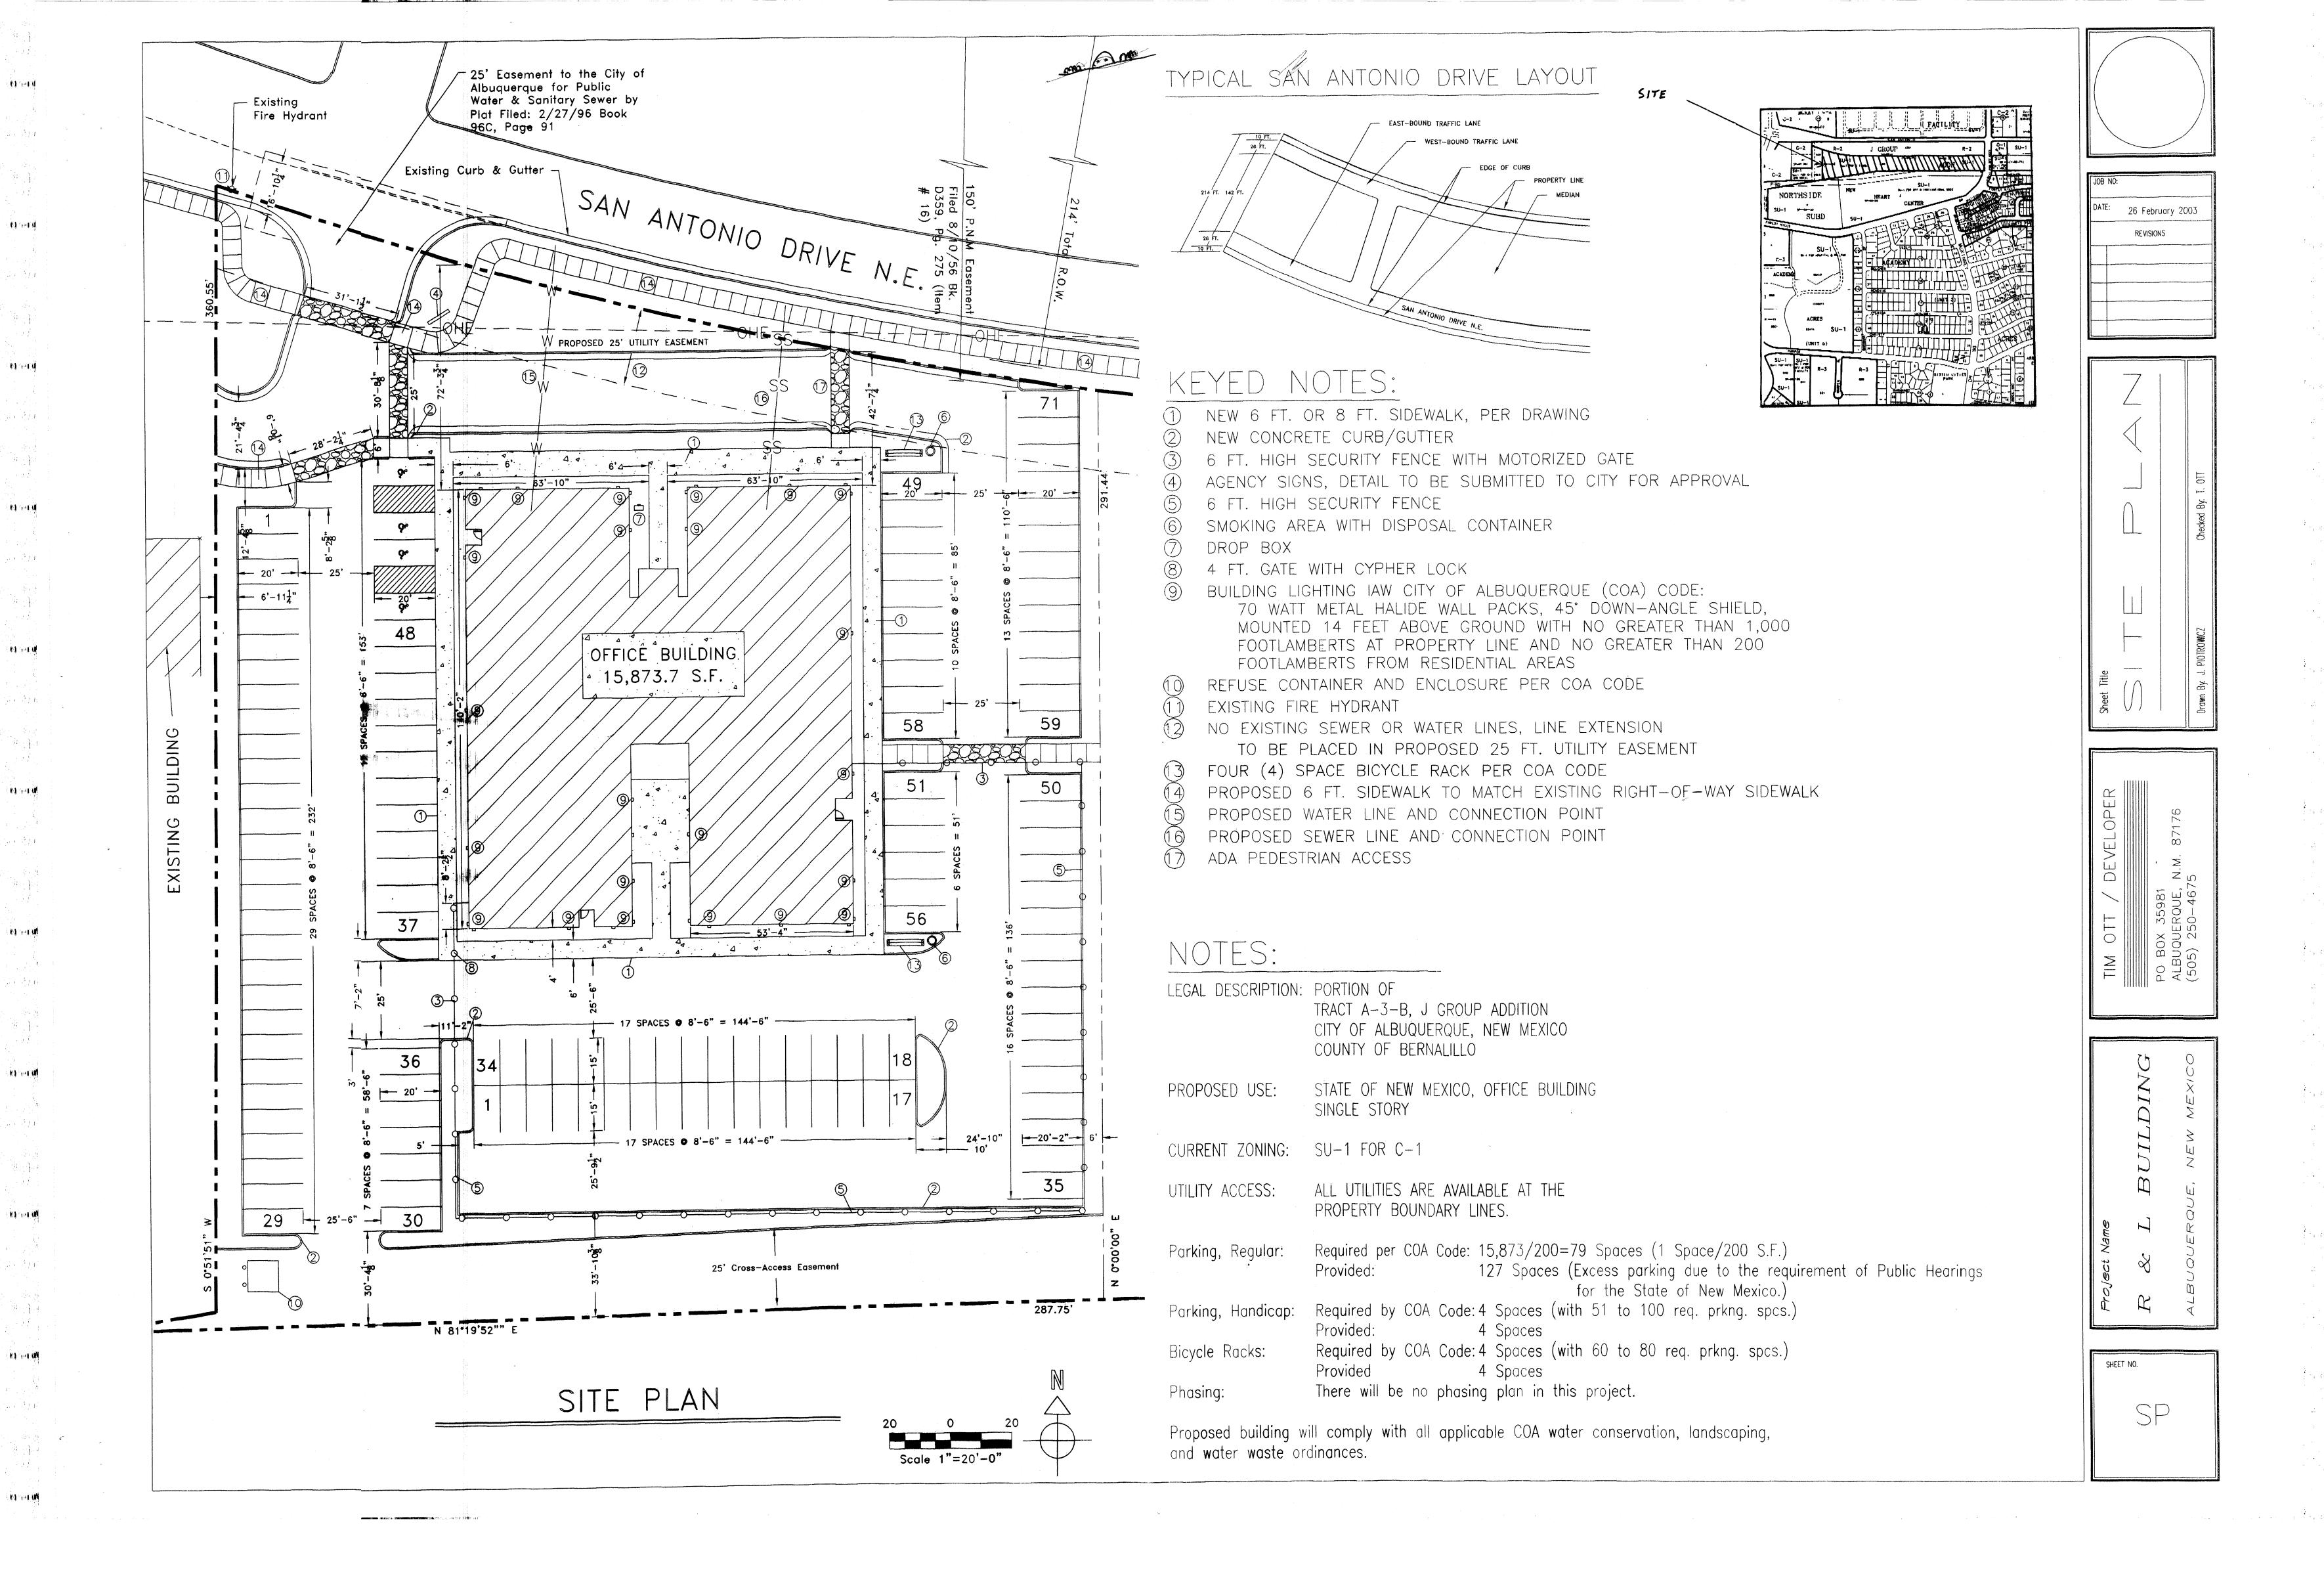

## STAKING NOTE

INFORMATION SHOWN IS FOR GRADING AND DRAINAGE ONLY AND IS NOT TO BE USED FOR STAKING PURPOSES. SEE SITE PLAN FOR ACTUAL LOCATION OF IMPROVEMENTS.

## TOPOGRAPHY NOTE


ALL EXISTING TOPOGRAPHIC SURVEY DATA SHOWN ON THESE PLANS HAS BEEN OBTAINED BY OTHERS. WALKER ENGINEERING HAS UNDERTAKEN NO FIELD VERIFICATION OF THIS INFORMATION, AND MAKES NO REPRESENTATION PERTAINING THERETO, AND ASSUMES NO RESPONSIBILITY OR LIABILITY THEREFOR.


## UTILITY NOTE

IF ANY UTILITY LINES, PIPELINES, OR UNDERGROUND UTILITY LINES ARE SHOWN ON THE DRAWING, THEY ARE SHOWN IN APPROXIMATE MANNER ONLY. UTILITY LINES MAY EXIST WHERE NONE ARE SHOWN. IF ANY SUCH EXISTING LINES ARE SHOWN, THE LOCATION IS BASED UPON INFORMATION PROVIDED BY THE UTILITY OR PIPELINE COMPANY, THE OWNER, OR BY OTHERS. THE INFORMATION MAY BE INCOMPLETE, OR MAY BE OBSOLETE BY THE TIME CONSTRUCTION COMMENCES.

THE ENGINEER HAS UNDERTAKEN NO FIELD VERIFICATION OF THE LOCATION, DEPTH, SIZE OR TYPE OF EXISTING ABOVE AND UNDERGROUND UTILITIES, OR EXISTING PIPELINES. THE ENGINEER MAKES NO REPRESENTATION PERTAINING THERETO, AND ASSUMES NO RESPONSIBILITY OR LIABILITY THEREFOR. THE CONTRACTOR SHALL INFORM HIMSELF OF THE LOCATION OF ANY EXISTING ABOVE AND UNDERGROUND UTILITIES, AND EXISTING PIPELINES, IN AND NEAR THE AREA OF THE WORK, IN ADVANCE OF AND DURING EXCAVATION WORK. THE CONTRACTOR IS FULLY RESPONSIBLE FOR ANY AND ALL DAMAGE CAUSED BY HIS FAILURE TO LOCATE, IDENTIFY AND PRESERVE ANY AND ALL EXISTING ABOVE AND UNDERGROUND UTILITIES, AND EXISTING PIPELINES. THE CONTRACTOR SHALL COMPLY WITH STATE STATUES PERTAINING TO THE LOCATION OF THESE LINES IN PLANNING AND CONDUCTING EXCAVATION WORK.

## **LEGEND**

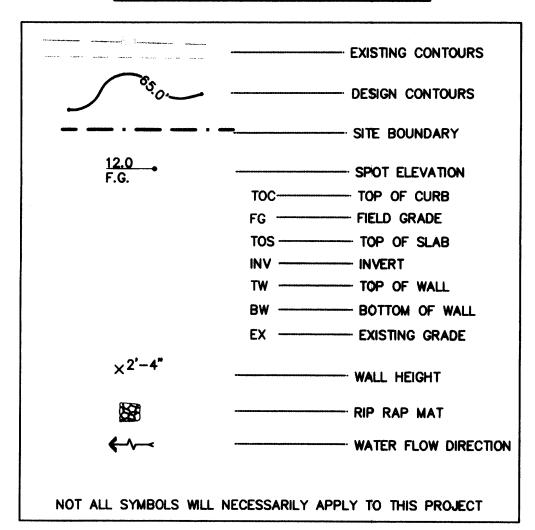

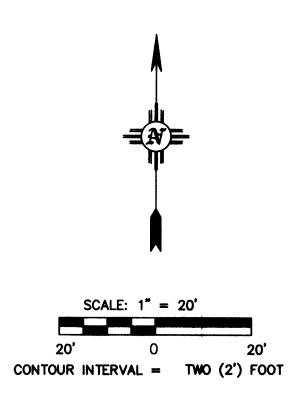

Civil Engineering • Water Resources • Traffic Engineering

W• E Walker Engineering

905 Camino Sierra Vista, • Santa Fe, NM 87501

505-820-7990


FAX 505-820-3539

		A.E.R.	A.E.R.	M.E.W.	
		02-224 DESIGNED BY:	DRAWN BY:	1/30/03 CHECKED BY:	
			02-22		
		PROJECT:	FILE:	DATE:	

			TRACT A-	4-3-R
L	DATE			DATE CAME ATTACK TO THE CAME ATTACK
		SIAIE	OFFICE	BUILDING
		SHEET TITLE:		
			CRADING AND	UNV
		,	חותשוח	AIND
			DEAINACE DIAN	NVID

WATER SUBDIVIS

C-1

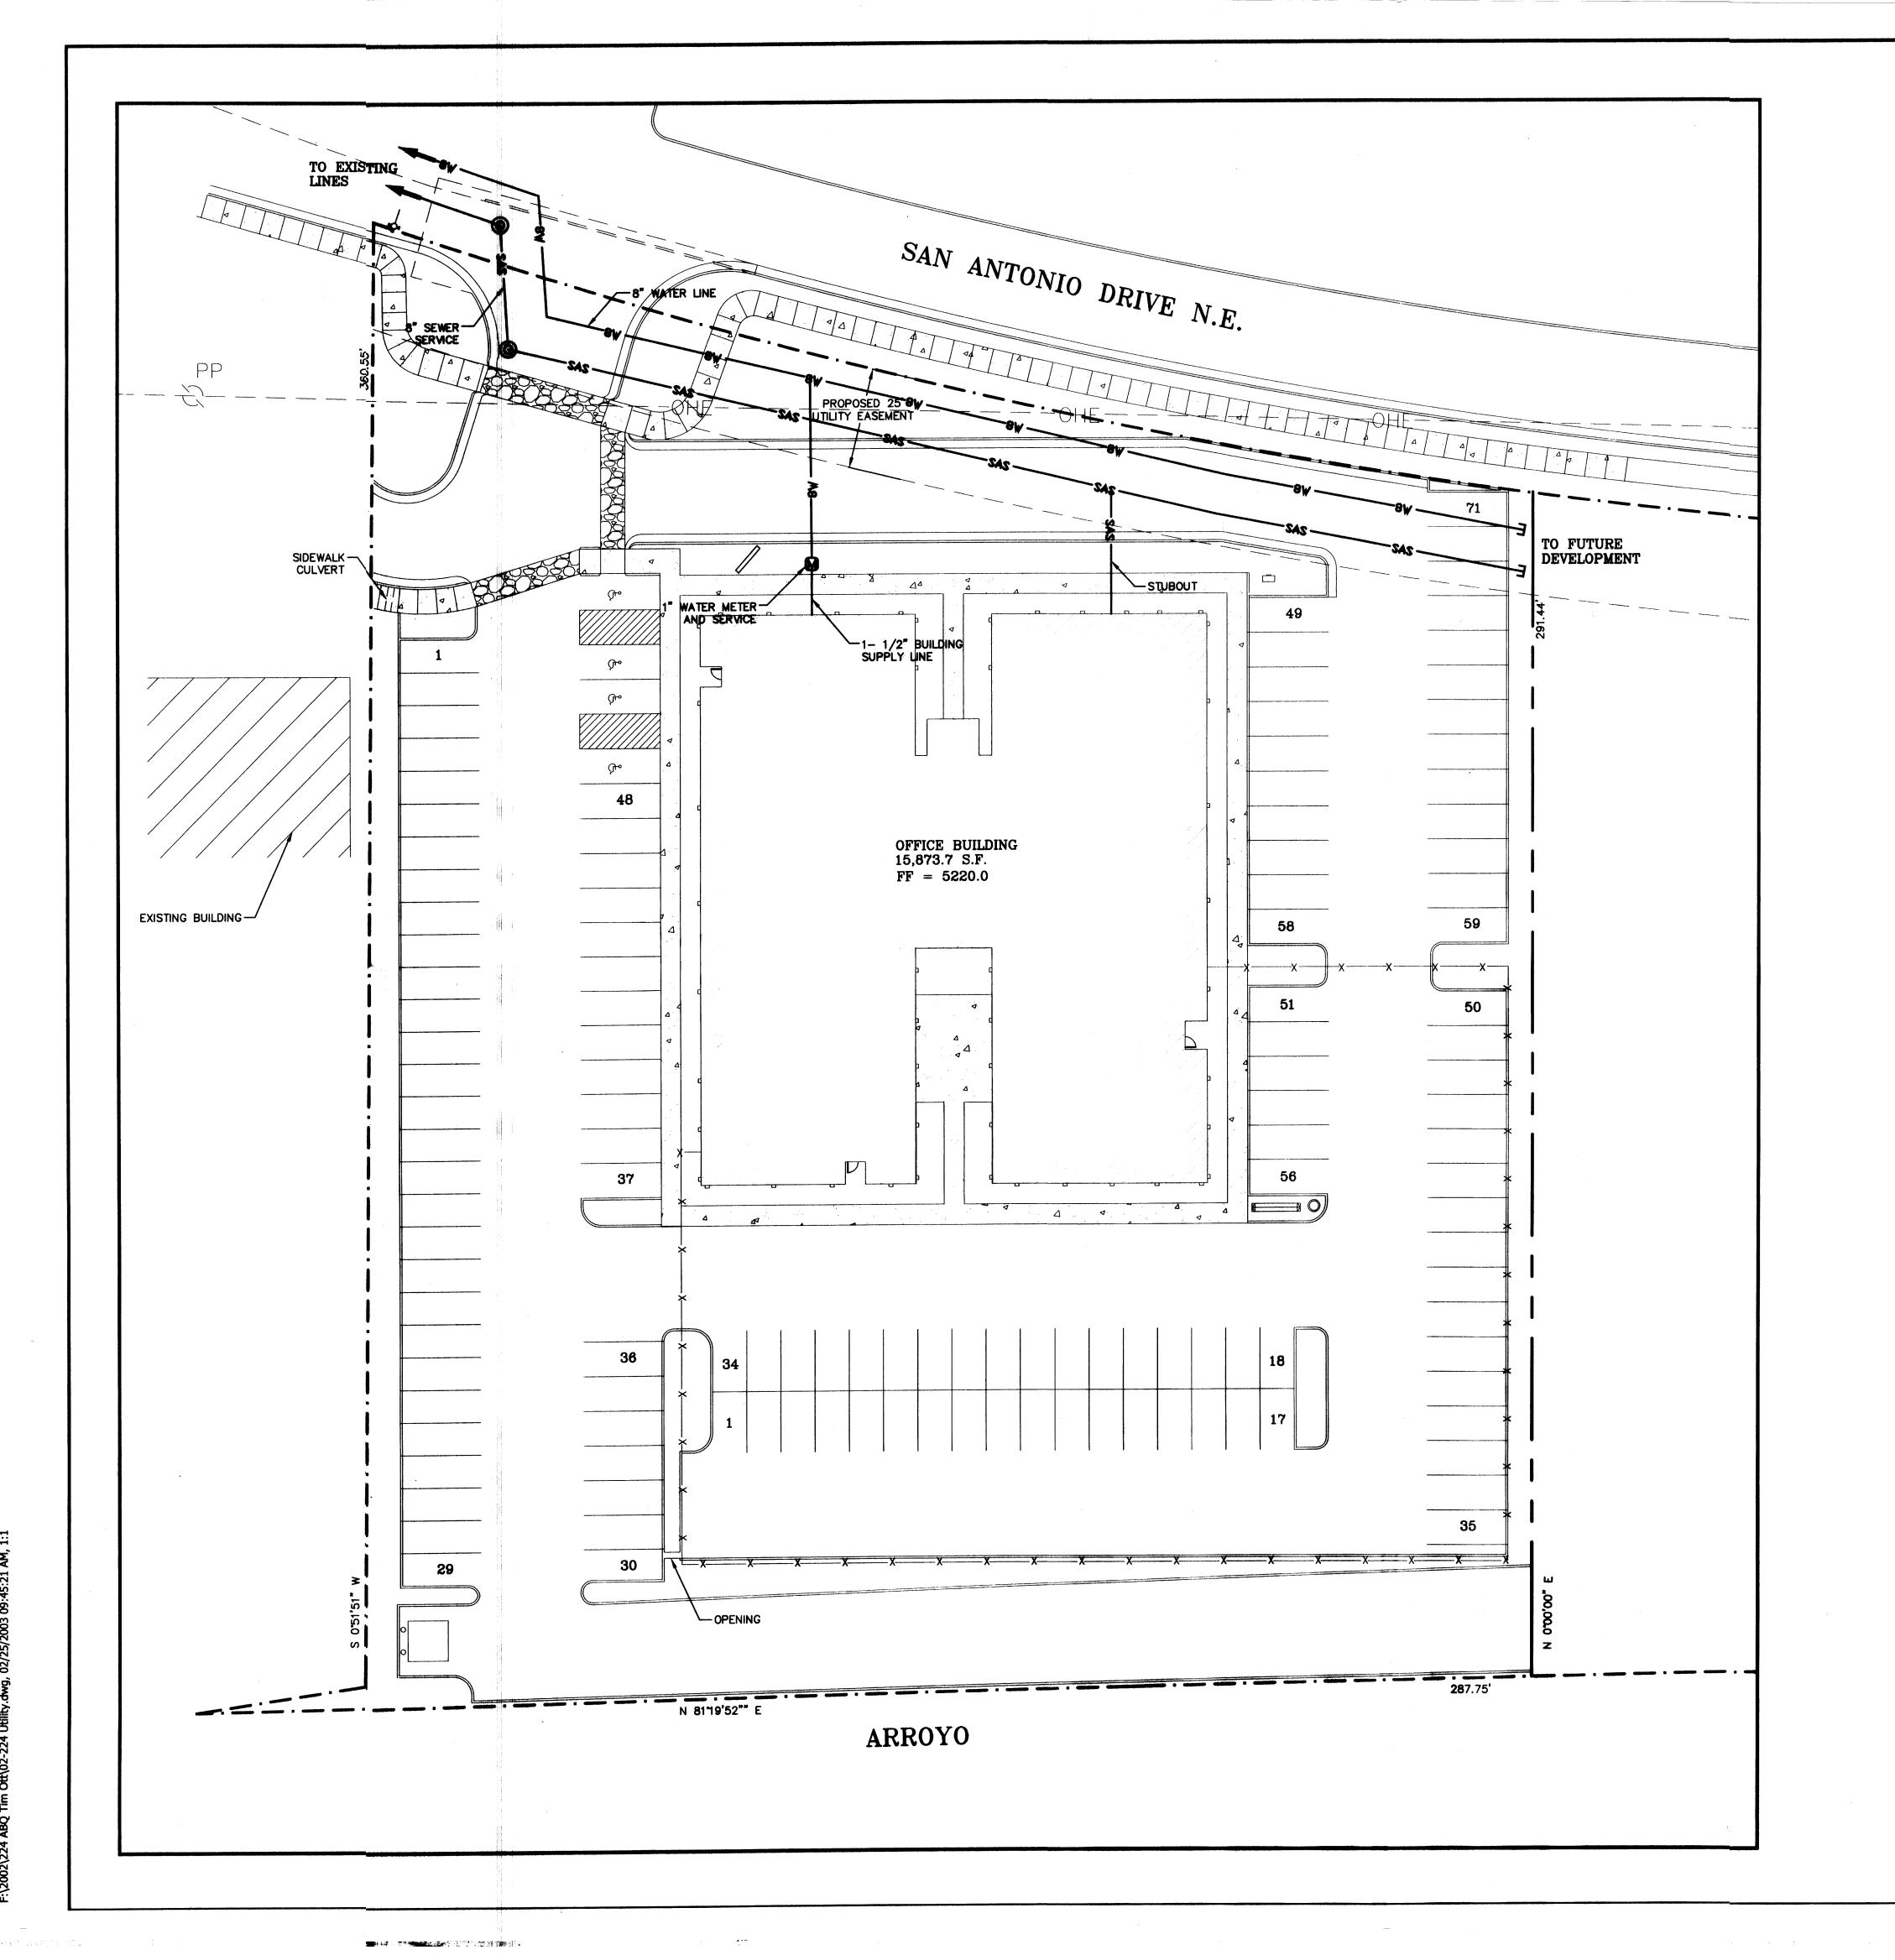


## UTILITY NOTE

IF ANY UTILITY LINES, PIPELINES, OR UNDERGROUND UTILITY LINES ARE SHOWN ON THE DRAWING, THEY ARE SHOWN IN APPROXIMATE MANNER ONLY. UTILITY LINES MAY EXIST WHERE NONE ARE SHOWN. IF ANY SUCH EXISTING LINES ARE SHOWN, THE LOCATION IS BASED UPON INFORMATION PROVIDED BY THE UTILITY OR PIPELINE COMPANY, THE OWNER, OR BY OTHERS. THE INFORMATION MAY BE INCOMPLETE, OR MAY BE OBSOLETE BY THE TIME CONSTRUCTION COMMENCES.

THE ENGINEER HAS UNDERTAKEN NO FIELD VERIFICATION OF THE LOCATION, DEPTH, SIZE OR TYPE OF EXISTING ABOVE AND UNDERGROUND UTILITIES, OR EXISTING PIPELINES. THE ENGINEER MAKES NO REPRESENTATION PERTAINING THERETO, AND ASSUMES NO RESPONSIBILITY OR LIABILITY THEREFOR. THE CONTRACTOR SHALL INFORM HIMSELF OF THE LOCATION OF ANY EXISTING ABOVE AND UNDERGROUND UTILITIES, AND EXISTING PIPELINES, IN AND NEAR THE AREA OF THE WORK, IN ADVANCE OF AND DURING EXCAVATION WORK. THE CONTRACTOR IS FULLY RESPONSIBLE FOR ANY AND ALL DAMAGE CAUSED BY HIS FAILURE TO LOCATE, IDENTIFY AND PRESERVE ANY AND ALL EXISTING ABOVE AND UNDERGROUND UTILITIES, AND EXISTING PIPELINES. THE CONTRACTOR SHALL COMPLY WITH STATE STATUES PERTAINING TO THE LOCATION OF THESE LINES IN PLANNING AND CONDUCTING EXCAVATION WORK.

## LEGEND

4W	4" WATER LINE (SDCW)
8w	8" WATER LINE (SDCW)
EX.W	EXISTING WATER LINE (SDCW)
Ф⊸≎	STREET LIGHT
<b>\$</b> -	FIRE HYDRANTS
0	LOT NUMBERS
<b>H</b>	WATER VALVE & BOX
d	3/4" CU-SERVICE
	3/4" CU-DOUBLE SERVICE
}—	FLUSHING HYDRANT
ALL SYMBO	LS WILL NOT NECESSARILY APPLY TO THIS PROJECT

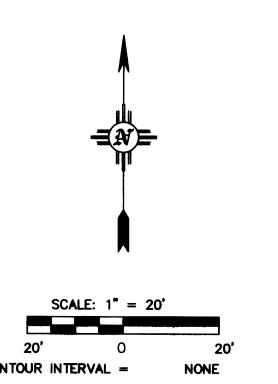

Civil Engineering • Water Resources • Traffic Engineering

W• E Walker Engineering

905 Camino Sierra Vista, • Santa Fe, NM 87501

FAX 505-820-3539

Civi		<b>A</b>	>					
DATE				A.E.R.	A.R.R.	M.E.W.	AS NOTED	
APP. I				DESIGNED BY:	BY:	ED BY:	AS	
BY A					DRAWN	CHECKED BY:		
NC				02-224	FILE: 02-224 UTILITY DRAWN BY:	1/30/03		
REVISION				T:	02-224			
No.				PROJECT:	FILE:	DATE:	SCALE:	
PROJECT: TRACT A-3-R		STATE OFFICE BUILDING		SHEET TITLE:	NAIN PLAN			
	DATE							
REVIEW	SIGN-OFF						CITY USE ONLY	
ITY		N'T. DIV.	·-				CITY	

(1) to 1 (1)

(A) and (A)

11 111

(1) 101 (II)


th will


the contract

61 mil

(1) jul (#

C-2

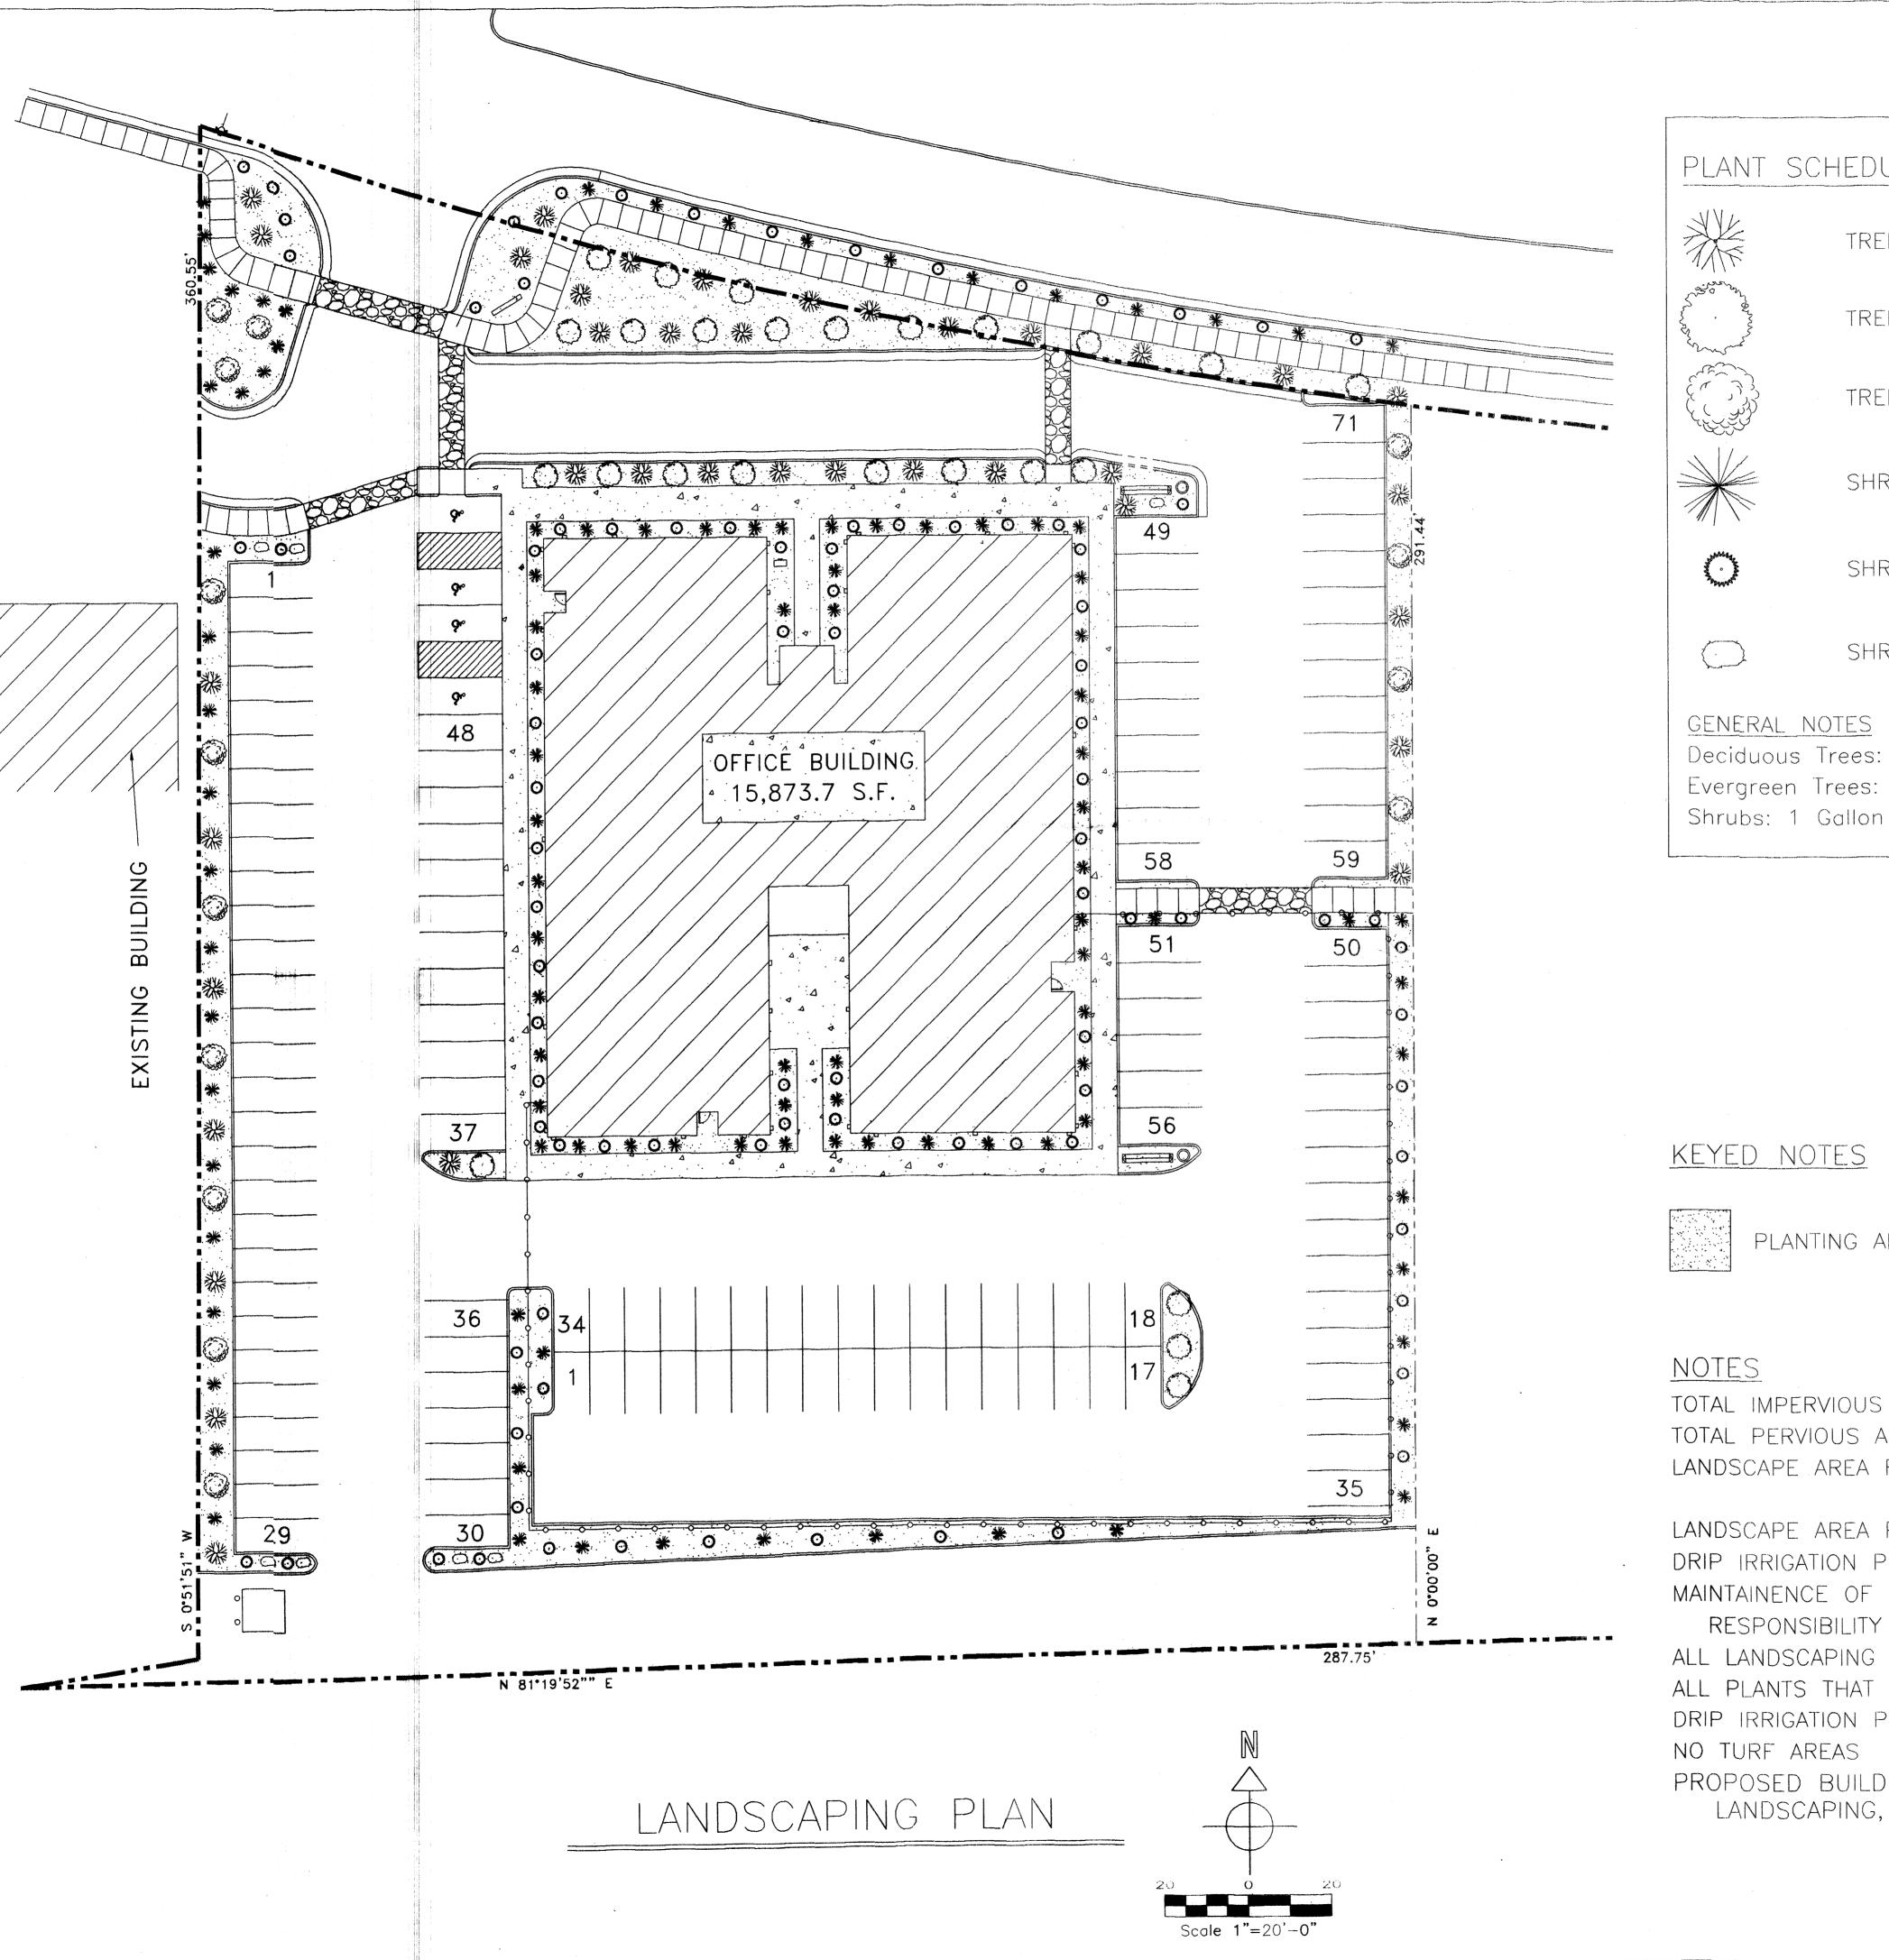

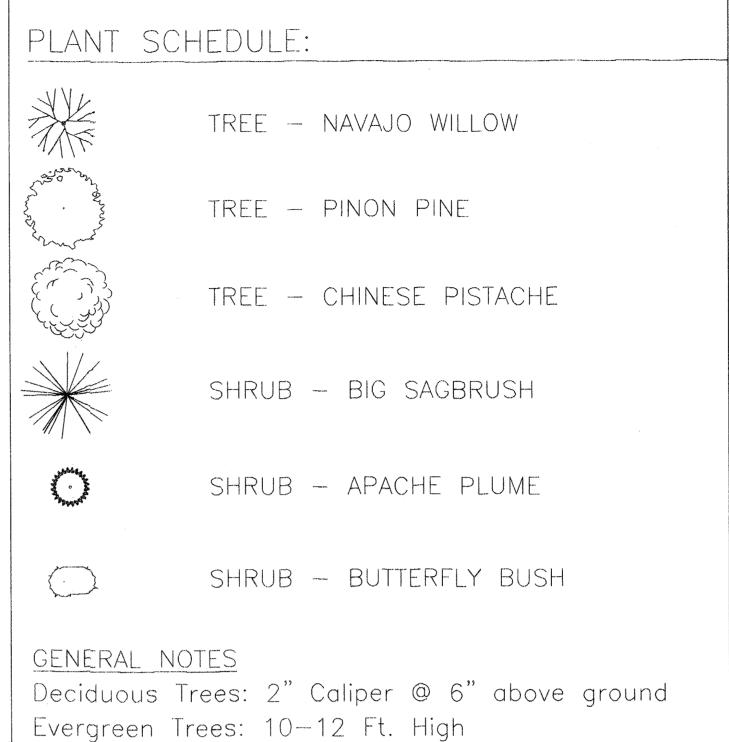

## KEYED NOTES

PLANTING AREAS, GRAVEL COVERED

TOTAL IMPERVIOUS AREA: 75,975.5 S.F.

TOTAL PERVIOUS AREA: 12,875.5 S.F.

LANDSCAPE AREA REQUIRED: [(LOT AREA - BUILDING AREA) X (15%)] =

 $[(88,851.0. - 15,873.7) \times (15\%)] = 10,946.6 \text{ S.F.}$ 

LANDSCAPE AREA PROVIDED: 12,875.5 S.F.

DRIP IRRIGATION PER CITY OF ALBUQUERQUE (COA) CODE

MAINTAINENCE OF LANDSCAPING AND IRRIGATION SYSTEM TO BE THE

RESPONSIBILITY OF THE PROPERTY OWNER

ALL LANDSCAPING WILL BE COMPLETE WITHIN 60 DAYS OF BUILDING OCCUPANCY

ALL PLANTS THAT DIE WILL BE REPLACED WITHIN 60 DAYS

DRIP IRRIGATION PER (COA) CODE


NO TURF AREAS

PROPOSED BUILDING WILL COMPLY WITH ALL COA WATER CONSERVATION,


LANDSCAPING, AND WATER WASTE ORDINANCES


DATE: 26 February 2003

SHEET NO.

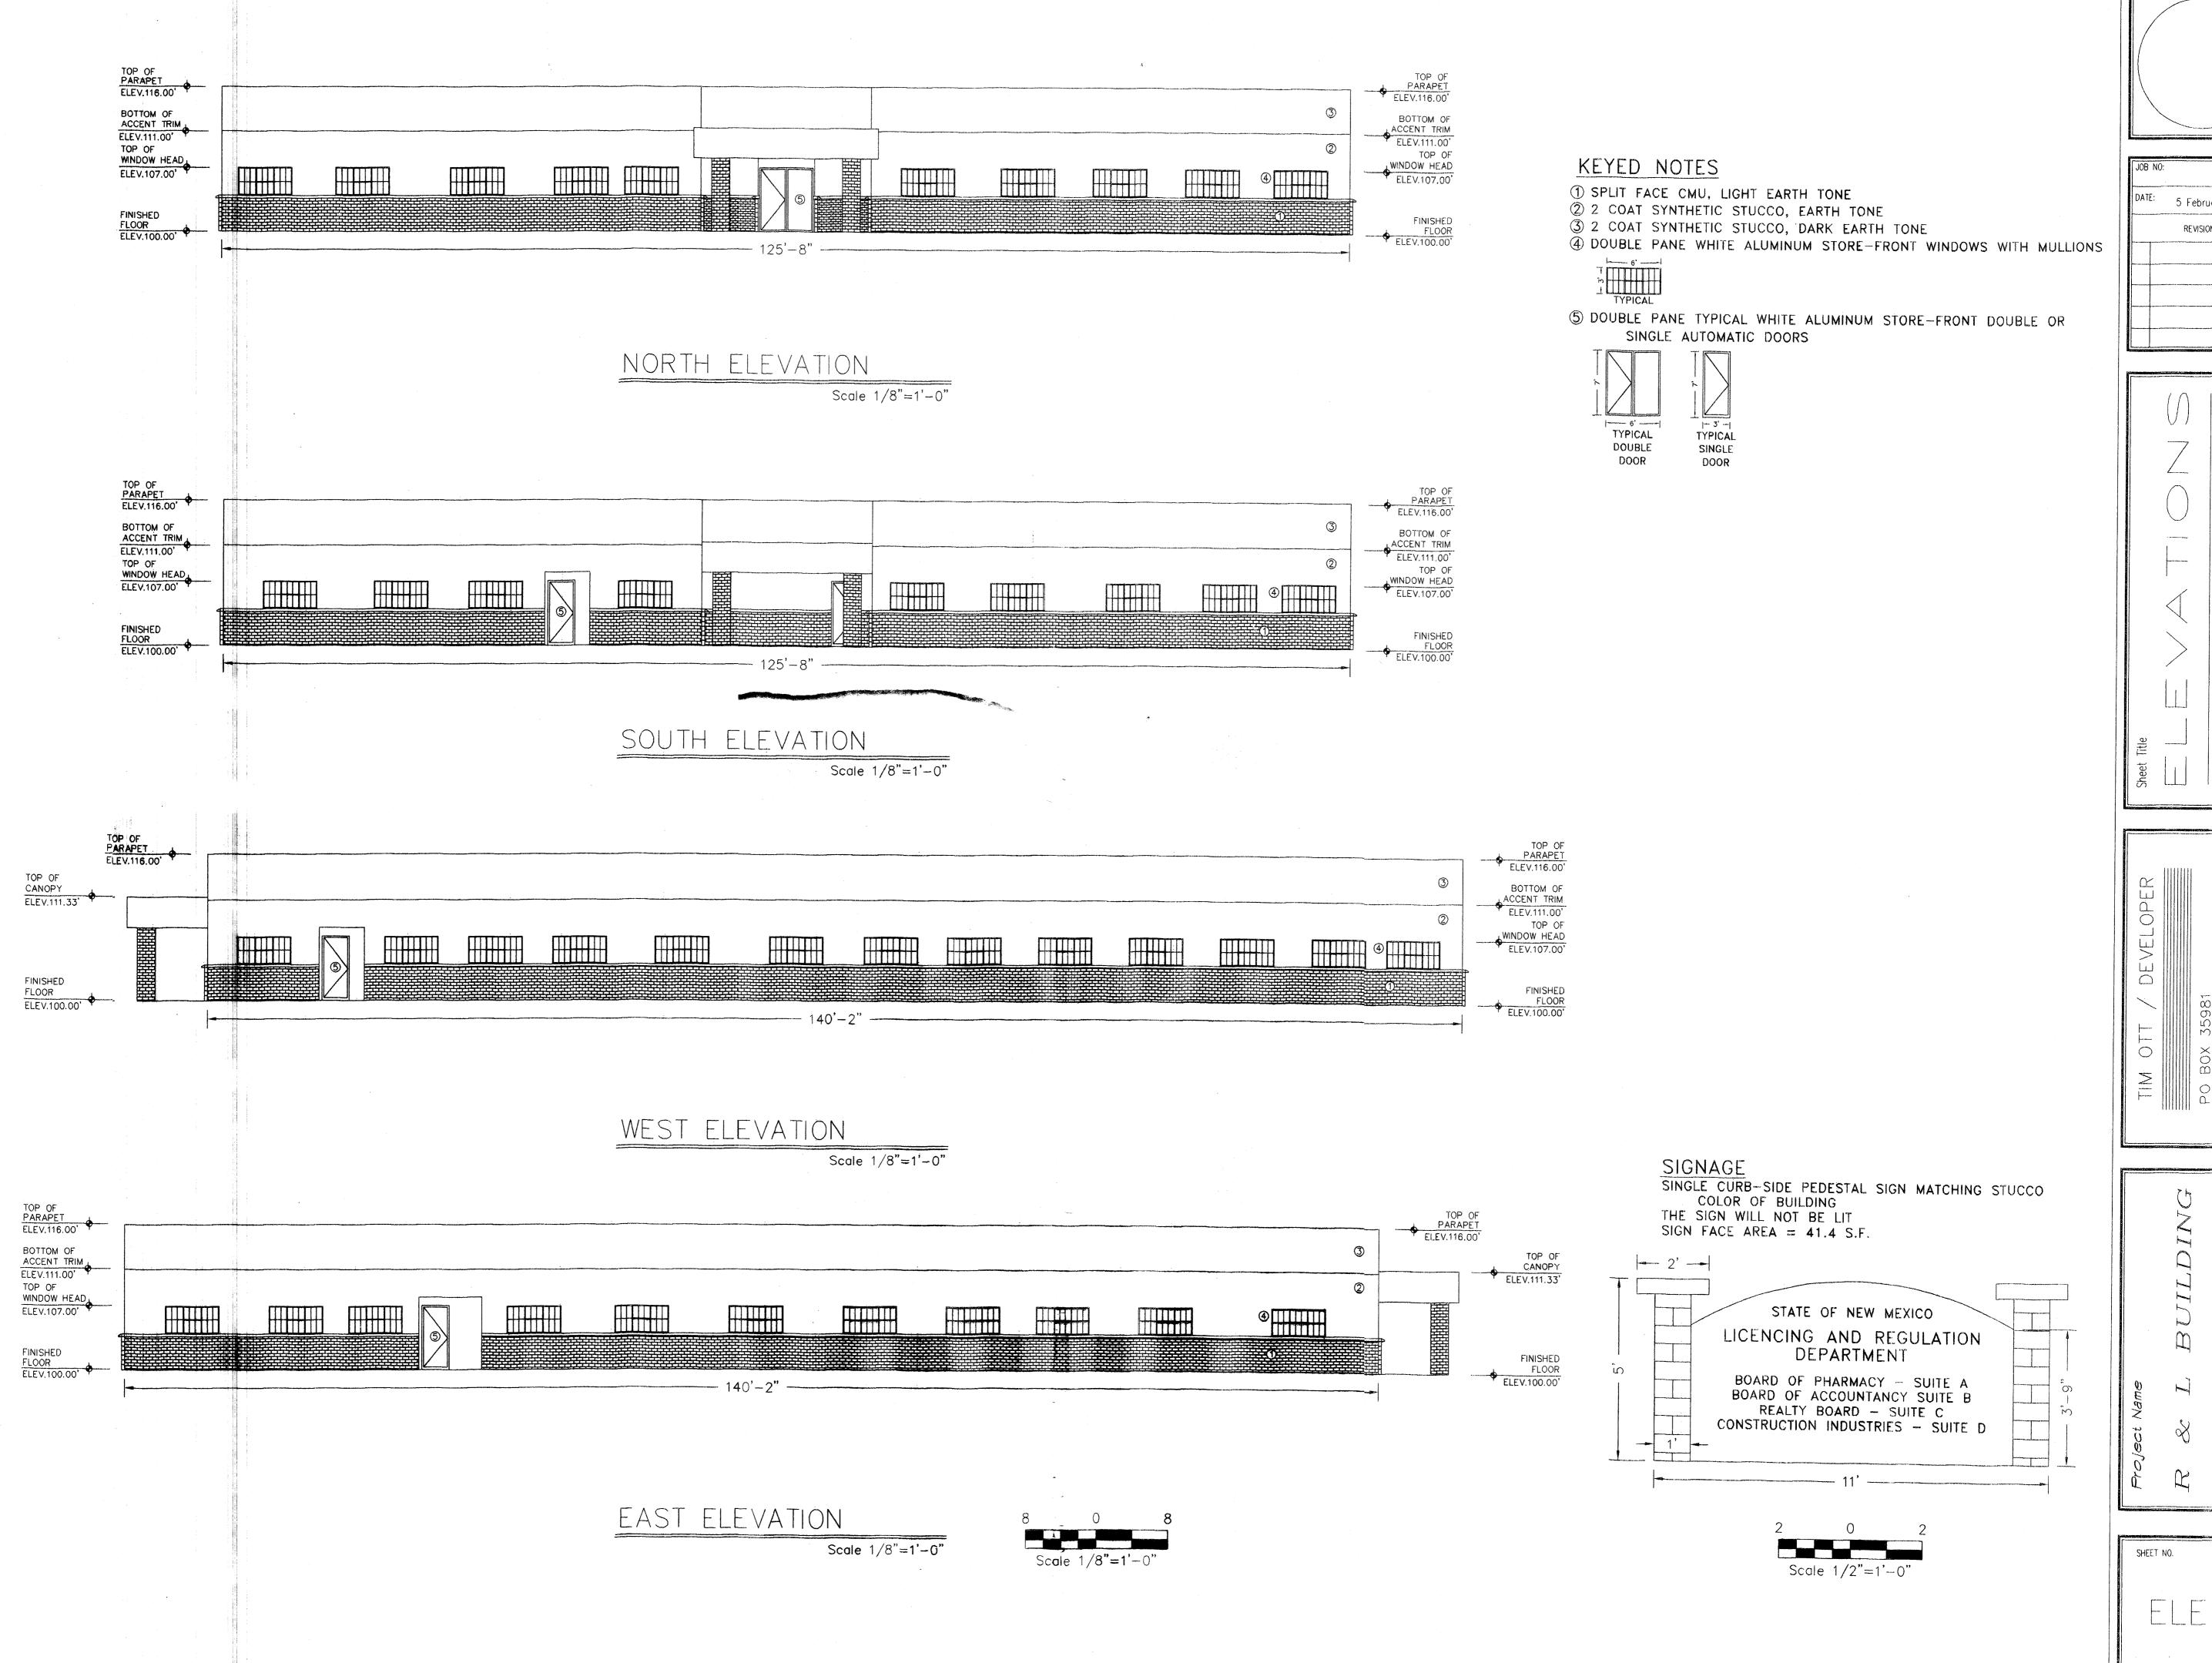

5 February 2003 REVISIONS

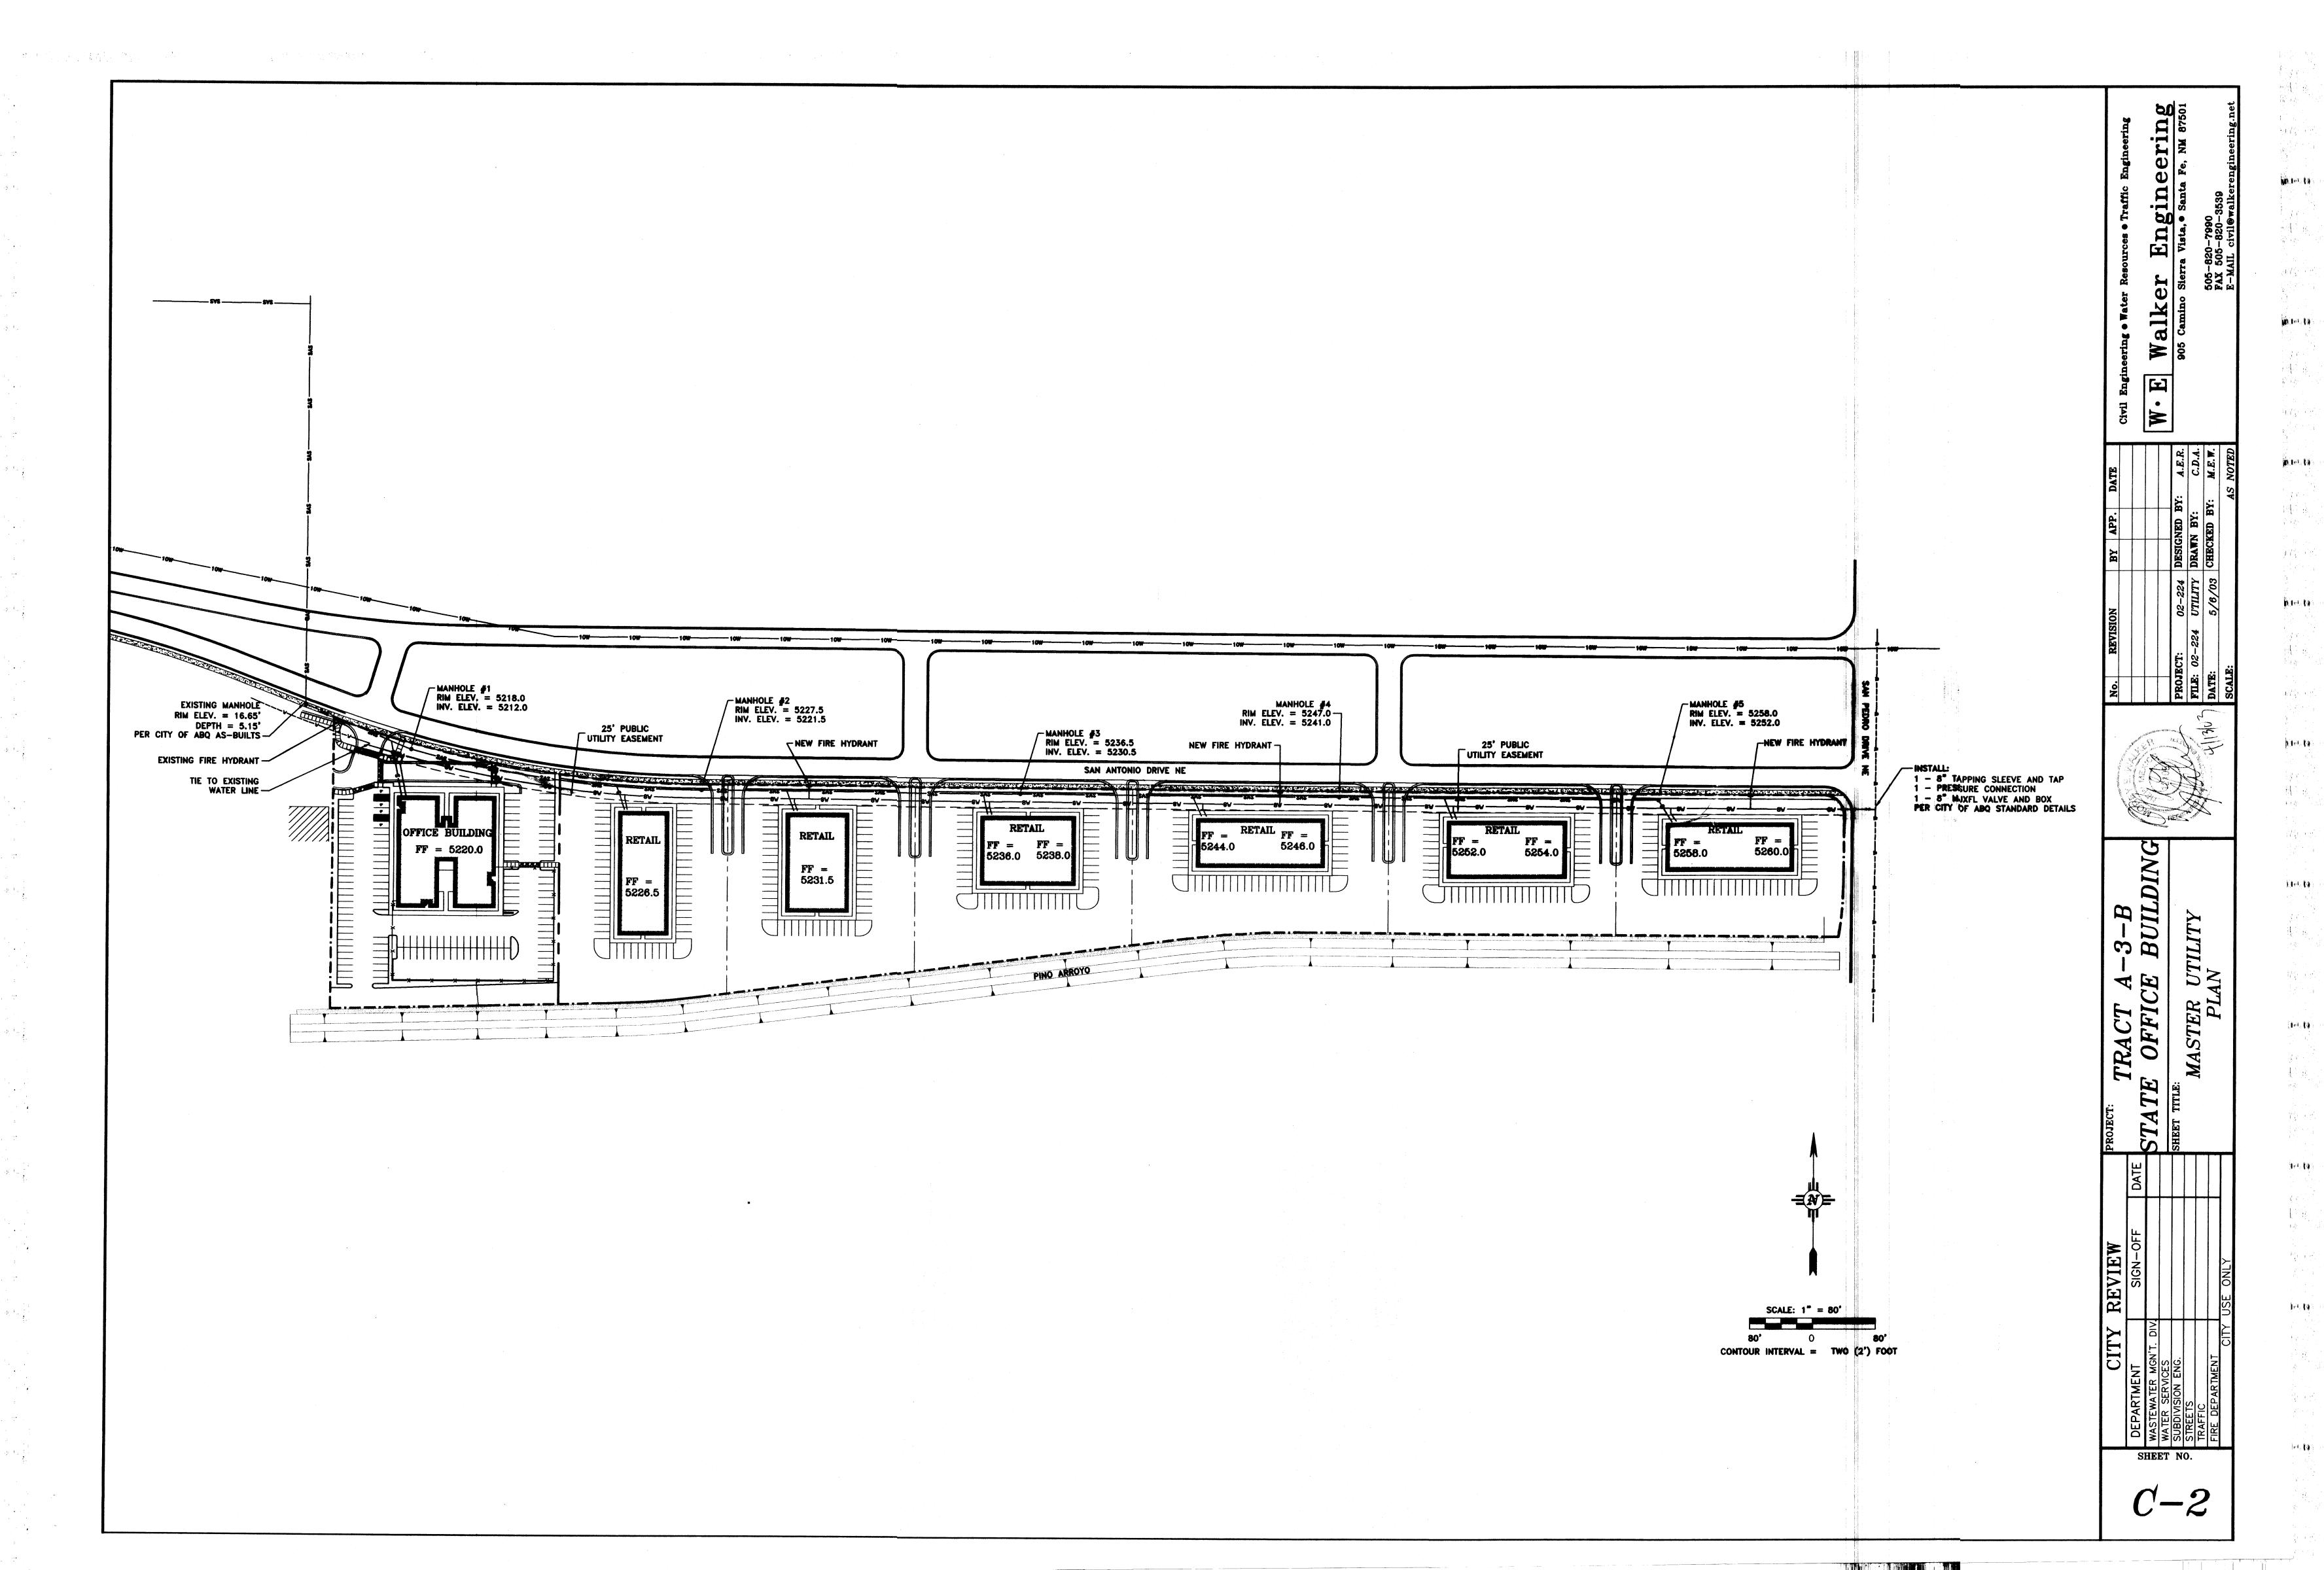

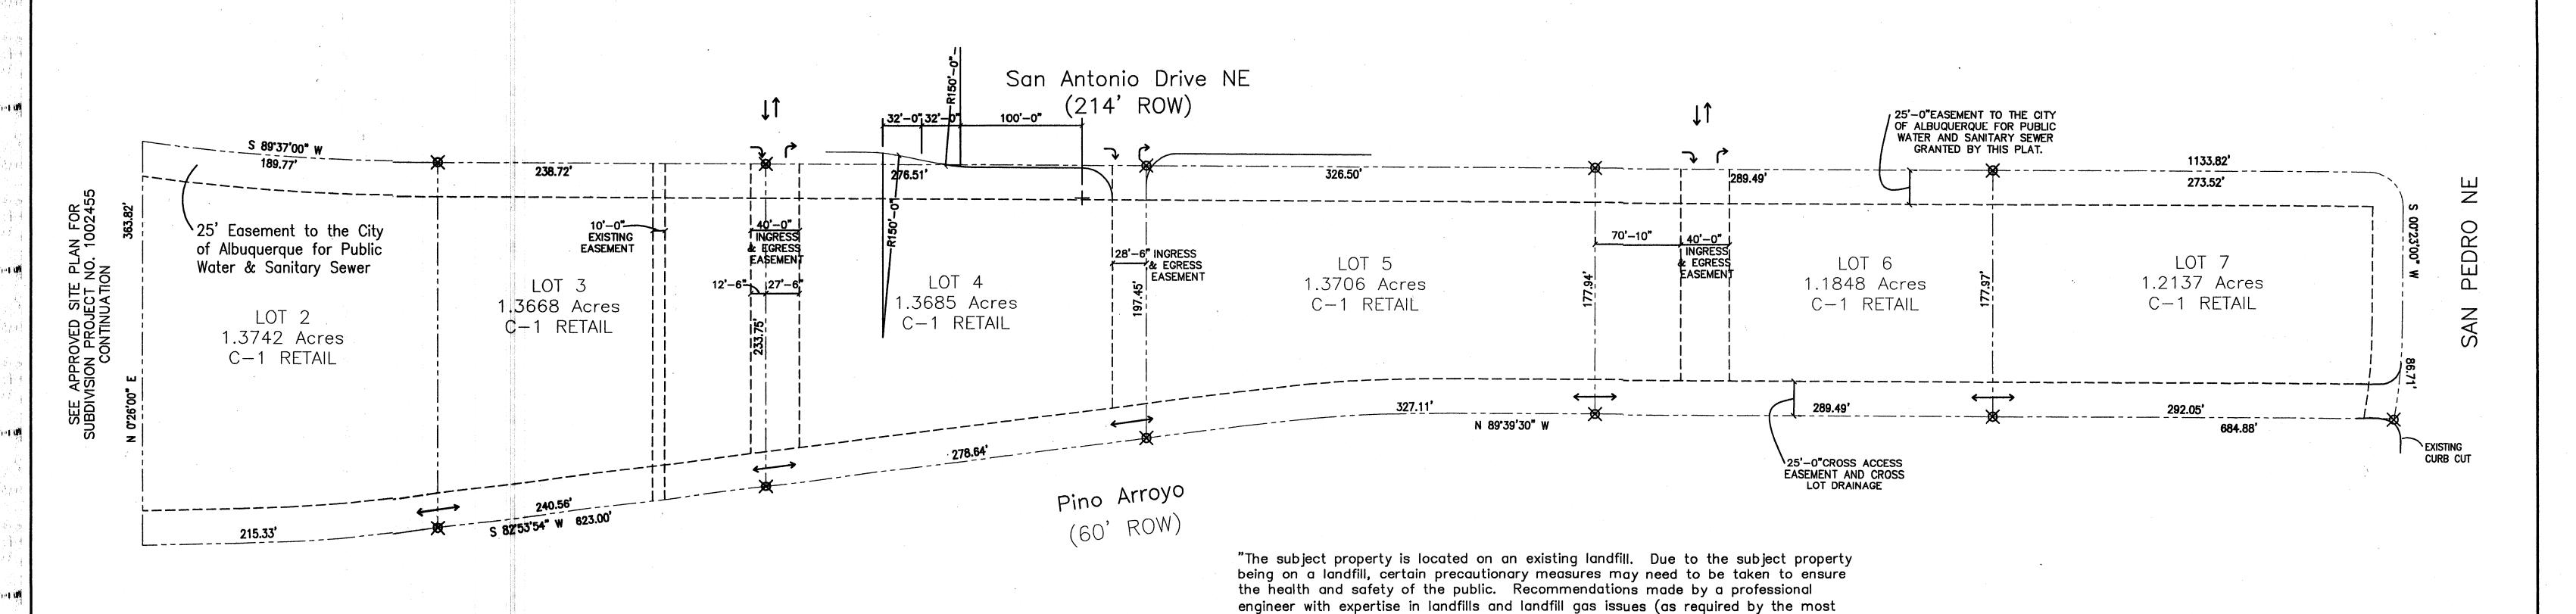

## LEGAL DESCRIPTION

LOTS 2 THRU 7

JJ SUBDIVISION

BEING A REPLAT OF TRACT A-3-B,

J GROUP ADDTION, TRACT 1,

NEW HEART CENTER & TRACT 1,

NORTHSIDE SUBDIVISION

WITHIN PROJECTED SECTION 25
TOWNSHIP 11 NORTH, RANGE 3 EAST
NEW MEXICO PRINCIPAL MERIDIAN

CITY OF ALBUQUERQUE BERNALILLO COUNTY NEW MEXICO

## NOTES: LOTS 2 THRU 7

BUILDING HEIGHT NOT TO EXCEED 34 FT.

MAXIMUM FLOOR-AREA RATION: 20.0%

BUILDING MINIMUM SETBACKS:

FRONT: 25.0 FT

SIDE: 5.0 FT

REAR: 5.0 FT

## TRAFFIC FLOW NOTES

-TWO WAY INGRESS

-TWO WAY INGRESS AND EGRESS
TRAFFIC FLOW

-RIGHT TURN ONLY INTO LOT

-RIGHT TURN ONLY OUT OF LOT

-TWO WAY INTERIOR AND CROSS-LOT TRAFFIC FLOW

GENERAL DESIGN CRITERIA

AMENDMENT TO SITE DEVELOPMENT

PLAN FOR SUBDIVISION

SCALE: 1"=60'-0"

- ALL STRUCTURES ON LOTS WILL BE LIMITED TO THE GENERAL CRITERIA DESCRIBED HEREIN.
   DESIGN OF BUILDING SHALL BE A COMPATIBLE STYLE, MATERIALS AND COLORS THROUGHOUT LOTS 2-7.
- 3. PARKING WILL NOT EXCEED THE REQUIRED PLUS 10%.
- 4. ACCESSIBLE (ADA) COMPLIANT PARKING WILL BE LOCATED ADJACENT TO THE MAIN BUILDING ENTRY, AND REQUIRED PARKING SHALL BE DISTRIBUTED ON AT LEAST TWO SIDES OF A BUILDING.
- 5. ALL SIDEWALKS WILL HAVE A MINIMUM OF 6 FEET CLEAN WALKWAY AREA PROTECTED BY PERMANENT CAR STOPS.
- 6. FRONT ENTRY SIDEWALK AREAS WILL BE COVERED OR SHADED BY TREES.
  7. ALL STRUCTURES SHALL BE CONNECTED BY PEDESTRIAN PATHWAYS PER CITY OF
- ALBUQUERQUE (COA) REQUIREMENTS AND THRU VEHICULAR AREAS.

  8. PATIO AREAS FOR EMPLOYEES WILL BE PROVIDED AND SHADED.
- 9. BICYCLE RACKS WILL BE PROVIDED PER COA CODE.
- 10. ALL LANDSCAPING WILL BE PER COA CODE. NO GREATER THAT 20% OF LANDSCAPED AREA WILL BE LOW WATER USE AND ALL APPLICABLE WATER CONSERVATIONS MEASURES REQUIRED AT THE TIME OF BUILDING PERMIT APPLICATION WILL BE ADHERED TO. 80% MINIMUM GROUND COVERAGE WITH LOW WATER USE OF NATIVE PLANTS.
- 11. PERIMETER WALLS WILL COMPLY WITH PLANNING DEPARTMENT GUIDELINES AT TIME OF
- BUILDING PERMIT APPLICATION NOT TO EXCEED 3'-4" HIGH.

  12. ALL ROOF TOP OR GROUND LEVEL MECHANICAL UNITS WILL BE PHYSICALLY SCREENED FROM

VIEW OR PAINTED TO BLEND WITH SURROUNDING STRUCTURE'S COLOR. ALL ROOF

- PENETRATIONS WILL MATCH STRUCTURE OR ROOF COLOR.

  13. FRONT FACADES WILL BE SHADED BY EITHER THE BUILDING STRUCTURE, CANOPIES, PORTALS, AWNINGS, OR SHADE TRESS PLANTED IN A MANNER TO SHADE THERE ENTIRE FRONT FACADE
- OF THE STRUCTURE.

  14. LOADING DOCKS SHALL BE SCREENED BY WALLS, TREES, AND OR STRUCTURE ELEMENTS
- THAT ARE ARCHITECTURALLY INTEGRATED INTO THE STRUCTURE.

  15. ALL REFUSE ENCLOSURES WILL COMPLY WITH COA CODE AND SOLID WASTE REGULATIONS.
- 16. MONUMENT SIGNS ARCHITECTURALLY INTEGRATED WITH THE STRUCTURE DESIGN WILL NOT
- EXCEED 10 FEET HIGH OR 75 SQUARE FEET PER SIGN.
  17. BUILDING SIGNS SHALL NOT EXCEED 6% OF THE FACADE AREA.
- 18. SITE AND BUILDING LIGHTING WILL COMPLY WITH COA CODES AND REGULATIONS, FULLY SHIELDED, ONE DESIGN TYPE, FOOTING SHALL MATCH STUCCO COLOR, AND 18'-0" HIGH MAXIMUM.
- 19. 3'-0" HIGH BOLLARD ILLUMINATION (AT LEAST ONE) AT CURB RAMPS ENTERING A CROSSWALK, BE ONE DESIGN TYPE, FULLY SHIELDED.
- 20. ALL CROSSWALKS TO BE TEXTURED WITH COLORED CONCRETE OR BRICK PAVING.

PROJECT NUMBER: 1002455
APPLICATION NUMER:

current version of the "Interim Guidelines for Development within City — Designated

Landfill Buffer Zones") shall be consulted prior to development of the site."

THIS PLAN IS CONSISTENT WITH THE SPECIFIC SITE
DEVELOPMENT PLAN APPROVED BY THE ENVIRONMENTAL
PLANNING COMMISSION (EPC) DATE
FINDING S AN CONDITIONS IN THE OFFICIAL NOTIFICATION OF
DECISION ARE SATISFIED.

DRB SITE DEVELOPMENT PLAN SIGNOFF APPROVAL:

TRAFFIC ENGINEERING, TRANSPORTATION DIVISION	DATE
UTILITITES DEVELOPMENT	DATE
PARKS AND RECREATIONAL DEPARTMENT	DATE
CITY ENGINEER	DATE
ENVIRONMENTAL HEALTH DEPARTMENT	DATE
SOLID WASTE MANAGEMENT	DATE
DRB/CHAIRPERSON, PLANNING DEPARTMENT	DATE

GRAPHIC SCALE

SITE

LOCATION

LOCATION MAP ZONE ATLAS: E-18-Z

3



1"=60'-0"

# AMENDMENT TO SITE DEVELOPMENT PLAN FOR SUBDIVISION

AFRA Construction & Design 2501 Yale Blvd. Suite 102 Albuquerque, New Mexico 87106


Tel 505.315.1482

SAN ANTONIO
ALBUQUERQUE, NM

DATE DESCRIPTION APVD

SP-1

11.15.06

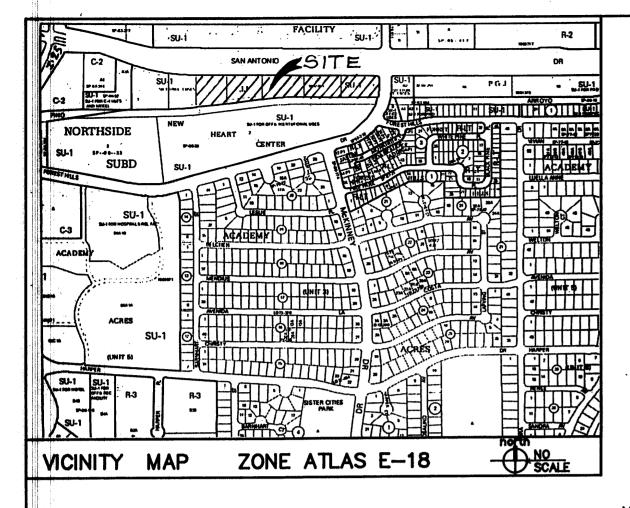

MASTER LANDFILL GAS EVAULUATION AND ABATEMENT SYSTEM PLAN NOTE:

As a condition of this subdivision plat approval by the City, owner, its successors and assigns, covenants and agrees to install a landfill gas monitoring well(s) and extraction system on the property, pursuant to that certain Master Landfill Gas Evaluation and

landfill gas monitoring well(s) and extraction system on the property, pursuant to that certain Master Landfill Gas Evaluation and Abatement System Plan for the proposed Subdivision at I—25 and San Antonio Boulevard, Lots A—3—B 1 thru 7 (now known as Lots 1 through 7, JJ Subdivision), Albuquerque, New Mexico, dated July 18, 2003 prepared by Lawrence Earth Engineering, Larry M. Coons, P.E. (the "Master Landfill Gas Evaluation and Abatement System Plan") and incorporated herein by reference. The landfill gas monitoring well(s) and extraction system shall be installed on a lot by lot basis as defined in the Master Landfill Gas Extraction and Abatement System Plan for any individual lot at the time of and as a condition to Site Development Plan approval, Design Review approval by the City's Design Review Committee or building permit approval, whichever occurs sooner.

The obligation of the owner, its successors and assigns, of an individual lot to install landfill gas monitoring well(s) and extraction system shall include the obligation to monitor well(s) on a periodic basis as approved by the City as detailed in the Master Landfill Gas Evaluation and Abatement System Plan on file at the City's Environmental Health Department and incorporated herein by reference and initiating the start up, operation and maintenance of the extraction system, as required by the City as detailed in the Master Landfill Gas Evaluation and Abatement System Plan.

This paragraph shall in its entirety constitute a covenant running with the title to each individual lot of the property as shown on this Plat shall be binding on the owner, its successors and assigns, of each individual lot for the benefit of the City until terminated.

(Above language by Assistant City Attornery, City of Albuquerque)

"The subject property is located (near, on) a (former, existing) landfill. Due to the subject property being (on, near) a former landfill, certain precautionary measures may need to be taken to ensure the health and safety of the public. Recommendations made by a professional engineer with expertise in landfills and landfill gas issues (as required by the most current version of the "interim Guidelines for Development within 1000 feet of Landfills") shall be consulted prior to development of the site."

UTILITY EASEMENTS:

This plat does not modify or vacate existing public utility easements, nor does it create or grant new public utility easements.

INGRESS/EGRESS EASEMENTS GRANTED BY THIS PLAT:

The new ingress and Egress easements created and granted by this plat are for the benefit of Lots 3—A through 7—A of the subject JJ Subdivision.
Individual lot owners are responsible for the maintenance of the portion of said easements lying within said owners individual lot.

#### PLAT NOTES:

- 1. BEARINGS ARE NM S.P.C.S. GRID BEARINGS. DISTANCES ARE GROUND DISTANCES.
- 2. UTILITY COUNCIL LOCATION SYSTEM LOG NO. 2007022819.
- 3. ALL EASEMENTS SHOWN ON THE RECORD PLAT OR MADE KNOWN TO ME BY THE OWNERS AND/OR PROPRIETORS, UTILITY COMPANIES, OR OTHER PARTIES EXPRESSING AN INTEREST, ARE SHOWN HEREON.
- 4. AREA OF SUBDIVISION IS 6.5044 ACRES.
- 5. CLERKS' INDEXING INFO:
  OWNER: SAN ANTONIO PROPERIES, LLC
  LOCATION: PROJ. SEC. 25, T11N, R3E, NMPM

DISCLOSURE STATEMENT:

THE PURPOSE OF THIS PLAT IS TO VACATE EXISTING EASEMENTS; GRANT ADDITIONAL ACCESS EASEMENTS, AND DEDICATE ADDITIONAL RIGHT-OF-WAY FOR SAN ANTONIO DRIVE N.E.. THIS PLAT DOES NOT FURTHER ALTER ORIGINAL LOT LINES.

#### LEGAL DESCRIPTION:

LOTS NUMBERED THREE (3) THROUGH SEVEN (7), INCLUSIVE, OF "JJ SUBDIVISION", AS THE SAME ARE SHOWN AND DESIGNATED ON THE PLAT THEREOF, FILED FOR RECORD IN THE OFFICE OF THE COUNTY CLERK OF BERNALILLO COUNTY, NEW MEXICO ON MAY 21, 2004 IN PLAT BOOK 2004C, FOLIO 158.

#### BERNALILLO COUNTY TREASURER'S CERTIFICATE:

THIS IS TO CERTIFY THAT TAXES ARE CURRENT AND PAID ON:

LOT NO.	UPC	PROPERTY OWNER OF RECORD
3	101806213150020142	
4	101806215850220143	
5	101806218850320144	Programme and the state of the
6	101806221950320146	
7	101806224750220147	
BERNALIL	LO COUNTY TREASURER'S OFFICE:	
Bv:		Date:

PLAT FOR

## LOT 3-A THROUGH LOT 7-A JJ SUBDIVISION

WITHIN THE ELENA GALLEGOS GRANT
PROJECTED SECTION 25, T11N, R3E, N.M.P.M.
CITY OF ALBUQUERQUE
BERNALILLO COUNTY, NEW MEXICO
JANUARY, 2007
SHEET 1 OF 2

PROJECT NO. 1002455

CATION NO.
Z-12-07
DATE

#### OWNERS' CONSENT, GRANT AND ACKNOWLEDGEMENT:

THE UNDERSIGNED OWNERS OF THE LAND SHOWN AND DESCRIBED HEREON STATE THAT THIS PLAT IS EXECUTED WITH THEIR FREE CONSENT AND IS IN ACCORDANCE WITH THEIR WISHES. SAID OWNERS DO HEREBY GRANT THE EASEMENTS SHOWN FOR THE PURPOSES STATED, AND DEDICATE THE ADDITIONAL RIGHT—OF WAY TO THE CITY OF ALBUQUERQUE IN FEE SIMPLE WITH WARRANTY COVENANTS. SAID OWNERS WARRANT THAT THEY HOLD COMPLETE AND INDEFEASABLE TITLE IN FEE SIMPLE TO THE LAND SUBDIVIDED.

SIMPLE TO THE LAND SUBDIVIDED.	
OWNER: SAN ANTONIO PROPERTIES, LLC	
JEPFERY RUBIN, MANAGING PARTNER	
STATE OF NEW MEXICO )	•

ON THIS 2+4 DAY OF 7-bruary 2007, THIS INSTRUMENT WAS EXECUTED BEFORE ME BY JEFFERY RUBIN AS HIS FREE ACT AND DEED.

NOTARY PUBLIC: Eilen M. Deme MY COMMISSION EXPIRES: 8-14-07

#### SURVEYOR'S CERTIFICATION:

I, REX J. VOGLER, A PROFESSIONAL SURVEYOR LICENSED UNDER THE LAWS OF THE STATE OF NEW MEXICO, CERTIFIES THAT THIS PLAT AND THE FIELD SURVEY ON WHICH IT IS BASED WAS PREPARED BY ME AND MEETS THE MINIMUM REQUIREMENTS FOR LAND SURVEYING IN NEW MEXICO AND MEETS THE REQUIREMENTS FOR MONUMENTATION AND SURVEYS OF THE ALBUQUERQUE SUBDIVISION ORDINANCE, AND IS JRUE AND CORRECT TO THE BEST OF MY KNOWLEDGE AND BELIEF.


REX J. VOGLER NM PS #10466 m. 29 2007

P.O. BOX 7155 ABQ., NM 87194 PHONE & FAX (505) 764—8891



## LOT 3-A THROUGH LOT 7-A JJ SUBDIVISION

WITHIN THE ELENA GALLEGOS GRANT PROJECTED SECTION 25, T11N, R3E, N.M.P.M. CITY OF ALBUQUERQUE BERNALILLO COUNTY, NEW MEXICO JANUARY, 2007

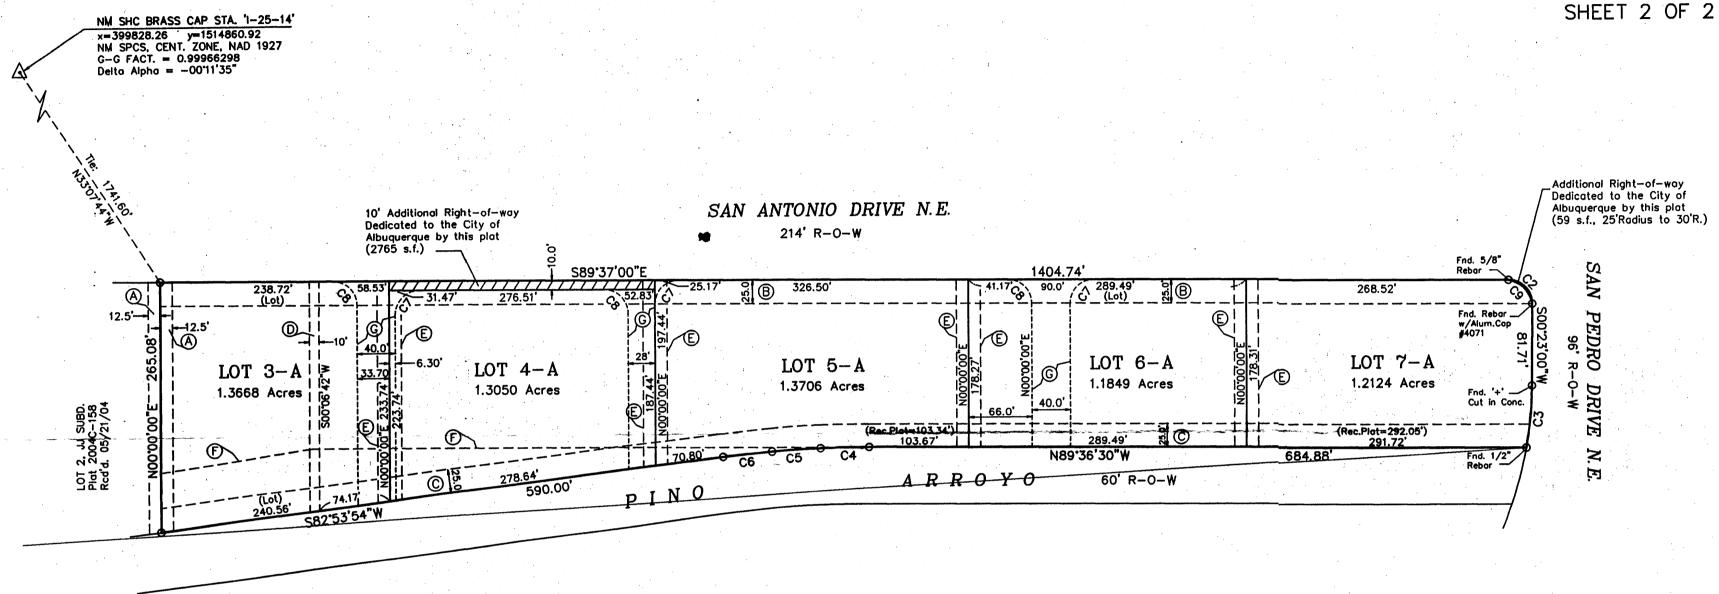

#### KEYED EASEMENT NOTES: ()

#### EXISTING EASEMENTS, NOT ALTERED BY THIS PLAT:

- A Existing 12.5' Ingress and Egress Easement, granted by the record plat, 2004C-158, 05/21/04. This plat retains said easement without modification.
- B Existing 25' C.O.A. Public Water & Sanitary Sewer Easement, granted by the record plat, 2004C-158, 05/21/04. This plat retains said easement without modification.
- C Existing 25' Cross—access, Cross—lot Drainage, and Public Utility Easement, granted by the record plat, 2004C—158, 05/21/04. This plat retains said easement without modification.
- D Existing 10' PNM Easement, granted by Doc. rcd'd. 7/12/88, Bk. Ms. 842A, Pg. 522 and shown on the record plat, 2004C-158, 05/21/04. This plat retains said easement without modification.
- F Existing remnant Blanket Easement for Access and Utilities, granted by plat 910-245, 11/01/91. This plat retains said easement without modification.

#### EXISTING EASEMENTS, VACATED BY THIS PLAT:

E Existing 12.5' Ingress and Egress Easement (private), granted by the record plat, 2004C-158, 05/21/04. Said easement is vacated by this plat:

#### NEW EASEMENTS CREATED BY THIS PLAT:

G New Ingress and Egress Easement granted by this plat, width and dimensions as shown. (See Ingress/Egress Easement Note to the right)

#### PUBLIC UTILITY EASEMENTS:

This plat does not modify or vacate existing public utility easements, nor does it create or grant new public utility easements.

## INGRESS/EGRESS EASEMENTS GRANTED BY THIS PLAT:


The new Ingress and Egress easements created and granted by this plat are for the benefit of Lots 3-A through 7-A of the subject JJ Subdivision. Individual lot owners are responsible for the maintenance of the portion of said easements lying within said owners individual lot.

#### PROPERTY CORNERS:

Unless noted otherwise, all property corners will be marked by a 5/8" rebar with yellow plastic cap stamped 'PS 10466'.

#### SOLAR ACCESS NOTE:

NO PROPERTY WITHIN THE AREA OF REQUESTED FINAL ACTION SHALL AT ANY TIME BE SUBJECT TO A DEED RESTRICTION, COVENANT OR BUILDING AGREEMENT PROHIBITING SOLAR COLLECTORS FROM BEING INSTALLED ON BUILDINGS OR ERECTED ON THE LOTS OR PARCELS WITHIN THE AREA OF THE PROPOSED PLAT. THE FOREGOING SHALL BE A CONDITION OF APPROVAL OF THIS PLAT OR SITE DEVELOPMENT PLAN FOR SUBDIVISION.

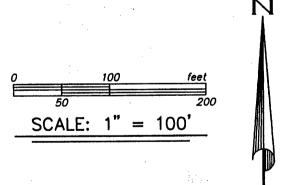

#### CURVE DATA TABLE:

NO.	RADIUS	DELTA	ARC	CHD.	BRG.
C2	25.00'	90'00'00"	39.27	35.36	S44°37'00"E
C3	698.90'	09'37'04"	66.96'	66.87'	S05"11'31"W
C4	1537.50	01*54'33"	51.23'	51.23'	S89°26'13"W
C5	787.50	03°40'29"	50.51	50.50'	S86'38'56"W
C6	1537.50'	01'54'33"	51.23'	51.23'	S83°51'11"W
C7	25.00'	90°23'00"	39.44	35.47	N45°11'30"E
C8	25.00'	89'37'00"	39.10'	35.24	N44'48'30"W
С9	30.00'	90'00'00"	47.12'	42.43'	S44°37'00"E

E		×20.7	·SU-i		FACILITY	SU-1		A SP 85 - 41 F	₩0	R-2
V		C-2		SAN ANTONIO	<b>ZSIT</b>	E				DR
		Parel SUI Pare	SULT	///////////////////////////////////////	[]	<i>\$</i> //2	SU-1	4 на	P Gr.J	SU-1
ŀ	C-2	ME MAICH 1875	Y//I/	SL					·   \$\psi - 1	
Ţ	<b>N</b>	ORTHSIDE	NEW	HEART ?		2		WHITE PINE		1 A 94 A 10 B 01 C 10 W 10 C 10 C 10 C 10 C 10 C 10 C
	SU-	SUBD	SU-1	GENTEN						- ACADEMY
ľ	CHEST PA	11		口田人	72/1					UELLA ANNE
		SU-1			9111	<b>3</b>	H			
	¢.	Shi tau hazater pu	"\	ACADEMY		基础	TIGH	77-1-1-1		
1	¥,/	DEM	~ 目:	111111	777777	日世		$\lambda + + + +$		avenda
		Ziga eratar	HE	NEWDRUS	(¢ TINU)	田田		\		T dint s
		ACRES	1 * 1 \	AVENDA 107		带属	[[]\b			CHRISTY TATAL
	<b>442 14</b>	4.	SU-1 0			山丘	N ACRES	119/		
		(UNIT 5)								
	SI.	SU-1 SU-1 SU-100 Pro-NC R-3	R-3	PAID	SISTER CITIE				目	
		700 to.	HARPER T	BARTONIAM	PARK		5	<u> </u>		
	n	ZINITY	MAP	70Ni	E ATL	AS F			nort	NO SCALE

#### OWNER'S CONSENT AND ACKNOWLEDGEMENT:

The undersigned owner of the land shown and described hereon state that this plat is executed with their free consent and is in accordance with his wishes. Said owner warrants that he holds complete and indefeasible title in fee simple to the land subdivided.

Owner: Timothy M. Ott (Lot 2)				
Timothy M. Ott				
State of New Mexico) County of Bernalillo) ss				
On this day of Timothy M. Ott as his free act and deed.	, 20	_ this instrument wa	s executed before me by	
Notary Public:		_ My commission e	xpires	

MASTER LANDFILL GAS EVAULUATION AND ABATEMENT SYSTEM PLAN NOTE:

MASIEK LANDFILL GAS EVAULUATION AND ABATEMENT STOLEM FLAN NOTE:

As a condition of this subdivision plat approval by the City, owner, its successors and assigns, covenants and agrees to install a landfill gas monitoring well(s) and extraction system on the property, pursuant to that certain Master Landfill Gas Evaluation and Abatement System Plan for the proposed Subdivision at I-25 and San Antonio Boulevard, Lots A-3-B 1 thru 7 (now known as Lots 1 through 7, JJ Subdivision), Albuquerque, New Mexico, dated July 18, 2003 prepared by Lawrence Earth Engineering, Larry M. Coons, P.E. (the "Master Landfill Gas Evaluation and Abatement System Plan") and incorporated herein by reference. The landfill gas monitoring well(s) and extraction system shall be installed on a lot by lot basis as defined in the Master Landfill Gas Extraction and Abatement System Plan for any individual lat at the time of and as a condition to Site Development Plan approval. Design and Abatement System Plan for any individual lot at the time of and as a condition to Site Development Plan approval, Design Review approval by the City's Design Review Committee or building permit approval, whichever occurs sooner.

The obligation of the owner, its successors and assigns, of an individual lot to install landfill gas monitoring well(s) and extraction system shall include the obligation to monitor well(s) on a periodic basis as approved by the City as detailed in the Master Landfill Gas Evaluation and Abatement System Plan on file at the City's Environmental Health Department and incorporated herein by reference and initiating the start up, operation and maintenance of the extraction system, as required by the City as detailed in the Master Landfill Gas Evaluation and Abatement System Plan.

This paragraph shall in its entirety constitute a covenant running with the title to each individual lot of the property as shown on this Plat shall be binding on the owner, its successors and assigns, of each individual lot for the benefit of the City until terminated.

(Above language by Assistant City Attornery, City of Albuquerque) "The subject property is located (near, on) a (former, existing) landfill. Due to the subject property being (on, near) a former landfill, certain precautionary measures may need to be taken to ensure the health and safety of the public. Recommendations made by a professional engineer with expertise in landfills and landfill gas issues (as required by the most current version of the

"Interim Guidelines for Development within 1000 feet of Landfills") shall be consulted prior to development of the site.

UTILITY EASEMENTS:

This plat does not modify or vacate existing public utility easements, nor does it create or grant new public utility easements.

INGRESS/EGRESS EASEMENTS GRANTED BY THIS PLAT:

The new ingress and Egress easements created and granted by this plat are for the benefit of Lots 1 through 7-A of the subject JJ Subdivision. Individual lot owners are responsible for the maintenance of the portion of said easements lying within said owners individual lot.

#### PLAT NOTES:

- BEARINGS ARE NM S.P.C.S. GRID BEARINGS.
- 2. UTILITY COUNCIL LOCATION SYSTEM LOG NO. 2007022819.
- 3. ALL EASEMENTS SHOWN ON THE RECORD PLAT OR MADE KNOWN TO ME BY THE OWNERS AND/OR PROPRIETORS, UTILITY COMPANIES, OR OTHER PARTIES EXPRESSING AN INTEREST, ARE SHOWN HEREON.
- 4. AREA OF SUBDIVISION IS 6.5044 ACRES.
- CLERKS' INDEXING INFO: OWNER: SAN ANTONIO PROPERIES, LLC LOCATION: PROJ. SEC. 25, T11N, R3E, NMPM

#### DISCLOSURE STATEMENT:

THE PURPOSE OF THIS PLAT IS TO VACATE EXISTING EASEMENTS; GRANT ADDITIONAL ACCESS EASEMENTS, AND DEDICATE ADDITIONAL RIGHT-OF-WAY FOR SAN ANTONIO DRIVE N.E.. THIS PLAT DOES NOT FURTHER ALTER ORIGINAL LOT LINES.

#### LEGAL DESCRIPTION:

LOTS NUMBERED TWO (2) THROUGH SEVEN (7), INCLUSIVE, OF "JJ SUBDIVISION", AS THE SAME ARE SHOWN AND DESIGNATED ON THE PLAT THEREOF, FILED FOR RECORD IN THE OFFICE OF THE COUNTY CLERK OF BERNALILLO COUNTY, NEW MEXICO ON MAY 21, 2004 IN PLAT BOOK 2004C, FOLIO 158.

## BERNALILLO COUNTY TREASURER'S CERTIFICATE:

LOT NO.	UPC	PROPERTY OWNER OF RECORD	
2 3	101806213150020142		
4	101806215850220143		
5	101806218850320144		
6	101806221950320146		
7	101806224750220147		
BERNALI	LLO COUNTY TREASURER'S OFFICE:		
By:		Date:	

PLAT FOR

## LOT 2-A THROUGH LOT 7-A JJ SUBDIVISION

WITHIN THE ELENA GALLEGOS GRANT PROJECTED SECTION 25, T11N, R3E, N.M.P.M. CITY OF ALBUQUERQUE BERNALILLO COUNTY, NEW MEXICO JANUARY, 2007 SHEET 1 OF 2

PROJECT NO. 1002455

APPROVALS:	APPLICATION NO.
Ill Bather	2-12-07 DATE
CITY SURVEYOR	DATE .
TRAFFIC ENGINEERING, TRANSPORTATION DIVISION	DATE
PARKS & RECREATION DEPARTMENT	DATE
UTILITIES DEVELOPMENT DIVISION	DATE
A.M.A.F.C.A.	DATE
CITY ENGINEER	DATE
DRB CHARPERSON, PLANS NO DEPARTMENT	EATS
REAL PROPERTY DIVISION	DATE
ENVIRONMENTAL HEALTH DEPARTMENT	DATE

#### OWNERS' CONSENT, GRANT AND ACKNOWLEDGEMENT:

THE UNDERSIGNED OWNERS OF THE LAND SHOWN AND DESCRIBED HEREON STATE THAT THIS PLAT IS EXECUTED WITH THEIR FREE CONSENT AND IS IN ACCORDANCE WITH THEIR WISHES. SAID OWNERS DO HEREBY GRANT THE EASEMENTS SHOWN FOR THE PURPOSES STATED, AND DEDICATE THE ADDITIONAL RIGHT-OF WAY TO THE CITY OF ALBUQUERQUE IN FEE SIMPLE WITH WARRANTY COVENANTS. SAID OWNERS WARRANT THAT THEY HOLD COMPLETE AND INDEFEASABLE TITLE IN FEE

MPLE TO THE LAND SUBDIVIDED.	
WNER: SAN ANTONIO PROPERTIES, LLC	
Joseph C	
FFERY RUBIN, MANAGING PARTNER	
TATE OF NEW MEXICO )	

ON THIS 8+h DAY OF February 2007, THIS INSTRUMENT WAS EXECUTED BEFORE ME BY JEFFERY RUBIN AS HIS FREE ACT AND DEED.

NOTARY PUBLIC: Esleen M. Wenne MY COMMISSION EXPIRES: 8-14-07

#### SURVEYOR'S CERTIFICATION:

I. REX J. VOGLER, A PROFESSIONAL SURVEYOR LICENSED UNDER THE LAWS OF THE STATE OF NEW MEXICO, CERTIFIES THAT THIS PLAT AND THE FIELD SURVEY ON WHICH IT IS BASED WAS PREPARED BY ME AND MEETS THE MINIMUM REQUIREMENTS FOR LAND SURVEYING IN NEW MEXICO AND MEETS THE REQUIREMENTS FOR MONUMENTATION AND SURVEYS OF THE ALBUQUERQUE SUBDIVISION ORDINANCE, AND IS TRUE AND CORRECT TO THE BEST OF MY KNOWLEDGE AND BELIEF.


REX J. YOGLER NM PS #10466

RIO GRANDE SURVEYING CO., PC P.O. BOX 7155 ABQ., NM 87194 PHONE & FAX (505) 764-8891

PLAT FOR

## LOT 2-A THROUGH LOT 7-A JJ SUBDIVISION

WITHIN THE ELENA GALLEGOS GRANT
PROJECTED SECTION 25, T11N, R3E, N.M.P.M.
CITY OF ALBUQUERQUE
BERNALILLO COUNTY, NEW MEXICO
JANUARY, 2007
SHEET 2 OF 2

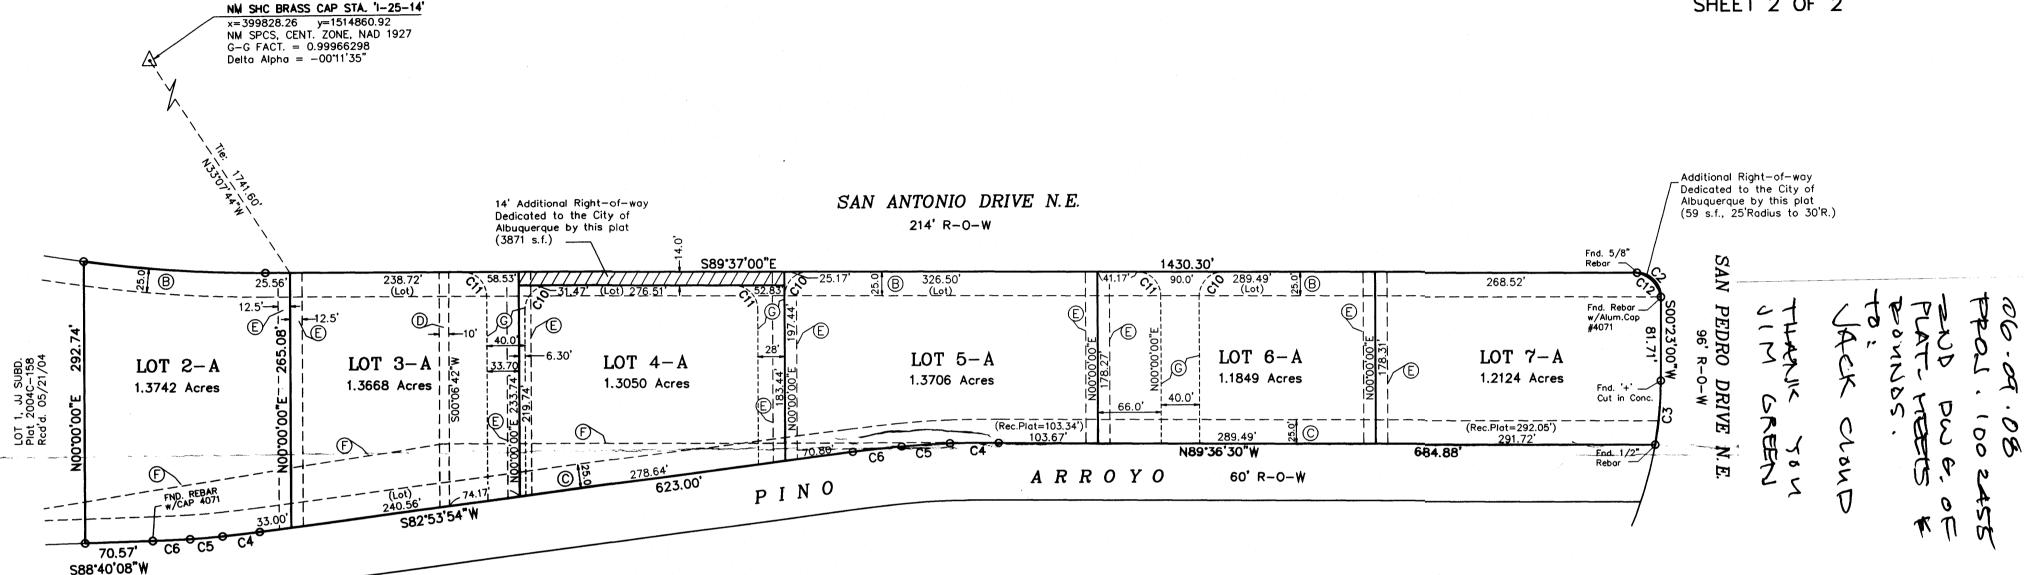

#### KEYED EASEMENT NOTES: 🔘

EXISTING EASEMENTS, NOT ALTERED BY THIS PLAT:

- Existing 25' C.O.A. Public Water & Sanitary Sewer Easement, granted by the record plat, 2004C-158, 05/21/04. This plat retains said easement without modification.
- Existing 25' Cross—access, Cross—lot Drainage, and Public Utility Easement, granted by the record plat, 2004C—158, 05/21/04. This plat retains said easement without modification.
- Existing 10' PNM Easement, granted by Doc. rcd'd. 7/12/88, Bk. Ms. 842A, Pg. 522 and shown on the record plat, 2004C—158, 05/21/04. This plat retains said easement without modification.
- Existing remnant Blanket Easement for Access and Utilities, granted by plat 91C-245, 11/01/91. This plat retains said easement without modification.

#### EXISTING EASEMENTS, VACATED BY THIS PLAT:

E Existing 12.5' Ingress and Egress Easement (private), granted by the record plat, 2004C-158, 05/21/04. Said easement is vacated by this plat:

#### NEW EASEMENTS CREATED BY THIS PLAT:

New Ingress and Egress Easement granted by this plat, width and dimensions as shown.

(See Ingress/Egress Easement Note to the right)

#### PUBLIC UTILITY EASEMENTS:

This plat does not modify or vacate existing public utility easements, nor does it create or grant new public utility easements.

#### INGRESS/EGRESS EASEMENTS GRANTED BY THIS PLAT:

The new Ingress and Egress easements created and granted by this plat are for the benefit of Lot 1 and Lots 2-A through 7-A of the subject JJ Subdivision.


Individual lot owners are responsible for the maintenance of the portion of said easements lying within said owners individual lot.

#### PROPERTY CORNERS:

Unless noted otherwise, all property corners will be marked by a 5/8" rebar with yellow plastic cap stamped 'PS 10466'.


#### SOLAR ACCESS NOTE:

NO PROPERTY WITHIN THE AREA OF REQUESTED FINAL ACTION SHALL AT ANY TIME BE SUBJECT TO A DEED RESTRICTION, COVENANT OR BUILDING AGREEMENT PROHIBITING SOLAR COLLECTORS FROM BEING INSTALLED ON BUILDINGS OR ERECTED ON THE LOTS OR PARCELS WITHIN THE AREA OF THE PROPOSED PLAT. THE FOREGOING SHALL BE A CONDITION OF APPROVAL OF THIS PLAT OR SITE DEVELOPMENT PLAN FOR SUBDIVISION.

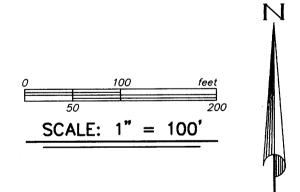

#### **CURVE DATA TABLE:**

NO.	RADIUS	DELTA	ARC	CHD.	BRG.
C1	486.25	07°26'14"	189.77	189.64	S85*53'53"E
C2	25.00'	90°00'00"	39.27	35.36	S44 <b>°</b> 37'00"E
C3	698.90'	09°37'04"	66.96	66.87	S05*11'31"W
C4	1537.50'	01*54'33"	51.23'	51.23	S89 <b>*</b> 26'13"W
C5	787.50	03°40'29"	50.51	50.50'	S86°38'56"W
C6	1537.50'	01°54'33"	51.23	51.23	S83°51'11"W
C7	1462.50	01*31'40"	39.00'	39.00'	S83*39'44"W
C8	712.50	02°42'54"	33.76	33.76	S85°47'01"W
С9	1462.50'	01°31'40"	39.00'	39.00'	S87 <b>°</b> 54'18"W
C10	25.00'	90°23'00"	39.44'	35.47	N45°11'30"E
C11	25.00'	89*37'00"	39.10'	35.24	N44°48'30"W
C12	30.00'	90°00'00"	47.12'	42.43'	S44°37'00"E

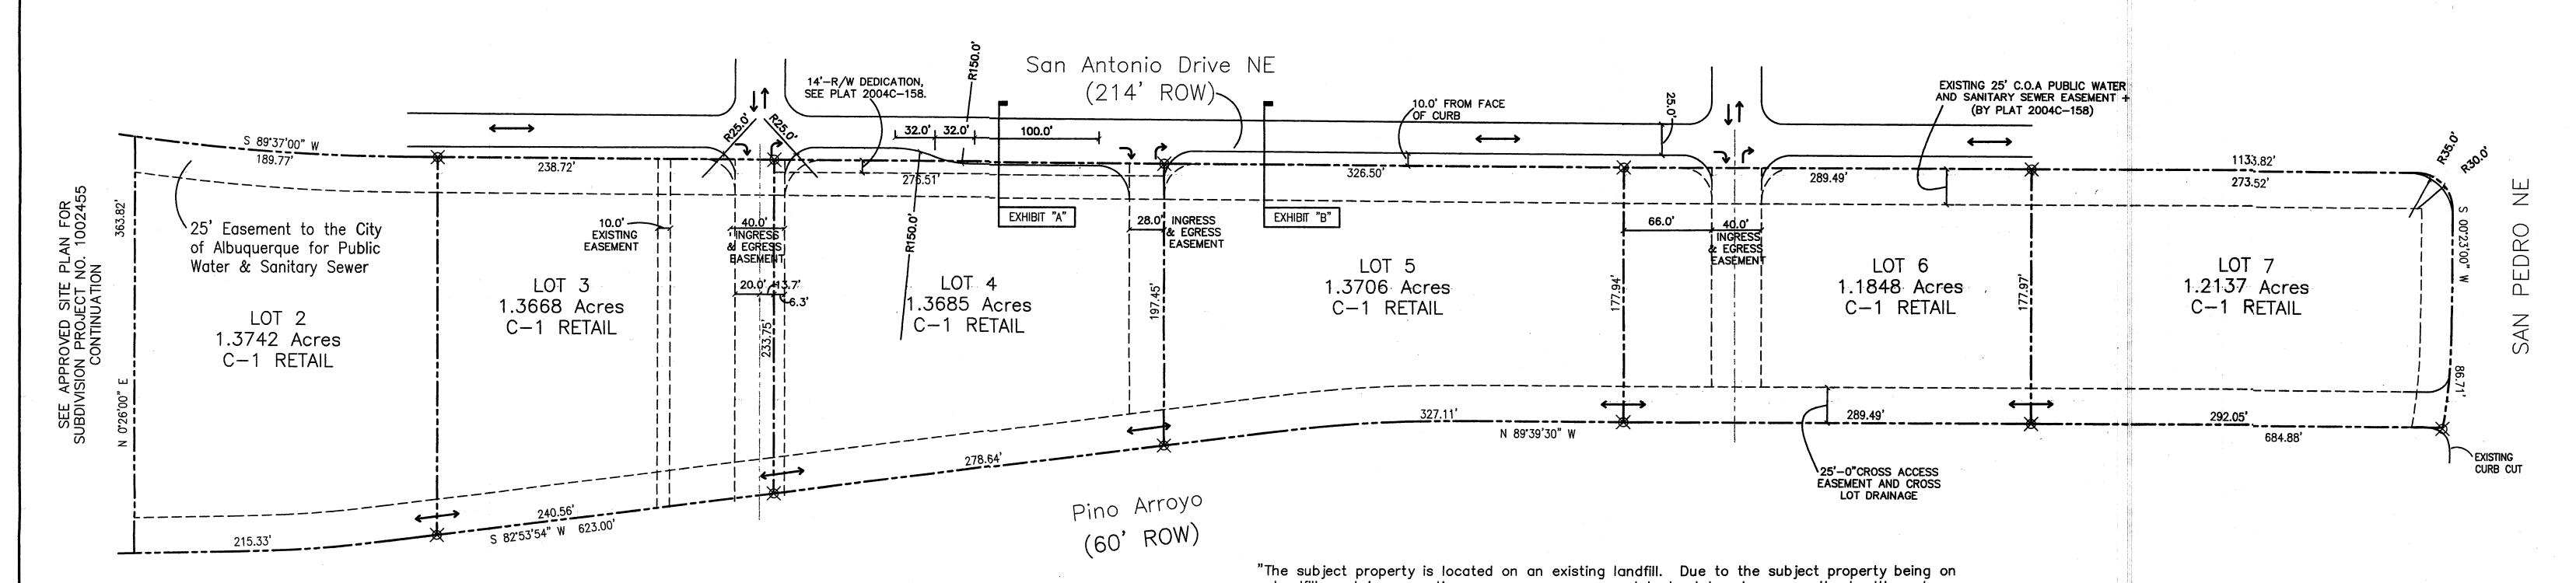

## **LEGAL DESCRIPTION**

LOTS 2 THRU 7 JJ SUBDIVISION BEING A REPLAT OF TRACT A-3-B. J GROUP ADDTION, TRACT 1. NEW HEART CENTER & TRACT 1. NORTHSIDE SUBDIVISION


WITHIN PROJECTED SECTION 25 TOWNSHIP 11 NORTH, RANGE 3 EAST NEW MEXICO PRINCIPAL MERIDIAN

> CITY OF ALBUQUERQUE BERNALILLO COUNTY NEW MEXICO

## NOTES: LOTS 2 THRU 7

BUILDING HEIGHT NOT TO EXCEED 34 FT. MAXIMUM FLOOR-AREA RATION: 20.0% BUILDING MINIMUM SETBACKS: FRONT: 25.0 FT SIDE: 5.0 FT REAR: 5.0 FT

## TRAFFIC FLOW NOTES

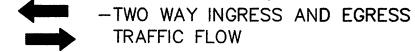

-RIGHT TURN ONLY INTO LOT

-RIGHT TURN ONLY OUT OF LOT

-TWO WAY INTERIOR AND CROSS-LOT TRAFFIC FLOW

# AMENDMENT TO SITE DEVELOPMENT PLAN FOR SUBDIVISION

SCALE: 1"=60'-0"



a landfill, certain precautionary measures may need to be taken to ensure the health and safety of the public. Recommendations made by a professional engineer with expertise in landfills and landfill gas issues (as required by the most current version of the "Interim Guidelines for Development within City — Designated Landfill Buffer Zones") shall be consulted prior to development of the site."

SITE LOCATION "THE DEVELOPERS OF THIS SITE ARE REQUIRED TO FOLLOW THE MOST CURRENT VERSION OF THE CITY OF ALBUQUERQUE INTERIM GUIDELINES FOR DEVELOPMENT WITHIN CITY DESIGNATED

LANDFILL BUFFER ZONES. A REVIEW AND APPROVAL OF THE SITE PLAN(S), THE PROPOSED CONSTRUCTION, DESIGN DRAWINGS, AND A CERTIFICATION OF CONSTRUCTION WILL BE REQUIRED BY THE ENVIRONMENTAL HEALTH DEPARTMENT (EHD), ENVIRONMENTAL SERVICES DIVISION.

## GENERAL DESIGN CRITERIA:

- 1. ALL STRUCTURES ON LOTS WILL BE LIMITED TO THE GENERAL CRITERIA DESCRIBED HEREIN. 2. DESIGN OF BUILDING SHALL BE A COMPATIBLE STYLE, MATERIALS AND COLORS THROUGHOUT LOTS 2-7.
- 3. PARKING WILL NOT EXCEED THE REQUIRED PLUS 10%.
- 4. ACCESSIBLE (ADA) COMPLIANT PARKING WILL BE LOCATED ADJACENT TO THE MAIN BUILDING ENTRY, AND REQUIRED PARKING SHALL BE DISTRIBUTED ON AT LEAST TWO SIDES OF A BUILDING.
- 5. ALL SIDEWALKS WILL HAVE A MINIMUM OF 6 FEET CLEAN WALKWAY AREA PROTECTED BY PERMANENT CAR STOPS.
- 6. FRONT ENTRY SIDEWALK AREAS WILL BE COVERED OR SHADED BY TREES. 7. ALL STRUCTURES SHALL BE CONNECTED BY PEDESTRIAN PATHWAYS PER CITY OF
- ALBUQUERQUE (COA) REQUIREMENTS AND THRU VEHICULAR AREAS. 8. PATIO AREAS FOR EMPLOYEES WILL BE PROVIDED AND SHADED.
- 9. BICYCLE RACKS WILL BE PROVIDED PER COA CODE. 10. ALL LANDSCAPING WILL BE PER COA CODE. NO GREATER THAT 20% OF LANDSCAPED AREA WILL BE LOW WATER USE AND ALL APPLICABLE WATER CONSERVATIONS MEASURES REQUIRED AT THE TIME OF BUILDING PERMIT APPLICATION WILL BE ADHERED TO. 80% MINIMUM GROUND COVERAGE WITH LOW WATER USE OF NATIVE PLANTS.
- 11. SCREEN WALLS WILL NOT TO EXCEED 3'-4" HIGH, AND SHALL MATCH STUCCO COLOR OF BUILDINGS.
- 12. ALL ROOF TOP OR GROUND LEVEL MECHANICAL UNITS WILL BE PHYSICALLY SCREENED FROM VIEW OR PAINTED TO BLEND WITH SURROUNDING STRUCTURE'S COLOR. ALL ROOF PENETRATIONS WILL MATCH STRUCTURE OR ROOF COLOR.
- 13. FRONT FACADES WILL BE SHADED BY EITHER THE BUILDING STRUCTURE, CANOPIES, PORTALS, AWNINGS, OR SHADE TRESS PLANTED IN A MANNER TO SHADE THERE ENTIRE FRONT FACADE OF THE STRUCTURE.
- 14. LOADING DOCKS SHALL BE SCREENED BY WALLS, TREES, AND OR STRUCTURE ELEMENTS THAT ARE ARCHITECTURALLY INTEGRATED INTO THE STRUCTURE.
- 15. ALL REFUSE ENCLOSURES WILL COMPLY WITH COA CODE AND SOLID WASTE REGULATIONS. 16. MONUMENT SIGNS ARCHITECTURALLY INTEGRATED WITH THE STRUCTURE DESIGN WILL NOT
- EXCEED 10 FEET HIGH OR 75 SQUARE FEET PER SIGN
- 17. BUILDING SIGNS SHALL NOT EXCEED 6% OF THE FACADE AREA. 18. SITE AND BUILDING LIGHTING WILL COMPLY WITH COA CODES AND REGULATIONS, FULLY SHIELDED, ONE DESIGN TYPE, FOOTING SHALL MATCH STUCCO COLOR, AND 18'-0" HIGH MAXIMUM.
- 19. 3'-0" HIGH BOLLARD ILLUMINATION (AT LEAST ONE) AT CURB RAMPS ENTERING A CROSSWALK, BE ONE DESIGN TYPE, FULLY SHIELDED.
- 20. ALL CROSSWALKS TO BE TEXTURED WITH COLORED CONCRETE OR BRICK PAVING.


#### PROJECT NUMBER: 1002455 APPLICATION NUMER:

THIS PLAN IS CONSISTENT WITH THE SPECIFIC SITE DEVELOPMENT PLAN APPROVED BY THE ENVIRONMENTAL PLANNING COMMISSION (EPC) DATE FINDING S AN CONDITIONS IN THE OFFICIAL NOTIFICATION OF DECISION ARE SATISFIED.

## DRB SITE DEVELOPMENT PLAN SIGNOFF APPROVAL:

TRAFFIC ENGINEERING, TRANSPORTATION DIVISION	DATE
UTILITITES DEVELOPMENT	DATE
PARKS AND RECREATIONAL DEPARTMENT	DATE
CITY ENGINEER	DATE
ENVIRONMENTAL HEALTH DEPARTMENT	DATE
SOLID WASTE MANAGEMENT	DATE
DRB/CHAIRPERSON, PLANNING DEPARTMENT	DATE

**GRAPHIC SCALE** 

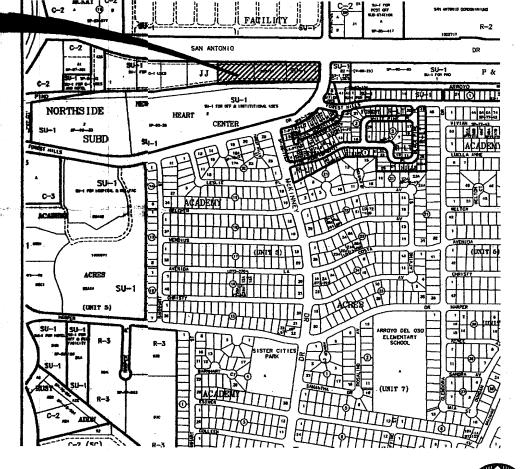

LOCATION MAP ZONE ATLAS: E-18-Z



104 (4)

## AMENDMENT TO SITE **DEVELOPMENT PLAN** FOR SUBDIVISION

1"=60'-0"


AFRA Construction & Design 2501 Yale Blvd. Suite 102 Albuquerque, New Mexico 87106 Tel 505.998.3128 Tel 505.998.3129

## SAN ANTONIO OFFICE & RETAIL ALBUQUERQUE, NM

REV	DATE	DESCRIPTION	APVD
1			
2			
3			

SD-1

6.9.08

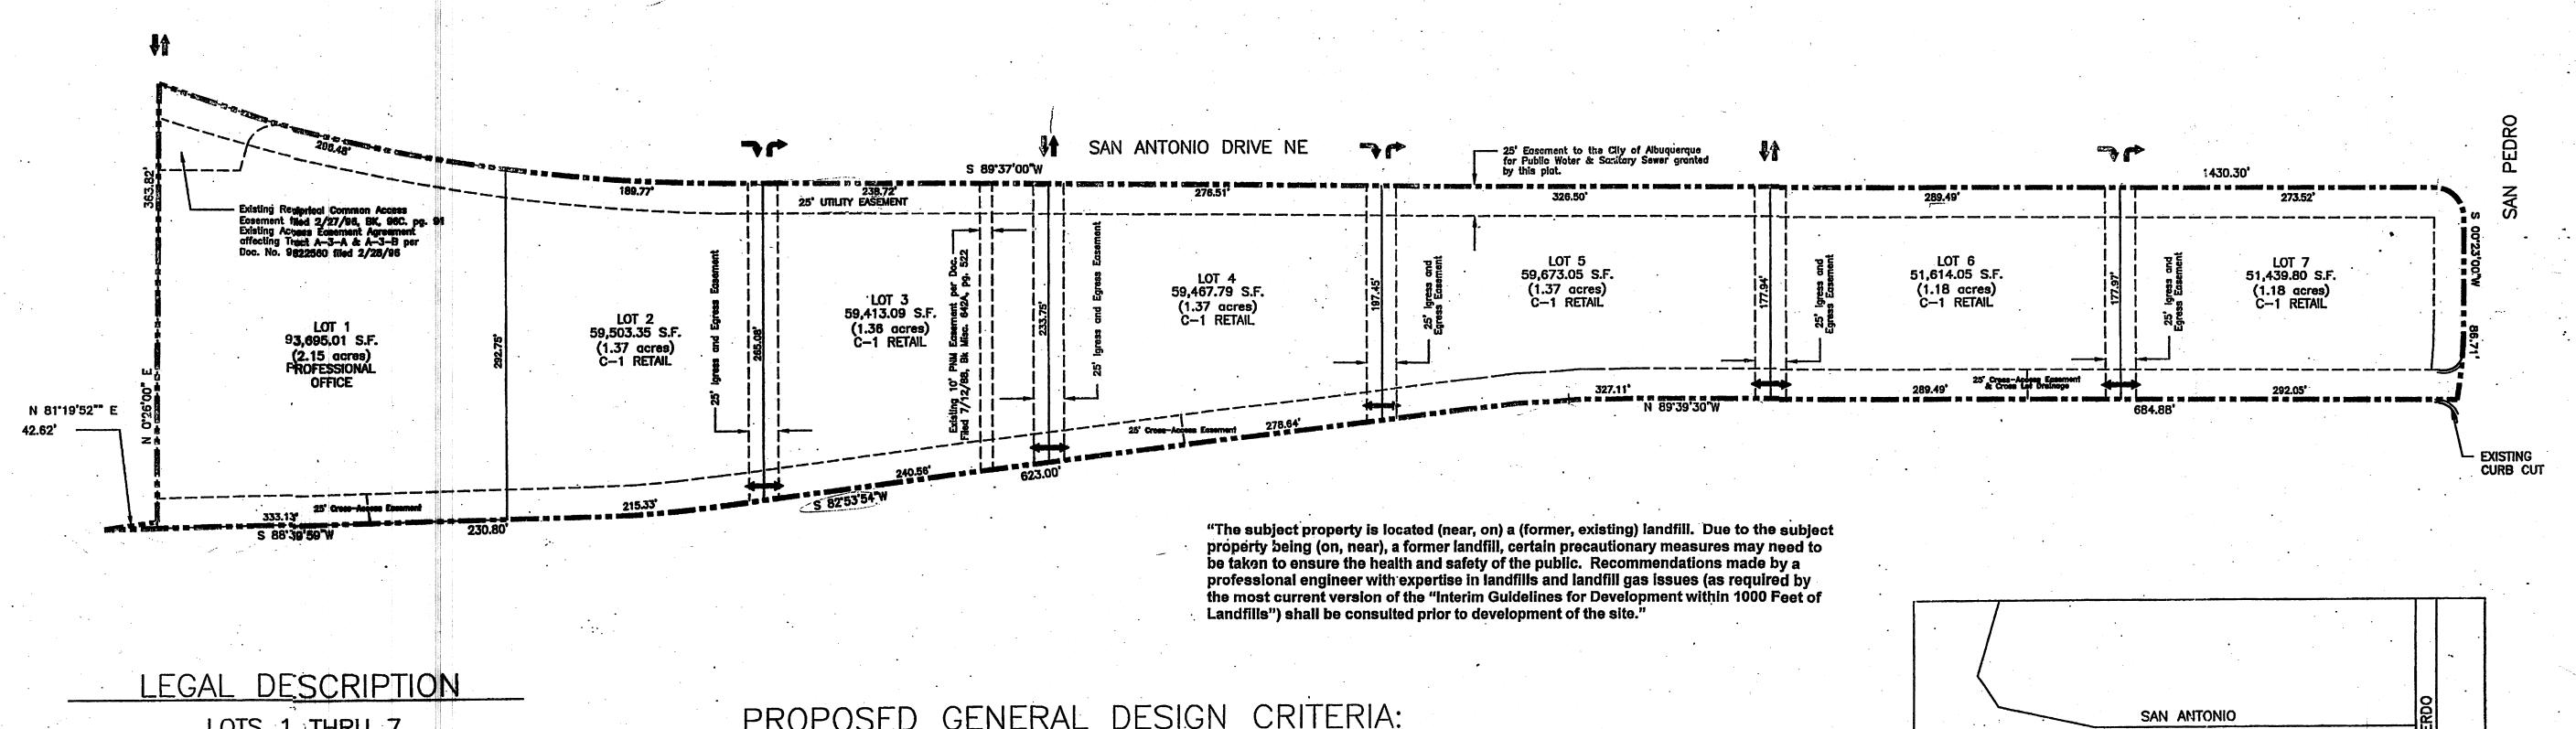

LOTS 1 THRU 7 JJ SUBDIVISION

#1 101

BEING A REPLAT OF TRACT A-3-B, J\_GROUP ADDITION, TRACT 1 NEW HEART CENTER & TRACT 1 NORTHSIDE SUBDIVISION

WITHIN PROJECTED SECTOIN -25-TOWNSHIP 11 NORTH, RANGE 3 EAST NEW MEXICO PRINCIPAL MERIDIAN

> CITY OF ALBUQUERQUE BERNALILLO COUNTY NEW MEXICO

NOTES: LOTS 1 thru 7 BUILDING HEIGHT NOT TO EXCEED 26 FT.

MAXIMUM FLOOR-AREA RATIO: 20.0% BUILDING MINIMUM SETBACKS: FRONT: 25.0 FT. SIDE: 5.0 FT.

5.0 FT.

## TRAFFIC FLOW NOTES


REAR:

- TRAFFIC FLOW
- RIGHT TURN ONLY INTO LOT
- RIGHT TURN ONLY OUT OF LOT

- TWO WAY INTERIOR AND CROSS-LOT TRAFFIC FLOW

## PROPOSED GENERAL DESIGN CRITERIA:

- ALL STRUCTURES ON LOTS WILL BE LIMITED TO THE GENERAL CRITERIA DESCRIBED HEREIN
- EXTERIOR APPEARANCE OF STRUCTURES WILL BE AS DEPICTED ON SHEET.
- PARKING WILL NOT EXCEED THE REQUIRED PLUS 10%.
- NO MORE THAN 25% OF THE REQUIRED PARKING WILL BE LOCATED IN FRONT OF THE BUILDING BETWEEN THE BUILDING AND THE STREET.
- ADA-COMPLIANT PARKING WILL BE LOCATED ADJACENT TO THE MAIN BUILDING ENTRY.
- ALL SIDEWALKS WILL HAVE A MINIMUM OF 6 FEET CLEAN TRAVEL AREA PROTECTED BY PERMANENT CAR STOPS.
- FRONT ENTRY SIDEWALK AREAS WILL BE COVERED OR SHADED BY TREES.
- ALL STRUCTURES SHALL BE CONNECTED BY PEDESTRIAN PATHWAYS PER CITY OF ALBUQUERQUE (COA) REQUIREMENTS.
- PATIO AREAS FOR EMPLOYEES WILL BE PROVIDED AND SHADED.
- BICYCLE RACKS WILL BE PROVIDED PER COA CODE.
- ALL LANDSCAPING WILL BE PER COA CODE. NO GREATER THAN 20% OF LANDSCAPED AREA WILL BE HIGH WATER USE AND ALL APPLICABLE WATER CONSERVATION MEASURES REQUIRED AT THE TIME OF BUILDING PERMIT APPLICATION WILL BE ADHERED TO.
- PERIMETER WALLS WILL COMPLY WITH PLANNING DEPARTMENT GUIDELINES AT TIME OF BUILDING PERMIT APPLICATION.
- ALL ROOFTOP OR GROUND LEVEL MECHANICAL UNITS WILL BE PHYSICALLY SCREENED FROM VIEW OR PAINTED TO BLEND WITH SURROUNDING STURCTURE'S COLOR. ALL ROOF PENETRATIONS WILL MATCH SRUCTURE, OR ROOF COLOR.
- FRONT FACADES WILL BE SHADED BY EITHER THE BUILDING STRUCTURE, CANOPIES, PORTALS, AWNINGS, OR SHADE TREES PLANTED IN A MANNER TO SHADE THE ENTIRE FRONT FACADE OF THE STRUCTURE.
- LOADING DOCKS SHALL BE SCREENED BY WALLS, TREES, AND OR STRUCTURE ELEMENTS THAT ARE ARCHITECTURALLY INTEGRATED INTO THE STRUCTURE.
- ALL REFUSE ENCLOSURES WILL COMPLY WITH COA CODE AND SOLID WASTE REGULATIONS.
- BUILDING FRONTS WILL BE NO CLOSER THAN 12 FEET FROM THE FACE OF CURB TO THE STRUCTURE.
- MONUMENT SIGNS ARCHITECTURALLY INTEGRATED WITH THE STRUCTURE DESIGN WILL NOT EXCEED 10 FEET HIGH OR 75 SQUARE FEET PER SIGN.
- BUILDING SIGNS SHALL NOT EXCEED 6% OF THE FACADE AREA.
- SITE AND BUILDING LIGHTING WILL COMPLY WITH COA CODES AND REGULATIONS., IN NO INSTANCE SHALL LIGHT ESCAPE BEYOND THE PROPERTY LINE.

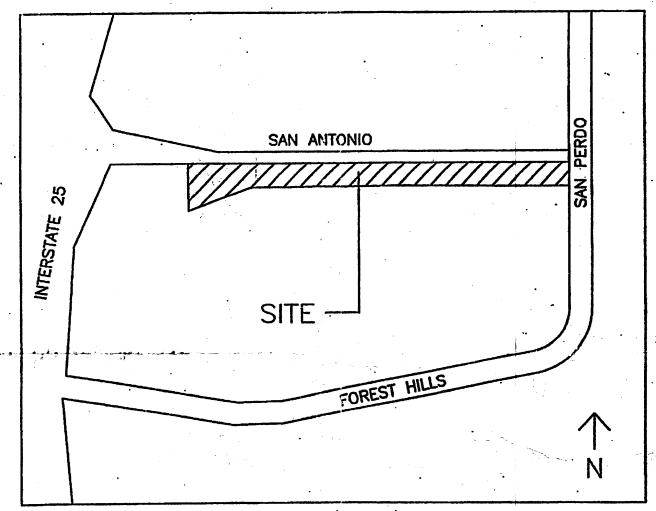

VICINITY MAP

Samuel Committee Com		
PROJECT NUMBER: _	1002455	
Application Number:		· · ·

This plan is consistemt with the specific Site Development Plan approved by the Environmental Planning Commission (EPC). date <u>March 21, 2003</u> and the Findings and Conditions in the Official Notification of Decision are satisfied.

DRB SITE DEVELOPMENT PLAN SIGNOFF APPROVAL:

Andrew Control of the	Ift so	10-29-03
	Traffic Engineering, Transportation Division	Date
r\ n	Kagen & Stree	10-29-03
NI NI	Utilities Development	Date
	Christina Sandoral	10/29/03
4	Parks and Recreation Department	Date 10 - 29-03
	Kill of buil	S-American Contract of the Con
	City Engineer	Date -
4	( Respectively )	BeF. 29, 2003
 	Environmental Health Department	Date
70 0 70	Michael Holton (will comply with all 5W arding	nes) 10/29/03
Scale 1"=70'-0"	Solid Waste Management	Date
	Theran / Jateon	10/29/03 - Date
	DRB/Chairperson, Planning Department	Date





I	JOB N	10:
	DATE:	30 September 2003
İ		REVISIONS
	-4	
	<u> </u>	
١,		


SUBDIVISION OR

SITE PLAN FOR SUBDIVISION

Scale 1"=70'-0"

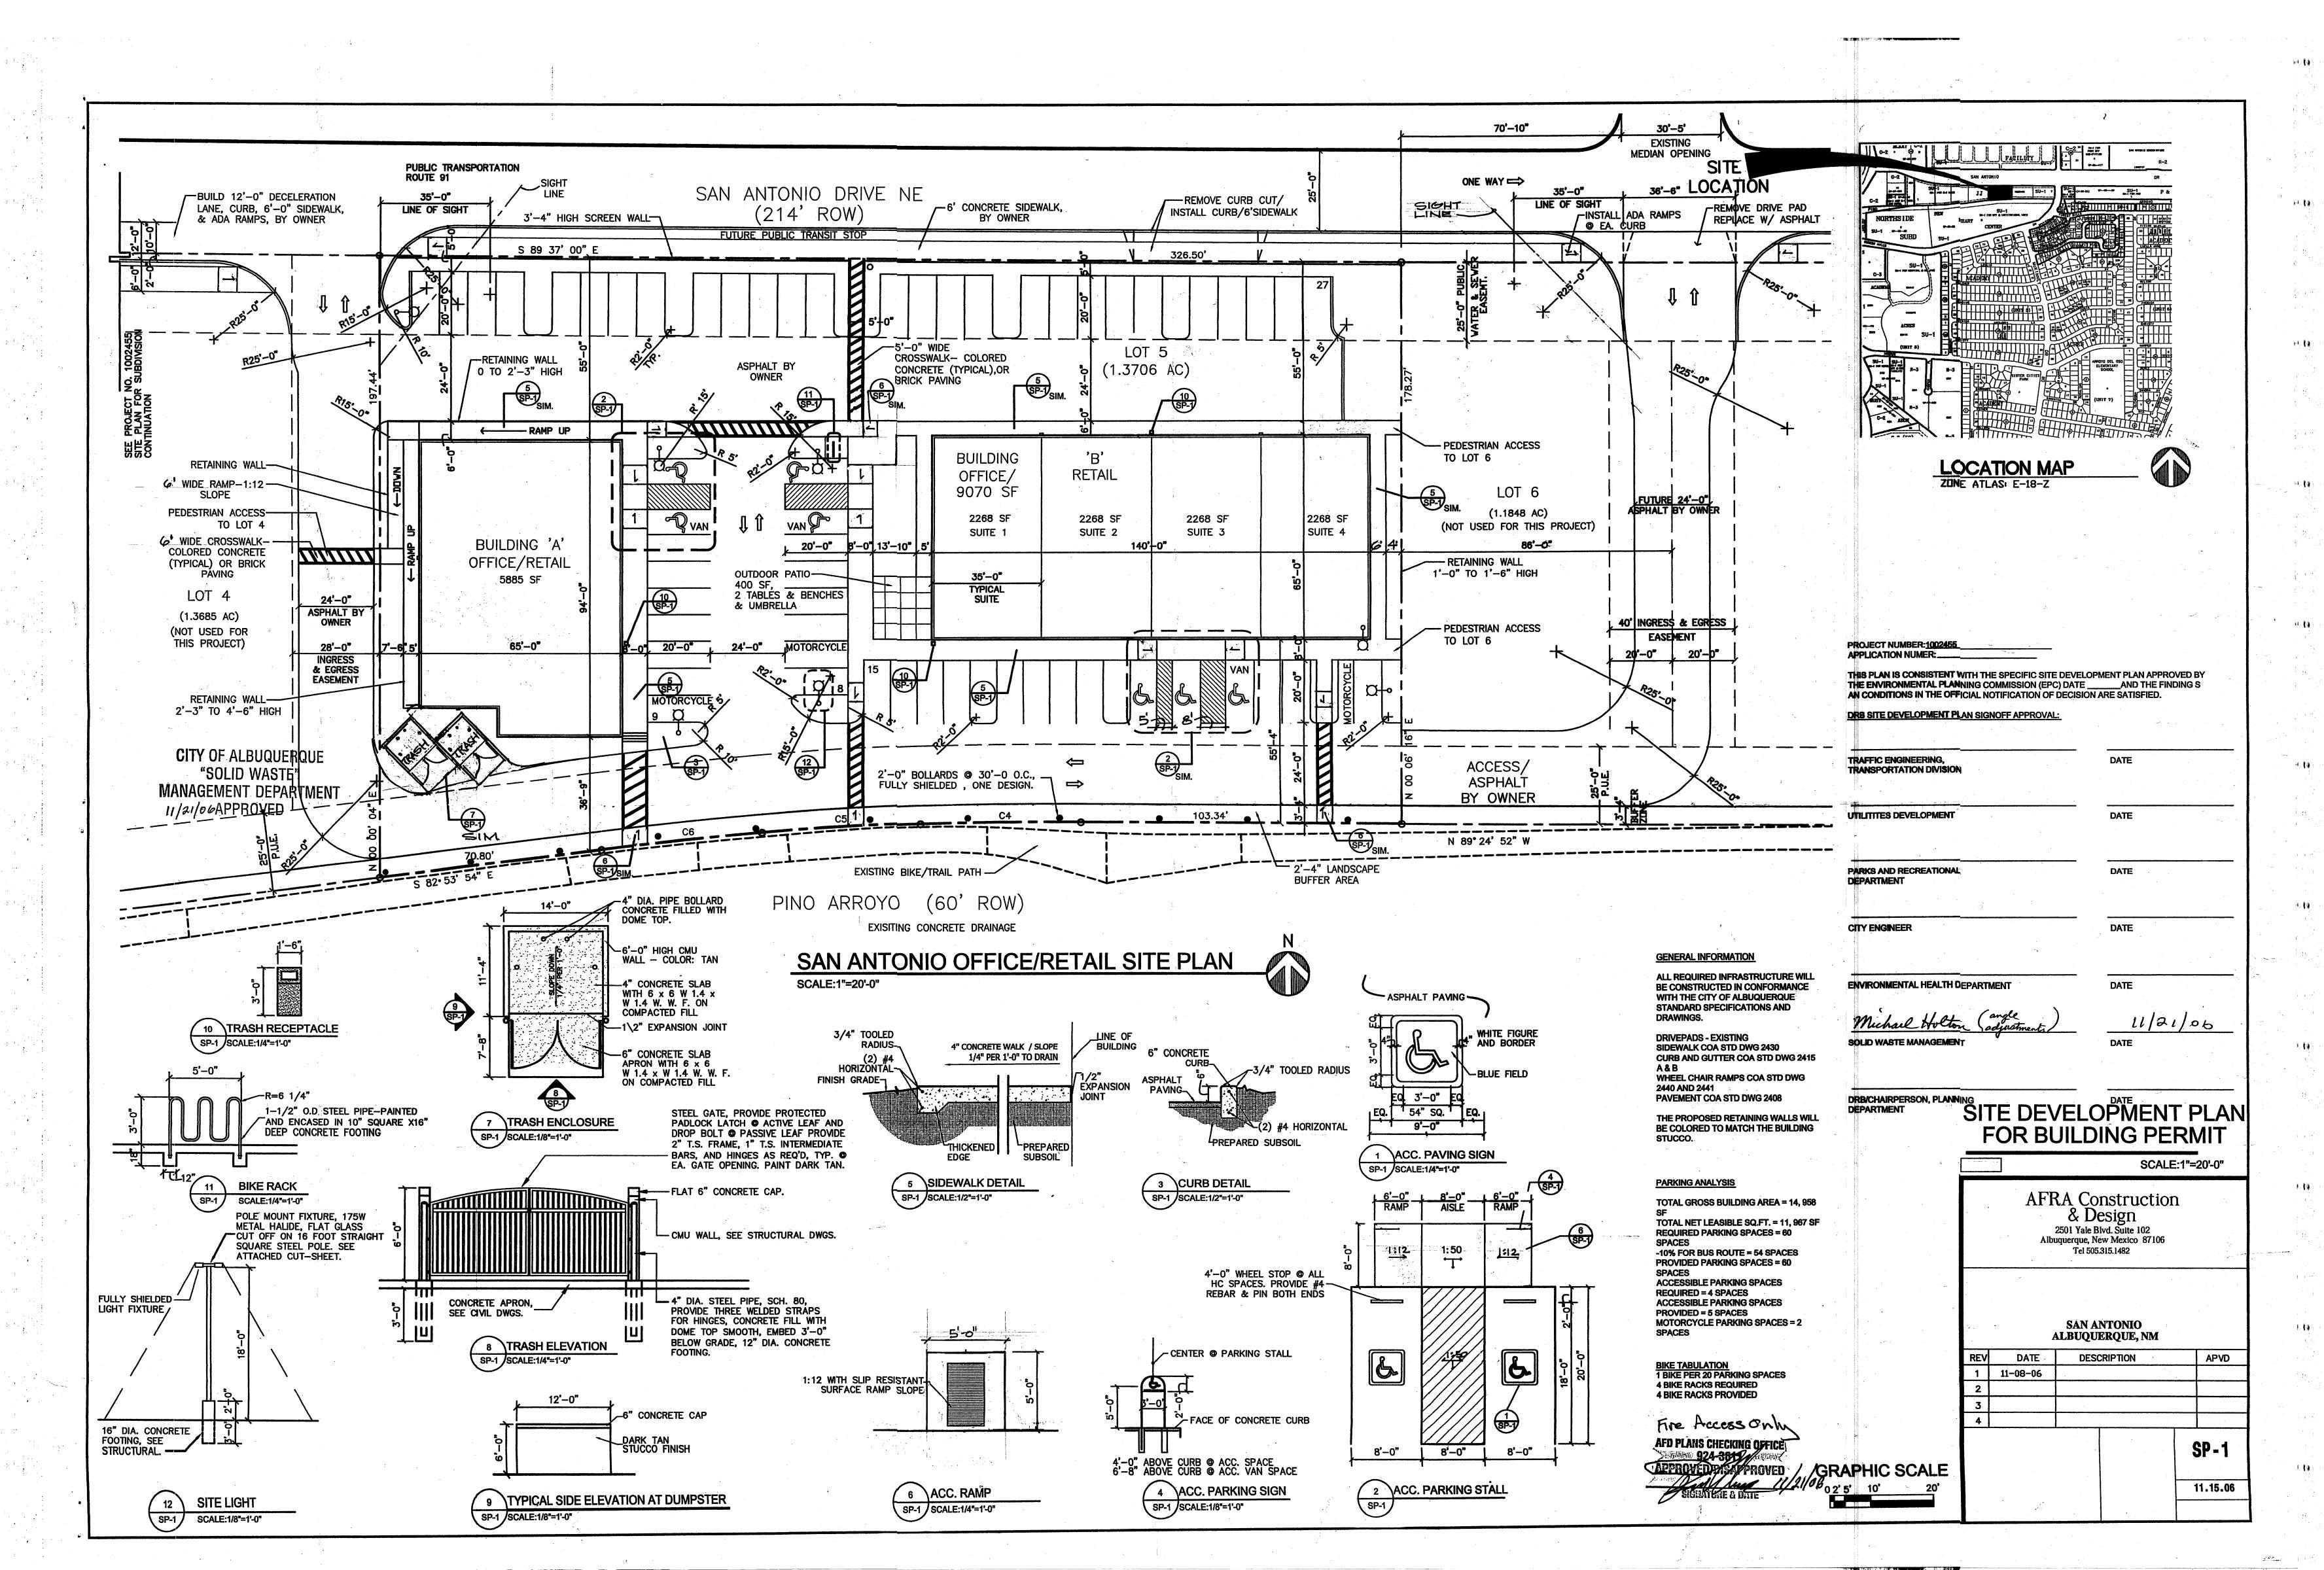

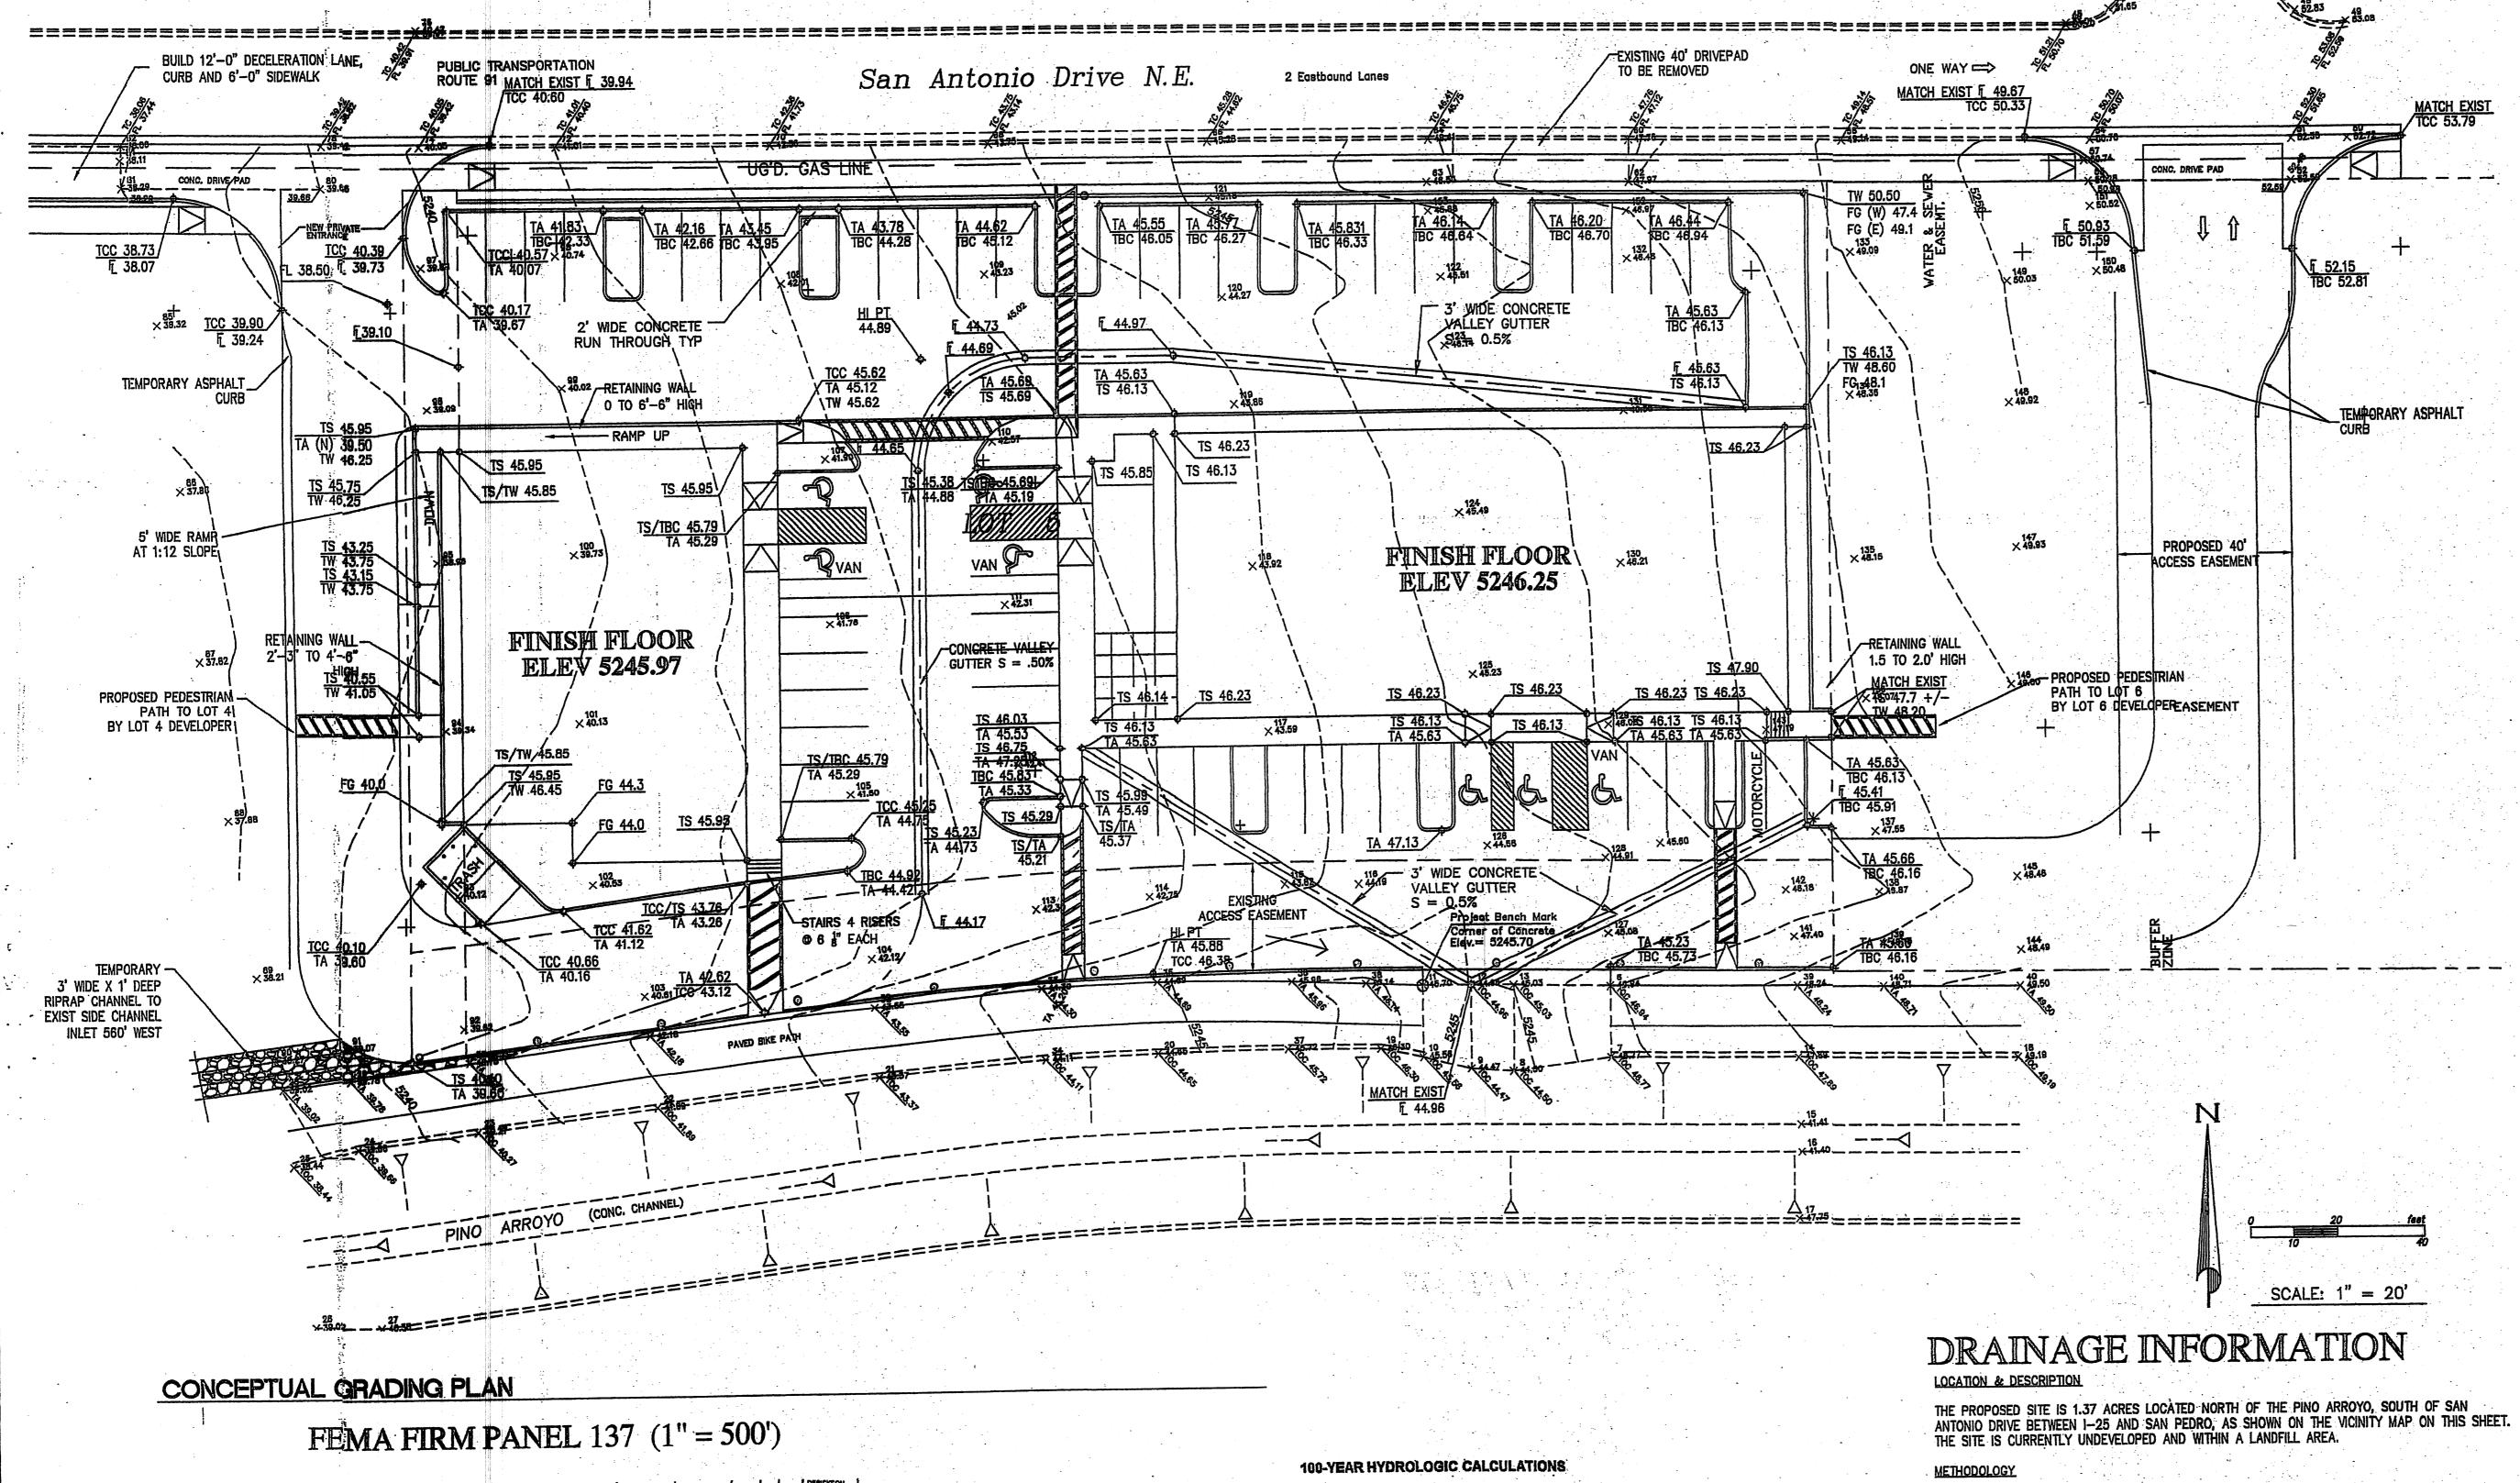

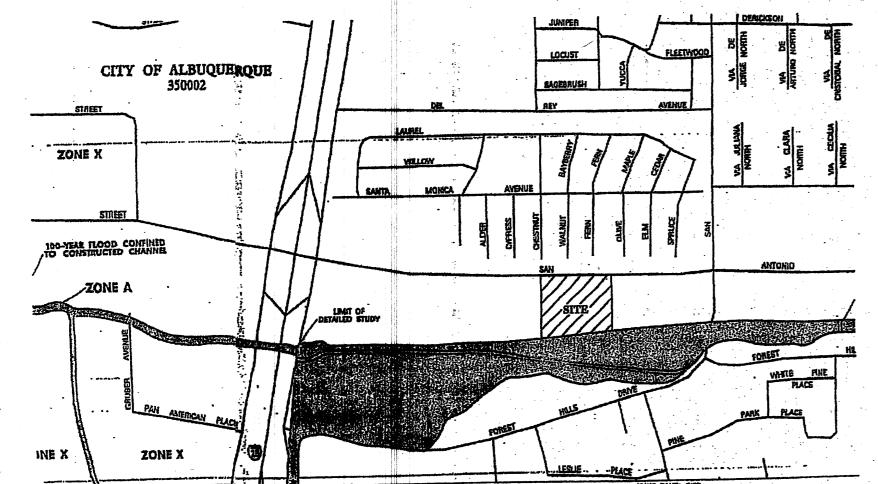

LAND TREATMENT WEIGHTED											
BASIN	AREA	Α	В	C	D	E	V (6-hr)	V (6-hr)	V(10 day)	V(10 day)	Q
#	(acre)	(%)	(%)	(%)	(%)	(in)	· (acre-ft)	(cu-ft)	(acre-ft)	(cu-ft)	(cfs)
					EXIST	NG CONDITI	ONS				
Α	1.3730	100.00	0.00	0.00	0.00	0.53	0.06	2,642	80.0	2,642	2.14
TOTAL	1.3730						0.08	2,642	0.06	2,642	2.14
					PROPO	SED CONDIT	TIONS				
A	1.3730	0.00	0.00	4.00	96.00	2.08	0.24	10,369	0.41	18,024	6.37
TOTAL	1.3730						0.24	10,369	0.41	18,024	6.37
EXCESS	PRECIP.	0.53	0.78	1.13	2.12	Ei (in)		• .		•	
PEAK DIS		1.56	2.28	3.14	4.7	Qr (cfs)					
		<u> </u>	L.,	<u>.</u>		•	-		ZONE =	2	•
WEIGHTED	) E (in) = (E	Ea)(%A) +	(E <sub>B</sub> )(%B)	+ (Ec)(%	(C) + (En)	(%D)			Ps-HR (in.) =	2,35	- •
Veur (acre-f									P24-HR (in.) =	2.75	
V10DAY (acre									P100AY (in.)	= 3.95	
Q (cfs) = (0	$\frac{1}{2}$	+ (AA)(aqO	(Qpc)(Ac	+ (Qpd)(	Ap)		:	• •			-

THE HYDROLOGY FOR THIS PROJECT WAS ANALYZED USING THE QUICK CALCULATIONS OF THE JUNE 1997 RELEASE OF THE CITY OF ALBUQUERQUE DEVELOPMENT PROCESS MANUAL, SECTION


THE 100-YR 6-HR DURATION STORM WAS USED AS THE DESIGN STORM FOR THIS ANALYSIS. THIS SITE IS WITHIN ZONE 2 AS IDENTIFIED IN THE CITY OF ALBUQUERQUE DEVELOPMENT PROCESS MANUAL, SECTION 22.2. TABLES WITHIN THIS SECTION WAS USED TO ESTABLISH THE 6-HOUR PRECIPITATION, EXCESS PRECIPITATION, AND PEAK DISCHARGE.

#### EXISTING DRAINAGE

THE PROPERTY SITS BETWEEN SAN ANTONIO DRIVE AND THE PINO ARROYO. IT IS UNDEVELOPED BUT IS FULLY DISTURBED WITH HARD COMPACTED EARTH WITH NO VEGETATION. EXISTING DRAINAGE IS TOWARD THE WEST WITH AN AVERAGE SLOPE OF 4%. THE RUNOFF SHEET FLOWS WEST TO AN EXISTING SIDE CHANNEL INLET ABOUT 560-FEET WEST OF THE SITE WHERE IT ENTERS THE PINO ARROYO.

## DEVELOPED CONDITION

THE PROPOSED DEVELOPMENT WILL CONTINUE TO UTILIZE FREE DISCHARGE INTO THE PINO ARROYO VIA THE EXISTING SIDE CHANNEL INLET WEST OF THE SITE. AS A TEMPORARY MEASURE, A RIPRAPED SWALE HAS BEEN PROPOSED TO CONVEY THE RUNOFF TO THE SIDE CHANNEL INLET. THIS SWALE WILL BE REPLACED BY PAVED ACCESS WHEN THE SITES TO THE WEST HAVE BEEN DEVELOPED IN THE CROSS LOT ACCESS EASEMENT ALONG THE NORTH SIDE OF THE BIKE PATH AND

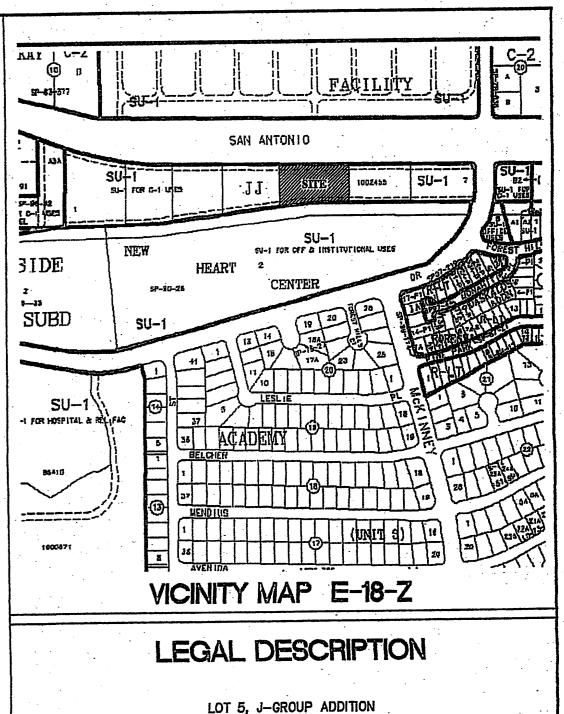

BERNALILLO COUNTY, NEW MEXICO

## FLOODPLAIN

THE PROPERTY SHOWN HEREON DOES NOT LIE WITHIN ANY DESIGNATED ALBUQUERQUE, BERNALILLO COUNTY, NEW MEXICO, COMMUNITY-PANEL NO. 35001C0137F; EFFECTIVE DATE NOVEMBER 19, 2003.

## GENERAL INFORMATION

THE CITY OF ALBUQUERQUE STANDARD SPECIFICATIONS AND DRAWINGS.

DRIVEPADS - EXISTING
SIDEWALK COA STD DWG 2430
CURB AND GUTTER COA STD DWG 2415 A&B WHEEL CHAIR RAMPS COA STD DWG 2440 AND 2441 PAVEMENT COA STD DWG 2408

THE PROPOSED RETAINING WALLS WILL BE COLORED TO MATCH THE BUILDING

## LARRY READ & ASSOCIATES, Inc.

Civil Engineers


2430 Midtown Place NE Suite C Albuquerque, New Mexico 87107 (505) 237-8421

AFRA Construction
& Design
7004 Avenida La Costa NE
Albuquerque, New Mexico 87109
Tel 505.315.1482

SAN ANTONIO OFFICE-RETAIL ALBUQUERQUE, NM

REV	DATE	DESCRIPTION	APVI
1	·		•
2			
3			
4			

11.15.06

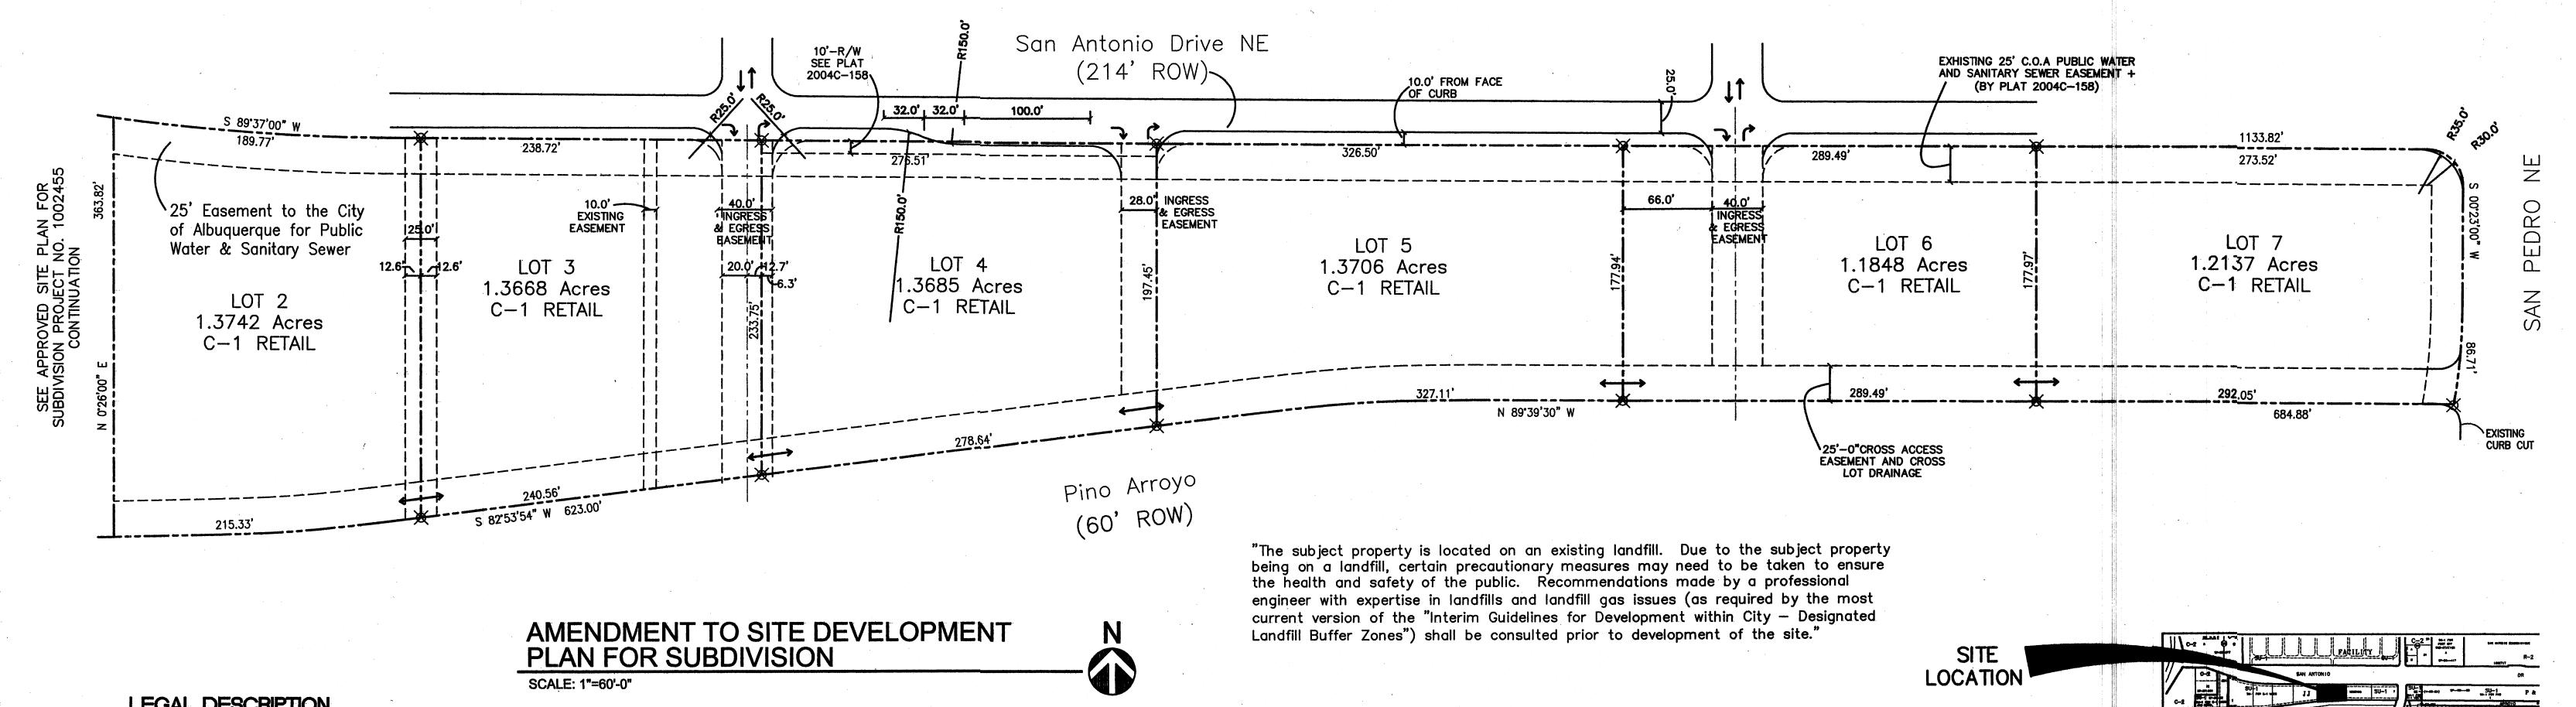

## LEGAL DESCRIPTION

LOTS 2 THRU 7 JJ SUBDIVISION BEING A REPLAT OF TRACT A-3-B, J GROUP ADDITION, TRACT 1, NEW HEART CENTER & TRACT 1, NORTHSIDE SUBDIVISION

WITHIN PROJECTED SECTION 25 TOWNSHIP 11 NORTH, RANGE 3 EAST NEW MEXICO PRINCIPAL MERIDIAN

> CITY OF ALBUQUERQUE BERNALILLO COUNTY NEW MEXICO

## NOTES: LOTS 2 THRU 7

BUILDING HEIGHT NOT TO EXCEED 34 FT. MAXIMUM FLOOR-AREA RATION: 20.0% **BUILDING MINIMUM SETBACKS:** FRONT: 25.0 FT

SIDE: 5.0 FT REAR: 5.0 FT

## TRAFFIC FLOW NOTES

-TWO WAY INGRESS AND EGRESS TRAFFIC FLOW



-RIGHT TURN ONLY INTO LOT



-RIGHT TURN ONLY OUT OF LOT



-TWO WAY INTERIOR AND CROSS-LOT TRAFFIC FLOW


## GENERAL DESIGN CRITERIA:

- 1. ALL STRUCTURES ON LOTS WILL BE LIMITED TO THE GENERAL CRITERIA DESCRIBED HEREIN. 2. DESIGN OF BUILDING SHALL BE A COMPATIBLE STYLE, MATERIALS AND COLORS THROUGHOUT LOTS 2-7.
- 3. PARKING WILL NOT EXCEED THE REQUIRED PLUS 10%.
- 4. ACCESSIBLE (ADA) COMPLIANT PARKING WILL BE LOCATED ADJACENT TO THE MAIN BUILDING ENTRY. AND REQUIRED PARKING SHALL BE DISTRIBUTED ON AT LEAST TWO SIDES OF A BUILDING.
- 5. ALL SIDEWALKS WILL HAVE A MINIMUM OF 6 FEET CLEAN WALKWAY AREA PROTECTED BY PERMANENT CAR STOPS.
- 7. ALL STRUCTURES SHALL BE CONNECTED BY PEDESTRIAN PATHWAYS PER CITY OF ALBUQUERQUE (COA) REQUIREMENTS AND THRU VEHICULAR AREAS.

6. FRONT ENTRY SIDEWALK AREAS WILL BE COVERED OR SHADED BY TREES.

- 8. PATIO AREAS FOR EMPLOYEES WILL BE PROVIDED AND SHADED.
- 9. BICYCLE RACKS WILL BE PROVIDED PER COA CODE. 10. ALL LANDSCAPING WILL BE PER COA CODE. NO GREATER THAT 20% OF LANDSCAPED AREA WILL BE LOW WATER USE AND ALL APPLICABLE WATER CONSERVATIONS MEASURES REQUIRED AT THE TIME OF BUILDING PERMIT APPLICATION WILL BE ADHERED TO. 80% MINIMUM GROUND COVERAGE WITH LOW WATER USE OF NATIVE PLANTS.
- 11. SCREEN WALLS WILL NOT TO EXCEED 3'-4" HIGH, AND SHALL MATCH STUCCO COLOR OF BUILDINGS.
- 12. ALL ROOF TOP OR GROUND LEVEL MECHANICAL UNITS WILL BE PHYSICALLY SCREENED FROM VIEW OR PAINTED TO BLEND WITH SURROUNDING STRUCTURE'S COLOR. ALL ROOF PENETRATIONS WILL MATCH STRUCTURE OR ROOF COLOR.
- 13. FRONT FACADES WILL BE SHADED BY EITHER THE BUILDING STRUCTURE, CANOPIES, PORTALS, AWNINGS, OR SHADE TRESS PLANTED IN A MANNER TO SHADE THERE ENTIRE FRONT FACADE OF THE STRUCTURE.
- 14. LOADING DOCKS SHALL BE SCREENED BY WALLS, TREES, AND OR STRUCTURE ELEMENTS THAT ARE ARCHITECTURALLY INTEGRATED INTO THE STRUCTURE.
- 15. ALL REFUSE ENCLOSURES WILL COMPLY WITH COA CODE AND SOLID WASTE REGULATIONS. 16. MONUMENT SIGNS ARCHITECTURALLY INTEGRATED WITH THE STRUCTURE DESIGN WILL NOT
- EXCEED 10 FEET HIGH OR 75 SQUARE FEET PER SIGN. 17. BUILDING SIGNS SHALL NOT EXCEED 6% OF THE FACADE AREA.
- 18. SITE AND BUILDING LIGHTING WILL COMPLY WITH COA CODES AND REGULATIONS, FULLY SHIELDED. ONE DESIGN TYPE, FOOTING SHALL MATCH STUCCO COLOR, AND 18'-0" HIGH MAXIMUM.
- 19. 3'-0" HIGH BOLLARD ILLUMINATION (AT LEAST ONE) AT CURB RAMPS ENTERING A CROSSWALK, BE ONE DESIGN TYPE, FULLY SHIELDED.
- 20. ALL CROSSWALKS TO BE TEXTURED WITH COLORED CONCRETE OR BRICK PAVING.

PROJECT NUMBER: 1002455 APPLICATION NUMER: THIS PLAN IS CONSISTENT WITH THE SPECIFIC SITE DEVELOPMENT PLAN APPROVED BY THE ENVIRONMENTAL PLANNING COMMISSION (EPC) DATE FINDING S AN CONDITIONS IN THE OFFICIAL NOTIFICATION OF DECISION ARE SATISFIED. DRB SITE DEVELOPMENT PLAN SIGNOFF APPROVAL: TRAFFIC ENGINEERING, TRANSPORTATION DIVISION DATE DATE UTILITITES DEVELOPMENT DATE PARKS AND RECREATIONAL DEPARTMENT DATE CITY ENGINEER ENVIRONMENTAL HEALTH DEPARTMENT DATE DATE SOLID WASTE MANAGEMENT DATE DRB/CHAIRPERSON, PLANNING DEPARTMENT **GRAPHIC SCALE** 

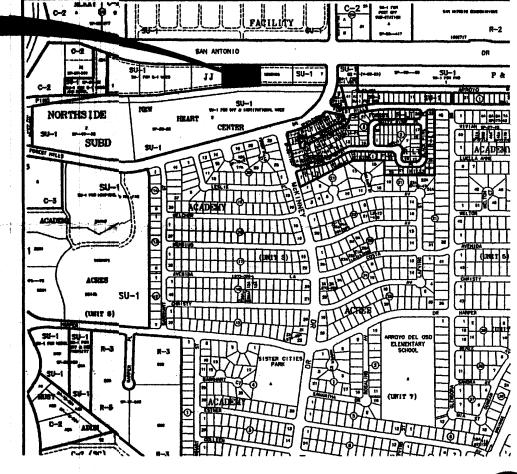

**LOCATION MAP** ZONE ATLAS: E-18-Z



AMENDMENT TO SITE DEVELOPMENT PLAN FOR SUBDIVISION


1"=60'-0"

AFRA Construction & Design 2501 Yale Blvd. Suite 102 Albuquerque, New Mexico 87106 Tel 505.998.3128 Tel 505.998.3129


SAN ANTONIO OFFICE & RETAIL ALBUQUERQUE, NM

DATE APVD DESCRIPTION

SD-1 6.2.08

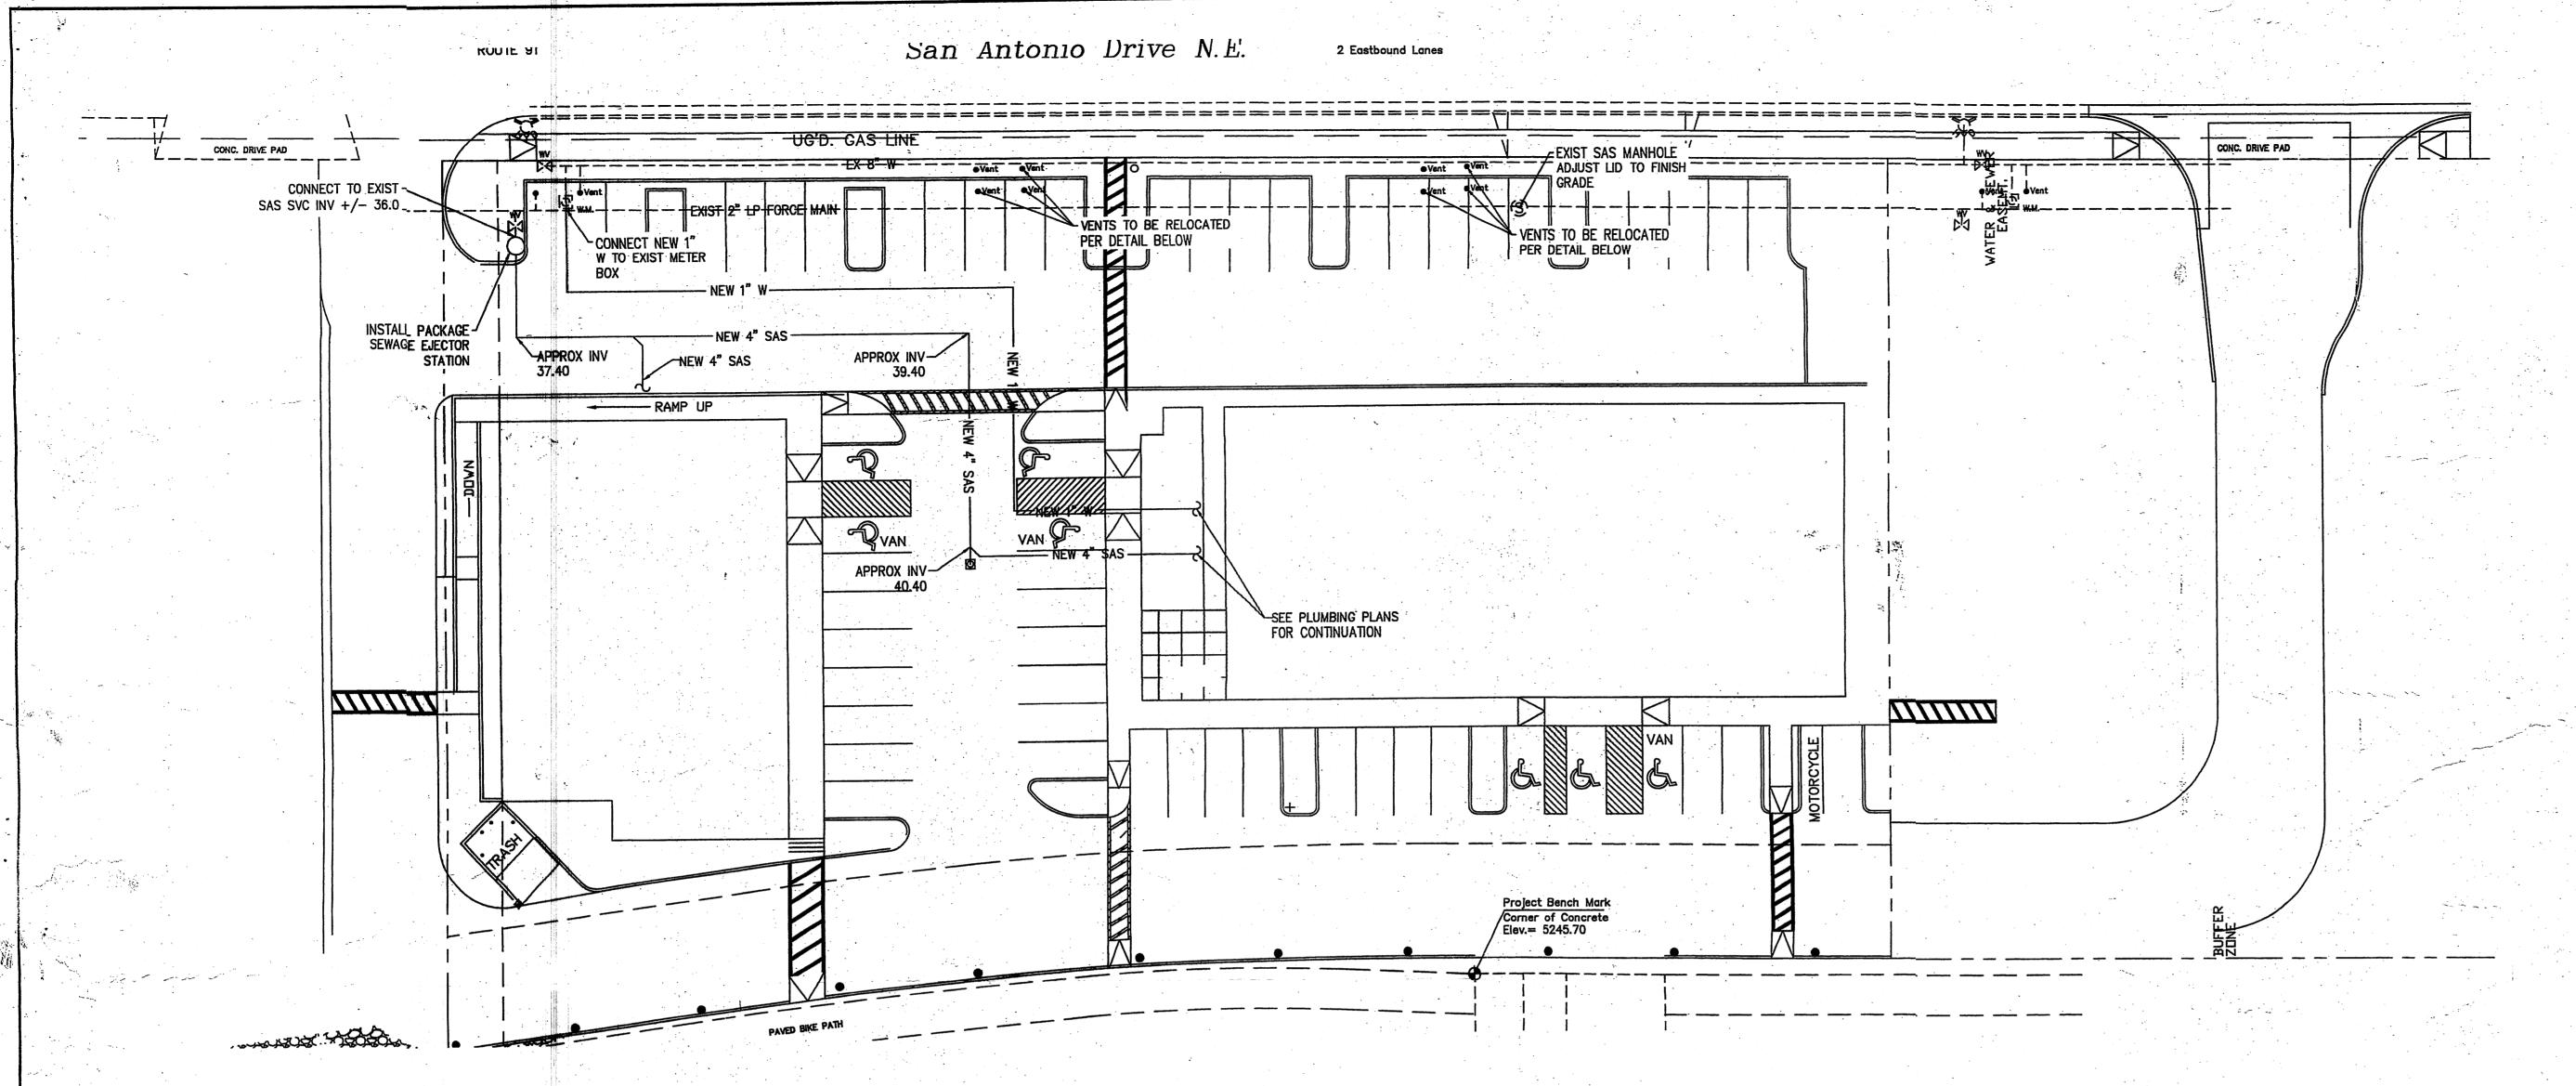

WATER AND SEWER PLAN

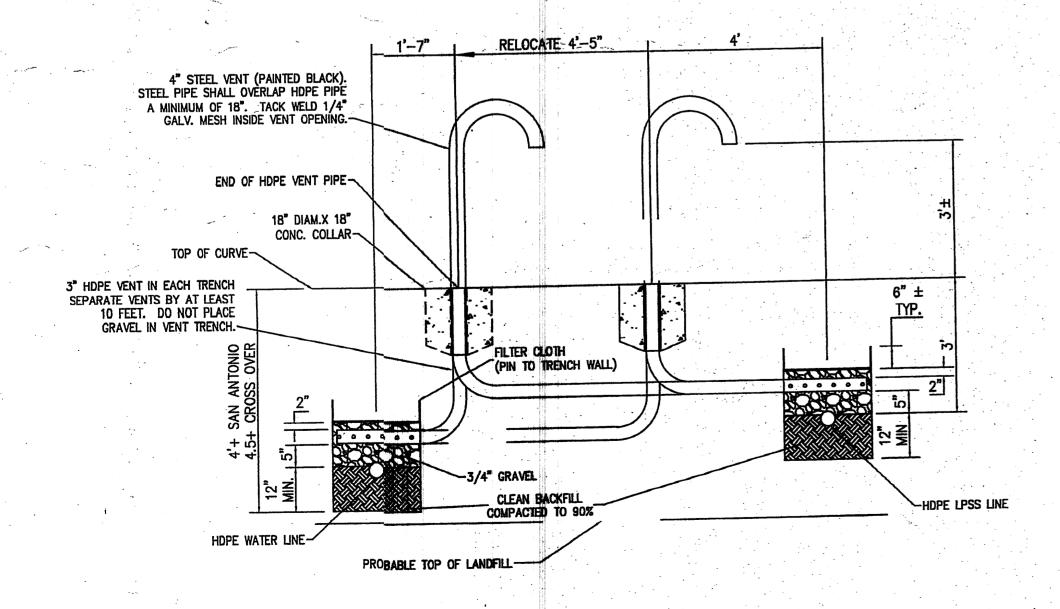

#### NOTES:

- 1. APPROXIMATE DEPTH TO TOP OF LANDFILL MATERIAL IS 5'.
- 2. ALL TRENCHES SHALL BE APPROX. 2' WIDE AT THE TOP OF PIPE.
- 3. ALL TRENCHES SHALL BE EXCAVATED TO A DEPTH OF ONE FOOT BELOW BOTTOM OF PIPE. THE CONTRACTOR SHALL MAINTAIN THE FULL DEPTH OF TRENCH UNTIL THE ENGINEER HAS INSPECTED THE TRENCH BOTTOM AND RECORDED FINDINGS. THE MAXIMUM LENGTH OF OPEN TRENCH IN EXCESS OF THREE FEET IN DEPTH SHALL BE THREE HUNDERD FEET.
- 4. BACKFILL AND VENTING FOR ALL TRENCHES SHALL BE AS SHOWN ABOVE. GRAVEL BACKFILL AND FILTER CLOTH SHALL BE CONTINUOUS ALONG PIPE. VENT PIPES IN EACH TRENCH SHALL BE LOCATED APPROXIMATELY AS SHOWN.
- 5. HORIZONTAL PORTION OF VENT PIPE SHALL BE PERFORATED (1/2" HOLES)
  WITHIN TRENCH PRISM AND SOLID WALLED BETWEEN TRENCHES. PERFORATIONS
  SHALL BE AT 90° LOCATIONS AND STAGGERED AT 4" SPACING ALONG PIPE.
- 6. 3/4" GRAVEL SHALL BE CLEAN, UNCRUSHED, RIVER RUN STONE (NON-LIMESTONE). FILTER CLOTH SHALL BE MIRAFI 140N OR APPROVED EQUAL AND SHALL CONTINUOUSLY PINNED TO TRENCH WALLS.

LARRY READ & ASSOCIATES, Inc.

Civil Engineers

2430 Midtown Place NE Suite C
Albuquerque, New Mexico 87107
(505) 237-8421

## WATER AND SEWER PLAN

AFRA Construction & Design 7004 Avenida La Costa NE Albuquerque, New Mexico 87109 Tel 505.315.1482

# SAN ANTONIO OFFICE-RETAIL ALBUQUERQUE, NM

REV DATE

1			
2	-	-	
3		·	
4			<u> </u>

DESCRIPTION

APVD

1 LANDFILL VENT RELOCATIONS DETAIL