

**PROJECT DATA**

**ZONING**  
SU-2  
**YARD STANDARDS:**  
FY = 30' MAXIMUM  
RY = 5'  
SY = 5'  
SY ABUTTING A SIDE STREET = 5' + 40' R.O.W.

**OCCUPANCY**  
GROUP B - BUSINESS  
**CONSTRUCTION**  
TYPE II-B  
**FIRE PROTECTION**  
TYPE II-B, UNPROTECTED, UNSPRINKLERED  
**PARTY & FIRE WALLS:** N/A  
**INTERIOR WALLS:** 0  
**TENANT SEPARATION:** N/A  
**UTILITY SHAFTS:** N/A  
**COLUMNS:** N/A  
**FLOOR/CEILING:** N/A  
**ROOF/CEILING:** N/A  
**EXTERIOR WALLS:** N/A  
**LANDSCAPING**  
REF. LANDSCAPE DRAWINGS  
**LAND AREA**  
70,279 SF = 1.613 ACRES  
**BUILDING AREA**  
BUILDING = 3,500 SQ. FT.  
**PARKING**  
BUSINESS PARKING SPACES  
3,500 SF/200 = 18 SP REQUIRED  
3,500 SF/200 = 24 SP PROVIDED  
**HANDICAP SPACES**  
= 1 SP REQUIRED  
1 SP VAN ACCESSIBLE SP PROVIDED

**PROJECT TEAM**

**PROPERTY OWNER:**  
BANK OF OKLAHOMA FINANCIAL CORPORATION  
BTC 3 SOUTH  
P.O. BOX 2300  
TULSA, OK 74192  
PHONE (918) 619-1286

**ARCHITECT:**  
BECK DESIGN  
120 N. ROBINSON, SUITE 2800  
FIRST NATIONAL CENTER  
OKLAHOMA CITY, OK 73102  
PHONE: (405) 232-7007  
FAX: (405) 232-7029

**ARCHITECT OF RECORD/CIVIL:**  
CLAUDIO MOL ARCHITECTS  
1801 RO GRANDE BLVD., N.W.  
ALBUQUERQUE, NM 87104  
PHONE (505) 842-1113  
FAX: (505) 842-1330

**LANDSCAPE:**  
CONSENSUS PLANNING  
302 EIGHTH STREET, N.W.  
ALBUQUERQUE, NM 87102  
PHONE: (505) 764-9801  
FAX: (505) 842-5495

**PUBLIC IMPROVEMENTS**  
D. MARK GOODWIN & ASSOCIATES, P.A.  
P.O. BOX 90808  
ALBUQUERQUE, NM 87199  
PHONE: (505) 828-2200  
FAX: (505) 797-9539



**SURVEY/PLAT**  
SURVEYS SOUTHWEST LTD  
333 LOMAS BOULEVARD, N.E.  
ALBUQUERQUE, NM 87102-2449  
PHONE: (505) 998-0303  
FAX: (505) 998-0306

**PROJECT DESCRIPTION**

SINGLE STORY STONE AND METAL FRAME PROTOTYPE BANK BUILDING. APPROXIMATELY 3,500 SF.

**SITE SYMBOLS LEGEND**

- - TRAFFIC SIGNAL BOX
- - TRAFFIC SIGNAL
- - POWER POLE
- - OVERHEAD UTILITY LINE
- - UNDERGROUND SEWER LINE
- - UNDERGROUND WATER LINE
- - SEWER MANHOLE
- - DRAINAGE MANHOLE
- ⊕ - WATER VALVE
- - ELECTRIC RISER

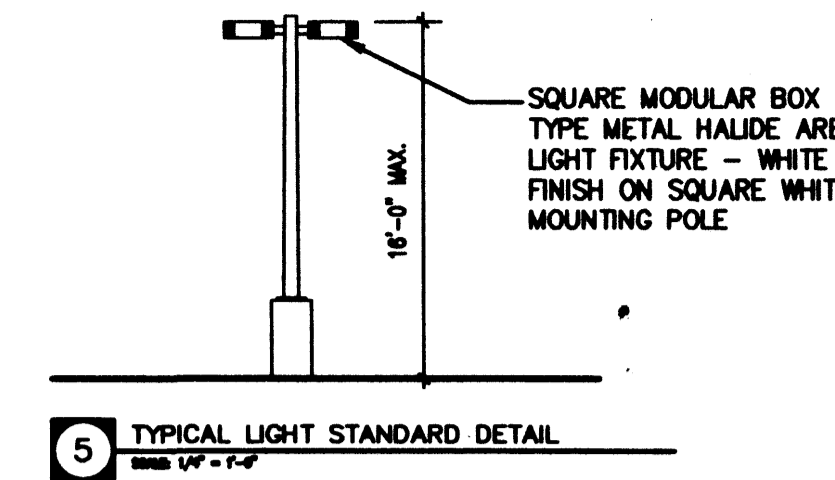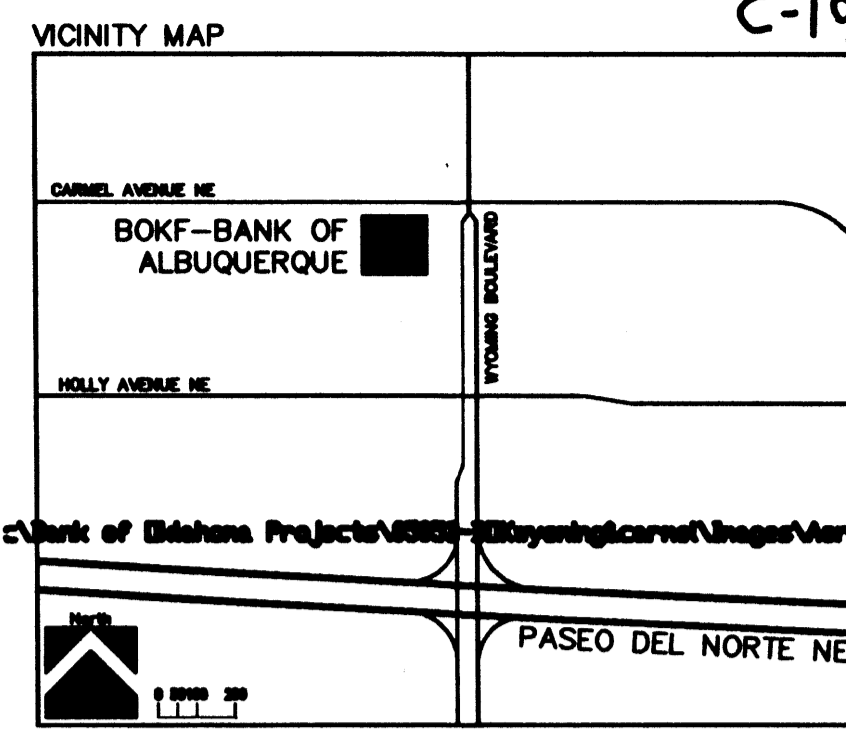

SITE LIGHTING SHALL BE LOCATED SO AS NOT TO GLARE ON TO ADJACENT SITES. LIGHTS SHALL BE LOCATED ON THE SITE AND THE BUILDING.

LIGHT SHALL NOT GLARE ON TO ANY PUBLIC RIGHT-OF-WAY AND SHALL NOT HAVE AN OFF-SITE LUMINANCE GREATER THAN 100 FOOT LAMBERTS. ALL LIGHT FIXTURES SHALL BE FULL CUTOFF TYPE TO PREVENT FUGITIVE LIGHT. NO LIGHT SOURCE SHALL BE VISIBLE FROM THE SITE PERIMETER. ALL LAMPS MUST BE FULLY SHIELDED TO PREVENT FUGITIVE LIGHT BEYOND THE PROPERTY LINE.

SITE LIGHTING FOR PAD STRUCTURES IS TO MATCH THE SITE LIGHTING PROVIDED FOR THE MAIN PARKING AREA. EXPOSED, I.E. UNSHIELDED LIGHT FIXTURES ARE PROHIBITED. ALL LAMPS MUST BE SHIELDED SHOE BOX TYPE FIXTURES.

ALL LIGHTING TO COMPLY WITH THE NIGHT SKY PROTECTION ACT.

THE SUBJECT PROPERTY IS LOCATED NEAR A FORMER LANDFILL. DUE TO THE SUBJECT PROPERTY BEING NEAR A FORMER LANDFILL, CERTAIN PRECAUTIONARY MEASURES MAY NEED TO BE TAKEN TO ENSURE THE HEALTH AND SAFETY OF THE PUBLIC. RECOMMENDATIONS MADE BY A PROFESSIONAL ENGINEER WITH EXPERTISE IN LANDFILLS AND LANDFILL GAS ISSUES (AS REQUIRED BY THE MOST CURRENT VERSION OF THE INTERIM GUIDELINES OF DEVELOPMENT WITHIN CITY DESIGNATED LANDFILL BUFFER ZONES) SHALL BE CONSULTED PRIOR TO DEVELOPMENT OF THE SITE.

**SIGNATURE BLOCK**

PROJECT NUMBER: 1002458  
APPLICATION CASE NUMBER: 06-00926

THIS PLAN IS CONSISTENT WITH THE SPECIFIC SITE DEVELOPMENT PLAN APPROVED BY THE ENVIRONMENTAL PLANNING COMMISSION (EPC), DATED 05/18/06, AND THE FINDINGS AND CONDITIONS IN THE OFFICIAL NOTIFICATION OF DECISION ARE SATISFIED.

IS AN INFRASTRUCTURE LIST REQUIRED? YES (X) NO IF YES, THEN A SET OF APPROVED DRG PLANS WITH A WORK ORDER IS REQUIRED FOR ANY CONSTRUCTION WITHIN PUBLIC RIGHT-OF-WAY OR FOR CONSTRUCTION OF PUBLIC IMPROVEMENTS

**DRG SITE DEVELOPMENT PLAN SIGNOFF APPROVAL:**

APPROVED: [Signature]	DATE: 10-10-06
APPROVED: [Signature]	DATE: 10-18-06
APPROVED: [Signature]	DATE: 10/18/06
APPROVED: [Signature]	DATE: 12/14/06
APPROVED: [Signature]	DATE: 10/16/06
APPROVED: [Signature]	DATE: 10/16/06
APPROVED: [Signature]	DATE: 12/14/06



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**PROJECT:**  
BANK OF ALBUQUERQUE

**WYOMING BLVD. & CARMEL ALBUQUERQUE, NM**

**PROJECT NUMBER:**  
05053

**CONSULTANT:**

**REVISIONS:**



**SEAL:**  
DESIGN DEVELOPMENT  
NOT FOR CONSTRUCTION

**ISSUE DATE:**  
27 SEPTEMBER 2006

**SHEET NUMBER:**

A101


SITE PLAN FOR BUILDING PERMIT

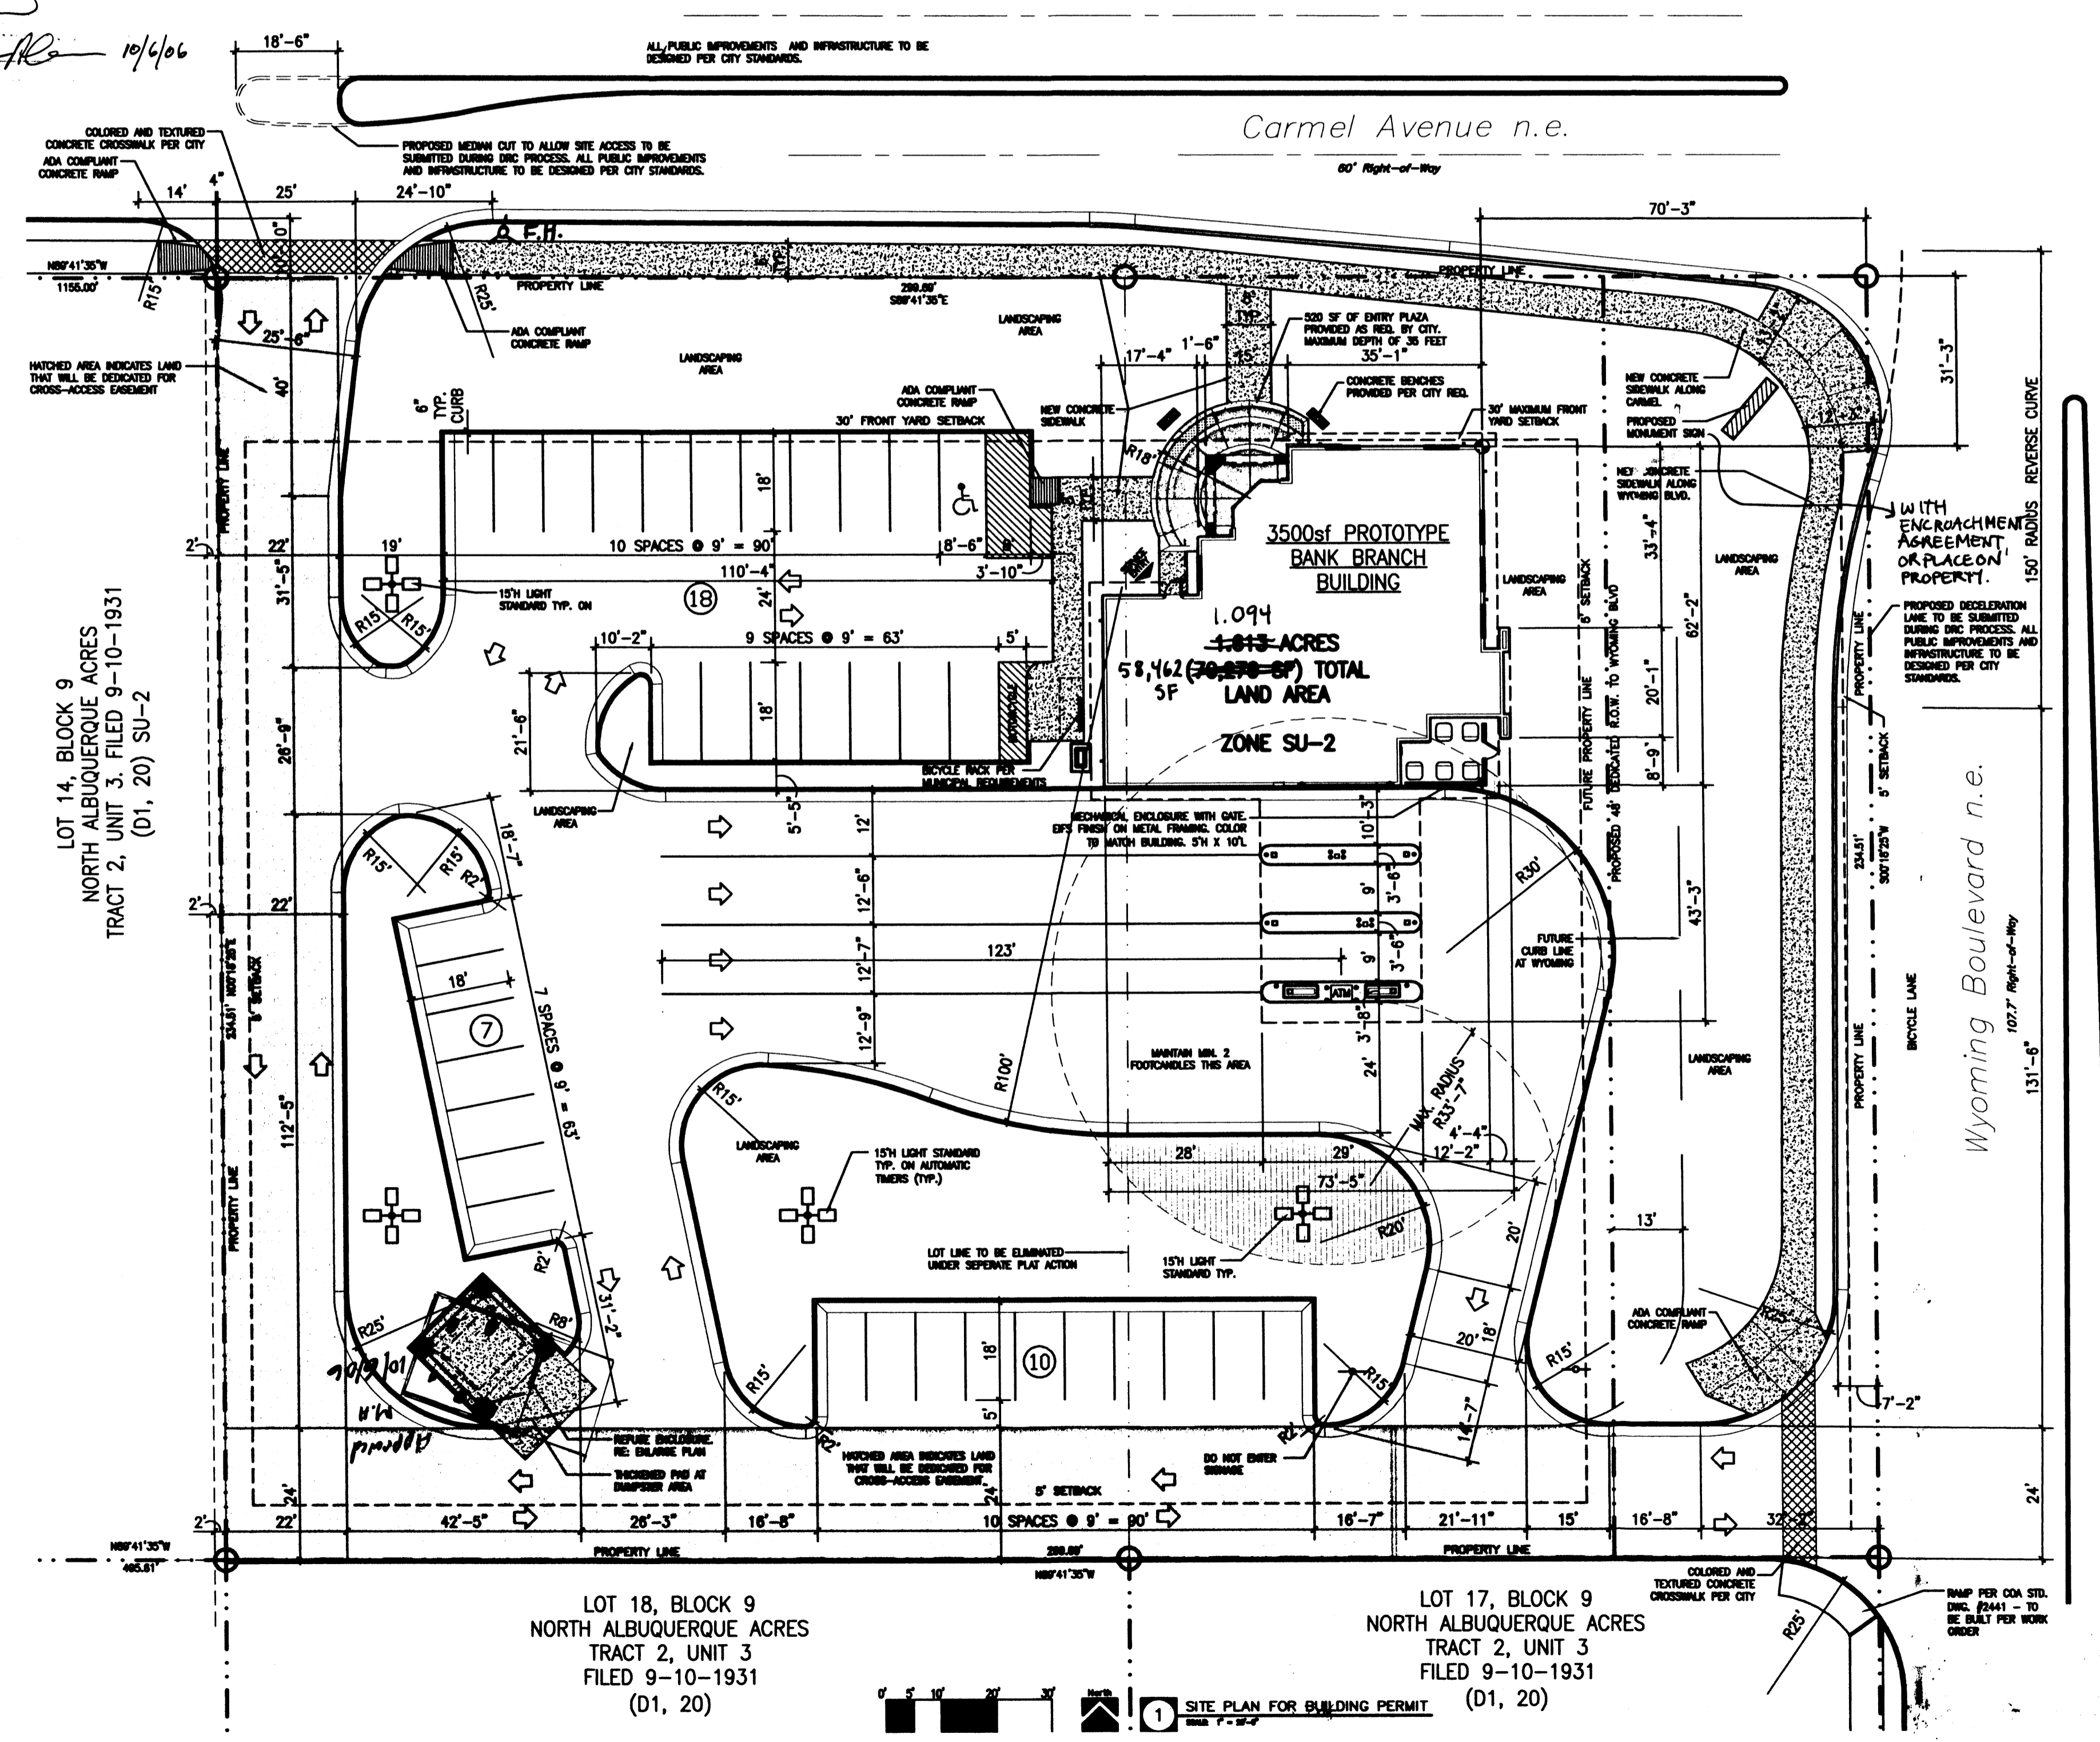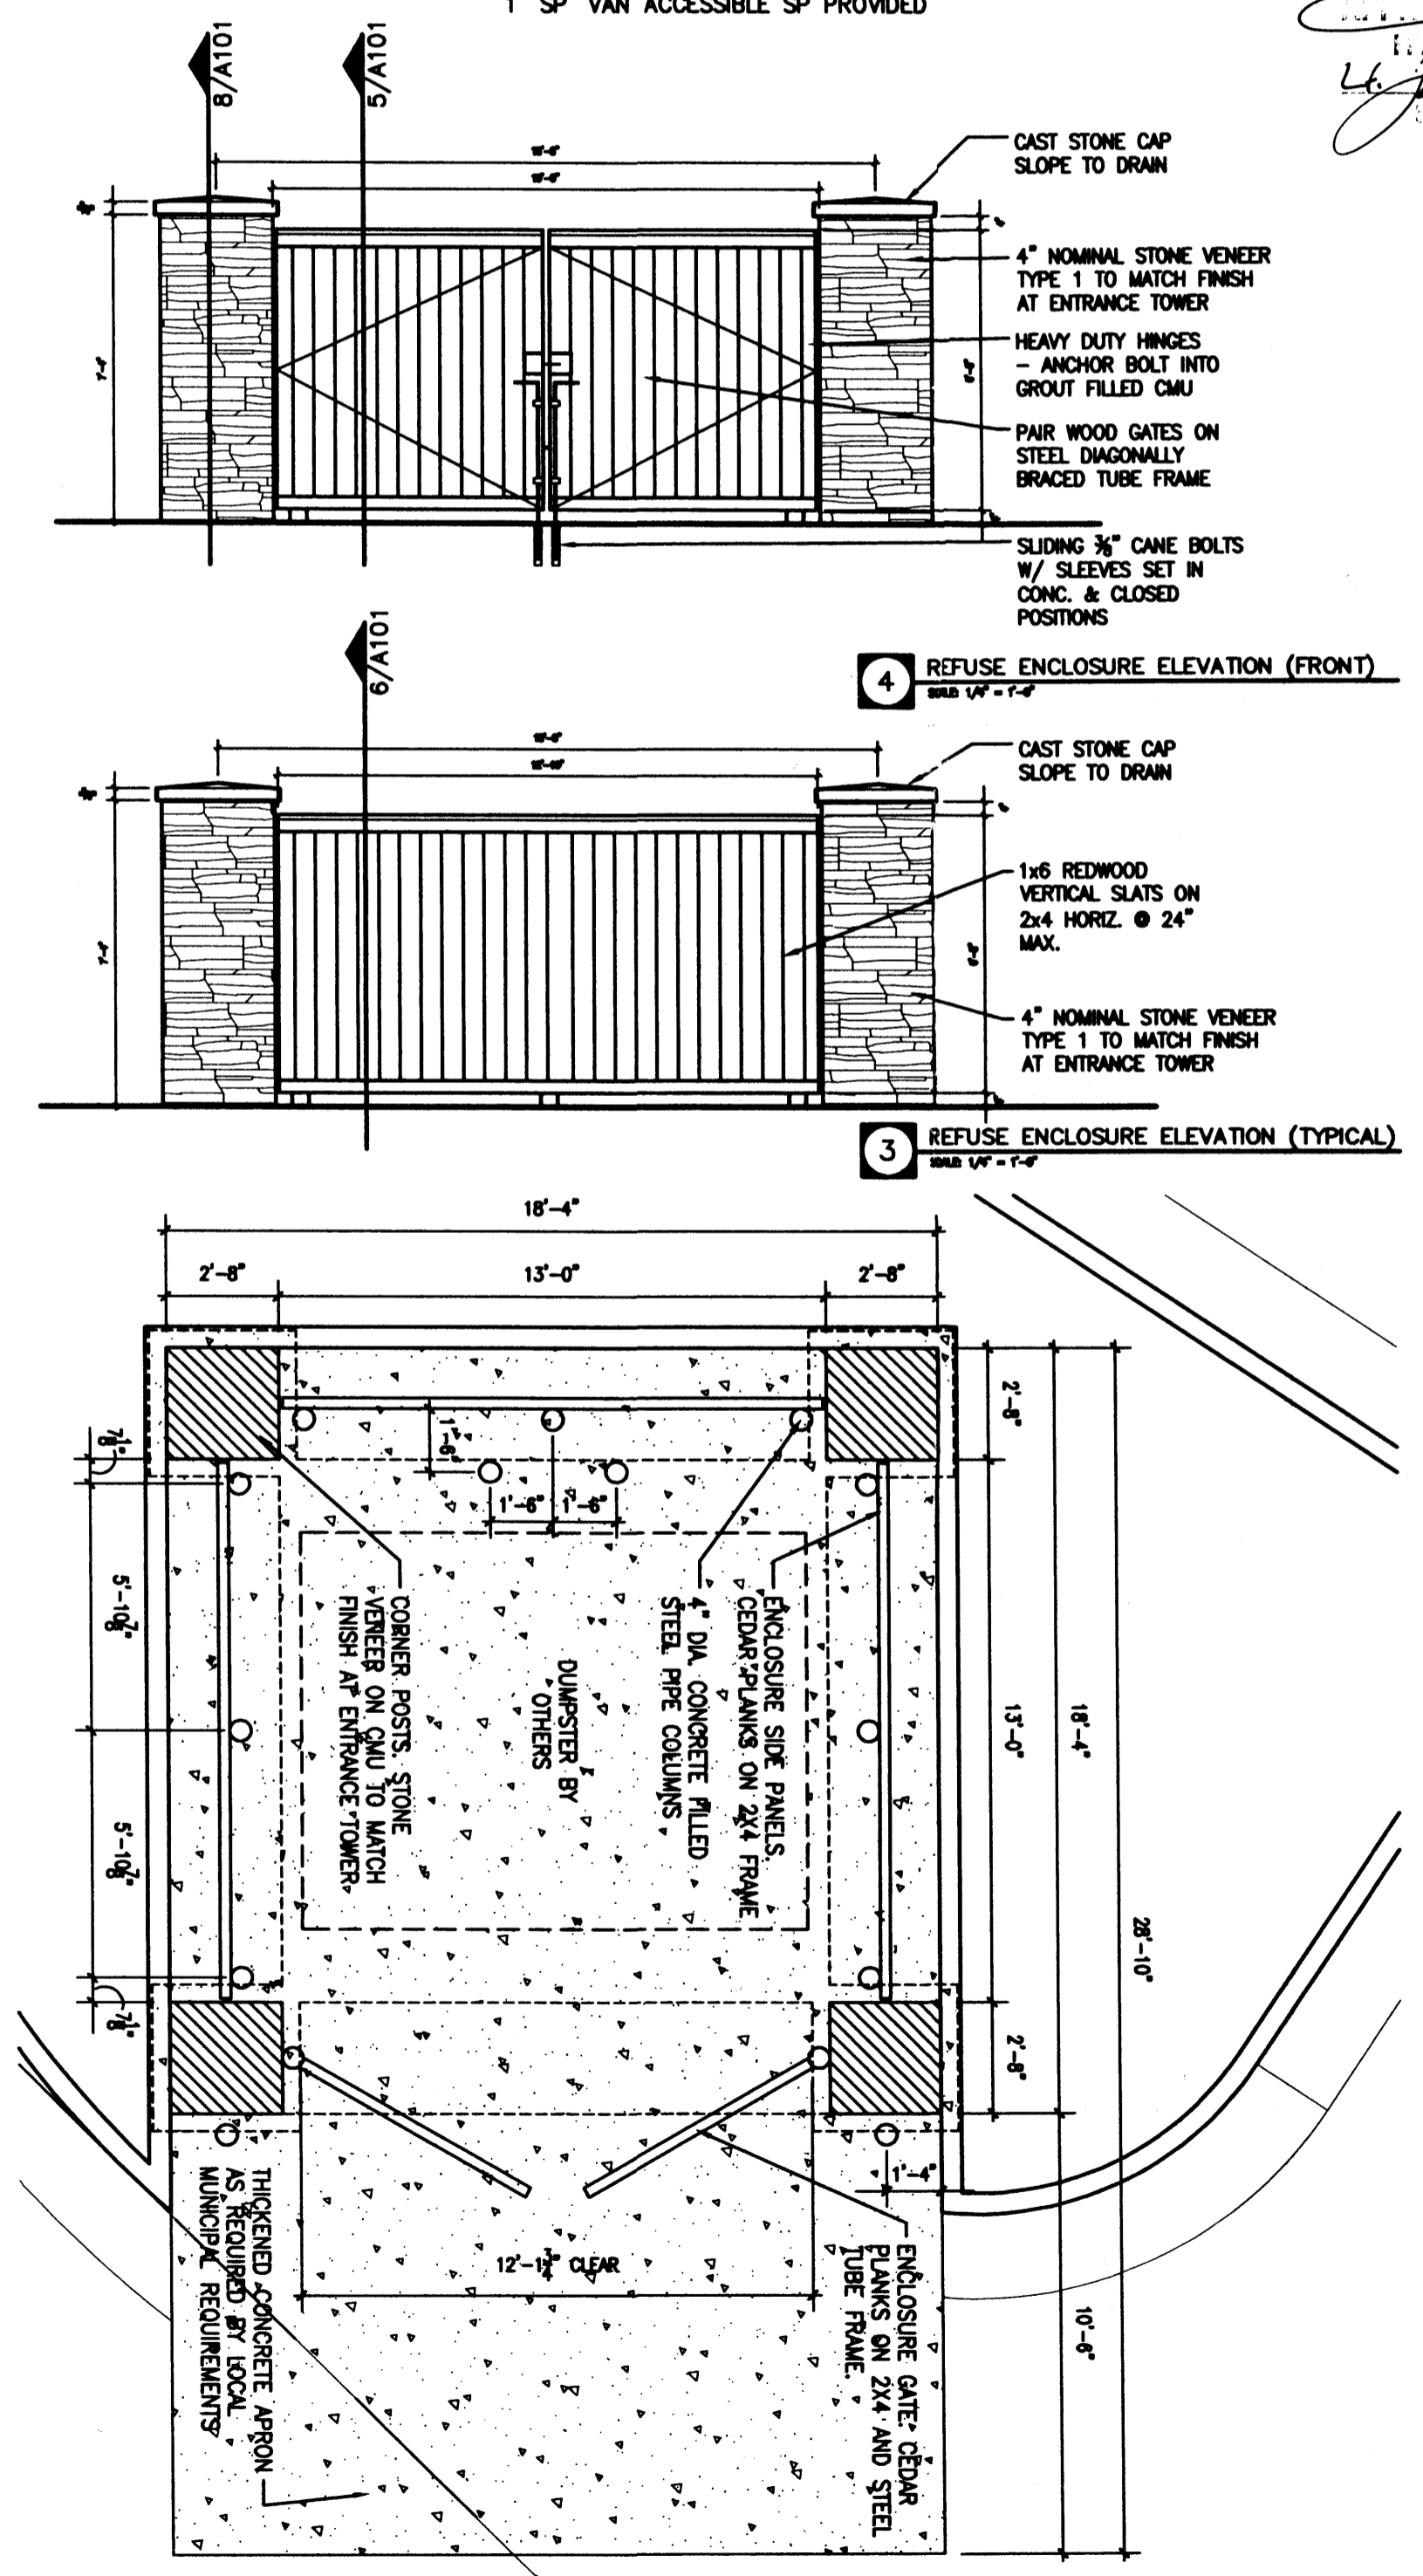

2 ENLARGED REFUSE ENCLOSURE PLAN

1 SITE PLAN FOR BUILDING PERMIT

PROJECT # 1002458

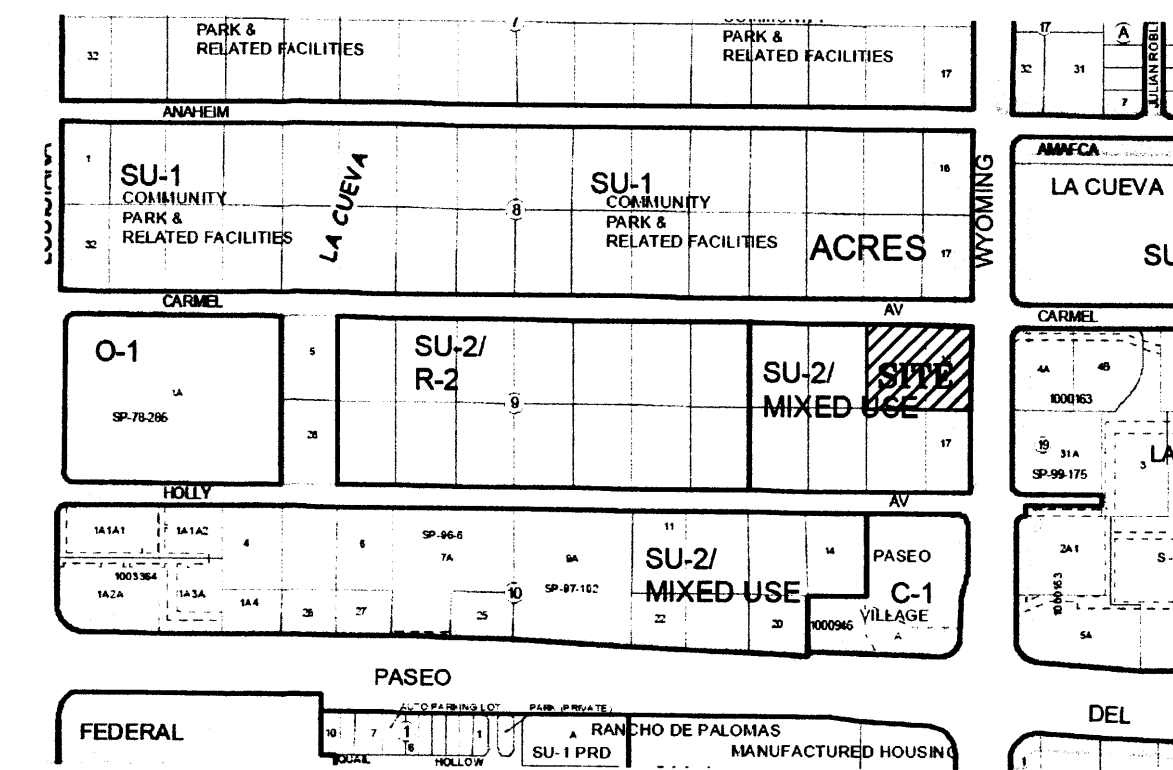

ADDRESS:  
 8400 EIRESPHNE ROAD  
 LEGAL DESCRIPTION:  
 LOTS 15 & 16, BLOCK 9, TRACT 2, UNIT 3 NORTH ALBUQUERQUE ACRES

**D-5 VICINITY MAP - C19**  
 SCALE: NONE  
 DRAINAGE PLAN

THE PROPOSED IMPROVEMENTS AS SHOWN BY THE VICINITY MAP, ARE LOCATED WEST OF WYOMING BOULEVARD NORTH OF PLASO DEL NORTE, ON THE SOUTH WEST CORNER OF THE INTERSECTION OF WYOMING BLVD. AND CARMEL AVE. THE SITE IS UNDEVELOPED AND SLOPES FROM EAST TO WEST AT AN APPROXIMATE SLOPE OF 4.0% PER MAP NO. 3500100137 E, THE SITE DOES NOT LIE WITHIN A FLOOD HAZARD ZONE. THE SITE IS HIGHER THAN THE LANDS TO THE WEST. THE LANDS TO THE NORTH AND SOUTH SLOPE FROM WEST TO EAST. THE EXISTING CURB AND GUTTER ALONG WYOMING BLVD. TO THE EAST BLOCKS FLOWS FROM THAT DIRECTION THEREFORE OFFSITE FLOWS ARE CONSIDERED INSIGNIFICANT.

THE PROPOSED SITE LIES WITHIN THE NORTH ALBUQUERQUE ACRES SUBDIVISION. THE PROPOSED IMPROVEMENTS CONSIST OF A NEW BANK BUILDING WITH ASSOCIATED PARKING AND LANDSCAPING. AS SHOWN BY THE CALCULATION THE PROPOSED DEVELOPMENT WILL INCREASE THE RATE AND VOLUME OF RUNOFF. THE PROPOSED RATE OF DISCHARGE IS 6.6 CFS (4.1 CFS/ACRE). THE DEVELOPED RUNOFF FROM THE SITE ARE TO BE DIRECTED TO THE PROPOSED DRIVE ENTRANCE ON CARMEL AVE. NO PONDING IS ANTICIPATED FOR THE SITE.

THE CALCULATIONS ANALYZE THE EXISTING AND PROPOSED CONDITIONS FOR 6-HOUR, 100 YEAR RAINFALL EVENT. THE ANALYSIS IS IN ACCORDANCE WITH THE CITY OF ALBUQUERQUE DEVELOPMENT PROCESS MANUAL VOLUME II.

CALCULATIONS  
 PRECIPITATION ZONE = 3  
 TOTAL SITE AREA = 1.613 ACRES  
 EXISTING CONDITIONS  
 LAND TREATMENT A=100%  
 $E = 0.66(1.00) = 0.66$  INCHES  
 $V = 0.66(1.613) / 12 = 0.089$  ACRE FEET  
 $Q = 1.87(1.00)(1.613) = 3.0$  CFS  
 DEVELOPED CONDITIONS  
 LAND TREATMENT B=44% D=56%  
 $E = 0.912(0.44) + 2.36(0.56) = 1.73$  INCHES  
 $V = 1.73(1.613) / 12 = 0.233$  ACRE FEET  
 $Q = [2.60(0.44) + 5.25(0.56)](1.613) = 6.6$  CFS  
 $Q = 6.6/1.613 = 4.1$  CFS/ACRE  
 INCREASE IN VOLUME OF RUNOFF = 0.144 AC FT  
 INCREASE IN RATE OF RUNOFF = 3.6 CFS

CONSTRUCTION NOTES

- TWO WORKING DAYS PRIOR TO ANY EXCAVATION, THE CONTRACTOR SHALL CALL FOR LOCATION OF EXISTING UTILITIES.
- ALL WORK WITHIN THE CITY RIGHT-OF-WAY SHALL BE PERFORMED IN ACCORDANCE WITH THE APPLICABLE CITY OF ALBUQUERQUE STANDARDS AND PROCEDURES.
- ALL WORK SHALL BE PERFORMED IN ACCORDANCE WITH THE APPLICABLE FEDERAL, STATE, AND LOCAL REGULATIONS, LAWS, AND RULES CONCERNING SAFETY AND HEALTH.
- PRIOR TO CONSTRUCTION THE CONTRACTOR SHALL VERIFY THE EXISTING SITE CONDITIONS AND INFORM THE ARCHITECT/ENGINEER OF ANY DISCREPANCY BETWEEN THE INFORMATION SHOWN ON THE PLANS AND THOSE OF THE EXISTING SITE.
- THE CONTRACTOR SHALL PROVIDE THE ARCHITECT/ENGINEER WITH AN AS BUILT SURVEY FOR ENGINEER'S CERTIFICATION.
- THE CONTRACTOR SHALL MAINTAIN A RECORD DRAWING SET OF PLANS AND PROMPTLY LOCATE EXISTING AND NEW ELEVATIONS (FINISH FLOORS, TOPS OF CURBS AND ASPHALT, FLOW LINE, PIPE INVERTS, ETC.), ON THE RECORD SET SHALL BE MAINTAINED ON THE PROJECT SITE AND SHALL BE AVAILABLE TO THE OWNER AND ARCHITECT AT ANY TIME DURING CONSTRUCTION. UPON COMPLETION OF THE PROJECT, THE RECORD SET SHALL BE TURNED OVER TO THE OWNER.
- THE OWNER/CONTRACTOR SHALL SUBMIT A NOTICE OF INTENT (NOI) TO THE EPA PRIOR TO BEGINNING OF CONSTRUCTION.
- CONTRACTOR SHALL COMPLY WITH STORM WATER POLLUTION PREVENTION PLAN (SWPPP) SPECIFIC TO THIS PROJECT.
- ALL POND BOTTOMS SHALL RECEIVE GRAVEL AND FILTER FABRIC SEE LANDSCAPE PLAN.
- THE BASIS OF ELEVATIONS FOR THIS SURVEY IS ACS BENCHMARK HEAVEN, THE PUBLISHED ELEVATION OF WHICH IS 5378.26. BENCHMARK IS LOCATED AT THE ENTRANCE TO GATE OF HEAVEN CEMETARY ON THE SOUTH SIDE OF PASEO DEL NORTE, JUST WEST OF WYOMING BOULEVARD.


FACILITY ACCESSIBILITY  
 ALL SURFACES ALONG THE ACCESSIBLE ROUTE SHALL COMPLY WITH ANSI A117-1998.

WALKING SURFACES SHALL BE STABLE, FIRM, AND SLIP RESISTANT. THE RUNNING SLOPE OF WALKING SURFACES SHALL NOT BE STEEPER THAN 1:20 WITH A CROSS SLOPE NOT STEEPER THAN 1:48.

CURB RAMP AND RAMP RUNS SHALL HAVE A RUNNING SLOPE NOT STEEPER THAN 1:12 WITH A CROSS SLOPE NOT STEEPER THAN 1:48. COUNTER SLOPES OF ADJOINING GUTTERS AND ROAD SURFACES IMMEDIATELY ADJACENT TO THE CURB RAMP OR ACCESSIBLE ROUTE SHALL NOT BE STEEPER THAN 1:20. TRANSITIONS FROM RAMP TO WALKS, GUTTERS OR STREETS SHALL BE AT THE SAME LEVEL. WHERE PEDESTRIANS MUST WALK ACROSS A CURB RAMP, THE RAMP SHALL HAVE FLARED SIDES WITH SLOPES NOT STEEPER THAN 1:10. WHERE THE TOP OF THE RAMP PARALLEL TO THE RUN OF THE RAMP IS LESS THAN 48 INCHES WIDE, THE FLARED SIDES SHALL HAVE A SLOPE NOT STEEPER THAN 1:12.

HANDICAP PARKING SPACES AND ACCESS AISLES SHALL HAVE SURFACE SLOPES NOT STEEPER THAN 1:48. ACCESS AISLES SHALL BE AT THE SAME LEVEL AS THE PARKING SPACES THEY SERVE.

THE CONTRACTOR SHALL PROVIDE ALL REQUIRED TRAFFIC CONTROL PLANS AND DEVICES. ALL SIGNS, BARRICADES, CHANNELIZATION DEVICES, SIGN FRAMES AND ERECTION OF SUCH DEVICES SHALL CONFORM TO THE REQUIREMENTS OF THE "MANUAL OF UNIFORM TRAFFIC CONTROL DEVICES FOR STREETS AND HIGHWAYS" LATEST EDITION. PRIOR TO CONSTRUCTION PRIOR TO CONSTRUCTION, THE TRAFFIC CONTROL PLAN SHALL BE SUBMITTED AND APPROVED BY THE GOVERNING AUTHORITY.

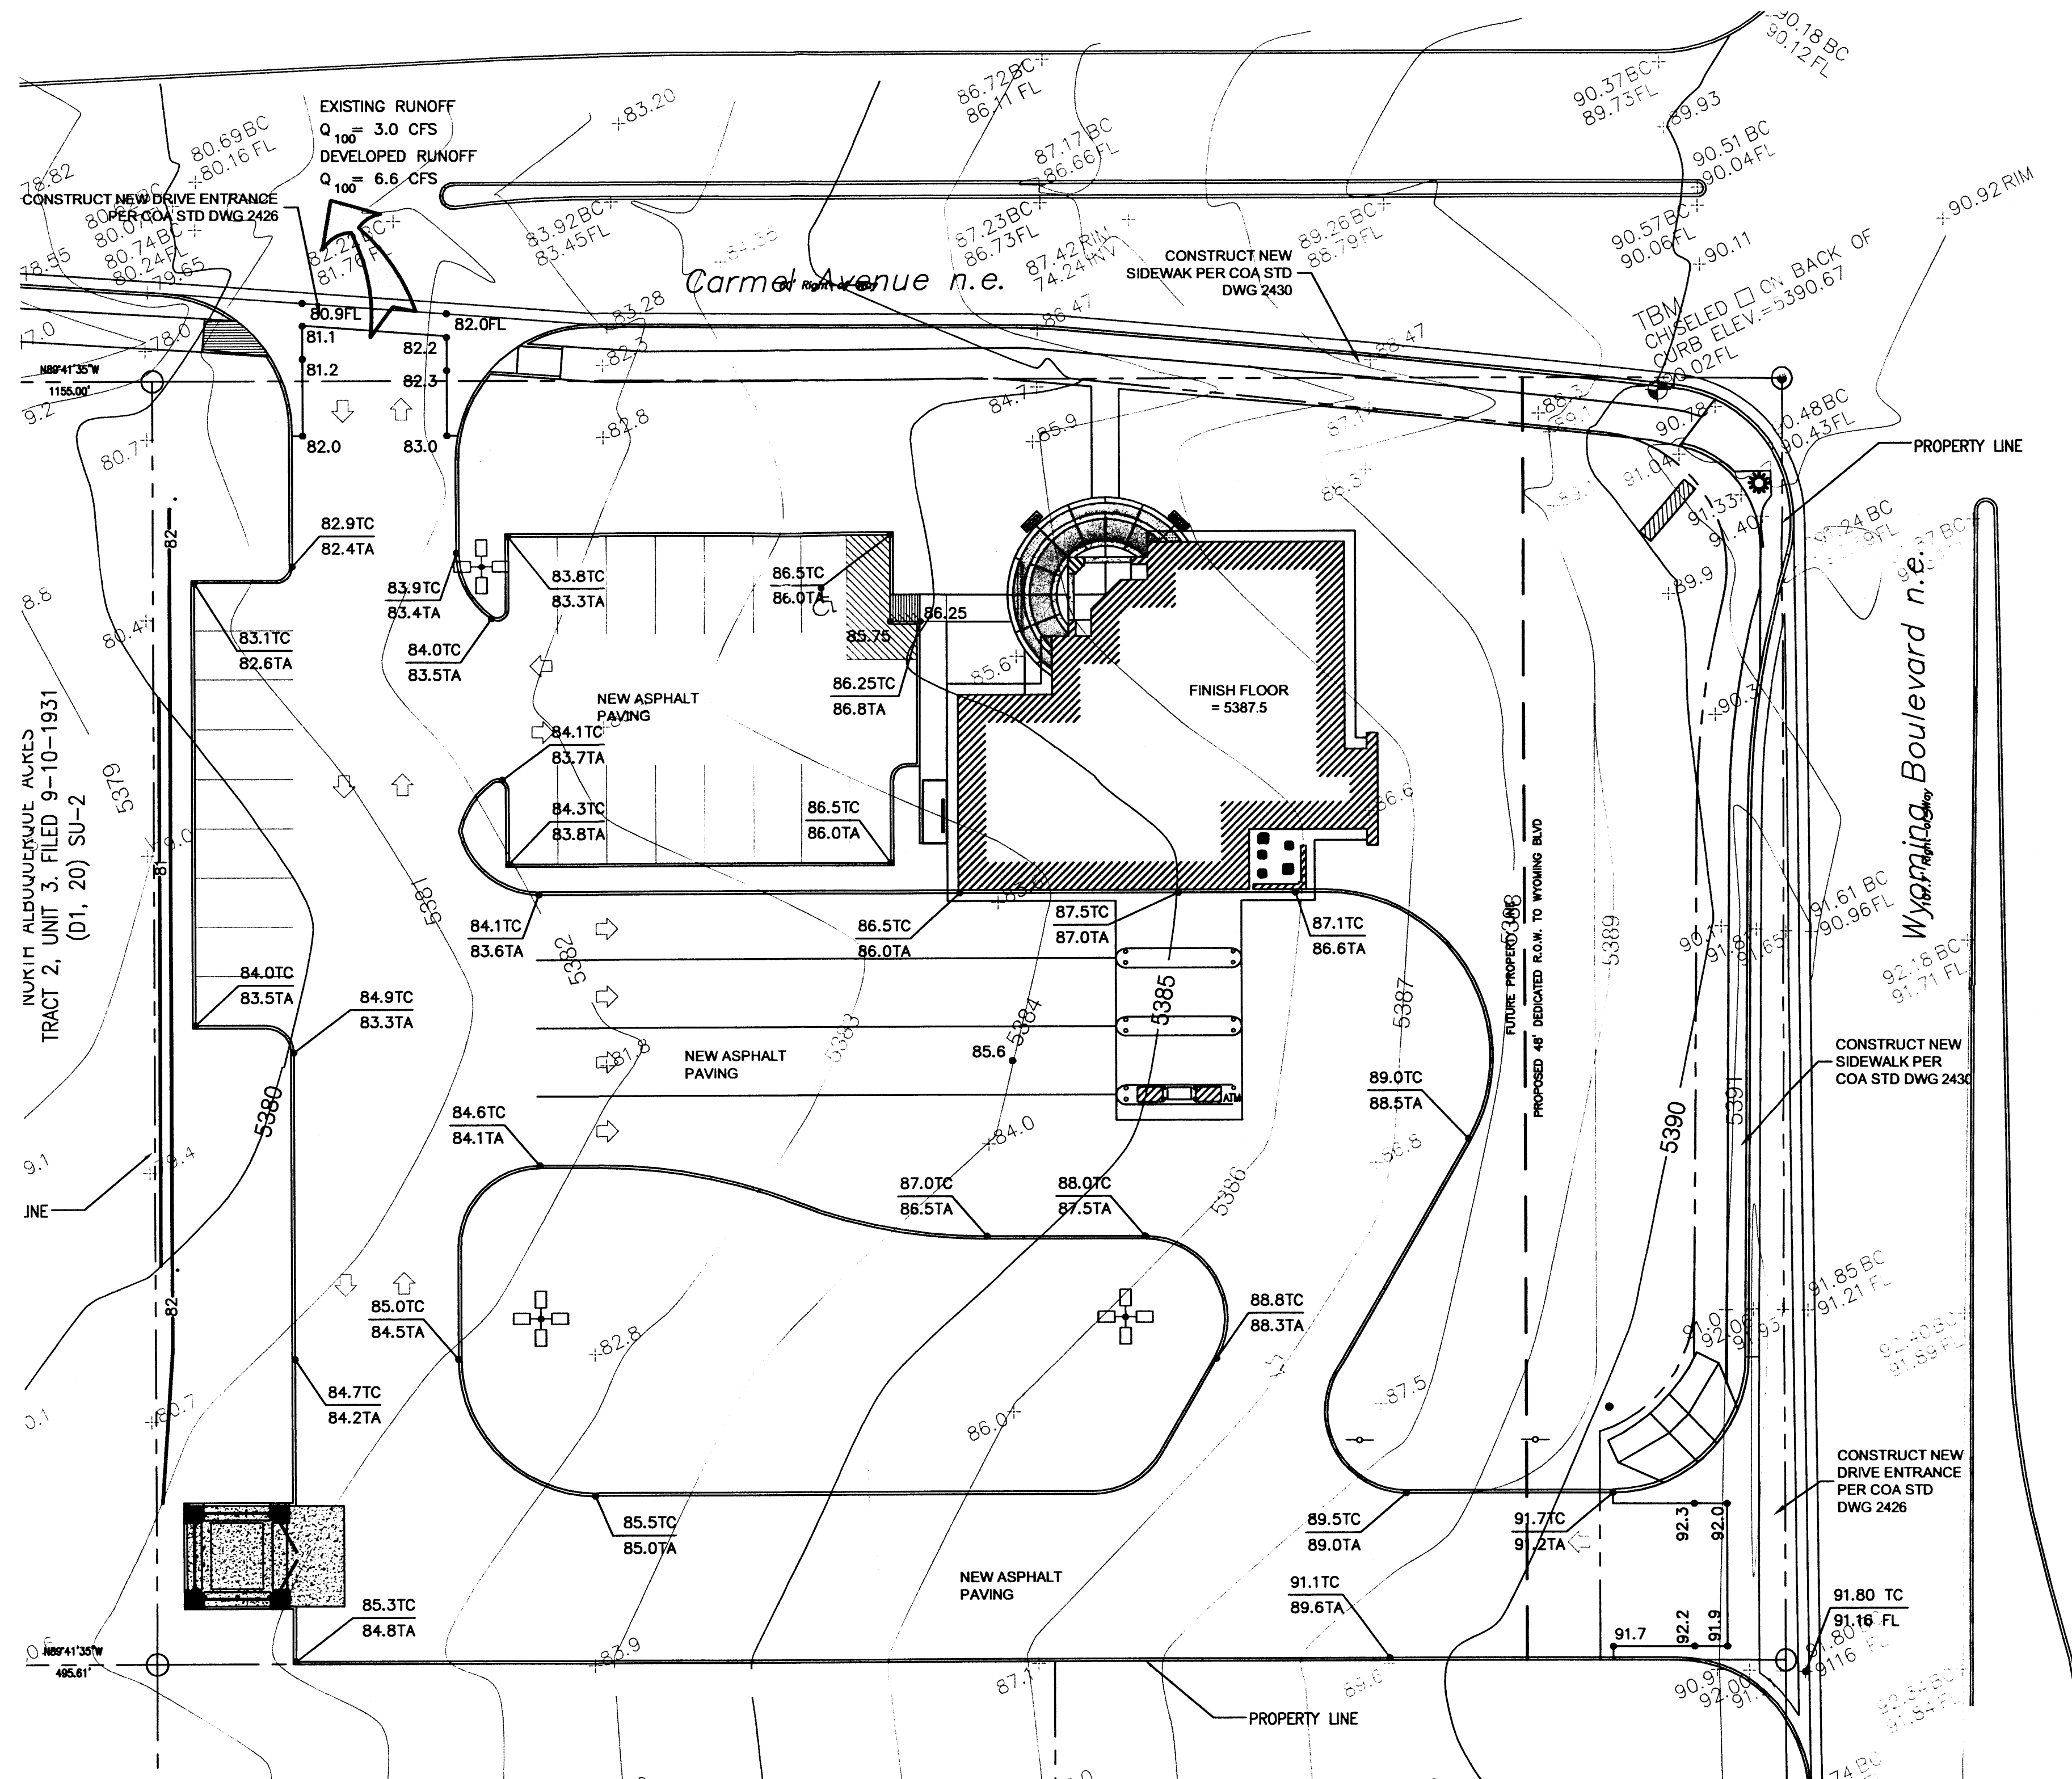

LEGEND:


± 93.1	EXISTING SPOT ELEVATION
• 51.00	NEW SPOT ELEVATION
— 51 —	EXISTING CONTOUR
— 51 —	NEW CONTOUR
— 51 —	SWALE
✓	VERIFIED ELEVATION
— 51.0 —	AS BUILT ELEVATION
—	BASEIN BOUNDARY
—	PROPERTY LINE
FL	FLOW LINE
GND	GROUND
INV	INVERT
TA	TOP OF ASPHALT
TC	TOP OF CURB
TG	TOP OF GRATE
TS	TOP OF CONCRETE SLAB
TW	TOP OF WALL
TBM	TEMPORARY BENCH MARK
[Pattern]	GRAVEL
[Pattern]	ASPHALT PAVING
[Pattern]	CONCRETE



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PROJECT:  
**BANK OF ALBUQUERQUE**  
 WYOMING BLVD. & CARMEL ALBUQUERQUE, NM




PROJECT NUMBER:  
**05053**  
 CONSULTANT:

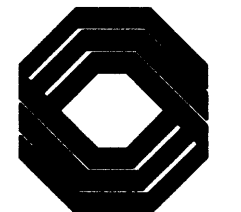CLAUDIO VIGIL ARCHITECTS

REVISIONS:


SEAL:

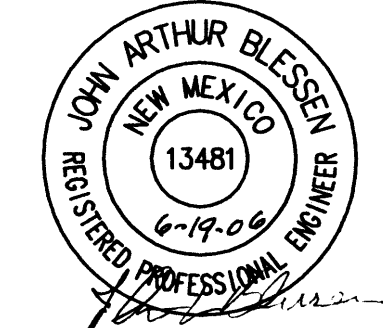

ISSUE DATE:  
**JUNE 15, 2006**  
 SHEET NUMBER:

**GD101**

GRADING PLAN FOR APPROVAL FOR DRB ACTION

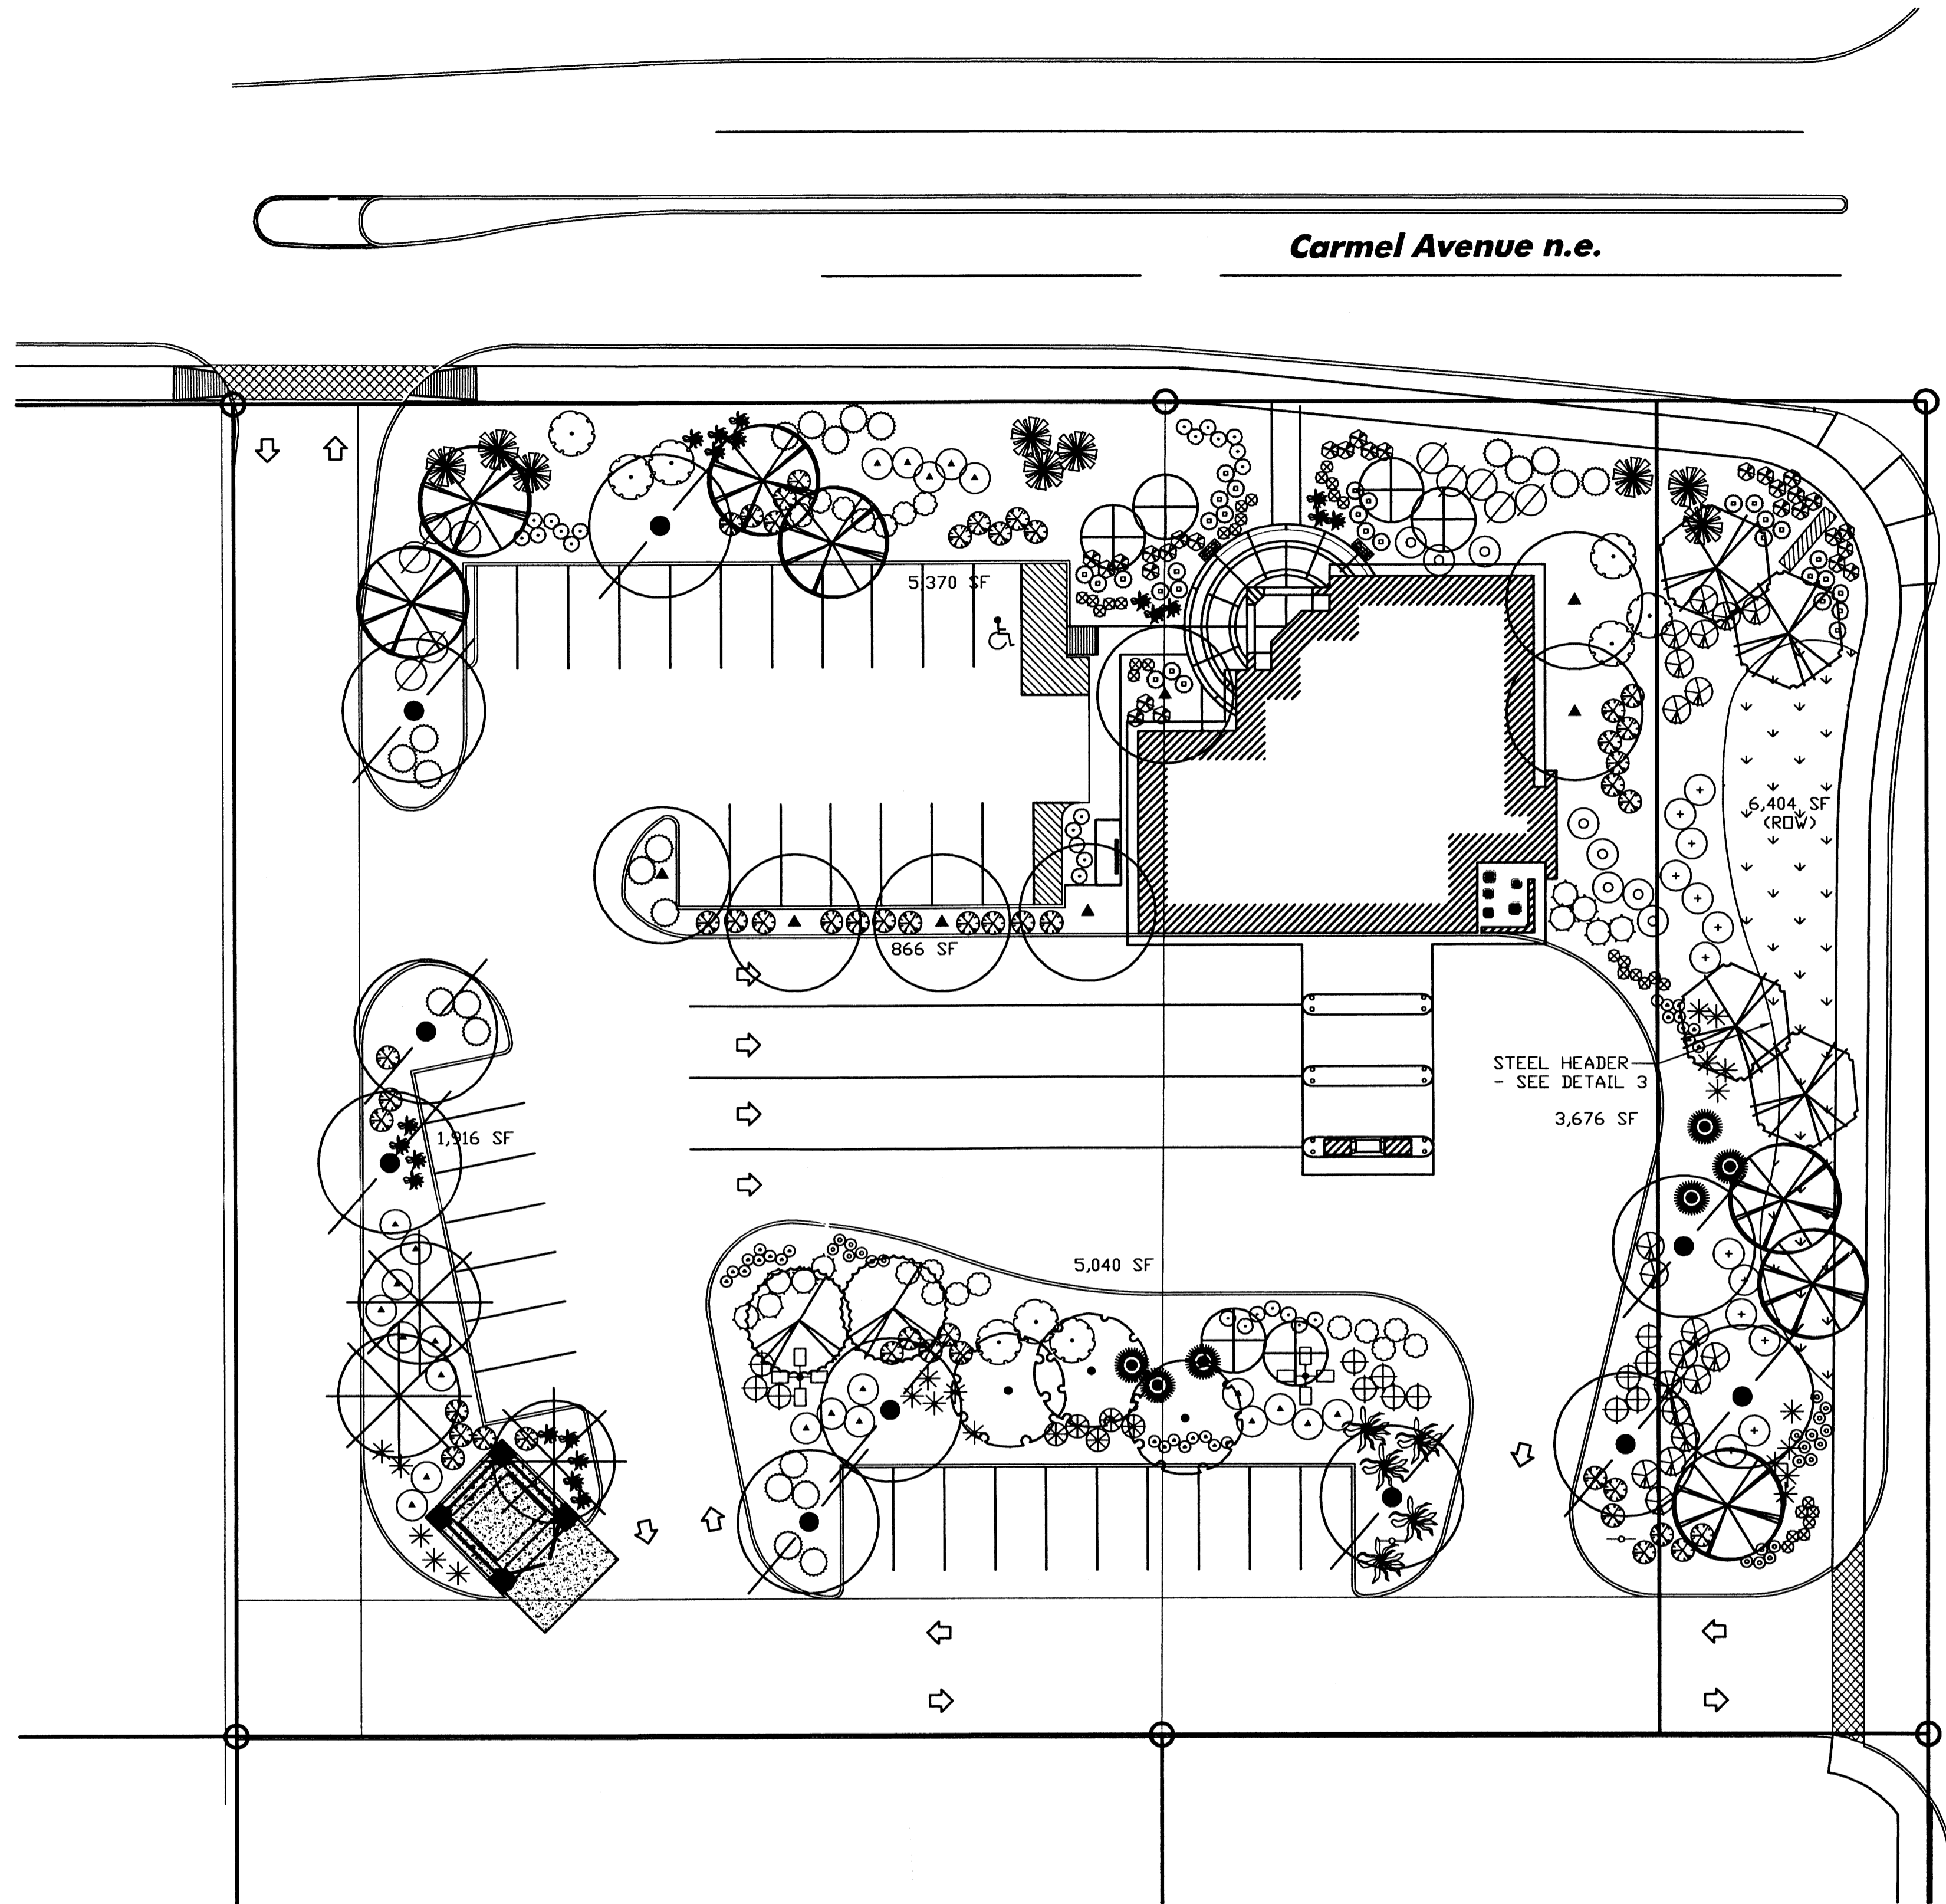

LANDSCAPE PALETTE

Symbol	Botanical Name / Common Name	Mature Size / Water Use	Symbol	Botanical Name / Common Name	Mature Size / Water Use
⊗	Trees <i>Garcia reniformis</i> 'Oklahoma' Oklahoma Redbud	25' x 25' Medium	⊗	<i>Perovskia atriplicifolia</i> Russian Sage	60" x 60" Medium
⊗	<i>Chilopsis linearis</i> 'Lucretia Hamilton' Desert Willow	20' x 25' Low+	⊗	<i>Potentilla fruticosa</i> Shrubby Cinquefoil	36" x 36" Medium+
⊗	<i>Chitalpa tashkentensis</i> 'Pink Dawn' Chitalpa	30' x 30' Medium	⊗	<i>Rhus aromatica</i> 'Gro-Low' Prostrate Sumac	24" x 48" Low+
⊕	Forestieria neomexicana New Mexico Olive	15' x 15' Medium	⊕	<i>Rhus trilobata</i> Three-leaf Sumac	48" x 60" Low+
⊕	<i>Robinia x ambigua</i> Purple Robe Locust	35' x 30' Medium+	⊕	<i>Rosmarinus officinalis</i> Prostrate Rosemary	24" x 60" Low+
⊕	<i>Pinus eldarica</i> Afghan Pine	40' x 35' Medium	⊕	<i>Salvia greggii</i> Cherry Sage	36" x 36" Medium
⊕	<i>Quercus buckleyi</i> Texas Red Oak	25' x 25' Medium	⊕	<b>Ornamental Grasses</b> <i>Miscanthus sinensis</i> Maiden Hair Grass	60" x 60" Medium+
⊕	<i>Tilia cordata</i> Littleleaf Linden	40' x 30' Medium	⊕	<i>Nolina microcarpa</i> Bear Grass	36" x 48" Medium
⊕	<b>Shrubs/Groundcovers</b> <i>Artemisia 'Fowlis Castle'</i> Fowlis Castle Sage	36" x 30" Medium	⊕	<b>Accents</b> <i>Dasylirion wheeleri</i> Sotol	48" x 60" Low
⊕	<i>Baccharis 'Stam Thompson'</i> Dwarf Coyotebush	24" x 60" Low	⊕	<i>Hesperaloe parviflora</i> Red/Yellow Flowering Yucca	36" x 36" Medium
⊕	<i>Buddleia davidii</i> 'Nanhoensis' Butterfly Bush	48" x 36" Medium	⊕	Native Grass/Wildflower Seed Mix	Low
⊕	<i>Cassia alpinia gillesii</i> Bird of Paradise	36" x 72" Low			
⊕	<i>Caryopteris clandonensis</i> Blue Mist	48" x 48" Low			
⊕	<i>Caryocarpus nuneococcus</i> Chenille	60" x 60" Low			
⊕	<i>Cytisus x 'Lena'</i> Lena's Broom	24" x 36" Low			
⊕	<i>Ericameria laricifolia</i> Dwarf Turpentine Bush	36" x 42" Low+			
⊕	<i>Erysimum 'Boules Mauves'</i> Boules Mauves Wallflower	24" x 36" Medium			
⊕	<i>Fallugia paradoxa</i> Apache Plume	60" x 60" Low			
⊕	<i>Gallardia grandiflora</i> 'Fantail' Blanket Flower	30" x 30" Low			
⊕	<i>Helianthus lasianthus</i> Yellow Rockrose	24" x 36" Medium			

LANDSCAPE CALCULATIONS

Total Site Area:	(1.61 acres) 10,278 SF
Building Area:	3,500 SF
Net Area:	6,678 SF
Required Landscape Area (15% of Net Area):	1,011 SF
Provided Landscape Area: (40%)	2,372 SF
On-site - 1,626 SF	
ROW - 6,404 SF	

MULCHES

All shrub planting areas shall be top dressed with 7/8" Santa Fe Brown Rock Mulch 2" - 4" Santa Ana Tan Cobble will be used as an accent mulch in certain areas.

IRRIGATION SYSTEM

Irrigation system standards outlined in the Water Conservation Landscaping and Water Waste Ordinance shall be strictly adhered to. A fully automated drip irrigation system will be used to irrigate tree, shrub and groundcover planting areas. A temporary spray system will be used to establish the native seeded area. Upon establishment, the spray system will be used only on an as needed basis.

MAINTENANCE RESPONSIBILITY

Maintenance of the landscaping and irrigation system, including those areas within the public ROW, shall be the responsibility of the Owner.

STATEMENT OF WATER WASTE

The Landscape Plan for the Bank of Albuquerque shall limit the provision of high water use turf to a maximum of 20 percent of the required landscape area.



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**BANK OF ALBUQUERQUE**  
WYOMING BLVD. & CARMEL ALBUQUERQUE, NM

PROJECT NUMBER:  
**05053**

CONSULTANT:  
**CONSENSUS PLANNING, INC.**  
Planning / Landscape Architecture  
302 Eighth Street NW  
Albuquerque, NM 87102  
(505) 764-9801 Fax 842-5485  
e-mail: cp@consensusplanning.com

REVISIONS:


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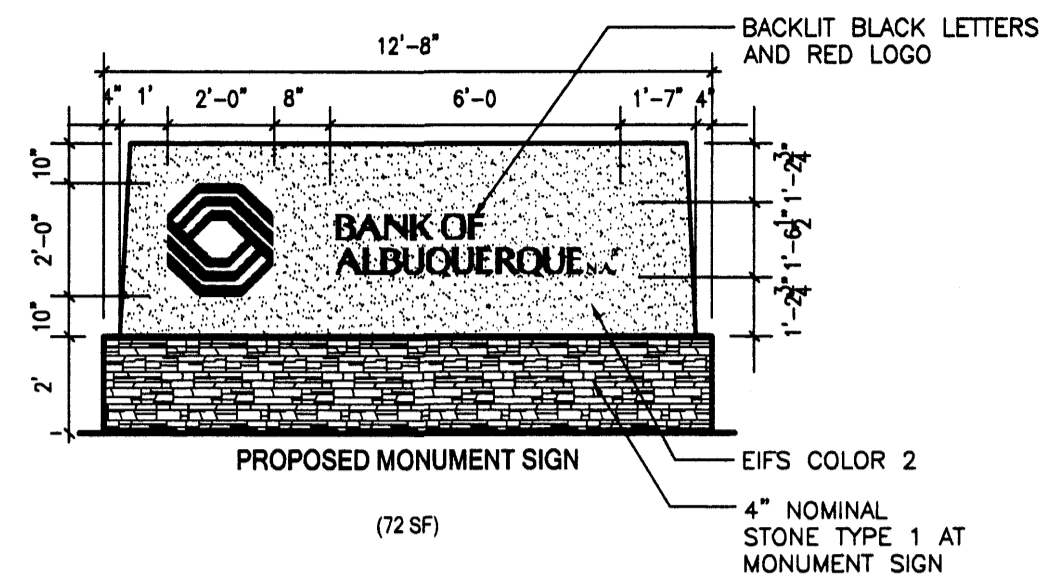
**SCHEMATIC DESIGN**  
NOT FOR CONSTRUCTION

ISSUE DATE:  
**SEPTEMBER 22, 2006**

SHEET NUMBER:


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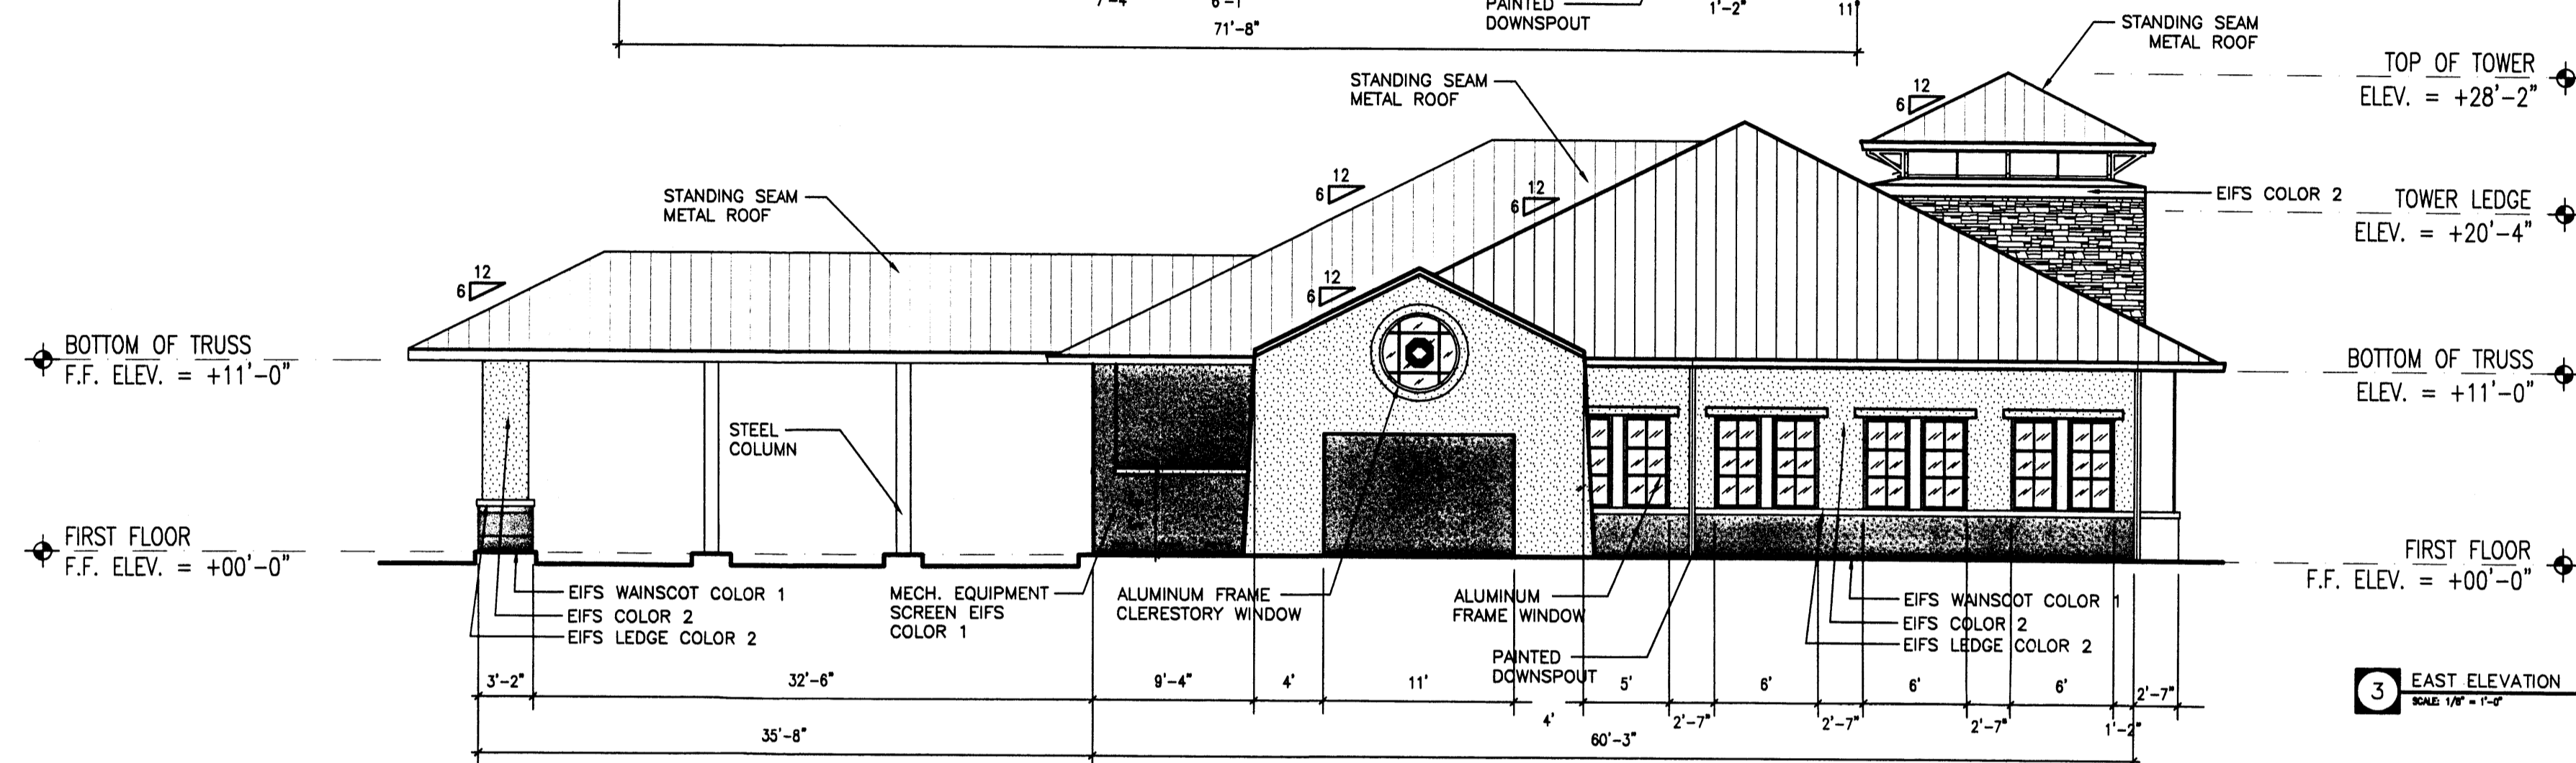


5 MONUMENT SIGN  
SCALE 1/8" = 1'-0"

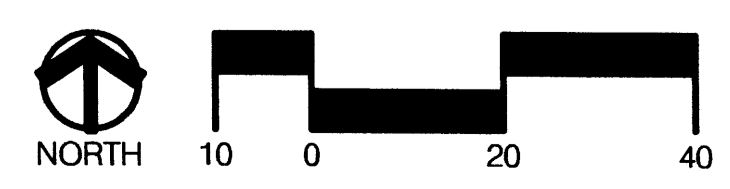
EXTERIOR FINISH LEGEND			
MATERIAL	MANUFACTURER	DESCRIPTION	NOTES
<b>DIVISION 4 - MASONRY</b>			
STONE VENEER TYPE 1	-	BUFF, GROUND FACE	MORTAR COLOR H10 LIGHT BUFF
PRE-FINISHED CONCRETE MASONRY UNIT	NO RHIFIELD	BUFF, GROUND FACE	MORTAR COLOR H10 LIGHT BUFF
<b>DIVISION 5 - METALS</b>			
TUBE STEEL BRACKET	SHERWIN WILLIAMS	LIGHT GRAY	PER SECTION 09900
PAINTED STEEL COLUMN AND UNTEL	SHERWIN WILLIAMS	SAFFRON GOLD	PER SECTION 09900
PRE-FINISHED METAL	PAC-CLAD	LIGHT GRAY	CANON RES. BREAK METAL
<b>DIVISION 6 - WOODS AND PLASTICS</b>			
FASCIA BOARD	-	LIGHT GRAY	PER SECTION 09900
<b>DIVISION 7 - THERMAL AND MOISTURE PROTECTION</b>			
EXTERIOR INSULATION AND FINISH SYSTEM - COLOR 1	DRYVIT	SAFFRON GOLD	TYPCAL COLOR, PER SECTION 09900
EXTERIOR INSULATION AND FINISH SYSTEM - COLOR 2	DRYVIT	OFF-WHITE	ACCENT COLOR, PER SECTION 09900
SHEET METAL FLASHING	PAC-CLAD	PAC-CLAD METALLIC - STONE WHITE	LOW REFLECTANCE
SHEET METAL FLASHING AND TRIM	PAC-CLAD	PAC-CLAD METALLIC - STONE WHITE	LOW REFLECTANCE
GUTTERS AND DOWNSPOUTS	PAC-CLAD	PAC-CLAD METALLIC - STONE WHITE	LOW REFLECTANCE
<b>DIVISION 8 - DOORS AND WINDOWS</b>			
ALUMINUM ENTRANCES AND STOREFRONT	KAWNEER	LIGHT GRAY POWDER COAT	
ALUMINUM PACKAGE WINDOWS	THERMAL WINDOWS	LIGHT GRAY	
BULLET-RESISTANT WINDOW	DIEBOLD	LIGHT GRAY	
TINTED SAFETY AND NON-SAFETY GLASS	VIKON	GRAY INSUL-SHIELD	
BULLET-RESISTANT GLASS	DIEBOLD	GRAY	




4 SOUTH ELEVATION  
SCALE 1/8" = 1'-0"

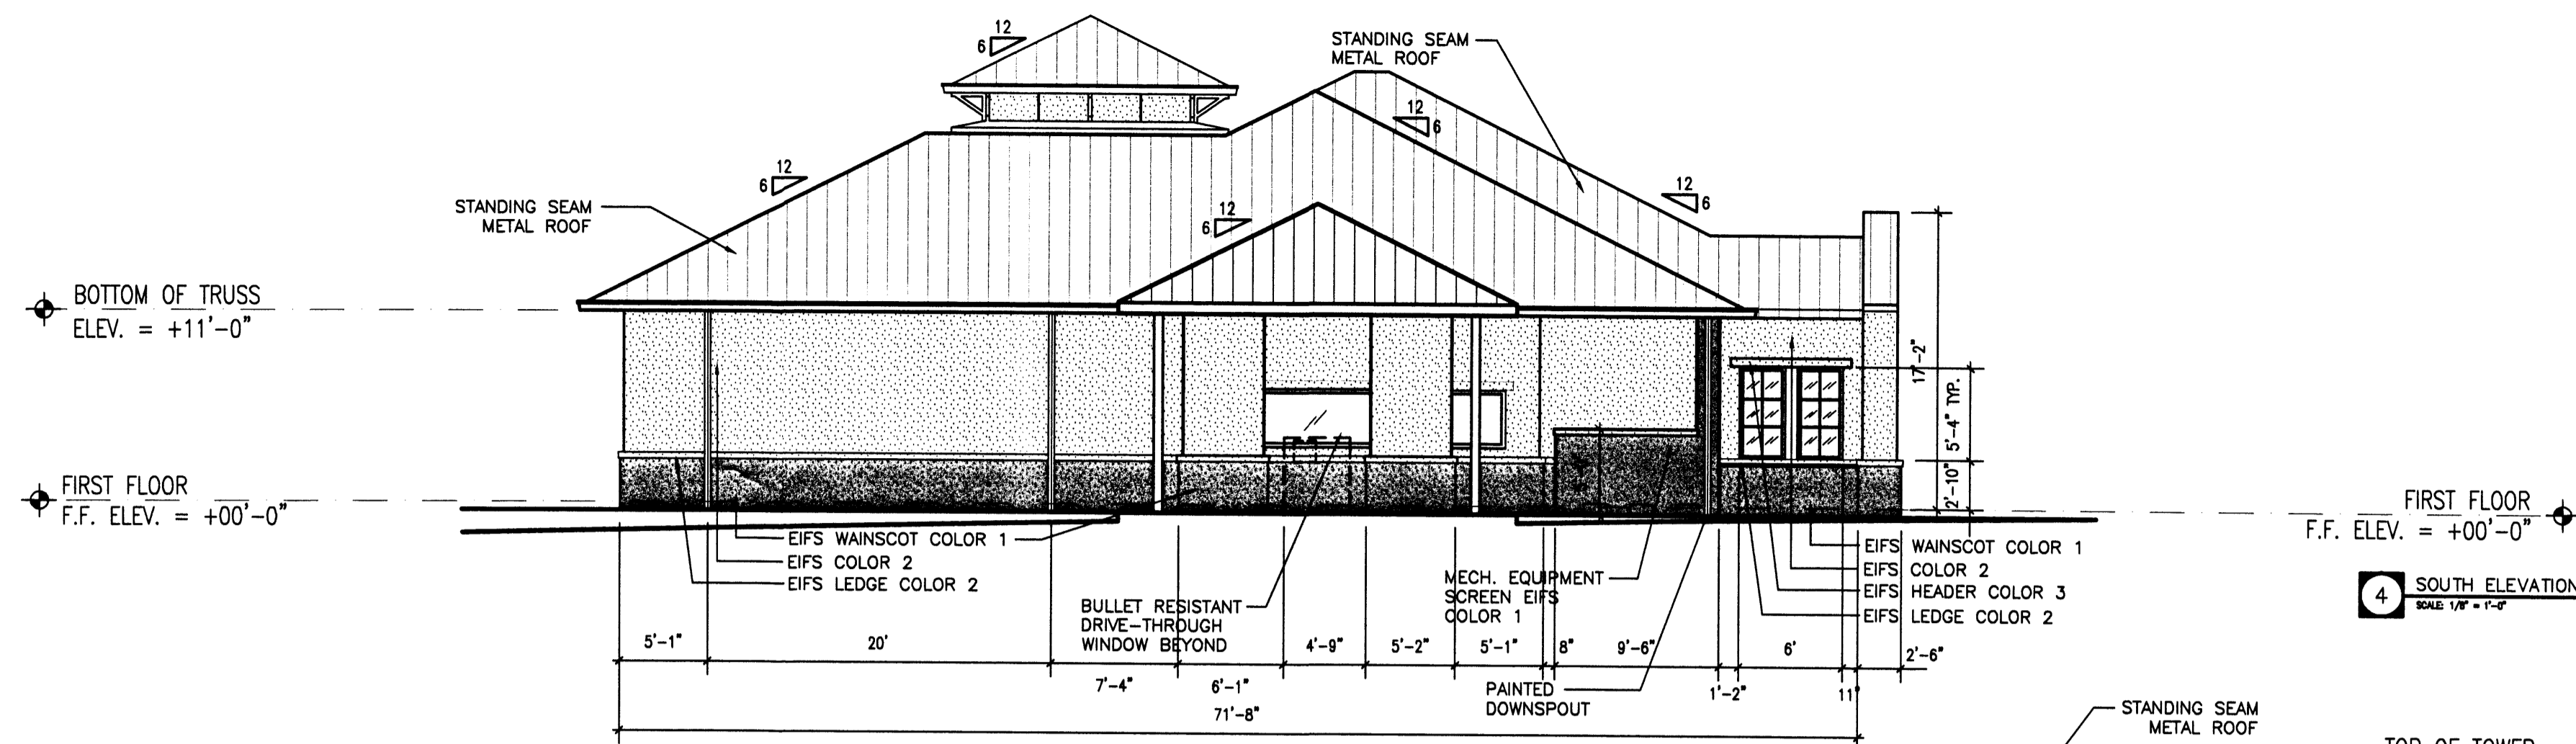

3 EAST ELEVATION  
SCALE 1/8" = 1'-0"

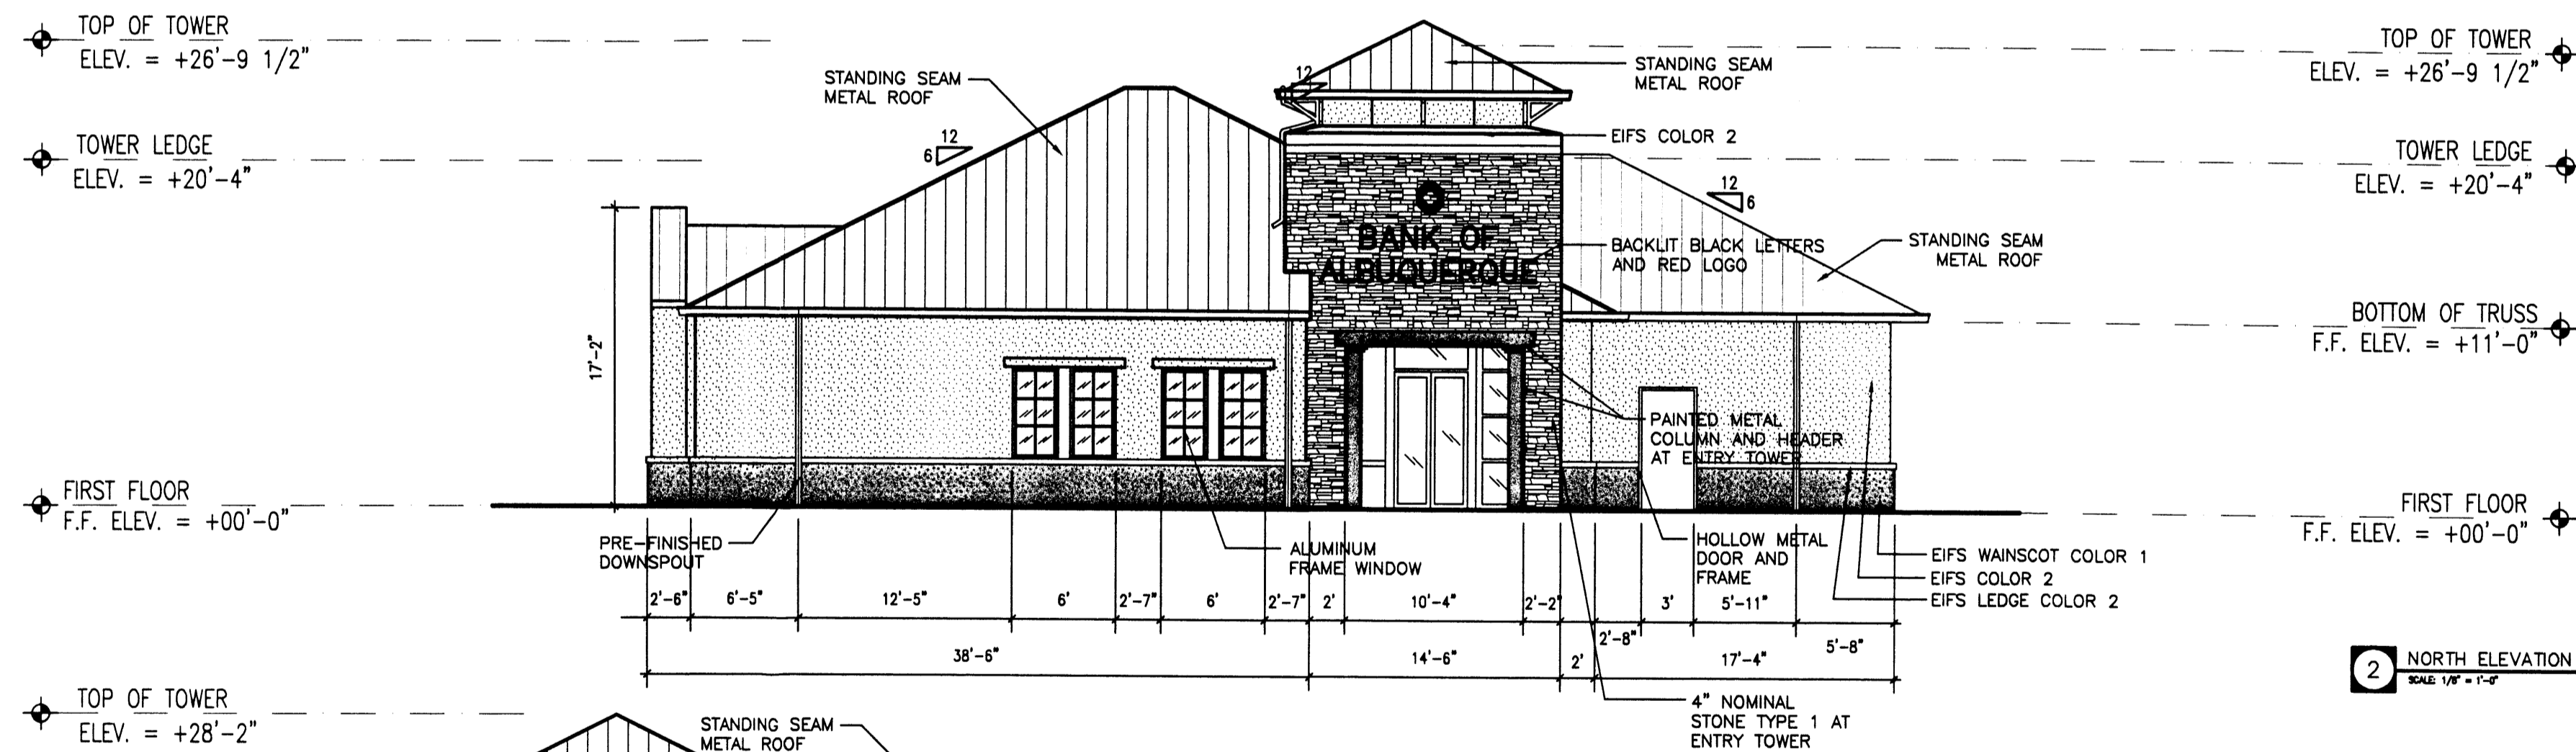

2 NORTH ELEVATION  
SCALE 1/8" = 1'-0"

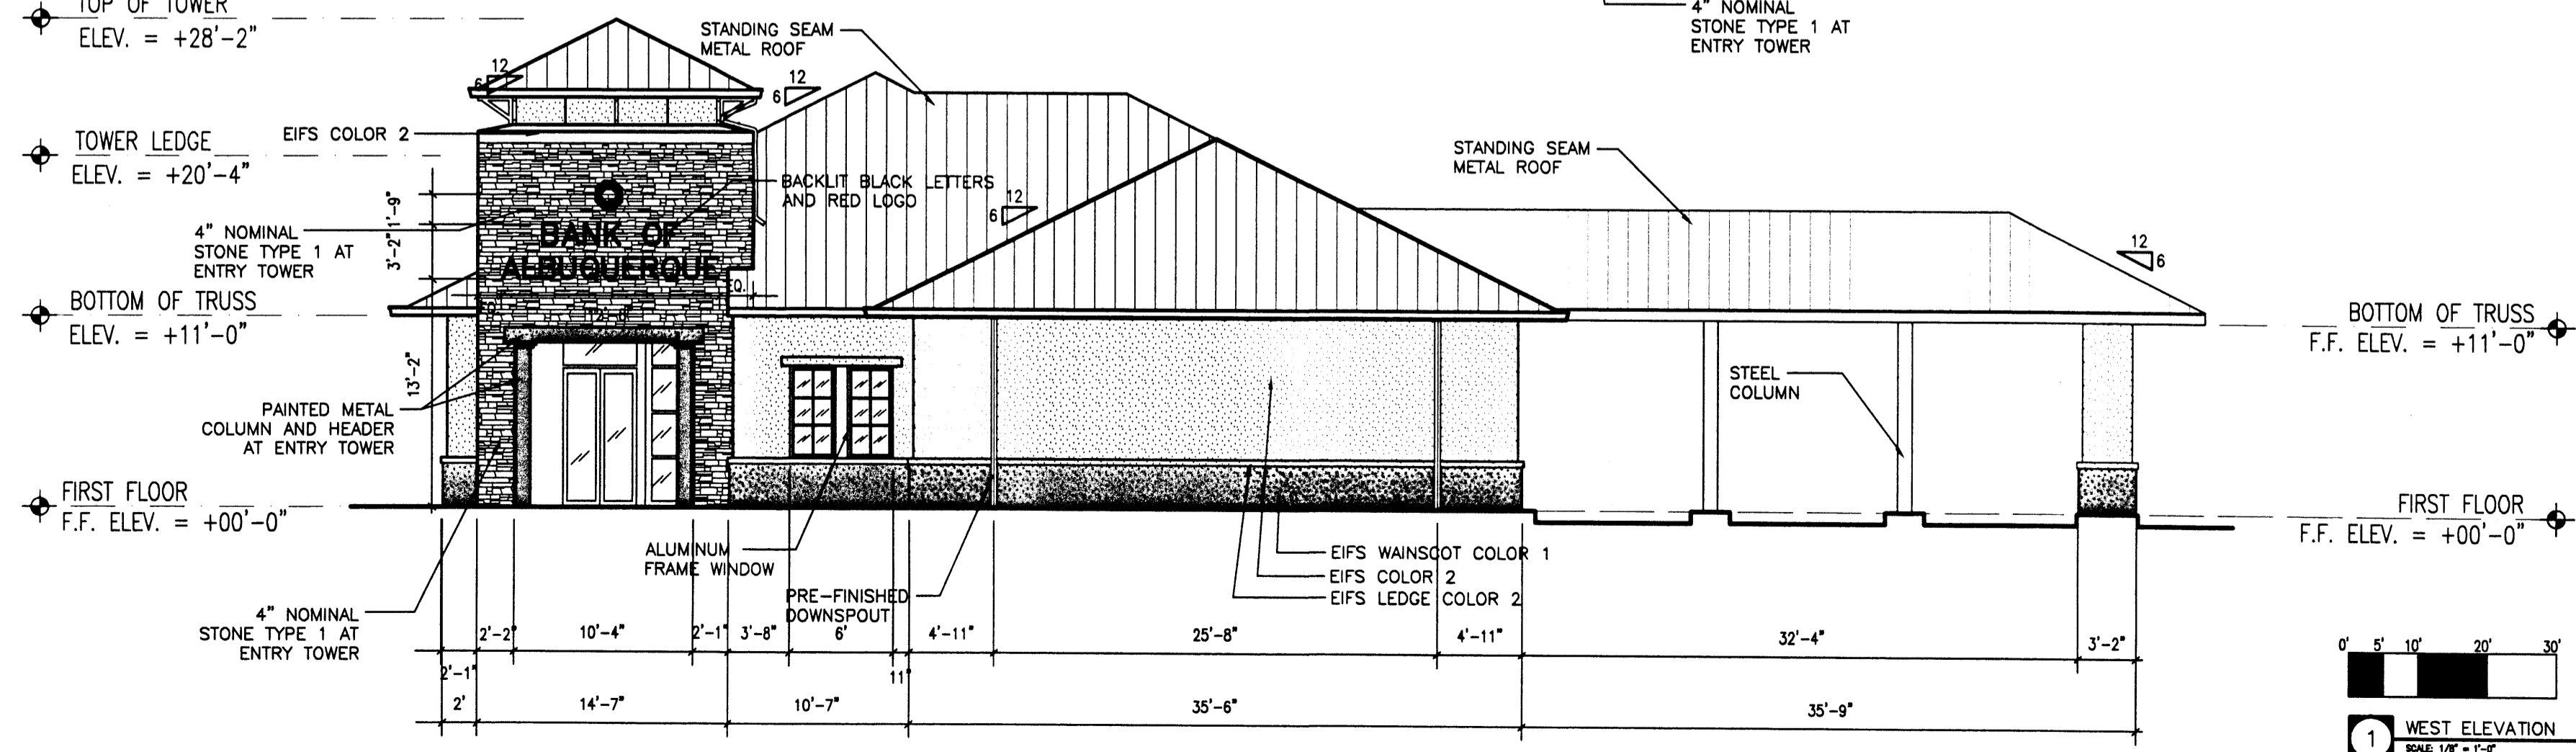

1 WEST ELEVATION  
SCALE 1/8" = 1'-0"




OKLAHOMA CITY  
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120 N. ROBINSON, SUITE 2800  
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THE MAYO HOTEL  
121 WEST FIFTH  
TULSA, OK 74103  
T: 918.583.6300  
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PROJECT:  
**BANK OF  
ALBUQUERQUE**

WYOMING BLVD. & CARMEL  
ALBUQUERQUE, NM



PROJECT NUMBER:  
**05053**

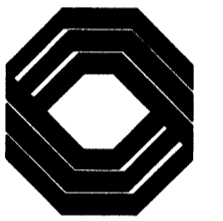CONSULTANT:

REVISIONS:

SEAL:

DESIGN  
DEVELOPMENT

NOT FOR CONSTRUCTION

ISSUE DATE:  
27 SEPTEMBER 2006

SHEET NUMBER:

A401

BUILDING AND STRUCTURE  
ELEVATIONS



OKLAHOMA CITY  
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PROJECT:  
**BANK OF ALBUQUERQUE**  
 WYOMING BLVD. & CARMEL ALBUQUERQUE, NM

PROJECT NUMBER:  
**05053**

CONSULTANT:  
  
**CLAUDIO VIGIL ARCHITECTS**

REVISIONS:


SEAL:  
**DESIGN DEVELOPMENT**  
 NOT FOR CONSTRUCTION

ISSUE DATE:  
**26 SEPTEMBER, 2006**


SHEET NUMBER:

**U101**

CONCEPTUAL UTILITY PLAN

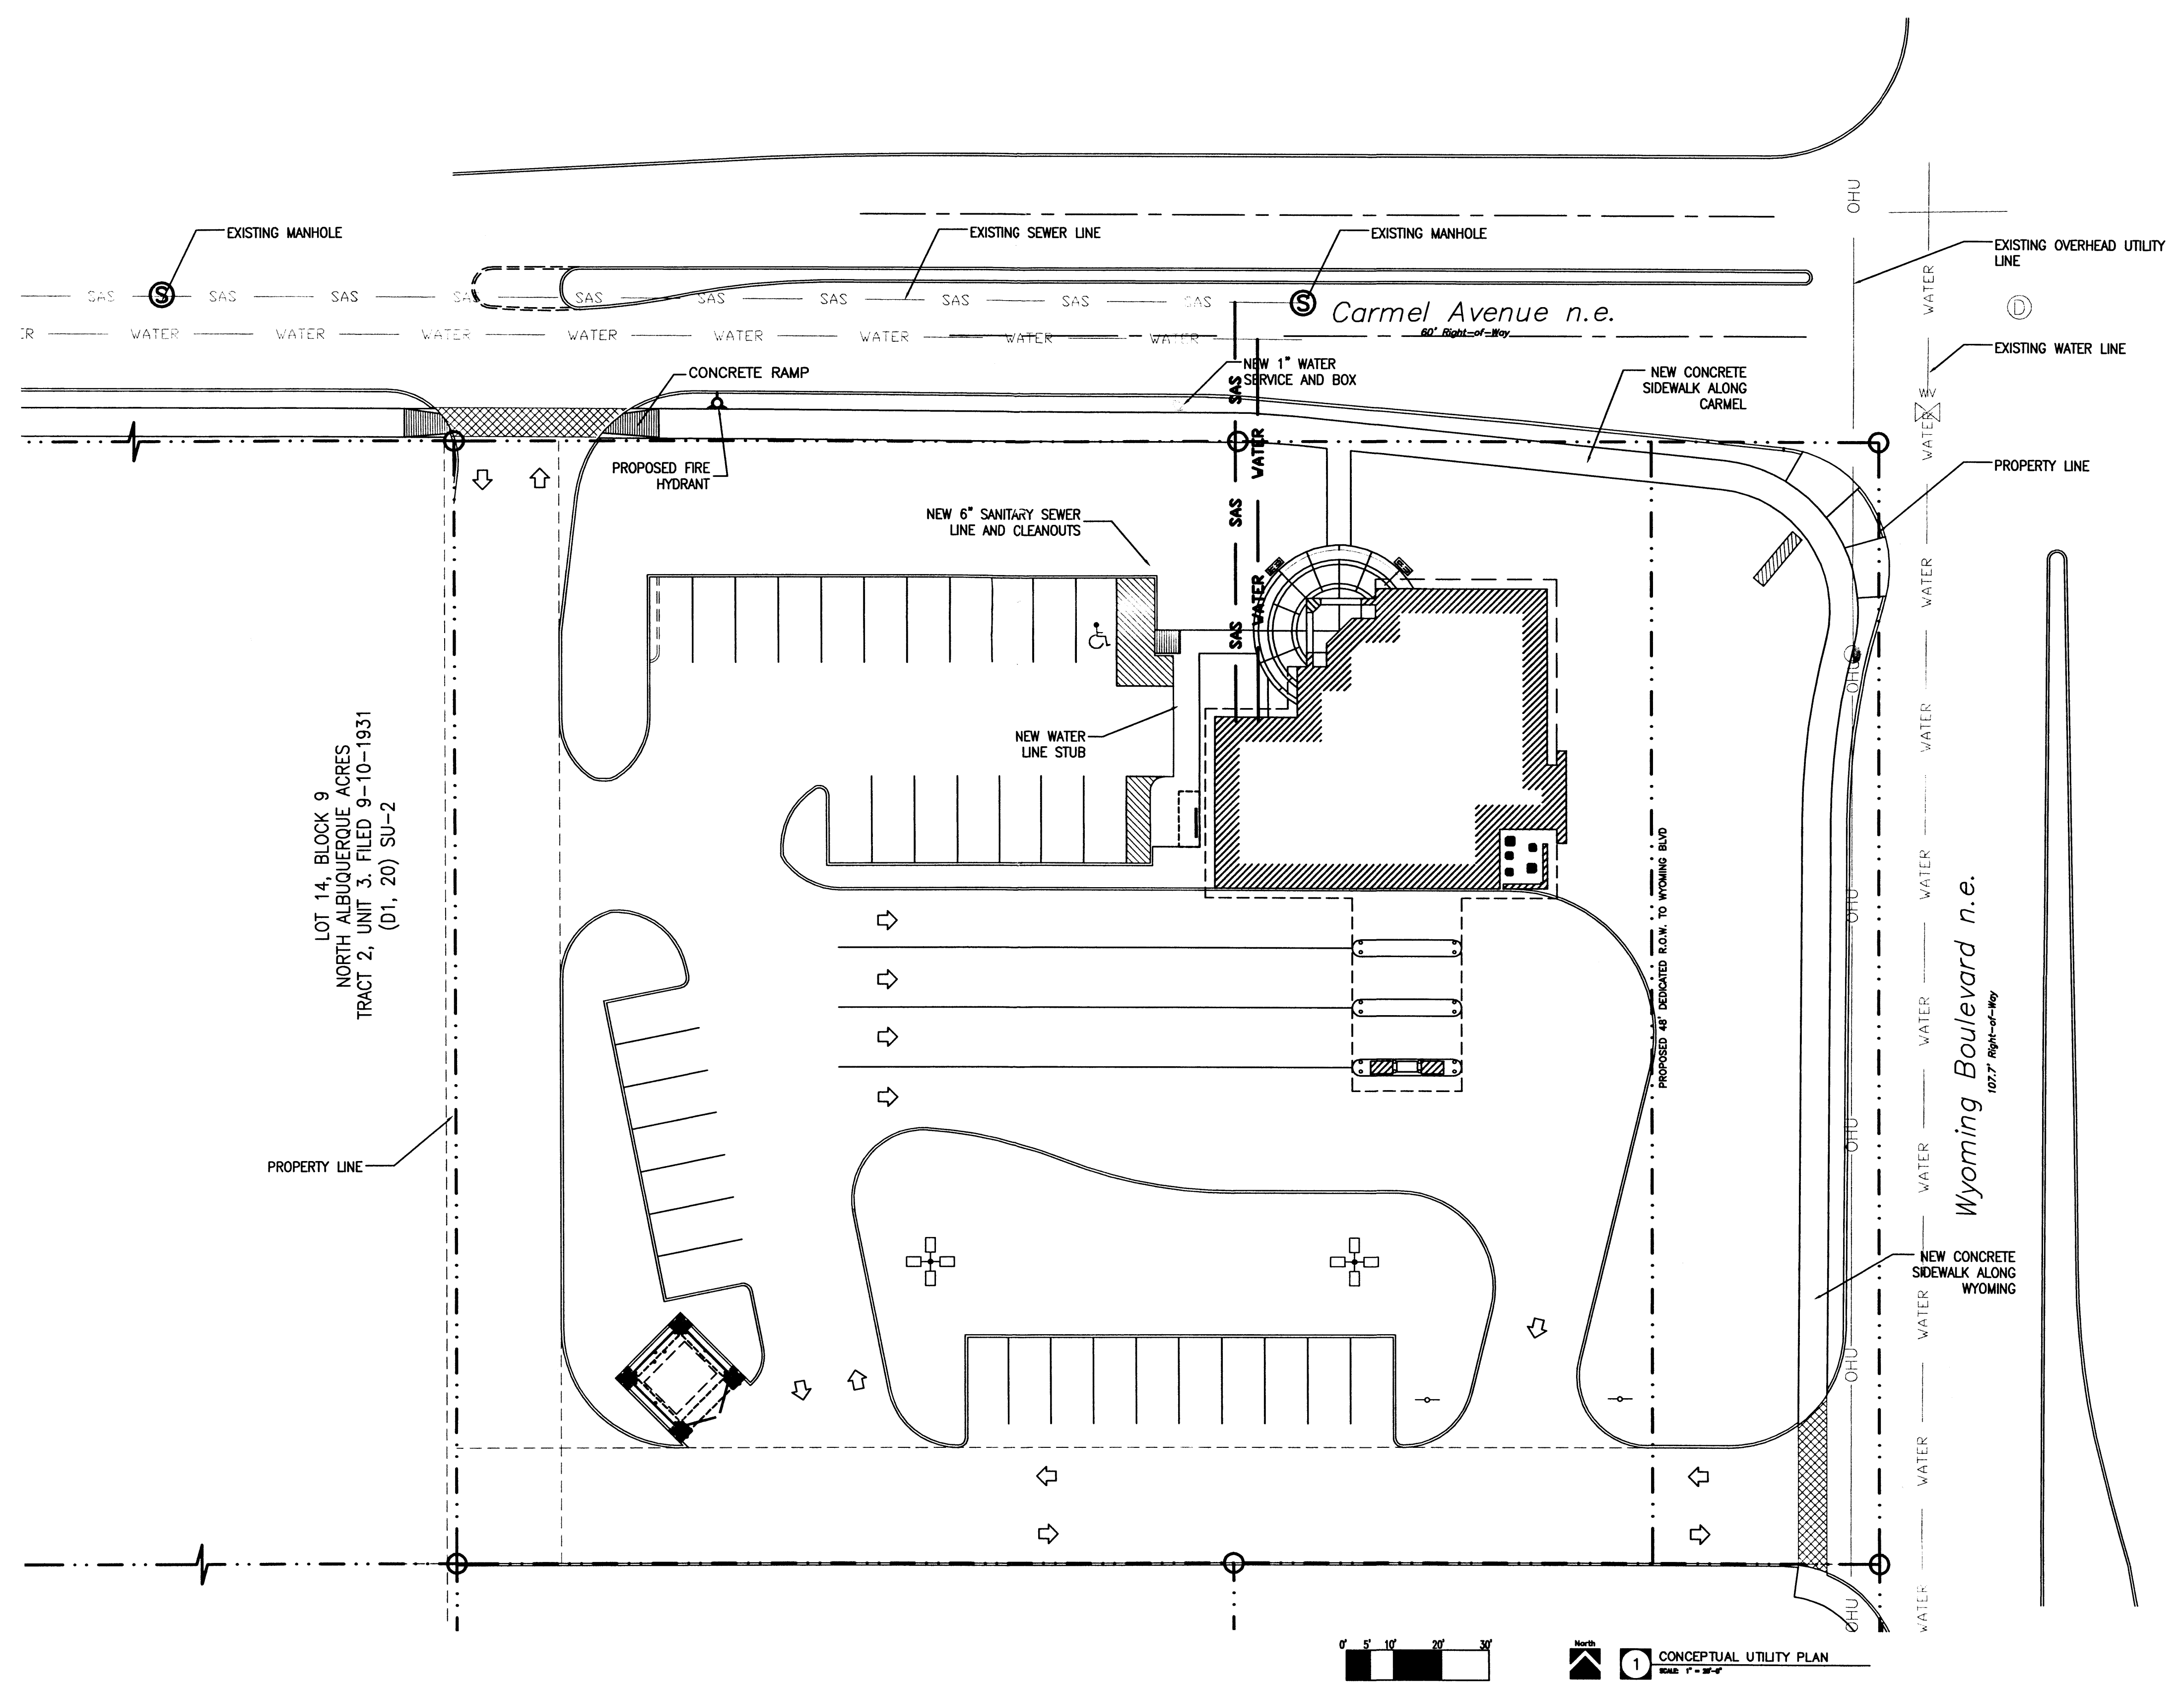

SYMBOLS LEGEND	
	= TRAFFIC SIGNAL BOX
	= TRAFFIC SIGNAL
	= POWER POLE
	= OVERHEAD UTILITY LINE
	= UNDERGROUND SEWER LINE
	= UNDERGROUND WATER LINE
	= SEWER MANHOLE
	= DRAINAGE MANHOLE
	= WATER VALVE
	= ELECTRIC RISER

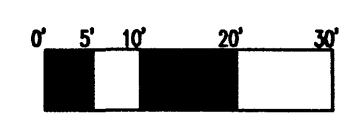

1 CONCEPTUAL UTILITY PLAN  
 DATE: 7-26-06