TALOS LOG # 2006-4024-98 NOR ESTE 2 SECTOR DEVELOPMENT AMAPGA-1 AMAFCA DOMINGO LA-CUEVA SU-1 PRD (20) U VILLAGE CUEVA PASEO CENTER SU+2 |MIXED-USE 1000948 ZONE ATLAS: C-19-Z PASEO DEL NORTE DEL RANGIO DE PALOMAS

Vicinity Map

SUBDIVISION DATA / NOTES

- 1. PLAT WAS COMPILED USING EXISTING RECORD DATA & ACTUAL FIELD SURVEY.
- 2. BEARINGS ARE NEW MEXICO STATE PLANE GRID BEARINGS, CENTRAL ZONE, NAD 1927, AND ARE BASED ON ACS CONTROL MONUMENTS HEAVEN AND 7-C19, AS SHOWN HEREON.
- 3. DISTANCES ARE GROUND DISTANCES.
- 4. PLAT SHOWS ALL EASEMENTS OF RECORD.
- 5. BEARINGS AND DISTANCES IN PARENTHESES () ARE PER THE PLAT OF NORTH ALBUQUERQUE ACRES, FILED IN BERNALILLO COUNTY, NEW MEXICO ON SEPTEMBER 10, 1931 IN VOLUME D1, FOLIO 20.
- 6. GROSS AREA: 1.8198
- 7. NUMBER OF EXISTING LOTS: 2
- 8. NUMBER OF LOTS CREATED: 1
- 9. THE 24' PRIVATE ACCESS EASEMENT IS FOR THE BENEFIT AND USE FOR THE OWNERS OF LOTS 16-A, 17 AND 18, BLOCK 9 AND IS TO BE MAINTAINED BY THE OWNERS OF LOT 16-A, BLOCK 9.
- 10. THE 22' PUBLIC ACCESS EASEMENT IS TO BE MAINTAINED BY THE OWNERS OF LOT 16-A, BLOCK 9.
- 11. PROPERTY IS ZONED SU-2.

LEGAL DESCRIPTION

Lots numbered Fifteen (15) and Sixteen (16) in Block numbered Nine (9) plat of Tract 2, Unit 3, North Albuquerque Acres as the same is shown and designated on the plat thereof, filed in the Office of the County Clerk of Bernalillo County, New Mexico in September 10, 1931 in Volume D1, folio 20 being more particularly described as follows: Commencing at City of Albuquerque Control station "HEAVEN" having New Mexico State Plane NAD 1927 Central Zone Grid Coordinates of X = 407,051.31, Y = 1,518,737.03 a ground to grid factor of 0.99965263 and a delta alpha of -00° 10′ 45"; thence N 11° 39' 57" E, a distance of 875.23 feet to the POINT OF BEGINNING being the southwest corner of said Lot 15; thence N 00° 18' 25" E, a distance of 264.51 feet; thence S 89° 41' 35" E, a distance of 299.69 feet; thence S 00° 18' 25" W, a distance of 264.51 feet; thence N 89° 41' 35" W, a distance of 299.69 feet to the POINT OF BEGINNING and containing 1.8198 acres more or less.

FREE CONSENT

THE UNDERSIGNED OWNER(S) AND PROPRIETOR(S) OF THE PROPERTY DESCRIBED HEREON DO HEREBY CONSENT TO THE PLATTING OF SAID PROPERTY AS SHOWN HEREON AND THE SAME IS WITH THE FREE CONSENT AND IN ACCORDANCE WITH THEIR DESIRES AND SAID OWNERS WARRANT THAT THEY HOLD COMPLETE AND INDEFEASIBLE TITLE IN FEE SIMPLE TO THE LAND SUBDIVIDED, DO HEREBY GRANT ADDITIONAL EASEMENT(S) AS SHOWN AND DO HEREBY DEDICATE ADDITIONAL STREET RIGHT-OF-WAY TO THE CITY OF ALBUQUERQUE IN FEE SIMPLE.

OWNER(S) SIGNATURE: David M. James ADDRESS:

ACKNOWLEDGMENT STATE OF OKLA

COUNTY OF TUSA

BY: DAVID M. JAMES

MY COMMISSION EXPIRES: 11-04-08

PLAT OF

LOT 16-A, BLOCK 9, TRACT 2, UNIT 3 NORTH ALBUQUERQUE ACRES PROJECTED SECTION 18, T. 11 N., R. 4 E., N.M.P.M. **ELENA GALLEGOS GRANT** CITY OF ALBUQUERQUE BERNALILLO COUNTY, NEW MEXICO SEPTEMBER 2006 SHEET 1 OF 2

DISCLOSURE STATEMENT

THE PURPOSE OF THIS PLAT IS TO COMBINE TWO (2) EXISTING LOTS INTO ONE (1) NEW LOT, TO GRANT PUBLIC ACCESS EASEMENTS AND TO DEDICATE ADDITIONAL STREET RIGHT-OF-WAY AS SHOWN.

CITY APPROVALS: PROJECT NO.: 1002 458 APP	PLICATION NO. 06 DLB-0/475
M. B. Jan	9-27-06
CITY SURVEYOR	DATE
101 1	1-5-07
TRAFFIC ENGINEERING	DATE
Christina Sandoral	10/18/04
RATIKS & HECREATION DEPARTMENT	DATE
Konthan	10.17.06
WATER UTILITIES DEVELOPMENT	DATE
Bradler S. Brushun	10/18/06
AMAFCA.	DATE
Bradley & Bylin	10/18/06
CITYENGINEER	DATE
MI atom	10/18/06
DOB CHAIRPERSON PLANNING DEPARTMENT	DATE

SURVEYOR'S CERTIFICATION

I, Mitchell W. Reynolds, a duly qualified Registered Professional Land Surveyor under the laws of the State of New Mexico, do hereby certify that this plat and description were prepared by me or under my supervision, shows all easements as shown on the plat of record or made known to me by the owners and/or proprietors of the subdivision shown hereon, utility companies and other parties expressing an interest and meets the minimum requirements for monumentation and surveys of the Albuquerque Subdivision Ordinance, and further meets the Minimum Standards for Land Surveying in the State of New Mexico and is true and correct to the best of my knowledge and belief.

New Mexico Professional Surveyor, 11224

SURVEYS SOUTHWEST LTD.

333 LOMAS BLVD., N.E. ALBUQUERQUE, NÉW MEXICO 87102

PHONE: (505) 998-0303 FAX: (505) 998-0306

T11N R4E SEC. 18



THIS IS TO CERTIFY THAT TAXES ARE CURRENT & PAID ON

UPC#: 2 Life (ad. 745/-019064-153010 312/7

PROPERTY OWNER OF RECORD: Saular Clarenter NA

PROJECT NO. 0601RS04 DRAWN BY RS ZONE ATLAS: C-19-Z 15-16NAA.CR5

60' RIGHT-OF-WAY (300.00') 299.69' (S90°00'00"E) S89°41'35"E 20,808.72 SO.FT. ADDITIONAL PUBLIC STREET RIGHT-OF-WAY DEDICATED TO THE CITY OF ALBUQUERQUE WITH THE FLUNG OF THIS FLAT S89'00'56"E /\$83'50'43"E /S89'41'35"E//108.57' N89'41'35"W FND #5 REBAR 1155.00 63.26 LOT 16 LOT 15 WYOMING BOULEVARD 107.7' RIGHT-OF-WAY LOT 14, BLOCK 9 NORTH ALBUQUERQUE ACRES TRACT 2, UNIT 3 LOT 16-A BLOCK 9 FILED 9-10-1931 I.8198 ACRES(GROSS) I.0940 ACRES(NET) (D1, 20) 24' PRIVATE ACCESS ESMT. (GRANTED BY THIS PLAT) **48.00**′/ 251.69 299.69' (300.00') N89°41'35"W (N90°00'00"W) FND #4 REBAR W/CAP LS10283 FND #4 REBAR LOT 17, BLOCK 9 NORTH ALBUQUERQUE LOT 18. BLOCK 9 NORTH ALBUQUERQUE ACRES TRACT 2, UNIT 3 FILED 9-10-1931 ACRES TRACT 2, UNIT 3 FILED 9-10-1931 (D1, 20) (01, 20) STATION: ACS 7-C19 X = 410171.36 Y = 1522006.02 GROUND TO GRID = 0.999647055 NEW MEXICO STATE PLANE COORDINATE SYSTEM CENTRAL ZONE CURVE TABLE CURVE RADIUS LENGTH DELTA CHORD BEARING CHORD LENGTH 44.06' 84'09'08" S41'46'09"E 30.00' 25.00' 39.27' 90'00'00" S44'41'35"E STATION: ACS HEAVEN X = 407051.31 Y = 1518737.03GROUND TO GRID = 0.99965263 DELTA ALPHA = -00'10'45" NEW MEXICO STATE PLANE COORDINATE SYSTEM CENTRAL ZONE

MONUMENT LEGEND

▲ - FOUND CONTROL STATION AS NOTED


 SET 1/2" REBAR W/RED PLASTIC CAP STAMPED "MWR 11224"

UNLESS OTHERWISE NOTED

FOUND MONUMENT AS NOTED

CARMEL AVENUE N.E.

PLAT OF
LOT 16-A, BLOCK 9, TRACT 2, UNIT 3
NORTH ALBUQUERQUE ACRES
PROJECTED SECTION 18, T. 11 N., R. 4 E., N.M.P.M.
ELENA GALLEGOS GRANT
CITY OF ALBUQUERQUE
BERNALILLO COUNTY, NEW MEXICO
SEPTEMBER 2006
SHEET 2 OF 2

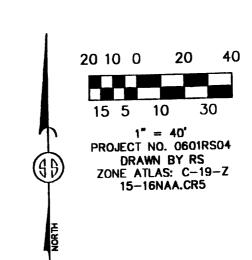

SURVEYS SOUTHWEST LTD.

333 LOMAS BLVD., N.E. ALBUQUERQUE, NEW MEXICO 87102 PHONE: (505) 998-0303 FAX: (505) 998-0306

T11N R4E SEC. 18

CARMEL AVENUE N.E. 60' RIGHT-OF-WAY (300.00') 299.69' (\$90°00'00"E) \$89°41'35"E 20,808.72 SO TT. ADDITIONAL PUBLY STREET ARECOVER OF WAY DEBICATED TO THE BITY OF ALBEIOUER OF HIS FLAT \$83.50.43"E /S89'41'35"E /108.57' S89'00'56"E N89'41'35'W 63.26 1155.00 53.19 LOT 16 LOT 15 WYOMING BOULEVARD 107.7' RIGHT-OF-WAY LOT 14, BLOCK 9 NORTH ALBUQUERQUE Lot 16-A ACRES TRACT 2, UNIT 3 FILED 9-10-1931 BLOCK 9 1.8198 ACRES(GROSS) 1.0940 ACRES(NET) (D1, 20) 24' PRIVATE ACCESS ESMT. (GRANTED BY THIS PLAT) 48,00 251.69 NB9'41'35"W 495.61' (485.00') 299.69' (300.00') FND #4 REBAR W/CAP LS10283 N89'41'35"W FND #4 REBAR (N90'00'00"W) LOT 17, BLOCK 9 NORTH ALBUQUERQUE LOT 18, BLOCK 9 NORTH ALBUQUERQUE ACRES TRACT 2, UNIT 3 TRACT 2, UNIT 3 FILED 9-10-1931 FILED 9-10-1931 (D1, 20) (01, 20) STATION: ACS 7-C19 X = 410171.36 Y = 1522006.02 GROUND TO GRID = 0.999647055 NEW MEXICO STATE PLANE COORDINATE SYSTEM CENTRAL ZONE DELTA CHORD BEARING CHORD LENGTH CURVE RADIUS LENGTH 84'09'08" S41'46'09"E 44.06 30.00' S44'41'35"E 90'00'00" 39.27 25.00 STATION: ACS HEAVEN X = 407051.31 Y = 1518737.03 GROUND TO GRID = 0.99965263 DELTA ALPHA = -00'10'45" NEW MEXICO STATE PLANE COORDINATE SYSTEM CENTRAL ZONE MONUMENT LEGEND


 SET 1/2" REBAR W/RED PLASTIC CAP STAMPED "MWR 11224" UNLESS OTHERWISE NOTED

☐ - FOUND MONUMENT AS NOTED

PLAT OF

LOT 16-A, BLOCK 9, TRACT 2, UNIT 3
NORTH ALBUQUERQUE ACRES
PROJECTED SECTION 18, T. 11 N., R. 4 E., N.M.P.M.
ELENA GALLEGOS GRANT
CITY OF ALBUQUERQUE
BERNALILLO COUNTY, NEW MEXICO
SEPTEMBER 2006
SHEET 2 OF 2

PRELIMINARY PLAT
APPROVED BY DRB
ON_10/18/06

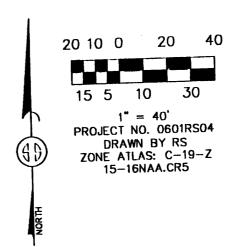

SURVEYS SOUTHWEST LTD.

333 LOMAS BLVD., N.E. ALBUQUERQUE, NEW MEXICO 87102 PHONE: (505) 998-0303 FAX: (505) 998-0306

T11N R4E SEC. 18

TALOS LOG # 2006-4024-98 NOR ESTE 2 SECTOR DEVELOPMENT AMAPGA-1 AMAFCA DOMINGO LA CUEVA SU-1 PRD (20 ACRES R-D R-T CARMEL D VILLAGE (UNIT 1) SU-27 CUEVA N.T.S. PASEO CENTER su+2/ MIXED USE ALPTACE ZONE ATLAS: C-19-Z PASEO DEL NORTE DEL RANCHO DE PALOMAS

Vicinity Map

SUBDIVISION DATA / NOTES

- 1. PLAT WAS COMPILED USING EXISTING RECORD DATA & ACTUAL FIELD SURVEY.
- 2. BEARINGS ARE NEW MEXICO STATE PLANE GRID BEARINGS, CENTRAL ZONE, NAD 1927, AND ARE BASED ON ACS CONTROL MONUMENTS HEAVEN AND 7-C19, AS SHOWN HEREON.
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- 6. GROSS AREA: 1.8198
- 7. NUMBER OF EXISTING LOTS: 2
- 8. NUMBER OF LOTS CREATED: 1
- 9. THE PRIVATE ACCESS EASEMENT IS FOR THE BENEFIT AND USE BY AND FOR THE OWNER OF LOT 16-A AND IS TO BE MAINTAINED BY SAID OWNER.
- 10. PROPERTY IS ZONED SU-2.

LEGAL DESCRIPTION

Lots numbered Fifteen (15) and Sixteen (16) in Block numbered Nine (9) plat of Tract 2, Unit 3, North Albuquerque Acres as the same is shown and designated on the plat thereof, filed in the Office of the County Clerk of Bernalillo County, New Mexico in September 10, 1931 in Volume D1, folio 20 being more particularly described as follows: Commencing at City of Albuquerque Control station "HEAVEN" having New Mexico State Plane NAD 1927 Central Zone Grid Coordinates of X = 407,051.31, Y = 1,518,737.03 a ground to grid factor of 0.99965263 and a delta alpha of -00° 10′ 45"; thence N 11° 39' 57" E, a distance of 875.23 feet to the POINT OF BEGINNING being the southwest corner of said Lot 15; thence N 00° 18' 25" E, a distance of 264.51 feet; thence S 89° 41' 35" E, a distance of 299.69 feet; thence S 00° 18' 25" W, a distance of 264.51 feet; thence N 89° 41' 35" W, a distance of 299.69 feet to the POINT OF BEGINNING and containing 1.8198 acres more or less.

FREE CONSENT

THE UNDERSIGNED OWNER(S) AND PROPRIETOR(S) OF THE PROPERTY DESCRIBED HEREON DO HEREBY CONSENT TO THE PLATTING OF SAID PROPERTY AS SHOWN HEREON AND THE SAME IS WITH THE FREE CONSENT AND IN ACCORDANCE WITH THEIR DESIRES AND SAID OWNERS WARRANT THAT THEY HOLD COMPLETE AND INDEFEASIBLE TITLE IN FEE SIMPLE TO THE LAND SUBDIVIDED, DO HEREBY GRANT ADDITIONAL EASEMENT(S) AS SHOWN AND DO HEREBY DEDICATE ADDITIONAL STREET RIGHT-OF-WAY TO THE CITY OF ALBUQUERQUE IN FEE SIMPLE.

OWNER(S) SIGNATURE: OWNER(S) PRINT NAME: David M. James

ADDRESS: ACKNOWLEDGMENT

STATE OF OKLA COUNTY OF TUSA

BY: DAVID M. JAMES MY COMMISSION EXPIRES:

11-04-08

PLAT OF LOT 16-A, BLOCK 9, TRACT 2, UNIT 3 NORTH ALBUQUERQUE ACRES

PROJECTED SECTION 18, T. 11 N., R. 4 E., N.M.P.M. **ELENA GALLEGOS GRANT** CITY OF ALBUQUERQUE BERNALILLO COUNTY, NEW MEXICO SEPTEMBER 2006 SHEET 1 OF 2

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CITY APPROVALS: PROJECT NO.:	APPLICATION NO.
11/1 B Hant	9-27-00
CITY SURVEYOR	DATE
TRAFFIC ENGINEERING	DATE
PARKS & RECREATION DEPARTMENT	DATE
WATER UTILITIES DEVELOPMENT	DATE
A.M.A.F.C.A.	DATE
	DATE
CITY ENGINEER	DATE
DOD CHAIRPERSON PLANNING DEPARTMENT	DATE

SURVEYOR'S CERTIFICATION

I, Mitchell W. Reynolds, a duly qualified Registered Professional Land Surveyor under the laws of the State of New Mexico, do hereby certify that this plat and description were prepared by me or under my supervision, shows all easements as shown on the plat of record or made known to me by the owners and/or proprietors of the subdivision shown hereon, utility companies and other parties expressing an interest and meets the minimum requirements for monumentation and surveys of the Albuquerque Subdivision Ordinance, and further meets the Minimum Standards for Land Surveying in the State of New Mexico and is true and correct to the best of my knowledge and belief.

New Mexico Professional Surveyor, 11224

SURVEYS SOUTHWEST LTD.

333 LOMAS BLVD., N.E. ALBUQUERQUE, NEW MEXICO 87102

PHONE: (505) 998-0303 FAX: (505) 998-0306


T11N R4E SEC.

THIS IS TO CERTIFY THAT TAXES ARE CURRENT & PAID ON

BERNALILLO COUNTY TREASURER'S OFFICE:

PROPERTY OWNER OF RECORD:

PROJECT NO. 0601RS04 DRAWN BY RS ZONE ATLAS: C-19-Z 15-16NAA.CR5

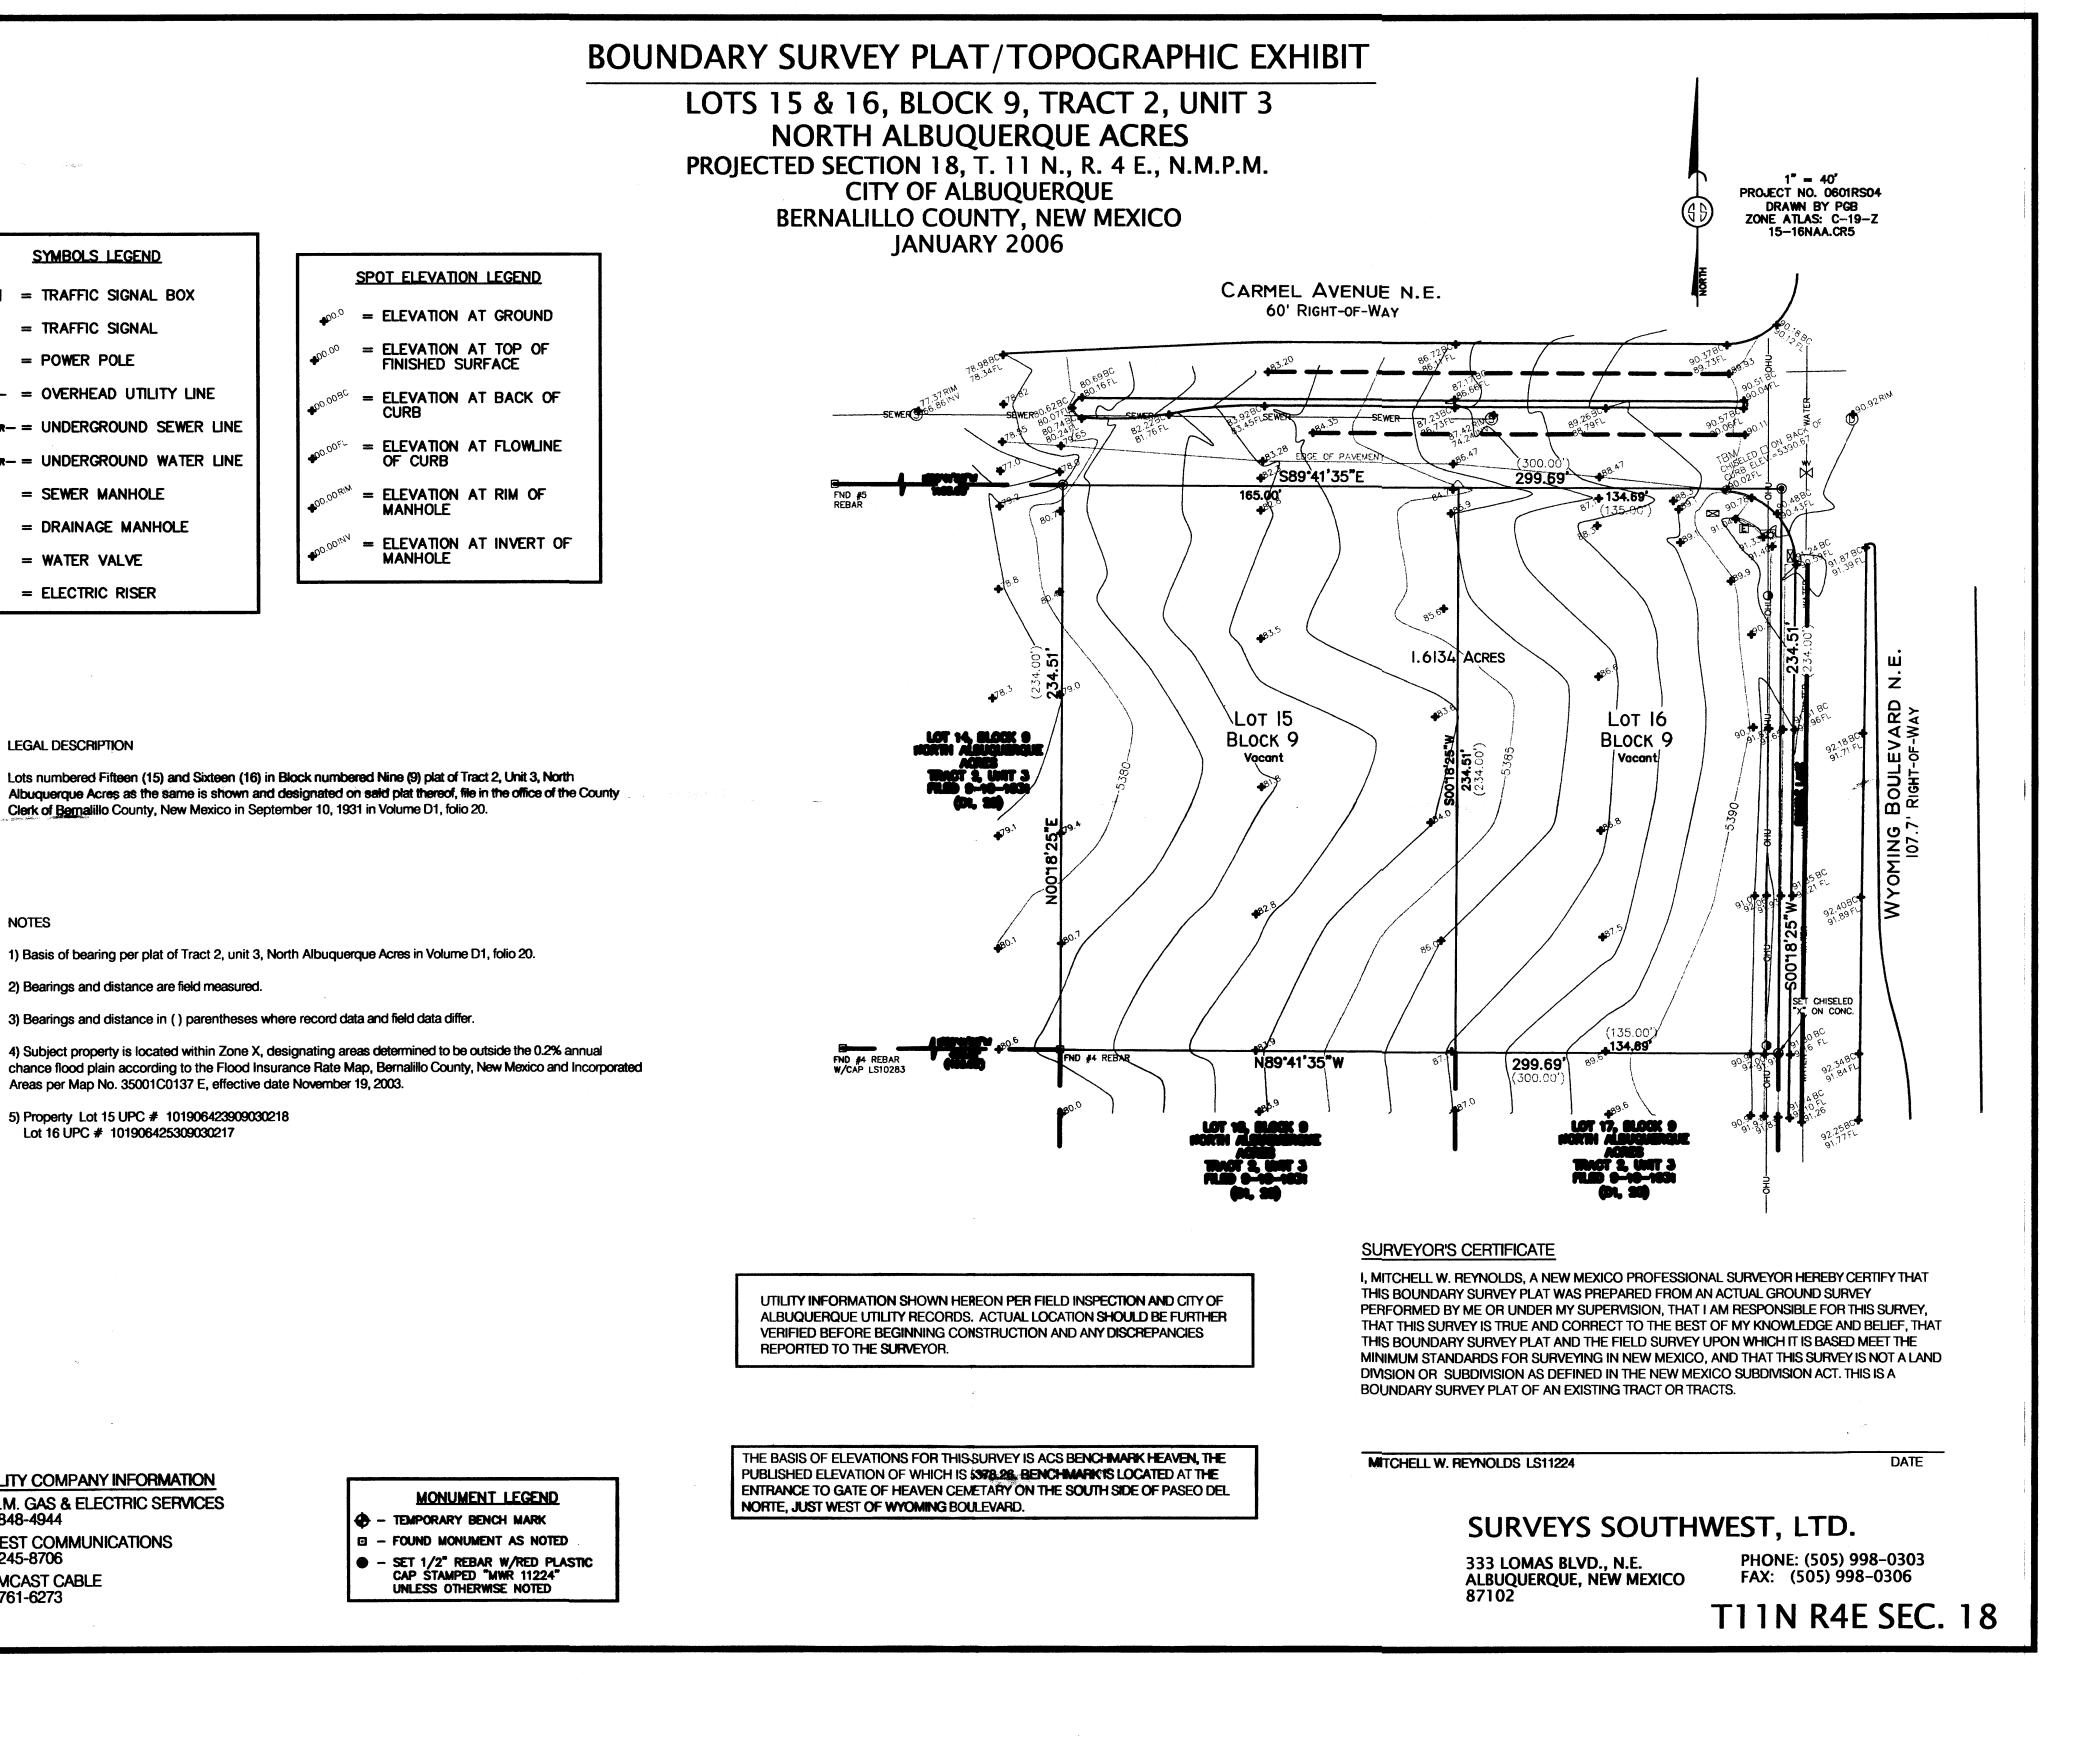

= TRAFFIC SIGNAL BOX

SYMBOLS LEGEND

• = TRAFFIC SIGNAL

 = POWER POLE -anu- = OVERHEAD UTILITY LINE

-sewer- = UNDERGROUND SEWER LINE

-water- = UNDERGROUND WATER LINE

S = SEWER MANHOLE

DRAINAGE MANHOLE

₩ = WATER VALVE

= ELECTRIC RISER

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2) Bearings and distance are field measured.


3) Bearings and distance in () parentheses where record data and field data differ.


4) Subject property is located within Zone X, designating areas determined to be outside the 0.2% annual chance flood plain according to the Flood Insurance Rate Map, Bernalillo County, New Mexico and Incorporated Areas per Map No. 35001C0137 E, effective date November 19, 2003.

5) Property Lot 15 UPC # 101906423909030218 Lot 16 UPC # 101906425309030217

UTILITY COMPANY INFORMATION P.N.M. GAS & ELECTRIC SERVICES 848-4944 **QWEST COMMUNICATIONS**

245-8706 COMCAST CABLE 761-6273

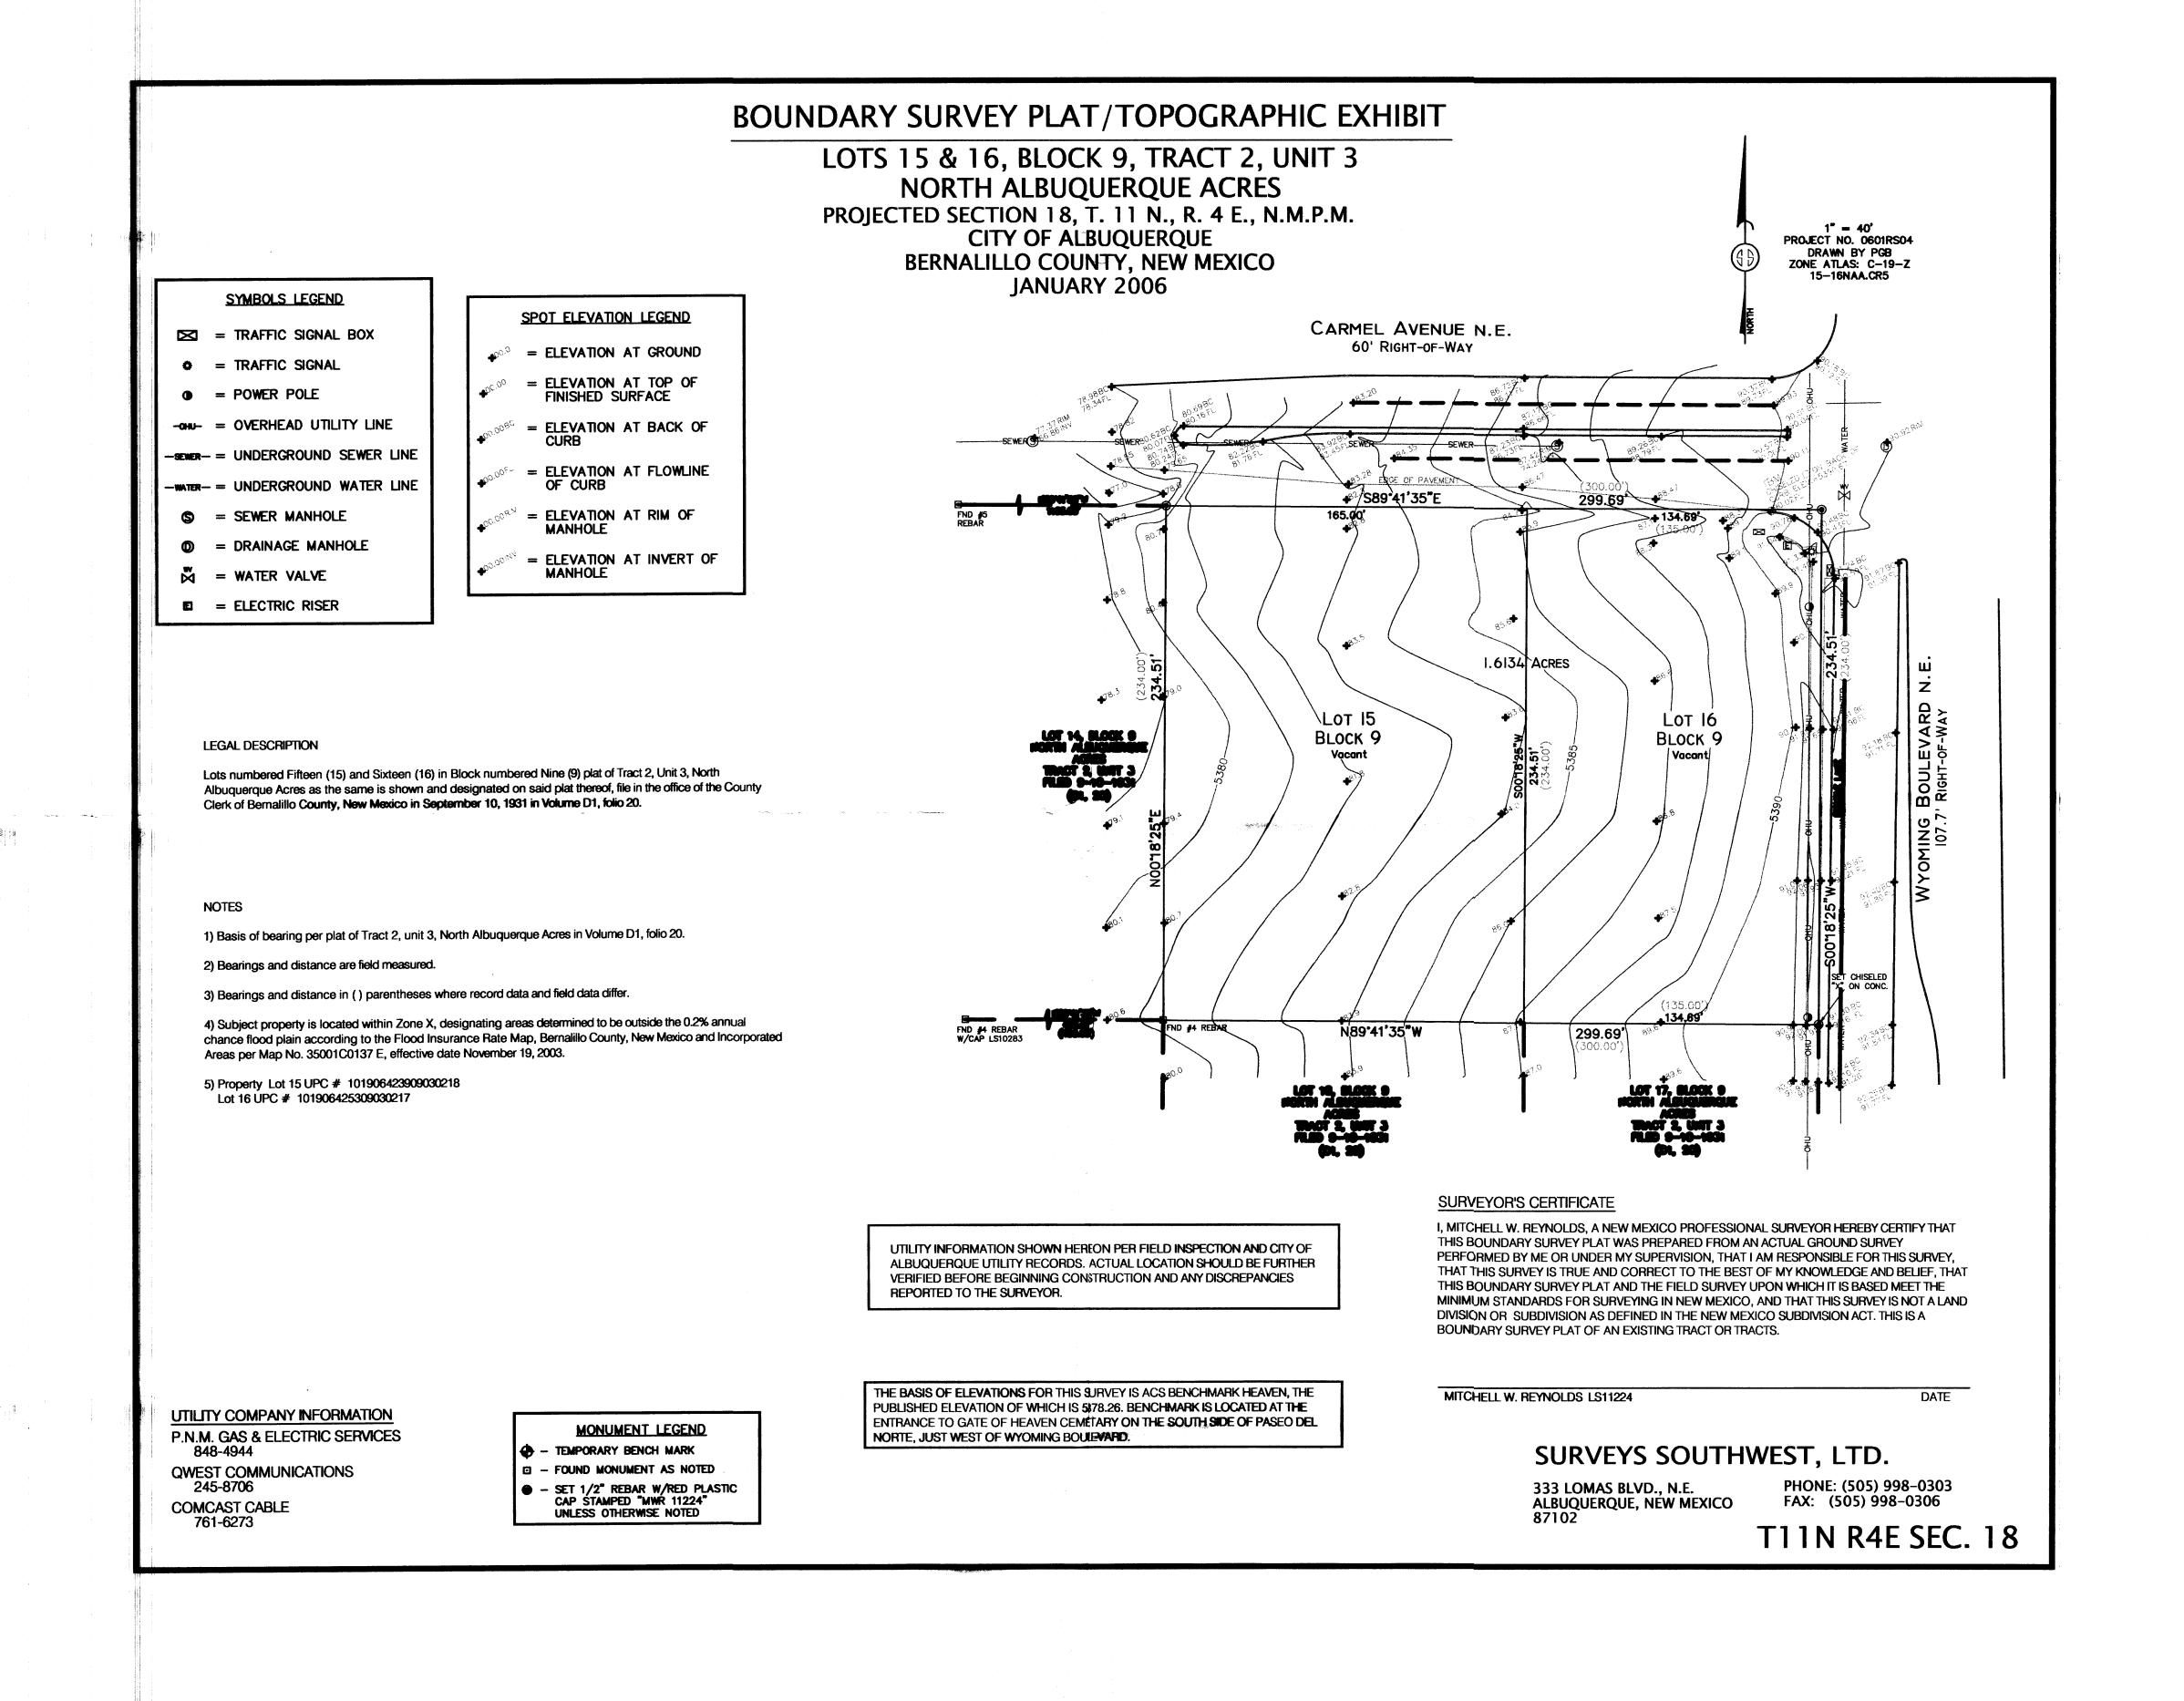

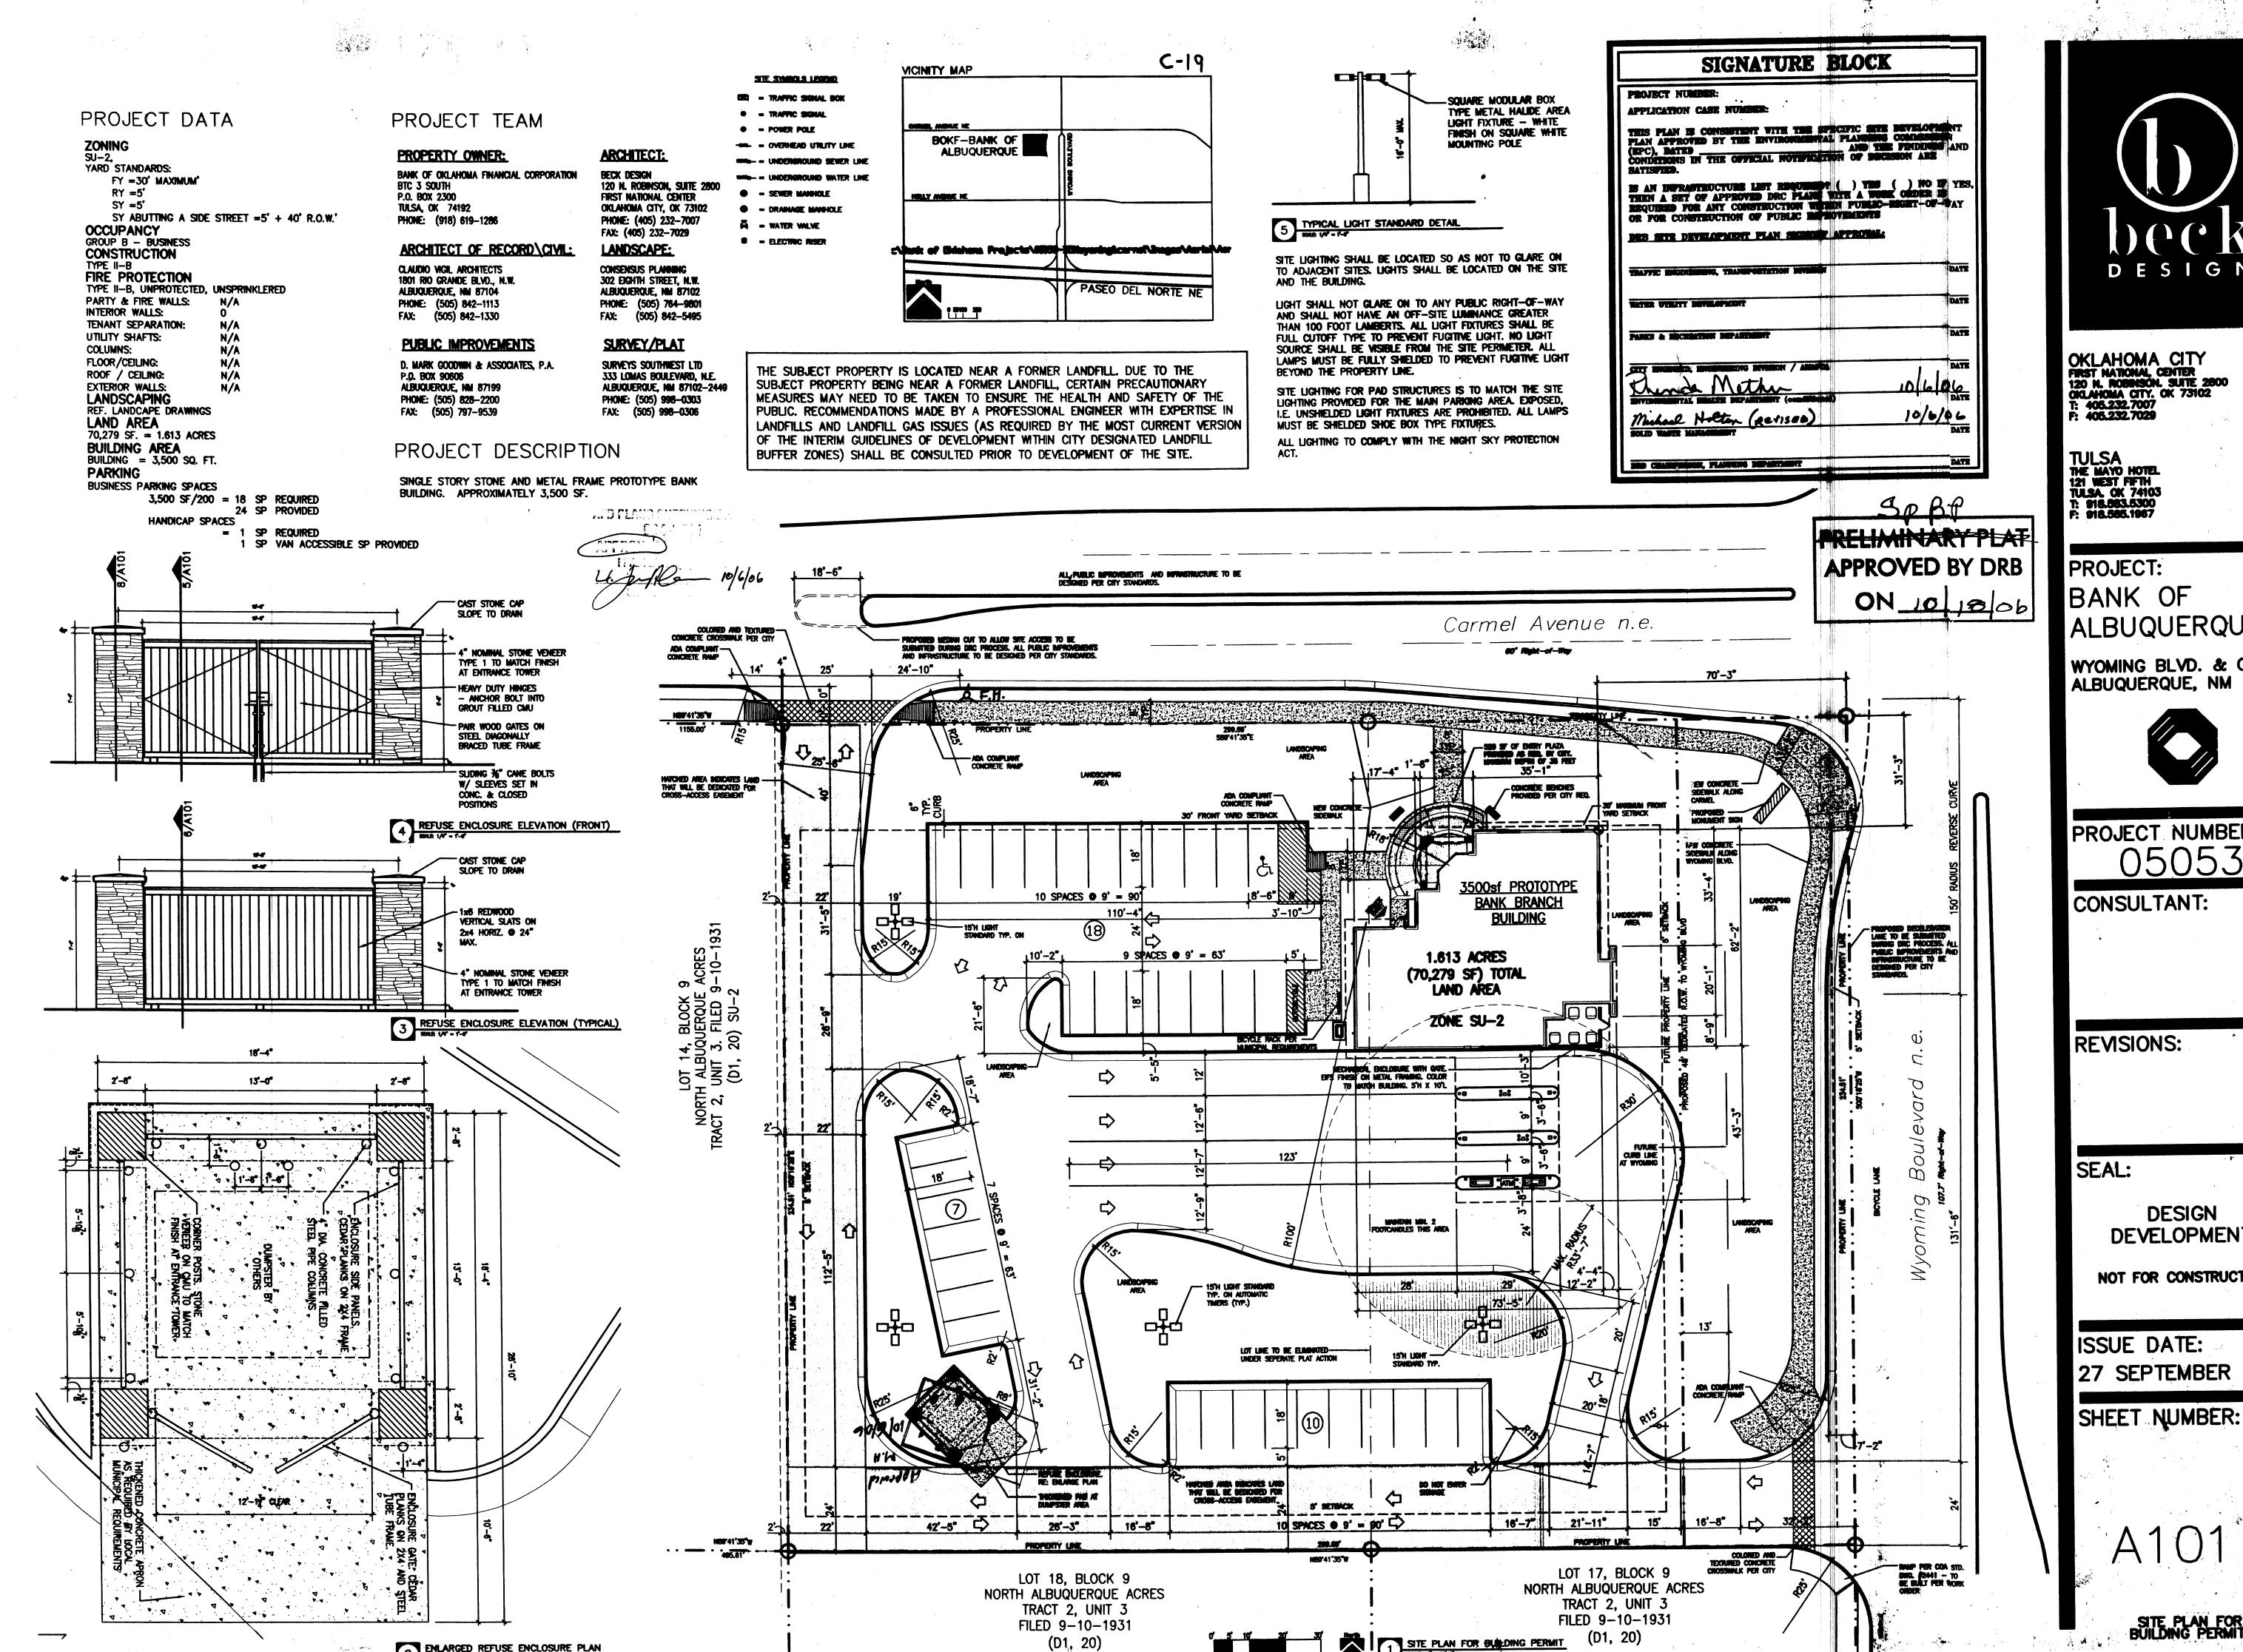

ENLARGED REFUSE ENCLOSURE PLAN



OKLAHOMA CITY
FIRST NATIONAL CENTER
120 N. ROBINSON. SUITE 2800
OKLAHOMA CITY. OK 73102
T: 405.232.7007
F: 405.232.7029

ALBUQUERQUE

WYOMING BLVD. & CARMEL ALBUQUERQUE, NM




PROJECT NUMBER: 05053


DESIGN DEVELOPMENT

NOT FOR CONSTRUCTION

27 SEPTEMBER 2006

SITE PLAN FOR BUILDING PERMIT

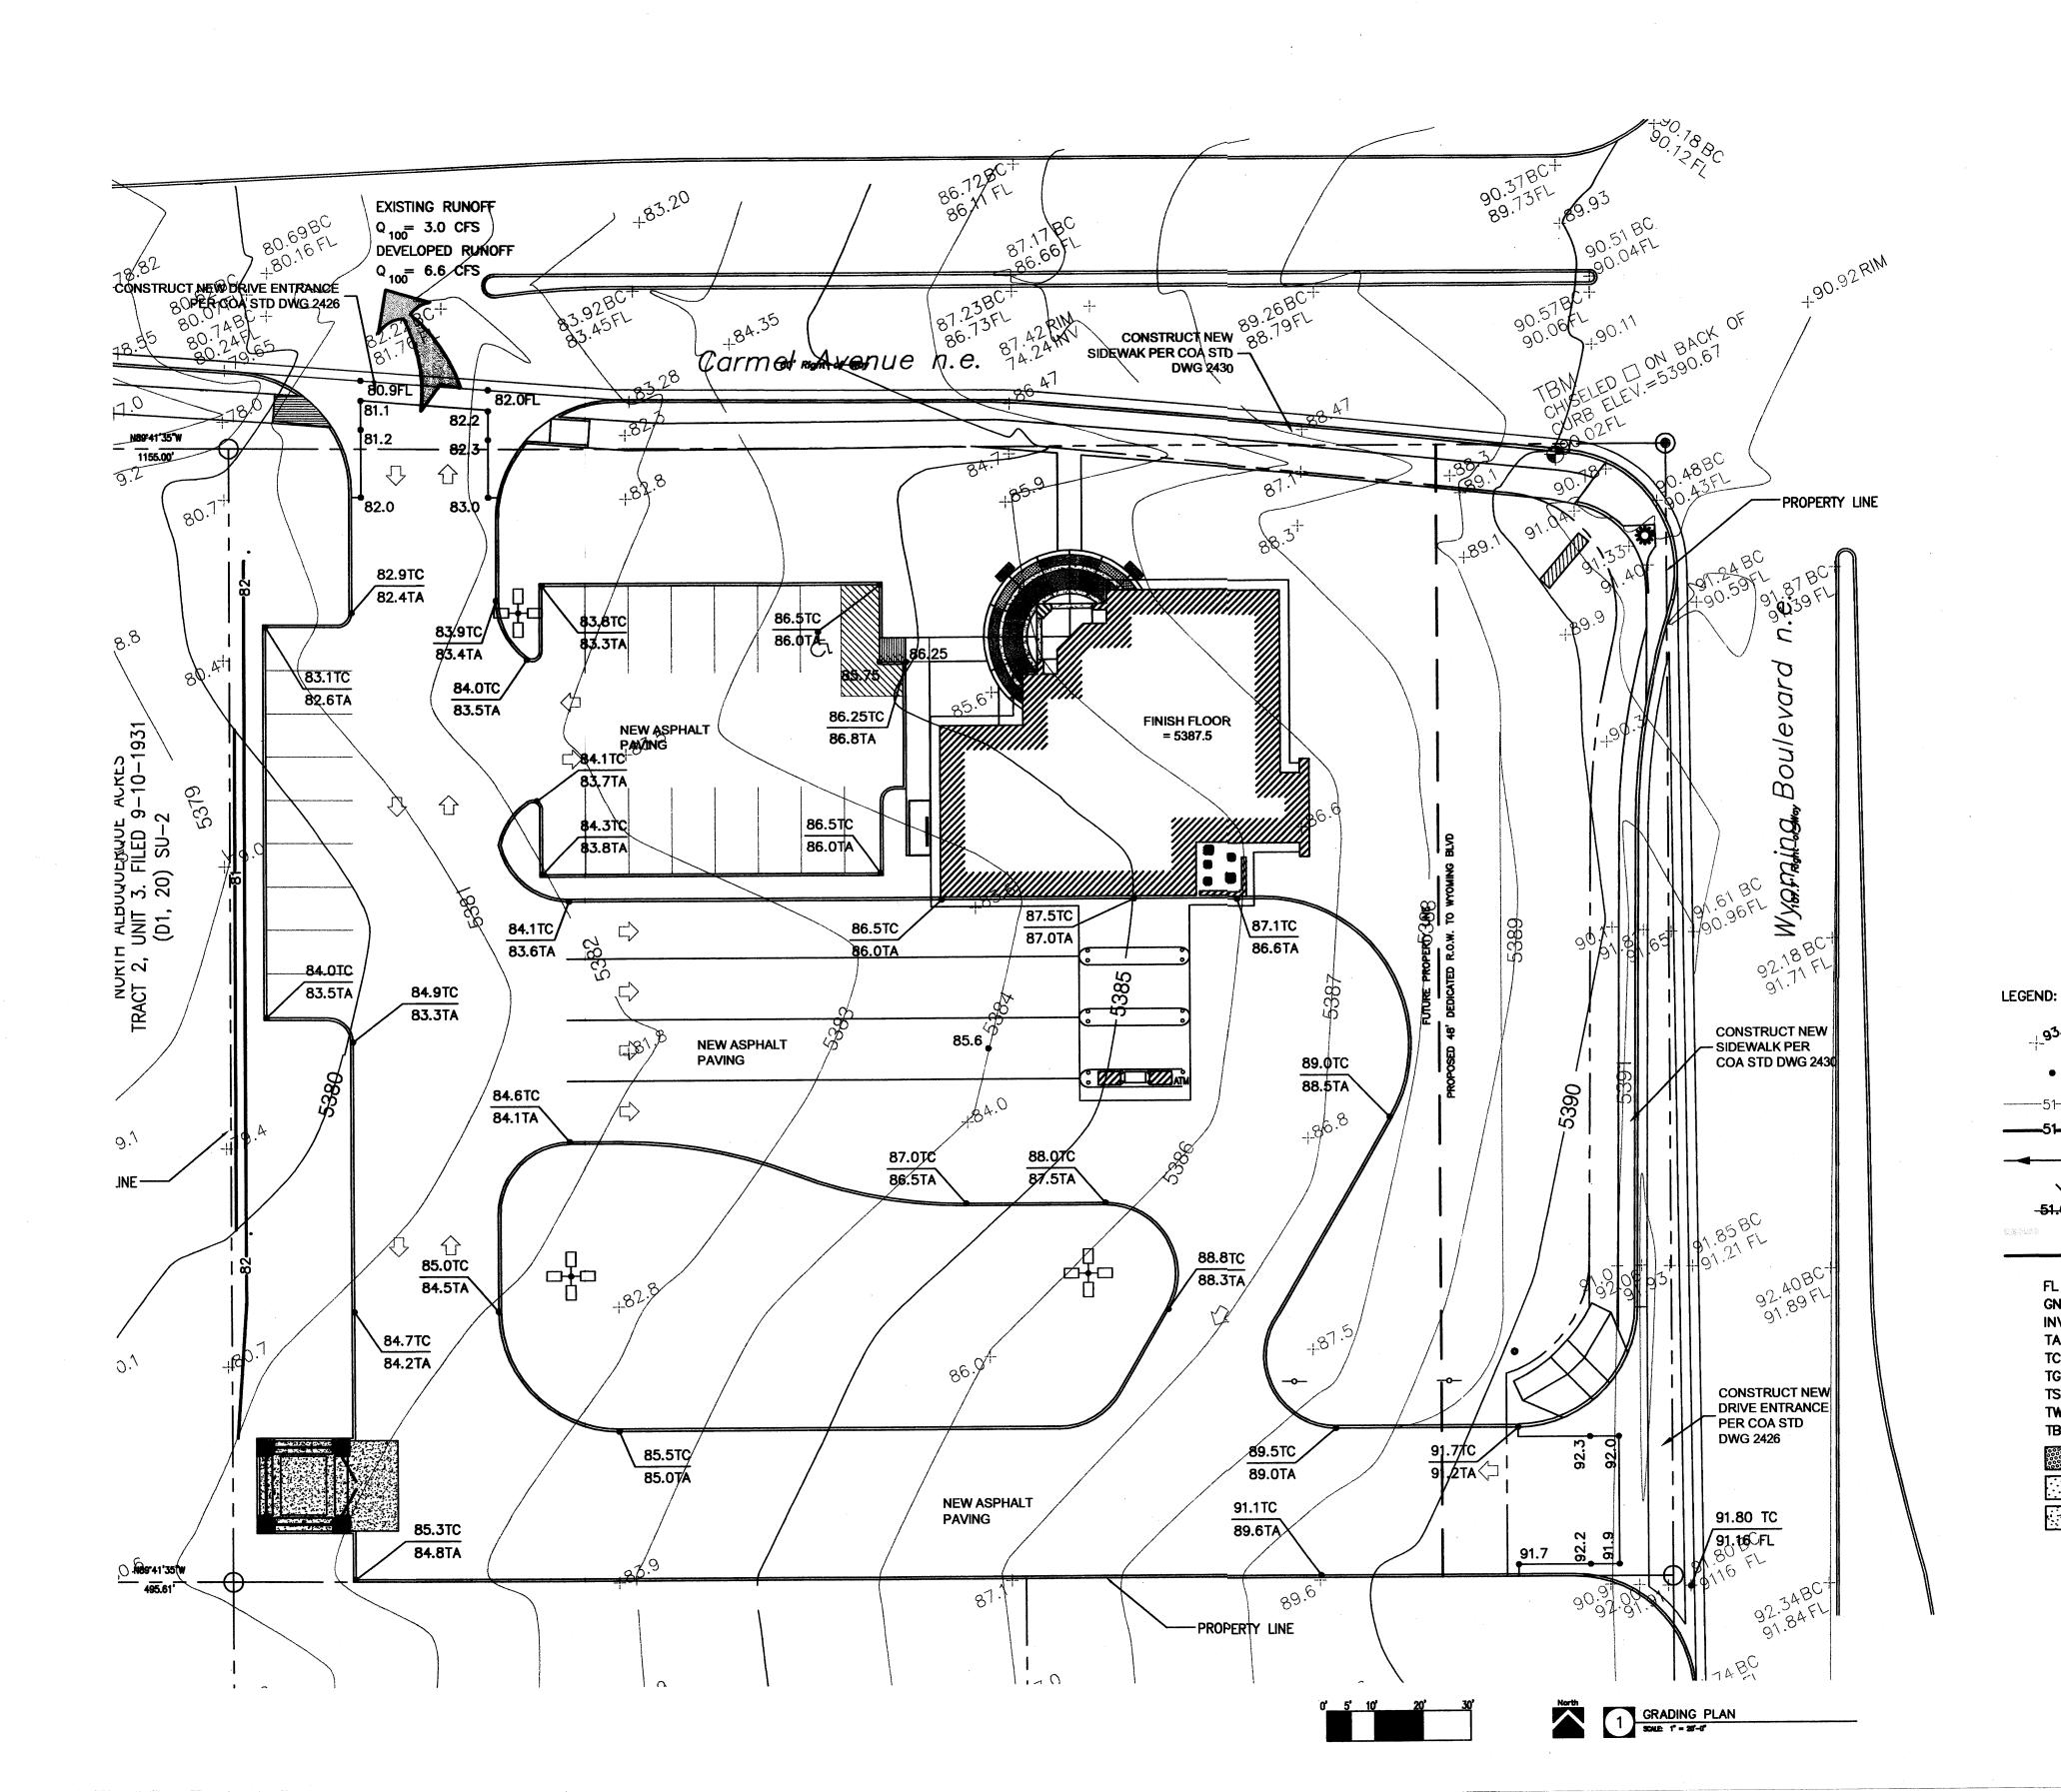

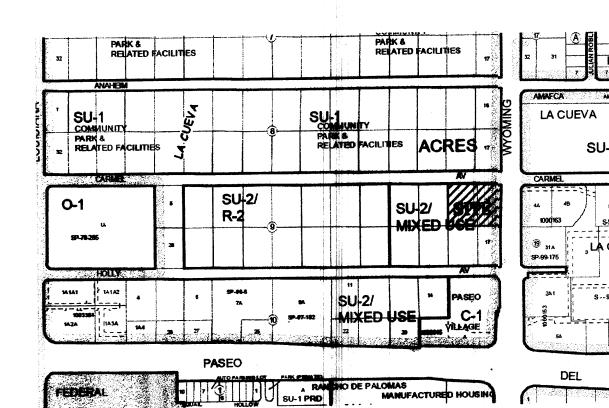

8400_FIRESTONE ROAD

LEGAL DESCRIPTION:
LOTS 15 & 16, BLOCK 9, TRACT 2, UNIT 3 NORTH ALBUQUERQUE ACRES

VICINITY MAP - C19 D-5

SCALE: NONE

DRAINAGE PLAN

THE PROPOSED IMPROVEMENTS AS SHOWN BY THE VICINITY MAP, ARE LOCATED WEST OF WYOMING BOULEVARD NORTH OF PLASO DEL MERTE, ON THE SOUTH WEST CORNER OF THE INTERSECTION OF WYOMING BLVD. AND CARMEL AVE. THE SITE IS UNDEVELOPED AND SLOPES FROM EAST TO WEST AT AN APPROVIMENTE SLOPE OF 4.0%. PER MAP NO. 35001C0137 E, THE SITE DOES NOT LIE WITHIN A FLOOD HAZARD ZONE. THE SITE IS HIGHER THAN THE LANDS TO THE WEST. THE LANDS TO THE NORTH AND SOUTH SLOPE FROM WEST TO EAST. THE EXISTING CURB AND GUTTER ALONG WYOMING BLVD. TO THE EAST BLOCKS FLOWS FORM THAT DIRECTION THEREFORE OFFSITE FLOWS ARE CONSIDERED INSIGNIFICANT.

THE PROPOSED SITE LIES WITHIN THE NORTH ALBUQUERQUE ACRES SUBDIVISION. THE PROPOSED IMPROVEMENTS CONSIST OF A NEW BANK BUILDING WITH ASSOCIATED PARKING AND LANDSCAPING. AS SHOWN BY THE CALCULATION THE PROPOSED DEVELOPMENT WILL INCREASE THE RATE AND VOLUME OF RUNOFF. THE PROPOSED RATE OF DISCHARGE IS 6.6 CFS (4.1 CFS/ACRE). THE DEVELOPED RUNOFF FROM THE SITE ARE TO BE DIRECTED TO THE PROPOSED DRIVE ENTRANCE ON CARMEL AVE. NO PONDING IS ANTICIPATED FOR THE SITE.

THE CALCULATIONS ANALYZE THE EXISTING AND PROPOSED CONDITIONS FOR 6-HOUR, 100 YEAR RAINFALL EVENT. THE ANALYSIS IS IN ACCORDANCE WITH THE CITY OF ALBUQUERQUE DEVELOPMENT PROCESS MANUAL VOLUME II.

<u>CALCULATIONS</u> PRECIPITATION ZONE = 3 TOTAL SITE AREA = 1.613 ACRES

EXISTING CONDITIONS LAND TREATMENT A=100%

E = 0.66(1.00) = 0.66 INCHES V = 0.66(1.613) / 12 = 0.089 ACRE FEET

Q = 1.87(1.00) (1.613) = 3.0 CFS

DEVELOPED CONDITIONS

LAND TREATMENT B=44% D=56% E = 0.912(0.44) + 2.36(0.56) = 1.73 INCHES

V = 1.73 (1.613) / 12 = 0.233 ACRE FEET Q = [2.60](0.44) + 5.25(0.56)](1.613) = 6.6 CFS

Q =6.6/1.613=4.1 CFS/ACRE INCREASE IN VOLUME OF RUNOFF = 0.144 ACRE FT INCREASE IN RATE OF RUNOFF = 3.6 CFS

CONSTRUCTION NOTES

EXISTING SPOT ELEVATION

• 51.00 NEW SPOT ELEVATION

EXISTING CONTOUR

VERIFIED ELEVATION

AS BUILT ELEVATION

BASIN BOUNDARY

TOP OF ASPHALT

TOP OF CONCRETE SLAB

TEMPORARY BENCH MARK

TOP OF CURB

TOP OF GRATE

TOP OF WALL

ASPHALT PAVING

GRAVEL

CONCRETE

PROPERTY LINE

FLOW LINE

GROUND

INVERT

- 1. TWO WORKING DAYS PRIOR TO ANY EXCAVATION, THE CONTRACTOR SHALL CALL FOR
- LOCATION OF EXISTING UTILITIES. 2. ALL WORK WITHIN THE CITY RIGHT-OF-WAY SHALL BE PERFORMED IN ACCORDANCE WITH
- THE APPLICABLE CITY OF ALBUQUERQUE STANDARDS AND PROCEDURES.
- 3. ALL WORK SHALL BE PERFORMED IN ACCORDANCE WITH THE APPLICABLE FEDERAL, STATE, AND LOCAL REGULATIONS, LAWS, AND RULES CONCERNING SAFETY AND HEALTH. 4. PRIOR TO CONSTRUCTION THE CONTRACTOR SHALL VERITY THE EXISTING SITE CONDITIONS AND INFORM THE ARCHITECT/ ENGINEER OF ANY DISCREPANCY BETWEEN THE
- 5. THE CONTRACTOR SHALL PROVIDE THE ARCHITECT / ENGINEER WITH AN AS BUILT SURVEY FOR ENGINEER'S CERTIFICATION.

INFORMATION SHOWN ON THE PLANS AND THOSE OF THE EXISTING SITE.

- 6. THE CONTRACTOR SHALL MAINTAIN A RECORD DRAWING SET OF PLANS AND PROMPTLY LOCATE EXISTING AND NEW ELEVATIONS (FINISH FLOORS, TOPS OF CURBS AND ASPHALT, FLOW LINE, PIPE INVERTS, ETC.), ON THE RECORD SET. THE RECORD SET SHALL BE MAINTAINED ON THE PROJECT SITE AND SHALL BE AVAILABLE TO THE OWNER AND ARCHITECT AT ANY TIME DURING CONSTRUCTION. UPON COMPLETION OF THE PROJECT, THE RECORD SET SHALL BE TURNED OVER TO THE OWNER.
- 7. THE OWNER / CONTRACTOR SHALL SUBMIT A NOTICE OF INTENT (NOI) TO THE EPA PRIOR TO BEGINNING OF CONSTRUCTION.
- 8. CONTRACTOR SHALL COMPLY WITH STORM WATER POLLUTION PREVENTION PLAN (SWPPP) SPECIFIC TO THIS PROJECT.
- 9. ALL POND BOTTOMS SHALL RECEIVE GRAVEL AND FILTER FABRIC SEE LANDSCAPE PLAN.
- 10. THE BASIS OF ELEVATIONS FOR THIS SURVEY IS ACS BENCHMARK HEAVEN, THE PUBLISHED ELEVATION OF WHICH IS 5378.28 BENCHMARK IS LOCATED AT THE ENTRANCE TO GATE OF HEAVEN CEMETARY ON THE SOUTH SIDE OF PASEO DEL NORTE, JUST WEST OF WYOMING BOULEVARD.

FACILITY ACCESSIBILITY

ALL SURFACES ALONG THE ACCESSIBLE ROUTE SHALL COMPLY WITH ANSI A117-1998.

WALKING SURFACES SHALL BE STABLE, FIRM, AND SLIP RESISTANT. THE RUNNING SLOPE OF WALKING SURFACES SHALL NOT BE STEEPER THAN 1:20 WITH A CROSS SLOPE NOT STEEPER

CURB RAMP AND RAMP RUNS SHALL HAVE A RUNNING SLOPE NOT STEEPER THAN 1:12 WITH A CROSS SLOPE NOT STEEPER THAN 1:48. COUNTER SLOPES OF ADJOINING GUTTERS AND ROAD SURFACES IMMEDIATELY ADJACENT TO THE CURB RAMP OR ACCESSIBLE ROUTE SHALL NOT BE STEEPER THAN 1:20. TRANSITIONS FROM RAMPS TO WALKS, GUTTERS OR STREETS SHALL BE AT THE SAME LEVEL. WHERE PEDESTRIANS MUST WALK ACROSS A CURB RAMP, THE RAMP SHALL HAVE FLARED SIDES WITH SUOPES NOT STEEPER THAN 1:10: WHERE THE TOP OF THE RAMP PARALLEL TO THE RUN OF THE RAMP IS LESS THAN 48 INCHES WIDE, THE FLARED SIDES SHALL HAVE A SLOPE NOT STEEPER THAN 1:12.

HANDICAP PARKING SPACES AND ACCESS AISLES SHALL HAVE SURFACE SLOPES NOT STEEPER THAN 1:48. ACCESS AISLES SHALL BE AT THE SAME LEVEL AS THE PARKING SPACES THEY SERVE.

THE CONTRACTOR SHALL PROVIDE ALL REQUIRED TRAFFIC CONTROL PLANS AND DEVICES. ALL SIGNS, BARRICADES, CHANNELIZATION DEVICES, SIGN FRAMES AND ERECTION OF SUCH DEVICES SHALL CONFORM THE THE REQUIREMENTS OF THE "MANUAL OF UNIFORM TRAFFIC CONTROL DEVICES FOR STREETS AND HIGHWAYS" LATEST EDITION. PRIOR TO CONSTRUCTION PRIOR TO CONSTRUCTION, THE TRAFFIC CONTROL PLAN SHALL BE SUBMITTED AND APPROVED BY THE



OKLAHOMA CITY FIRST NATIONAL CENTER 120 N. ROBINSON, SUITE 2800 OKLAHOMA CITY. OK 73102 T: 405.232.7007 F: 405.232.7029

TULSA
THE MAYO HOTEL
121 WEST FIFTH
TULSA. OK 74103
T: 918.583.5300 F: 918.585.1967

PROJECT: BANK OF ALBUQUERQUE

WYOMING BLVD. & CARMEL ALBUQUERQUE, NM



PROJECT NUMBER:


CONSULTANT:



CLAUDIO VIGIL **ARCHITECTS**

REVISIONS:

SEAL:

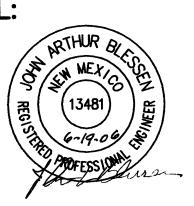

ISSUE DATE: JUNE 15, 2006

SHEET NUMBER:

GRADING PLAN FOR APPROVAL FOR DRB ACTION

Carmel Avenue n.e.

STEEL HEADER-- SEE DETAIL 3

 \Rightarrow

5,040 SF

I ANDSCAPE PAI ETTE

Symbol	Botanical Name / Common Name	Mature Size Water Use	Symbol	Botanics Name / Common Name	Mature Water
	Trees		$\langle \rangle$	Perovskie atriplicifolia	60' x (
(2)	Cercis reniformis 'Oklahoma' Oklahoma Redibud	25' x 25' Med ium	V	Ruelah Sage	Medium
O			\bigcirc	Potentille fruticosa	36" x 3 Medium
\otimes	Chilopsis linearis 'Lucretia Hamilton' Desert Willow	20' x 25' Lou+		Shrubby Cinquefoll	
•			•	Rhue archatica 'Gro-Lou' Prostrata Sumac	24" x 4 Low+
₩	Chitalpa tashkentensis 'Pink Daun' Chitalpa	30' x 30' Me clium	_		
_	•	15' x 15'	\odot	Rhus tribibata Three-tenif Sumac	48" x 6 Low+
\oplus	Forestieri neomexicānā New Mexico Olive	Me dium			24' × 6
α	Robinia x ambigua	35' × 30'	©	Roemarinus officinalis Prostratus Rosemary	Low+
	Purple Robe Locust	Medium+			36' x 3
xtx	Pinus elda rica	40' x 35'	\oplus	Salvia greggii Cherry sage	Medium
女	Afghan Pine	Me dium			·
	Quercus buckleyi	25' × 25'		Omangetal Grasses	4.01
	Texas Red Oak	Medium	₩	Miscentine singnéls Malden Hair Grass	60' x Medium
$\left(\cdot \right)$	Tilia cordata	40' x 30'	A1100		36' x 4
	Littl eleaf Li nden	Me dium		Nolina microcarpa Bear Grace	Medium
_	Shrubs/Groundcovers	36' × 30'			
\circ	Artemisia 'Powis Castle' Powis Castle Sage	Medium		Accents	
_	•	24" × 60"		Dasylition wheeleri Sotol	48" x 6 Low
\circ	Baccharie 'Starn Thompson' Dwarf Coyotebush	Low			241
	Buddleia davidii Nanhoensis'	48' × 36'	*	Hesperatos parviflora Red/Tellou Flouering Yucca	36'x : Mediur
\odot	Butterfly Bush	Medium			
	Caesalpina gillesii	96' × 12'	***	Native Grass/Wildflower Seed Mix	Low
\odot	Bird of Paradise	Lou	نننا		
•	Caryopteris clandonensis	48" × 48"			
€	Blue Mist	Lou			
\bigcirc	Chrysothamnus nauseosus	60' × 60'			
\odot	Chamisa	Low			
8	Cytisus x 'Lena'	24' × 36'		•	
•	Lena's Broom	Lou			
\odot	Ericameria laricifolia	36' x 42'			

LANDSCAPE CALCULATIONS

Blanket Flower

Total Site Area:	(161 acres) 10219 SF
Building Area:	3,500 SF
Net Area:	66,779 SF
Required Landscape Area (15% of Net Area):	10,117 SF
Provided Landscape Area: (40%)	23,272 S F
On-site - 16,868 SF	
ROW 6,404 SF	

All shrub planting areas shall be top dressed with 1/8" Santa Fe Brown Rock Mulch 2" - 4" Santa Ana Tan Cobbie will be used as an accent mulch in certain areas.

IRRIGATION SYSTEM
Irrigation system standards outlined in the Water Conservation Landscaping and Water Wasts Ordinance
shall be strictly adhered to. A fully automated drip irrigation system will be used to irrigate tree, shrub and
groundcover planting areas. A temporary spray system will be used to establish the native seaded area.
Upon establishment, the spray system will be used only on an as needed basis.

24' x 36'

MAINTENANCE RESPONSIBILITY

Maintenance of the landscaping and irrigation system, including those areas within the public ROW, shall be the responsibility of the Owner.

STATEMENT OF WATER WASTE
The Landscape Plan for the Bank of Albuquerque shall limit the provision of high water uses turf to a maximum of 20 percent of the required landscape area.



OKLAHOMA CITY
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TULSA
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121 WEST FIFTH
TULSA. OK 74103

T: 918.583.5300

PROJECT:

BANK OF ALBUQUERQUE

WYOMING BLVD. & CARMEL ALBUQUERQUE, NM

PROJECT NUMBER: 05053

CONSULTANT:

CONSENSUS PLANNING, NC.
Planning / Landscape Architecture
302 Eighth Street NW
Albuquerque, NM 87102
(505) 764-9801 Fax 842-5495
e-mail: cp@consensusplanning.com

REVISIONS:

SCHEMATIC DESIGN


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ISSUE DATE:

SEPTEMBER 22, 2006


SHEET NUMBER:

CONCEPTUAL LANDSCAPE PLAN

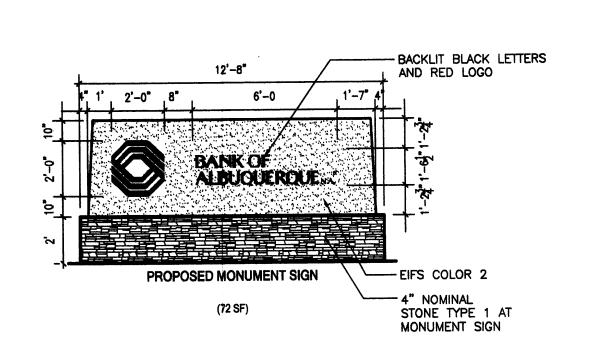

MONUMENT SIGN SOME 1/4" = 1'-0"

	EXTERIOR FINI	SH LEGEND	
MATERIAL	MANUFACTURER	DESCRIPTIO N	NO TES
DIVISION 4 - MASONRY			
STO NE VENEER TYPE 1	-	BUFF; GROUND FACE	MORTARCOLOR H10 LIGHT BUFF
PRE-FINISHED CONCRETE MASO NRY UNIT	NO RTHFIELD	BUFF; GRO UND FACE	MORTARCOLOR H10 LIGHT BUFF
DIVISION 5 - METALS	************************************		
TUBE STEEL BRACKET	SHERWIN WILLIAMS	LIGHT GRAY	PER SECTION 09900
PAINTED STEEL COLUMN AND LINTEL	SHERWIN WILLIAMS	SAFFRON GOLD	PER SECTION 09900
PRE-FINISHED METAL	PAC-CLAD	LIGHT GRAY	CANO PIES; BREAK METAL
DIVISION 6 - WOODS AND FLASTICS			
FASCIA BO ARD	-	LIGHT GRAY	PER SECTION 09900
DIVISION 7 - THERMAL AND MOISTURE PROTECTION			
EXTERIORINSULATION AND FINISH SYSTEM - COLOR1	DRYVIT	SAFFRON GOLD	TYPICAL COLOR, PER SECTION 09900
EXTERO RINSULATION AND FINISH SYSTEM - COLOR2	DRYMT	OFF-WHITE	ACCENT COLOR PER SECTION 09900
SHEET METAL ROOFING	PAC-CLAD	PAC-CLAD METALLIC - STO NEWHITE	LOWREFLECTANCE
SHEET METAL FLASHING AND TRIM	PAC-CLAD	PAC-CLAD METALLIC - STO NEWHITE	LOW REFLECTANCE
GUTTERS AND DOWNSPOUTS	PAC-CLAD	PAC-CLAD METALLIC - STONEWHITE	LOW REFLECTANCE
DIVISION 8 -DOORS AND WINDOWS			
ALUMINUM ENTRANCES AND STO REFRONT	KAWNEER	LIGHT GRAY POWDER COAT	
ALUMINUM PACKAGEWINDOWS	THERMALWINDOWS	LIGHT GRAY	
BULLET-RESISTANT WINDO W	DIEBOLD	LIGHT GRAY	
TINTED SAFETY AND NO N-SAFETY GLASS	VIRACON	GRAY INSUL-SHIELD	
BULLET-RESISTANT GLASS	DIEBOLD	GRAY	

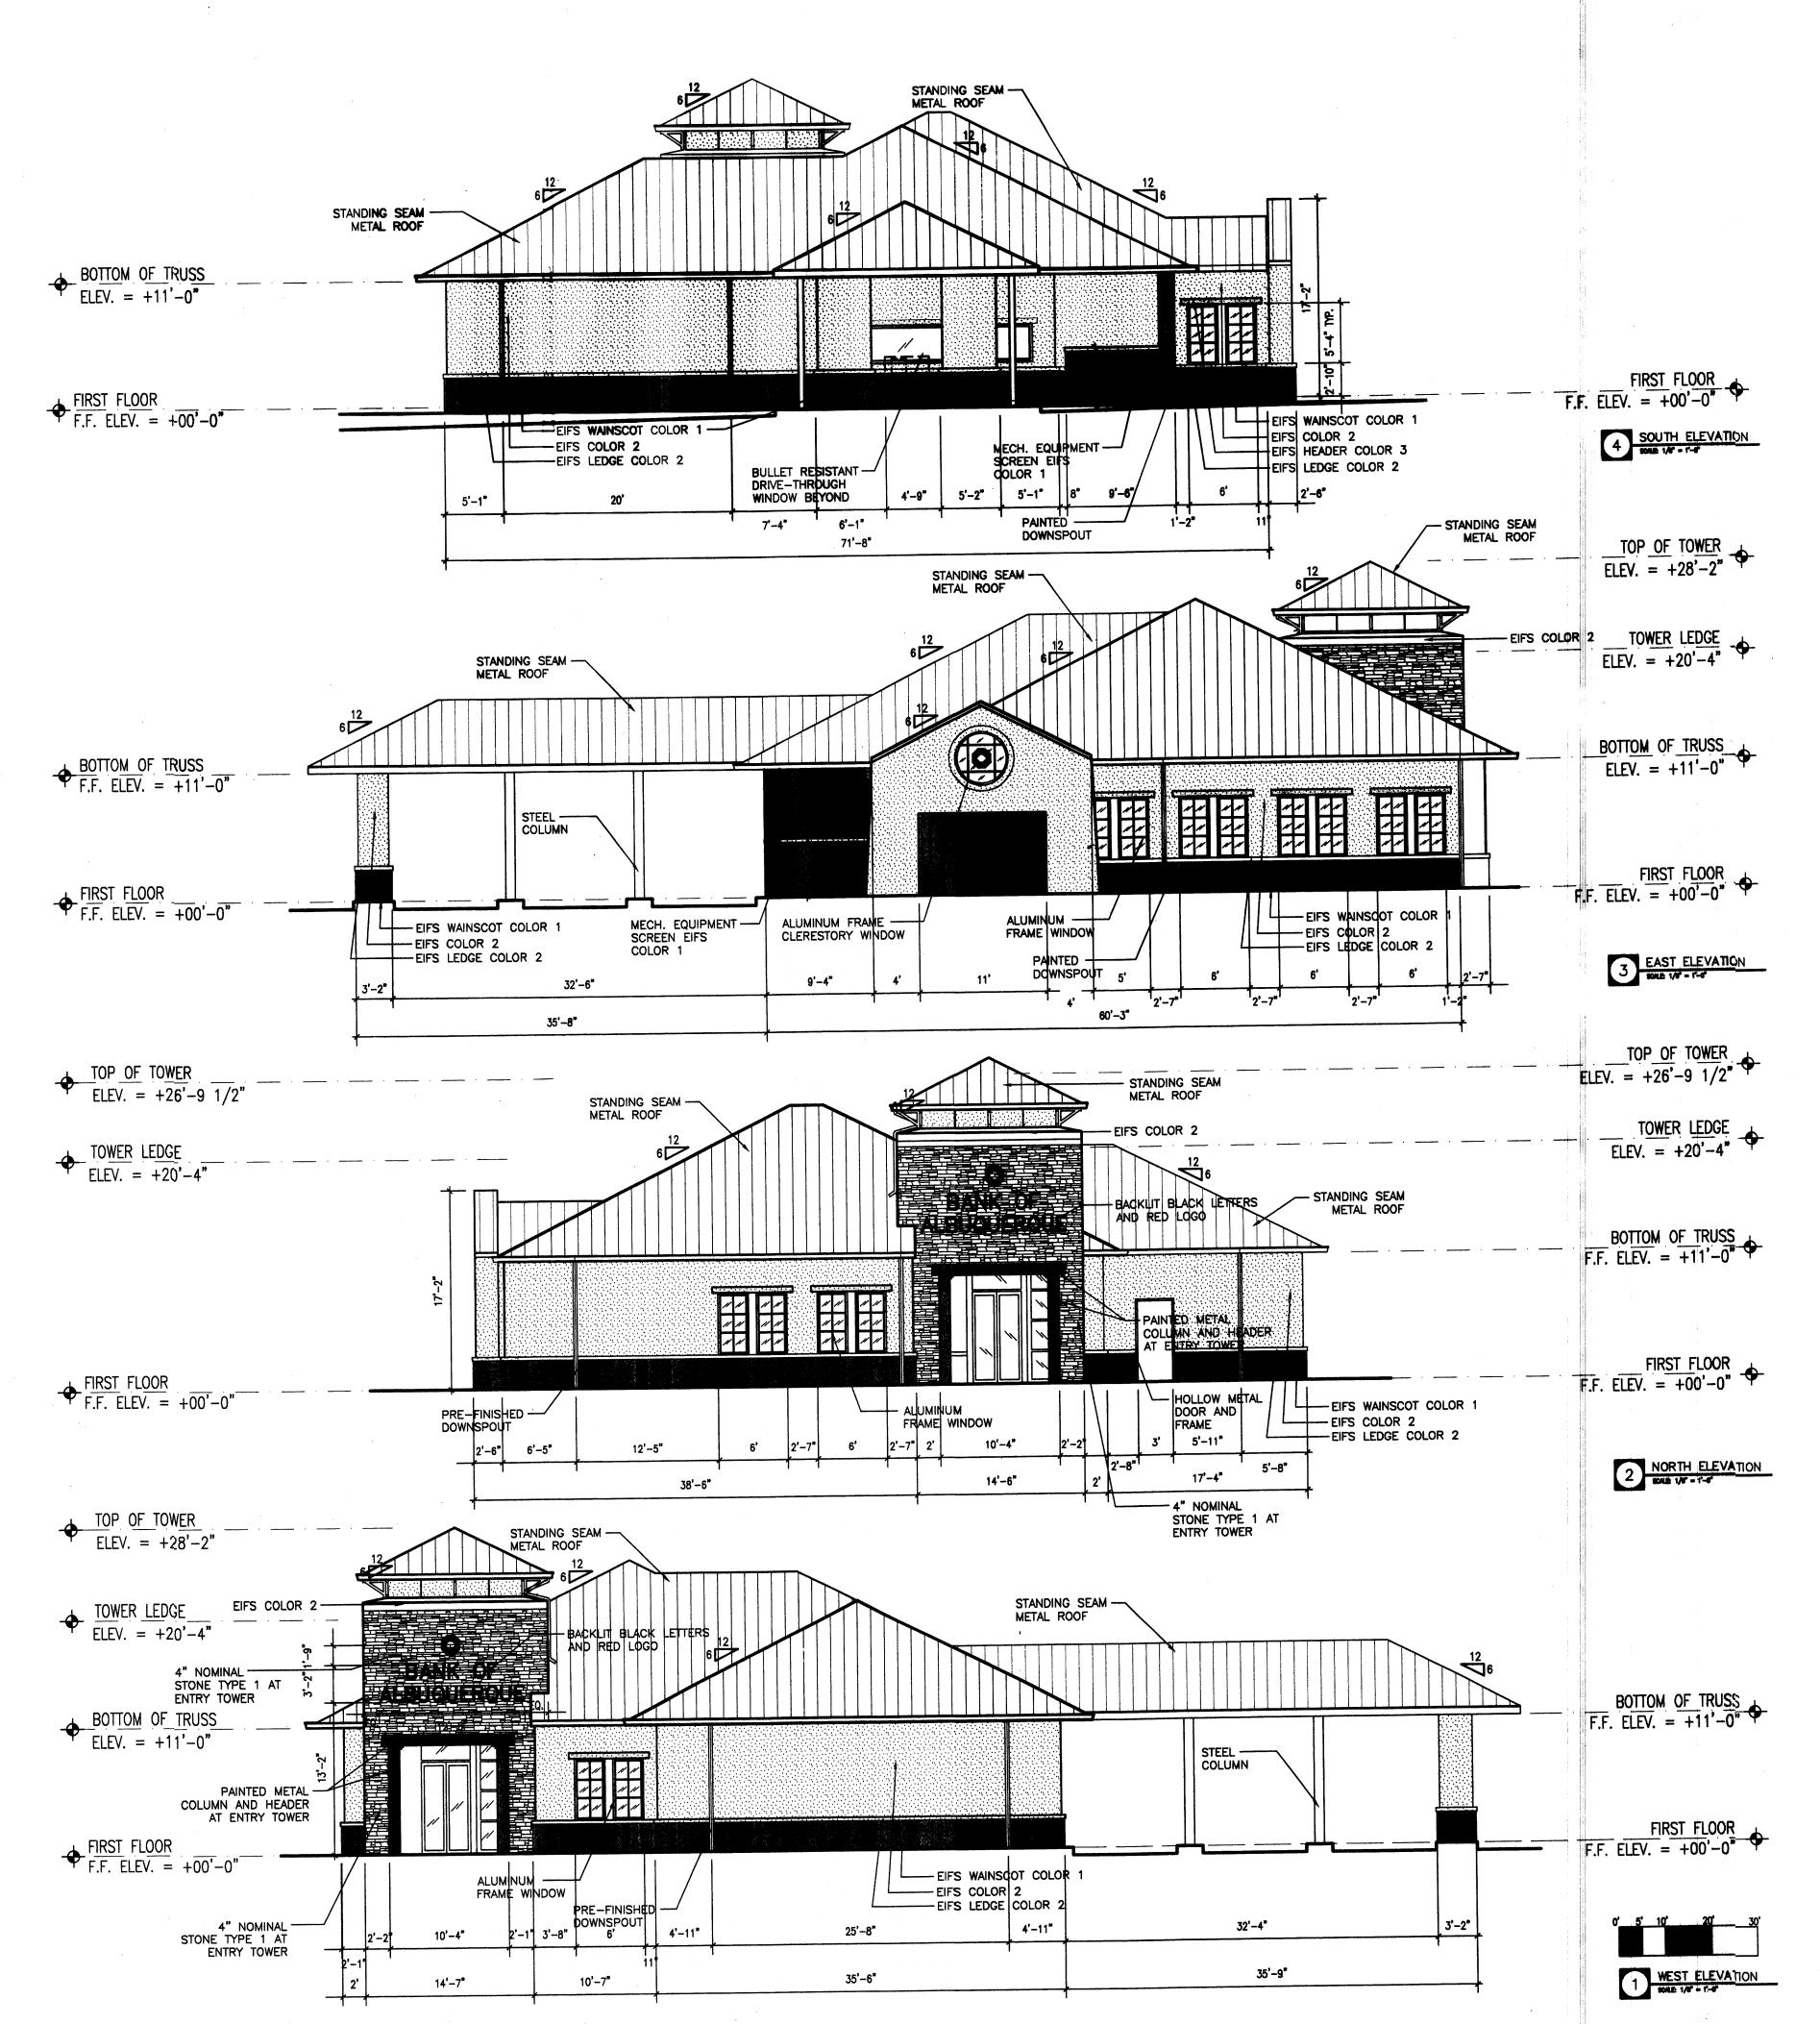



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F: 918.585.1987

PROJECT:
BANK OF
ALBUQUERQUE
WYOMING BLVD. & CARMEL
ALBUQUERQUE, NM



PROJECT NUMBER: 05053

101 (1)

CONSULTANT:

REVISIONS:

SEAL:

DESIGN DEVELOPMENT


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ISSUE DATE: 27 SEPTEMBER 2006

SHEET NUMBER:

A401

BUILDING AND STRUCTURE ELEVATIONS



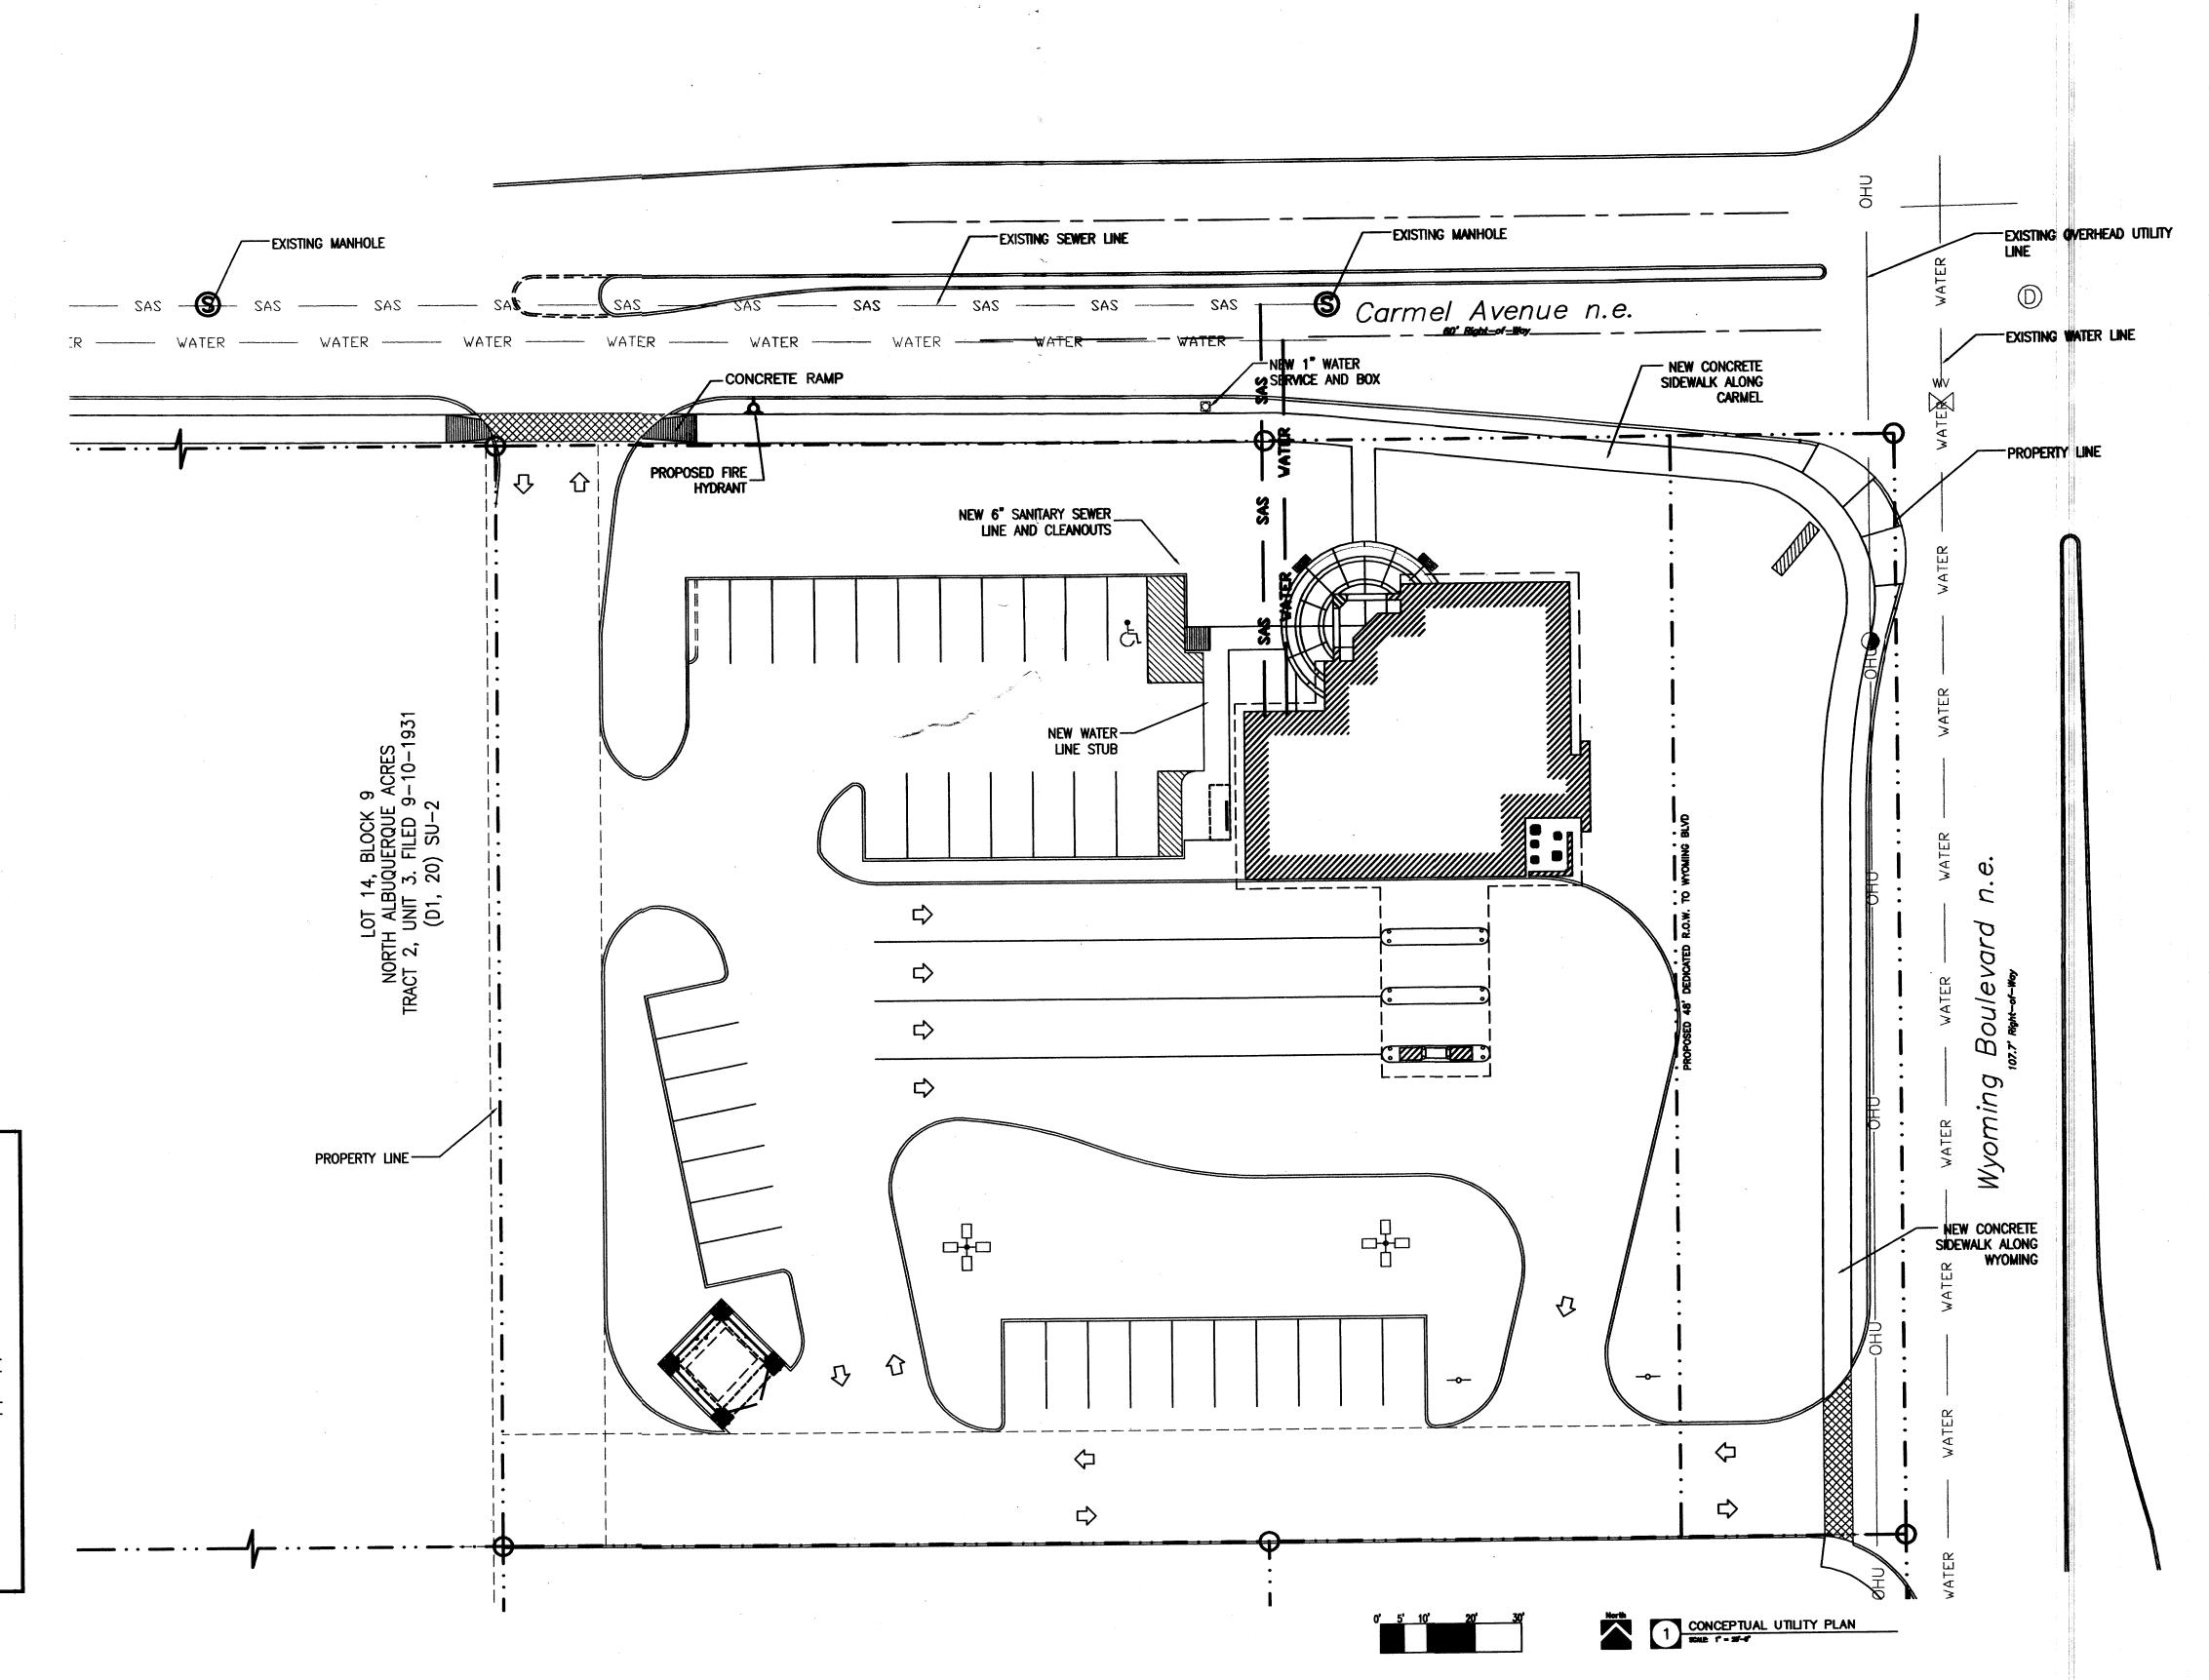

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PROJECT:
BANK OF
ALBUQUERQUE

WYOMING BLVD. & CARMEL ALBUQUERQUE, NM

PROJECT NUMBER: 05053

CONSULTANT:



REVISIONS:

SEAL:

DESIGN DEVELOPMENT

NOT FOR CONSTRUCTION

ISSUE DATE:

26 SEPTEMBER, 2006

SHEET NUMBER:

U101

CONCEPTUAL UTILITY PLAN

SYMBOLS LEGEND

* = TRAFFIC SIGNAL

• = POWER POLE

-они- = OVERHEAD UTILITY LINE


-sewer- = UNDERGROUND SEWER LINE

-water- = UNDERGROUND WATER LINE

S = SEWER MANHOLE

S = SEWER MAINTOL

= ELECTRIC RISER

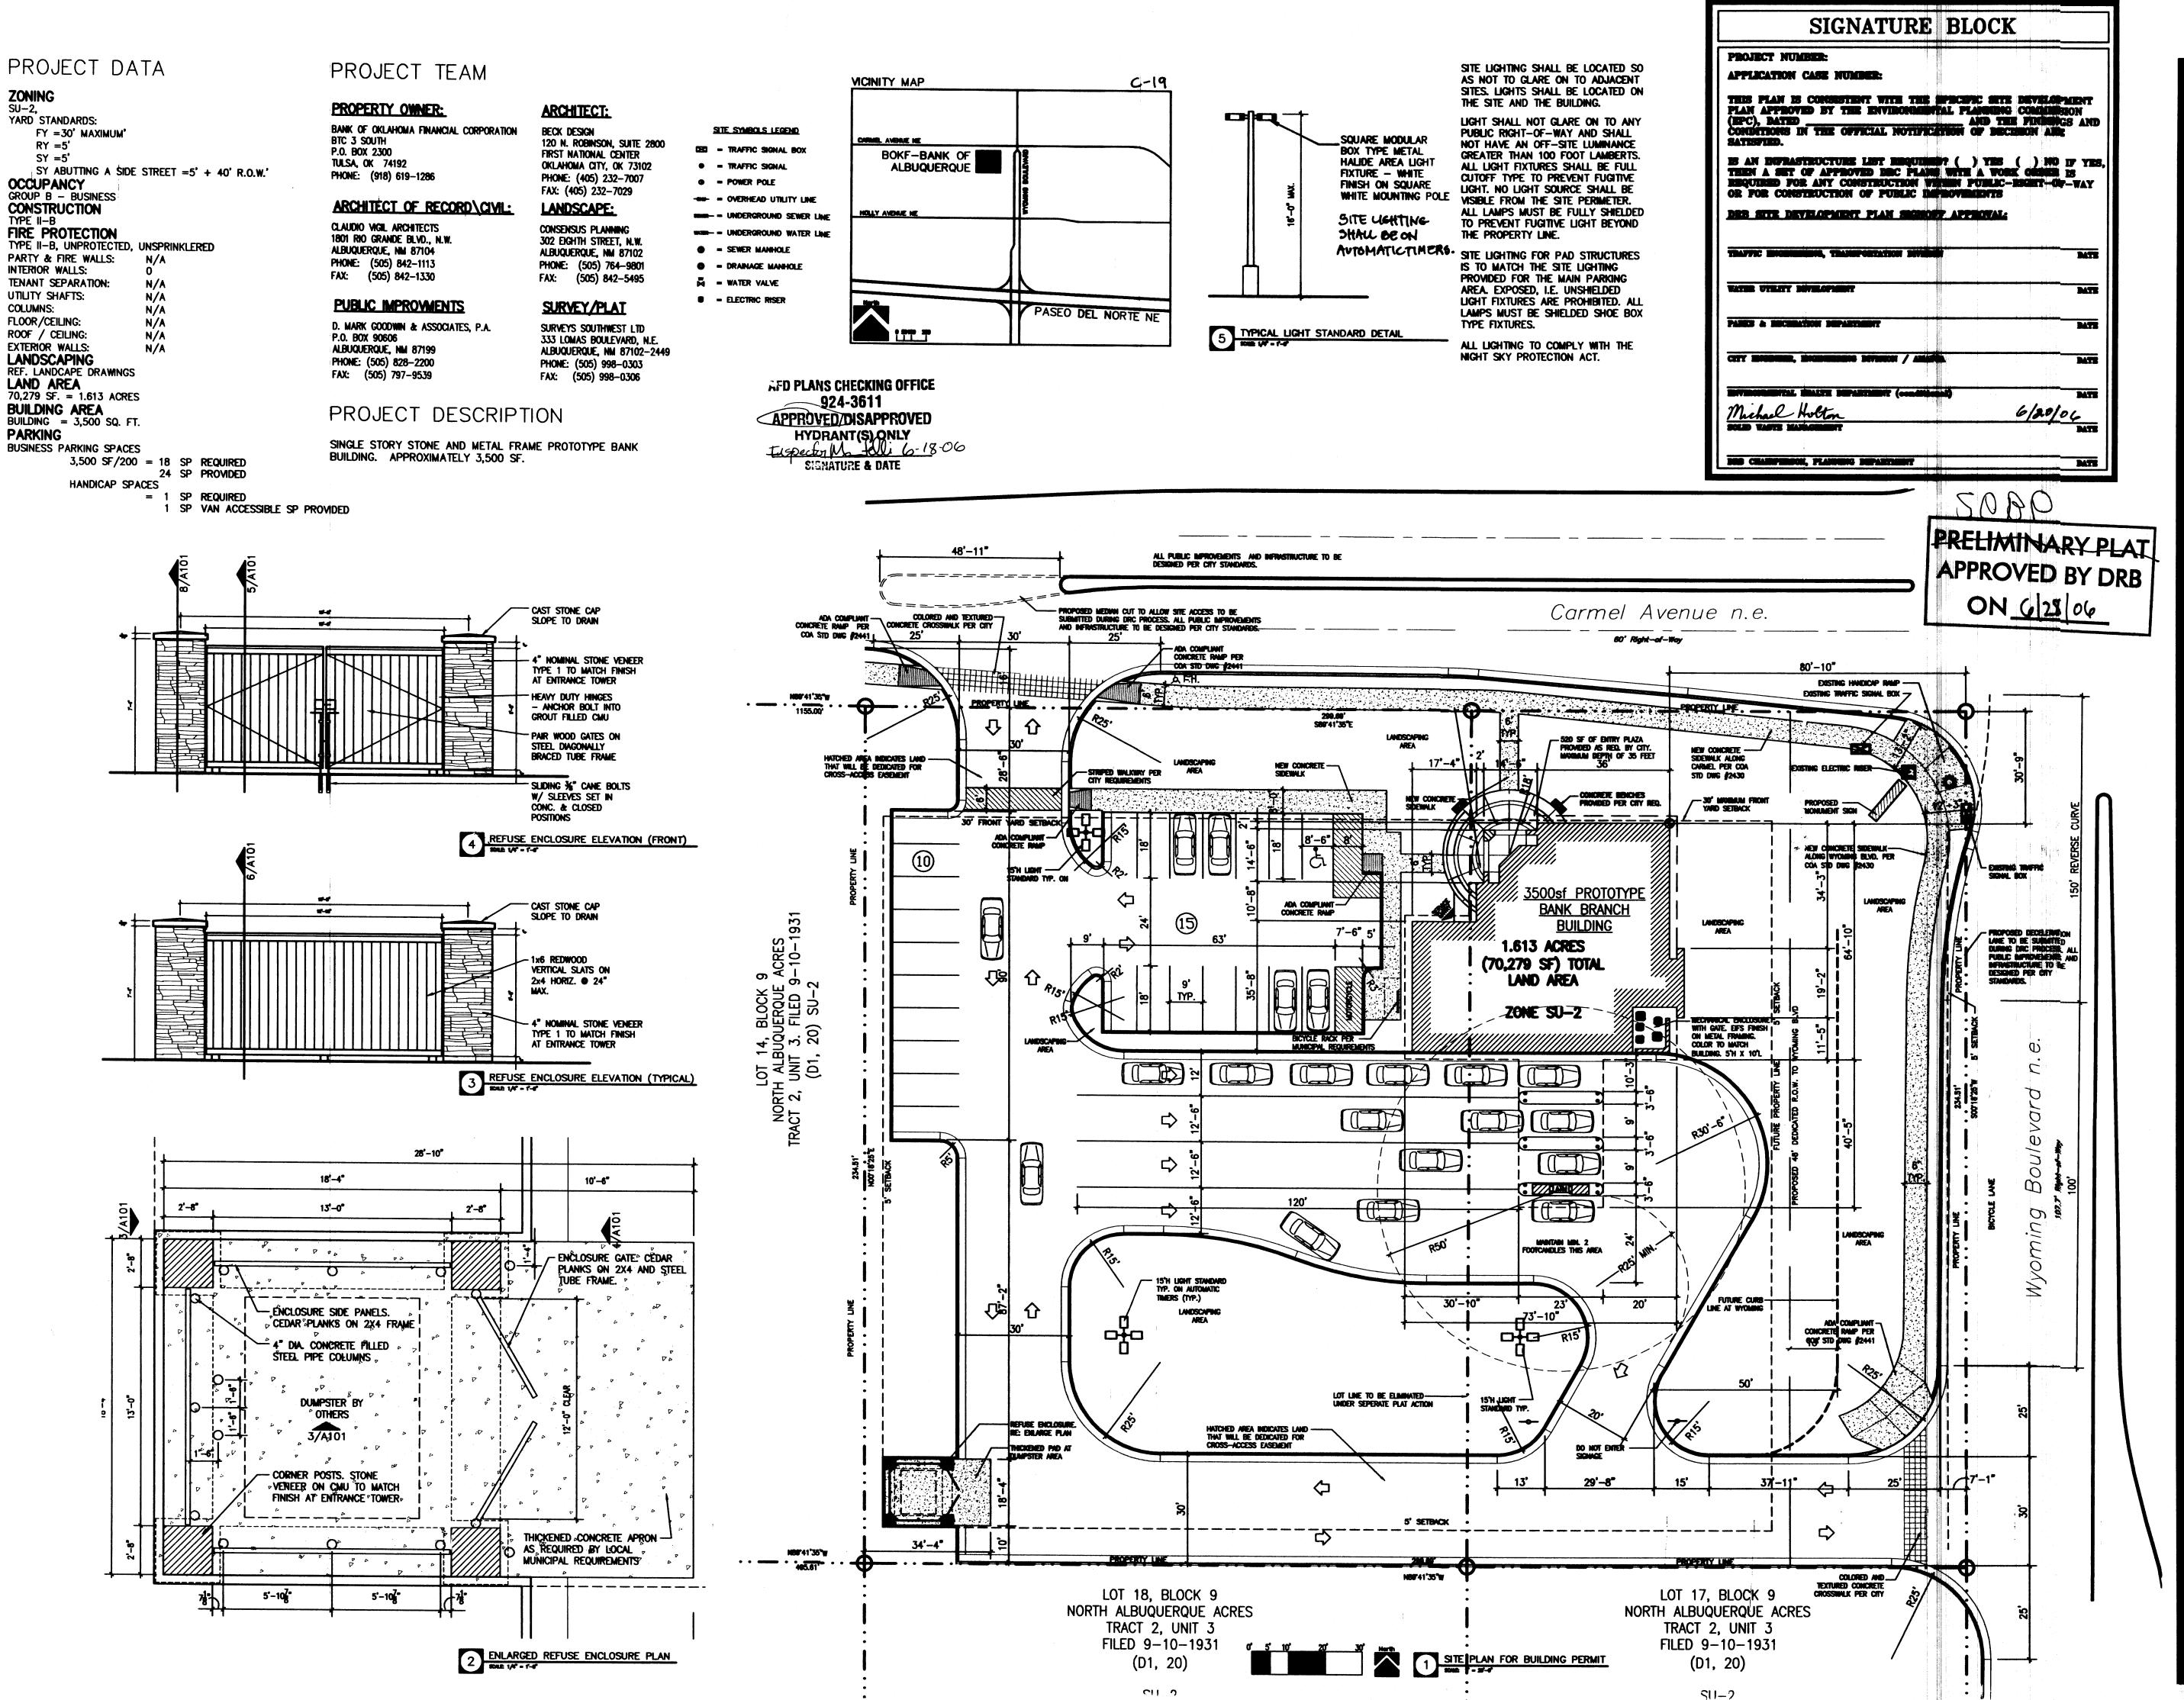



NA IL DOMENT

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DESIGN DEVELOPMENT


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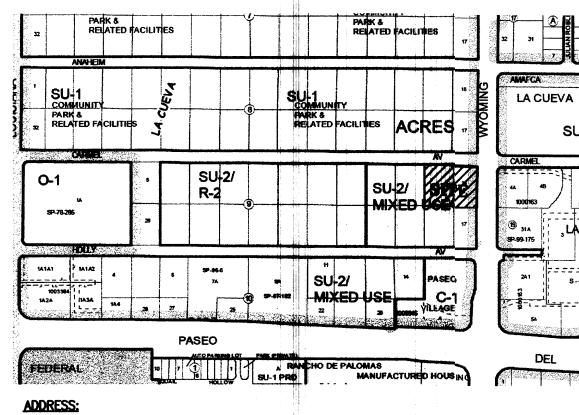
ISSUE DATE: 19 JUNE 2006

SHEET NUMBER:

A101

SITE PLAN FOR BUILDING PERMIT



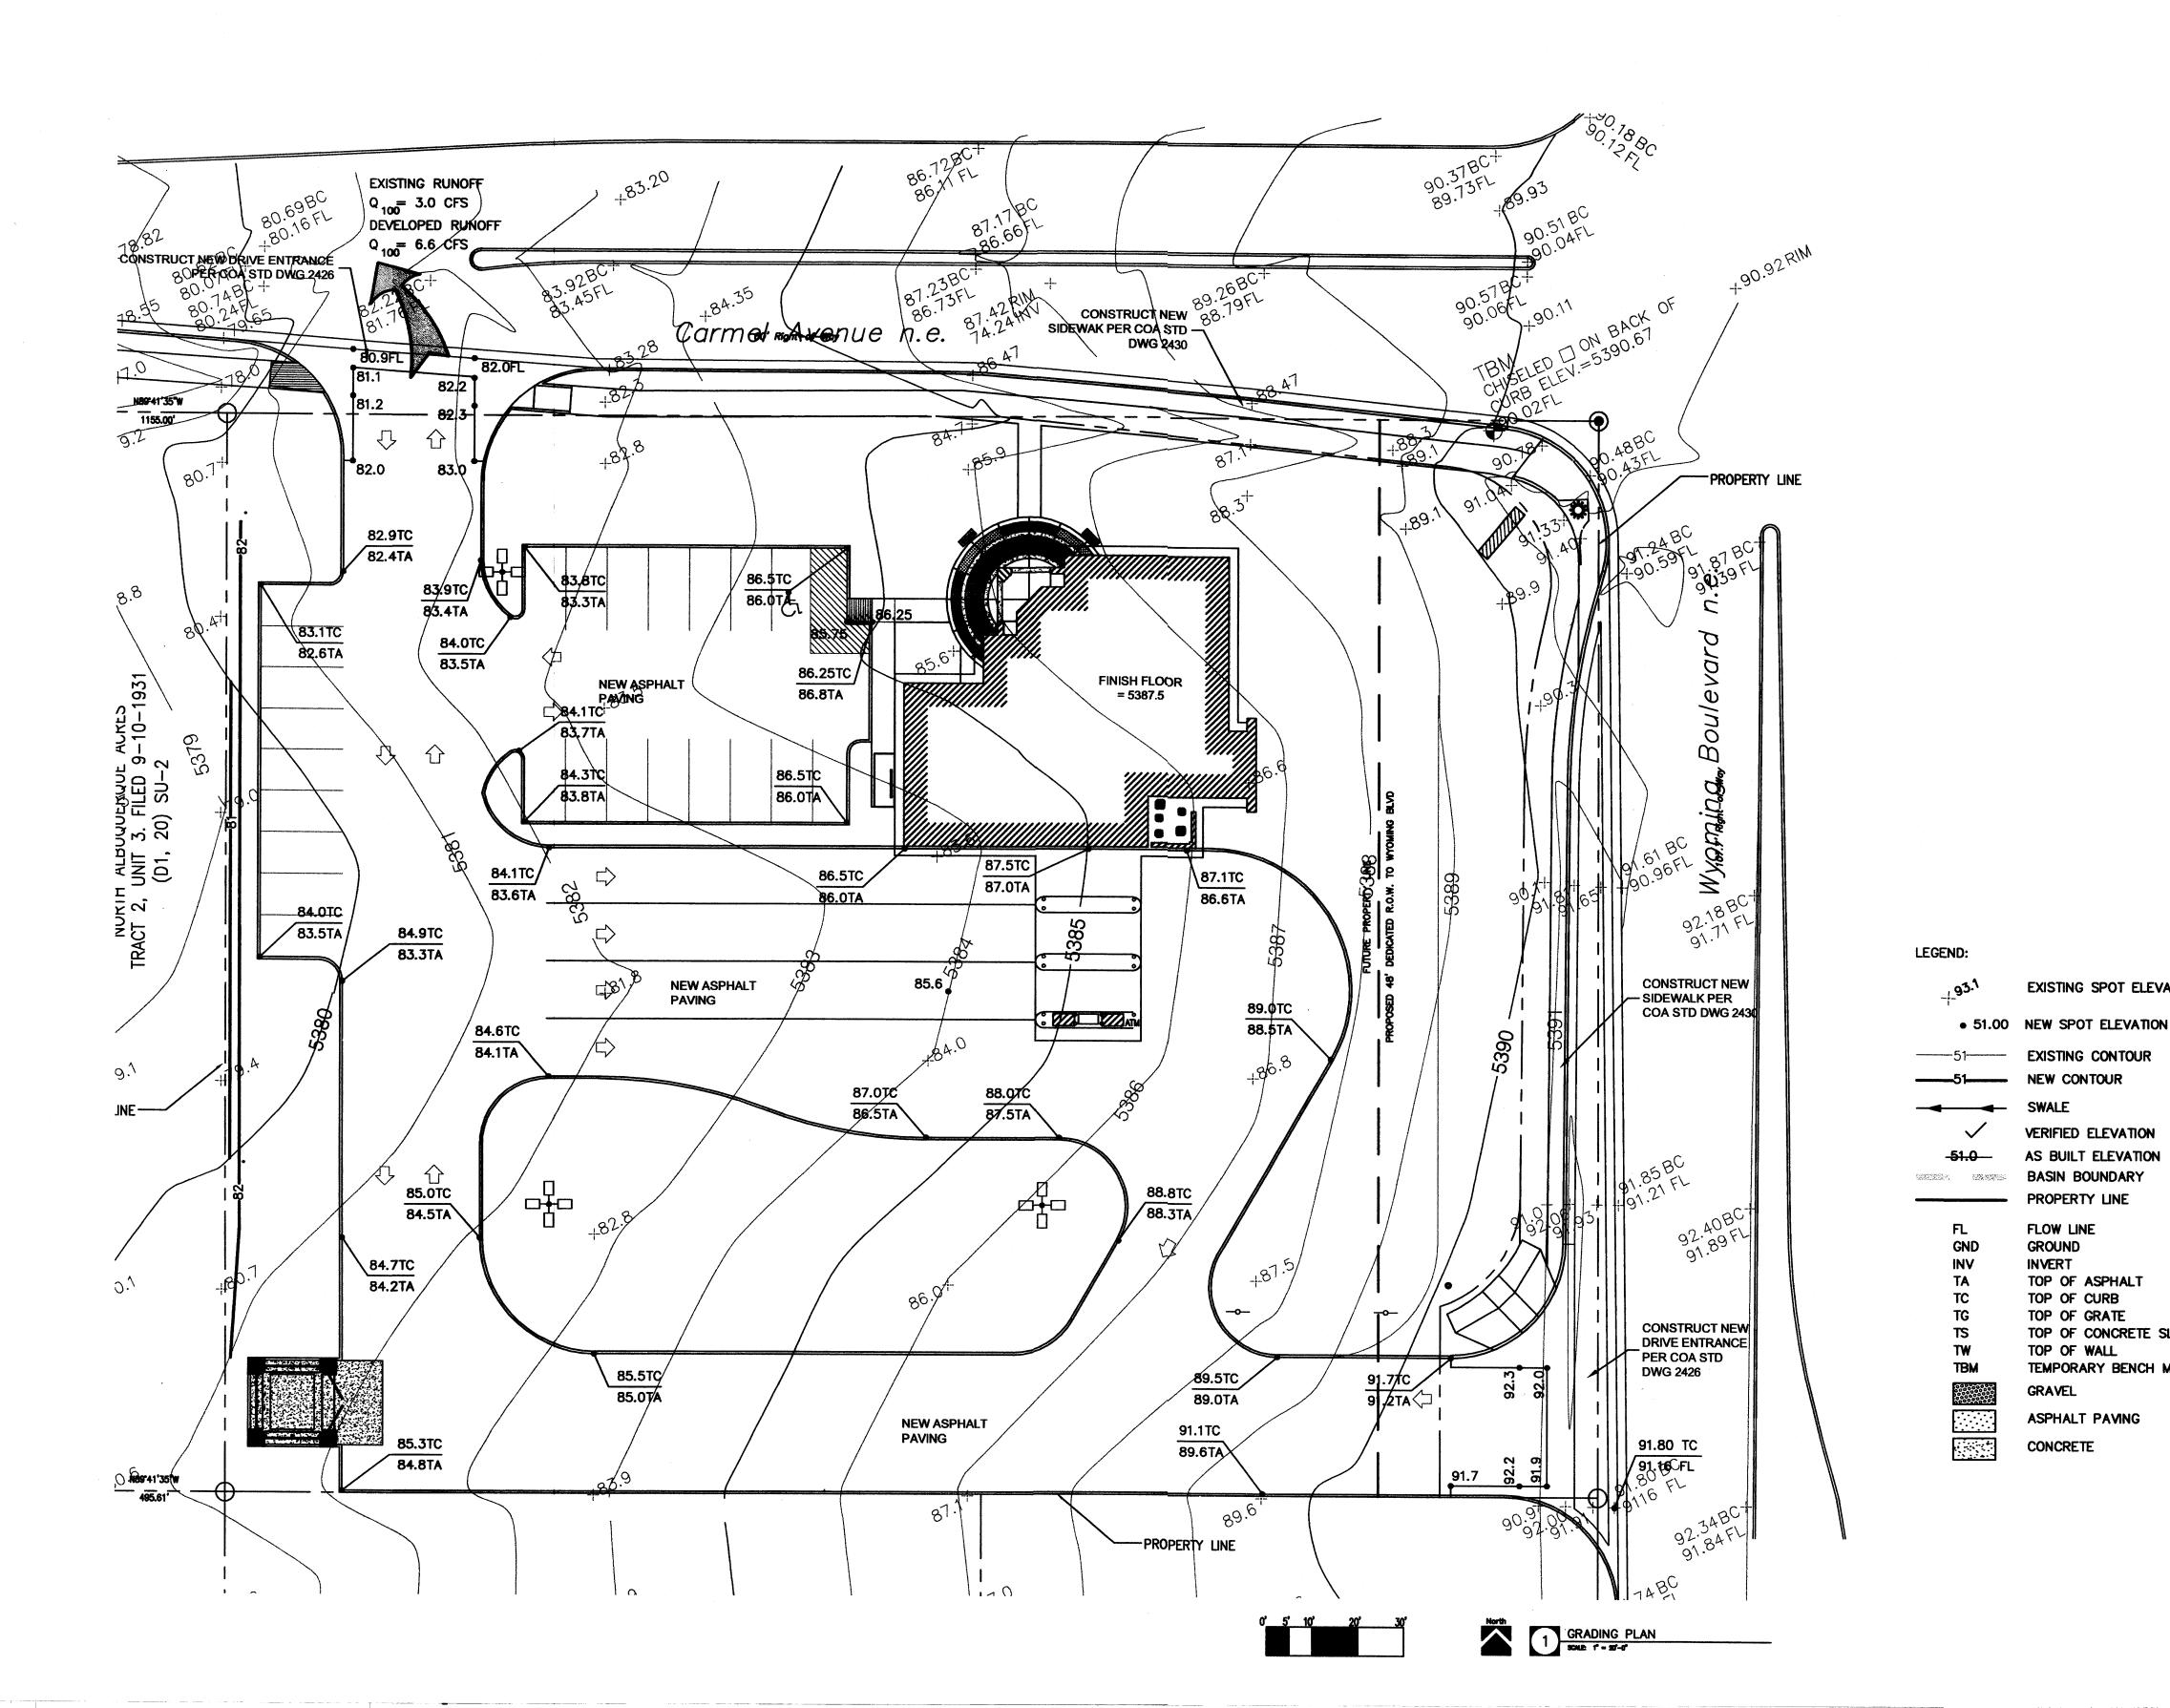

8400 FIRESTONE ROAD

LEGAL DESCRIPTION:
LOTS 15 & 16, BLOCK 9, TRACT 2, UNIT 3 NORTH ALBUQUERQUE ACRES

VICINITY MAP - C19 D-5

SCALE: NONE

DRAINAGE PLAN

THE PROPOSED IMPROVEMENTS AS SHOWN BY THE VICINITY MAP, ARE LOCATED WEST OF WYOMING BOULEVARD NORTH OF PLASO DEL MORTE, ON THE SOUTH WEST CORNER OF THE INTERSECTION OF WYOMING BLVD. AND CARMEL AVE. THE SITE IS UNDEVELOPED AND SLOPES FROM EAST TO WEST AT AN APPROXIMATE SLOPE OF 4.0% PER MAP NO. 35001C0137 E, THE SITE DOES NOT LIE WITHIN A FLOOD HAZARD ZONE. THE SITE IS HIGHER THAN THE LANDS TO THE WEST. THE LANDS TO THE NORTH AND SOUTH SLOPE FROM WEST TO EAST. THE EXISTING CURB AND GUTTER ALONG WYOMING BLVD. TO THE EAST BLOCKS FLOWS FORM THAT DIRECTION THEREFORE OFFSITE FLOWS ARE CONSIDERED

THE PROPOSED SITE LIES WITHIN THE NORTH ALBUQUERQUE ACRES SUBDIVISION. THE PROPOSED IMPROVEMENTS CONSIST OF A NEW BANK BUILDING WITH ASSOCIATED PARKING AND LANDSCAPING. AS SHOWN BY THE CALCULATION THE PROPOSED DEVELOPMENT WILL INCREASE THE RATE AND VOLUME OF RUNOFF. THE PROPOSED RATE OF DISCHARGE IS 6.6 CFS (4.1 CFS/ACRE). THE DEVELOPED RUNOFF FROM THE SITE ARE TO BE DIRECTED TO THE PROPOSED DRIVE ENTRANCE ON CARMEL AVE. NO PONDING IS ANTICIPATED FOR THE SITE.

THE CALCULATIONS ANALYZE THE EXISTING AND PROPOSED CONDITIONS FOR 6-HOUR, 100 YEAR RAINFALL EVENT. THE ANALYSIS IS IN ACCORDANCE WITH THE CITY OF ALBUQUERQUE DEVELOPMENT PROCESS MANUAL VOLUME N.

<u>CALCULATIONS</u> PRECIPITATION ZONE = 3 TOTAL SITE AREA = 1.613 ACRES

EXISTING CONDITIONS

LAND TREATMENT A=100% E = 0.66(1.00) = 0.66 INCHES

V = 0.66(1.613) / 12 = 0.089 ACRE FEET Q = 1.87(1.00)(1.613) = 3.0 CFS

DEVELOPED CONDITIONS LAND TREATMENT B=44% D=56%

E = 0.912(0.44) + 2.36(0.56) = 1.73 INCHES V = 1.73 (1.613) / 12 = 0.233 ACRE FEET $Q = [2.60^{\circ}(0.44) + 5.25(0.56)](1.613) = 6.6 \text{ CFS}$

Q =6.6/1.613=4.1 CFS/ACRE INCREASE IN VOLUME OF RUNOFF = 01144 ACRE FT INCREASE IN RATE OF RUNOFF = 3.6 CFS

CONSTRUCTION NOTES

EXISTING SPOT ELEVATION

VERIFIED ELEVATION

AS BUILT ELEVATION

TOP OF ASPHALT

TOP OF CONCRETE SLAB

TEMPORARY BENCH MARK

TOP OF CURB

TOP OF GRATE

TOP OF WALL

ASPHALT PAVING

GRAVEL

CONCRETE

FLOW LINE

GROUND

INVERT

- 1. TWO WORKING DAYS PRIOR TO ANY EXCAVATION, THE CONTRACTOR SHALL CALL FOR LOCATION OF EXISTING UTILITIES.
- 2. ALL WORK WITHIN THE CITY RIGHT-OF-WAY SHALL BE PERFORMED IN ACCORDANCE WITH THE APPLICABLE CITY OF ALBUQUERQUE STANDARDS AND PROCEDURES.
- 3. ALL WORK SHALL BE PERFORMED IN ACCORDANCE WITH THE APPLICABLE FEDERAL, STATE, AND LOCAL REGULATIONS, LAWS, AND RULES CONCERNING SAFETY AND HEALTH.
- 4. PRIOR TO CONSTRUCTION THE CONTRACTOR SHALL VERITY THE EXISTING SITE CONDITIONS AND INFORM THE ARCHITECT/ ENGINEER OF ANY DISCREPANCY BETWEEN THE INFORMATION SHOWN ON THE PLANS AND THOSE OF THE EXISTING SITE.
- 5. THE CONTRACTOR SHALL PROVIDE THE ARCHITECT / ENGINEER WITH AN AS BUILT SURVEY FOR ENGINEER'S CERTIFICATION.
- 6. THE CONTRACTOR SHALL MAINTAIN A RECORD DRAWING SET OF PLANS AND PROMPTLY LOCATE EXISTING AND NEW ELEVATIONS (FINISH FLOORS, TOPS OF CURBS AND ASPHALT, FLOW LINE, PIPE INVERTS, ETC.), ON THE RECORD SET. THE RECORD SET SHALL BE MAINTAINED ON THE PROJECT SITE AND SHALL BE AVAILABLE TO THE OWNER AND ARCHITECT AT ANY TIME DURING CONSTRUCTION. UPON COMPLETION OF THE PROJECT, THE RECORD SET SHALL BE TURNED OVER TO THE OWNER.
- 7. THE OWNER / CONTRACTOR SHALL SUBMIT A NOTICE OF INTENT (NOI) TO THE EPA PRIOR TO BÉGINNING OF CONSTRUCTION.
- 8. CONTRACTOR SHALL COMPLY WITH STORM WATER POLLUTION PREVENTION PLAN (SWPPP) SPECIFIC TO THIS PROJECT.
- 9. ALL POND BOTTOMS SHALL RECEIVE GRAVEL AND FILTER FABRIC SEE LANDSCAPE PLAN.
- 10. THE BASIS OF ELEVATIONS FOR THIS SURVEY IS ACS BENCHMARK HEAVEN, THE PUBLISHED ELEVATION OF WHICH IS 5378.26. BENCHMARK IS LOCATED AT THE ENTRANCE TO GATE OF HEAVEN CEMETARY ON THE SOUTH SIDE OF PASEO DEL NORTE, JUST WEST OF WYOMING BOULEVARD.

FACILITY ACCESSIBILITY

ALL SURFACES ALONG THE ACCESSIBLE ROUTE SHALL COMPLY WITH ANSI A117-1998.

WALKING SURFACES SHALL BE STABLE, FIRM, AND SLIP RESISTANT. THE RUNNING SLOPE OF WALKING SURFACES SHALL NOT BE STEEPER THAN 1:20 WITH A CROSS SLOPE NOT STEEPER

CURB RAMP AND RAMP RUNS SHALL HAVE A RUNNING SLOPE NOT STEEPER THAN 1:12 WITH A CROSS SLOPE NOT STEEPER THAN 1:48. COUNTER SLOPES OF ADJOINING GUTTERS AND ROAD SURFACES IMMEDIATELY ADJACENT TO THE CURB RAMP OR ACCESSIBLE ROUTE SHALL NOT BE STEEPER THAN 1:20. TRANSITIONS FROM RAMPS TO WALKS, GUTTERS OR STREETS SHALL BE AT THE SAME LEVEL. WHERE PEDESTRIANS WUST WALK ACROSS A CURB RAMP. THE RAMP SHALL HAVE FLARED SIDES WITH SLOPES NOT STEEPER THAN 1:10: WHERE THE TOP OF THE RAMP PARALLEL TO THE RUN OF THE RAMP IS LESS THAN 48 INCHES WIDE, THE FLARED SIDES SHALL HAVE A SLOPE NOT STEEPER THAN 1:12.

HANDICAP PARKING SPACES AND ACCESS AISLES SHALL HAVE SURFACE SLOPES NOT STEEPER THAN 1:48. ACCESS AISLES SHALL BE AT THE SAME LEVEL AS THE PARKING SPACES THEY SERVE.

THE CONTRACTOR SHALL PROVIDE ALL REQUIRED TRAFFIC CONTROL PLANS AND DEVICES. ALL SIGNS, BARRICADES, CHANNELIZATION DEVICES, SIGN FRAMES AND ERECTION OF SUCH DEVICES SHALL CONFORM THE THE REQUIREMENTS OF THE "MANUAL OF UNIFORM TRAFFIC CONTROL DEVICES FOR STREETS AND HIGHWAYS" LATEST EDITION, PRIOR TO CONSTRUCTION PRIOR TO CONSTRUCTION, THE TRAFFIC CONTROL PLAN SHALL BE SUBMITTED AND APPROVED BY THE GOVERNING AUTHORITY.



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PROJECT: BANK OF **ALBUQUERQUE**

WYOMING BLVD. & CARMEL ALBUQUERQUE, NM



PROJECT NUMBER:

CONSULTANT:



CLAUDIO VIGIL **ARCHITECTS**


REVISIONS:

SEAL:



ISSUE DATE: JUNE 15, 2006

SHEET NUMBER:

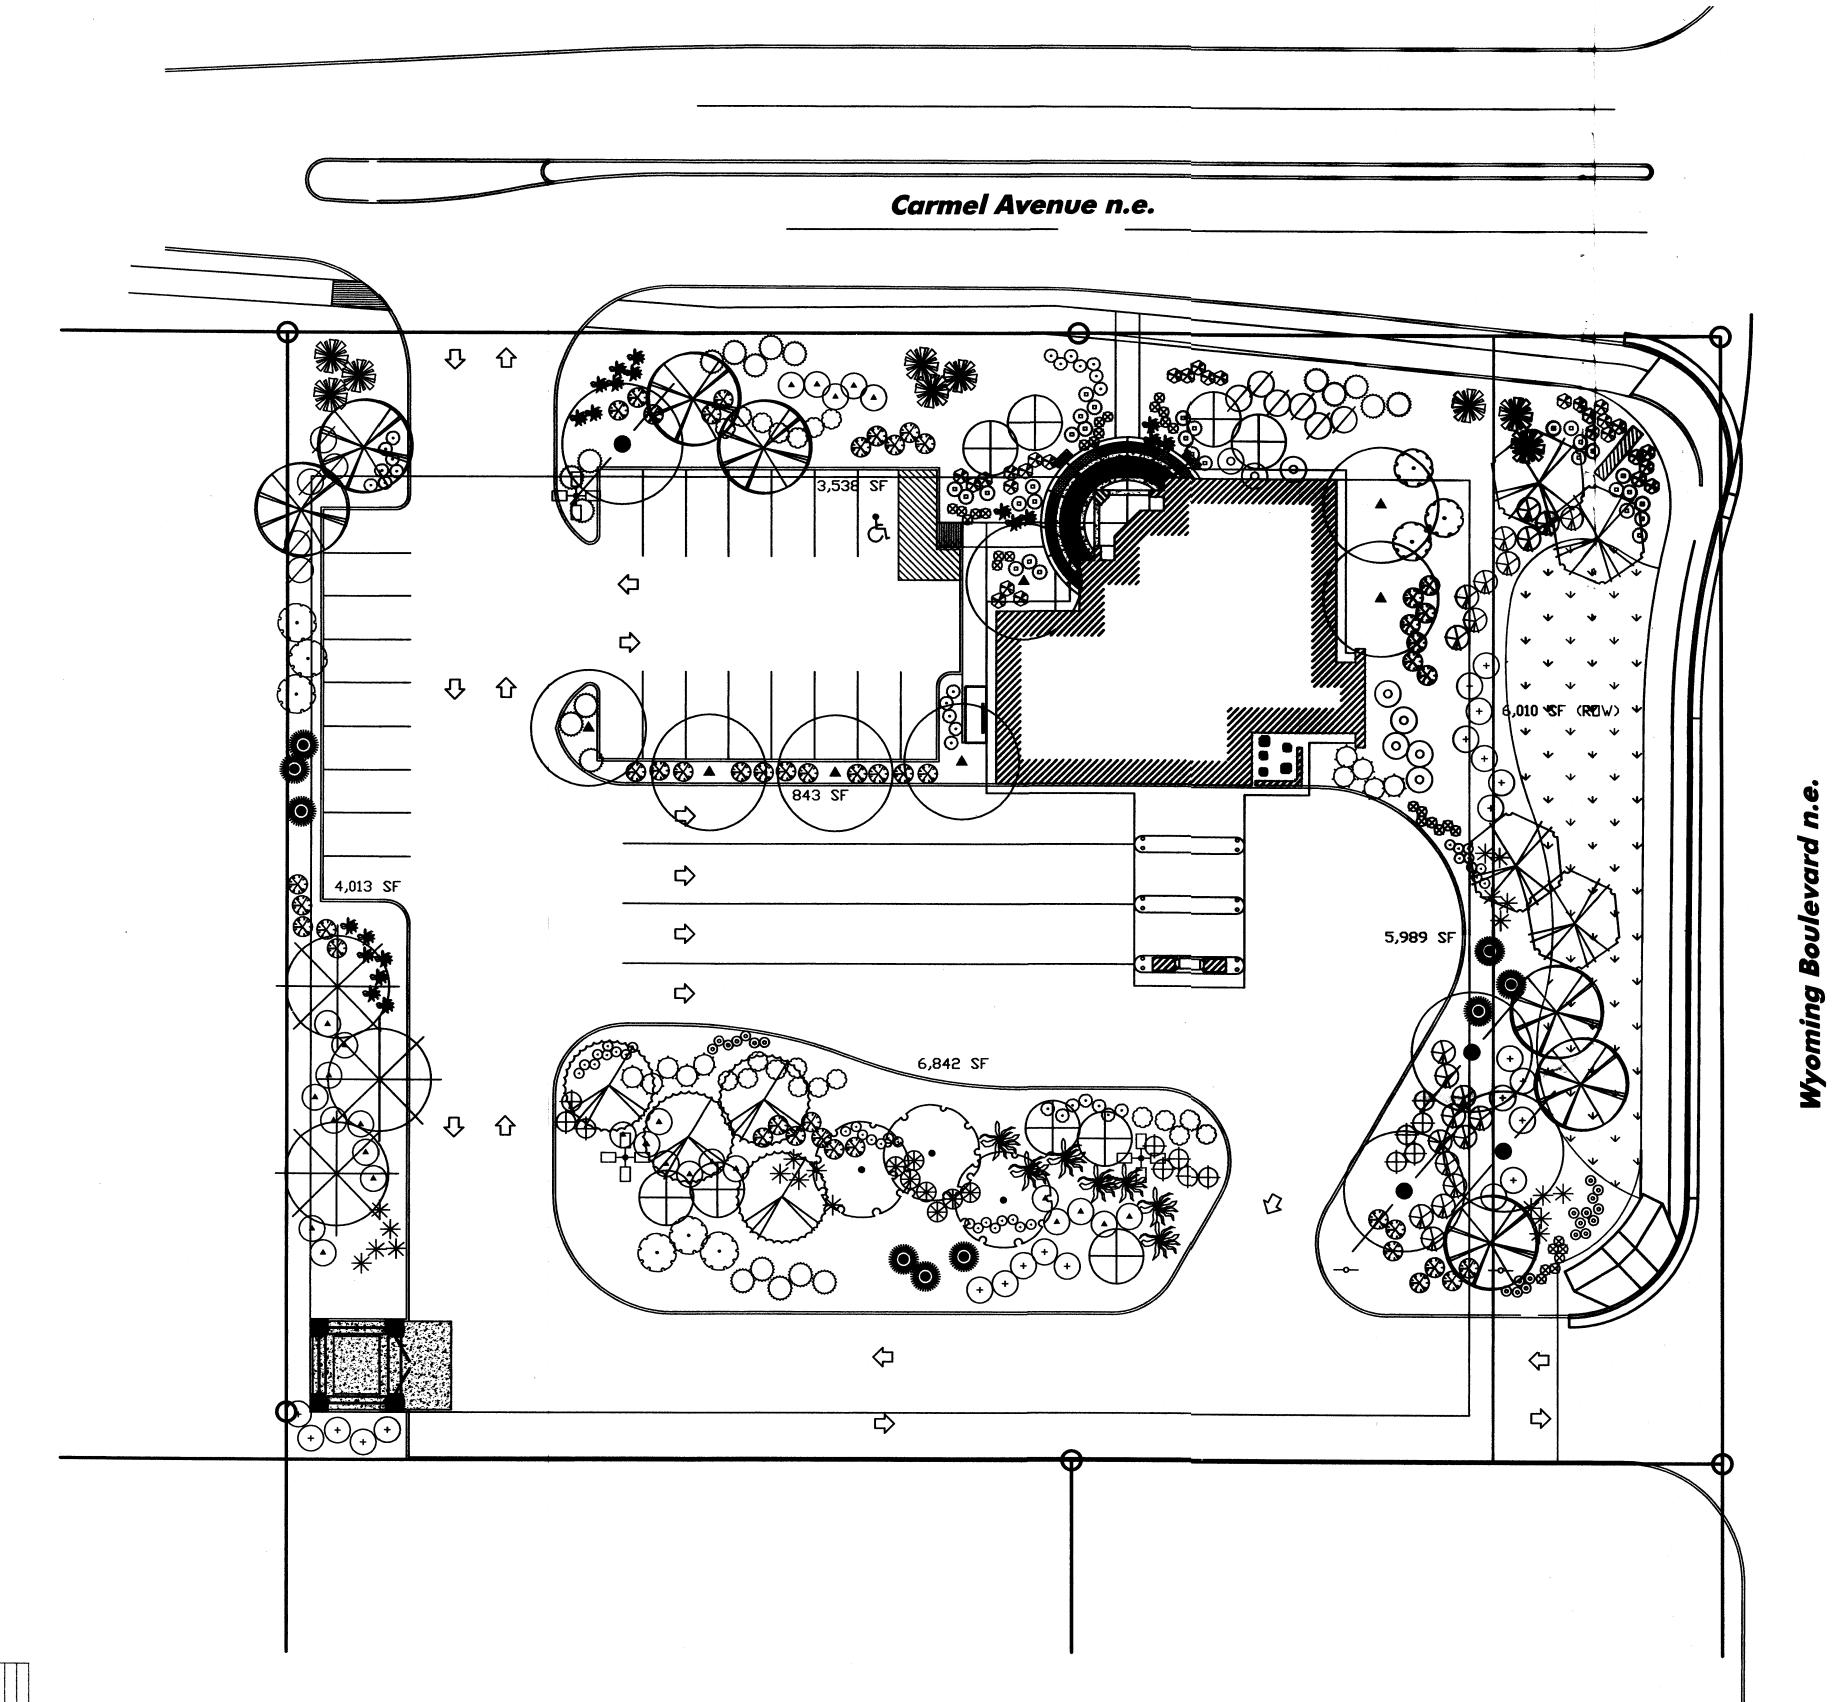

LANDSCAPE PALETTE

	· · · · · · · · · · · · · · · · · ·	·			
Symbol	Botanical Name / Common Name	Mature Size Water Lise	Symbol	Botanical Name / Common Name	Mature Siz Water Use
(A)	Trees Cercis reniformis 'Oklahoma'	25' × 25'	Ø	Perovskia atriplicifolia Russian Saga	60" x 60" Medium
~	Oklahona Radbud	Medium 20' x 25'	\Diamond	Potentilla fruticosa Shrubby Cinquefoil	36" x 36" Medium+
80	Chilopsis linearis "Lucretia Hamilton" Desert Willow	Low+		Rhue aromatica 'Gro-Lou'	24" × 48"
	Chitalipa tashkentensis 'Pink Dawn' Chitalipa	30' x 30' Medium	0	Prostrate Sunac	Low+
\oplus	Forestieri neomexicana New Mexico Olive	15' x 15' Medium	\odot	Rhue trilobata Three-leaf Sumac	48" x 60" Low+
	Robinia x ambigua	35' × 30'	©	Roemarinus officinalis Prostrate Roesmary	24" × 60" Low+
	Purple Robe Locust	Medium+	\oplus	Salvia greggii	36' x 36'
\bigotimes	Pinus eldarica Afghan Pine	40' x 35' Medium	Ψ	Charry Sage	Medium
\odot	Quercus buckleyi Texas Red Oak	25' x 25' Me dium	₩	Omanental Grasoes Miscantus sinensis	60' × 60'
\odot	Tilia cordata Littleleaf Linden	40' x 30' Medium	0	Maiden Hair Grass Muhlenbergin capillaries 'Regal Mist'	Medium+ 36" x 42"
_	Shrubs/Groundcovers		_	Muhly Grass	Medium
O	Artemisia 'Powis Castle' Powis Castle Sage	36" x 30" Medium	*	Nassella t errus eima Threadgrase	24" x 18" Low
0	Baccharis 'Stam Thompson' Dwarf Coyotebush	24" x 60" Low		Nolina microcarpa Bear Grass	36" x 48" Medium
0	Buddleia davidii 'Nanhoensis' Butterfly Bush	48" x 36" Me dium		Accents Davidson and a	401 4 01
\odot	Caesalpina gillesii Bird of Paradise	96' x 72' L <i>o</i> w		Dasylirion ultrasleri Sotol	48' x 60' Low
⊗	Caryopteris clandonensis Blue Mist	48" × 48" Low	*	Hesperalos parviflora Red/Yellou flouering Yucca	36" x 36" Medium
\odot	Chrysothamnus nauscosus Chamisa	60" x 60" Low		Native Graen/Wildflower Seed Mix	Low
8	Cytisus x 'Lena' Lena's Broom	24" × 36" Low			
\odot	Ericameria laricifolia Dwarf Turpentine Bush	36" × 42" Low+			
•	Erysimum 'Bowles Mauve' Bowles Mauve Wallflower	24" x 36" Medium			
~					

LANDSCAPE CALCULATIONS

Total Site Area:	(1.61 acres) 70,279 SF
Building Area:	3,500 SF
Net Area:	66,779 SF
Required Landscape Area (15% of Net Area):	10,117 SF
Provided Landscape Area: (40%)	26,392 SF
On-site - 20,382 8F	
ROW 6/01/0 8F	

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18' x 18'



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PROJECT:

BANK OF ALBUQUERQUE

WYOMING BLVD. & CARMEL ALBUQUERQUE, NM

PROJECT NUMBER:

05053

CONSULTANT:



REVISIONS:

SCHEMATIC DESIGN

NOT FOR CONSTRUCTION


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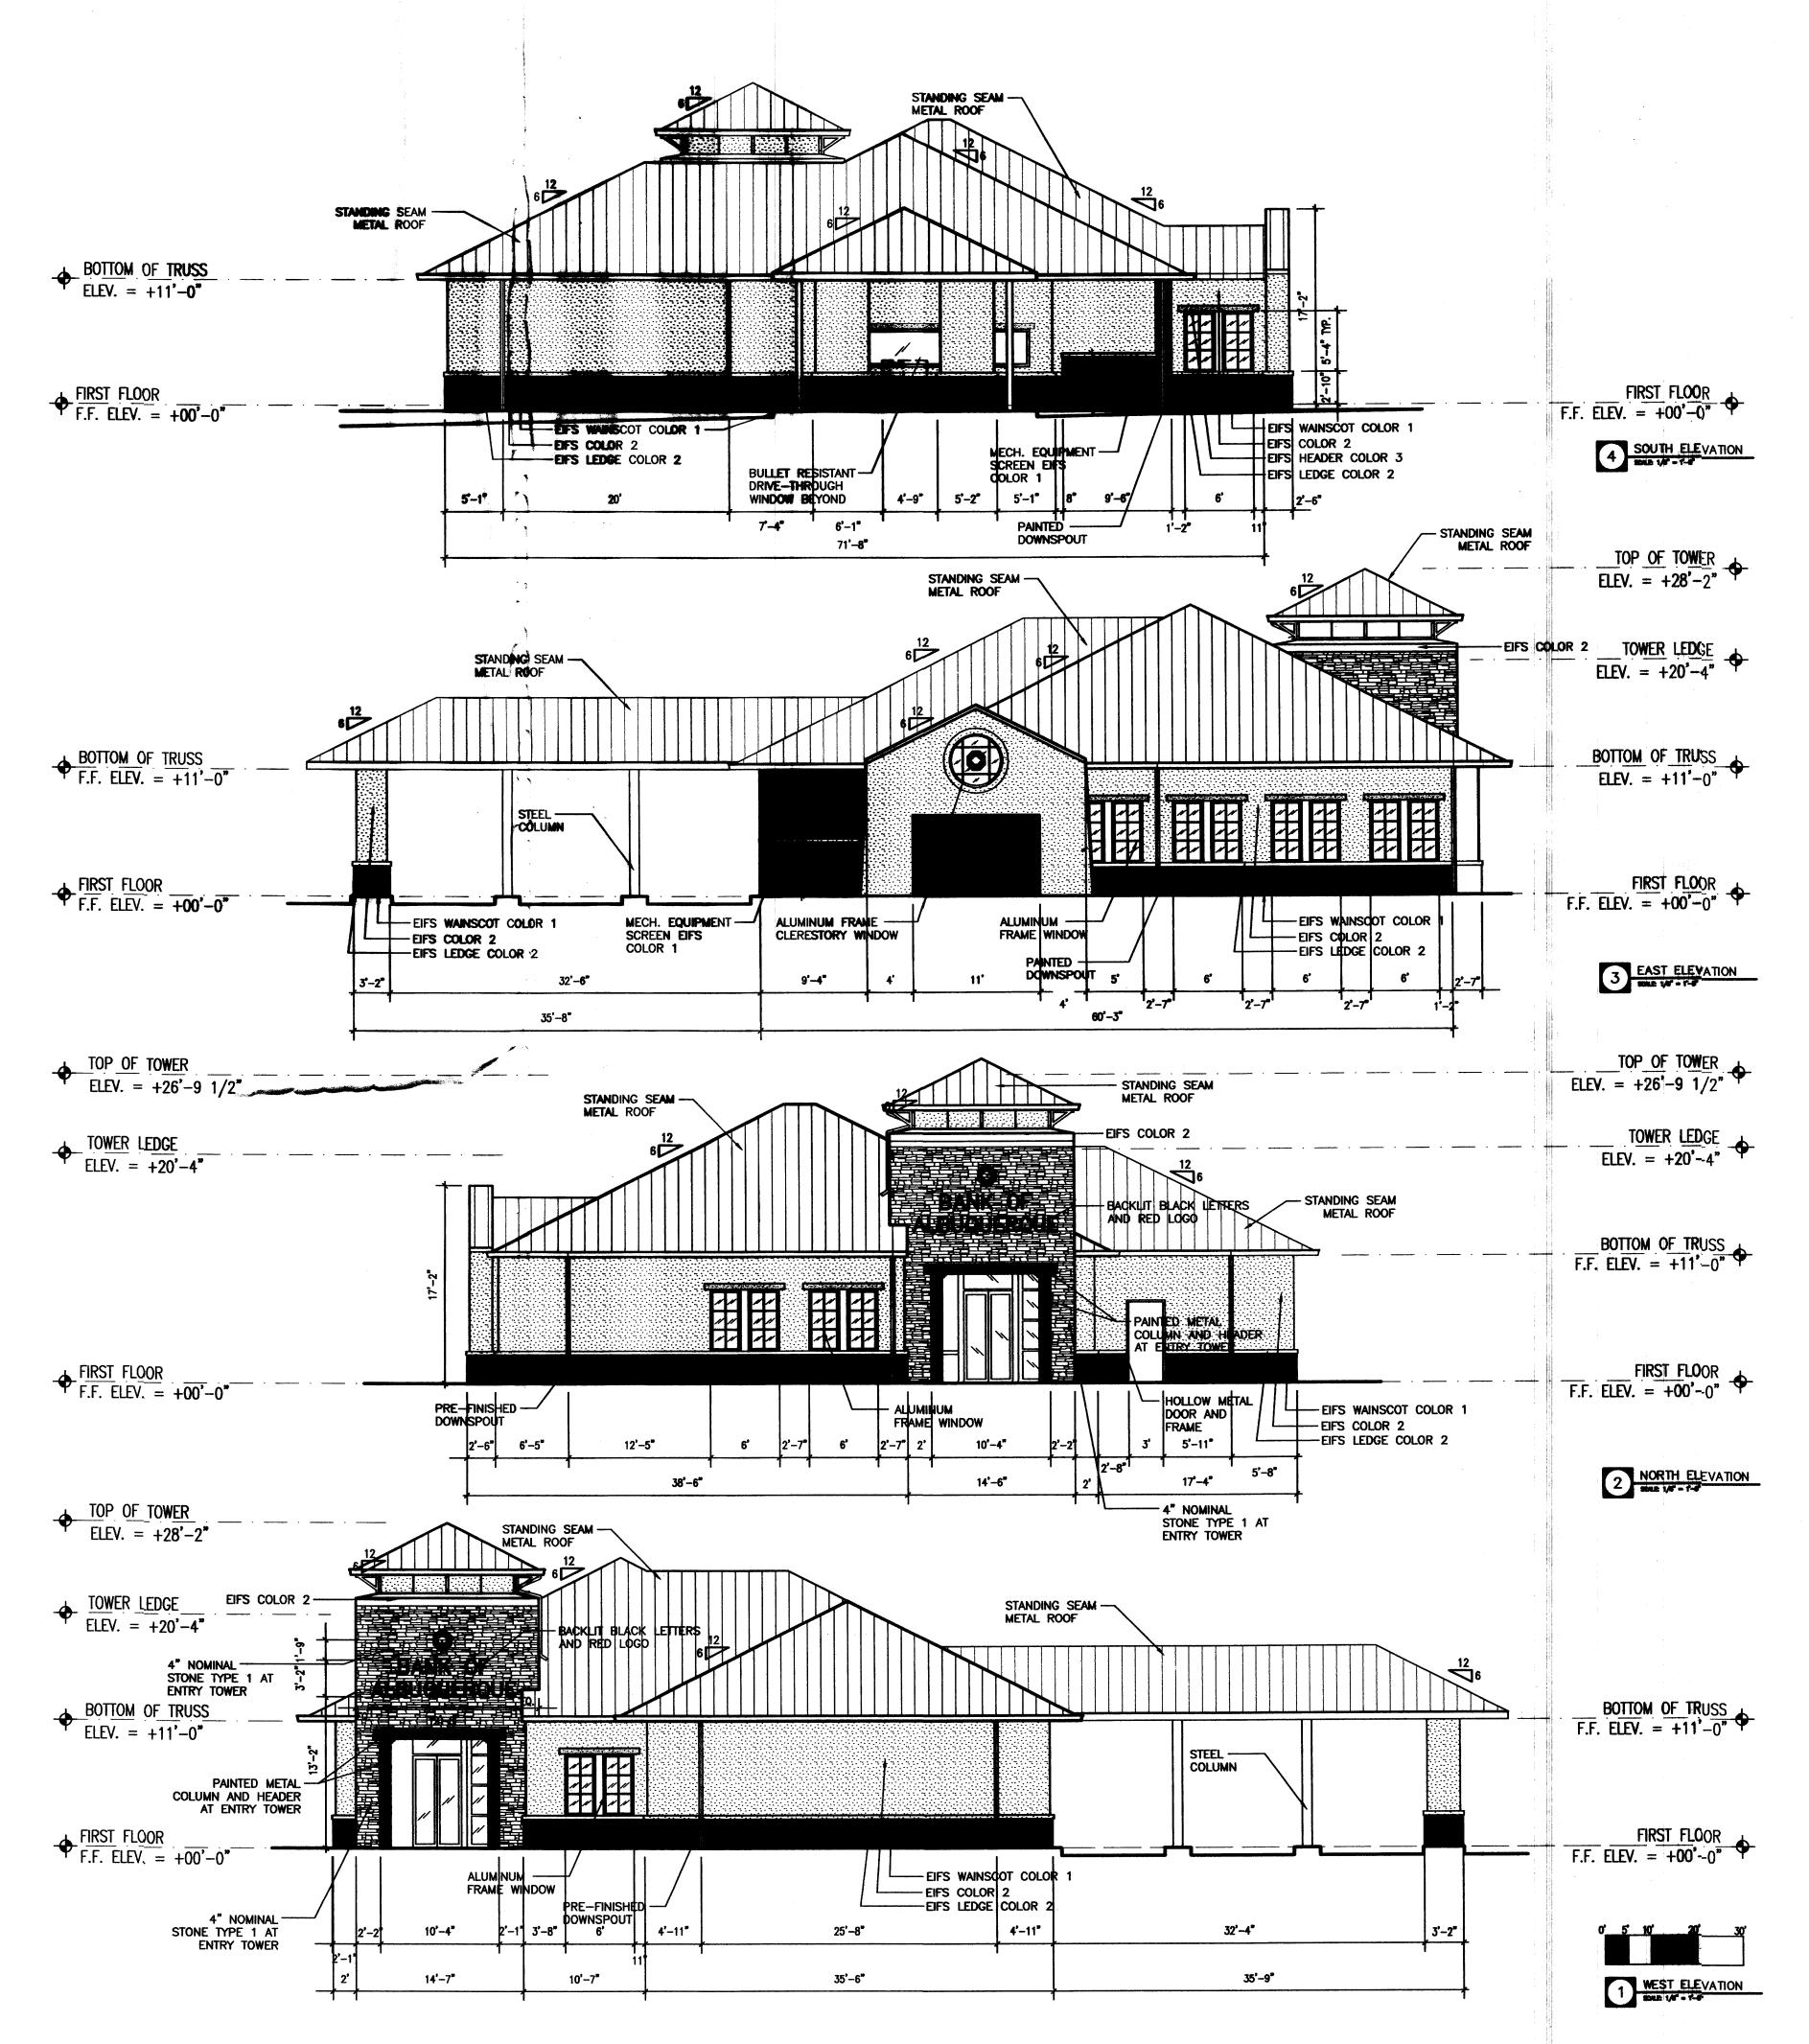
L-101

CONCEPTUAL LANDSCAPE PLAN



5 MONUMENT SIGN SCALE 1/4" = 1-6"

		EXTERIC F :	ISH LEGE'. D	
MATE	RAL	MANUFACTURER	DESCRIPTIO N	NO TES
DIVISIO	DN 4 - MASONRY			
	STO NEVENEERTYPE 1	-	BUFF; GROUND FACE	MORTARCOLOR H10 LIGHT BUFF
	FRE-FINISHED CONCRETE MASONRY UNIT	NORTHFIELD	BUFF; GROUND FACE	MORTARCOLOR H10 LIGHT BUFF
DIVISIO	DN 5 - METALS			
	TUBE STEEL BRACKET	SHERWIN WILLIAMS	LIGHT GRAY	PER SECTION 09900
	PAINTED STEEL COLUMN AND LINTEL	SHERWIN WILLIAMS	SAFTRON GOLD	PER SECTION 09900
	PRE-FINISHED METAL	PAC-CLAD	LIGHT GRAY	CANOPIES, BREAK METAL
DIVISIO	DN 6 - WOODS AND FLASTICS	· · · · · · · · · · · · · · · · · · ·		
	FASCIA BO ARD	-	LIGHT GRAY	PER SECTION 09900
DIVISIO	DN 7 - THERMALAND MOISTURE PROTECTION EXTERIOR INSULATION AND FINISH SYSTEM - COLOR1	DRYVIT	SAFTRON GOLD	TYPICAL COLOR PER SECTION 09900
	EXTERIOR INSULATION AND FINISH SYSTEM - COLOR2	DRYVIT	OFF-WHITE	ACCENT COLOR, PER SECTION 09900
	SHEET METAL ROOFING	PAC-CLAD	PAC-CLAD METALLIC - STONEWHITE	LOWRETLECTANCE
	SHEET METAL FLASHING AND TRIM	PAC-CLAD	PAC-CLAD METALLIC - STONEWHITE	LOWREFLECTANCE
	GUTTERS AND DOWNSPOUTS	PAC-CLAD	PAC-CLAD METALLIC - STONEWHITE	LOWREFLECTANCE
DIVISIO	DN 8-DOORSAND WINDOWS			
	ALUMINUM ENTRANCES AND STORETRO NT	KAWNEER	LIGHT GRAY POWDER COAT	
	ALUMINUM PACKAGEWINDOWS	THERMAL WINDOWS	LIGHT GRAY	
	BULLET-RESISTANT WINDOW	DIEBOLD	LIGHT GRAY	
			ODWANG BORED	
	TINTED SAFETY AND NO N-SAFETY GLASS	VIRACON	GRAY INSUL-SHIELD	

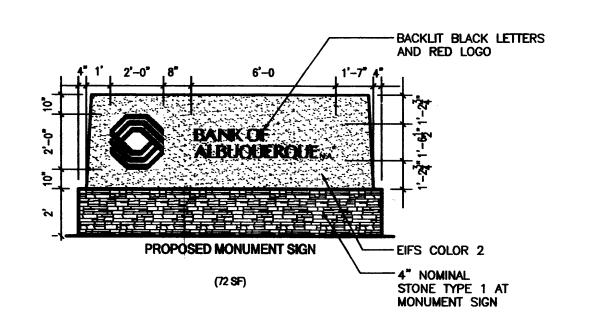



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BANK OF
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WYOMING BLVD. & CARMEL ALBUQUERQUE, NM



PROJECT NUMBER: 05053

CONSULTANT:

REVISIONS:

SEAL:

DESIGN DEVELOPMENT

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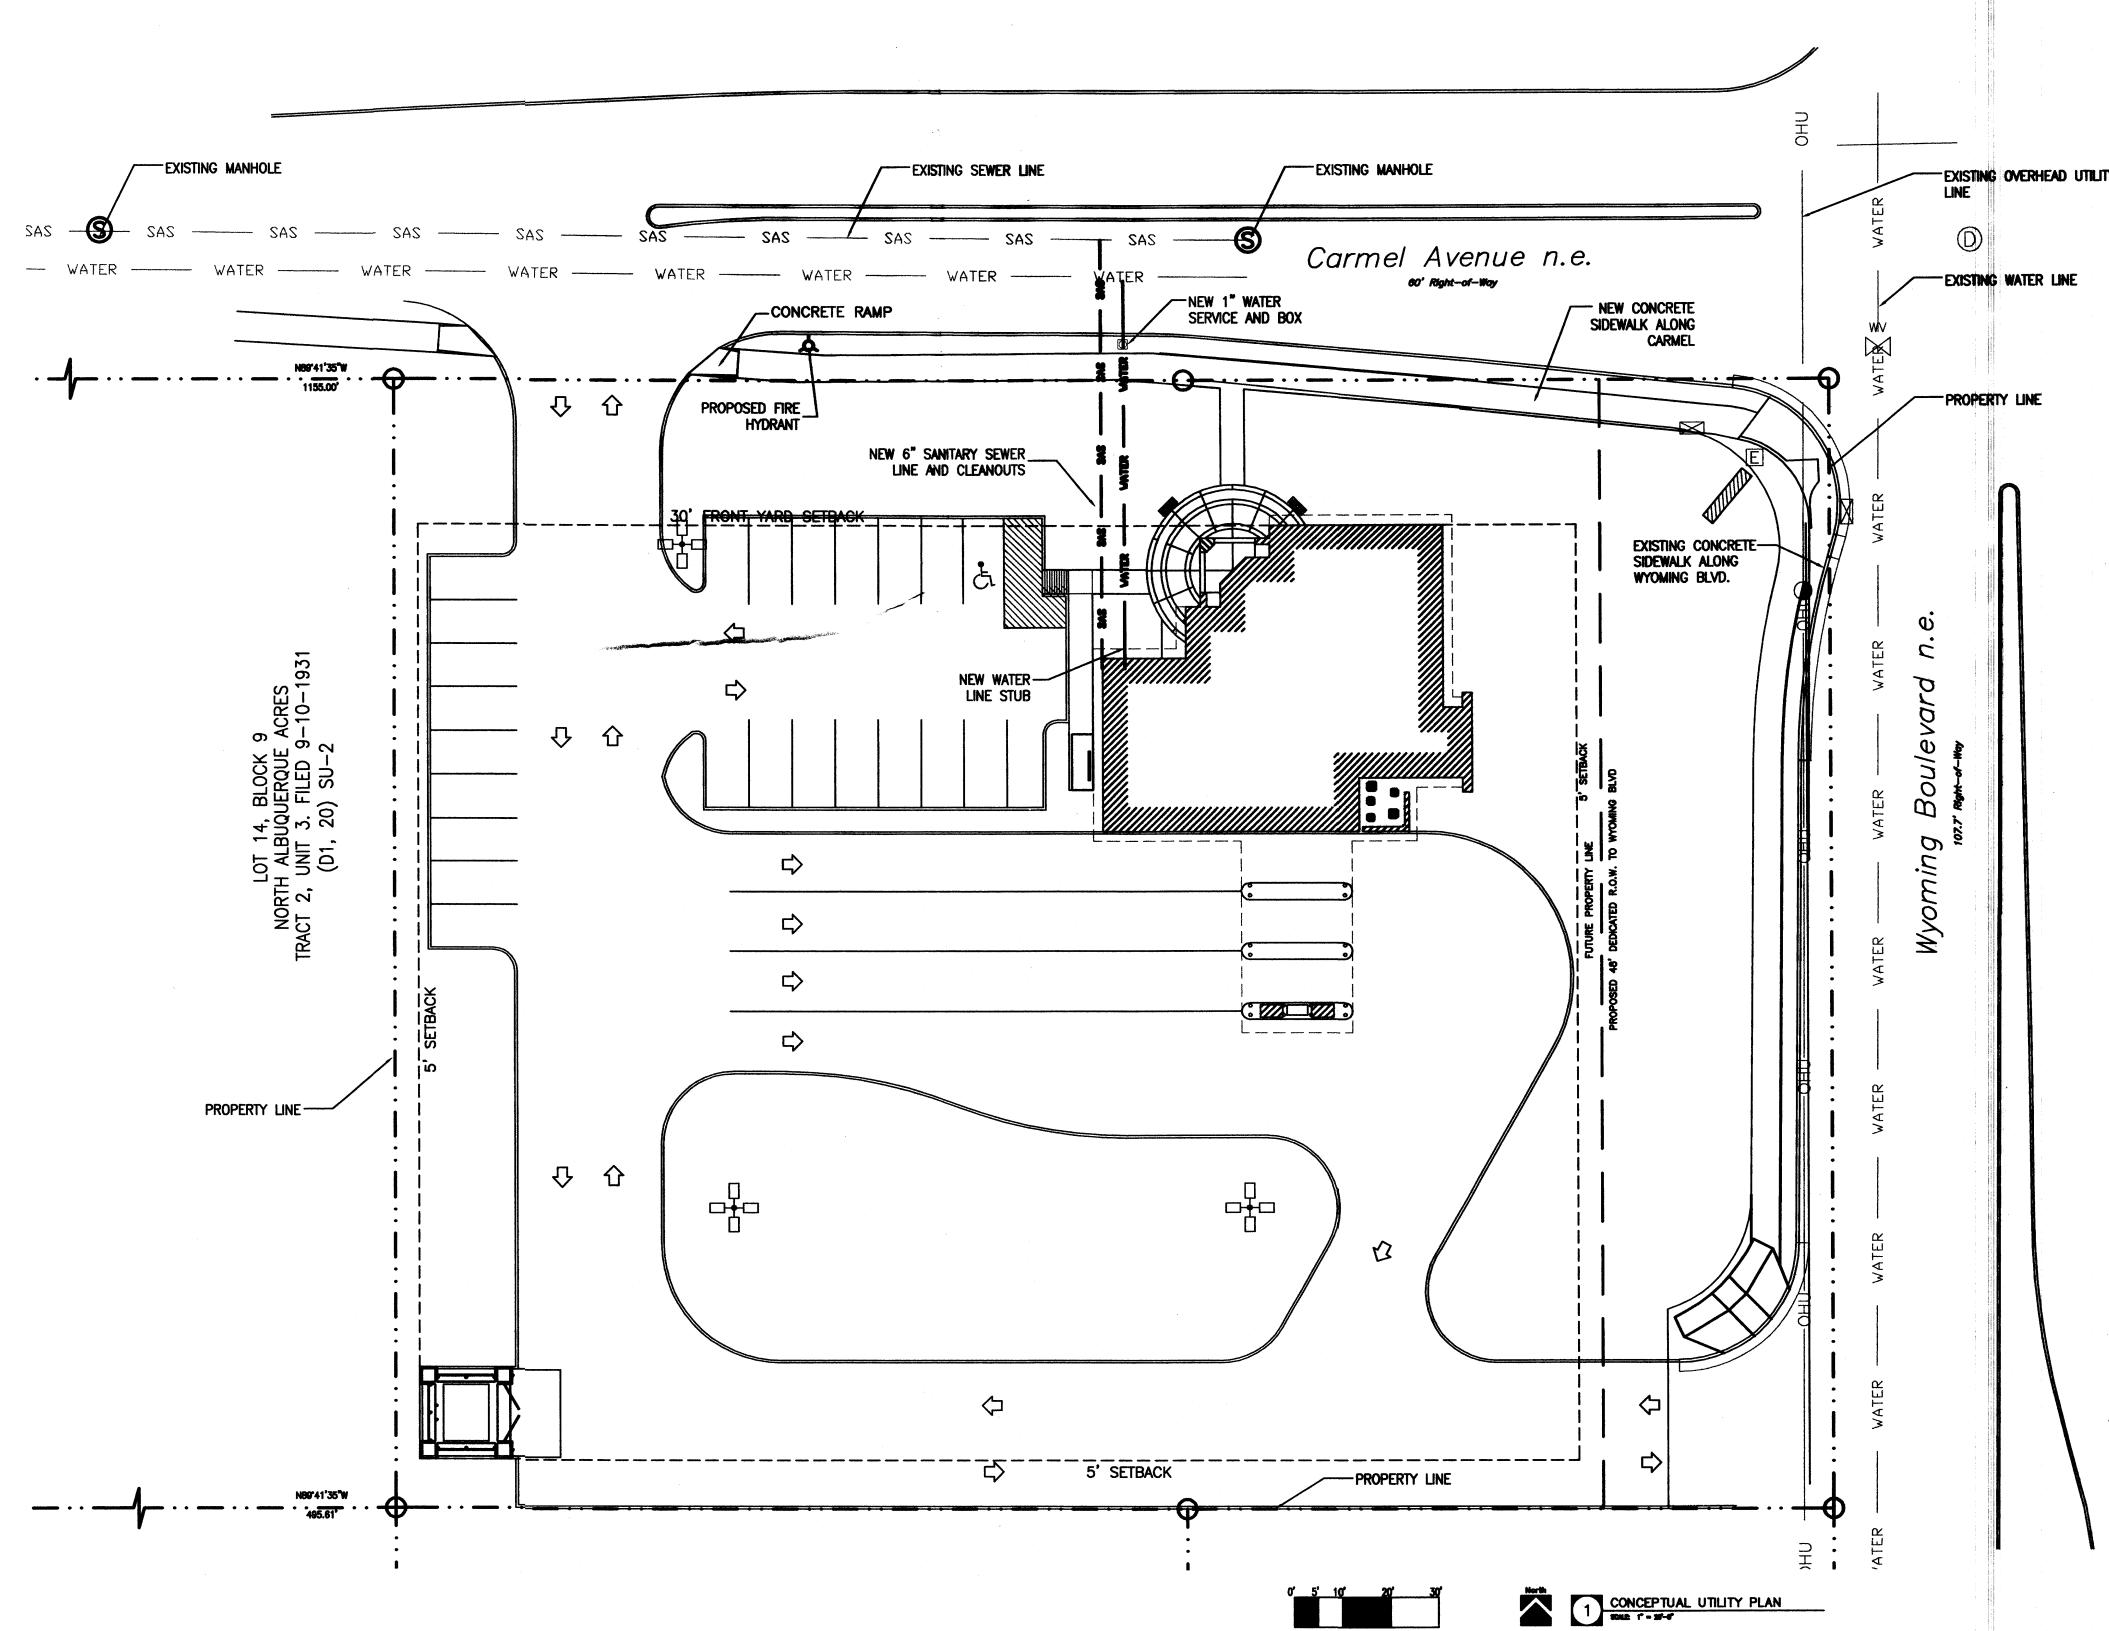
ISSUE DATE: 19 JUNE 2006

SHEET NUMBER:

A401

BUILDING AND STRUCTURE ELEVATIONS

MACES 37 MACES 37 MATER 37 MATER 37



SYMBOLS LEGEND

-OHU- = OVERHEAD UTILITY LINE

-sewer- = UNDERGROUND SEWER LINE

-water- = UNDERGROUND WATER LINE

= DRAINAGE MANHOLE


= TRAFFIC SIGNAL

S = SEWER MANHOLE

= WATER VALVE

= ELECTRIC RISER

= POWER POLE

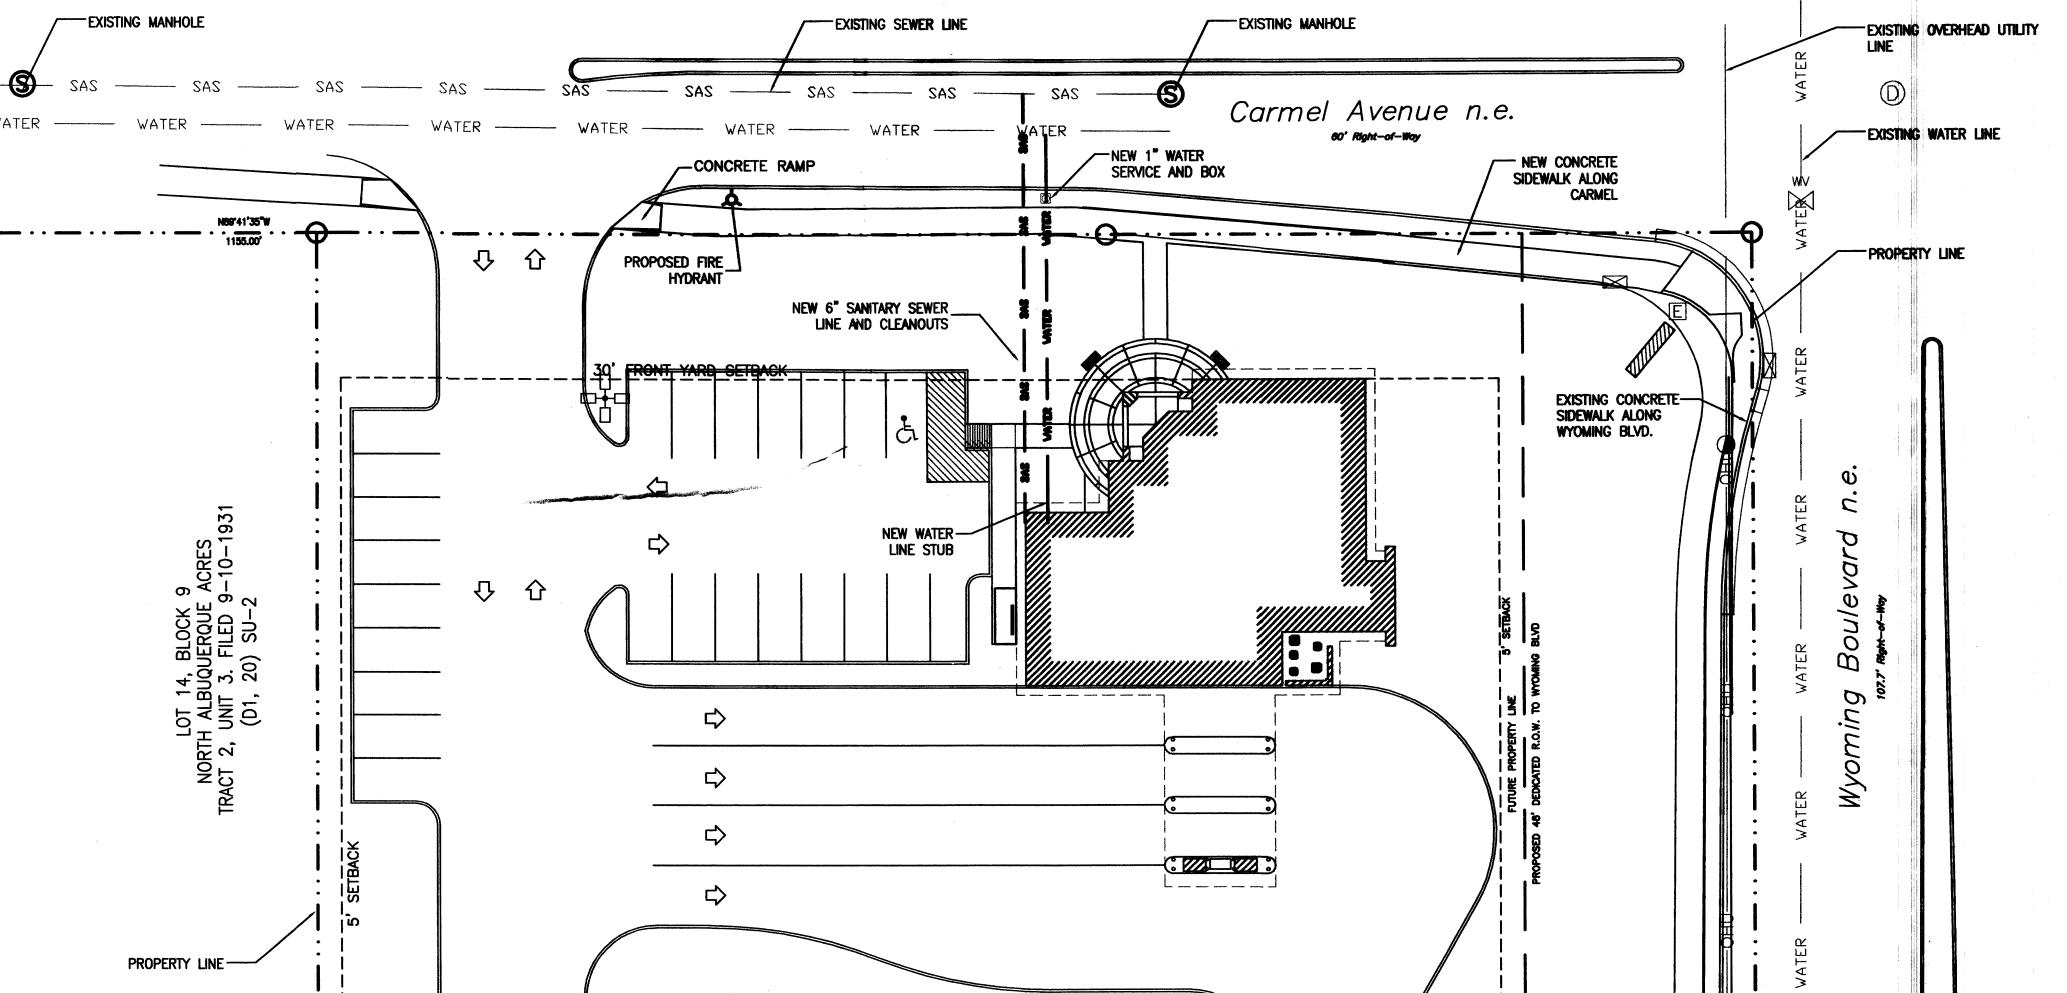

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PROJECT: BANK OF ALBUQUERQUE

WYOMING BLVD. & CARMEL ALBUQUERQUE, NM



PROJECT NUMBER: 05053

CONSULTANT:



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