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R E E VARIES TRACT A

3.7870 ACRES

CURVE	RADIUS	DELTA	ARC	BEARING	CHORD
C1	30.00	92'06'43"	48.23	N 49'46'08" W	43.20
C2	138.00	19"56'32"	48.03	N 06'35'34" E	47.79
C3	138.00	20'01'36"	48.24	N 13"21"05" W	47.99
C4	588.00	0979'33"	95,71	N 0177'01" E	95.60
<b>C</b> 5	312.00	0017'44"	1.61	N 05'54'59" E	1.61
C6	312.00	05'34'43"	30.38	N 02"58"45" E	30.37
C7	312.00	05"52'28"	31.99	N 03'07'37" E	31.97

P.S.#11463 WERE SET AT ALL PROPERTY CORNERS.

5: BASIS OF BEARINGS IS THE NEW MEXICO STATE PLANE COORDINATE SYSTEM, CENTRAL ZONE, NAD 1927.

7: BEARINGS AND DISTANCES SHOWN IN PARENTHESIS ARE RECORD.

9: CURRENT ZONING: SU-1 FOR 0-1 AND SELF STORAGE.

2: THIS PLAT SHOWS ALL EASEMENTS OF RECORD.
3: TOTAL AREA OF PROPERTY: 3.7870 ACRES.

6: DISTANCES ARE GROUND, BEARINGS ARE GRID.

8: DATE OF FIELD WORK: APRIL, 2003

#### FREE CONSENT

THE SUBDIVISION HEREON DESCRIBED IS WITH THE FREE CONSENT AND IN ACCORDANCE WITH THE DESIRES OF THE UNDERSIGNED OWNERS AND PROPRIETOR THEREOF. SAID OWNER / PROPRIETOR DOES HEREBY GRANT ANY AND ALL EASEMENTS AS MAY BE CREATED BY THIS PLAT. THOSE SIGNING AS OWNERS WARRANT THAT THEY HOLD AMONG THEM COMPLETE AND INDEFEASIBLE TITLES TO THE LAND SUBDIVIDED.

Town 98, KCC by 6-2-03
DATE

MANAGING


MEMBER

ACKNOWLEDGMENT MEMBER

ACKNOWLEDGMENT
THIS INSTRUMENT WAS ACKNOWLEDGED BEFORE ME A NOTARY PUBLIC

BY: Jower 98, LCC by loger Setych
OWNERS NAME


MY COMMISSION EXPIRES: 3-10-2007 BY: Que B. HULL

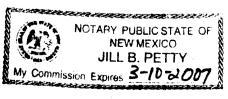

THIS IS TO C			ARE CUI		
UPC# 100905	6116102				

PROPERTY OWNER OF RECORD:

BERNALILLO CO. TREASURER'S OFFICE:\_\_\_

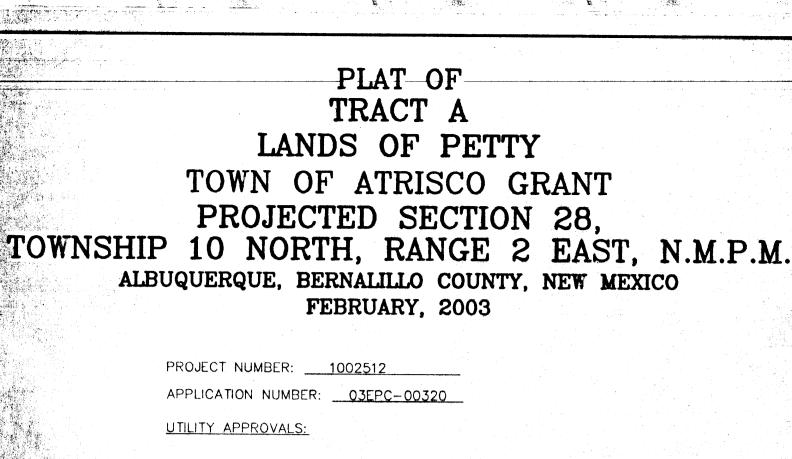

PNM ELECTRIC SERVICES PNM GAS SERVICES QWEST TELECOMMUNICATIONS COMCAST DATE NEW MEXICO UTILITIES DATE CITY APPROVALS 6.3.03 \*REAL PROPERTY DIVISION (CONDITIONAL) DATE \*\*ENVIRONMENTAL HEALTH DEPARTMENT (CONDITIONAL) DATE TRAFFIC ENGINEERING, TRANSPORTATION DIVISION DATE UTILITIES DEVELOPMENT DATE PARKS AND RECREATION DEPARTMENT DATE AMAFCA DATE CITY ENGINEER DATE DRB CHAIRPERSON, PLANNING DEPARTMEN APPROVAL AND CONDITIONAL ACCEPTANCE AS SPECIFIED BY THE ALBUQUERQUE SUBDIVISION ORDINANCE, CHAPTER 14 ARTICLE 14, REVISED ORDINANCES OF ALBUQUERQUE, NEW MEXICO, 1994

#### LEGAL DESCRIPTION:

ALBUQUERQUE PLANNING DIVISION

CITY PLANNER.

TRACT B

TRACT C

LOT 6

LOT 5

LOT 4

FND #4 R/I W/CAP

S 84"04'47" W

YGNACI

A CERTAIN TRACT OF LAND BEING THE REMAINING PORTION OF TRACT NUMBERED FORTY (40) TOGETHER WITH THE SOUTH ONE—HALF OF VACATED TOWER ROAD VACATED BY VACATION ACTION No. 1002642 ALL BEING SHOWN ON THE MAP SHOWING A PORTION OF TRACTS ALLOTTED FROM THE TOWN OF ATRISCO GRANT, FILED IN THE OFFICE OF THE COUNTY CLERK OF BERNALILLO COUNTY, NEW MEXICO ON DECEMBER 5, 1944 IN VOLUME D, FOLIO 117 AND 118 BEING MORE PARTICULARLY DESCRIBED AS FOLLOWS:

PARTICULARLY DESCRIBED AS FOLLOWS:
BEGINNING AT THE NORTHWEST CORNER OF THE HEREIN DESCRIBED TRACT, BEING
A POINT ON THE EASTERLY LINE OF 98th STREET, WHENCE THE CITY OF ALBUQUERQUE
CONTROL STATION "7-L9" HAVING NEW MEXICO STATE PLANE COORDINATES OF
X=352,978.14 AND Y=1,478,346.71 BEARS FIRST N. 02 deg. 21' 46" E., A DISTANCE
OF 69.71 FEET AND THENCE S. 61 deg. 35' 49" W., A DISTANCE OF 265.24 FEET RUNNING:
THENCE N. 84 deg. 04' 17" E., A DISTANCE OF 117.03 FEET TO THE NORTHEAST CORNER;
THENCE S. 05 deg. 55' 43" E., A DISTANCE OF 30.00 FEET TO A POINT;
THENCE S. 05 deg. 54' 28" E., A DISTANCE OF 1065.51 FEET TO THE SOUTHEAST CORNER,
BEING A POINT ON THE NORTHERLY LINE OF SAN YENACIO BOAD. A

THENCE S. 84 deg. 04' 47" W., ALONG THE NORTHERLY LINE OF SAN YGNACIO ROAD, A DISTANCE OF 145.47 FEET TO A POINT OF CURVE; THENCE 48.23 FEET ALONG THE ARC OF A CURVE TO THE RIGHT HAVING A RADIUS OF 30.00' AND A CHORD BEARING AND DISTANCE OF N. 49 deg. 46' 08" E., 43.30 FEET TO A POINT ON THE EASTERLY LINE OF 98th STREET; THENCE ALONG THE FASTERLY LINE OF 98th STREET FOR THE NEXT B CALLS:

THENCE ALONG THE EASTERLY LINE OF 98th STREET FOR THE NEXT 8 CALLS: 48.03 FEET ALONG THE ARC OF A CURVE TO THE RIGHT HAVING A RADIUS OF 138.00 FEET AND A CHORD BEARING AND DISTANCE OF N. 06 deg. 35' 34" E., 47.79 FEET TO A POINT;

THENCE N. 16 deg. 33' 53" E., A DISTANCE OF 10.90 FEET TO A POINT;
THENCE N. 03 deg. 22' 46" W., A DISTANCE OF 81.80 FEET TO A POINT;
THENCE N. 23 deg. 19' 25" W., A DISTANCE OF 10.90 FEET TO A POINT OF CURVE;
THENCE 48.24 FEET ALONG THE ARC OF A CURVE TO THE RIGHT HAVING A RADIUS OF
138.00 FEET AND A CHORD BEARING AND DISTANCE OF N. 13 deg. 21' 05" W., 47.99 FEET
TO A POINT;

THENCE N. 03 deg. 22' 46" W., A DISTANCE OF 742.08 FEET TO A POINT OF CURVE; THENCE 95.71 FEET ALONG THE ARC OF A CURVE TO THE RIGHT HAVING A RADIUS OF 588.00 FEET AND A CHORD BEARING AND DISTANCE OF N. 01 deg. 17' 01" E., 95.60 FEET TO A POINT OF REVERSE CURVE; THENCE 31.99 FEET ALONG THE ARC OF A CURVE TO THE LEFT HAVING A RADIUS OF

THENCE 31.99 FEET ALONG THE ARC OF A CURVE TO THE LEFT HAVING A RADIUS OF 312.00 FEET AND A CHORD BEARING AND DISTANCE OF N. 03 deg. 07' 37" E., 31.97 FEET TO THE NORTHWEST CORNER AND PLACE OF BEGINNING CONTAINING 3.7870 ACRES MORE OR LESS.

SURVEYORS CERTIFICATE:

STATE OF NEW MEXICO ) S.S.

COUNTY OF BERNALILLO )

I, ANTHONY L. HARRIS, A DULY PROFESSIONAL LAND SURVEYOR, UNDER THE LAWS OF THE STATE OF NEW MEXICO, DO HEREBY CERTIFY THAT THE PLAT WAS PREPARED UNDER MY DIRECT SUPERVISION. THAT I AM RESPONSIBLE FOR SAID PLAT AND MEETS THE REQUIREMENTS FOR MONUMENTATION AND SURVEY OF THE ALBUQUERQUE SUBDIVISION ORDINANCE AND IS TRUE AND CORRECT TO THE BEST OF MY KNOWLEDGE AND BELIEF AND MEETS THE MINIMUM REQUIREMENTS FOR LAND SURVEYS AS SET... FORTH BY THE STATE OF NEW MEXICO.

GIVEN UNDER MY HAND AND SEAL AT ALBUQUERQUE, NEW MEXICO, THIS 2003.

ANTHONY L. HARRIS. P.S. #11463

ANTHONY L. HARRIS. P.S. # 11463

THARRIS SURVEYING, INC. PHONE: (505) 889-8056

ALBUQUERQUE, NEW MEXICO 87110

FAX: (505) 889-8645

PLAT OF TRACT A LANDS OF PETTY TOWN OF ATRISCO GRANT NORTH ONE-HALF VACATED TOWER ROAD PROJECTED SECTION 28, VACATED BY
VACATION ACTION
No. 1002642 TOWNSHIP 10 NORTH, RANGE 2 EAST, N.M.P.M. N 84'04'17" E ALBUQUERQUE, BERNALILLO COUNTY, NEW MEXICO 115.53 SOUTH 1/2 OF FEBRUARY, 2003 VACATED TOWER ROAD VICINITY MAP No. 19 138.40 VACATED BY VACATION ACTION No. 1002642 PROJECT NUMBER: \_\_\_\_1002512 APPLICATION NUMBER: \_\_\_03EPC-00320 Applies Lies No ACS STATION "7-L9" X=352,978.14 Y=1,478,346.71GRD TO GRID=0.99967727  $\Delta \propto = -00^{\circ}$  16' 56" 43 OR 800730 **UTILITY APPROVALS:** 6-12-03 CENTRAL ZONE, NAD 1927 TRACT A 6-23-03 SCALE: 1" = 60'DISCLOSURE STATEMENT: THE PURPOSE OF THIS PLAT IS TO COMBINE THE REMAINING PORTION OF TRACT 40 WITH THE SOUTH ONE-HALF OF VACATED TOWER ROAD AND GRANT ANY EASEMENTS AS SHOWN. PARTMENT (CONDITIONAL) GENERAL NOTES: 1: UNLESS NOTED, No. 4 REBAR WITH CAP STAMPED P.S.#11463 WERE SET AT ALL PROPERTY CORNERS. 2: THIS PLAT SHOWS ALL EASEMENTS OF RECORD. 3: TOTAL AREA OF PROPERTY: \_\_\_\_\_\_\_\_\_ ACRES. TRACT B 4: TALOS LOG NO. \_\_\_\_2003147314 5: BASIS OF BEARINGS IS THE NEW MEXICO STATE PLANE COORDINATE SYSTEM, CENTRAL ZONE, NAD 1927. 6: DISTANCES ARE GROUND, BEARINGS ARE GRID. 7: BEARINGS AND DISTANCES SHOWN IN PARENTHESIS ARE RECORD. 8: DATE OF FIELD WORK: APRIL, 2003 9: CURRENT ZONING: SU-1 FOR 0-1 AND SELF STORAGE. TRACT A ⋛∽ APPROVAL AND CONDITIONAL ACCEPTANCE AS SPECIFIED BY THE 3.8404 ACRES ALBUQUERQUE SUBDIVISION ORDINANCE, CHAPTER 14 ARTICLE 14, REVISED ORDINANCES OF ALBUQUERQUE, NEW MEXICO, 1994 VARIE VARIE N Lu PLANNER. ALBUQUERQUE PLANNING DIVISION TRACT C CURVE **RADIUS** DELTA ARC BEARING CHORD LEGAL DESCRIPTION: 30.00 92'06'43" 48.23 N 49'46'08" W 43.20 A CERTAIN TRACT OF LAND BEING THE REMAINING PORTION OF TRACT NUMBERED FORTY (40) TOGETHER WITH THE SOUTH ONE-HALF OF VACATED TOWER ROAD VACATED BY VACATION ACTION 138.00 19'56'32" 48.03 N 06'35'34" E 47.79 C3 138.00 48.24 N 13"21"05" W 47.99 No. 1002642 ALL BEING SHOWN ON THE MAP SHOWING A PORTION OF TRACTS ALLOTTED FROM C4 588.00 0919'33" 95.71 N 0177'01" E 95.60 THE TOWN OF ATRISCO GRANT, FILED IN THE OFFICE OF THE COUNTY CLERK OF BERNALILLO C5 312.00 09"33'29" 52.05 N 01:17'07"E 51.99 COUNTY, NEW MEXICO ON DECEMBER 5, 1944 IN VOLUME D, FOLIO 117 AND 118 BEING MORE PARTICULARLY DESCRIBED AS FOLLOWS: BEGINNING AT THE NORTHWEST CORNER OF THE HEREIN DESCRIBED TRACT, BEING A POINT ON THE EASTERLY LINE OF 98th STREET, WHENCE THE CITY OF ALBUQUERQUE CONTROL STATION "7-L9" HAVING NEW MEXICO STATE PLANE COORDINATES OF X=352,978.14 AND Y=1,478,346.71 BEARS X=352,978.14 AND Y=1,478,346.71 BEARS

S. 83 deg. 28 09" W., A DISTANCE OF 123,43 FEET RUNNING:
THENCE N. 84 deg. 04' 17" E., A DISTANCE OF 145,53 FEET TO THE NORTHEAST CORNER;
THENCE S. 05 deg. 55' 43" E., A DISTANCE OF 50.00 FEET TO A POINT;
THENCE S. 05 deg. 54' 28" E., A DISTANCE OF 1065.51 FEET TO THE SOUTHEAST CORNER,
BEING A POINT ON THE NORTHERLY LINE OF SAN YGNACIO ROAD;
THENCE S. 84 deg. 04' 47" W., ALONG THE NORTHERLY LINE OF SAN YGNACIO ROAD, A
DISTANCE OF 145.47 FEET TO A POINT OF CURVE;
THENCE 48.23 FEET ALONG THE ARC OF A CURVE TO THE RIGHT HAVING A RADIUS OF
30.00' AND A CHORD BEARING AND DISTANCE OF N. 49 deg. 46' 08" W. 43 20 FEFT TO FREE CONSENT FND #4 R/E w/CAP THE SUBDIVISION HEREON DESCRIBED IS WITH THE FREE CONSENT AND IN ACCORDANCE WITH THE DESIRES OF THE UNDERSIGNED OWNERS AND PROPRIETOR THEREOF. SAID OWNER / PROPRIETOR 30.00' AND A CHORD BEARING AND DISTANCE OF N. 49 deg. 46' 08" W., 43.20 FEET TO A POINT ON THE EASTERLY LINE OF 98th STREET;
THENCE ALONG THE EASTERLY LINE OF 98th STREET FOR THE NEXT 8 CALLS: LOT 6 DOES HEREBY GRANT ANY AND ALL EASEMENTS AS MAY BE CREATED BY THIS PLAT. THOSE SIGNING AS OWNERS WARRANT 48.03 FEET ALONG THE ARC OF A CURVE TO THE RIGHT HAVING A RADIUS OF 138.00 THAT THEY HOLD AMONG THEM COMPLETE AND INDEFEASIBLE FEET AND A CHORD BEARING AND DISTANCE OF N. 06 deg. 35' 34" E., 47.79 FEET TO TITLES TO THE LAND SUBDIVIDED. THENCE N. 16 deg. 33' 53" E., A DISTANCE OF 10.90 FEET TO A POINT;
THENCE N. 03 deg. 22' 46" W., A DISTANCE OF 81.80 FEET TO A POINT;
THENCE N. 23 deg. 19' 25" W., A DISTANCE OF 10.90 FEET TO A POINT OF CURVE;
THENCE 48.24 FEET ALONG THE ARC OF A CURVE TO THE RIGHT HAVING A RADIUS OF 138.00 FEET AND A CHORD BEARING AND DISTANCE OF N. 13 deg. 21' 05" W., 47.99 FEET MANAGING SUBDIVI CH 26. PAGE THENCE N. 03 deg. 22' 46" W., A DISTANCE OF 742.08 FEET TO A POINT OF CURVE; THENCE 95.71 FEET ALONG THE ARC OF A CURVE TO THE RIGHT HAVING A RADIUS OF 588.00 FEET AND A CHORD BEARING AND DISTANCE OF N. 01 deg. 17' 01" E., 95.60 FEET MEMBET LOT 5 ACKNOWLEDSMENT TO A POINT OF REVERSE CURVE; WAS ACKNOWLEDGED BEFORE ME A NOTARY PUBLIC THENCE 31.99 FEET ALONG THE ARC OF A CURVE TO THE LEFT HAVING A RADIUS OF 312.00 FEET AND A CHORD BEARING AND DISTANCE OF N. 01 deg. 17'07" E., 51.99 FEET TO THE NORTHWEST CORNER AND PLACE OF BEGINNING CONTAINING 3.8405 ACRES MORE LOT 4 07/24/2003 11:21A NOTARY PUBLIC STATE OF SURVEYORS CERTIFICATE: STATE OF NEW MEXICO ) S.S. **NEW MEXICO** JILL B. PETTY COUNTY OF BERNALILLO ) My Commission Expires 3-10-2007 FND #4 R/B I, ANTHONY L. HARRIS, A DULY PROFESSIONAL LAND SURVEYOR, UNDER THE LAWS OF THE STATE OF NEW MEXICO, DO HEREBY CERTIFY THAT THE PLAT WAS PREPARED UNDER MY DIRECT SUPERVISION, THAT I AM RESPONSIBLE FOR SAID PLAT AND MEETS THE REQUIREMENTS FOR MONUMENTATION AND ROAD SURVEY OF THE ALBUQUERQUE SUBDIVISION ORDINANCE AND IS TRUE AND CORRECT TO THE BEST OF YGNACIO SURVEY OF THE ALBUQUERQUE SUBDIVISION UNDINANCE AND IS TRUE AND CONNECT TO THE MY KNOWLEDGE AND BELIEF AND MEETS THE MINIMUM REQUIREMENTS FOR EARNO SURVEYS AS SETTING BY THE STATE OF NEW MEXICO. GIVEN UNDER MY HAND AND SEAL AT ALBUQUERQUE, NEW MEXICO, THIS 2nd DAY OF June 2003. THIS IS TO CERTIFY THAT TAXES ARE CURRENT AND PAID ON UPC#\_100905611610230806

PROPERTY OWNER OF RECORD: BERNALILLO CO. TREASURER'S OFFICE: \_\_\_ PHONE: (505) 889-8

FAX: (505) 889-8845

JELANIS SURVEYING, INC.

2412-D MONROE STREET N.E.

ALBUQUERQUE, NEW MEXICO 87110

L-9-Z SCALE IN FEET VICINITY MAP

VACANT LOT

CURVE RADIUS

С3

C4

**C5** 

30.00

138.00

138.00

588.00

312.00

312.00

312.00

DELTA

92\*06'43\*

19\*56′32\*

09\*19'33"

00\*17'44"

05°34′43**″** 

ARC

48,23

95.71

1.61

30.38

31.99

PLAT OF TOPOGRAPHY TRACT 40

PROJECTED SECTION 28, TOWNSHIP 10 NORTH, RANGE 2 EAST, N.M.P.M. TOWN OF ATRISCO GRANT ALBUQUERQUE, BERNALILLO COUNTY, NEW MEXICO

APPROVALS: FEBRUARY, 2003 PROJECT NO. 1002512 EPC CASE NUMBER 03EPC-00320 CITY PLANNER / ALBUQUERQUE ELF TORAGE PARKS DEPARTMENT AND GENERAL SERVICES READER BOARD-TRAFFIC ENGINEER, TRANSPORTATION CMU BLOCK TO-MATCH BUILDINGS CITY ENGINEER, ENGINEERING DIVISION SIGN DETAIL N.T.S. ALBUQUERQUE METROPOLITAN FLOOD CONTROL

TYPICAL BUILDING MOUNTED SITE LIGHT

FEATURES

HOUSING — Rear housing is rugged, corrosion-resistent, die-cast aluminum. Corrosion-resistent external hardware includes slotted hex-head and temper-proof fasteners. Finish is dark bronze thermoset polyester powder, electrostatically applied.

BALLAST — High-reactance, high power factor. Encased-and-potted solid-state ignitors. Ballast is copper wound and 100% factory tested. Meets ANSI standards and is UL listed. Electrical components are mounted on back housing. (For 50 hertz availability, consult factory).

OPTICS — Reflector is finished in white thermoset polyaster powder, electrostatically applied. Front housing and refractor are one-piece, injection-molded, UV-stabilized polycarbonate. Standard finish on opaque portion of front cover and back housing is dark bronze polyeater enamel. Refractor is sealed and gasketed to inhibit the entrance of outside

INSTALLATION — Top 3/4" threeded wiring access. Back access through removable 3/4" knockout. Feed-thru wiring can be achieved by using a condulet tee. Mount on any flet vertical surface.

SDCKET — Porcelain, horizontally-oriented, medium-base socket with copper alloy, nickel-plated screw shell and center contact. UL listed 660V, 600V and 4KV pulse rated.

LISTING — UL listed suitable for wet locations. Listed and labeled to com-ply with Canadian and Maxican Standards (see Options). IP64 rated in accordance with IEC Standard 529.

NOTE: Not recommended for use in car wash interior applications.

HIGH PRESSURE SODIUM 8' to 25' Mounting Height 15-7/16" (39.2cm) Width: 16-1/8" (41cm) Depth: 7-3/4" (19.7cm) Weight: 14 to 15 lbs. (6 to / kg)

10025/2

2. Sheet ST-1 Noti # 2 re: Light of Veify language against regulations. 0≥ OK **4**00 **EXISTING** CUL-D-SAC Z G LANE OF LUMETA LIDEZ VIGIL FILED APPEL 21, 1992 VILLING AS, FOLIO 141 65'-5 1/4" TRACT D TRACT C VACANT LUT EXIST. RETAINING TRACT B VACANT LOT 1030'-0" VACANT LOT BULDING-D 53'-4 11 <u>6</u> BULDAYO A BULDING-G 780'-0" BULDING-C 1.7870 ACRES VACANT LAN 518'-0" BULDING-F BULDING-B 120'-0" 98th STREET 1 SITE PLAN AFD PLANS CHECKING OFFICE 124' R/W & VARIES 924-3611 APPROVED/2019/APPROVED/2019 GRAPHIC SCALE HYDRANT(S) C.... SIGNATURE & LALL ZONING DESIGN DATA UBC CODE DESIGN DATA **GENERAL NOTES** KEYED NOTES ZONING LOT AREA OCCUPANCY GROUP

TOTAL BUILDING AREA

LANDSCAPING REQUIRED

LANDSCAPING PROVIDED

PARKING REQUIREMENTS

OFFICE AREA

= 0-1 TO SU-1 =159,840 SF., 3.67 ACRES

= 159,840 S.F. (GROSS) - 64,379 S.F. (BLDG.) = 95,461 S.F. (NET) = 15% OF LOT 95,461 SF. = 14,319 S.F.

= 64,379 SF.

**BUILDING SF** 

BUILDING "C BUILDING "D

BUILDING "G"

TOTAL STORAGE SE

TOTAL BUILDING SF.

TOTAL OFF./APT./GAR. SF.

11,800 SF

7,950 SF

7,600 SF

1,500 SF

576 SF

3,359 SF.

64,379 SF.

61,020 SF

BUILDING

BUILDING

**APARTMENT** 

GARAGE

5-27-03

WATER UTILITIES DEPARTMENT

TYPE OF CONSTRUCTION = V-N, II-N

= 61,470 S.F.

= 2,783 S.F. = 576 S.F.

= 64,829 S.F.

= 1,500 PSI

= 3,000 PSI

= LUMBER: Fb = 970 MIN.

= 15 PSF DL, 20 PSF LL

= 16.4 PSF HORIZ. (75 MPH WIND)

= STEEL: 50,000 PSI.

= SLAB ON GRADE

= 2B

STORAGE BUILDINGS

APARTMENT/OFFICE

SEISMIC ZONE

STRESS VALUES

TOTAL BUILDING AREA

SOIL BEARING CAPACITY

CONCRETE STRENGTH

WIND DESIGN LOAD

ROOF DESIGN LOAD

FLOOR DESIGN LOAD

CORRIDOR DESIGN LOAD = N/A

1. SPLIT FACE CMU.

LANDSCAPE AREA

6. 2" ASPHALT PAVING

7. 4" SEWER LINE 8. 1 1/2" GAS LINE

10. NEW FIRE HYDRANT.

16. 24' ROLLING GATE

12. NEW CONCRETE SIDEWALK.

. CONCRETE DRIVE-PAD

14. RIGHT TURN ONLY AT EXIT

OVER 2x6 FRAMING

9. 1" WATER LINE

CHORD

47.99

95.60

31.97

BEARING

N 49°46'08" W

N 01\*17'01" E

N 05\*54'59"

N 02\*58'45' E

N 03\*07'37" E

48.03 N 06\*35'34'

48.24 N 13\*21'05" W

SMOOTH FACE CMU WALL

DUMSTER ENCLOSURE SEE DET. 5/ST-2

5. 2-12'x6' H. WROUGHT IRON GATES

11. BUILDING MOUNTED SITE LITE (SHEILDED)

15. FREE STANDING SIGN, SEE DET. A/ST-1

17. 2 HOUR FIRE RATED SEPERATION WALL

2 LAYERS OF 5/8" TYPE 'X' GYP. BD.

18. CONC. STEP DOWN AT CHANGE OF ELEVATION

Michael Holton 5-2 REFUSE DEPARTMENT wilcomply w/COA Specs

BENNETT

REVISION DATE

OF NEW

RICHARD P

2. LIGHTING: LIGHTING SHALL NOT HAVE AN OFFSITE LUMINANCE GREATER THAN 1000 FOOT LAMBERTS MEASURED FROM ANY PRIVATE PROPERTY IN A RESIDENTIAL ZONE. DATE 05-20-03 PREMISE ID ADDRESS SHALL BE LEGIBLE AND VISIBLE FROM THE STREET FRONTING THE PROPERTY AND SHALL CONTRAST

1. PAVING SHALL BE MAINTANED LEVEL AND SERVICEABLE, SHALL BE BLACKTOP OR EQUAL, 2" INCHES OF ASPHALTIC CONCRETE ON A PRIME COAT OVER A FOUR INCH COMPACTED

5. NEW HYDRANTS (IF REQUIRED) TO BE INSTALLED SHALL BE MADE SERVICEABLE PRIOR TO AND DURING CONSTRUCTION


6. FULL CUT-OFF LIGHT FIXTURES SHOULD ALSO BE REQUIRED TO MITIGATE ANY FUGITVE LIGHT AND SHALL COMPLY WITH THE ZONING CODE REGARDING LUMINANCE.


3. IRRIGATION: SEE LANDSCAPE PLAN

TO ITS BACKGROUND.

SHEET NUMBER

**ST-1** 

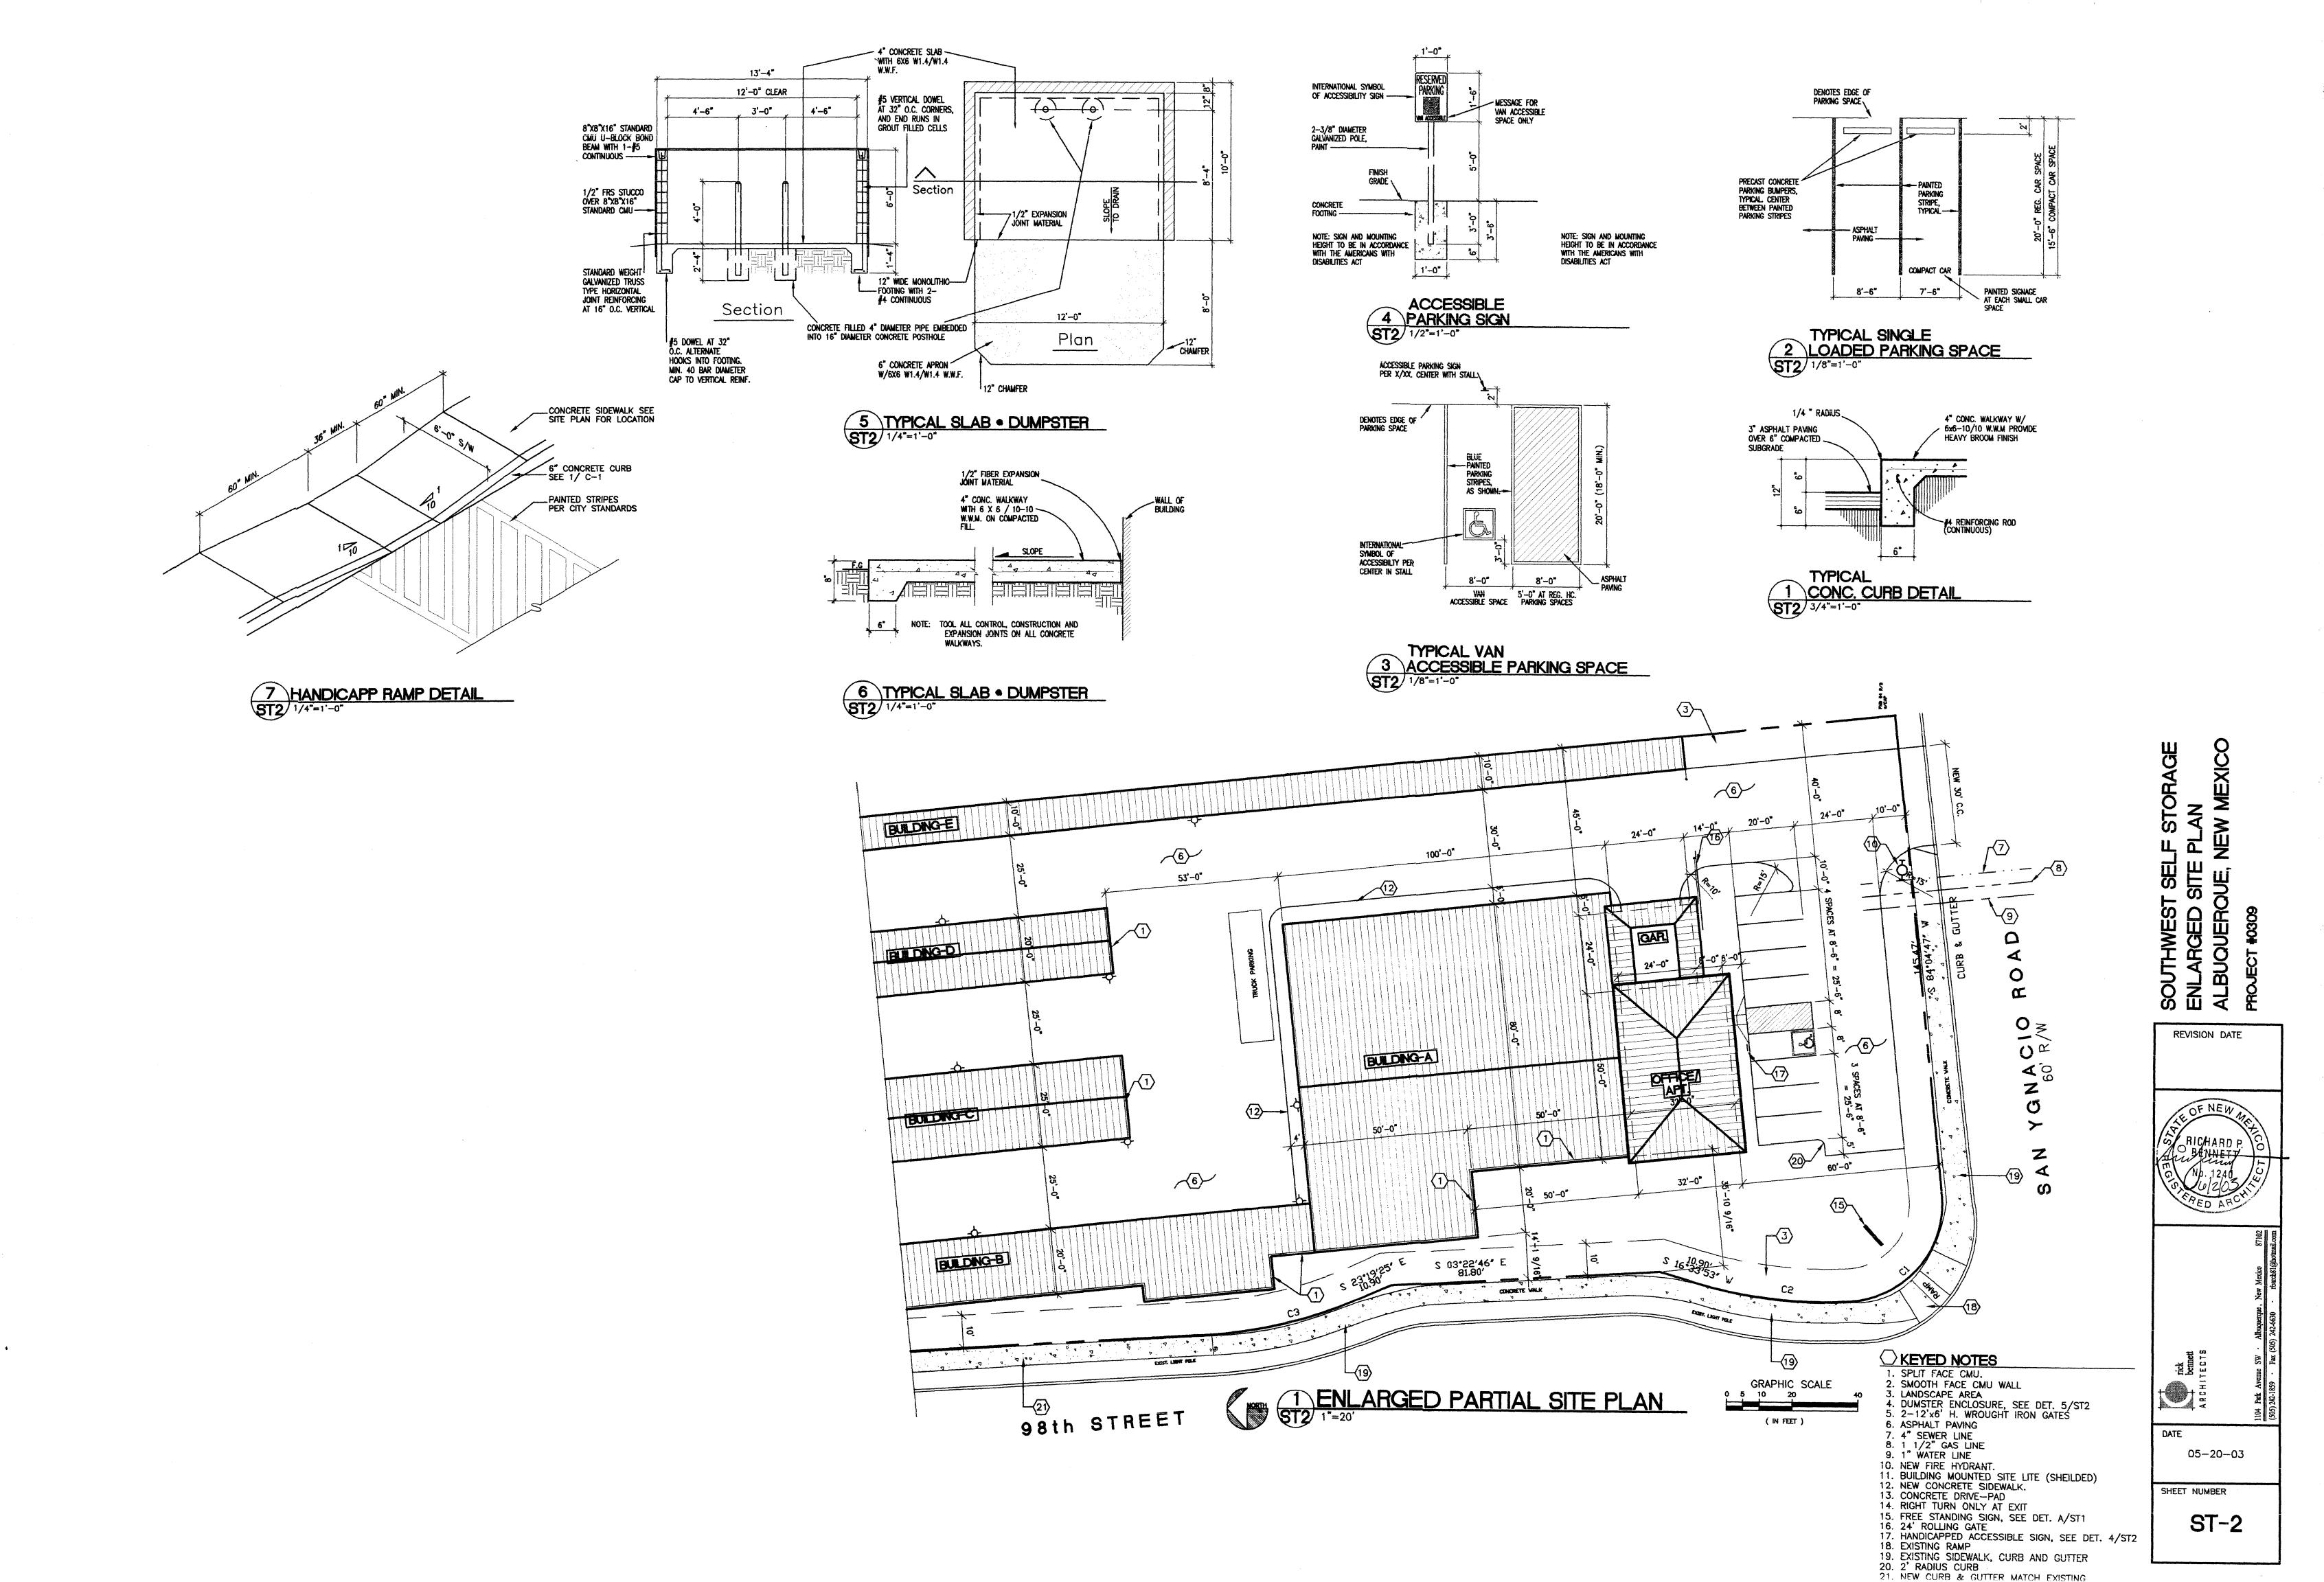

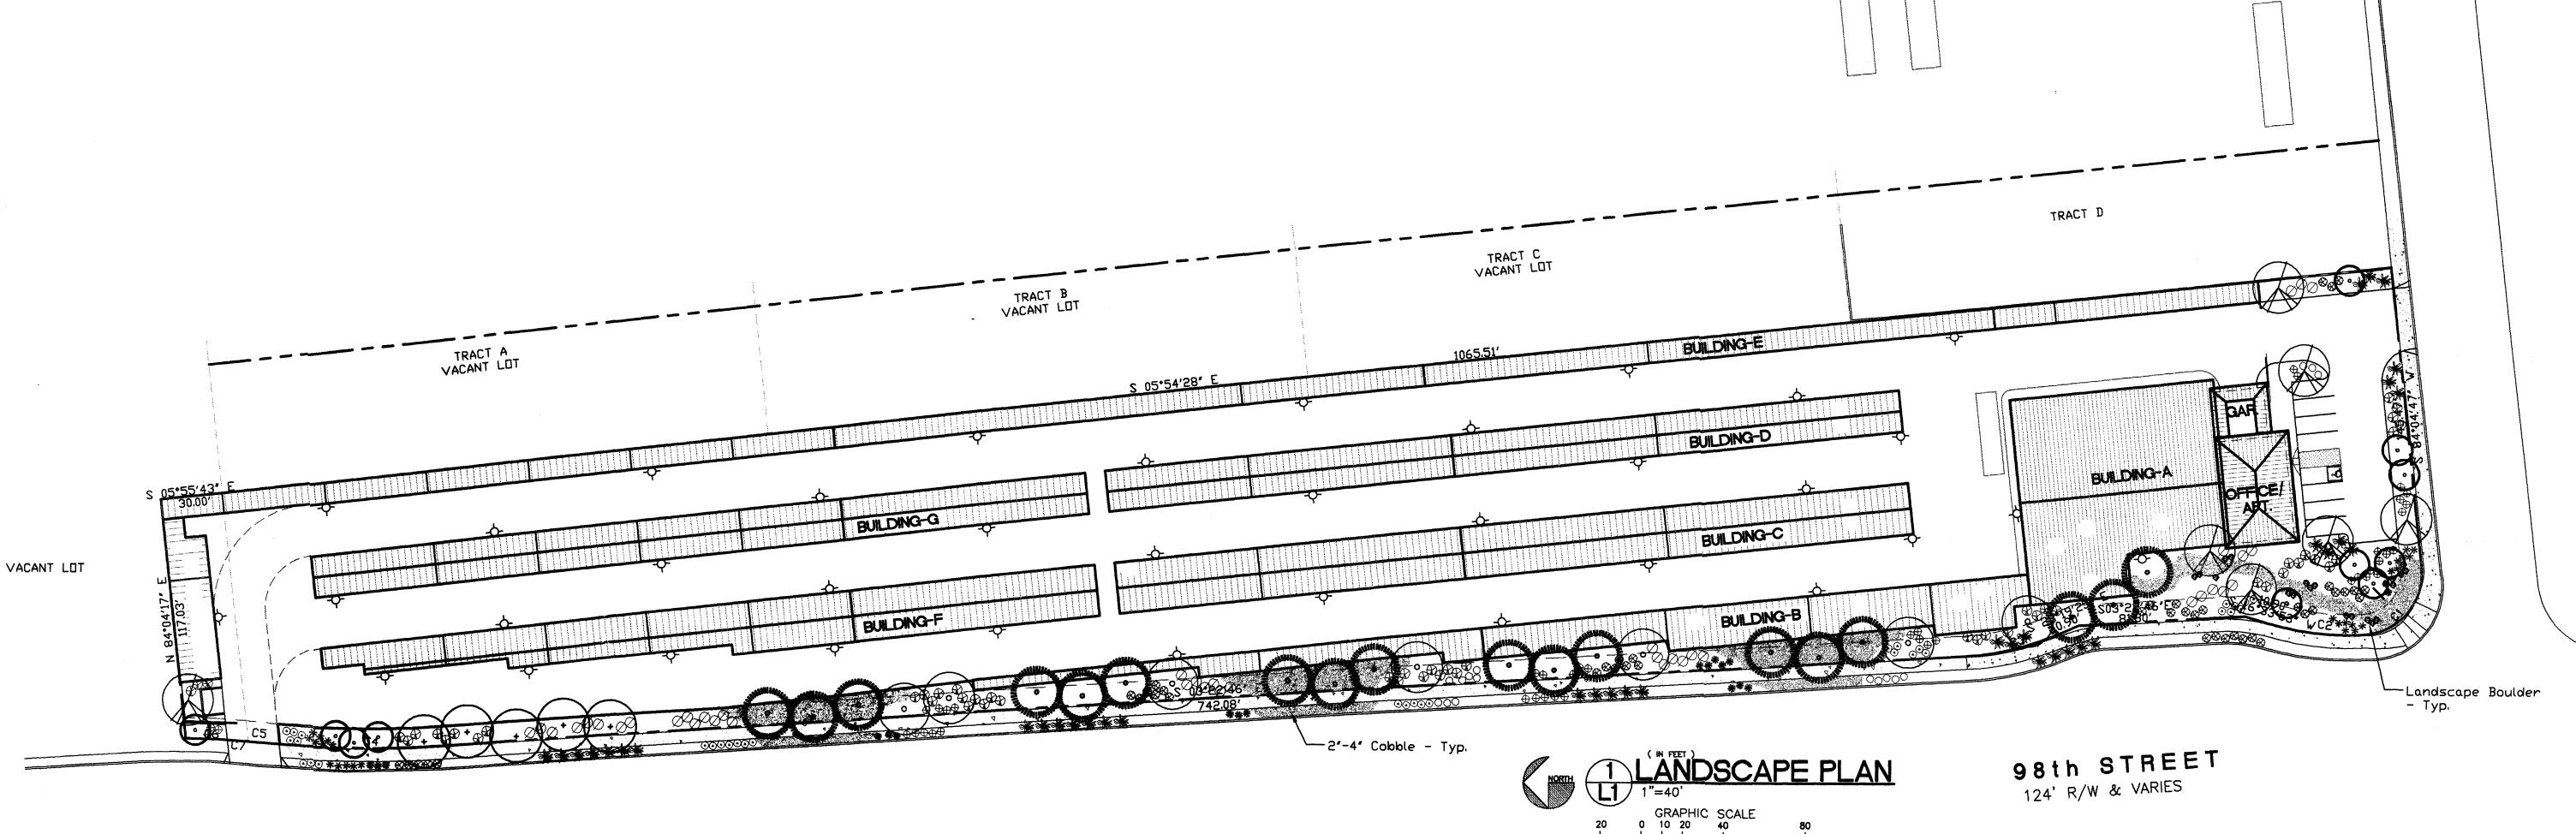

The design and provision of landscape features for the project will be in conformance with the City of Albuquerque Zoning Code, Street Tree Ordinance, and the Water Conservation Landscaping and Water Waste Ordinance. In general, water conservative, environmentally sound landscape principles will be followed in the design and installation.

STREET TREE REQUIREMENTS

Street trees are required along 98th Street as follows:

Required: 37

Provided: 37 IRRIGATION SYSTEM

irrigation system standards outlined in the Water Conservation Landscaping and Water Waste Ordinance shall be strictly adhered to. A fully automated irrigation system will be used to irrigate tree, shrub and groundcover planting areas.

MAINTENANCE RESPONSIBILITY

Maintenance of the landscaping and irrigation system, including those areas within public ROW., shall be the responsibility of the Owner.

STATEMENT OF WATER WASTE

The Landscape Plan shall limit the provision of high water use turf to a maximum of 20 percent of the provided landscape area.

#### LANDSCAPE REQUIREMENTS

Site Area (3.8 acres)	164,960	SF
Building Footprint	- 67,801	SF
Off-site Landscape	- 10,516	
Total Area	86,643	SF
Required Landscape %	×	
Landscape Area Required	12,996	SF
Landscape Area Provided	27,795	
į.		

# PLANT LEGEND

WATER USE BOTANICAL / COMMON NAME Trees (2" B&B or 8' Height) Fraxinus velutina 'Modesto' / Modesto Ash Medium + Chilopsis linearis/Desert Willow Low Pyrus calleryana "Bradford" / Bradford Pear Medium + Pinus nigra / Austrian Pine Medium Gleditsia triacanthos inemis / Honeylocust Medium + Shrubs (1 and 5 gallon) Artemesia 'Powis Castle' / Powis Castle Sage Low + Oenothera berlandieri / Evening Primrose Low + 0 Potentilla fruticosa / Yellow Cinquefoil Medium + Juniperus sabina 'Buffalo' / Buffalo Juniper Low + Perovskia atriplicifolia / Russian Sage Medium Fallugia paradoxa / Apache Plume Low Salvia greggii / Cherry Sage Medium Caryopteris clandonensis / Blue Mist Medium Ornamental Grasses (1 and 5 gallon) Stipa tenniussima / Threadgrass Low + Muhlenbergia capillaris / Bush Muhly Grass Medium

2'-4" Santa Ana Tan Cobble



Moss Rock Boulders - 3'x3' (min.)



REVISION DATE

DATE 06-02-03


SHEET NUMBER

L-1

CONSENSUS PLANNING, INC.


Planning / Landscape Architecture

924 Park Avenue SW 로 Albuquerque, NM 87102 \_\_\_ (505) 764-9801 Fax 842-5495 CONSENSUS e-mail: cp@consensusplanning.com

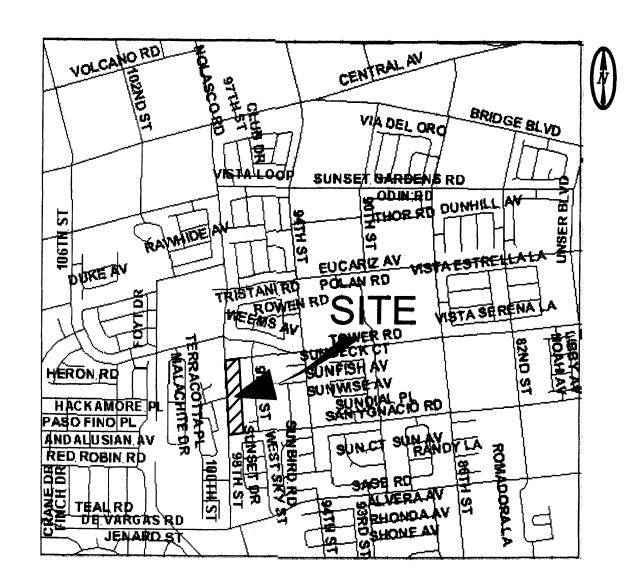

#### LOCATION MAP L9

NOT TO SCALE

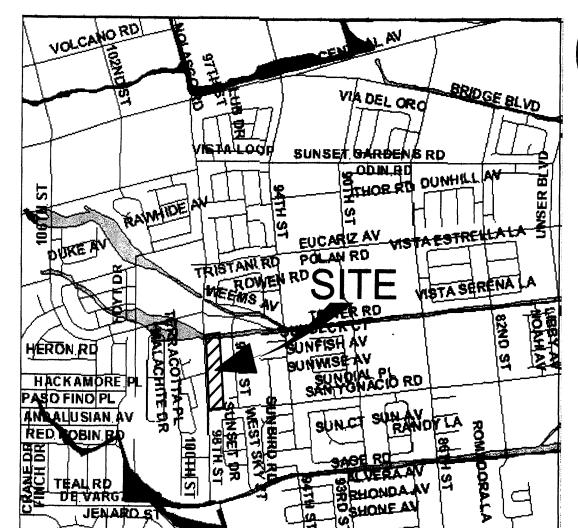

FIRM PANEL NOT TO SCALE

#### **GRADING & DRAINAGE PLAN**

#### PURPOSE AND SCOPE

DEVELOPMENT PROCESS MANUAL, THIS GRADING AND DRAINAGE PLAN OUTLINES THE DRAINAGE MPROVEMENTS. THIS PLAN IS PRESENTED TO PROVIDE GRADING AND DRAINAGE CRITERIA AND DETAILS TO SUPPORT BUILDING PERMIT APPLICATION.

#### EXISTING CONDITIONS

THE PROJECT SITE CONTAINS APPROXIMATELY 3.79-ACRES AND IS LOCATED ON 98TH STREET SW. BETWEEN SAN IGNACIO AND TOWER ROAD SW. THE SITE IS BOUNDED BY 98TH STREET ON THE WEST, DEVELOPING PROPERTIES ON THE EAST, SAN IGNACIO ON THE SOUTH, AND OLD TOWER ROAD ON THE NORTH. THE SITE IS PRESENTLY UNDEVELOPED. SITE TOPOGRAPHY SLOPES FROM WEST TO EAST AT

AS SHOWN BY THE FIRM PANEL FOR THIS AREA, THIS PROPERTY IS NOT LOCATED WITHIN A DESIGNATED FLOOD HAZARD ZONE.

#### PROPOSED CONDITIONS

AS SHOWN BY THE PLAN, THE PROPERTY IS TO BE DEVELOPED INTO A SELF STORAGE FACILITY. ALL RUNOFF WILL BE CONVEYED OVERLAND VIA PAVED ACCESS ROADS AND PARKING LOT SWALES TO SAN YGNACIO ROAD. PER THE DRAINAGE MASTERPLAN FOR SPECIAL ASSESSMENT DISTRICT 222. THIS SITE IS LOCATED WITHIN BASIN B1-D. THE ALLOWABLE DISCHARGE FROM THE BASIN IS 3.97 CFS PER ACRE, WHICH EQUATES TO 15.0 CFS FOR THIS SITE. AS SHOWN BY THE AHYMO TABLE ON THIS SHEET, DEVELOPED PEAK DISCHARGE FROM THE SITE WILL NOT EXCEED THE DMP THRESHOLD.

THE PLAN SHOWS THE CONTOURS AND ELEVATIONS REQUIRED TOPROPERLY GRADE AND CONSTRUCT THE RECOMMENDED IMPROVEMENTS. FLOW ARROWS ARE GIVEN TO DEMONSTRATE THE DIRECTION OF DRAINAGE FLOWS, AND PROJECT HYDROLOGY IS GIVEN FOR BOTH EXISTING AND DEVELOPED CONDITIONS. PERTINENT CONSTRUCTION DETAILS ARE PROVIDED ON SHEET C-3.

#### TEMPORARY EROSION CONTROL

TEMPORARY EROSION CONTROL MEASURES WILL BE IMPLEMENTED DURING CONSTRUCTION TO LIMIT THE DISCHARGE OF SEDIMENT FROM THE SITE TO ADJACENT PROPERTIES. SEE STORM WATER POLLUTION PREVENTION PLAN -SHEET C-2.

#### CALCULATIONS

THE CALCULATIONS SHOWN HEREON DEFINE THE 100-YEAR/6 HOUR DESIGN STORM IMPACTING THE SITE AND CONTRIBUTINF OFF-SITE DRAINAGE BASINS UNDER EXISTING AND DEVELOPED CONDITIONS. THE AHYMO METHOD OF ESTIMATING PEAK RUNOFF IS PRESENTED AS OUTLINED IN THE DEVELOPMENT PROCESS MANUAL, VOLUME 2, SECTION22.2, PART 'A', UPDATED JULY 1997.

CURVE

C2

C3

C4

C5

2.20"

**RADIUS** 

30.00

138.00

138.00

588.00

312.00

312.00

312.00

ALLOWABLE DISCHARGE PER SAD 222 = 3.97 CFS/AC

FOR THIS SITE Q100 ALLOWABLE = 3.79(3.97)=15.0 CFS

DELTA

92°06'43"

19°56'32"

20°01'36"

09°19'33"

00°17'44"

05°34'43"

05°52'28"

PROJECT HYDROLOGY

 UNDEVELOPED:

 AREA (ac)
 A (ac)
 B (ac)
 C (ac)
 D (ac)
 E
 Q (cfs)
 VOL (ac ft)

 3.787
 3.79
 0.00
 0.00
 0.00
 0.44
 4.9
 0.139

| DEVELOPED (PROPOSED): | AREA (ac) | A (ac) | B (ac) | C (ac) | D (ac) | E | Q (cfs) | VOL (ac ft) | 3.787 | 0.00 | 0.27 | 0.49 | 3.03 | 1.75 | 15.0 | 0.552 |

BEARING

N 49°46'08" W

N 06°35'34" E

N 13°21'05" W

N 01°17'01" E

N 05°54'59" E

N 02°58'45" E

N 03°07'37" E

CHORD

43.20

47.79

47.99

95.60

1.61

30.37

31.97

98th STREET STORAG

ARC

48.23

48.03

48.24

95.71

1.61

30.38

31.99

#### DRAINAGE PLAN NOTES

- 1. BLI recommends that the Owner obtain a Geotechnical Evaluation of the on-site soils prior to foundation/structural design.
- 2. This Plan recommends positive drainage away from all structures to prohibit ponding of runoff which may cause structural settlement. Future alteration of grades adjacent to the proposed structures is not recommended.
- 3. Irrigation within 10 feet of any proposed structure is not recommended. Introduction of irrigation water into subsurface soils adjacent to the structure could cause settlement.
- 4. This Plan is prepared to establish on-site drainage and grading criteria only. BLI assumes no responsibility for subsurface analysis, foundation/structural design, or utility design.
- 5. Local codes may require all footings to be placed in natural undisturbed soil. If the Contractor plans to place footings on engineered fill, a certification by a registered Professional Engineer will be required. If the contractor wishes BLI to prepare the Certification, we must be notified PRIOR to placement of the fill.
- 6. BLI recommends that the Owner obtain the services of a Geotechnical Engineer to test and inspect all earthwork aspects of the project.
- 7. The property boundary shown on this Plan is given for information only to describe the project limits. Property boundary information shown hereon does not constitute a boundary survey. A boundary survey performed by a licensed New Mexico Registered Professional Surveyor is recommended prior to construction.
- 8. All spot elevations are top of pavement unless noted otherwise. noted otherwise.
- 9. All perimeter storage units must drain into the site. No roof drains may discharge onto adjoining properties.

# GRADING AND DRAINAGE PLAN

#### PROPERTY ADDRESS

PROJECT DATA

98th STREET SW

### LEGAL DESCRIPTION

TRACT 40, PROJECTED SECTION 28 T10N, R2E, NMPM TOWN OF ATRISCO GRANT MAPPING

FIELD MEASUREMENTS BY HARRIS SURVEYING FEBRUARY 2003

### LEGEND

---- 6001 -- EXISTING CONTOUR ELEVATION

EXISTING SPOT ELEVATION

PROPOSED CONTOUR ELEVATION

PROPERTY LINE

PROPOSED SPOT ELEVATION

DIRECTION OF FLOW DRAINAGE SWALE

SITE LIGHT POLE

EXISTING FIRE HYDRANT

NEW FIRE HYDRANT

■ ■ ■ ■ NEW RETAINING WALL

#### KEYED NOTES

1. EXISTING STANDARD CURB & GUTTER

2. NEW DRIVEPAD EXISTING CONCRETE WALL

4. NEW REFUSE ENCLOSURE 5. NEW ASPHALT PAVEMENT

6. NEW RETAINING WALL AT BUILDING 7. EXISTING DROP INLET

8. EXISTING ASPHALT PAVEMENT TO REMAIN 9. IRON SECURITY GATE 10. EXISTING CONCRETE SIDEWALK TO REMAIN

11. NEW PARKING STRIPING PER CITY CODE 12. NEW LANDSCAPING. SEE SITE PLAN 13. NEW 6" CONCRETE CURB

14. NEW CONCRETE SIDEWALK (ON-SITE)

14. NEW CONCRETE SIDEWALK (ON-SITE)
15. NEW 6' CONCRETE SIDEWALK (PUBLIC)
16. NEW ACCESSIBLE RAMP - SEE SITE PLAN
17. MONUMENT SIGN - SEE SITE PLAN
18. CONSTRUCTION CONCRETE CHANNEL - SEE SECTION (A)
19. CONSTRUCT 3 - 24" SW CULVERTS PER
COA STD DWG 2236
20. PROVIDE 12" CURB BREAK AT DRAINAGE SWALE
21. NEW 8" CONCRETE CURB
22. PROVIDE 12 - FT CURB BREAK AT CHANNEL INLET

### SURVEY NOTES:

1: CONTOUR INTERVAL IS ONE (1) FOOT.

2: ELEVATIONS ARE BASED ON CITY OF ALBUQUERQUE STATION No. "22-L19", HAVING AN ELEVATION OF \_\_5163.06\_\_.

1 inch = 40 ft.

3: UTILITIES SHOWN HEREON ARE IN THEIR APPROXIMATE LOCATION BASED ONLY ON ABOVE GROUND EVIDENCE FOUND IN THE FIELD AND AS-BUILT INFORMATION PROVIDED BY THE CLIENT. UTILITIES SHOWN HEREON, WHETHER INDICATED AS ABANDONED OR NOT, SHALL BE VERIFIED BY OTHERS FOR EXACT LOCATION AND/ OR DEPTH PRIOR TO EXCAVATION OR DESIGN CONSIDERATIONS.

5: THIS IS NOT A BOUNDARY SURVEY. BEARINGS AND DISTANCES SHOWN HEREON ARE FOR REFERENCE ONLY.

#### DRAINAGE FACILITIES WITHIN CITY RIGHT-OF WAY NOTICE TO CONTRACTOR

- 1. AN EXCAVATION PERMIT WILL BE REQUIRED BEFORE BEGINNING ANY WORK WITHIN CITY RIGHT-OF-WAY.
- 2. ALL WORK DETAILED ON THESE PLANS TO BE PERFORMED, EXCEPT AS OTHERWISE STATED OR PROVIDED HEREON, SHALL BE CONSTRUCTED IN ACCORDANCE WITH THE "CITY OF ALBUQUERQUE INTERIM STANDARD SPECIFICATIONS FOR PUBLIC WORKS CONSTRUCTION", 1985
- 3. THREE WORKING DAYS PRIOR TO ANY EXCAVATION, THE CONTRACTOR MUST CONTACT LINE LOCATING SERVICE, 765-1234 FOR THE LOCATION OF EXISTING UTILITIES.
- 4. PRIOR TO CONSTRUCTION THE CONTRACTOR SHALL EXCAVATE AND VERIFY THE LOCATIONS OF ALL CONSTRUCTIONS. SHOULD A CONFLICT EXIST, THE CONTRACTOR SHALL NOTIFY THE ENGINEER SO THAT THE CONFLICT CAN BE RESOLVED WITH A MINIMUM AMOUNT OF DELAY.
- 5. BACKFILL COMPACTION SHALL BE ACCORDING TO TRAFFIC/STREET USE. 6. MAINTENANCE OF THE FACILITY SHALL BE THE RESPONSIBILITY OF THE OWNER OF THE PROPERTY BEING SERVED.

7. WORK ON ARTERIAL STREETS SHALL BE PERFORMED ON A 24-HOUR BASIS.


**APPROVALS** 

**INSPECTOR** 

DATE


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REVISION DATE

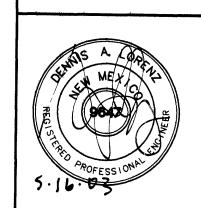

DATE 05-16-2003

SHEET NUMBER

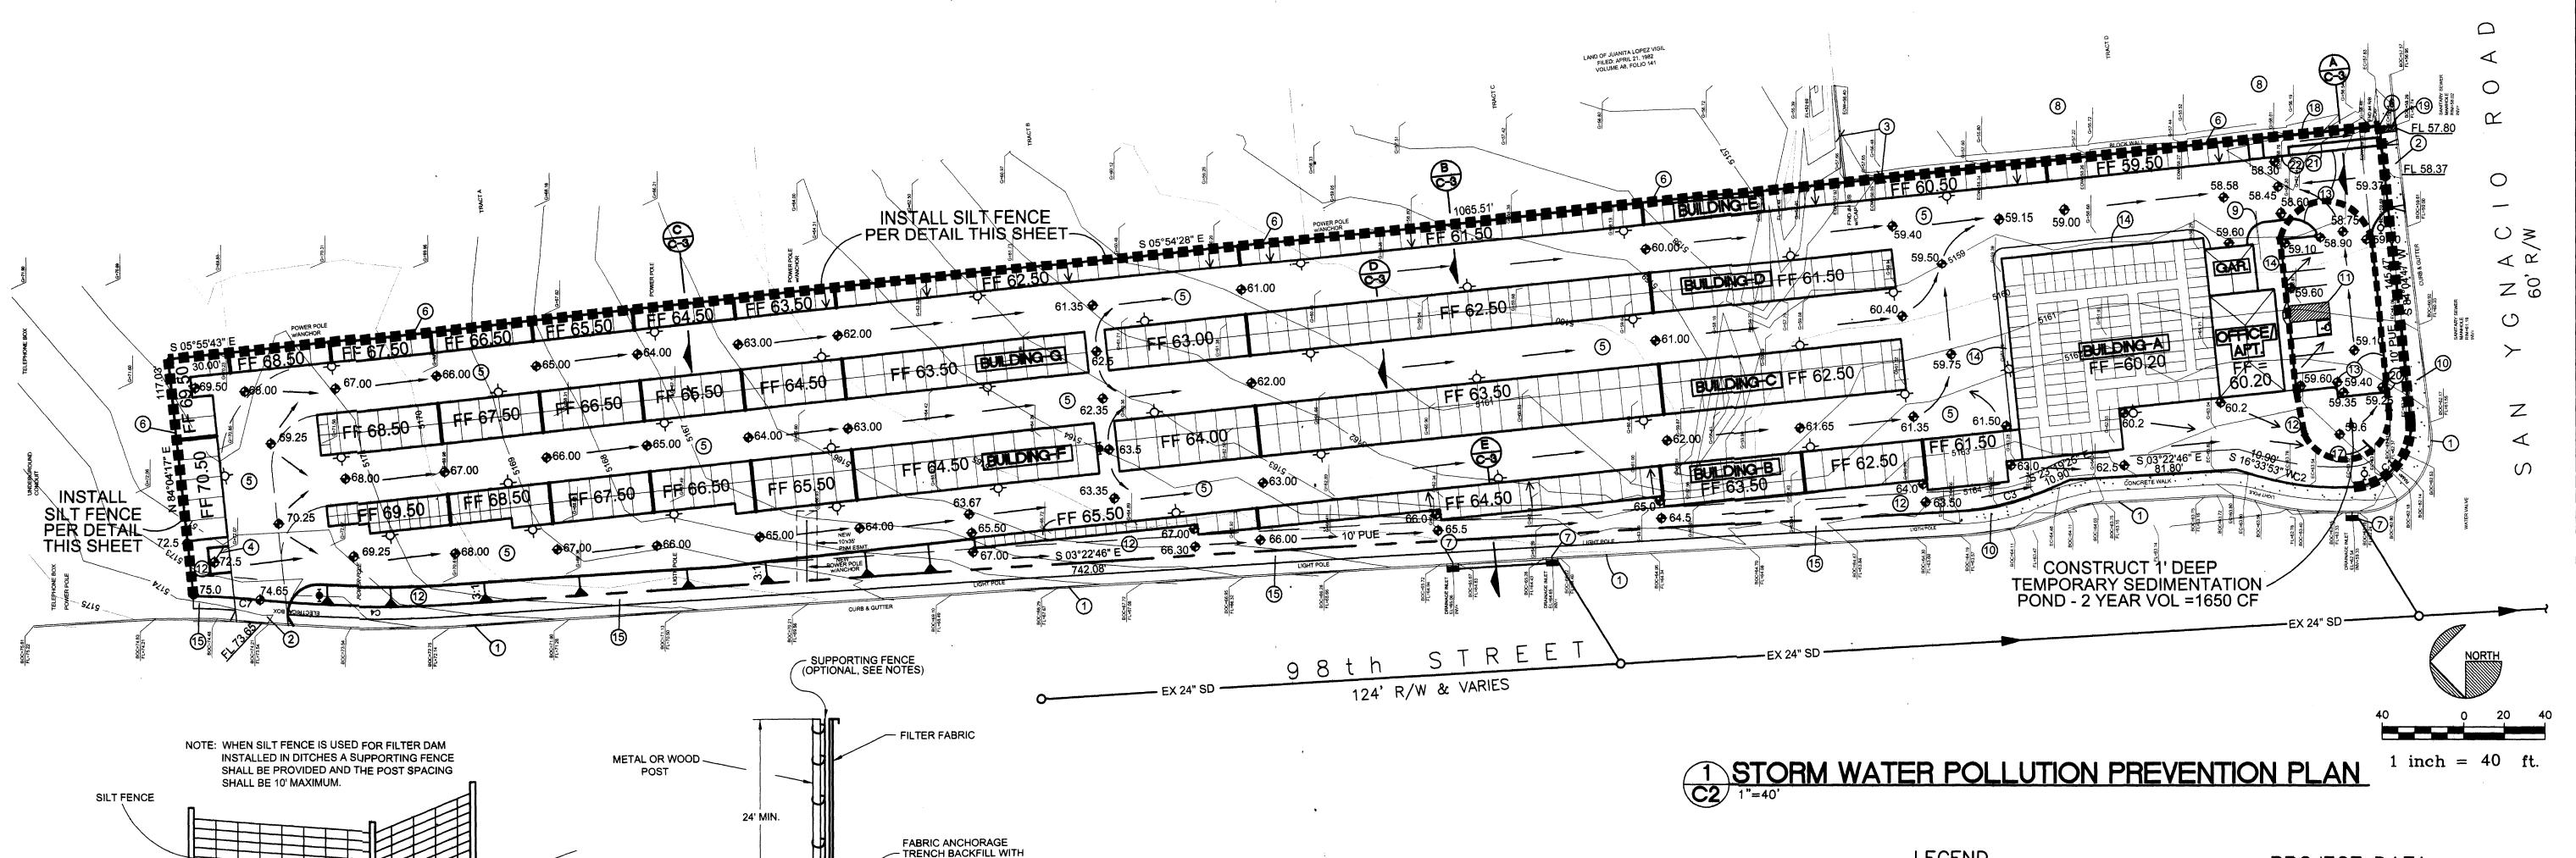

**ELEVATION - FILTER DAM** 

(SILT FENCE OPTION)

**ELEVATION - FILTER DAM** (SILT FENCE OPTION)

DIRECTION OF **RUNOFF FLOW**  TAMPED NATURAL SOIL

SILT FENCING DETAILS

## SWPPP INFORMATION SHEET

SITE DESCRIPTION & NOI INPUTS		
NATURE OF ACTIVITY		COMMERCIAL CONSTRUCTION
GENERAL LOCATION AND SITE MAP		REFER TO LOCATION MAP AND GRADING AND DRAINAGE PLAN
DISTURBED AN UNDISTURBED AREA		REFER TO SWPPP
STRUCTURAL & NON-STRUCTURAL CONTROLS		REFER TO SWPPP
LOCATIONS WHERE STABILIZATION WILL OCCUR		REFER TO LANDSCAPING PLAN AND SWPPP
TOTAL SITE AREA	3.79 AC	AREA WITHIN THE CONSTRUCTION LIMITS
RECEIVING WATER		PUBLIC STORM DRAIN IN SAN YGNACIO ROAD
TOTAL DISTURBED AREA	3.79 AC	AREA WITHIN THE CONSTRUCTION LIMITS
LATITUDE	35°03'40"	
LONGITUDE	106°44'27"	
ESTIMATE OF LIKEHOOD OF DISCHARGE		ONCE PER MONTH
ENDANGERED SPECIES OR CRITICAL HABITAT (YES OR NO)	ENVIR RPT	NO
PART B3e(2) OF THE PERMIT (a,b,c,er.d)	ENVIR RPT	a

DRAINAGE PATTERNS		REFER TO GRADING AND DRAINAGE PLAN
APPROXIMATE SLOPE AFTER MAJOR GRADING		REFER TO GRADING AND DRAINAGE PLAN
RAINFALL PRECIPITATION ZONE	3	
2 - YEAR 24 - HOUR, inches	1.35	
2 - YEAR 1 - HOUR, inches	0.93	
HYDROLOGICAL SOIL GROUP	В	
EXCESS PRECIPITATION, UNDISTURBED SITE, inches	0.00 .	
EXCESS PRECIPITATION, DISTURBED SITE, inches	0.12	
UNIT PEAK DISCHARGE, UNDISTURBED SITE, cfs/acre	0.00	
UNIT PEAK DISCHARGE, DISTURBED SITE, cfs/acre	0.47	
UNIT PEAK DISCHARGE, POST CONSTRUCTION, cfs/acre	1.75	

RUNOFF DISCHARGE & VOLUME CALCULATION THE FOLLOWING PROCEDURES SHOULD BE USED TO CALCULATE THE RUNOFF DISCHARGE AND VOLUME TO DESIGN THE EROSION CONTROL MEASURES. PEAK DISCHARGE AND VOLUME ESTIMATED BY THE AHYMO METHOD, AS OUTLINE IN THE CITY OF ALBUQUERQUE DEVELOPMENT PROCESS MANUAL VOLUME 2, CHAPTER 22, PART A, JULY 1997:

DISCHARGE: WHERE:

Q = qA Q = DISCHARGE, cfs q = UNIT PEAK DISCHARGE, cfs/acre

A = AREA OF THE SITE, acres **VOLUME:** V = EA/12V = VOLUME, acre-feet WHERE:

ASSUME:

E = EXCESS PRECIPITATION, inches Tc = TIME OF CONCENTRATION, hours Tc = 12 MIN. FOR BASIN WITHIN PROJECT LIMITS

L = LENGHT OF WATERSHED, ft V = VELOCITY, fps

SEE GRADING AND DRAINAGE PLAN FOR DETAILED PROJECT HYDROLOGY

#### **GENERAL NOTES:**

1. THE 1997 EDITION OF NMSHTD NATIONAL POLLUTANT DISCHARGE ELIMINATION SYSTEM (NPDES) HANDBOOK AND SECTION 603 - TEMPORARY EROSION & SEDIMENT CONTROL OF THE 1996 EDITION OF THE NEW MEXICO STATE HIGHWAY AND TRANSPORTATION DEPARTMENT STANDARD SPECIFICATION FOR HIGHWAY AND BRIDGE CONSTRUCTION - SHALL BE USED AS MINIMUM REQUIREMENTS TO DEVELOPE OR MODIFY THE STORM WATER POLLUTION PREVENTION PLAN (SWPPP).

- 2. THE NPDES PERMIT NUMBER FOR THE PROJECT OR A COPY OF THE NOTICE OF INTENT (NOI) IF A PERMIT NUMBER HAS NOT YET BEEN ASSIGNED, SHALL BE POSTED AT THE PROJECT SITE OR THE FIELD OFFICE AT ALL TIMES DURING CONSTRUCTION.
- 3. THE STORM WATER POLLUTION PREVENTION PLAN (SWPPP) AND ALL MAINTENANCE AND INSPECTION REPORTS SHALL BE SIGNED BY A QUALIFIED INSPECTOR ASSIGNED BY CONTRACTOR THE SWPPP AND THE INSPECTION REPORTS SHALL BE AVAILABLE TO EPA REPRESENTATIVE AT ALL TIMES DURING CONSTRUCTION.
- 4. ALL DRAINAGE INFORMATION NEEDED TO COMPLETE THE NOTICE OF INTENT (NOI) ARE PROVIDED IN THIS PLAN.

#### STORM WATER POLLUTION PREVENTION PLAN

#### INTRODUCTION

THIS SWPPP DEFINES THE CONSTRUCTION ACTIVITIES AND TEMPORARY EROSION CONTROLS TO BE EMPLOYED TO CONTROL THE RELEASE OF POLLUTION FROM THE CONSTRUCTION SITE. THE THREE PRIMARY GOALS OF THE SWPPP ARE TO REDUCE EROSION, MINIMIZE SEDIMENT, AND CONTROL THE DISCHARGE OF NON-STORM WATER POLLUTANTS.

ALL REQUIREMENTS OUTLINED IN THE FEDERAL ENVIRONMENTAL PROTECTION AGENCY (EPA) NATIONAL POLLUTANT DISCHARGE ELIMINATION SYSTEM (NPDES) AND THE NEW MEXICO CLEAN WATER ACT SHALL BE STRICTLY OBEYED DURING THE CONSTRUCTION PHASE OF THIS PROJECT.

EXPOSED AREAS SHALL BE KEPT TO A MINIMUM TO PERFORM CONSTRUCTION AND SHALL BE PROTECTED BY IMPLEMENTING THE TEMPORARY EROSION CONTROL MEASURES RECOMMENDED BY

#### PROJECT DESCRIPTION

THIS PROJECT CONSISTS OF THE CONSTRUCTION OF A SELF STORAGE FACILITY ON THE SUBJECT 3.79-ACRE PARCEL. THE SITE IS LOCATED ON THE EAST SIDE OF 98TH STREET NW BETWEEN TOWER RD AND SAN YGNACIO RD. THE SITE IS BOUNDED BY OLD TOWER ROAD ON THE NORTH, SAN YGNACIO ON THE SOUTH, 98TH ST ON THE WEST, AND RESIDENTIAL PROPERTY ON THE EAST. SITE TOPOGRAPHY SLOPES FROM WEST TO EAST AT APPROXIMATELY 3 PERCENT. NO OFF-SITE FLOWS IMPACT THE SITE. DEVELOPED DISCHARGES WILL DRAIN TO AN EXISTING PUBLIC STORM DRAIN LOCATED IN SAN YGNACIO RD.

AS SHOWN BY THE FLOOD INSURANCE RATE MAP FOR THIS AREA, THIS SITE IS NOT LOCATED WITHIN A MAPPED FLOOD HAZARD ZONE.

AS STATED ABOVE, THE PROJECT IS TO BE DEVELOPED AS A SELF STORAGE FACILITY. THERE WILL BE NO INDUSTRIAL ACTIVITY, AND THEREFORE, NO INDUSTRIAL DISCHARGES. DURING CONSTRUCTION, POTENTIAL STORM WATER POLLUTANTS ARE TO CONSIST MAINLY OF SOIL SEDIMENT. POST CONSTRUCTION POLLUTANTS ARE ANTICIPATED TO CONSIST OF SOIL SEDIMENT AND VEHICLE BY PRODUCTS WASHED FROM ASPHALTIC PAVEMENTS.

#### CONSTRUCTION ACTIVITY

CONSTRUCTION ACTIVITY WILL CONSIST OF EARTHMOVING, AND THE CONSTRUCTION OF UNDERGROUND UTILITIES, BUILDINGS, ASPHALTIC PAVEMENTS, CONCRETE SIDEWALKS AND LANDSCAPING IMPROVEMENTS. ALL BUILDING MATERIALS ARE TO BE STORED ON-SITE WITHIN A SECURED FENCED AREA. NO INDUSTRIAL DISCHARGES ARE ANTICIPATED DURING CONSTRUCTION.

# LEGEND

EXISTING CONTOUR ELEVATION

EXISTING SPOT ELEVATION

PROPOSED CONTOUR ELEVATION

PROPERTY LINE

**01.5** ◆ PROPOSED SPOT ELEVATION

DIRECTION OF FLOW

DRAINAGE SWALE

SILT FENCING

TEMPORARY EROSION CONTROL PLAN

# PROJECT DATA

PROPERTY ADDRESS

LEGAL DESCRIPTION

TRACT 40, PROJECTED SECTION 28 T10N, R2E, NMPM

TOWN OF ATRISCO GRANT MAPPING

FIELD MEASUREMENTS BY HARRIS SURVEYING FEBRUARY 2003

- THE TEMPORARY EROSION CONTROL MEASURES TO BE TAKEN FOR THIS PROJECT ARE AS FOLLOWS:
- 1. THE CONTRACTOR SHALL OBTAIN ALL REQUIRED CONSTRUCTION PERMITS PRIOR TO COMMENCING
- ANY EARTHWORK ACTIVITIES. 2. A NOTICE OF INTENT (NOI) MUST BE FILED WITH THE ENVIRONMENTAL PROTECTION AGENCY 48-HOURS
- PRIOR TO COMMENCING ANY EARTHWORK ACTIVITIES. 3. THIS SWPPP MUST BE KEPT ON FILE AT THE CONSTRUCTION SITE AT ALL TIMES.
- 4. SILT FENCING SHALL BE INSTALLED AT THE DOWNSTREAM CONSTRUCTION LIMTS AS SHOWN BY THE 5. THE ON-SITE DETENTION PONDS SHALL BE EXCAVATED TO THE DIMENSIONS AND ELVATIONS
- INDICATED ON THE PLAN, AND SHALL BE UTILIZED FOR STORAGE OF EXCESS RUNOFF DURING 6. ALL TEMPORARY EROSION CONTROLS SHALL BE PROPERLY MAINTAINED BY THE OPERATOR UNTIL
- FINAL SITE IMPROVEMENTS ARE COMPLETED. 7. ALL DISTURBED AREAS SHALL BE LANDSCAPED AND RE-SEEDED PER THE PROJECT LANDSCAPING


#### INSPECTION AND MAINTENANCE

INSPECTION AND MAINTENANCE OF THE PROTECTIVE CONTROLS THAT ARE A PART OF THIS PLAN SHALL BE PERFORMED AS FOLLOWS:

- 1. IT IS THE RESPONSIBILITY OF THE OPERATOR TO PROVIDE TRAINED INSPECTORS AND TRAINING OF
- 2. THE EPA REQUIRES INSPECTION EVERY 14 DAYS OR WITHIN 24 HOURS OF A STORM OF 0.5 INCH OR
- 3. ALL DISTURBED AREAS OF THE SITE, AREAS FOR MATERIAL STORAGE, AND ALL OF THE EROSION AND SEDIMENT CONTROLS THAT WERE IDENTIFIED AS PART OF THE PLAN, SHOULD BE INSPECTED. CONTROLS MUST BE IN GOOD OPERATING CONDITION UNTIL THE AREAS THEY PROTECT HAVE BEEN COMPLETELY STABILIZED AND THE CONSTRUCTION ACTIVITY IS COMPLETE.
- 4. THE INSPECTOR SHOULD NOTE ANY DAMAGES OR DEFICIENCIES IN THE CONTROL MEASURES ON
- INSPECTION REPORT FORMS TO BE KEPT ON FILE AT THE CONSTRUCTION SITE.
- 5. THE OPERATOR SHOULD CORRECT DAMAGE OR DEFICIENCIES AS SOON AS PRACTICABLE AFTER THE INSPECTION, AND ANY CHANGES THAT MAY BE REQUIRED TO CORRECT DEFICIENCIES IN THE SWPPP

SHOULD BE MADE AS SOON AS PRACTICABLE AFTER THE INSPECTION.


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YENTION PLAN NEW MEXICO STORAGE

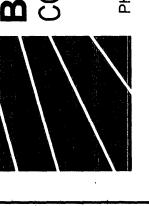SOUTHWEST SE STORM WATER POLUTION PREV ALBUQUERQUE, S S A A

REVISION DATE




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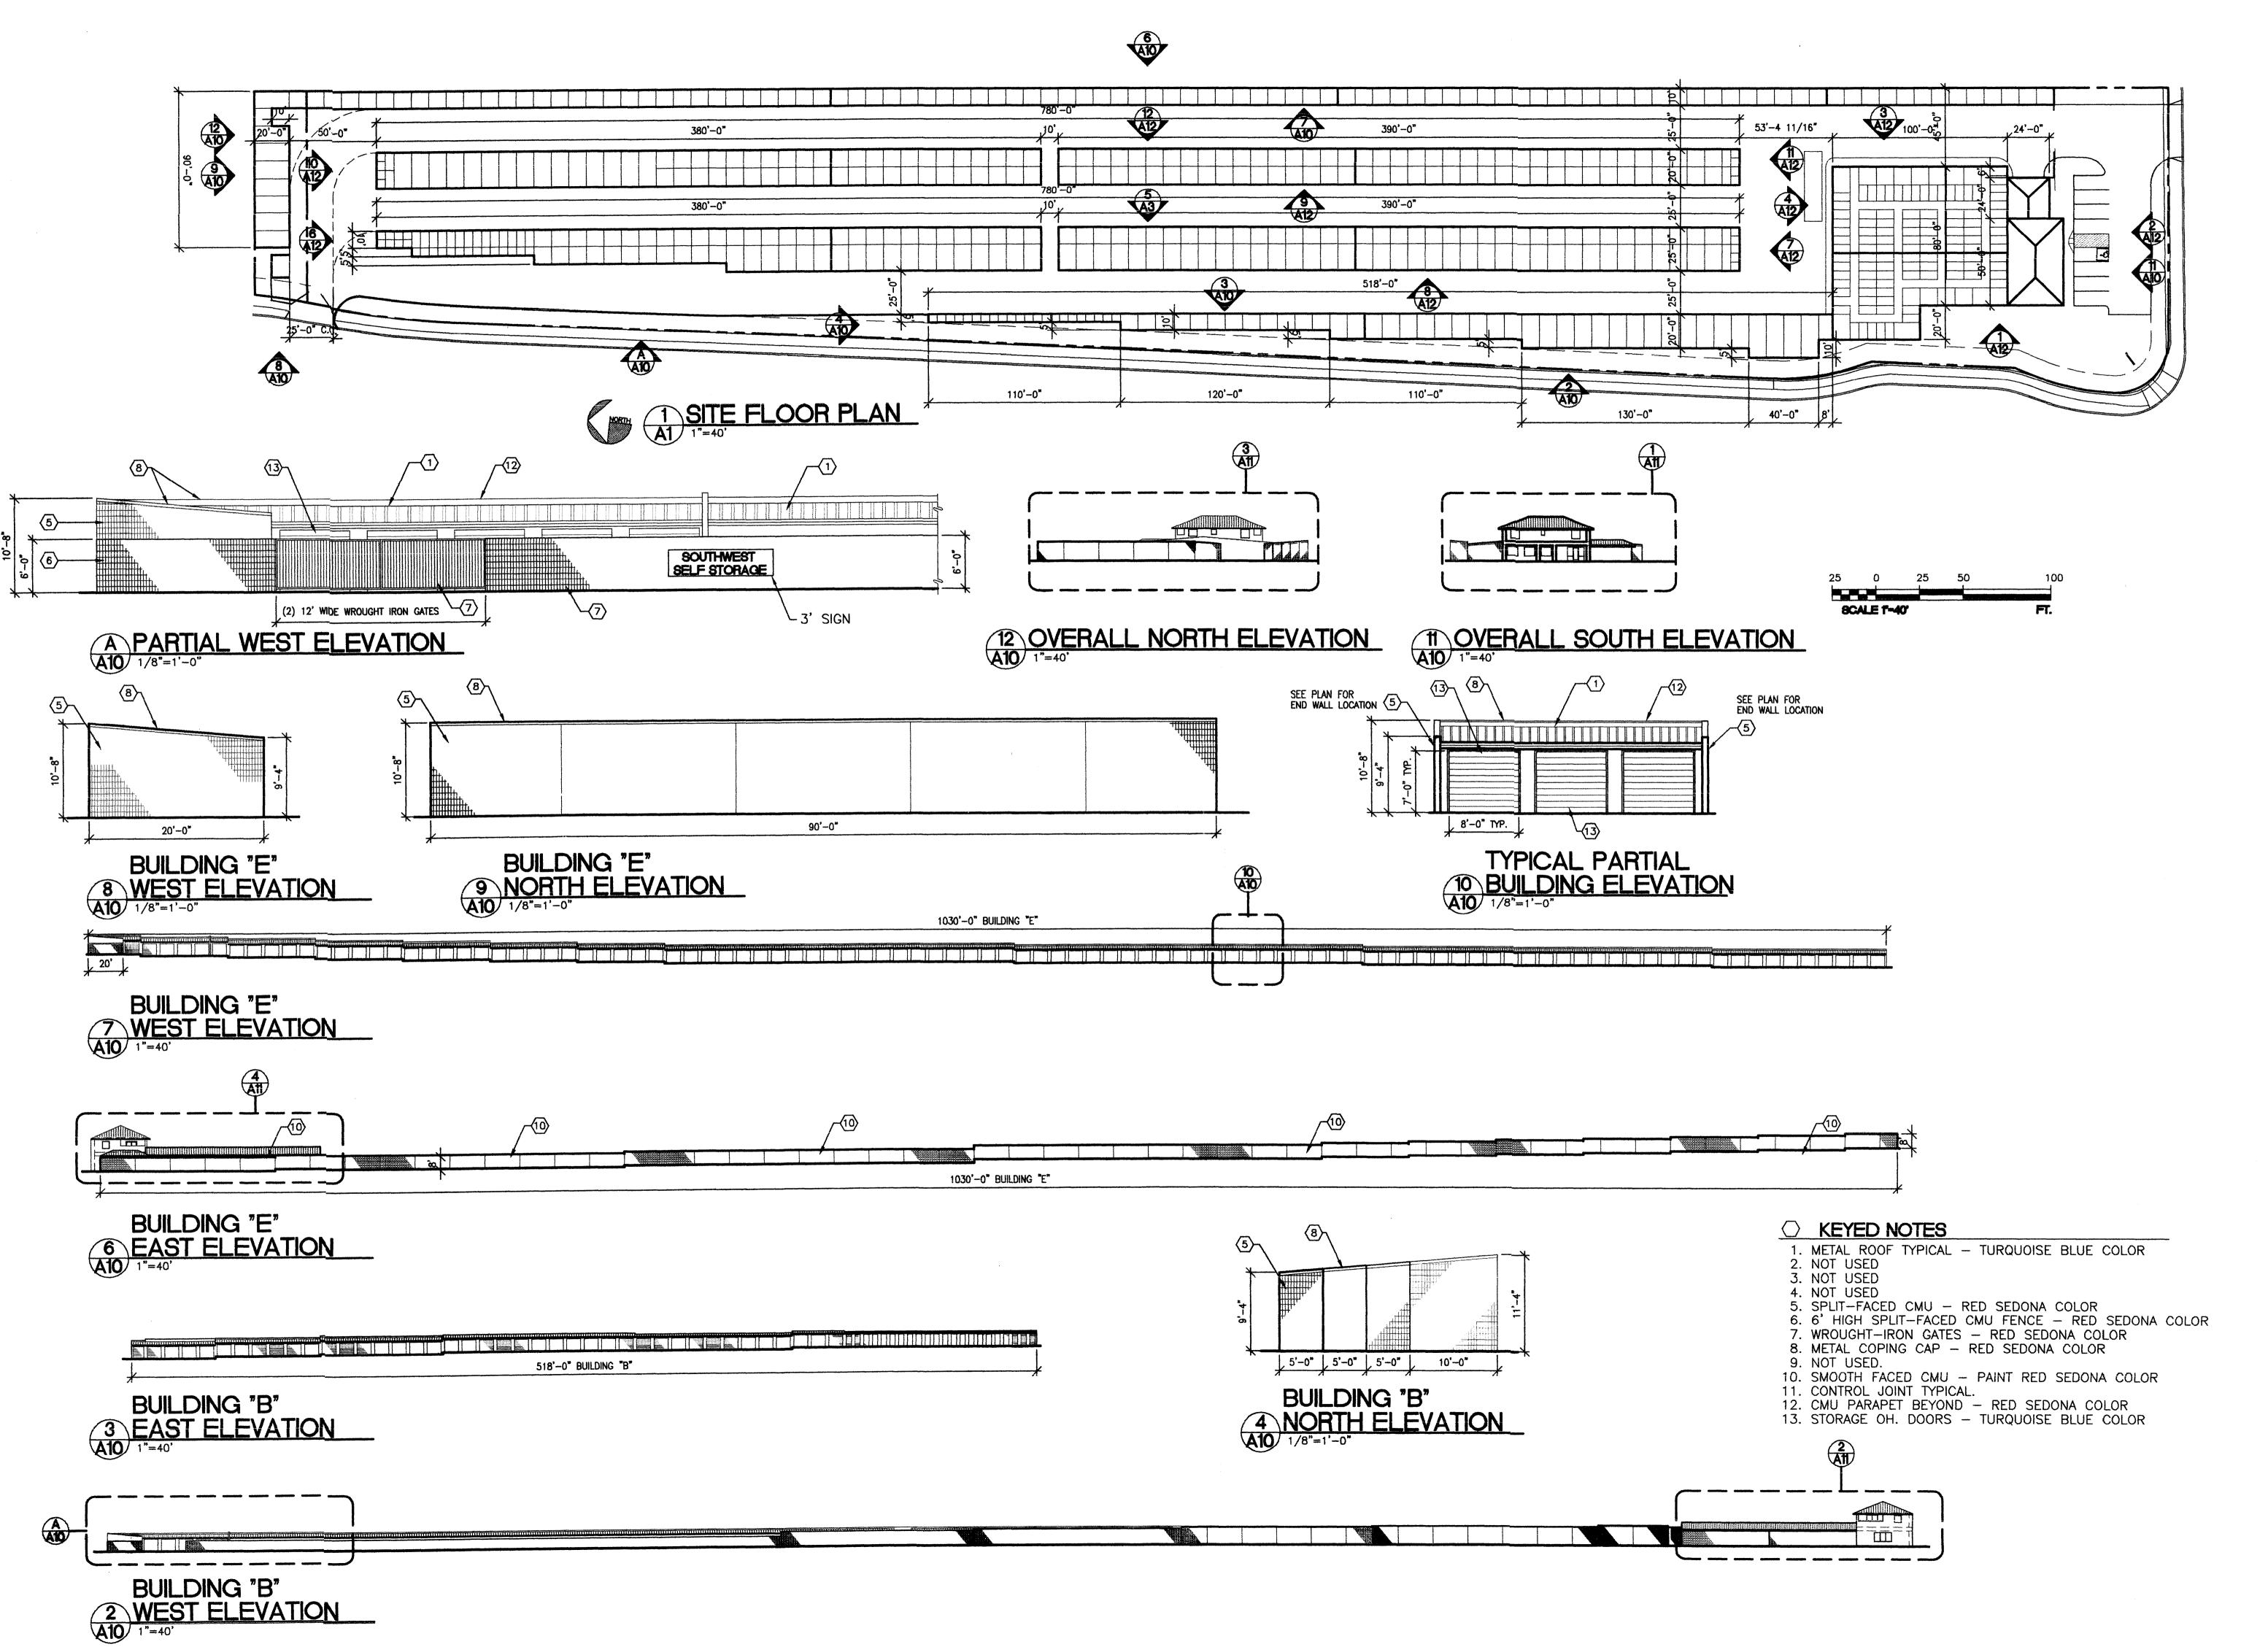
MEXICO F STORAGE

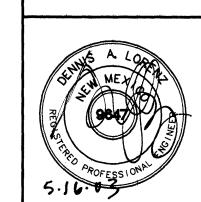REVISION DATE



05-16-2003

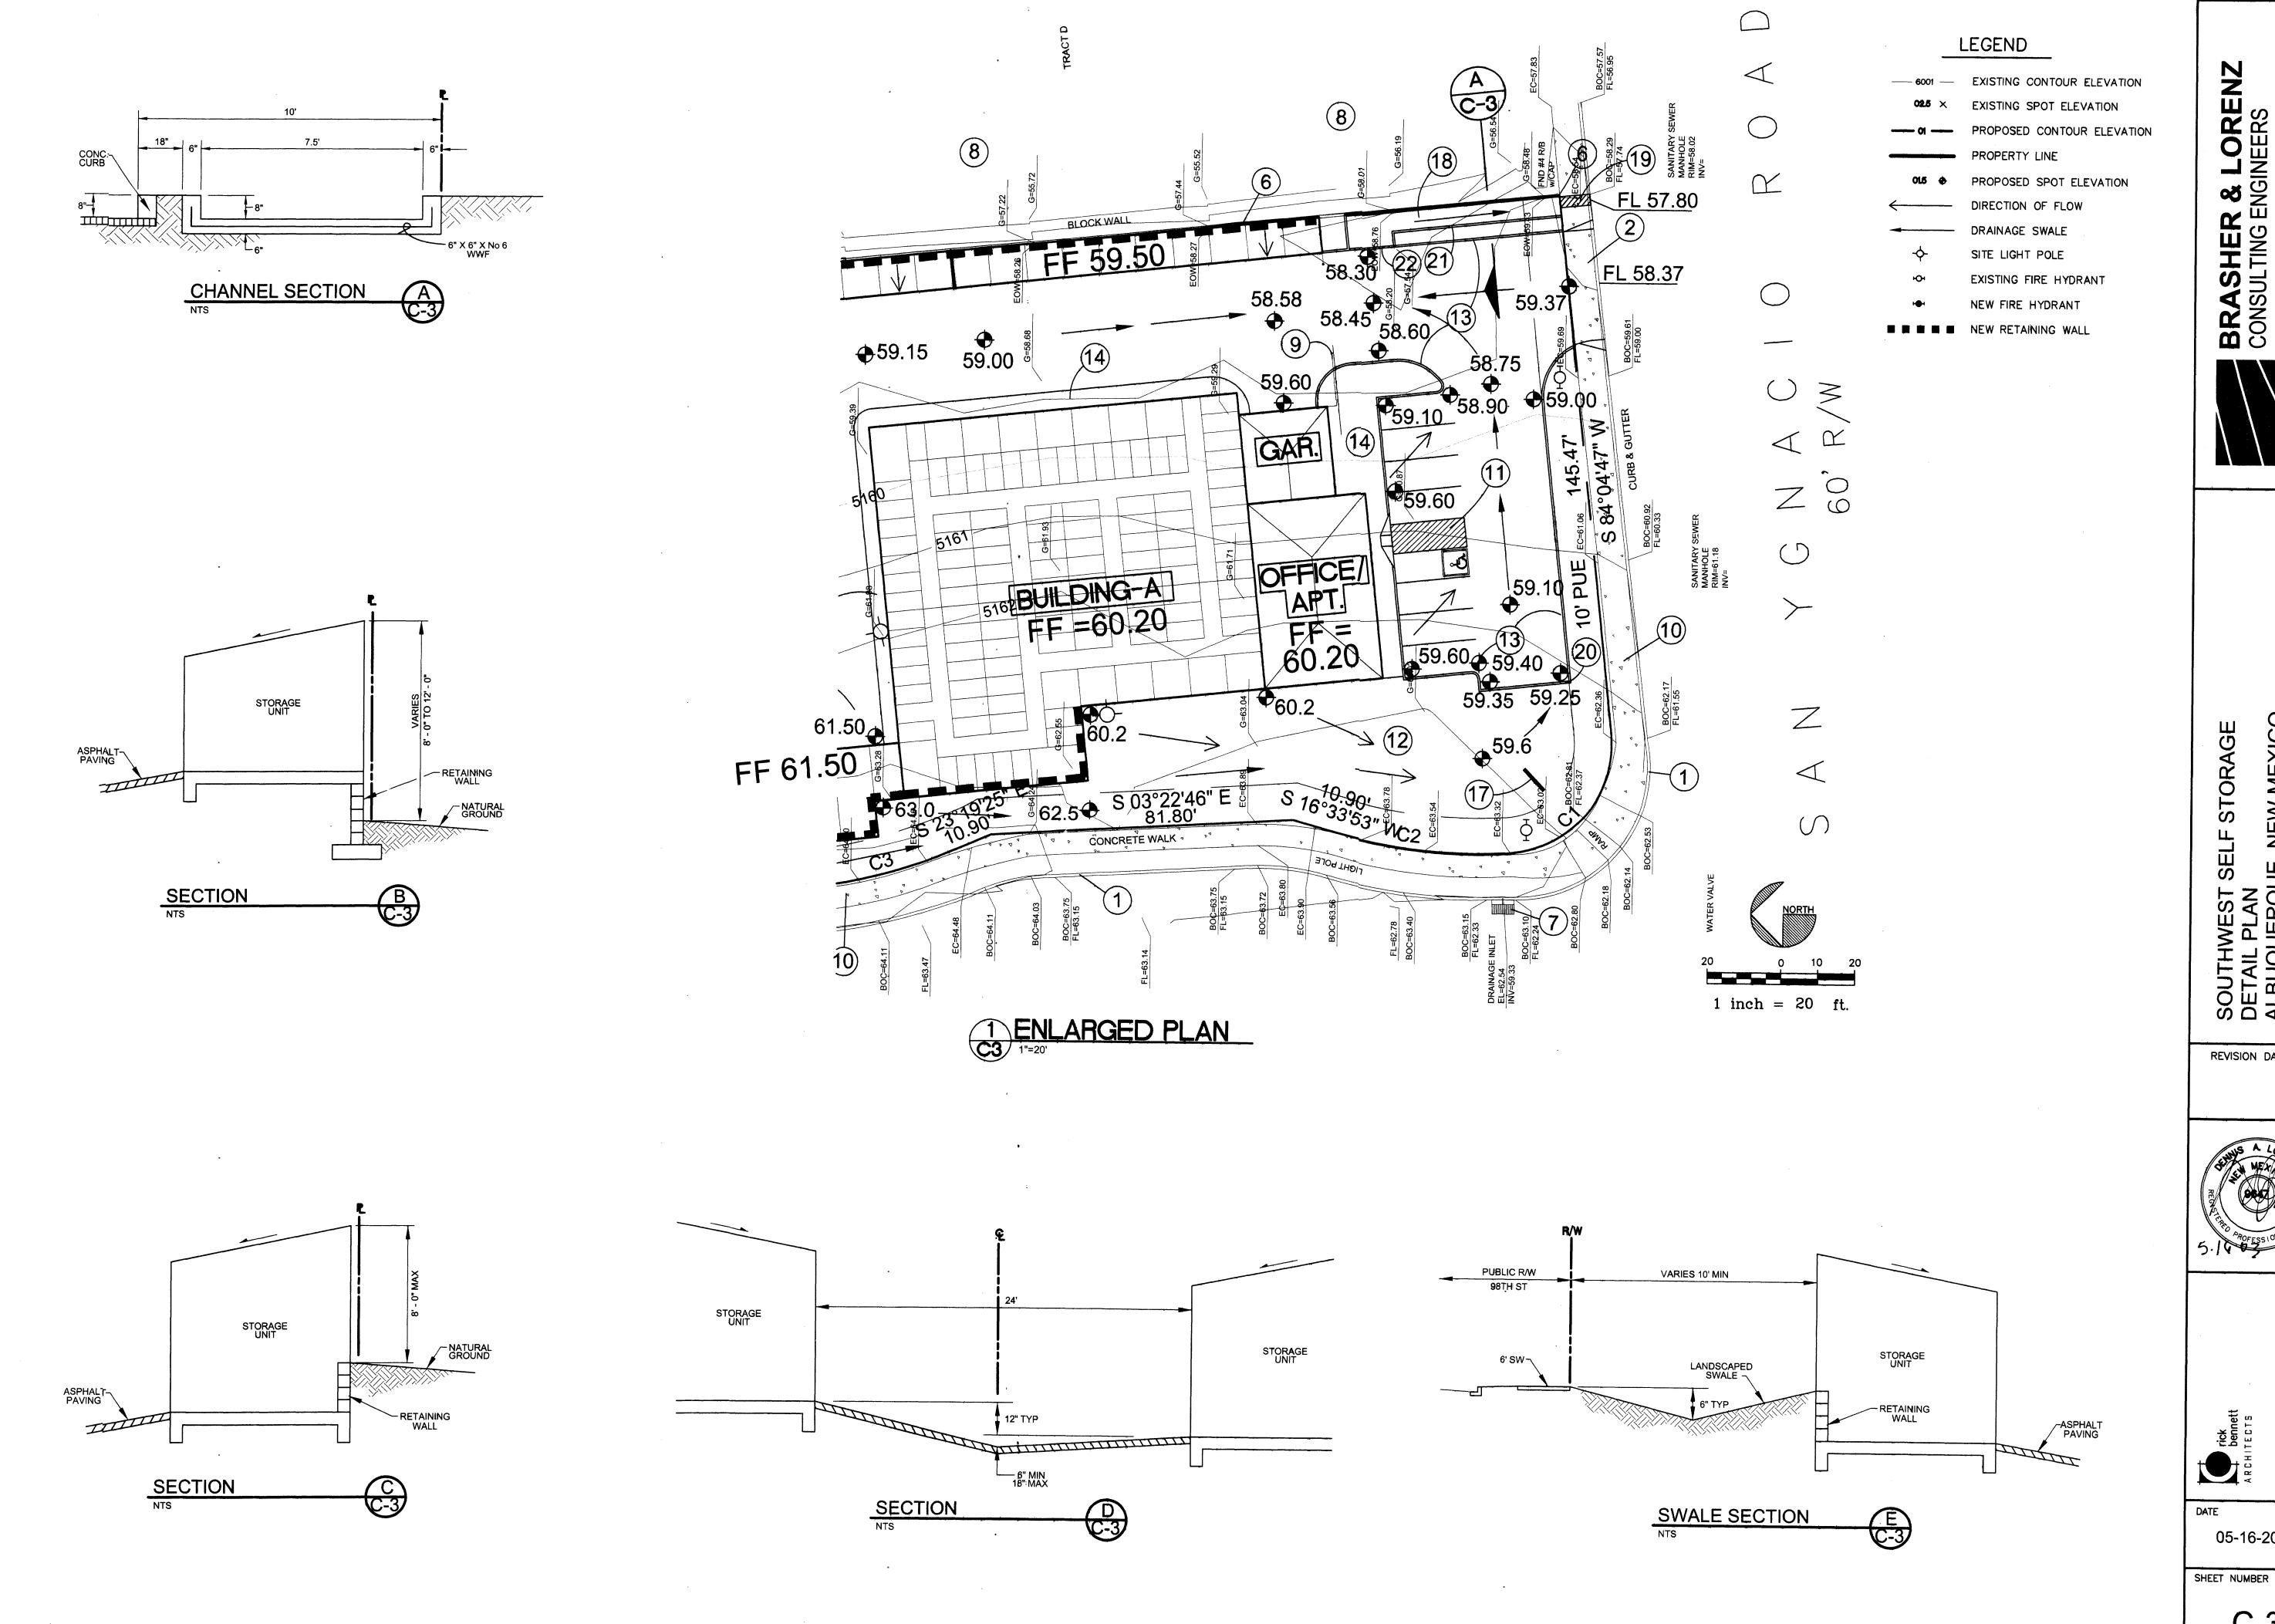C-3



SOUTHWEST SELF STORAGE
BUILDING ELEVATIONS
ALBUQUERQUE, NEW MEXICO

REVISION DATE

OF NEW METT

NO. 1240

WILL OF NEW METT

NO. 1240

OF

ARCHITECTS

ARCHITECTS

1104 Park Avenue SW · Albuquerque, New Mexico 87102

DATE
05-20-03
SHEET NUMBER


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SOUTHWEST SELF STORAGE
ENLARGED OFFICE BUILDING ELEVATIONS
ALBUQUERQUE, NEW MEXICO

05-20-03

A-11

SHEET NUMBER

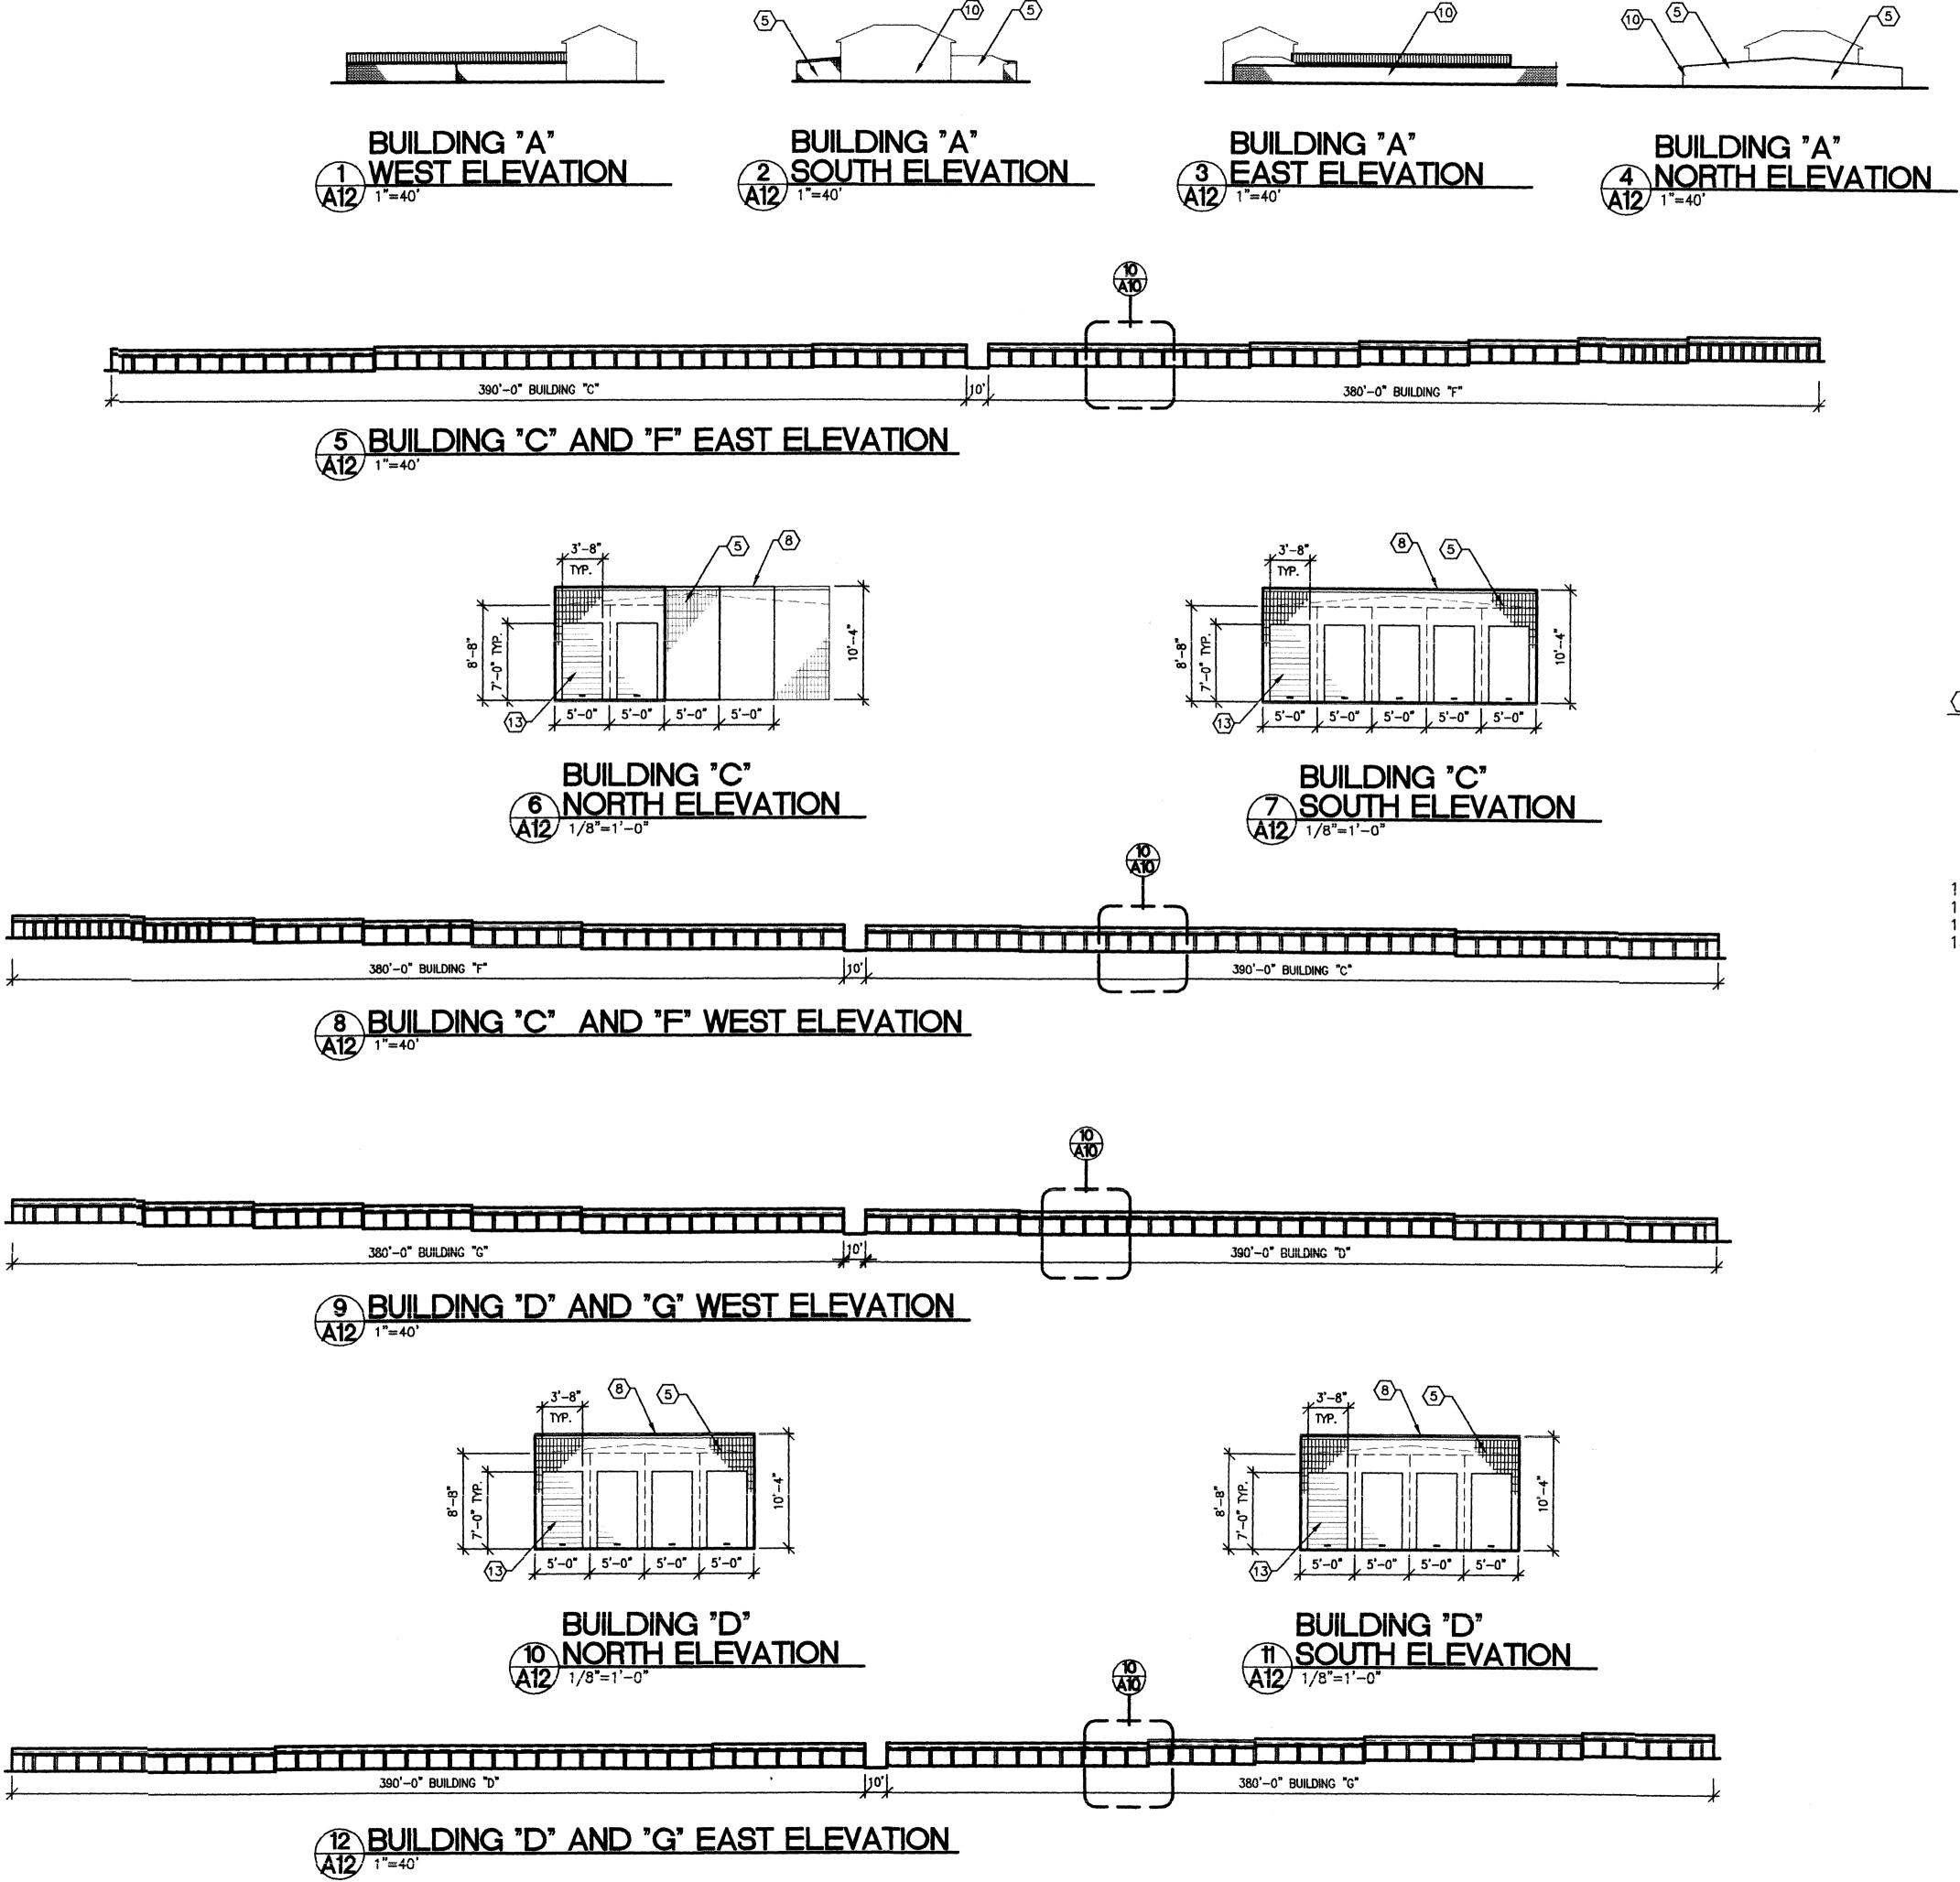

REVISION DATE

SCALE T-40'

**KEYED NOTES** 

1. METAL ROOF TYPICAL - TURQUOISE BLUE COLOR 2. NOT USED

3. NOT USED
4. NOT USED
5. SPLIT—FACED CMU — RED SEDONA COLOR
6. 6' HIGH SPLIT—FACED CMU FENCE — RED SEDONA COLOR

12. CMU PARAPET BEYOND - RED SEDONA COLOR

7. WROUGHT—IRON GATES — RED SEDONA COLOR
8. METAL COPING CAP — RED SEDONA COLOR
9. NOT USED.
10. SMOOTH FACED CMU — PAINT RED SEDONA COLOR
11. CONTROL JOINT TYPICAL. 13. STORAGE OH. DOORS - TURQUOISE BLUE COLOR

DATE

05-20-03

A-12

SHEET NUMBER