## VENTURA PLACE ATPASEO AND VENTURA

## INDEX TO DRAWINGS

1	TITLE	<b>SHEET</b>
<b>.</b> •		


- AMENDED SITE PLAN FOR SUBDIVISION
- SITE PLAN FOR SUBDIVISION NOTES
- SITE PLAN FOR BUILDING PERMIT
- LANDSCAPING PLAN
- CONCEPTUAL GRADING PLAN
- MASTER UTILITY PLAN

### **ELEVATION PLANS**

- ANCHOR BUILDING-WEST 7.1A-
- ANCHOR BUILDING-EAST 7.1B-
- OFFICE BUILDING 7.2-
- RESTAURANT/BUILDING 7.3-
- RESTAURANT 7.4-
- DRYCLEANER/RETAIL 7.5-
- **BANK** 7.6-
- PUBLIC ACTIVITIES PAVILION & ELEVATION OF MONUMENT SIGNS 7.7-
- DAYCARE (KINDERCARE) 7.8-



1 OF 7

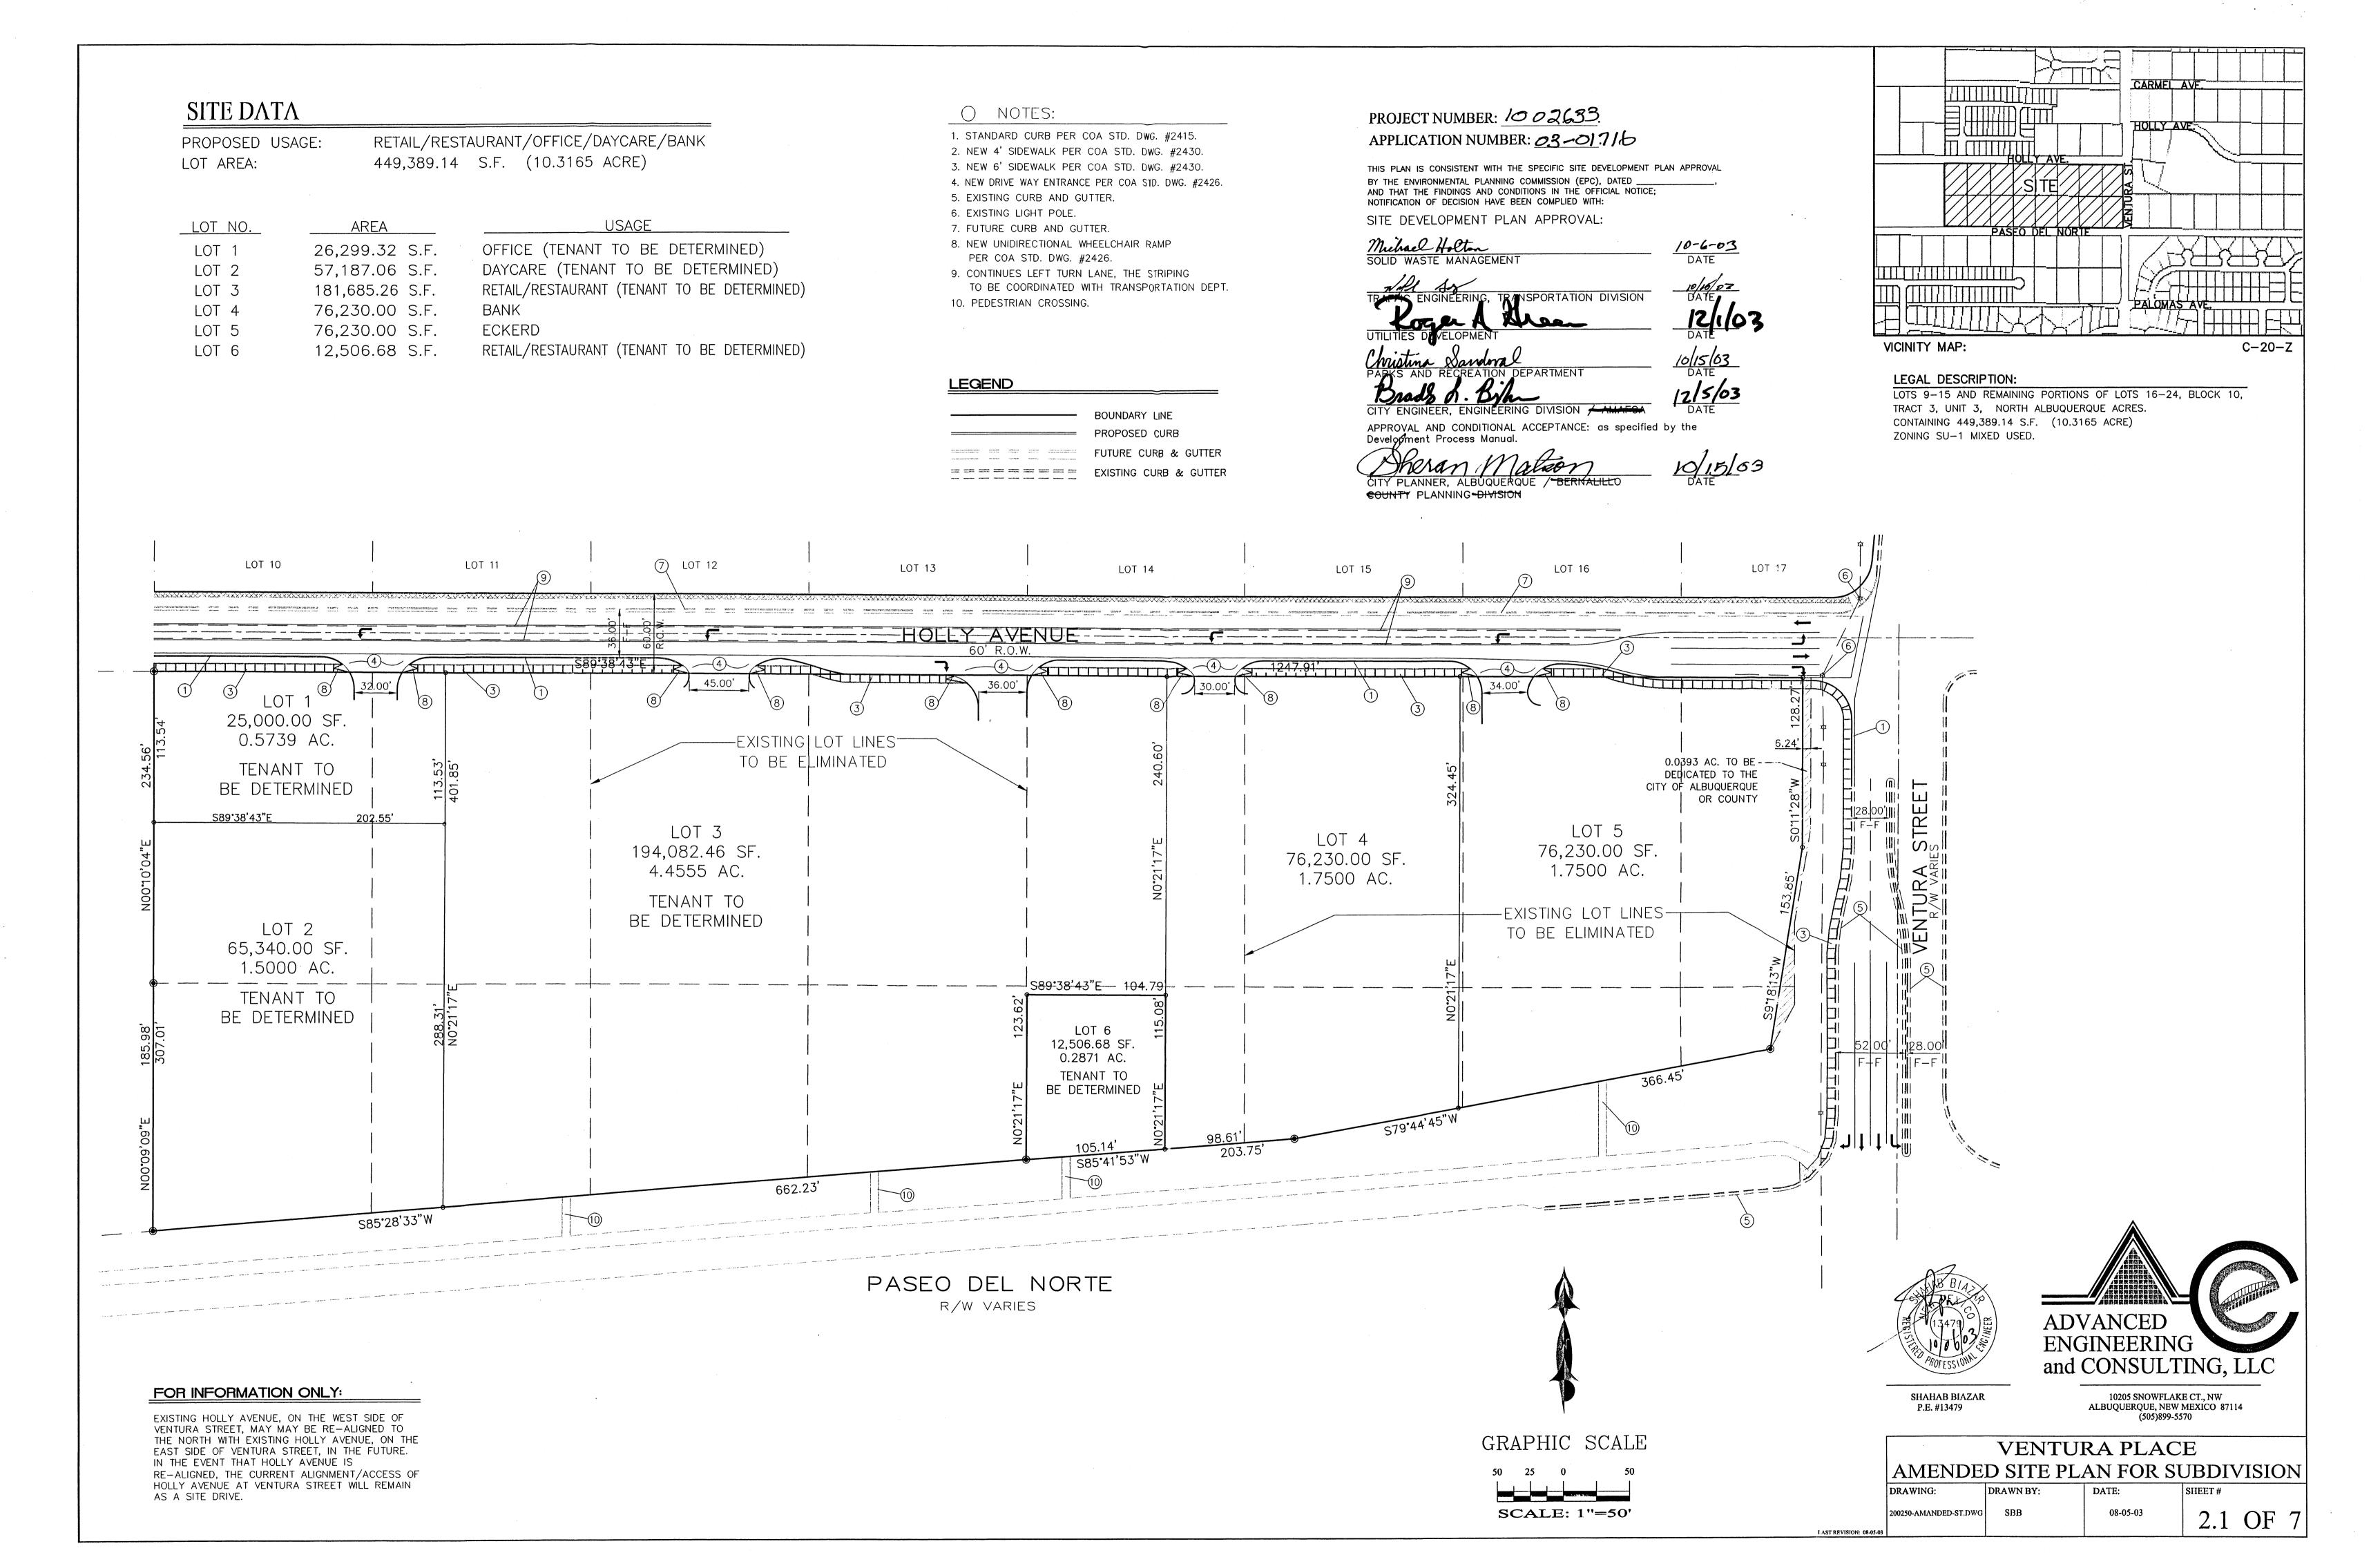

## SITE PLAN FOR SUBDIVISION NOTES

1. PROPOSED DEVELOPMENT

PLAN MUST CONFORM TO THE REQUIREMENTS OF THE LA CUEVA SECTOR DEVELOPMENT PLAN, AND THE CITY OF ALBUQUERQUE COMPREHENSIVE ZONING CODE.

2. PERMISSIVE USES

PERMISSIVE USES AS INDICATED IN LA CUEVA SECTOR DEVELOPMENT PLAN SECTION 5.4.5 SU-2/MIXED USE

THE HEIGHT REQUIREMENTS OF THE O-1 ZONE APPLY EXCEPT THAT THE MAXIMUM BUILDING HEIGHT IS 36 FEET.

MINIMUM SETBACKS ARE AS DEFINED IN THE O-1 ZONE. NO PARKING IS ALLOWED ALONG HOLLY AVENUE. MAXIMUM SETBACK FROM HOLLY SHALL NOT EXCEED 30 FEET.

5. OFF-STREET PARKING

INTENT: PROVIDE SAFE VEHICULAR PARKING WITH ATTENTION TO FUNCTIONAL AND AESTHETIC CONCERNS. ALL PARKING SHOULD BE JUSTIFIED. OVERSIZED PARKING LOTS OR FACILITIES SHOULD BE DISCOURAGED.

IN ADDITION TO THE OFF-STREET PARKING REGULATIONS IN THE CITY ZONING CODE, THE FOLLOWING REGULATIONS MUST BE MET.

A: THE NUMBER OF REQUIRED PARKING SPACES CAN BE REDUCED 10% WHERE THE SITE IS ADJACENT TO A BUS STOP AND DIRECT PEDESTRIAN ACCESS IS PROVIDED TO THE BUS STOP.

B: PARKING SPACES SHALL BE DISTRIBUTED ON THE SITE TO MINIMIZE VISUAL IMPACT. PARKING AT THE REAR OF THE SITE IS ENCOURAGED. WHEN PARKING IS LOCATED AT THE FRONT OR SIDES OF THE SITE, PARKING AREAS SHALL BE PLACED ON AT LEAST TWO SIDES OF A BUILDING. PARKING AREAS MUST BE BROKEN UP INTO MODULES SEPARATED BY LANDSCAPING AND OTHER FEATURES.

C: THE MINIMUM REQUIRED PARKING SPACES PLUS TEN PERCENT IS THE MAXIMUM PARKING ALLOWED. A VARIANCE TO THE STANDARD MUST BE APPROVED TO INCREASE THE ALLOWED

D: PARKING AREAS SHOULD BE DESIGNED TO MINIMIZE LOCAL TEMPERATURE GAIN AND REDUCE AIR POLLUTION. POTENTIAL METHODS OF ACCOMPLISHING THIS INCLUDE LIGHT COLORED MATERIALS IN PARKING LOT SURFACES AND TREES OR OTHER SHADING DEVICES TO SHADE THE SURFACE AREA OF THE LOT.

E: PARKING SHOULD BE PLACED TO ENCOURAGE AND FACILITATE PARKING ONCE AND WALKING TO MULTIPLE DESTINATIONS.

F: SHARD PARKING IN MIXED-USE AREAS IS ENCOURAGED AND TOTAL SPACES MAY BE REDUCED WHEN THE OWNER DEMONSTRATES THAT THE MIX OF USES HAS STAGGERED PARKING

6. SIGNAGE

INTENT: ESTABLISH CONTINUITY AND CONSISTENCY IN THE DESIGN AND LOCATION OF PUBLIC SIGNAGE, SO THAT THE AESTHETIC APPEARANCE IS IMPROVED.

IN ADDITION TO THE REGULATIONS OF THE CITY ZONING CODE, THE FOLLOWING REGULATIONS MUST BE MET.

A: ALL SIGNAGE SHALL BE DESIGNED TO BE CONSISTENT WITH AND COMPLEMENT THE MATERIALS, COLOR AND ARCHITECTURAL STYLE OF THE BUILDING OR SITE.

B: WALL MOUNTED SIGNS SHALL NOT EXTEND ABOVE THE ROOF LINE.

C: NO WALL MOUNTED SIGNS ARE ALLOWED OF FACADES THAT FACE ABUTTING RESIDENTIAL ZONES.

D: WHERE FREESTANDING SIGNS ARE ALLOWED, ALL FREESTANDING SIGNS SHALL BE MONUMENT SIGNS. HEIGHT OF MONUMENT SIGNS IS LIMITED TO EIGHT (8) FEET WITH A MAXIMUM FACE AREA OF 50 SQUARE FEET.

E: NO OFF-PREMISES SIGNS ARE ALLOWED.

F: NO SIGNAGE IS ALLOWED THAT USES FLASHING, OSCILLATING, REVOLVING, BLINKING OR AUDIBLE DEVICES. NO BANNERS, PENNANTS, RIBBONS, OR STREAMERS ARE ALLOWED EXCEPT FOR THEMATIC SPECIAL EVENTS AND WITH PRIOR APPROVAL BY THE PLANNING DIRECTOR.

G: SIGNAGE MAY BE ILLUMINATED IN ACCORDANCE WITH THE LIGHTING REGULATION REGULATIONS IN SECTION 14 OF THE CITY ZONING CODE.

H: THE MAXIMUM INDIVIDUAL LETTER SIZE OF ALL BUILDING MOUNTED SIGNS SHALL BE TWO FEET.

7. ARCHITECTURAL CHARACTER, NON-RESIDENTIAL BUILDINGS INTENT: REDUCE THE APPARENT SCALE AND UNIFORMITY OF FACADES TO MAKE LARGE BUILDINGS SEEM MORE INVITING.

A: MULTIPLE BUILDINGS ON THE SAME SITE SHALL BE DESIGNED TO CREATED A COHESIVE VISUAL RELATIONSHIP BETWEEN BUILDINGS.

B: EXTERIOR BUILDING DESIGN AND DETAILS ON ALL ELEVATIONS SHALL BE COORDINATED WITH REGARD TO COLOR, TYPES OF MATERIALS, NUMBER OF MATERIALS, AND ARCHITECTURAL FORM TO ACHIEVE HARMONY AND CONTINUITY OF DESIGN.

CONTINUING 7. ARCHITECTURAL CHARACTER, NON-RESIDENTIAL BUILDINGS C: BUILDING MASSES SHALL BE BROKEN UP INTO SMALLER SCALE COMPONENTS TO REDUCE PERCEIVED HEIGHT AND BULK AND TO PROVIDE VISUAL INTEREST CONSISTENT WITH THE COMMUNITY'S IDENTITY, CHARACTER, AND SCALE.

D: FACADES GREATER THAN 100 FEET IN LENGTH MUST INCORPORATE RECESSIONS OR PROJECTIONS ALONG AT LEAST 20% OF THE LENGTH OF THE FACADE. RECESSION MUST BE A MINIMUM OF DEPTH OF THREE FEET AND MINIMUM WIDTH OF 10 FEET.

E: NO INDIVIDUAL BUILDING SHALL BE GREATER THAN 50,000 SQUARE FEET IN SIZE.

F: SMALLER RETAIL STORES THAT ARE PART OF A LARGE RETAIL BUILDING SHALL HAVE DISPLAY WINDOWS. SUCH SMALLER STORES ARE ENCOURAGED. OUTSIDE ENTRANCES TO THESE SMALLER STORES ARE ENCOURAGED.

G: EACH COMMERCIAL OR OFFICE BUILDING SHALL HAVE A CLEARLY DEFINED, HIGHLY VISIBLE CUSTOMER ENTRANCE WITH FEATURES SUCH AS CANOPIES OR PORTICOS, ARCADES, ARCHES, WING WALLS AND/OR INTEGRAL PLANTERS.

H: NO GENERIC PROTOTYPICAL ARCHITECTURE IS ALLOWED. DESIGN SHALL BE CONTEXTUAL TO IT SURROUNDINGS.

8. BUILDING MATERIALS AND COLORS

INTENT: FOSTER COMMUNITY IDENTITY THROUGH THE USE OF COMPATIBLE BUILDING MATERIALS

A: PREDOMINANT EXTERIOR BUILDING MATERIALS MUST BE OF HIGH QUALITY. THESE MATERIALS INCLUDE TINTED/TEXTURED CONCRETE MASONRY UNITS OR STUCCO. SMOOTH-FACED CONCRETE BLOCK, TILT-UP CONCRETE PANELS OR PRE-FABRICATED STEEL PANELS ARE PROHIBITED AS THE PREDOMINANT EXTERIOR BUILDING MATERIAL.

B: FACADE COLORS MUST BE OF LOW REFLECTING, SUBTLE, NEUTRAL OR EARTH TONE COLORS. THE USE OF HIGH INTENSITY COLORS, METALLIC COLORS, BLACK OR FLUORESCENT COLORS IS PROHIBITED.

C: DARK-COLORED ROOFS CONTRIBUTE TO HIGHER HVAC COST AND SHOULD BE PROHIBITED. ROOF COLORS MUST BE OF LOW REFLECTING, SUBTLE, NEUTRAL OR EARTH TONE COLORS. PUEBLO STYLE FLAT ROOFS OR PITCHED ROOFS WITH ROOF TILES ARE PREFERRED.

D: TRIM MATERIALS AND COLORS MUST BLEND WITH THE PREDOMINANT BUILDING MATERIALS. THE USE OF HIGH INTENSITY COLORS, METALLIC COLORS OR FLUORESCENT COLORS IS PROHIBITED. NO PLASTIC, VINYL, OR BACK-LIT PANELS, FASCIAS OR CANOPIES ARE ALLOWED.

E: ALL CANOPIES AND OUTBUILDINGS SHALL BE CONTEXTUAL AND SHALL BE OF THE SAME MATERIALS USED IN THE GENERAL BUILDING DESIGN

F: NO BACKLIT AND/OR SHINY AWNING MATERIALS SHALL BE USED.

9. ROOF EQUIPMENT SCREENS

MECHANICAL EQUIPMENT ON ROOFS IS TO BE SCREENED FROM PUBLIC VIEW AS MUCH AS PRACTICAL. ROOF EQUIPMENT SCREENS ARE TO BE AT LEAST AS HIGH AS THE HIGHEST PART OF THE EQUIPMENT. ROOF SCREENS ARE TO BE ARCHITECTURALLY COMPATIBLE WITH THE BUILDING.

10. LIGHTING

INTENT: LIGHTING DESIGN SHOULD BE CONSISTENT WITH THE NORTH ALBUQUERQUE ACRES AND SANDIA HEIGHTS LIGHT POLLUTION ORDINANCE AS A TRANSITION FROM AN URBAN TO A RURAL ENVIRONMENT.

A: SEARCHLIGHTS, SPOTLIGHTS OR FLOODLIGHTS ARE PROHIBITED.

B: ALL OUTDOOR LIGHT FIXTURES SHALL BE FULLY SHIELDED AND EQUIPPED WITH AUTOMATIC TIMING DEVICES.

C: ALL OUTDOOR LIGHT FIXTURES WITHIN COMMERCIAL OR OFFICE ZONES SHALL REMAIN OFF BETWEEN 11:00 PM AND SUNRISE EXCEPT FOR SECURITY PURPOSES OR TO ILLUMINATE WALKWAYS, DRIVEWAYS, EQUIPMENT YARDS AND PARKING LOTS.

D: ALL OUTDOOR LIGHT FIXTURES USED FOR SECURITY PURPOSES OR TO ILLUMINATE WALKWAYS, DRIVEWAYS, EQUIPMENT YARDS AND PARKING LOTS SHALL BE DESIGNED AND OPERATED AS CUTOFF OR SEMI-CUTOFF FIXTURES AND SHALL BE EQUIPPED WITH LIGHT AND MOTION SENSORS AND/OR AUTOMATIC TIMING DEVICES.

E: ALL OUTDOOR LIGHT FIXTURES USED FOR DECORATIVE EFFECTS SHALL BE SHIELDED AND FOCUSED TO MINIMIZE LIGHT POLLUTION. SUCH OUTDOOR LIGHTING FIXTURES SHALL BE TURNED OFF BETWEEN 11:00 PM AND SUNRISE.

F: ALL OUTDOOR LIGHTING FIXTURES MOUNTED ON BUILDINGS OR STRUCTURES SHALL BE MOUNTED AT A HEIGHT NO MORE THAN 16 FEET ABOVE FINISHED GRADE.

G: ALL OUTDOOR LIGHTING SYSTEMS SHALL BE DESIGNED AND OPERATED SO THAT THE AREA 10 FEET BEYOND THE PROPERTY LINE OF THE PREMISES RECEIVES NO MORE THAN 0.25 (ONE-QUARTER) OF A FOOT CANDLE OF LIGHT FROM THE PREMISES LIGHTING SYSTEM. GAS STATION CANOPY LIGHTING SHALL BE SHIELDED OR RECESSED TO AVOID IMPACT ON SURROUNDING RESIDENCES.

11. LOADING DOCKS, TRASH COLLECTION, AND SIMILAR FACILITIES INTENT: IMPROVE OVERALL COMMUNITY DESIGN BY MINIMIZING NEGATIVE VISUAL IMPACTS.

A: LOADING DOCKS, TRASH RECEPTACLES, UTILITY STRUCTURES AND SIMILAR FACILITIES SHALL BE INCORPORATED INTO THE OVERALL DESIGN OF THE BUILDING AND LANDSCAPING SO THAT THE VISUAL AND ACOUSTIC IMPACTS OF THESE FUNCTIONS ARE FULLY CONTAINED AND OUT OF VIEW FROM ADJACENT PROPERTIES AN PUBLIC STREETS. SCREENING MATERIALS FOR THESE AREAS SHALL BE THE SAME AS THE PRINCIPAL MATERIALS OF THE BUILDING AND LANDSCAPE.

B: ROOF CANOPIES SHALL BE PROVIDED OVER ALL LOADING DOCKS. ROOF CANOPIES SHALL BE ARCHITECTURALLY INTEGRATED WITH THE BUILDING.

12. PERIMETER WALLS INTENT: ADD VISUAL INTEREST AND CHARACTER TO THE STREETSCAPE AND INCREASE THE OVERALL APPEAL OF THE DEVELOPMENT.

A: WALLS SHALL BE DESIGNED TO COMPLEMENT THE ARCHITECTURAL CHARACTER OF THE SUBDIVISION OR NEIGHBORING ARCHITECTURE BY INCORPORATING THE ARCHITECTURAL FEATURES AND MOTIFS USED ON ADJACENT HOMES OR BUILDINGS.

B: MATERIALS SUCH AS STUCCO OVER CONCRETE MASONRY UNITS, CURVED INTERLOCK BLOCK, SPLIT FACE BLOCK, SLUMP BLOCK, STABILIZED ADOBE, BRICK, TUBULAR WROUGHT IRON, SEE-THROUGH MASONRY BLOCKS, LANDSCAPING OR A COMBINATION OF THOSE MATERIALS SHALL BE USED FOR PERIMETER WALLS. WOOD AND CHAIN LINK ARE NOT ALLOWED. CONCERTINA WIRE IS NOT ALLOWED.

C: LONG EXPANSES OF UNBROKEN WALLS ARE PROHIBITED. WALLS SHALL BE INDENTED, OFFSET OR IN SERPENTINE FORM TO AVOID "TUNNEL" EFFECT, AS SHOWN IN FIGURE 9.

D: THE ADOPTED CITY OF ALBUQUERQUE WALL DESIGN GUIDELINES SHALL BE ADOPTED AS

INTENT: ENSURE THAT DEVELOPMENT RESPECTS THE VIEWS OF THE SANDIA MOUNTAINS TO THE EAST AND THE MESA TO THE WEST. THIS INCLUDES PRESERVING VIEWS FROM OUT OF THE SITE AND SITE DESIGN TO TAKE ADVANTAGE OF VIEWS FROM THE SITE.

A: SITE DEVELOPMENT PLANS SHALL INCLUDE A VIEW ANALYSIS THAT SHALL IDENTIFY VIEWS INTO AND OUT OF THE SITE AND INDICATE HOW THESE VIEWS WILL BE PROTECTED WITHIN THE

B: ALL UTILITIES SHALL BE PLACED UNDERGROUND.


C: ROOFTOP MECHANICAL AND ELECTRICAL EQUIPMENT, MICROWAVE ANTENNAE, OR SIMILAR ROOFTOP HARDWARE SHALL BE SCREENED FROM PUBLIC VIEW. THE BUILDING ELEMENTS TO SCREEN SUCH EQUIPMENT SHALL BE DESIGNED AS AN INTEGRAL PART OF THE BUILDING ARCHITECTURE. ALL HVAC EQUIPMENT SHALL BE LESS THAN OR EQUAL TO THE TOP OF ANY PARAPET OR SCREEN WALL. THE PARAPET OR SCREEN WALL SHALL BE ARCHITECTURALLY INTEGRATED INTO THE GENERAL BUILDING DESIGN. WHERE A PUBLIC ROAD OR OTHER PUBLIC AREA IS ELEVATED, ROOFTOP EQUIPMENT VISIBLE FROM THE ROAD MUST BE COVERED.

INTENT: PROVIDE A PLEASANT MICROCLIMATE FOR PEDESTRIANS AND INCREASE THE AESTHETIC APPEAL OF A DEVELOPMENT.

A: THE STANDARDS OF THE STREET TREE ORDINANCE AND LANDSCAPING PROVISIONS OF THE CITY ZONING CODE APPLY EXCEPT THAT

1. TREES FLACED ALONG THE PRIMARY PEDESTRIAN WALKWAY MUST BE NO MORE THAT 25 FEET APART.


2. TREES MAY BE CLUSTERED AT PLAZA AREAS OR OTHER PUBLIC GATHERING PLACES.

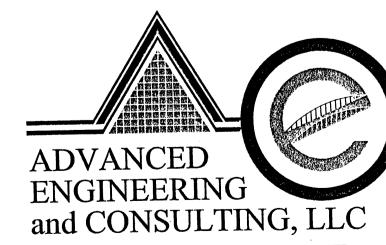

10205 SNOWFLAKE CT., NW ALBUQUERQUE, NEW MEXICO 87114

VENTURA PLACE SITE PLAN FOR SUBDIVISION NOTES SHEET# DATE: DRAWN BY: DRAWING: 04-30-03 SBB 200250-ST.DWG

LAST REVISION: 10-06-03

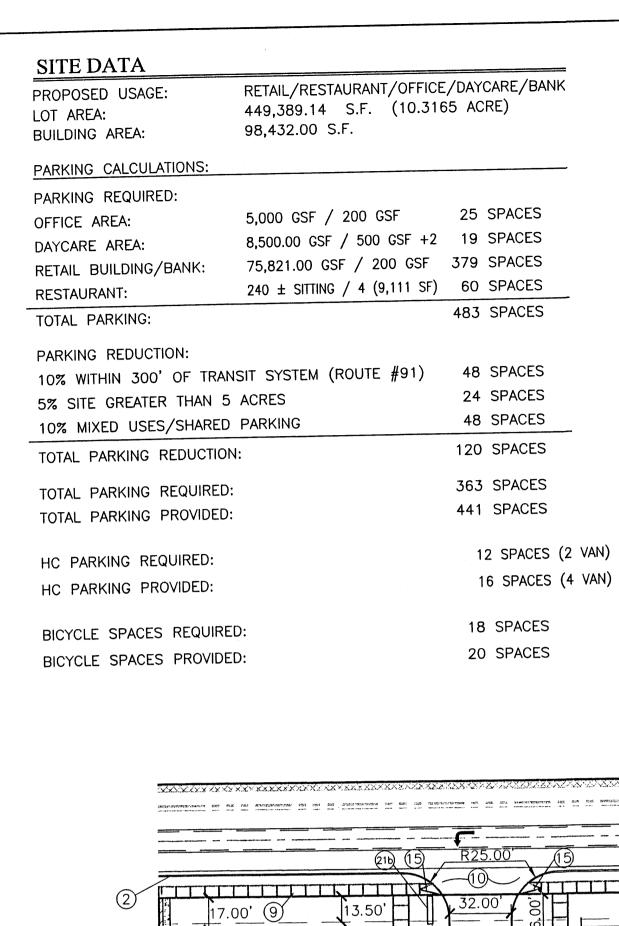

### GENERAL NOTES:

1. SITE LIGHTING WILL CONSIST OF BUILDING-MOUNTED OR STEEL POLE SEE BELOW FOR SITE LAYOUT AND TYPE.

2. THE SIGNAGE WILL CONSIST OF A MONUMENT SIGN AND BUILDING MOUNTED SIGN. THE MONUMENT SIGN SIZE SHALL NOT EXCEED 50 SQUARE FEET AND THE HIGHT SHALL NOT EXCEED 8.00' (SEE ELEVATION SHEET 7.7 FOR DETAIL).

3. THIS SITE WILL COMPLY WITH THE REQUIREMENTS OF THE STREET TREE ORDINANCE.

4. CURRENT ZONING CURRENT IS SU-1 MIXED USED.

5. WATER AND SEWER:

PRIOR TO DEVELOPMENT, CITY OF ALBUQUERQUE WATER AND SANITARY SERVICE TO THE SITE MUST BE VERIFIED AND COORDINATED WITH THE CITY OF ALBUQUERQUE

6. BUILDINGS:

BUILDING STRUCTURE SHALL NOT EXCEED 36 FEET IN HEIGHT.

BUILDING TYPES AND COLORS:

SEE ELEVATION PLANS, SHEETS 7.1 THRU 7.8.

7. THE LANDSCAPING PLAN WILL COMPLY WITH THE REQUIREMENTS OF THE WATER CONSERVATION LANDSCAPING AND WATER WASTE ORDINANCE.

8. LANDSCAPE MAINTENANCE SHALL BE THE RESPONSIBILITY OF THE PROPERTY OWNER.

9. SITE PLAN FOR BUILDING PERMIT SHALL REQUIRE TO MEET THE SIGNAGE REQUIREMENTS OF C-1 ZONING SECTION 16-14-2-16-A-11 AND NOT NECESSARILY AS THOSE SHOWN ON THE SITE PLAN FOR BUILDING PERMIT.

10. MAINTENANCE OF PUBLIC OPEN SPACE AMENDITIES SHALL BE THE RESPONSIBILITY OF THE PROPERTY OWNER.

O NOTES:

1. 6" CONCRETE CURB PER COA STD. DWG. #2415. 2. STANDARD CURB PER COA STD. DWG. #2415.

3. ACCESSIBLE SIDEWALK RAMP.

4. NEW ASPHALT PAVING AREA.

5. 6' WIDE TEXTURED CONCRETE PEDESTRAIN CROSSING.

6. CONCRETE WALK.

7. 6' WIDE ASPHALT PEDESTRIAN CROSSING

8. NEW 4' SIDEWALK PER COA STD. DWG. #2430.

9. NEW 6' SIDEWALK PER COA STD. DWG. #2430. 10. NEW DRIVE WAY ENTRANCE PER COA STD. DWG. #2426.

11. 8" CMU REFUSE ENCLOSURE PER COA SOLID WASTE DEPARTMENT STANDARDS.

12. EXISTING CURB AND GUTTER.

13. EXISTING POWER POLE.

14. FUTURE CURB AND GUTTER.

15. NEW UNIDIRECTIONAL WHEELCHAIR RAMP PER COA STD. DWG. #2426.

16. 9' WIDE X 20' DEEP PARKING SPACES

17. 9' WIDE X 18' DEEP PARKING SPACES

18. HANDICAP SINE PER COA STANDARDS. 19. BICYCLE RACK

20. TAN SPLIT FACE BLOCK WALL (HEIGHT NOT TO EXCEED 8').

21a. MONUMENT SIGN, SEE ELEVATION SHEET 7.7 FOR DETAIL.

21b. MONUMENT SIGN, 4' HIGH. NO ILLUMINATION. 21c. MONUMENT SIGN, REFER TO ECKERD'S SUBMITTAL,

22. PUBLIC ACTIVITIES PAVILION, SEE ELEVATION SHEET 7.7 FOR DETAIL.

R/W VARIES

PROJECT NUMBER: 1002633 APPLICATION NUMBER: 03-01718

THIS PLAN IS CONSISTENT WITH THE SPECIFIC SITE DEVELOPMENT PLAN APPROVAL BY THE ENVIRONMENTAL PLANNING COMMISSION (EPC), DATED \_ AND THAT THE FINDINGS AND CONDITIONS IN THE OFFICIAL NOTICE; NOTIFICATION OF DECISION HAVE BEEN COMPLIED WITH:

SITE DEVELOPMENT PLAN APPROVAL:

Michael Holton SOLID WASTE MANAGEMENT 10-15-03 DATE 10/10/03 DATE ENGINEERING, TRANSPORTATION DIVISION 12/05/03 DATE 10/15/03 bristing Dandows CITY ENGINEER, ENGINEERING DIVISION / AMAFCA APPROVAL AND CONDITIONAL ACCEPTANCE: as specified by the

Development Process Manual.

CITY PLANNER, ALBUQUERQUE / BERNALILLO

COUNTY PLANNING DIVISION

LEGEND

BOUNDARY LINE

PROPOSED CURB

EXISTING CURB & GUTTER

FUTURE CURB & GUTTER

FOR DECIDUOUS TREE

SIDEWALK

TREE LOCATION

NUMBER OF PARKING SPACES


FIXTURE SITTING WITH PLANTER

PASEO DEL NORT C-20-Z VICINITY MAP:

HOLLY AVE.

LEGAL DESCRIPTION: LOTS 9-15 AND REMAINING PORTIONS OF LOTS 16-24, BLOCK 10, TRACT 3, UNIT 3, NORTH ALBUQUERQUE ACRES. CONTAINING 449,389.14 S.F. (10.31655 ACRE).

ZONING SU-1 MIXED USED.

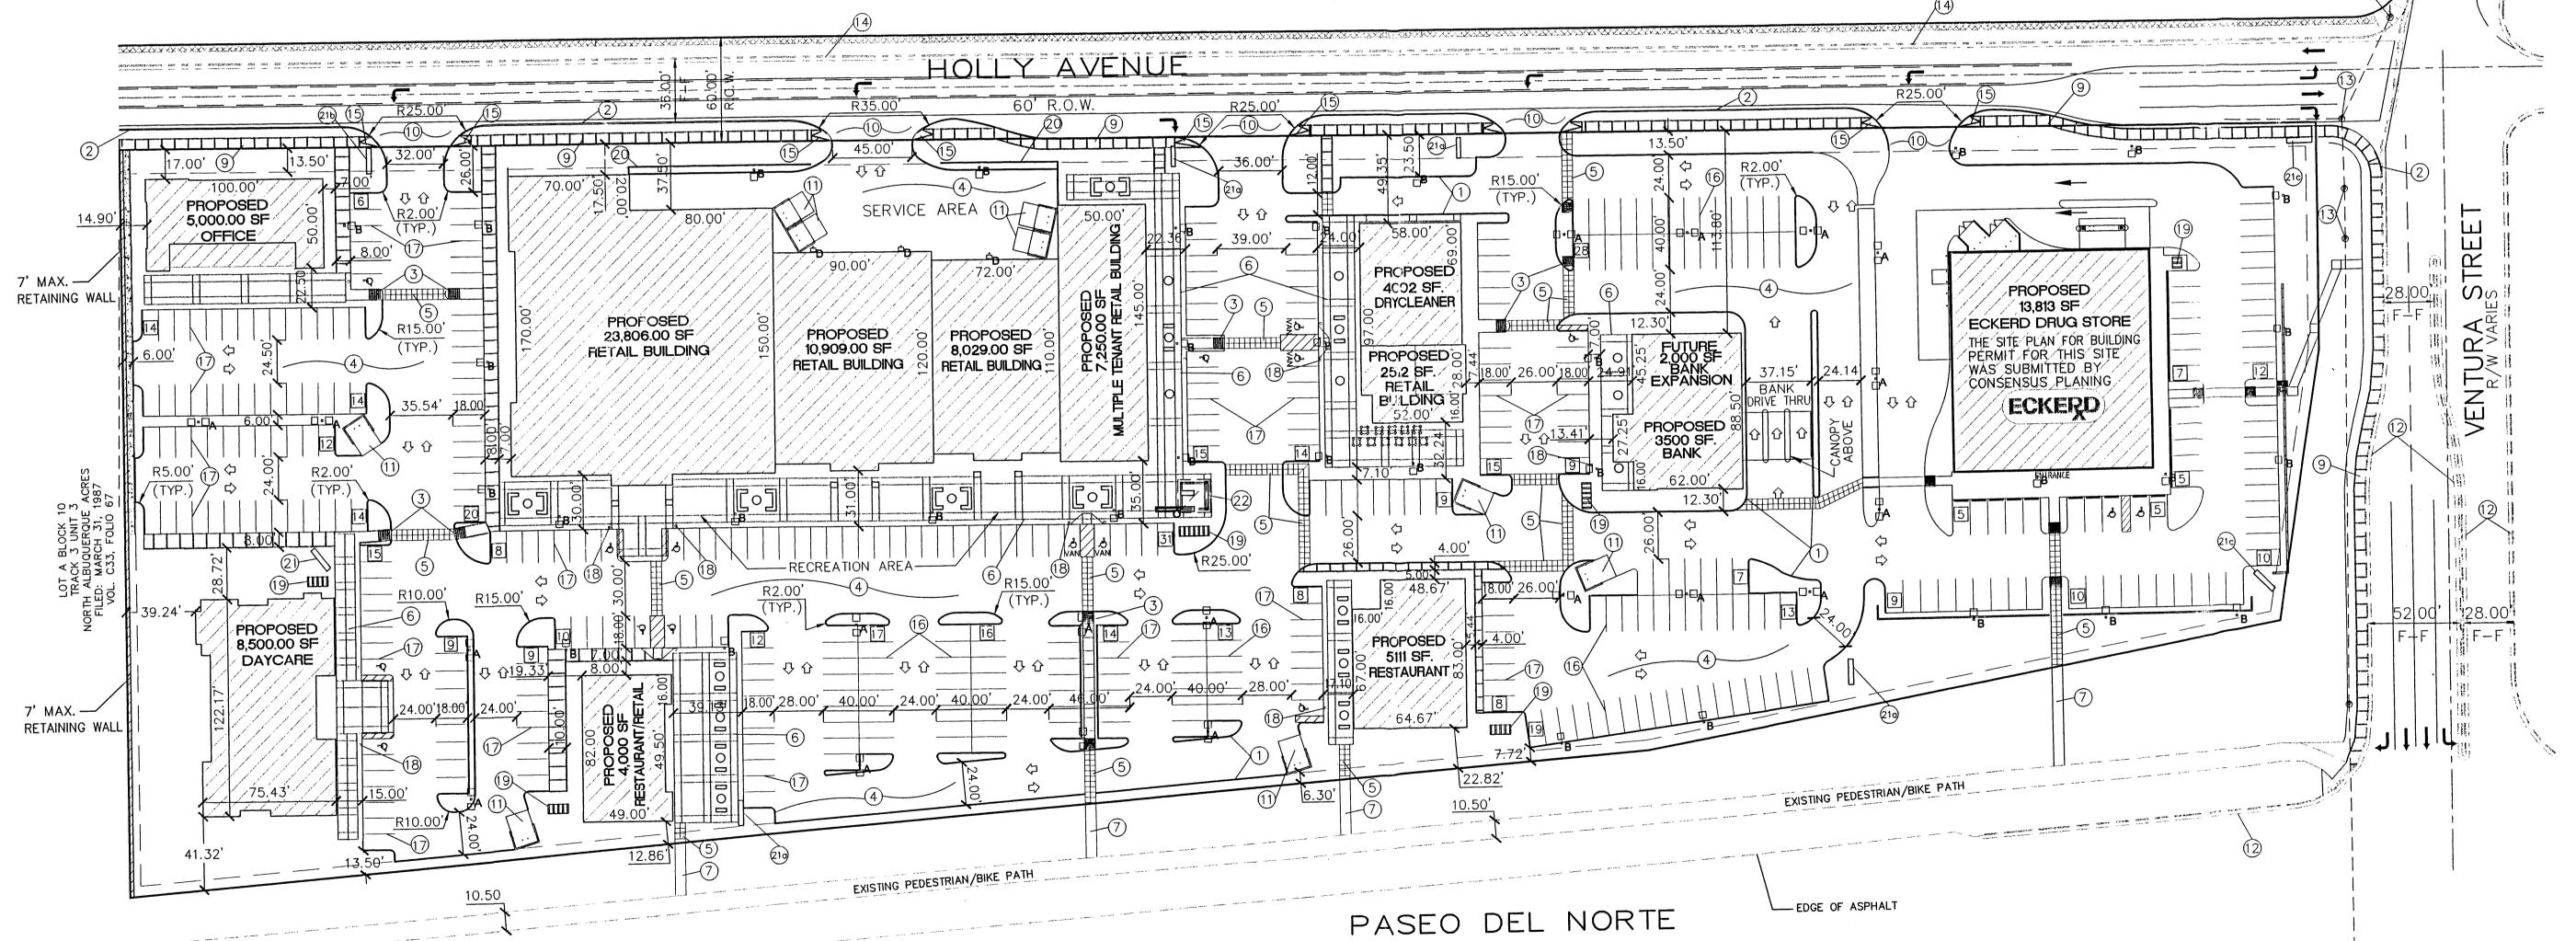



GRAPHIC SCALE

SCALE: 1"=50'

ENGINEERING and CONSULTING, LLC

SHAHAB BIAZAR

P.E. #13479

LAST REVISION: 09-29-0

10205 SNOWFLAKE CT., NW ALBUQUERQUE, NEW MEXICO 87114


VENTURA PLACE DATE: DRAWN BY:

SITE PLAN FOR BUILDING PERMIT DRAWING: 3 OF 7 04-30-03 SHH 200250-ST.DWG


#### FOR INFORMATION ONLY:

EXISTING HOLLY AVENUE, ON THE WEST SIDE OF VENTURA STREET, MAY MAY BE RE-ALIGNED TO THE NORTH WITH EXISTING HOLLY AVENUE, ON THE EAST SIDE OF VENTURA STREET, IN THE FUTURE. IN THE EVENT THAT HOLLY AVENUE IS RE-ALIGNED, THE CURRENT ALIGNMENT/ACCESS OF HOLLY AVENUE AT VENTURA STREET WILL REMAIN AS A SITE DRIVE.

EDGE OF ASPHALT -

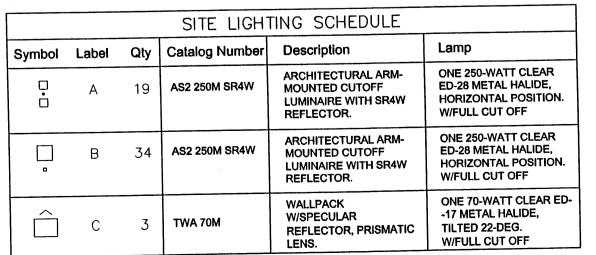

LIGHT POLES SHALL NOT EXCEED A HEIGHT OF 30' WHEN MEASURED FROM THE FINISHED GRADE TO THE TOP OF THE POLE AND AT NO TIME SHALL THE HEIGHT OF A LIGHT POLE EXCEED 16' WITHIN 100' OF RESIDENTIAL ZONE.

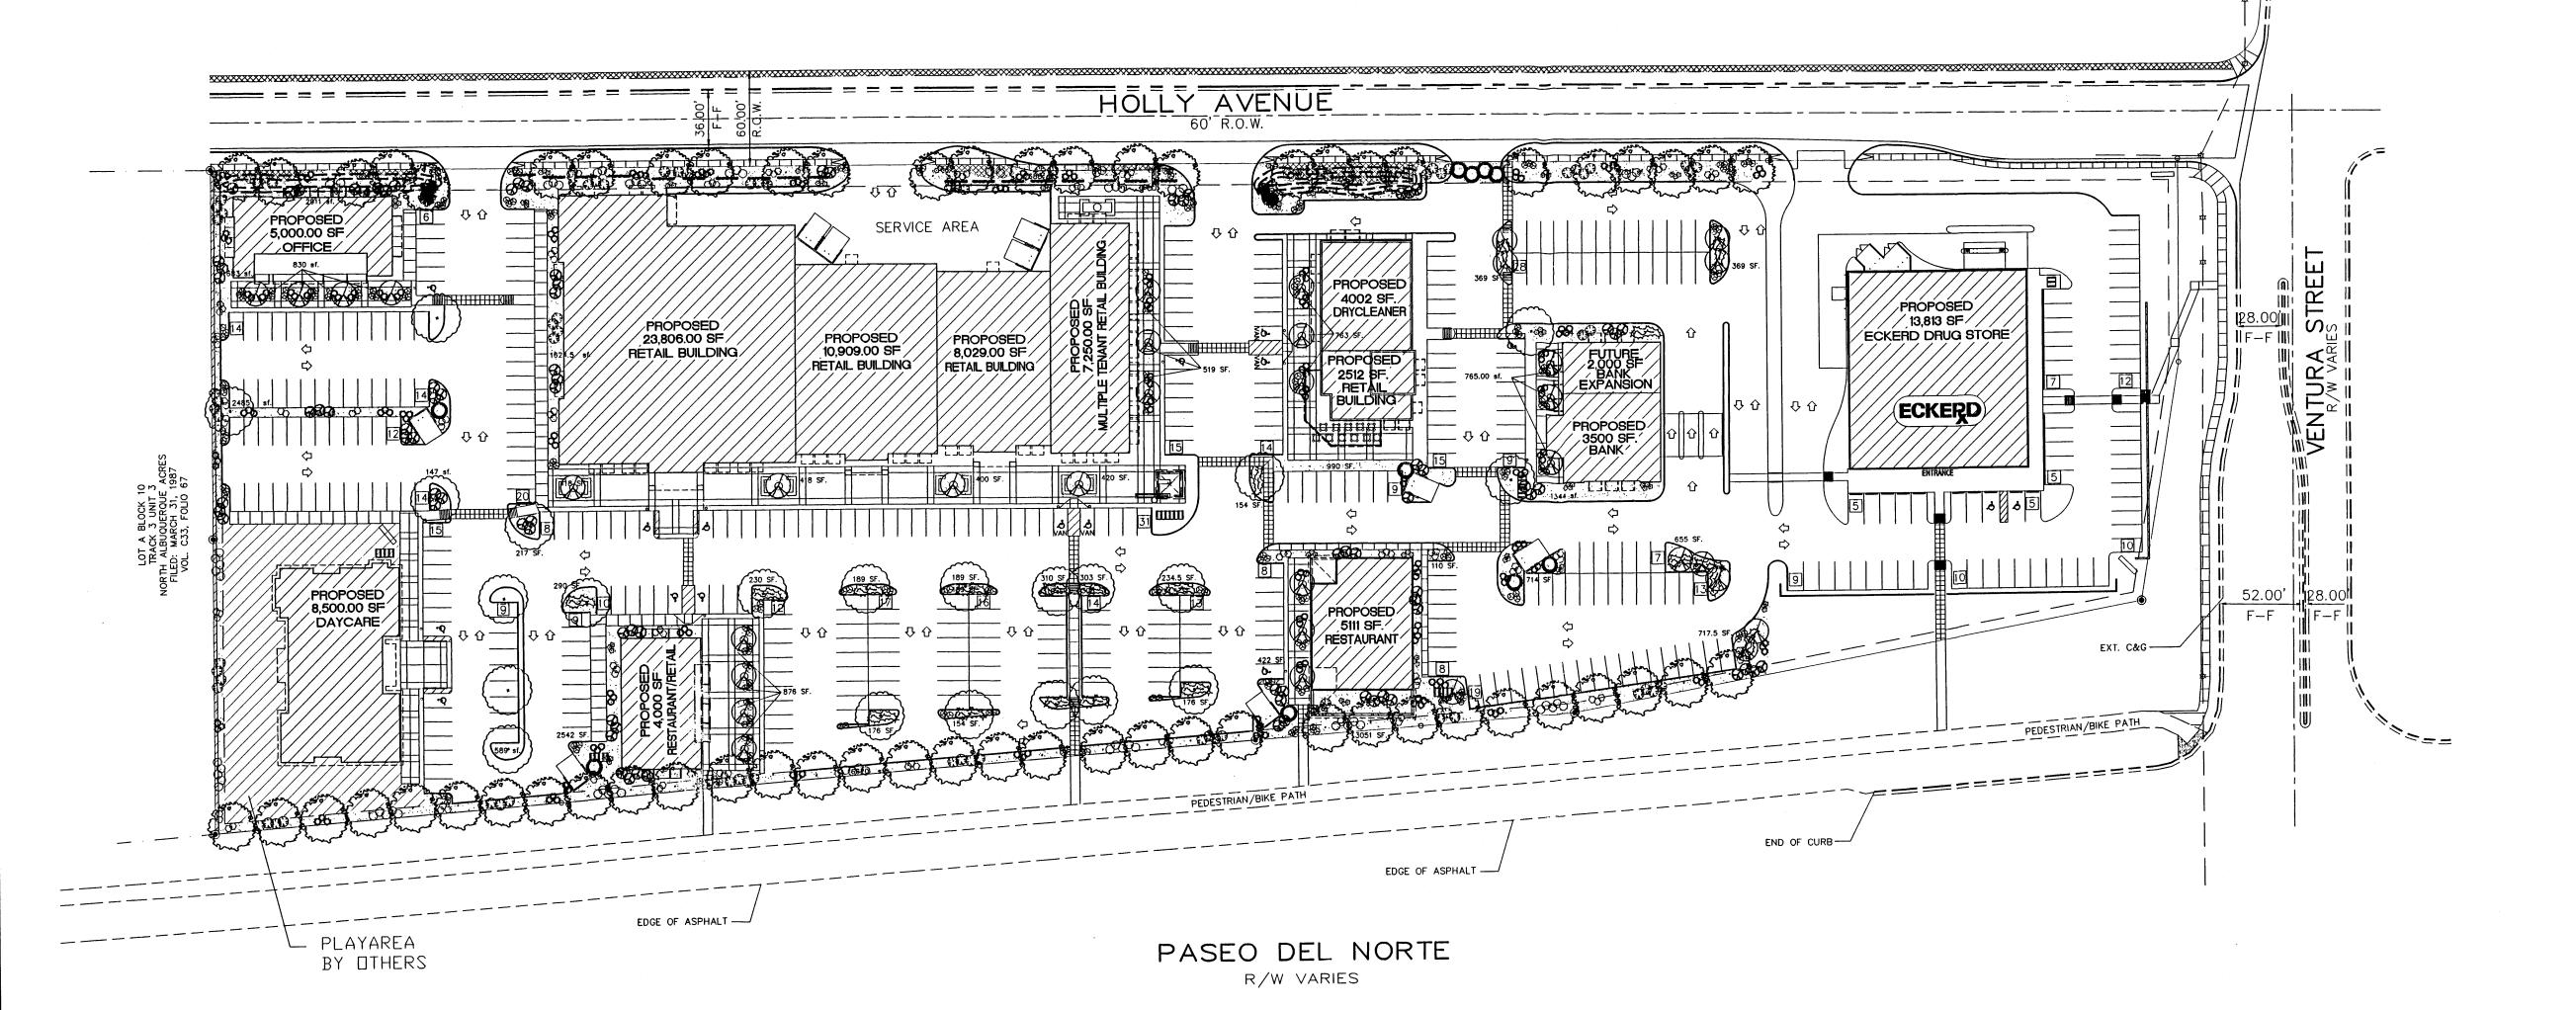

### PLANT LEGEND

ASH (H) AND HONEY LOCUST (H) 61
AUSTRIAIN PINE
Fraxinus pennsylvanica
Gleditsia triacanthos 2" Cal.

PURPLE ROBE LOCUST (M)
Robinia ambigua
2" Cal.

LANAS/ SCOTCH BROOM (M) 86

Potentilla fruticosa 2 Gal.

HONEYSUCKLE (M) 84

CHAMISA (L) 80 Chrysothamnus nauseosus 1 Gal. 25sf

WILDFLOWER 214

HONEYSUCKLE (M) 18 Lonicera sempervirens 1 Gal. 200sf

OVERSIZED GRAVEL & 8 BOULDERS

S.F. BROWN GRAVEL WITH FILTER FABRIC

### LANDSCAPE CALCULATIONS

#### NET LANDSCAPF ARFA

TOTAL NATIVE SEED PROVIDED

NET LANUSCAPE AREA		
TOTAL LOT AREA	373,159	square feet
TOTAL BUILDINGS AREA	84,618	square feet
OFFSITE AREA	0	square feet
NET LOT AREA	288,541	square feet
LANDSCAPE REQUIREMENT	15%	
TOTAL LANDSCAPE REQUIREMENT	43,281	square feet
TOTAL LANDSCAPE PROVIDED	48,686	square feet
TOTAL BED PROVIDED	48,686	square feet
TOTAL SOD PROVIDED	0	square feet

### LANDSCAPE NOTES:

Landscape maintenance shall be the responsibility of the Property Owner.

It is the intent of this plan to comply with the City Of Albuquerque Water Conservation Landscaping and Water Waste Ordinance planting restriction approach.

Approval of this plan does not constitute or imply exemption from water waste provisions of the Water Conservation Landscaping and Water Waste Ordinance. Water management is the sole responsibility of the Property Owner.

All landscaping will be in conformance with the City of Albuquerque Zoning Code, Street Tree Ordinance, Pollen Ordinance, and Water Conservation Landscaping and Water Waste Ordinance. In general, water conservative, environmentally sound landscape principles will be followed in design and installation.

Plant beds shall achieve 75% live ground cover at maturity.

S.F. Brown Gravel over Filter Fabric shall be placed in all landscape areas which are not designated to receive native seed.

#### **IRRIGATION NOTES:**


Irrigation shall be a complete underground system with Trees to receive (5) 1.0 GPH
Drip Emitters and Shrubs to receive (2) 1.0 GPH Drip Emitters. Drip and Bubbler systems to be tied to 1/2" polypipe with flush caps at each end.

Run time per each drip valve will be approximately 15 minutes per day, to be adjusted according to the season.

Point of connection for irrigation system is unknown at current time and will be coordinated in the field.


Irrigation will be operated by automatic controller. Location of controller to be field determined and power source for controller to be provided by others.

Irrigation maintenance shall be the responsibility of the Property Owner.

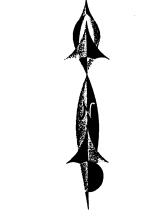

SCALE: 1"=60'



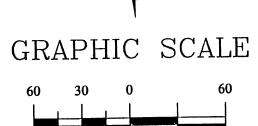




Cont. Lic. #26458 7909 Edith N.E. Albuquerque, NM 87184 Ph. (505) 898-9690 Fax (505) 898-7737 cmd@hilltoplandscaping.com

All creative ideas contained Herein remains the property of The Hilltop Landscape Architects and Contractors and are protected by copyright laws. This is an original design and must not be released or copied unless applicable fees have been paid or job order

LAST REVISION: 10-06-03

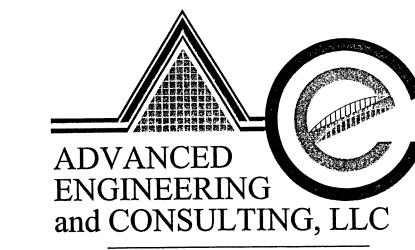



10205 SNOWFLAKE CT., NW ALBUQUERQUE, NEW MEXICO 87114 (505)899-5570


PASEO PLACE LANDSCAPING PLAN

DATE: SHEET# DRAWN BY: DRAWING:


04-29-03 4 OF 7 200250-LS.DWG JES

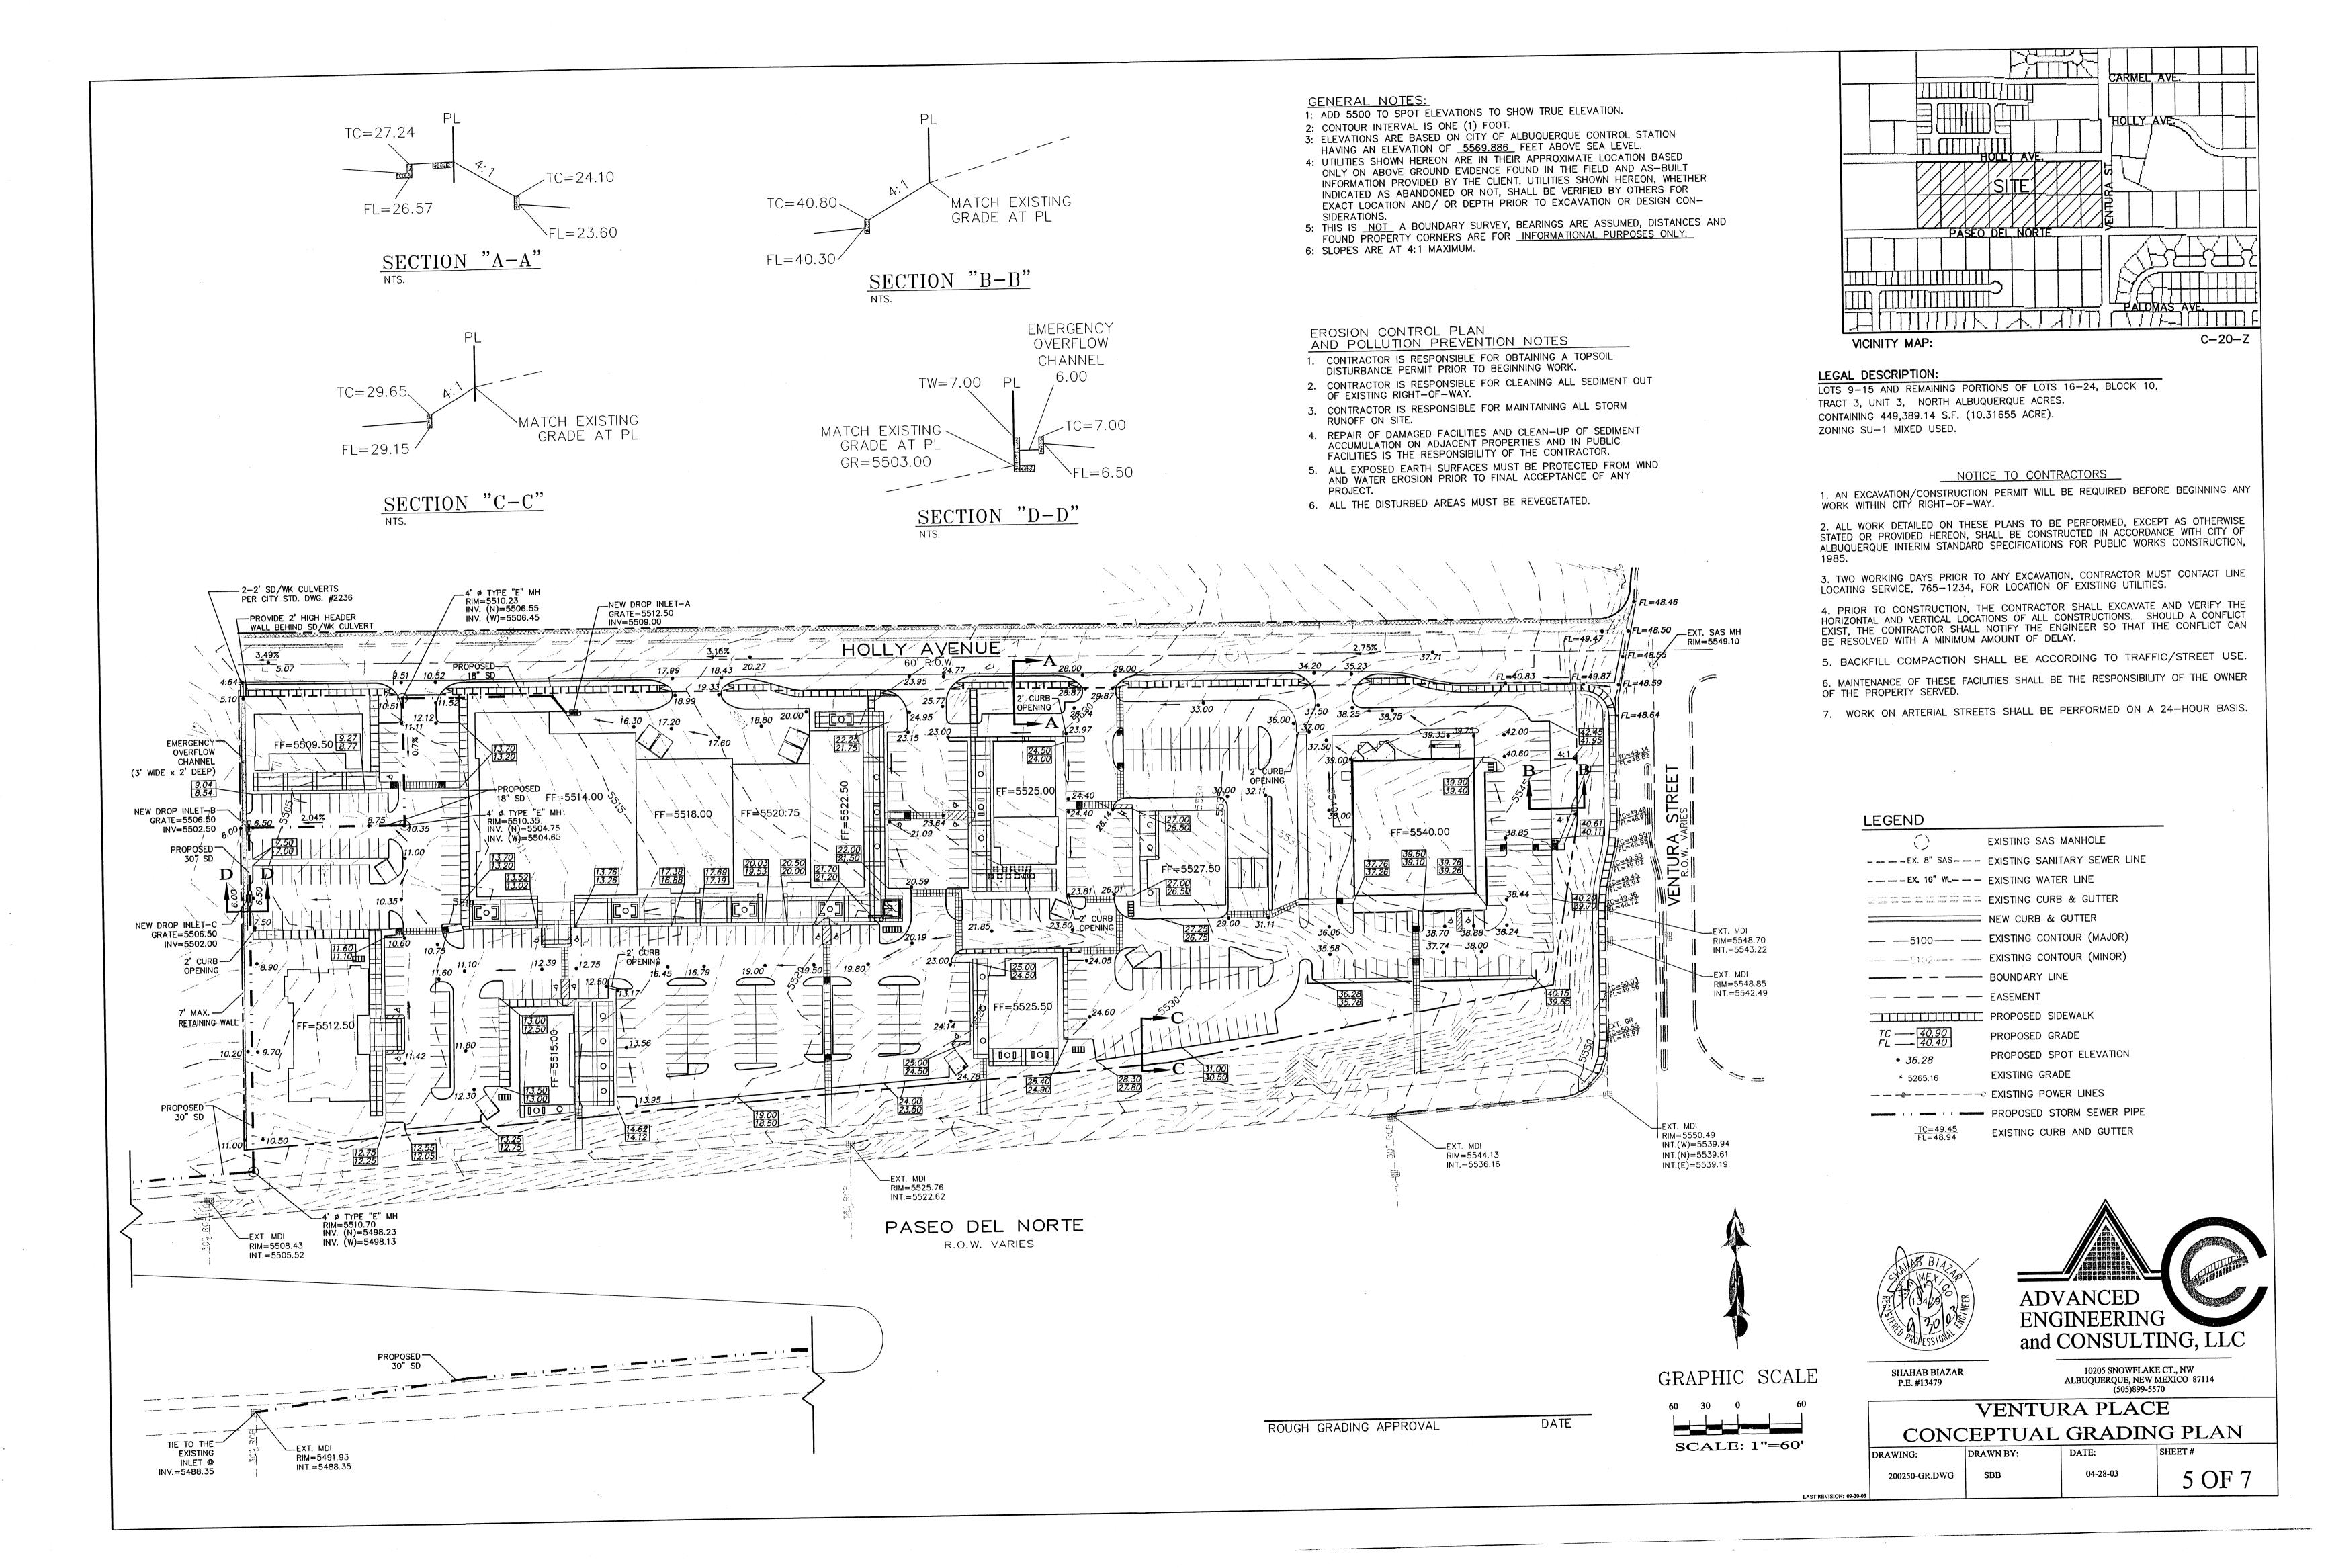

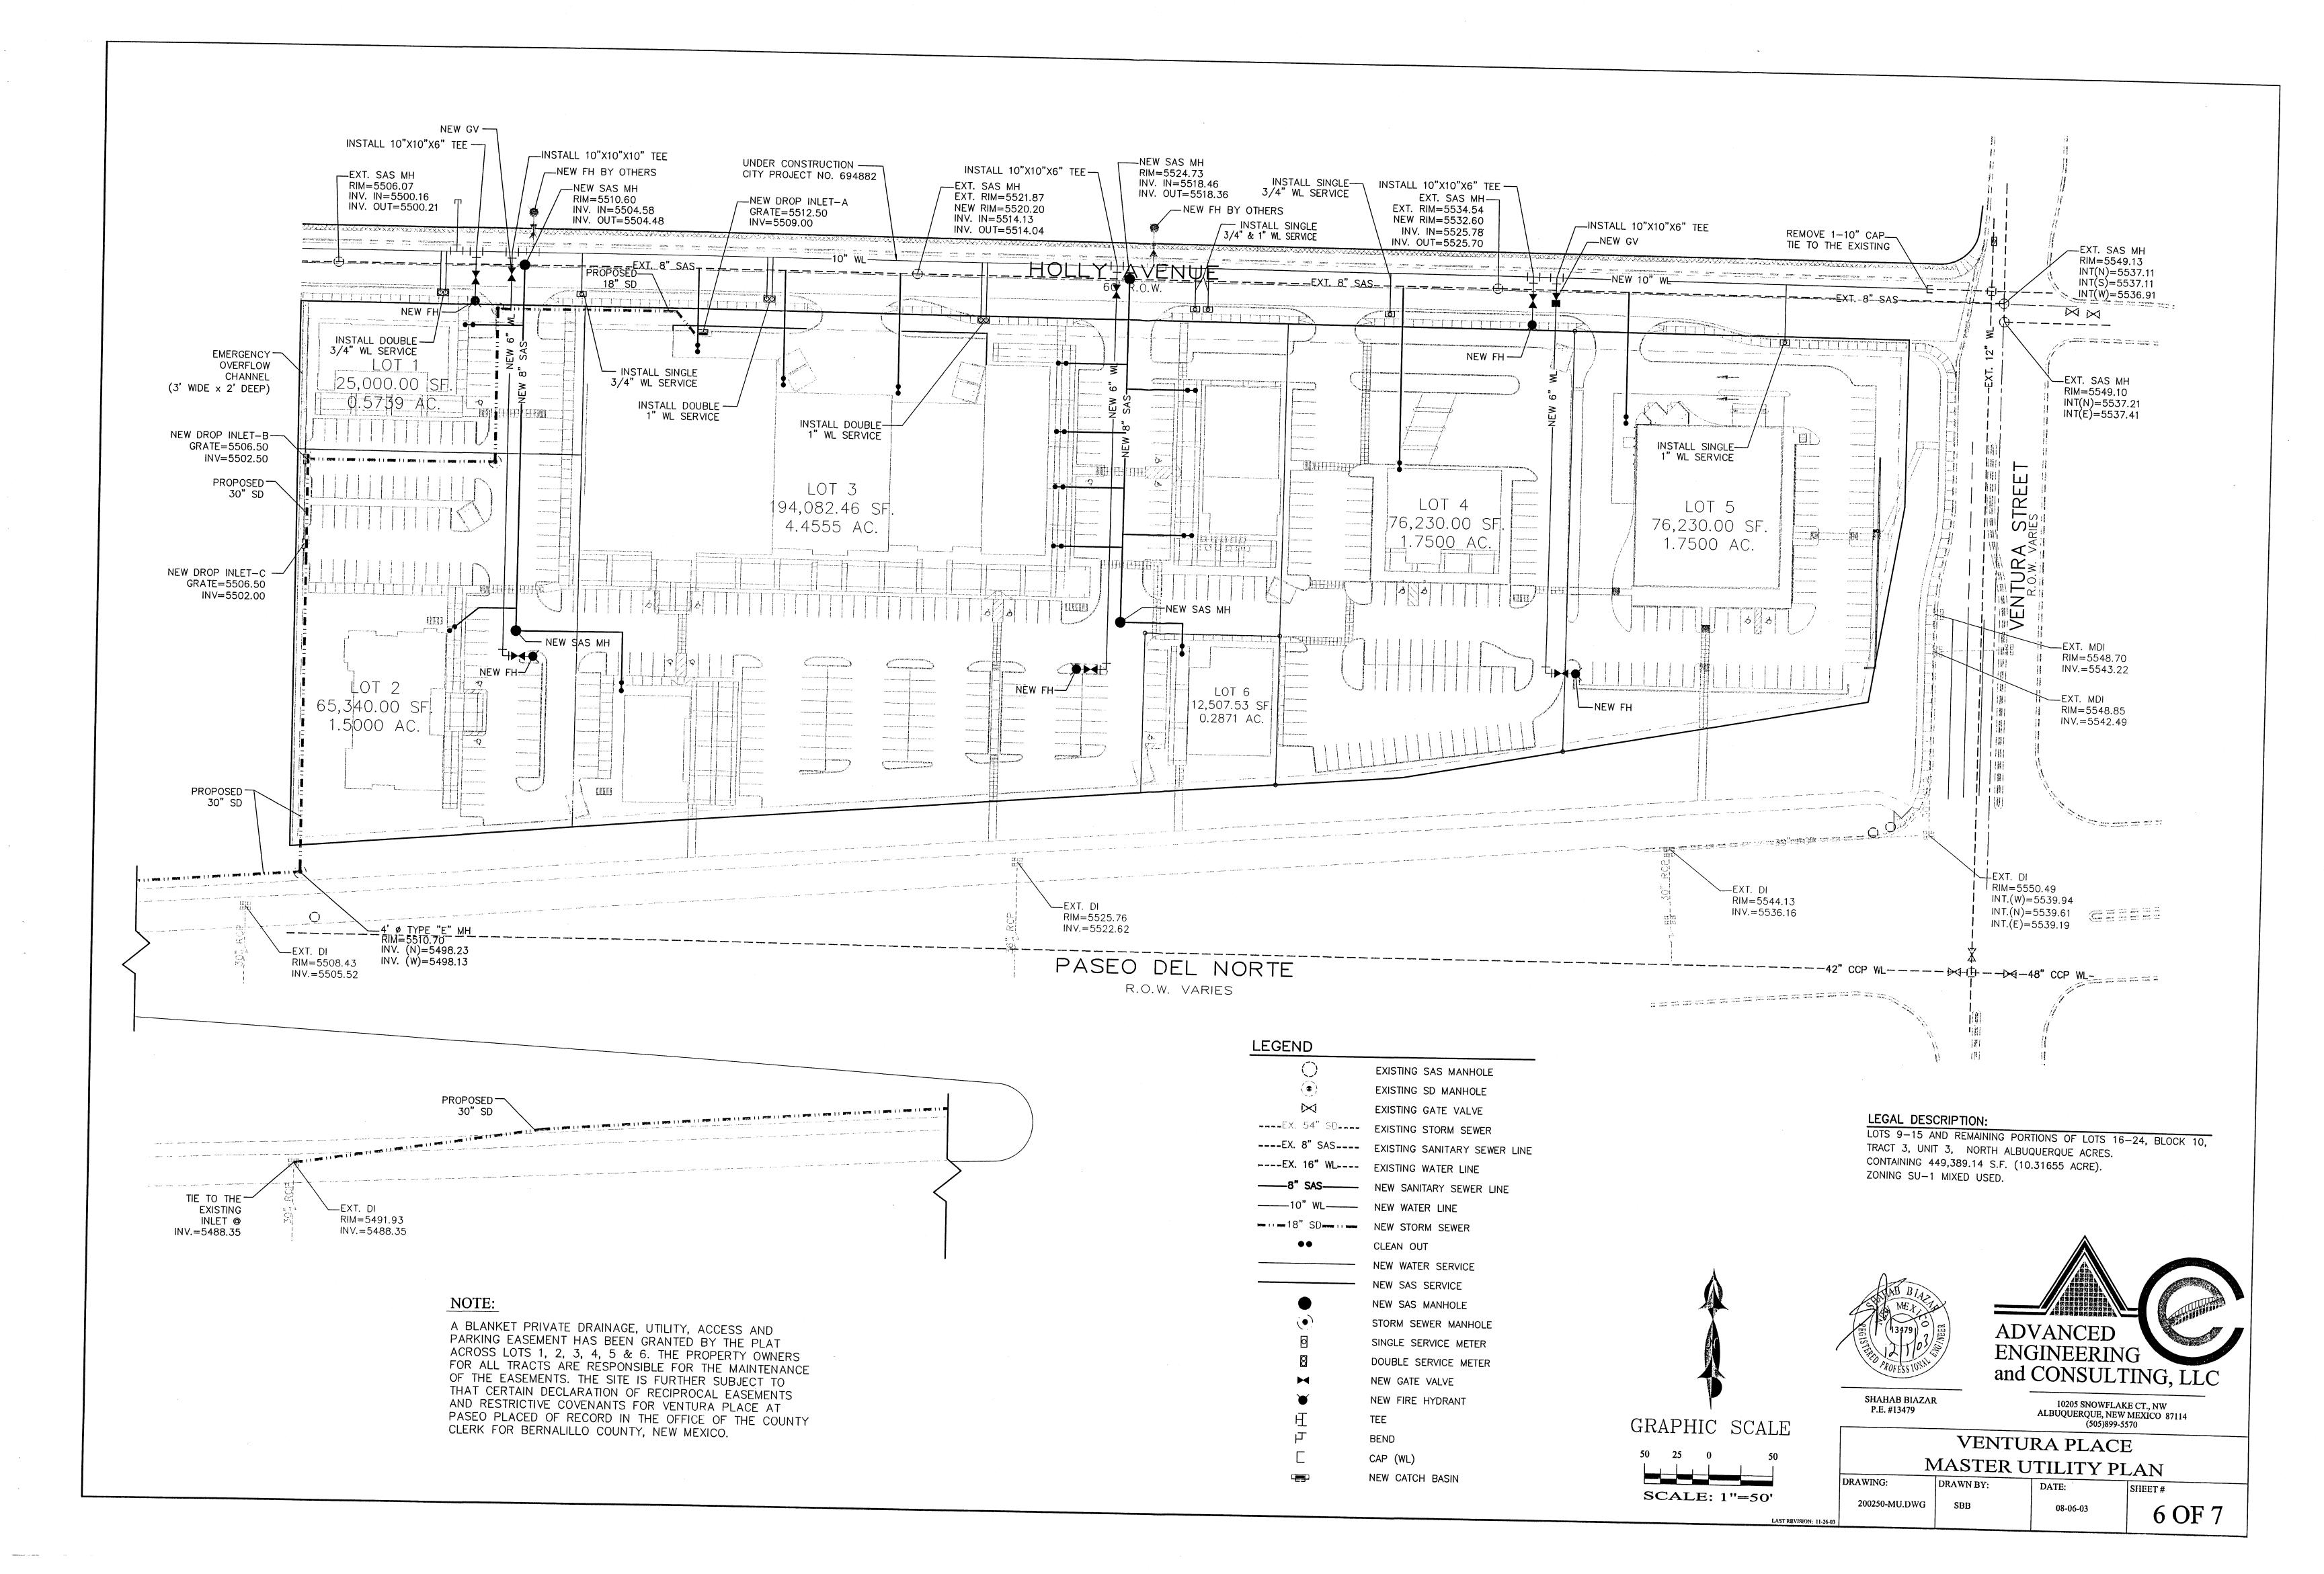


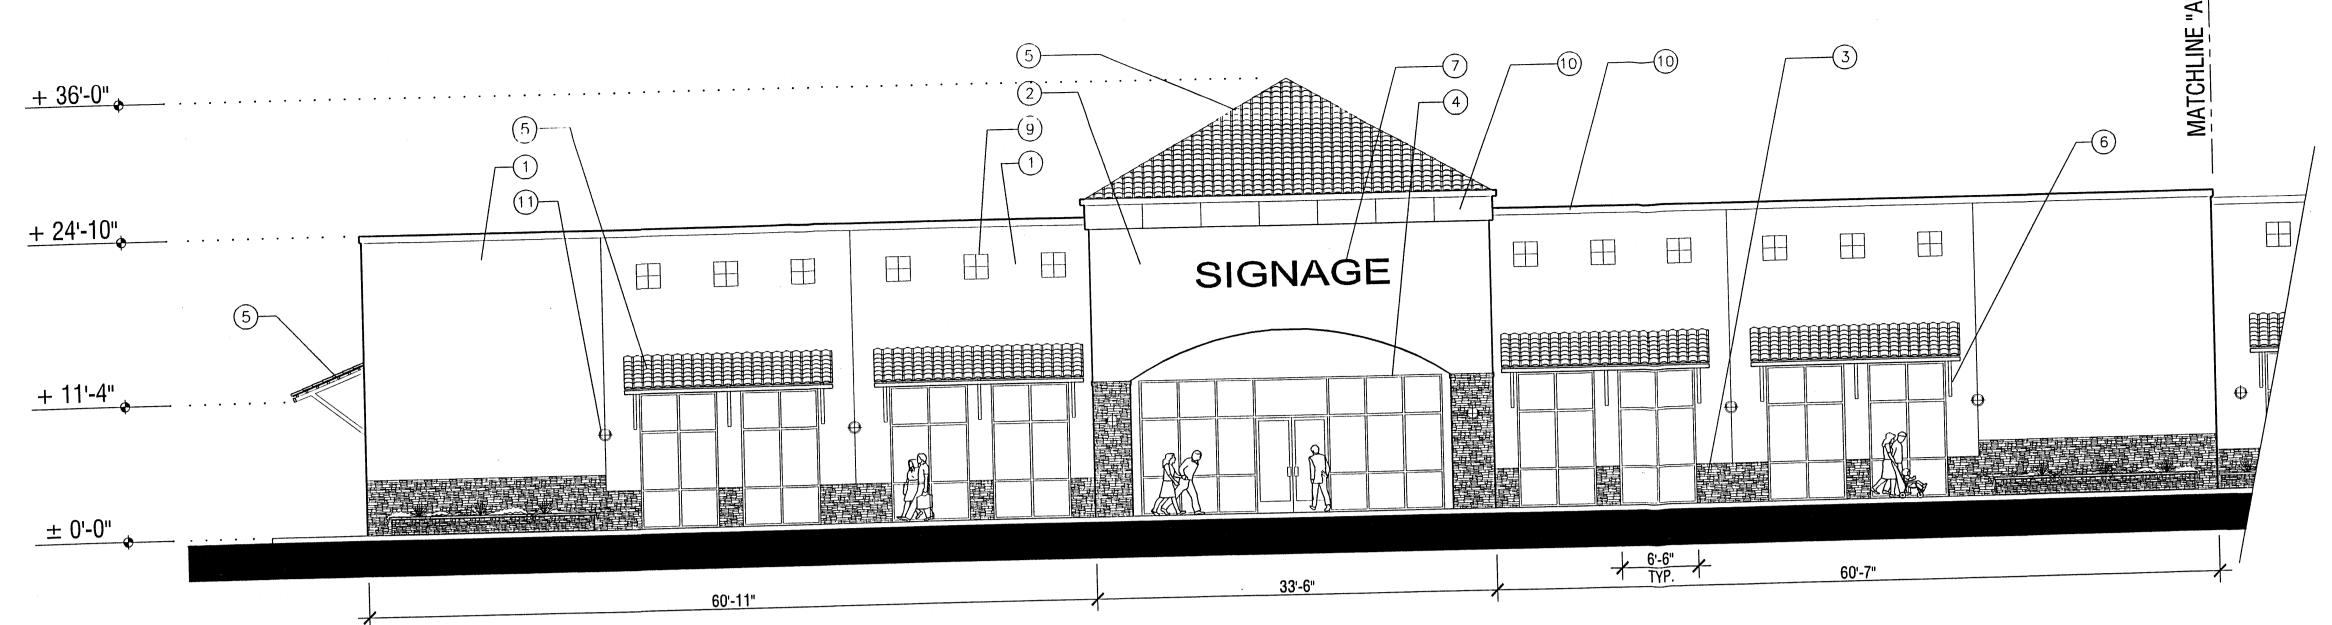

### South Elevation (West End) SCALE: 1/8" = 1'-0"

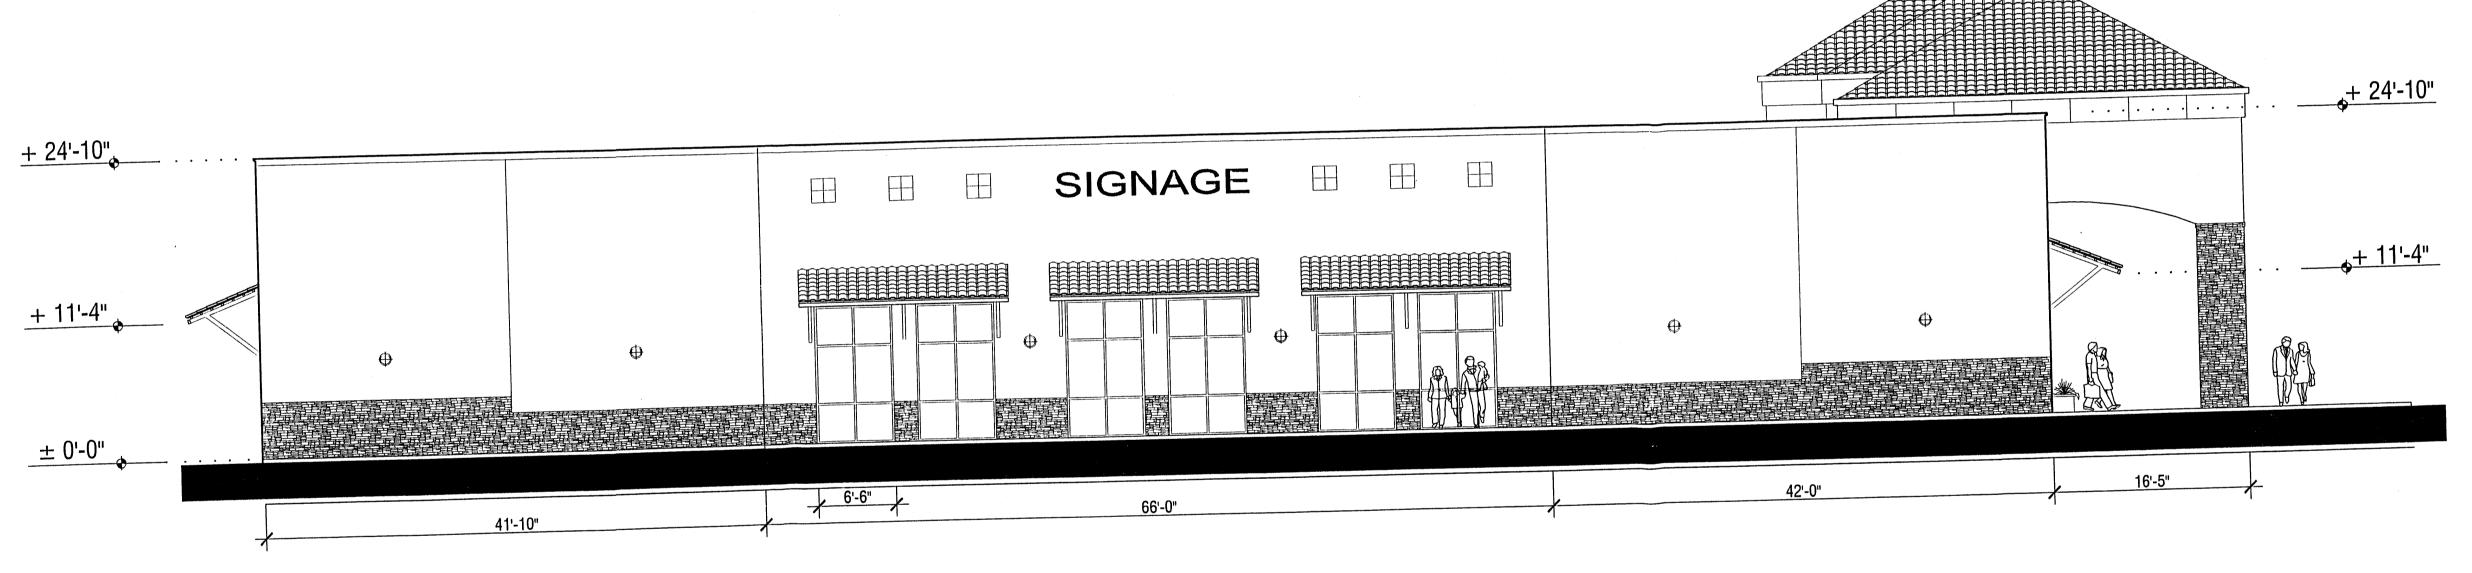


### West Elevation

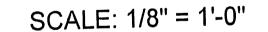



### North Elevation (West End)

SCALE: 1/8" = 1'-0"

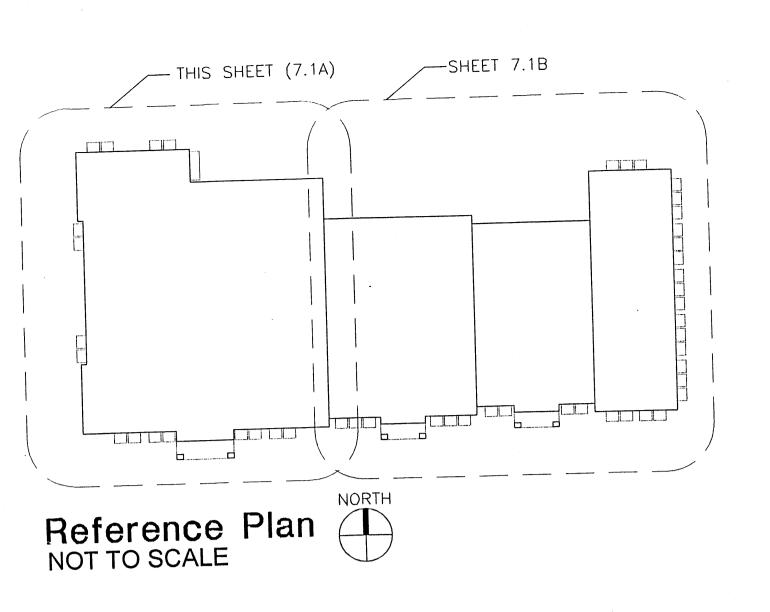

## Anchor Building (West End)

## Elevations for Site Development Plan for Building Permit

### DRAWING SCALE: 1/8" = 1' - 0"

75 WATTS EACH

<u>+ 36'-0"</u>

### KEYED NOTES (TYPICAL AT ALL ELEVATIONS):

- ACRYLIC STUCCO, LIGHT TAN TO MATCH BENJAMIN MOORE HC-6 ACRYLIC STUCCO, MEDIUM TAN TO MATCH BENJAMIN MOORE HC-55 STONE VENEER BY CULTURED STONE SHALE PRO-FIT LEDGE STONE PF #8601 ALUMINUM STOREFRONT WINDOW SYSTEM, FRAME COLOR TO MATCH BENJAMIN
- MOURE 1055
  CONCRETE ROOF TILE BY MONIER/LIFETILE, MISSION 'S' VILLA— COLOR 3601
  TUBE STEEL AWNING FRAME PAINT MEDIUM TAN TO MATCH BENJAMIN MOORE HC-55
  BACK LIT SIGNAGE, INDIVIDUAL LETTERS (24" MAXIMUM)
  BACK LIT SIGNAGE, INDIVIDUAL LETTERS (16" MAXIMUM)
  CERAMIC TILE ACCENT, FOUR 12"x12" TILES, CROSS AMERICANA SERIES
  AV 114 GRAND CANYON
- 9" CORNICE, PAINTED TO MATCH WINDOWS SURFACE-MOUNTED ACCENT LIGHTING, ALUMINUM AND GLASS, 12" DIAMETER,


## Ventura Place

Briscoe Architects, p.c.


ALBUQUERQUE, NEW MEXICO

4100 Menaul Boulevard NE, Suite 2B Albuquerque, New Mexico F: 505.881.9114

AUGUST 7, 2003

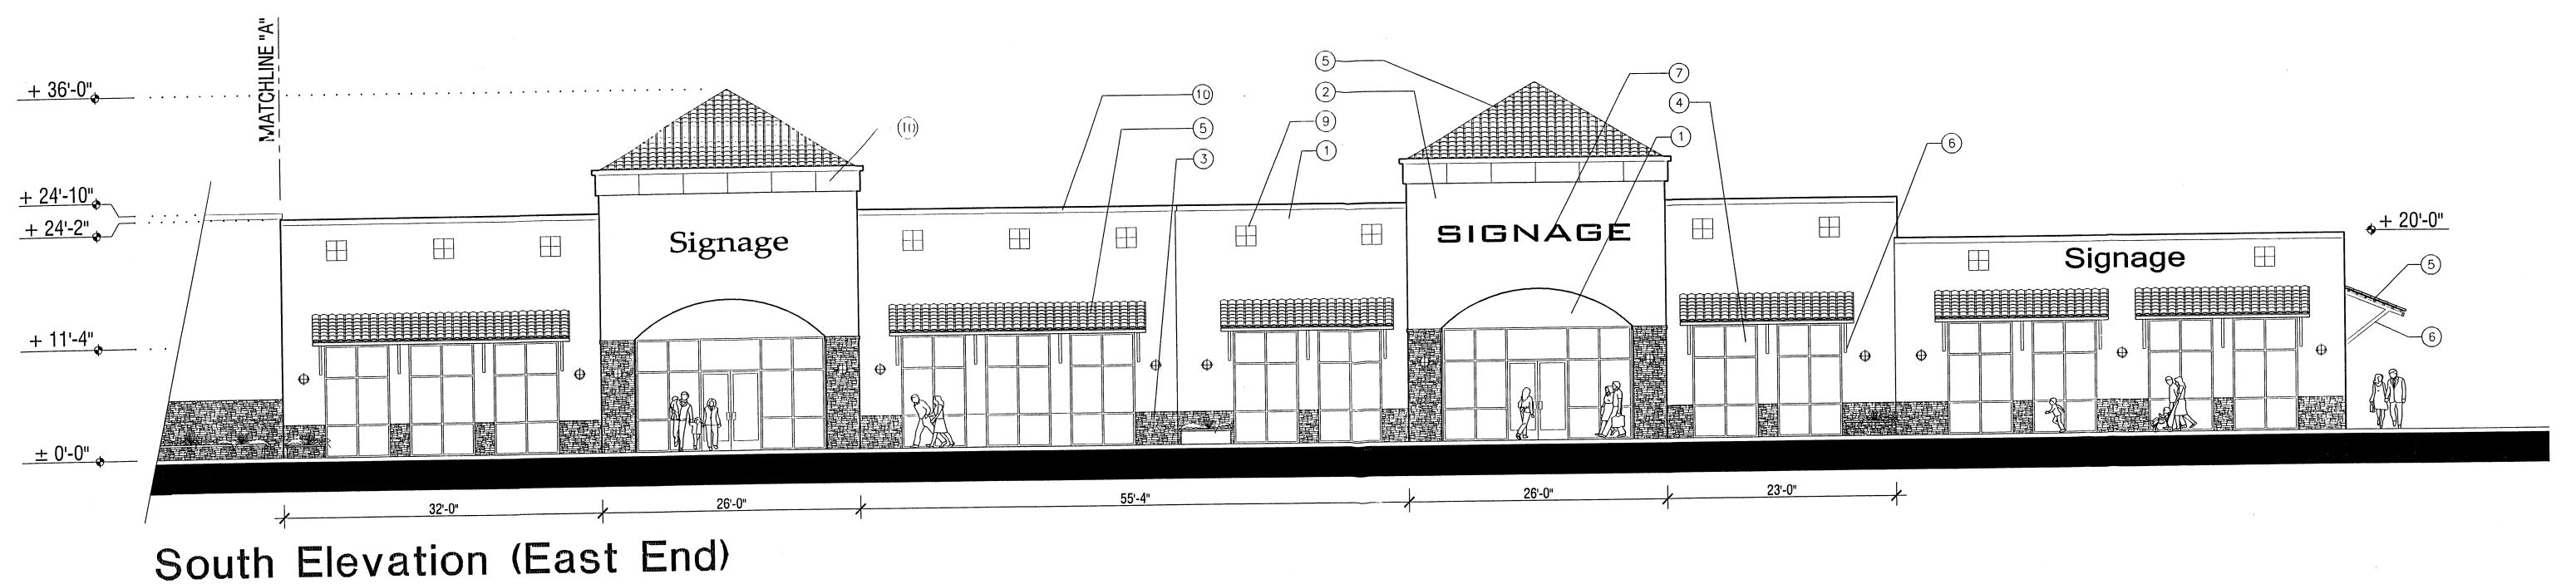



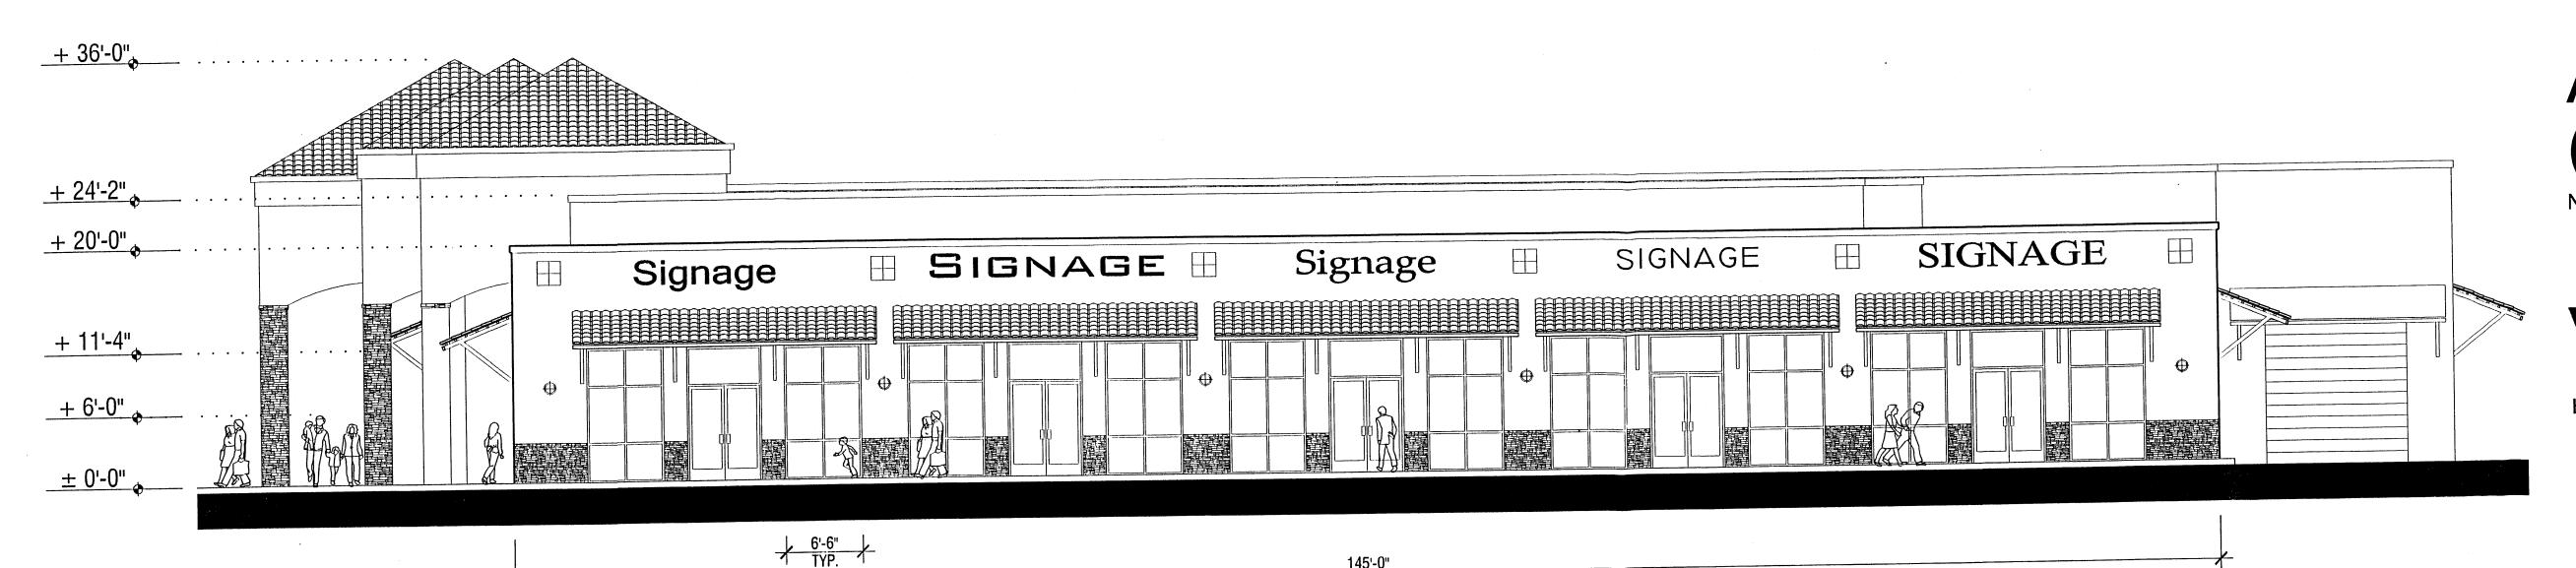

### East Elevation

SCALE: 1/8" = 1'-0"

## Anchor Building (East End)


NOTE: SEE SHEET 7.1A FOR KEYED NOTES AND REFERENCE PLAN.


## Ventura Place

HOLLY BOULEVARD AT VENTURA BOULEVARD AND PASEO DEL NORTE ALBUQUERQUE, NEW MEXICO

Briscoe Architects, p.c.


AUGUST 7, 2003

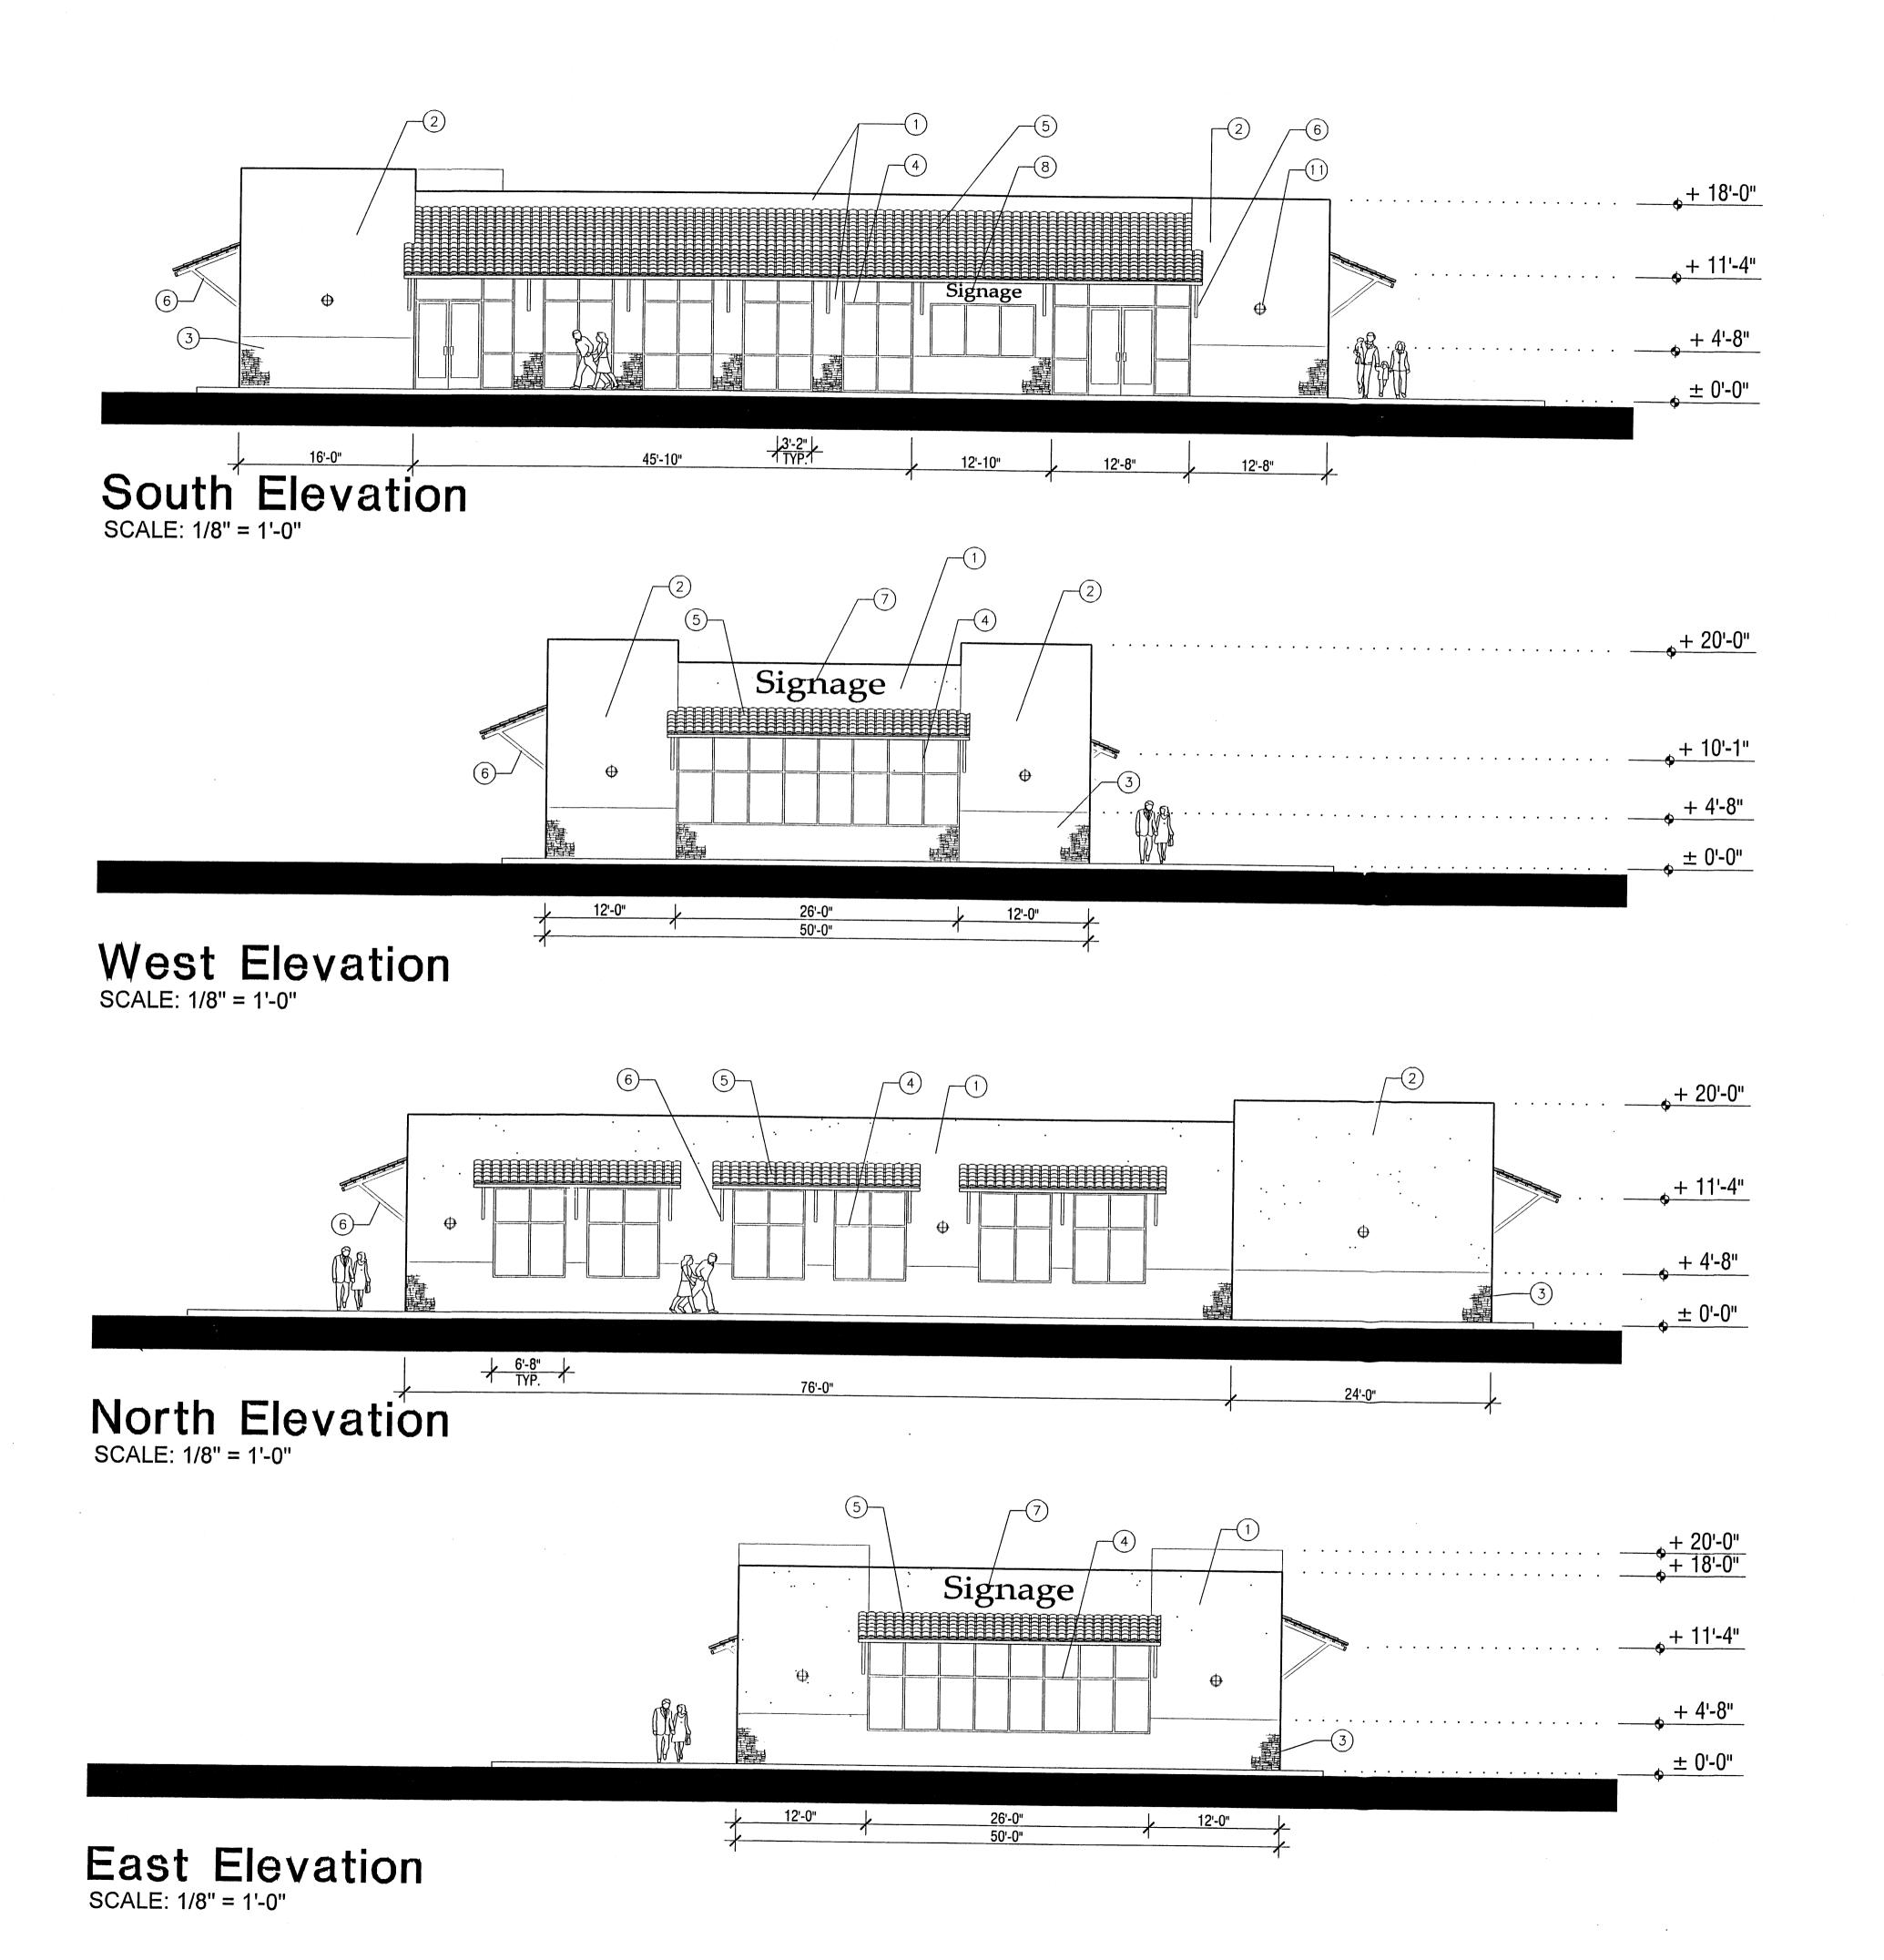

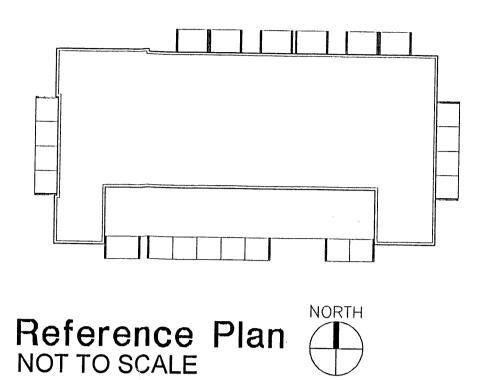

## Office Building

Elevations for Site Development Plan for Building Permit

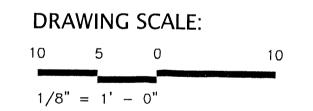

### KEYED NOTES (TYPICAL AT ALL ELEVATIONS):

ACRYLIC STUCCO, LIGHT TAN TO MATCH BENJAMIN MOORE HC-6
 ACRYLIC STUCCO, MEDIUM TAN TO MATCH BENJAMIN MOORE HC-55
 STONE VENEER BY CULTURED STONE SHALE PRO-FIT LEDGE STONE PF #8601
 ALUMINUM STOREFRONT WINDOW SYSTEM, FRAME COLOR TO MATCH BENJAMIN BENJAMIN MOORE HC-1055
 CONCRETE ROOF TILE BY MONIER/LIFETILE, MISSION 'S' VILLA- COLOR 3601
 TUBE STEEL AWNING FRAME - PAINT MEDIUM TAN TO MATCH BENJAMIN MOORE HC-55
 BACK LIT SIGNAGE, INDIVIDUAL LETTERS (24" MAXIMUM)
 BACK LIT SIGNAGE, INDIVIDUAL LETTERS (16" MAXIMUM)
 CERAMIC TILE ACCENT, FOUR 12"x12" TILES, CROSS AMERICANA SERIES AV 114 GRAND CANYON
 9" CORNICE, PAINTED TO MATCH WINDOWS
 SURFACE-MOUNTED ACCENT LIGHTING, ALUMINUM AND GLASS, 12" DIAMETER, 75 WATTS EACH


## Ventura Place HOLLY BOULEVARD AT VENTURA BOULEVARD AND PASEO DEL NORTE ALBUQUERQUE, NEW MEXICO


Briscoe Architects, p.c.

4100 Menaul Boulevard NE, Suite 2B Albuquerque, New Mexi
V: 505.262.0193 F: 505.881.9114 E: brisco

AUGUST 7, 2003

SHEET NO.

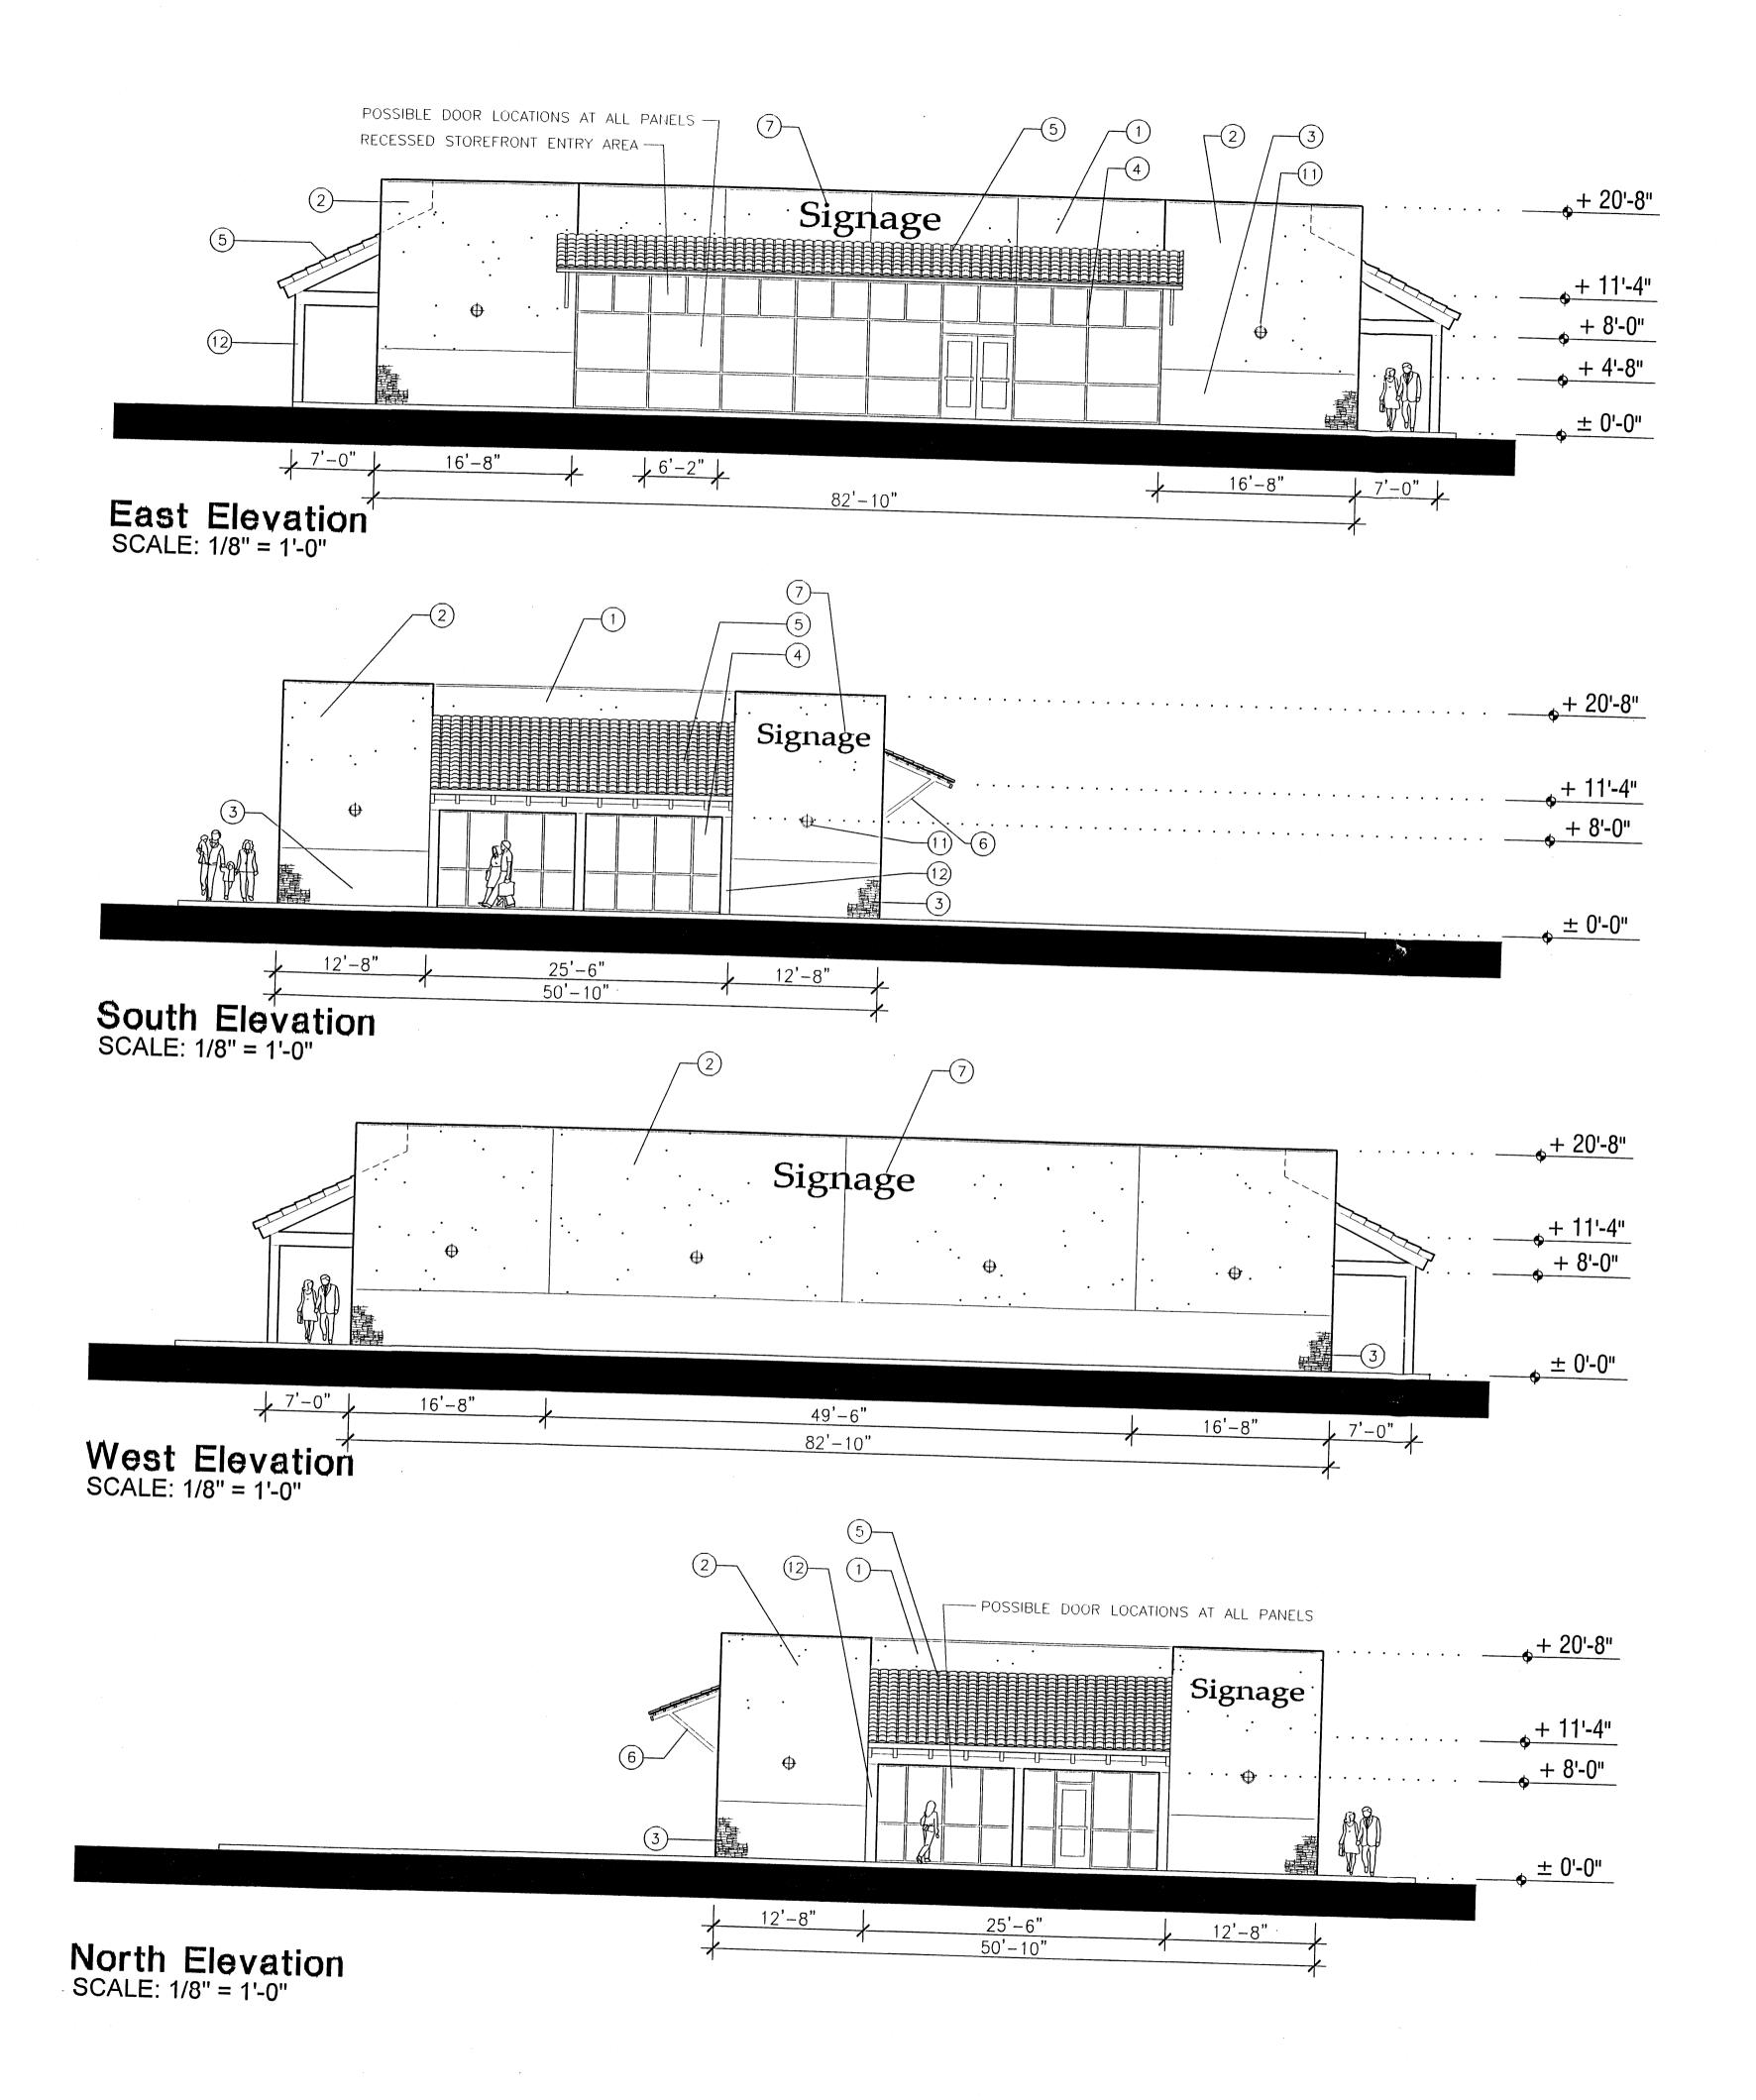

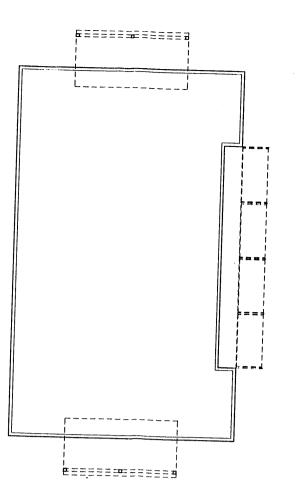

## Restaurant/ Retail Building

Elevations for Site Development Plan for Building Permit

DRAWING SCALE: 1/8" = 1' - 0"

### KEYED NOTES (TYPICAL AT ALL ELEVATIONS):

- ACRYLIC STUCCO, LIGHT TAN TO MATCH BENJAMIN MOORE HC-6

  ACRYLIC STUCCO, MEDIUM TAN TO MATCH BENJAMIN MOORE HC-55

  STONE VENEER BY CULTURED STONE SHALE PRO-FIT LEDGE STONE PF #8601

  ALUMINUM STOREFRONT WINDOW SYSTEM, FRAME COLOR TO MATCH BENJAMIN

  BENJAMIN MOORE HC-1055

  CONCRETE ROOF TILE BY MONIER/LIFETILE, MISSION 'S' VILLA— COLOR 3601

  TUBE STEEL AWNING FRAME PAINT MEDIUM TAN TO MATCH BENJAMIN MOORE HC-55

  BACK LIT SIGNAGE, INDIVIDUAL LETTERS (24" MAXIMUM)

  BACK LIT SIGNAGE, INDIVIDUAL LETTERS (16" MAXIMUM)

  CERAMIC TILE ACCENT, FOUR 12"x12" TILES, CROSS AMERICANA SERIES

  AV 114 GRAND CANYON

  O "CORNICE, PAINTED TO MATCH WINDOWS

  SURFACE—MOUNTED ACCENT LIGHTING, ALUMINUM AND GLASS, 12" DIAMETER,


- 12. TUBE STEEL, PAINTED FINISH: MEDIUM TAN TO MATCH BENJAMIN MOORE HC-55


### Ventura Place ALBUQUERQUE, NEW MEXICO

Briscoe Architects, p.c. 4100 Menaul Boulevard NE, Suite 2B Albuquerque, New Mexico 87110 V: 505.262.0193 F: 505.881.9114

AUGUST 7, 2003

SHEET NO.

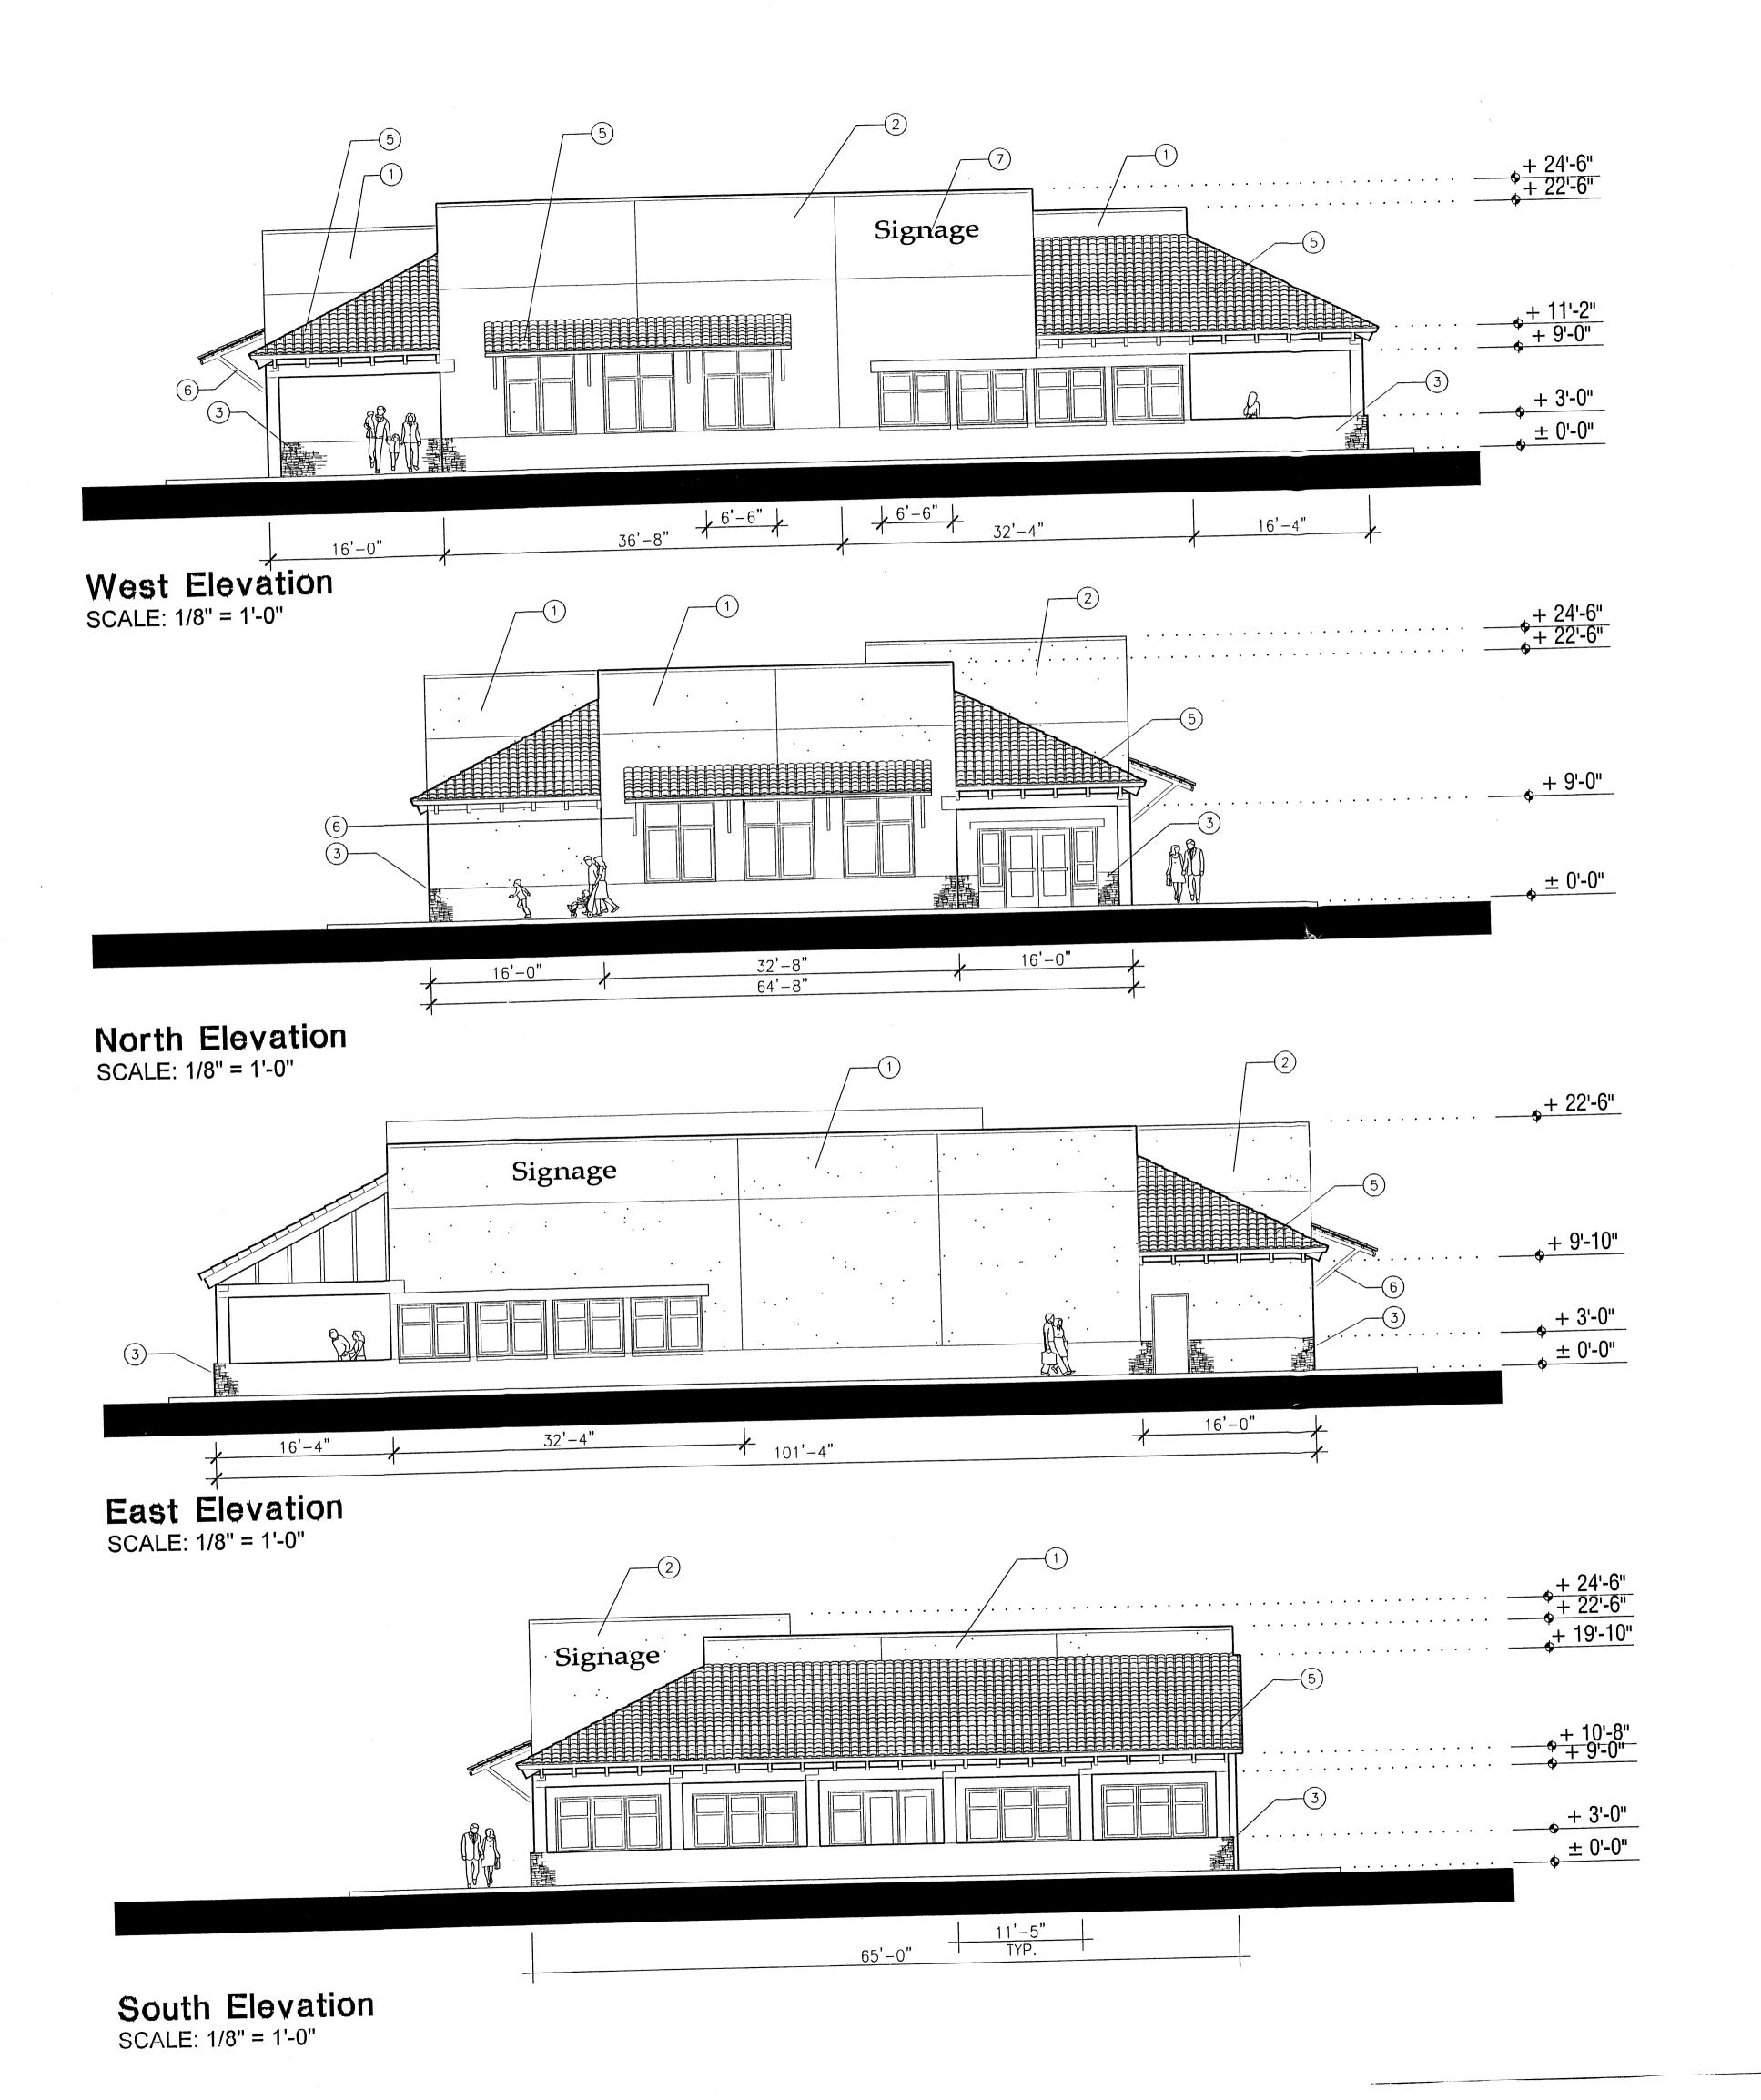

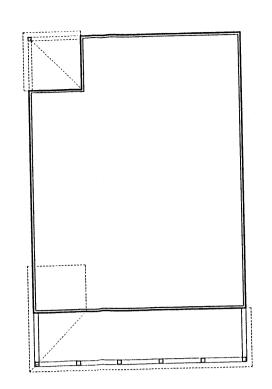

### Restaurant

Elevations for Site Development Plan for Building Permit

DRAWING SCALE:

1/8" = 1' - 0"

### KEYED NOTES (TYPICAL AT ALL ELEVATIONS):

- ACRYLIC STUCCO, LIGHT TAN TO MATCH BENJAMIN MOORE HC-6
  ACRYLIC STUCCO, MEDIUM TAN TO MATCH BENJAMIN MOORE HC-55
  STONE VENEER BY CULTURED STONE SHALE PRO-FIT LEDGE STONE PF #8601
  ALUMINUM STOREFRONT WINDOW SYSTEM, FRAME COLOR TO MATCH BENJAMIN
  BENJAMIN MOORE HC-1055
- BENJAMIN MOORE HC-1055
  CONCRETE ROOF TILE BY MONIER/LIFETILE, MISSION 'S' VILLA- COLOR 3601
  TUBE STEEL AWNING FRAME PAINT MEDIUM TAN TO MATCH BENJAMIN MOORE HC-55
  BACK LIT SIGNAGE, INDIVIDUAL LETTERS (24" MAXIMUM)
  BACK LIT SIGNAGE, INDIVIDUAL LETTERS (16" MAXIMUM)
  CERAMIC TILE ACCENT, FOUR 12"x12" TILES, CROSS AMERICANA SERIES
  AV 114 GRAND CANYON

- 9" CORNICE, PAINTED TO MATCH WINDOWS
  SURFACE-MOUNTED ACCENT LIGHTING, ALUMINUM AND GLASS, 12" DIAMETER,
  75 WATTS EACH


Ventura Place


ALBUQUERQUE, NEW MEXICO


AUGUST 7, 2003


Briscoe Architects, p.c. 4100 Menaul Boulevard NE, Suite 2B Albuquerque, New Mexico 87110 F: 505.881.9114 V: 505.262.0193

SHEET NO.

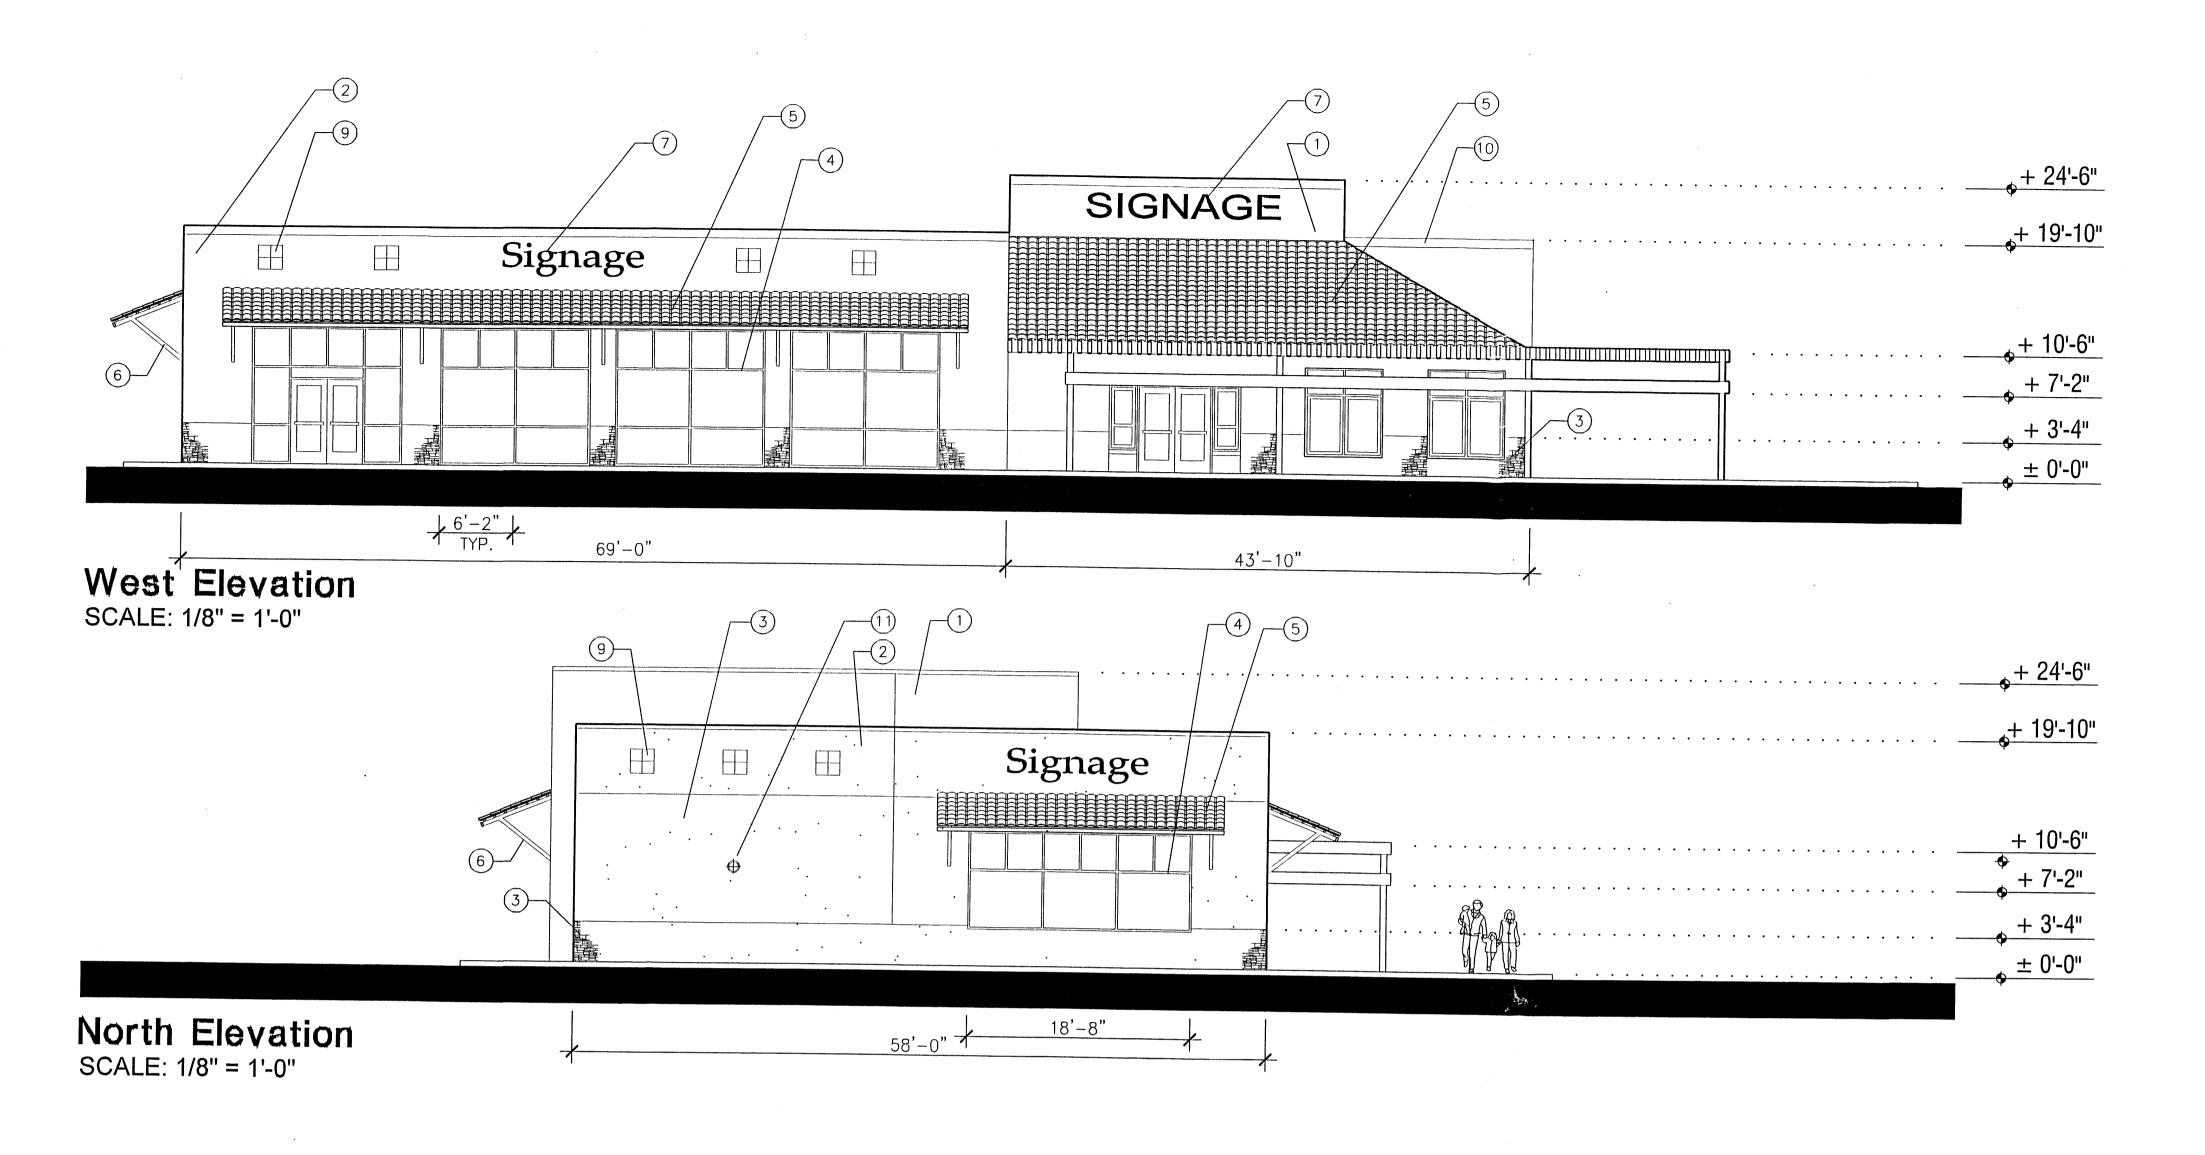

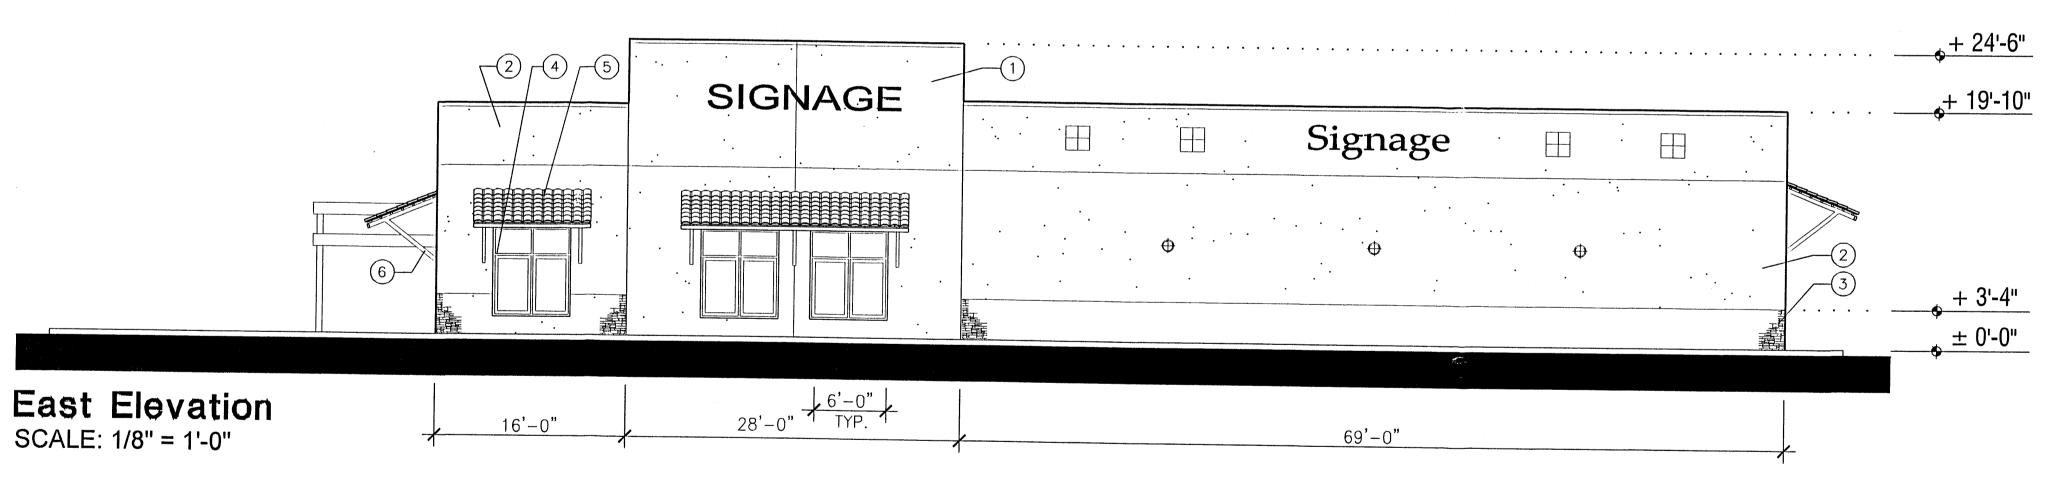


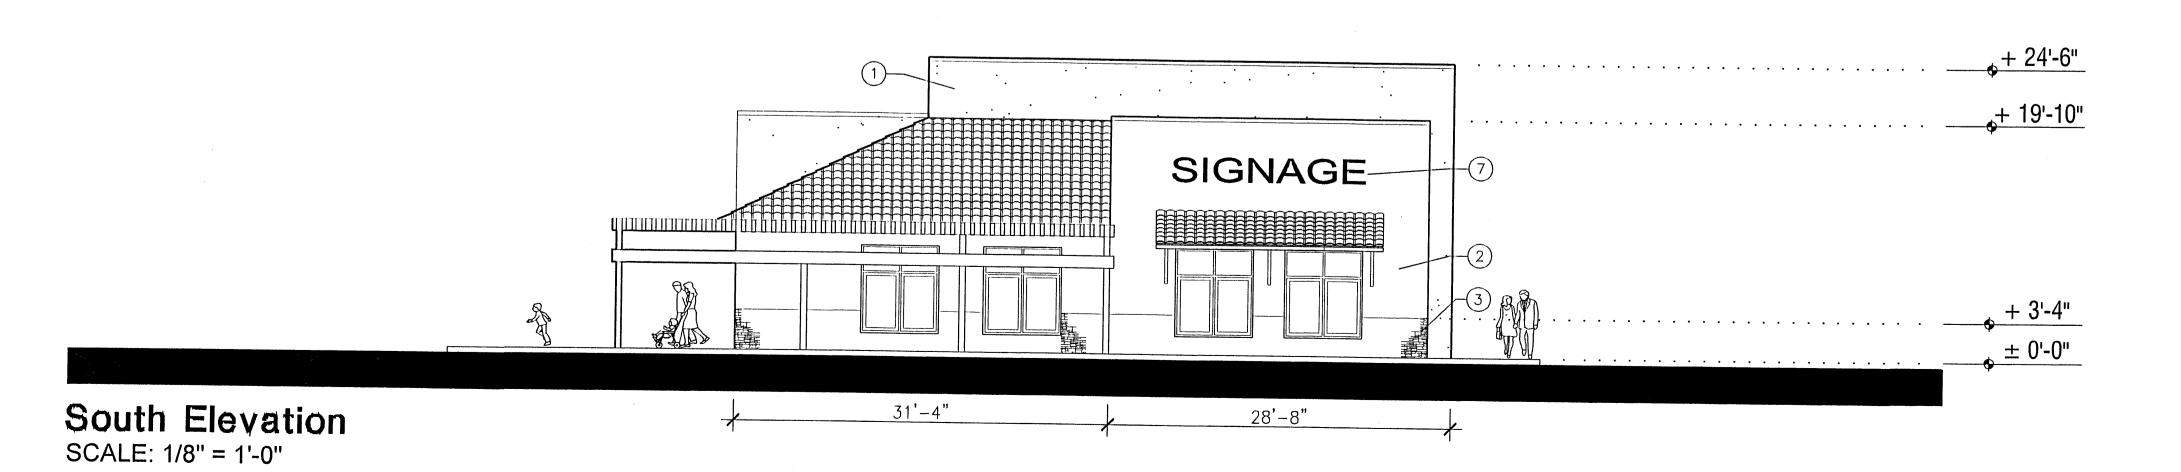

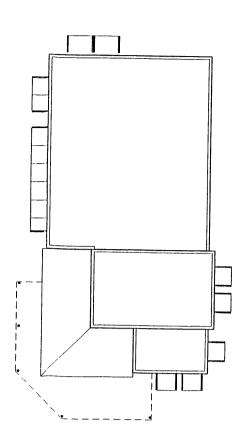

### Dry Cleaner and Retail

Elevations for Site Development Plan for Building Permit

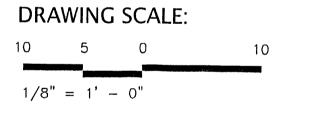

#### KEYED NOTES (TYPICAL AT ALL ELEVATIONS):

ACRYLIC STUCCO, LIGHT TAN TO MATCH BENJAMIN MOORE HC-6
ACRYLIC STUCCO, MEDIUM TAN TO MATCH BENJAMIN MOORE HC-55
STONE VENEER BY CULTURED STONE SHALE PRO-FIT LEDGE STONE PF #8601
ALUMINUM STOREFRONT WINDOW SYSTEM, FRAME COLOR TO MATCH BENJAMIN BENJAMIN MOORE HC-1055
CONCRETE ROOF TILE BY MONIER/LIFETILE, MISSION 'S' VILLA— COLOR 3601
TUBE STEEL AWNING FRAME — PAINT MEDIUM TAN TO MATCH BENJAMIN MOORE HC-55
BACK LIT SIGNAGE, INDIVIDUAL LETTERS (24" MAXIMUM)
BACK LIT SIGNAGE, INDIVIDUAL LETTERS (16" MAXIMUM)
CERAMIC TILE ACCENT, FOUR 12"x12" TILES, CROSS AMERICANA SERIES
AV 114 GRAND CANYON

9" CORNICE, PAINTED TO MATCH WINDOWS
SURFACE—MOUNTED ACCENT LIGHTING, ALUMINUM AND GLASS, 12" DIAMETER,
75 WATTS EACH


## Ventura Place HOLLY BOULEVARD AT VENTURA BOULEVARD AND PASEO DEL NORTE ALBUQUERQUE, NEW MEXICO


Briscoe Architects, p.c.

4100 Menaul Boulevard NE, Suite 2B Albuquerque, New Mexico 87110
V: 505.262.0193 F: 505.881.9114 E: briscoe@msn.com

AUGUST 7, 2003


5HEET NO. **7.5** 

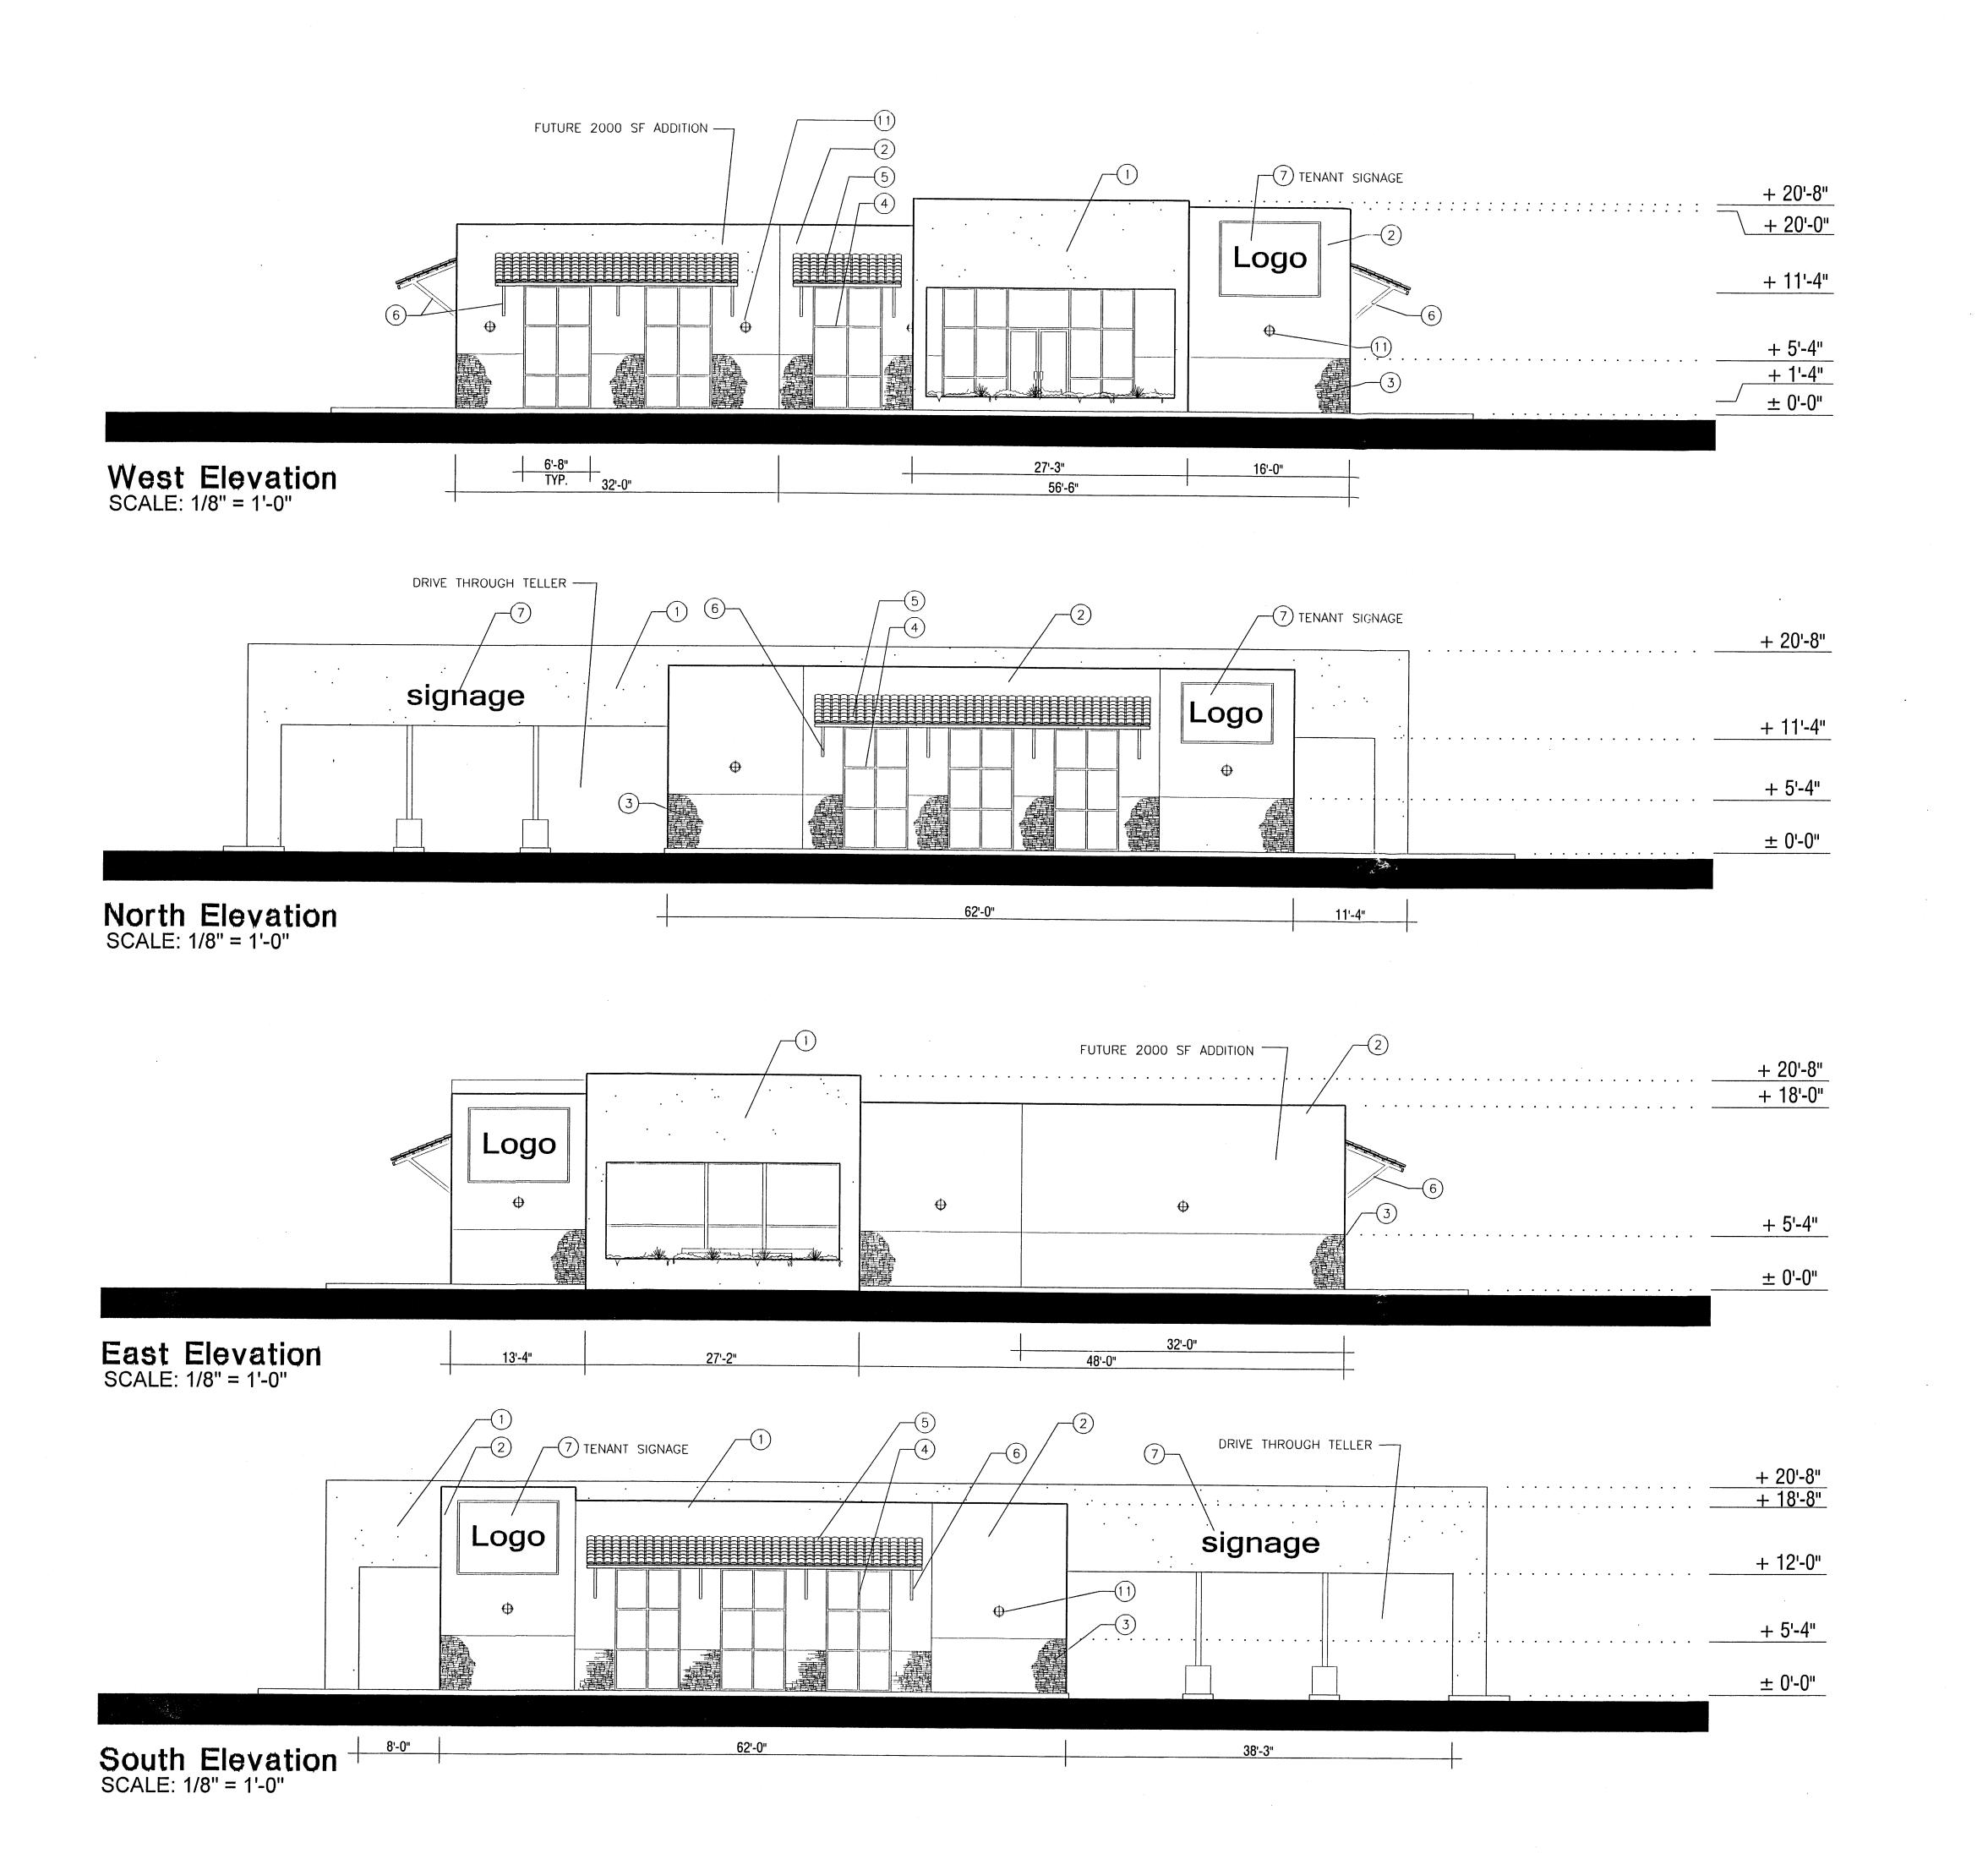

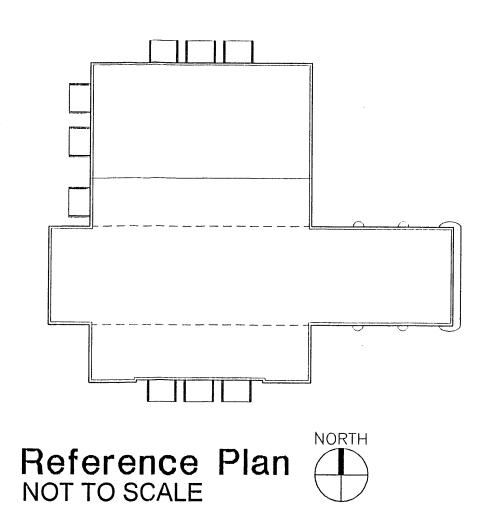

### Bank

Elevations for Site Development Plan for Building Permit

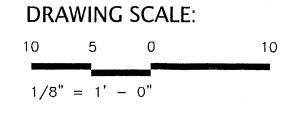

V: 505.262.0193

#### **KEYED NOTES (TYPICAL AT ALL ELEVATIONS):**

. ACRYLIC STUCCO, LIGHT TAN TO MATCH BENJAMIN MOORE HC-6
. ACRYLIC STUCCO, MEDIUM TAN TO MATCH BENJAMIN MOORE HC-55
. STONE VENEER BY CULTURED STONE SHALE PRO-FIT LEDGE STONE PF #8601
. ALUMINUM STOREFRONT WINDOW SYSTEM, FRAME COLOR TO MATCH BENJAMIN BENJAMIN MOORE HC-1055
. CONCRETE ROOF TILE BY MONIER/LIFETILE, MISSION 'S' VILLA- COLOR 3601
. TUBE STEEL AWNING FRAME - PAINT MEDIUM TAN TO MATCH BENJAMIN MOORE HC-55
. BACK LIT SIGNAGE, INDIVIDUAL LETTERS (24" MAXIMUM)
. BACK LIT SIGNAGE, INDIVIDUAL LETTERS (16" MAXIMUM)
. CERAMIC TILE ACCENT, FOUR 12"x12" TILES, CROSS AMERICANA SERIES
AV 114 GRAND CANYON
. 9" CORNICE, PAINTED TO MATCH WINDOWS
. SURFACE-MOUNTED ACCENT LIGHTING, ALUMINUM AND GLASS, 12" DIAMETER,

## Ventura Place HOLLY BOULEVARD AT VENTURA BOULEVARD AND PASEO DEL NORTE ALBUQUERQUE, NEW MEXICO


Briscoe Architects, p.c.

Mengul Boulevard NF. Suite 2B Albuquerque New Mey


F: 505.881.9114

AUGUST 7, 2003


7.6

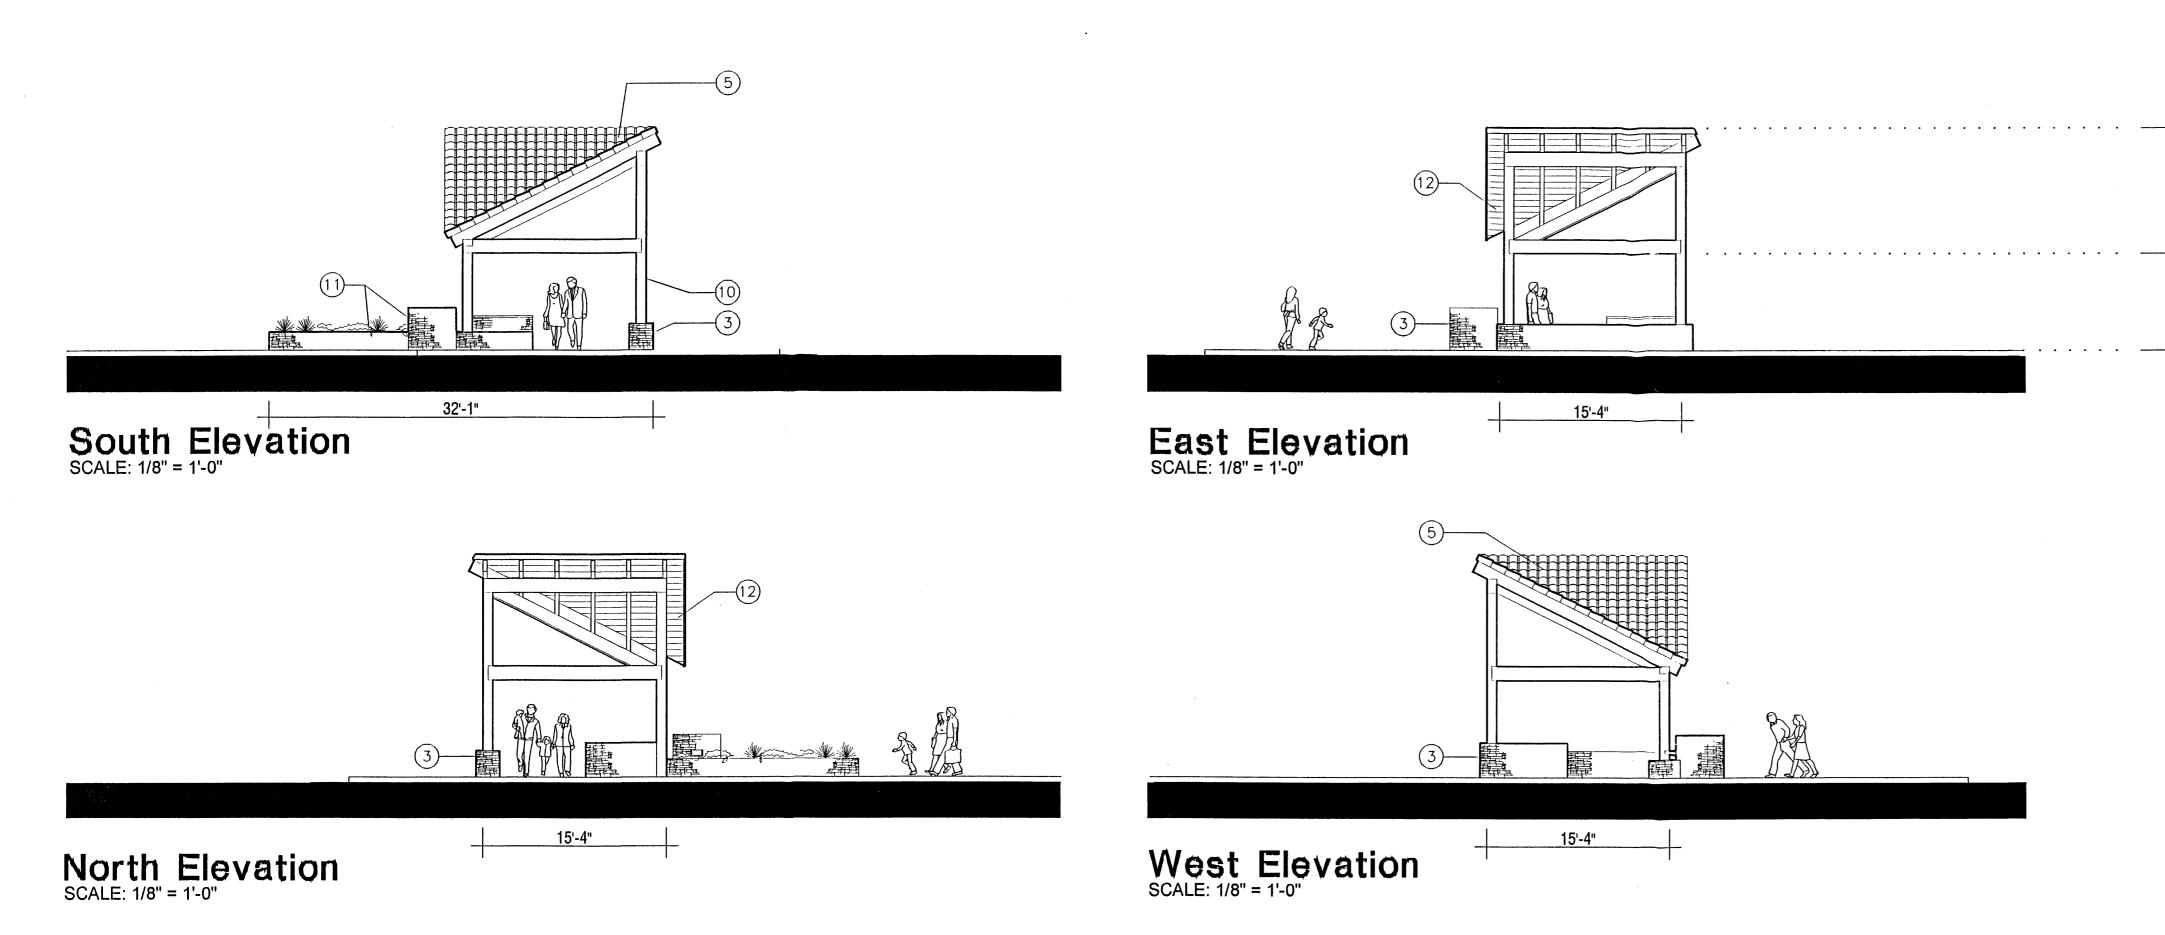

### Public Activities Pavilion

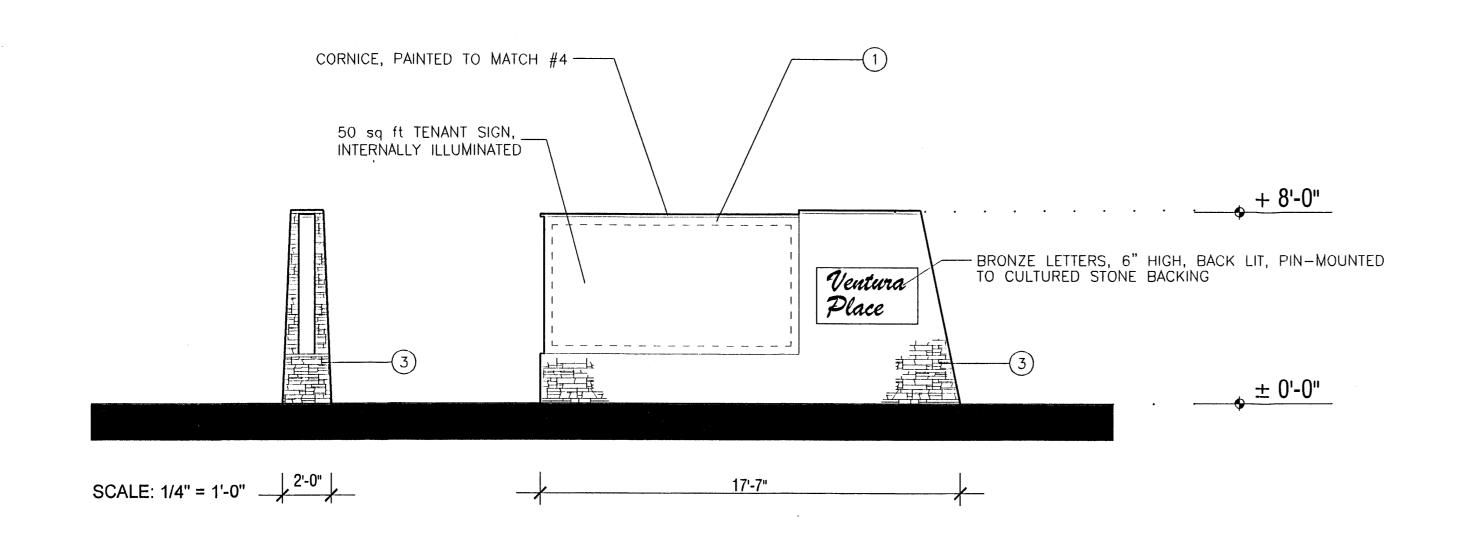

TYPICAL AT ALL LOCATIONS, EXCEPT THAT SIGN AT WEST ENTRY FROM HOLLY IS LIMITED TO 6' HEIGHT AND WITHOUT INTERNAL ILLUMINATION

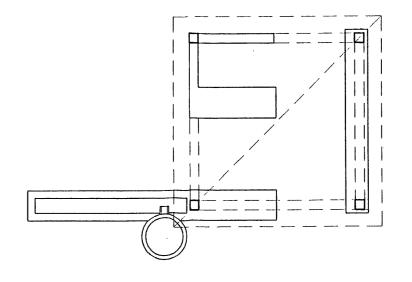

Reference Plan NOT TO SCALE

### Public Activities Pavilion and Monument Signage

Elevations for Site Development Plan for Building Permit



1/8" = 1' - 0"

#### **KEYED NOTES (TYPICAL AT ALL ELEVATIONS):**

- ACRYLIC STUCCO, LIGHT TAN TO MATCH BENJAMIN MOORE HC-6 ACRYLIC STUCCO, MEDIUM TAN TO MATCH BENJAMIN MOORE HC-55
- STONE VENEER BY CULTURED STONE SHALE PRO-FIT LEDGE STONE PF #8601 ALUMINUM STOREFRONT WINDOW SYSTEM, FRAME COLOR TO MATCH BENJAMIN
- BENJAMIN MOORE HC-1055
- CONCRETE ROOF TILE BY MONIER/LIFETILE, MISSION 'S' VILLA- COLOR 3601 TUBE STEEL AWNING FRAME - PAINT MEDIUM TAN TO MATCH BENJAMIN MOORE HC-55
- BACK LIT SIGNAGE, INDIVIDUAL LETTERS (24" MAXIMUM)
  BACK LIT SIGNAGE, INDIVIDUAL LETTERS (16" MAXIMUM)
  CERAMIC TILE ACCENT, FOUR 12"x12" TILES, CROSS AMERICANA SERIES
- AV 114 GRAND CANYON
- 9" CORNICE, PAINTED TO MATCH WINDOWS
- SURFACE-MOUNTED ACCENT LIGHTING, ALUMINUM AND GLASS, 12" DIAMETER,
- 12. TONGUE AND GROOVE, MEDIUM TAN TO MATCH BENJAMIN MOORE HC-55


### Ventura Place HOLLY BOULEVARD AT VENTURA BOULEVARD AND PASEO DEL NORTE ALBUQUERQUE, NEW MEXICO

Briscoe Architects, p.c.

AUGUST 7, 2003

4100 Menaul Boulevard NE, Suite 2B Albuquerque, New Mexico 87110 V: 505.262.0193 F: 505.881.9114



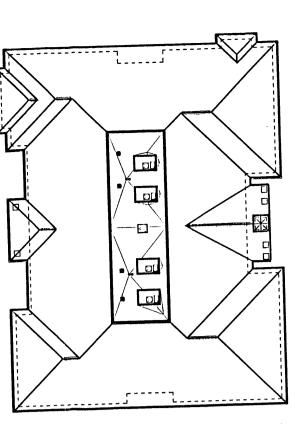

## Day Care Elevations

# Elevations for Site Development Plan for Building Permit

DRAWING SCALE:

### KEYED NOTES (TYPICAL AT ALL ELEVATIONS):

ACRYLIC STUCCO, LIGHT TAN TO MATCH BENJAMIN MOORE HC-6
ACRYLIC STUCCO, MEDIUM TAN TO MATCH BENJAMIN MOORE HC-55
STONE VENEER BY CULTURED STONE SHALE PRO-FIT LEDGE STONE PF #8601
ALUMINUM STOREFRONT WINDOW SYSTEM, FRAME COLOR TO MATCH BENJAMIN
BENJAMIN MOORE HC-1055 BENJAMIN MOORE HC-1055
CONCRETE ROOF TILE BY MONIER/LIFETILE, MISSION 'S' VILLA— COLOR 3601
CONCRETE ROOF TILE BY MONIER/LIFETILE, MISSION 'S' VILLA— COLOR 3601
TUBE STEEL AWNING FRAME — PAINT MEDIUM TAN TO MATCH BENJAMIN MOORE HC-55
TUBE STEEL AWNING FRAME — PAINT MEDIUM TAN TO MATCH MINDOWS
BACK LIT SIGNAGE, INDIVIDUAL LETTERS (16" MAXIMUM)
CERAMIC TILE ACCENT, FOUR 12"x12" TILES, CROSS AMERICANA SERIES
AV 114 GRAND CANYON 9" CORNICE, PAINTED TO MATCH WINDOWS SURFACE-MOUNTED ACCENT LIGHTING, ALUMINUM AND GLASS, 12" DIAMETER,

75 WATTS EACH

### KEYED NOTES (DAY CARE ONLY):

ALUMINUM GUTTER - COLOR: OLIVE TO MATCH BENJAMIN MOORE HC-1055 DOWNSPOUT TIED INTO STORM DRAIN SYSTEM - COLOR: OLIVE TO MATCH BENJAMIN WOOD TRIM — COLOR: OLIVE TO MATCH BENJAMIN MOORE HC-1055
FLAT ROOF BEHIND FOR MECHANICAL EQUIPMENT
ROOF TOP MECHANICAL UNIT (RTU)
DRINKING FOUNTAIN MOUNTED 36" A.F.F. MAX TO BUBBLIER ROOF DRAIN OVERFLOW OUTLET VINYL DOUBLE HUNG WINDOW (CLEAR TEMPERED GLASS). FRAME COLOR: OLIVE TO MATCH BENJAMIN MOORE HC-1055

## Ventura Place ALBUQUERQUE, NEW MEXICO

Briscoe Architects, p.c.

V: 505.262.0193

AUGUST 7, 2003

SHEET NO