

PROJECT DATA - ZONING

LEGAL DESCRIPTION: 2129 AND 2131 LEAD AVENUE SE LOT(S) 12, BLOCK(S) 3 BUENA VISTA HEIGHTS ADDITION ZONE ATLAS PAGE K-15-Z

ZONE DESIGNATION: SU-2/JC UNIVERSITY NEIGHBORHOODS SECTOR DEV. PLAN

LOT AREA= +/-14,200 SF (33 ACRES)

OFFSTREET PARKING: UNITS < 1000 SF = 15 SPACES EACH REQUIRED APARTMENTS 1, 2 AND 3 AT +/-400 SF = 45 SPACES

NEW RESIDENCE AT +/-1500 SF AND 2 BATHROOMS = 2 SPACES

NON-RESIDENTIAL = 1:300 SF = 2174 SF/300 = 7.2 SPACES

10% REDUCTION IN REQUIRED SPACES FOR PROXIMITY TO BUS LINE = 13.71-1.31 SPACES 13.7 - 1.31 = 12.39

TOTAL PARKING SPACES REQUIRED / PROVIDED = 13 (INCL 1 VAN ACCESSIBLE) AN ADDITIONAL 2 MOTORCYCLE SPACES ARE PROVIDED

NOTE: ALL EXISTING PARKING TO BE ASPHALT OR EQUAL

PROJECT DATA - LANDSCAPING

DESCRIPTION OF WORK: LANDSCAPING AREAS SHOWN ARE APPROXIMATE. SEE LANDSCAPE PLAN FOR PLANTING TYPES AND EXTENT

OPEN SPACE= REQUIREMENTS: 300 SF PER DWELLING UNIT WITH 2 OR MORE BEDS = 300 * 5 UNITS = 1500 SQ FT OPEN SPACE REQUIRED +/-2,226 SQ FT PROVIDED (SEE LANDSCAPE PLAN)

GENERAL NOTES - SITE

PERMITS AND CODES: CONTRACTOR RESPONSIBLE FOR ALL STATE AND LOCAL PERMITS AND SUBMITTALS REQUIRED. THIS INCLUDES BUT IS NOT LIMITED TO STRUCTURAL, ELECTRICAL, MECHANICAL, AND UTILITY HOOK-UPS. CONTRACTOR IS RESPONSIBLE FOR FOLLOWING GUIDELINES SET FORTH IN THE CURRENT ADOPTED EDITION OF THE INTERNATIONAL CODE COUNCIL (ICC) FAMILY OF CODES, APPLICABLE PORTIONS OF THE CURRENT ACCESSIBILITY CODES AND ALL APPLICABLE LOCAL CODES.

ELECTRICAL WIRING METHODS AND MATERIALS SHALL MEET THE PROVISIONS OF THE NATIONAL ELECTRICAL CODE AND NEW MEXICO ELECTRICAL CODE AND OTHER APPLICABLE CODES OR STANDARDS.

PLUMBING SHALL MEET ALL PROVISIONS OF THE UNIFORM PLUMBING CODE, UNIFORM MECHANICAL CODE, AND THE NEW MEXICO PLUMBING AND MECHANICAL CODE AND OTHER APPLICABLE CODES OR STANDARDS.

IF THERE ARE ANY CONFLICTS BETWEEN INFORMATION PROVIDED IN THESE DOCUMENTS, THE ARCHITECT IS TO BE NOTIFIED IMMEDIATELY.

OPTIONS AND MODIFICATIONS: ANY MODIFICATIONS AND CHANGES SHOULD BE REVIEWED BY THE ARCHITECT. NO STRUCTURAL CHANGES SHALL BE MADE WITHOUT THE WRITTEN CONSENT OF THE ARCHITECT.

CONCRETE & STEM WALLS: ALL CONCRETE TO BE MINIMUM 3000 PSI.

SITE: FINISHED FLOOR OR TOP OF STEM WALL TO BE MINIMUM 6" ABOVE ADJACENT GRADE

CARE SHOULD BE TAKEN TO MINIMIZE DAMAGE TO EXISTING TREES, GRADES, AND FOLIAGE AROUND BUILDING FOOTPRINT. SITE TO BE KEPT CLEAN AND SAFE AT ALL TIMES. TRASH IS TO BE CONTAINED AND HAULED OFF WEEKLY. RECYCLE AS MUCH SCRAP AND PACKAGING AS POSSIBLE.

COMPACT EARTH AROUND HOUSE AFTER COMPLETION OF STEM WALL AND RE-GRADE AROUND HOUSE TO ENHANCE FREE DRAINAGE AWAY FROM BUILDING, MINIMUM 1/4" SLOPE PER FOOT FOR 10'-0". MAINTAIN POSITIVE DRAINAGE DURING ENTIRE CONSTRUCTION PROCESS. FINAL GRADING TO BE PROPERLY SLOPED AND RAKED CLEAN. MAINTAIN 1/8" PER FOOT MIN SLOPE FROM BUILDING AT PAVED SURFACES ADJACENT TO BUILDING

PROVIDE SPLASH BLOCKS BELOW CANALES OR DRAIN PIPES TO DIRECT WATER AWAY FROM FOUNDATIONS


DO NOT PLACE PLANTS REQUIRING HEAVY IRRIGATION NEXT TO THE BUILDING-AVOID FRENCH DRAINS ADJACENT TO THE FOUNDATION TO MINIMIZE WATER INFILTRATION AT THE FOUNDATION LEVEL. IF RETENTION BASINS, PLANTERS AND/OR LANDSCAPING ARE ADJACENT TO OR NEAR THE STRUCTURE, SUCH FEATURES SHOULD BE SEALED AND CONTAIN SHALLOW ROOTED LANDSCAPING. GRADES IN BASINS OR PLANTERS SHOULD SLOPE AWAY FROM THE STRUCTURE AND OUTLETS PROVIDED FOR OVERFLOW

PROVIDE FREE-DRAINING SOIL LAYER AT BACK OF RETAINING WALLS. TIE VERTICAL DRAINAGE ZONE TO DAYLIT GRAVITY DRAINAGE SYSTEM AT BASE OF WALL

CONTRACTOR IS RESPONSIBLE FOR ALL UTILITY HOOK-UPS TO THE BUILDINGS. THIS INCLUDES WATER, ELECTRICITY, PHONE LINES (BFR MIN.), & CABLE TV.


EXTERIOR LIGHTING SHOULD BE SCREENED 15 DEG FROM HORIZON TO MINIMIZE NIGHT SKY POLLUTION.

AS A CONDITION OF SUBSTANTIAL COMPLETION, THE CONTRACTOR SHALL CLEAN UP THE SITE, DELIVER ALL GUARANTEES, LIEN WAIVERS, MAINTENANCE MANUALS, AND PROJECT RECORDS, AND SHALL FURNISH A CERTIFICATE OF OCCUPANCY TO THE OWNER

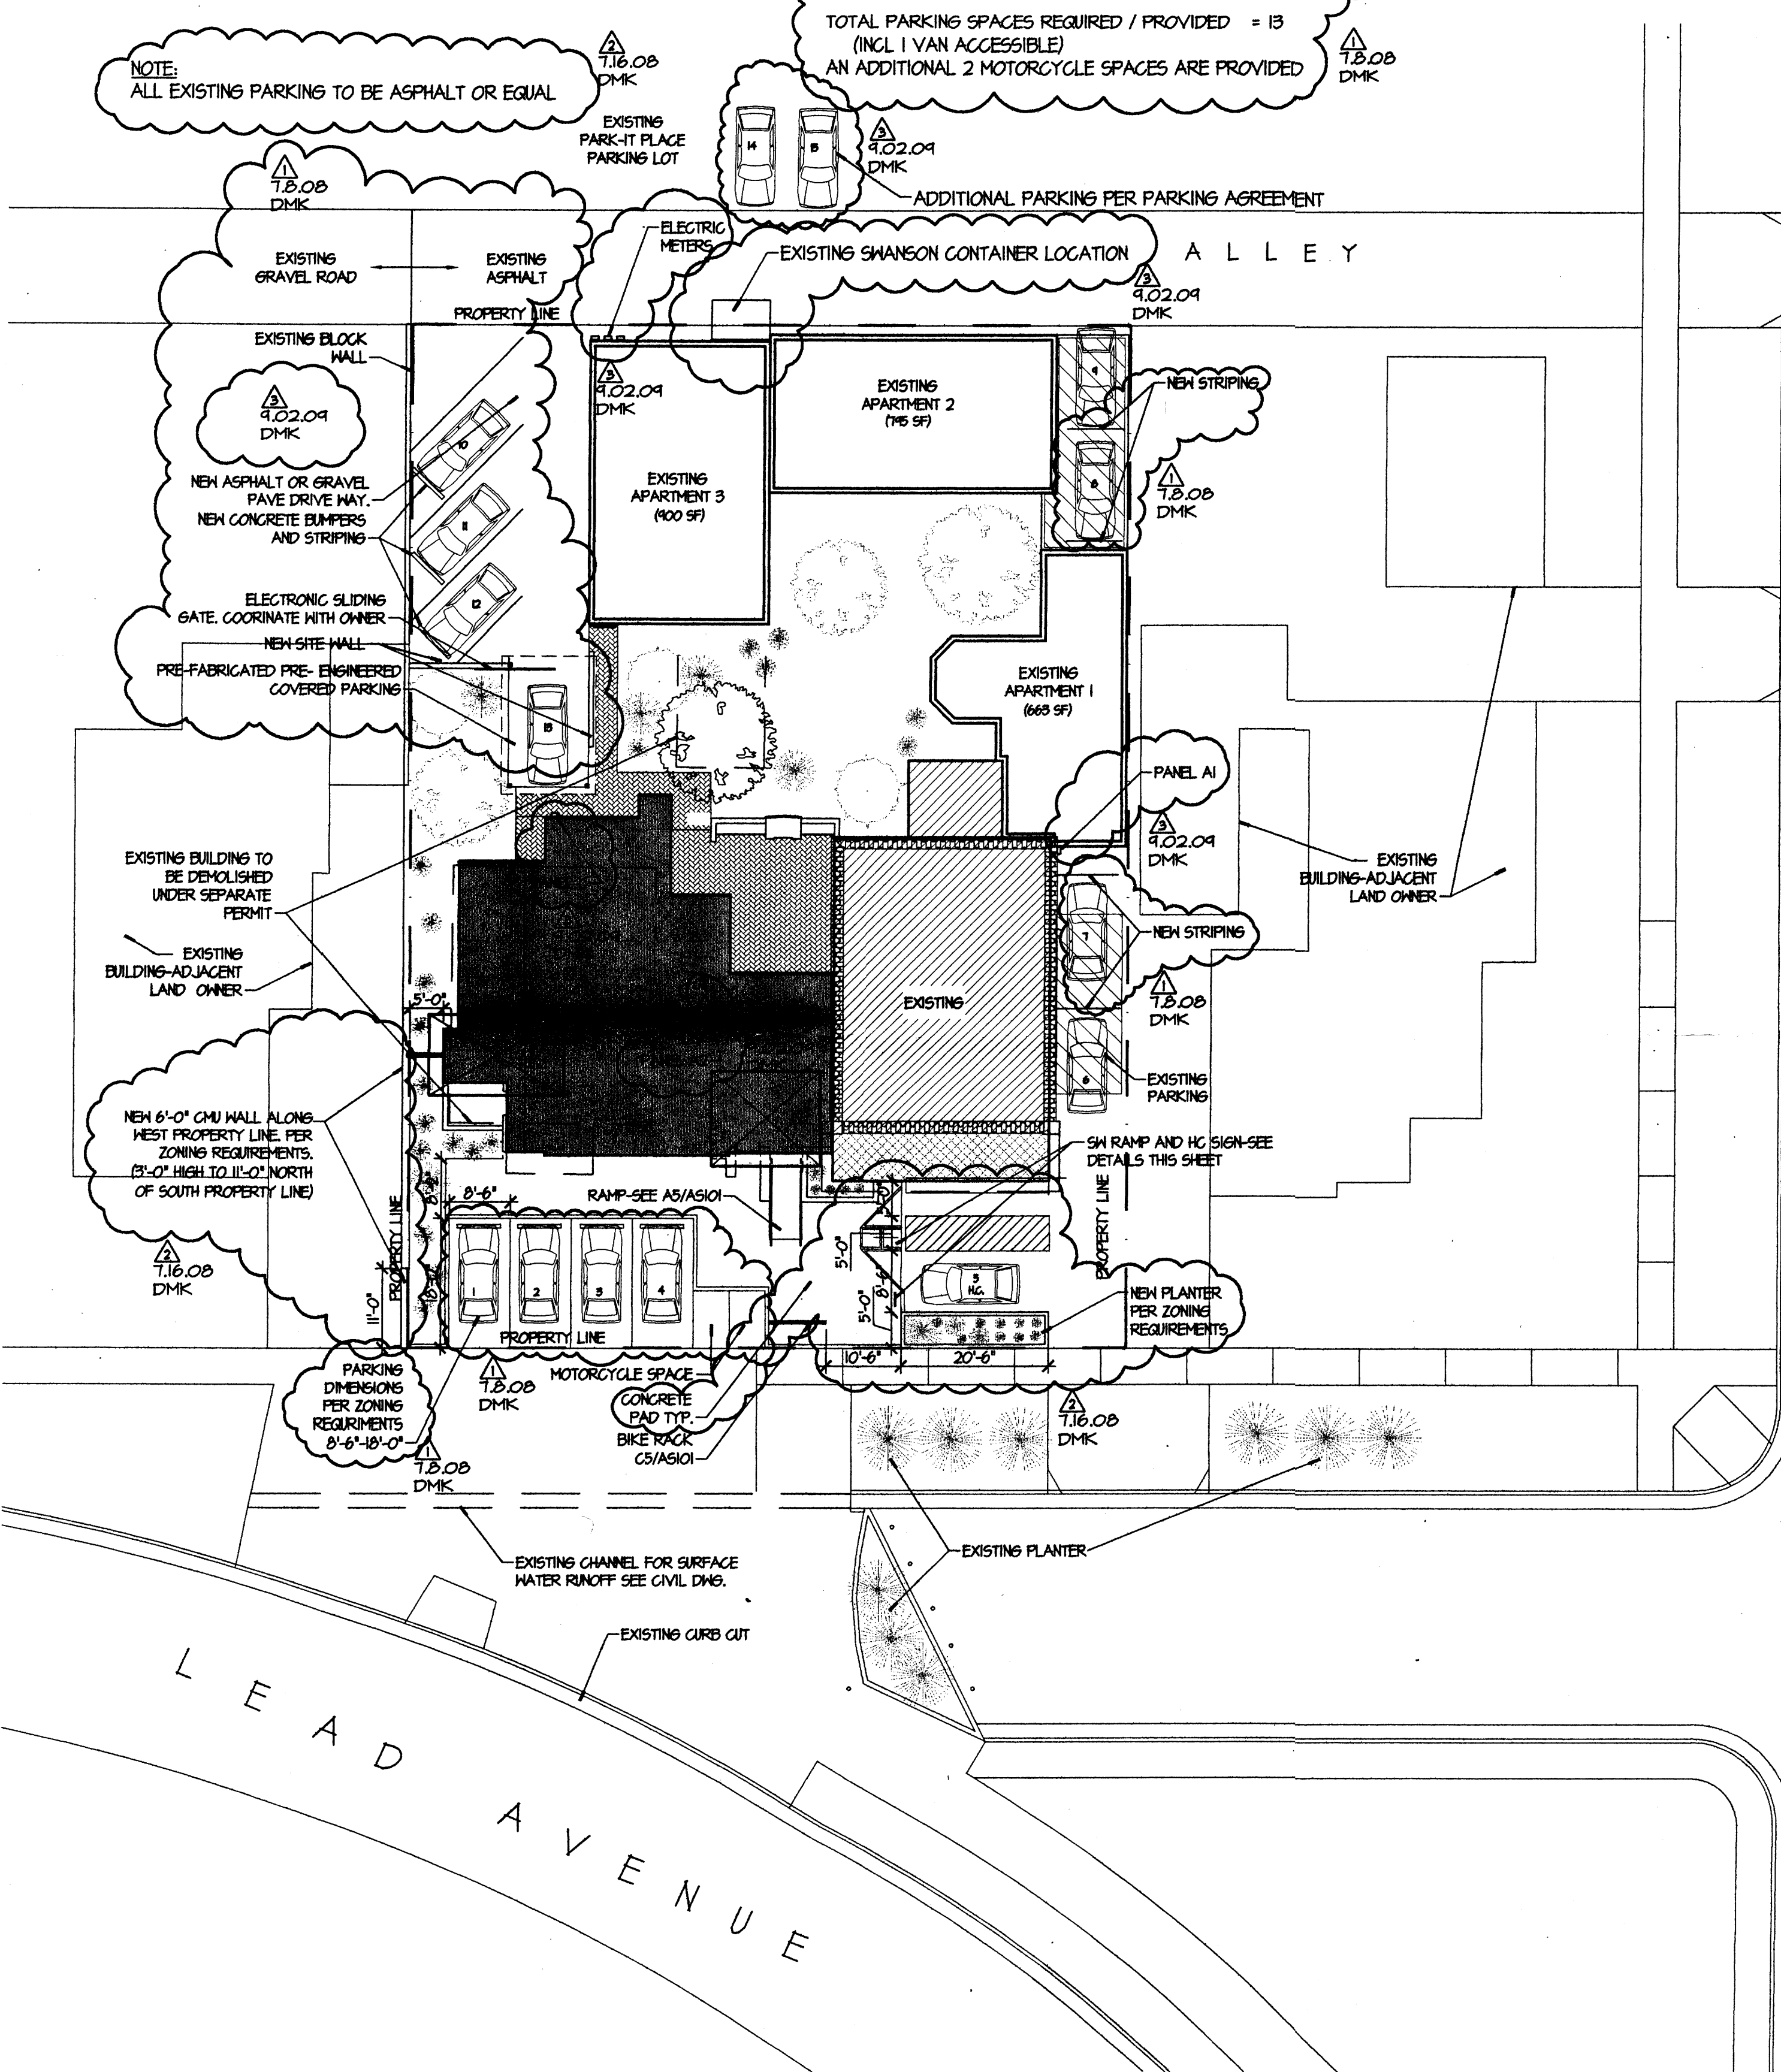


A1 SITE PLAN

1/16" = 1'-0"

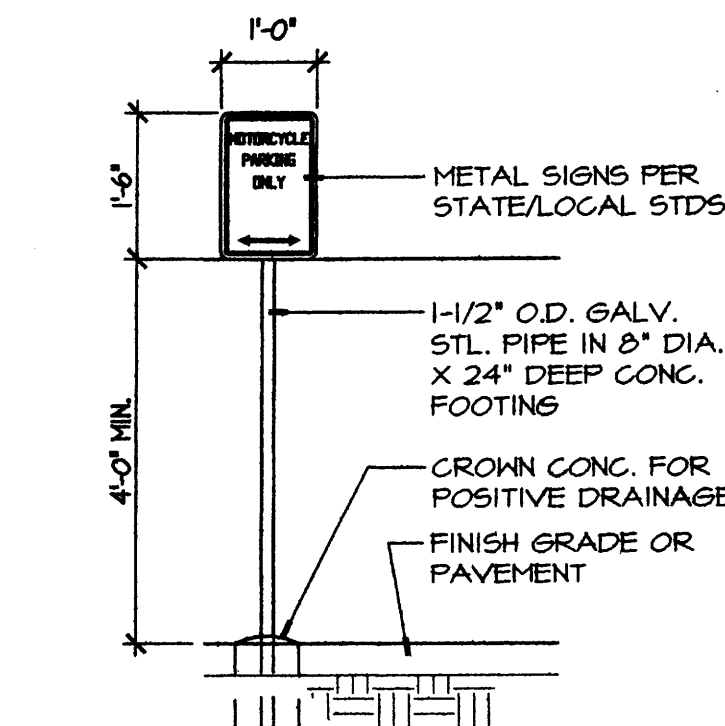


D4 MOTORCYCLE PARKING SIGN

SCALE: 1/2" = 1'-0"

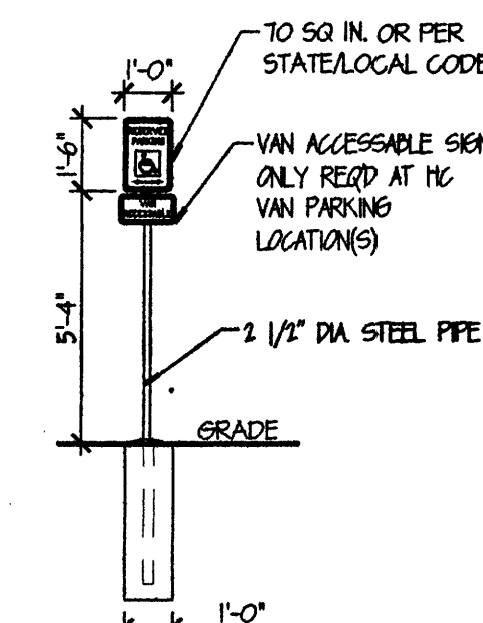


C4 ADA SIGNAGE

SCALE: 1/4" = 1'-0"

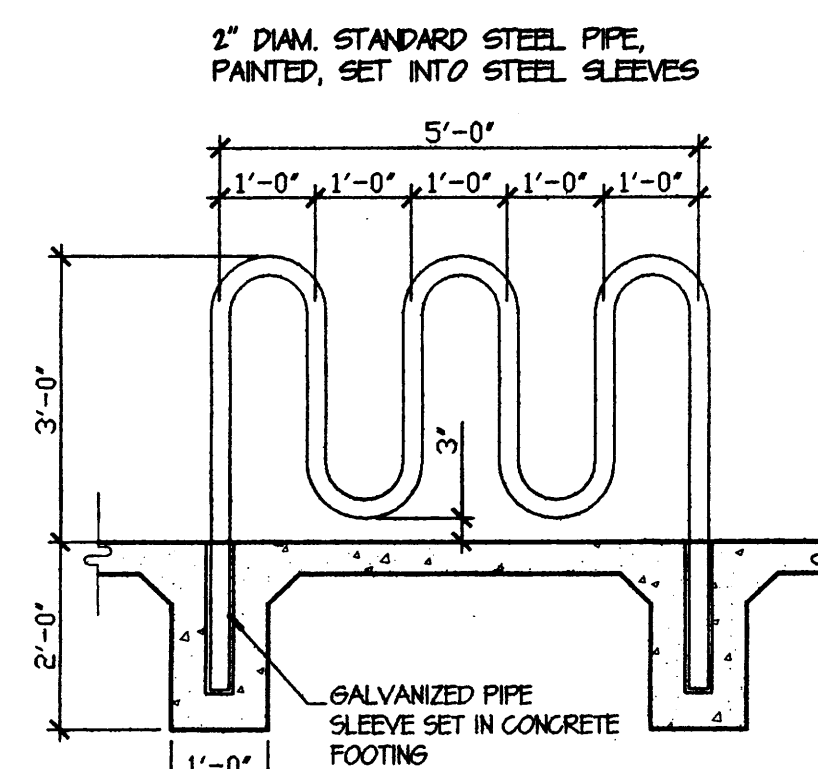


C5 BIKE RACK

SCALE: 1/2" = 1'-0"

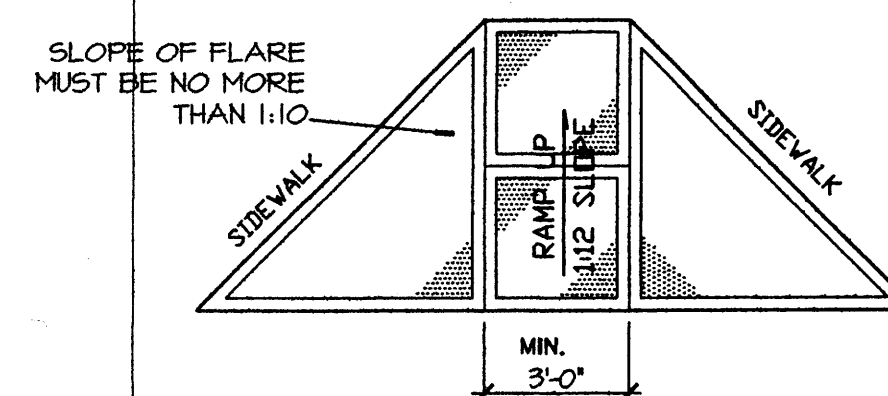


B4 PARKING RAMP PLAN

SCALE: 1/4" = 1'-0"

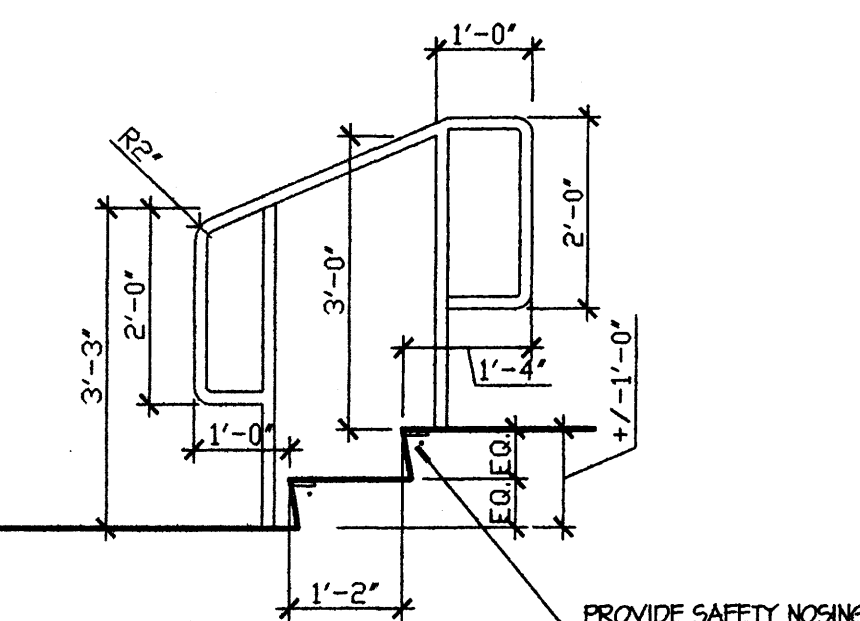


A4 STAIR SECTION

SCALE: 1/2" = 1'-0"

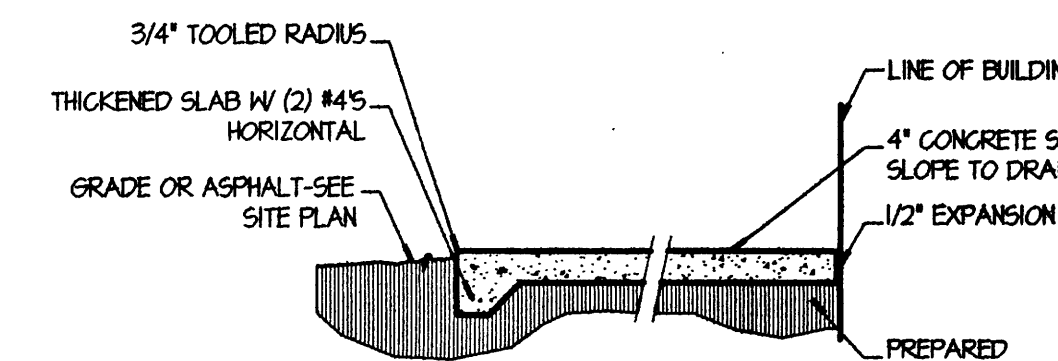

B5 SIDEWALK DETAIL

SCALE: 1/2" = 1'-0"

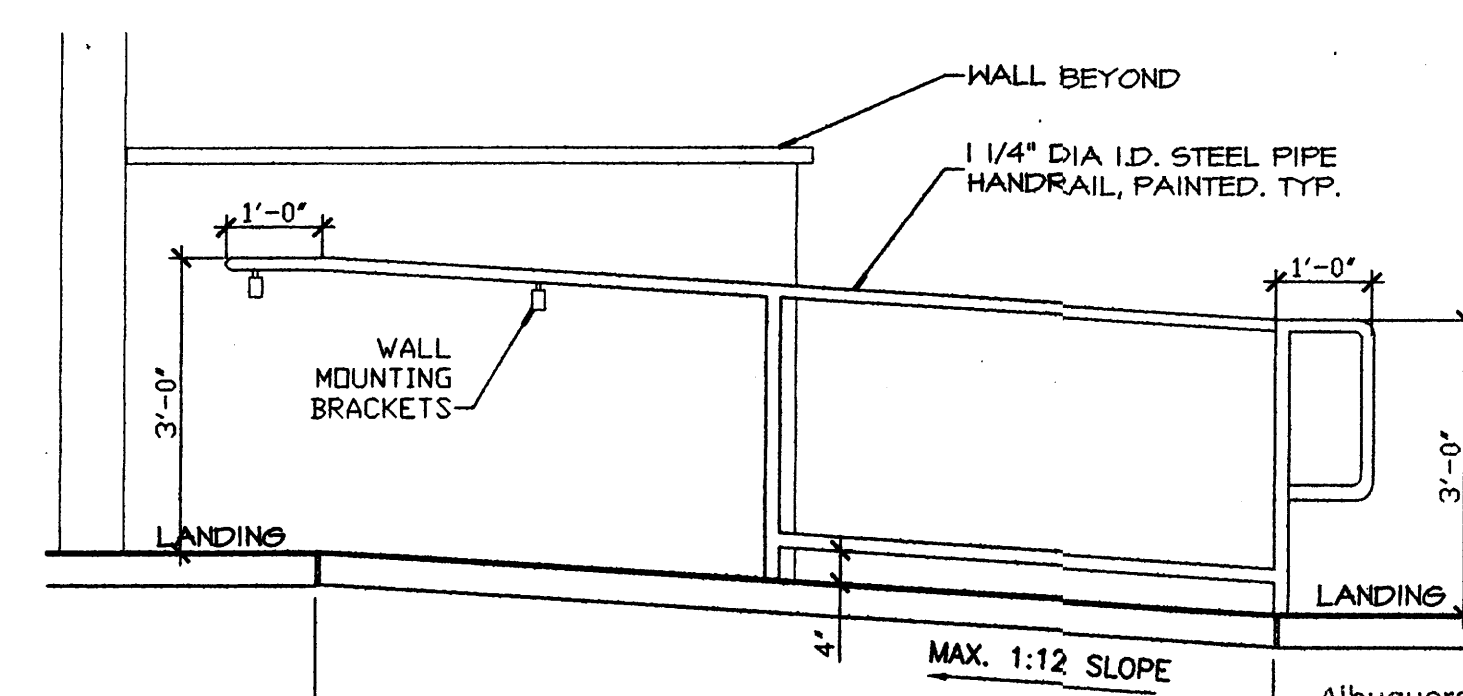


A5 RAMP SECTION

SCALE: 1/2" = 1'-0"

Y A L E B L V D.

EDIN VNC IARMOINCS ENTAL

BARBARA JARVIS
2129 AND 2131 LEAD AVE SE
ALBUQUERQUE NM 87106

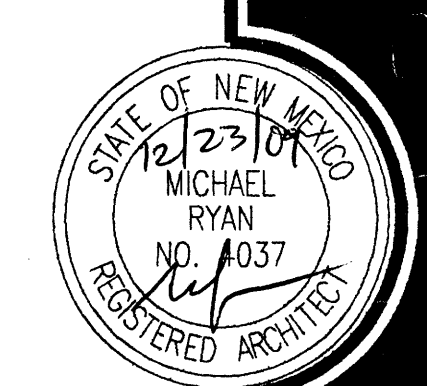

ISSUE: PERMIT SET

DRAWN: DMK

CHECKED: MFR

DATE: 12.21.09

REVISIONS

1.16.08

1.16.08

4.2.09

ARCHITECTURAL SITE PLAN

0653
AS101