

1/8" = 1'-0"

LEGAL DESCRIPTION

Tract lettered A plat of Tracts A & B LANDS OF ALBUQUERQUE LITTLE THEATER in Section 18, TION, R3E NMPM as the same is shown and designated on said plat thereof filed in the office of the County Clerk of Bernalillo County on MAy 12, 2004 in Book 2004C, Page 150.

Current Zoning: CLD Commercial/Low Density Zoning Ordinance: Huning Castle and Reynolds Addition Sector

Minimum Setbacks: 5' from Central Avenue, 15' from all other lot lines. Maximum Density: Maximum floor area ratio is .61 Maximum Height: Maximum height is 46'

Usable Open Space: 400 sf for each efficiency or one-bedroom dwelling unit, 500 sf for each two-bedroom dwelling unit, and 600 sf for each dwelling unit containing three or more bedrooms.

3 BDR units * 9 = 5,400 sf

= 6,400 sf Usable Open Space required

Lot Area: 44, 632 sf or 1.02 acres Setbacks: 5' from Central Avenue & 15' from all other lot lines Density: 27,217 sf Habitable/44,632 sf (site) = .61 FAR Height: 38' at highest point, refer to Building Elevations on sheet A301 (sheet 5 of 6).

Lot Area - [Paving Area and Building Footprint] = Usable Open Space 44,632 - [15,501 + 14,928] = 14,203 sf Usable Open Space provided

PROJECT DATA

<u>Dwelling Units:</u> Unit A - 3BR/2BA - 4 units x 1,995 sf = 7,980 sf Unit B - 4BR/2BA - 4 units x 2,132 sf = 8,528 sf

Unit C ~ 2BR/2BA - 2 units x 1,428 sf = 2,856 sf Unit D - 3BR/2BA - 1 unit $\times 2,122 \text{ sf} = 2,122 \text{ sf}$ 11 units

Retail Space • First Floor: Retail 1 - 408 sf

Total Habitable Area = 27,217 sf

PARKING DATA

Required: 1 Parking Space for each bathroom within the dwellings unit but no less than 1.5 spaces. All proposed dwelling units have 2 bathrooms therefore each unit is required to have 2 parking spaces.

23 spaces required

1 space for every 200 sf of Habitable Retail or Office space. Habitable Retail & Office space = 5,731 sf Less Storage & Egress Area - 860 sf

= 25 spaces

<u>Proposed:</u>
All proposed dwelling units are provided with a 2 car garage.


Retail & Office parking provided: 23 spaces provided

Bicycle Parking Required: Residential: 1 Bicycle space per 2 dwelling units. Nonresidential: 1 Bicycle space per 20 automobile parking spaces 11 dwelling units = 6 bicycle spaces. 23 nonresidential parking spaces = 2 bicycle spaces = 8 spaces required

Bicycle Parking Provided: 16 Bicycle spaces provided



J-13-Z

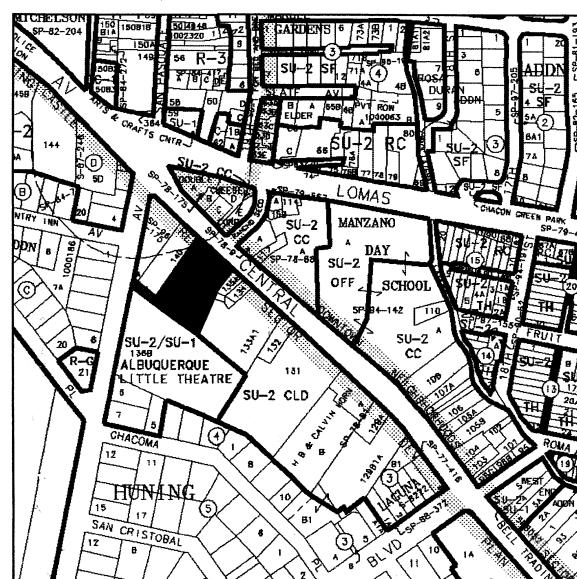

architecture interiors engineering

6801 Jefferson NE Suite 100 Albuquerque, NM 87109 505 761-9700 fax 761-4222 dps@dpsabq.com

ARCHITECT

ISSUED FOR DRB 10.26.04

ENGINEER


SHEET INDEX

- 1. SITE DEVELOPMENT PLAN
- 2. LANDSCAPE PLAN 3. CONCEPTUAL GRADING AND DRAINAGE PLAN
- 4. CONCEPTUAL UTILITY PLAN 5. BUILDING ELEVATIONS
- 6. BUILDING ELEVATIONS

GENERAL NOTES

A. All signage shall conform to the City of Albuquerque sign code.

B. All mechanical/electrical equipment shall be screened from view to the greatest extent practicable. Equipment shall be roof mounted and screened from view by building parapets. All yard mounted equipment shall be screened by fencing or stucco walls.

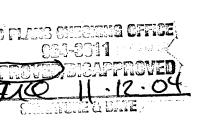

PROJECT NUMBER: 1003010

APPLICATION NUMBER: 04EPC-00860 EPC Site Development Plan-Building Permit 04 DRB 01687

Is an Infrastructure List Required? (x) Yes () No If yes, then a set of approved DRC plans with a work order is required for any construction within Public Right-of-Way or for construction of public

DRB SITE DEVELOPMENT PLAN APPROVAL:	11-12-04
TRANSPORTATION DIV	7ISION DATE
Christina Sandoval	DATE 4/19/05
Bradly L. By	DATE 4/20/05
CITY ENGINEER	DATE

RIS RIVERS 761-81412 OR Nev 12,04 SOZIO WASTE MANAGEMENT DRB CHAIRPERSON, PLANNING DEPARTMENT

1 9/20/04 EPC Conditions incorporated 2 11/10/04 DRB comments incorporated

Housing (a) Touguerque Little

erque

16

REVISIONS

DRAWN BY REVIEWED BY DATE 10.26.04 PROJECT NO. 04037 DRAWING NAME

SITE DEVELOPMENT PLAN FOR BUILDING PERMIT

SHEET NO.


PLANTING LEGEND

TREE				
SYMBOL	EST. QTY.	INSTALLED SIZE	COMMON NAME	Botanical name
	7	11'x5' B#B	DESERT WILLOW	Chilopsis linearis
+	1	2"-Cal @ 10'x4'	VALLEY COTTONWOOD	Populus wislizenii
	4	2"-Cal @ 9'x4'	PURPLE ROBE LOCUST	Robinia × ambigua

SYMBOL	EST. QTY.	INSTALLED SIZE	COMMON NAME	Botanical name													
② 13 ③ 29	13	1-Gal @ 9"x9"	1-Gal @ 9"x9"	1-Gal @ 9"x9"	1-Gal @ 9"x9"	13 1-Gal @ 4"x4"	13 1-Gal @ 9"x9" MARIOLA	1-Gal e 9"x9" MARIOLA Parti	1-Gal @ 4"x4" MARIOLA	1-Gal @ 9"x9"	1-Gal e 9"x9"	MARIOLA	al e 9°×9° MARIOLA Partheniu	9"x9" MARIOLA Partheni	I-Gal e 9"x9" MARIOLA	MARIOLA	Parthenium incanum
	1-Gal @ 9"x6"	TURPENTINE BUSH	Ericameria laricifolia														
ACCENTS																	
SYMBOL	EST. QTY.	installed size	COMMON NAME	Botanical name													
.	7	12"×12"	PARRYS AGAVE	Agave parrui													

SYMBOL	EST. ATY.	INSTALLED SIZE	COMMON NAME	Botanical name
*	٦	12"x12"	PARRYS AGAVE	Agave parryi
*	52	5-Gal e 12"x12"	RED HESPERALOE	Hesperaloe parviflora
\oplus	16	15-Gal e 2'x2'	ARIZONA BEARGRASS	Nolina microcarpa
کہک	6	5-Gal e 4 PAD MIN	DESERT PRICKLY PEAR	Opuntia engelmannii
₩	5	6' - 2 HEADS	THOMPSON'S YUCCA	Yucca thompsoniana

SYMBOL	EST. QTY.	INSTALLED SIZE	COMMON NAME	Botanical name
0	28	1-Gal @ 9"x6"	SUNSET HYSSOP	Agastache rupestris
\odot	21	1-Gal @ 6"x6"	PRAIRIE SAGE	Artemesia ludoviciana
\Diamond	35	5-Gal e 15"x15"	DEER GRASS	Muhlenbergia rigens
Δ	36	1-Gal e 6"x6"	ROCKY MTN PENSTEMON	Penstemon strictus
~~~	19	5-Gal e 2'x1'	YELLOW LADY BANKS' ROSE	Rosa banksiae 'Lutea'
	125	4" Pots @ 3"X4"	TURKISH SPEEDWIELL	Veronica liwanensis
0	25	POTTED PLANT LOCATIONS: TERRA COTTA POTS, 18"-24" SIZES, INCLUDING POTTING SOI		s, including potting soil
	r	SUCH AS: DAHLBERG I	RDY, DROUGHT TOLERANT ACCENT AND DAISY, BLUE CUP FLOMER, RED YUCCA, F UMPET; HAND MATER AS NEEDED	

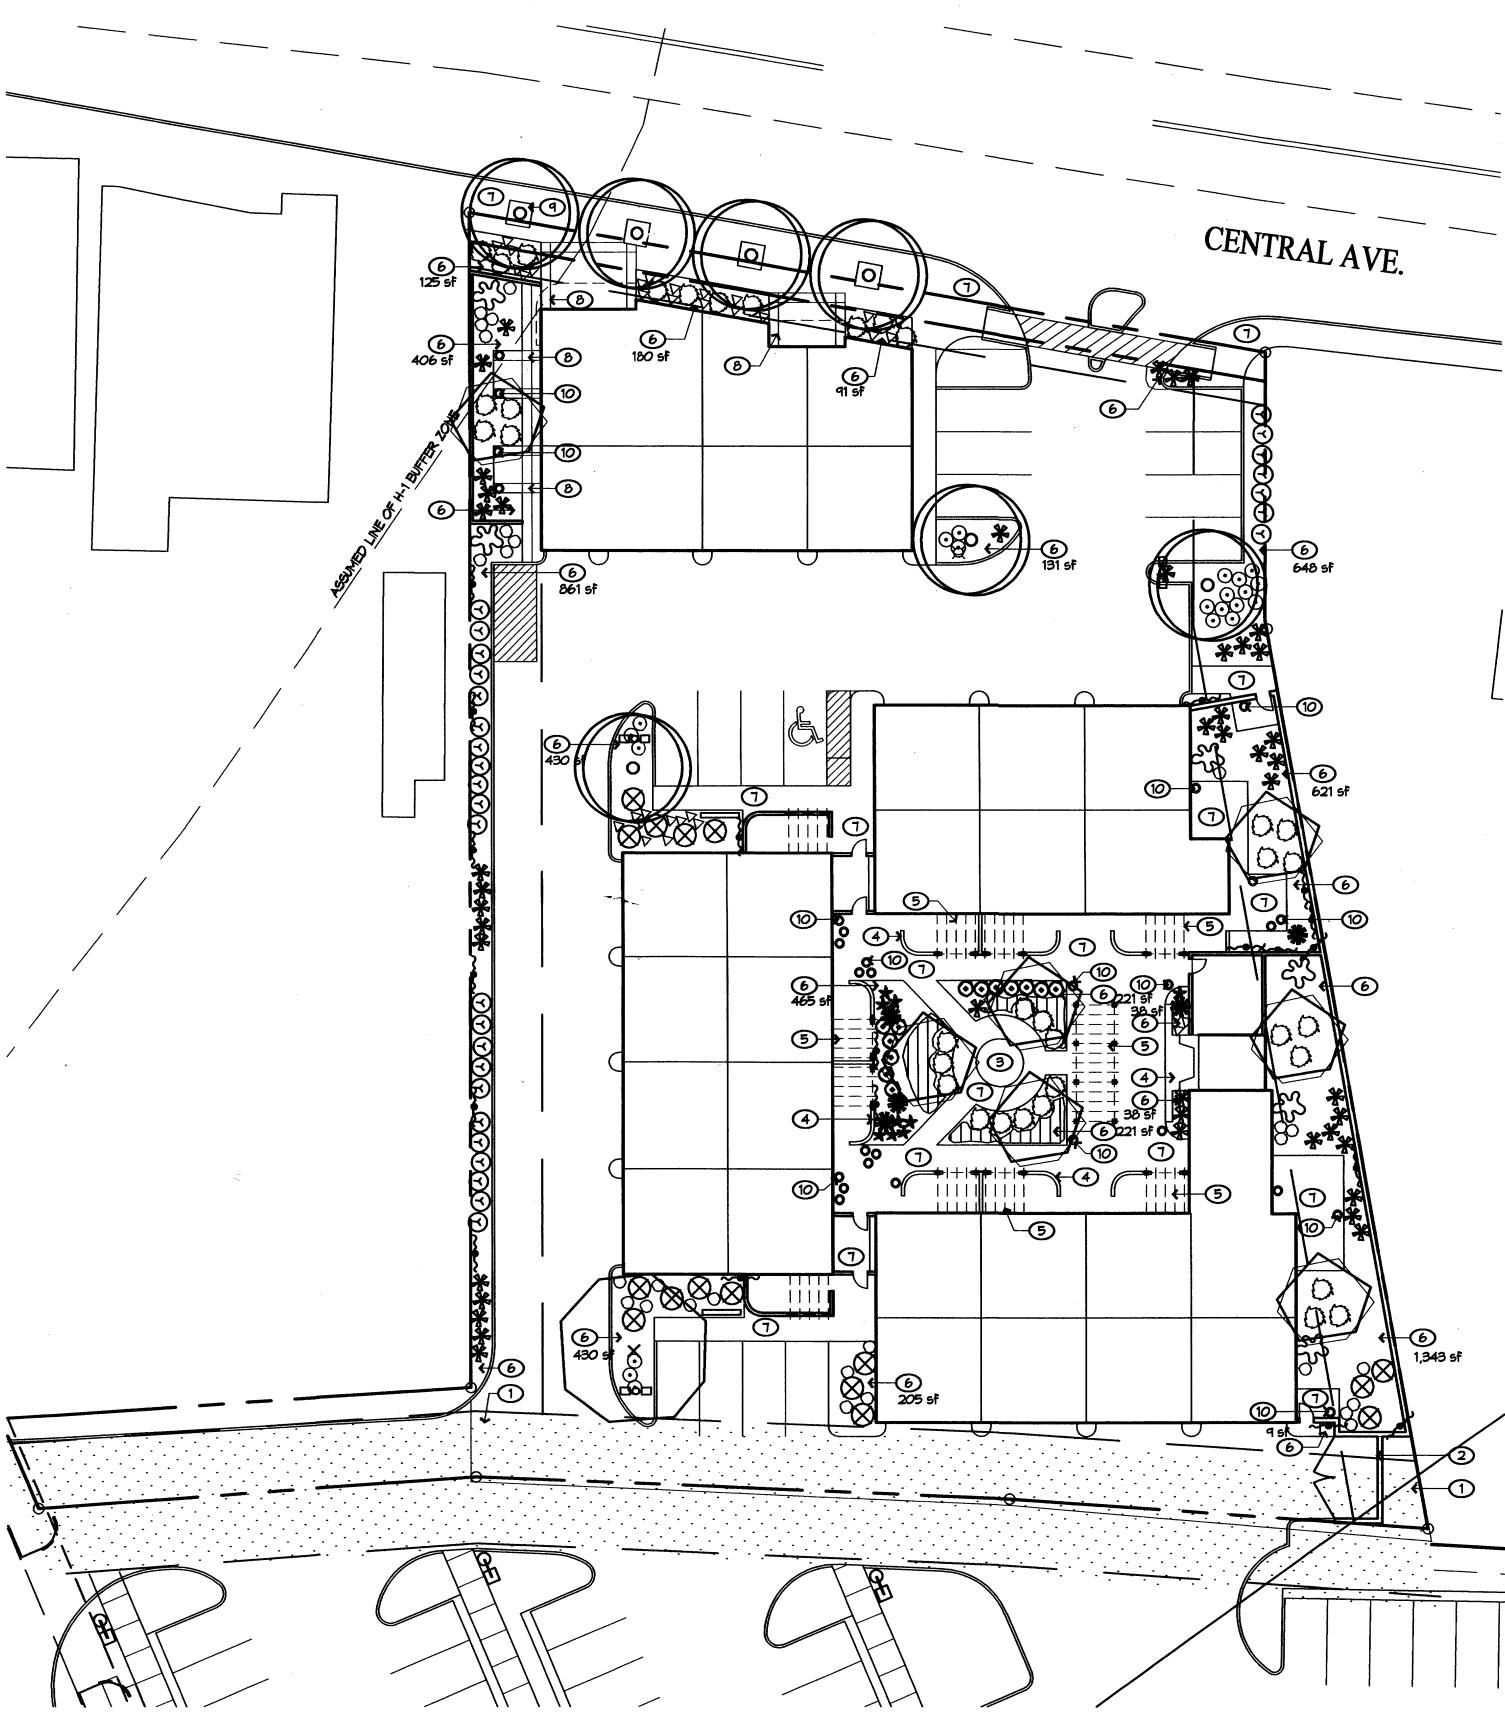

1" = 20'-0"

LANDSCAPE PLAN



- 1 SHARED ACCESS EASEMENT (TYP)
  2 SERVICE YARD WITH GATE
- SERVICE YARD WITH GATE
  FOUNTAIN
- LOW GARDEN WALL (TYP) / SHADE RAMADA (TYP)
- LANDSCAPE AREA: SANTA ANA TAN CRUSHER FINES MULCH, DEPTH: 2", NO FILTER FABRIC (TYP)
- BRICK OR CONCRETE PAVING (TYP)
- DECORATIVE PAVING (TYP)
  TREE GRATE (TYP)
- 10 POTTED PLANT LOCATION: SEE PLANT LEGEND (TYP)

## LANDSCAPE NOTES

1. DESIGN: THE PLANTING DESIGN ACCENTUATES THE SITE PLAN'S VEHICULAR AND PEDESTRIAN PATTERNS. IT RELATES THE FEEL OF THE NATURAL VALLEY AND OLD TOWN NEIGHBORHOODS WITH THE ARID, HIGH DESERT CLIMATE.

MEDIUM TO LARGE TREES, SEMI-EVERGREEN VINES, AND UNDERSTORY GROUNDCOVERS SHADE PARKING AREAS AND HELP SCREEN VIEWS ONTO ADJACENT PROPERTIES. PRIVATE, INTERIOR SPACES UTILIZE DECORATIVE PAVING, ALONG WITH A DESERT-OASIS EFFECT OF COMPACT, LOW WATER-USE TREES OTHER REGIONALLY NATIVE PLANTINGS, INCLUDING FORM, FLOWER COLOR AND EVERGREEN APPEARANCE. ORNAMENTAL GRASSES AND FLOWERING GROUNDCOVERS WERE USED IN SOME PROTECTED, SHADY AREAS THROUGHT THE PROJECT.

SUCCULENTS ARE PROPOSED IN STRATEGIC LOCATIONS TO REINFORCE THE LANDSCAPE'S SENSE OF PLACE NEAR OLD-TOWN, USED TO REINFORCE ALBUQUERQUE'S REGIONAL AND HISTORIC IDENTITY.

- 2. PLANTING AND IRRIGATION DESIGN AND INSTALLATION SHALL COMPLY WITH THE INTENT OF THE CITY OF ALBUQUERQUE WATER CONSERVATION, LANDSCAPING AND WATER WASTE ORDINANCE. PLANTING AREAS SHALL ACHIEVE MINIMUM 75% LIVE VEGETATIVE COVERAGE UPON PLANT MATURITY. NOTED PLANT QUANTITIES ARE APPROXIMATE, AND REFLECT THE ESTIMATED NUMBER OF PLANTS NECESSARY TO ACHIEVE THE DESIGN INTENT AND THE REQUIRED COVERAGE AT PLANT MATURITY.
- 3. PLANTING AND IRRIGATION INSTALLATION SHALL MEET CITY OF ALBUQUERQUE REQUIREMENTS.
- 4. PLANTING AND IRRIGATION MAINTENANCE SHALL BE THE RESPONSIBILITY OF THE PROPERTY OWNER.
- 5. CONTROLLER: THE IRRIGATION SYSTEM SHALL BE RUN WITH A FULLY AUTOMATED IRRIGATION CONTROLLER. THE RUN TIME FOR THE VARIOUS ZONES SHALL BE APPROXIMATELY 45 MINUTES FOR THE DRIP ZONES AND 20 MINUTES FOR THE SPRAY ZONES. RUN TIME WILL BE ADJUSTED ACCORDING TO SEASON, LOCATION, AND PLANT ESTABLISHMENT. DRIP EMITTERS SHALL BE USED FOR ALL PLANT MATERIAL EXCEPT FOR GROUND COVER AREAS IN THE INNER COURTYARD. THIS AREA MAY BE IRRIGATED WITH SPRAY EMITTERS APPROPRIATELY DESIGNED TO AVOID OVERSPRAY ONTO IMPERMEABLE SURFACES AND ADJACENT PAVING.
- 6. POINT OF CONNECTION: A PROPOSED CONNECTION TO CITY WATER FOR IRRIGATION PURPOSES EXISTS ON THE PROPERTY.
- T. MULCH: ALL PLANTING BEDS SHALL BE COVERED WITH MULCH. CRUSHER FINES MULCH WILL BE USED APPROPRIATELY TO ADD VISUAL INTEREST AND PROTECT SOIL MOISTURE.
- 8. COTTONWOOD TREE: ROOT BARRIER SHALL BE USED AROUND THE EDGE OF THE PARKING MEDIAN WHERE COTTONWOOD TREE IS TO BE INSTALLED. THIS CHEMICALLY TREATED EDGING WILL REPEL SURFACE ROOTS AND ENCOURAGE DEEP ROOTING OF THESE TREES.


#### ANDSCAPE CALCULATIONS

TOTAL AREA: 44,632 SF BUILDING AREA: 27,217 SF NET AREA: 17,415 SF

REGUIRED LANDSCAPE AREA (15% OF NET AREA): 2,612 SF PROVIDED LANDSCAPE AREA: 6,463 SF

ALLOWABLE HIGH WATER USE TURF (20% OF LANDSCAPE AREA): 261 SF PROVIDED HIGH WATER USE TURF AREA: 0 SF



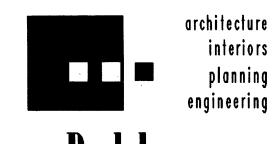

# Dekker Perich Sabatin

6801 Jefferson NE Suite 100 Albuquerque, NM 87109 505761-9700 fax 761-4222 dps@dpsabq.com

ARCHITECT

ISSUED FOR DRB 10.26.04

NGINEER

Albuquerque Little Theater Central Ave. SW

DRAWN BY DAC
REVIEWED BY MB

DATE 10.26.04


PROJECT NO. 04037


LANDSCAPE PLAN

SHEET NO

DRAWING NAME



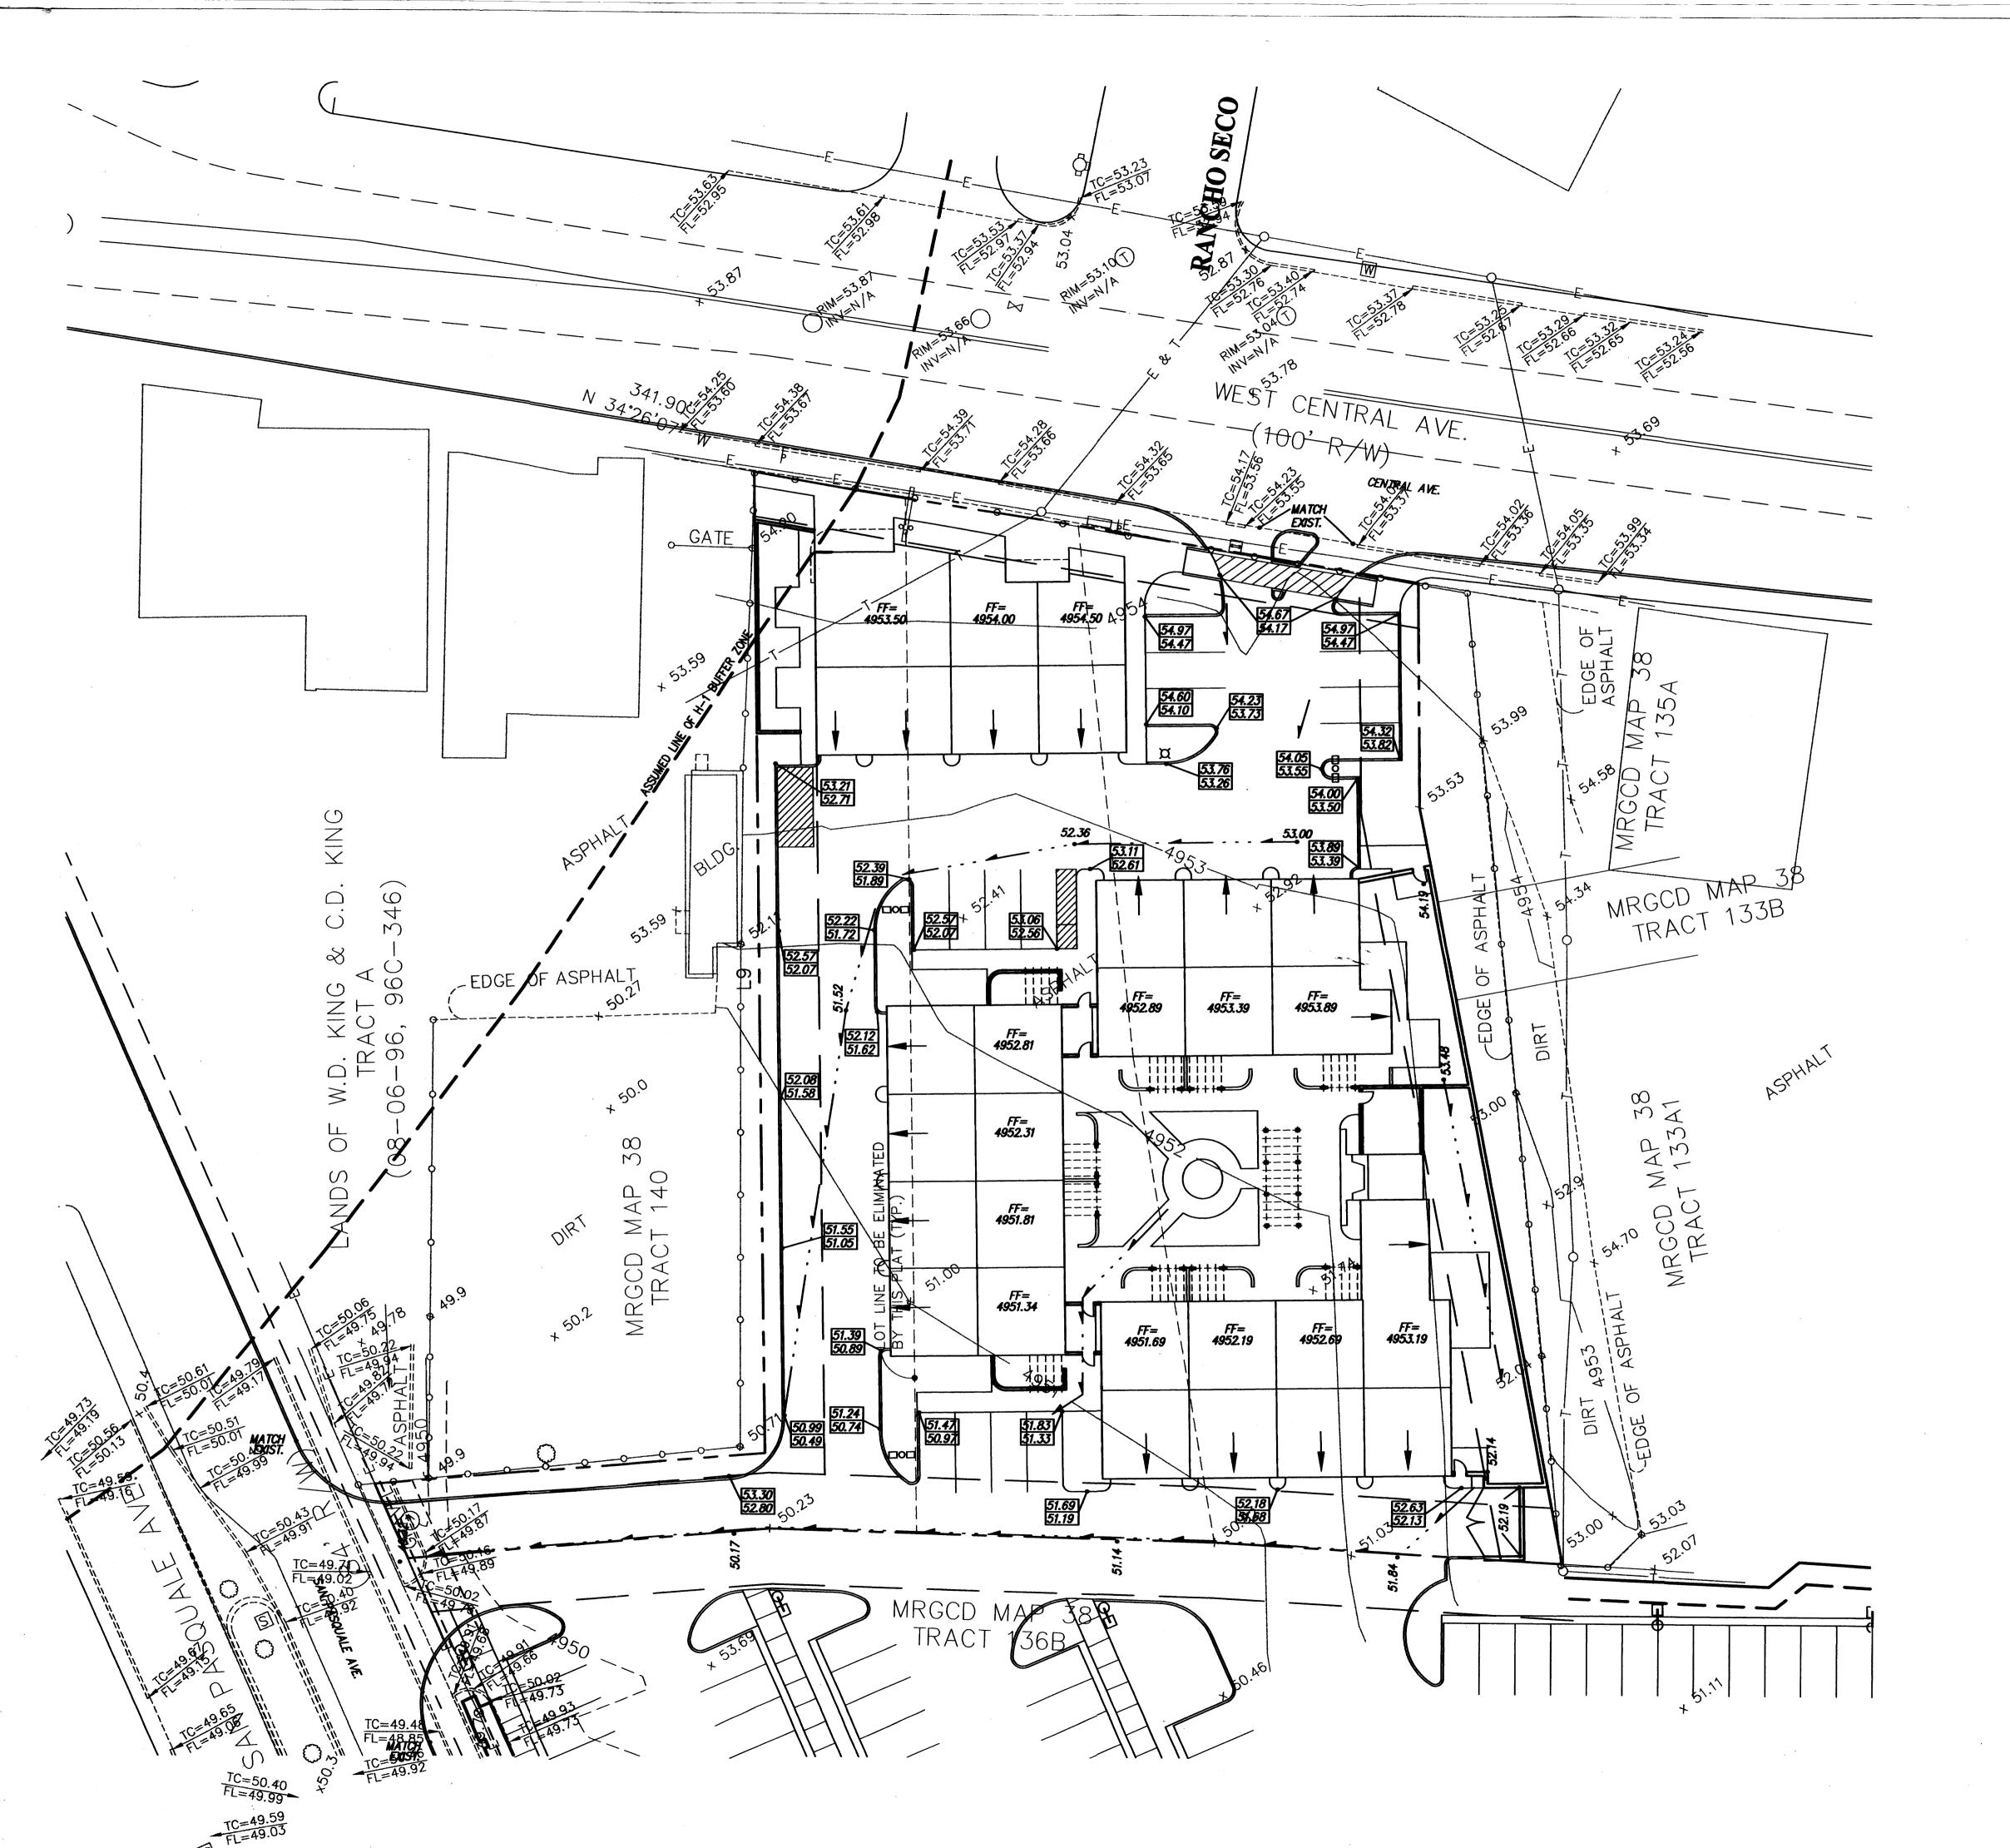

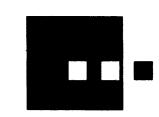

architecture

6801 Jefferson NE Suite 100 Albuquergue, NM 87109 505 761-9700 fax 761-4222 dps⊕dpsabq.com

ISSUED FOR EPC 06.01.04

The Theate

Housing Suquerque | Central A

----- EXISTING CONTOUR MAJOR EXISTING INLET EXISTING SANITARY SEWER LINE — — — EXIST SAS — — — EXISTING SANITARY SEWER MANHOLE — — — EXIST WL — — — EXISTING WATERLINE EXISTING GATE VALVE EXISTING WATER SERVICE METER -o--o--o---o------ EXISTING FENCE *•FL=36.8* EXISTING FLOWLINE ELEVATION •*37.6* EXISTING SPOT ELEVATION PROPOSED CONTOUR LINE **.**85.00 PROPOSED SPOT ELEVATION PROPOSED TOP CURB ELEVATION

LEGAL DESCRIPTION

LEGEND

TRACT A, LANDS OF ALBUQUERQUE LITTLE THEATER.

SCALE: 1" = 20'



PROPOSED FLOWLINE ELEVATION

PROPOSED SAS MANHOLE

ROOF DRAIN

PROPOSED SWALE

REVISIONS DRAWN BY REVIEWED BY


DATE 06.01.04 PROJECT NO. 04037 CONCEPTUAL GRADING PLAN

MARK GOODWIN & ASSOCIATES, P.A. CONSULTING ENGINEERS P.O. BOX 90606 ALBUQUERQUE, NEW MEXICO 87199 (505)828-2200, FAX (505)797-9539

SHEET NO.

C001

A04JOBS/A4040/A04040GD2OR/10-26-04/ACH

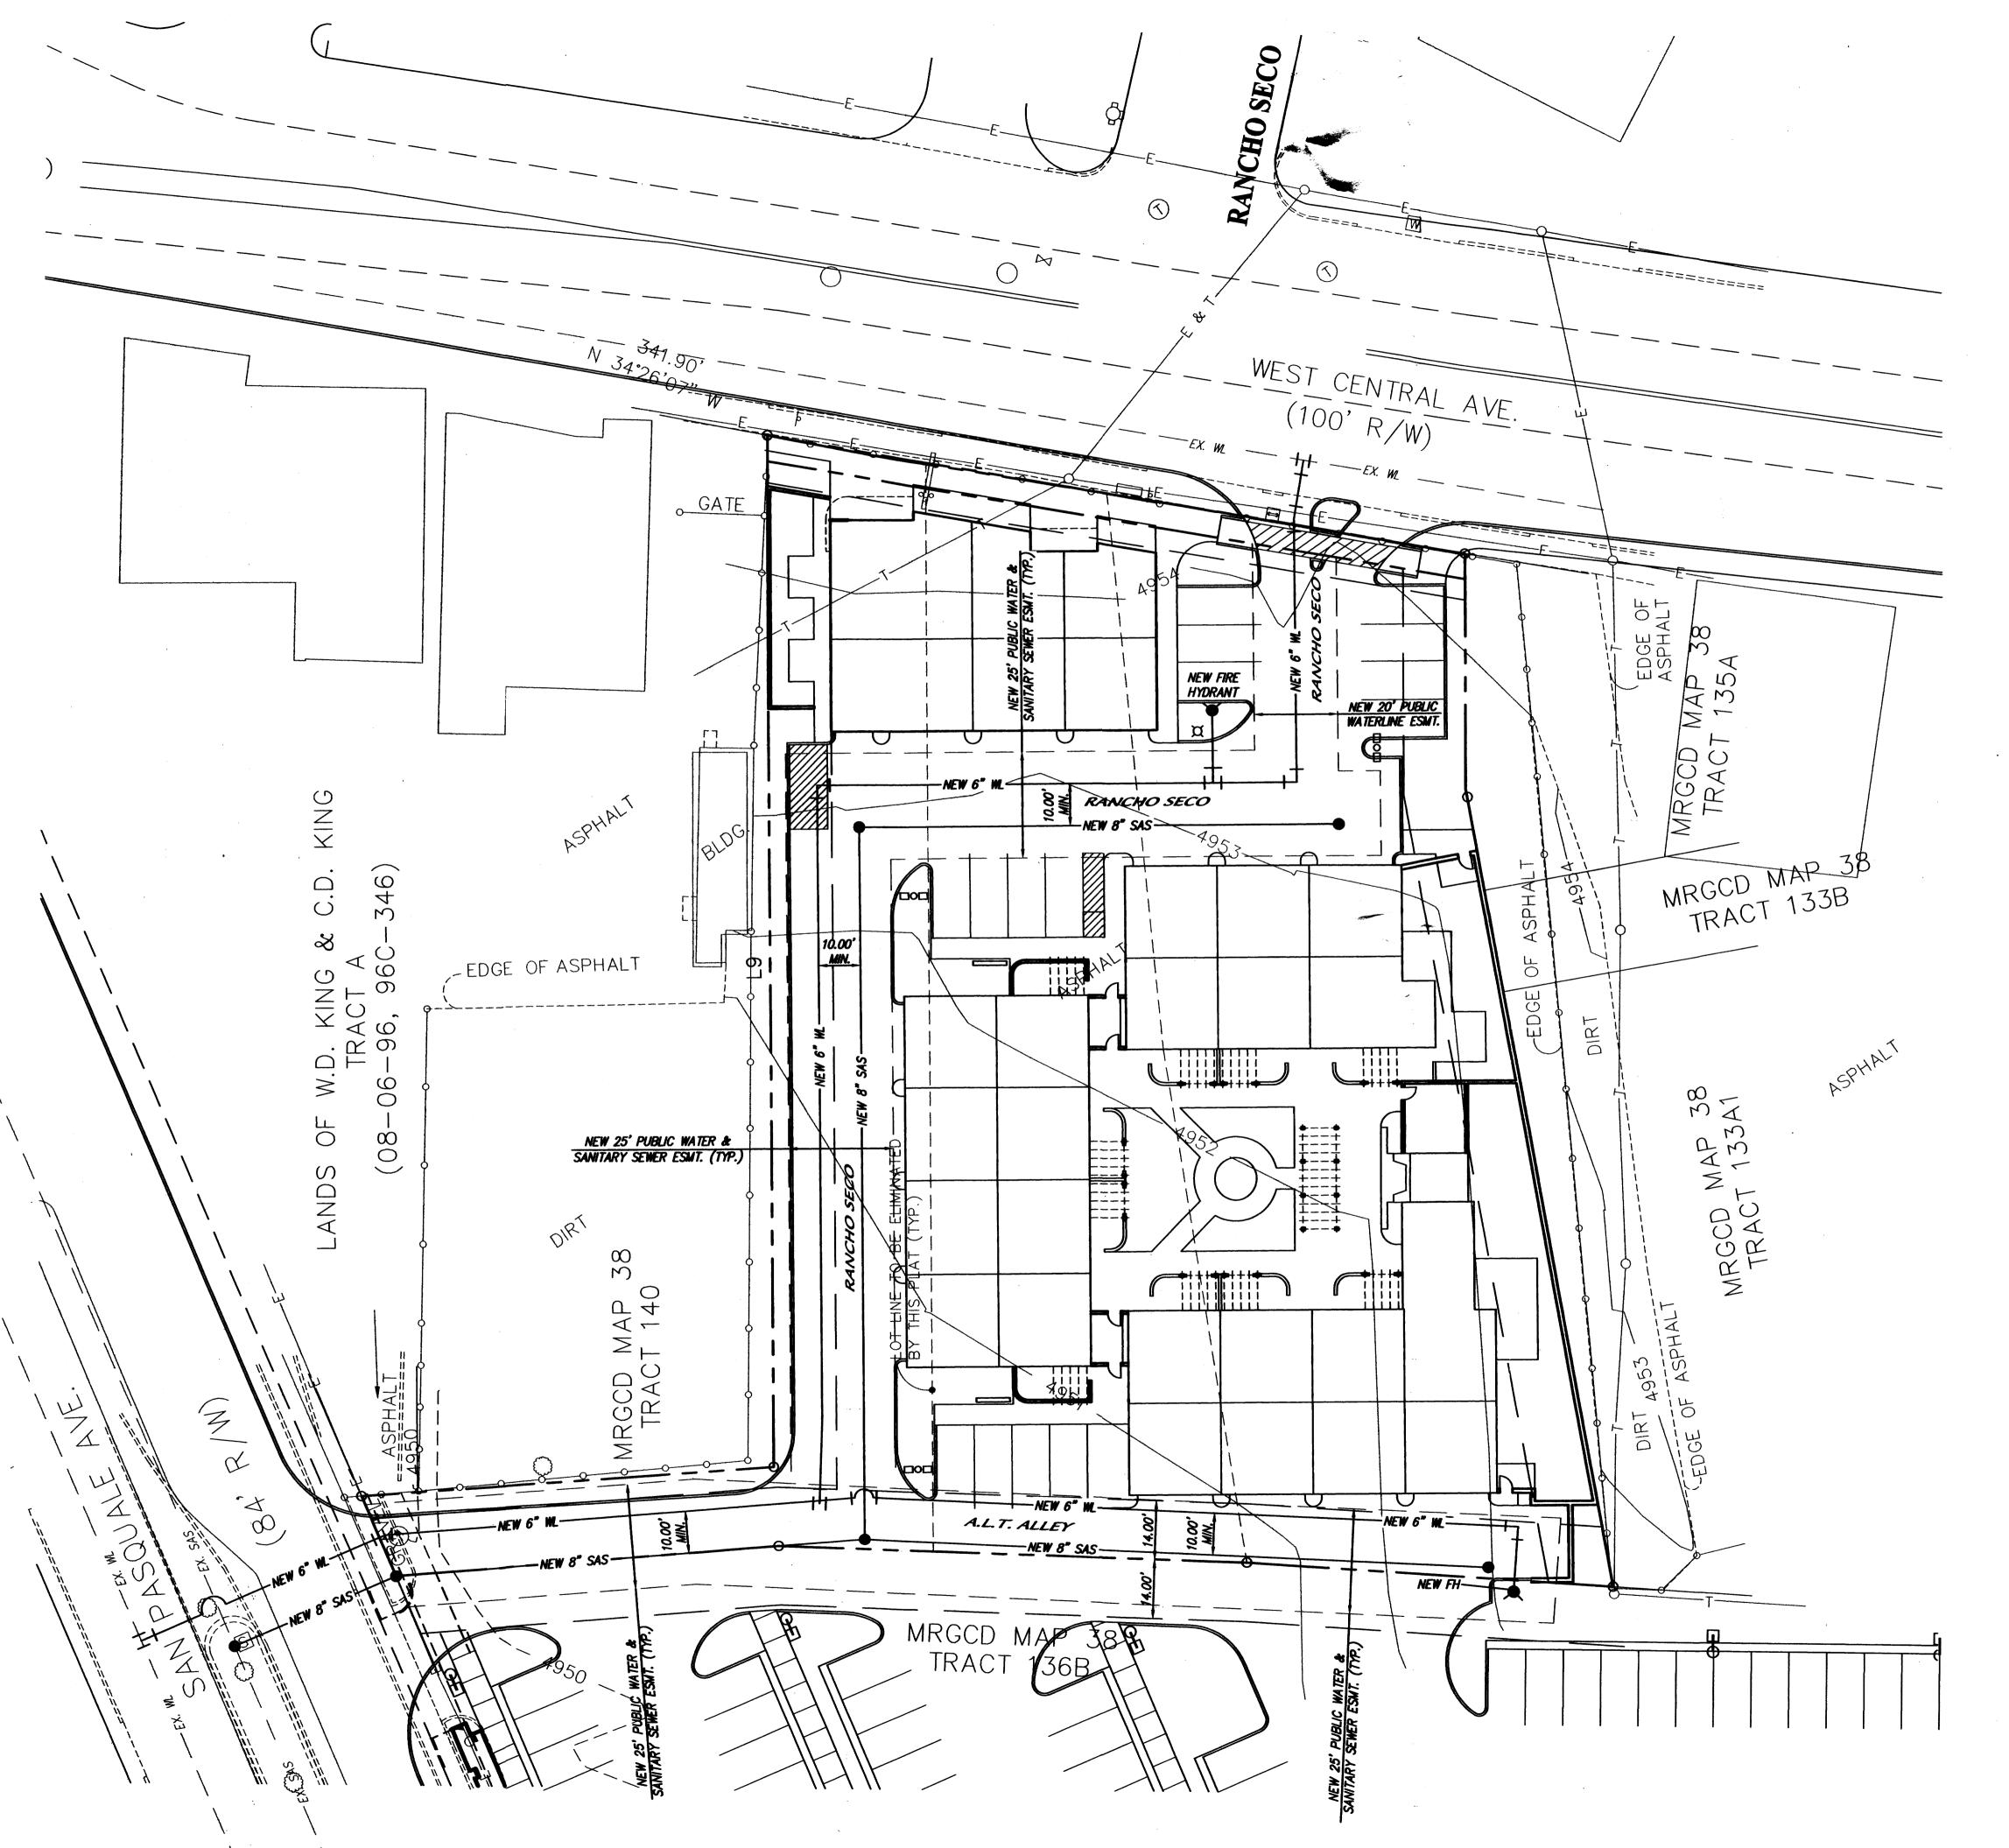

# NOTES:

ALL NEW UTILITIES SHOWN ON THIS PLAN ARE TO BE PUBLIC AND ULTIMATELY MAINTAINED BY THE CITY OF ALBUQUERQUE.
 ALL NEW RESIDENTIAL AND NON-RESIDENTIAL UNITS SHALL HAVE INDIVIDUAL PUBLIC WATER AND SEWER SERVICE PROVIDED TO EACH UNIT.

engineering

architecture

6801 Jefferson NE Suite 100 Albuquerque, NM 87109 505 761-9700 fax 761-4222 dps Odpsabq.com

ISSUED FOR EPC 06.01.04

LEGAL DESCRIPTION:

A certain tract of land being and comprising Tracts 135—B, 136—A, 136—B, 137 and 138 as the same are shown and designated on M.R.G.C.G. Map No. 38; together with Lots 5, 6, & 7 in Block 4 of HUNING CASTLE ADDITION, as the same are shown and designated on the plat thereof, filed in the office of the County Clerk of Bernalillo County, New Mexico on March 1, 1928 in Volume D1, Folio 1, being more particularly described as follows:

BEGINNING at the Northwest corner of said tract herein described, a point on the easterly


right-of-way line of San Pasquale Avenue S.W., whence ACS Control Station 13-J13 bears N 04° 28' 42" E, 433.45 feet distant; thence, leaving said Easterly right-of-way S 59° 45' 49" E, 102.60 feet; thence N 34° 24' 09" E, 245.36 feet to the most Northerly corner, a point on the Southerly right-of-way of Central Avenue; thence S 44° 52' 14" E, 26.24 feet along said Southerly right-of-way to an angle point; thence S 45° 57' 34" E, 143.46 feet along said Southerly right-of-way to the Northeast corner; thence, leaving said Southerly right—of—way S 34° 37° 21" W, 56.54 feet; thence S 24° 11' 53" W, 194.01 feet; thence S 53° 18' 43" E, 50.30 feet; thence N 83° 36' 29" E, 9.82 feet; thence S 50° 57' 57" E, 156.54 feet to the most Easterly corner of said tract herein described; thence S 34° 59' 52" W, 213.99 feet; thence N 66° 36' 18" W, 187.37 feet; thence S 11° 22' 35" W, 129.38 feet to the most Southerly corner of said tract herein described, being a point on the Northerly right-of-way of Chacoma Place S.W.; thence N 78° 37' 25" W, 190.00 feet along said Northerly right-of-way to the Southwest corner of said tract herein described, being a point on the Easterly right-of-way of San Pasquale S.W.; thence N 11° 22' 35" E, 170.00 feet along said Easterly right-of-way; thence

N 78° 37' 25" W, 4.75 feet along said Easterly right—of—way, thence N 11° 22' 35" E, 348.08 feet along said Easterly right—of—way to the point of beginning, and containing 4.4750 acres, more or less.

#### LEGEND

5064	EXISTING CONTOUR MINOR
5065	EXISTING CONTOUR MAJOR
	EXISTING CURB & GUTTER
	EXISTING INLET
•	EXISTING SANITARY SEWER MANHOLE
————EXIST SAS————	EXISTING SANITARY SEWER LINE
————EXIST WL————	EXISTING WATERLINE
M	EXISTING GATE VALVE
	EXISTING WATER SERVICE METER
-000	EXISTING FENCE
<i>•FL=36.8</i>	EXISTING FLOWLINE ELEVATION
• <i>37.6</i>	EXISTING SPOT ELEVATION
•	PROPOSED SAS MANHOLE
NEW SAS	PROPOSED SANITARY SEWER LINE
NEW WL	PROPOSED WATERLINE



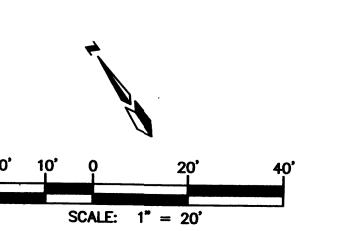

F: \A04J0BS\A4040\A4040-UT20R\10-25-04 RDQ NHE

DRAWN BY REVIEWED BY DATE 06.01.04 PROJECT NO.

CONCEPTUAL UTILITY PLAN

Housing Albuquerque

MARK GOODWIN & ASSOCIATES, P.A. CONSULTING ENGINEERS


P.O. BOX 90606
ALBUQUERQUE, NEW MEXICO 87199
(505)828-2200, FAX (505)797-9539

SHEET NO.



#### FINISH NOTES

- A. All stucco is a light tan color, similar to STO color 20512.
- B. All steel railings, balconies, gates, & window grilles are painted black, similar to Sherwin-Milliams- Black Magic- 6991.
- C. All trellis structures, and window trim are painted off-white, similar to Sherwin-Williams- Aesthetic White- 7035.
- D. All garage doors, window frames, and door frames are painted off-white, similar to Sherwin-Milliams- Aesthetic White- 7035.
- E. Metal roofing is galvanized finish.
- F. Brick coping is mottled red/brown, similar to Kinney Brick-Old Tucson Q/5.

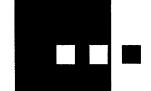

planning

architecture

interiors

6801 Jefferson NE Suite 100 Albuquerque, NM 87109 505 761-9700 fax 761-4222 dps@dpsabq.com


ARCHITECT


ISSUED FOR 10.26.04

Theater Albuquerque, Albuquerque

CG

10.26.04

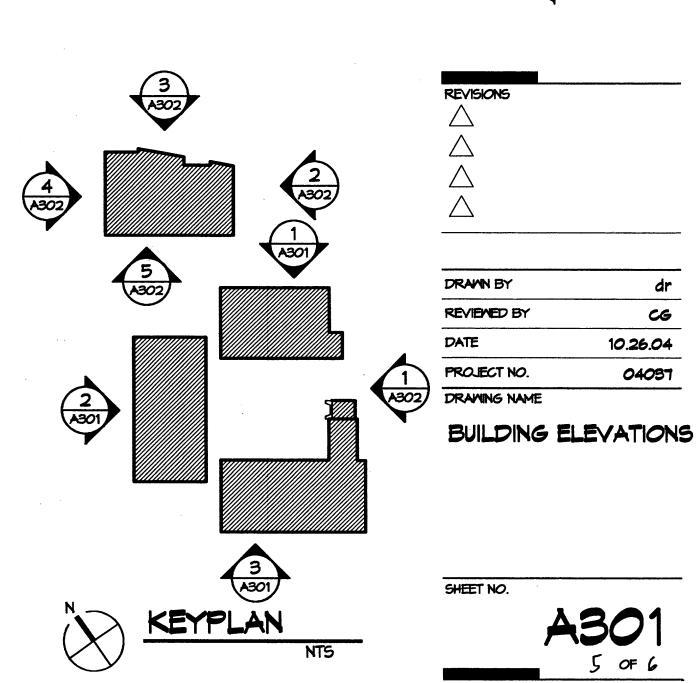

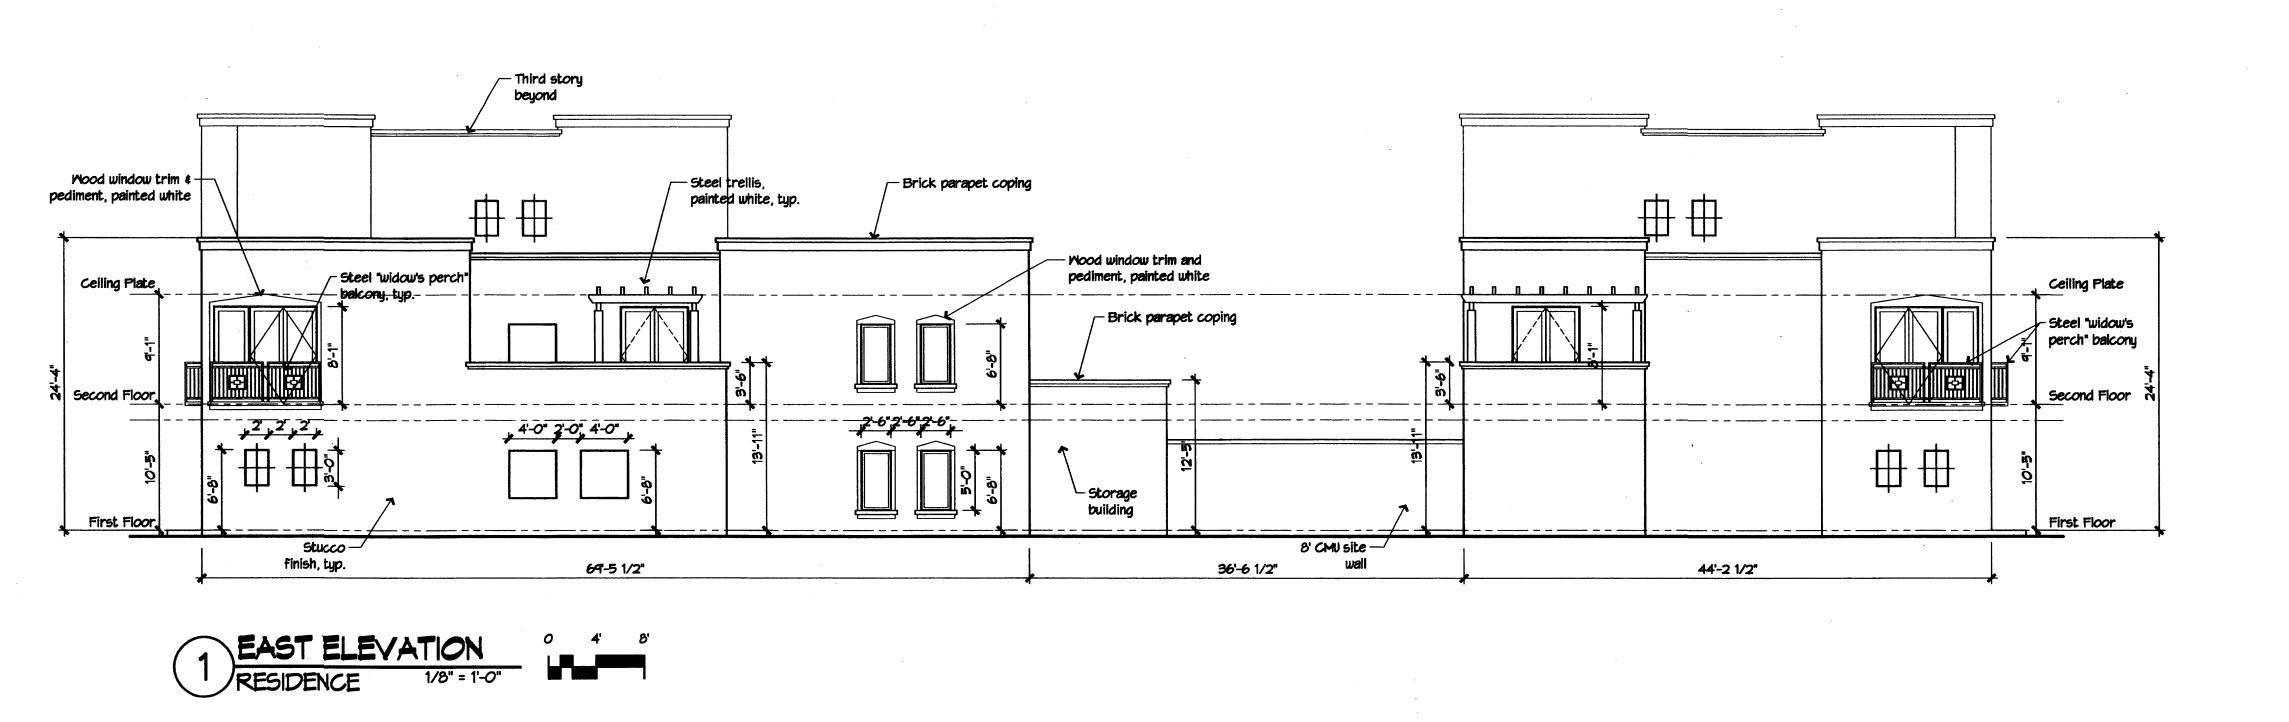



- A. All stucco is a light tan color, similar to STO color 20512.
- B. All steel railings, balconies, gates, & window grilles are painted black, similar to Sherwin-Williams-Black Magic-6991.
- C. All trellis structures, and window trim are painted off-white, similar to Sherwin-Williams- Aesthetic White- 7035.
- D. All garage doors, window frames, and door frames are painted off-white, similar to Sherwin-Williams- Aesthetic White- 7035.
- E. Metal roofing is galvanized finish.
- F. Brick coping is mottled red/oroum, similar to Kinney Brick-Old Tucson Q/5.

#### SIGNAGE NOTES

A. All signage will be internally illuminated, individual letters, channel type with acrylic face.



architecture

interiors

planning


engineering

6801 Jefferson NE Suite 100 Albuquerque, NM 87109 505 761-9700 fax 761-4222 dps@dpsabq.com

ARCHITECT


ISSUED FOR 10.26.04


The le Theater

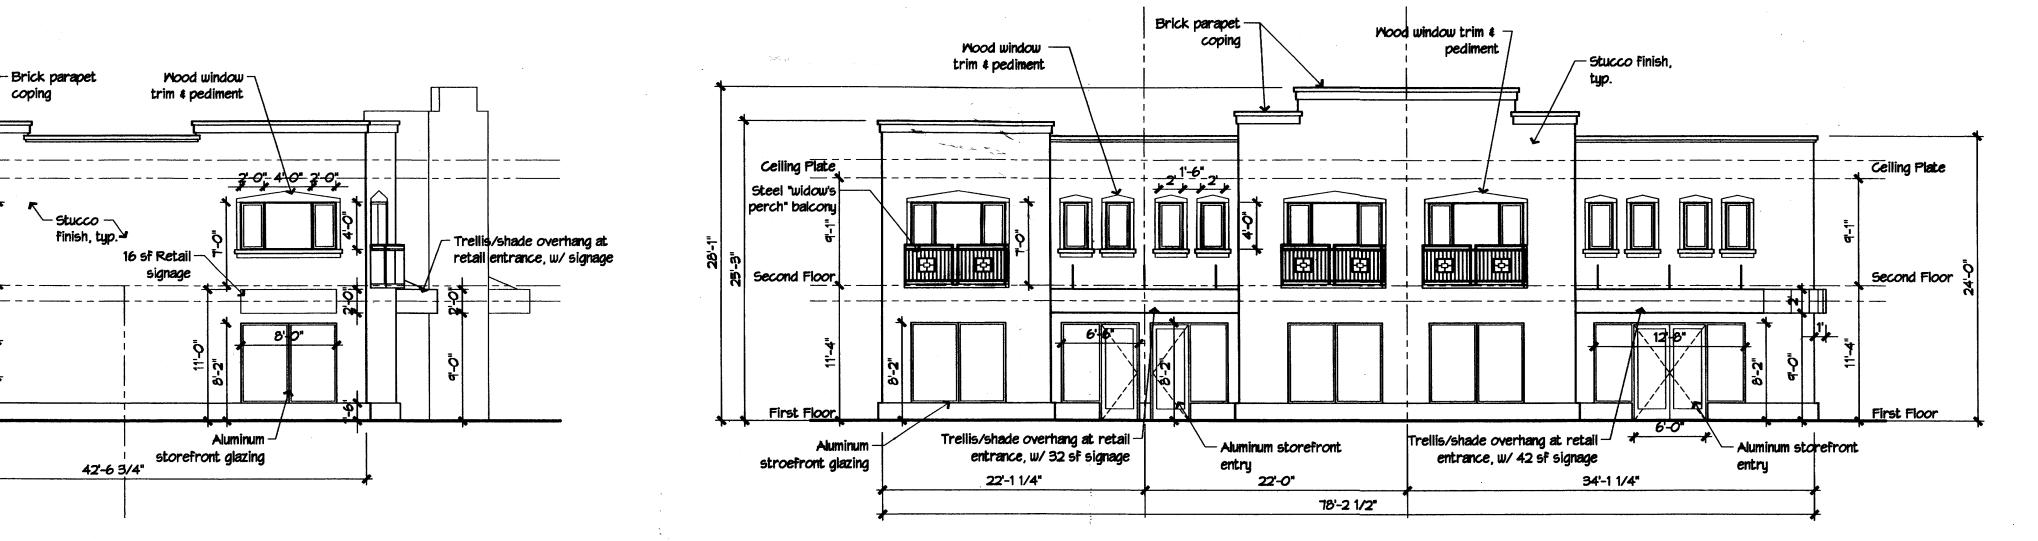


2 EAST ELEVATION 0 4' 8'
RETAIL/OFFICE 1/8" = 1'-0"

3 NORTH ELEVATION PRETAIL/OFFICE 1/8" = 1'-0"

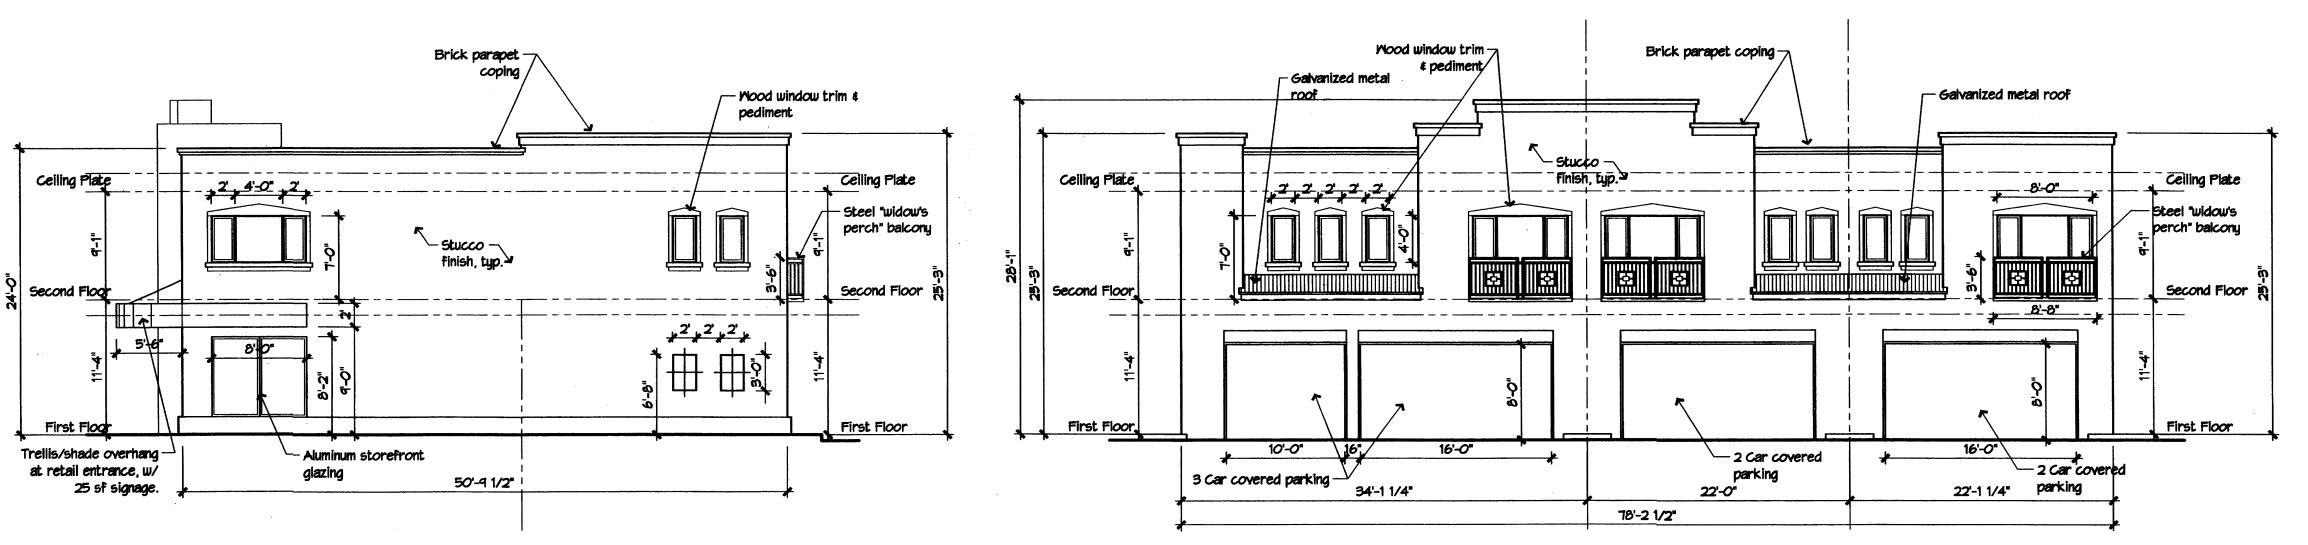

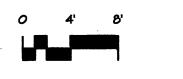

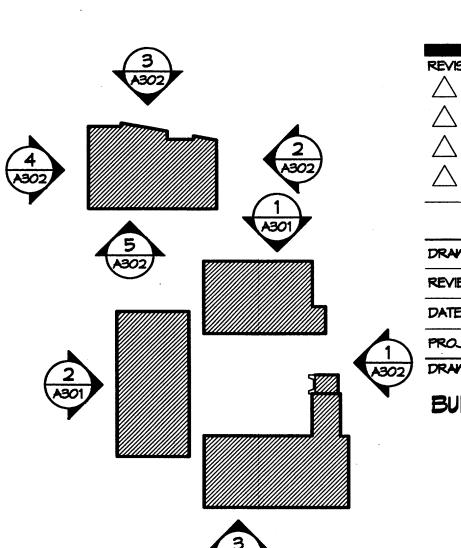

DRAWN BY REVIEWED BY 10.26.04 PROJECT NO. DRAWING NAME

BUILDING ELEVATIONS

SHEET NO.