
PASEO DEL NORTE

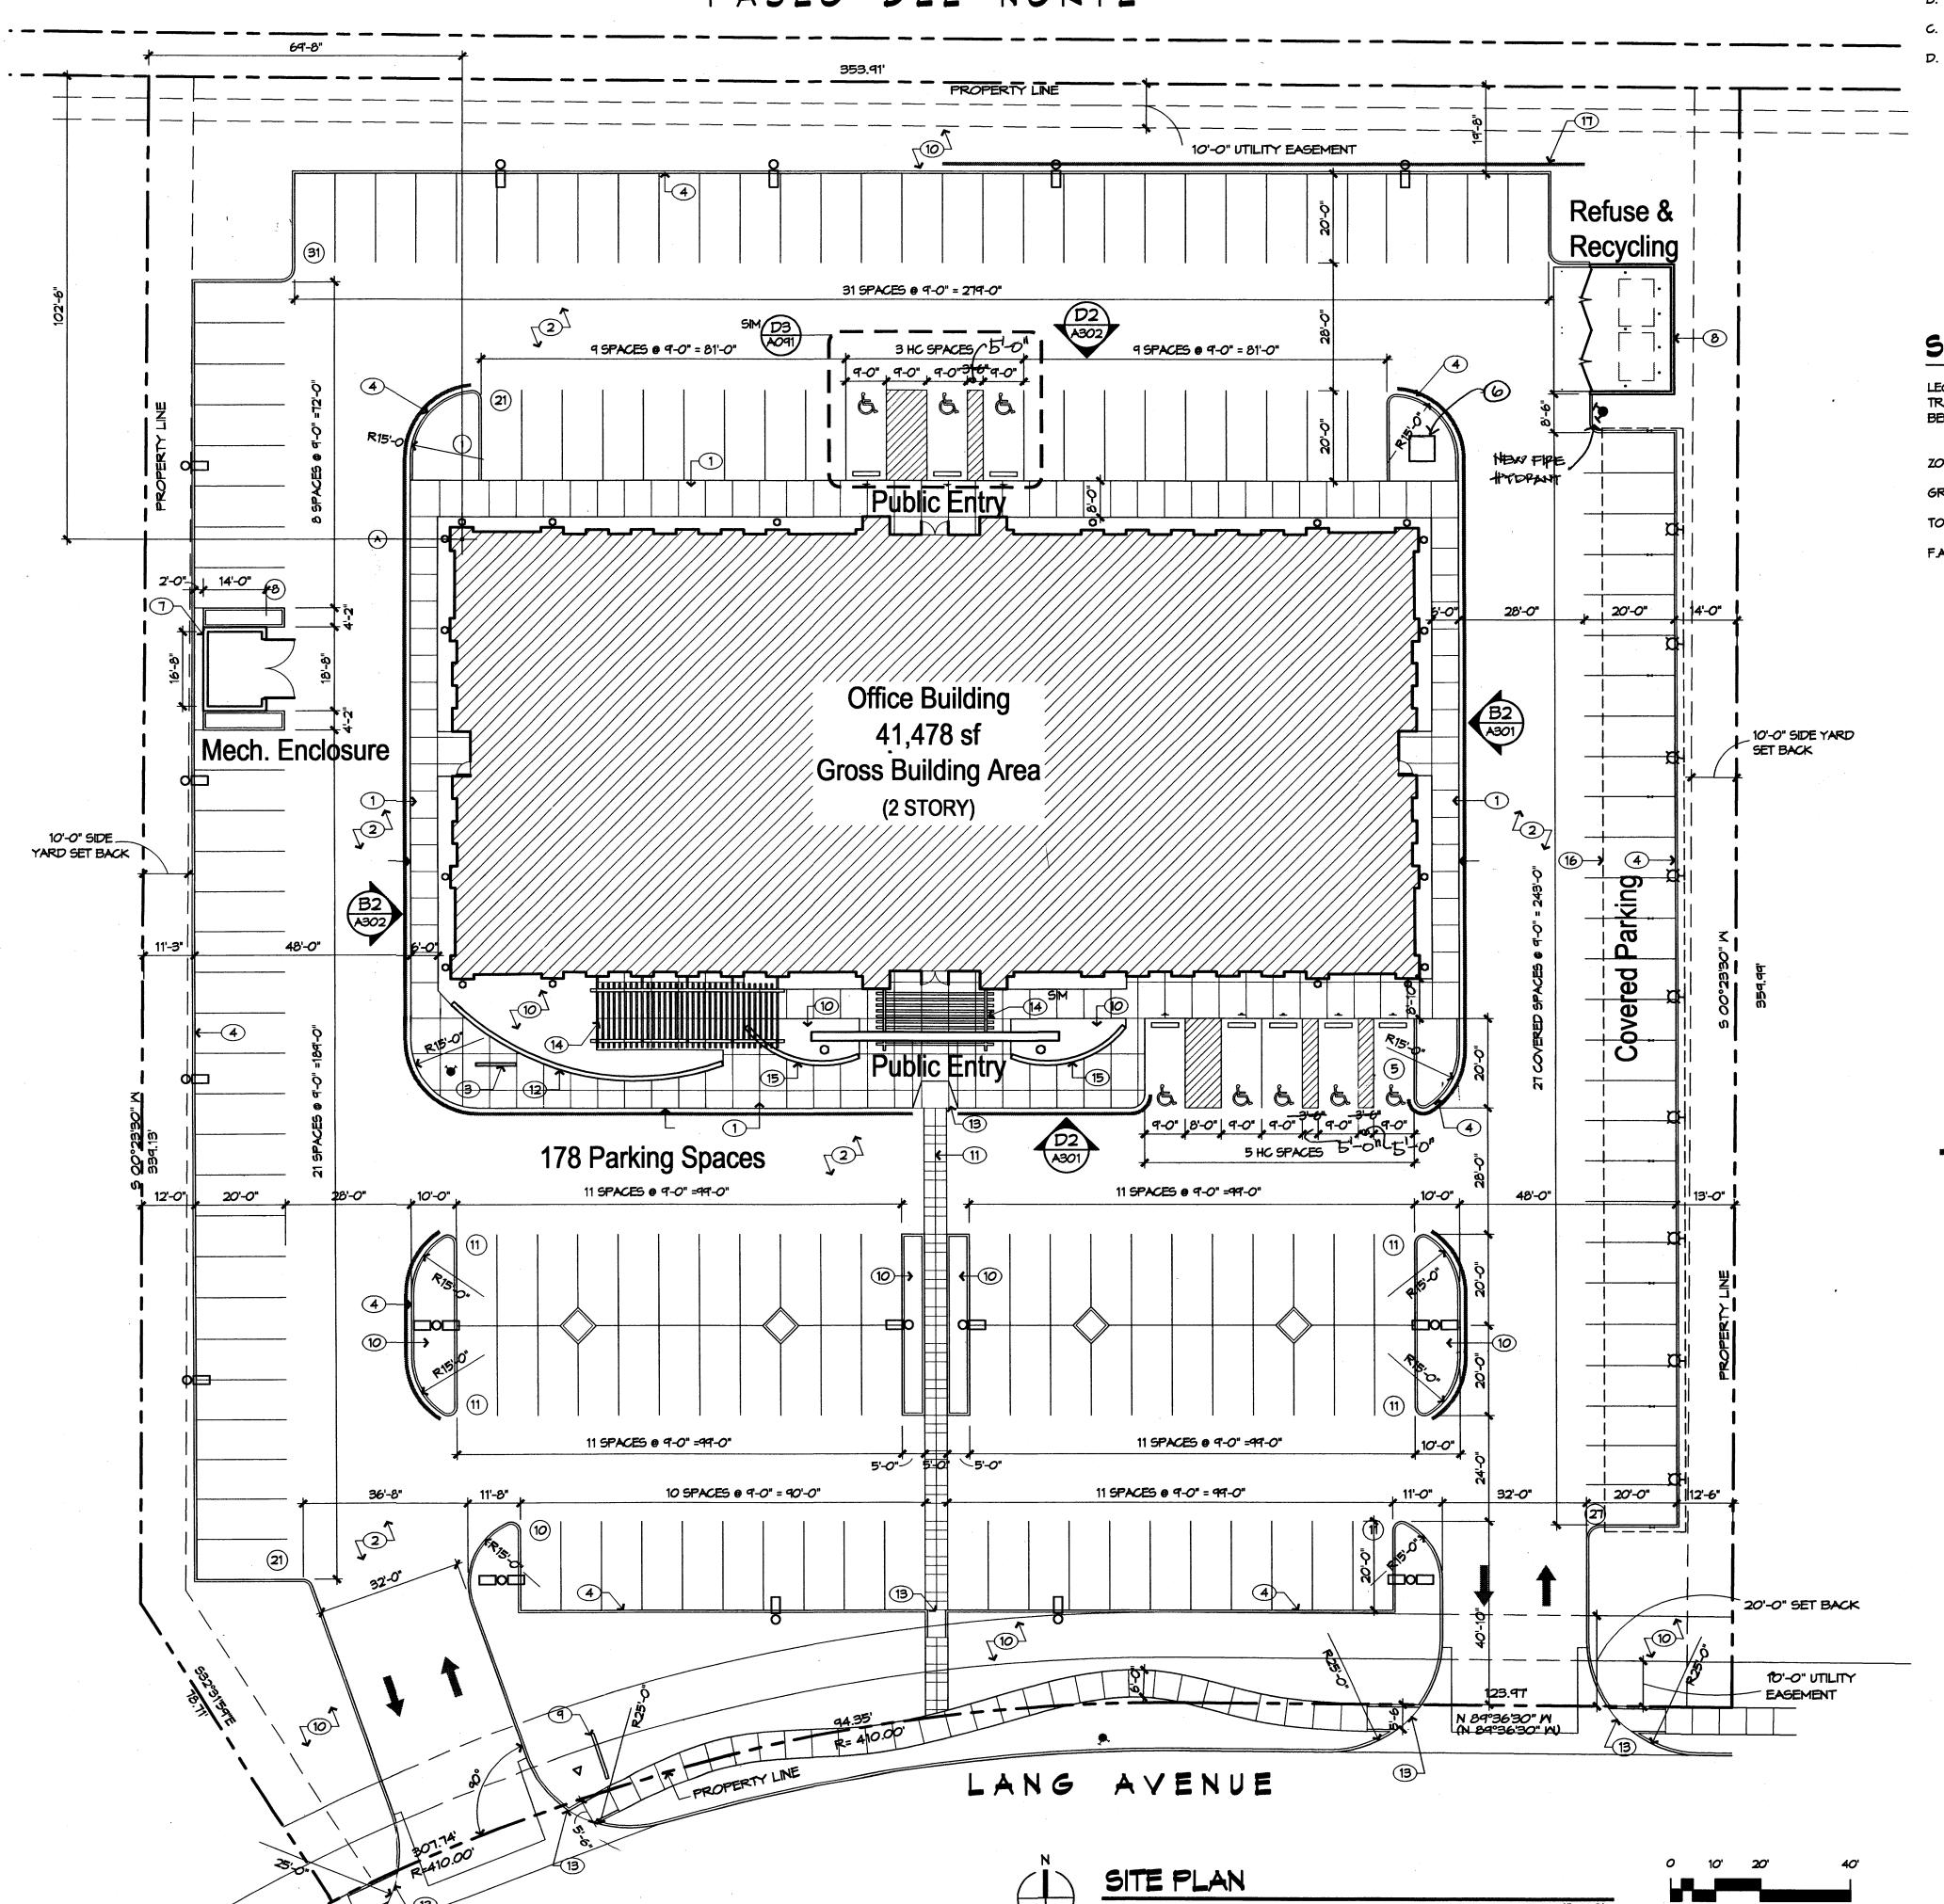

GENERAL NOTES

- A. PARKING AREA SHALL BE DESIGNED & BUILT TO CURRENT DPM STANDARDS
- B. REFER TO SHEET LOO1 FOR LANDSCAPE
- DESIGN AND INFORMATION C. REFER TO SHEETS C101 FOR GRADING AND
- DRAINAGE DESIGN AND INFORMATION
- REFER TO SHEET A301 & A302 FOR ADDITIONAL BUILDING LIGHTING INFORMATION

KEYED NOTES

- 1. SIDEMALK, CONCRETE
- 2. PAVING, ASPHALT 3. BICYCLE RACK, PIANT, (5) BICYCLES, RE: B3/A091
- 4. CURB, 6" HIGH, CONCRETE 5. CURB W GUTTER, 6" HIGH, CONCRETE (NOT USESD)
- 6. TRANSFORMER SCREEN WALL 15'-4" HIGH, 2-COAT STUCCO SYSTEM OVER 12" CMU, COLOR TO MATCH BUILDING
- 8. SCREEN WALL, 6'-O" HIGH, 2-COAT STUCCO SYSTEM OVER 8" CMU, COLOR TO MATCH BUILDING, RE: A1/A091
- MONUMENT SIGN, RE: A2/A091
- 10. LANDSCAPE AREA, RE: LOO1
- 11. INTEGRALLY COLORED CONCRETE, PEDESTRIAN PATH 12. SCREEN WALL, 4'-0" HIGH WV 8" CAP BLOCK. STONE VENEER OVER 8"
- CMU. RADIUS = 56'-11" 13. HC RAMP, RE. A4/A091
- 14. STEEL TRELLIS, COLOR TO MATCH GALVALUM FINISH
- 15. SCREEN WALL, 1'-4" HIGH W/8" CAP BLOCK. STONE VENEER OVER 8" CMU, RADIUS = 21'-0"
- 16. STEEL PARKING CANOPY W/ ALUMINUM PANEL, GALVALUM FINISH, DECK RE; B2/A091
- 17. RETAINING WALL, RE. C1/A091, C101 FOR ELEVATION.

SITE INFORMATION

TRACT1A-2-A-2 IN JOURNAL CENTER, ALBUQUERQUE, BERNALILLO COUNTY, NEW MEXICO

ZONE: IP INDUSTRIAL PARK

LEGEND

GROSS BUILDING SQUARE FOOTAGE: 41,478 SF

TOAL SITE AREA: 130,680 SF / 3.0 ACRES

F.A.R.: 0.317

PARKING INFORMATION

OFFICES: NET LEASABLE SF/ 200 (1ST FL)AND 300 (2ND FL)

FIRST FLOOR: 20,070 SF/ 200 = 101 SECOND FLOOR: 19,078 SF/ 300 = 64

TOTAL SPACES REQUIRED: 165 (INCLUDING 8 ACCESSIBLE SPACES

MITH 4 VAN ACCESSIBLE)

TOTAL SPACES PROVIDED: 178 (INCLUDING 8 ACCESSIBLE SPACES WITH 4 VAN ACCESSIBLE)

COMPACT SPACES: NONE PROVIDED BICYCLE REQUIREMENTS: 165/20 = 9 BICYCLE SPACES PROVIDED = 10

- PROJECT LOCATION

EXISTING FIRE HYDRANT

NEW FIRE HYDRANT, RE. C101

XX) PARKING SPACE COUNT

LIGHT POLE - DOUBLE HEAD, RE. D2/A091

LIGHT POLE - SINGLE HEAD RE. D2/A091

TH SURFACE MOUNTED LIGHT

FIXTURE, RE. D1/A091


▼ FLOOD LIGHT, RE. D1/A091

O UP LIGHT, RE. D1/A091

PAINT WHITE

PAINT CURB RED, & PAINT TEXT "FIRE LANE NO PARKING"

SCALE: 1" = 20'-0"

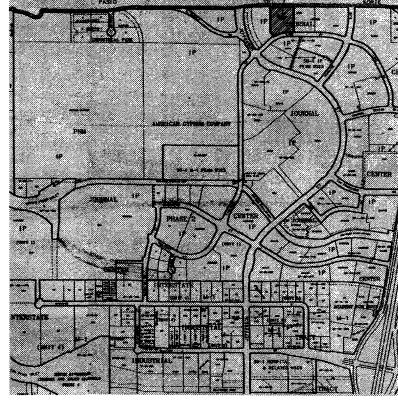


ZONE ATLAS MAP

1003184 PROJECT NUMBER: APPLICATION NUMBER: 04-00656

This plan is consistent with the specific Site Development plan approved by the Environmental Planning Commission (EPC), dated _____ Conditions in the Official Notification of decision are satisfied.

Is an Infrastructure List required? Yes () No If yes, then a set of approved DRC plans with a work order is required for any construction within Public Right-of-Way or for construction of public improvements.

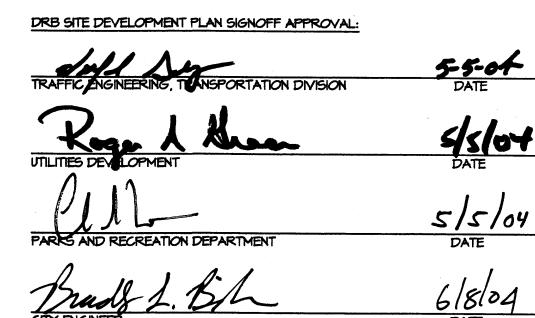

* ENVIRONMENTAL HEALTH DEPARTMENT (CONDITIONAL) DATE

Michael Holton SOLID WASTE MANAGEMENT DRB CHAIRPERSON, PLANNING DEPARTME

5-4-04 DATE

0 500 1000

architecture

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Albuquerque, NM

505 761-9700

fax 761-4222 dps@dpsabq.com

Suite 100

DRAWN BY REVIEWED BY DATE 04/27/04 PROJECT NO. 04040

DRAWING NAME Site Development Plan for Building Permit

SHEET NO.

* Environmental Health, If necessary

TYPICAL VALLEY GUTTER SECTION

CONCRETE FOR ALL VALLEY GUTTERS WILL HAVE A MINIMUM

COMPRESSIVE STRENGTH OF 3500 PSI IN 24 HOURS.

6. THE CONTRACTOR IS TO ENSURE THAT NO SOIL ERODES FROM THE SITE ONTO ADJACENT PROPERTY OR PUBLIC RIGHT-OF-WAY. THIS SHOULD BE ACHIEVED BY CONSTRUCTING

7. A DISPOSAL SITE FOR ANY & ALL EXCESS EXCAVATION MATERIAL, AND UNSUITABLE MATERIAL AND/OR A BORROW SITE CONTAINING ACCEPTABLE FILL MATERIAL SHALL BE

OR BORROW SITE AND HAUL TO OR FROM SHALL BE CONSIDERED INCIDENTAL TO THE PROJECT AND NO SEPARATE MEASUREMENT OR PAYMENT SHALL BE MADE.

8. PAVING AND ROADWAY GRADES SHALL BE +/- 0.1' FROM PLAN ELEVATIONS. PAD ELEVATION SHALL BE +/- 0.05' FROM BUILDING PLAN ELEVATION.

9. ALL PROPOSED CONTOURS REFLECT TOP OF PAVEMENT ELEVATIONS IN THE PARKING AREA AND MUST BE ADJUSTED FOR MEDIANS AND ISLANDS.

10. VERIFY ALL ELEVATIONS SHOWN ON PLAN FROM BASIS OF ELEVATION CONTROL STATION PRIOR TO BEGINNING SONSTRUCTION.

OBTAINED BY THE CONTRACTOR IN COMPLIANCE WITH APPLICABLE ENVIRONMENTAL REGULATIONS AND APPROVED BY THE OBSERVER. ALL COSTS INCURRED IN OBTAINING A DISPOSAL

TEMPORARY BERMS AT THE PROPERTY LINES AND WETTING THE SOIL TO PROTECT IT FROM WIND EROSION.

LEGEND

PROPERTY LINE

EXISTING CONTOURS EXISTING GROUND SPOT ELEVATION EXISITNG ELECTRICAL POLE PROPOSED SPOT ELEVATION TC=TOP OF CURB, FL=FLOW LINE TW=TOP OF WALL, BW=BOTTOM OF WALL EXISTING SPOT ELEVATION S=2.0% PROPOSED DIRECTION OF FLOW **** WATER BLOCK PROPOSED RETAINING WALL PROPOSED INDEX CONTOURS PROPOSED INTER CONTOURS PROPOSED CURB & CUTTER EASEMENT EXISITNG TREE PROPOSED LIGHTING PROPOSED STORM DRAIN LINE PROPOSED STORM DRAIN MANHOLE PROPOSED STORM DRAIN INLET

GRADING KEYED NOTES

- 1) PROVIDE OPENING IN WALL FOR DRAINAGE.
- (2) SIDEWALK TO BE FLUSH WITH ASHPALT.
- (3) INSTALL TYPE 'D' INLET PER COA STD. DWG. 2206
- (4) THE 18" TYPE HI RCP STORM DRAIN TO EXISTING 18" STUB OUT. PROVIDE 19.03LF AT 1.0% SLOPE TO NEW TYPE 'D' INLET.

EXISTING STORM DRAIN MANHOLE

- (5) INSTALL 4" PVC AT 0.5% SLOPE UNDER SIDEWALK
- (6) INSTALL CONCRETE VALLEY GUTTER PER DETAIL THIS

Bohannan A Huston

ENGINEERING . SPATIAL DATA . ADVANCED TECHNOLOGIES



VICINITY MAP ZONE ATLAS No.

LEGAL DESCRIPTION

PLAT OF TRACTS 1A-2-A-1, 1A-2-A-2 AND 1A-2-A-3 JOURNAL CENTER TRACT 1A-2-A-2

BENCHMARK

ACS 1 3/4" ALUMINUM DISK, STAMPED "ACS BM, 14-C17, EPOXIED TO TOP OF CONCRETE BASE OF TRAFFIC LIGHT STANCHION, N.E. QUADRANT OF PASEO DEL NORTE & JEFFERSON ST. N.E., ON THE N.E. CORNER OF SAID CONCRETE BASE.


6801 Jefferson HE Albuquerque, NM 87109 505 761-9700 fex 761-4222

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engineering

ARCHITECT



PROJECT

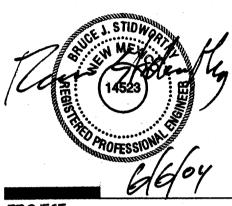GENERAL NOTES

- 3. PRIOR TO CONSTRUCTION, THE CONTRACTOR SHALL FIELD VERIFY THE HORIZONTAL AND VERTICAL LOCATIONS OF ALL POTENTIAL OBSTRUCTIONS INCLUDING ALL UNDERGROUND UTILITIES. SHOULD A CONFLICT EXIST, THE CONTRACTOR SHALL NOTIFY THE CONSTRUCTION OBSERVER OR ENGINEER SO THAT THE CONFLICT CAN BE RESOLVED
- 4. TWO (2) WORKING DAYS PRIOR TO ANY EXCAVATION, THE CONTRACTOR SHALL CONTACT LINE LOCATING SERVICE FOR LOCATION OF EXISTING UTILITIES.
- 5. ALL ELECTRICAL, TELEPHONE, CABLE TV, GAS AND OTHER UTILITY LINES, CABLES, AND APPURTENANCES ENCOUNTERED DURING CONSTRUCTION THAT REQUIRE RELOCATION, SHALL BE COORDINATED WITH THAT UTILITY. THE CONTRACTOR SHALL BE RESPONSIBLE FOR COORDINATION OF ALL NECESSARY UTILITY ADJUSTMENTS. NO ADDITIONAL COMPENSATION WILL BE ALLOWED FOR DELAYS OR INCONVENIENCES CAUSED BY UTILITY COMPANY WORK CREWS. THE CONTRACTOR MAY BE REQUIRED TO RESCHEDULE HIS ACTIVITIES TO ALLOW UTILITY CREWS TO PERFORM
- AREA. ANY DAMAGE TO EXISTING FACILITIES CAUSED BY CONSTRUCTION ACTIVITY SHALL BE REPAIRED OR REPLACED AT THE CONTRACTOR'S EXPENSE AND APPROVED BY THE CONSTRUCTION OBSERVER.
- 7. CONSTRUCTION ACTIVITY SHALL BE LIMITED TO THE PROPERTY AND/OR PROJECT LIMITS. ANY DAMAGE TO ADJACENT PROPERTIES RESULTING FROM THE CONSTRUCTION PROCESS SHALL BE REPAIRED OR REPLACED AT THE
- 8. OVERNIGHT PARKING OF CONSTRUCTION EQUIPMENT SHALL NOT OBSTRUCT DRIVEWAYS OR DESIGNATED TRAFFIC LANES. THE CONTRACTOR SHALL NOT STORE ANY EQUIPMENT OR MATERIAL WITHIN THE PUBLIC RIGHT-OF-WAY.
- CONSTRUCTION (I.E., BARRICADING, TOPSOIL DISTURBANCE, EXCAVATION PERMITS, EPA STORM WATER PERMITS, ETC.).

- 14. THE CONTRACTOR SHALL TAKE ALL STEPS NECESSARY TO CONFORM WITH EPA REQUIREMENTS, INCLUDING COMPLIANCE WITH NPDES PHASE 2 REQUIREMENTS.


REVISIONS

DRAWN BY	RPS
REVIEWED BY	BJS
DATE	06/07/04
PROJECT NO.	040378
DRAWING NAME	

GRADING AND DRAINAGE PLAN

SHEET NO.

- 1. ALL WORK DETAILED ON THESE PLANS AND PERFORMED UNDER THIS CONTRACT SHALL BE CONSTRUCTED IN ACCORDANCE WITH THE PROJECT SPECIFICATIONS AND THE PROJECT GEOTECHNICAL REPORT. WHERE APPLICABLE, CITY OF ALBUQUERQUE PUBLIC WORKS STANDARDS SHALL APPLY.
- 2. THE CONTRACTOR SHALL ABIDE BY ALL LOCAL, STATE, AND FEDERAL LAWS, RULES AND REGULATIONS WHICH APPLY TO THE CONSTRUCTION OF THESE IMPROVEMENTS, INCLUDING EPA REQUIREMENTS WITH RESPECT TO STORM WATER DISCHARGE.
- WITH A MINIMUM AMOUNT OF DELAY.
- THEIR REQUIRED WORK.
- 6. THE CONTRACTOR IS RESPONSIBLE FOR PROTECTING ALL EXISTING UTILITY LINES WITHIN THE CONSTRUCTION
- CONTRACTOR'S EXPENSE.
- 9. THE CONTRACTOR SHALL OBTAIN ALL THE NECESSARY PERMITS FOR THE PROJECT PRIOR TO COMMENCING
- 10. ALL PROPERTY CORNERS DESTROYED DURING CONSTRUCTION SHALL BE REPLACED AT THE CONTRACTOR'S EXPENSE. ALL PROPERTY CORNERS MUST BE RESET BY A REGISTERED LAND SURVEYOR.
- 11. THE CONTRACTOR SHALL PREPARE A CONSTRUCTION TRAFFIC CONTROL AND SIGNING PLAN AND OBTAIN APPROVAL OF SUCH PLAN FROM THE CITY OF ALBUQUERQUE, TRAFFIC ENGINEERING DEPARTMENT, PRIOR TO BEGINNING ANY CONSTRUCTION WORK ON OR ADJACENT TO EXISTING STREETS.
- 12. ALL BARRICADES AND CONSTRUCTION SIGNING SHALL CONFORM TO APPLICABLE SECTIONS OF THE "MANUAL ON UNIFORM TRAFFIC CONTROL DEVICES" (MUTCD), US DEPARTMENT OF TRANSPORTATION, LATEST EDITION.
- 13. THE CONTRACTOR SHALL MAINTAIN ALL CONSTRUCTION BARRICADES AND SIGNING AT ALL TIMES. THE CONTRACTOR SHALL VERIFY THE PROPER LOCATION OF ALL BARRICADING AT THE END AND BEGINNING OF EACH

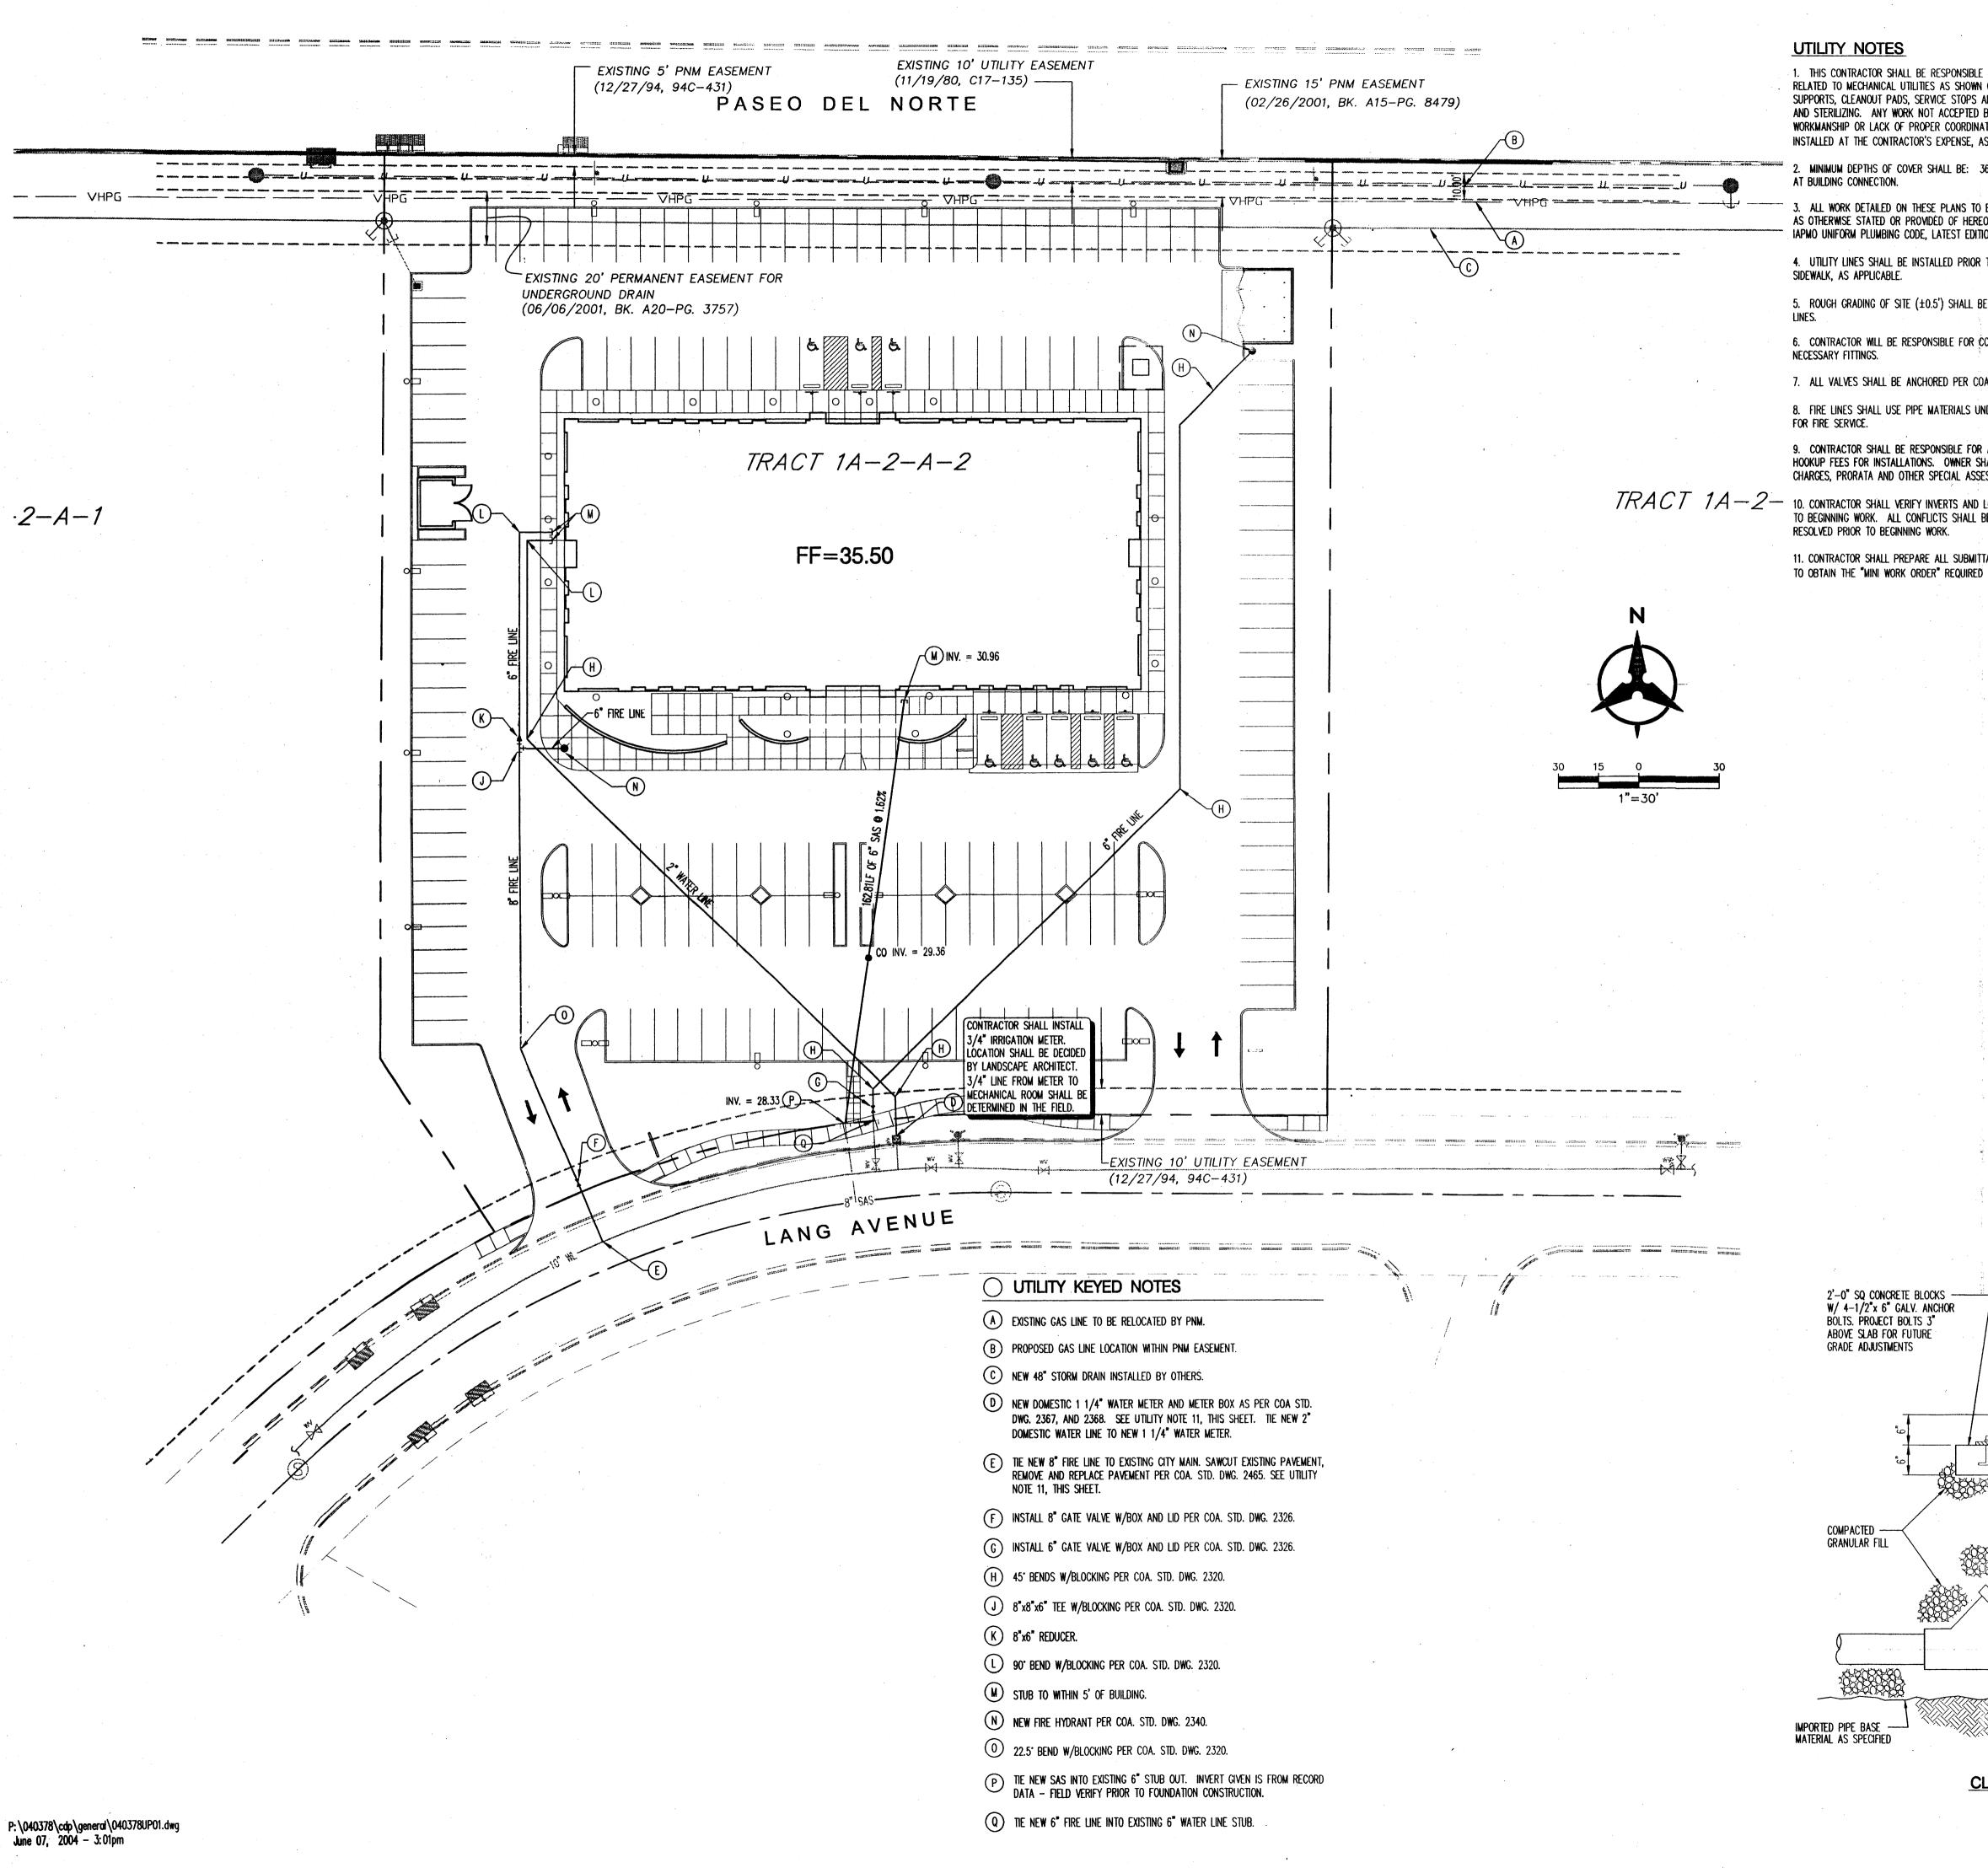

UTILITY NOTES

1. THIS CONTRACTOR SHALL BE RESPONSIBLE FOR THE COMPLETE INSTALLATION OF ALL WORK RELATED TO MECHANICAL UTILITIES AS SHOWN ON THIS PLAN INCLUDING: TRENCHING, BACKFILL, SUPPORTS. CLEANOUT PADS, SERVICE STOPS AND BOXES, SERVICE LINES, TESTING, CLEANING, AND STERILIZING. ANY WORK NOT ACCEPTED BY THE ARCHITECT OR ENGINEER DUE TO IMPROPER WORKMANSHIP OR LACK OF PROPER COORDINATION SHALL BE REMOVED AND CORRECTLY INSTALLED AT THE CONTRACTOR'S EXPENSE, AS DIRECTED.

. MINIMUM DEPTHS OF COVER SHALL BE: 36" FOR WATERLINES AND 48" FOR SEWER, EXCEPT AT BUILDING CONNECTION.

3. ALL WORK DETAILED ON THESE PLANS TO BE PERFORMED UNDER CONTRACT SHALL, EXCEPT AS OTHERWISE STATED OR PROVIDED OF HEREON, BE CONSTRUCTED IN ACCORDANCE WITH THE IAPMO UNIFORM PLUMBING CODE, LATEST EDITION.

4. UTILITY LINES SHALL BE INSTALLED PRIOR TO PAVEMENT, CURB AND GUTTER, AND/OR SIDEWALK, AS APPLICABLE.

5. ROUGH GRADING OF SITE (± 0.5) Shall be completed prior to installation of utility

6. CONTRACTOR WILL BE RESPONSIBLE FOR CONNECTIONS TO BUILDING DRAIN LINES AND ALL NECESSARY FITTINGS.

7. ALL VALVES SHALL BE ANCHORED PER COA STANDARD DWG. 2333.

8. FIRE LINES SHALL USE PIPE MATERIALS UNDERWRITERS LABORATORIES LISTED AND APPROVED FOR FIRE SERVICE.

9. CONTRACTOR SHALL BE RESPONSIBLE FOR ALL WATER METER, FIRE LINE, AND SEWER HOOKUP FEES FOR INSTALLATIONS. OWNER SHALL BE RESPONSIBLE FOR UTILITY EXPANSION CHARGES, PRORATA AND OTHER SPECIAL ASSESSMENTS.

TRACT 1A-2- 10. Contractor shall verify inverts and locations of existing water/sas lines prior TO BEGINNING WORK. ALL CONFLICTS SHALL BE BROUGHT TO ATTENTION OF THE ENGINEER AND RESOLVED PRIOR TO BEGINNING WORK.

> 11. CONTRACTOR SHALL PREPARE ALL SUBMITTAL MATERIALS & PAY APPLICABLE FEES REQUIRED TO OBTAIN THE "MINI WORK ORDER" REQUIRED TO TAP THE EXISTING CITY WATER MAIN.

Bohannan A Hustong

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6801 Jefferson NE Suite 100 Albuquerque, NM 87109 505 761-9700 fax 761-4222

dp: Odp:abq.com

ARCHITECT

LEGAL DESCRIPTION

VICINITY MAP

ZONE ATLAS No.

PLAT OF TRACTS 1A-2-A-1, 1A-2-A-2 AND 1A-2-A-3
JOURNAL CENTER TRACT 1A-2-A-2

LEGEND

---5301------EXISTING CONTOURS χ 5301.15 Existing ground spot elevation

> EXISITNG ELECTRICAL POLE PROPOSED SPOT ELEVATION

TC=TOP OF CURB, FL=FLOW LINE TW=TOP OF WALL, BW=BOTTOM OF WALL EX=EXISTING, TG=TOP OF GRADE

PROPOSED DIRECTION OF FLOW

^ WATER BLOCK PROPOSED RETAINING WALL


S=2.0%

PROPOSED INDEX CONTOURS PROPOSED INTER CONTOURS PROPOSED CURB & GUTTER

EASEMENT EXISITNG TREE

PROPOSED LIGHTING PROPOSED STORM DRAIN LINE PROPOSED STORM DRAIN MANHOLE

PROPOSED STORM DRAIN INLET EXISTING STORM DRAIN MANHOLE

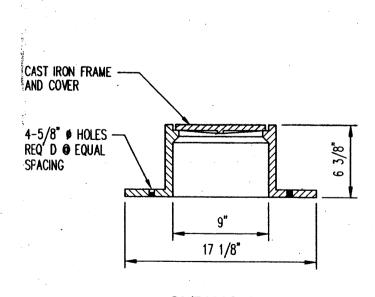

CLEANOUT FRAME & COVER N.T.S.

AFD Plans Checking Office 924-3611 HYDRANTS ONLY Hydrants shall be installed prior to construction APPROVED DISAPPROVED Signature & Date

REVISIONS DRAWN BY RP5

REVIEWED BY BJS DATE 06/07/04 PROJECT NO. 040378 DRAWING NAME

UTILITY PLAN

SHEET NO.

— FINISH GRADE COMPACTED -GRANULAR FILL -PLUG OR ADAPTER TO SERVICE CONN. PIPE AS REQUIRED 400000E

- CLEANOUT FRAME AND COVER AS SPECIFIED. SEE DETAIL

- WATERTIGHT PIPE

- 3" Thru 8" Service

CONNECTION PIPE


IF REQUIRED

CLEANOUT



6801 Jefferson NE Suite 100 Albuquerque, NM 87109 505761-9700 fax 761-4222 dps@dpsabq.com

ARCHITECT

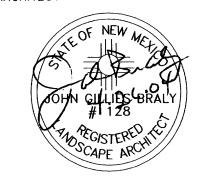

ENGINEER

ouquerque nittal Set Ave. NE Alba DRB Submi


REVISIONS

DRAWN BY	RL
REVIEWED BY	JB
DATE	4-27-04
PROJECT NO.	03094

DRAWING NAME

Landscape Plan

SHEET NO.

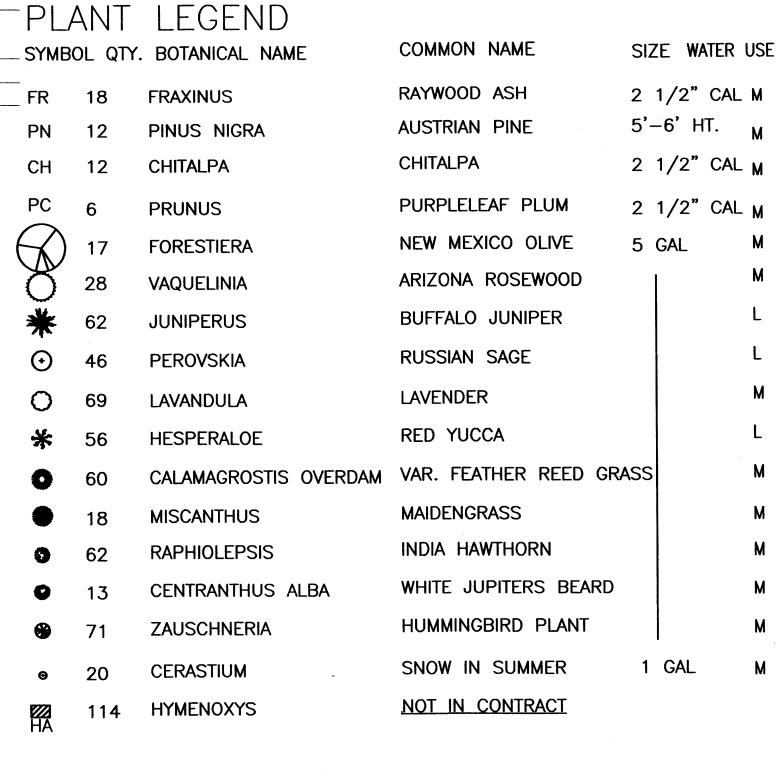

SITE DATA 16,454 SF REQUIRED LANDSCAPE 15% OF NET LOT AREA PROPOSED LANDSCAPE 32,579 SF PERCENT OF NET LOT AREA HIGH WATER USE TURF
MAX. 20% OF LANDSCAPE AREA 0 SF 0 SF PROPOSED HIGH WATER USE TURF PERCENT OF LANDSCAPE AREA

PLANTING RESTRICTIONS APPROACH A MINIMUM OF 80% OF THE PLANTINGS TO BE

LOW OR MEDIUM WATER USE PLANTS A MAXIMUM OF 20% OF THE LANDSCAPE AREA TO BE HIGH WATER USE TURF

NOTE

MAINTENANCE OF LANDSCAPE PROVIDED BY OWNER

PLANTINGS TO BE WATERED BY AUTO. DRIP IRRIGATION SYSTEM

WATER MANAGEMENT IS THE SOLE RESPONSIBILITY OF THE PROPERTY OWNER

THIS PLAN IS TO COMPLY WITH C.O.A. LANDSCAPE AND WATER WASTE ORDINANCE PLANTING RESTRICTIONS APPROACH

IT IS THE INTENT OF THIS PLAN TO PROVIDE MIN. 75% LIVE GROUNDCOVER OF LANDSCAPE AREAS AT MATURITY


LANDSCAPE AREAS TO BE MULCHED WITH SANTA FE BROWN CRUSHER FINES AT 2"-3" DEPTH OVER FILTER FABRIC


APPROVAL OF THE LANDSCAPE PLAN DOES NOT CONSTITUTE OR IMPLY COMPLIANCE WITH, OR EXEMPTION FROM, THE C.O.A LANDSCAPE AND WATER WASTE ORDINANCE

TREES ARE NOT TO BE PLACED IN PUBLIC UTILITY EASEMENTS

NO PARKING SPACE SHALL BE MORE THEN 100' FROM A TREE.

> LANDSCAPE CONTRACTORS 7525 SECOND ST. NW ALBUQUERQUE, NM (505) 898-9615 LICENSE 18890 www.headsuplandscape.com

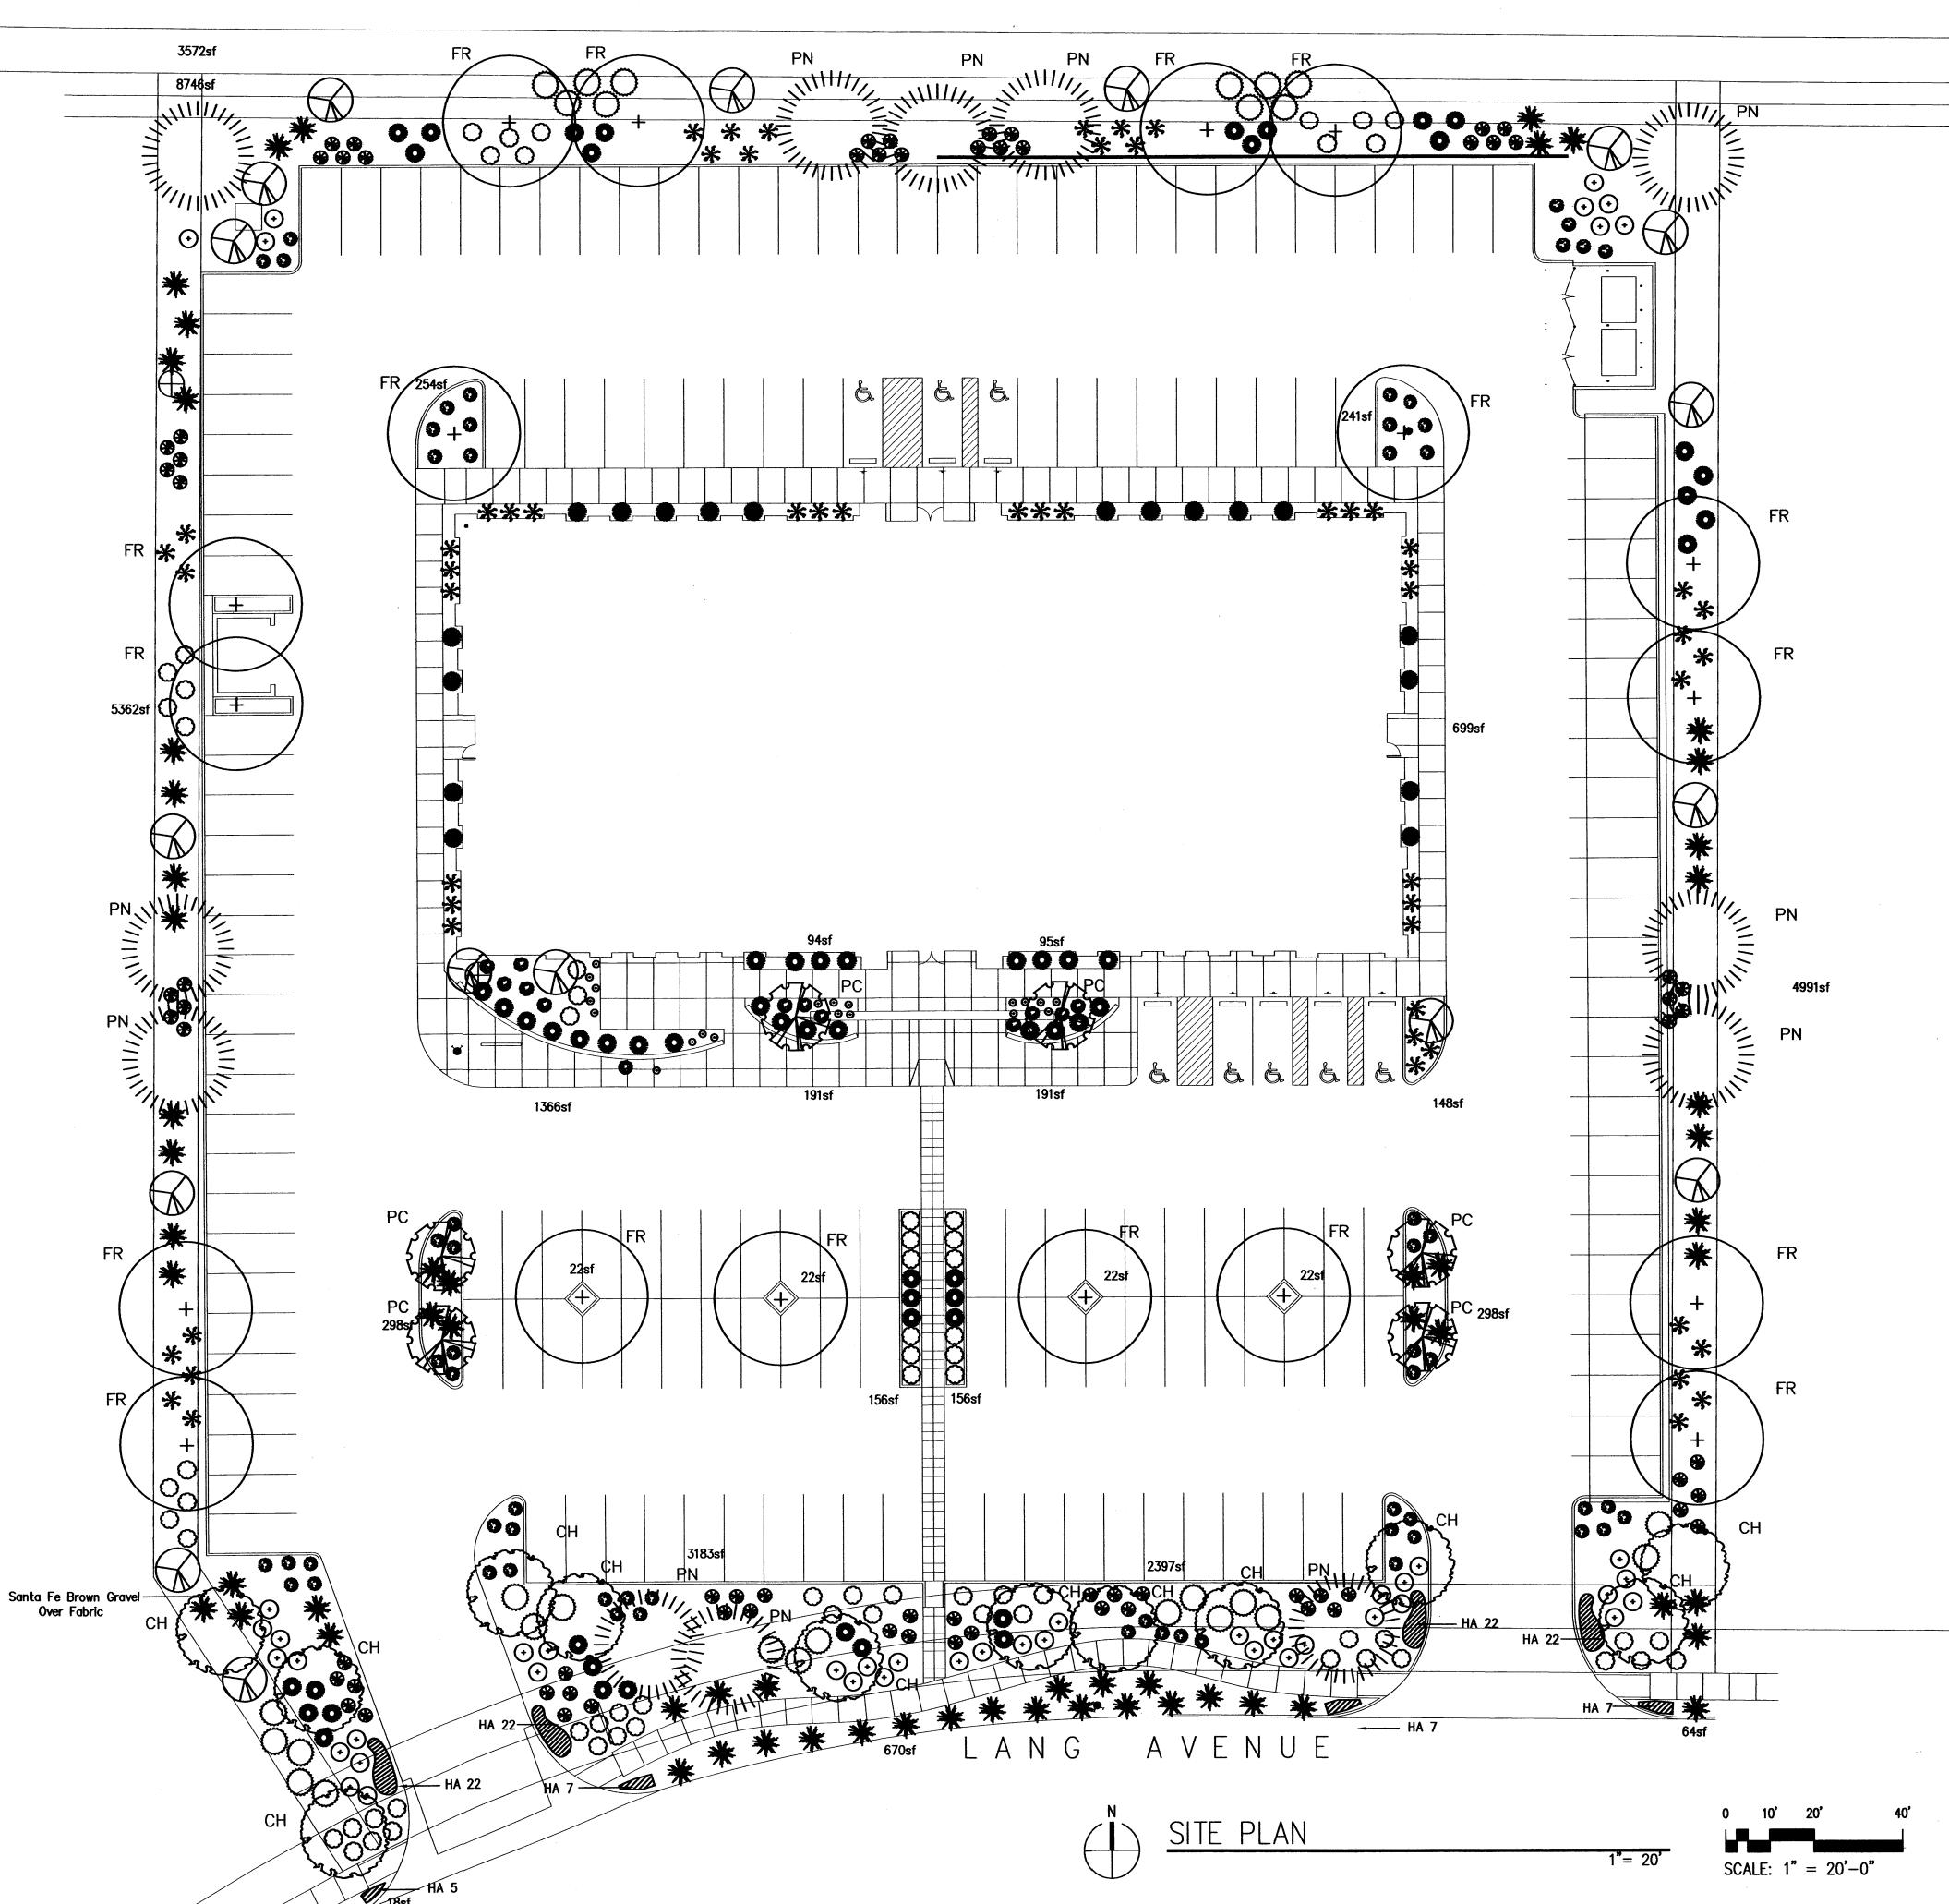

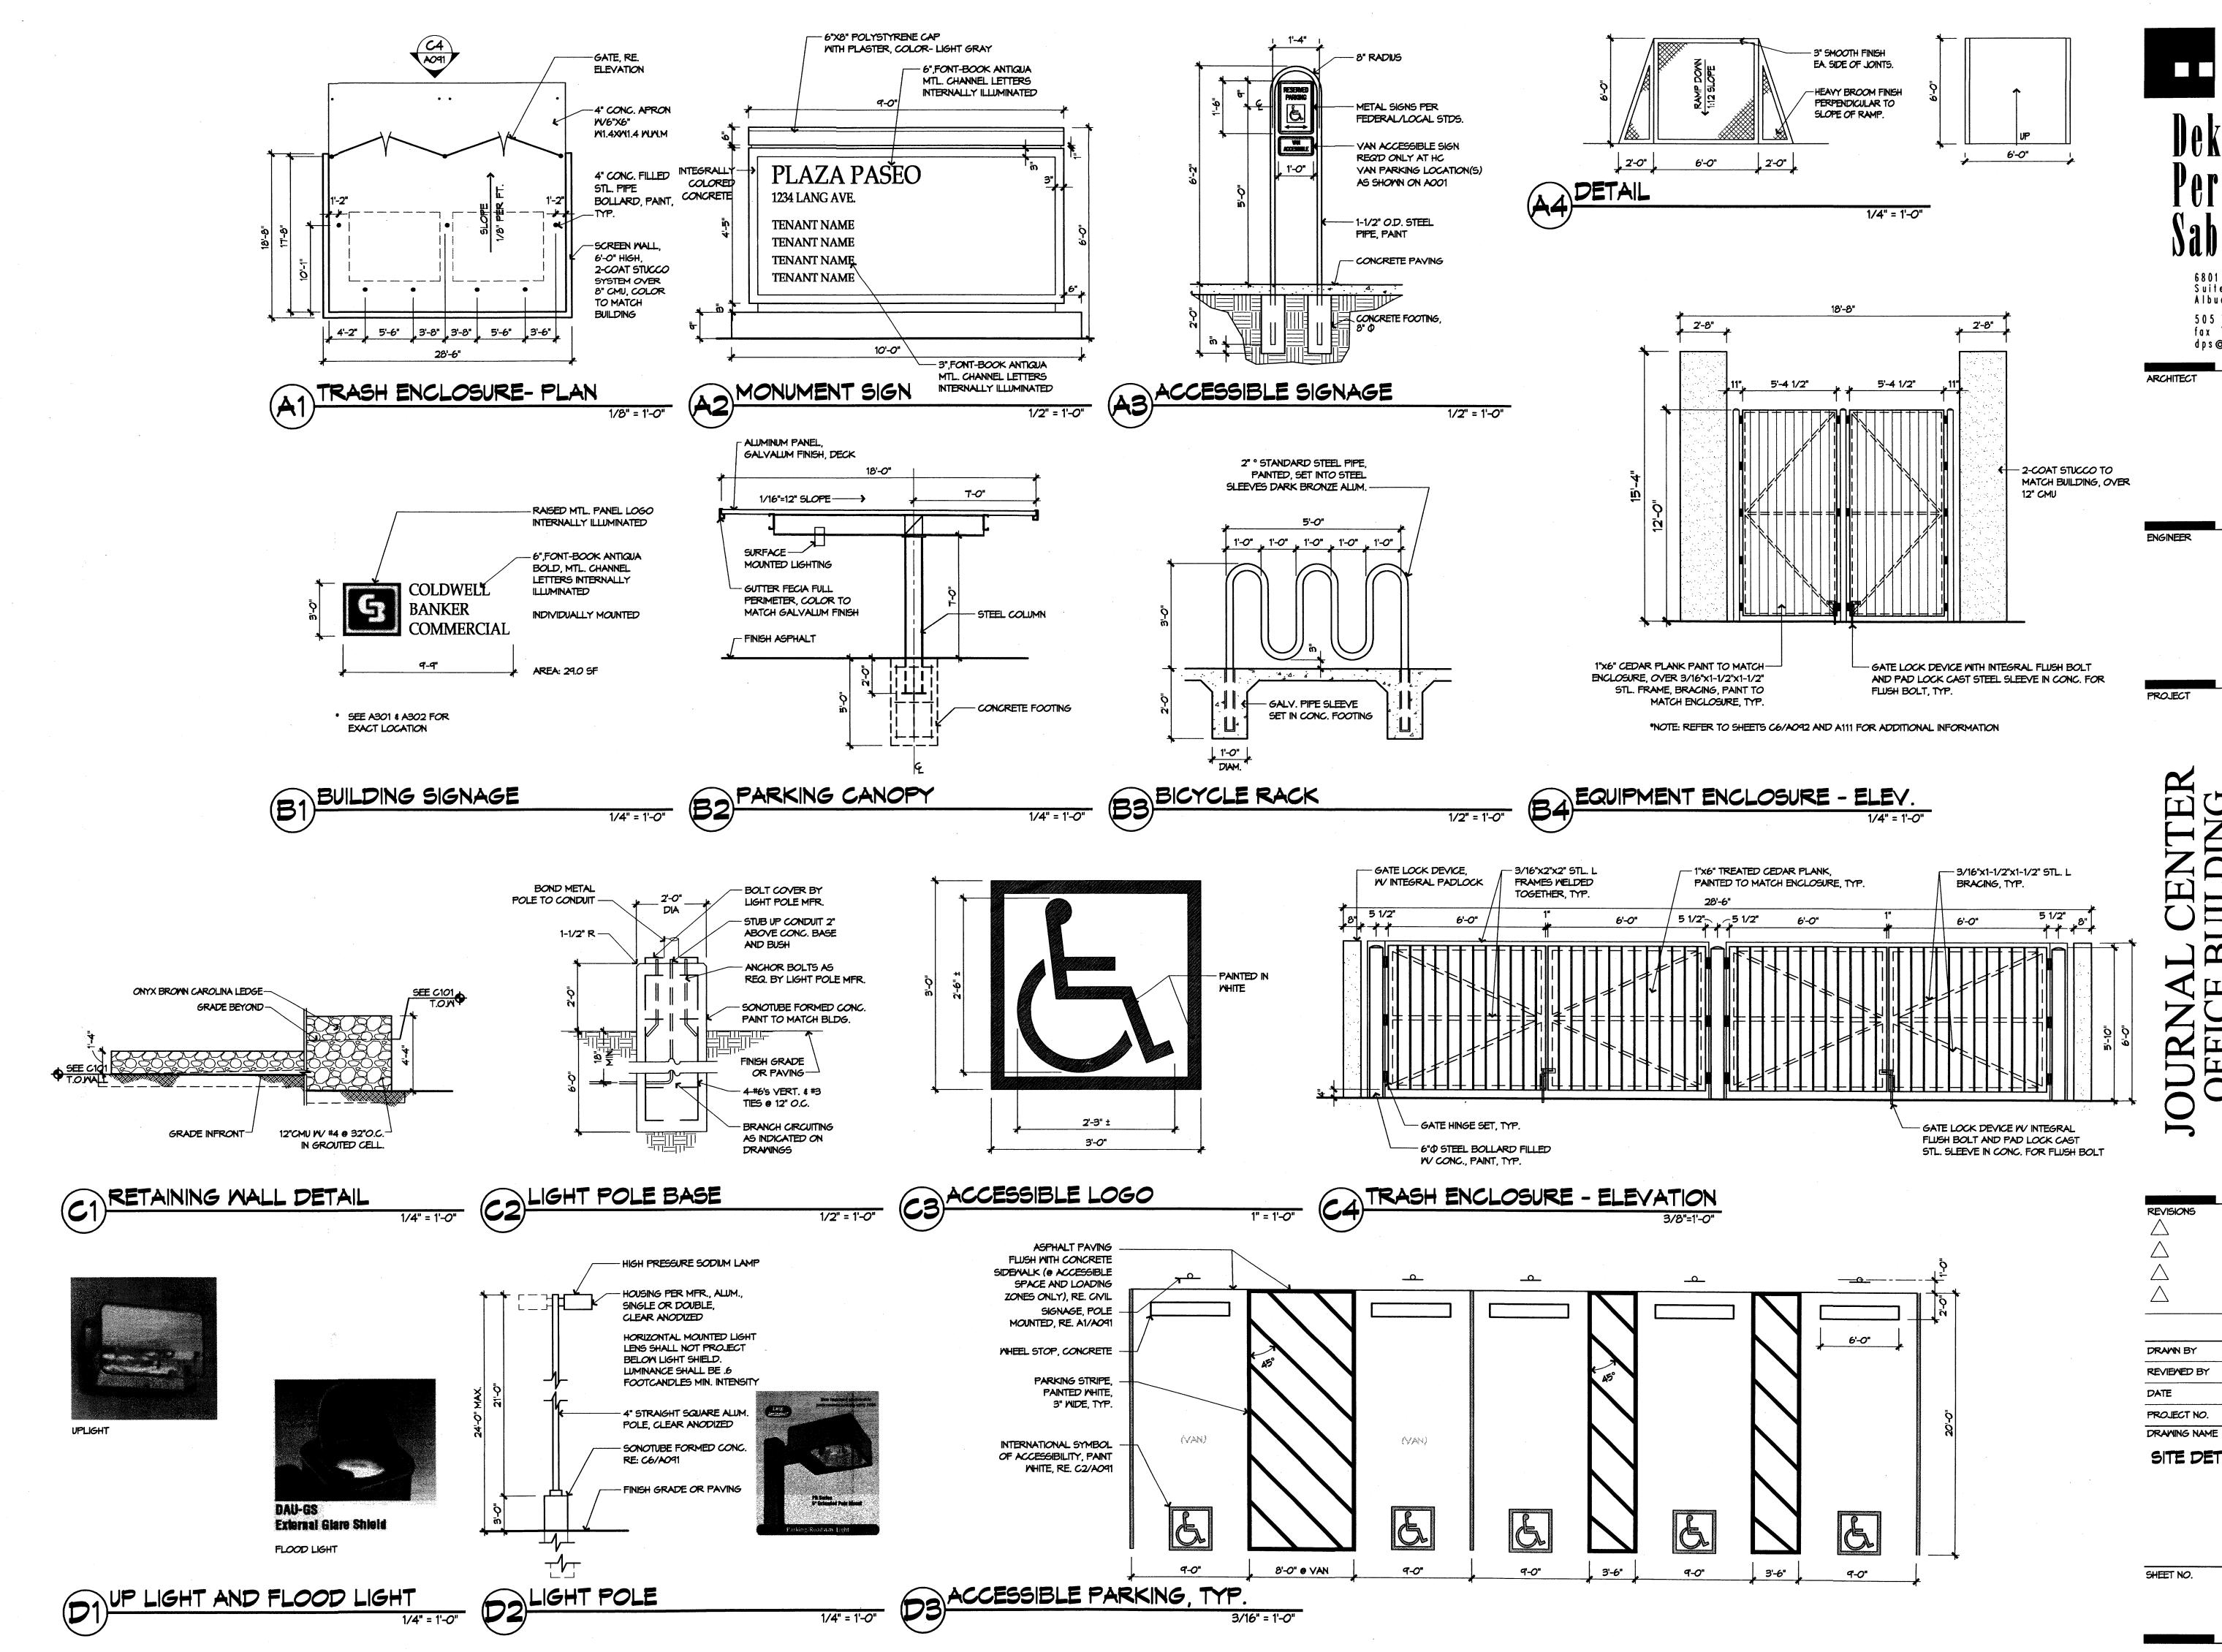

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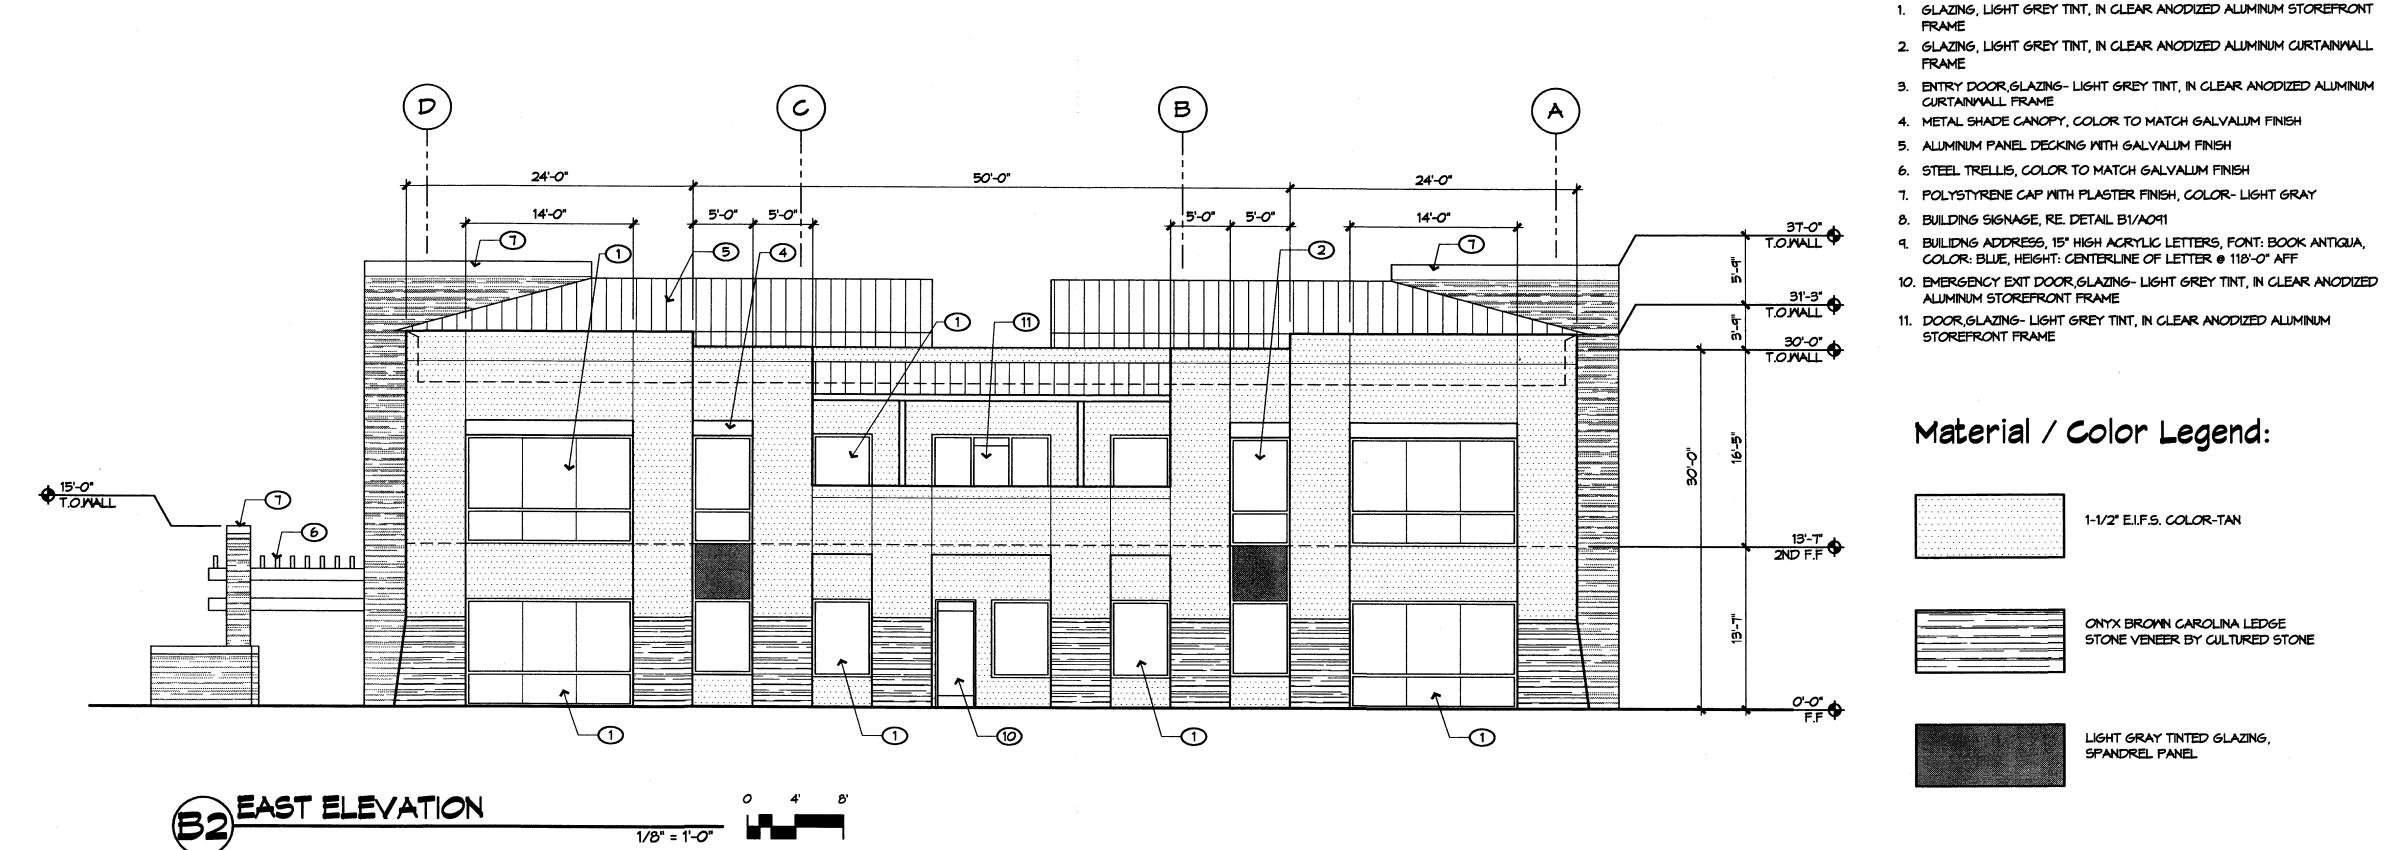
PROJECT

3, Albuquerque, Submittal Set

REVISIONS DRAWN BY

CP REVIEWED BY AMC 04/27/04 PROJECT NO. 04040

SITE DETAILS



Sheet Notes:

Keyed Notes ⊗:

FRAME

CURTAINMALL FRAME

ALUMINUM STOREFRONT FRAME

A. ALL MECH. EQUIP. SHALL BE SCREENED PER JOURNAL CENTER GUIDELINES

architecture

interiors planning engineering

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ARCHITECT

Material / Color Legend:

COLOR: BLUE, HEIGHT: CENTERLINE OF LETTER @ 118'-0" AFF




ONYX BROWN CAROLINA LEDGE STONE VENEER BY CULTURED STONE

1-1/2" E.I.F.S. COLOR-TAN



LIGHT GRAY TINTED GLAZING, SPANDREL PANEL

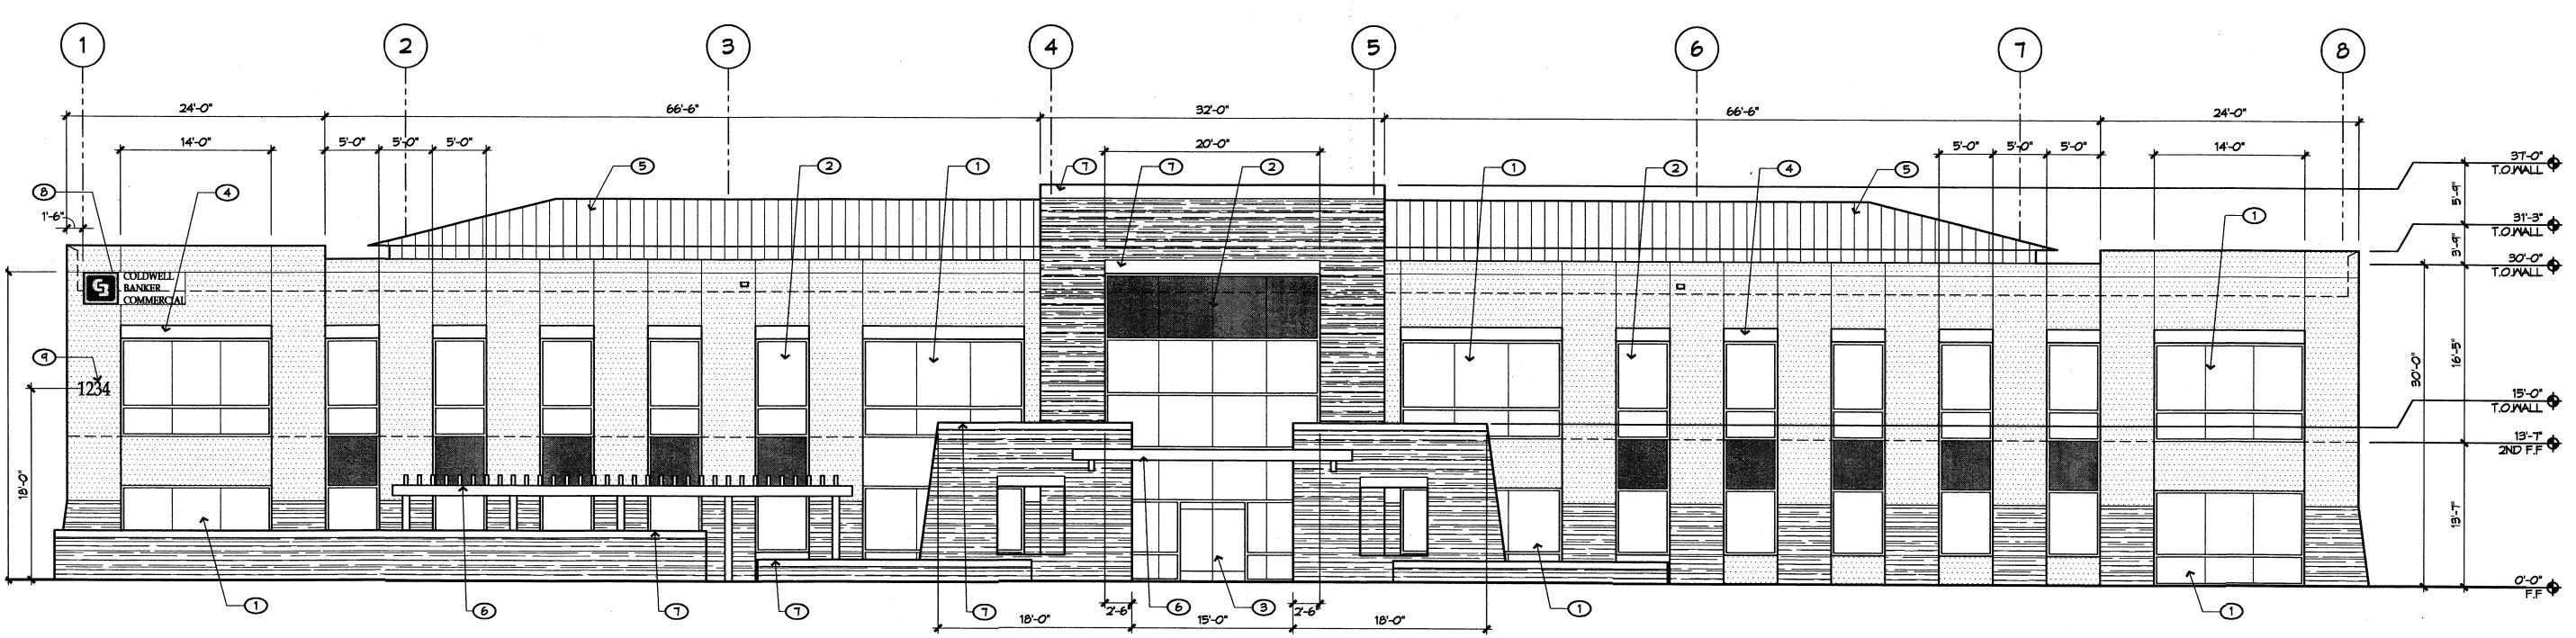


NE, Albuquerque, B Submittal Set REVISIONS


DRAWN BY

REVIEWED BY 04/27/04 PROJECT NO. 04040 DRAWING NAME

Building Elevations

50UTH ELEVATION

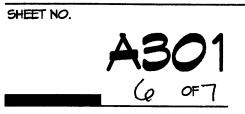

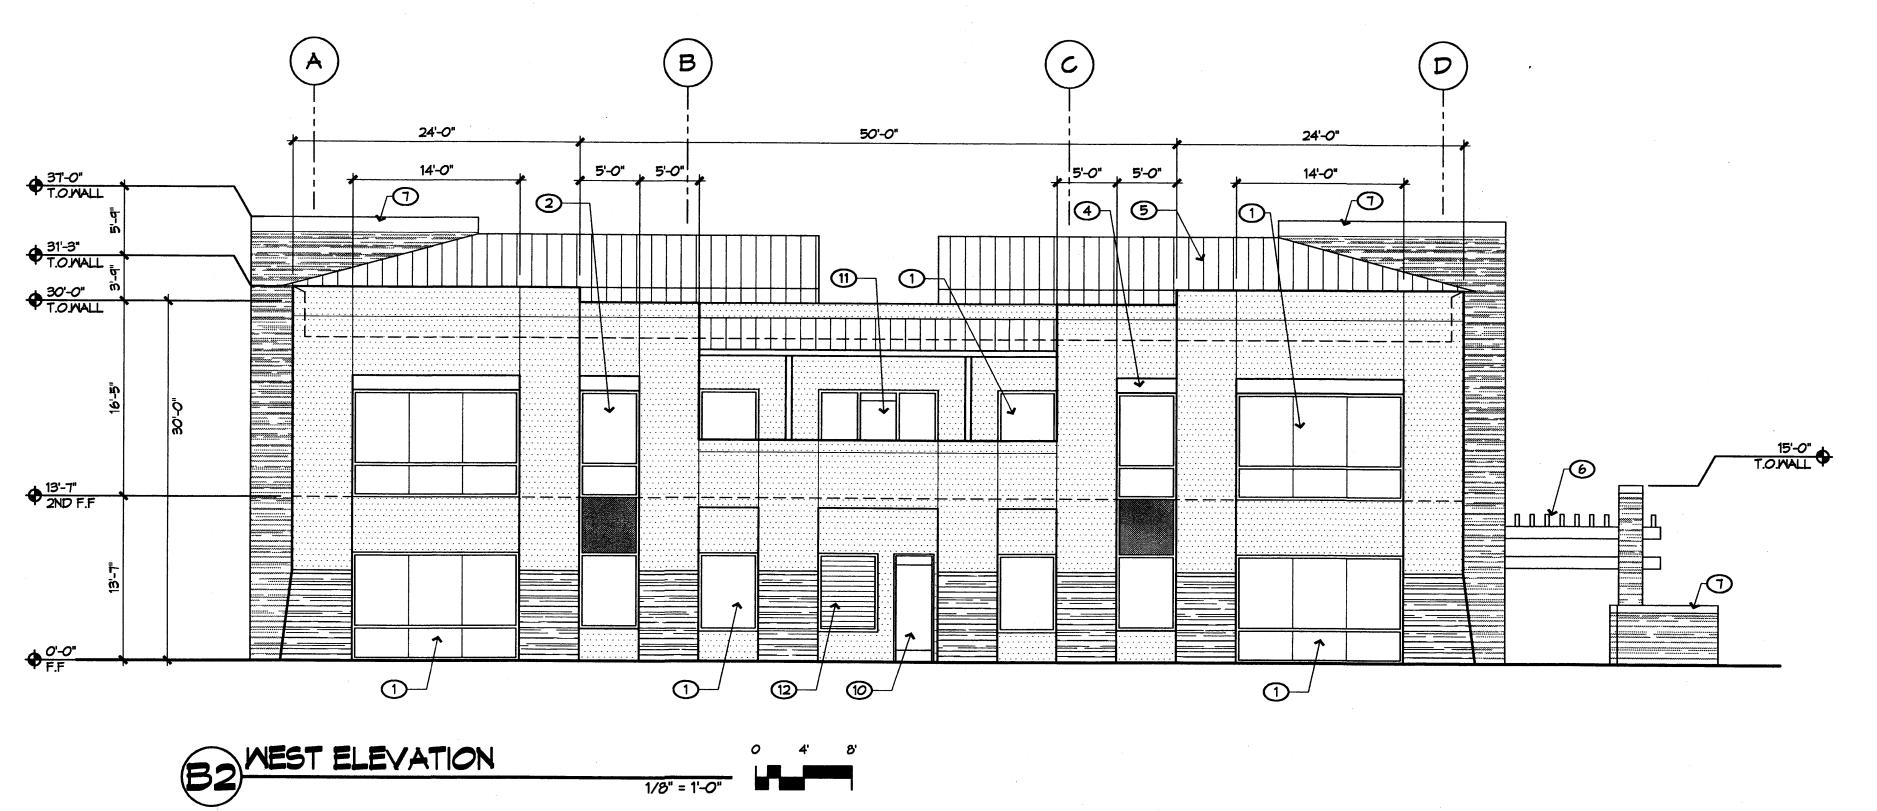

Sheet Notes:

Keyed Notes ⊗:

CURTAINWALL FRAME

A. ALL MECH. EQUIP. SHALL BE SCREENED PER JOURNAL CENTER GUIDELINES

1. GLAZING, LIGHT GREY TINT, IN CLEAR ANODIZED ALUMINUM STOREFRONT

2. GLAZING, LIGHT GREY TINT, IN CLEAR ANODIZED ALUMINUM CURTAINWALL

3. ENTRY DOOR, GLAZING-LIGHT GREY TINT, IN CLEAR ANODIZED ALUMINUM

4. METAL SHADE CANOPY, COLOR TO MATCH GALVALUM FINISH

7. POLYSTYRENE CAP WITH PLASTER FINISH, COLOR-LIGHT GREY

COLOR: BLUE, HEIGHT: CENTERLINE OF LETTER @ 118'-0" AFF

9. BUILIDNG ADDRESS, 15" HIGH ACRYLIC LETTERS, FONT: BOOK ANTIQUA,

1-1/2" E.I.F.S. COLOR-TAN

5. ALUMINUM PANEL DECKING WITH GALVALUM FINISH

8. BUILDING SIGNAGE, RE. DETAIL B1/A091

6. STEEL TRELLIS, COLOR TO MATCH GALVALUM FINISH

planning engineering

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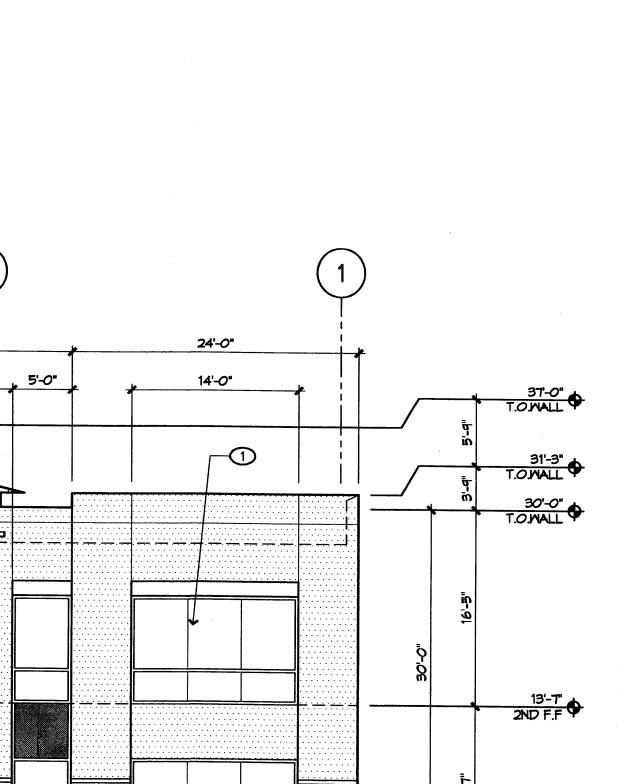
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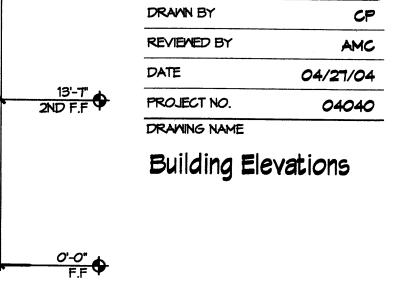
ARCHITECT


LIGHT GRAY TINTED GLAZING, SPANDREL PANEL

ONYX BROWN CAROLINA LEDGE STONE VENEER BY CULTURED STONE



5'-0" 5'-0"



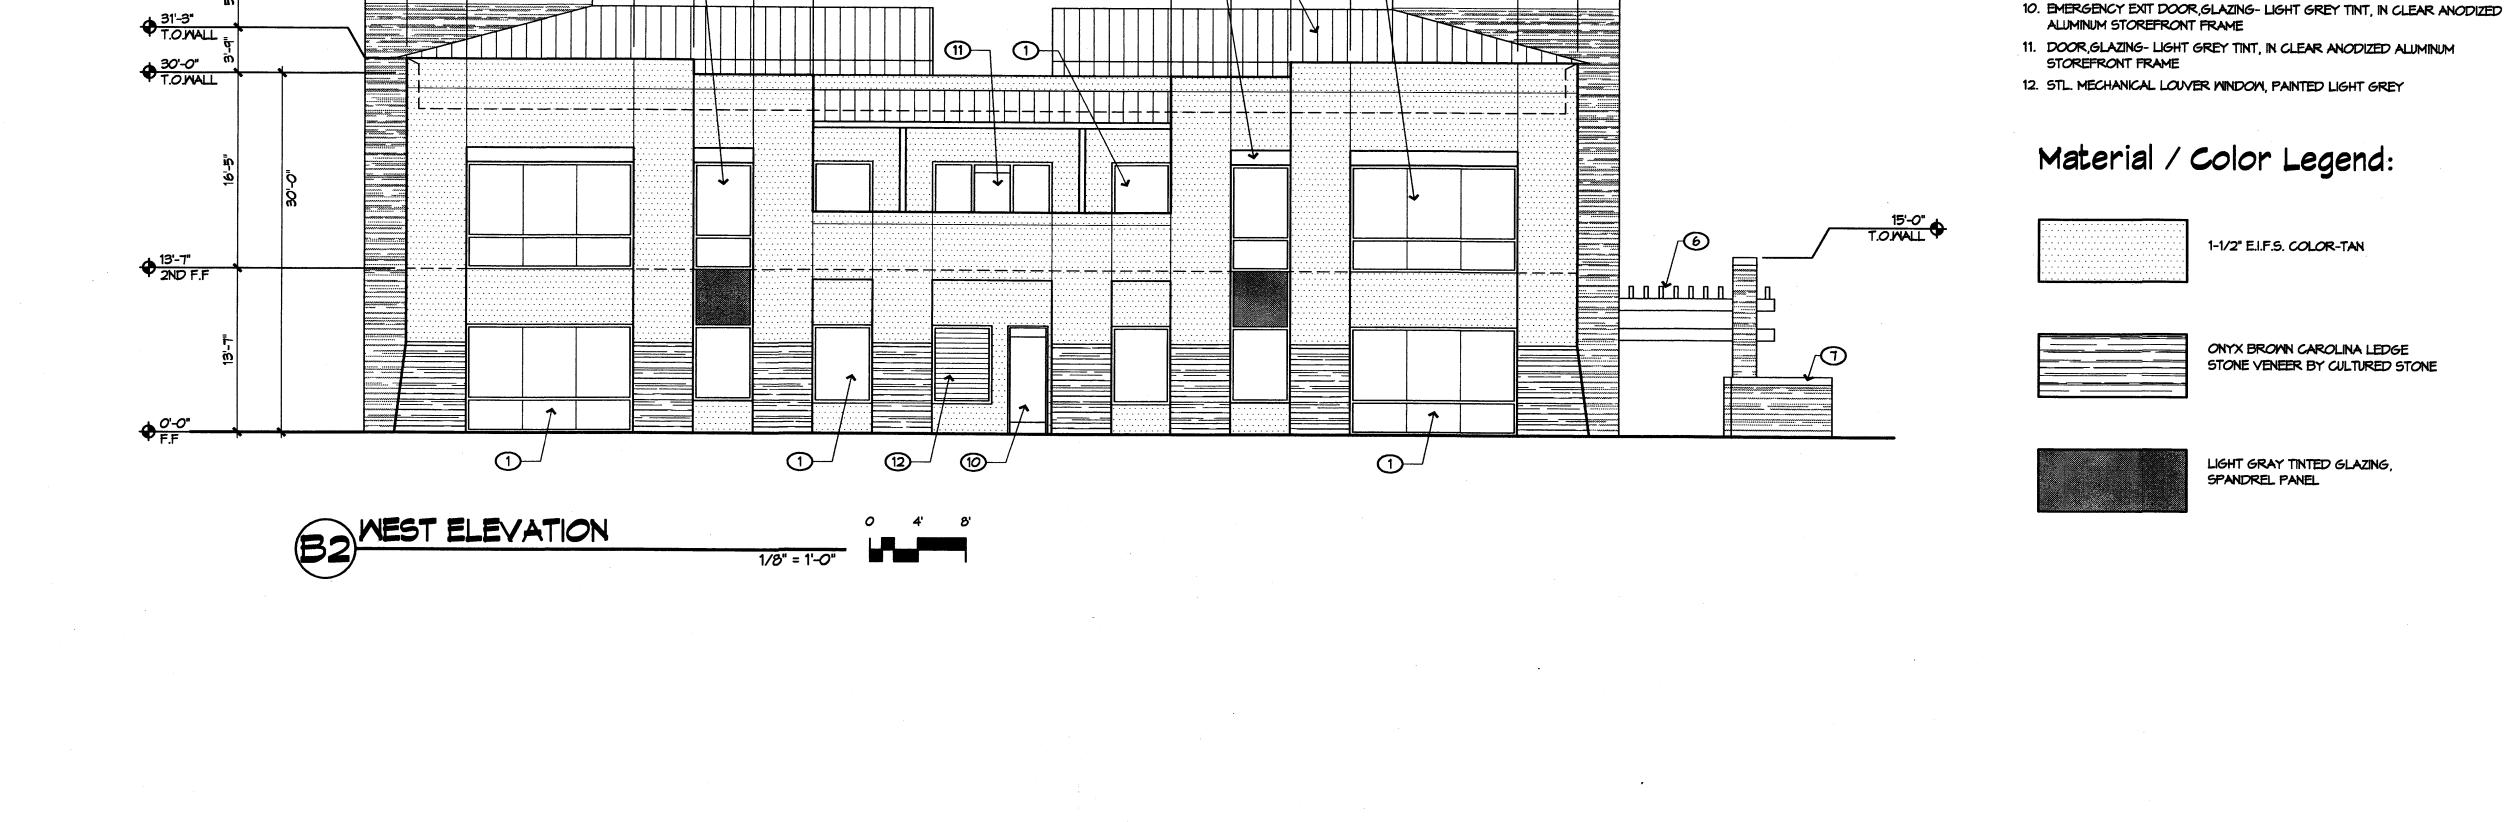

32'-0"

20'-0"

①__

(T)

①__

NORTH ELEVATION

5'-0" 5'-0" 5'-0"

14'-0"

COLDWELL BANKER COMMERCIAL

①__