

SITE LIGHTING SHALL BE LOCATED SO AS NOT TO GLARE ON TO ADJACENT SITES. LIGHTS SHALL BE LOCATED ON THE SITE AND THE BUILDING.

LIGHT SHALL NOT GLARE ON TO ANY PUBLIC RIGHT-OF-WAY AND SHALL NOT HAVE AN OFF-SITE LUMINANCE GREATER THAN 100 FOOT LAMBERTS. ALL LIGHT FIXTURES SHALL BE FULL CUTOFF TYPE TO PREVENT FUGITIVE LIGHT. NO LIGHT SOURCE SHALL BE VISIBLE FROM THE SITE PERIMETER. ALL LAMPS MUST BE FULLY SHIELDED TO PREVENT FUGITIVE LIGHT BEYOND THE PROPERTY LINE.

SITE LIGHTING FOR PAD STRUCTURES IS TO MATCH THE SITE LIGHTING PROVIDED FOR THE MAIN PARKING AREA. EXPOSED, I.E. UNSHIELDED LIGHT FIXTURES ARE PROHIBITED. ALL LAMPS MUST BE SHIELDED SHOE BOX TYPE FIXTURES.

ALL LIGHTING TO COMPLY WITH THE NIGHT SKY PROTECTION ACT. LIGHTING DETAIL

SCALE: N.T.S.

CMU WALL -STUCCO ON CMU WALL **GATES** STUCCO ON-STONE VENEER -CONCRETE FILLED -STONE VENEER CMU WALL **BOLLARDS** WITH STONE WITH STONE WATERTABLE WATERTABLE

WITH GATES

WITHOUT GATES FRONT ELEVATION

REAR ELEVATION SIDE ELEVATION

CITY WORK ORDER

PROCESS.

-STUCCO ON

TRASH ENCLOSURE ELEVATIONS SCALE: $1/6^{\circ} = 1'-0^{\circ}$

SU-1 PDA TO INCLUDE C-3 USES EXISTING DAYCARE FACILITY -EXISTING FENCE CMU RETAINING WALL, ON ADJACENT LOT COLOR TAN - HEIGHT VARIES, 5' MAX. HEIGHT PROPERTY-EXISTING-SIDEWALK PROPOSED OFFICE/RETAIL BUILDING SHELL 10,200 SF GROSS BUS ROUTE 94 ON EAGLE RANCH HANDICAP PARKING-BICYCLE -SIDEWALK ACCESS PATH PER COA STD. DWG. #2430 TEXTURED CONCRETE
PEDESTRIAN CROSSING 9 FEXISTING 6 CONCRETE SIDEWALK RO -EXISTING CURB NEW WHEEL CHAIR RAMP PER C.O.A. STD. DWG. #2441 HTEXTURED CONCRETE WALKWAY -NEW DRIVE ENTRANCE PER C.O.A. CONCRET PEDESTRIA STD. DWG. #2426 -NEW WHEEL CHAIR RAMP PER C.O.A. STD. DWG. #2441 **MONUMENT SIGN-**- SEE EXTERIOR
ELEVATIONS EXISTING 10' NEW EXISTING 6 -EXISTING 10' WATER LEXISTING 10' NEW STANDAR EXISTING **PUBLIC UTILITY** AND SANITARY **NMUI EASEMENT** EASEMENT CURBLEUITER CONCRETE **SEWER EASEMENT** SIDEWALK PER ALL SAINTS ROAD NW PER COA STO. DWG. #2415ABY DWG.#2430

70' R.O.W.

R-LT EXISTING RESIDENTIAL



PROJECT NUMBER: 1603272 APPLICATION NUMBER: 06 DRB-01509 IS AN INFRASTRUCTURE LIST REQUIRED? (\times) YES $(\)$ NO IF YES, THEN A SET OF APPROVED DRC PLANS WITH A WORK ORDER IS REQUIRED FOR ANY CONSTRUCTION WITHIN PUBLIC— RIGHT-OF-WAY OR FOR CONSTRUCTION OF PUBLIC IMPROVEMEN DRB SITE DEVELOPMENT PLAN APPROVAL: 3-12-07 TRAFFIC ENGINEERING, TRANSPORTATION DIVISION DATE pristing Sandoral 10/25/06 PARKS & RECREATION DEPARTMENT William O. Bolen UTILITIES DEVELOPMENT DATE 10/25/06 CITY ENGINEER, ENGINEERING DIVISION / AMAFCA DATE ENVIRONMENTAL HEALTH DEPARTMENT (conditional) DATE Appento CAHFO SOLID WASTE MANAGEMENT DATE 10/25/06 DATE DRB CHAIRPERSON, PLANNING DEPARTMENT

SIT	E PLAN LEGEND
	INDICATES EXTENT OF LANDSCAPE AREA
+ + + + + +	INDICATES EXTENT OF ASPHALTIC CONCRETE PAVING. MINIMUM 2" OF ASPHALT OVER 4" BASE COURSE.
4	INDICATES EXTENT OF CONCRETE PAVING AND CONCRETE SIDEWALKS.
	PROPERTY LINE.

PARKING ANALYSIS:

PLNZ(10706) 12/16/03

REQUIRED: 10200 / 200 - 10% FOR BUS ROUTE = 51 - 5 = 46 PROVIDED: 46

ADA SPACES REQUIRED AND PROVIDED: 3

BICYCLE PARKING REQUIRED: 45 / 20 = 3, PROVIDED: 4

PARKING SPACE SIZES: REGULAR: 9'-0" x 18'-0" WITH 2'-0" OVERHANG

COMPACT: 8'-0" x 13'-6" WITH 1'-6" OVERHANG

BICYCLE SPACES:

REQUIRED: 45 / 20 = 3 PROVIDED: 4

TOTAL LOT AREA: 45,141 SF = 2.24 ACRES


NET LOT AREA: 34,941 SF

CONSTRUCTION TYPE: VB- SPRINKLERED AFD PLANS CHECKING OFFICE

924-3611

APPROVED DISAPPROVED


SIGNATURE & DATE

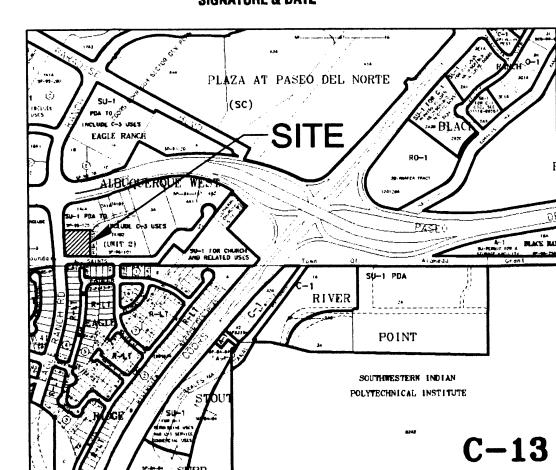

VICINITY MAP

SCALE: $1^{\circ} = 750' + / -$

SITE PLAN

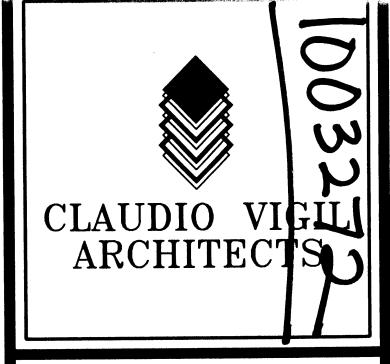

Rio Grande Boulevard, N.W. Albuquerque, New Mexico Phone: (505) 842-1113 Fax: (505) 842-1330

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CONSULTANTS



HIGH ASSETS SHOPPING CENTER

BUILDING SHELL

ALL SAINTS ROAD NW ALBUQUERQUE, NEW MEXICO

MARK	DATE	DESCRIPTION
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-	-	•
-	-	-
-	-	-
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PROJECT NUMB	ER: 06260
DRAWING FILE:	06260\3DESDEV\HA C-101 SP
DRAWN BY:	LH
CHECK BY:	
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DATE:	OCTOBER 16, 2006

SHEET TITLE

SITE PLAN FOR BUILDING PERMIT

> SHEET NUMBER C-101

ROAD RANCH R.O.W. VARI EAGLE (1 OF 2) ALTO COMM VALVE WITH GAL WEE (TYP.) O'L. CLOSE HAPPLE (TYP.) O'L. UNION (TYP.) PAC SLEDNE THROUGH COMORETE (TYP.) 0000 ... Mastervalve w/RPBA ALL SAINTS ROAD NW

A2

SCALE: 1" = 20

70' R.O.W.

LANDSCAPE PLAN

PLANT LEGEND

Qty.	Symbol	Scientific Name Common Name	Size	Water Use
	Trees			
10		Fraxinus oxycarpa 'Raywood' Raywood Ash	2" B&B	Medium+
5		Cedrus atlantica glauca Blue Atlas Cedar	5'-6'	Medium
4	\bigcirc	Pistacia chinensis Chinese Pistache	2" B&B	Medium +
Shrub	s/Groundo	overs		
21		Artemisia 'Powis Castle' Powis Castle Sage	1-Gal	Low +
25	0	Caryopteris clandonensis Blue Mist	1-Gal	Medium
13	⊗	Ericameria laricifolia 'Aguirre' Turpentine Bush	5-Gal	Low+
15	0	Nepeta mussini Giant Catmint	1-Gal	Medium
38	0	Rhus aromatica Grow Low Sumac	5-Gal	Low+
25	*	Rosmarinus officinalis 'Arp' Arp Rosemary	5-Gal	Low +
Ornar	mental Gras	sses	****	
40	مطانه			
19		Miscanthus sinensis 'Gracillimus' Maiden Grass	5-Gal	Medium
33	**	Muhlenbergia capillaris 'Regal Mist' 1-Gal Regal Mist		Medium
17	*	Nasella tenuissima Threadgrass		Low +

SITE DATA

GROSS LOT AREA LESS BUILDING(S) NET LOT AREA	<u>42064</u> SF <u>10352</u> SF <u>31712</u> SF
REQUIRED LANDSCAPE 15% OF NET LOT AREA PROPOSED LANDSCAPE PERCENT OF NET LOT AREA	<u>4757</u> SF <u>11916</u> SF <u>38%</u> %
HIGH WATER USE TURF MAX. 20% OF LANDSCAPE AREA PROPOSED HIGH WATER USE TURF PERCENT OF LANDSCAPE AREA	0 SF 0 SF 0 %

REQUIRED STREET TREES (EAGLE RANCH & ALL SAINTS RD)
PROVIDED AT 30' O.C. SPACING ALONG STREET 13 REQUIRED PARKING LOT TREES

PROVIDED AT 1 PER 10 SPACES (46 SPACES/10) 5

PLANTING RESTRICTIONS APPROACH

A MINIMUM OF 80% OF THE PLANTINGS TO BE LOW OR MEDIUM WATER USE PLANTS

A MAXIMUM OF 20% OF THE LANDSCAPE AREA TO BE HIGH WATER USE TURF

NOTE

MAINTENANCE OF LANDSCAPE PROVIDED BY OWNER

PLANTINGS TO BE WATERED BY AUTO. DRIP IRRIGATION SYSTEM WITH REDUCED PRESSURE BACKFLOW PREVENTER PER CITY OF ALBUQUERQUE

WATER MANAGEMENT IS THE SOLE RESPONSIBILITY OF THE PROPERTY OWNER

THIS PLAN IS TO COMPLY WITH C.O.A. LANDSCAPE AND WATER WASTE ORDINANCE PLANTING RESTRICTIONS APPROACH

IT IS THE INTENT OF THIS PLAN TO PROVIDE MIN. 75% LIVE GROUNDCOVER OF LANDSCAPE AREAS AT MATURITY

LANDSCAPE AREAS TO BE MULCHED WITH SANTA FE BROWN CRUSHER FINES AT 3" DEPTH NO FILTER FABRIC

APPROVAL OF THE LANDSCAPE PLAN DOES NOT CONSTITUTE OR IMPLY COMPLIANCE WITH, OR EXEMPTION FROM, THE C.O.A LANDSCAPE AND WATER WASTE ORDINANCE

TREES ARE NOT TO BE PLACED IN PUBLIC UTILITY EASEMENTS


NO PARKING SPACE SHALL BE MORE THEN 100' FROM A TREE.



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CONSULTANTS



HIGH ASSETS SHOPPING CENTER

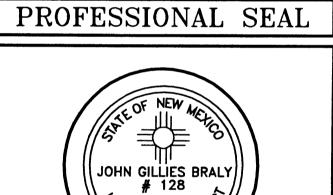BUILDING SHELL

ALL SAINTS ROAD NW ALBUQUERQUE, NEW MEXICO

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MARK	DATE	DESCRIPTION

PROJECT NUM	BER: 06260
DRAWING FILE	: 06260\3DESDEV\HA L-101
DRAWN BY:	LH
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DATE.	OCTORER 16 2006

SHEET TITLE

LANDSCAPE PLAN

SHEET NUMBER L-101 FACILITY ACCESSIBILITY

RETAINING WALL

RETAINING WALL

FINISH FLOOR

75.8TG

NMUI EASEMENT.

79.3TA

-EXISTING 6'

CONCRETE

RETAINING WALL

77.0

PROPERTY-

SIDEWALK ACCESS -

PATH PER COA STD. DWG. #2430

ROAD S

RANCH R.O.W. VAR

EAGLE

× 80.21

ALL SURFACES ALONG THE ACCESSIBLE ROUTE SHALL COMPLY WITH ANSI A117-1998.

WALKING SURFACES SHALL BE STABLE, FIRM, AND SLIP RESISTANT. THE RUNNING SLOPE OF WALKING SURFACES SHALL NOT BE STEEPER THAN 1:20 WITH A CROSS SLOPE NOT STEEPER THAN 1:48.

CURB RAMP AND RAMP RUNS SHALL HAVE A RUNNING SLOPE NOT STEEPER THAN 1:12 WITH A CROSS SLOPE NOT STEEPER THAN 1:48. COUNTER SLOPES OF ADJOINING GUTTERS AND ROAD SURFACES IMMEDIATELY ADJACENT TO THE CURB RAMP OR ACCESSIBLE ROUTE SHALL NOT BE STEEPER THAN 1:20. TRANSITIONS FROM RAMPS TO WALKS, GUTTERS OR STREETS SHALL BE AT THE SAME LEVEL. WHERE PEDESTRIANS MUST WALK ACROSS A CURB RAMP, THE RAMP SHALL HAVE FLARED SIDES WITH SLOPES NOT STEEPER THAN 1:10: WHERE THE TOP OF THE RAMP PARALLEL TO THE RUN OF THE RAMP IS LESS THAN 48 INCHES WIDE, THE FLARED SIDES SHALL HAVE A SLOPE NOT STEEPER THAN 1:12.

HANDICAP PARKING SPACES AND ACCESS AISLES SHALL HAVE SURFACE SLOPES NOT STEEPER THAN 1:48. ACCESS AISLES SHALL BE AT THE SAME LEVEL AS THE PARKING SPACES THEY SERVE.

FINISH FLOOR

INDERGROUND STORAGE

PIPES 350 LF 36 RE

WATER AND SANITARY

SEWER EASEMENT

ALL SAINTS ROAD NW

70' R.O.W.

PUBLIC UTILITY EASEMENT

THE CONTRACTOR SHALL PROVIDE ALL REQUIRED TRAFFIC CONTROL PLANS AND DEVICES. ALL SIGNS, BARRICADES, CHANNELIZATION DEVICES, SIGN FRAMES AND ERECTION OF SUCH DEVICES SHALL CONFORM THE THE REQUIREMENTS OF THE "MANUAL OF UNIFORM TRAFFIC CONTROL DEVICES FOR STREETS AND HIGHWAYS" LATEST EDITION. PRIOR TO CONSTRUCTION, THE TRAFFIC CONTROL PLAN SHALL BE SUBMITTED AND APPROVED BY THE GOVERNING AUTHORITY.

CONSTRUCTION NOTES

LEGEND:

72.0TG

FINISH FLOOR

71.4TA

70.5 INV

FEXISTING FENCE

ON ADJACENT LOT

73.0

PROPOSED OFFICE/RETAIL

BUILDING SHELL

FINISH FLOOR

- 1. TWO WORKING DAYS PRIOR TO ANY EXCAVATION, THE CONTRACTOR SHALL CALL FOR LOCATION OF EXISTING UTILITIES.
- 2. ALL WORK WITHIN THE CITY RIGHT-OF-WAY SHALL BE PERFORMED IN ACCORDANCE WITH THE APPLICABLE CITY OF ALBUQUERQUE STANDARDS AND PROCEDURES.
- WITH THE APPLICABLE CITY OF ALBUQUERQUE STANDARDS AND PROCEDURES.

 3. ALL WORK SHALL BE PERFORMED IN ACCORDANCE WITH THE APPLICABLE FEDERAL,
- STATE, AND LOCAL REGULATIONS, LAWS, AND RULES CONCERNING SAFETY AND HEALTH.

 4. PRIOR TO CONSTRUCTION THE CONTRACTOR SHALL VERITY THE EXISTING SITE
 CONDITIONS AND INFORM THE ARCHITECT/ ENGINEER OF ANY DISCREPANCY BETWEEN
 THE INFORMATION SHOWN ON THE PLANS AND THOSE OF THE EXISTING SITE.
- 5. THE CONTRACTOR SHALL PROVIDE THE ARCHITECT / ENGINEER WITH AN AS BUILT SURVEY FOR ENGINEER'S CERTIFICATION.
- 6. THE CONTRACTOR SHALL MAINTAIN A RECORD DRAWING SET OF PLANS AND PROMPTLY LOCATE EXISTING AND NEW ELEVATIONS (FINISH FLOORS, TOPS OF CURBS AND ASPHALT, FLOW LINE, PIPE INVERTS, ETC.), ON THE RECORD SET. THE RECORD SET SHALL BE MAINTAINED ON THE PROJECT SITE AND SHALL BE AVAILABLE TO THE OWNER AND ARCHITECT AT ANY TIME DURING CONSTRUCTION. UPON COMPLETION OF THE PROJECT, THE RECORD SET SHALL BE TURNED OVER TO THE OWNER.
- 7. THE OWNER / CONTRACTOR SHALL SUBMIT A NOTICE OF INTENT (NOI) TO THE EPA PRIOR TO BEGINNING OF CONSTRUCTION.
- 8. CONTRACTOR SHALL COMPLY WITH STORM WATER POLLUTION PREVENTION PLAN (SWPPP) SPECIFIC TO THIS PROJECT.

EXISTING SPOT ELEVATION FL

• 51.00 NEW SPOT ELEVATION

NEW CONTOUR

VERIFIED ELEVATION

AS BUILT ELEVATION

BASIN BOUNDARY

51—— EXISTING CONTOUR

———— PROPERTY LINE

THE 12 - 77

M---70+71.

9. ALL POND BOTTOMS SHALL RECEIVE GRAVEL AND FILTER FABRIC SEE LANDSCAPE PLAN.

FLOW LINE

TOP OF ASPHALT

TOP OF CONCRETE SLAB

TEMPORARY BENCH MARK

TOP OF CURB

TOP OF GRATE

TOP OF WALL

ASPHALT PAVING

GROUND

INVERT

GRAVEL

CONCRETE

CONCRETE SIDEWALK

EXISTING

NEW WHEEL CHAIR RAMP PER C.O.A.


STD. DWG. #2441

NEW DRIVE

ENTRANCE PER C.O.A. STD. DWG. #2426

NEW WHEEL CHAIR RAMP PER C.O.A.

STD. DWG. #2441

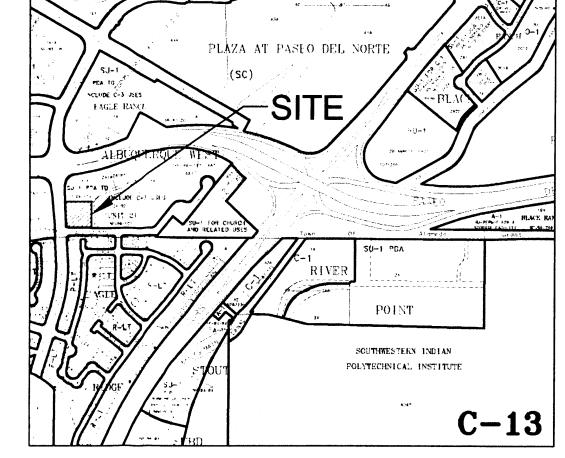

Z-C-13 VICINITY MAP

SCALE: $1^* = 750' + / -$

DRAINAGE PLAN

THE PROPOSED IMPROVEMENTS AS SHOWN BY THE VICINITY MAP, ARE LOCATED EAST OF COORS BOULEVARD SOUTH OF PLASO DEL NORTE, ON THE NORTHEAST CORNER OF THE INTERSECTION OF EAGLE RANCH ROAD AND ALL SAINTS ROAD. THE SITE IS UNDEVELOPED AND SLOPES FROM WEST TO EAST AT AN APPROXIMATE SLOPE OF 4.0%. PER PANEL 08, THE SITE DOES NOT LIE WITHIN A FLOOD HAZARD ZONE. THE SITE IS HIGHER THAN THE LANDS TO THE EAST AND SOUTH. THE LANDS TO THE NORTH SLOPE TO THE EAST, AND THE EXISTING CURB AND GUTTER ALONG EAGLE RANCH ROAD TO THE WEST BLOCKS FLOWS FORM THAT DIRECTION THEREFORE OFFSITE FLOWS ARE CONSIDERED INSIGNIFICANT.

THE PROPOSED SITE LIES WITHIN THE ALBUQUERQUE WEST UNIT 2 MASTER PLAN PREPARED BY ISAACSON & ARFMAN WHICH HAS ESTABLISHED A DISCHARGE RATE OF 1.66 CFS FOR THE SUBJECT SITE. THE PROPOSED IMPROVEMENTS CONSIST OF A NEW OFFICE BUILDING WITH ASSOCIATED PARKING AND LANDSCAPING. AS SHOWN BY THE CALCULATION THE PROPOSED DEVELOPMENT WILL INCREASE THE RATE AND VOLUME OF RUNOFF. THE RUNOFF IS DIRECTED TO THE UNDERGROUND STORAGE PIPES LOCATED UNDER THE PARKING AREA. DISCHARGE FROM THE STORAGE SYSTEM IS TO ALL SAINTS ROAD AND IS LIMITED TO THE THE 1.66 CFS ALLOWED BY THE MASTER PLAN BY A CONTROL ORIFICE.

THE CALCULATIONS ANALYZE THE EXISTING AND PROPOSED CONDITIONS FOR 6-HOUR, 100 YEAR RAINFALL EVENT. THE ANALYSIS IS IN ACCORDANCE WITH THE CITY OF ALBUQUERQUE DEVELOPMENT PROCESS MANUAL VOLUME II.

<u>CALCULATIONS</u> PRECIPITATION ZONE = 1 TOTAL SITE AREA = 1.036 ACRES

- EXISTING CONDITIONS
 LAND TREATMENT A=100%
- E = 0.44(1.00) = 0.44 INCHES V = 0.44(1.036) / 12 = 0.038 ACRE FEET Q = 1.29(1.00) (1.036) = 1.34 CFS
- DEVELOPED CONDITIONS

 LAND TREATMENT B=22% D=78%

 E = 0.67(0.22)+1.97(0.78)= 1.69 INCHES

 V = 1.69 (1.036) / 12 = 0.146 ACRE FEET
- Q = [1.29 (0.22)+4.37(0.78)](1.036)=4.0 CFS Q = 4.0/1.036=3.86 CFS/ACREINCREASE IN VOLUME OF RUNOFF = 0.108 ACRE FT INCREASE IN RATE OF RUNOFF = 2.7 CFS

T= 2.107 E At/Qp - 0.25 Ad/At = 0.725 HR

T= (0.7 Tc)+((1.6-Ad/At))/12) = 0.208 HR

V_{required}= 2,948 CF

POND VOLUME

DISCHARGE PIPE SIZES
Q
ALLOWABLE = 1.66 CFS

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ARCHITECTS


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CONSULTANTS

PROFESSIONAL SEAL



HIGH ASSETS SHOPPING CENTER

BUILDING SHELL

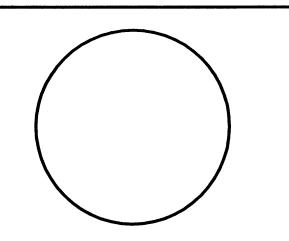ALL SAINTS ROAD NW
ALBUQUERQUE, NEW MEXICO

MARK	DATE	DESCRIPTION
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PROJECT NUMBER: 06260
DRAWING FILE: HA-C102-GRADING.DWG
DRAWN BY: jab
CHECK BY:
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DATE: OCTOBER 9, 2006

PRELIMINARY
SITE GRADING PLAN
FOR DRB APPROVAL

SHEET NUMBER C-102

A2

SCALE: 1" = 20'

SITE GRADING PLAN

BENCHMARK


ACS MONUMENT

"R.ALAMEDA B. NO. 2" ELEVATION=5058.25

-SUBMERSIBLE PUMP

-SIDE WALK CULVERT

PER COA DWG#2236

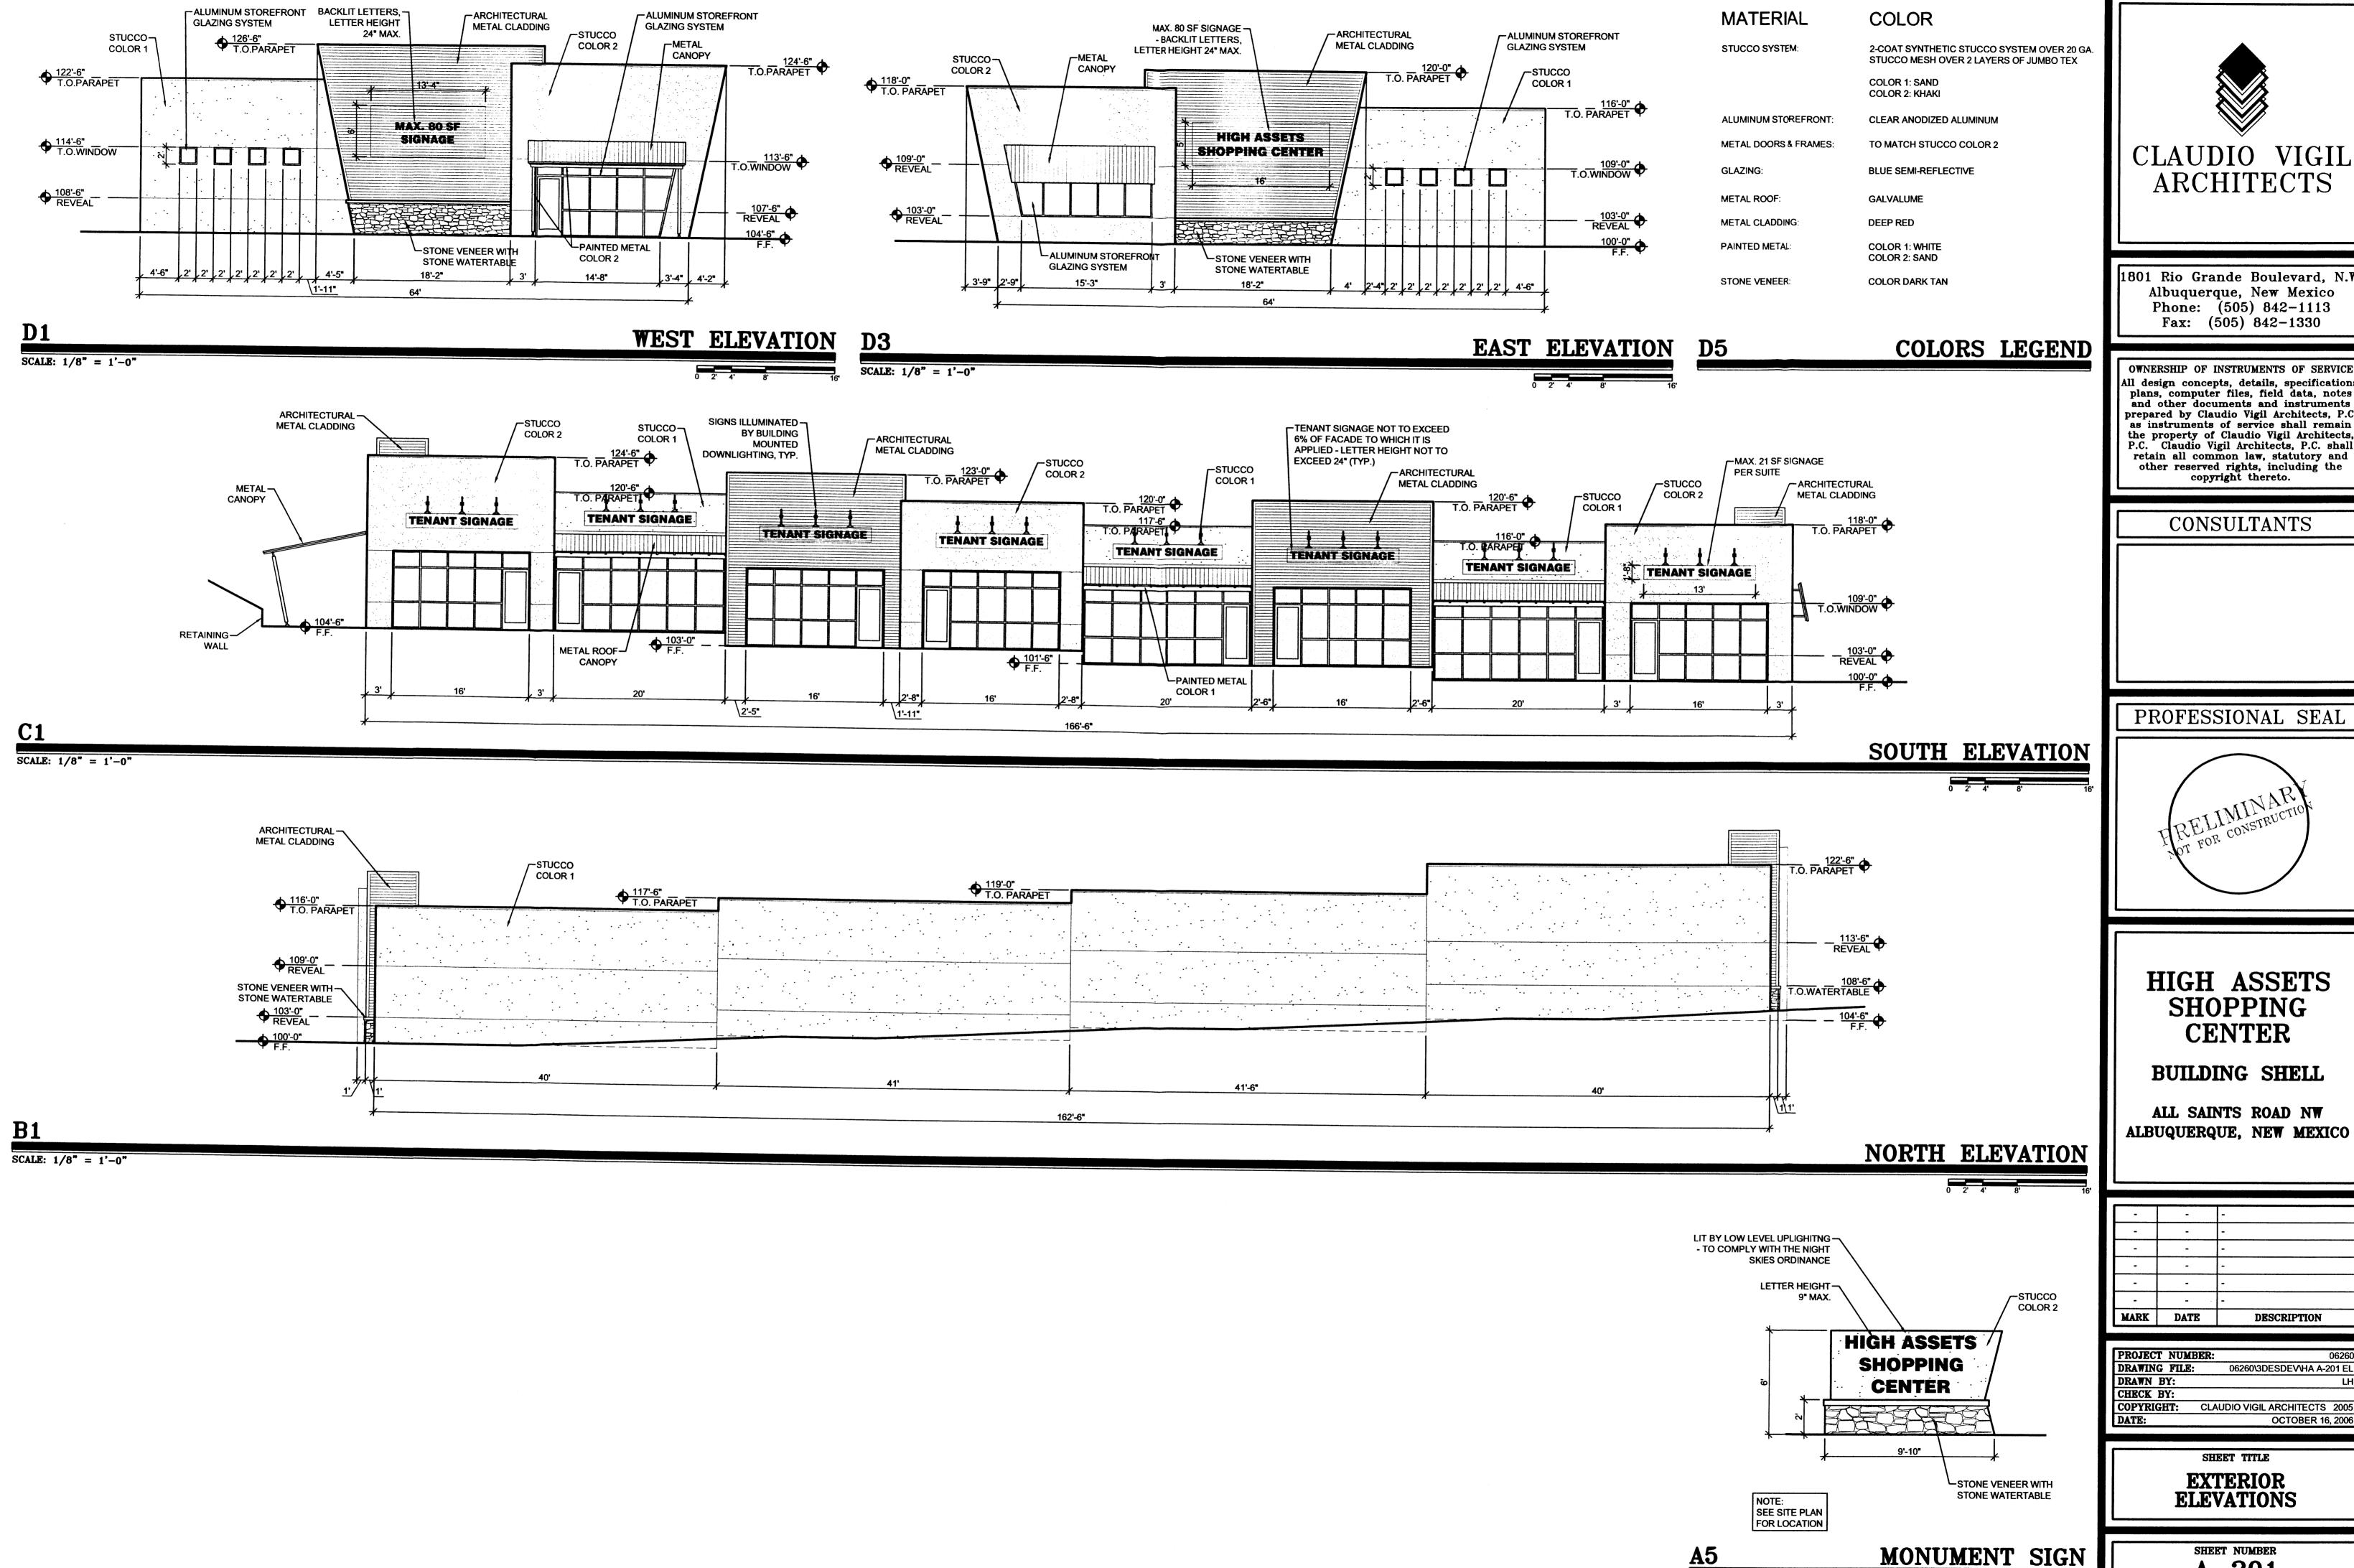

ARCHITECTS

801 Rio Grande Boulevard, N.W. Albuquerque, New Mexico Phone: (505) 842-1113

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PROFESSIONAL SEAL



HIGH ASSETS SHOPPING

BUILDING SHELL

ALL SAINTS ROAD NW


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MARK	DATE	DESCRIPTION

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ELEVATIONS

SHEET NUMBER A - 201

SCALE: 1/4" = 1'-0"



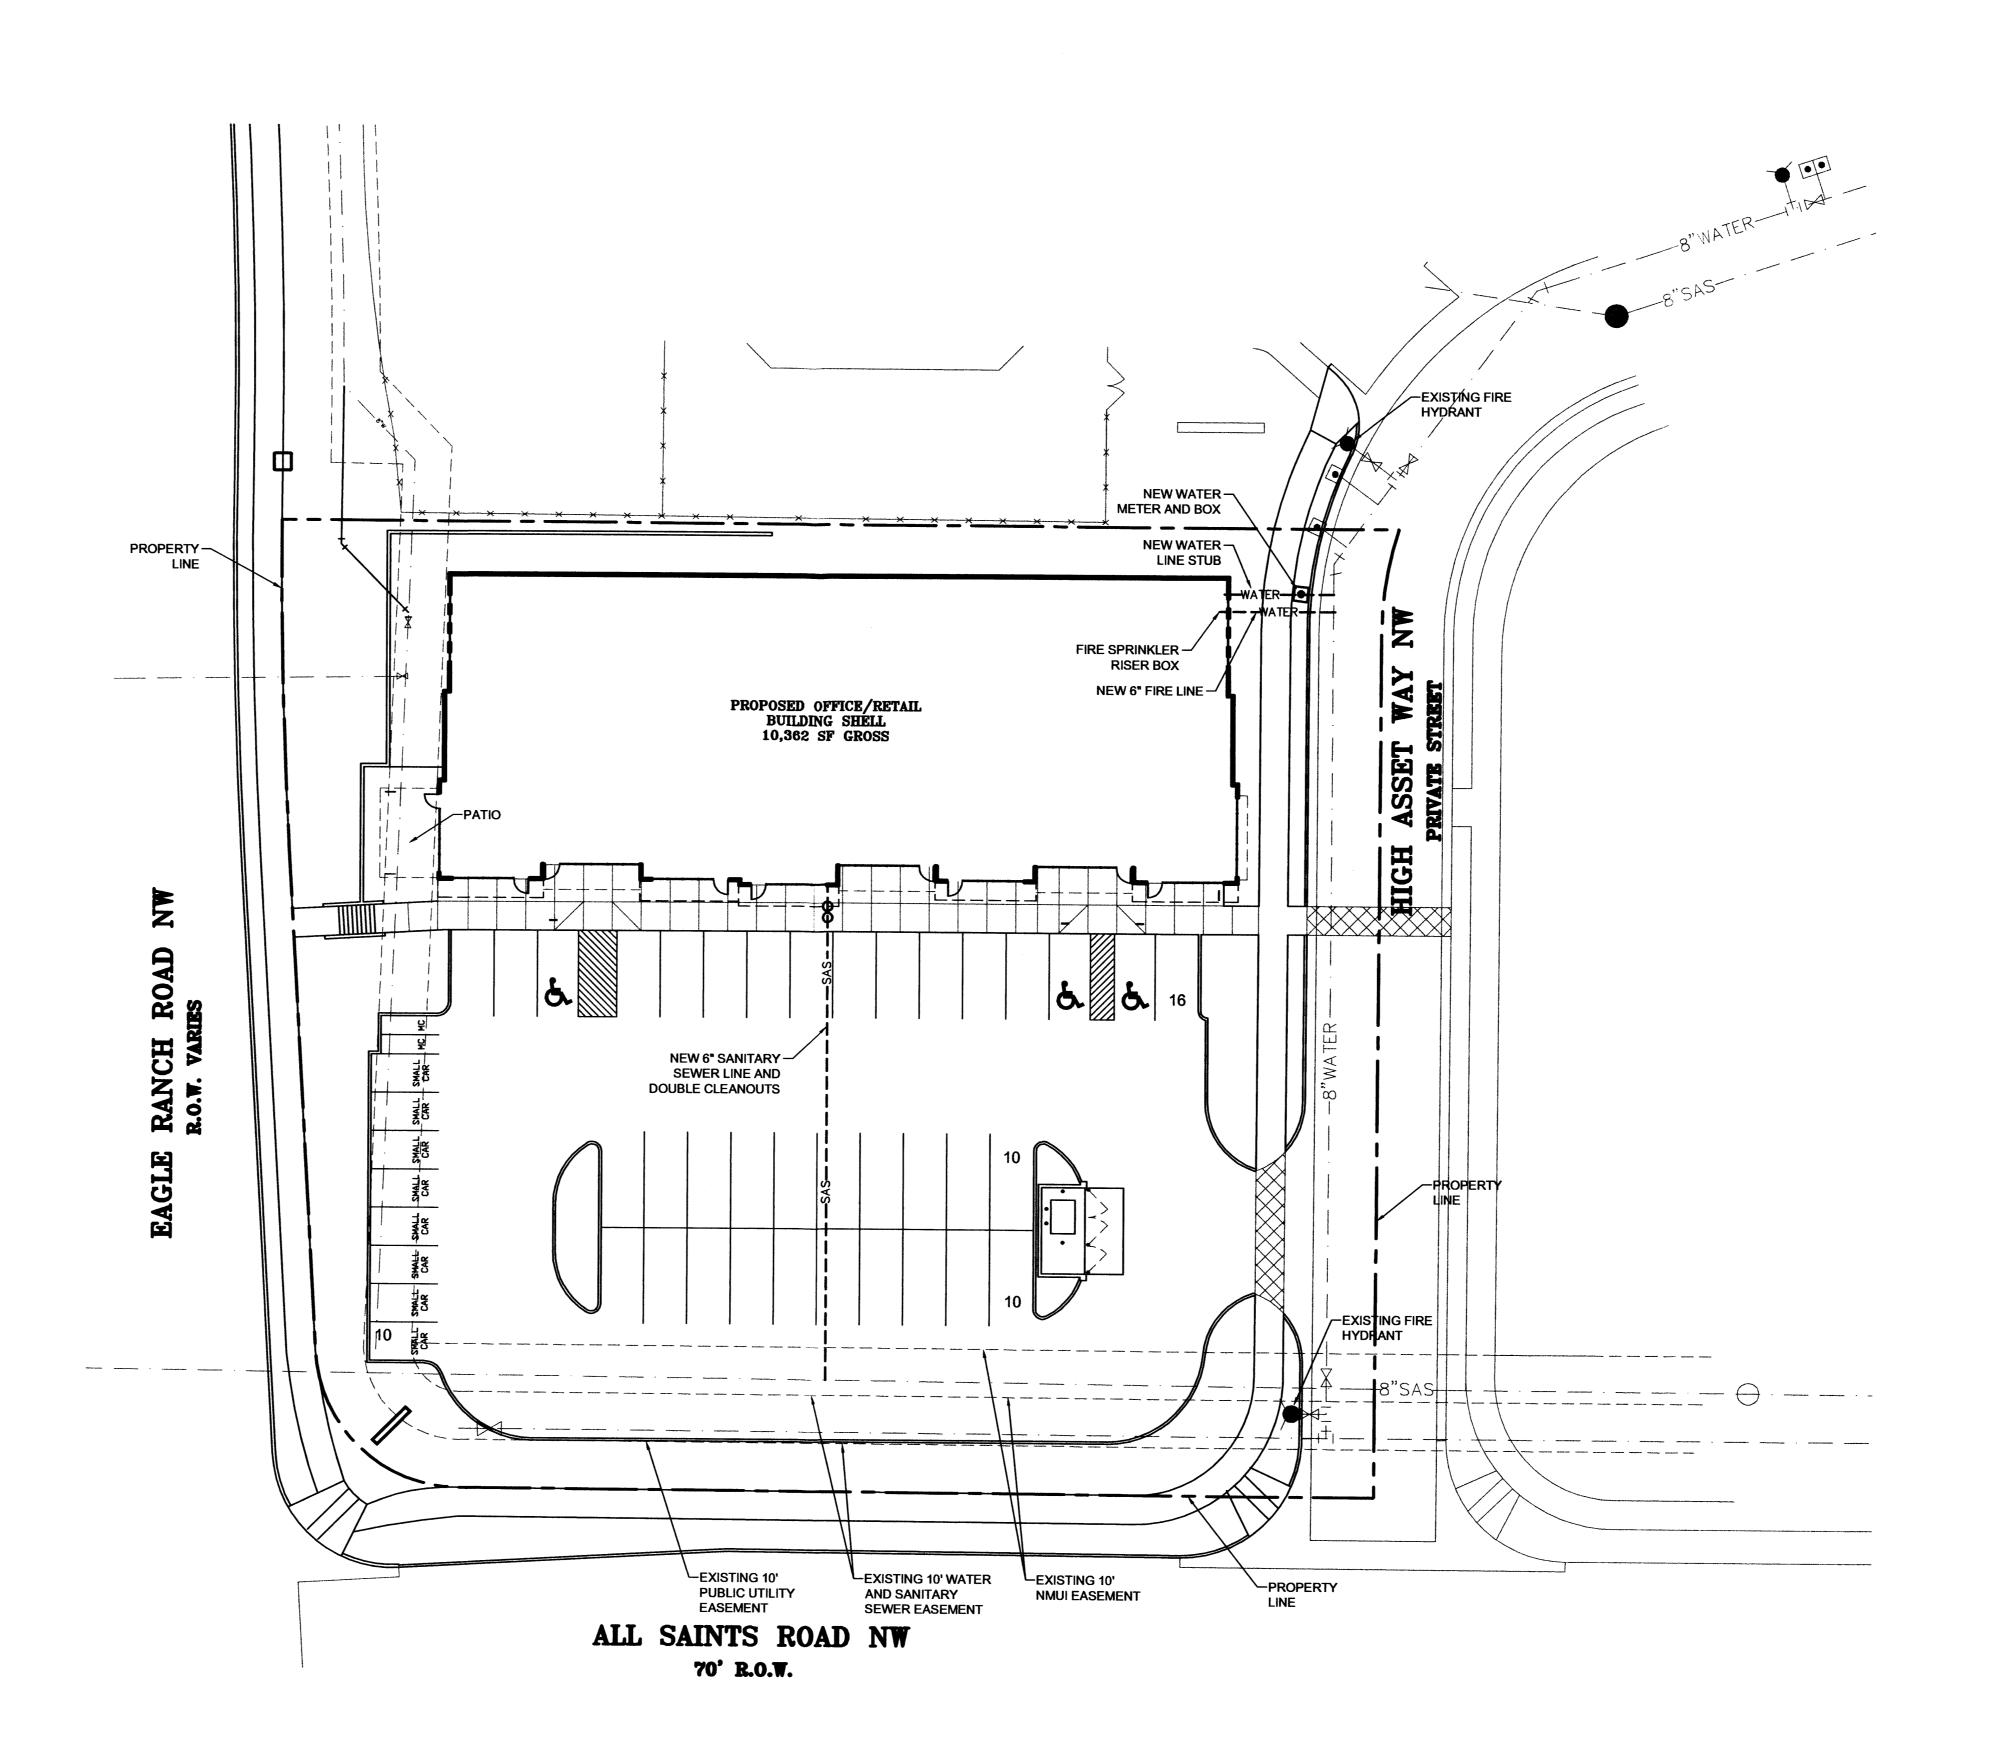


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HIGH ASSETS SHOPPING CENTER

BUILDING SHELL

ALL SAINTS ROAD NW
ALBUQUERQUE, NEW MEXICO

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PROJECT NUM	BER: 0626
DRAWING FILE	: 06260\3DESDEV\HA C-101 SI
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DATE:	OCTOBER 26, 200

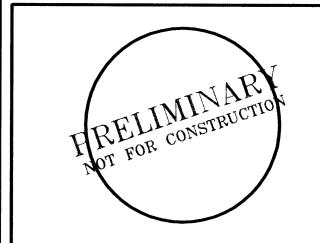SHEET TITLE

CONCEPTUAL

UTILITY PLAN

SHEET NUMBER
U-101

NORT