PROJECT NUMBER:

1003272

05 PRB 01657

Is an Infrastructure List required? () Yes No If yes, then a set of approved DRC plans with a work order is required for any construction within Public Right-of-Way or for construction of public improvements.

DRB SITE DEVELOPMENT PLAN SIGNOFF APPROVAL:

Traffic Engineering, Transportation Division

9-20-05

9-20-06

JOB NO:

DATE: Oct 05

REVISION: SEPT 06

DRAWN BY: JWM

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CHECKED BY: J.W.M.

9/20/06


REQUIRED - 1 ST FL - 2768/200 - 14 SPACES

> 2 ND FL - 2,268/300 - 8 SPACES

TOTAL SPACES REQUIRED = 22 SPACES

TOTAL SPACES PROVIDED = 23 SPACES

REQUIRED = 2 SPACES

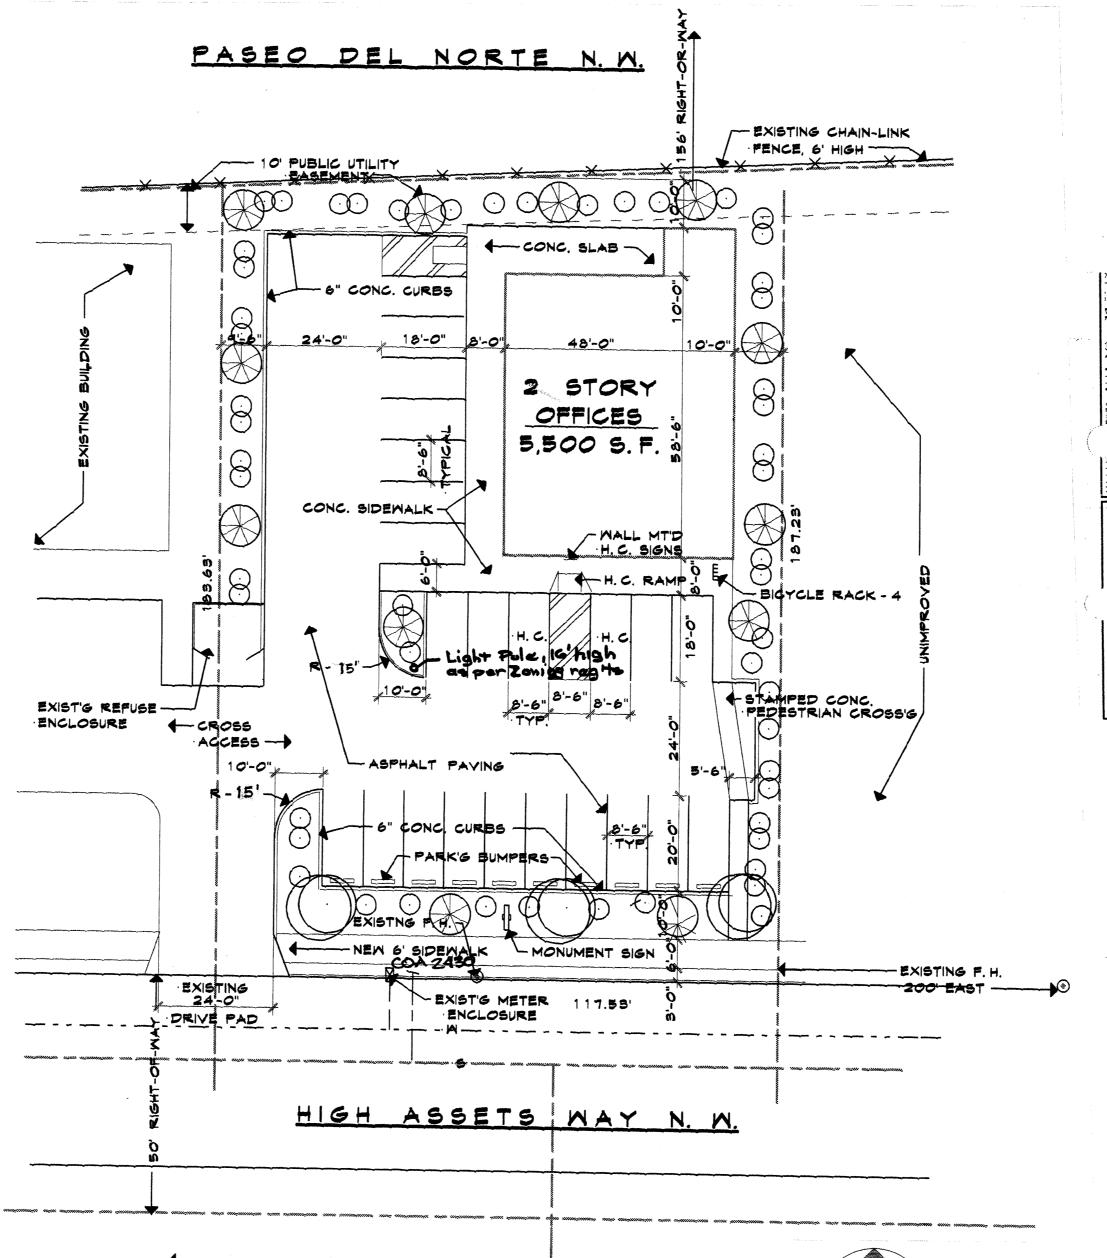

SITE PLAN 1" = 20'

0 10, 50, 30,

LEGAL DESCRIPTION

LOT #2-A-1-B-2-A UNIT TWO, ALBUQUERQUE, WEST SUBDIVISION, CITY OF ALBUQUERQUE, BERNALILLO COUNTY, NEW MEXICO


-FLARED SIDES

HANDICAPPED RAMP DETAIL

HANDICAPPED SIGN DETAIL

FINISH GRADE


'ADA' APPROVED H. C. SIGN

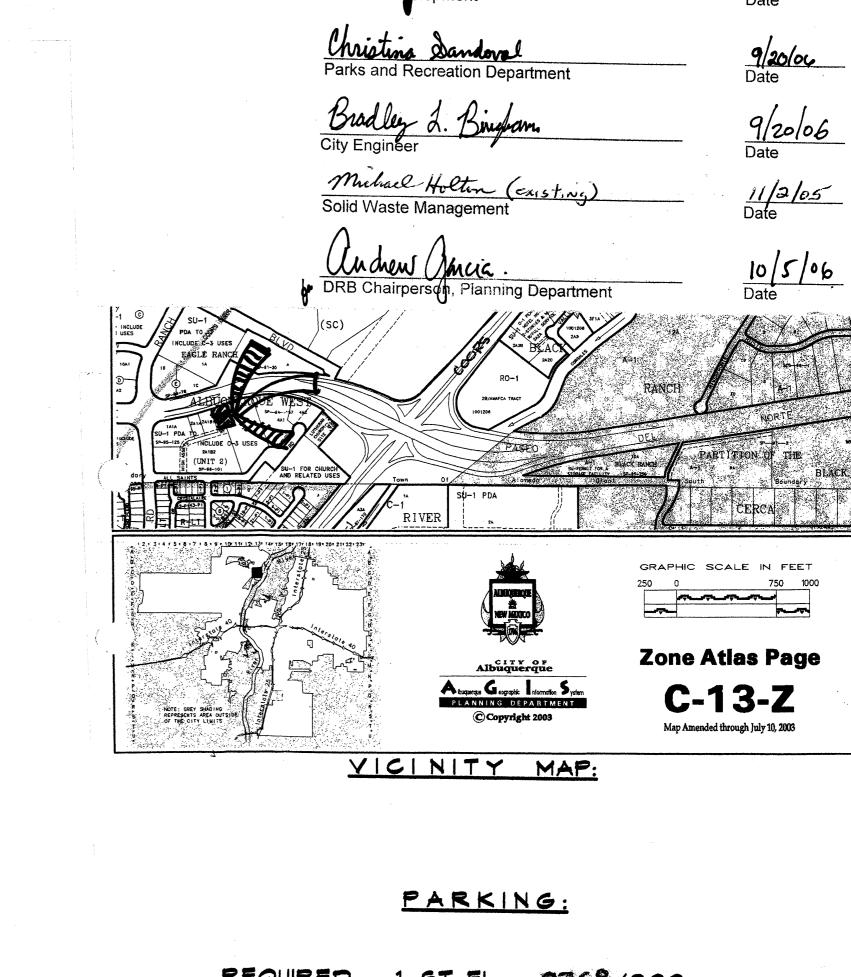


BICYCLE PARKING:

PROVIDED = 4 SPACES

JOB TITLE

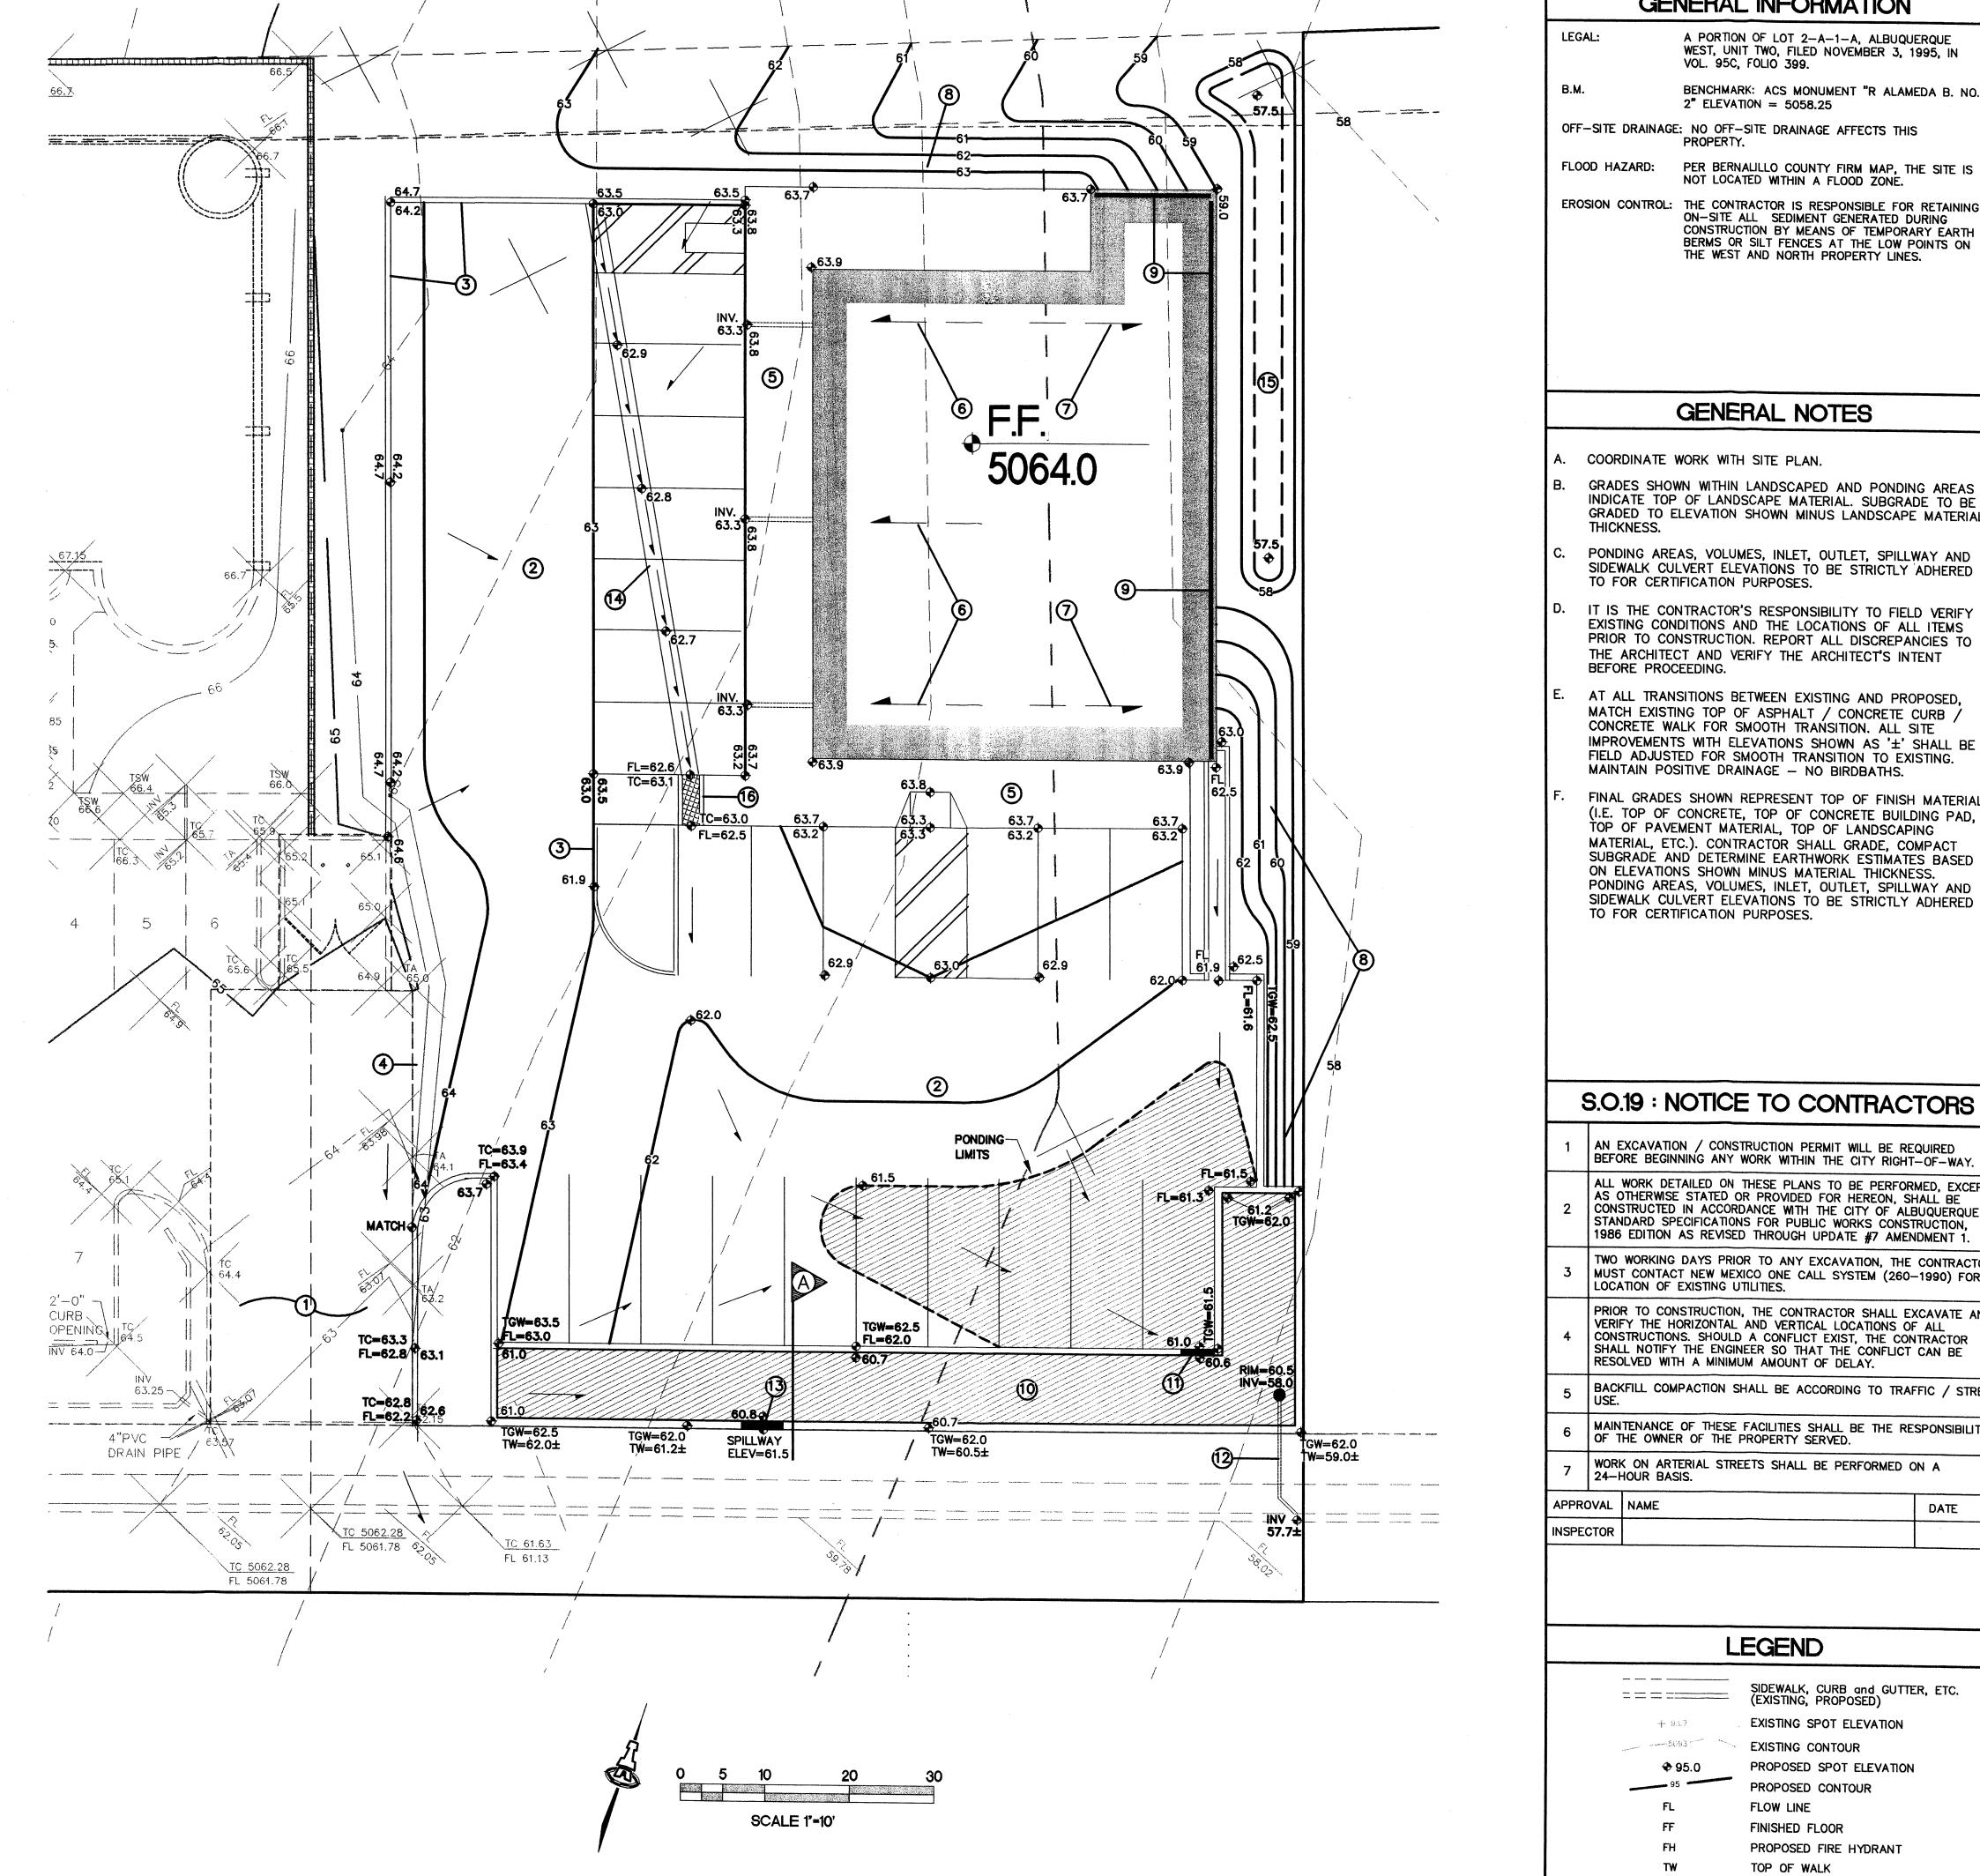

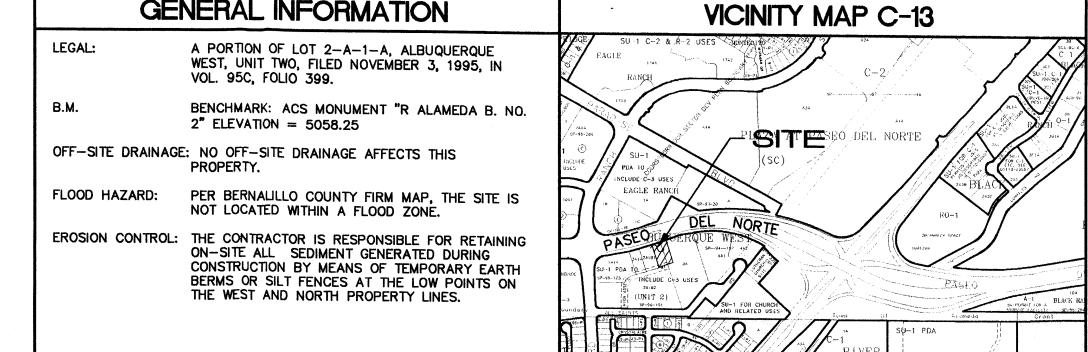

GENERAL NOTES

GENERAL INFORMATION

- COORDINATE WORK WITH SITE PLAN.
- GRADES SHOWN WITHIN LANDSCAPED AND PONDING AREAS INDICATE TOP OF LANDSCAPE MATERIAL. SUBGRADE TO BE GRADED TO ELEVATION SHOWN MINUS LANDSCAPE MATERIAL THICKNESS.
- PONDING AREAS, VOLUMES, INLET, OUTLET, SPILLWAY AND SIDEWALK CULVERT ELEVATIONS TO BE STRICTLY ADHERED TO FOR CERTIFICATION PURPOSES.
- IT IS THE CONTRACTOR'S RESPONSIBILITY TO FIELD VERIFY EXISTING CONDITIONS AND THE LOCATIONS OF ALL ITEMS PRIOR TO CONSTRUCTION. REPORT ALL DISCREPANCIES TO THE ARCHITECT AND VERIFY THE ARCHITECT'S INTENT BEFORE PROCEEDING.
- AT ALL TRANSITIONS BETWEEN EXISTING AND PROPOSED. MATCH EXISTING TOP OF ASPHALT / CONCRETE CURB / CONCRETE WALK FOR SMOOTH TRANSITION. ALL SITE IMPROVEMENTS WITH ELEVATIONS SHOWN AS '±' SHALL BE FIELD ADJUSTED FOR SMOOTH TRANSITION TO EXISTING. MAINTAIN POSITIVE DRAINAGE - NO BIRDBATHS.
- FINAL GRADES SHOWN REPRESENT TOP OF FINISH MATERIAL (I.E. TOP OF CONCRETE, TOP OF CONCRETE BUILDING PAD, TOP OF PAVEMENT MATERIAL, TOP OF LANDSCAPING MATERIAL, ETC.). CONTRACTOR SHALL GRADE, COMPACT SUBGRADE AND DETERMINE EARTHWORK ESTIMATES BASED ON ELEVATIONS SHOWN MINUS MATERIAL THICKNESS. PONDING AREAS, VOLUMES, INLET, OUTLET, SPILLWAY AND SIDEWALK CULVERT ELEVATIONS TO BE STRICTLY ADHERED TO FOR CERTIFICATION PURPOSES.

AN EXCAVATION / CONSTRUCTION PERMIT WILL BE REQUIRED

BEFORE BEGINNING ANY WORK WITHIN THE CITY RIGHT-OF-WAY.

ALL WORK DETAILED ON THESE PLANS TO BE PERFORMED, EXCEPT AS OTHERWISE STATED OR PROVIDED FOR HEREON, SHALL BE

CONSTRUCTED IN ACCORDANCE WITH THE CITY OF ALBUQUERQUE STANDARD SPECIFICATIONS FOR PUBLIC WORKS CONSTRUCTION,

TWO WORKING DAYS PRIOR TO ANY EXCAVATION, THE CONTRACTOR MUST CONTACT NEW MEXICO ONE CALL SYSTEM (260-1990) FOR

PRIOR TO CONSTRUCTION, THE CONTRACTOR SHALL EXCAVATE AND

VERIFY THE HORIZONTAL AND VERTICAL LOCATIONS OF ALL

RESOLVED WITH A MINIMUM AMOUNT OF DELAY.

OF THE OWNER OF THE PROPERTY SERVED.

CONSTRUCTIONS. SHOULD A CONFLICT EXIST, THE CONTRACTOR

SHALL NOTIFY THE ENGINEER SO THAT THE CONFLICT CAN BE

BACKFILL COMPACTION SHALL BE ACCORDING TO TRAFFIC / STREET

MAINTENANCE OF THESE FACILITIES SHALL BE THE RESPONSIBILITY

DATE

WORK ON ARTERIAL STREETS SHALL BE PERFORMED ON A

LEGEND

SIDEWALK, CURB and GUTTER, ETC. (EXISTING, PROPOSED)

EXISTING SPOT ELEVATION

PROPOSED SPOT ELEVATION

PROPOSED FIRE HYDRANT

TOP OF GARDEN WALL

EXISTING CONTOUR

PROPOSED CONTOUR

FLOW LINE

FINISHED FLOOR

TOP OF WALK

1986 EDITION AS REVISED THROUGH UPDATE #7 AMENDMENT 1.

LOCATION OF EXISTING UTILITIES.

24-HOUR BASIS.

� 95.0

KEYED NOTES

SOUTHWESTERN INDIAN POLYTECHNICAL INSTITUTE

U S INDIAN SERVICE

1"=750'±

- 1) EXISTING SHARED SITE ACCESS
- PROPOSED ASPHALT PAVING. SEE ARCHITECTURAL FOR INFORMATION REGARDING PARKING LAYOUT, DIMENSIONS, STRIPING, ETC.
- (3) CONSTRUCT MEDIAN CURB AND GUTTER PER C.O.A. STD. DWG. 2415 シ (TYPICAL).
- (4) PAVING HIGH POINT THIS AREA. NO OFFSITE FLOW ENTERS SITE.
- (5) CONSTRUCT TURNED DOWN CONCRETE WALK THIS AREA. TOP OF WALK IS 6" ABOVE TOP OF ADJACENT PAVEMENT (TYPICAL). SEE ARCHITECTURAL FOR RAMP LOCATIONS / DIMENSIONS AND ADDITIONAL
- 6) ROOF TO SHED EAST AND WEST AS SHOWN. ALL WEST ROOF DRAINAGE SHALL BE RELEASED DIRECTLY TO PAVEMENT THROUGH PVC PIPES THROUGH WALK. SEE ARCHITECTURAL FOR SPECIFIC OUTFALL
- 7) ALL EAST ROOF DRAINAGE SHALL BE CAPTURED WITHIN A GUTTER SYSTEM TO BE RELEASED TO A 2' WIDE 'U' SHAPED CONCRETE CHANNEL AT THE SOUTHEAST BUILDING CORNER. SEE DETAIL THIS
- 8) CONSTRUCT SITE RETAINING WALL OR ARMORED SIDESLOPE (ANGULAR FACED ROCK, 8" AVG. DIA.) THIS AREA TO ACHIEVE GRADE DIFFERENCES SHOWN. SEE ARCHITECTURAL FOR ADDITIONAL INFORMATION (DESIGN BY OTHERS).
- 9) CONSTRUCT EXTENDED STEMWALL THIS AREA TO ACHIEVE GRADE DIFFERENCES SHOWN. SEE ARCHITECTURAL FOR ADDITIONAL INFORMATION (DESIGN BY OTHERS).
- (10) CONSTRUCT 1.5' MAX. DEPTH DETENTION POND WITH CONCRETE PERIMETER WALLS AT ELEVATIONS SHOWN TO CAPTURE SITE FLOW. POND DIMENSIONS AND ELEVATIONS TO BE STRICTLY ADHERED TO FOR CERTIFICATION PURPOSES. SEAL JOINTS WITH URETHANE SEALANT (SONOLASTIC NP-1 O.A.E.)
- PROVIDE 4' WIDE OPENING IN CURB TO PASS CONCENTRATED FLOW TO PONDING AREA. INSTALL COBBLES AT OPENING FOR EROSION
-) INSTALL POND OUTLET STRUCTURE AND 4" DIA. PVC PIPE AT INVERT ELEVATIONS SHOWN TO CONTROL RELEASE OF PONDED WATER TO HIGH ASSETS WAY. SEE DETAIL THIS SHEET. S.O.19 PERMIT REQUIRED. SEE FORM THIS SHEET.
- (13) CONSTRUCT 5' WIDE SPILLWAY TO RELEASE POND VOLUME IN EXCESS OF REQUIRED STORAGE. SEE DETAIL SHEET C-2.
- (14) CONSTRUCT 68 LF 2' WIDE CONCRETE VALLEY GUTTER AT FLOWLINE ELEVATIONS SHOWN (SLOPE < 1.0%) TO DIRECT FLOW SOUTH TO
- CONSTRUCT 6" DEEP LANDSCAPED STILLING BASIN TO CAPTURE MINOR PERIMETER FLOW AND UTILIZE FOR LANDSCAPE.
- 6 CONSTRUCT 2' WIDE (BOTTOM WIDTH) X 6" DEEP 'U' SHAPED CONCRETE CHANNEL (6" THICK CONCRETE) TO PASS FLOW THROUGH WALK. PROVIDE STEEL PLATE COVER FLUSH WITH WALK.

JSAACSON & ARFMAN, P.A. Consulting Engineering Associates

128 Monroe Street N.E. Albuquerque, New Mexico 87108

Ph. 505-268-8828 Fax. 505-268-2632

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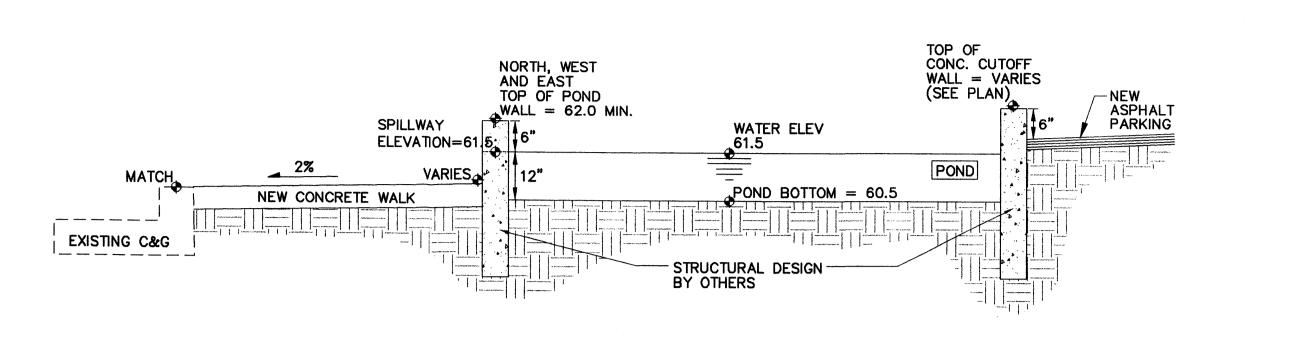
This design, calculations, and concepts are owned by and remain the property of Isaacson &

HIGH ASSETS LEGAL OFFICE


Micheal Barthelemy

GRADING AND DRAINAGE PLAN


1483 09-11-06 Drawn By: Ckd By: FCA




POND SECTION A

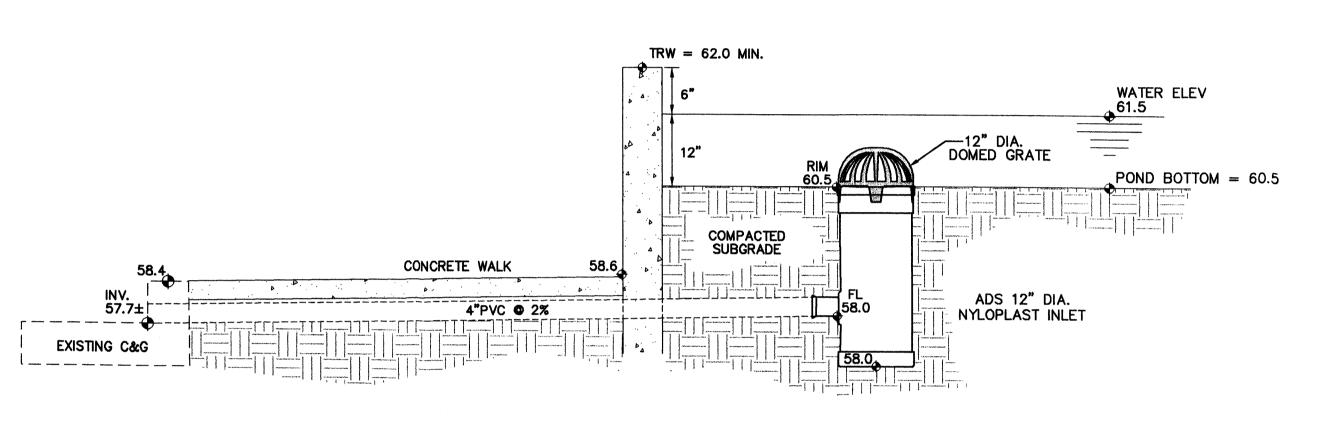

NYLOPLAST OUTLET STRUCTURE

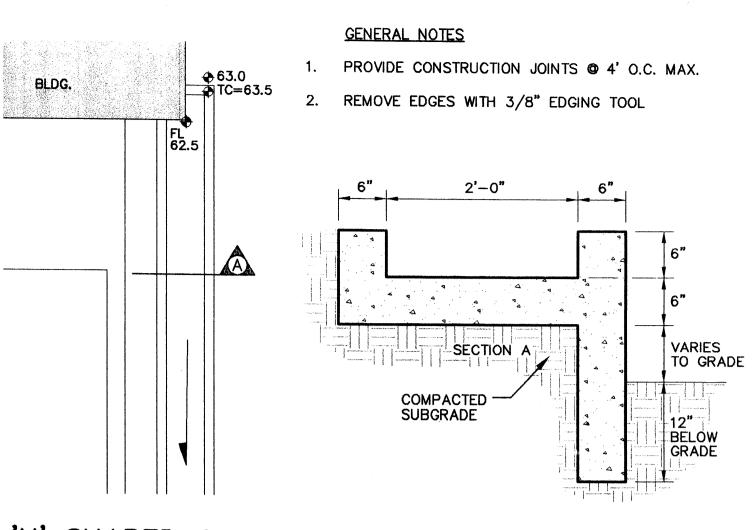


'U' SHAPED CONC. CHANNEL

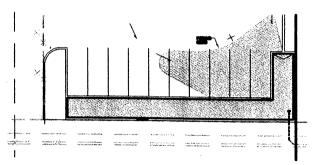

N.T.S.


GENERAL NOTES

REMOVE EDGES WITH 3/8" EDGING TOOL

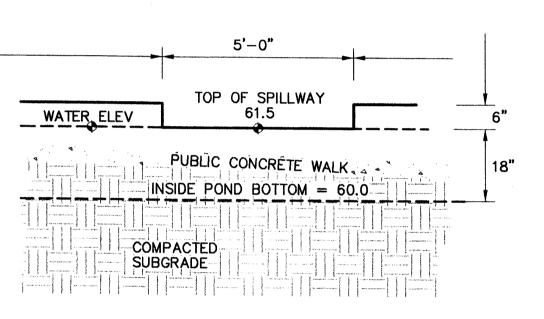

POND SPILLWAY ELEVATION


N.T.S

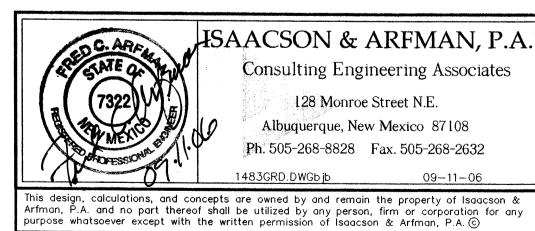


HIGH ASSETS LEGAL OFFICE Micheel Barthelemy

GRADING AND DRAINAGE PLAN

Date:	No.	Revision:	Date:	Job No.
09-11-06				1483
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Ckd By: FCA				SH. OF

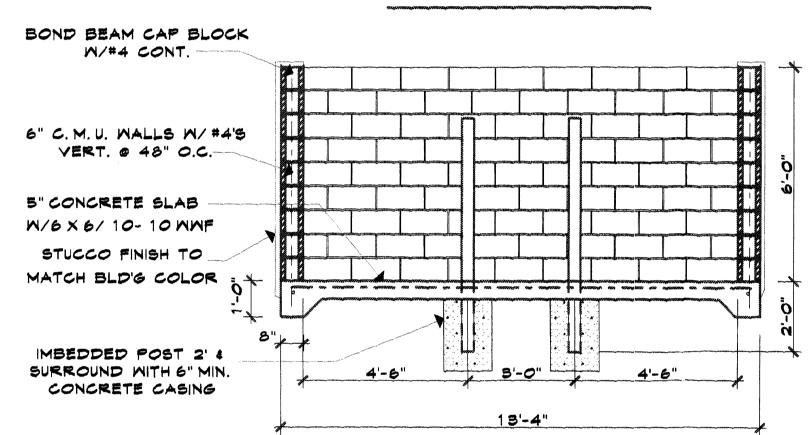


TRASH ENCLOSURE

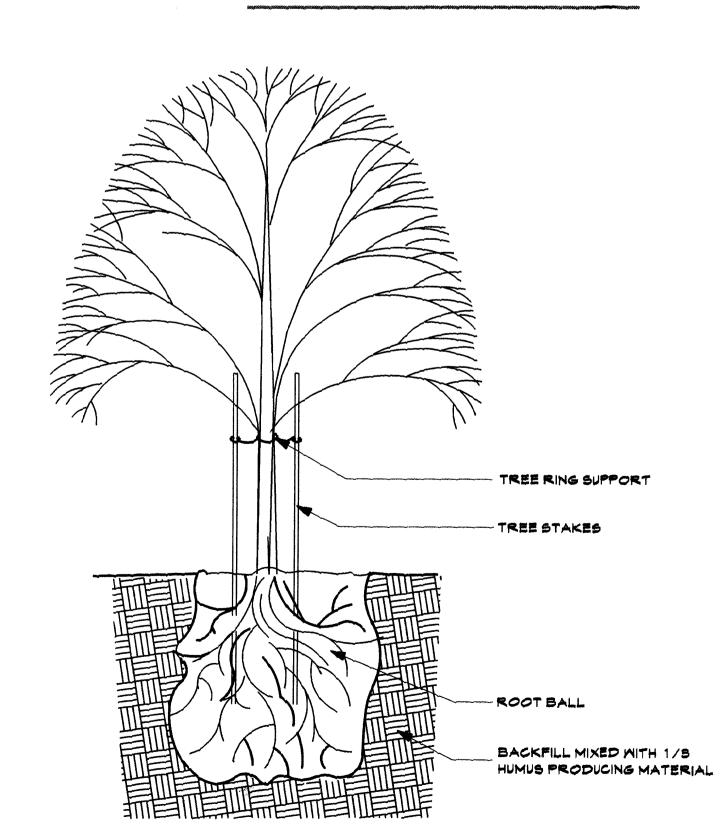

TREE PLANTING DETAIL

SCALE: 5/8" = 1'-0"

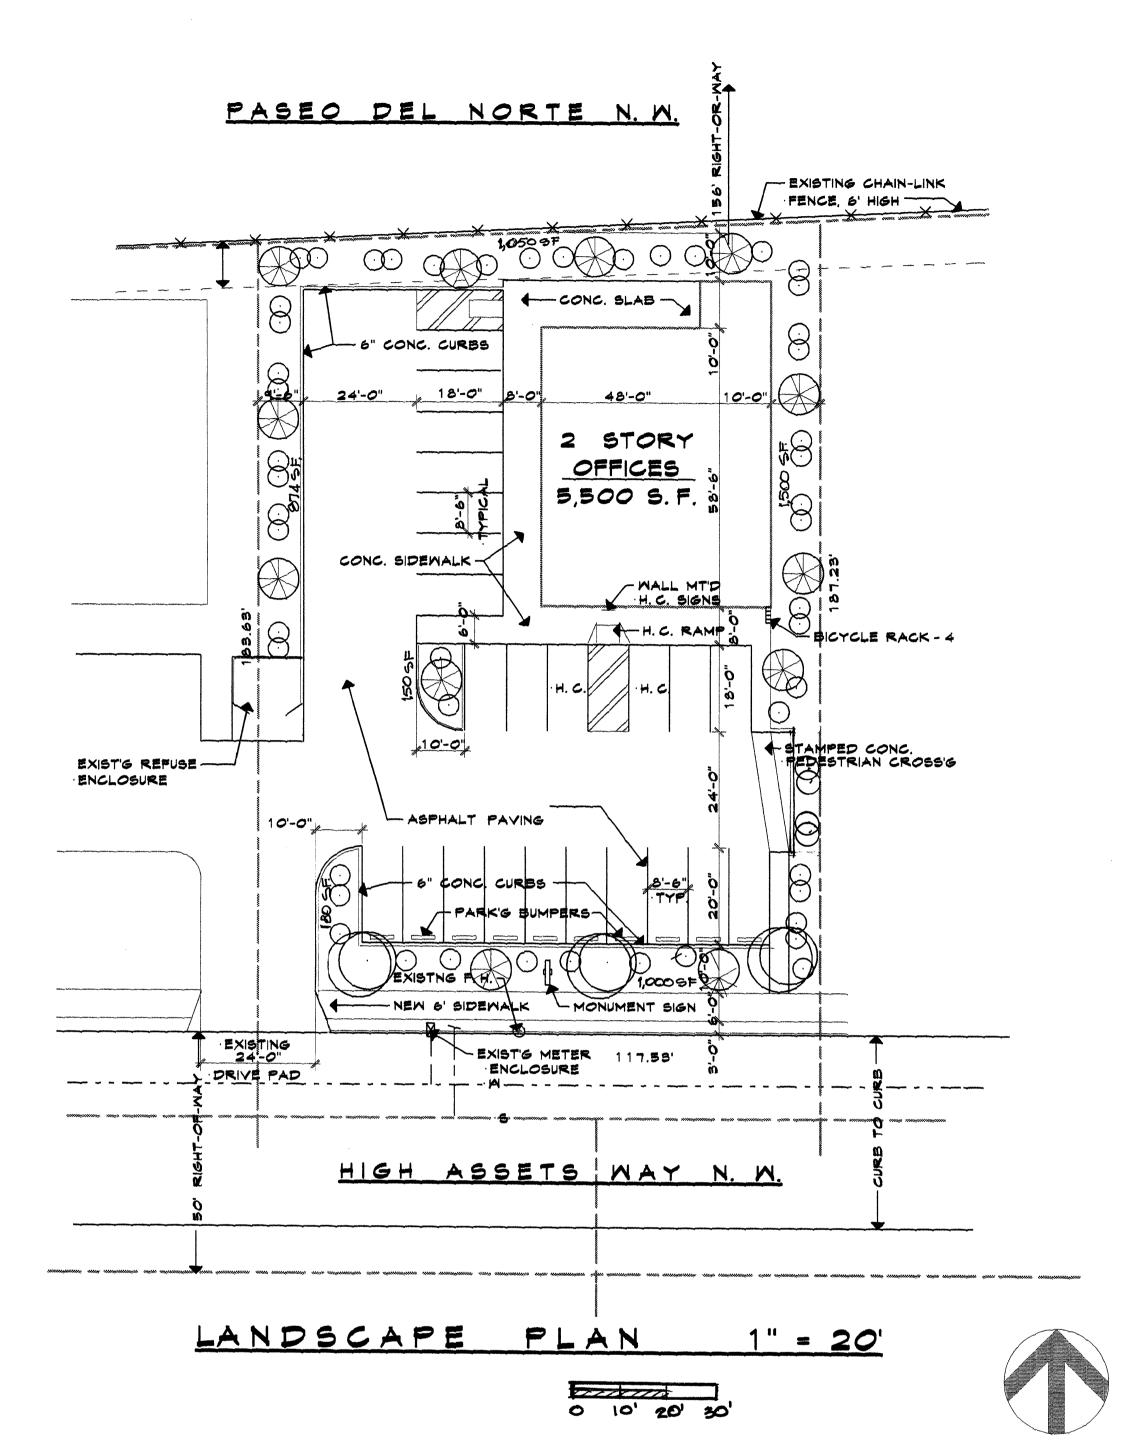

LANDSCAPE NOTES:

IT IS THE INTENT OF THIS PLAN TO COMPLY WITH THE CITY OF ALBUQUERQUE WATER CONSERVATIO LANDSCAPING AND WATER WASTE ORDINANCE PLANTING RESTRICTION APPROACH. APPROVAL OF THIS PLAN DOES NOT CONSTITUTE OR IMPLY EXEMPTION FROM WATER WASTE PROVISIONS OF THE WATER CONSERVATION LANDSCAPING AND MATER MASTE ORDINANCE. MATER MANAGEMENT IS THE SOLE RESPONSIBILITY OF THE PROPERTY OWNER

IN GENERAL, WATER CONSERATIVE, ENVIRONMENTALLY SOUND LANDSCAPE PRINCIPLES M WILL BE FOLLOWED IN DESIGN AND INSTALLATION

PLANT BEDS SHALL ACHIEVE 75 % LIVE GROUND COVER AT MATURITY.

SFB GRAVEL OVER FILTER FABRIC SHALL BE PLACED IN ALL LANDSCAPE AREAS WHICH ARE NOT DESIGNATED TO RECEIVE NATIVE SEED

IRRIGATIONN NOTES

IRRIGATION SHALL BE A COMPLETE UNDERGROUND SYSTEM WITH TREES TO RECEIVE (5) & SHRUBS TO RECEIVE (2) 1.0 GPH DRIP EMITTERS. DRIP & BUBBLER SYSTEMS TO BE TIED TO 1/2" POLYPIPE W/FLUSH CAPS AT EACH END.

RUN TIME PER EACH TRIP WILL BE APPROXIMATELY 15 MINUTE PER DAY, TO BE ADJUSTED ACCORDING TO THE SEASON.

LANDSCAPE LEGEND:

CHINESE PISTACNE - 2" CALIPHER (MODERATE WATER USE) - 3 PLANTS

AUSTRIAN PINE - 2" CALIPHER (MODERATE WATER USE) - 12 PLANTS

SPANISH BROOM - 5 GAL - 5 GAL (MODERATE WATER USE) -44 PLANTS

GROUND COVER - 3/4" GRAVEL SANTA FE TAN'

IRRIGATION BY DRIP IRRIGATION SYSTEM

LANDSCAPE REQUIRED

LAND AREA 22,005 S.F. - 3,000 S.F. \times 15% = 2,851 SQ. FT.

LANDSCAPE PROVIDED:

1,050 + 180 + 150 = 4,754 SQ. FT.

LANDSCAPE TO PROPERTY RATIO:

4,754 S. F. / 22,005 S. F. = 21%

GRASS SOD - 'ALBUQUERQUE BLEND'

MAINTENANCE BY OWNER

874 + 1,000 + 1,500

ALL LANDSCAPING WILL BE IN CONFORMANCE W/CITY OF ALBUQ. ZONING CODE, STREET TREE OR'D POLLEN, WASTE WATER & WATER CON-SERVATION LANDSCAPE ORDINANCES

JOB TITLE

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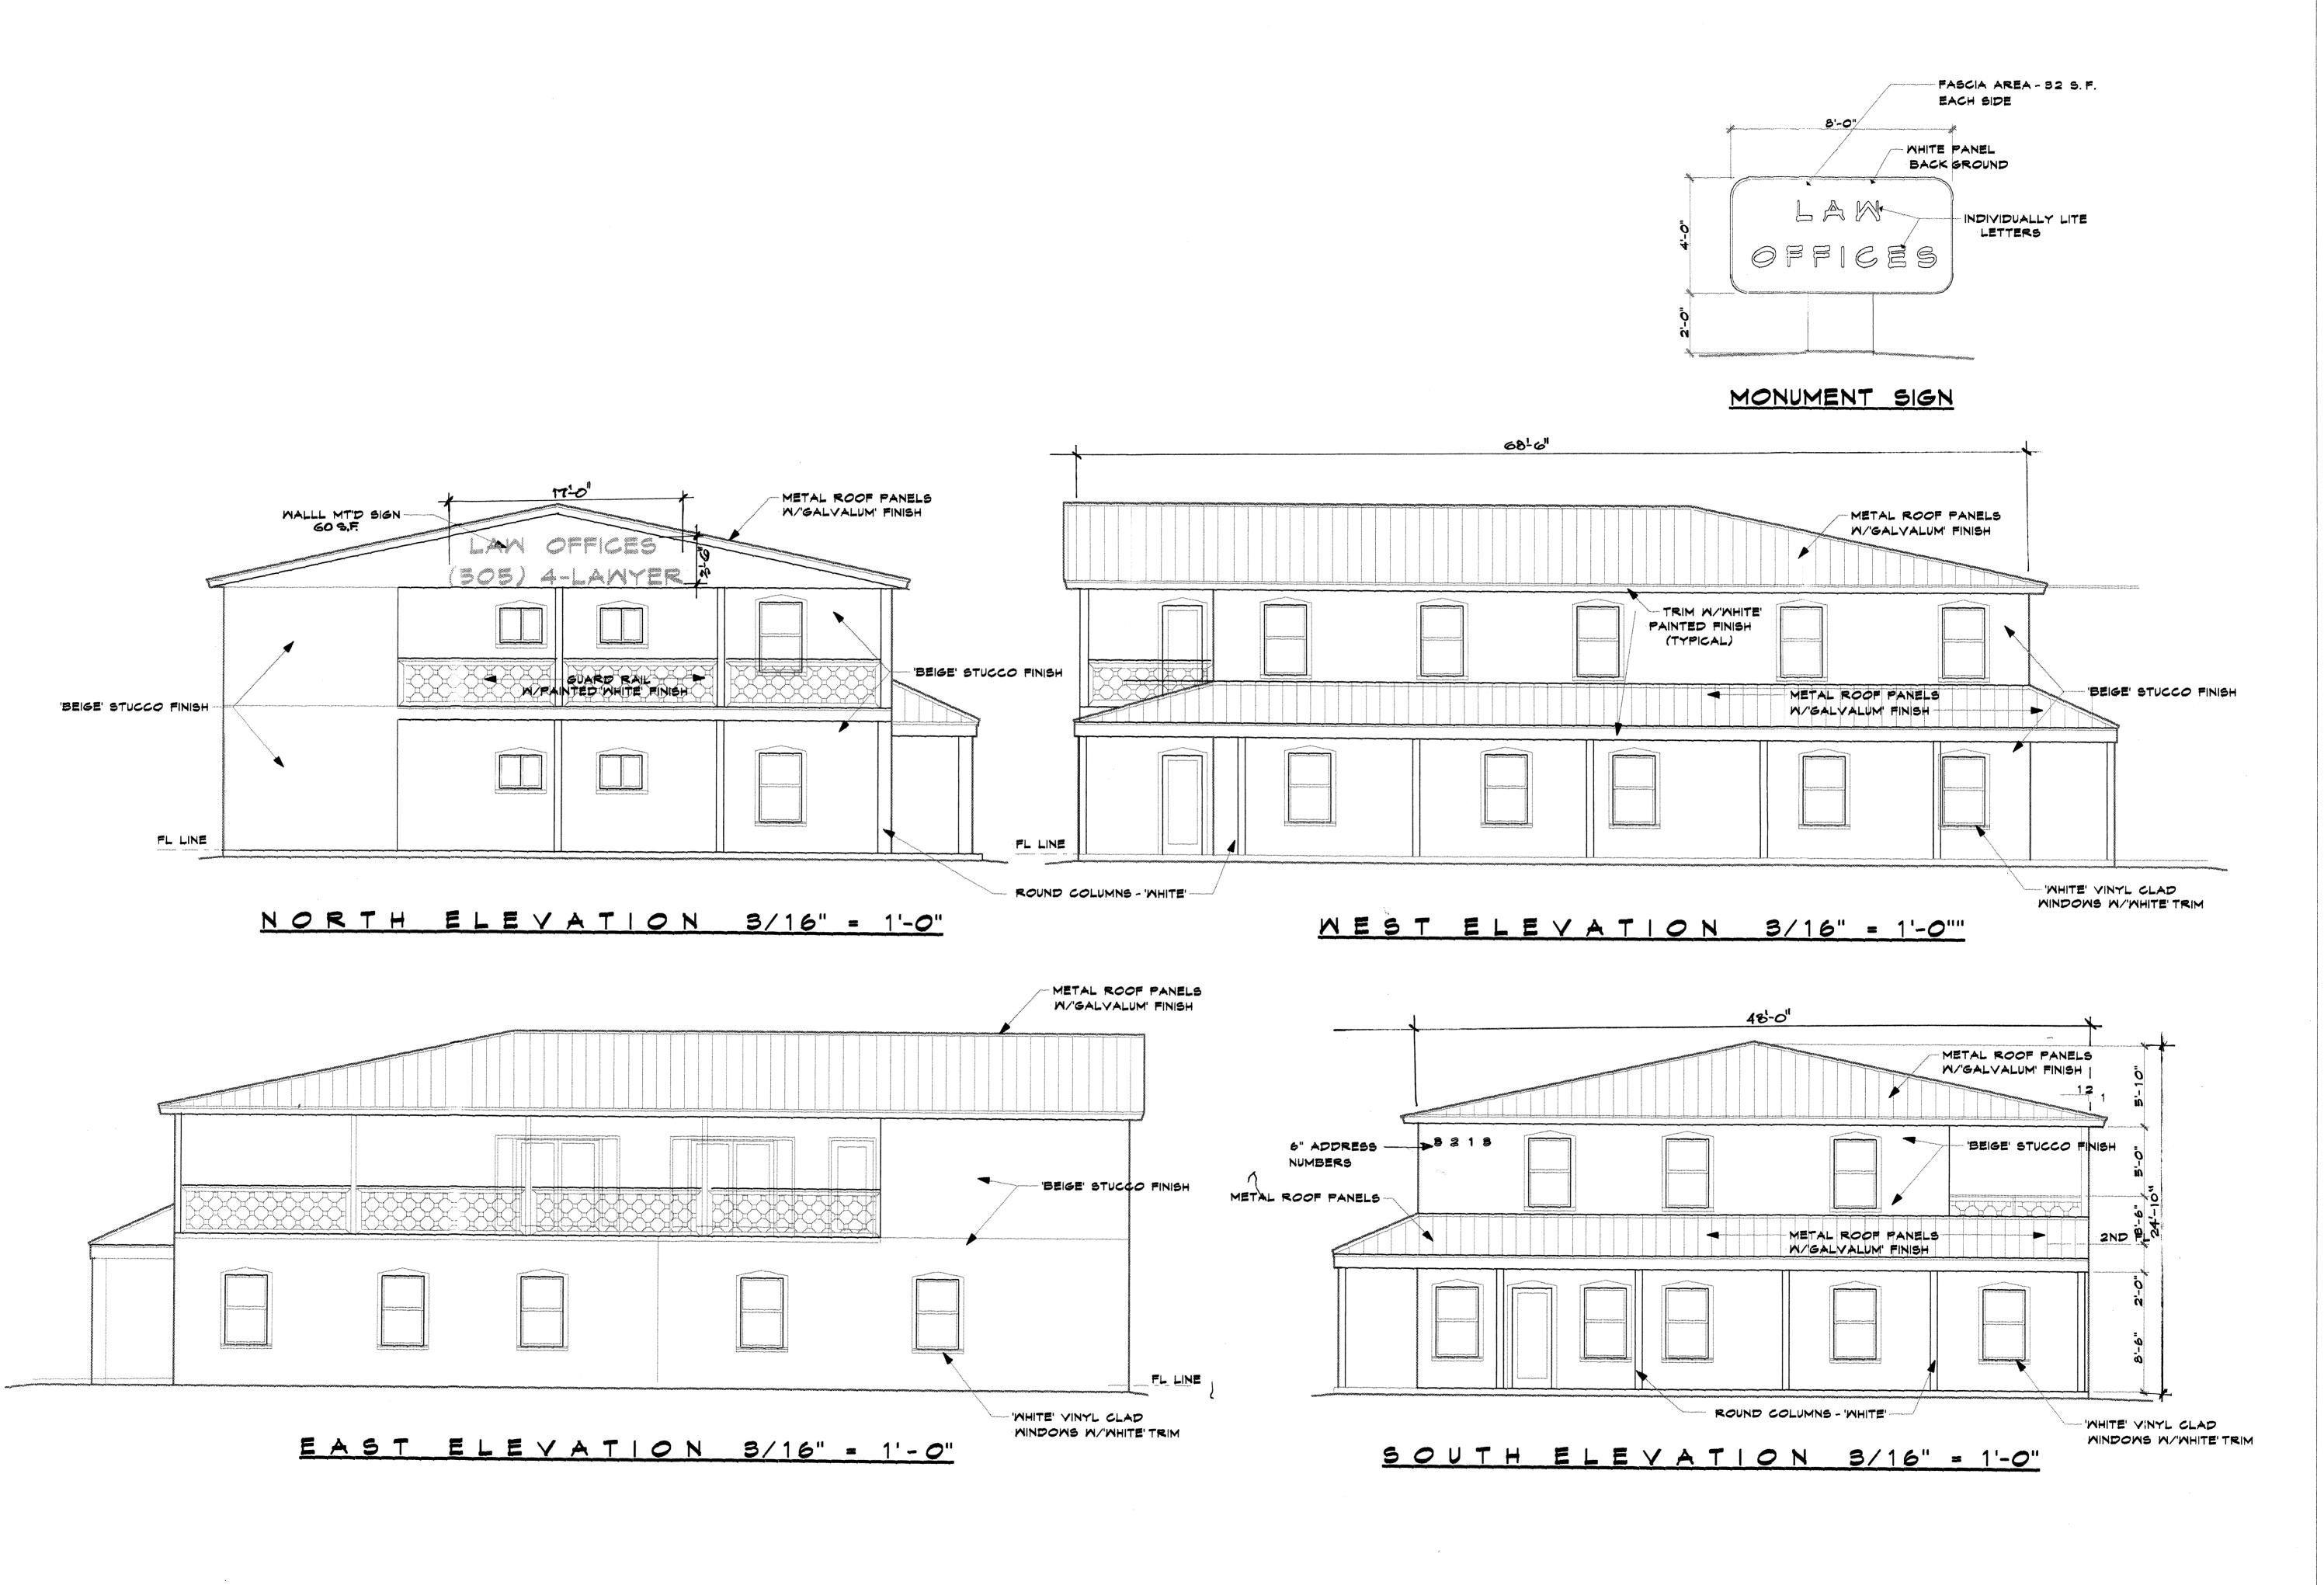
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REVISION:

DRAWN BY:

CHECKED BY:



Oct 65 REVISION SOPE OF

DRAWN BY
TWM. CHECKED BY

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MILLER AND ASOCIATES
ARCHITECTS PLANNERS
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