


Warehouse for Commercial Enterprises
 8901 WASHINGTON PLACE NE ALBUQUERQUE, NEW MEXICO


KEN HOVEY, ARCHITECT
 505) 259-8488 * 3808 SIMMS AVENUE SE * ALBUQUERQUE, NM * 87108

JOB NO:	0309
DATE:	30 MARCH 2004
REVISIONS	

SHEET NO.
C.1

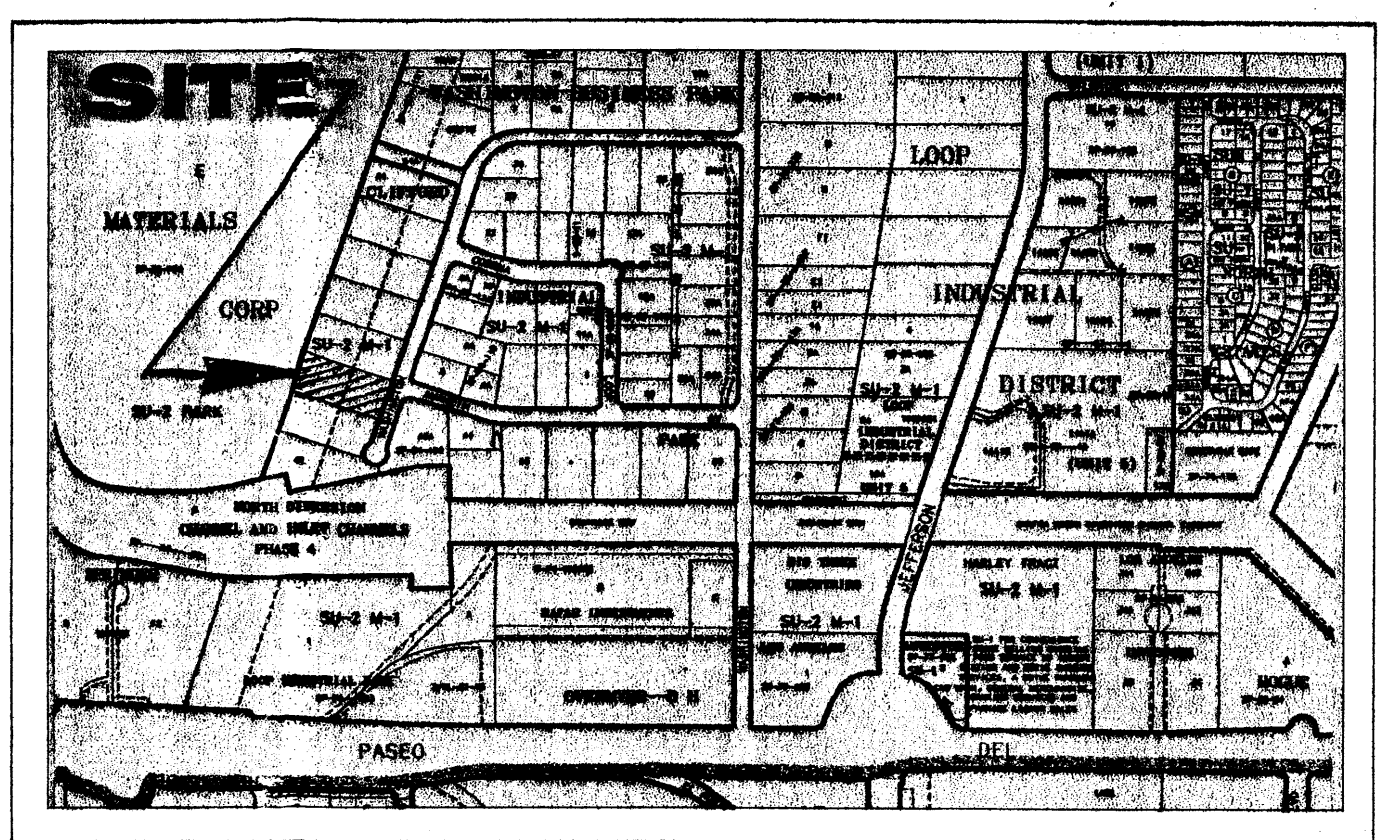


VICINITY MAP ZONE ATLAS NO. C-17-Z

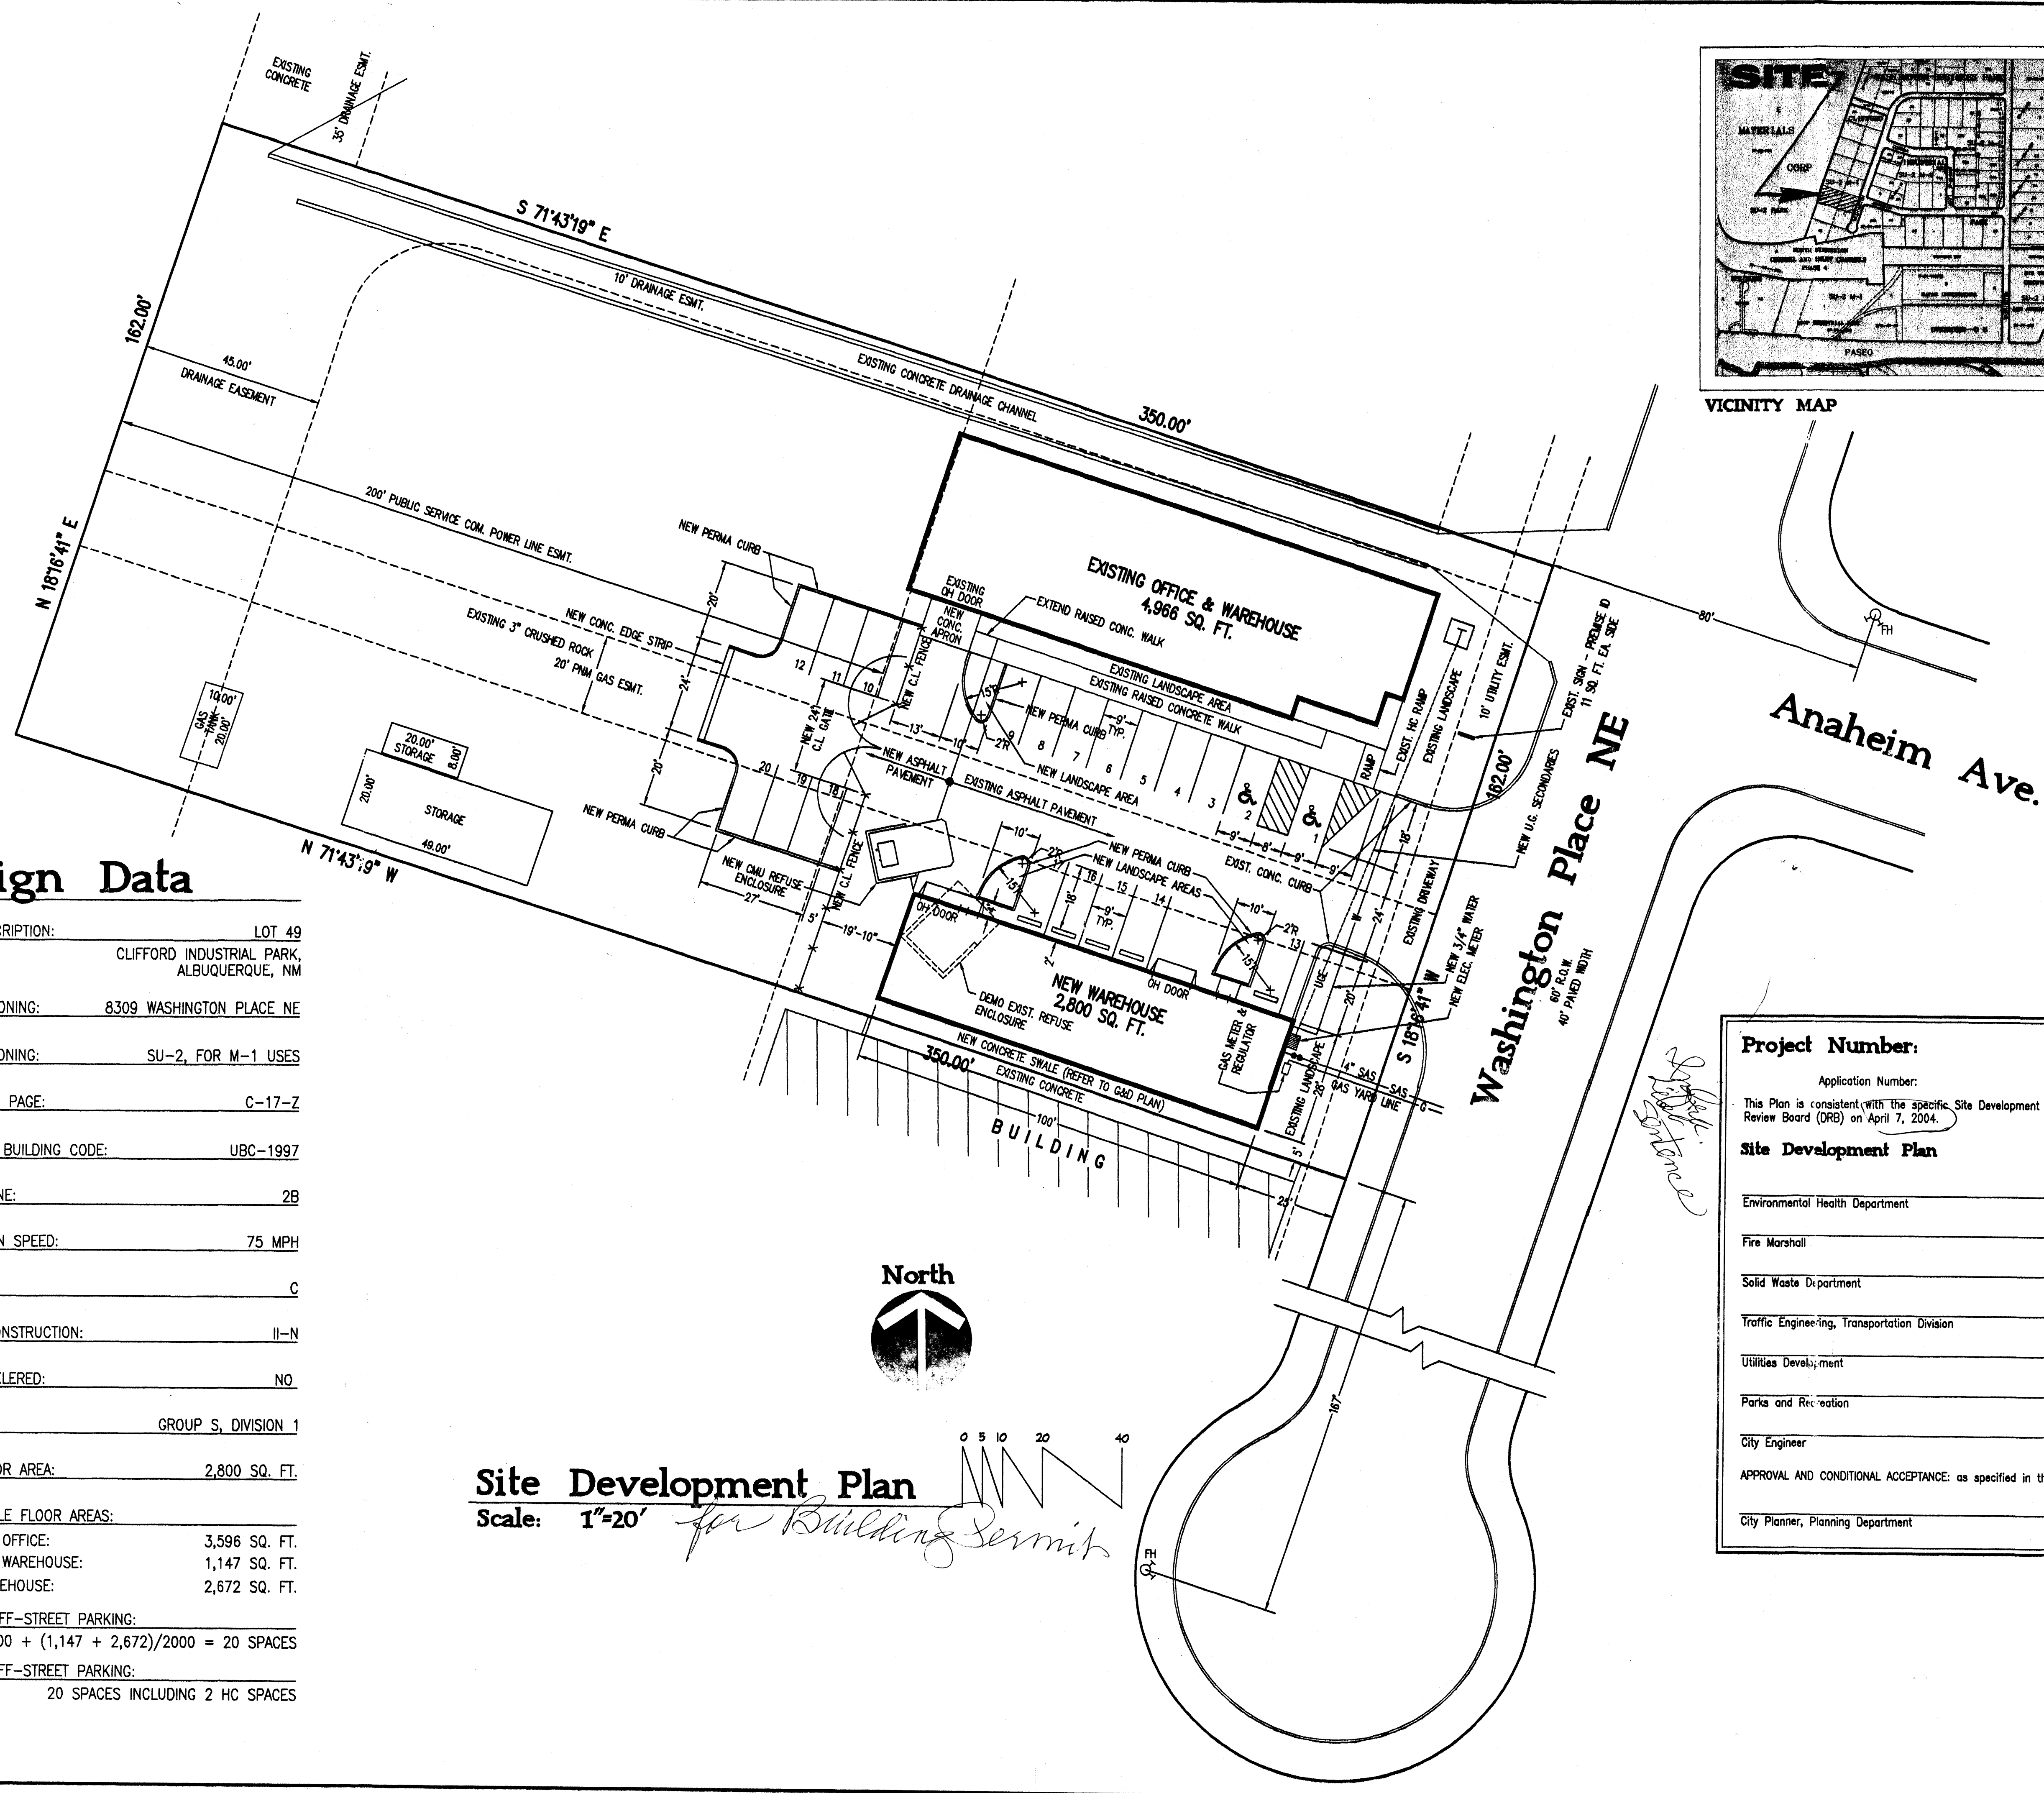


Design Data

LEGAL DESCRIPTION:	LOT 49 CLIFFORD INDUSTRIAL PARK, ALBUQUERQUE, NM
CURRENT ZONING:	8309 WASHINGTON PLACE NE
CURRENT ZONING:	SU-2, FOR M-1 USES
ZONE ATLAS PAGE:	C-17-Z
APPLICABLE BUILDING CODE:	UBC-1997
SEISMIC ZONE:	2B
WIND DESIGN SPEED:	75 MPH
EXPOSURE:	C
TYPE OF CONSTRUCTION:	II-N
FIRE SPRINKLERED:	NO
OCCUPANCY:	GROUP S, DIVISION 1
GROSS FLOOR AREA:	2,800 SQ. FT.
NET LEASABLE FLOOR AREAS:	
EXISTING OFFICE:	3,596 SQ. FT.
EXISTING WAREHOUSE:	1,147 SQ. FT.
NEW WAREHOUSE:	2,672 SQ. FT.
REQUIRED OFF-STREET PARKING:	
$3,596/200 + (1,147 + 2,672)/2000 = 20$ SPACES	
PROVIDED OFF-STREET PARKING:	
20 SPACES INCLUDING 2 HC SPACES	

Site Development Plan
 Scale: 1"=20' for Building Permit

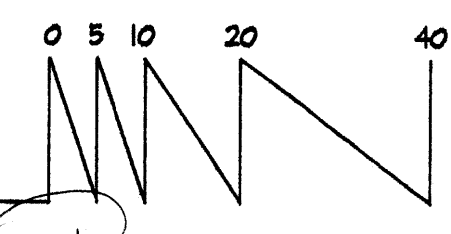

Ken Hovey

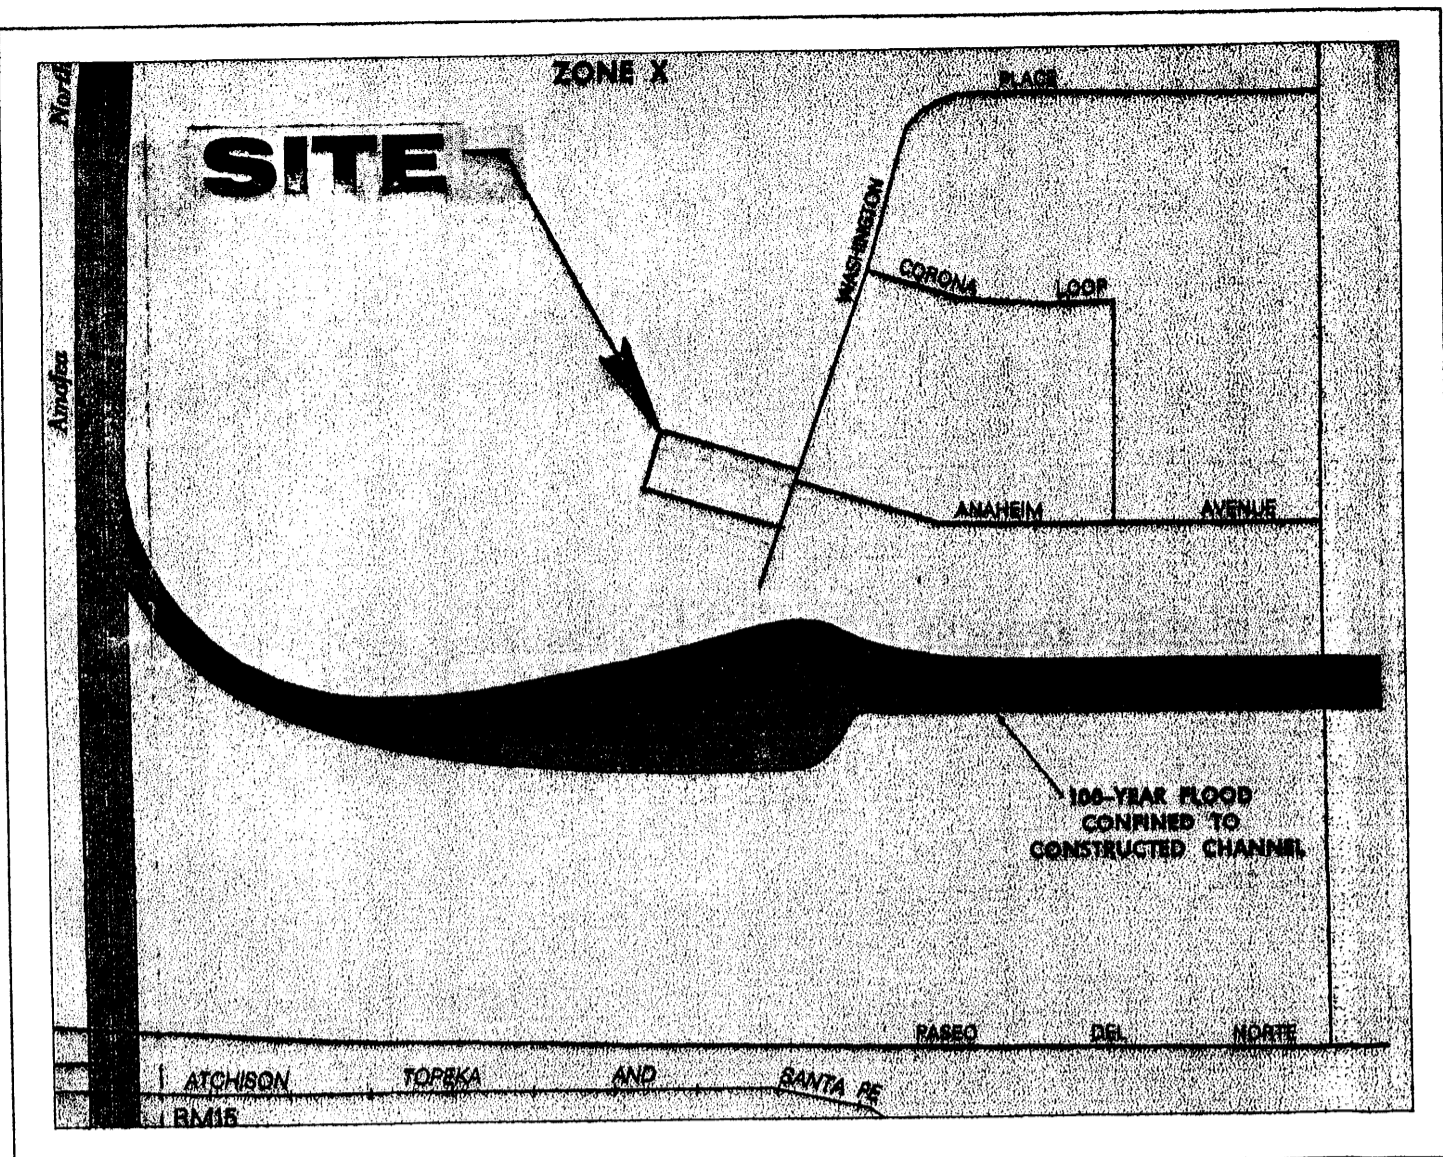

FLOOD INSURANCE RATE MAP MAP NO. 35001C0136 D

GENERAL NOTES:

- 1: CONTOUR INTERVAL IS ONE (1) FOOT.
- 2: ELEVATIONS ARE BASED ON CITY OF ALBUQUERQUE STATION No. "12-C17", HAVING AN ELEVATION OF 5107.95
- 3: UTILITIES SHOWN HEREON ARE IN THEIR APPROXIMATE LOCATION BASED ONLY ON ABOVE GROUND EVIDENCE FOUND IN THE FIELD AND AS-BUILT INFORMATION PROVIDED BY THE CLIENT. UTILITIES SHOWN HEREON, WHETHER INDICATED AS ABANDONED OR NOT, SHALL BE VERIFIED BY OTHERS FOR EXACT LOCATION AND/OR DEPTH PRIOR TO EXCAVATION OR DESIGN CONSIDERATIONS.
- 5: THIS IS NOT A BOUNDARY SURVEY. BEARINGS AND DISTANCES SHOWN HEREON ARE FOR REFERENCE ONLY.

LEGEND:


EXISTING	NEW	DESCRIPTION
— 5000 —	— 80 —	CONTOUR
— 80.00 —	80.00 +	SPOT ELEVATION
— — —	— — —	PROPERTY LINE
— — —	— — —	SWALE
— — —	— — —	SHEET FLOW
— — —	— — —	ROOF FLOW
— — —	— — —	ROOF GUTTER
— — —	— — —	DOWNSPOUT
LEGEND		
TC		= TOP OF CONCRETE
FL		= FLOW LINE
TG		= TOP OF GRADE
EOW		= END OF WALL

EROSION CONTROL NOTES:

- THE CONTRACTOR SHALL BE RESPONSIBLE FOR COMPLIANCE WITH THE FOLLOWING:
1. NO SEDIMENT-BEARING WATER SHALL BE ALLOWED TO DISCHARGE FROM THE SITE DURING CONSTRUCTION.
 2. DURING GRADING OPERATIONS AND UNTIL THE PROJECT HAS BEEN COMPLETED, ALL ADJACENT PROPERTY, RIGHTS-OF-WAY, AND EASEMENTS SHALL BE PROTECTED FROM FLOODING BY RUNOFF FROM THE SITE.
 3. SHOULD THE CONTRACTOR FAIL TO PREVENT SEDIMENT-BEARING WATER FROM ENTERING PUBLIC RIGHT-OF-WAY, HE SHALL PROMPTLY REMOVE FROM THE PUBLIC RIGHT-OF-WAY ANY AND ALL SEDIMENT ORIGINATING FROM THE SITE.
 4. CONTROL OF SEDIMENT-LADEN WATERS WILL BE ACCOMPLISHED BY USE OF A COMPACTED EARTH BERM OF ADEQUATE HEIGHT. THE BERM SHALL BE LOCATED ALONG THE DOWNSTREAM PERIMETER OF THE PROPERTY.


LEGAL DESCRIPTION:

LOT 49, CLIFFORD INDUSTRIAL PARK, ALBUQUERQUE, NEW MEXICO.

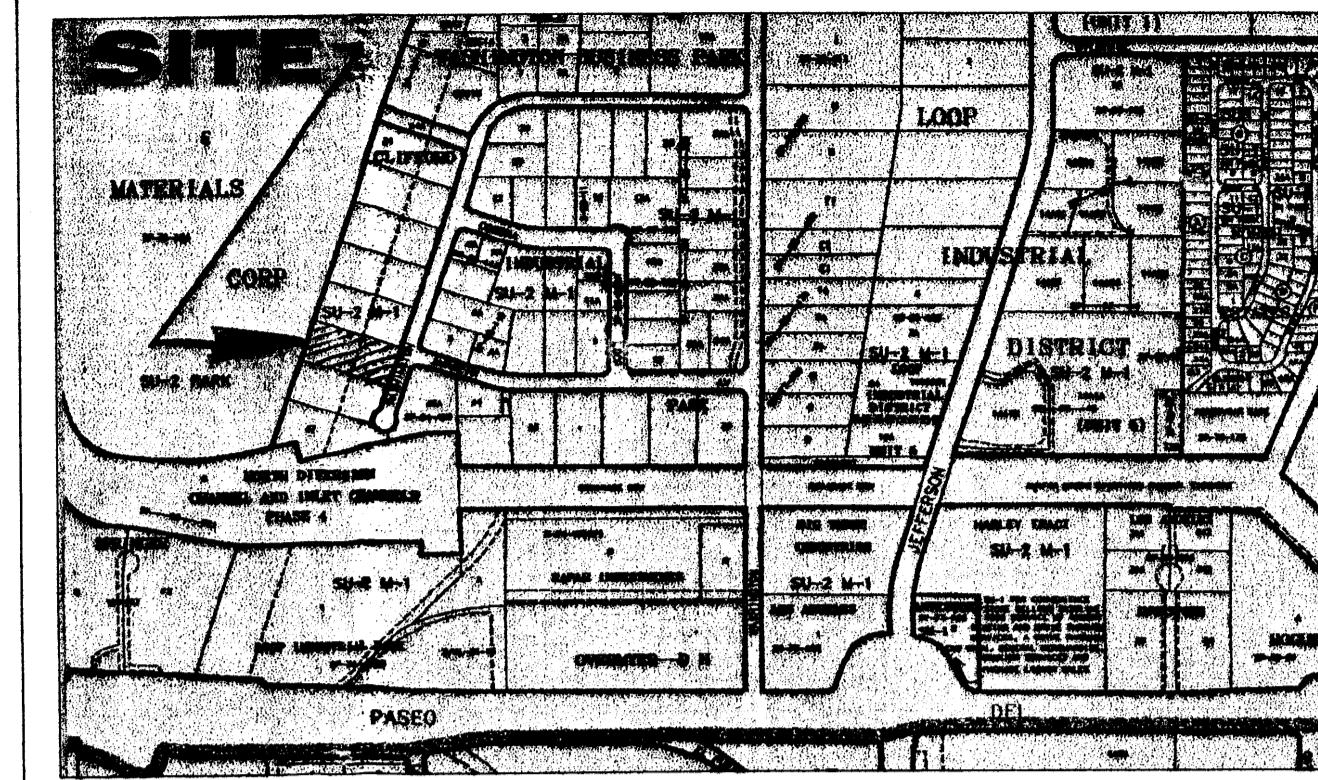


VICINITY MAP

ZONE ATLAS NO. C-17-Z

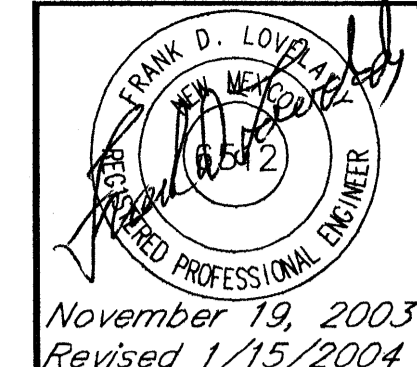

November 19, 2003
Revised 1/15/2004

Warehouse for Commercial Enterprises
8301 WASHINGTON PLACE NE ALBUQUERQUE, NEW MEXICO

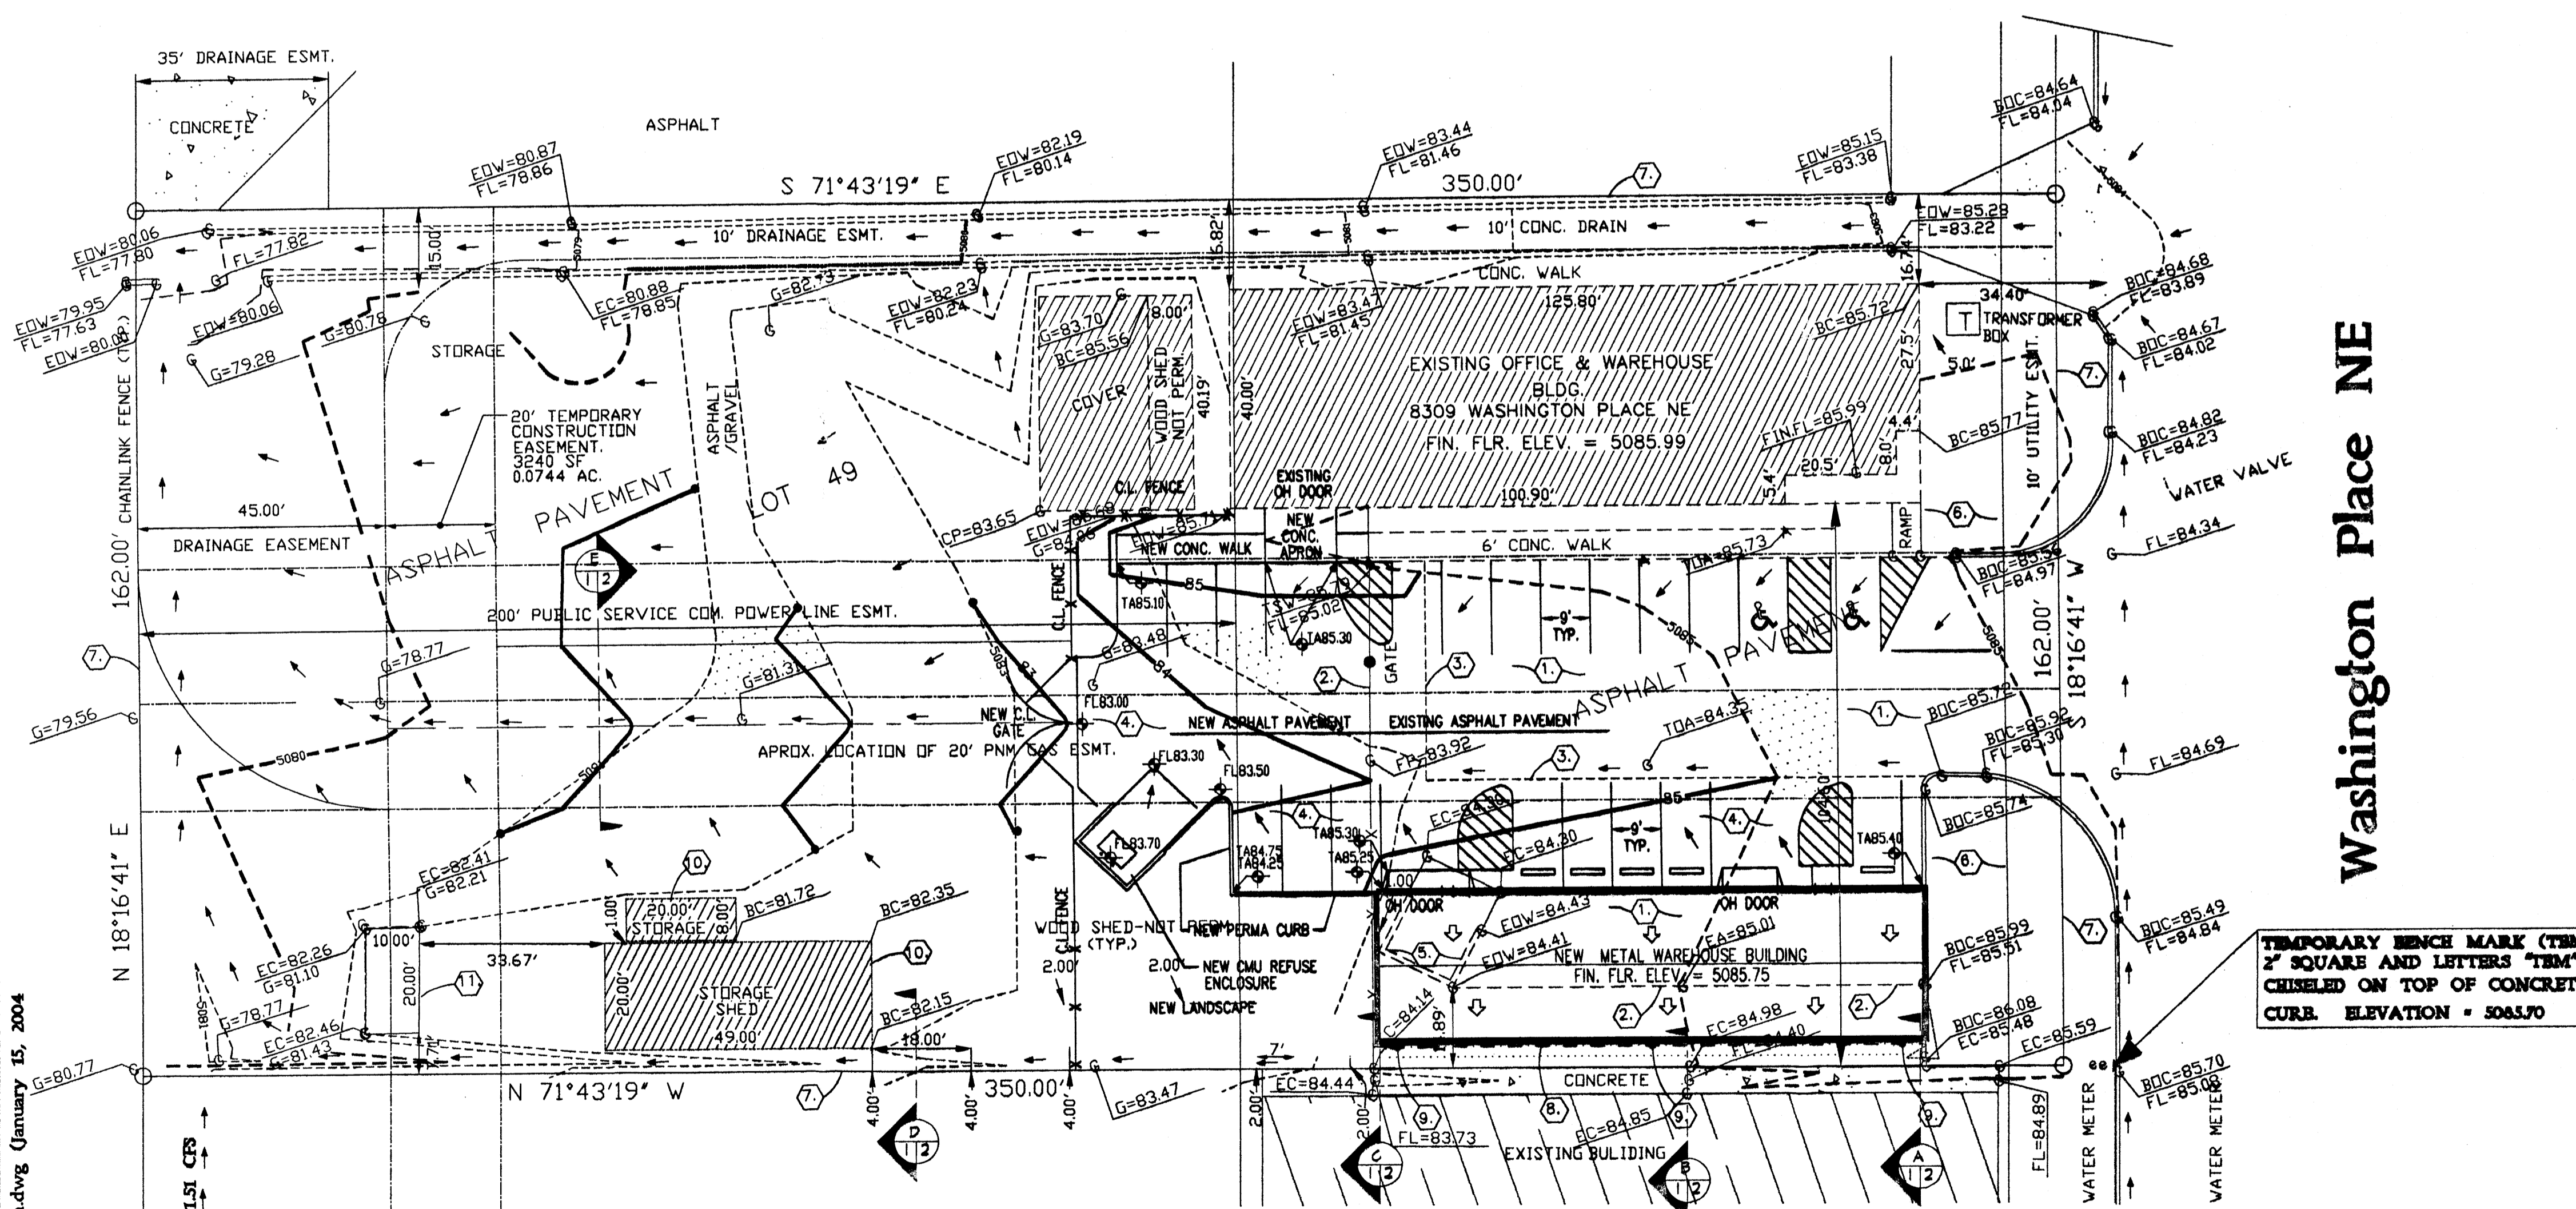

Washington Place NE

TEMPORARY BENCH MARK (TBM) 2" SQUARE AND LETTERS "TBM" CHISELED ON TOP OF CONCRETE CURB. ELEVATION = 5085.70

GENERAL NOTES:


1. PRIOR TO CONSTRUCTION, THE CONTRACTOR SHALL EXCAVATE AND VERIFY THE LOCATION OF ALL POTENTIAL OBSTRUCTIONS. SHOULD A CONFLICT EXIST, THE CONTRACTOR SHALL NOTIFY THE ENGINEER AS SOON AS POSSIBLE TO RESOLVE THE CONFLICT WITH A MINIMUM AMOUNT OF DELAY.
2. ALL WORK ON THIS PLAN SHALL BE PERFORMED IN ACCORDANCE WITH APPLICABLE FEDERAL, STATE AND LOCAL LAWS, RULES AND REGULATIONS CONCERNING CONSTRUCTION SAFETY AND HEALTH.
3. IF ANY UTILITY LINES, PIPELINES, OR UNDERGROUND UTILITY LINES ARE SHOWN ON THESE DRAWINGS, THEY ARE SHOWN IN AN APPROXIMATE LOCATION ONLY, AND LINES MAY EXIST WHERE NONE ARE SHOWN. THE LOCATION IS BASED UPON INFORMATION PROVIDED BY THE UTILITY OWNER OR FROM EXISTING PLANS, AND THIS INFORMATION MAY BE INCOMPLETE, OR OBSOLETE AT THE TIME OF CONSTRUCTION. THE ENGINEER HAS NOT UNDERTAKEN ANY FIELD VERIFICATION OF THESE LOCATIONS, LINE SIZES OR MATERIAL TYPE, MAKES NO REPRESENTATION THERETO, AND ASSUMES NO RESPONSIBILITY OR LIABILITY THEREFOR. THE CONTRACTOR SHALL INFORM ITSELF OF THE LOCATIONS OF ANY UTILITY LINE, PIPELINE OR UNDERGROUND INSTALLATION IN OR NEAR THE AREA IN ADVANCE OF OR DURING ANY EXCAVATION WORK. THE CONTRACTOR IS FULLY RESPONSIBLE FOR ANY AND ALL DAMAGES CAUSED BY ITS FAILURE TO LOCATE, IDENTIFY AND PRESERVE ANY AND ALL EXISTING UTILITIES, PIPELINES AND UNDERGROUND FACILITIES. IN PLANNING AND CONDUCTING EXCAVATIONS, THE CONTRACTOR SHALL COMPLY WITH ALL STATE STATUTES, MUNICIPAL AND LOCAL ORDINANCES, RULES AND REGULATIONS, IF ANY, PERTAINING TO THE LOCATION OF THESE LINES AND FACILITIES.
4. THE CONTRACTOR SHALL ENSURE THAT NO SOIL ERODES FROM THE SITE INTO PUBLIC RIGHTS-OF-WAY OR ONTO PRIVATE PROPERTY. THIS CAN BE ACHIEVED BY CONSTRUCTING TEMPORARY BERMS AND BY WETTING THE SOIL TO KEEP IT FROM BLOWING.
5. THE CONTRACTOR SHALL OBTAIN ANY AND ALL PERMITS REQUIRED BY THE CITY OF ALBUQUERQUE FOR THE COMPLETION OF THE WORK PRIOR TO BEGINNING CONSTRUCTION.

KEYED NOTES:

1. EXISTING ASPHALT PAVEMENT.
2. EDGE OF EXISTING ASPHALT PAVEMENT.
3. EDGE OF ASPHALT REMOVAL AND REPLACEMENT.
4. NEW ASPHALT PAVEMENT.
5. EXISTING REFUSE ENCLOSURE - DEMOLISH.
6. EXISTING LANDSCAPING.
7. PROPERTY LINE.
8. ROOF GUTTER.
9. DOWNSPOUT.
10. EXISTING TEMPORARY BUILDINGS TO BE REMOVED, RELOCATED OR, LEFT IN PLACE, AS DETERMINED BY THE OWNER. NOTE: ALL TEMPORARY BUILDINGS WITHIN THE CHANNEL CONST. AREA HAVE BEEN REMOVED.
11. EXISTING CONCRETE PAD. CITY PLANS FOR CLIFFORD CHANNEL, REALIGNMENT CALL FOR REMOVAL AND DISPOSAL OF THIS PAD.

C:\AI Proj\668\Grading_Plan.dwg (January 15, 2004)

Grading & Drainage Plan
Scale: 1"=20'

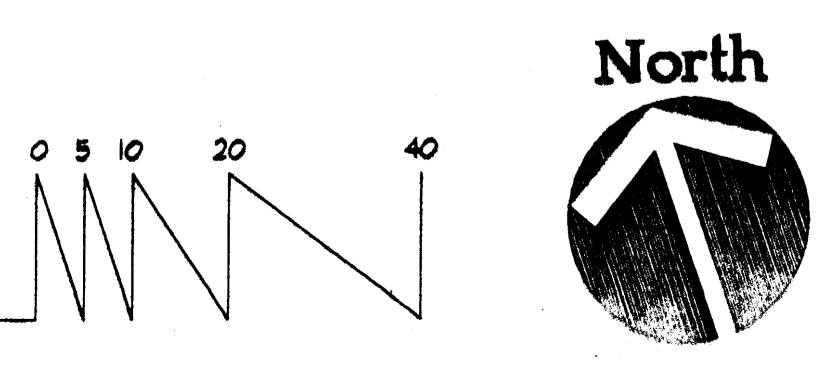

JOB NO:	0309
DATE:	15 JANUARY 2004
REVISIONS	
1	TBM RELOCATED, TEMP. CONST. EASEMENT ADDED.

SHEET NO.
C.1.1

DRAINAGE CALCULATIONS:

EXISTING CONDITIONS:

The site is located on the west side of Washington Place NE, the third lot north of the Domingo Baca Channel. There is a drainage concrete channel along the north edge of the site. The existing building roof has an east-west ridge and the north side of the building drains directly into the drainage channel via splash blocks that extend over the channel wall. The parking lot is paved and there are several non-permanent buildings on the site. drainage is from east to west. At the NW corner of the site the drainage channel continues west into the old baloon fiesta area. The lots north and south of the site are also developed. (See aerial photo, Sheet C.1.2)

DEVELOPED CONDITIONS:

It is proposed to construct a new metal storage building on the site as shown. The building will be constructed in an area which is now partially paved. The pavement will be extended to the west as shown. All runoff will continue to flow to the west and then north into the existing easement as it presently does.

FUTURE IMPROVEMENTS:

The City of Albuquerque proposes to construct "Clifford Channel Realignment at Former Los Angeles Landfill". Construction plans have been prepared and a reduced set will be submitted with this grading and drainage submittal. No attempt has been made to show the channel grades on this plan.

DRAINAGE CRITERIA:

The calculations shown on this plan were prepared in accordance with Section 22.2, Hydrology, of the Development Process Manual, Volume 2, Design Criteria, for the City of Albuquerque in cooperation with Bernalillo County, New Mexico and the Metropolitan Arroyo Flood Control Authority, January, 1992.

PRECIPITATION ZONE:

The site is between the Rio Grande River and San Mateo Blvd. and is, therefore, in Precipitation Zone 2.

LAND TREATMENT 'D'

SURFACE	EXISTING	DEVELOPED
CONCRETE	4,095	5,236
ASPHALT PAVING	8,623	9,698
BUILDING	8,369	11,169
TOTAL	21,087	26,103

LAND TREATMENT AREAS:

The peak discharge per acre and excess precipitation are shown for the four land treatments in Zone 2 in the table below, and the values shown are from the City of Albuquerque D.P.M. Also shown are the existing and proposed land treatment areas.

LAND TREAT.	c(Fs/ac)		E (in)		Existing Site Areas		Developed Site Areas		
	100-yr.	10-yr.	100-yr.	10-yr.	%	Sq. Ft.	%	Sq. Ft.	
A	1.56	0.38	0.53	0.13	0.0	0.0000	0.0	0.0000	
B	2.28	0.95	0.78	0.28	4.8	2,720	0.0624	4.8	2,720
C	3.14	1.71	1.13	0.52	58.0	32,893	0.7551	49.2	27,877
D	4.70	3.14	2.12	1.34	32.2	21,087	0.4841	46.0	26,103
Totals					100.0	56,700	1.3016	100.0	56,700

PEAK DISCHARGE:

EXISTING CONDITIONS:

$$Q_{100} = 0.0624 \times 2.28 + 0.7551 \times 3.14 + 0.4841 \times 4.70 = 4.79 \text{ cfs}$$

$$Q_{10} = 0.0624 \times 0.95 + 0.7551 \times 1.71 + 0.4841 \times 3.14 = 2.87 \text{ cfs}$$

DEVELOPED CONDITIONS:

$$Q_{100} = 0.0624 \times 2.28 + 0.6400 \times 3.14 + 0.5992 \times 4.70 = 4.97 \text{ cfs}$$

$$Q_{10} = 0.0624 \times 0.95 + 0.6400 \times 1.71 + 0.5992 \times 3.14 = 3.04 \text{ cfs}$$

VOLUME, 100-YEAR AND 10-YEAR, 6-HOUR:

EXISTING CONDITIONS:

$$V_{100} = (2,720 \times 0.78 + 32,893 \times 1.13 + 21,087 \times 2.12) / 12 = 7,000 \text{ cf}$$

$$V_{10} = (2,720 \times 0.28 + 32,893 \times 0.52 + 21,087 \times 1.34) / 12 = 3,844 \text{ cf}$$

DEVELOPED CONDITIONS:

$$V_{100} = (2,720 \times 0.78 + 27,877 \times 1.13 + 26,103 \times 2.12) / 12 = 7,413 \text{ cf}$$

$$V_{10} = (2,720 \times 0.28 + 27,877 \times 0.52 + 26,103 \times 1.34) / 12 = 4,186 \text{ cf}$$

SUMMARY OF ON-SITE VOLUMES AND PEAK DISCHARGE RATES:

	V100(CF)	V10(CF)	Q100(CFS)	Q10(CFS)
DEVELOPED	7,413	4,186	4.97	3.04
EXISTING	7,000	3,844	4.79	2.87
INCREASE	413	342	0.18	0.17

NEW BUILDING ROOF RUNOFF:

AREA = 3300 SF

$$Q_{100} = (3300 / 43,560) \times 4.7 = 0.36 \text{ CFS}$$

CAPACITY OF SWALE (SECTION D):

SWALE 5' WIDE X 0.5' DEEP

$$\text{AREA} = 1.25 \text{ SF}$$


$$P = 5.1 \quad \text{SLOPE} = 4.14 = 200 = 0.0207$$

$$R = A/P = 1.25 / 5.1 = 0.25 \quad N = 0.035 \text{ (GRAVEL)}$$

$$V = (1.486 / 0.035) \times (0.25)^{2/3} \times (0.0207)^{1/2} = 2.4 \text{ FPS}$$


$$Q = AV = 1.25 \times 2.4 = 3.00 \text{ CFS}$$

$$3.00 \text{ CFS} > 0.36 \text{ CFS} \quad \text{ADEQUATE}$$

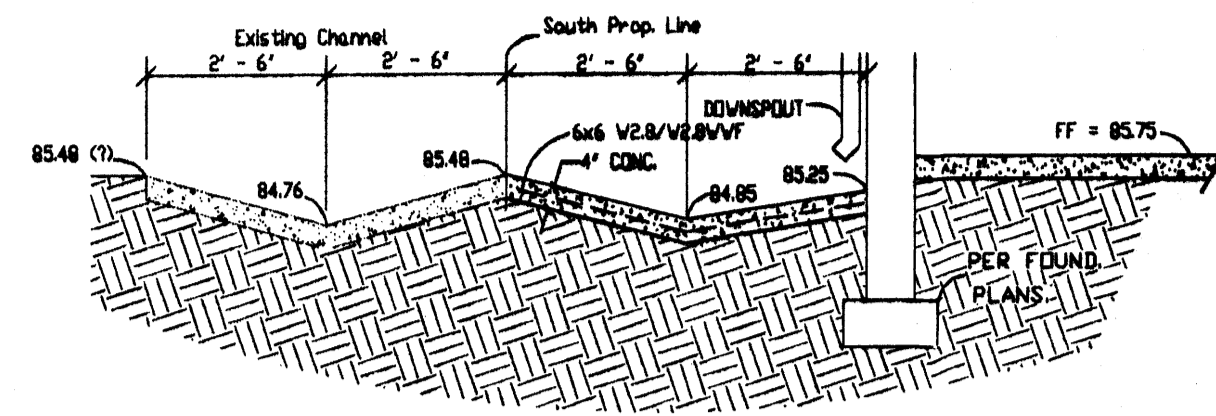


A
3/8" = 1' - 0"

NOTE:
TOTAL DISTANCE BETWEEN SECTIONS 'A' & 'B' IS 43.6'
SLOPE = (84.85 - 84.50) / 43.6 = 0.0080 FT./FT.

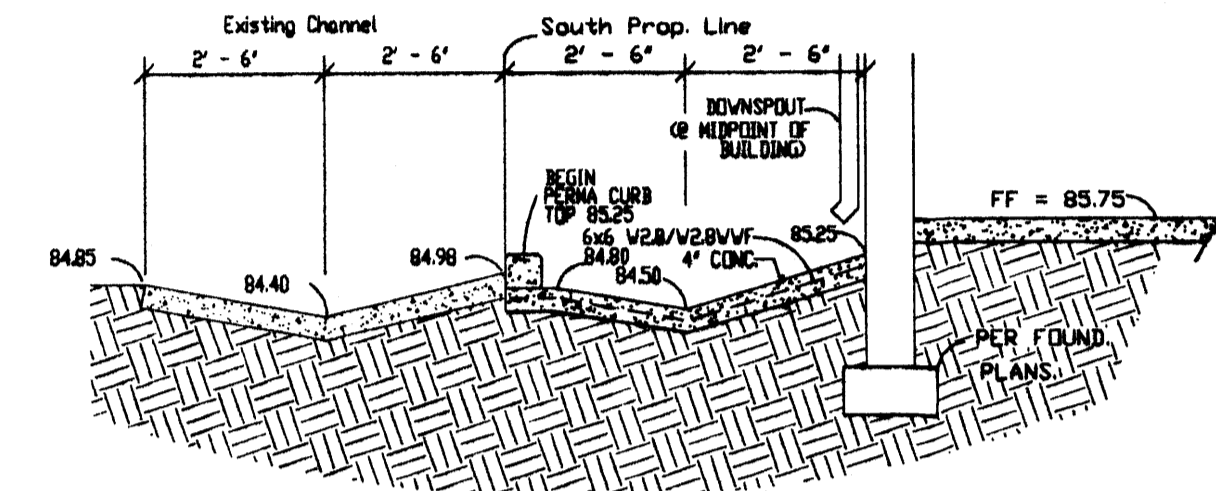


B
3/8" = 1' - 0"


NOTE:
TRANSITION FROM 'V' SHAPED CHANNEL TO FLAT BOTTOMED
CHANNEL BETWEEN SECTIONS 'B' AND 'C'. TOTAL DISTANCE
IS 56.0'. SLOPE = (84.5 - 84.14) / 56 = 0.0064 FT./FT.

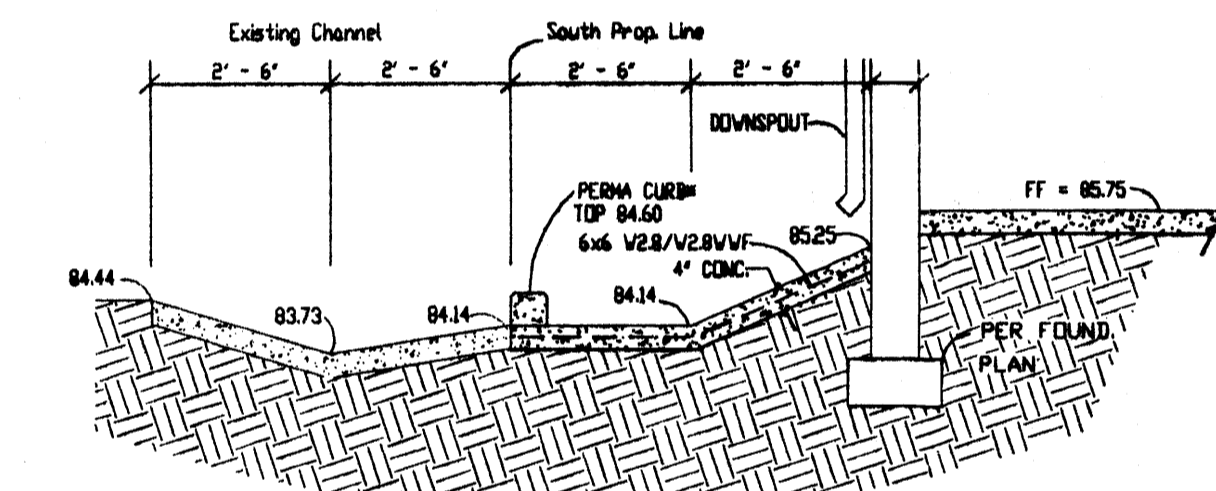

C
3/8" = 1' - 0"

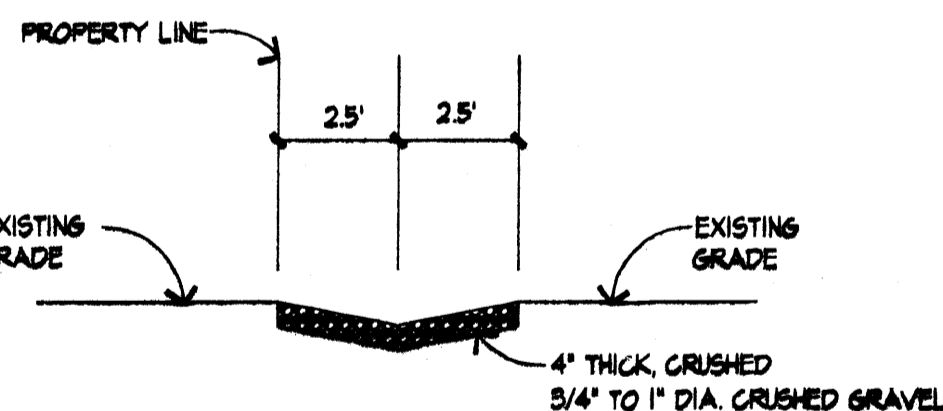


D
1/4" = 1' - 0"

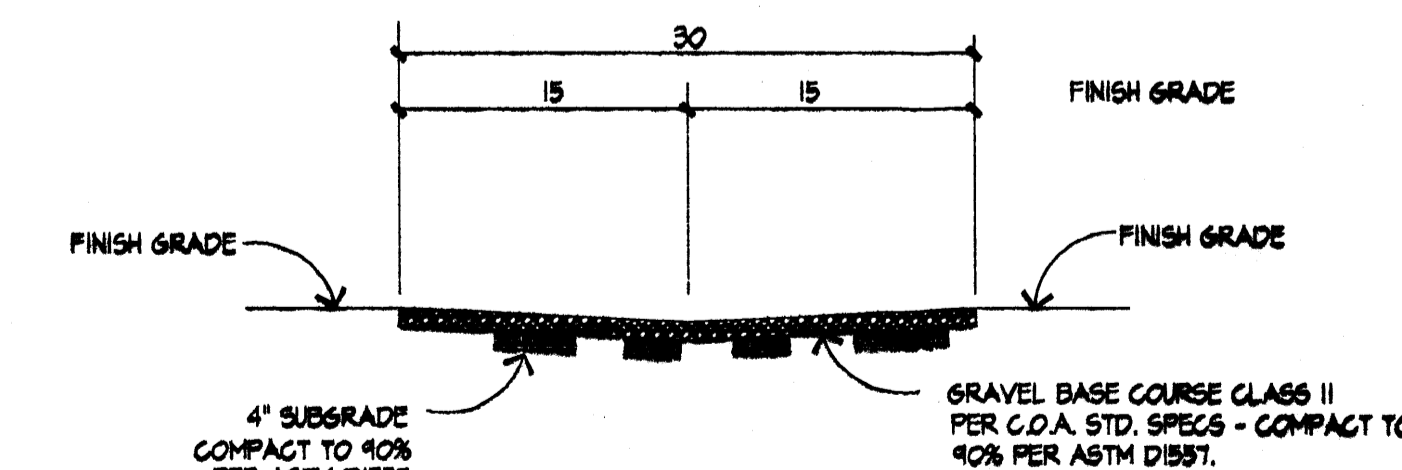

E
1/2" = 1' - 0"

HORIZONTAL 1" = 10'
VERTICAL 1" = 5'

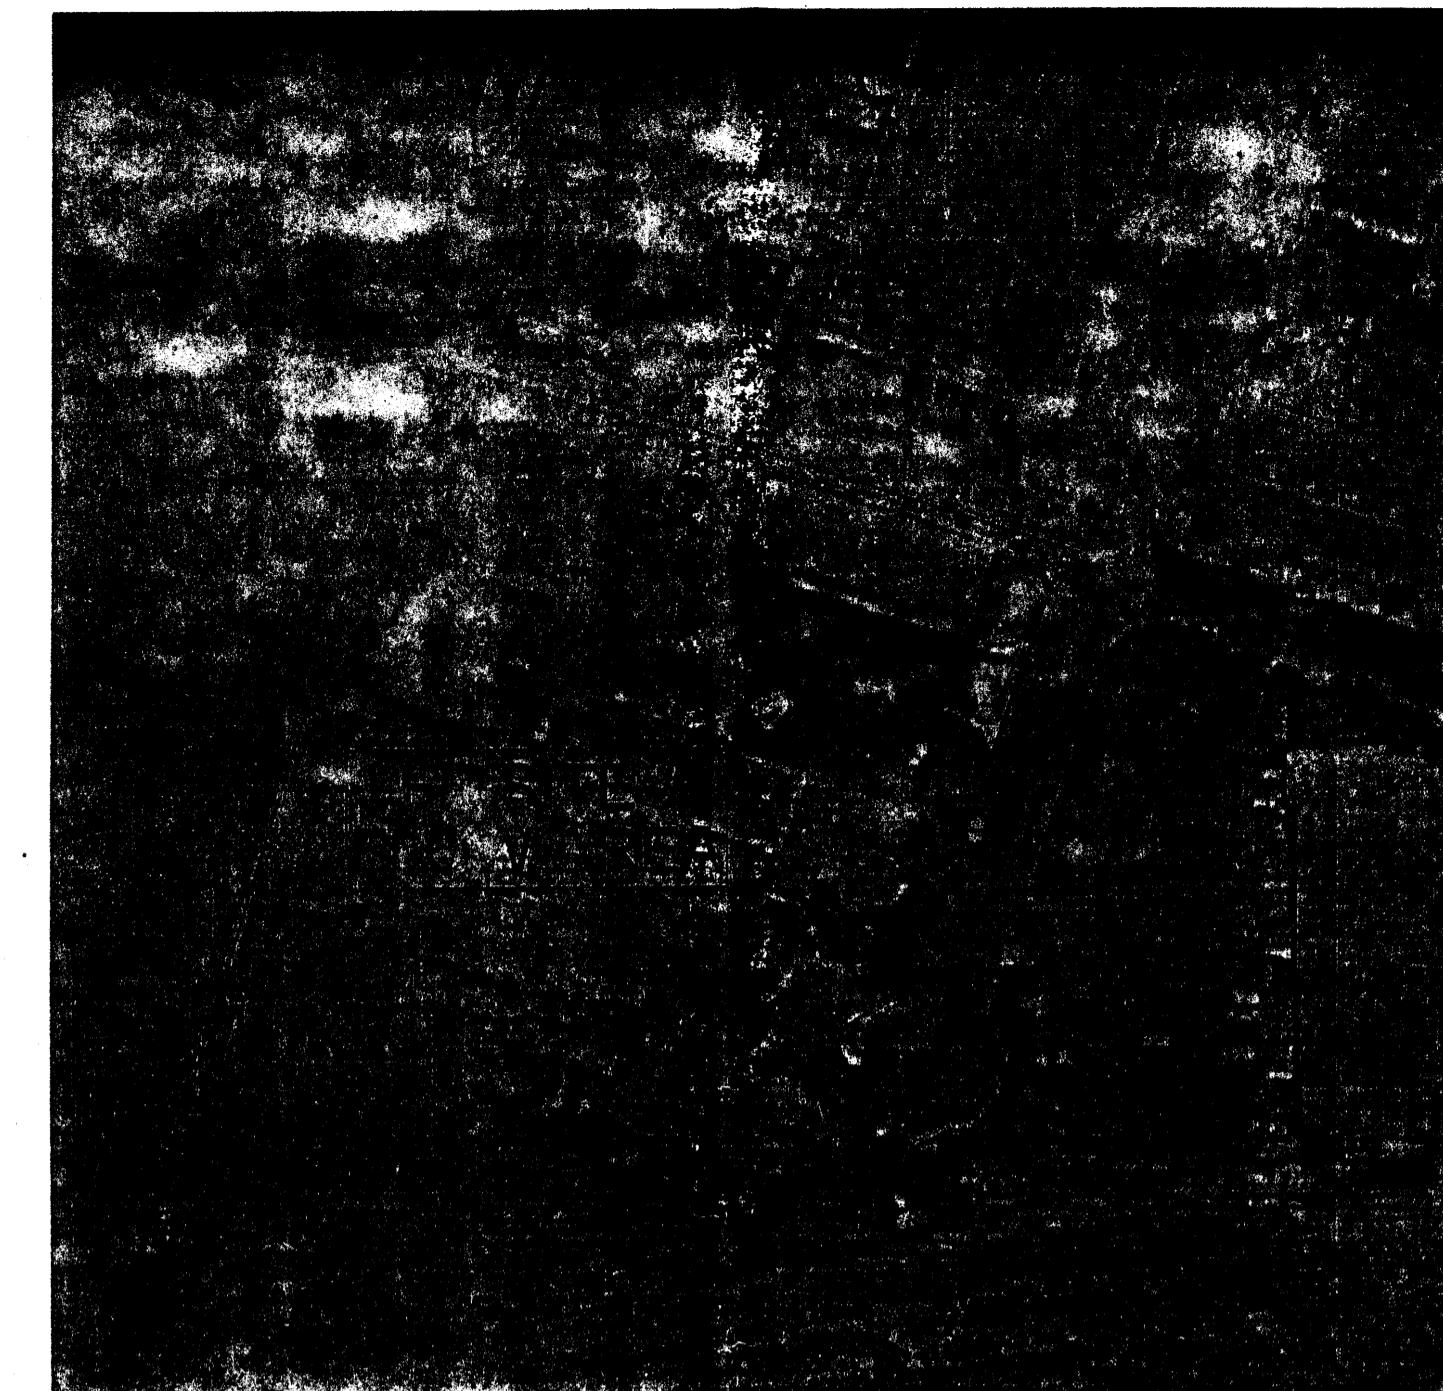


AERIAL PHOTO OF SITE AREA

APPROX. SCALE 1" = 100'

OFF-SITE FLOW CALCULATIONS:

AREA = 2.72 ACRES - SEE ABOVE MAP.
PER TABLE A-5 OF THE DPM, LIGHT INDUSTRIAL IS 70% TREATMENT D.
ASSUME 30 PERCENT TREATMENT C.
WEIGHTED 100-YEAR PEAK DISCHARGE PER ACRE:
 $q_w = 0.3 \times 3.14 + 0.7 \times 4.70 = 4.23 \text{ CFS PER ACRE.}$
 $Q_{100} = 4.23 \text{ CFS PER ACRE} \times 2.72 \text{ ACRES} = 11.51 \text{ CFS}$

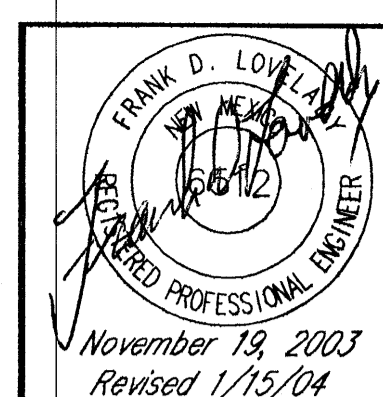


GRADING AND DRAINAGE CALCULATIONS
Warehouse for Commercial Enterprises
8301 WASHINGTON PLACE NE ALBUQUERQUE, NEW MEXICO

KEN HOVEY, ARCHITECT
505) 259-8458 * 3808 SIMMS AVENUE SE * ALBUQUERQUE, NM * 87108

JOB NO:	0309
DATE:	15 JANUARY 2004
REVISIONS	
1	OFF-SITE FLOW AREA & CALCS

SHEET NO.
C.1.2

C:\All Proj\Proj662\Calcs.dwg January 15, 2004

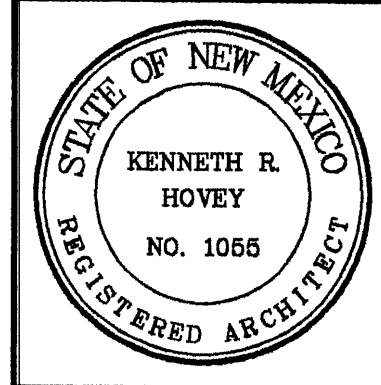


Warehouse for Commercial Enterprises
 8309 WASHINGTON PLACE NE ALBUQUERQUE, NEW MEXICO




JOB NO:	0309
DATE:	30 MARCH 2004
REVISIONS	

SHEET NO.
C.3

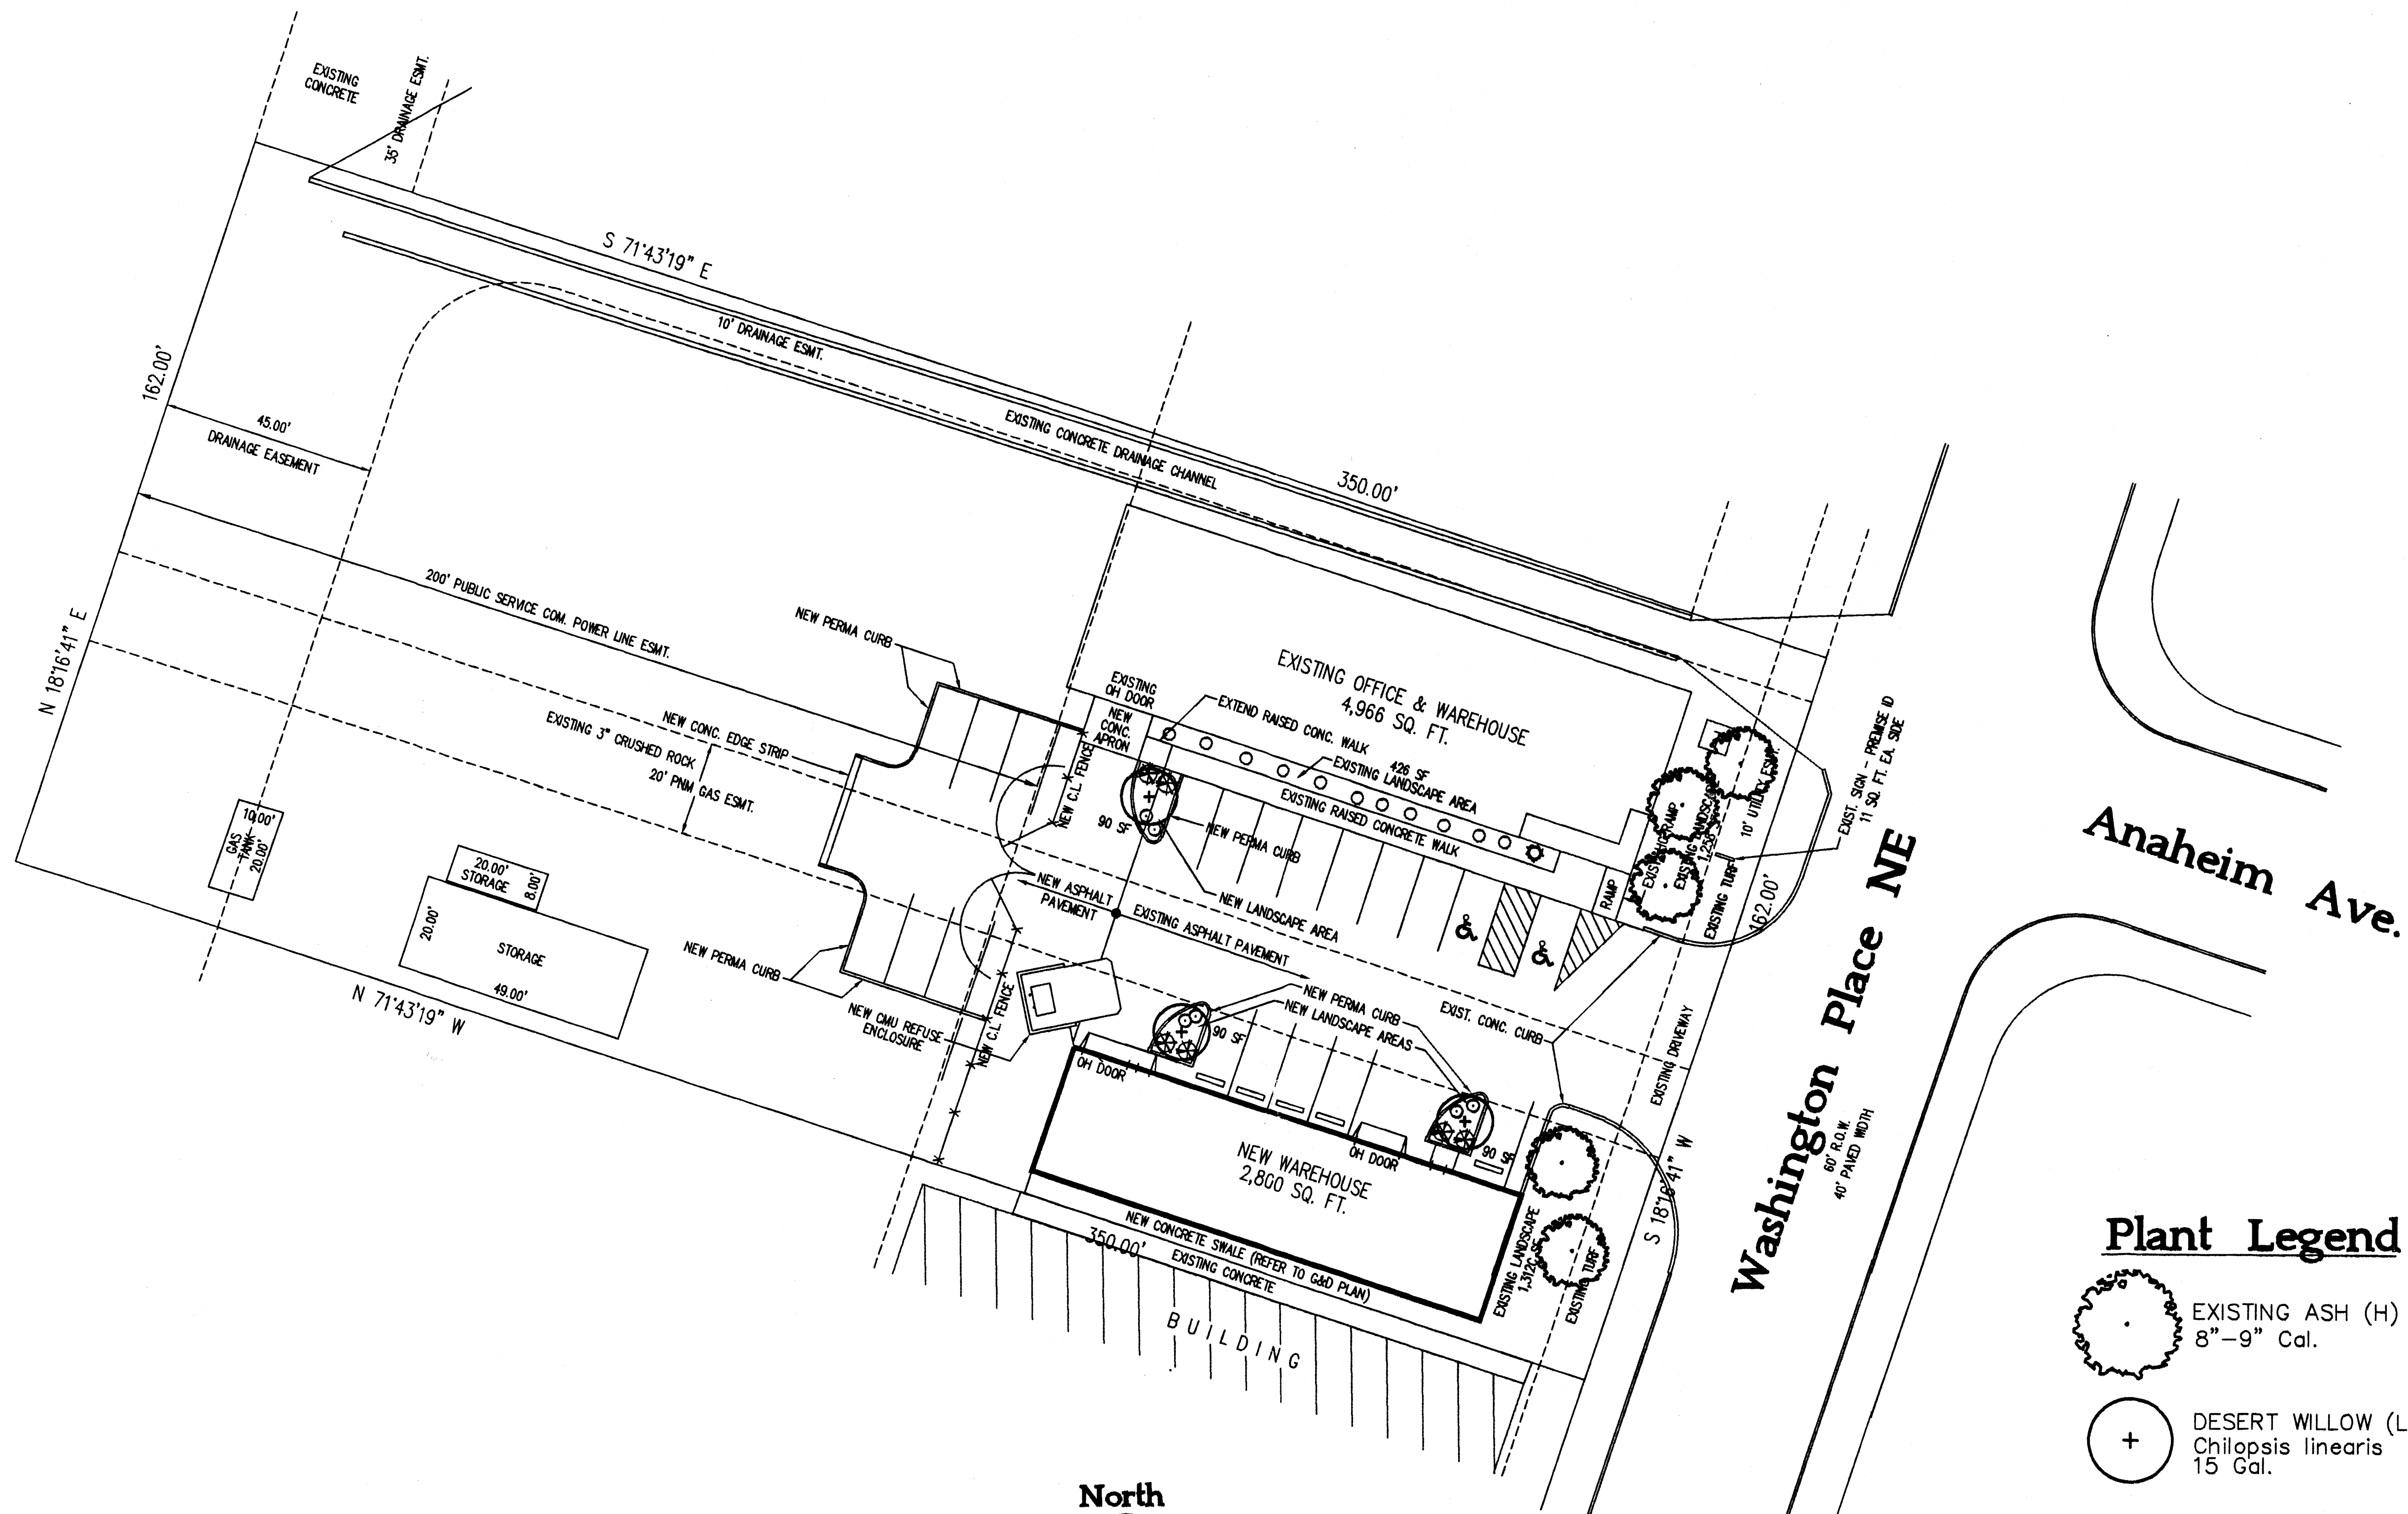

Plant Legend

- EXISTING ASH (H) 5
8"-9" Cal.
- DESERT WILLOW (L) 3
Chilopsis linearis
15 Gal.
- SILVERBERRY (M) 6
Elaeagnus pungens
5 Gal. 100sf
- INDIAN HAWTHORN (M) 6
Raphiolepis indica
5 Gal.
- EXISTING PHOTINIA (M) 11
- EXISTING FORSYTHIA (M) 1

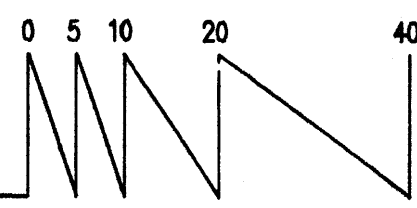

Landscape Plan
 Scale: 1"=20'

Landscape Notes:

Landscape maintenance shall be the responsibility of the Property Owner.

It is the intent of this plan to comply with the City of Albuquerque Water Conservation Landscaping and Water Waste Ordinance planting restriction approach.

Approval of this plan does not constitute or imply exemption from water waste provisions of the Water Conservation Landscaping and Water Waste Ordinance. Water management is the sole responsibility of the Property Owner.

All landscaping will be in conformance with the City of Albuquerque Zoning Code, Street Tree Ordinance, Pollen Ordinance, and Water Conservation Landscaping and Water Waste Ordinance. In general, water conservative, environmentally sound landscape principles will be followed in design and installation.

Plant beds shall achieve 75% live ground cover at maturity.

3/4" Gray Gravel over Filter Fabric shall be placed in all landscape areas which are not designated to receive native seed.

Irrigation Notes:


Irrigation shall be a complete underground system with Trees to receive (5) 1.0 GPH Drip Emitters and Shrubs to receive (2) 1.0 GPH Drip Emitters. Drip and Bubbler systems to be tied to 1/2" poly pipe with flush caps at each end.

Run time per each drip valve will be approximately 15 minutes per day, to be adjusted according to the season.

Point of connection for irrigation system is unknown at current time and will be coordinated in the field.

Irrigation will be operated by automatic controller. Location of controller to be field determined and power source for controller to be provided by others.

Irrigation maintenance shall be the responsibility of the Property Owner.

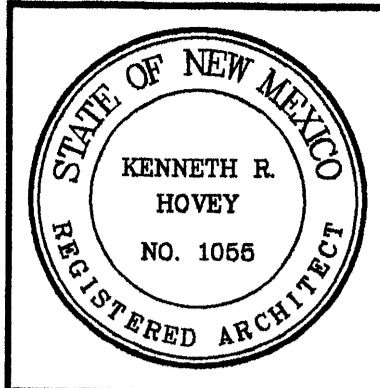


Warehouse for Commercial Enterprises
 8804 WASHINGTON PLACE NE, ALBUQUERQUE, NEW MEXICO



KEN HOVEY, ARCHITECT
 6051 2511-6458 • 3000 SIMMS AVE SE • ALBUQUERQUE, NM • 87105

JOB NO:	0301
DATE:	30 MARCH 2004
REVISIONS	



SHEET NO.
A.2

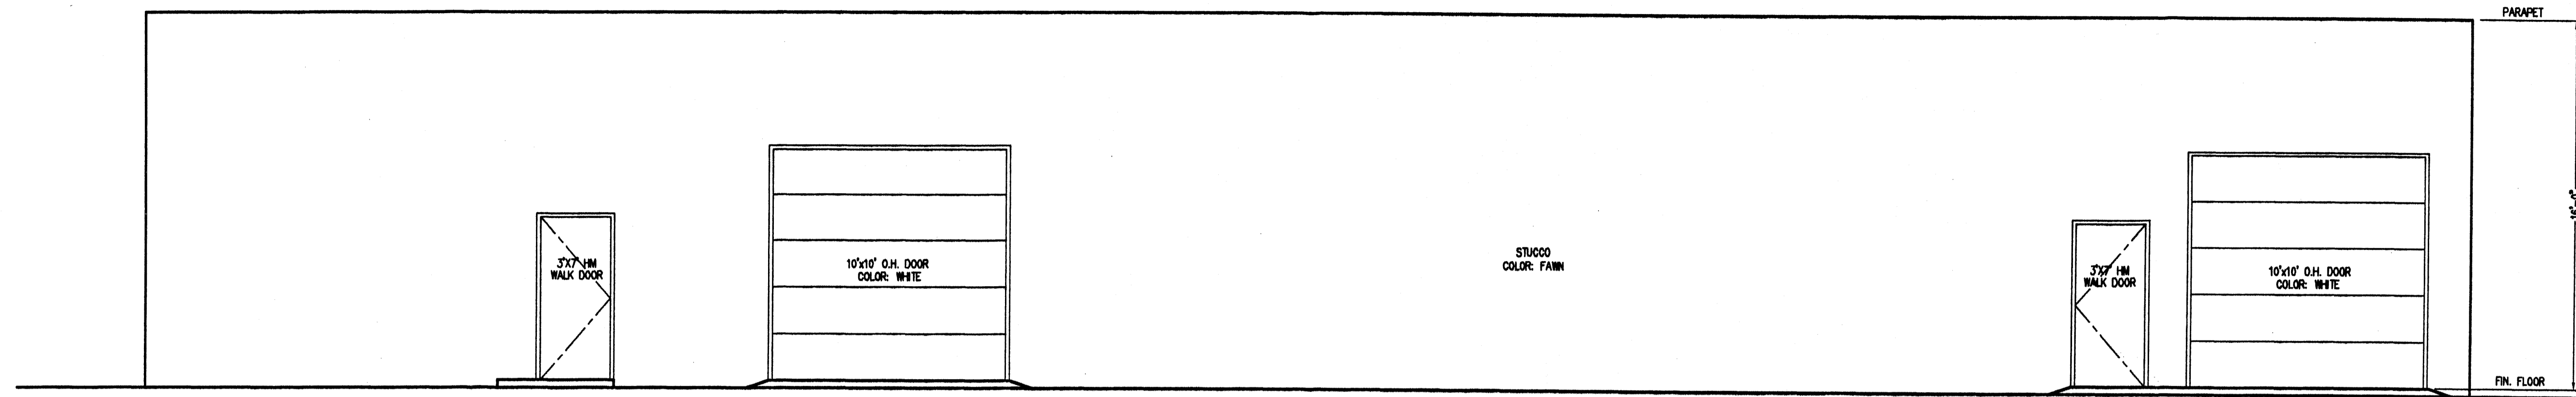



North Elevation
 Scale: 1/4"=1'-0"

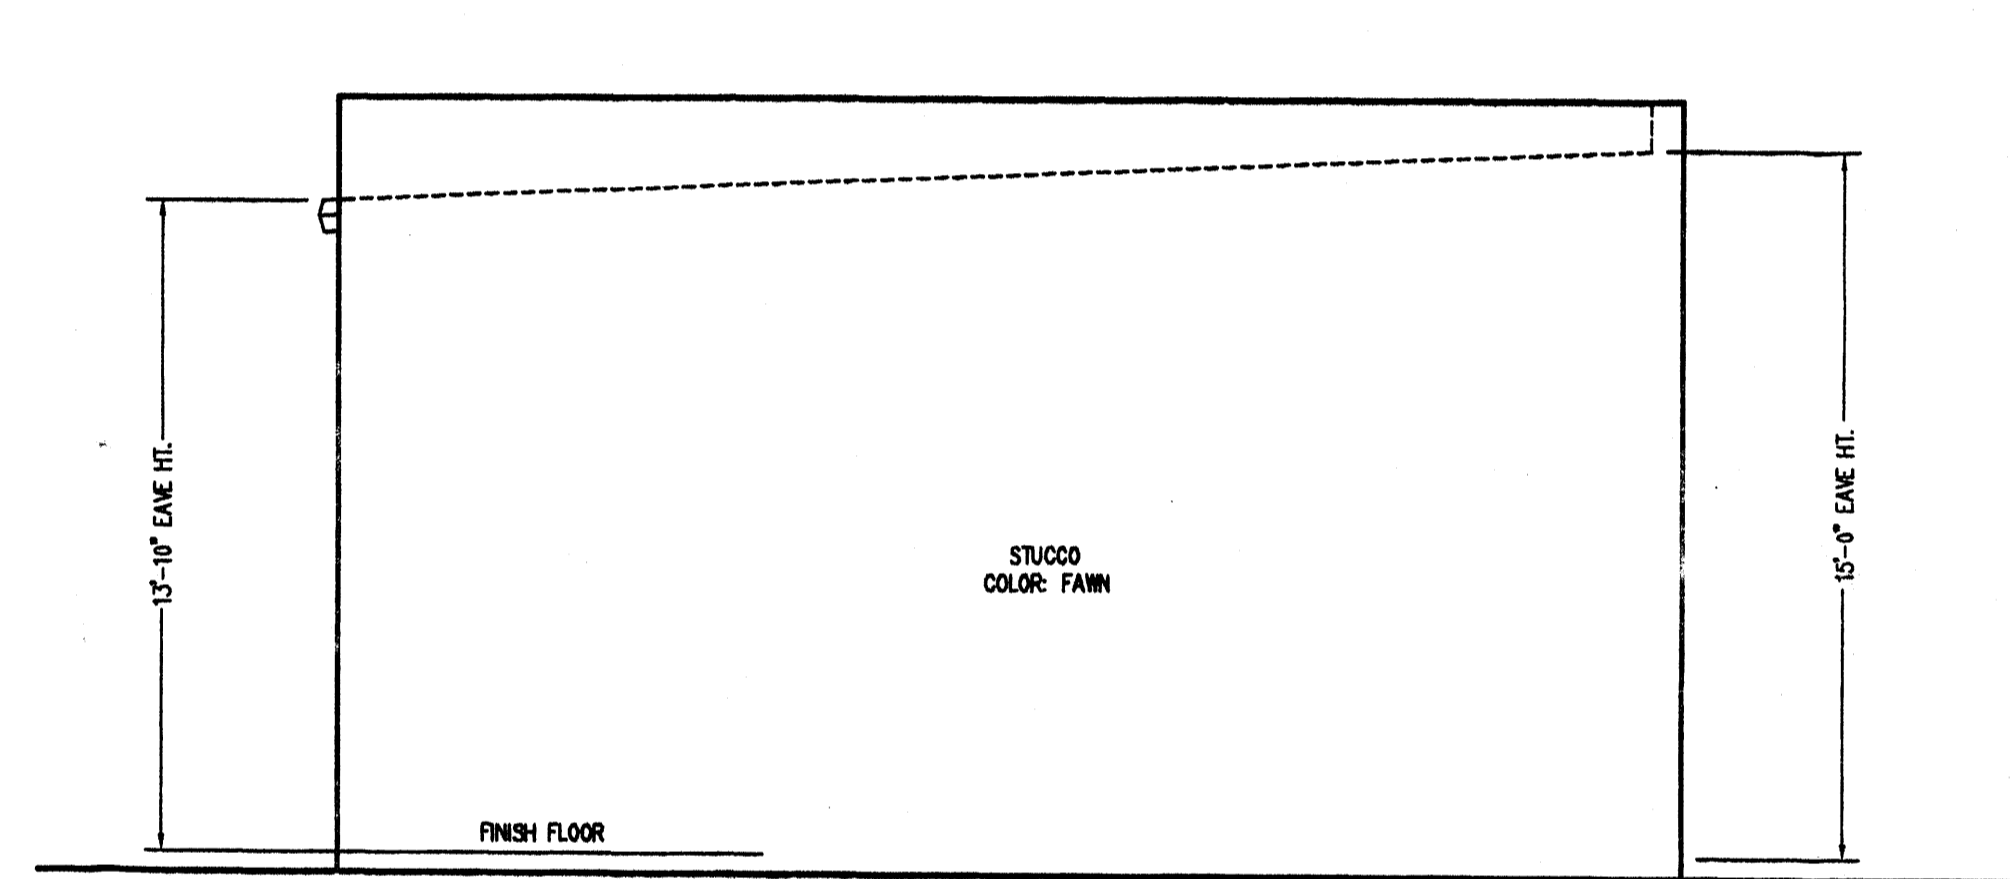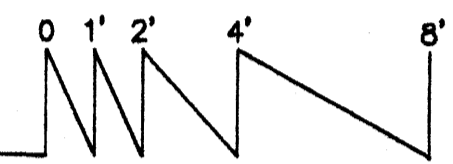


East Elevation
 Scale: 1/4"=1'-0"

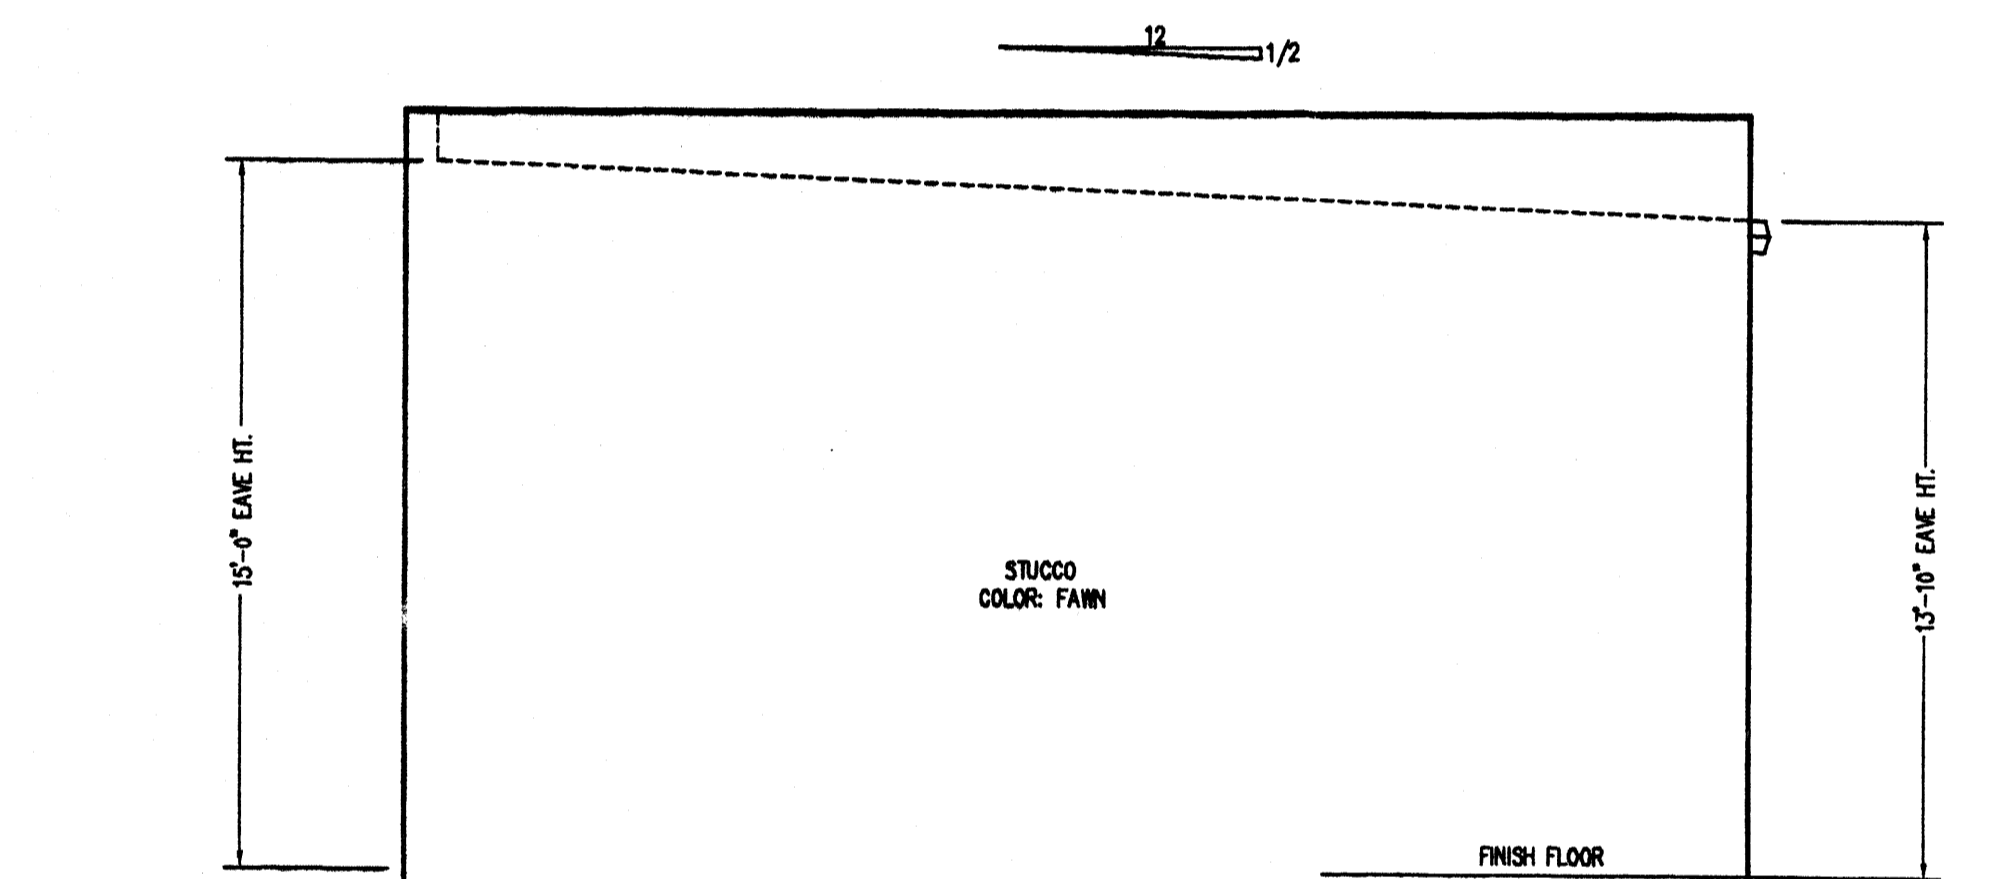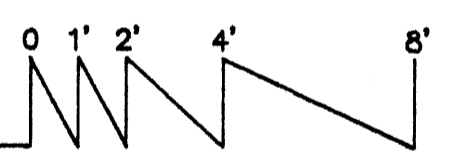


West Elevation
 Scale: 1/4"=1'-0"

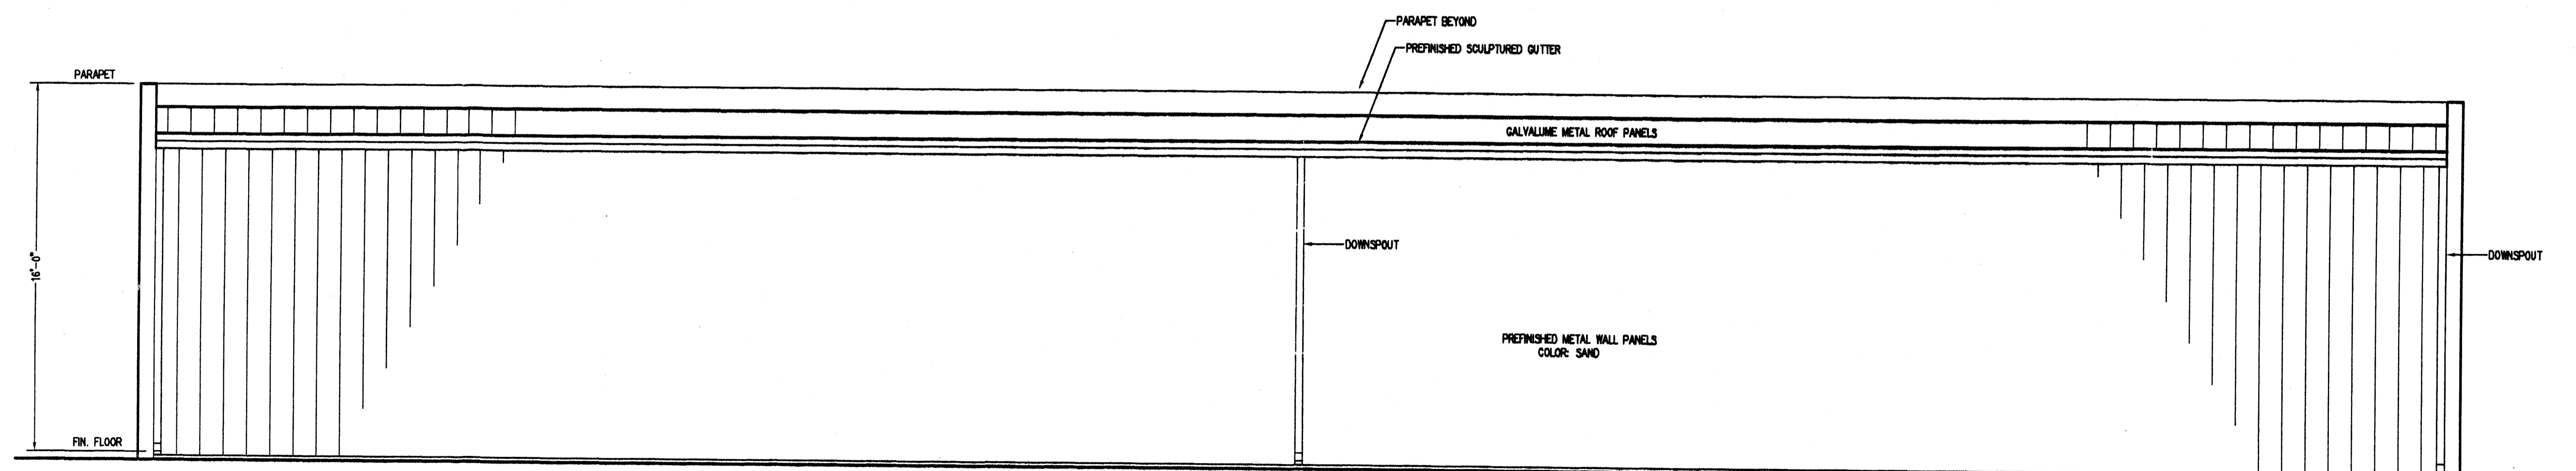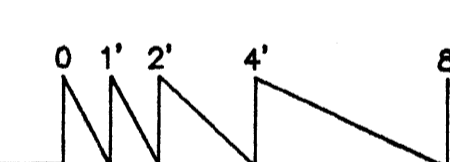


South Elevation
 Scale: 1/4"=1'-0"

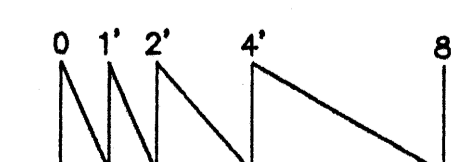

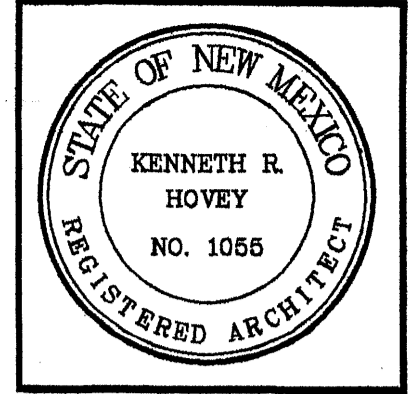


Warehouse for Commercial Enterprises
 2809 WASHINGTON PLACE NE ALBUQUERQUE, NEW MEXICO

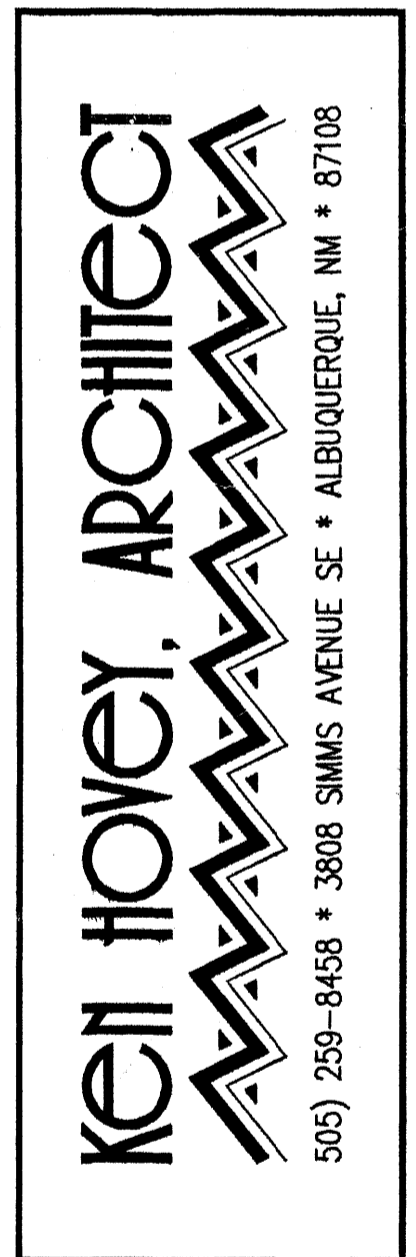


JOB NO:	0309
DATE:	30 MARCH 2004
REVISIONS:	

SHEET NO.
C.1

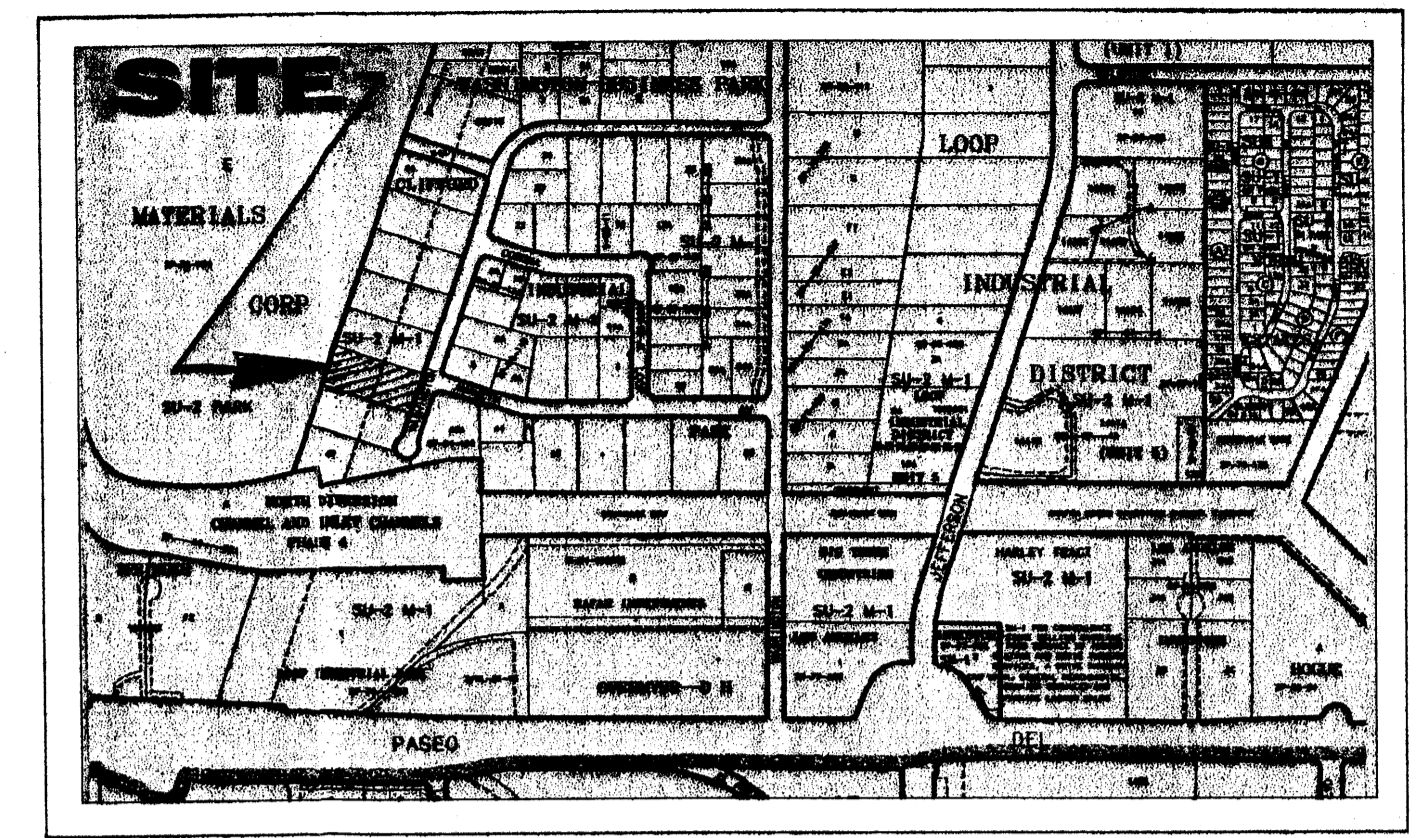


VICINITY MAP ZONE ATLAS NO. C-17-Z

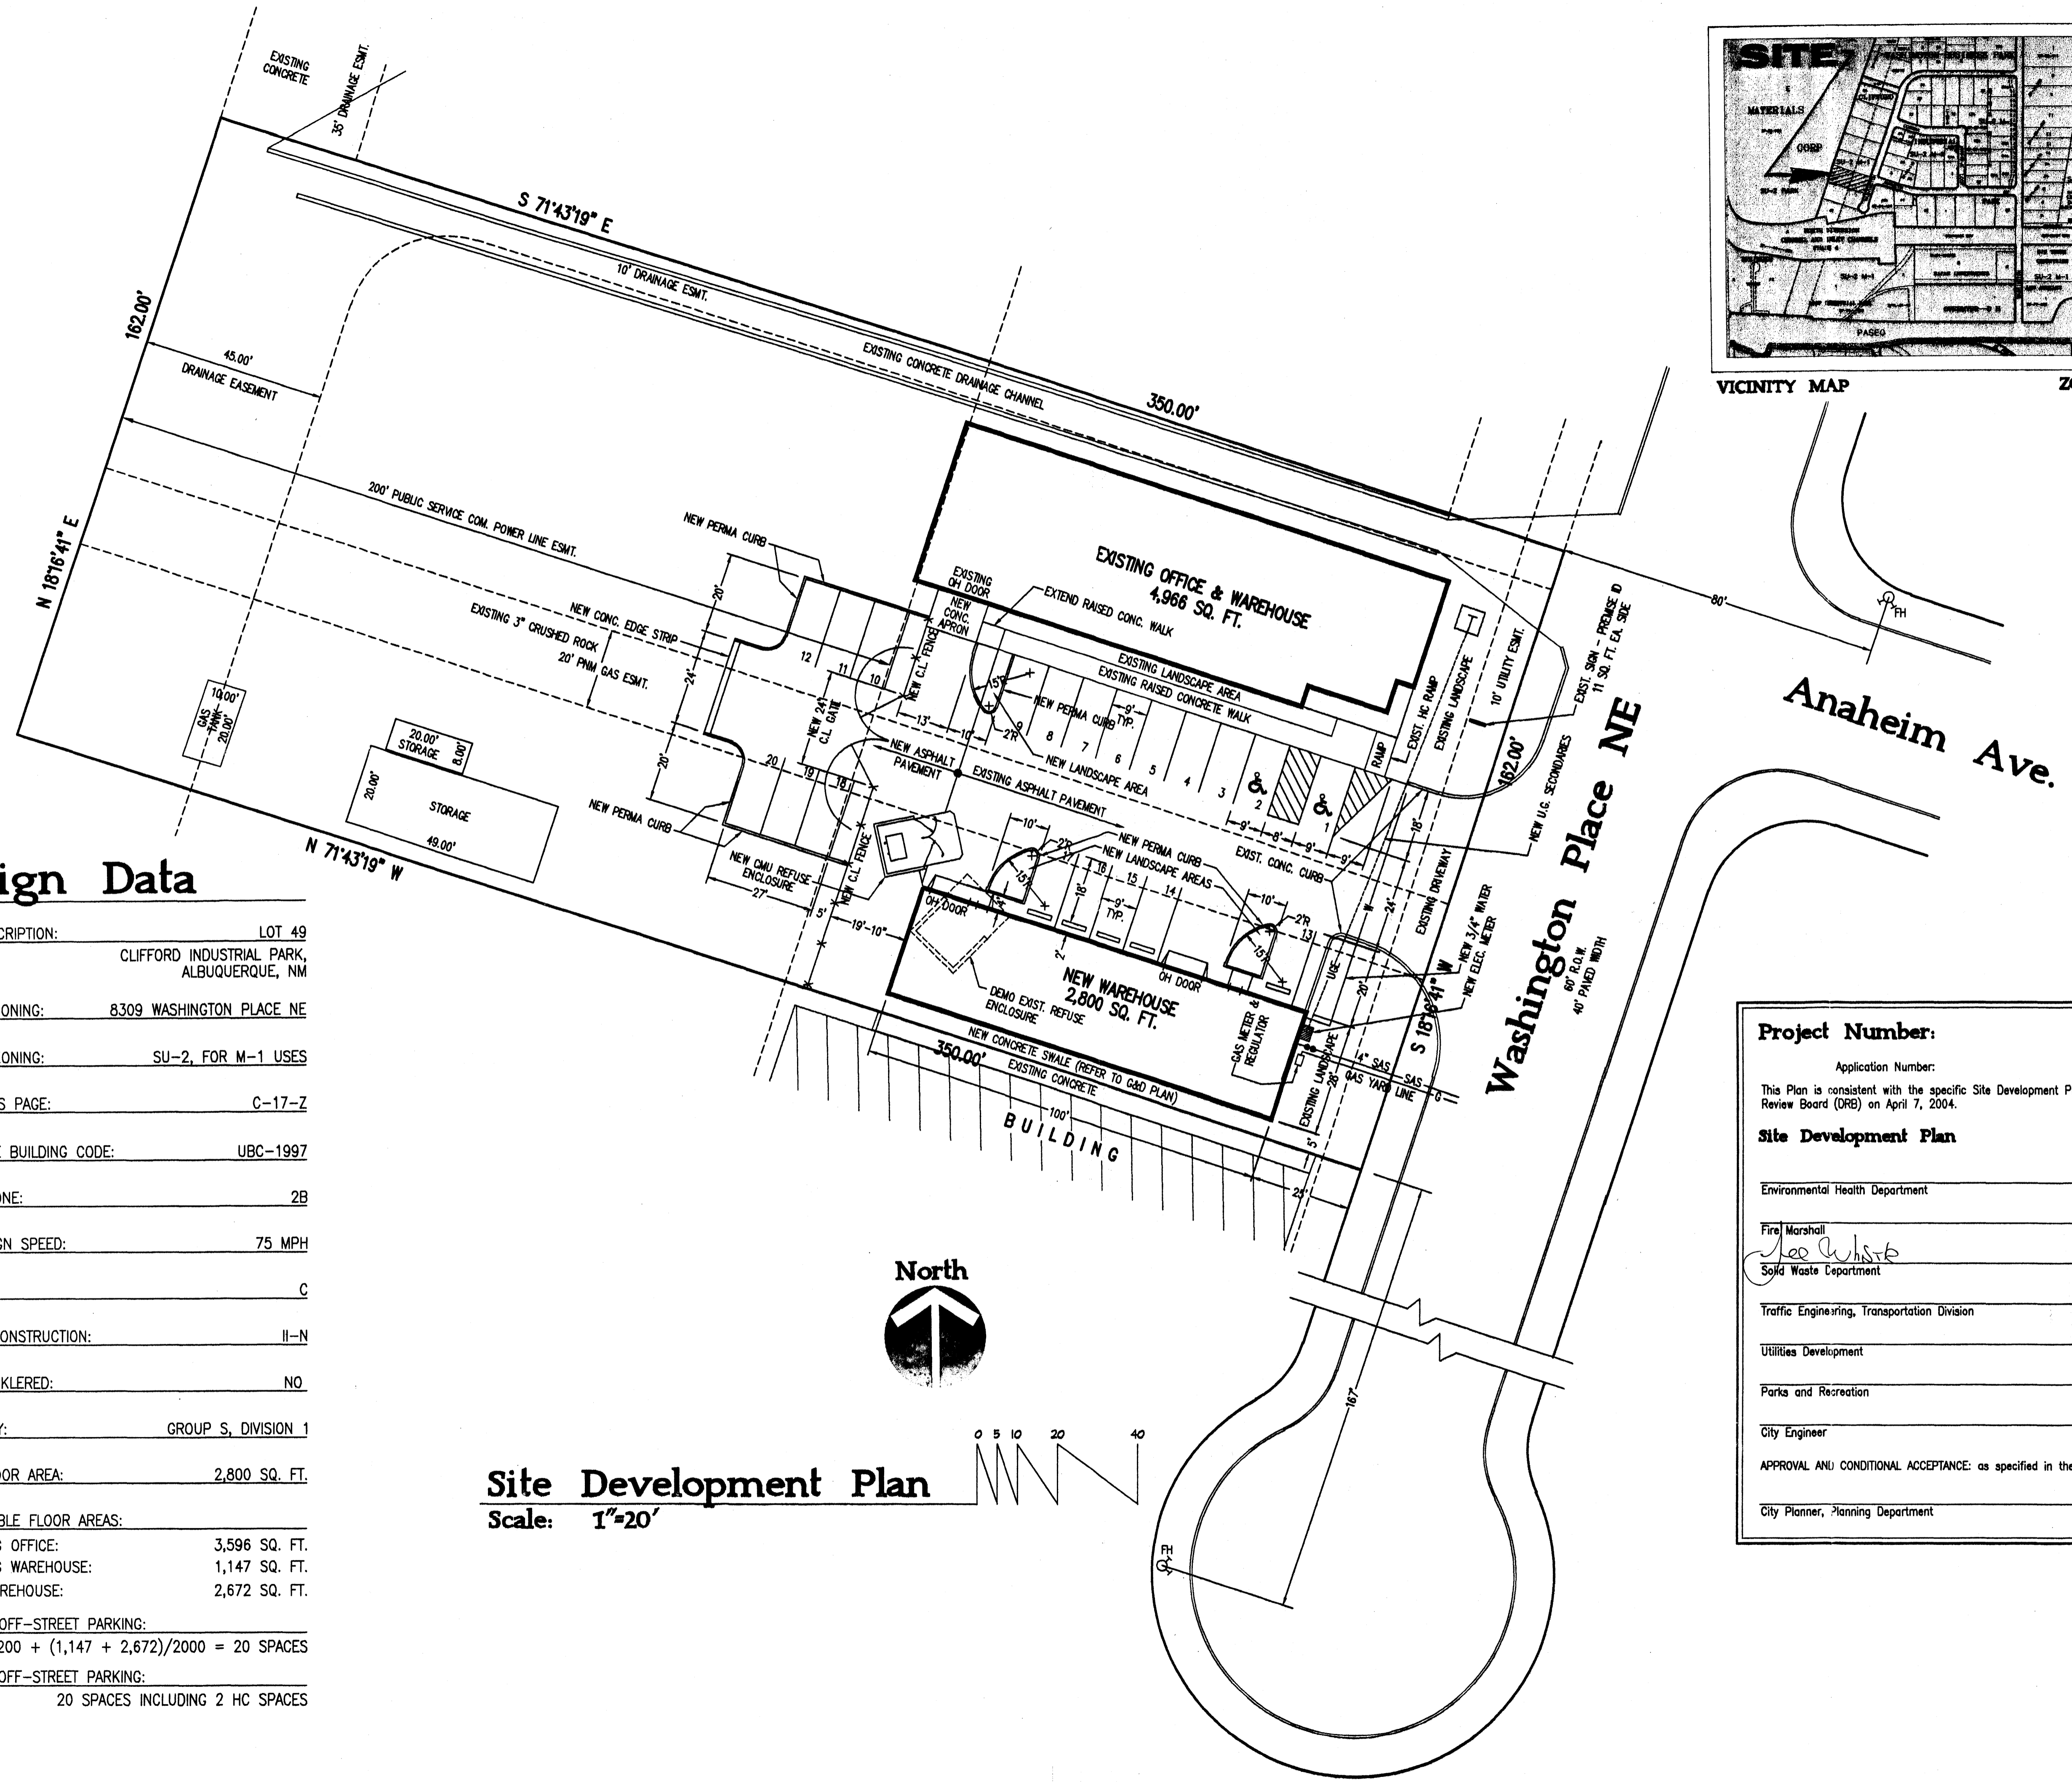


Design Data

LEGAL DESCRIPTION:	LOT 49 CLIFFORD INDUSTRIAL PARK, ALBUQUERQUE, NM
CURRENT ZONING:	8309 WASHINGTON PLACE NE
CURRENT ZONING:	SU-2, FOR M-1 USES
ZONE ATLAS PAGE:	C-17-Z
APPLICABLE BUILDING CODE:	UBC-1997
SEISMIC ZONE:	2B
WIND DESIGN SPEED:	75 MPH
EXPOSURE:	C
TYPE OF CONSTRUCTION:	II-N
FIRE SPRINKLERED:	NO
OCCUPANCY:	GROUP S, DIVISION 1
GROSS FLOOR AREA:	2,800 SQ. FT.
NET LEASABLE FLOOR AREAS:	
EXISTING OFFICE:	3,596 SQ. FT.
EXISTING WAREHOUSE:	1,147 SQ. FT.
NEW WAREHOUSE:	2,672 SQ. FT.
REQUIRED OFF-STREET PARKING:	
3,596/200 + (1,147 + 2,672)/2000 = 20 SPACES	
PROVIDED OFF-STREET PARKING:	
20 SPACES INCLUDING 2 HC SPACES	

Site Development Plan
Scale: 1"=20'

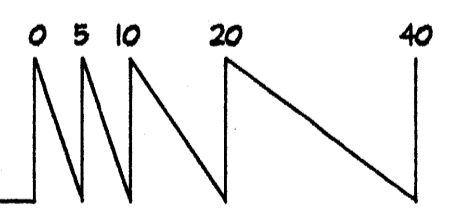


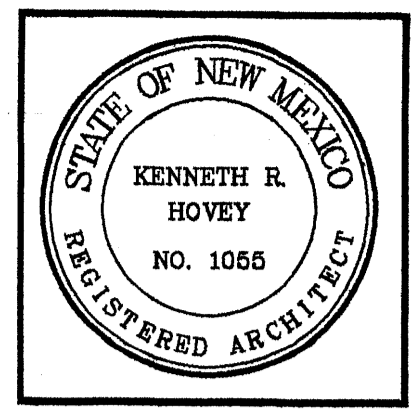


Warehouse for Commercial Enterprises
 8901 WASHINGTON PLACE NE ALBUQUERQUE, NEW MEXICO

KEN HOVEY, ARCHITECT
 505) 259-8458 * 3808 SIMMS AVENUE SE * ALBUQUERQUE, NM * 87108

JOB NO:	0309
DATE:	30 MARCH 2004
REVISIONS	


SHEET NO.
C.1

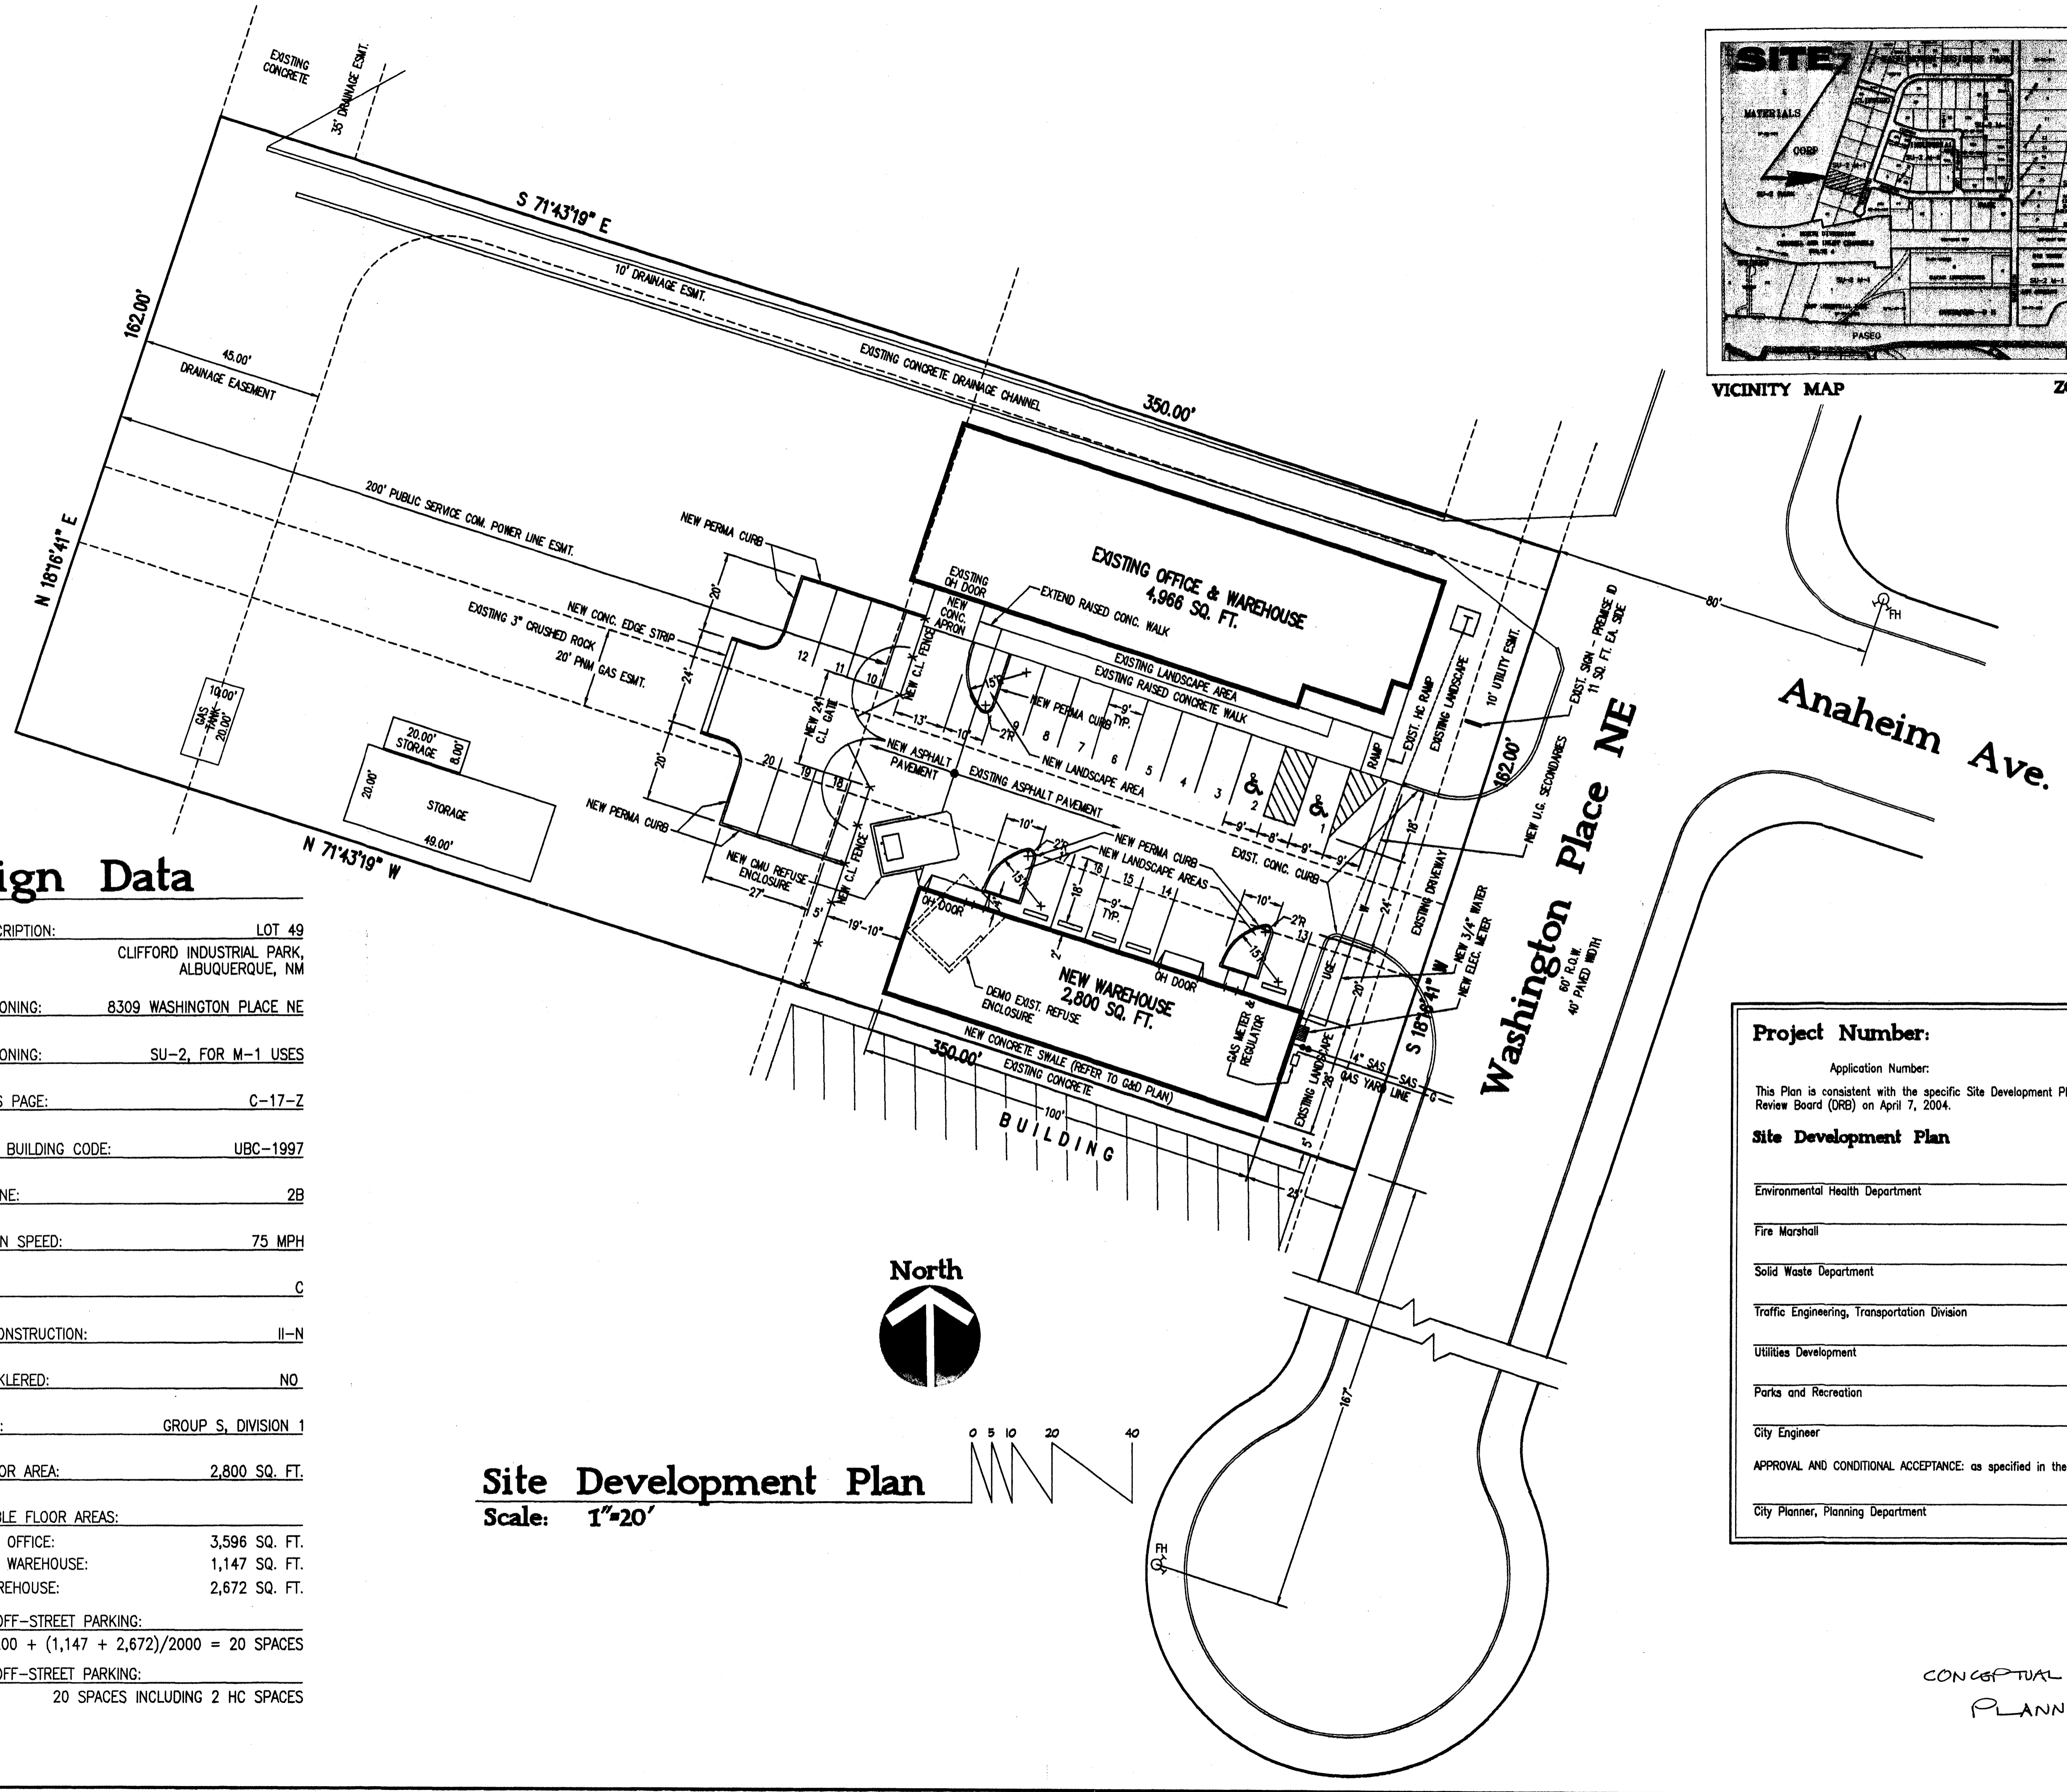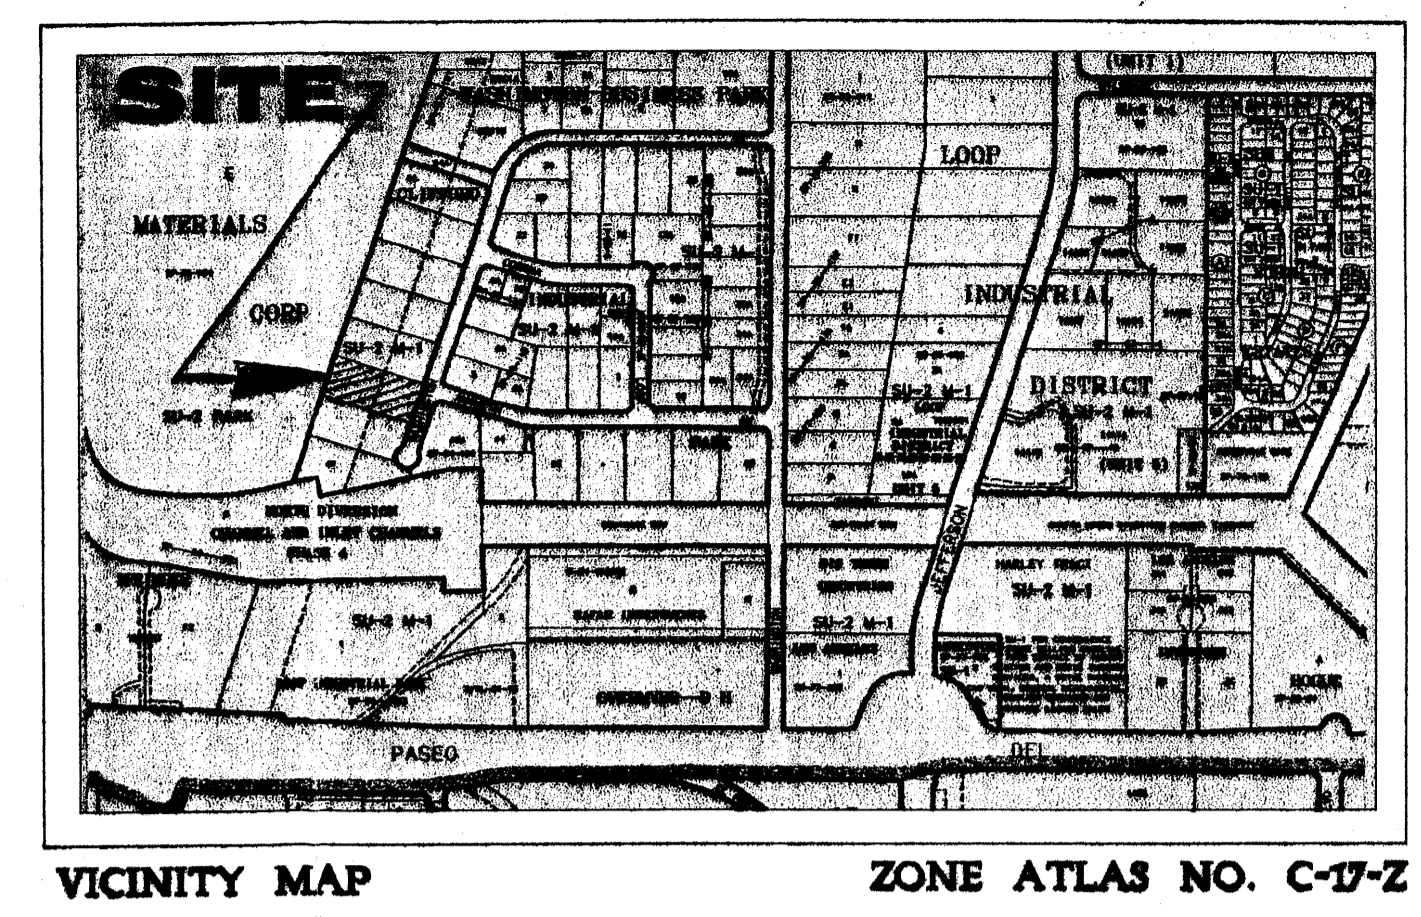

Design Data

LEGAL DESCRIPTION:	LOT 49 CLIFFORD INDUSTRIAL PARK, ALBUQUERQUE, NM
CURRENT ZONING:	8309 WASHINGTON PLACE NE
CURRENT ZONING:	SU-2, FOR M-1 USES
ZONE ATLAS PAGE:	C-17-Z
APPLICABLE BUILDING CODE:	UBC-1997
SEISMIC ZONE:	2B
WIND DESIGN SPEED:	75 MPH
EXPOSURE:	C
TYPE OF CONSTRUCTION:	II-N
FIRE SPRINKLERED:	NO
OCCUPANCY:	GROUP S, DIVISION 1
GROSS FLOOR AREA:	2,800 SQ. FT.
NET LEASABLE FLOOR AREAS:	
EXISTING OFFICE:	3,596 SQ. FT.
EXISTING WAREHOUSE:	1,147 SQ. FT.
NEW WAREHOUSE:	2,672 SQ. FT.
REQUIRED OFF-STREET PARKING:	$3,596/200 + (1,147 + 2,672)/2000 = 20$ SPACES
PROVIDED OFF-STREET PARKING:	20 SPACES INCLUDING 2 HC SPACES

Site Development Plan
 Scale: 1"=20'

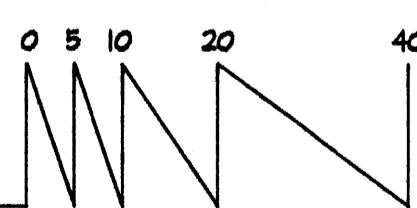

Project Number: _____
 Application Number: _____

This Plan is consistent with the specific Site Development Plan approved by the Development Review Board (DRB) on April 7, 2004.


Site Development Plan

Environmental Health Department	Date: _____
Fire Marshal	Date: _____
Solid Waste Department	Date: _____
Traffic Engineering, Transportation Division	Date: _____
Utilities Development	Date: _____
Parks and Recreation	Date: _____
City Engineer	Date: _____

APPROVAL AND CONDITIONAL ACCEPTANCE: as specified in the Development Process Manual.

City Planner, Planning Department	Date: _____
-----------------------------------	-------------

CONCEPTUAL UTILITY LAYOUT
 PLANNING

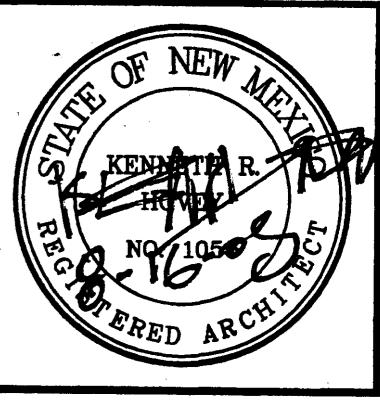


Warehouse for Commercial Enterprises
 8901 WASHINGTON PLACE NE ALBUQUERQUE, NEW MEXICO


KEN HOVEY, ARCHITECT
 505) 259-8458 * 3808 SIMMS AVENUE SE * ALBUQUERQUE, NM * 87108

JOB NO: 0309
 DATE: 12 AUGUST 2005
 REVISIONS

SHEET NO.
SD.1

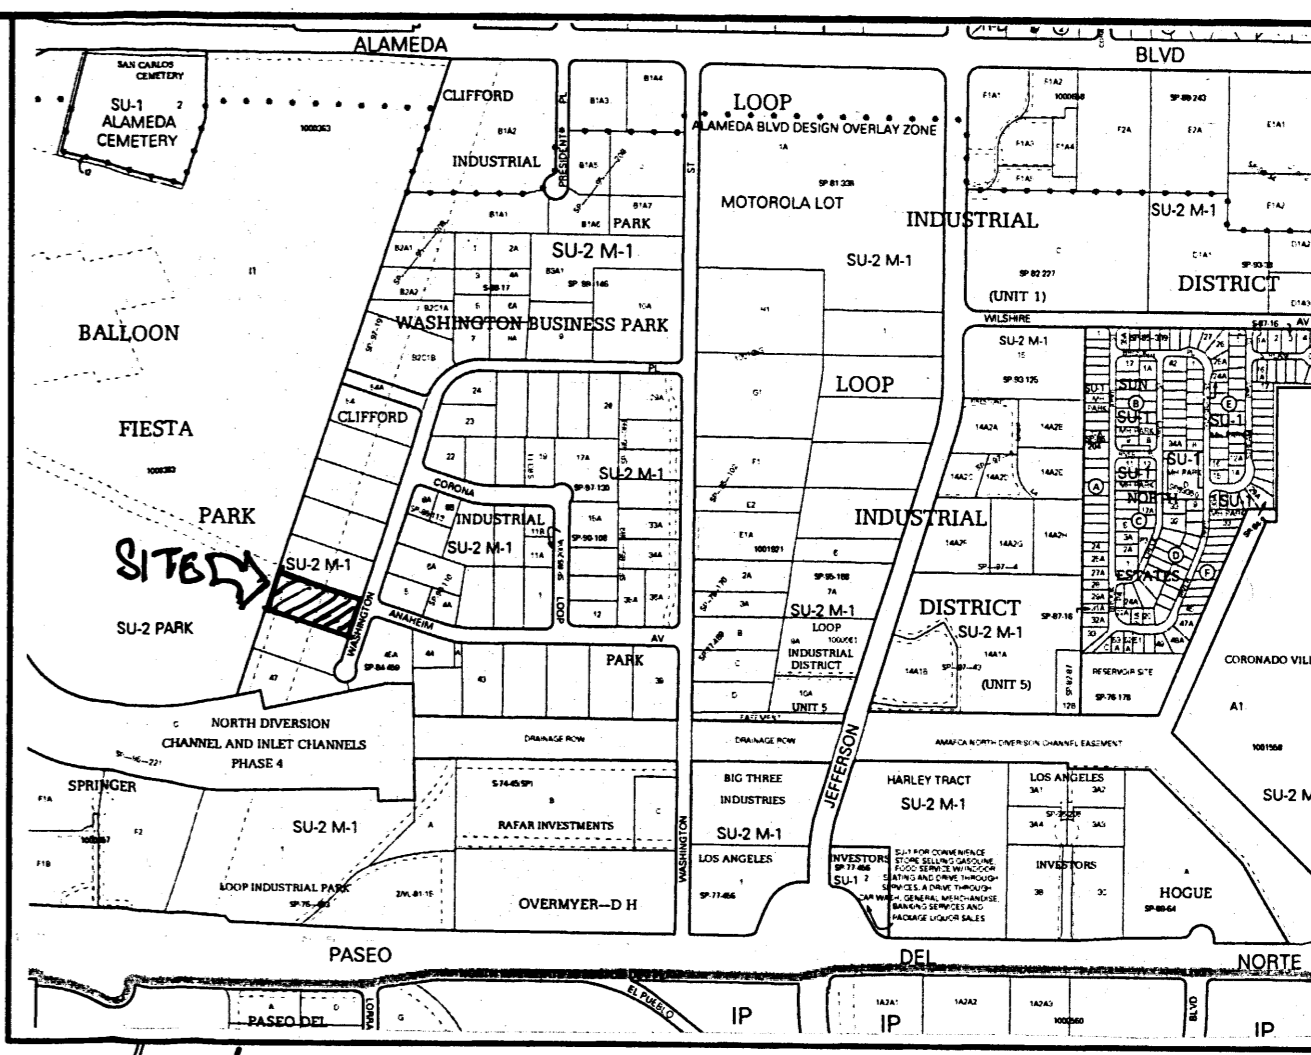

Vicinity Map C-17

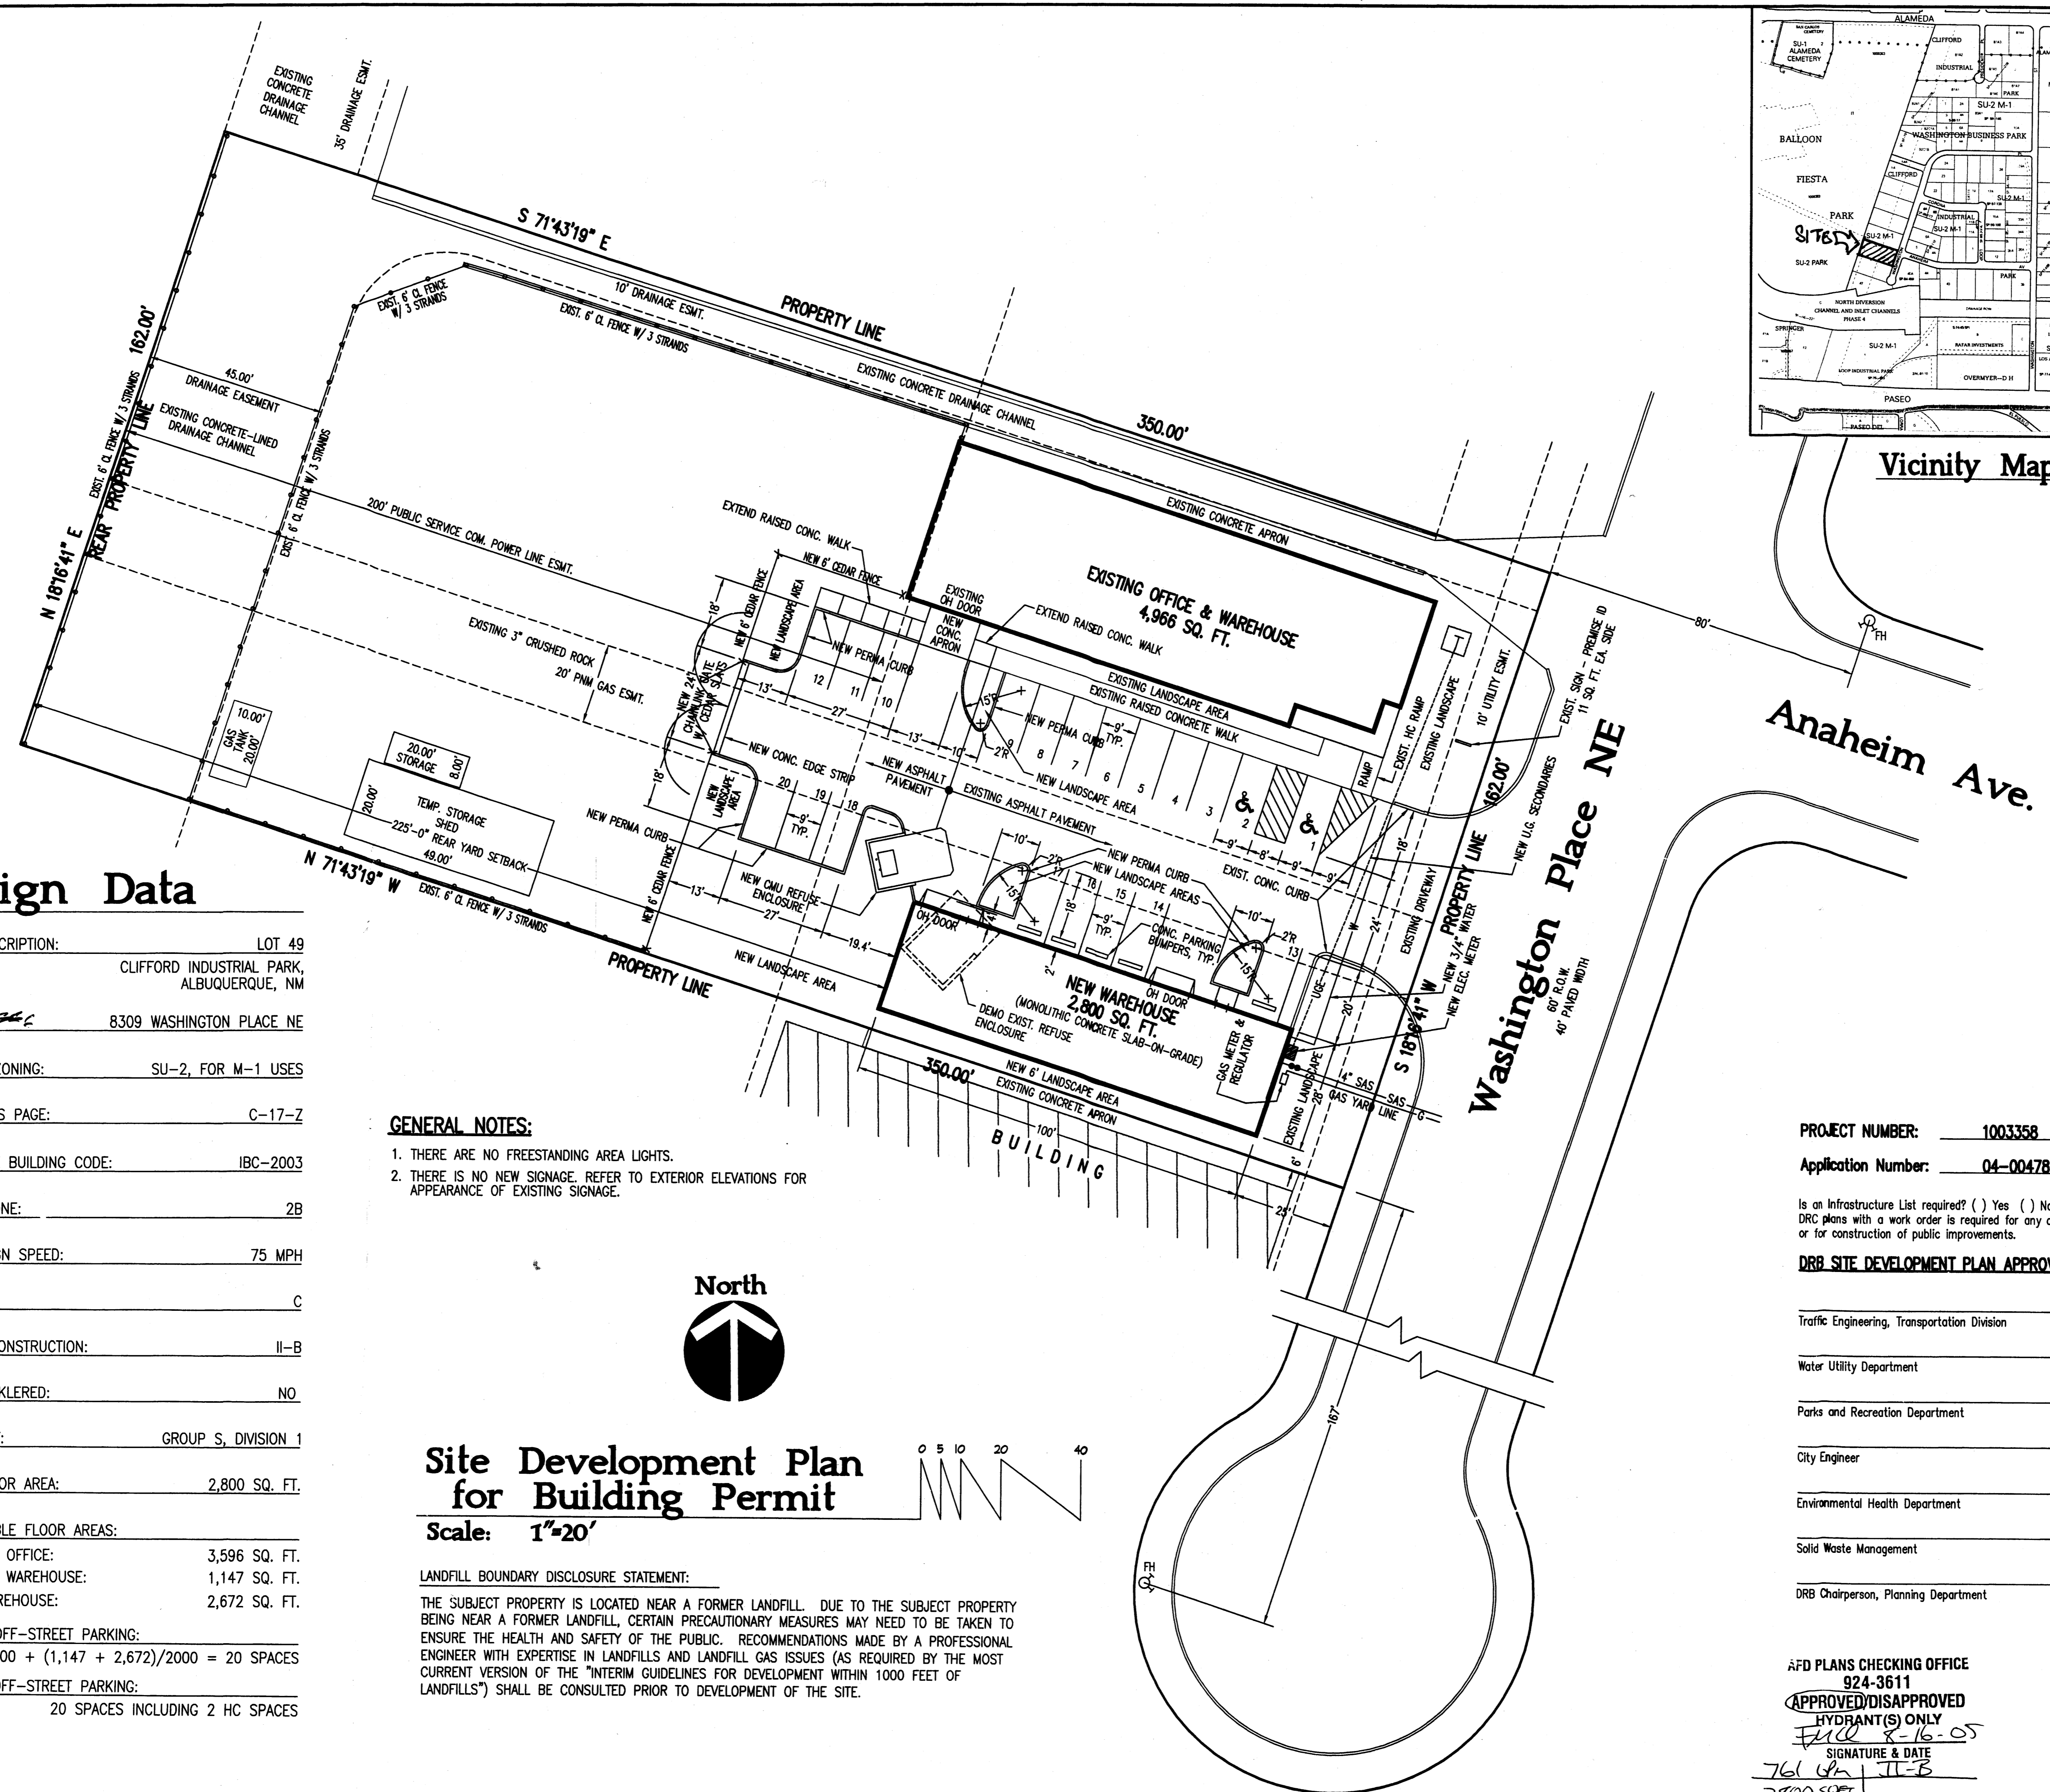

Design Data

LEGAL DESCRIPTION: LOT 49
 CLIFFORD INDUSTRIAL PARK,
 ALBUQUERQUE, NM

ADDRESS: 8309 WASHINGTON PLACE NE

CURRENT ZONING: SU-2, FOR M-1 USES

ZONE ATLAS PAGE: C-17-Z

APPLICABLE BUILDING CODE: IBC-2003

SEISMIC ZONE: 2B

WIND DESIGN SPEED: 75 MPH

EXPOSURE: C

TYPE OF CONSTRUCTION: II-B

FIRE SPRINKLERED: NO

OCCUPANCY: GROUP S, DIVISION 1

GROSS FLOOR AREA: 2,800 SQ. FT.

NET LEASABLE FLOOR AREAS:
 EXISTING OFFICE: 3,596 SQ. FT.
 EXISTING WAREHOUSE: 1,147 SQ. FT.
 NEW WAREHOUSE: 2,672 SQ. FT.

REQUIRED OFF-STREET PARKING:
 $3,596/200 + (1,147 + 2,672)/2000 = 20$ SPACES

PROVIDED OFF-STREET PARKING:
 20 SPACES INCLUDING 2 HC SPACES

GENERAL NOTES:


1. THERE ARE NO FREESTANDING AREA LIGHTS.
2. THERE IS NO NEW SIGNAGE. REFER TO EXTERIOR ELEVATIONS FOR APPEARANCE OF EXISTING SIGNAGE.



Site Development Plan for Building Permit

Scale: 1"=20'

LANDFILL BOUNDARY DISCLOSURE STATEMENT:
 THE SUBJECT PROPERTY IS LOCATED NEAR A FORMER LANDFILL. DUE TO THE SUBJECT PROPERTY BEING NEAR A FORMER LANDFILL, CERTAIN PRECAUTIONARY MEASURES MAY NEED TO BE TAKEN TO ENSURE THE HEALTH AND SAFETY OF THE PUBLIC. RECOMMENDATIONS MADE BY A PROFESSIONAL ENGINEER WITH EXPERTISE IN LANDFILLS AND LANDFILL GAS ISSUES (AS REQUIRED BY THE MOST CURRENT VERSION OF THE "INTERIM GUIDELINES FOR DEVELOPMENT WITHIN 1000 FEET OF LANDFILLS") SHALL BE CONSULTED PRIOR TO DEVELOPMENT OF THE SITE.

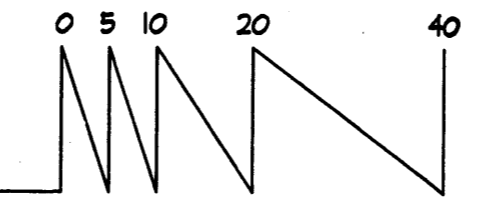

PROJECT NUMBER: 1003358
 Application Number: 04-00478

Is an Infrastructure List required? () Yes () No If yes, then a set of approved DRG plans with a work order is required for any construction within Public Right-of-Way or for construction of public improvements.

DRB SITE DEVELOPMENT PLAN APPROVAL:

Traffic Engineering, Transportation Division	_____	Date
Water Utility Department	_____	Date
Parks and Recreation Department	_____	Date
City Engineer	_____	Date
Environmental Health Department	_____	Date
Solid Waste Management	_____	Date
DRB Chairperson, Planning Department	_____	Date

AFD PLANS CHECKING OFFICE
 924-3611
APPROVED/DISAPPROVED
 HYDRANT(S) ONLY
 FILE 8-16-05
 SIGNATURE & DATE
 761 gm / II-B
 2800 sqft





Warehouse for Commercial Enterprises
 8309 WASHINGTON PLACE NE ALBUQUERQUE, NEW MEXICO

KEN HOVEY, ARCHITECT
 505) 259-8458 • 3808 SIMMS AVENUE SE • ALBUQUERQUE, NM • 87108

JOB NO.	0309
DATE	12 JULY 2004
REVISIONS	


SHEET NO.
C.1

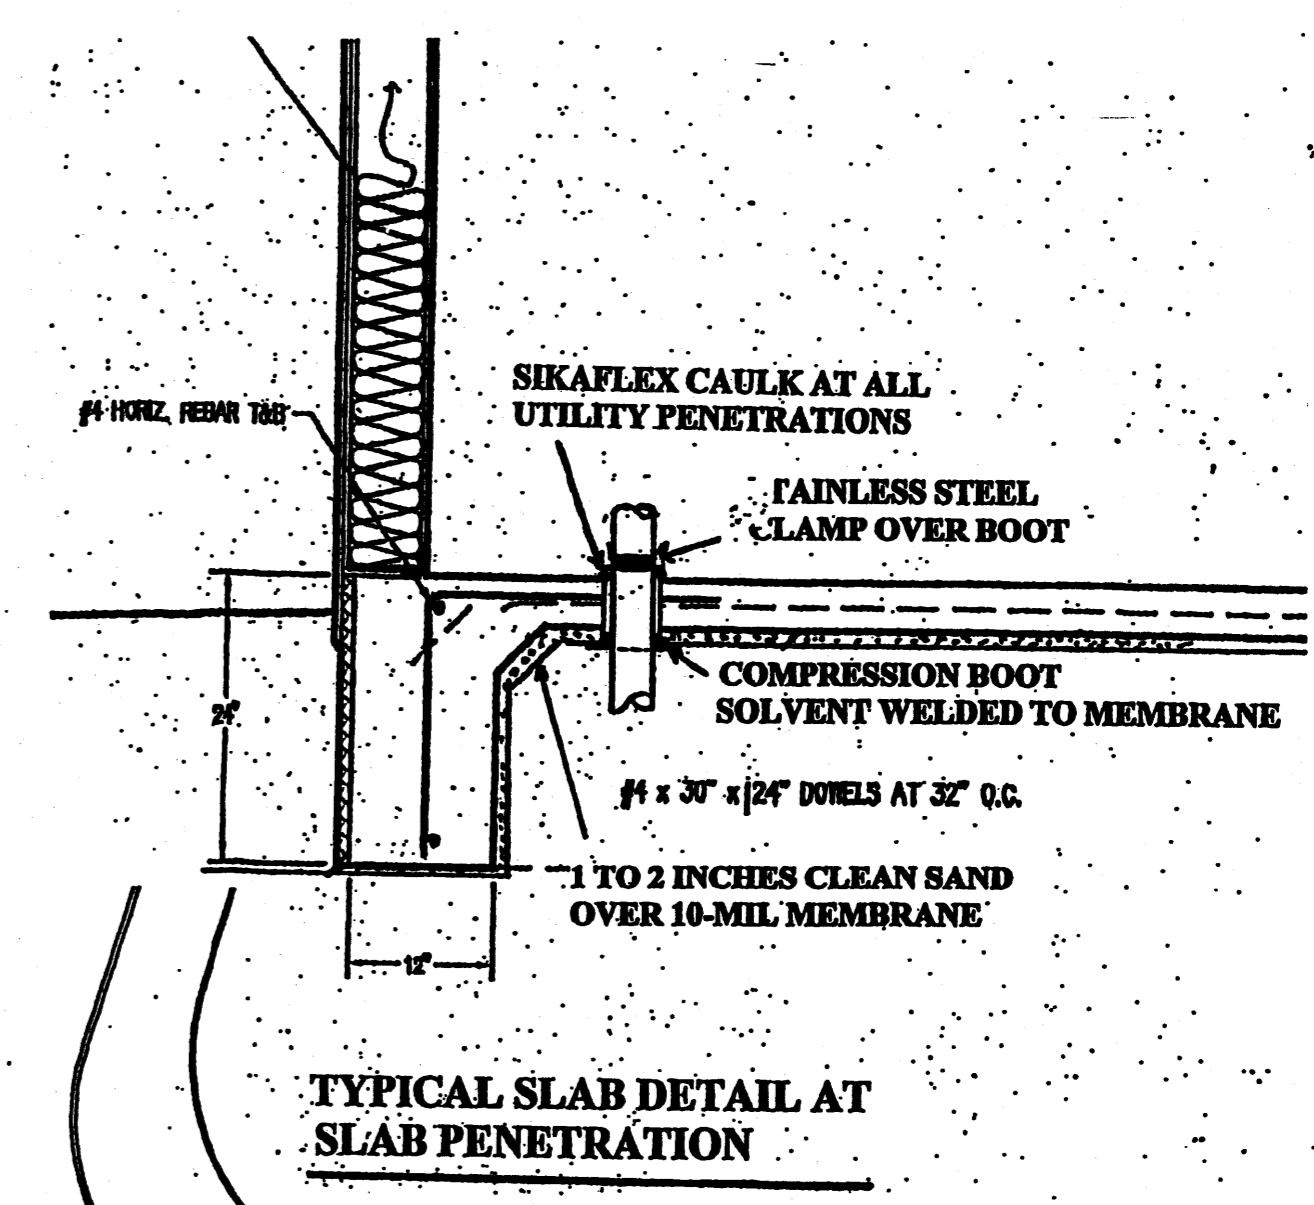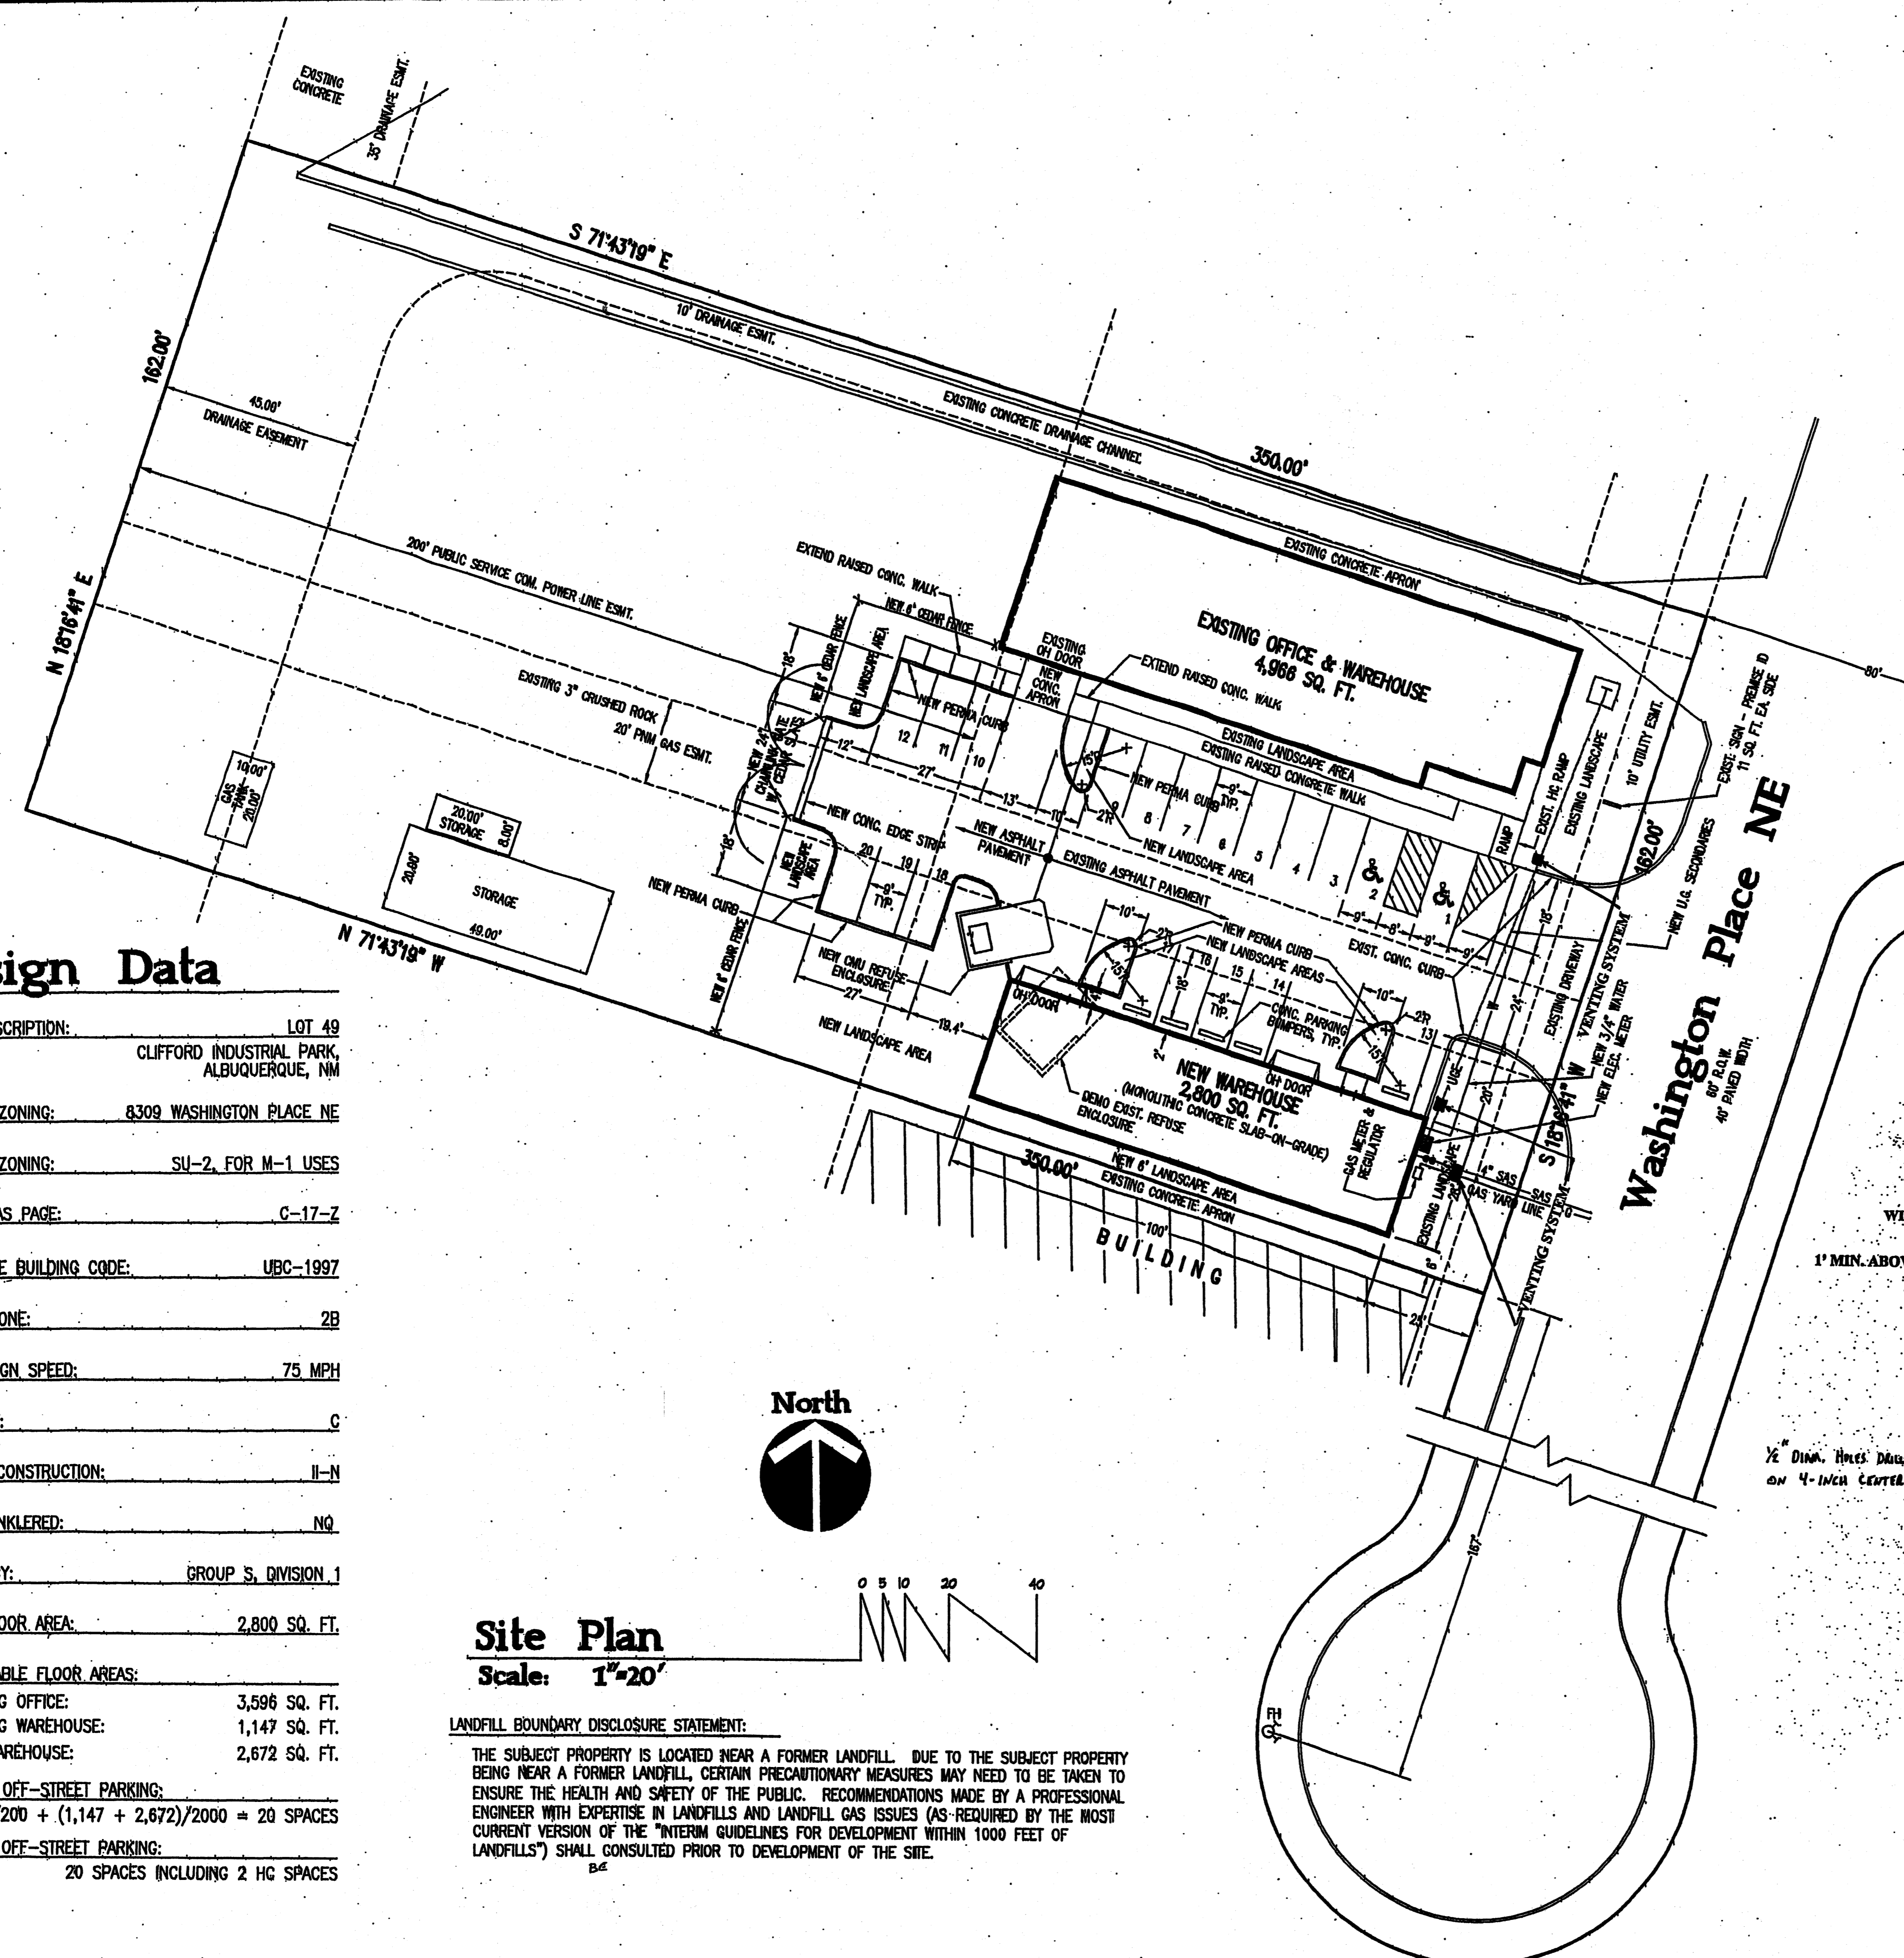

LANDSCAPE FABRIC SPECIFICATION CHART

Product Model	LAKB Standard
Manufacturing	Standard
Material	Polyester
Weight	1.50 lb/sq. yd.
Strength	3.25 in.
Permeability	45.1
Water Flow	130
UV-Treated	65-85
Permeability	200
UV-Treated	75%
UV-Treated	
UV-Treated	

Colorado Dept. of Transportation Minimum Requirements (2000) A8724 (2-00) Test Per Approved Worksheet

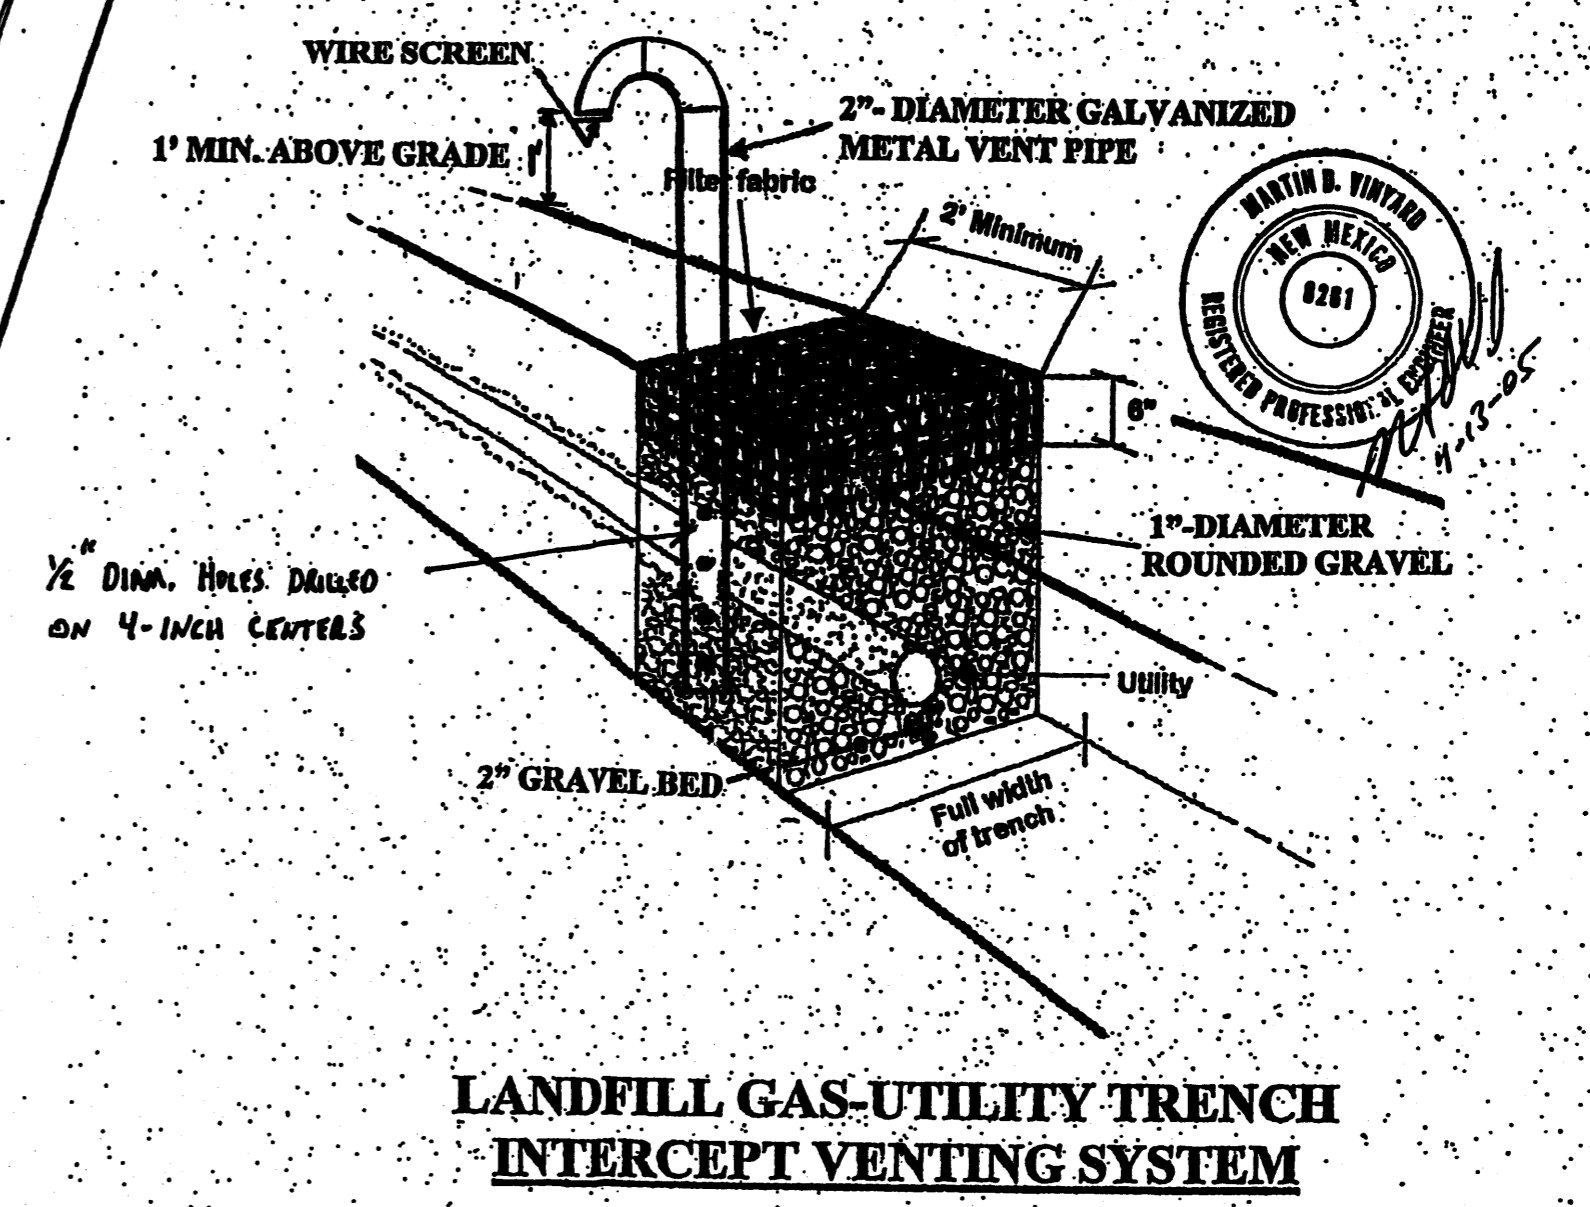



Design Data

LEGAL DESCRIPTION:	LOT 49 CLIFFORD INDUSTRIAL PARK, ALBUQUERQUE, NM
CURRENT ZONING:	8309 WASHINGTON PLACE NE
CURRENT ZONING:	SU-2, FOR M-1 USES
ZONE ATLAS PAGE:	C-17-Z
APPLICABLE BUILDING CODE:	UBC-1997
SEISMIC ZONE:	2B
WIND DESIGN SPEED:	75 MPH
EXPOSURE:	C
TYPE OF CONSTRUCTION:	II-N
FIRE SPRINKLERED:	NQ
OCCUPANCY:	GROUP S, DIVISION 1
GROSS FLOOR AREA:	2,800 SQ. FT.
NET LEASABLE FLOOR AREAS:	
EXISTING OFFICE:	3,596 SQ. FT.
EXISTING WAREHOUSE:	1,147 SQ. FT.
NEW WAREHOUSE:	2,672 SQ. FT.
REQUIRED OFF-STREET PARKING:	
3,596/200 + (1,147 + 2,672)/2000 = 20 SPACES	
PROVIDED OFF-STREET PARKING:	
20 SPACES INCLUDING 2 HC SPACES	

Site Plan
 Scale: 1"=20'

LANDFILL BOUNDARY DISCLOSURE STATEMENT:
 THE SUBJECT PROPERTY IS LOCATED NEAR A FORMER LANDFILL. DUE TO THE SUBJECT PROPERTY BEING NEAR A FORMER LANDFILL, CERTAIN PRECAUTIONARY MEASURES MAY NEED TO BE TAKEN TO ENSURE THE HEALTH AND SAFETY OF THE PUBLIC. RECOMMENDATIONS MADE BY A PROFESSIONAL ENGINEER WITH EXPERTISE IN LANDFILLS AND LANDFILL GAS ISSUES (AS REQUIRED BY THE MOST CURRENT VERSION OF THE "INTERIM GUIDELINES FOR DEVELOPMENT WITHIN 1000 FEET OF LANDFILLS") SHALL CONSULTED PRIOR TO DEVELOPMENT OF THE SITE.

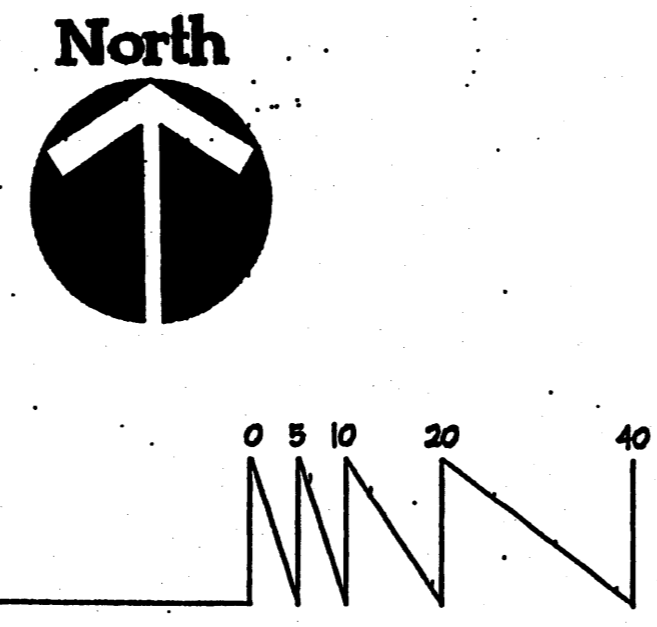

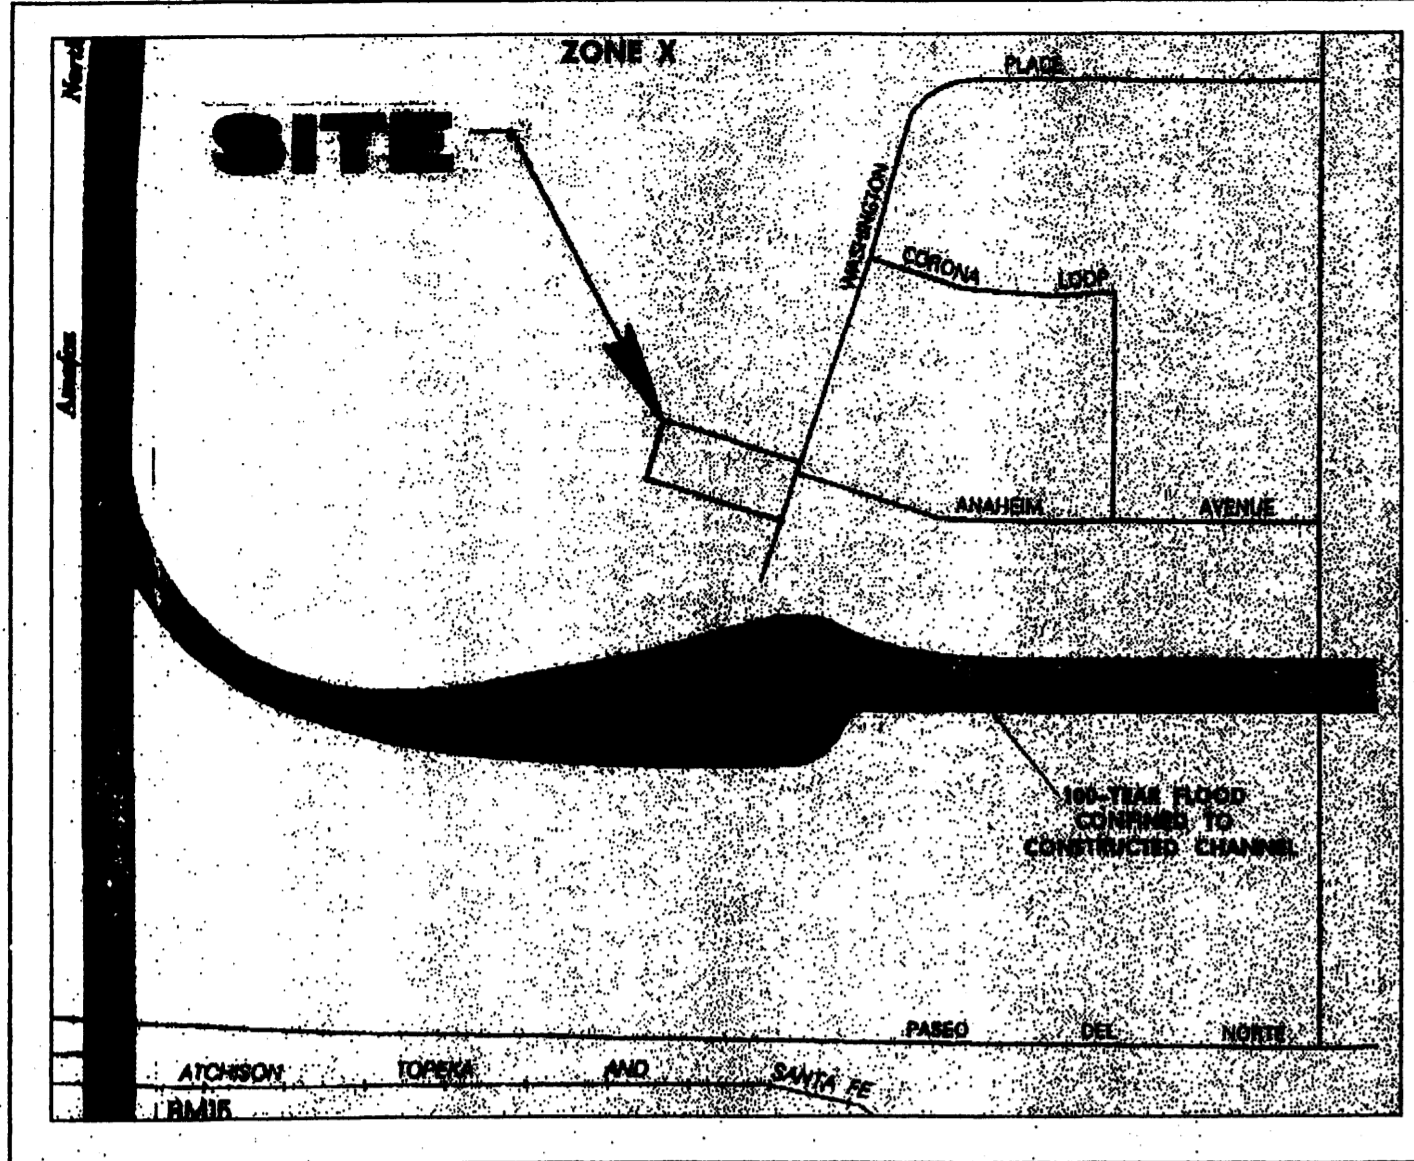

FLOOD INSURANCE RATE MAP MAP NO. 35001C0136 D


- GENERAL NOTES:**
1. CONTOUR INTERVAL IS ONE (1) FOOT.
 2. ELEVATIONS ARE BASED ON CITY OF ALBUQUERQUE STATION No. "12-C17", HAVING AN ELEVATION OF 5107.95
 3. UTILITIES SHOWN HEREON ARE IN THEIR APPROXIMATE LOCATION BASED ONLY ON ABOVE GROUND EVIDENCE FOUND IN THE FIELD AND AS-BUILT INFORMATION PROVIDED BY THE CLIENT. UTILITIES SHOWN HEREON, WHETHER INDICATED AS ABANDONED OR NOT, SHALL BE VERIFIED BY OTHERS FOR EXACT LOCATION AND/OR DEPTH PRIOR TO EXCAVATION OR DESIGN CONSIDERATIONS.
 5. THIS IS NOT A BOUNDARY SURVEY. BEARINGS AND DISTANCES SHOWN HEREON ARE FOR REFERENCE ONLY.

LEGEND:


EXISTING	NEW	DESCRIPTION
— 500 —	— 80 —	CONTOUR
— 80.00 —	— 80.00 —	SPOT ELEVATION
— — —	— — —	PROPERTY LINE
— — —	— — —	SWALE
— — —	— — —	SHEET FLOW
— — —	— — —	ROOF FLOW
— — —	— — —	ROOF GUTTER
— — —	— — —	DOWNSPOUT
LEGEND		
— — —	— — —	TC = TOP OF CONCRETE
— — —	— — —	FL = FLOW LINE
— — —	— — —	TG = TOP OF GRADE
— — —	— — —	EOW = END OF WALL

- EROSION CONTROL NOTES:**
1. THE CONTRACTOR SHALL BE RESPONSIBLE FOR COMPLIANCE WITH THE FOLLOWING
 1. NO SEDIMENT-BEARING WATER SHALL BE ALLOWED TO DISCHARGE FROM THE SITE DURING CONSTRUCTION.
 2. DURING GRADING OPERATIONS AND UNTIL THE PROJECT HAS BEEN COMPLETED, ALL ADJACENT PROPERTY, RIGHTS-OF-WAY, AND EASEMENTS SHALL BE PROTECTED FROM FLOODING BY RUNOFF FROM THE SITE.
 3. SHOULD THE CONTRACTOR FAIL TO PREVENT SEDIMENT-BEARING WATER FROM ENTERING PUBLIC RIGHT-OF-WAY, HE SHALL PROMPTLY REMOVE FROM THE PUBLIC RIGHT-OF-WAY ANY AND ALL SEDIMENT ORIGINATING FROM THE SITE.
 4. CONTROL OF SEDIMENT-LADEN WATERS WILL BE ACCOMPLISHED BY USE OF A COMPACTED EARTH BERM OF ADEQUATE HEIGHT. THE BERM SHALL BE LOCATED ALONG THE DOWNSTREAM PERIMETER OF THE PROPERTY.



LEGAL DESCRIPTION:
LOT 49, CLIFFORD INDUSTRIAL PARK, ALBUQUERQUE, NEW MEXICO.

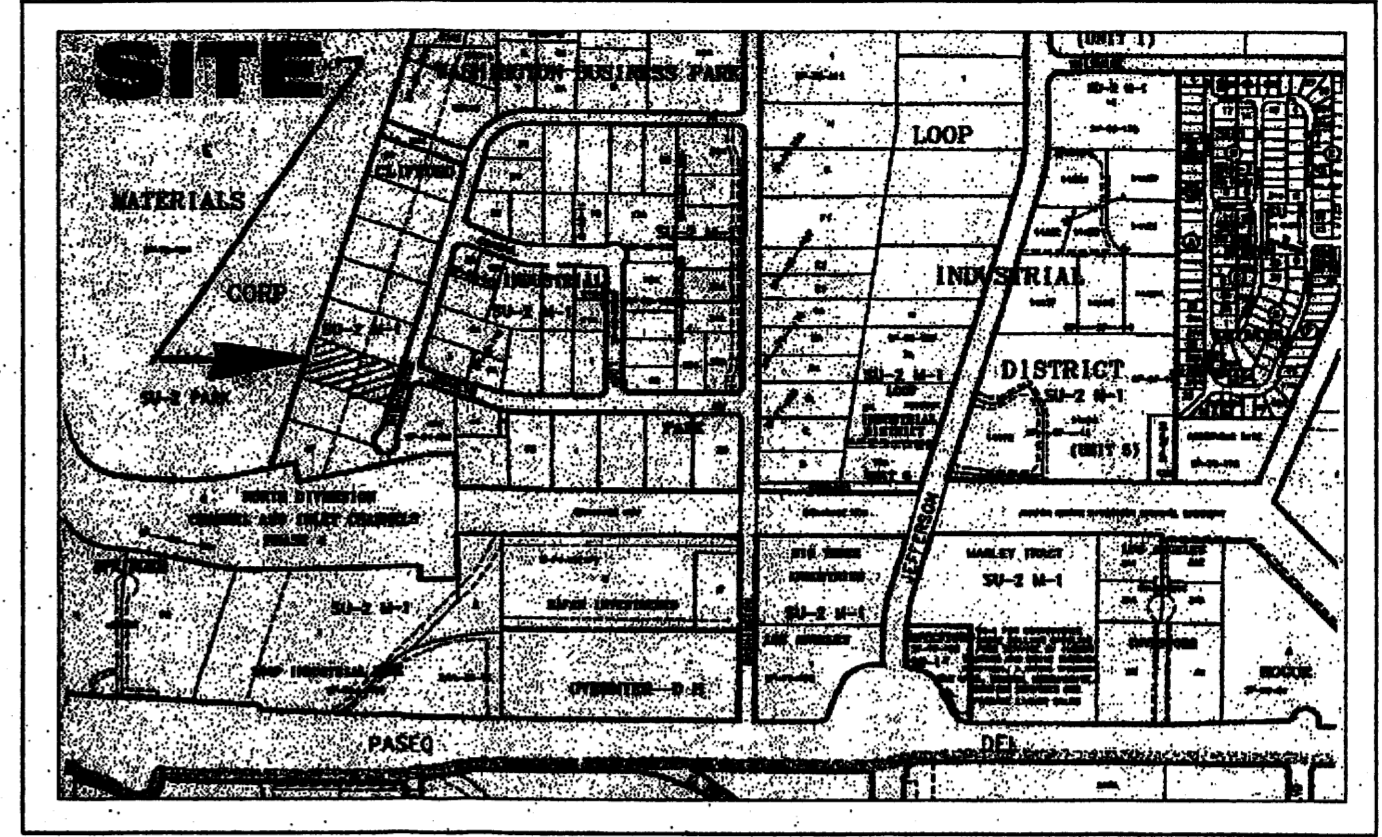

VICINITY MAP ZONE ATLAS NO. C-17-Z

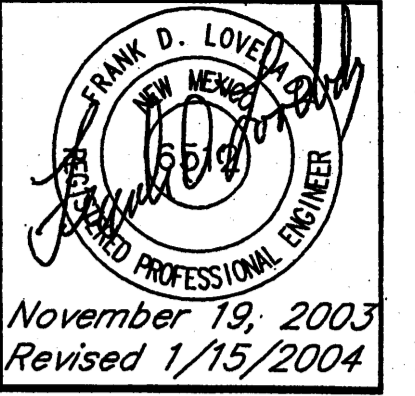

Warehouse for Commercial Enterprises
8801 WASHINGTON PLACE NE ALBUQUERQUE, NEW MEXICO

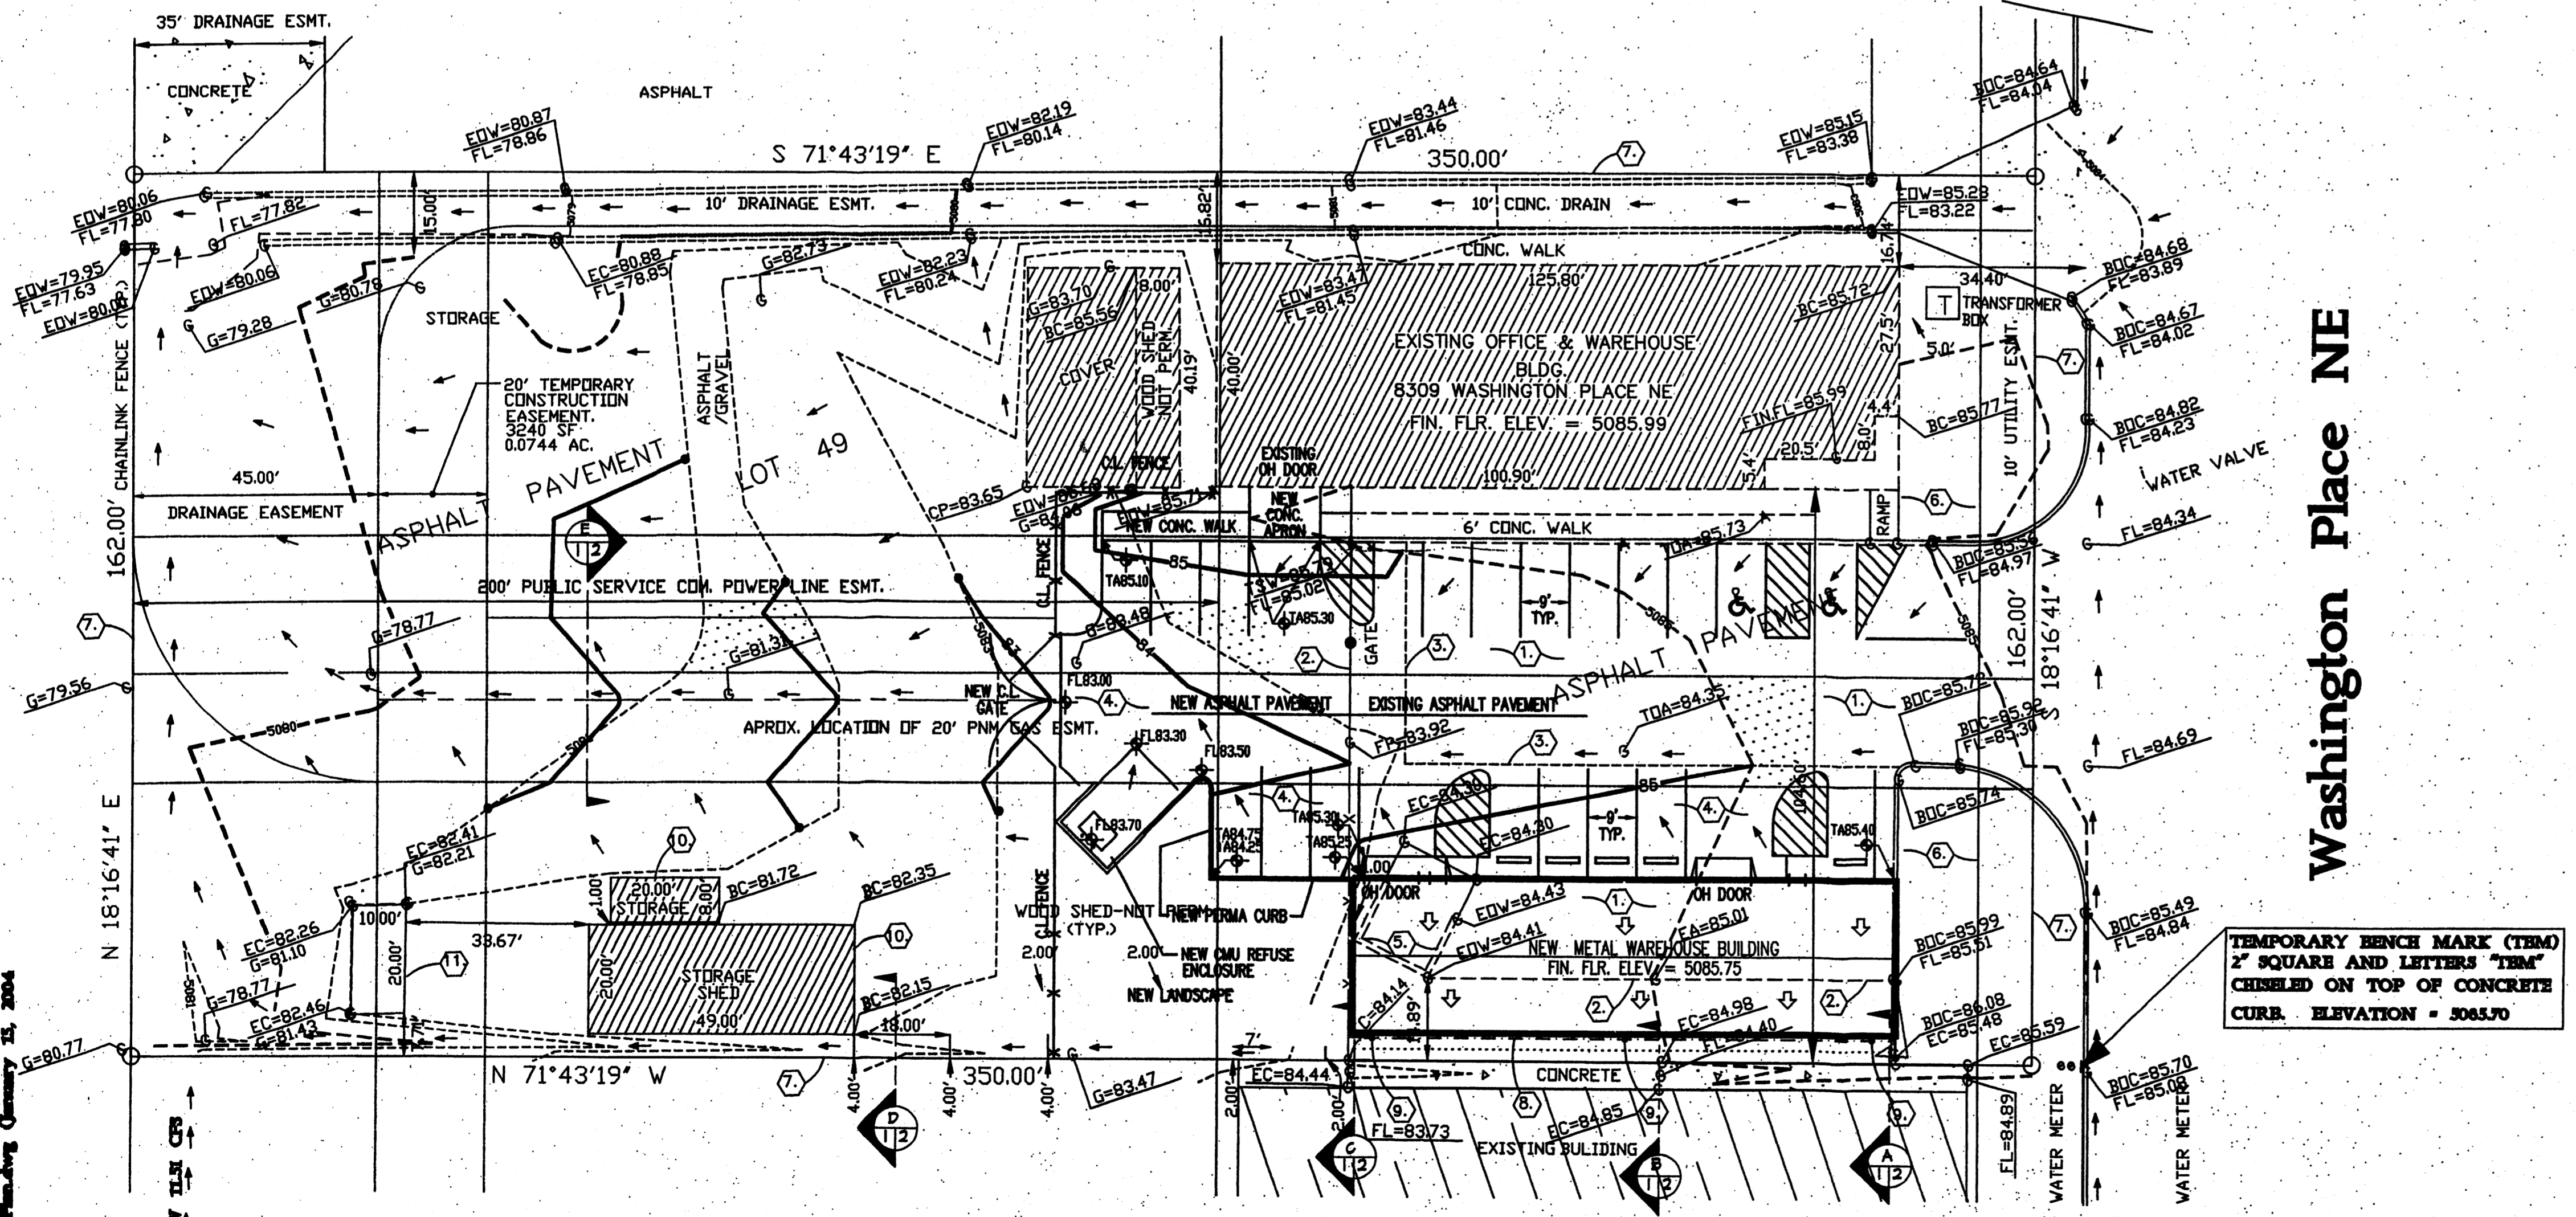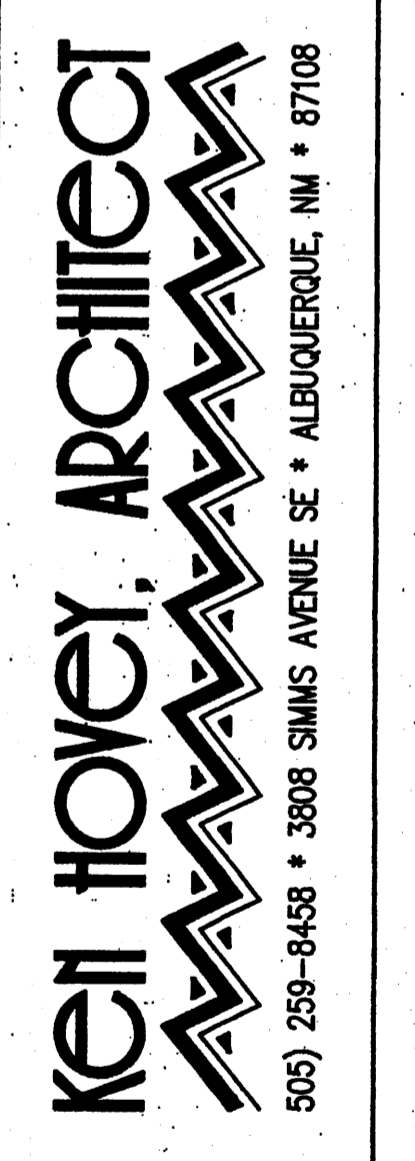

Washington Place NE

- GENERAL NOTES:**
1. PRIOR TO CONSTRUCTION, THE CONTRACTOR SHALL EXCAVATE AND VERIFY THE LOCATION OF ALL POTENTIAL OBSTRUCTIONS. SHOULD A CONFLICT EXIST, THE CONTRACTOR SHALL NOTIFY THE ENGINEER AS SOON AS POSSIBLE TO RESOLVE THE CONFLICT WITH A MINIMUM AMOUNT OF DELAY.
 2. ALL WORK ON THIS PLAN SHALL BE PERFORMED IN ACCORDANCE WITH APPLICABLE FEDERAL, STATE AND LOCAL LAWS, RULES AND REGULATIONS CONCERNING CONSTRUCTION SAFETY AND HEALTH.
 3. IF ANY UTILITY LINES, PIPELINES, OR UNDERGROUND UTILITY LINES ARE SHOWN ON THESE DRAWINGS, THEY ARE SHOWN IN AN APPROXIMATE LOCATION ONLY, AND LINES MAY EXIST WHERE NONE ARE SHOWN. THE LOCATION IS BASED UPON INFORMATION PROVIDED BY THE UTILITY OWNER OR FROM EXISTING PLANS, AND THIS INFORMATION MAY BE INCOMPLETE, OR OBSOLETE AT THE TIME OF CONSTRUCTION. THE ENGINEER HAS NOT UNDERTAKEN ANY FIELD VERIFICATION OF THESE LOCATIONS, LINE SIZES OR MATERIAL TYPE, MAKES NO REPRESENTATION THERETO, AND ASSUMES NO RESPONSIBILITY OR LIABILITY THEREFOR. THE CONTRACTOR SHALL INFORM ITSELF OF THE LOCATIONS OF ANY UTILITY LINE, PIPELINE OR UNDERGROUND INSTALLATION IN OR NEAR THE AREA IN ADVANCE OF OR DURING ANY EXCAVATION WORK. THE CONTRACTOR IS FULLY RESPONSIBLE FOR ANY AND ALL DAMAGES CAUSED BY ITS FAILURE TO LOCATE, IDENTIFY AND PRESERVE ANY AND ALL EXISTING UTILITIES, PIPELINES AND UNDERGROUND FACILITIES. IN PLANNING AND CONDUCTING EXCAVATIONS, THE CONTRACTOR SHALL COMPLY WITH ALL STATE STATUTES, MUNICIPAL AND LOCAL ORDINANCES, RULES AND REGULATIONS, IF ANY, PERTAINING TO THE LOCATION OF THESE LINES AND FACILITIES.
 4. THE CONTRACTOR SHALL ENSURE THAT NO SOIL ERODES FROM THE SITE INTO PUBLIC RIGHTS-OF-WAY OR ONTO PRIVATE PROPERTY. THIS CAN BE ACHIEVED BY CONSTRUCTING TEMPORARY BERMS AND BY WETTING THE SOIL TO KEEP IT FROM BLOWING.
 5. THE CONTRACTOR SHALL OBTAIN ANY AND ALL PERMITS REQUIRED BY THE CITY OF ALBUQUERQUE FOR THE COMPLETION OF THE WORK PRIOR TO BEGINNING CONSTRUCTION.

- KEYED NOTES:**
1. EXISTING ASPHALT PAVEMENT.
 2. EDGE OF EXISTING ASPHALT PAVEMENT.
 3. EDGE OF ASPHALT REMOVAL AND REPLACEMENT.
 4. NEW ASPHALT PAVEMENT.
 5. EXISTING REFUSE ENCLOSURE - DEMOLISH.
 6. EXISTING LANDSCAPING.
 7. PROPERTY LINE.
 8. ROOF GUTTER.
 9. DOWNSPOUT.
 10. EXISTING TEMPORARY BUILDINGS TO BE REMOVED, RELOCATED OR LEFT IN PLACE AS DETERMINED BY THE OWNER. NOTE: ALL TEMPORARY BUILDINGS WITHIN THE CHANNEL CONST. AREA HAVE BEEN REMOVED.
 11. EXISTING CONCRETE PAD. CITY PLANS FOR CLIFFORD CHANNEL, REALIGNMENT CALL FOR REMOVAL AND DISPOSAL OF THIS PAD.

Grading & Drainage Plan
Scale: 1"=20'

JOB NO:	0309
DATE:	15 JANUARY 2004
REVISIONS	
1	ITEM RELOCATED, TEMP. CONST. EASEMENT ADDED.

SHEET NO.
C.1.1

DRAINAGE CALCULATIONS:

EXISTING CONDITIONS:

The site is located on the west side of Washington Place NE, the third lot north of the Domingo Baca Channel. There is a drainage concrete channel along the north edge of the site. The existing building roof has an east-west ridge and the north side of the building drains directly into the drainage channel via splash blocks that extend over the channel wall. The parking lot is paved and there are several non-permanent buildings on the site. drainage is from east to west. At the NW corner of the site the drainage channel continues west into the old balcon fiesta area. The lots north and south of the site are also developed. (See aerial photo, Sheet C.1.2)

DEVELOPED CONDITIONS:

It is proposed to construct a new metal storage building on the site as shown. The building will be constructed in an area which is now partially paved. The pavement will be extended to the west as shown. All runoff will continue to flow to the west and then north into the existing easement as it presently does.

FUTURE IMPROVEMENTS:

The City of Albuquerque proposes to construct 'Clifford Channel Realignment at Former Los Angeles Landfill'. Construction plans have been prepared and a reduced set will be submitted with this grading and drainage submittal. No attempt has been made to show the channel grades on this plan.

DRAINAGE CRITERIA:

The calculations shown on this plan were prepared in accordance with Section 22.2, Hydrology, of the Development Process Manual, Volume 2, Design Criteria, for the City of Albuquerque in cooperation with Bernalillo County, New Mexico and the Metropolitan Arroyo Flood Control Authority, January, 1993.

PRECIPITATION ZONE:

The site is between the Rio Grande River and San Mateo Blvd. and is, therefore, in Precipitation Zone 2.

LAND TREATMENT 'D':

SURFACE	EXISTING	DEVELOPED
CONCRETE	4,095	5,236
ASPHALT PAVING	8,623	9,698
BUILDING	8,369	11,169
TOTAL	21,087	26,103

LAND TREATMENT AREAS:

The peak discharge per acre and excess precipitation are shown for the four land treatments in Zone 2 in the table below, and the values shown are from the City of Albuquerque D.P.M. Also shown are the existing and proposed land treatment areas:

LAND TREAT.	C (cfs/acre)		E (in)		Existing Site Areas		Developed Site Areas		
	100-yr	10-yr	100-yr	10-yr	%	Sq. Ft.	%	Sq. Ft.	
A	1.56	0.38	0.53	0.13	0.0	0.0000	0.0	0.0000	
B	2.28	0.95	0.78	0.28	4.8	2,726	0.0624	4.8	2,720
C	3.14	1.71	1.13	0.52	58.0	32,893	0.7551	49.2	27,877
D	4.70	3.14	2.12	1.34	32.2	21,087	0.4841	46.0	26,103
Totals					100.0	56,700	1.3016	100.0	56,700

PEAK DISCHARGE:

EXISTING CONDITIONS:

$$Q_{100} = 0.0624 \times 2.28 + 0.7551 \times 3.14 + 0.4841 \times 4.70 = 4.79 \text{ cfs}$$

$$Q_{10} = 0.0624 \times 0.95 + 0.7551 \times 1.71 + 0.4841 \times 3.14 = 2.87 \text{ cfs}$$

DEVELOPED CONDITIONS:

$$Q_{100} = 0.0624 \times 2.28 + 0.6400 \times 3.14 + 0.5992 \times 4.70 = 4.97 \text{ cfs}$$

$$Q_{10} = 0.0624 \times 0.95 + 0.6400 \times 1.71 + 0.5992 \times 3.14 = 3.04 \text{ cfs}$$

VOLUME 100-YEAR AND 10-YEAR, 6-HOUR:

EXISTING CONDITIONS:

$$V_{100} = (2,720 \times 0.78 + 32,893 \times 1.13 + 21,087 \times 2.12) / 12 = 7,000 \text{ cf}$$

$$V_{10} = (2,720 \times 0.28 + 32,893 \times 0.52 + 21,087 \times 1.34) / 12 = 3,844 \text{ cf}$$

DEVELOPED CONDITIONS:

$$V_{100} = (2,720 \times 0.78 + 27,877 \times 1.13 + 26,103 \times 2.12) / 12 = 7,413 \text{ cf}$$

$$V_{10} = (2,720 \times 0.28 + 27,877 \times 0.52 + 26,103 \times 1.34) / 12 = 4,186 \text{ cf}$$

SUMMARY OF ON-SITE VOLUMES AND PEAK DISCHARGE RATE:

	V100(CF)	V10(CF)	Q100(CFS)	Q10(CFS)
DEVELOPED	7,413	4,186	4.97	3.04
EXISTING	7,000	3,844	4.79	2.87
INCREASE	413	342	0.18	0.17

NEW BUILDING ROOF RUNOFF:

AREA = 3300 SF

$$Q_{100} = (3300 / 43,560) \times 4.7 = 0.36 \text{ CFS}$$

CAPACITY OF SWALE (SECTION D):

SWALE 5' WIDE X 0.5' DEEP

AREA = 1.25 SF


$$P = 5.1 \quad \text{SLOPE} = 4.14 = 200 = 0.0207$$

$$R = A/P = 1.25 / 5.1 = 0.25 \quad N = 0.035 \text{ (GRAVEL)}$$

$$V = (1.486 / 0.035) \times (0.25)^{2/3} \times (0.0207)^{1/2} = 2.4 \text{ FPS}$$


$$Q = AV = 1.25 \times 2.4 = 3.00 \text{ CFS}$$

3.00 CFS > 0.36 CFS ADEQUATE

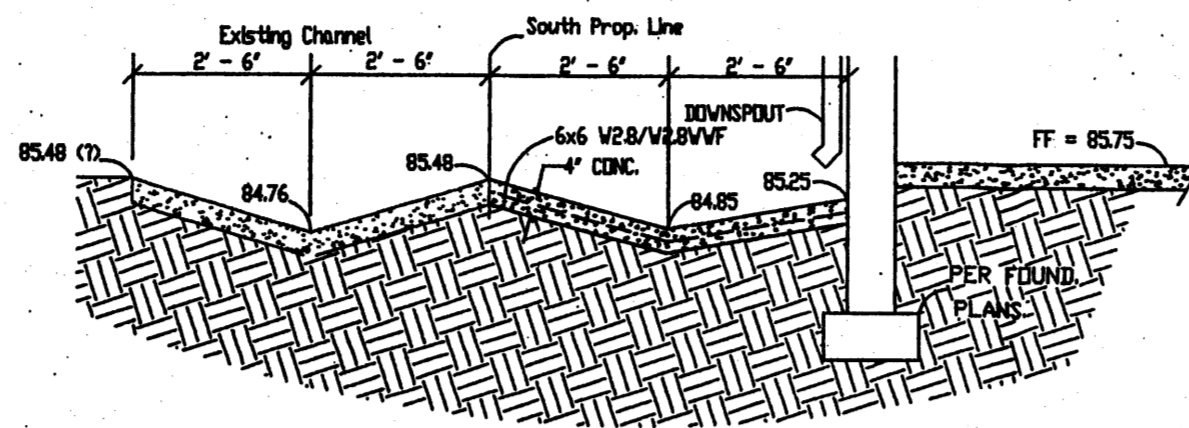


A
1/2" 3/8" = 1" - 0"

NOTE:
TOTAL DISTANCE BETWEEN SECTIONS 'A' & 'B' IS 43.6'
SLOPE = (84.85 - 84.50) / 43.6 = 0.0080 FT/FT.

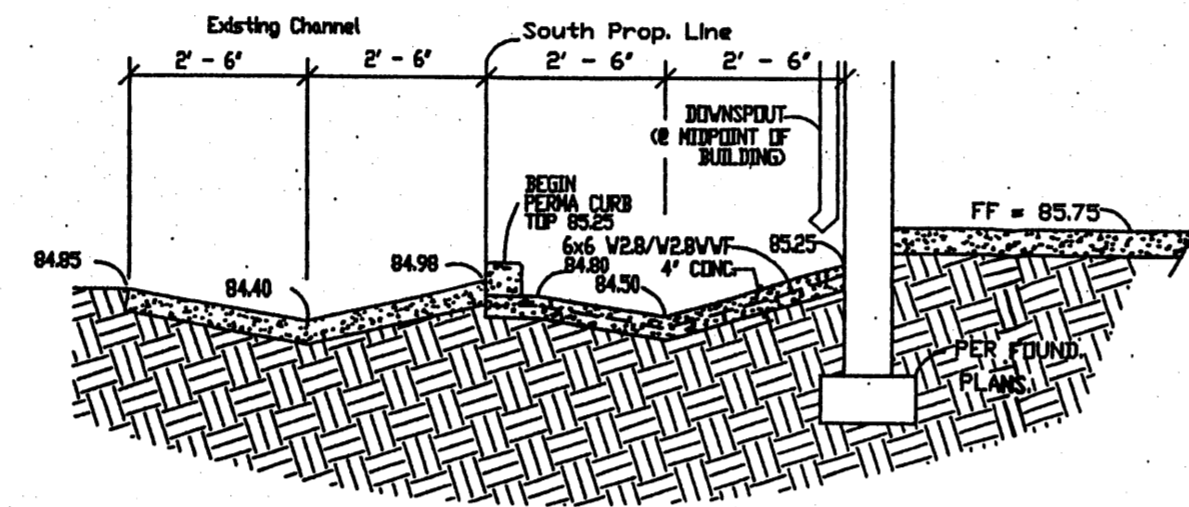


B
1/2" 3/8" = 1" - 0"


NOTE:
TRANSITION FROM 'V' SHAPED CHANNEL TO FLAT BOTTOMED
CHANNEL BETWEEN SECTIONS 'B' AND 'C'. TOTAL DISTANCE
IS 56.0'. SLOPE = (84.5 - 84.1) / 56 = 0.0064 FT/FT.

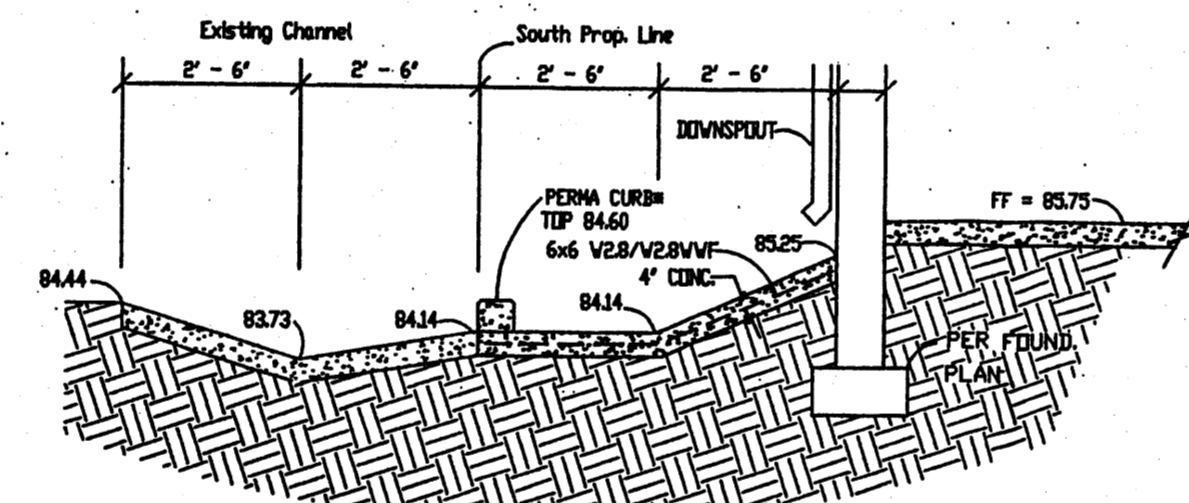


C
1/2" 3/8" = 1" - 0"

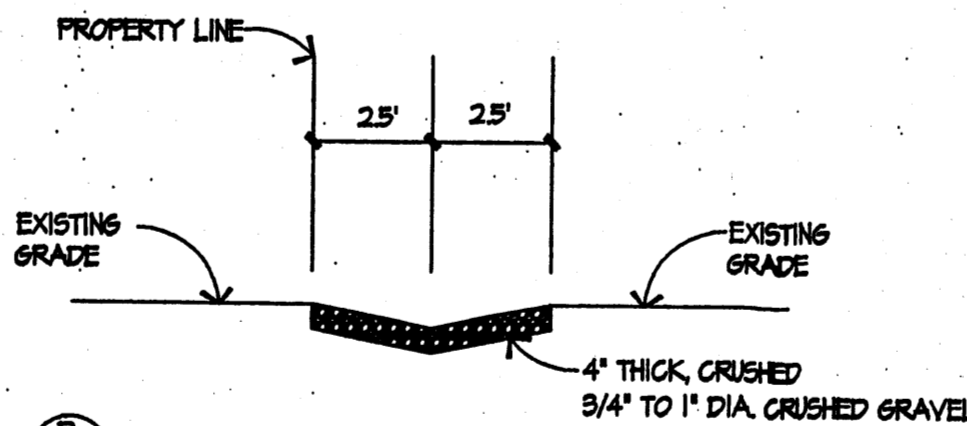

D
1/4" 1/4" = 1" - 0"

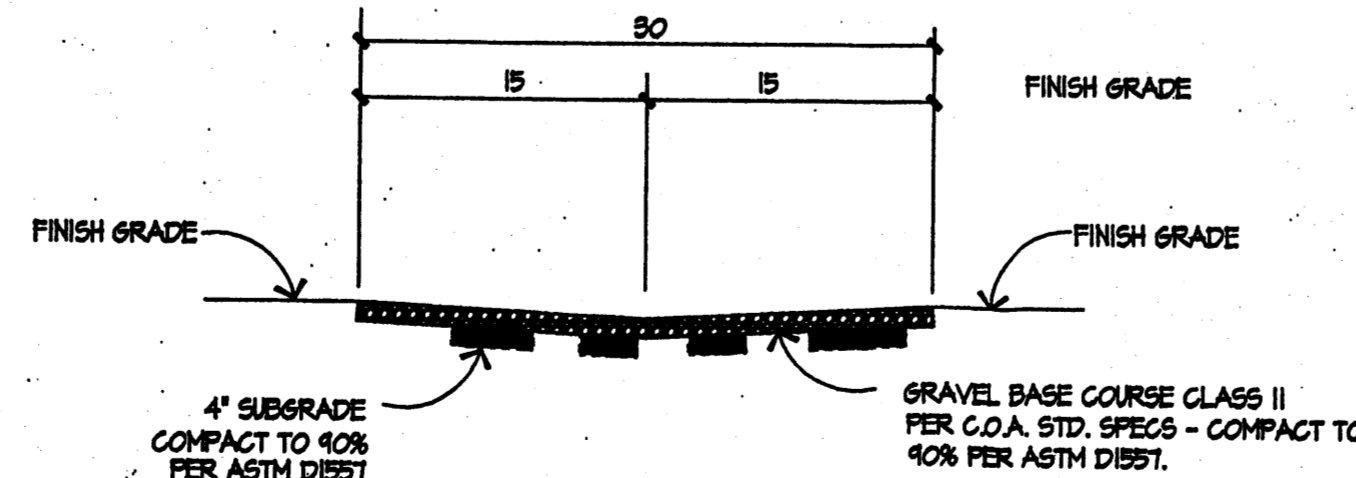

E
1/2" HORIZONTAL 1" = 10'
VERTICAL 1" = 5'

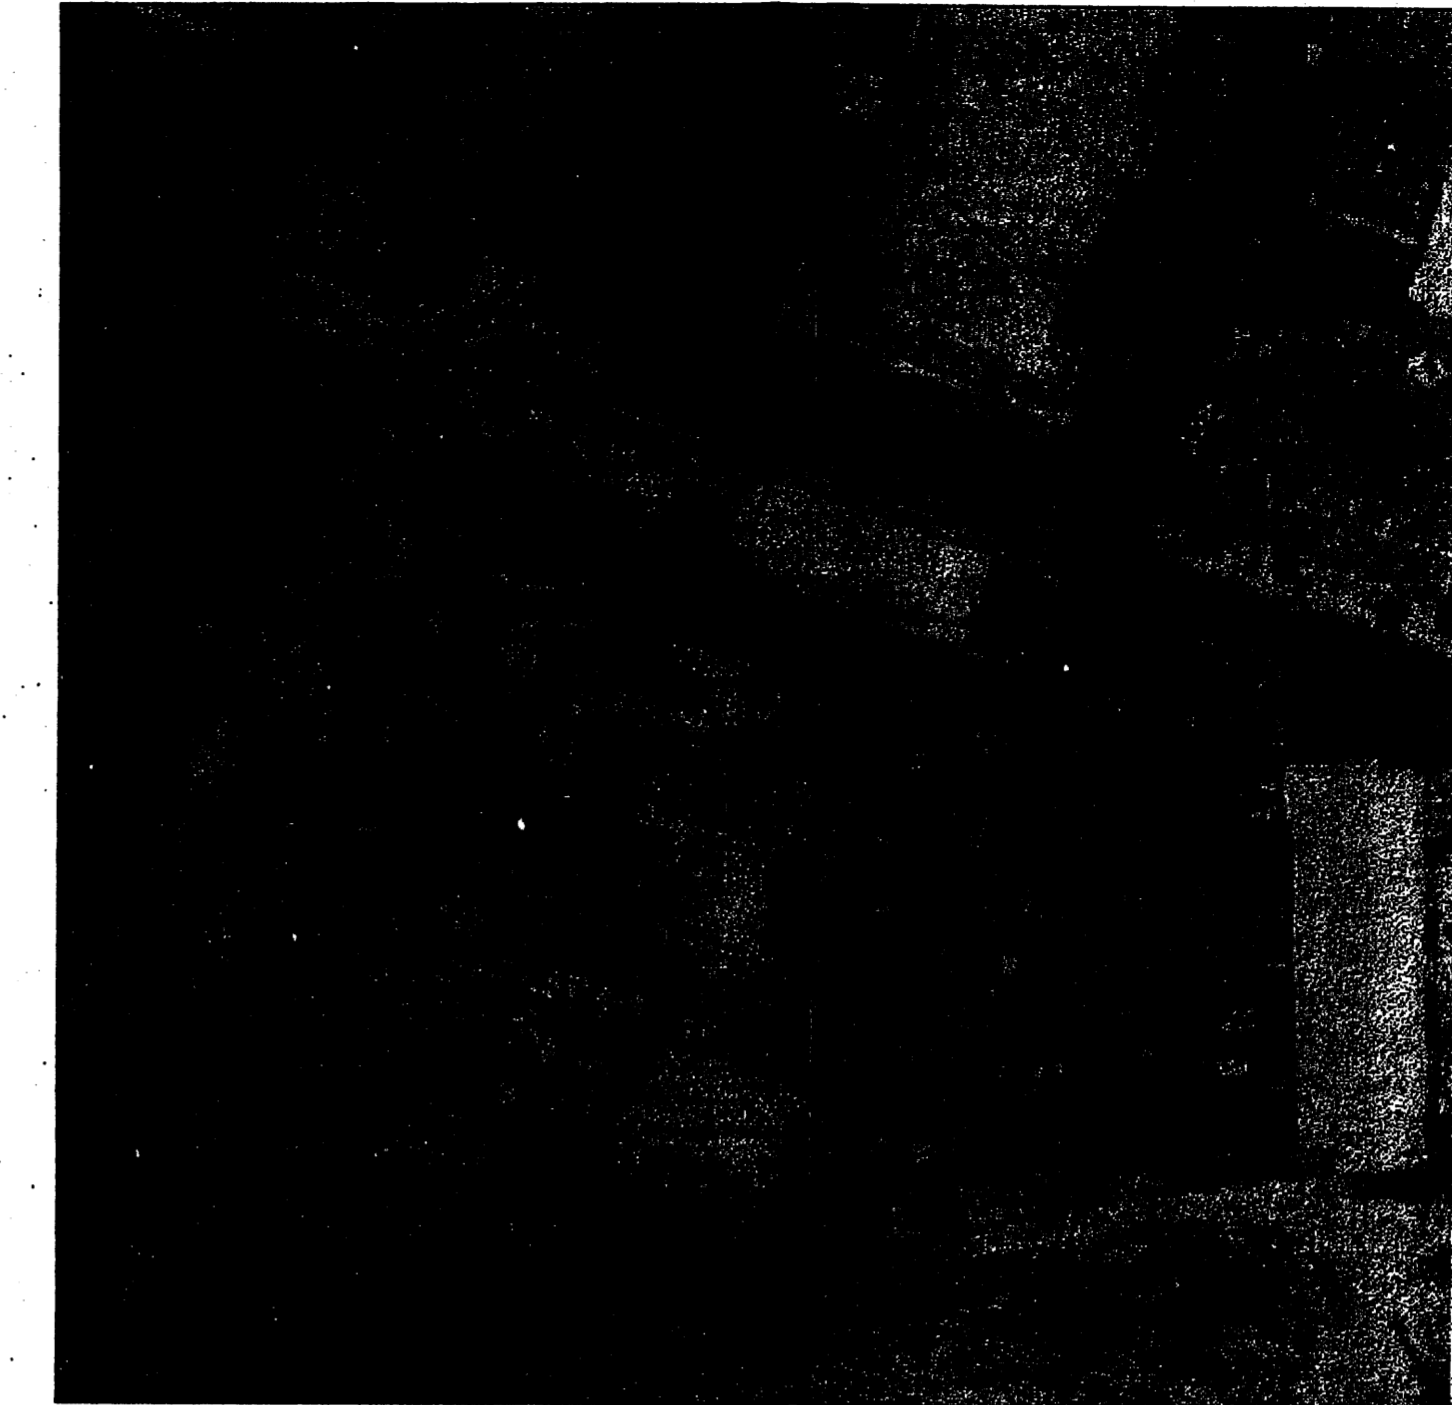

AERIAL PHOTO OF SITE AREA
APPROX. SCALE 1" = 100'

OFF-SITE FLOW CALCULATION:

AREA = 2.72 ACRES - SEE ABOVE MAP.


PER TABLE A-5 OF THE DPM, LIGHT INDUSTRIAL IS 70% TREATMENT D.

ASSUME 30 PERCENT TREATMENT C.

WEIGHTED 100-YEAR PEAK DISCHARGE PER ACRE:

$$q = 0.3 \times 3.14 + 0.7 \times 4.70 = 4.23 \text{ CFS PER ACRE}$$

$$Q_{100} = 4.23 \text{ CFS PER ACRE} \times 2.72 \text{ ACRES} = 11.51 \text{ CFS}$$

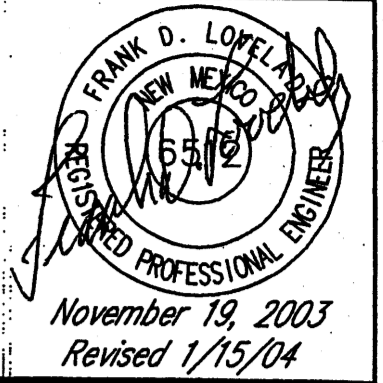


GRADING AND DRAINAGE CALCULATIONS
Warehouse for Commercial Enterprises
8804 WASHINGTON PLACE NE ALBUQUERQUE, NEW MEXICO

KEN HOVEY, ARCHITECT
505) 259-8458 • 3608 SIMMS AVENUE SE • ALBUQUERQUE, NM • 87108

JOB NO:	0309
DATE:	15 JANUARY 2004
REVISIONS	
1.	OFF-SITE FLOW AREA & CALCS

SHEET NO.
C.1.2

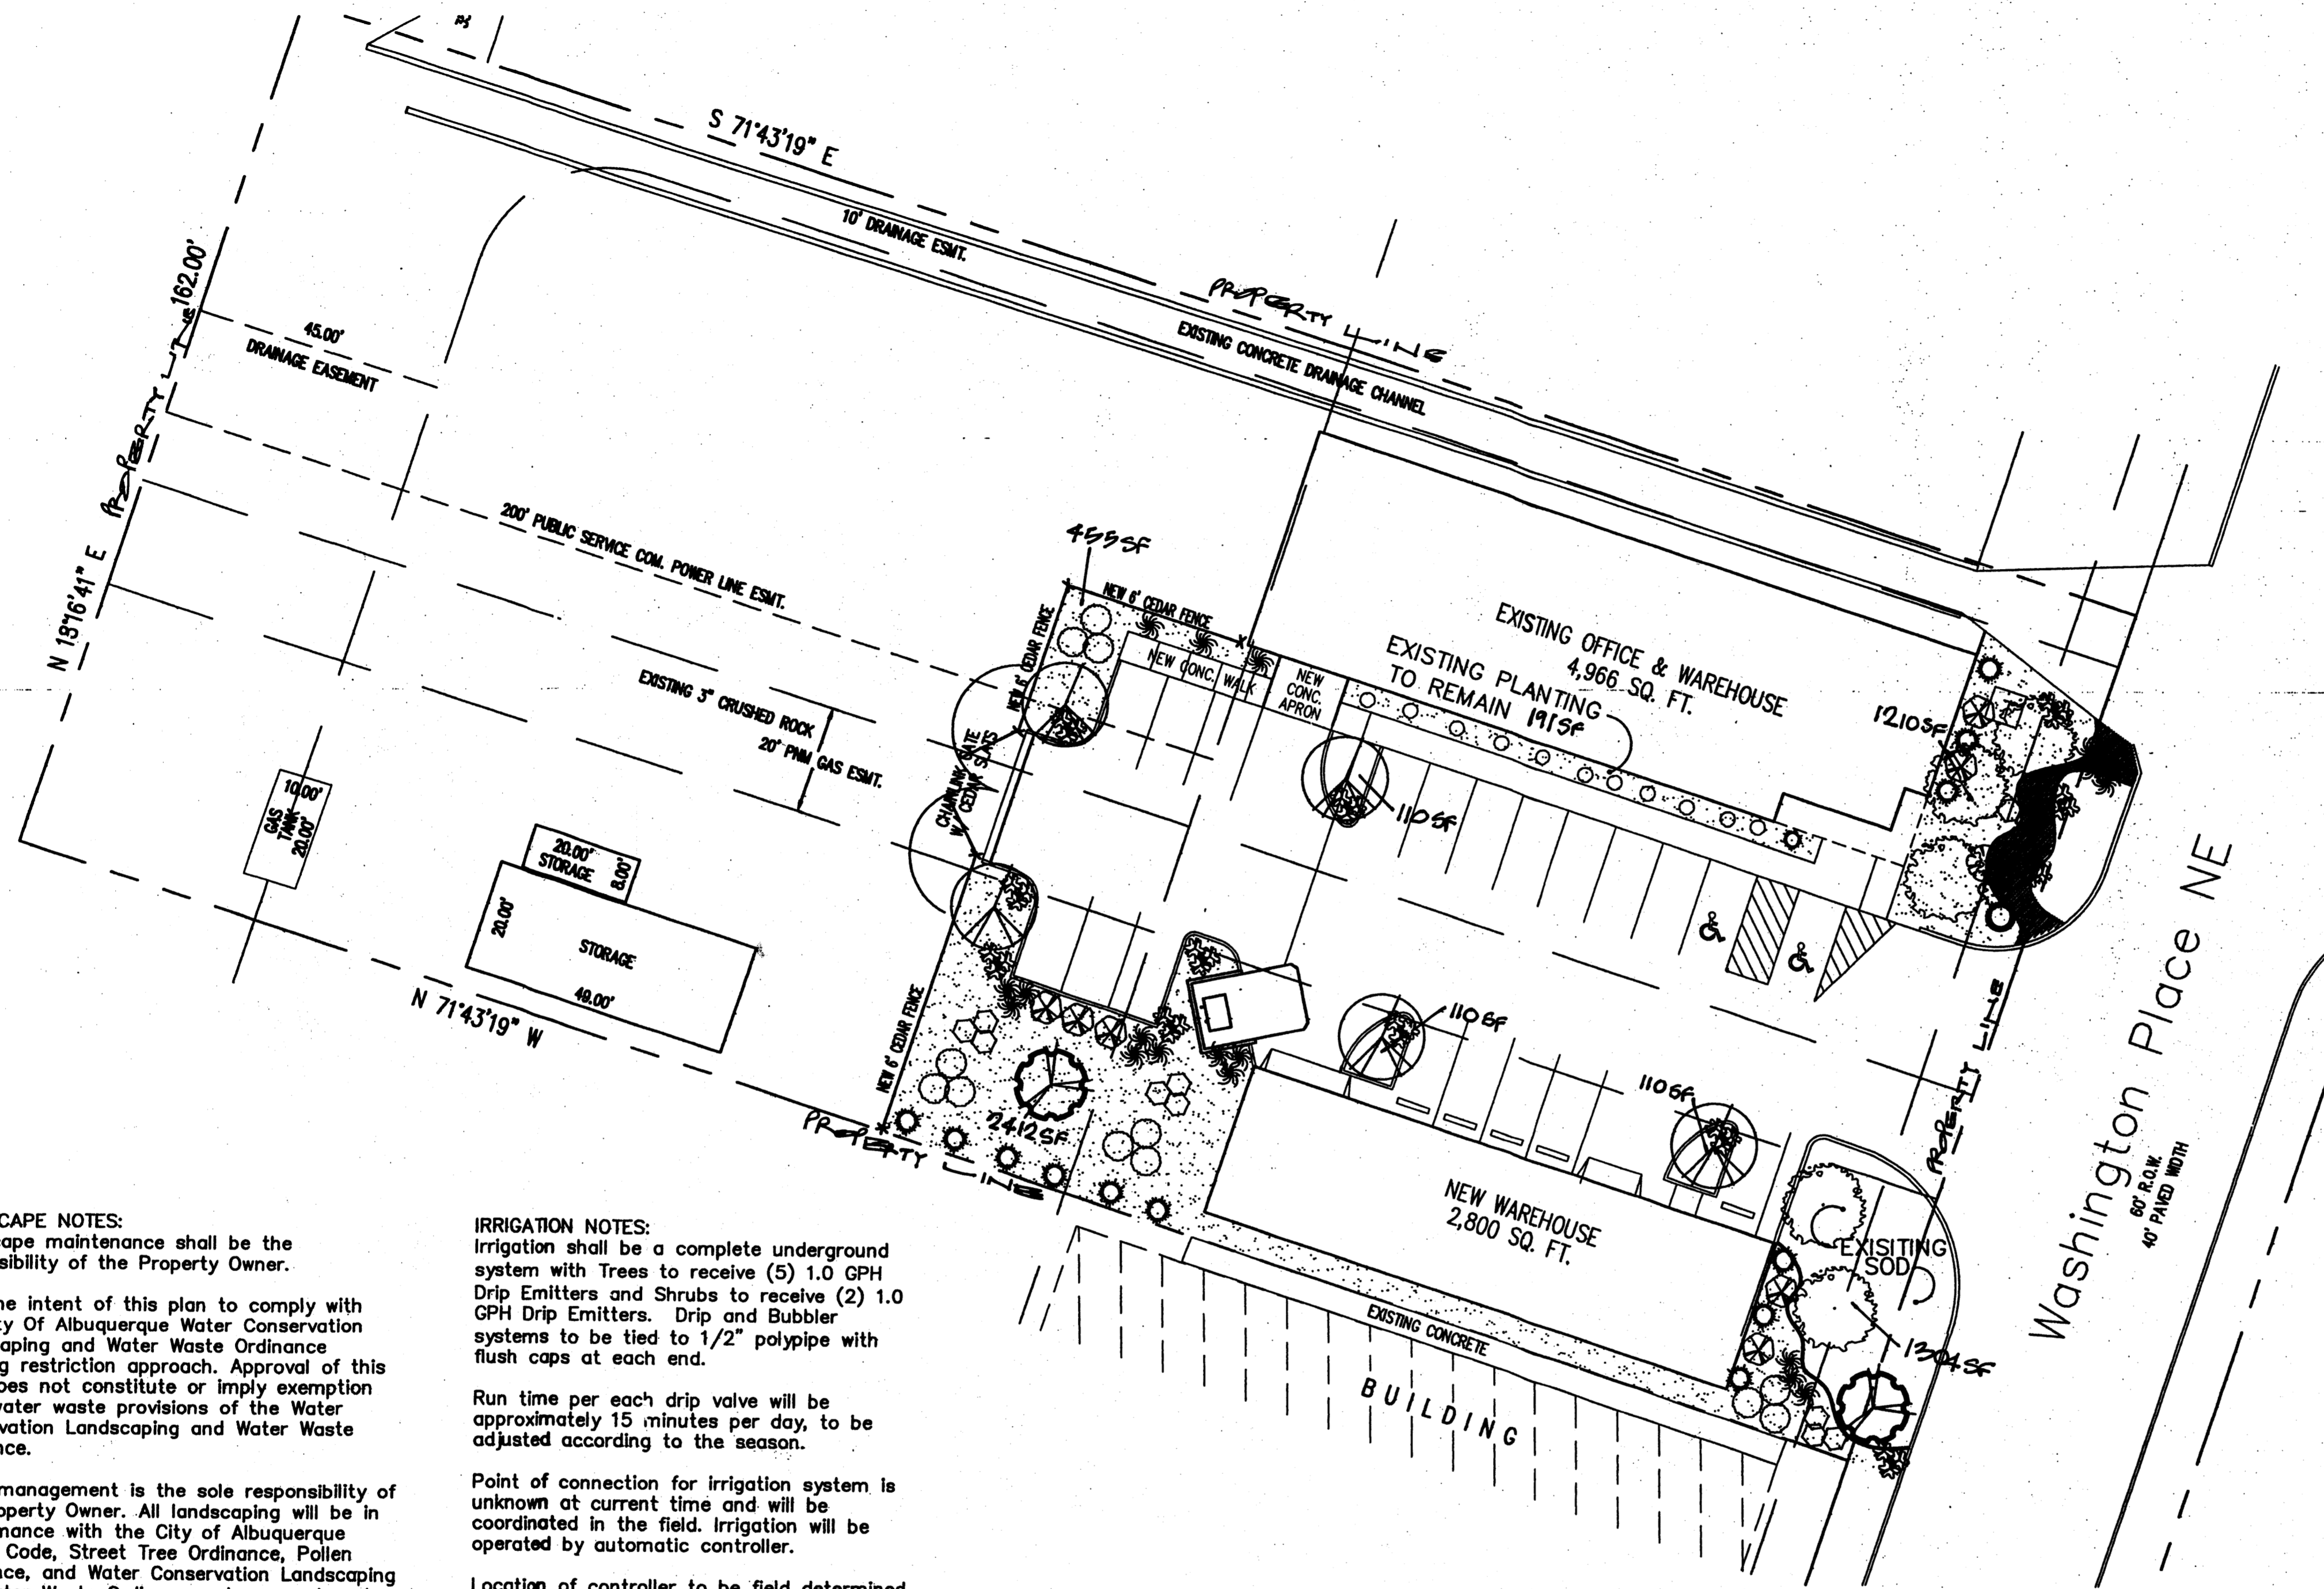

LANDSCAPE NOTES:

Landscape maintenance shall be the responsibility of the Property Owner.

It is the intent of this plan to comply with the City Of Albuquerque Water Conservation Landscaping and Water Waste Ordinance planting restriction approach. Approval of this plan does not constitute or imply exemption from water waste provisions of the Water Conservation Landscaping and Water Waste Ordinance.

Water management is the sole responsibility of the Property Owner. All landscaping will be in conformance with the City of Albuquerque Zoning Code, Street Tree Ordinance, Pollen Ordinance, and Water Conservation Landscaping and Water Waste Ordinance. In general, water conservative, environmentally sound landscape principles will be followed in design and installation.

Plant beds shall achieve 75% live ground cover at maturity.

Gray Gravel over Filter Fabric shall be placed in all landscape areas which are not designated to receive native seed.

IRRIGATION NOTES:

Irrigation shall be a complete underground system with Trees to receive (5) 1.0 GPH Drip Emitters and Shrubs to receive (2) 1.0 GPH Drip Emitters. Drip and Bubbler systems to be tied to 1/2" polytype with flush caps at each end.

Run time per each drip valve will be approximately 15 minutes per day, to be adjusted according to the season.

Point of connection for irrigation system is unknown at current time and will be coordinated in the field. Irrigation will be operated by automatic controller.

Location of controller to be field determined and power source for controller to be provided by others.



Irrigation maintenance shall be the responsibility of the Property Owner.

Water and Power source shall be the responsibility of the Developer/Builder.

LANDSCAPE AREA REQUIREMENTS:

TOTAL SITE AREA:	56,700 SF
LESS BUILDING AREAS:	(7,766 SF)
LESS NON-PUBLIC SITE AREA NOT USED FOR REQUIRED PARKING:	(28,662 SF)
NET SITE AREA:	20,272 SF
REQ'D LANDSCAPE AREA: 72,532 SF x 15 PERCENT =	3,041 SF
PROVIDED LANDSCAPE AREA:	5,902 SF

Fabco Model 765

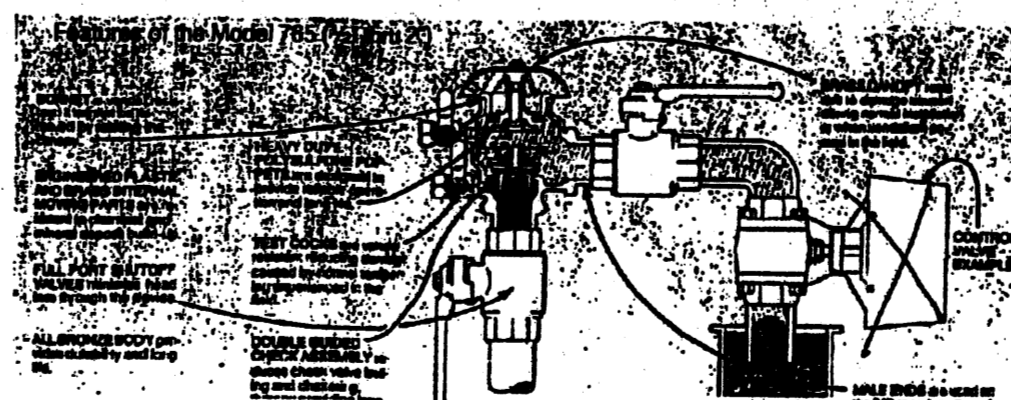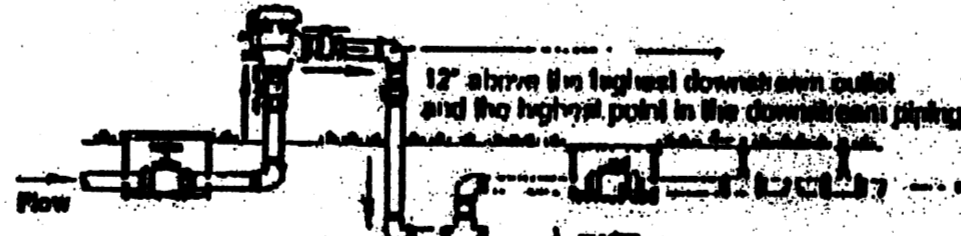


BACKFLOW PREVENTOR DETAIL
no scale

PLANT LEGEND

- FLOWERING PEAR (M+)**
Pyrus calleryana
2" Cal.
- PURPLE-LEAF PLUM (M)**
Prunus spp.
1 1/2" Cal.
- MUGO PINE (M)**
Pinus mugo
5 Gal.
- APACHE PLUME (L)**
Fallugia paradoxa
5 Gal.
- AMERICAN ARBORVITAE**
Cytisus scoparius/
5 Gal. 9sf
- AUTUMN SAGE (M)**
Salvia greggii
2 Gal. 9sf
- CRIMSON PIGMY BARBERRY (M) 19**
Berberis thunbergii "Atropur. Nana"
1 Gal. 4sf
- CHAMISA (L)**
Chrysothamnus nauseosus
1 Gal. 25sf
- MAIDENGRASS (M)**
Miscanthus sinensis
5 Gal. 16sf
- THREADGRASS (M)**
Stipa tenuissima
1 Gal. 4sf
- PRICKLY PEAR (L)**
Opuntia macrocentra
9 sf
- NATURAL EDGE**
- OVERSIZED GRAVEL & BOULDERS**
- 3/4" CRUSHED GRAY GRAVEL WITH FILTER FABRIC**
- SANTA FE BROWN CRUSHER FINES WITH FILTER FABRIC**

GRAPHIC SCALE

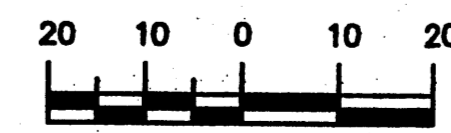

SCALE: 1"=20'



The Hilltop
LANDSCAPE ARCHITECTS & CONTRACTORS

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Fax (505) 898-7737
cjohnson@hilltoplandscaping.com


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Warehouse for Commercial Enterprises
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JOB NO:	0309
DATE:	25 MARCH 2005
REVISIONS	

SHEET NO.
L.1




Warehouse for Commercial Enterprises
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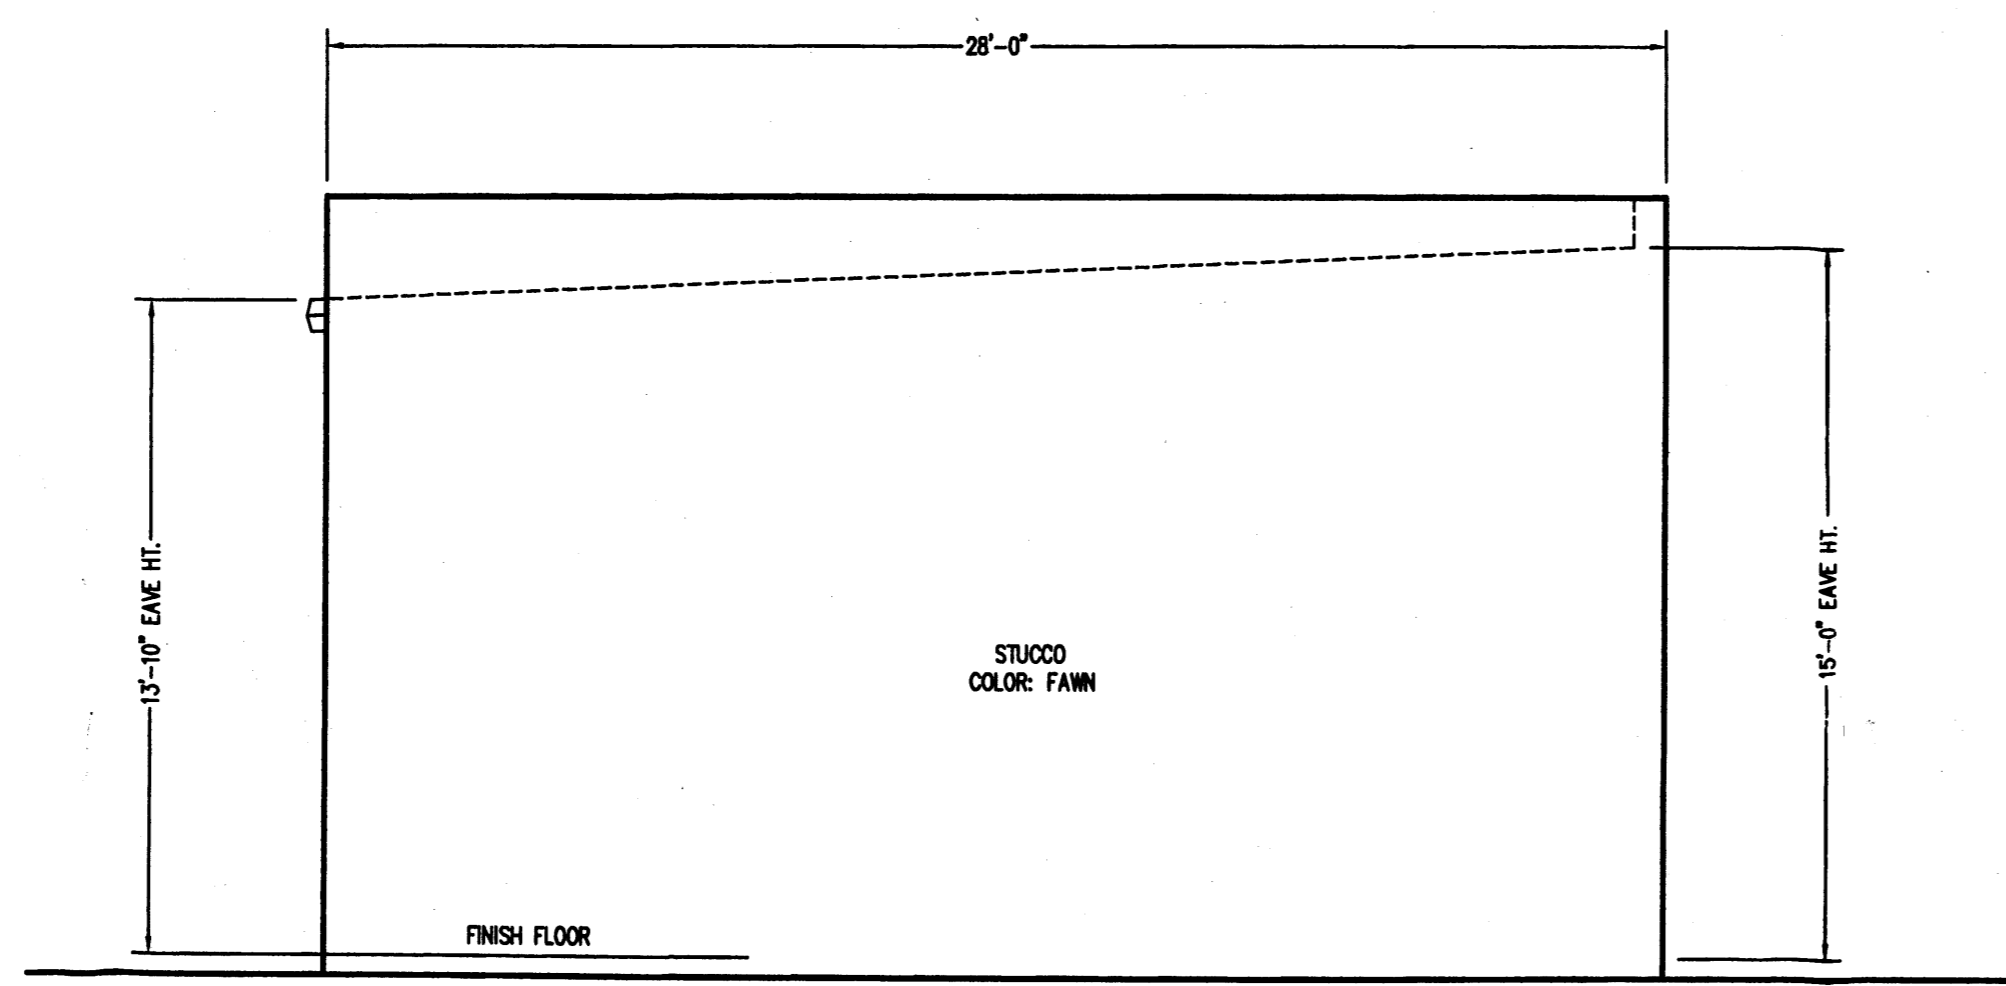
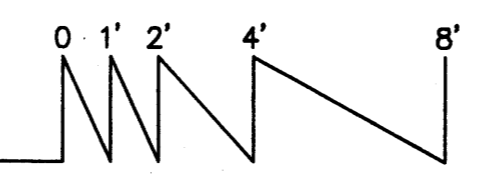
KEN HOVEY, ARCHITECT
6005 25th AVENUE SE • ALBUQUERQUE, NM • 87105
505 251-8458

JOB NO:	0301
DATE:	30 MARCH 2004
REVISIONS	


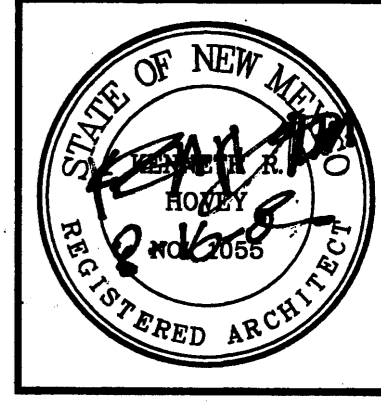
SHEET NO.
A.2

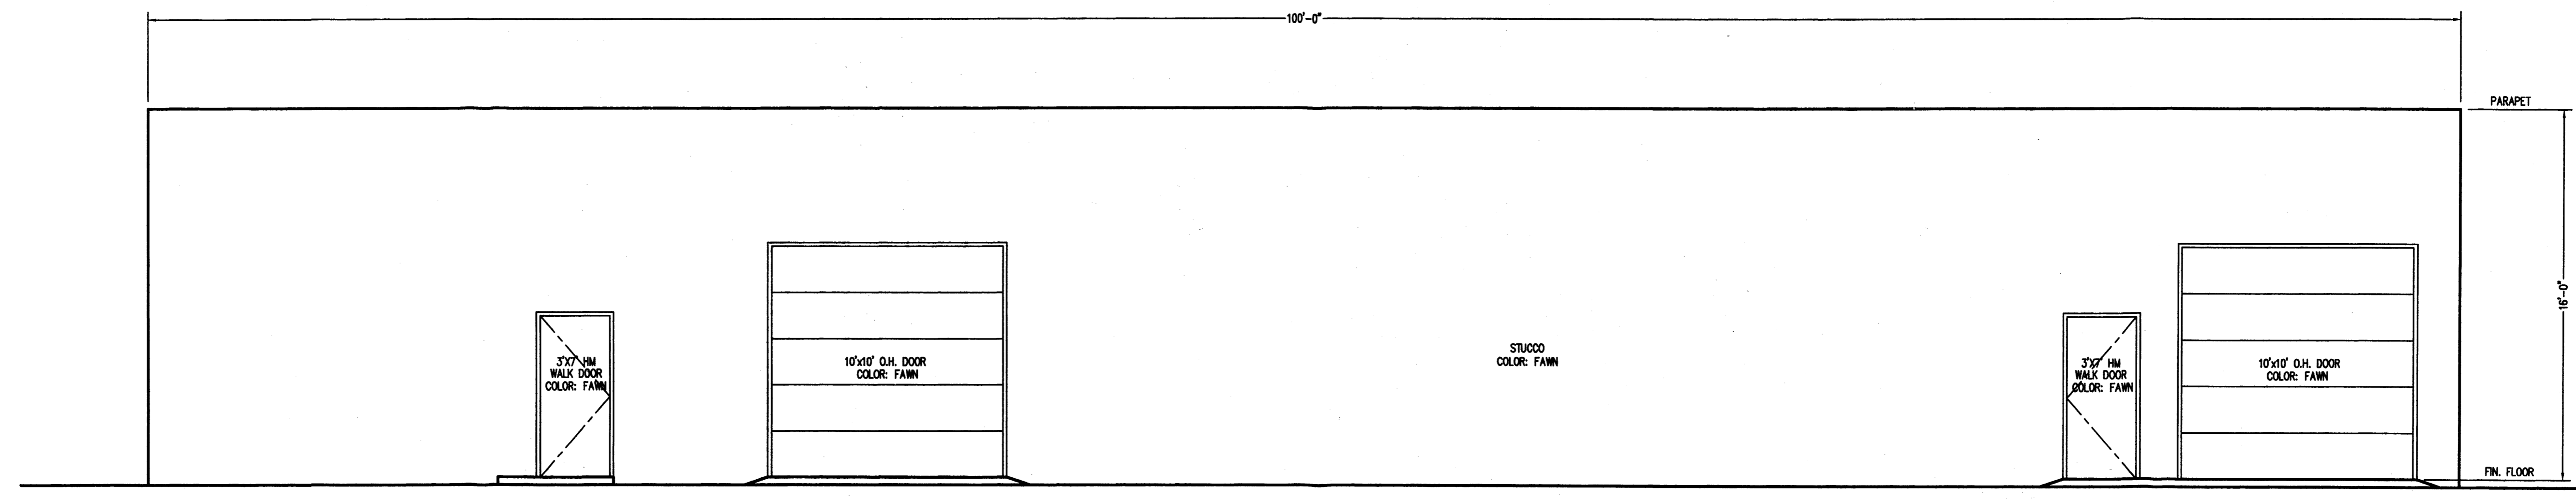



North Elevation
Scale: 1/4"=1'-0"




East Elevation
Scale: 1/4"=1'-0"

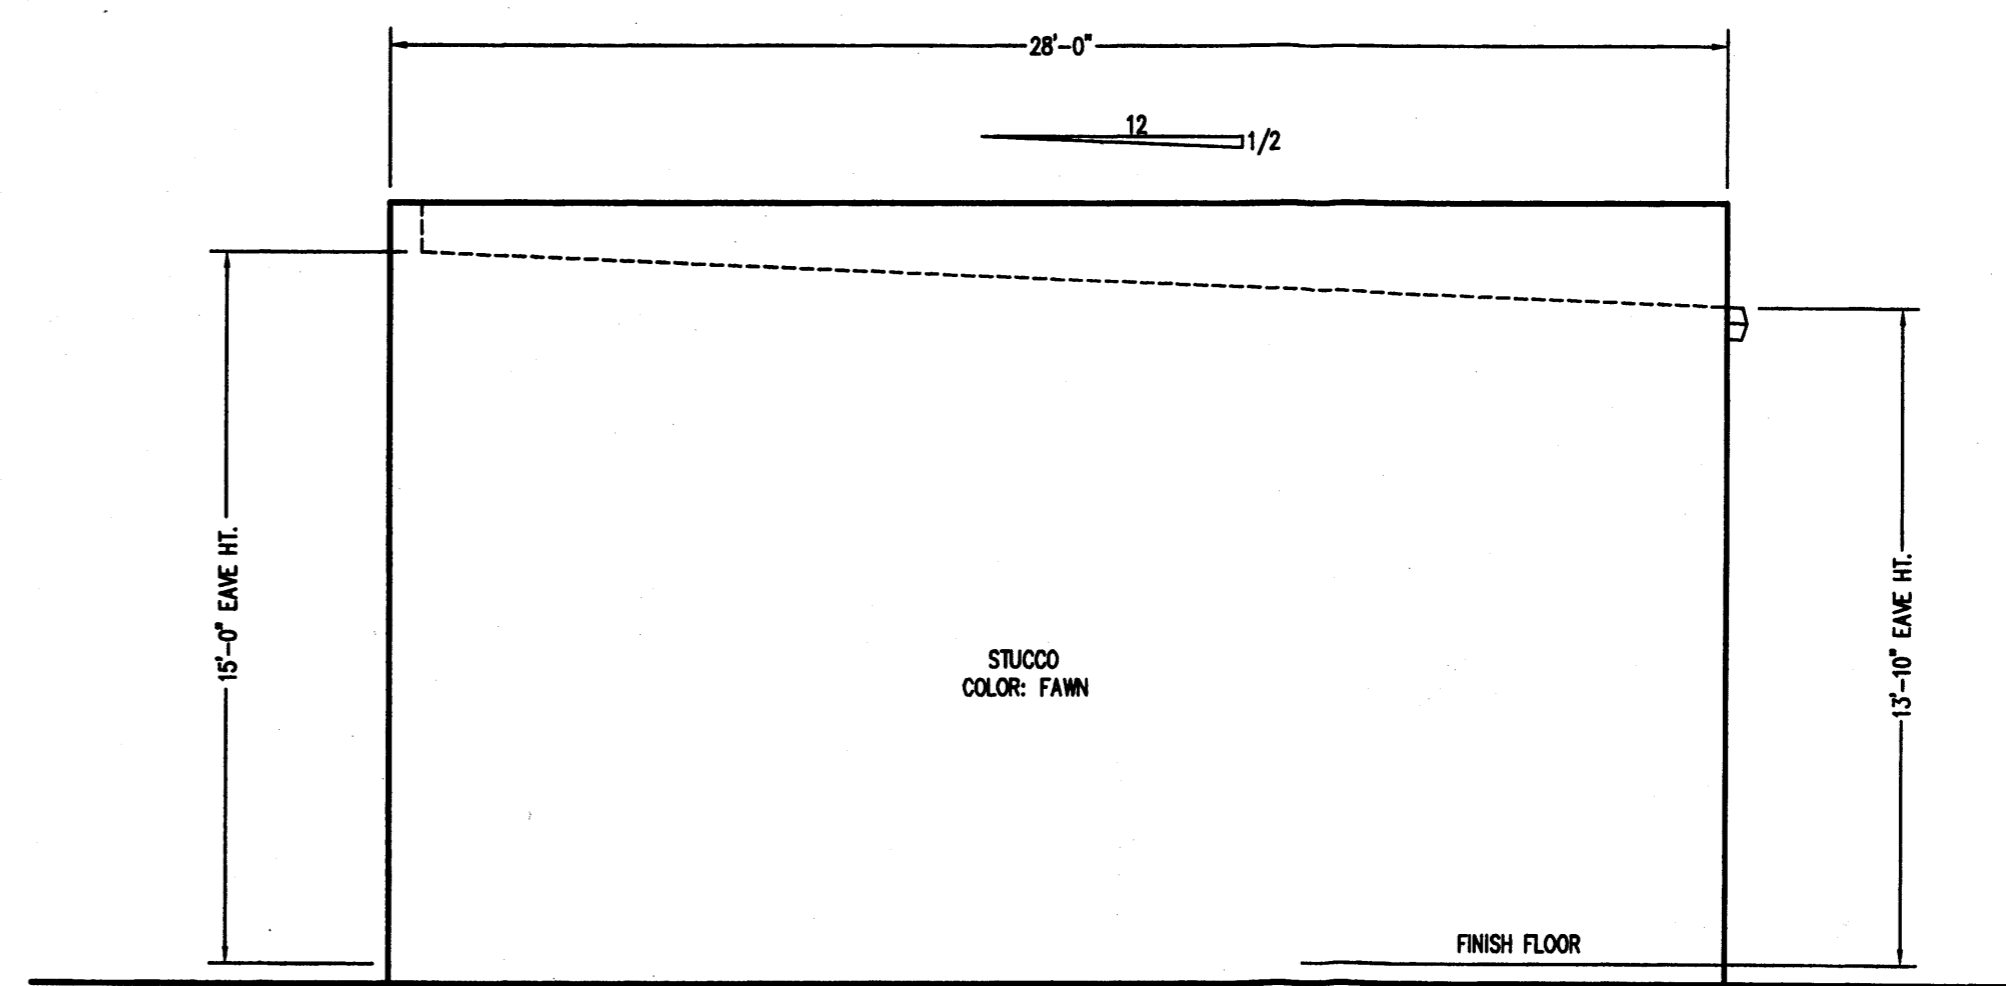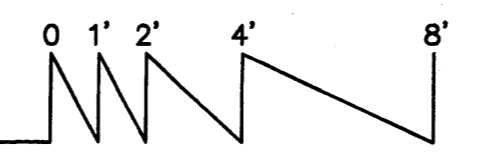


West Elevation
Scale: 1/4"=1'-0"

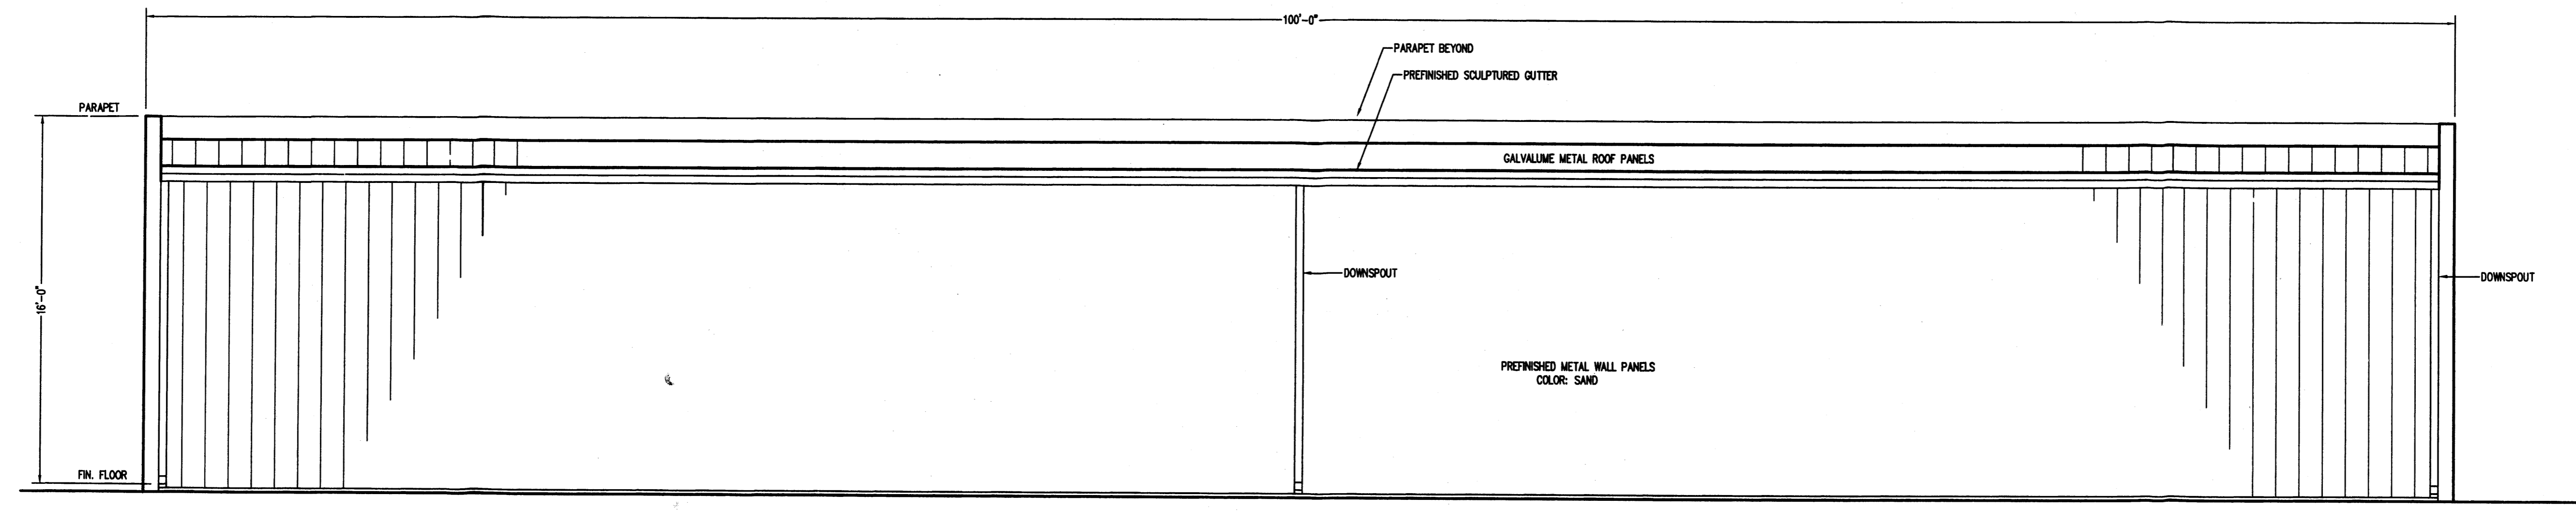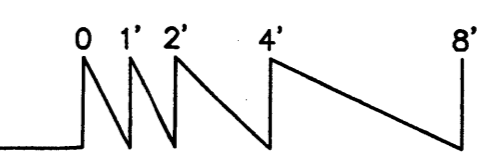

South Elevation
Scale: 1/4"=1'-0"

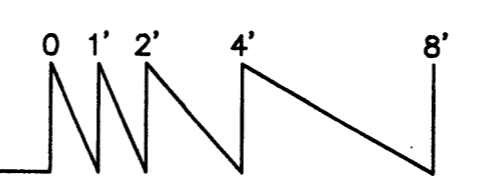

Exterior Building Elevations

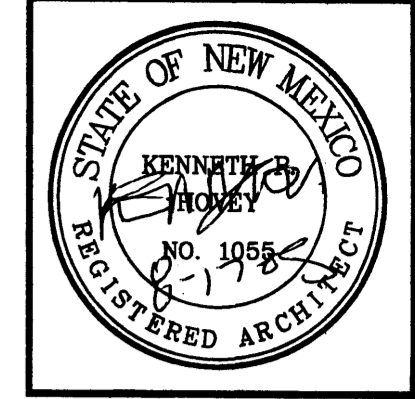


Warehouse for Commercial Enterprises
8801 WASHINGTON PLACE NE ALBUQUERQUE, NEW MEXICO


KEN HOVEY, ARCHITECT
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PROJECT NO:	0309
DATE:	16 AUGUST 2005
REVISIONS:	

SHEET NO.
SD.1

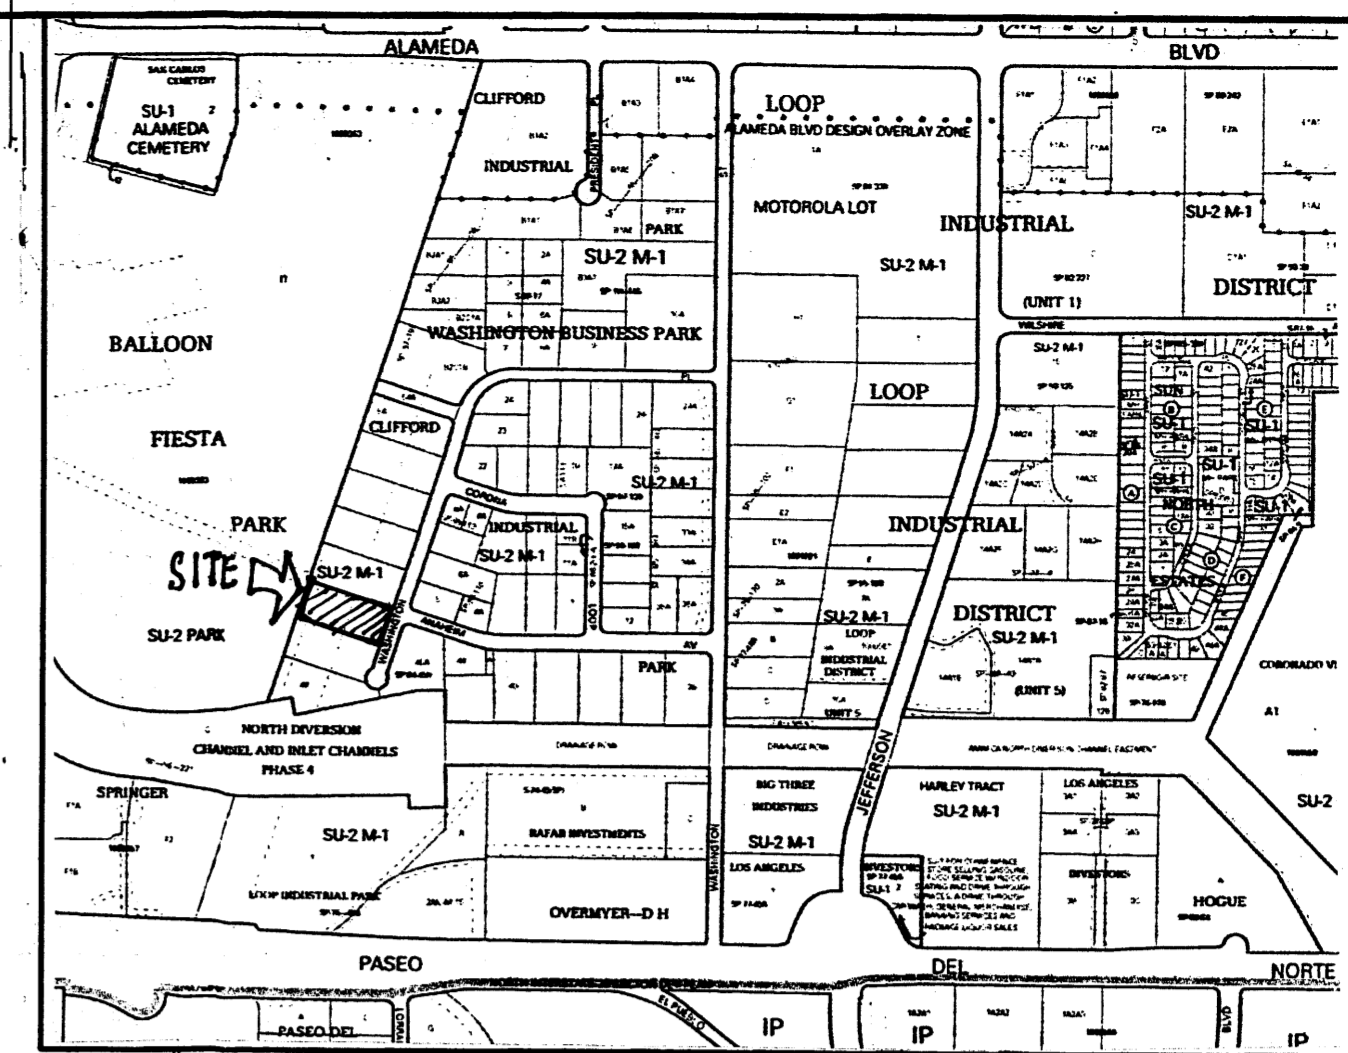

Vicinity Map C-17

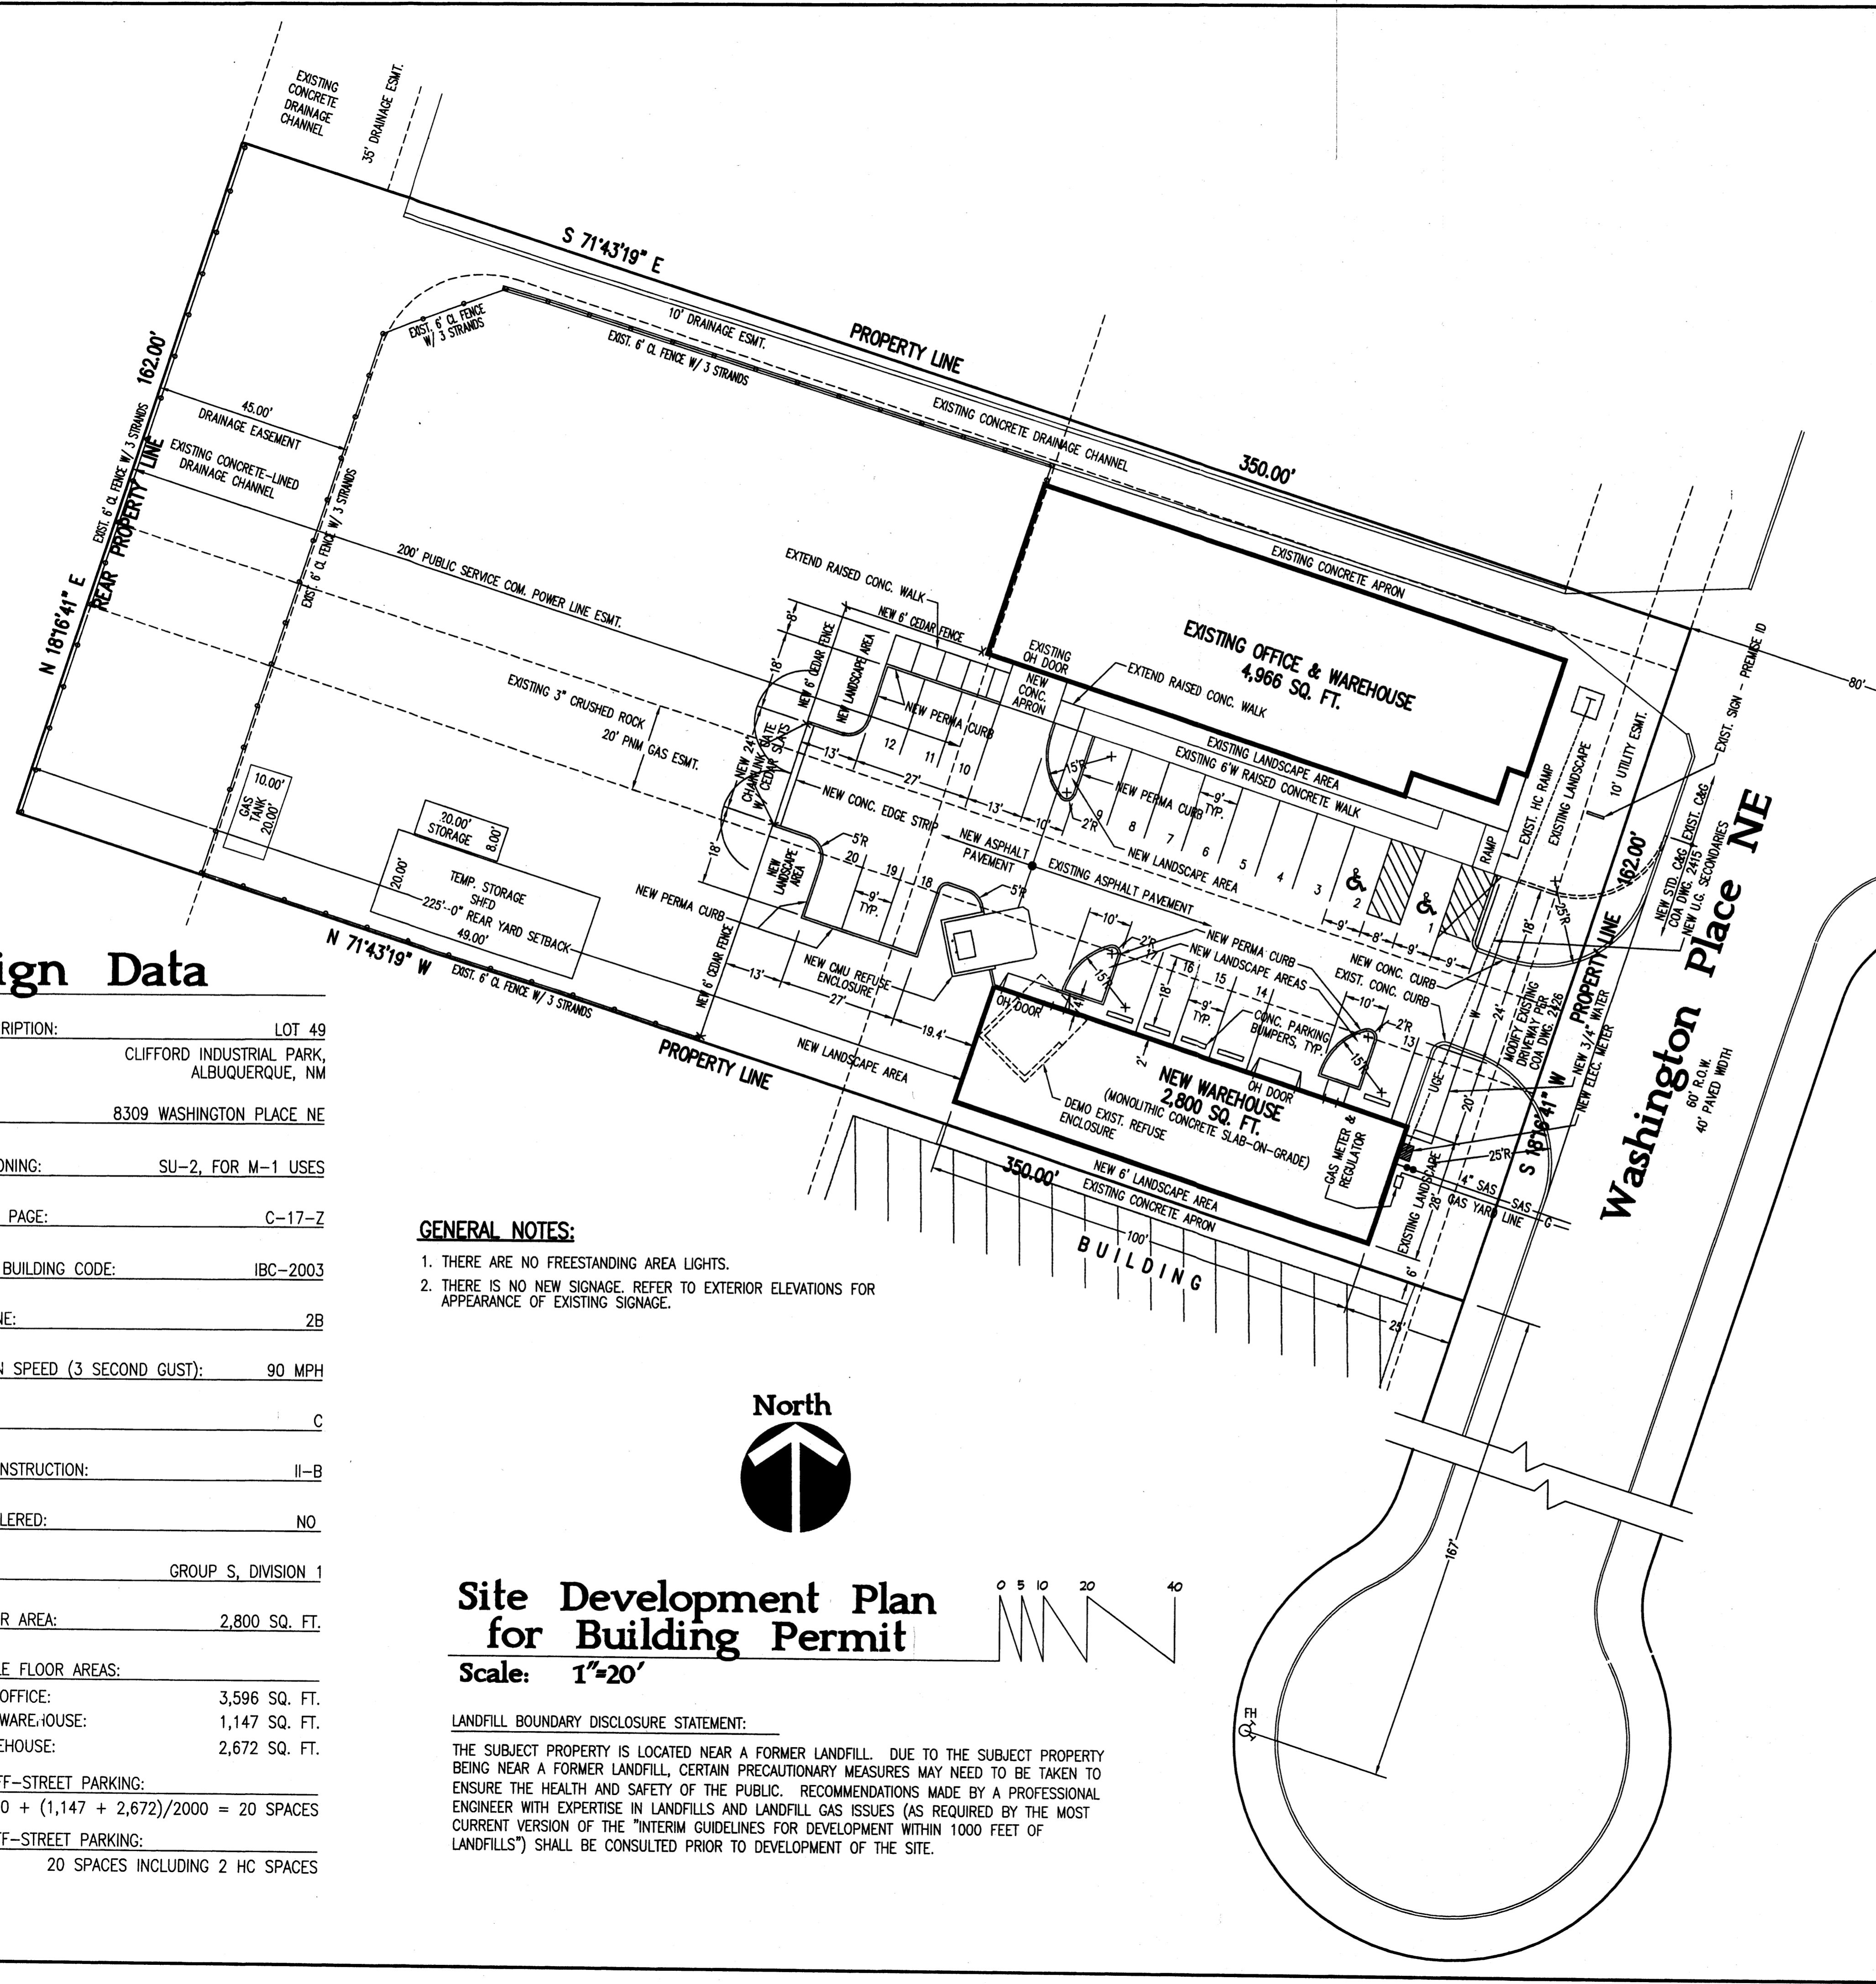

Anaheim Ave.

Washington Place NE

Design Data

LEGAL DESCRIPTION:	LOT 49 CLIFFORD INDUSTRIAL PARK, ALBUQUERQUE, NM
ADDRESS:	8309 WASHINGTON PLACE NE
CURRENT ZONING:	SU-2, FOR M-1 USES
ZONE ATLAS PAGE:	C-17-Z
APPLICABLE BUILDING CODE:	IBC-2003
SEISMIC ZONE:	2B
WIND DESIGN SPEED (3 SECOND GUST):	90 MPH
EXPOSURE:	C
TYPE OF CONSTRUCTION:	II-B
FIRE SPRINKLERED:	NO
OCCUPANCY:	GROUP S, DIVISION 1
GROSS FLOOR AREA:	2,800 SQ. FT.
NET LEASABLE FLOOR AREAS:	
EXISTING OFFICE:	3,596 SQ. FT.
EXISTING WAREHOUSE:	1,147 SQ. FT.
NEW WAREHOUSE:	2,672 SQ. FT.
REQUIRED OFF-STREET PARKING:	
$3,596/200 + (1,147 + 2,672)/2000 = 20$ SPACES	
PROVIDED OFF-STREET PARKING:	
20 SPACES INCLUDING 2 HC SPACES	


GENERAL NOTES:

1. THERE ARE NO FREESTANDING AREA LIGHTS.
2. THERE IS NO NEW SIGNAGE. REFER TO EXTERIOR ELEVATIONS FOR APPEARANCE OF EXISTING SIGNAGE.



Site Development Plan for Building Permit

Scale: 1"=20'

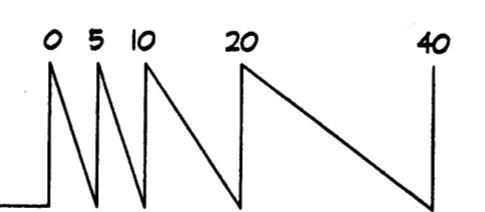

LANDFILL BOUNDARY DISCLOSURE STATEMENT:

THE SUBJECT PROPERTY IS LOCATED NEAR A FORMER LANDFILL. DUE TO THE SUBJECT PROPERTY BEING NEAR A FORMER LANDFILL, CERTAIN PRECAUTIONARY MEASURES MAY NEED TO BE TAKEN TO ENSURE THE HEALTH AND SAFETY OF THE PUBLIC. RECOMMENDATIONS MADE BY A PROFESSIONAL ENGINEER WITH EXPERTISE IN LANDFILLS AND LANDFILL GAS ISSUES (AS REQUIRED BY THE MOST CURRENT VERSION OF THE "INTERIM GUIDELINES FOR DEVELOPMENT WITHIN 1000 FEET OF LANDFILLS") SHALL BE CONSULTED PRIOR TO DEVELOPMENT OF THE SITE.

PROJECT NUMBER: 1003358
 Application Number: 04-00478

Is an Infrastructure List required? () Yes () No If yes, then a set of approved DRG plans with a work order is required for any construction within Public Right-of-Way or for construction of public improvements.

DRB SITE DEVELOPMENT PLAN APPROVAL:

Traffic Engineering, Transportation Division	Date
Water Utility Department	Date
Parks and Recreation Department	Date
City Engineer	Date
Environmental Health Department	Date
Solid Waste Management	Date
DRB Chairperson, Planning Department	Date